PUYALLUP STATION PARKING

RTA/CN 0612-18
CONTRACT S300017
PUYALLUP STATION PARKING AND ACCESS IMPROVEMENTS

DESIGN PACKAGE #2 - SITEWORK AND UTILITIES E-20-0504 - CIVIL PERMIT RESUBMITTAL 1/11/2021

PREPARED BY:



HENSEL PHELPS

Plan. Build. Manage.




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THE PREPARATION OF THIS DOCUMENT HAS BEEN FINANCED IN PART THROUGH A GRANT FROM THE U.S. DEPARTMENT OF TRANSPORTATION FEDERAL TRANSIT ADMINISTRATION UNDER THE URBAN MASS TRANSPORTATION ACT OF 1964, AS AMENDED, AND IN PART BY THE CENTRAL PUGET SOUND REGIONAL TRANSIT AUTHORITY DISTRICT OF WASHINGTON, AND THE STATE OF WASHINGTON






CONTRACT LOCATION MAP

DRAWING No.:

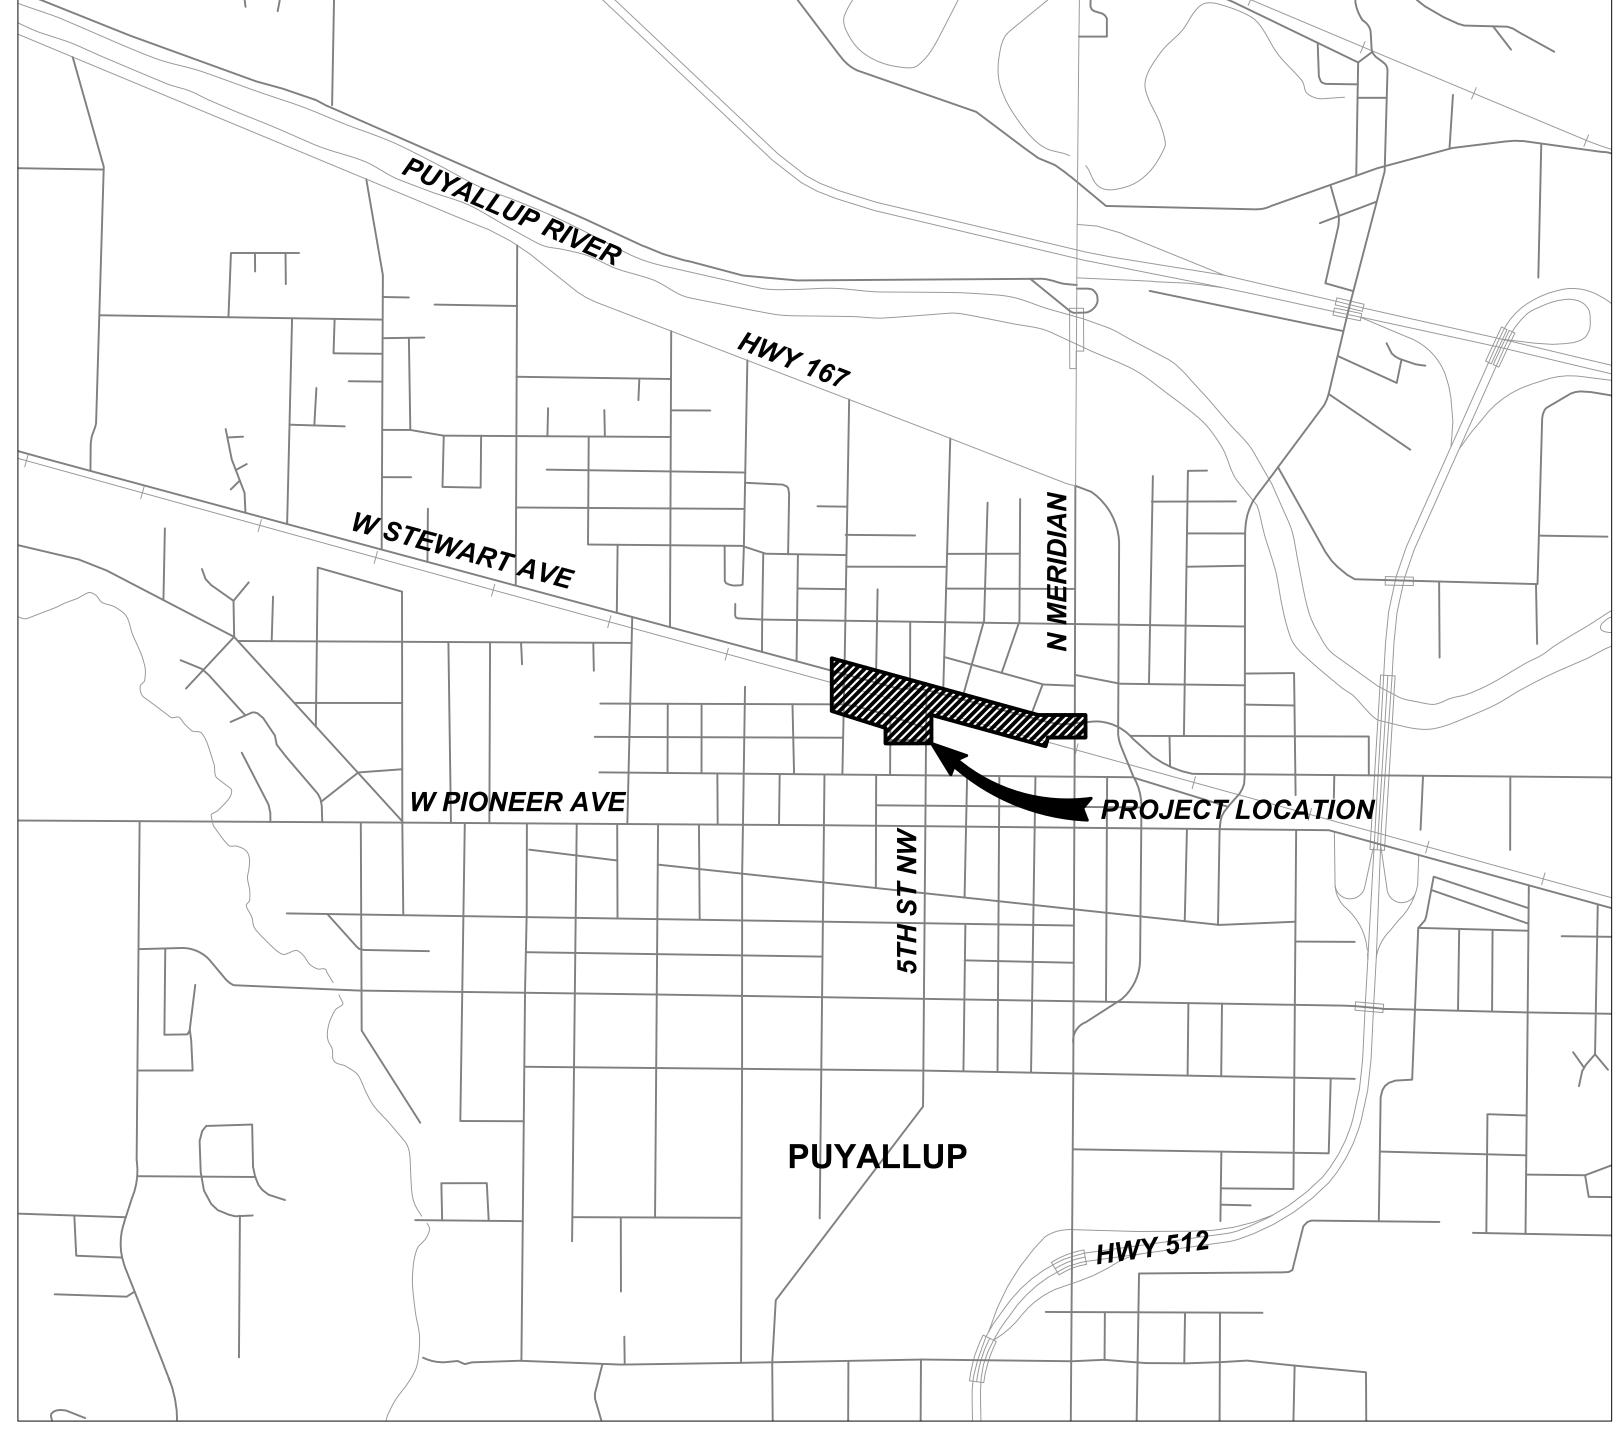GEN-GZT121

BOOK 1 OF 1

F1592
HEET No.: REV

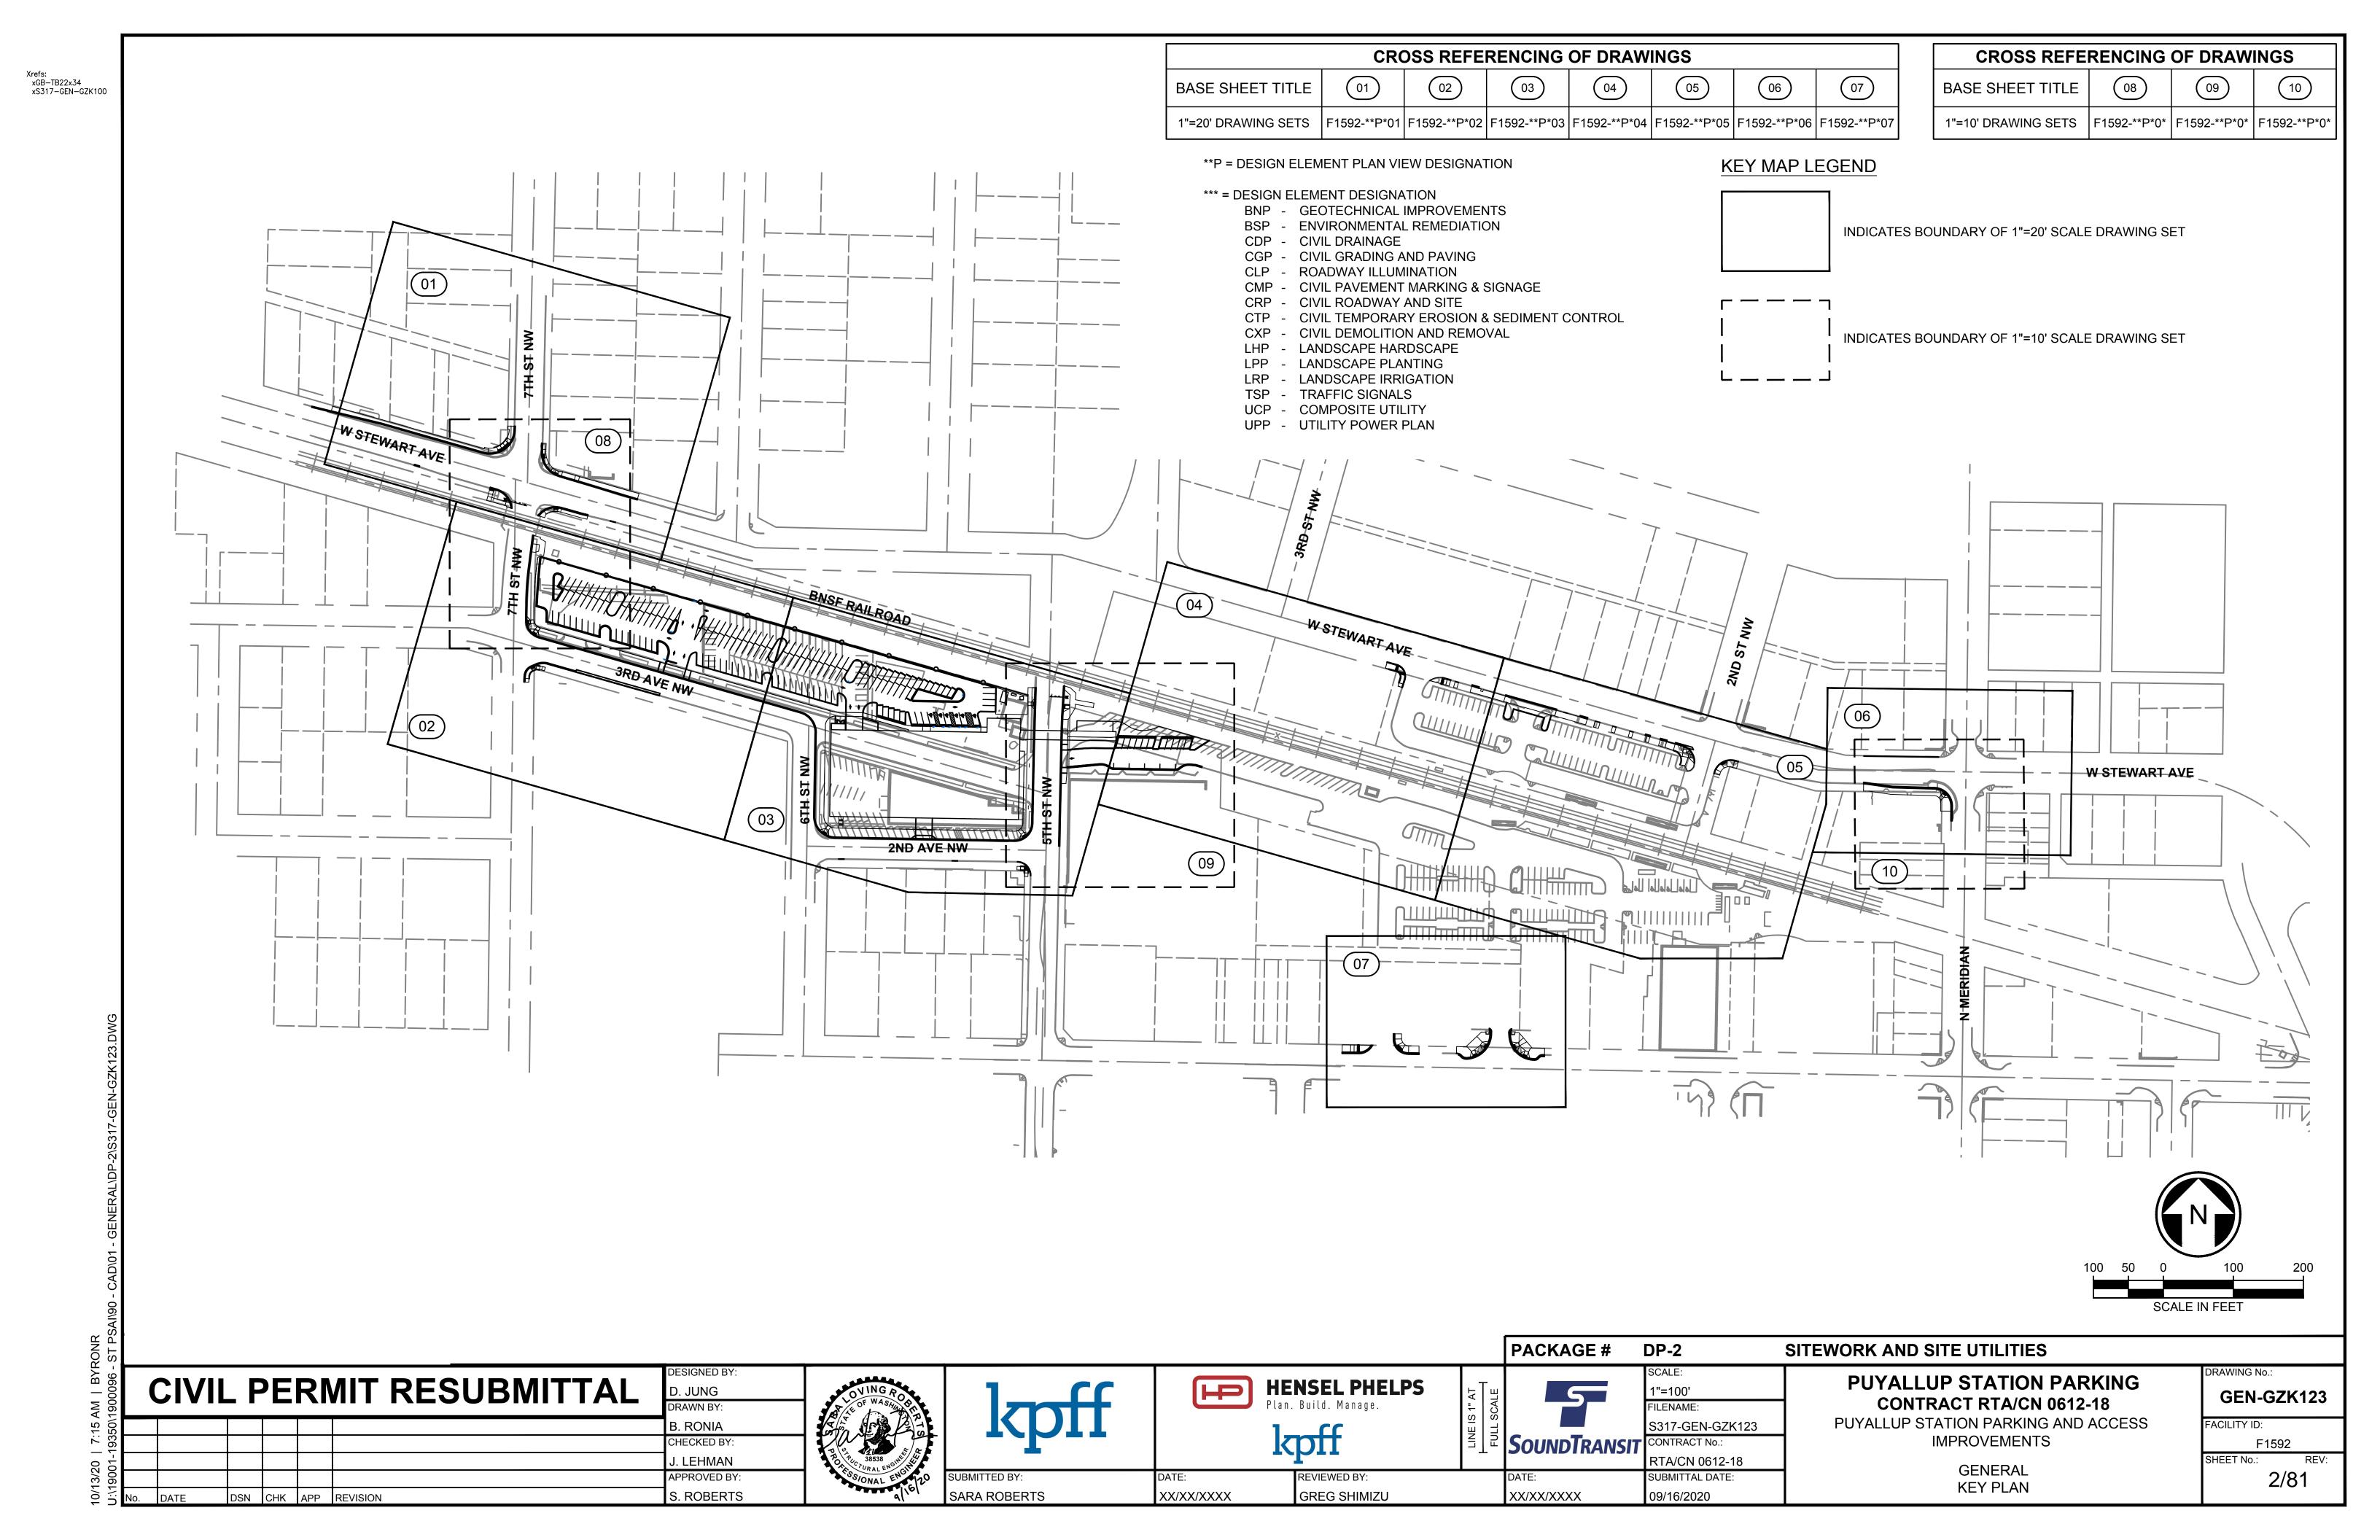

PLANS AT THE MEETING.

1. ALL WORK IN CITY RIGHT-OF-WAY REQUIRES A PERMIT FROM THE CITY OF PUYALLUP. PRIOR TO ANY WORK COMMENCING. THE GENERAL CONTRACTOR SHALL ARRANGE FOR A PRECONSTRUCTION MEETING AT THE DEVELOPMENT SERVICES CENTER TO BE ATTENDED BY ALL CONTRACTORS THAT WILL PERFORM WORK SHOWN ON THE ENGINEERING PLANS, REPRESENTATIVES FROM ALL APPLICABLE UTILITY COMPANIES, THE PROJECT OWNER AND APPROPRIATE CITY STAFF. CONTACT ENGINEERING SERVICES TO SCHEDULE THE MEETING

(253) 841-5568. THE CONTRACTOR IS RESPONSIBLE TO HAVE THEIR OWN APPROVED SET OF

- AFTER COMPLETION OF ALL ITEMS SHOWN ON THESE PLANS AND BEFORE ACCEPTANCE OF THE PROJECT, THE CONTRACTOR SHALL OBTAIN A "PUNCH LIST" PREPARED BY THE CITY'S INSPECTOR DETAILING REMAINING ITEMS OF WORK TO BE COMPLETED. ALL ITEMS OF WORK SHOWN ON THESE PLANS SHALL BE COMPLETED TO THE SATISFACTION OF THE CITY PRIOR TO ACCEPTANCE OF THE WATER SYSTEM AND PROVISION OF SANITARY SEWER SERVICE.
- ALL MATERIALS AND WORKMANSHIP SHALL CONFORM TO THE STANDARD SPECIFICATIONS FOR ROAD, BRIDGE, AND MUNICIPAL CONSTRUCTION (HEREINAFTER REFERRED TO AS THE "STANDARD SPECIFICATIONS"), WASHINGTON STATE DEPARTMENT OF TRANSPORTATION AND AMERICAN PUBLIC WORKS ASSOCIATION, WASHINGTON STATE CHAPTER, LATEST EDITION, UNLESS SUPERSEDED OR AMENDED BY THE CITY OF PUYALLUP CITY STANDARDS FOR PUBLIC WORKS ENGINEERING AND CONSTRUCTION (HEREINAFTER REFERRED TO AS THE "CITY STANDARDS").
- A COPY OF THESE APPROVED PLANS AND APPLICABLE CITY DEVELOPER SPECIFICATIONS AND DETAILS SHALL BE ON SITE DURING CONSTRUCTION.
- ANY REVISIONS MADE TO THESE PLANS MUST BE REVIEWED AND APPROVED BY THE DEVELOPER'S ENGINEER AND THE ENGINEERING SERVICES STAFF PRIOR TO ANY IMPLEMENTATION IN THE FIELD. THE CITY SHALL NOT BE RESPONSIBLE FOR ANY ERRORS AND/OR OMISSIONS ON THESE PLANS.
- THE CONTRACTOR SHALL HAVE ALL UTILITIES VERIFIED ON THE GROUND PRIOR TO ANY CONSTRUCTION. CALL (811) AT LEAST TWO WORKING DAYS IN ADVANCE. THE OWNER AND HIS/HER ENGINEER SHALL BE CONTACTED IMMEDIATELY IF A CONFLICT EXISTS.
- ANY STRUCTURE AND/OR OBSTRUCTION WHICH REQUIRE REMOVAL OR RELOCATION RELATING TO THIS PROJECT, SHALL BE DONE SO AT THE DEVELOPER'S EXPENSE.
- LOCATIONS OF EXISTING UTILITIES ARE APPROXIMATE . IT SHALL BE THE CONTRACTOR'S RESPONSIBILITY TO DETERMINE THE TRUE ELEVATIONS AND LOCATIONS OF HIDDEN UTILITIES. ALL VISIBLE ITEMS SHALL BE THE ENGINEER'S RESPONSIBILITY.
- 9. THE CONTRACTOR SHALL INSTALL, REPLACE, OR RELOCATE ALL SIGNS, AS SHOWN ON THE PLANS OR AS AFFECTED BY CONSTRUCTION, PER CITY STANDARDS.
- 10. POWER, STREET LIGHT, CABLE, AND TELEPHONE LINES SHALL BE IN A TRENCH LOCATED WITHIN A 10-FOOT UTILITY EASEMENT ADJACENT TO PUBLIC RIGHT-OF-WAY. RIGHT-OF-WAY CROSSINGS SHALL HAVE A MINIMUM HORIZONTAL SEPARATION FROM OTHER UTILITIES (SEWER, WATER, AND STORM) OF 5 FEET.
- 11. ALL CONSTRUCTION SURVEYING FOR EXTENSIONS OF PUBLIC FACILITIES SHALL BE DONE UNDER THE DIRECTION OF A WASHINGTON STATE LICENSED LAND SURVEYOR OR A WASHINGTON STATE LICENSED PROFESSIONAL CIVIL ENGINEER.
- 12. DURING CONSTRUCTION, ALL PUBLIC STREETS ADJACENT TO THIS PROJECT SHALL BE KEPT CLEAN OF ALL MATERIAL DEPOSITS RESULTING FROM ON-SITE CONSTRUCTION, AND EXISTING STRUCTURES SHALL BE PROTECTED AS DIRECTED BY CITY.
- 13. CERTIFIED RECORD DRAWINGS ARE REQUIRED PRIOR TO PROJECT ACCEPTANCE.
- 14. A NPDES STORMWATER GENERAL PERMIT MAY BE REQUIRED BY THE DEPARTMENT OF ECOLOGY FOR THIS PROJECT. FOR INFORMATION CONTACT THE DEPARTMENT OF ECOLOGY. SOUTHWEST REGION OFFICE AT (360)407-6300.
- 15. ANY DISTURBANCE OR DAMAGE TO CRITICAL AREAS AND ASSOCIATED BUFFERS, OR SIGNIFICANT TREES DESIGNATED FOR PRESERVATION AND PROTECTION SHALL BE MITIGATED IN ACCORDANCE WITH A MITIGATION PLAN REVIEWED AND APPROVED BY THE CITY'S PLANNING DIVISION. PREPARATION AND IMPLEMENTATION OF THE MITIGATION PLAN SHALL BE AT THE DEVELOPER'S EXPENSE.

PUYALLUP STORM WATER NOTES:

- DURING CONSTRUCTION, ALL EXISTING AND NEWLY INSTALLED DRAINAGE STRUCTURES SHALL BE PROTECTED FROM SEDIMENTS.
- ALL STORM MANHOLES SHALL CONFORM TO CITY STANDARD DETAIL NO. 02.01.01. FLOW CONTROL MANHOLE/OIL WATER SEPARATOR SHALL CONFORM TO CITY STANDARD DETAIL NO. 02.01.06 AND 02.01.07.
- MANHOLE RING AND COVER SHALL CONFORM TO CITY STANDARD DETAIL 06.01.02. 4. CATCH BASINS TYPE I SHALL CONFORM TO CITY STANDARD DETAIL NO.02.01.02 AND 02.01.03 AND SHALL BE USED ONLY FOR DEPTHS LESS THAN 5 FEET FROM TOP OF THE GRATE TO THE
- INVERT OF THE STORM PIPE. CATCH BASINS TYPE II SHALL CONFORM TO CITY STANDARD DETAIL NO.02.01.04 AND SHALL BE USED FOR DEPTHS GREATER THAN 5 FEET FROM TOP OF THE GRATE TO THE INVERT OF THE STORM PIPE. CITY OF PUYALLUP - CITY STANDARDS STORM REVISED 10/2019 200-17.
- CAST IRON OR DUCTILE IRON FRAME AND GRATE SHALL CONFORM TO CITY STANDARD DETAIL NO.02.01.05. GRATE SHALL BE MARKED WITH "DRAINS TO STREAM". SOLID CATCH BASIN LIDS (SQUARE UNLESS NOTED AS ROUND) SHALL CONFORM TO WSDOT STANDARD PLAN B-30.20-04 (OLYMPIC FOUNDRY NO. SM60 OR (EQUAL). VANED GRATES SHALL CONFORM TO WSDOT STANDARD PLAN B-30.30-03 (OLYMPIC FOUNDRY NO. SM60V OR EQUAL).
- STORMWATER PIPE SHALL BE ONLY PVC, CONCRETE, DUCTILE IRON, OR DUAL WALLED POLYPROPYLENE PIPE.
- A. THE USE OF ANY OTHER TYPE SHALL BE REVIEWED AND APPROVED BY THE ENGINEERING SERVICES STAFF PRIOR TO INSTALLATION.
- B. PVC PIPE SHALL BE PER ASTM D3034, SDR 35 FOR PIPE SIZE 15-INCH AND SMALLER AND F679 FOR PIPE SIZES 18 TO 27 INCH. MINIMUM COVER ON PVC PIPE SHALL BE 3.0 FEET.
- C. CONCRETE PIPE SHALL CONFORM TO THE WSDOT STANDARD SPECIFICATIONS FOR CONCRETE UNDERDRAIN PIPE. MINIMUM COVER ON CONCRETE PIPE SHALL NOT LESS THAN
- D. DUCTILE IRON PIPE SHALL BE CLASS 50, CONFORMING TO AWWA C151. MINIMUM COVER ON DUCTILE IRON PIPE SHALL BE 1.0 FOOT.
- E. POLYPROPYLENE PIPE (PP) SHALL BE DUAL WALLED, HAVE A SMOOTH INTERIOR AND EXTERIOR CORRUGATIONS AND MEET WSDOT 9-05.24(1). 12-INCH THROUGH 30-INCH PIPE SHALL MEET OR EXCEED ASTM F2736 AND AASHTO M330, TYPE S, OR TYPE D. 36-INCH THROUGH 60-INCH PIPE SHALL MEET OR EXCEED ASTM F2881 AND AASHTO M330, TYPE S, OR TYPE D TESTING SHALL BE PER ASTM F1417. MINIMUM COVER OVER POLYPROPYLENE PIPE SHALL BE 3-FEET.
- 15. TRENCHING, BEDDING, AND BACKFILL FOR PIPE SHALL CONFORM TO CITY STANDARD DETAIL NO. 06.01.01.
- 16. STORM PIPE SHALL BE A MINIMUM OF 10 FEET AWAY FROM BUILDING FOUNDATIONS AND/OR ROOF LINES.
- 17. ALL STORM DRAIN MAINS SHALL BE TESTED AND INSPECTED FOR ACCEPTANCE AS OUTLINED IN SECTION 406 OF THE CITY OF PUYALLUP SANITARY SEWER SYSTEM STANDARDS.
- 18. ALL TEMPORARY SEDIMENTATION AND EROSION CONTROL MEASURES, AND PROTECTIVE MEASURES FOR CRITICAL AREAS AND SIGNIFICANT TREES SHALL BE INSTALLED PRIOR TO INITIATING ANY CONSTRUCTION ACTIVITIES.

PUYALLUP WATER SYSTEM NOTES:

1. ALL WORK IN CITY RIGHT-OF-WAY REQUIRES A PERMIT FROM THE CITY OF PUYALLUP. PRIOR TO ANY WORK COMMENCING, THE GENERAL CONTRACTOR SHALL ARRANGE FOR A PRECONSTRUCTION MEETING AT THE DEVELOPMENT SERVICES CENTER TO BE ATTENDED BY ALL CONTRACTORS THAT WILL PERFORM WORK SHOWN ON THE ENGINEERING PLANS, REPRESENTATIVES FROM ALL APPLICABLE UTILITY COMPANIES, THE PROJECT OWNER AND APPROPRIATE CITY STAFF. CONTACT ENGINEERING SERVICES TO SCHEDULE THE MEETING (253) 841-5568. THE CONTRACTOR IS RESPONSIBLE TO HAVE THEIR OWN APPROVED SET OF PLANS AT THE MEETING.

GENERAL NOTES

- 2. AFTER COMPLETION OF ALL ITEMS SHOWN ON THESE PLANS AND BEFORE ACCEPTANCE OF THE PROJECT, THE CONTRACTOR SHALL OBTAIN A "PUNCH LIST" PREPARED BY THE CITY'S INSPECTOR DETAILING REMAINING ITEMS OF WORK TO BE COMPLETED. ALL ITEMS OF WORK SHOWN ON THESE PLANS SHALL BE COMPLETED TO THE SATISFACTION OF THE CITY PRIOR TO ACCEPTANCE OF THE WATER SYSTEM AND PROVISION OF SANITARY SEWER SERVICE.
- 3. ALL MATERIALS AND WORKMANSHIP SHALL CONFORM TO THE STANDARD SPECIFICATIONS FOR ROAD, BRIDGE, AND MUNICIPAL CONSTRUCTION (HEREINAFTER REFERRED TO AS THE "STANDARD SPECIFICATIONS"), WASHINGTON STATE DEPARTMENT OF TRANSPORTATION AND AMERICAN PUBLIC WORKS ASSOCIATION, WASHINGTON STATE CHAPTER, LATEST EDITION, UNLESS SUPERSEDED OR AMENDED BY THE CITY OF PUYALLUP CITY STANDARDS FOR PUBLIC WORKS ENGINEERING AND CONSTRUCTION (HEREINAFTER REFERRED TO AS THE "CITY STANDARDS"), OR AS DIRECTED BY FRUITLAND MUTUAL WATER COMPANY (FMWC), VALLEY WATER (VW), OR TACOMA CITY WATER (TCW) IS THE PURVEYOR.
- 4. A COPY OF THESE APPROVED PLANS AND APPLICABLE CITY DEVELOPER SPECIFICATIONS AND DETAILS SHALL BE ON SITE DURING CONSTRUCTION. 5. ANY REVISIONS MADE TO THESE PLANS MUST BE REVIEWED AND APPROVED BY THE
- DEVELOPER'S ENGINEER, THE ENGINEERING SERVICES STAFF, AND THE FMWC, VW OR TCW WHEN SERVED BY THAT PURVEYOR, PRIOR TO ANY IMPLEMENTATION IN THE FIELD. THE CITY SHALL NOT BE RESPONSIBLE FOR ANY ERRORS AND/OR OMISSIONS ON THESE
- 6. THE CONTRACTOR SHALL HAVE ALL UTILITIES VERIFIED ON THE GROUND PRIOR TO ANY CONSTRUCTION. CALL (811) AT LEAST TWO WORKING DAYS IN ADVANCE. THE OWNER AND HIS/HER ENGINEER SHALL BE CONTACTED IMMEDIATELY IF A CONFLICT EXISTS.
- 7. ANY STRUCTURE AND/OR OBSTRUCTION WHICH REQUIRES REMOVAL OR RELOCATION RELATING TO THIS PROJECT SHALL BE DONE SO AT THE DEVELOPER'S EXPENSE.
- 8. BACTERIOLOGICAL (COLIFORM AND IRON BACTERIA) TEST SAMPLES WILL BE TAKEN BY THE CITY (OR FMWC, VW OR TCW WHEN SERVED BY THAT PURVEYOR) AND PAID FOR BY THE CONTRACTOR, EXCEPT FOR CAPITAL IMPROVEMENT PROJECTS (CIP) WHICH SHALL BE PAID FOR BY THE CITY.
- 9. WATER MAINS SHALL HAVE A MINIMUM COVER OF 36 INCHES FROM PAVED FINAL GRADE IN IMPROVED RIGHT-OF-WAY AND IMPROVED EASEMENTS, AND A MINIMUM OF 48 INCHES IN UNIMPROVED RIGHT-OFWAY AND UNIMPROVED EASEMENTS. CITY OF PUYALLUP - CITY STANDARDS WATER REVISED 3/2020 300-8.
- 10. PIPE FOR WATER MAINS SHALL BE DUCTILE IRON CONFORMING TO SECTION 7-09 OF THE STANDARD SPECIFICATIONS, CLASS 52 WITH TYTON OR APPROVED EQUAL JOINTS. PIPE SHALL BE CEMENT LINED IN ACCORDANCE WITH A.S.A. SPECIFICATION A 21.4-1964.
- 11. CONNECTIONS TO EXISTING WATER MAINS TYPICALLY SHALL BE WET TAPS THROUGH A TAPPING TEE AND TAPPING VALVE AND SHALL BE MADE BY A CITY APPROVED CONTRACTOR. THE TAPPING SLEEVE SHALL BE ROMAC SST ALL STAINLESS STEEL TAPPING SLEEVE OR APPROVED EQUAL. A TWO-PIECE EPOXY COATED OR DUCTILE IRON TAPPING SLEEVE MAY BE USED ON DUCTILE IRON PIPE, WHEN THE TAP IS SMALLER THAN THE WATER MAIN SIZE I.E. 6 INCH TAP ON 8 INCH PIPE. THE CITY (OR FMWC, VW OR TCW WHEN SERVED BY THAT PURVEYOR) SHALL APPROVE THE TIME AND LOCATION FOR THESE CONNECTIONS.
- 12. ALL WATER MAINS AND APPURTENANCES SHALL BE HYDROSTATICALLY TESTED AT 200 PSI IN ACCORDANCE WITH STANDARD SPECIFICATION 7-09.3(23). PRESSURE TESTING SHALL NOT BE PERFORMED UNTIL SATISFACTORY PURITY SAMPLES HAVE BEEN RECEIVED. EXCEPT WHEN NEW WATER MAINS ARE INSTALLED INDEPENDENTLY FROM THE WATER
- 13. FIRE HYDRANTS SHALL BE INSTALLED IN ACCORDANCE WITH CITY STANDARD DETAIL
- 03.05.01 AND AS DIRECTED BY THE CITY OF PUYALLUP FIRE CODE OFFICIAL. 14. VALVE MARKER POSTS SHALL BE INSTALLED WHERE VALVE BOXES ARE HIDDEN FROM VIEW OR IN UNPAVED AREAS. THE INSTALLATION SHALL BE IN ACCORDANCE WITH CITY STANDARD DETAIL 03.01.02.
- 15. RESILIENT SEATED WEDGE GATE VALVES SHALL BE USED FOR 10-INCH MAINS AND
- SMALLER. BUTTERFLY VALVES SHALL BE USED FOR MAINS GREATER THAN 10 INCHES. 16. PIPE FITTING FOR WATER MAINS SHALL BE DUCTILE IRON AND SHALL BE MECHANICAL JOINT CONFORMING TO AWWA SPECIFICATION C111-72.
- 17. WATER MAIN PIPE AND SERVICE CONNECTIONS SHALL BE A MINIMUM OF 10 FEET AWAY FROM BUILDING FOUNDATIONS AND/OR ROOF LINES.
- 18. WHERE A WATER MAIN CROSSES THE NORTHWEST GAS PIPELINE, THE WATER LINE SHALL BE CASED WITH PVC PIPE A MINIMUM OF 10 FEET BEYOND EACH SIDE OF THE GAS LINE EASEMENT. CONTACT WILLIAMS NORTHWEST PIPELINE BEFORE THE CROSSING IS MADE.
- 19. TRENCHING, BEDDING, AND BACKFILL FOR WATER MAINS SHALL BE INSTALLED IN ACCORDANCE WITH CITY STANDARD DETAIL 06.01.01
- 20. ALL COMMERCIAL AND INDUSTRIAL DEVELOPMENTS, IRRIGATION SYSTEMS, AND MULTI-FAMILY WATER SERVICE CONNECTIONS SHALL BE PROTECTED BY A DOUBLE CHECK VALVE ASSEMBLY OR A REDUCED PRESSURE BACKFLOW ASSEMBLY AS DIRECTED BY THE CITY (OR FMWC, VW OR TCW WHEN SERVED BY THAT PURVEYOR) CONFORMING TO CITY STANDARD DETAILS 03.04.01, 03.04.02, AND 03.04.03.
- 21. ANY LEAD JOINT FITTING DISTURBED DURING CONSTRUCTION SHALL BE REPLACED WITH A MECHANICAL JOINT FITTING AT THE CONTRACTOR'S EXPENSE.
- 22. WHEN HYDRAULIC FIRE FLOW MODELING IS REQUIRED FOR A PROJECT, THE CITY WILL ISSUE A PERMIT. THE HYDRAULIC MODELING CRITERIA IS BASED ON THE PROJECTED 2030 WATER DEMAND. WHILE MAINTAINING A MINIMUM SYSTEM PRESSURE OF 20 POUNDS PER SQUARE INCH AND A MAXIMUM VELOCITY OF 10 FEET PER SECOND. CITY OF PUYALLUP -CITY STANDARDS WATER REVISED 3/2020 300-9.
- 23. WHEN FILLING A NEW WATER MAIN FOR PURITY WITH HIGHLY CONCENTRATED CHLORINE WATER, THAT "SUPER" CHLORINATED WATER CANNOT SIT INSIDE THE NEW WATER MAIN FOR GREATER THAN 5 DAYS.
- 24. WHEN USING A FIRE HYDRANT FOR NON-FIREFIGHTING PURPOSES, A CITY HYDRANT METER MUST BE USED. COORDINATE THE ACQUISITION OF THE HYDRANT METER WITH THE CITY'S UTILITY BILLING DIVISION AT PUYALLUP CITY HALL. A CITY APPROVED BACKFLOW PROTECTION ASSEMBLY SHALL BE INSTALLED BY THE PERSON REQUESTING USE OF A FIRE HYDRANT. THE ASSEMBLY SHALL BE ACCOMPANIED BY A CURRENT BACKFLOW ASSEMBLY TEST REPORT. THE TEST REPORT SHALL BE AVAILABLE AT THE SITE FOR THE DURATION OF THE HYDRANT USE.

PUYALLUP SANITARY SEWER NOTES:

- 1. ALL WORK IN CITY RIGHT-OF-WAY REQUIRES A PERMIT FROM THE CITY OF PUYALLUP. PRIOR TO ANY WORK COMMENCING, THE GENERAL CONTRACTOR SHALL ARRANGE FOR A PRECONSTRUCTION MEETING AT THE DEVELOPMENT SERVICES CENTER TO BE ATTENDED BY ALL CONTRACTORS THAT WILL PERFORM WORK SHOWN ON THE ENGINEERING PLANS, REPRESENTATIVES FROM ALL APPLICABLE UTILITY COMPANIES, THE PROJECT OWNER AND APPROPRIATE CITY STAFF. CONTACT ENGINEERING SERVICES TO SCHEDULE THE MEETING (253) 841-5568. THE CONTRACTOR IS RESPONSIBLE TO HAVE THEIR OWN APPROVED SET OF PLANS AT THE MEETING.
- 2. AFTER COMPLETION OF ALL ITEMS SHOWN ON THESE PLANS AND BEFORE ACCEPTANCE OF THE PROJECT, THE CONTRACTOR SHALL OBTAIN A "PUNCH LIST" PREPARED BY THE CITY'S INSPECTOR DETAILING REMAINING ITEMS OF WORK TO BE COMPLETED. ALL ITEMS OF WORK SHOWN ON THESE PLANS SHALL BE COMPLETED TO THE SATISFACTION OF THE CITY PRIOR TO ACCEPTANCE OF THE SEWER SYSTEM AND PROVISION OF SANITARY SEWER SERVICE.
- 3. ALL MATERIALS AND WORKMANSHIP SHALL CONFORM TO THE STANDARD SPECIFICATIONS FOR ROAD, BRIDGE, AND MUNICIPAL CONSTRUCTION (HEREINAFTER REFERRED TO AS THE "STANDARD SPECIFICATIONS"). WASHINGTON STATE DEPARTMENT OF TRANSPORTATION AND AMERICAN PUBLIC WORKS ASSOCIATION, WASHINGTON STATE CHAPTER, LATEST EDITION, UNLESS SUPERSEDED OR AMENDED BY THE CITY OF PUYALLUP CITY STANDARDS FOR PUBLIC WORKS ENGINEERING AND
- CONSTRUCTION (HEREINAFTER REFERRED TO AS THE "CITY STANDARDS"). 4. A COPY OF THESE APPROVED PLANS AND APPLICABLE CITY DEVELOPER SPECIFICATIONS AND DETAILS SHALL BE ON SITE DURING CONSTRUCTION.
- 5. ANY REVISIONS MADE TO THESE PLANS MUST BE REVIEWED AND APPROVED BY THE DEVELOPER'S ENGINEER AND THE ENGINEERING SERVICES STAFF PRIOR TO ANY IMPLEMENTATION IN THE FIELD. THE CITY SHALL NOT BE RESPONSIBLE FOR ANY ERRORS AND/OR OMISSIONS ON THESE PLANS.
- 6. THE CONTRACTOR SHALL HAVE ALL UTILITIES VERIFIED ON THE GROUND PRIOR TO ANY CONSTRUCTION. CALL (811) AT LEAST TWO WORKING DAYS IN ADVANCE. THE OWNER AND HIS/HER
- ENGINEER SHALL BE CONTACTED IMMEDIATELY IF A CONFLICT EXISTS. 7. ANY STRUCTURE AND/OR OBSTRUCTION WHICH REQUIRE REMOVAL OR RELOCATION RELATING TO
- THIS PROJECT SHALL BE DONE SO AT THE DEVELOPER'S EXPENSE. 8. MINIMUM GRADE ON ALL 4 INCH RESIDENTIAL SIDE SEWERS SHALL BE 2 PERCENT AND 6 INCH COMMERCIAL SIDE SEWERS SHALL BE 1 PERCENT; MAXIMUM SHALL BE 8 PERCENT. ALL SIDE SEWERS
- SHALL BE 6 INCHES WITHIN CITY RIGHT-OF-WAY. 9. SIDE SEWERS SHALL BE INSTALLED IN ACCORDANCE WITH CITY STANDARD NOS. 04.03.01, 04.03.02, 04.03.03 AND 04.03.04. SIDE SEWER INSTALLATION WORK SHALL BE DONE IN ACCORDANCE WITH THE WASHINGTON INDUSTRIAL SAFETY AND HEALTH ACT (WISHA).
- 10. ALL SEWER PIPE SHALL BE PVC, POLYPROPYLENE, OR DUCTILE IRON. PVC SEWER PIPE SHALL CONFORM TO ASTM D-3034, SDR35 FOR PIPE SIZES 15-INCH AND SMALLER AND ASTM F679 FOR PIPE SIZES 18- TO 27-INCH, DUCTILE IRON PIPE SHALL BE CLASS 51 OR GREATER, LINED WITH PROTECTO 401TM CITY OF PUYALLUP - CITY STANDARDS SANITARY SEWER REVISED 03/2020 400-8 EPOXY LINING OR EQUIVALENT, UNLESS OTHERWISE NOTED. 12-INCH THROUGH 30-INCH POLYPROPYLENE PIPE (PP) SHALL BE DUAL WALLED. HAVE A SMOOTH INTERIOR AND EXTERIOR CORRUGATIONS AND MEET WSDOT 9-05.24(2). IT SHALL MEET OR EXCEED ASTM F2764. 36-INCH THROUGH 60-INCH PP PIPE SHALL BE TRIPLE WALLED AND MEET WSDOT 9-05.24(2). IT SHALL MEET OR EXCEED ASTM F2764. PP SHALL HAVE A MINIMUM PIPE STIFFNESS OF 46 PII WHEN TESTED IN ACCORDANCE WITH ASTM D2412. TESTING SHALL BE PER ASTM F1417. TRENCHING, BEDDING, AND BACKFILL SHALL BE IN ACCORDANCE WITH CITY STANDARD NO. 06.01.01. MINIMUM COVER ON PVC AND PP PIPE SHALL BE 3.0 FEET. MINIMUM COVER ON DUCTILE IRON PIPE SHALL BE 1.0 FOOT.
- 11. SANITARY SEWER MANHOLE FRAMES AND COVERS SHALL CONFORM TO CITY STANDARD NO. 06.01.02. 12. SANITARY SEWER MANHOLES SHALL CONFORM TO CITY STANDARD NOS. 04.01.01, 04.01.02, 04.01.03 AND 04.01.04. ALL MANHOLES SHALL BE CHANNELED FOR FUTURE LINES AS SPECIFIED ON THESE
- PLANS. MANHOLE STEPS AND LADDER SHALL CONFORM TO STANDARD NO. 06.01.03. 13. SANITARY SEWER PIPE AND SIDE SEWERS SHALL BE 10 FEET AWAY FROM BUILDING FOUNDATIONS AND/OR ROOF LINES WITH THE EXCEPTION OF SIDE SEWERS THAT PROVIDE SERVICE TO A SINGLE-FAMILY RESIDENCE. AT THE DISCRETION OF THE REVIEW ENGINEER, A LICENSED PROFESSIONAL ENGINEER WILL BE REQUIRED TO STAMP THE DESIGN TO ACCOUNT FOR DEPTH OR PROXIMITY TO FOUNDATION, STEEP SLOPES, OR OTHER FACTORS.
- 14. NO SIDE SEWERS SHALL BE CONNECTED TO ANY HOUSE OR BUILDING UNTIL ALL MANHOLES ARE ADJUSTED TO THE FINISHED GRADE OF THE COMPLETED ASPHALT ROADWAY AND THE ASPHALT PATCH AND SEAL AROUND THE RING ARE ACCEPTED.
- 15. FOR COMMERCIAL DEVELOPMENTS IN WHICH SOURCES OF GREASE AND/OR OILS MAY BE INTRODUCED TO THE CITY SANITARY SEWER SYSTEM, A CITY APPROVED GREASE INTERCEPTOR SHALL BE INSTALLED DOWNSTREAM FROM THE SOURCE.
- 16. ONCE SEWER AND ALL OTHER UTILITY CONSTRUCTION IS COMPLETED, ALL SANITARY SEWER MAINS AND SIDE SEWERS SHALL BE TESTED PER SECTION 406 OF THE CITY STANDARDS.

SITEWORK NOTES:

- CONST CURB AND GUTTER, SEE COP STD PLAN 01.02.09.
- CONST SIDEWALK, SEE COP STD PLAN 01.02.01.
- CONST DECORATIVE CONCRETE, SEE HARDSCAPE PLANS.

CONSTRUCTION NOTES

- CONST CEMENT CONCRETE TRAFFIC CURB, SEE WSDOT STD PLAN F-10.12.
- CONST DEPRESSED CURB ALONG ADA PARKING, SEE WSDOT STD PLAN F-10.12.
- CONST PARKING LOT PAVEMENT, SEE DWG F1592-CRY021. CONST FULL DEPTH PAVEMENT, SEE COP STD PLAN 01.01.06.
- CONST CURB RAMP TYPE B, SEE COP STD PLAN 01.03.04. CONST WIDENED REINFORCED PROTECTION GUTTER, SEE F1592-CPD011.
- 10. CONST FULL DEPTH PAVEMENT PATCH PER 01.01.20, EXCEPT WITHOUT OVERLAY.
- 11. CONST CURB RAMP TYPE A, SEE COP STD PLAN 01.03.03. 12. CONST CURB RAMP TYPE C, SEE COP STD PLAN 01.03.05.
- 15. CONST FRENCH DRAIN, SEE DWG F1592-CRY021.
- 17. CONST CHAIN LINK FENCE TYPE 3, SEE WSDOT STD PLAN L-20.10-03.
- 20. CONST TRANSFORMER PAD, 6" SIDEWALK CONCRETE 21. CONST GENERATOR PAD, 6" SIDEWALK CONCRETE

13. CONST DRIVEWAY ALT 1, SEE COP STD PLAN 01.02.17.

- 22. CONST TRASH RECEPTACLE PAD, 6" SIDEWALK CONCRETE
- 23. CONST BOLLARD, SEE WSDOT STD PLAN H-60.20-01 24. 4" WIDE YELLOW PAINT STRIPE
- 25. CONST PRE-CAST CONCRETE WHEEL STOP. 26. DISABLED PERSON SYMBOL MARKING, SEE COS STD PLAN 721a.
- 27. 4" WIDE WHITE PAINT STRIPE.
- 28. PROTECT EXISTING IRRIGATION MAIN AND CONTROL WIRES,
- SEE DRAWING F15192-LRP104 FOR THE PROPOSED IRRIGATION MAIN 34. TYPE 1 PAVEMENT ARROW PER COP STD PLAN 01.03.14.
- 35. 18" WIDE THERMOPLASTIC WHITE STOP LINE.
- 36. CONST SIGN R6-2L (ONE WAY [LEFT]) ON TELESPAR POST, PER COP STD PLAN 01.40.01
- 37. CONST SIGN R6-2R (ONE WAY [RIGHT]) ON TELESPAR POST, PER COP STD PLAN 01.40.01
- 38. CONST STOP SIGN PER COP STD PLAN 01.04.02.

- 39. CONST SIGN R7-801 (RESERVED PARKING) ON TELESPAR POST. 40. CONST SIGN ASSEMBLY R7-801, R7-801A (RESERVED PARKING, VAN ACCESSIBLE) ON
- TELESPAR POST, PER COP STD PLAN 01.40.01
- 41. CONST SIGN R6-2R (ONE WAY [RIGHT]) ON EXISTING SIGNAL POLE.

UTILITY NOTES:

- CONST 6" PVC SAMPLING TEE PER COP STD 01.03.04.
- CONST SIDE SEWER MAIN TAP PER COP STD 04.02.01.
- 4. CONST 6" TO 4" PVC REDUCER.
- CONST 6" PVC SIDE SEWER. CONST 48" MH PER COP STD 04.01.01
- CONST 44" OIL WATER SEPARATOR.
- 8. CONST DI 6" RESILIENT WEDGE GATE VALVE.
- 9. CONST 3" PVC SIDE SEWER. 10. CONST 4" X 4" X 3" WYE.
- 11. CONST DI 6" FIRE SVC.
- 12. CONST 2" DOM WATER SVC PER COP STD 03.03.02.
- 13. CONST 2" IRRG SVC PER COP STD. 14. CONST 8" DI WATER MAIN PER COP STD 03.01.01.
- 15. CONST FH PER COP STD 03.05.01.
- 16. CONST THRUST BLK PER COP STD'S 03.03.01-1 & 03.02.01-3.
- 17. CONST 10" DI WATER MAIN PER COP STD 03.01.01. 18. CONST 2" DCVA PER COP STD 03.04.01.
- 19. CONNECT TO MAIN PER COP STD SPEC 301.1 NOTE 3.
- 20. CONNECT TO EXIST 8" MAIN WITH TAPPING SLEEVE. 21. CONNEC TO EXIST 10" MAIN WITH TAPPING SLEEVE.
- 30. PSE TO CONST PP, NIC.
- 31. PSE TO CONST POWER SVC.
- 32. PSE TO RMV PP. NIC. 35. CONST 4" CONDUIT.

DEMOLITION NOTES:

- REMOVAL LIMITS. REMOVE UTILITY STRUCTURE.
- REMOVE UTILITY PIPE.
- 4. ABANDON UTILITY PIPE. ADJUST EXISTING UTILITY TO FINISH GRADE.
- 6. REMOVE/RELOCATE/ADJUST UTILITY (BY OTHERS).
- REMOVE STRUCTURE AND OBSTRUCTION. REMOVE AND DISPOSE OF EXISTING CHAIN LINK FENCE AND GATE.
- 10. RELOCATE BNSF EQUIPMENT (BY OTHERS).
- 11. PROTECT EXISTING UTILITY OR STRUCTURE.
- 12. RELOCATE EXISTING UTILITY STRUCTURE.
- 13. CAP WATER MAIN. 14. INSTALL THRUST BLOCK, PER COP STD PLAN 03.02.01-1 & 03.02.01-3.
- 15. PLUG UTILITY PIPE.
- 16. REMOVE BLDG STRUCTURE.
- 17. PSE TO REMOVE PP NIC.
- 18. PSE TO REMOVE OHP NIC. 19. PAVEMENT PATCH PER COP STD PLAN 01.01.20 MODIFIED TO
- ELIMINATE GRIND AND OVERLAY.
- 20. 2" HMA PATCH OVER TRENCH BACKFILL.

SITEWORK AND UTILITIES

- 21. REMOVE WATER VALVE. 22. PROTECT TREES.
- 23. REMOVE CURB.
- 24. REMOVE SIDEWALK. 26. FILL ABANDONED PIRE WITH CDE

 28. PROTECT EXISTING IRRIGATION MAIN AND CONTROL WIRES, SE

DRAWING F1592-LRP104 FOR THE PROPOSED IRRIGATION MAIN

DEVELOPMENT SERVICES DATE 2/17/2021 NOTE: THIS APPROVAL IS VOID AFTER 180 DAYS FROM APPROVAL THE CITY WILL NOT BE

RESPONSIBLE FOR ERRORS AND/

OR OMISSIONS ON THESE PLANS.

APPROVED

CITY OF PUYALLUP

Berkey

FIELD CONDITIONS MAY DICTATE CHANGES TO THESE PLANS AS DETERMINED BY THE ENGINEERING SERVICES MANAGER.

CIVIL PERMIT RESUBMITTAL S. KIRBY . CURTIS CHECKED BY . MATTHEWS APPROVED BY: SGR JGM JGM REVISIONS FOR CITY PERMIT 0504 1/11/21



. MATTHEWS



SARA ROBERTS





XX/XX/XXXX

NTS SoundTransit

ILENAME: S317-F1592-CZN001 CONTRACT No. RTA/CN 0612-18

DP-2

SCALE:

PUYALLUP STATION PARKING CONTRACT RTA/CN 0612-18

PUYALLUP STATION PARKING AND ACCESS **IMPROVEMENTS**

F1592-CZN001 FACILITY ID:

RAWING No.:

kpli

REVIEWED BY: **GREG SHIMIZU**

XX/XX/XXXX

PACKAGE #

SUBMITTAL DATE: 09/16/2020


CIVIL **GENERAL NOTES**

F1592 SHEET No. 3/81

SYMBOLS ABBREVIATIONS PROPOSED UTILITY LINE (CONT'D) EXISTING PROPOSED EXISTING EXISTING PROPOSED GB-SEAL-JGM40855 xGB-TB22x34 xS317-F1592-CZN001 TRAFFIC SIGNAL POLE DITCH AND **ROCK PROTECTION OUTFALL** SIGNAL JUNCTION BOX BUILDING BLDG JUNCTION BOX TYPE I TRAFFIC SIGNAL POLE WITH LUMINAIRE BLK BLOCK **CLEARING AND GRUBBING LIMITS CONTROLLED DENSITY FILL** CDF JUNCTION BOX TYPE II CAMERA COMM COMMUNICATION **CONSTRUCTION FENCE** CABLE VAULT\INFORMATION JUNCTION BOX TYPE VIII CONST CONSTRUCT, CONSTRUCTION HAND RAILING CRUSHED BASE COURSE **TECHNOLOGY SERVICES** TYPE 1, PS, OR PEDESTRIAN CSBC CRUSHED SURFACING BASE COURSE PUSHBUTTON POLE DOUBLE LUMINAIRE *--* ***--*** CSTC CRUSHED SURFACING TOP COURSE PEDESTRIAN SIGNAL HEAD **UNDERGROUND UTILITIES W/ A DIAMETER OR WIDTH 18" & GREATER** BOLLARD DB DUCT BANK $\frac{}{\nabla}$ DCVA **DETECTOR CHECK VALVE ASSEMBLY** RAILROAD CROSSING GATE STANDPIPE WITH HOSE VALVE 18"SS = = = = = SANITARY SEWER **DUCTILE IRON** DI \boxtimes SIGNAL CONTROLLER CABINET WM OR ⊞ WATER METER DOM DOMESTIC SYS SERVICE CABINET 18"SD DWG DRAWING - $\frac{18"SD}{}$ - STORM DRAIN WATER MANHOLE **EXIST** EXISTING COUPLING 18" CS = = = = = COMBINED SEWER THRUST BLOCK FIRE HYDRANT FΗ AIR RELEASE VALVE HOT MIX ASPHALT REDUCER = = = = = = WATER 18"W INTERNAL DIAMETER ID **ROAD SIGN** Q OR -O-FIRE HYDRANT IRRIGATION $= \frac{T(2' W X 2' D DB)}{=}$ TELEPHONE DUCT BANK T (2'W X 2'D DB) REMOVE TREE/SHRUB LEFT FIRE DEPARTMENT CONNECTION = T&FO (2' W X 2' D DB)

TELEPHONE/FIBER OPTIC DUCT BANK MATCH EXISTING T&FO (2'W X 2'D DB BUTTERFLY VALVE, M.J. MH MANHOLE LIGHTPOLE = = = = = = CONCRETE CULVERT 24" CC MINIMUM EMPTY CASING (CAPPED) NOT IN CONTRACT POST INDICATOR VALVE E (2'W X 2'D DB) = = = = = = ELECTRIC DUCT BANK OHP **OVERHEAD POWER PROPOSED EXISTING** UTILITY LINE PC POINT OF CURVATURE GATE VALVE CABLE TV UNDERGROUND POINT OF INTERSECTION CAPPED PIPE/PLUG, MECHANICAL JOINT PP POWER POLE ---- OC---- CABLE TV OVERHEAD PSE CHECK VALVE PUGET SOUND ENERGY ELECTRIC UNDERGROUND PT POINT OF TANGENT WATER BLOWOFF VALVE PVC POLYVINYL CHLORIDE (PIPE) —— EFO —— ICV IRRIGATION CONTROL VALVE **PVMT** PAVEMENT ----OE---OE- ELECTRIC OVERHEAD _____OE____ RADIUS **LEGEND** GAS VALVE RMV REMOVE ——— OEC ——— PAD MOUNTED TRANSFORMER SD STORM DRAIN **DEMOLITION** ----ET---ET- ELECTRIC/TELEPHONE ----- ET -----SDMH STORM DRAIN MANHOLE ΕV EV OR E ELECTRIC VAULT ELECTRIC/TELEPHONE OVERHEAD _____OET _____ SPEC **SPECIFICATION** HMA PAVEMENT REMOVAL EMH OR (E) EMH ELECTRIC MANHOLE STD STANDARD ELECTRIC/TELEPHONE/CABLE OVERHEAD ———— OEC ——— SS SANITARY SEWER ELECTRIC METER ELECTRIC/FIBER OPTIC OVERHEAD _____ OEFO _____ SVC SERVICE DEMO STRUCTURE UTILITY POLE TYP **TYPICAL** ELECTRIC/CABLE/FIBER OPTIC OVERHEAD —— OECFO —— WQ WATER QUALITY UTILITY POLE ANCHOR FIBER OPTIC ——— F0 ——— REMOVAL LIMITS AND STAGING AREA WSDOT WASHINGTON DEPARTMENT OF TRANSPORTATION ★ OR ← UTILITY POLE W/ LIGHT -X OR ◆-X ——— CFO ——— WATER WTR FACILITY TO ABANDON -//--// WITH **GUY POLE W/ANCHOR** _____ TCFO _____ FACILITY TO REMOVE -/*//--///--///* W/O WITHOUT TELEPHONE RISER ———————— T&FO——— TELEPHONE/FIBER OPTIC ------ T&FO ------SAW CUT ZEOLITE-PERLITE-GRANULAR ACTIVATED CARBON ZPG **UTILITY VAULT** ----TC---TC- TELEPHONE/CABLE TV SIDEWALK REMOVAL UNK **UNKNOWN VAULT** _____ OP _____ **TELEPHONE MANHOLE** ---- OP---- OP- OIL PIPELINE **CABLE TV MANHOLE SANITARY SEWER PROPOSED** FO FIBER OPTIC MANHOLE STEAM _ ._. _ . _ . _ . _ . _ . HMA PARKING LOT, SEE TYPICAL SECTIONS **TELEPHONE VAULT** STORM DRAIN FIBER OPTIC VAULT FO **UNDERDRAIN** С CONCRETE SIDEWALK CABLE TV VAULT **COMBINED SEWER TEST STATION** TS TELEPHONE + + + + + + + + + + LANDSCAPE, SEE LANDSCAPE PLANS TCB OR TCB OR 🔀 TRAFFIC CABINET ---- OT---- OT- TELEPHONE OVERHEAD TRAFFIC VAULT FIBER OPTIC OVERHEAD **FULL DEPTH PAVEMENT** SEE TYPICAL SECTIONS SAN. SEWER CLEAN OUT WATER **APPROVED** SAN. SEWER MANHOLE **GUY WIRE** 2" HMA PLANE AND OVERLAY STORM DRAIN INLET GRADE LINE CITY OF PUYALLUP STORM DRAIN CULVERT DEVELOPMENT SERVICES **FENCE** DATE_ 2/17/2021 OR(STORM DRAIN MANHOLE (LABELED BY TYPE) **NOTE**: THIS APPROVAL IS VOID EMBEDDED TRACK DRAIN ASSEMBLY AFTER 180 DAYS FROM APPROVAL MAJOR CONTOUR CONCRETE MINOR CONTOUR POTHOLE THE CITY WILL NOT BE **GRADE BREAK** RESPONSIBLE FOR ERRORS AND/ DOUBLE DETECTOR CHECK VALVE DDCA OR OMISSIONS ON THESE PLANS. **GUARD RAIL** CANAL CONTROL OF THE BIOSWALE FIELD CONDITIONS MAY DICTATE **CONTRACTOR WORKING LIMITS** CHANGES TO THESE PLANS AS CATCH BASIN (LABELED BY TYPE) TOP OF CUT DETERMINED BY THE ENGINEERING SERVICES STORM DRAIN CLEAN OUT TOE OF FILL MANAGER. MONUMENT MARKER PACKAGE # DP-2 **SITEWORK AND UTILITIES** SCALE: RAWING No.: **PUYALLUP STATION PARKING** CIVIL PERMIT RESUBMITTAL **HENSEL PHELPS** HP S. KIRBY

. CURTIS CHECKED BY . MATTHEWS 1/11/21 SGR JGM JGM REVISIONS FOR CITY PERMIT 0504 APPROVED BY: J. MATTHEWS

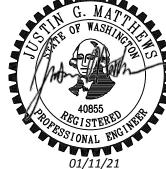



SARA ROBERTS



XX/XX/XXXX

REVIEWED BY:

GREG SHIMIZU

	FULL SCALE	SoundTransi
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XX/XX/XXXX

ILENAME: S317-F1592-CZN010 CONTRACT No.: RTA/CN 0612-18 SUBMITTAL DATE:

09/16/2020


CONTRACT RTA/CN 0612-18


PUYALLUP STATION PARKING AND ACCESS


IMPROVEMENTS CIVIL SYMBOLS, LEGEND, AND ABBREVIATIONS F1592-CZN010

FACILITY ID:

F1592 4/81

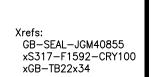

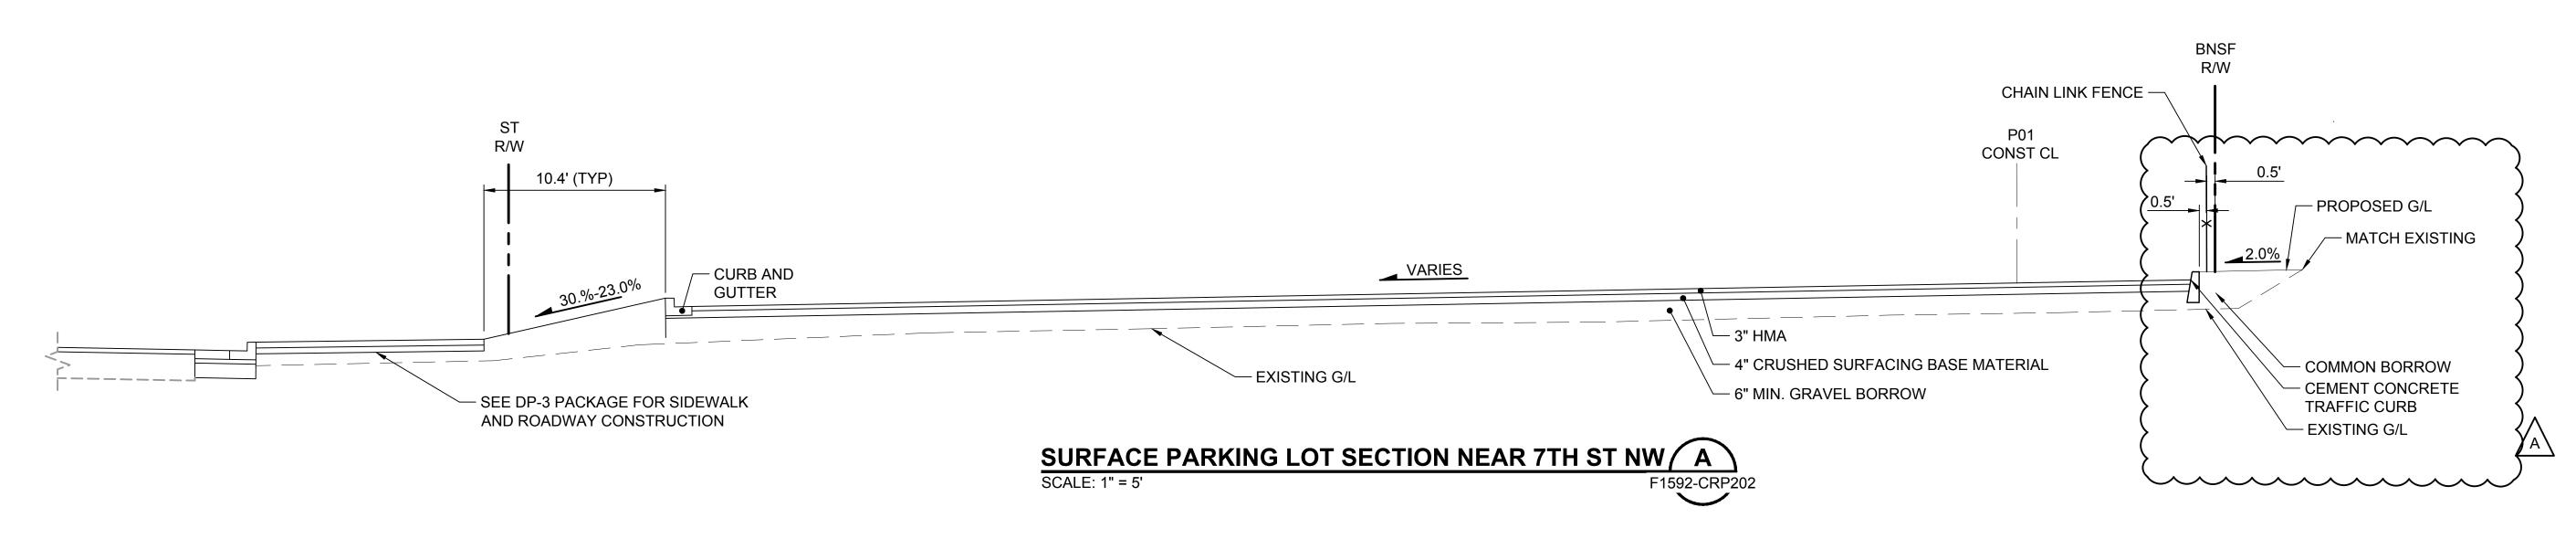

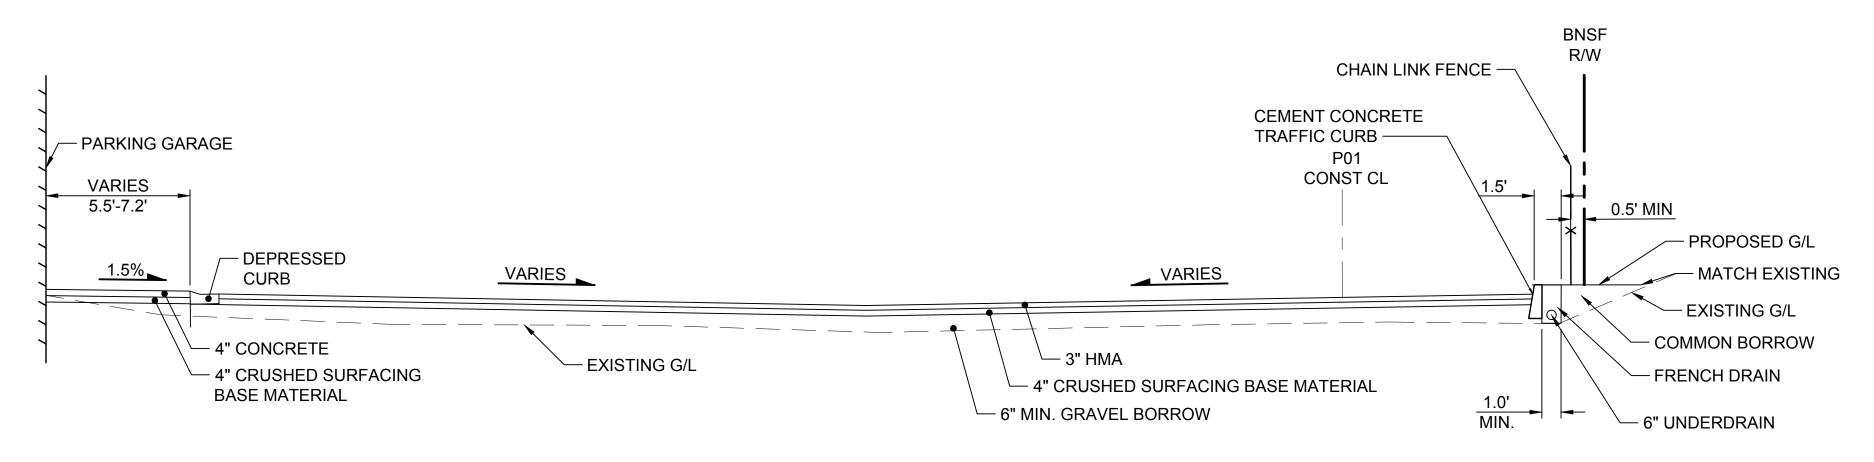

GREG SHIMIZU

SURFACE PARKING LOT SECTION NEAR 5TH ST NW / B F1592-CRP203

APPROVED CITY OF PUYALLUP DEVELOPMENT SERVICES


DATE 2/17/2021

NOTE: THIS APPROVAL IS VOID AFTER 180 DAYS FROM APPROVAL

THE CITY WILL NOT BE RESPONSIBLE FOR ERRORS AND/ OR OMISSIONS ON THESE PLANS.

FIELD CONDITIONS MAY DICTATE CHANGES TO THESE PLANS AS DETERMINED BY THE ENGINEERING SERVICES MANAGER.

					<u> </u>	DESIGNED BY:	
	CIVIL	_ F	E	R۱	IIT RESUBMITTAL	S. GUJULUVA RAJAN DRAWN BY:	
						J. CURTIS	
						CHECKED BY:	
						J. MATTHEWS	
Α	1/11/21	SGR	JGM	JGM	REVISIONS FOR CITY PERMIT 0504	APPROVED BY:	'
).	DATE	DSN	CHK	APP	REVISION	J. MATTHEWS	

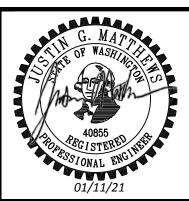





XX/XX/XXXX

LINE IS 1" AT	FULL SCALE	Soun
		DATE:

XX/XX/XXXX

	PACKAGE#	DP-2
		SCALE:
		1"=5'
		FILENAME:
7 - 1		S317-F1592-CRY02
-	SoundTransit	CONTRACT No.:
		RTA/CN 0612-18
	DATE:	SUBMITTAL DATE:

09/16/2020

SITEWORK AND UTILITIES **PUYALLUP STATION PARKING** CONTRACT RTA/CN 0612-18 PUYALLUP STATION AND ACCESS **IMPROVEMENTS**

F1592-CRY021 FACILITY ID: F1592

5/81

DRAWING No.:

CIVIL SITE SECTIONS

GENERAL NOTES: Xrefs:
xS317-F1592-RPP100
xS317-F1592-VRX100
GB-SEAL-JGM40855
xGB-TB-Views_x20
xS317-F1592-CXP100
xGB-TB22x34
xS317-F1592-CPP100 1. FOR GENERAL NOTES, SEE DRAWING F1592-CZN001. 2. FOR SYMBOLS, ABBREVIATION, AND LEGEND, SEE DRAWING F1592-CZN010. **BURLINGTON NORTHERN RAILROAD CONSTRUCTION NOTES:** (2) REMOVE UTILITY STRUCTURE ABANDON UTILITY PIPE (13) CAP WATER MAIN INSTALL THRUST BLOCK, PER COP STD PLAN 03-.02.01-1 & 03.02.01-3 TO ELIMINATE GRIND AND OVERLAY 2" HMA PATCH OVER TRENCH BACKFILL 3RD AVE NW R04 11+00 R04 10+00-APPROVED CITY OF PUYALLUP DEVELOPMENT SERVICES DATE 2/17/2021 **NOTE**: THIS APPROVAL IS VOID AFTER 180 DAYS FROM APPROVAL THE CITY WILL NOT BE RESPONSIBLE FOR ERRORS AND/ OR OMISSIONS ON THESE PLANS. FIELD CONDITIONS MAY DICTATE CHANGES TO THESE PLANS AS DETERMINED BY THE ENGINEERING SERVICES SCALE IN FEET PACKAGE # DP-2 SITEWORK AND UTILITIES DRAWING No.: **DESIGNED BY** CIVIL PERMIT RESUBMITTAL **PUYALLUP STATION PARKING HENSEL PHELPS** P S. KIRBY 1"=20' F1592-CXP202 CONTRACT RTA/CN 0612-18 DRAWN BY: Plan. Build. Manage. ILENAME: PUYALLUP STATION PARKING AND ACCESS M .VU S317-F1592-CXP202 FACILITY ID: kpff SOUNDTRANSIT B 02/12/21 SGR JGM JGM REVISIONS FOR CITY PERMIT 0504 CHECKED BY: **IMPROVEMENTS** CONTRACT No.: F1592 A 01/11/21 SGR JGM JGM REVISIONS FOR CITY PERMIT 0504 J. MATTHEWS RTA/CN 0612-18 CIVIL APPROVED BY: 4 6/81 01/27/21 SGR JGM JGM ISSUED FOR CONSTRUCTION REVIEWED BY: SUBMITTAL DATE: SITE DEMOLITION AND REMOVAL PLAN **GREG SHIMIZU** J. MATTHEWS SARA ROBERTS 01/27/2021 01/27/2021 01/27/2021

Xrefs: xS317-F1592-RPP100 **GENERAL NOTES:** xS317-F1592-VRX100 GB-SEAL-JGM40855 REMOVAL OF STORM DRAINAGE PIPE AND xGB-TB-Views_x20 xS317-F1592-CXP100 xGB-TB22x34 STRUCTURES TO TAKE PLACE AFTER RELOCATION OF BURLINGTON NORTHERN RAILROAD STORM VAULT, SEE F1592-CGP203 FOR MORE DETAIL REMOVAL OF WATER MAIN AND FIRE HYDRANT TO OCCUR AFTER NEW MAIN CONNECTION AND P02 31+04.74, 36.62 LT REPLACEMENT FIRE HYDRANT HAS BEEN ACTIVATED. BEGIN CURB REMOVAL PROTECT IN PLACE DISTRIBUTION AND/OR TRANSMISSION LINES. SEE WAC 296-54-529 FOR CONSTRUCTION CLEARANCES. (21) **CONSTRUCTION NOTES:** 1 REMOVAL LIMITS (2) REMOVE UTILITY STRUCTURE (3) REMOVE UTILITY PIPE (4) ABANDON UTILITY PIPE (13) CAP WATER MAIN P02 31+01.86, 11.28' LT **BEGIN CURB REMOVAL** (14) INSTALL THRUST BLOCK, PER COP STD PLAN 03-.02.01-1 & 03.02.01-3 (15) PLUG UTILITY PIPE PAVEMENT PATCH PER COP STD PLAN 01.01.20 MODIFIED TO ELIMINATE GRIND & OVERLAY 3RD AVE NW R04 14+00 (21) REMOVE WATER VALVE (23) REMOVE CURB (26) FILL ABANDONED PIPE WITH CDF **APPROVED** CITY OF PUYALLUP DEVELOPMENT SERVICES DATE____2/17/2021 **NOTE**: THIS APPROVAL IS VOID AFTER 180 DAYS FROM APPROVAL THE CITY WILL NOT BE RESPONSIBLE FOR ERRORS AND/ OR OMISSIONS ON THESE PLANS. FIELD CONDITIONS MAY DICTATE CHANGES TO THESE PLANS AS
DETERMINED BY THE
ENGINEERING SERVICES MANAGER. SCALE IN FEET PACKAGE # DP-2 SITEWORK AND UTILITIES RAWING No.: **CIVIL PERMIT RESUBMITTAL PUYALLUP STATION PARKING HENSEL PHELPS** H S. KIRBY 1"=20' F1592-CXP203 **CONTRACT RTA/CN 0612-18** Plan. Build. Manage. ILENAME: PUYALLUP STATION PARKING AND ACCESS FACILITY ID: J. CURTIS S317-F1592-CXP203 **kpff S**OUND**T**RANSIT **IMPROVEMENTS** CHECKED BY: CONTRACT No. F1592 1/11/21 | SGR | JGM | JGM | REVISIONS FOR CITY PERMIT 0504 . MATTHEWS RTA / CN 0612-18 CIVIL 7/81 SGR JGM JGM ISSUED FOR CONSTRUCTION APPROVED BY: REVIEWED BY: SUBMITTAL DATE: SITE DEMOLITION AND REMOVAL PLAN **GREG SHIMIZU** J. MATTHEWS SARA ROBERTS 12/04/2020 12/04/2020 12/04/2020

Xrefs: xS317-F1592-RPP100 xS317-F1592-VRX100 GB-SEAL-JGM40855 xGB-TB-Views_x20 xS317-F1592-CXP100 xGB-TB22x34 xS317-F1592-CPP100 **GENERAL NOTES:** 1. RECONNECT WATER MAIN AT TIME OF DEMO. SEE SHEET F1592-UCP204. 2. PROTECT IN PLACE DISTRIBUTION AND/OR TRANSMISSION LINES. SEE WAC 296-54-529 FOR W STEWART AVE CONSTRUCTION CLEARANCES. R01 26+00 R01 27+00 R01 25+00 **CONSTRUCTION NOTES:** SEE DP-3 FOR STREET AND SIDEWALK REMOVAL LIMITS DEMOLITION IN PUBLIC ROW (3) REMOVE UTILITY PIPE (23) REMOVE CURB THE PROPOSED IRRIGATION MAIN **BURLINGTON NORTHERN RAILROAD** P02 33+00.68, 24.56' LT END CURB REMOVAL (28) CONC WALK **APPROVED** P02 32+90.77, 12.83' RT CITY OF PUYALLUP DEVELOPMENT SERVICES END CURB REMOVAL DATE____2/17/2021 **NOTE**: THIS APPROVAL IS VOID AFTER 180 DAYS FROM APPROVAL THE CITY WILL NOT BE RESPONSIBLE FOR ERRORS AND/ OR OMISSIONS ON THESE PLANS. FIELD CONDITIONS MAY DICTATE CHANGES TO THESE PLANS AS DETERMINED BY THE ENGINEERING SERVICES MANAGER. SCALE IN FEET PACKAGE # DP-2 SITEWORK AND UTILITIES RAWING No.: **PUYALLUP STATION PARKING CIVIL PERMIT RESUBMITTAL HENSEL PHELPS** P S. KIRBY 1"=20' F1592-CXP204 CONTRACT RTA/CN 0612-18 Plan. Build. Manage. ILENAME: PUYALLUP STATION PARKING AND ACCESS S317-F1592-CXP204 FACILITY ID: J. CURTIS kpff **SOUNDTRANSIT IMPROVEMENTS** F1592 CHECKED BY: CONTRACT No. 1/11/21 SGR JGM JGM REVISIONS FOR CITY PERMIT 0504 J. MATTHEWS RTA/CN 0612-18 CIVIL APPROVED BY: 8/81 SGR JGM JGM ISSUED FOR CONSTRUCTION REVIEWED BY: SUBMITTAL DATE: DEMOLITION AND REMOVAL PLAN SARA ROBERTS 12/04/2020 **GREG SHIMIZU** J. MATTHEWS 12/04/2020 12/04/2020

GENERAL NOTES: Xrefs: xS317-F1592-RPP100 S317-F1592-RFP100 GB-SEAL-JGM40855 xGB-TB-Views_x20 xS317-F1592-CSP100 xS317-F1592-CPP100 xGB-TB22x34 1. FOR GENERAL NOTES, SEE DRAWING F1592-CZN001 2. FOR SYMBOLS AND LEGENDS, SEE DRAWING **BURLINGTON NORTHERN RAILROAD** F1592-CZN010 P01 20+99.84, 10.81' LT xGB-1B22x34 xS317-F1592-CLP100 xS317-F1592-ELP100 xS317-F1592-VRX100 xS317-F1592-TSP100 xS317-F1592-LPP100 **BEGIN FENCE** SEE F1592-CGP202 THRU F1592-CGP204 FOR HORIZONTAL AND VERTICAL CONTROL OF CURBS SEE F1592-LRP102 THRU F1592-LRP104 FOR IRRIGATION PIPE SLEEVES UNDER PAVING. SEE F1592-LHP102 THRU F1502-LHP104 FOR SIDEWALK FINISHES AND SPECIALTY PAVING. P01 20+00 P01.22+00 P0124+00 RIGHT OF WAY DEDICATION **CONSTRUCTION NOTES:** TO CITY OF PUYALLUP -CONST CURB AND GUTTER, SEE COP STD PLAN 01.02.09 CONST CEMENT CONCRETE TRAFFIC CURB, SEE WSDOT STD PLAN F-10.12 CONST PARKING LOT PVMT, SEE DWG F1592-CRY021 CONST CHAIN LINK FENCE TYPE-3, SEE WSDOT STD PLAN L-20.10-03 - WORK IN THE RIGHT OF WAY IN DESIGN PACKAGE DP-3 3RD AVE NW - 3RD AVE SOUTH CURB LINE WORK IN DESIGN PACKAGE DP-1 **APPROVED** CITY OF PUYALLUP DEVELOPMENT SERVICES DATE___ 2/17/2021 **NOTE**: THIS APPROVAL IS VOID AFTER 180 DAYS FROM APPROVAL THE CITY WILL NOT BE RESPONSIBLE FOR ERRORS AND/ OR OMISSIONS ON THESE PLANS. FIELD CONDITIONS MAY DICTATE CHANGES TO THESE PLANS AS DETERMINED BY THE ENGINEERING SERVICES MANAGER. SCALE IN FEET PACKAGE # DP-2 SITEWORK AND UTILITIES DRAWING No.: **CIVIL PERMIT RESUBMITTAL PUYALLUP STATION PARKING HENSEL PHELPS** P S. GUJULUVA RAJAN 1"=20' F1592-CRP202 CONTRACT RTA/CN 0612-18 Plan. Build. Manage. ILENAME: PUYALLUP STATION PARKING AND ACCESS S317-F1592-CRP202 FACILITY ID: Γ. CURTICE **kpff SOUNDTRANSIT IMPROVEMENTS** CHECKED BY: CONTRACT No.: F1592 1/11/21 SGR JGM JGM REVISIONS FOR CITY PERMIT 0504 J. MATTHEWS RTA/CN 0612-18 CIVIL

REVIEWED BY:

12/04/2020

GREG SHIMIZU

SUBMITTAL DATE:

12/04/2020

12/04/2020

9/81

SITE PLAN

SGR JGM JGM ISSUED FOR CONSTRUCTION

APPROVED BY:

J. MATTHEWS

SARA ROBERTS

GENERAL NOTES: xS317-F1592-RPP100 xS317-F1592-VRX100 FOR GENERAL NOTES, SEE DRAWING F1592-CZN001. GB-SEAL-JGM40855 xGB-TB-Views_x20 FOR SYMBOLS AND LEGENDS, SEE DRAWING xS317-F1592-CSP10 BURLINGTON NORTHERN RAILROAD xS317-F1592-CPP10 F1592-CZN010. xGB-TB22x34 xS317-F1592-SGP0 SEE F1592-CGP202 THRU F1592-CGP204 FOR P01 28+22.52, 12.40' LT F1592-CRY02 HORIZONTAL AND VERTICAL CONTROL OF CURBS xS317-F1592-ELP100 P01 25+84.40, 10.00' LT xS317-F1592-TSP100 xS317-F1592-LRP100 xS317-F1592-LPP100 START MODIFIED CURB P01 26+01.40, 10.00' LT SEE F1592-LRP102 THRU F1592-LRP104 FOR THE END MODIFIED CURB IRRIGATION PIPE SLEEVES UNDER PAVING. SEE F1592-LHP102 THRU F1502-LHP104 FOR SIDEWALK FINISHES AND SPECIALTY PAVING. **CONSTRUCTION NOTES:** CONST CURB AND GUTTER, SEE COP STD PLAN 01.02.09 CONST SIDEWALK, SEE COP STD PLAN 01.02.01 CONST DECORATIVE CONCRETE, SEE DRAWING F1592-LHD101 P01 27+69.83, 49.52' RT END DEPRESSED CURB CONST CEMENT CONCRETE TRAFFIC CURB, SEE WSDOT STD PLAN F-10.12 BEGIN DEPRESSED CURB CONST DEPRESSED CURB ALONG ADA PARKING, SEE WSDOT STD PLAN F-10.12. CONST PARKING LOT PVMT, WAY IS IN DESIGN RIGHT OF WAY √ PACKAGE DP-3 DEDICATION TO CITY OF 3RD AVE NW PUYALLUP CONST CHAIN LINK FENCE TYPE-3, SEE WSDOT STD PLAN L-20.10-03 CONST TRASH ENCLOSURE PAD, SEE STRUCTURAL 18 CONST PLANS CONST TRANSFORMER PAD, 6" SIDEWALK CONCRETE CONST GENERATOR PAD, 6" SIDEWALK CONCRETE MATCH BACK OF SIDEWALK, SEE DR-3 FOR SIDEWALK DESIGN AND CONST TRASH RECEPTACLE PAD, 6" SIDEWALK CONCRETE CONSTRUCTION (23) CONST BOLLARD, SEE WSDOT STD PLAN H-60.20-01 CONST MODIFIED CURB, SEE DETAIL 4 ON DRAWING WORK IN THE RIGHT OF WAY IS IN DESIGN **S7** PACKAGE DP-3 **APPROVED** BY_fosich Berkey CITY OF PUYALLUP DEVELOPMENT SERVICES 2ND AVE NW DATE 2/17/2021 **NOTE**: THIS APPROVAL IS VOID AFTER 180 DAYS FROM APPROVAL THE CITY WILL NOT BE RESPONSIBLE FOR ERRORS AND/ OR OMISSIONS ON THESE PLANS. FIELD CONDITIONS MAY DICTATE CHANGES TO THESE PLANS AS DETERMINED BY THE ENGINEERING SERVICES SCALE IN FEET PACKAGE # DP-2 SITEWORK AND UTILITIES RAWING No.: **CIVIL PERMIT RESUBMITTAL PUYALLUP STATION PARKING HENSEL PHELPS** H S. GUJULUVA RAJAN 1"=20' F1592-CRP203 CONTRACT RTA/CN 0612-18 Plan. Build. Manage. ILENAME: PUYALLUP STATION PARKING AND ACCESS FACILITY ID: Γ. CURTICE S317-F1592-CRP203 **kpff** SoundTransit **IMPROVEMENTS** CHECKED BY: CONTRACT No. F1592 1/11/21 SGR JGM JGM REVISIONS FOR CITY PERMIT 0504 . MATTHEWS RTA/CN 0612-18

REVIEWED BY:

12/04/2020

GREG SHIMIZU

CIVIL

SITE PLAN

SUBMITTAL DATE:

12/04/2020

12/04/2020


10/81

SGR JGM JGM ISSUED FOR CONSTRUCTION

APPROVED BY:

J. MATTHEWS

SARA ROBERTS

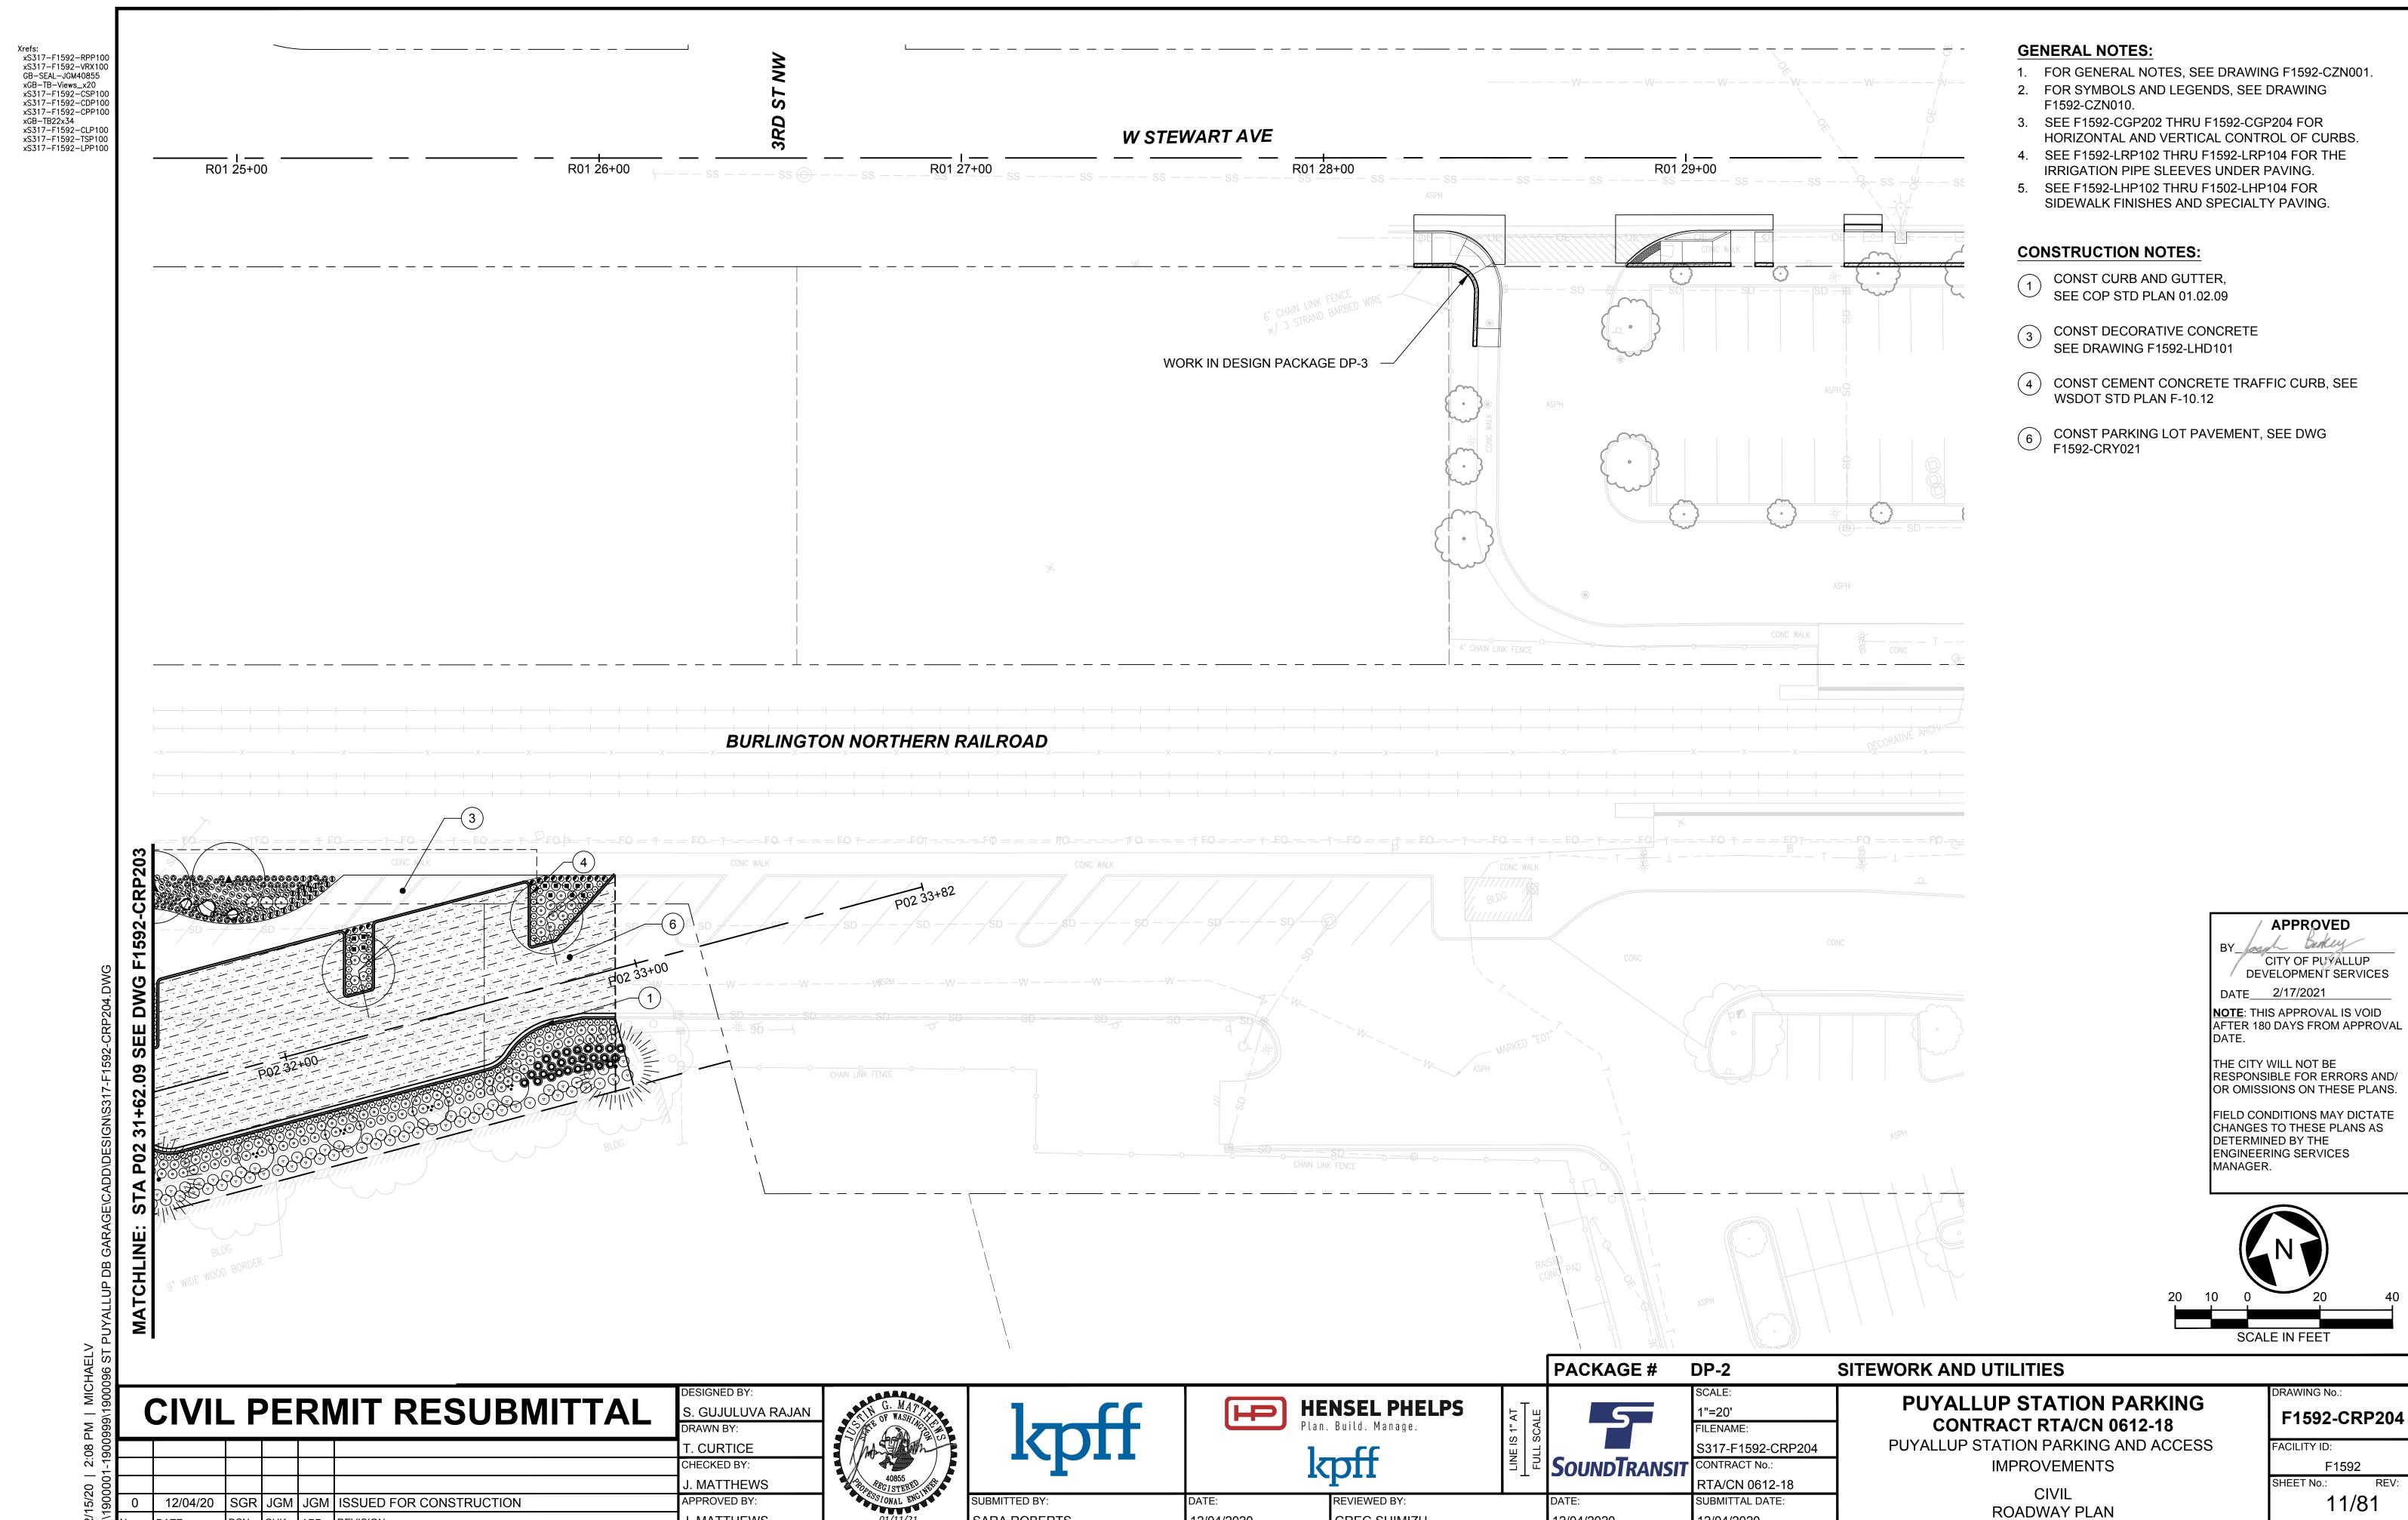

12/04/2020

SARA ROBERTS

J. MATTHEWS

GREG SHIMIZU

12/04/2020

12/04/2020

GENERAL NOTES: Xrefs: xS317-F1592-RPP100 TAX ID 9999999183 FOR GENERAL NOTES, SEE DRAWINGS F1592-CZN001 xS317-F1592-RPP100 xS317-F1592-VRX100 GB-SEAL-JGM40855 xGB-TB-Views_x20 xS317-F1592-CSP100 xS317-F1592-CDP100 xGB-TB22x34 xS317-F1592-ELP100 xS317-F1592-CLP100 xS317-F1592-TSP100 2. FOR SYMBOLS AND LEGEND, SEE DRAWING F1592-CZN010 **BURLINGTON NORTHERN RAILROAD** P01 20+00 P01 24+00 **CONSTRUCTION NOTES:** (27) 4" WIDE WHITE PAINT STRIPE (34) TYPE 1 PAVEMENT ARROW PER COP STD PLAN (27) TYP. (35) 18" WIDE THERMOPLASTIC WHITE STOP LINE (36) CONST SIGN R6-2L (ONE WAY [LEFT]) ON TELESPAR POST, PER COP STD PLAN 01.40.01 CONST STOP SIGN PER COP STD PLAN 01.04.02 SEE DP-3 FOR STREET AND 3RD AVE NW SIDEWALK CONSTRUCTION IN CITY ROW APPROVED CITY OF PUYALLUP DEVELOPMENT SERVICES DATE 2/17/2021 **NOTE**: THIS APPROVAL IS VOID AFTER 180 DAYS FROM APPROVAL THE CITY WILL NOT BE RESPONSIBLE FOR ERRORS AND/ OR OMISSIONS ON THESE PLANS. FIELD CONDITIONS MAY DICTATE CHANGES TO THESE PLANS AS DETERMINED BY THE ENGINEERING SERVICES MANAGER. SCALE IN FEET PACKAGE # DP-2 SITEWORK AND UTILITIES DRAWING No.: **CIVIL PERMIT RESUBMITTAL PUYALLUP STATION PARKING HENSEL PHELPS** P S. GUJULUVA RAJAN 1"=20' F1592-CMP202 CONTRACT RTA/CN 0612-18 Plan. Build. Manage. FILENAME: PUYALLUP STATION PARKING AND ACCESS T. CURTICE S317-F1592-CMP202 FACILITY ID: kpff **SOUNDTRANSIT IMPROVEMENTS** CHECKED BY: CONTRACT No.: F1592 1/11/21 SGR JGM JGM REVISIONS FOR CITY PERMIT 0504

REVIEWED BY:

12/04/2020

SARA ROBERTS

GREG SHIMIZU

RTA/CN 0612-18

SUBMITTAL DATE:

12/04/2020

DATE:

12/04/2020

CIVIL

PAVEMENT MARKING AND SIGNAGE PLAN

12/81

12/04/20 SGR JGM JGM ISSUED FOR CONSTRUCTION

CHK APP REVISION

J. MATTHEWS

J. MATTHEWS

APPROVED BY:

GENERAL NOTES: Xrefs: xS317-F1592-RPP100 FOR GENERAL NOTES, SEE DRAWINGS F1592-CZN001 xS317-F1592-RPF100 xS317-F1592-VRX100 GB-SEAL-JGM40855 xGB-TB-Views_x20 xS317-F1592-CSP100 xS317-F1592-CDP100 FOR SYMBOLS AND LEGEND, SEE DRAWING F1592-CZN010 BURLINGTON NORTHERN RAILROAD xGB-TB22x34 xS317-F1592-CLP100 xS317-F1592-TSP100 xS317-F1592-ELP100 P01 27+00 P0126+00 P01 25+00 P01 29+00 P01 29+23 P01 28+00 **CONSTRUCTION NOTES:** (24) 4" WIDE YELLOW PAINT STRIPE CONST PRE-CAST CONCRETE WHEEL STOP, SEE DETAIL 1 ON DRAWING F1592-CPD024 ON DRAWING F1592-CPD024 (27) 4" WIDE WHITE PAINT STRIPE TYPE 1 PAVEMENT ARROW PER COP STD PLAN CONST SIGN R6-2L (ONE-WAY [LEET]) ON TELESPAR POST PER COP STD PLAN 01.40.01 25) TYP. TYP. 25) CONST SIGN R6-2R (ONE WAY [RIGHT]) ON TELESPAR POST, PER COP STD PLAN 01.40.01 3RD AVE NW CONST SIGN R7-801 (RESERVED PARKING) ON TELESPAR POST, PER COP STD PLAN 01.40.01 CONST SIGN ASSEMBLY R7-801, R7-801A (RESERVED PARKING, VAN ACCESSIBLE) ON TELESPAR POST, PER COP STD PLAN 01.40.01 CONST SIGN R6-2R (ONE WAY [RIGHT]) ON EXISTING SIGNAL POLE **APPROVED** CITY OF PUYALLUP DEVELOPMENT SERVICES DATE 2/17/2021 **NOTE**: THIS APPROVAL IS VOID AFTER 180 DAYS FROM APPROVAL SEE/DP-3 FOR STREET AND SIDEWALK CONSTRUCTION IN CITY ROW THE CITY WILL NOT BE RESPONSIBLE FOR ERRORS AND/ OR OMISSIONS ON THESE PLANS. FIELD CONDITIONS MAY DICTATE CHANGES TO THESE PLANS AS
DETERMINED BY THE
ENGINEERING SERVICES MANAGER. SCALE IN FEET PACKAGE # DP-2 SITEWORK AND UTILITIES DRAWING No.: **CIVIL PERMIT RESUBMITTAL PUYALLUP STATION PARKING HENSEL PHELPS** P S. GUJULUVA RAJAN 1"=20' F1592-CMP203 CONTRACT RTA/CN 0612-18 Plan. Build. Manage. ILENAME: PUYALLUP STATION PARKING AND ACCESS FACILITY ID: Γ. CURTICE S317-F1592-CMP203 **kpff SOUNDTRANSIT IMPROVEMENTS** CHECKED BY: CONTRACT No. F1592 1/11/21 SGR JGM JGM REVISIONS FOR CITY PERMIT 0504 . MATTHEWS RTA/CN 0612-18 CIVIL 13/81 SGR JGM JGM ISSUED FOR CONSTRUCTION APPROVED BY: REVIEWED BY: SUBMITTAL DATE: PAVEMENT MARKING AND SIGNAGE PLAN **GREG SHIMIZU**


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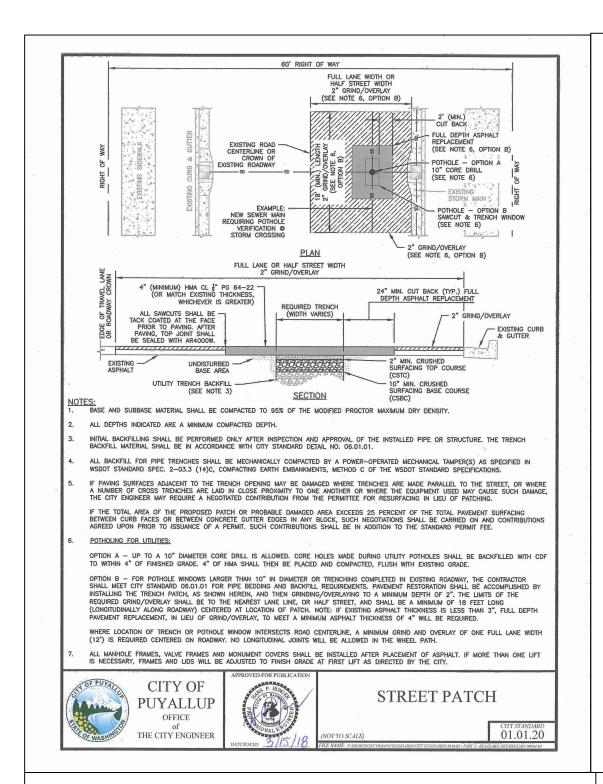
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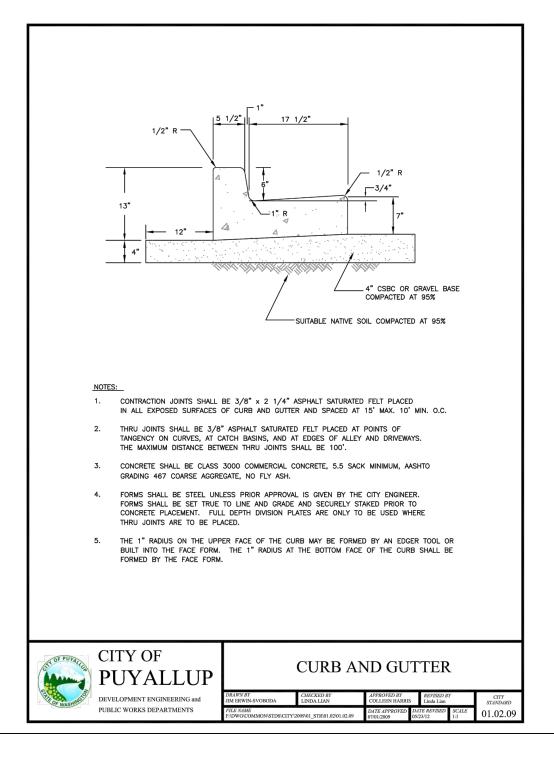
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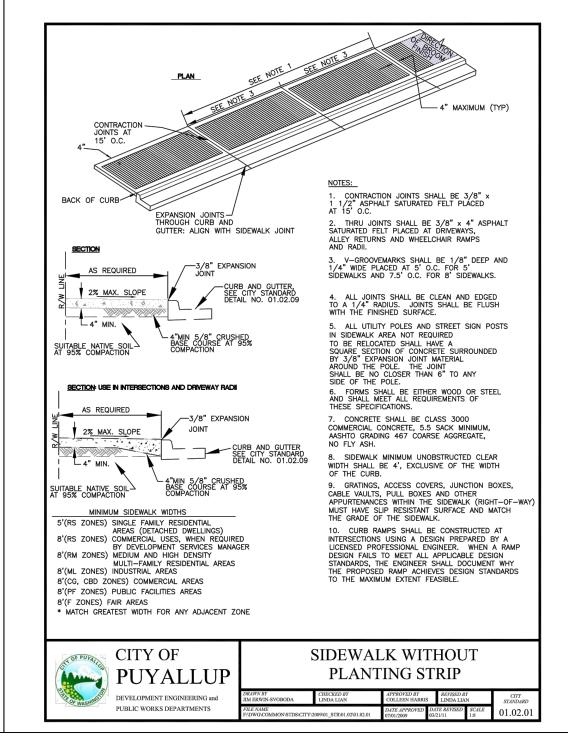
J. MATTHEWS


SARA ROBERTS









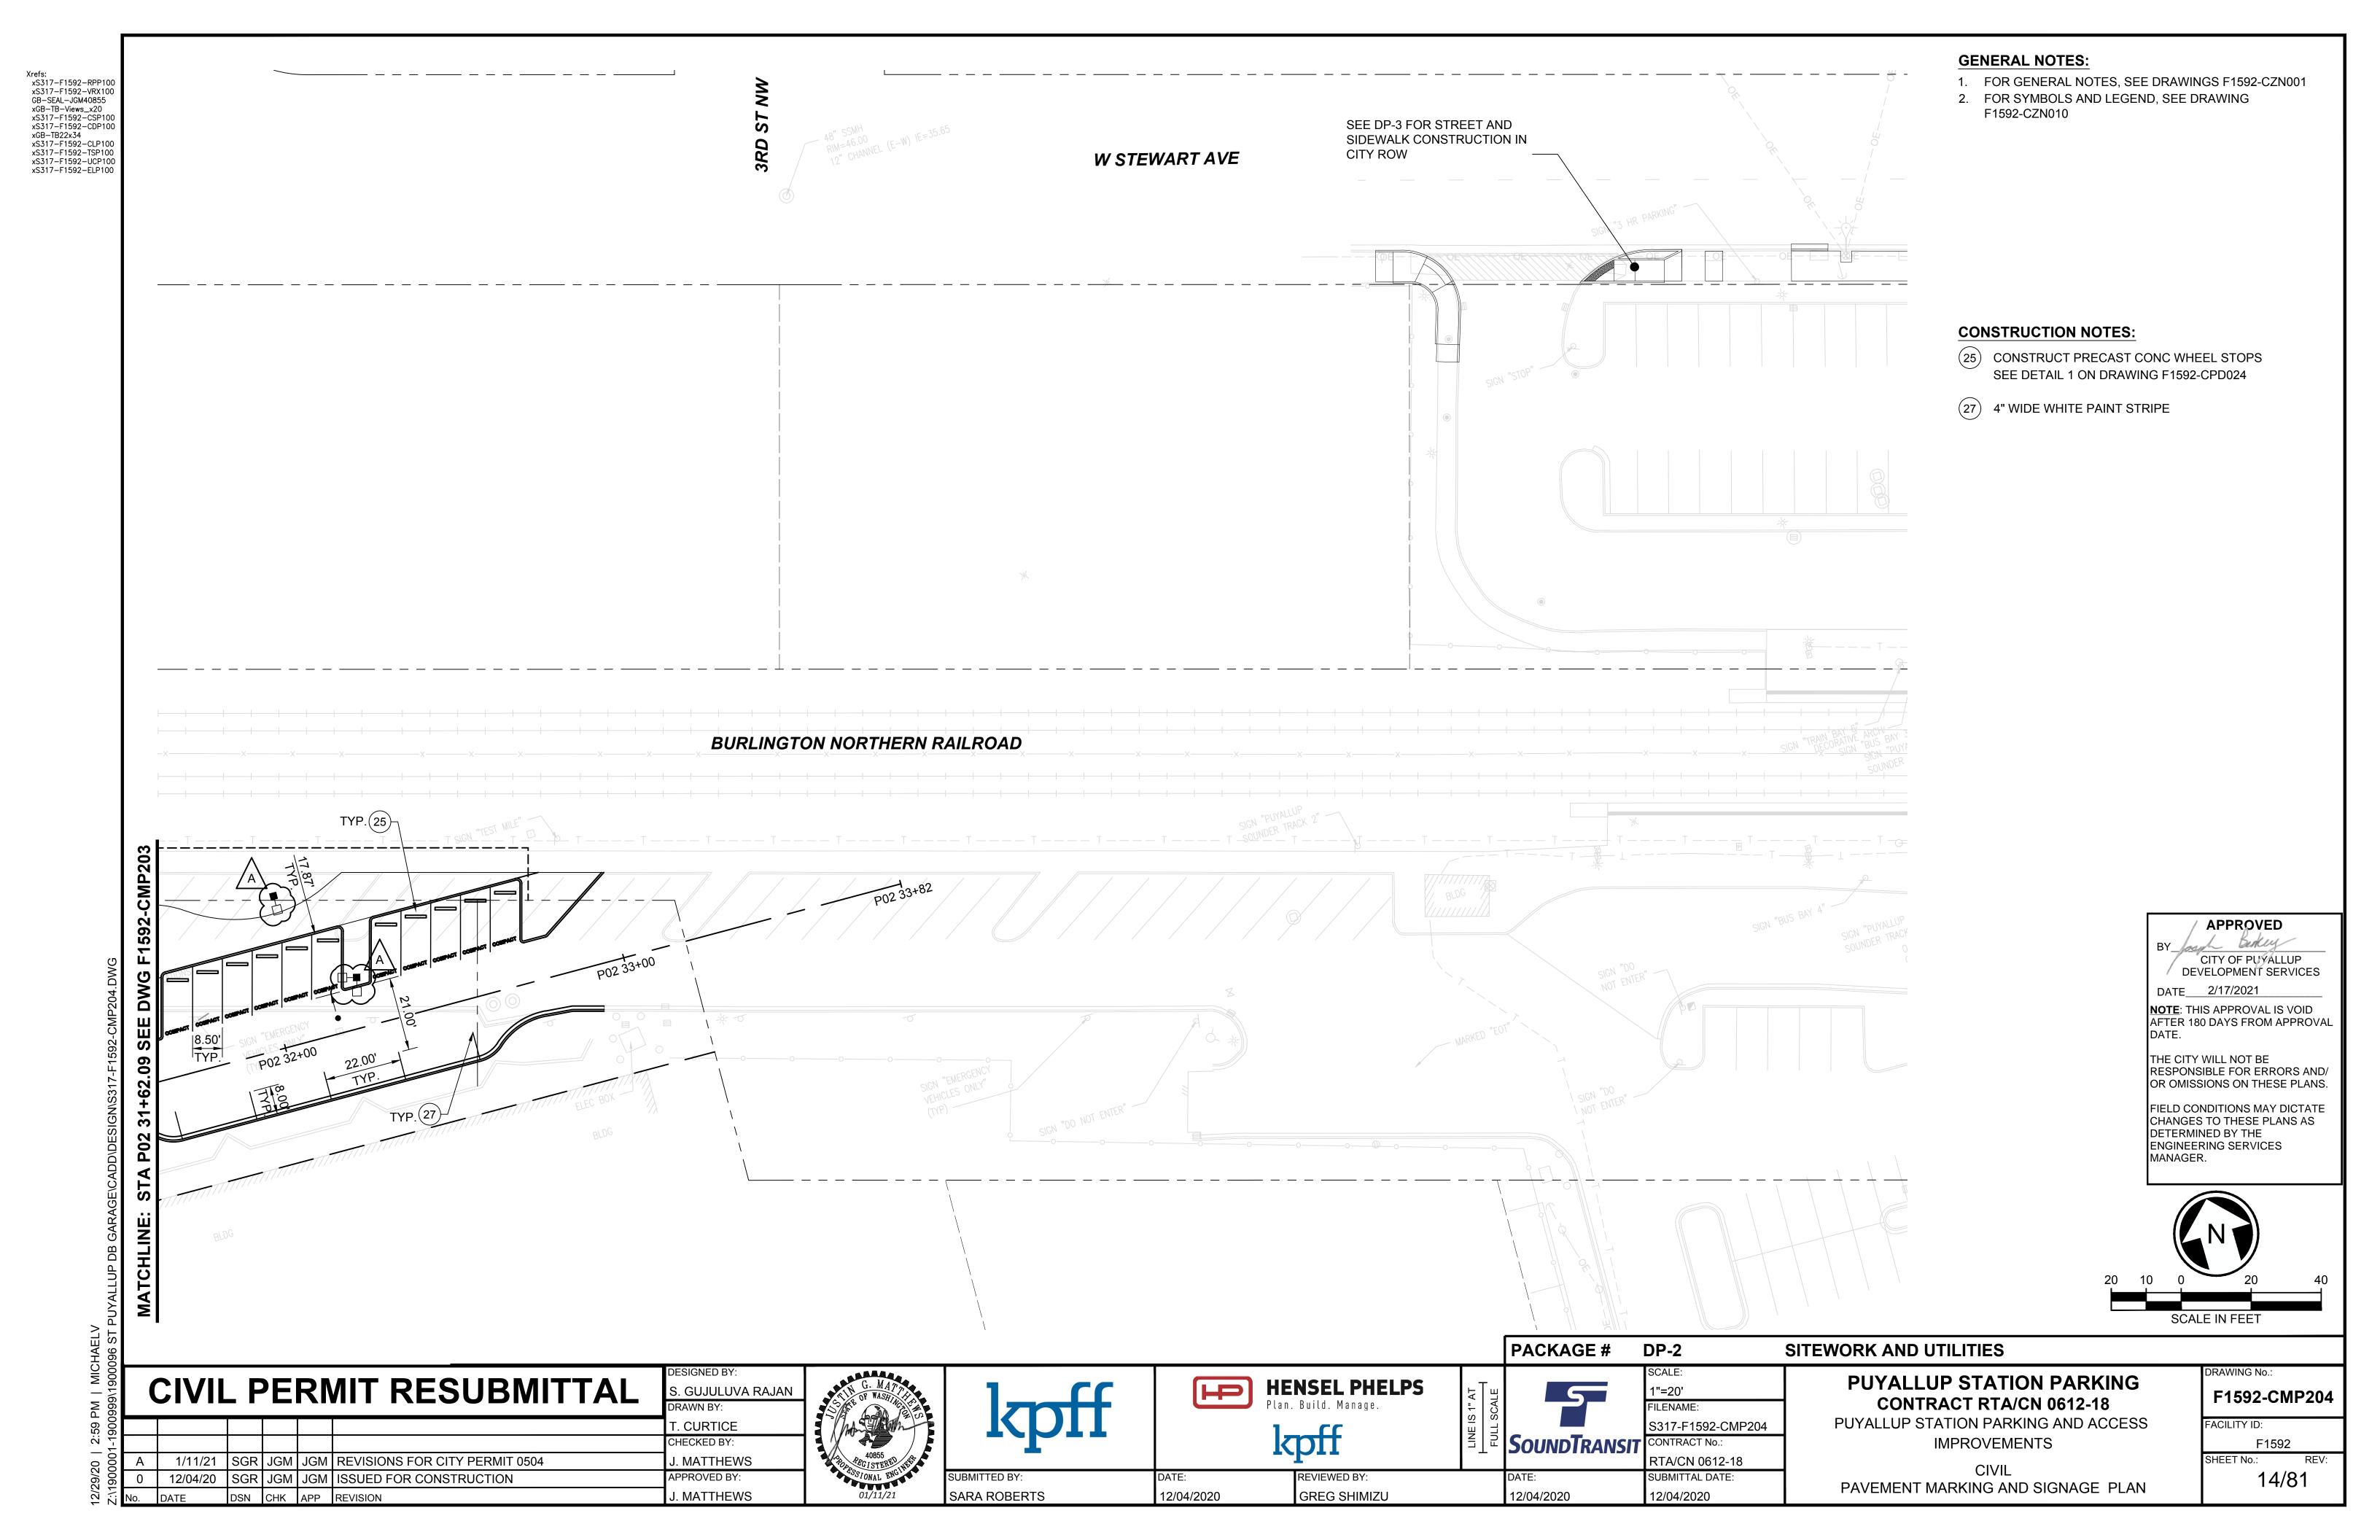


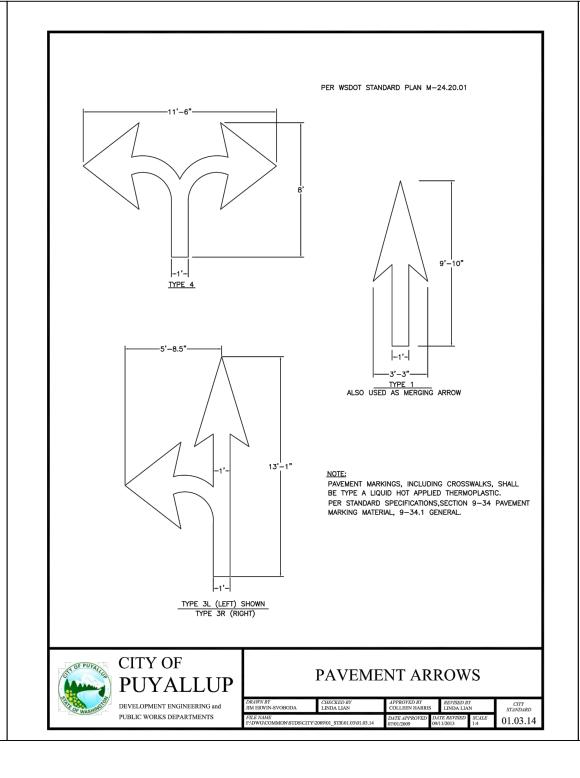


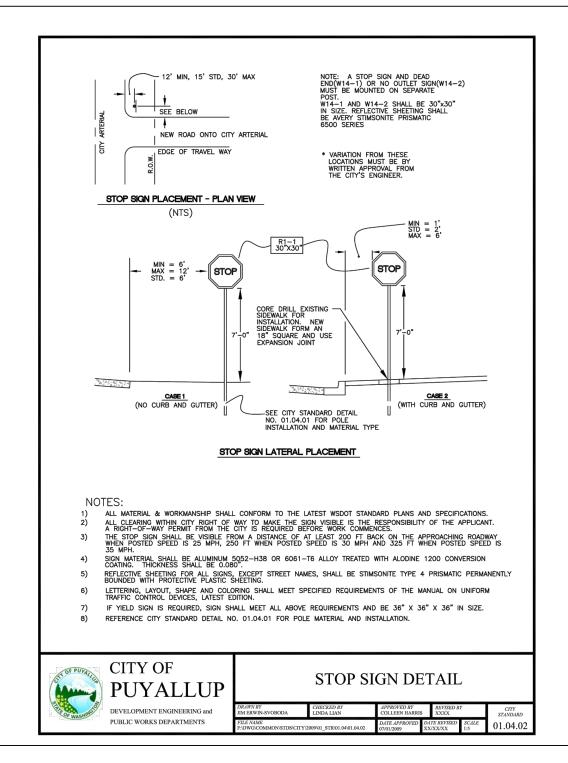

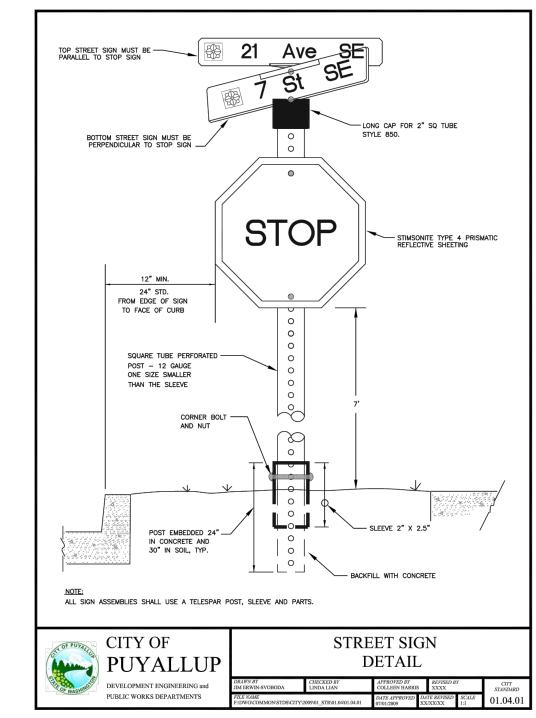

CHK APP REVISION

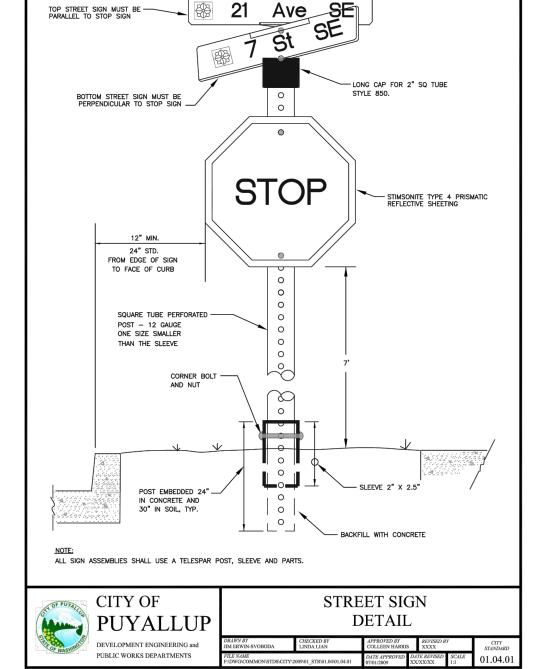

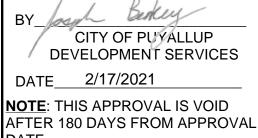


APPROVED

THE CITY WILL NOT BE RESPONSIBLE FOR ERRORS AND/

OR OMISSIONS ON THESE PLANS.

FIELD CONDITIONS MAY DICTATE CHANGES TO THESE PLANS AS DETERMINED BY THE ENGINEERING SERVICES MANAGER.

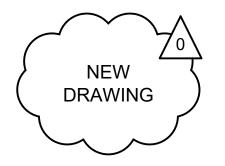

CIVIL PERMIT RESUBMITTAL S. GUJULUVA RAJAN M. VU CHECKED BY: 1/11/21 | SGR | JGM | JGM | REVISIONS FOR CITY PERMIT 0504 . MATTHEWS SGR JGM JGM ISSUED FOR CONSTRUCTION APPROVED BY: 12/04/20



J. MATTHEWS



SARA ROBERTS





NTS ILENAME: S317-F1592-CRD021 SoundTransii CONTRACT No.: RTA/CN 0612-18 SUBMITTAL DATE:

DP-2

12/04/2020

SITEWORK AND UTILITIES **PUYALLUP STATION PARKING** CONTRACT RTA/CN 0612-18

PUYALLUP STATION PARKING AND ACCESS **IMPROVEMENTS**

> CIVIL SITE DETAILS

RAWING No.: F1592-CRD021

FACILITY ID:


F1592 15/81

12/04/2020

REVIEWED BY: **GREG SHIMIZU**

DATE: 12/04/2020

PACKAGE #

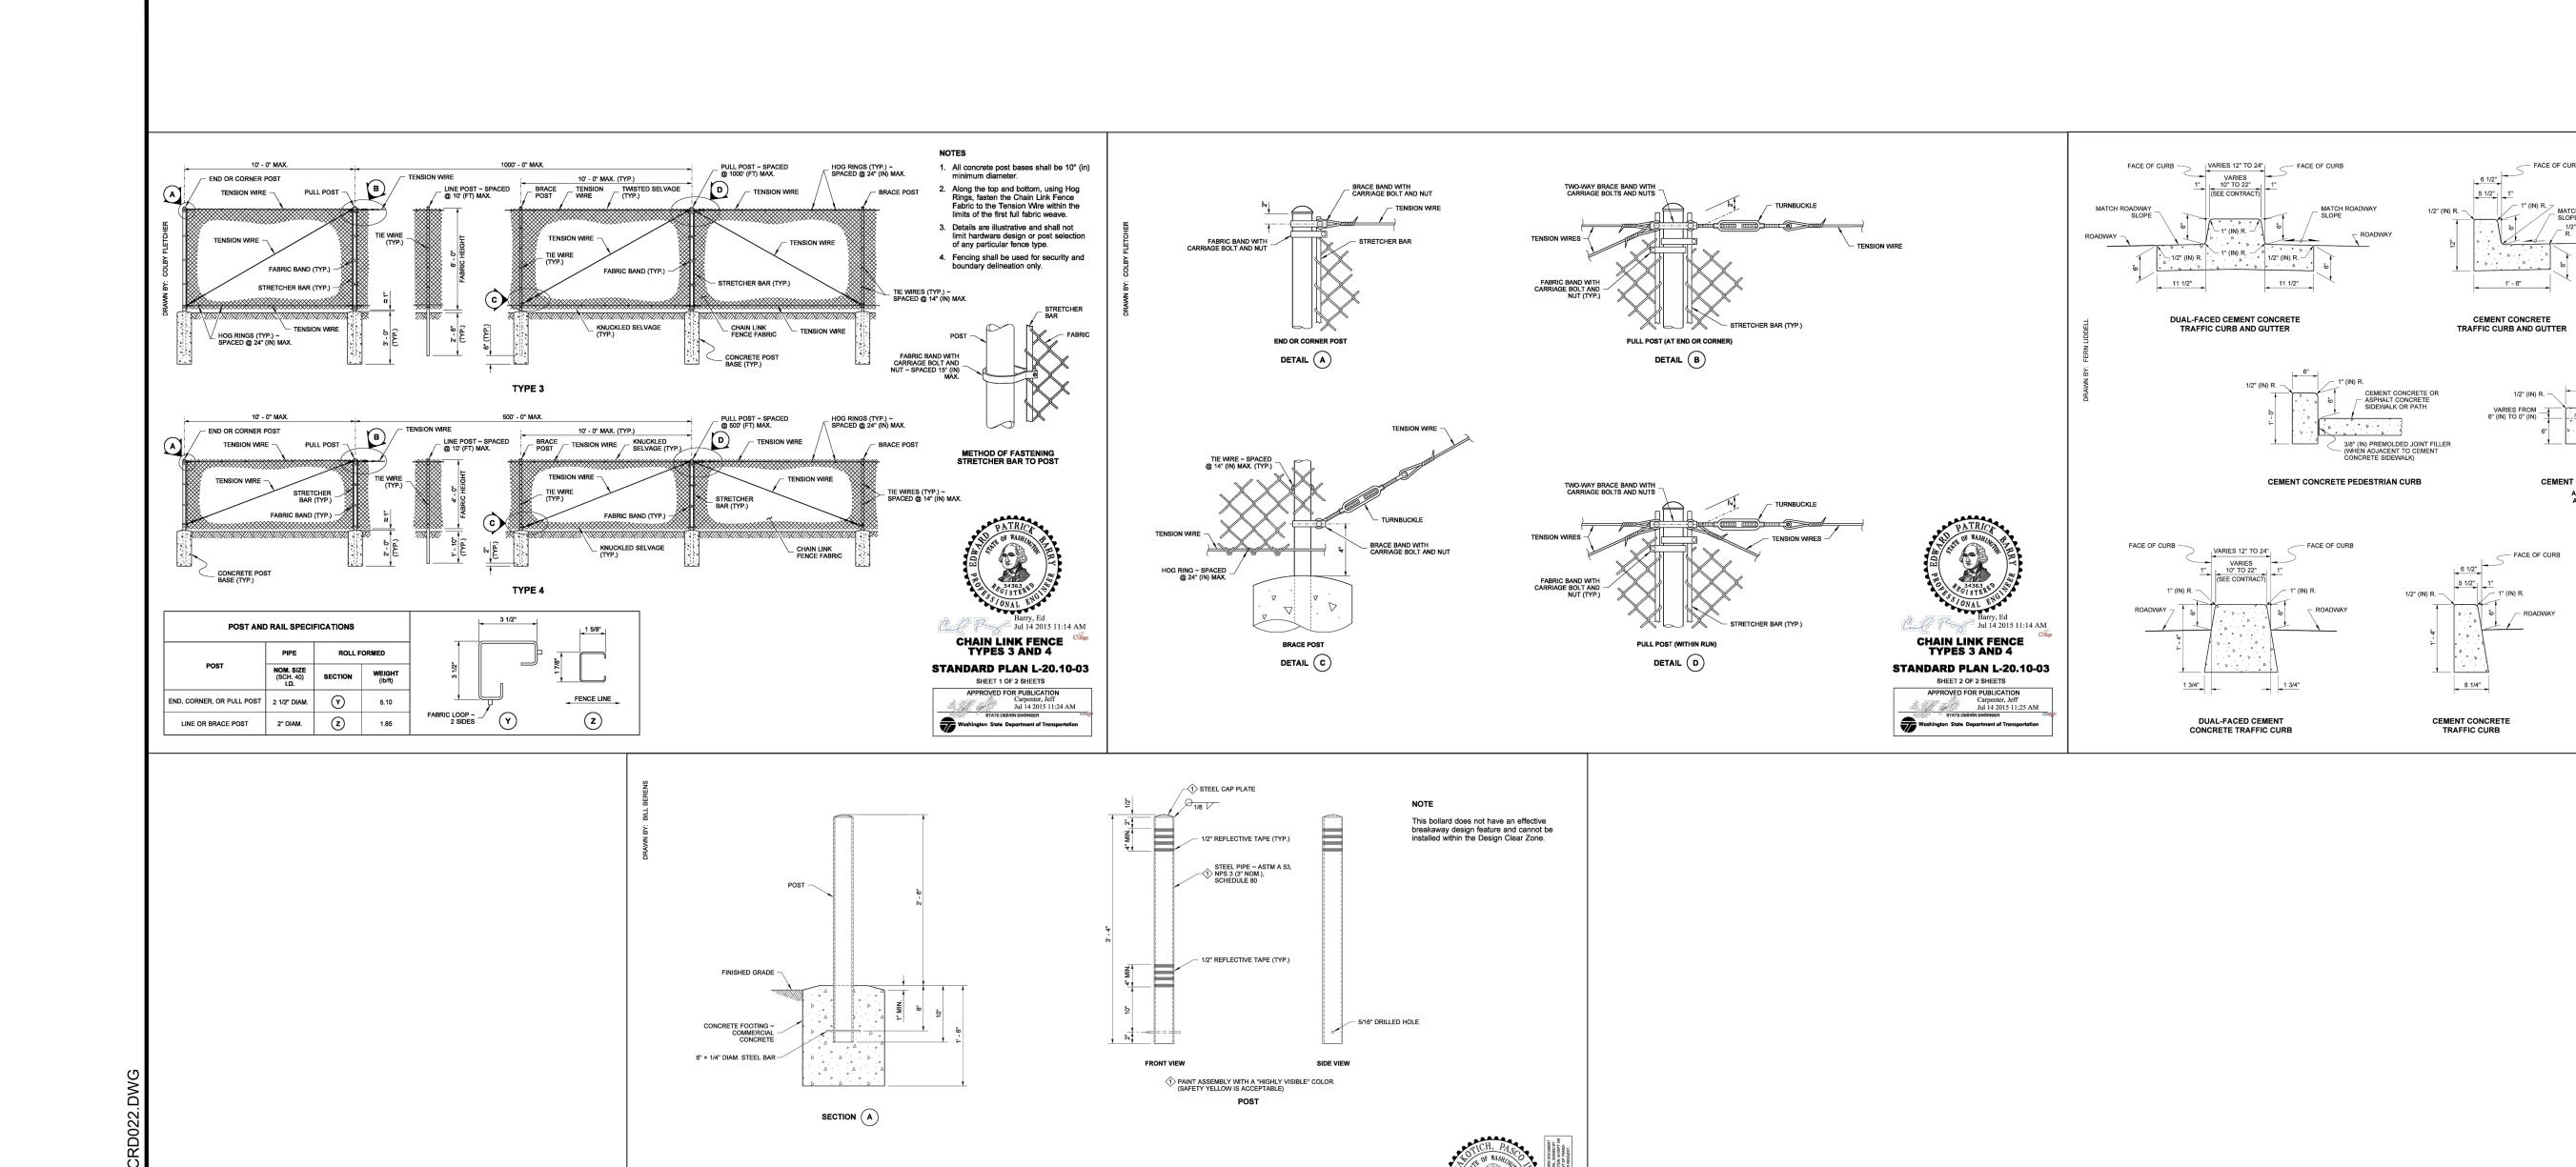

APPROVED CITY OF PUYALLUP DEVELOPMENT SERVICES

DEPRESSED CURB AND GUTTER SECTION

AT CURB RAMPS AND DRIVEWAY ENTRANCES

8 1/4"

MOUNTABLE CEMENT

CEMENT CONCRETE PEDESTRIAN CURB AT CURB RAMPS, LANDINGS, AND DRIVEWAY ENTRANCES

See Standard Plan F-30.10 for Curb Expansion and Contraction Joint spacing. See Standard Specification, Sections 8-04 and 9-04 for

Michael S

CEMENT CONCRETE CURBS

STANDARD PLAN F-10.12-04

SHEET 1 OF 1 SHEET

Washington State Department of Transportation

APPROVED FOR PUBLICATION
Date: 2020.09.24
07:57:43-07'00'
STATE DESIGN ENGINEER

NOTE: THIS APPROVAL IS VOID AFTER 180 DAYS FROM APPROVAL

DATE_ 2/17/2021


THE CITY WILL NOT BE RESPONSIBLE FOR ERRORS AND/ OR OMISSIONS ON THESE PLANS.

FIELD CONDITIONS MAY DICTATE CHANGES TO THESE PLANS AS DETERMINED BY THE ENGINEERING SERVICES MANAGER.



CIVIL PERMIT RESUBMITTAL S. GUJULUVA RAJAN M. VU CHECKED BY: 1/11/21 SGR JGM JGM REVISIONS FOR CITY PERMIT 0504 J. MATTHEWS SGR JGM JGM ISSUED FOR CONSTRUCTION APPROVED BY: 12/04/20

CHK APP REVISION

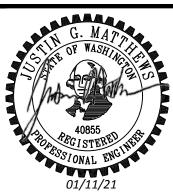

J. MATTHEWS

PLAN VIEW

SARA ROBERTS

BOLLARD TYPE 2

STANDARD PLAN H-60.20-01

SHEET 1 OF 1 SHEET

APPROVED FOR PUBLICATION


Pasco Bakotich III 07-03-08

12/04/2020



REVIEWED BY:

GREG SHIMIZU

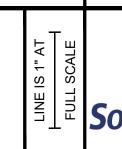

NTS ILENAME: S317-F1592-CRD022 SoundTransit CONTRACT No.: RTA/CN 0612-18 DATE: SUBMITTAL DATE:

DP-2

12/04/2020

PACKAGE #

12/04/2020

SITEWORK AND UTILITIES **PUYALLUP STATION PARKING**

CONTRACT RTA/CN 0612-18 PUYALLUP STATION PARKING AND ACCESS **IMPROVEMENTS**

CIVIL SITE DETAILS DRAWING No.: F1592-CRD022

FACILITY ID:

F1592 16/81

GENERAL NOTES: P01 23+44.17, 7.46' RT xS317-F1592-RPP100 BURLINGTON NORTHERN RAILROAD P01 23+43,44, 24.42' RT xS317-F1592-VRX10 PI CURB P01 22+92.55, 14.50' LT FOR GENERAL NOTES, SEE DRAWING F1592-CZN001 GB-SEAL-JGM40855 P01 22+30.06, 10.00' LT P01 23+11.98, 24.38' RT xGB-TB-Views_x20 R=5,00' BEGIN DITCH 1592-CDD022 xS317-F1592-CSP10 GDBK PAVING R=2.50' 2. FOR LEGENDS AND SYMBOLS, SEE DRAWING EL=46.32' xS317-F1592-CDP10 EL=47.15' EL=47.88' EL=45.80' F1595-CZN010. xS317-F1592-UWP10 R=2.50' P01 23+51.29, 6.98' RT xS317-F1592-UPP10 P01 23+47.04, 24.64' R1 EL=46.15' xGB-TB22x34 3. FOR DRAINAGE PROFILE, SEE DRAWINGS F1592-CDV021 PI CURB xS317-F1592-CGP1 P01 23+08.38, 24.16' RT AND F1592-CDV022. R=2.50' xS317-F1592-CLP100 P01 20+99.11, 9.59 LT R=2.50' xS317-F1592-TSP100 PI CURB EL=46.22' 4. FOR CURB TYPES AND PAVING, SEE DRAWINGS PI CURE R=2.50' F1592-CRP202 THROUGH F1592-CRP204. R=1.2' EL=46.21' EL=48.32' FOR FINISHED GRADING OF THE PLANTING AREAS, SEE P01 23+11.24, 41.34' RT DRAWINGS F1592-LPP102 THROUGH F1592-LPP105. P01 24+11.75, 14.50' L PI CURB AP DITCH ALL THE HORIZ AND VERT CURB CONTROL LABELS ARE P01 20+00 R=5.00' P01 23+00 P01 22+00 EL=46.28' P01 24+00 POINTING TO THE FACE OF CURB. EL=45.63' RIDGE . SEE DESIGN PACKAGE DP-3 FOR STORMWATER P01-21+34.15, 23.30' RT P01 23+50.67, 59.43' R P01 23+04.12, 41.82' RT CONVEYANCE IN CITY RIGHT OF WAY. **PI CURB** P01 21+33.61, 42.49' RT EL=46.18' P01 21+41.82, 25.81' RT R=1.5' PI CURB R=2.50' PI CURB EL=45.97' LOT CB#3 - RIDGE R=1.50' EL=45.79' R=1.50 LINE TYPE-1 (AREA DRAIN) EL=45.32' **CURVE TABLE, RADIUS = 5.0'** EL=46.11 -P01 24+03.82, 50.39' RT LOT CB#2 **POINT RIDGE** STATION/OFFSET EL P01 21+12.67, 58.80' RT TYPE-1 (AREA DRAIN) LINE **AP CURB** P01 23+27.74, 50.00' RT P01 21+25.20, 12.39' RT 46.56 EL=45.20' 46.78 P01 21+30.03, 6.00' RT LOT CB#1A CONTECH STORMFILTER TYPE 1 (AREA DRAIN) F1592-CDD023 SEE SHEET F1592-CDD023 **CURVE TABLE, RADIUS = 5.0'** P01 22+92.12, 51.15' RT -P01 24+55.96, 48.30' RT FOR STATION/OFFSET AP GDBK **POINT** STATION/OFFSET EL EL=45.80' P01 21+32.27, 6.00' RT 46.78 -EL=43.89 PT P01 21+37.10, 12.29' RT 46.57 EL=43.93-7TH AVE CB#2 **CURVE TABLE, RADIUS = 7.50** P01 21+01.85, 76.32' R7 P01 21+37.48, 42.49' RT - MATCH **POINT** EL STATION/OFFSET PI CURB R=1.50' **DRIVEWAY** P01 22+10.65, 33.36' RT 47.04 EL=45.32' CONSTRUCTION WORK IN THE RIGHT OF 3RD AVE NW WAY IS IN DESIGN P01 21+32.54, 76.30' RT PT P01 22+25.14, 37.24' RT 47.08 PACKAGE DP-3 AP CURB EL=44.16' – SD – **CURVE TABLE, RADIUS = 7.50** POINT STATION/OFFSET EL P01 22+11.74, 76.30' RT P01 22+16.49, 11.56' RT 47.37 AP CURB EL=46.54' PT P01 22+30.98, 15.44' RT 47.42 CURVE TABLE, RADIUS = 7.50 POINT STATION/OFFSET P01 22+09.58, 68.24' RT 46.61 3RD AVE SDMH#1 P01 22+27.26, 76.30' RT F1592-CDD028 P01 21+17.32, 117.93' RT – AP CURB PT P01 22+24.07, 64.36' RT 46.80 **CURB AND GUTTER REPLACEMENT** EL=46.54' TO THE SOUTH OF 3RD AVENUE **CURVE TABLE, RADIUS = 7.50'** P01 24+52.48, 76.30' RT NW IS IN DESIGN PACKAGE DP-1 P01 22+93.74, 59.39' RT AP CURB **POINT** STATION/OFFSET EL PI CURB EL=45.61' R=1.5' P01 24+50.84, 33.36' RT 45.95 EL=46.00' P01 23+55.68, 76.30' RT LOT CB#1 PT P01 24+65.33, 37.24' RT 45.79 **AP CURB** TYPE-1 (GUTTER DRAIN) EL=45.96' P01 22+94.63, 75.61' RT **CURVE TABLE, RADIUS = 7.5' CURVE TABLE, RADIUS = 7.50' APPROVED** Berkey P01 22+97.66, 76.30' RT POINT STATION/OFFSET POINT STATION/OFFSET EL EL CITY OF PUYALLUP **AP CURB** DEVELOPMENT SERVICES EL=45.76' P01 21+22.09, 58.79' RT P01 24+56.68, 11.56' RT 46.17 44.90 DATE 2/17/2021 NOTE: THIS APPROVAL IS VOID PT P01 21+29.34, 64.36' RT P01 24+71.17, 15.44' RT 44.59 46.01 AFTER 180 DAYS FROM APPROVAL **CURVE TABLE, RADIUS = 10.0' CURVE TABLE, RADIUS = 15.0'** CURVE RETURN TABLE, RADIUS = 7.50 THE CITY WILL NOT BE **POINT** STATION/OFFSET STATION/OFFSET EL **POINT** EL POINT STATION/OFFSET RESPONSIBLE FOR ERRORS AND/ OR OMISSIONS ON THESE PLANS. PC P01 23+42.71, 68.80' RT 45.32 P01 22+97.71, 58.80' RT 45.92 PC P01 24+50.32, 68.24' RT 45.54 PC FIELD CONDITIONS MAY DICTATE CHANGES TO THESE PLANS AS PT P01 23+49.48, 59.34' RT P01 23+12.71, 73.80' RT P01 24+64.81, 64.36' RT DETERMINED BY THE 45.95 45.06 45.59 ENGINEERING SERVICES SCALE IN FEET MANAGER. PACKAGE # **SITEWORK AND UTILITIES** DP-2 RAWING No.: **PUYALLUP STATION PARKING CIVIL PERMIT RESUBMITTAL HENSEL PHELPS** HP S. GUJULUVA RAJAN 1"=20' F1592-CGP202 CONTRACT RTA/CN 0612-18 Plan. Build. Manage. ILENAME: PUYALLUP STATION PARKING AND ACCESS FACILITY ID: . CURTIS S317-F1592-CGP202 **IMPROVEMENTS** KpH SoundTransit CHECKED BY CONTRACT No. F1592 1/11/21 | SGR | JGM | JGM | REVISIONS FOR CITY PERMIT 0504 E. MENDEL RTA/CN 0612-18 CIVIL 17/81 SGR ERM JGM ISSUED FOR CONSTRUCTION APPROVED BY REVIEWED BY: SUBMITTAL DATE: 12/04/20 GRADING AND DRAINAGE PLAN SARA ROBERTS J. MATTHEWS 12/04/2020 **GREG SHIMIZU** 12/04/2020 12/04/2020

GENERAL NOTES: P01 28+22.16, 22.50 RT P01 26+00.00, 11.00' LT P02 31+62.78, 50.42' LT xS317-F1592-CGP100 P01 28+19.95, 13.85' RT P01 28+19.00, 11.00' LT BURLINGTON NORTHERN RAILROAD P01 24+70.22, 10.00' LT xS317-F1592-RPP100 AP SIDEWALK **END DITCH** 1. FOR GENERAL NOTES, SEE DRAWING F1592-CZN001. END FRENCH DRAIN AP SIDEWALK xS317-F1592-VRX100 GDBK PAVING GB-SEAL-JGM40855 START FRENCH DRAIN EL=48.13' CO-10 EL=48.50 2. FOR LEGENDS AND SYMBOLS, SEE DRAWING LOT SDMH#2 xGB-TB-Views x20 EL=46.44' P01 27+58.00, 11.00' LT xS317-F1592-CSP100 EL= 45.78 /P01 28+18.99, 11.00 LT P02 31+62.77, 35.74' LT F1595-CZN010. 48"/TYPE-2 xS317-F1592-CDP100 RIM = 47.19P01 26.00.00, 11.00' LT xS317-F1592-UWP10 F1592-CPD022 AP SIDEWALK P01 28+05.78, 6.23' RT 3. FOR DRAINAGE PROFILE, SEE DRAWINGS F1592-CDV021 IE = 45.00'xS317-F1592-UPP10 RIM=47.04' IE = 46.70' EL=48.50' xGB-TB22x34 AND F1592-CDV022. P01 27+75.63, 10.00' LT P02 30+50.20, 93.71' LT xS317-F1592-SGP01 xS317-F1592-CLP100 xS317-F1592-TSP100 P02 30+47.70, 73.24' LT P01 27+58.80, 11.00' LT FOR CURB TYPES AND PAVING, SEE DRAWINGS EL=46.52' RIM = 47.21'AP SIDE WALK F1592-CRP202 THROUGH F1592-CRP204. FOR FINISHED GRADING OF THE PLANTING AREAS, SEE P02 31+01.65, 31.33' LT DRAWINGS F1592-LPP102 THROUGH F1592-LPP105 LOT ŠDMH#1 ALL THE HORIZ AND VERT CURB CONTROL LABELS ARE 48" TYPF-2 POINTING TO THE FACE OF CURB. P01 26+00 6.00' LT P01 25+00 P01 28+00 P01 25+82.55, 14.50' LT P01/29+00 P01 29+23 RIM =47.94' SEE DESIGN PACKAGE DP-3 FOR STORMWATER AP DITCH P01 26+38.04, 10.00' LT CONVEYANCE IN CITY RIGHT OF WAY. EL= 45.82' GDBK PAVING IE = 44.30'RIM = 47.08 RIDGE LINE **CURVE TABLE, RADIUS = 7.50'** TYPE-1 (AREA DRAIN) P01 25+90.25, 57.05' RT -POINT STATION/OFFSET EL - RÍDGE CONNECT TO EXIST SD LINE 16"X16"X4" TEE F1592-CDD024 CO-4 P01 25+63.62, 31.66' RT APPROX IE=42.00'/ 45.88 I RIM = 47\10\ CO-16 (CONNECT TO **CONTECH STORMFILTER** NE = 44.25 ROOF DRAINAGE) P01 25+78.11, 35.54' RT 46.01 SEE SHEET F1592-CDD024 P02 31+05.59, 52.84' LT FOR STATION/OFFSET RIM = 48.48'LOT CB#4 **CURVE TABLE, RADIUS = 7.50** IE = 42.23'TYPE-1 (AREA DRAIN) **VALLEY LINE** F1592-CDD025 IP02 31+02.61, 39.70' LT **POINT** STATION/OFFSET P01 25+16.15, 50.26' RT -EL CONTECH STORMFILTER IEL=48.00' P01 25+69.01, 11.56' RT 46.14 SEE SHEET F1592-CDD025 P01 25+83.49, 15.44' RT 46.28 (CONNECT TO GARAGE VALLEY LINE -**CURVE TABLE, RADIUS = 20.0'** F1592-CDD028 P02 30+89.98, 22.74' LT P02 30+00-DRAINAGE) (CONNECT TO EX SD) P02 31+23.56, 21.76' RT P01 27+25.00, 67.54' RT **POINT** EL STATION/OFFSET P02 30+99.51, 12.47' LT END GDBK 3RD AVE NW RIM=46.97 END PARKING LOT CURB EAST LOT SDMH#2 IE=42.17— EL= 46.12' P02 31+44.68, 11.62' RT 47.12 P01 24+68.01, 76.30' RT 48" TYPE-2 EAST LOT CB#4 AP CURB P02 31+21.93, 0.00' 48" TYPE-2 EL=45.68' 1/2 P02 31+52.14, 12.21' RT 47.23 RIM = 45.76'P02 31+20.23, 18.59' RT/ P02 30+96.64, 12.42' RT IE = 43.58(CONNECT TO EX SD) PT P02 31+58.87, 15.50' RT 47.33 EL=45.97' **CURVE TABLE, RADIUS = 30.0'** EAST LOT SDMH#1 STATION/OFFSET EL **POINT** F1592-CDD028 P02 31+01.29, 16.91 RT (CONNECT TO EX SD) RIM =45.75' PC P02 31+65.67, 50.42' LT 48.49 F1592-CPD021 1E = 42.75'CONTECH STORMFILTER F1592-CDD026 SEE SHEET F1592-CDD026 1/2 P02 31+74.65, 49.04' LT 48.88 FOR STATION/OFFSET NN PT P02 31+82.81, 45.04' LT 49.09 **CURVE TABLE, RADIUS = 40.0' POINT** STATION/OFFSET EL SEE DP-3 FOR PUBLIC **ROW STORMWATER** P02 31+59.54, 27.35' LT 48.37 **IMPROVEMENTS** P02 31+63.09, 27.51' LT 1/2 48.40 CO-1 RIM = 45.77'CO-2 P02 31+66.60, 27.98' LT PT 48.43 IE = 42.25'RIM = 46.35'IE = 43.25'**APPROVED** SEE DP-3 FOR PUBLIC ROW CITY OF PUYALLUP STORM WATER IMPROVEMENTS -DEVELOPMENT SERVICES DATE 2/17/2021 **NOTE**: THIS APPROVAL IS VOID AFTER 180 DAYS FROM APPROVAL **CURVE TABLE, RADIUS = 200.0'** NOTES: THE CITY WILL NOT BE 1. THE LOCATION AND INVERTS F1592-CPD023 **POINT** STATION/OFFSET EL RESPONSIBLE FOR ERRORS AND/ OF THE CLEANOUTS FOR OR OMISSIONS ON THESE PLANS. PERIMETER FOOTING DRAIN P02 31+18.06, 12.42' LT 47.06 ARE APPROXIMATE. SEE FIELD CONDITIONS MAY DICTATE **DETAIL 1 ON DRAWING** CHANGES TO THESE PLANS AS P02 31+28.99, 12.12' LT 1/2 47.33 DETERMINED BY THE F1592-CDD022 FOR PIPE ENGINEERING SERVICES MATERIAL AND SIZE. SCALE IN FEET PT P02 31+38.64, 11.50' LT 47.53 PACKAGE # DP-2 **SITEWORK AND UTILITIES** RAWING No.: **PUYALLUP STATION PARKING** CIVIL PERMIT RESUBMITTAL **HENSEL PHELPS** H S. GUJULUVA RAJAN 1"=20' F1592-CGP203 CONTRACT RTA/CN 0612-18 Plan. Build. Manage. DRAWN BY: ILENAME: PUYALLUP STATION PARKING AND ACCESS FACILITY ID: . CURTIS S317-F1592-CGP203 kpii **IMPROVEMENTS** SoundTransit CHECKED BY CONTRACT No. F1592 1/11/21 | SGR | JGM | JGM | REVISIONS FOR CITY PERMIT 0504 E. MENDEL RTA/CN 0612-18 CIVIL 18/81 SGR JGM JGM ISSUED FOR CONSTRUCTION APPROVED BY REVIEWED BY: SUBMITTAL DATE:

12/04/2020

GREG SHIMIZU


12/04/2020

12/04/2020

SARA ROBERTS

J. MATTHEWS

GRADING AND DRAINAGE PLAN

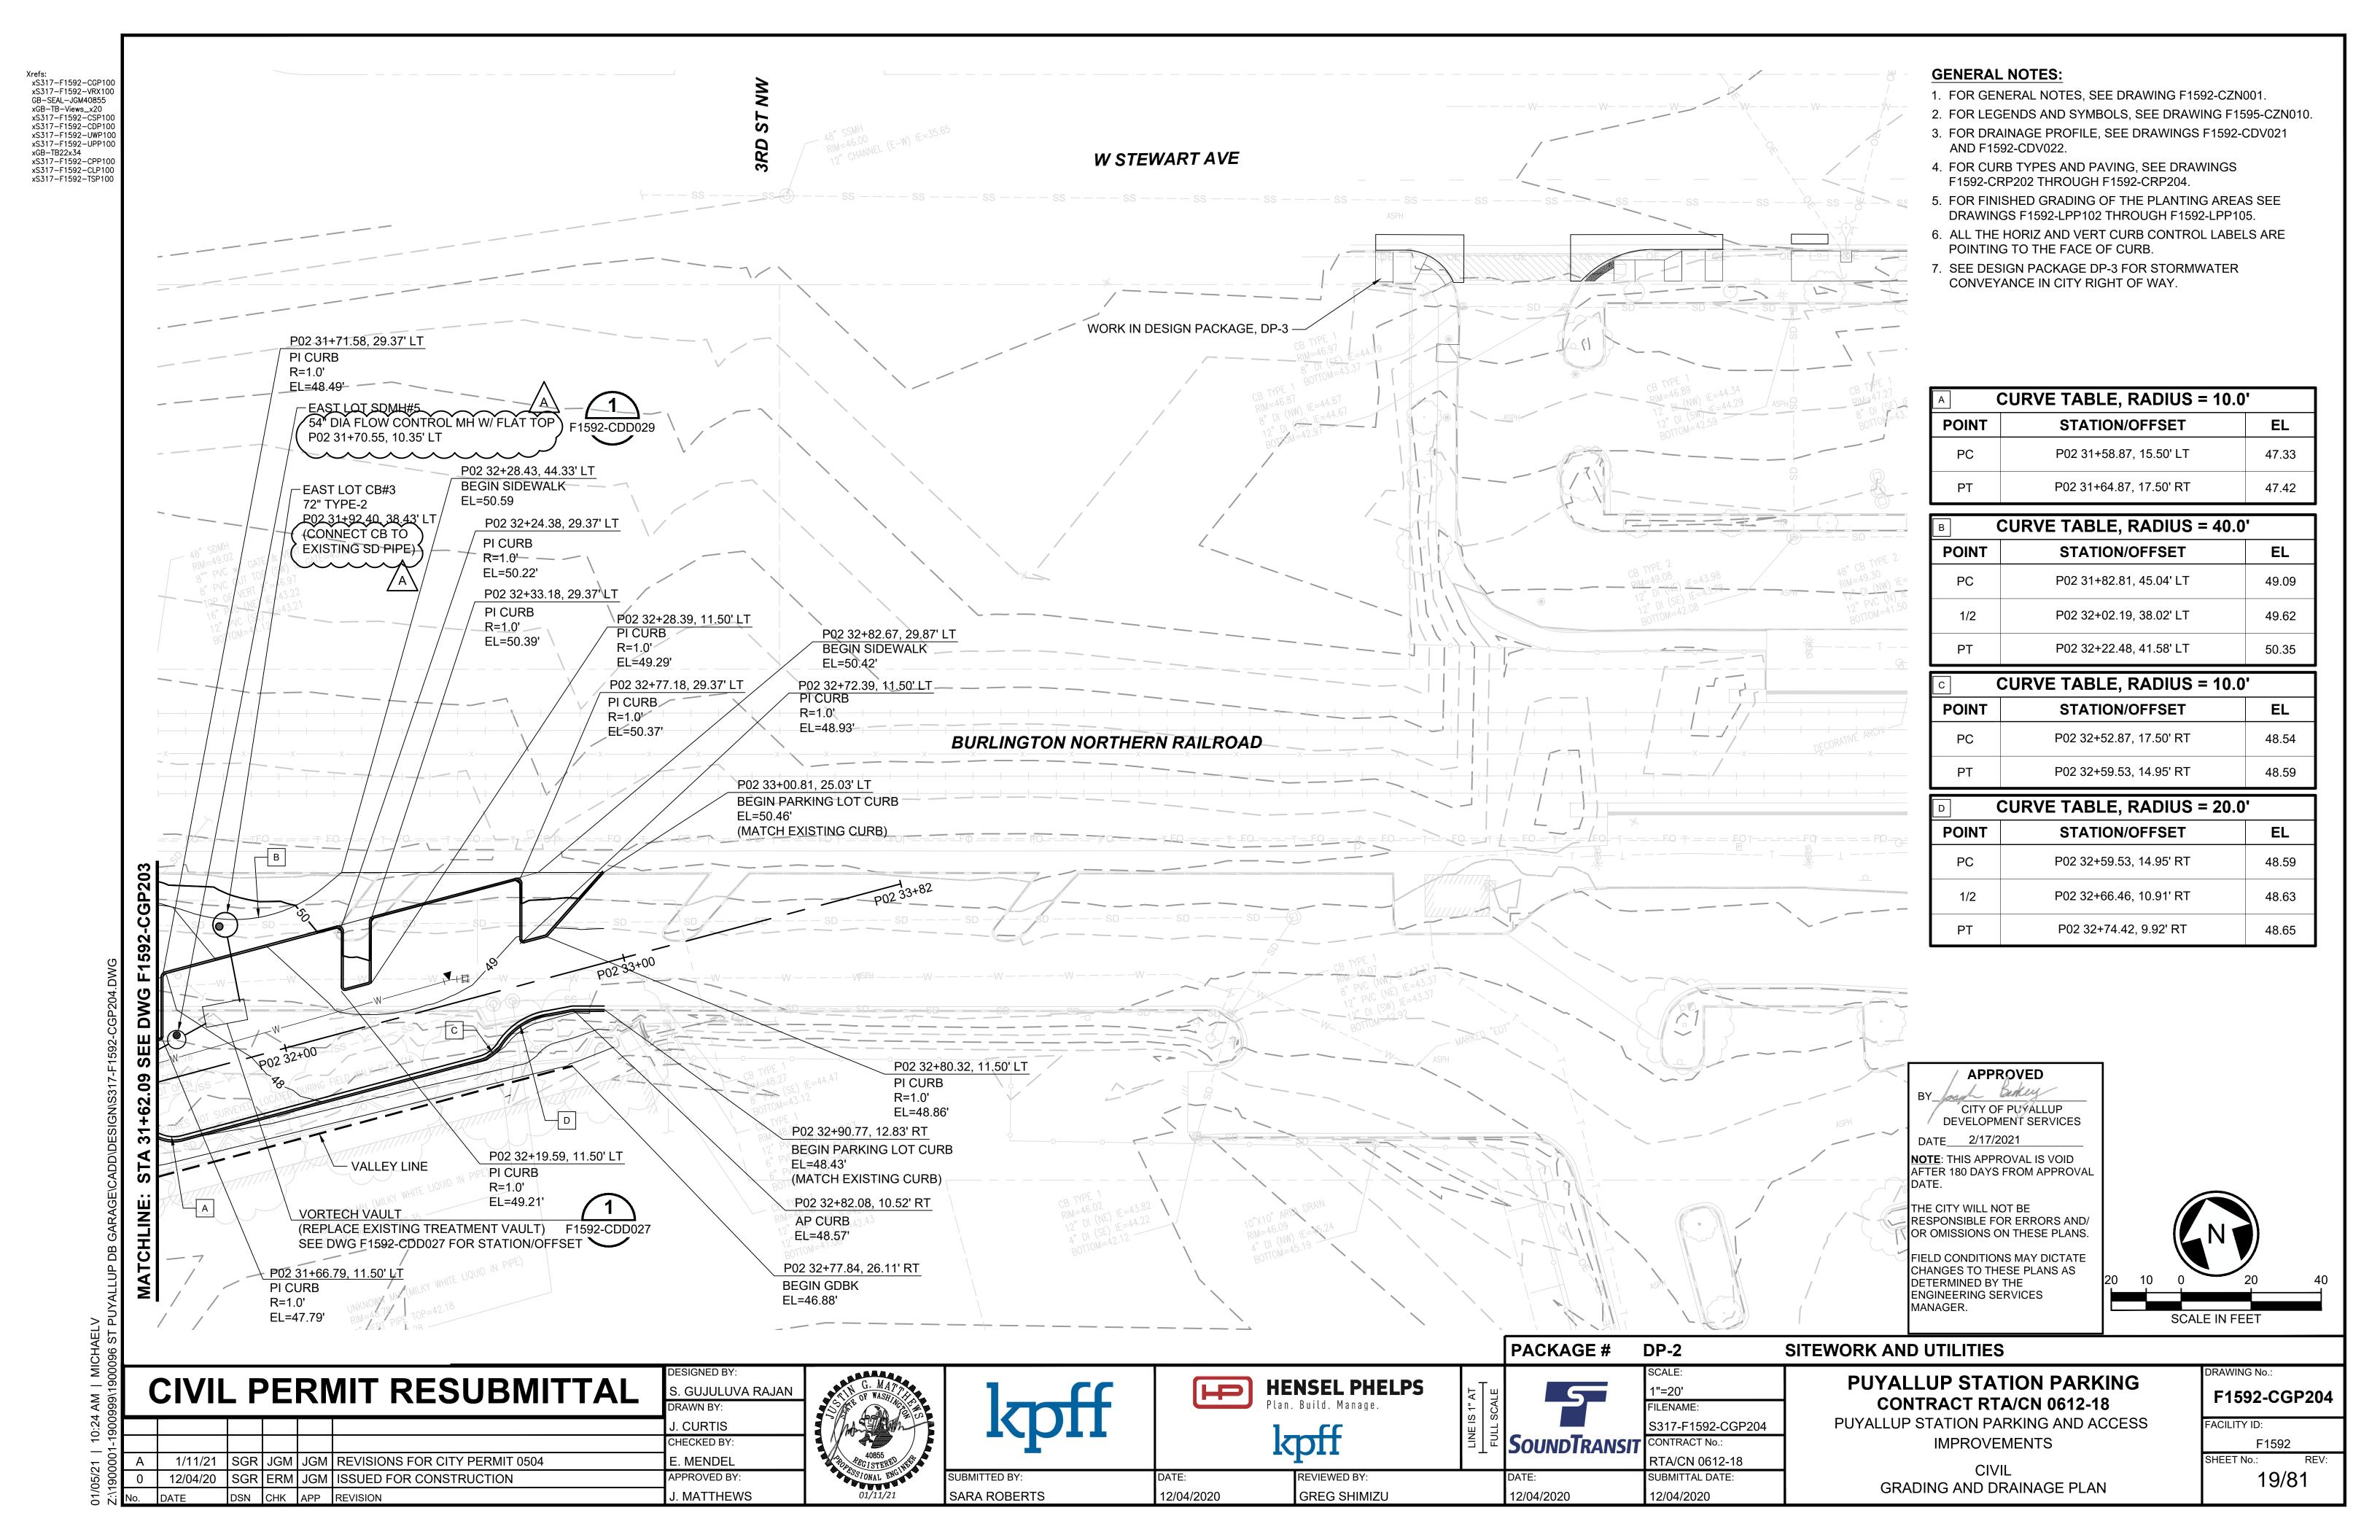


Xrefs: xS317-F1592-CGP100 **GENERAL NOTES:** xS317-F1592-RPP100 xS317-F1592-VRX100 1. FOR GENERAL NOTES, SEE DRAWING F1592-CZN001. P01 25+63.63, 58.80' RT GB-SEAL-JGM40855 xS317-F1592-CSP100 xS317-F1592-CDP100 EL=45.93' F1595-CZN010. xS317-F1592-UWP100 xS317-F1592-UPP100 xGB-TB22x34 P01 26+17.32, 57.63' RT P01 25+60.12, 58.80' RT - VALLEY LINE xS317-F1592-SGP010 F1592-CRP202 THROUGH F1592-CRP204. PI CURB xS317-F1592-TSP100 xS317-F1592-CLP100 P01 25+71.23, 61.38' RT EL=46.87' R=2.0' P01 26+18.85, 57.63' RT EL=45.86' DRAWINGS F1592-LPP102 THROUGH F1592-LPP105. P01 26+05.41, 63.51' RT PI CURB EL=45.91' R=2.0' POINTING TO THE FACE OF CURB. EL=46.49' - R⁄=12.5' EL=46.94' P01 25+75.70, 68.05' RT R=15' -EL=45.92' P01 26+23.76, 75.97' RT AP CURB EL=47.13' P01 26+02.83. 76.53' RT P01 26+23.38, 76.47' RT P01 25+64.81, 76.30' RT RAMP TOP AP CURB EL=46.72' EL=47.62' EL=46.12' P01 25+64.36, 86.50' RT P01 25+70.79, 85.22' RT P01 25+79.67, 82.83' RT 4.46% 0.34% 1/2 P01 26+23.38, 81.97' RT EL=46.12' EL=45.64' EL=45.89' RAMP TOP EL=47.69' P01 25+57.81, 86.93' RT EL=45.54' P01 26+27.08, 81.97' RT **AP PAVING** P01 26+04.29, 81.97' RT EL=47.70' — R=50' P01 25+66.38, 92.10' RT RAMP BOTTOM EL=46.83' EL=45.74' P01 25+57.89, 98.63' RT EL=45.30' P01 25+81.10, 88.14' RT **END CURB** P01 26+30.57, 94.98' RT TOC=BOC=46.20' P01 25+69.33, 102.13' RT EL=47.40' **APPROVED** FL=46.32' P01 25+83.33, 98.36' RT P01 26+09.33, 100.69' RT EL=46.48' CITY OF PUYALLUP EL=47.00' DEVELOPMENT SERVICES P01 25+63.62, 103.66' RT EL=46.25' DATE_ 2/17/2021 **NOTE**: THIS APPROVAL IS VOID AFTER 180 DAYS FROM APPROVAL P01 25+56.50, 109.25' RT PC P01 25+85.67, 107.05' RT EL=44.92' **BEGIN CURB** TOC=47.00' BOC=46.50' P01 25+65.95, 112.36' RT EL=46.30' MANAGER. PACKAGE # DP-2 SITEWORK AND UTILITIES DRAWING No.: **CIVIL PERMIT RESUBMITTAL PUYALLUP STATION PARKING HENSEL PHELPS** P S. GUJULUVA RAJAN 1" = 5' CONTRACT RTA/CN 0612-18 Plan. Build. Manage. ILENAME: PUYALLUP STATION PARKING AND ACCESS S317-F1592-CPD021 M. VU kpff **IMPROVEMENTS** SOUNDTRANSIT CONTRACT No.: CHECKED BY:

- 2. FOR LEGENDS AND SYMBOLS, SEE DRAWING
- 3. FOR CURB TYPES AND PAVING, SEE DRAWINGS
- 4. FOR FINISHED GRADING OF THE PLANTING AREAS, SEE
- 5. ALL THE HORIZ AND VERT CURB CONTROL LABELS ARE

THE CITY WILL NOT BE RESPONSIBLE FOR ERRORS AND/ OR OMISSIONS ON THESE PLANS

FIELD CONDITIONS MAY DICTATE CHANGES TO THESE PLANS AS DETERMINED BY THE ENGINEERING SERVICES



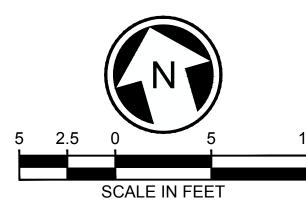

CIVIL

PAVING AND GRADING DETAILS

J. MATTHEWS

APPROVED BY:

J. MATTHEWS

12/04/20 SGR JGM JGM ISSUED FOR CONSTRUCTION

SARA ROBERTS

12/04/2020

REVIEWED BY:

12/04/2020

GREG SHIMIZU

RTA/CN 0612-18 SUBMITTAL DATE:

12/04/2020

F1592-CPD021 FACILITY ID:

F1592 20/81 Xrefs: xS317-F1592-CGP100 **GENERAL NOTES:** P01 27+25.20, 6.02' RT xS317-F1592-RPP100 xS317-F1592-VRX100 P01 27+23.77, 6.12' RT 1. FOR GENERAL NOTES, SEE DRAWING F1592-CZN001. GB-SEAL-JGM40855 EL=46.88' PI CURB P01 27+80.85, 9.51' RT 2. FOR LEGENDS AND SYMBOLS, SEE DRAWING xS317-F1592-CSP100 xS317-F1592-CDP100 EL=46.88' P01 27+31.95, 8.43' RT — R=9' PAVING GRADE BREAK F1595-CZN010. xS317-F1592-UWP100 xS317-F1592-UPP100 R=2.00' EL=46.41' 3. FOR CURB TYPES AND PAVING, SEE DRAWINGS xGB-TB22x34 EL=46.69' xS317-F1592-SGP010 F1592-CRP202 THROUGH F1592-CRP204. xS317-F1592-CLP100 xS317-F1592-TSP100 P01 27+34.80, 15.00' RT 4. FOR FINISHED GRADING OF THE PLANTING AREAS, SEE DRAWINGS F1592-LPP102 THROUGH F1592-LPP105. EL=46.49' 5. ALL THE HORIZ AND VERT CURB CONTROL LABELS ARE POINTING TO THE FACE OF CURB. P01 27+34.80, 15.28' RT EL=46.49' P01 26+69.20, 22.40' RT P01 27+84.42, 22.84' RT P01 27+19.41, 22.40' RT PI CURB **AP CURB** EL=46.55' AP CURB **VALLEY LINE** EL=46.51' R=2.00' EL=46.79' P01 27+75.80, 35.05' RT P01 27+32.94, 20.75' RT AP SIDEWALK 1/2 EL=47.10' EL=46.33' P01 27+64.72, 28.12' RT P01 27+28.14, 23.97' RT EL=46.51' P01 27+61.39, 31.04' RT EL=46.59' P01 27+61.69, 35.45' RT P01 27+18.42, 27.35' RT EL=46.66' **LOW POINT** 6" CURB EL=45.90' **CURB HEIGHT TRANSITION -**VALLEY LINE P01 26+64.17, 41.17' RT PI CURB EL=46.47' R=2.00' P01 27+69.83, 49.52' RT AP CURB TOC=BOC=46.89' P01 26+63.04, 57.99' RT EL=46.67' **APPROVED** ∕— R= 2.50' P01 26+66.16, 59.05' RT CITY OF PUYALLUP DEVELOPMENT SERVICES EL=46.67' DATE 2/17/2021 P01 26+61.58, 60.95' RT NOTE: THIS APPROVAL IS VOID AFTER 180 DAYS FROM APPROVAL P01 27+00.97, 68.55' RT P01 27+72.46, 56.82' RT EL=46.72' RAMP BOTTOM RAMP BOTTOM EL=46.90' EL=47.00' P01 26+90.35, 71.41' RT THE CITY WILL NOT BE P01 26+65.61, 75.97' RT RESPONSIBLE FOR ERRORS AND/ RAMP TOP P01 27+79.16, 47.53' RT AP CURB OR OMISSIONS ON THESE PLANS EL=47.40' RAMP TOP EL=46.98' EL=47<u>11</u>' ____ ___ FIELD CONDITIONS MAY DICTATE CHANGES TO THESE PLANS AS P01 26+75.35, 74.93' RT DETERMINED BY THE AP CURB ENGINEERING SERVICES P01 27+81.04, 54.51 RT EL=46.89' MANAGER. RAMP TOP EL=47.25' 4.55% NEW DRAWING P01 27+02.85, 75.54' RT RAMP BOTTOM EL=47.00' P01 26+92.23, 78.40' RT RAMP TOP EL=47.50' P01 26+72.28, 81.97 RT AP PAVING EL=47.54' P01 26+72.73, 83.64' RT **AP PAVING** EL=47.58' SCALE IN FEET PACKAGE # DP-2 SITEWORK AND UTILITIES DRAWING No.: **CIVIL PERMIT RESUBMITTAL PUYALLUP STATION PARKING HENSEL PHELPS** P S. GUJULUVA RAJAN 1" = 5' F1592-CPD022 CONTRACT RTA/CN 0612-18 Plan. Build. Manage. ILENAME: PUYALLUP STATION PARKING AND ACCESS S317-F1592-CPD022 FACILITY ID: M. VU kpff **IMPROVEMENTS SOUNDTRANSIT** F1592 CHECKED BY: CONTRACT No.: J. MATTHEWS RTA/CN 0612-18 CIVIL 21/81 SGR JGM JGM ISSUED FOR CONSTRUCTION APPROVED BY: REVIEWED BY: SUBMITTAL DATE:

12/04/2020

GREG SHIMIZU

12/04/2020


12/04/2020


PAVING AND GRADING DETAILS

12/04/20

J. MATTHEWS

SARA ROBERTS

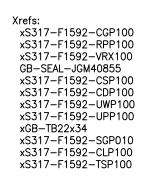

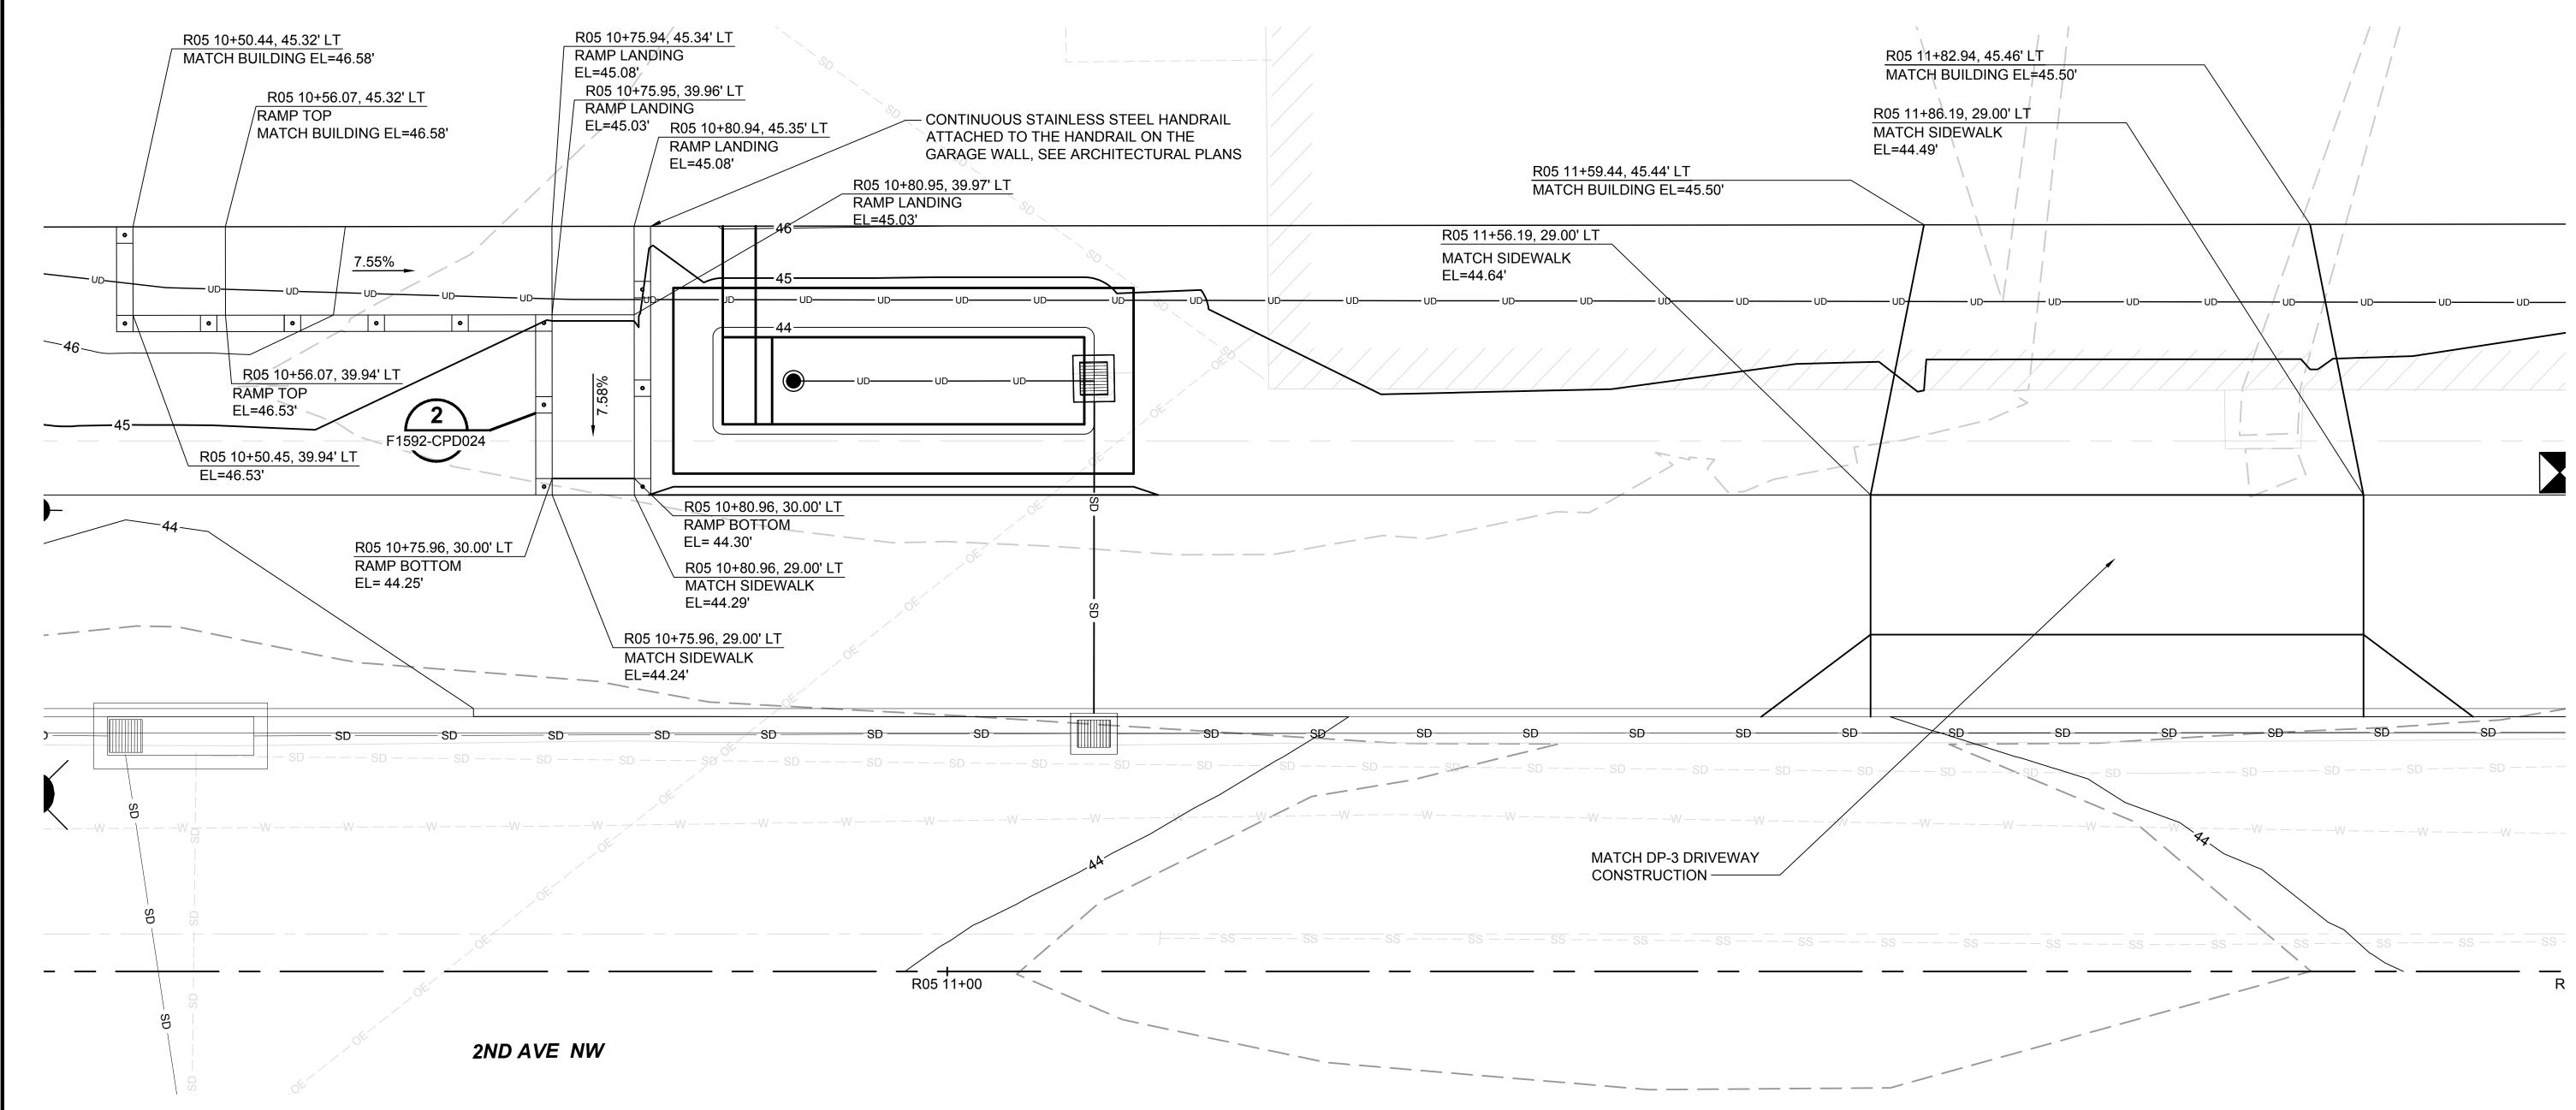

GENERAL NOTES:

- 1. FOR GENERAL NOTES, SEE DRAWING F1592-CZN001.
- 2. FOR LEGENDS AND SYMBOLS, SEE DRAWING F1595-CZN010.
- 3. FOR CURB TYPES AND PAVING, SEE DRAWINGS F1592-CRP202 THROUGH F1592-CRP204.
- 4. FOR FINISHED GRADING OF THE PLANTING AREAS, SEE DRAWINGS F1592-LPP102 THROUGH F1592-LPP105.

5. ALL THE HORIZ AND VERT CURB CONTROL LABELS ARE POINTING TO THE FACE OF CURB.

APPROVED

CITY OF PUYALLUP
DEVELOPMENT SERVICES


DATE 2/17/2021

NOTE: THIS APPROVAL IS VOID
AFTER 180 DAYS FROM APPROVAL

THE CITY WILL NOT BE RESPONSIBLE FOR ERRORS AND/ OR OMISSIONS ON THESE PLANS.

FIELD CONDITIONS MAY DICTATE CHANGES TO THESE PLANS AS DETERMINED BY THE ENGINEERING SERVICES MANAGER.

SITEWORK AND UTILITIES

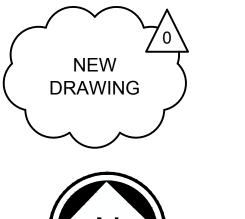

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(CIVIL	_ F	PE	R۱	IT RESUBMITTAL	DESIGNED BY: S. GUJULUVA RAJAN DRAWN BY:	
						M. VU	
						CHECKED BY:	
1	1/11/21	SGR	JGM	JGM	REVISIONS FOR CITY PERMIT 0504	J. MATTHEWS	
)	12/04/20	SGR	JGM	JGM	ISSUED FOR CONSTRUCTION	APPROVED BY:	•
	DATE	DSN	CHK	APP	REVISION	J. MATTHEWS	







12/04/2020

REVIEWED BY:

GREG SHIMIZU

		PACKAGE#	DP-2
			SCALE:
AT	- 	5	1" = 5'
	SCALE		FILENAM
LINE IS 1" AT	╛		S317-F
\leq	J.	SOUNDTRANSIT	CONTRA
			RTA/CI

12/04/2020

	SCALE:
	1" = 5'
	FILENAME:
	S317-F1592-CPD023
ISIT	CONTRACT No.:
	RTA/CN 0612-18
	SUBMITTAL DATE:

12/04/2020

PUYALLUP STATION PARKING CONTRACT RTA/CN 0612-18

PUYALLUP STATION PARKING AND ACCESS IMPROVEMENTS

CIVIL PAVING AND GRADING DETAILS


F1592-CPD023
FACILITY ID:
F1592


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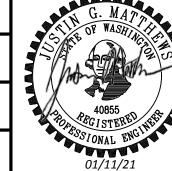
F1592
SHEET No.: R
PADING DETAILS


22/81



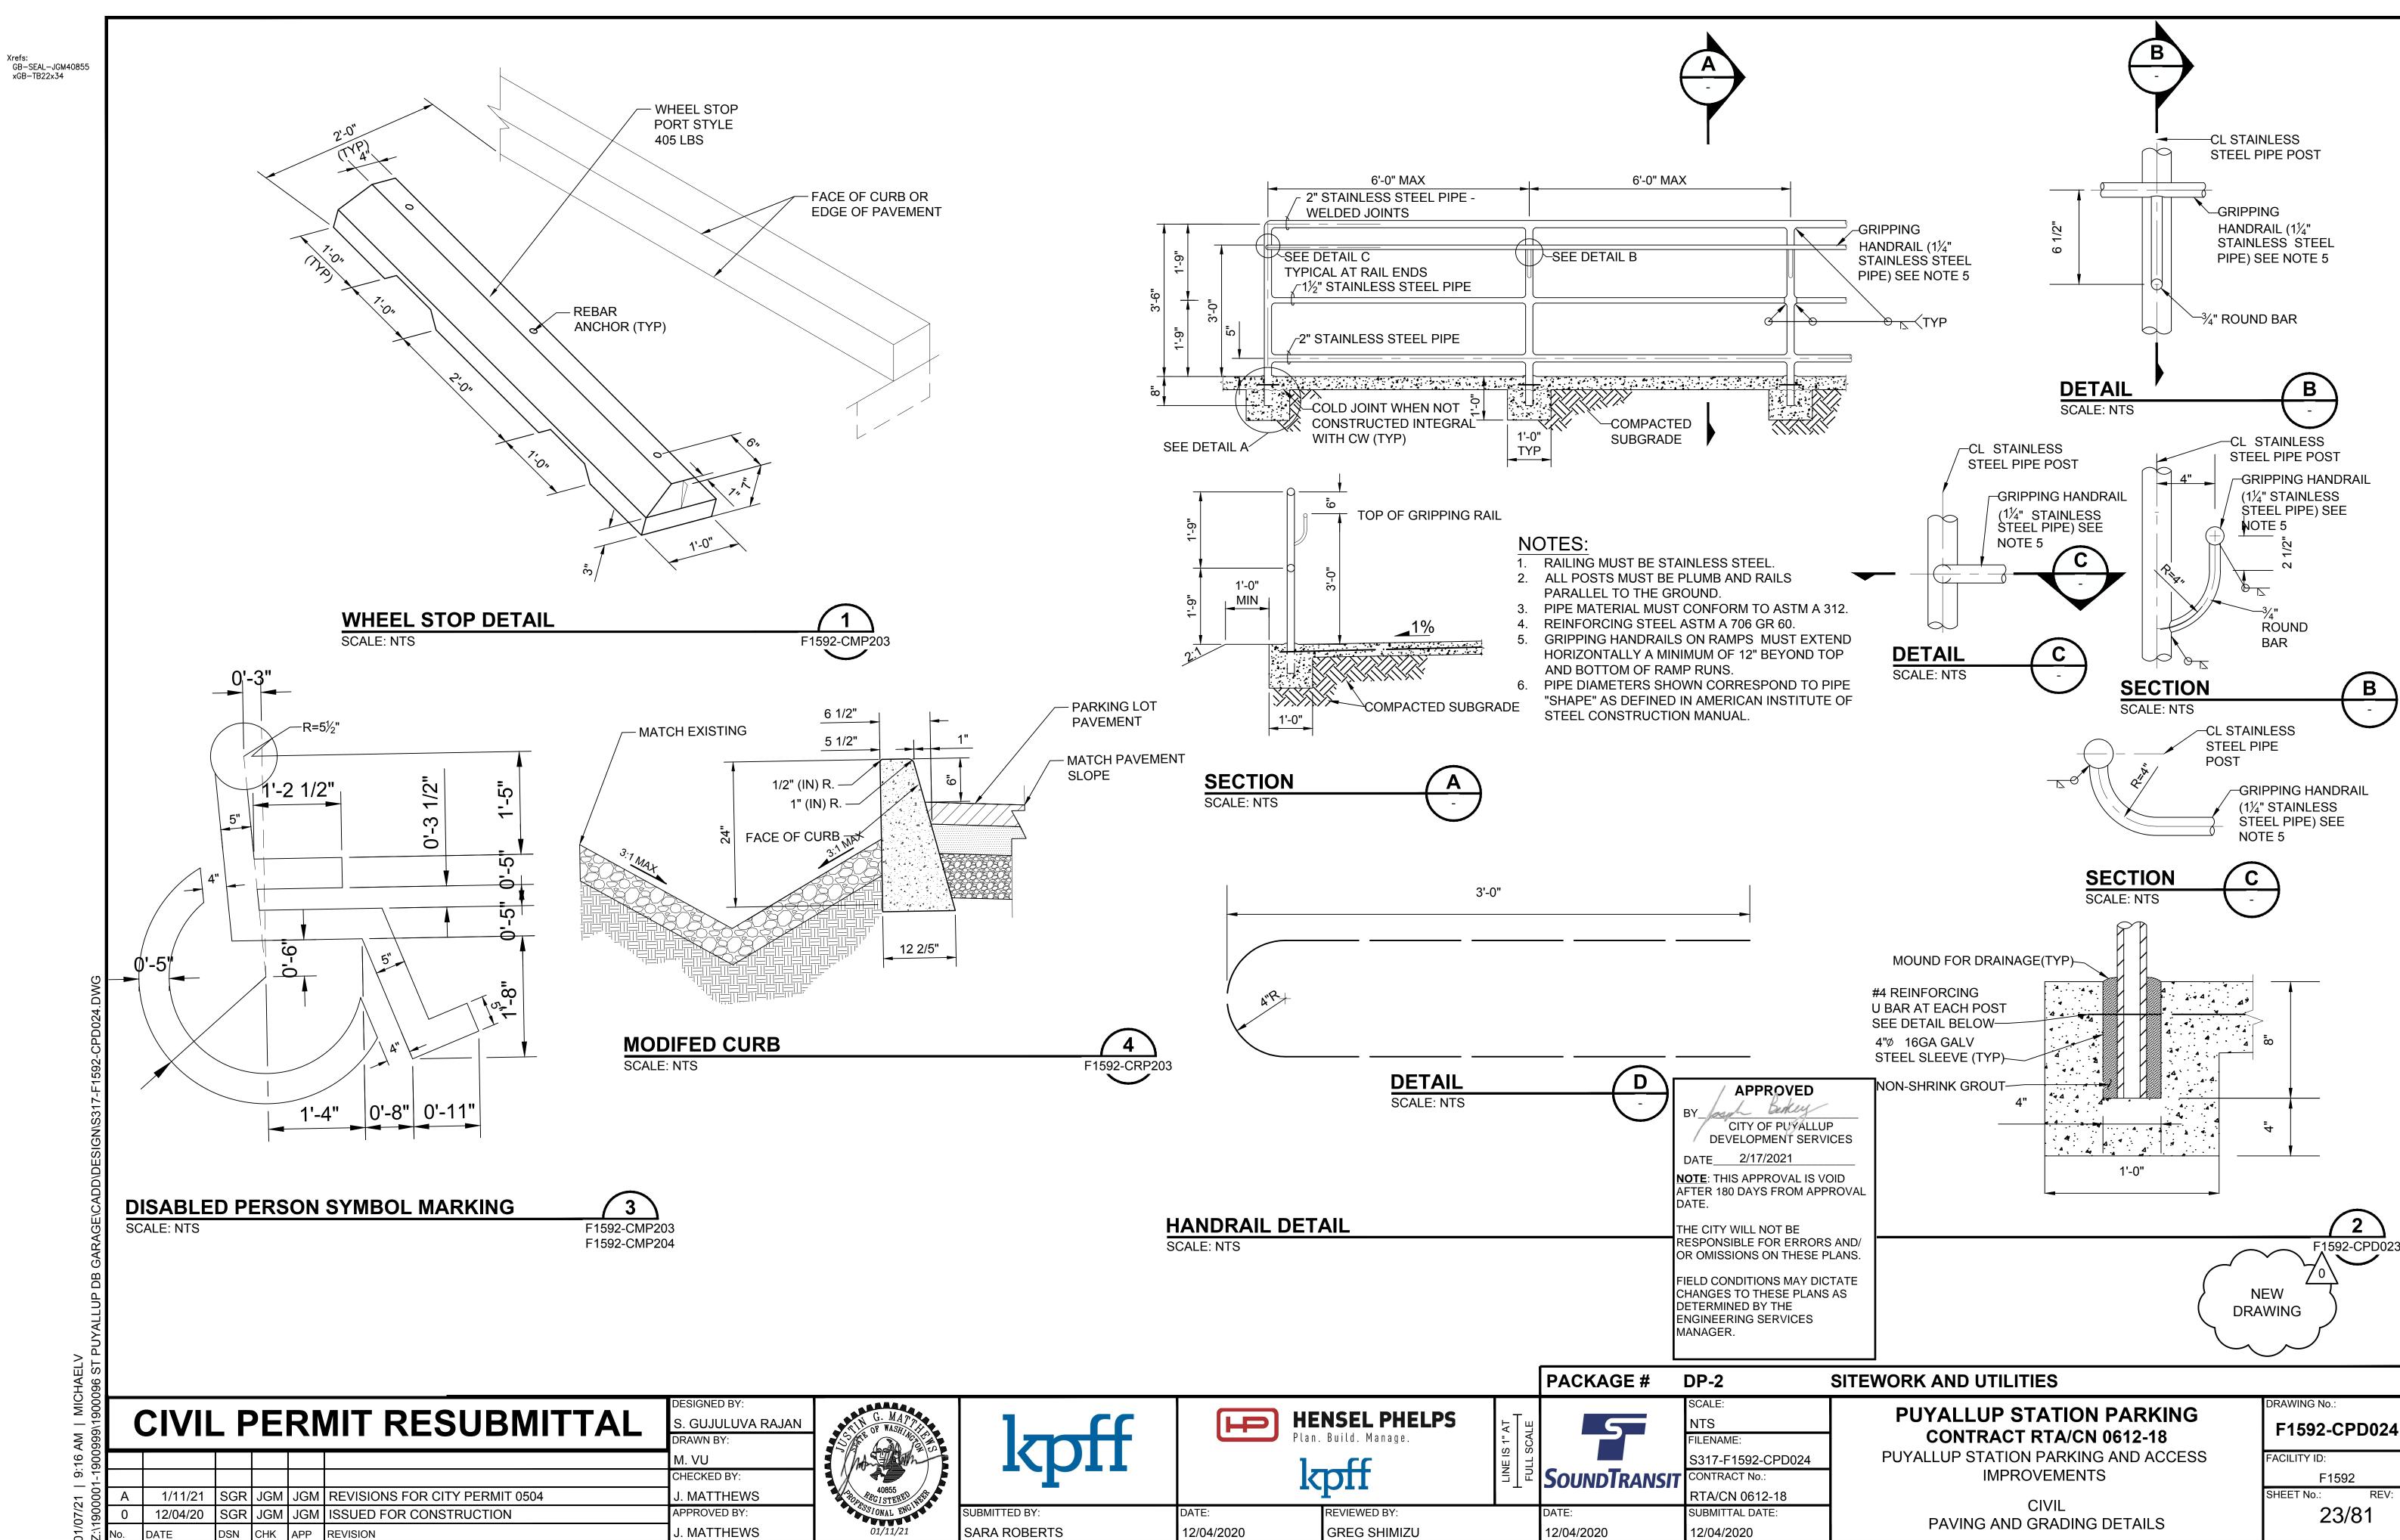

J. CURTIS CHECKED BY 1/11/21 SGR JGM JGM REVISIONS FOR CITY PERMIT 0504 E. MENDEL SGR JGM JGM ISSUED FOR CONSTRUCTION APPROVED BY J. MATTHEWS

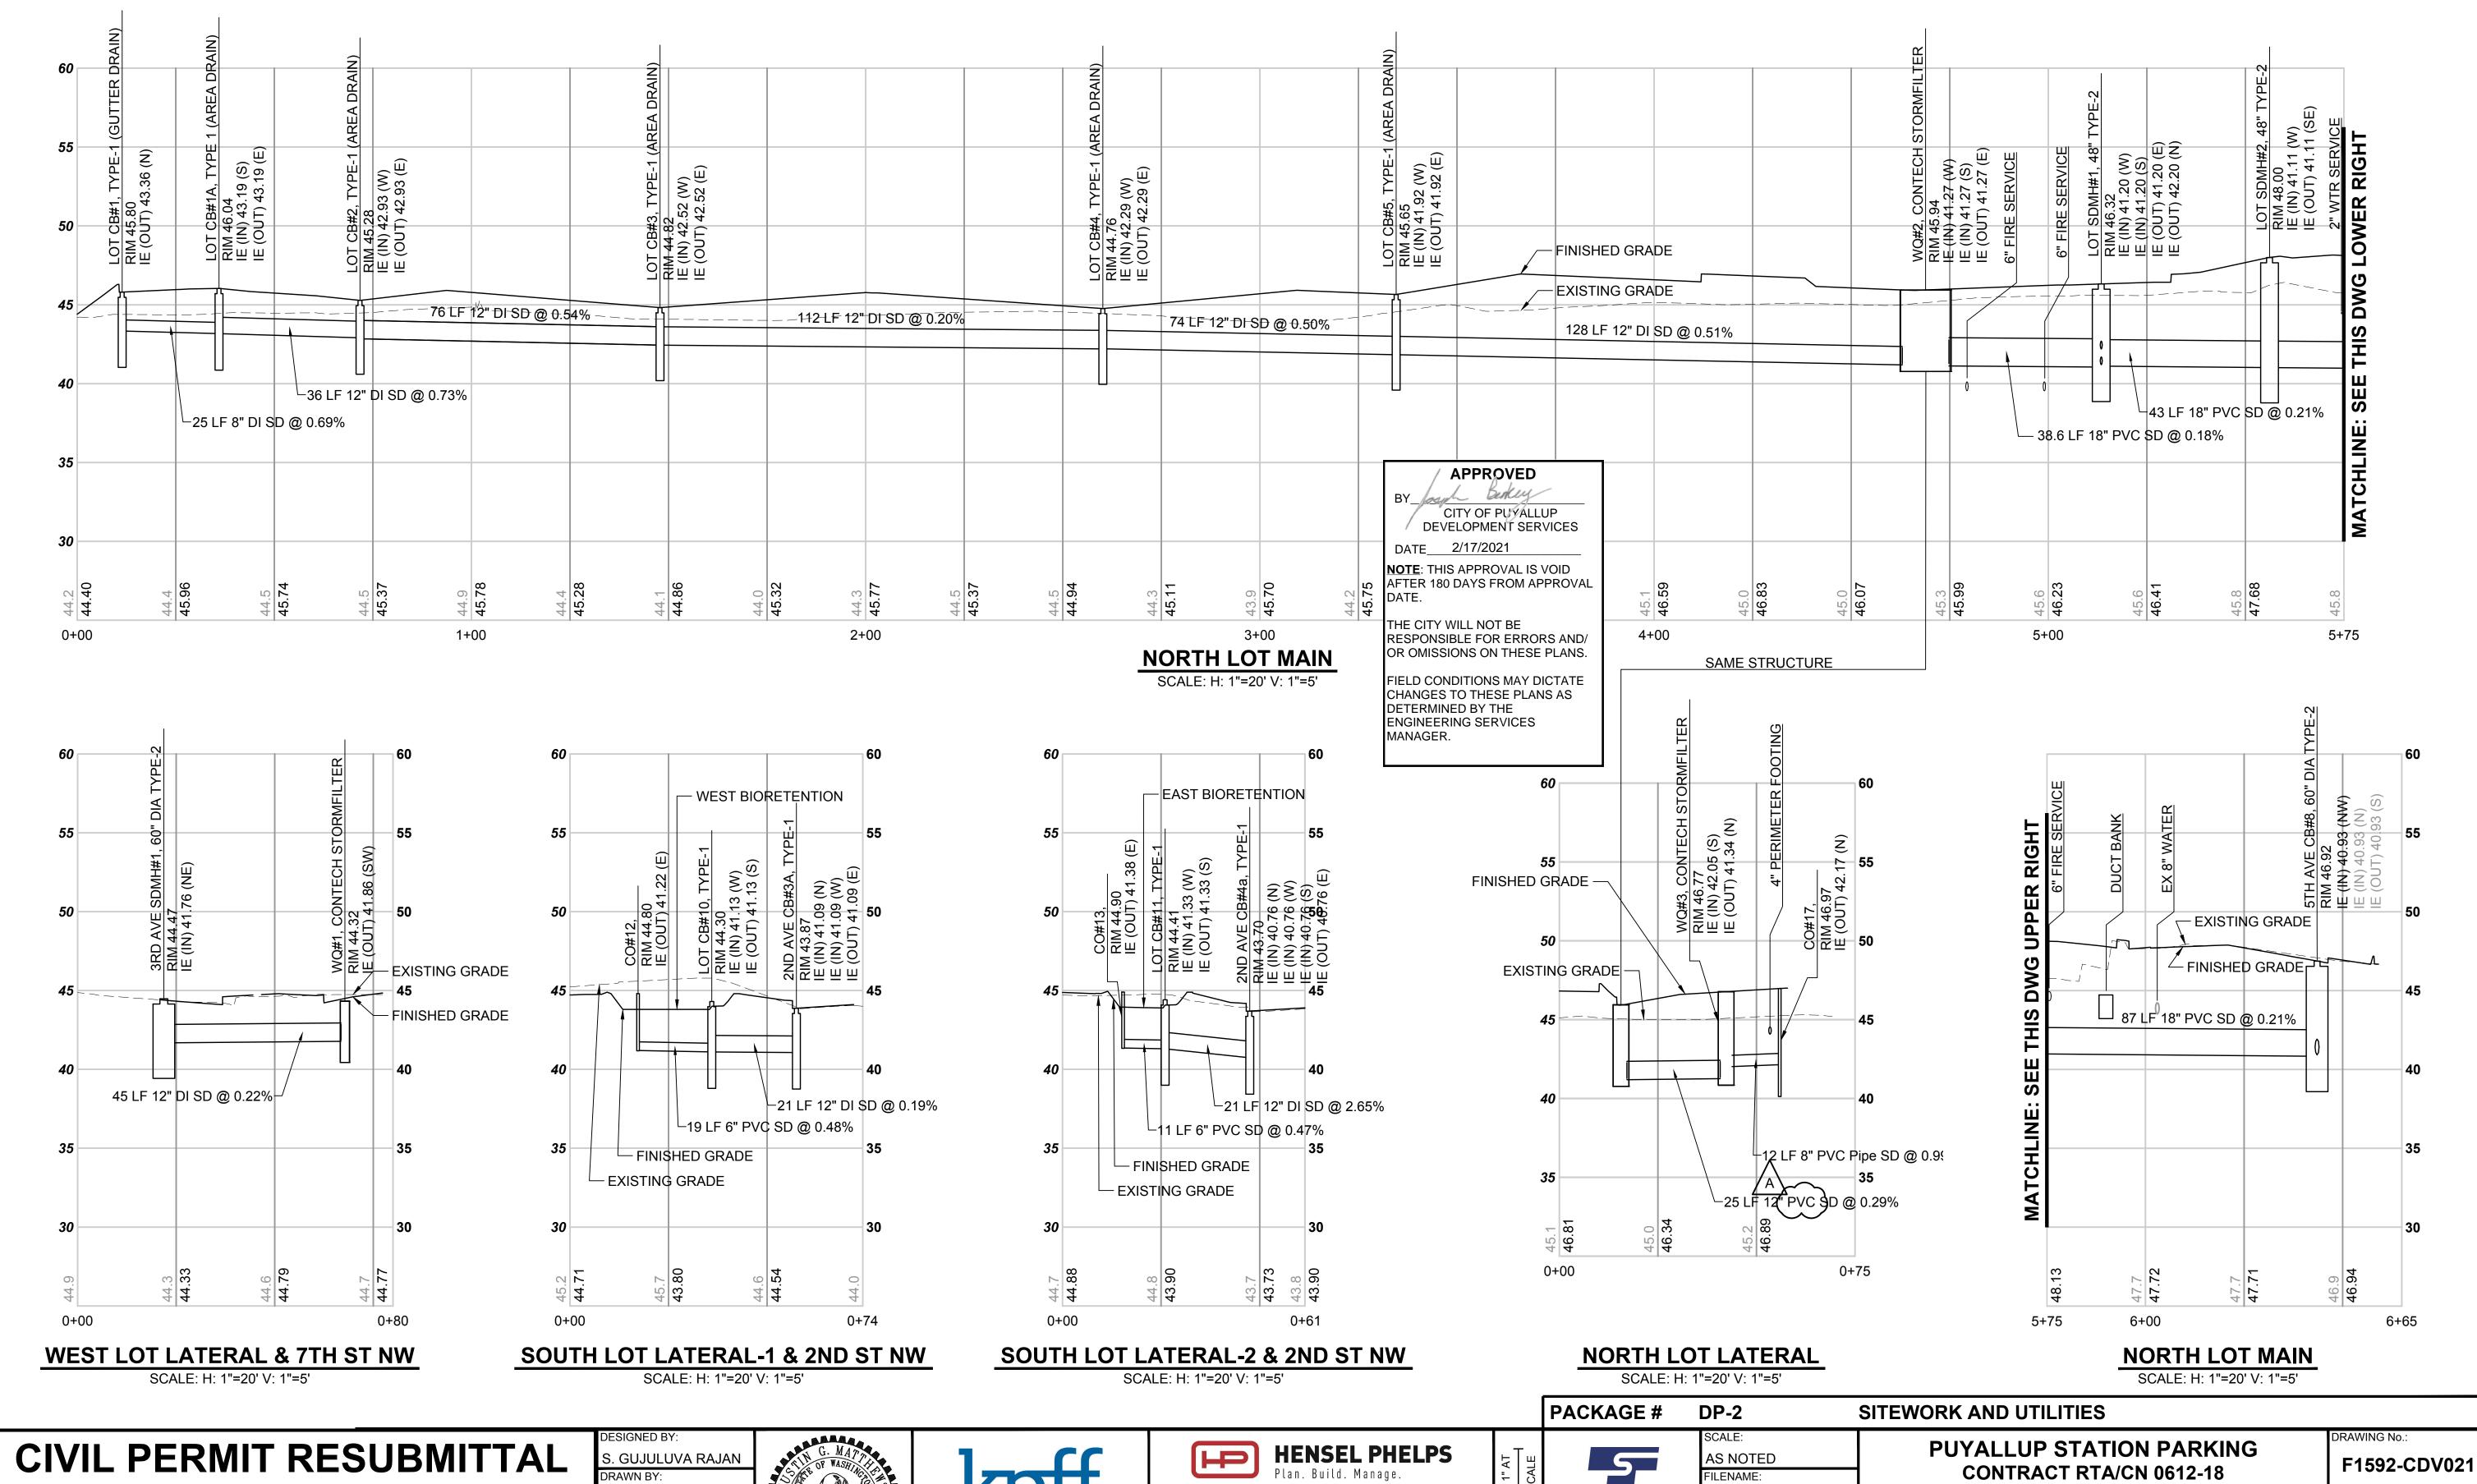

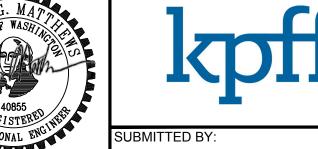

SARA ROBERTS



12/04/2020



GREG SHIMIZU

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		R
	DATE:	SU

12/04/2020

317-F1592-CDV021 ONTRACT No.: RTA/CN 0612-18 JBMITTAL DATE:


12/04/2020

PUYALLUP STATION PARKING AND ACCESS **IMPROVEMENTS**

CIVIL

DRAINAGE PROFILES

FACILITY ID: F1592 24/81

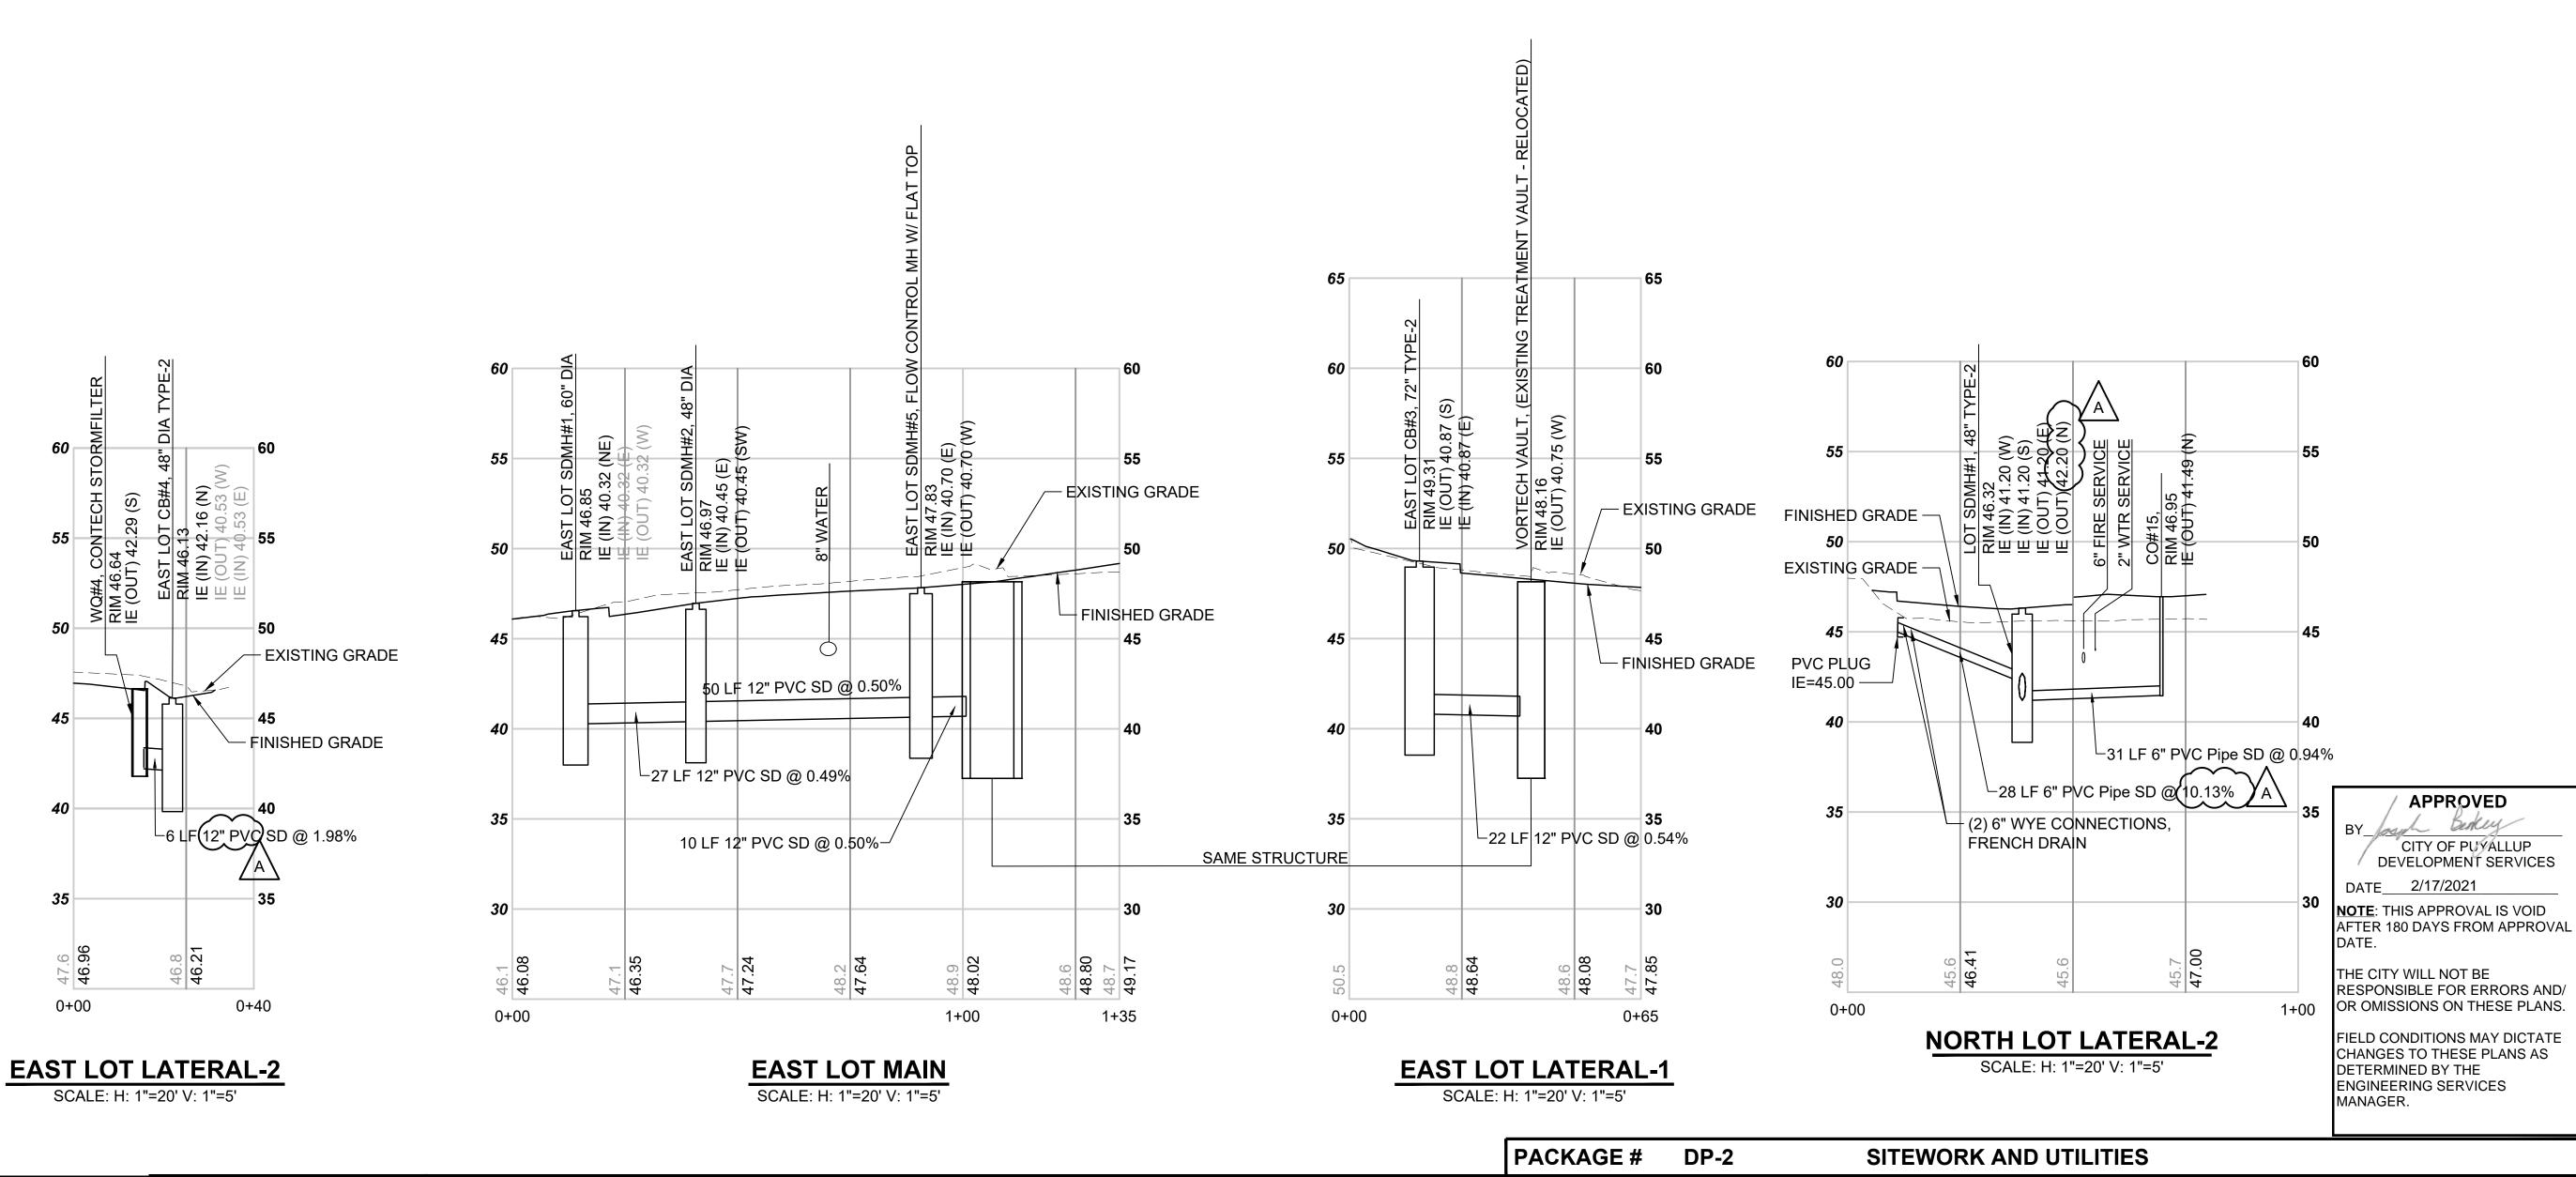

01/05/21 | 10:27 AM | MICHAELV Z:\1900001-1900999\1900096 ST PUYALLUP DB GARA

CIVIL PERMIT RESUBMITTAL

S. GUJULUVA RAJAN
DRAWN BY:

J. CURTIS

CHECKED BY:


E. MENDEL

O 12/04/20 SGR JGM JGM REVISION

DATE

DSN CHK APP REVISION

J. MATTHEWS

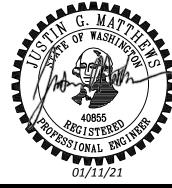



SARA ROBERTS



GREG SHIMIZU

12/04/2020

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12/04/2020

SCALE:
AS NOTED
FILENAME:
S317-F1592-CDV022
CONTRACT No.:
RTA/CN 0612-18
SUBMITTAL DATE:

12/04/2020

PUYALLUP STATION PARKING
CONTRACT RTA/CN 0612-18
PUYALLUP STATION PARKING AND ACCESS


JP STATION PARKING AND ACCESS
IMPROVEMENTS
CIVIL


DRAINAGE PROFILES

DRAWING No.: **F1592-CDV022**


FACILITY ID:

F1592 SHEET No.: REV 25/81

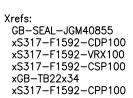


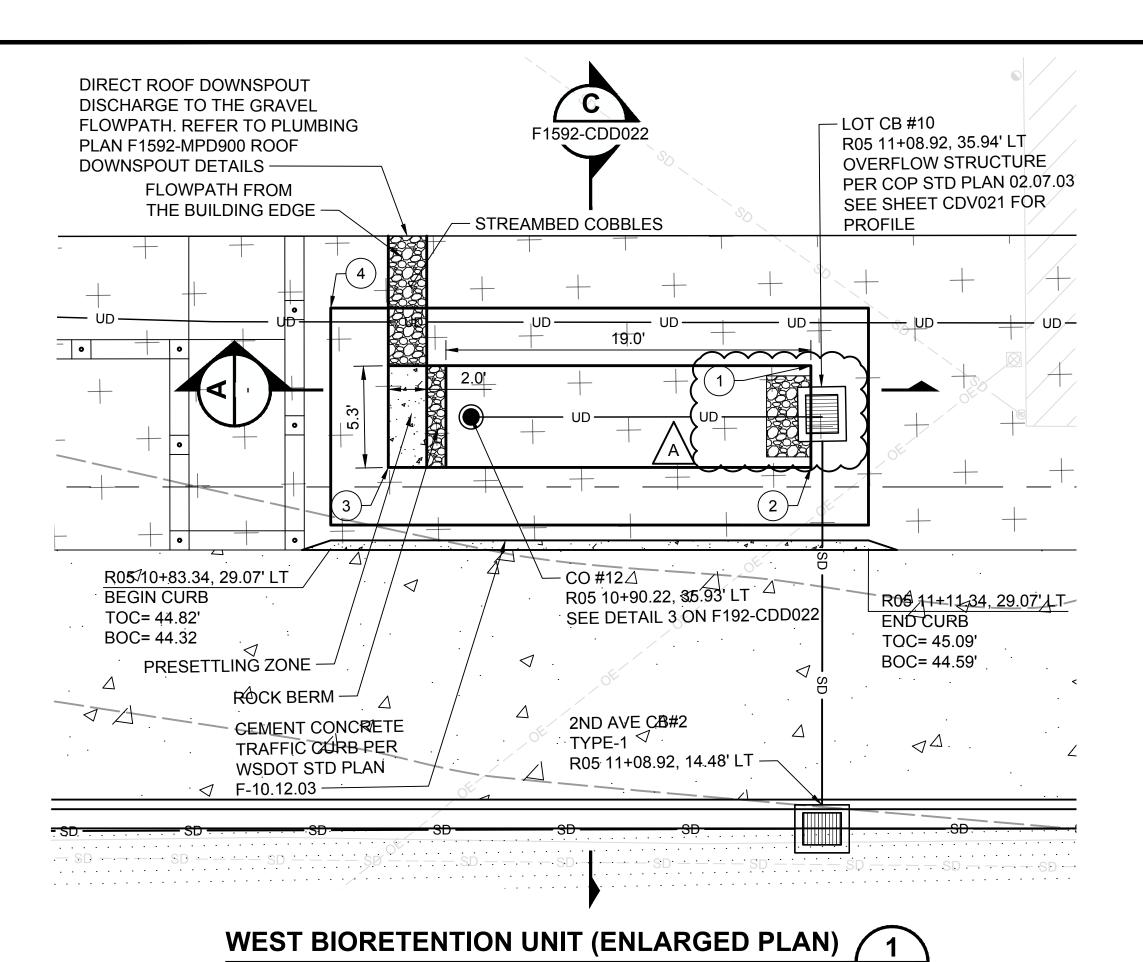


WE	ST BIORETENTION UNIT	
UPST	TREAM BOTTOM ELEVATION = 43.80'	
NO.	STATION/OFFSET	
1	LOT 26+69.50, 219.93' RT	
2	LOT 26+70.87, 225.05' RT	
3	LOT 26+49.62, 230.74' RT	
4	LOT 26+44.57, 223.50' RT	
EAST BIORETENTION UNIT		
UPST	TREAM BOTTOM ELEVATION = 43.90'	
5	LOT 27+76.98, 191.02' RT	
6	LOT 27+78.35, 196.14' RT	
7	LOT 27+67.72, 198.98' RT	
8	LOT 27+66.35, 193.86' RT	

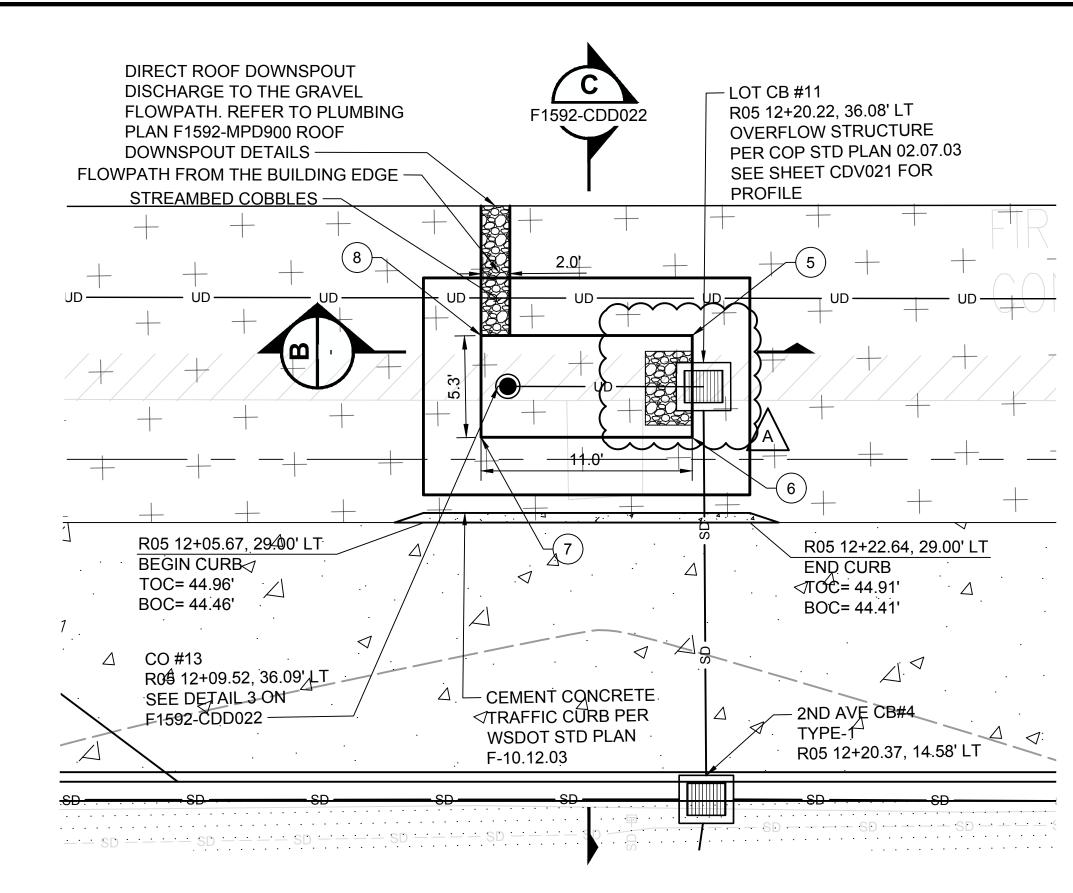



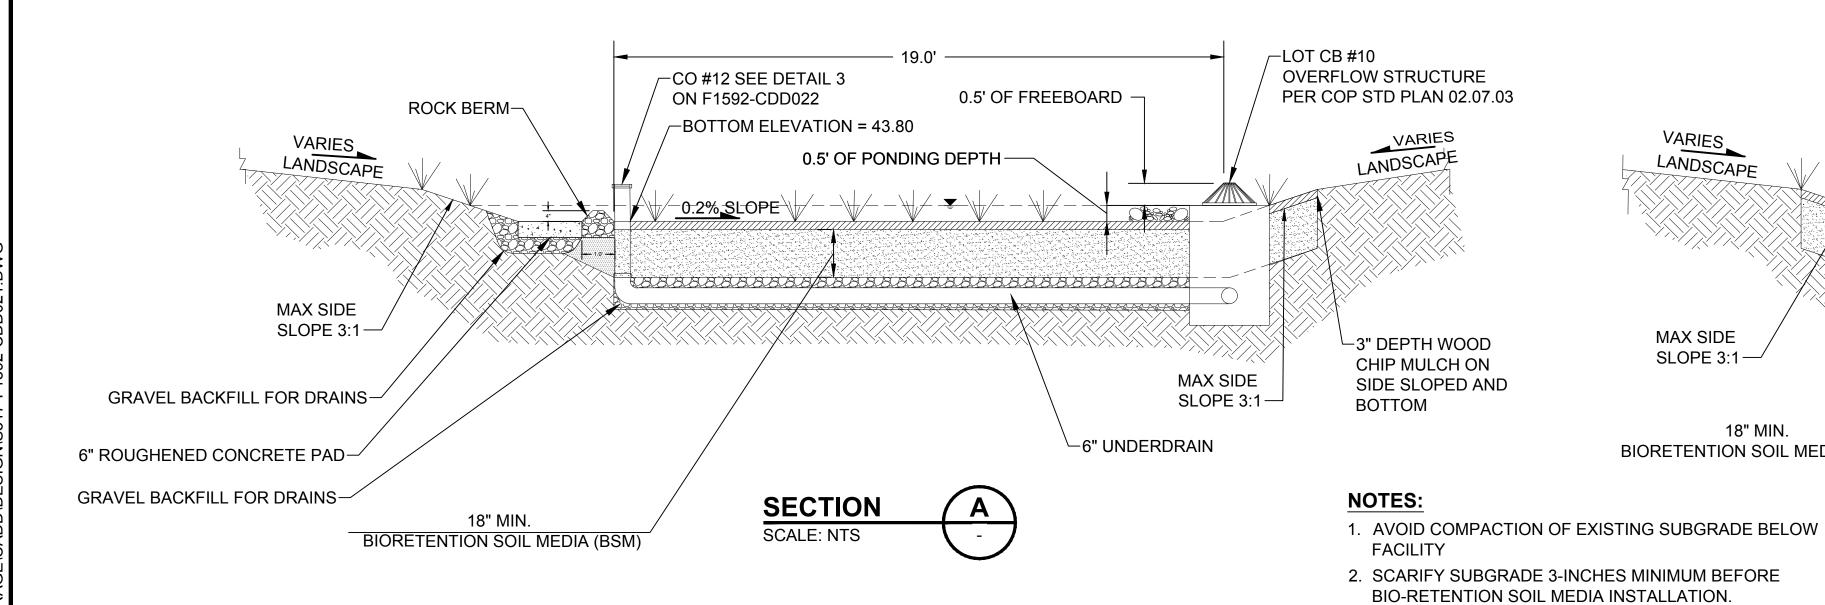

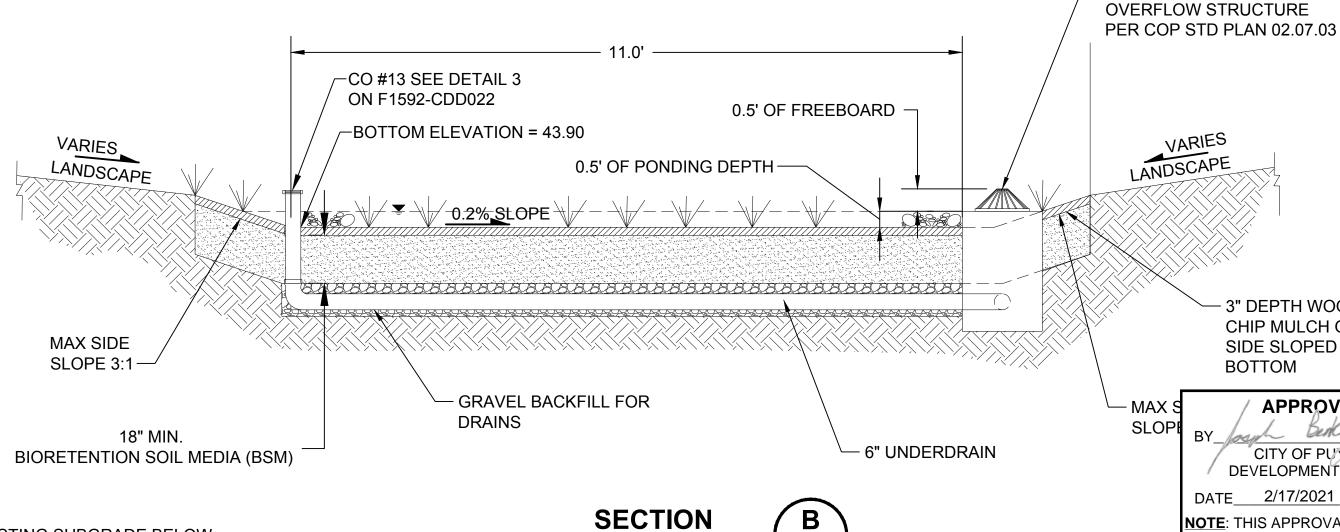

SCALE: NTS

APPROVED CITY OF PUYALLUP DEVELOPMENT SERVICES DATE 2/17/2021 В **NOTE**: THIS APPROVAL IS VOID AFTER 180 DAYS FROM APPROVAL

- LOT CB #11

VARIES

THE CITY WILL NOT BE RESPONSIBLE FOR ERRORS AND/ OR OMISSIONS ON THESE PLANS.

3" DEPTH WOOD

CHIP MULCH ON

BOTTOM

SIDE SLOPED AND

FIELD CONDITIONS MAY DICTATE CHANGES TO THESE PLANS AS DETERMINED BY THE ENGINEERING SERVICES

CIVIL PERMIT RESUBMITTAL S. GUJULUVA RAJAN . CURTIS CHECKED BY: 1/11/21 | SGR | JGM | JGM | REVISIONS FOR CITY PERMIT 0504 . MATTHEWS APPROVED BY: SGR JGM JGM ISSUED FOR CONSTRUCTION 12/04/20 J. MATTHEWS

CHK APP REVISION

SCALE: NTS

F1592-CGP203

SARA ROBERTS

HENSEL PHELPS H Plan. Build. Manage.

3. ROUGHENED CONCRETE PAD MUST BE

MUST HAVE PROTRUDING AGGREGATE.

6" ROCK MINIMUM.

12/04/2020

CONSTRUCTED WITH COMMERCIAL CONCRETE

EMBED WELL TO MIXED 6"-8" STREAMBED AGGREGATE

TO CREATE ROUGHNESS. 50% MIN OF THE SURFACE

4. CONSTRUCT ROCK BERM WITH STREAMBED COBBLES.

kpff

REVIEWED BY:

GREG SHIMIZU

SoundTransit

12/04/2020

PACKAGE #

NTS ILENAME: S317-F1592-CDD021 CONTRACT No.: RTA/CN 0612-18 SUBMITTAL DATE:

12/04/2020

DP-2

PUYALLUP STATION PARKING CONTRACT RTA/CN 0612-18 PUYALLUP STATION PARKING AND ACCESS

SITEWORK AND UTILITIES


IMPROVEMENTS CIVIL DRAINAGE DETAILS

RAWING No.: F1592-CDD021 FACILITY ID:

F1592 26/81

APPROVED Berkey GB-SEAL-JGM40855 CITY OF PUYALLUP xS317-F1592-CDP100 xS317-F1592-VRX100 xS317-F1592-CSP100 xGB-TB22x34 - GRAVEL BACKFILL DEVELOPMENT SERVICES FOR DRAINS DATE 2/17/2021 - COMMON BORROW **NOTE**: THIS APPROVAL IS VOID 1. SEE DRAWING F1592-LPD101 FOR LANDSCAPE AFTER 180 DAYS FROM APPROVAL - FINISHED SOIL PREPARATION AND F1592-LPX101 FOR GRADE SANDY LOAM FILL ADJACENT TO GARAGE THE CITY WILL NOT BE RESPONSIBLE FOR ERRORS AND/ OR OMISSIONS ON THESE PLANS. - PARKING LOT | ≓ EXISTING CEMENT CONCRETE **PAVEMENT** ☆ GRADE FIELD CONDITIONS MAY DICTATE TRAFFIC CURB PER CHANGES TO THESE PLANS AS WSDOT STD PLAN DETERMINED BY THE — 0.5' OF FREEBOARD F-10.12.03 -ENGINEERING SERVICES MANAGER. - 6" UNDERDRAIN 2% MIN. 0.5' **BACKFILL VARIES** (SEE NOTE 1) 1.5% TYP. 3" DEPTH WOOD CHIP MULCH ON SIDE SLOPED AND BOTTOM **GEOTEXTILE WRAP** OVERLAP END 12" MIN -- 6" PERFORATED - PERIMETER UNDERDRAIN FOOTING DRAIN GRAVEL BACKFILL FOR DRAINS -- FOOTING, SEE STRUCTURAL EQ EQ PLANS FOR GARAGE FOUNDATION 18" MIN. - 0.5' OF PONDING DEPTH **BIORETENTION SOIL MEDIA (BSM)** - UNDERDRAIN 4" PERFORATED UNDERDRAIN **GEOTEXTILE** SLOPE AT 0.25% MIN **SECTION C-C** PERIMETER FOOTING DRAIN **FRENCH DRAIN** F1592-CDD021 SCALE: NTS SCALE: NTS F1592-CGP203 F1592-CGP20 SCALE: NTS BOTTOM OF BIORI ROUND CAST IRON CLEANOUT COVER, THREADED PVC CLEANOUT JR SMITH 4231 SERIES OR EQUAL ADAPTOR AND PLUG (SAME SIZE AS PIPE) (SAME SIZE AS PIPE) CHAINLINK FENCE 0.50' 0.50' /-- FINISHED FLOOR/GRADE /— FINISHED GRADE **VARIES** BNSF PROPERTY LINE MATCH EXISTING GRADE -2.4' PARKING LOT **VARIES** PAVEMENT -PERFORATED UNDERDRAIN - PERFORATED PERFORATED ROCK LINED DITCH PIPE PER PLANS PIPE PER PLANS 0.5' MIN. DEPTH OF 2"-4" QUARRY SPALLS COMMON BORROW PLAN INVERT PLAN INVERT CEMENT CONCRETE TRAFFIC **ELEVATION ELEVATION** - 90° BEND CURB PER WSDOT STD PLAN SUBGRADE PLUG OR UPSTREAM — WYE F-10.12.03 PIPE PER PLANS - PLUG OR UPSTREAM PIPE PER PLANS 3 **BIORETENTION CLEANOUT DITCH DETAIL CLEANOUT DETAIL** SCALE: NTS F1592-CDD021 SCALE: NTS F1592-CGP203 SCALE: NTS F1592-CRP203 PACKAGE # DP-2 **SITEWORK AND UTILITIES** SCALE: RAWING No.: **CIVIL PERMIT RESUBMITTAL PUYALLUP STATION PARKING HENSEL PHELPS** H S. GUJULUVA RAJAN NTS F1592-CDD022 **CONTRACT RTA/CN 0612-18** Plan. Build. Manage. FILENAME: PUYALLUP STATION PARKING AND ACCESS FACILITY ID: M. VU S317-F1592-CDD022 CONTRACT No .:

CHECKED BY: 1/11/21 SGR JGM JGM REVISIONS FOR CITY PERMIT 0504 J. MATTHEWS SGR JGM JGM ISSUED FOR CONSTRUCTION APPROVED BY: J. MATTHEWS

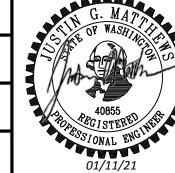



SARA ROBERTS



12/04/2020

REVIEWED BY:

GREG SHIMIZU

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FULL SCALE	SoundTransit

12/04/2020


RTA/CN 0612-18


SUBMITTAL DATE:

12/04/2020

IMPROVEMENTS

CIVIL DRAINAGE DETAILS F1592 27/81

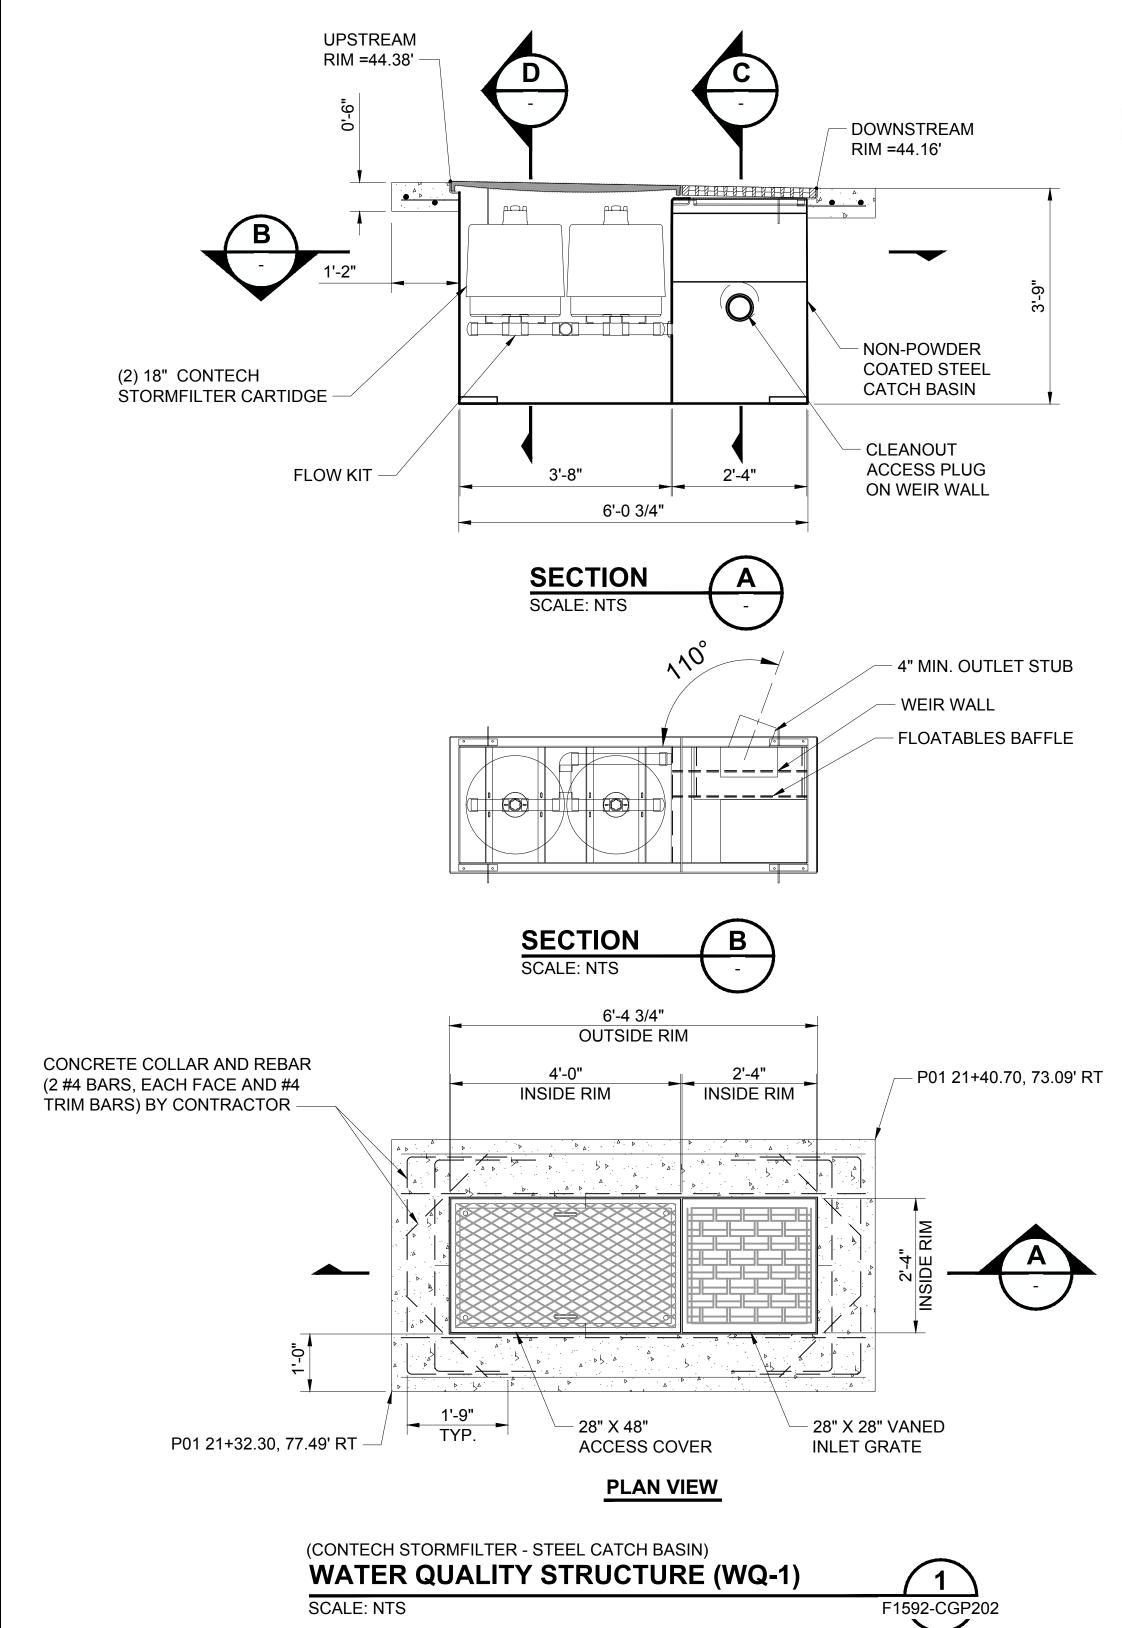

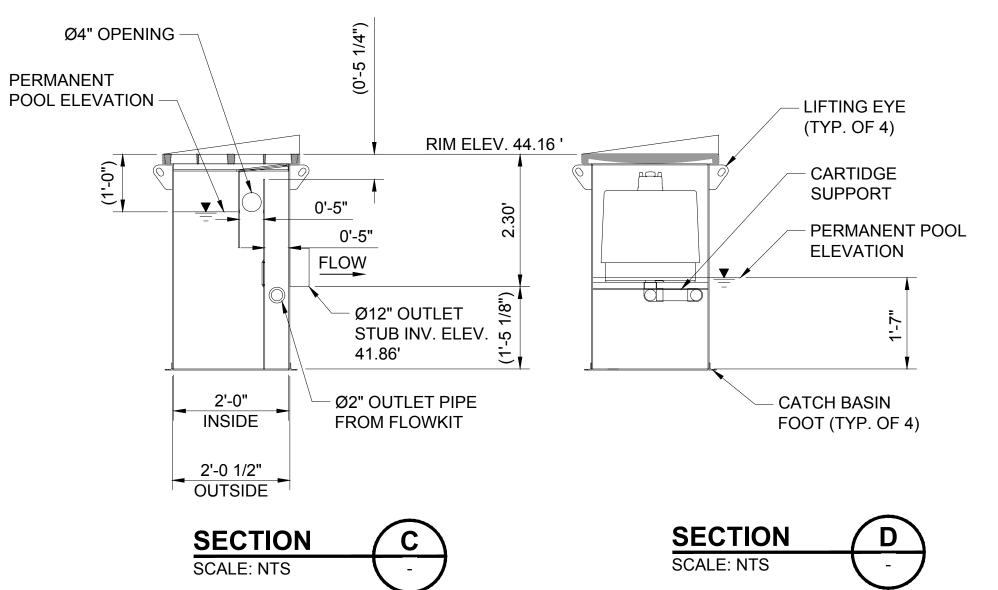

MATERIAL LIST PROVIDED BY CONTECH								
COUNT	DESCRIPTION	INSTALLED BY						
2	18" 7.5 GPM, ZPG CARTRIDGE (BLU)	CONTECH						
1	FLOW KIT	CONTECH						
1	NON-POWDER COATED STEEL CATCH BASIN	CONTECH						
1	28" X 28" VANED INLET COVER	CONTRACTOR						
1	28" X 48" ACCESS COVER	CONTRACTOR						

NOTES:

- CONTECH TO PROVIDE ALL MATERIALS UNLESS NOTED OTHERWISE.
 FOR FABRICATION DRAWINGS WITH DETAILED STRUCTURE DIMENSION
- 2. FOR FABRICATION DRAWINGS WITH DETAILED STRUCTURE DIMENSIONS AND WEIGHTS, PLEASE CONTACT YOUR CONTECH ENGINEERED SOLUTIONS REPRESENTATIVE. WWW.CONTECHES.COM
- STORMFILTER WATER QUALITY STRUCTURE SHALL BE IN ACCORDANCE WITH ALL DESIGN DATA AND INFORMATION CONTAINED IN THIS DRAWING. CONTRACTOR TO CONFIRM STRUCTURE MEETS REQUIREMENTS OF PROJECT.
- 4. STRUCTURE SHALL MEET AASHTO HS20 LOAD RATING, ASSUMING EARTH COVER OF 0' 5' AND GROUNDWATER ELEVATION AT, OR BELOW, THE OUTLET PIPE INVERT ELEVATION. ENGINEER OF RECORD TO CONFIRM ACTUAL GROUNDWATER ELEVATION. CASTINGS SHALL MEET AASHTO M306 AND BE CAST WITH THE CONTECH LOGO.
- STEEL STRUCTURE TO BE MANUFACTURED OF 1/4 INCH STEEL PLATE. CASTINGS SHALL MEET AASHTO HS20 LOAD RATING. FOR HS20 LOAD RATING ON STRUCTURE, CONCRETE COLLAR IS REQUIRED AND TO BE PROVIDED BY CONTRACTOR.
- 6. MANUFACTURER TO APPLY A SURFACE BEAD WELD IN THE SHAPE OF THE LETTER "O" ABOVE THE OUTLET PIPE STUB ON THE EXTERIOR SURFACE OF THE STEEL SFCB.
- CONTRACTOR TO TAKE APPROPRIATE MEASURES TO PROTECT CARTRIDGES FROM CONSTRUCTION-RELATED EROSION RUNOFF.

APPROVED

BY CITY OF PUYALLUP
DEVELOPMENT SERVICES

DATE 2/17/2021


NOTE: THIS APPROVAL IS VOID AFTER 180 DAYS FROM APPROVAL DATE.

THE CITY WILL NOT BE RESPONSIBLE FOR ERRORS AND/ OR OMISSIONS ON THESE PLANS.

FIELD CONDITIONS MAY DICTATE CHANGES TO THESE PLANS AS DETERMINED BY THE ENGINEERING SERVICES MANAGER.

	<u> </u>				AIT DECLIDAMITTAL	DESIGNED BY:	
(IVIL	_		KI	IIT RESUBMITTAL	S. GUJULUVA RAJAN DRAWN BY:	3
						M. VU	
						CHECKED BY:	
						E. MENDEL	2
0	12/04/20	SGR	JGM	JGM	ISSUED FOR CONSTRUCTION	APPROVED BY:	

DSN CHK APP REVISION

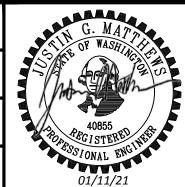

J. MATTHEWS





12/04/2020

REVIEWED BY:

GREG SHIMIZU



PACKAGE #

12/04/2020

| SCALE:
| NTS |
| FILENAME:
| S317-F1592-CDD023 |
| CONTRACT No.:
| RTA/CN 0612-18 |
| DATE: | SUBMITTAL DATE:

DP-2

12/04/2020

SITE DATA

WATER QUALITY FLOW RATE

PEAK FLOW RATE

RETURN PERIOD OF PEAK FLOW

FILTER MEDIA TYPE

CARTRIDGE FLOWRATE

0.02 CFS

ZPG

7.5GPM

PUYALLUP STATION PARKING CONTRACT RTA/CN 0612-18

SITEWORK AND UTILITIES


PUYALLUP STATION PARKING AND ACCESS
IMPROVEMENTS


CIVIL DRAINAGE DETAILS F1592-CDD023


RAWING No.:

F1592
SHEET No.: REV:
28/81

12/29/20 | 2:56 PM | MICHAELV

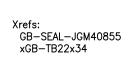

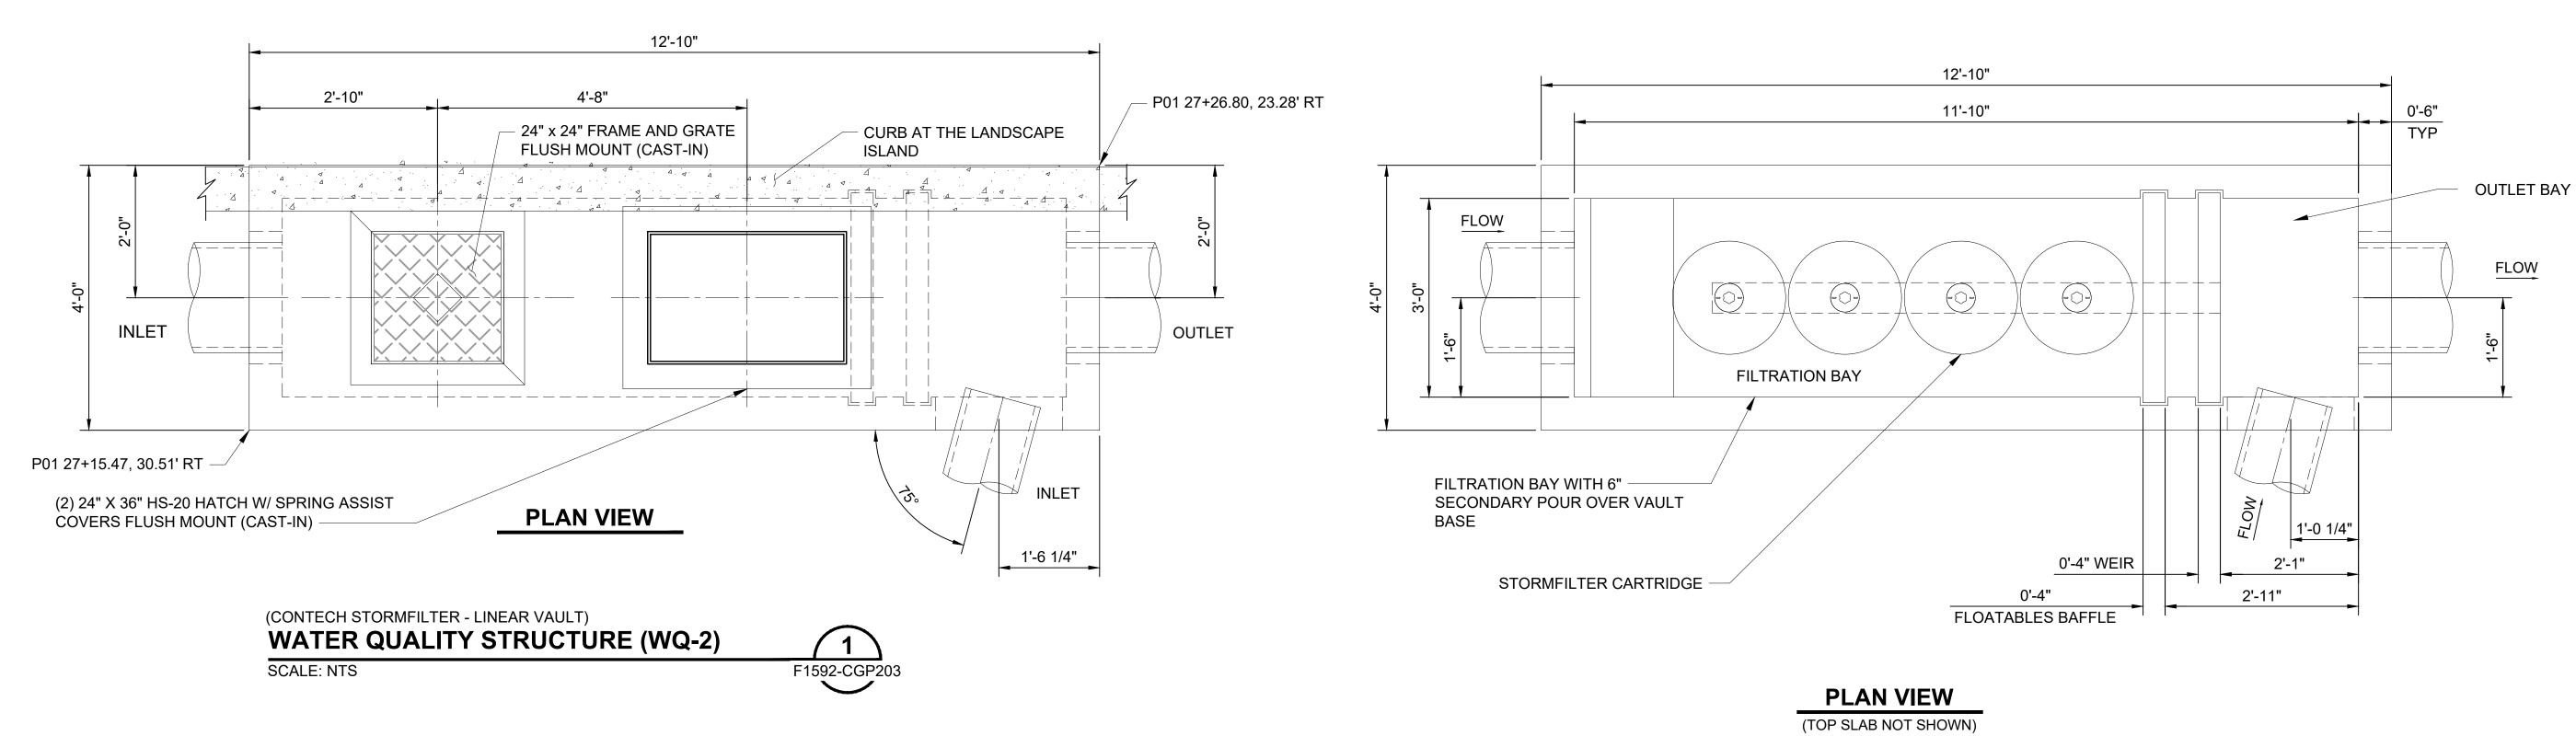

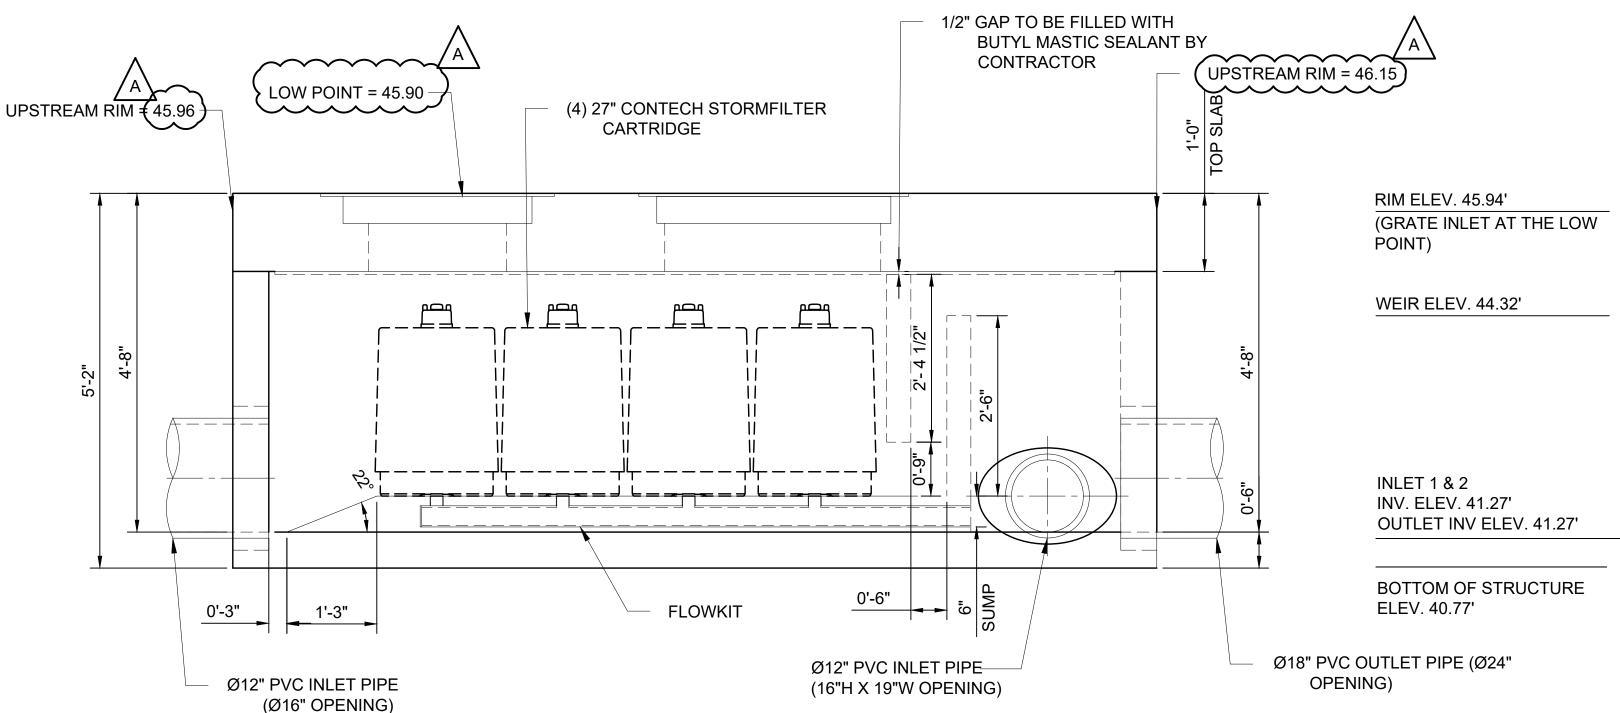

SITE DATA	
WATER QUALITY FLOW RATE	0.09 CFS
PEAK FLOW RATE	-
RETURN PERIOD OF PEAK FLOW	-
FILTER MEDIA TYPE	ZPG
CARTRIDGE FLOWRATE	11.3 GPM

ELEVATION VIEW

MATERIAL LIST PROVIDED BY CONTECH COUNT **INSTALLED BY DESCRIPTION** 27", 7.50 GPM, ZPG CARTRIDGE (BLU) CONTECH FLOW KIT (LN4) CONTECH JOINT SEALANT (BY PRECASTER) CONTRACTOR 24"X36"X5" HS-20 HATHC, EJ CONTECH #00821221B02 (CAST IN)

NOTES:

- 1. CONTECH TO PROVIDE ALL MATERIALS UNLESS NOTED OTHERWISE. 2. FOR FABRICATION DRAWINGS WITH DETAILED STRUCTURE DIMENSIONS
- AND WEIGHTS, PLEASE CONTACT YOUR CONTECH ENGINEERED SOLUTIONS LLC REPRESENTATIVE. WWW.CONTECHES.COM
- 3. STORMFILTER WATER QUALITY STRUCTURE SHALL BE IN ACCORDANCE WITH ALL DESIGN DATA AND INFORMATION CONTAINED IN THIS DRAWING. CONTRACTOR TO CONFIRM STRUCTURE MEETS REQUIREMENTS OF PROJECT.
- 4. STRUCTURE SHALL MEET AASHTO HS-20 LOAD RATING, ASSUMING GROUNDWATER ELEVATION AT, OR BELOW, THE OUTLET PIPE INVERT ELEVATION. ENGINEER OF RECORD TO CONFIRM ACTUAL GROUNDWATER ELEVATION. CASTINGS SHALL MEET AASHTO M306 AND BE CAST WITH THE CONTECH LOGO
- 5. STORMFILTER STRUCTURE SHALL BE PRECAST CONCRETE CONFORMING WITH ASTM C-857, ASTM C-918 AND ACI-318 LOAD FACTOR DESIGN METHOD.
- 6. CONTRACTOR TO TAKE APPROPRIATE MEASURES TO PROTECT CARTRIDGES FROM CONSTRUCTION-RELATED EROSION RUNOFF.

	ENGINEERING SERVICES MANAGER.	
PACKAGE#	DP-2	SITEWORK AND UTILITIES

APPROVED

Berkey

CITY OF PUYALLUP

DEVELOPMENT SERVICES

NOTE: THIS APPROVAL IS VOID

AFTER 180 DAYS FROM APPROVAL

RESPONSIBLE FOR ERRORS AND/ OR OMISSIONS ON THESE PLANS.

FIELD CONDITIONS MAY DICTATE CHANGES TO THESE PLANS AS

DATE 2/17/2021

THE CITY WILL NOT BE

DETERMINED BY THE

SUBMITTAL DATE:

12/04/2020

(CIVIL	_ F	PE	RI	MIT RESUBMITTAL	DESIGNED BY: S. GUJULUVA RAJAN DRAWN BY:	
						M. VU	
						CHECKED BY:	
	1/11/21	SGR	JGM	JGM	REVISIONS FOR CITY PERMIT 0504	J. MATTHEWS	1
	12/04/20	SGR	JGM	JGM	ISSUED FOR CONSTRUCTION	APPROVED BY:	l '
	DATE	DSN	CHK	APP	REVISION	J. MATTHEWS	





SARA ROBERTS



12/04/2020

REVIEWED BY:

GREG SHIMIZU



DATE:

12/04/2020

ILENAME: S317-F1592-CDD024 SoundTransit CONTRACT No.: RTA/CN 0612-18

PUYALLUP STATION PARKING CONTRACT RTA/CN 0612-18


PUYALLUP STATION PARKING AND ACCESS **IMPROVEMENTS**

> CIVIL DRAINAGE DETAILS

FACILITY ID: F1592 29/81


F1592-CDD024

DRAWING No.:

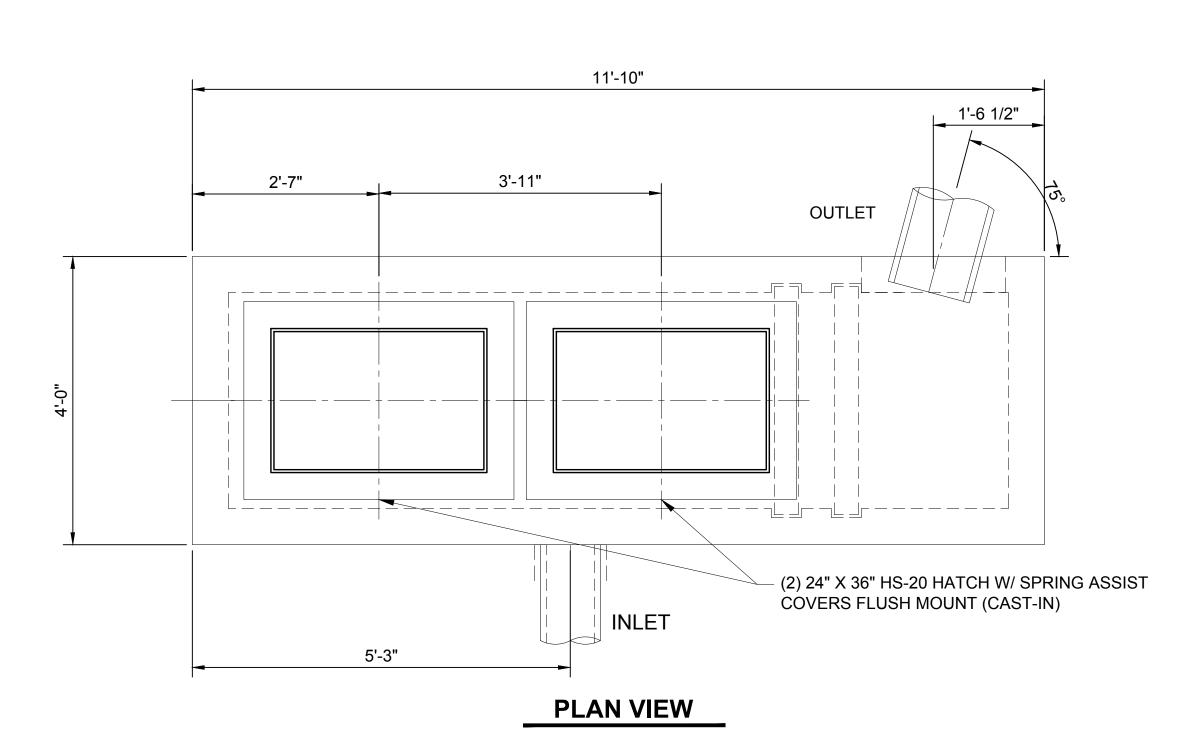


(CONTECH STORMFILTER - LINEAR VAULT)

WATER QUALITY STRUCTURE (WQ-3) F1592-CGP203 SCALE: NTS

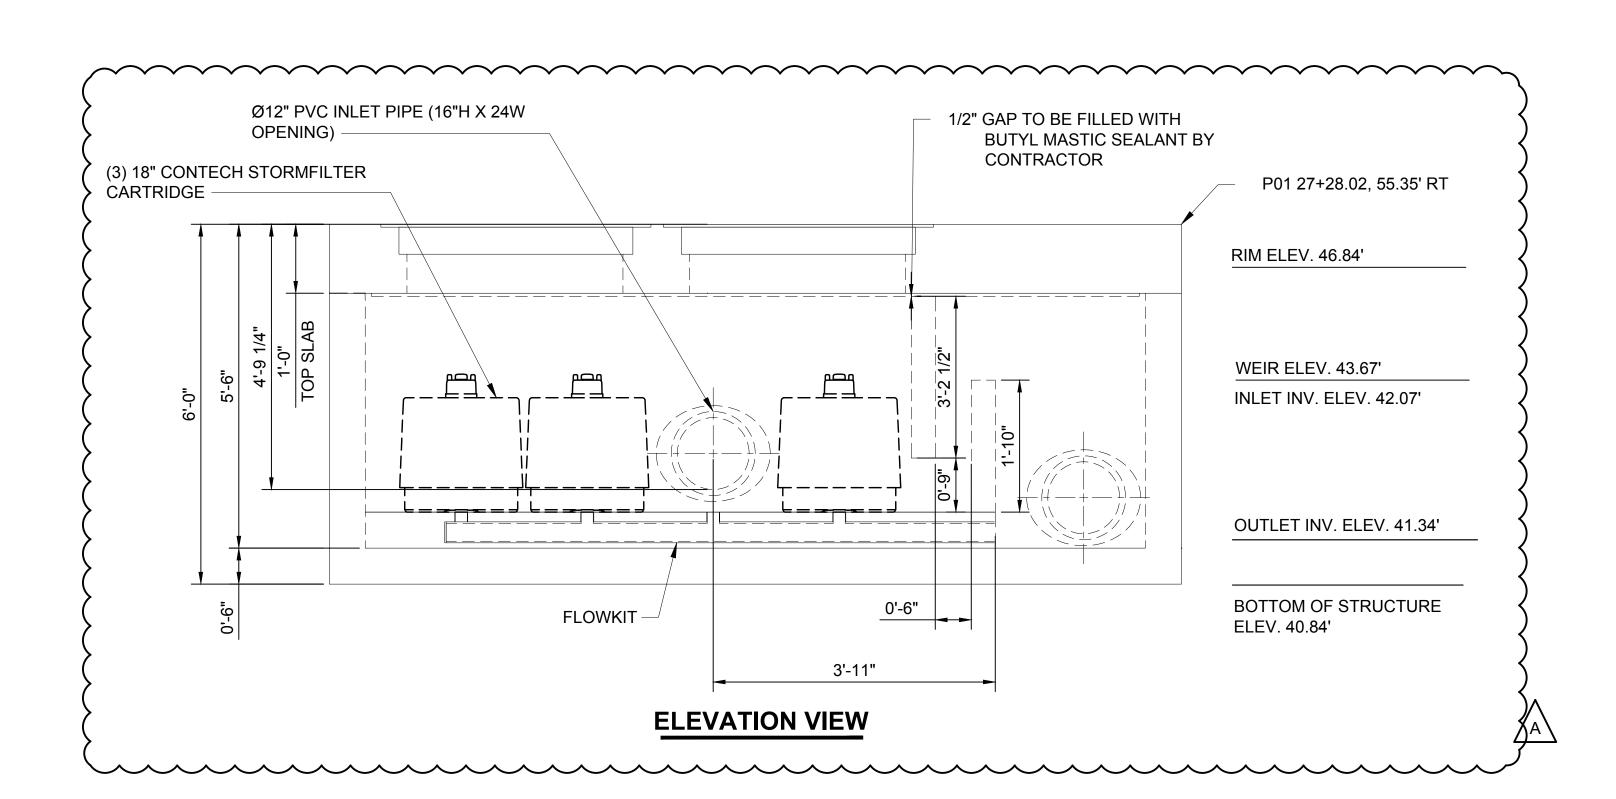

J. MATTHEWS

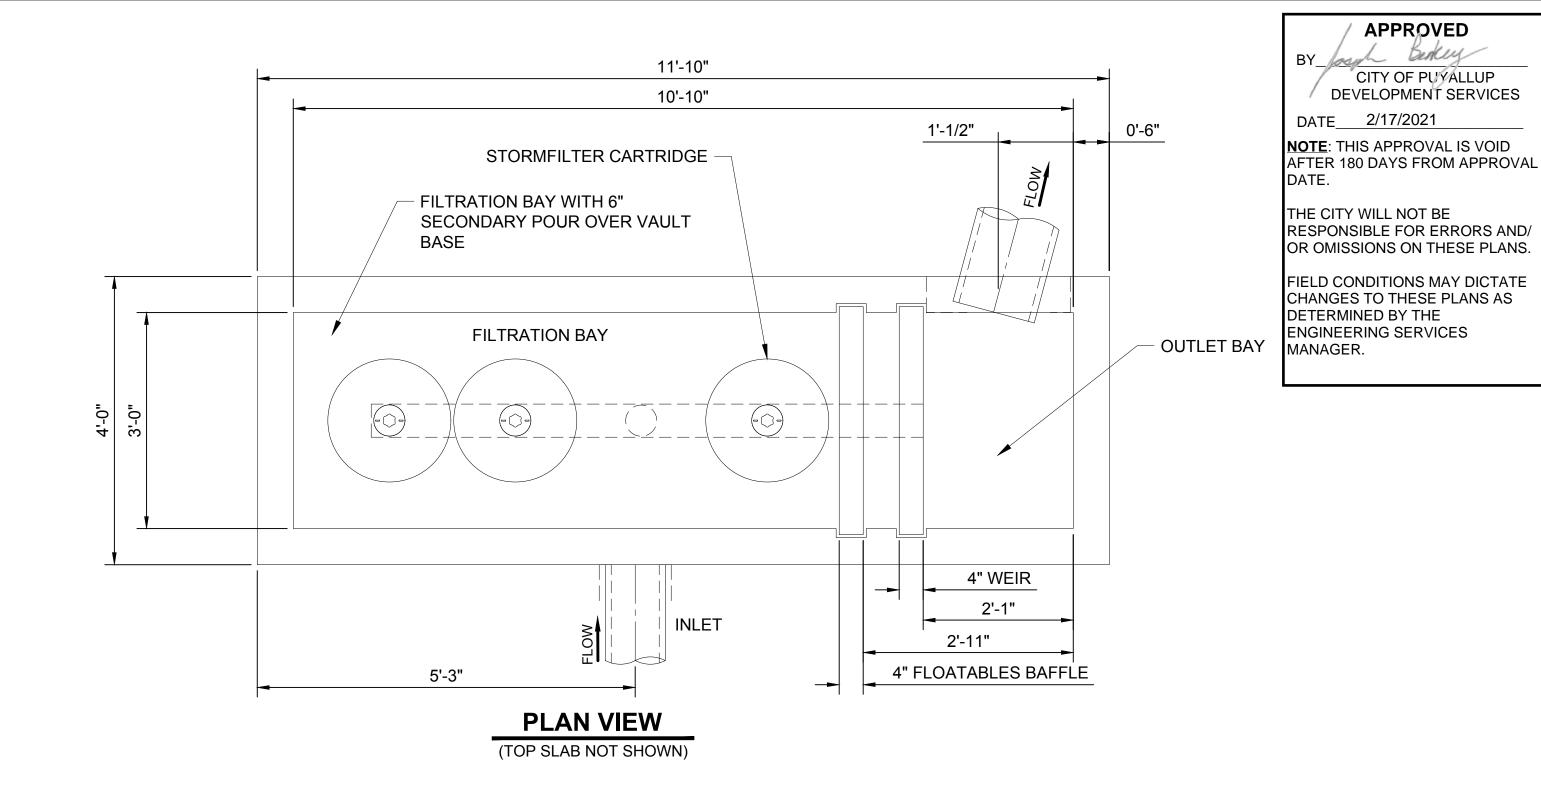

MATERIAL LIST PROVIDED BY CONTECH									
COUNT	DESCRIPTION	INSTALLED BY							
3	18", 7.50 GPM, ZPG CARTRIDGE (BLU)	CONTECH							
1	2"Ø PVC SLIP PLUG	CONTECH							
1	FLOW KIT (LN4)	CONTECH							
1	JOINT SEALANT (BY PRECASTER)	CONTRACTOR							
2	24"X36"X5" HS-20 HATHC, EJ #00821221B02 (CAST IN)	CONTECH							


SITE DATA	
WATER QUALITY FLOW RATE	0.04 CFS
PEAK FLOW RATE	-
RETURN PERIOD OF PEAK FLOW	-
FILTER MEDIA TYPE	ZPG
CARTRIDGE FLOWRATE	7.5 GPM

NOTES:

- 1. CONTECH TO PROVIDE ALL MATERIALS UNLESS NOTED OTHERWISE. 2. FOR FABRICATION DRAWINGS WITH DETAILED STRUCTURE DIMENSIONS AND WEIGHTS, PLEASE CONTACT YOUR CONTECH ENGINEERED SOLUTIONS LLC REPRESENTATIVE. www.ContechES.com
- 3. STORMFILTER WATER QUALITY STRUCTURE SHALL BE IN ACCORDANCE WITH ALL DESIGN DATA AND INFORMATION CONTAINED IN THIS DRAWING. CONTRACTOR TO CONFIRM STRUCTURE MEETS REQUIREMENTS OF PROJECT.
- 4. STRUCTURE SHALL MEET AASHTO HS-20 LOAD RATING, ASSUMING GROUNDWATER ELEVATION AT, OR BELOW, THE OUTLET PIPE INVERT ELEVATION. ENGINEER OF RECORD TO CONFIRM ACTUAL GROUNDWATER ELEVATION. CASTINGS SHALL MEET AASHTO M306 AND BE CAST WITH THE CONTECH LOGO
- 5. STORMFILTER STRUCTURE SHALL BE PRECAST CONCRETE CONFORMING WITH ASTM C-857, ASTM C-918 AND ACI-318 LOAD FACTOR DESIGN
- 6. CONTRACTOR TO TAKE APPROPRIATE MEASURES TO PROTECT CARTRIDGES FROM CONSTRUCTION-RELATED EROSION RUNOFF.

CIVIL PERMIT RESUBMITTAL						DESIGNED BY: S. GUJULUVA RAJAN DRAWN BY:	
						M. VU	
						CHECKED BY:	
Α	1/11/21	SGR	JGM	JGM	REVISIONS FOR CITY PERMIT 0504	J. MATTHEWS	
0	12/04/20	SGR	JGM	JGM	ISSUED FOR CONSTRUCTION	APPROVED BY:	

DSN CHK APP REVISION

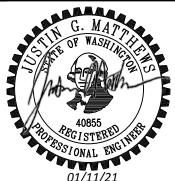




SARA ROBERTS



12/04/2020

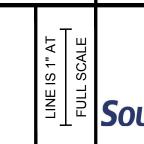

NTS FILENAME: S317-F1592-CDD025 SOUNDTRANSIT CONTRACT No.: RTA/CN 0612-18 SUBMITTAL DATE:

DP-2

SITEWORK AND UTILITIES **PUYALLUP STATION PARKING** CONTRACT RTA/CN 0612-18

PUYALLUP STATION PARKING AND ACCESS **IMPROVEMENTS**

CIVIL

F1592-CDD025 FACILITY ID:

RAWING No.:

APPROVED

CITY OF PUYALLUP DEVELOPMENT SERVICES

> F1592 30/81


HENSEL PHELPS Plan. Build. Manage.

> REVIEWED BY: **GREG SHIMIZU**

DATE: 12/04/2020 12/04/2020

PACKAGE #


DRAINAGE DETAILS

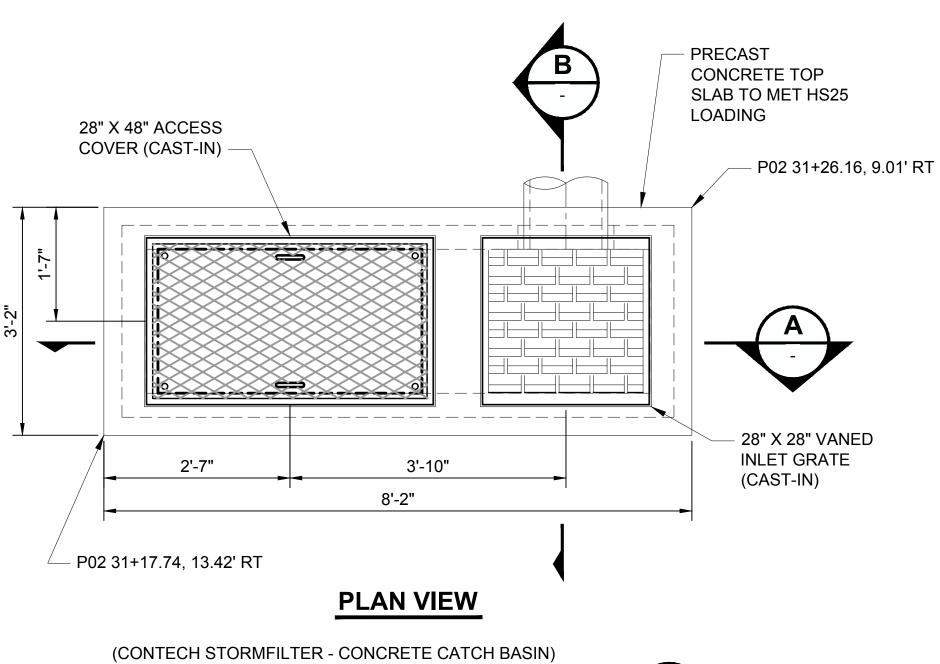


F1592-CGP203

WATER QUALITY STRUCTURE (WQ-4)

SCALE: NTS

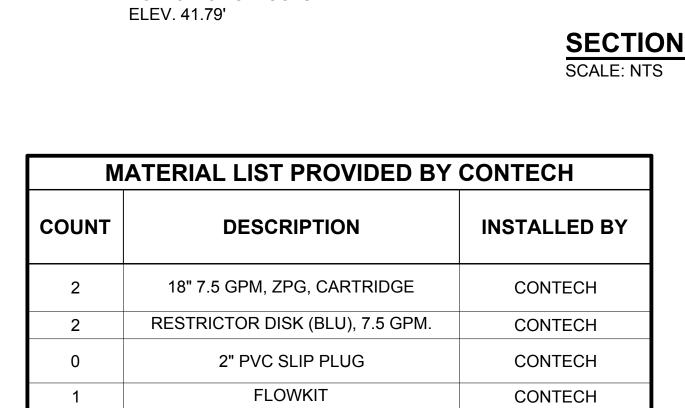

SITE DATA						
WATER QUALITY FLOW RATE	0.02 CFS					
PEAK FLOW RATE	-					
RETURN PERIOD OF PEAK FLOW	-					
FILTER MEDIA TYPE	ZPG					
CARTRIDGE FLOWRATE	7.5GPM					

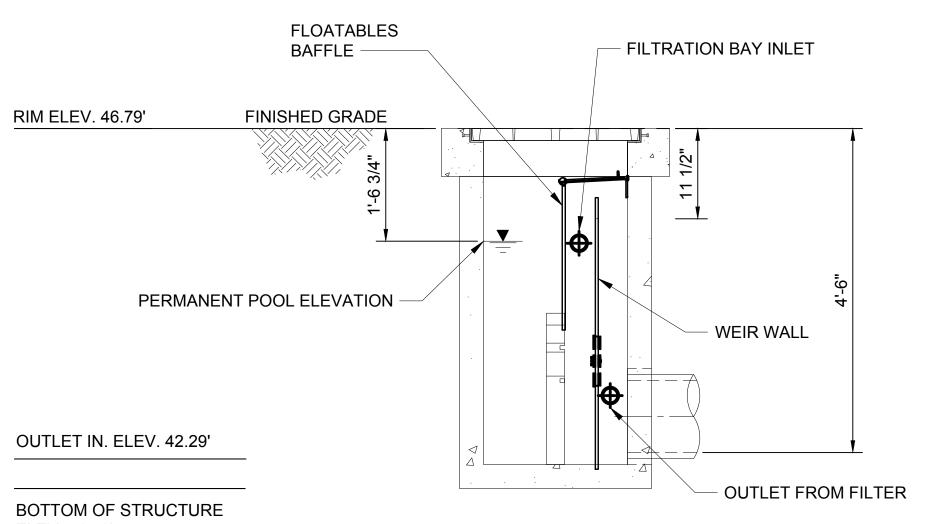


М	ATERIAL LIST PROVIDED BY	CONTECH
COUNT	DESCRIPTION	INSTALLED BY
2	18" 7.5 GPM, ZPG, CARTRIDGE	CONTECH
2	RESTRICTOR DISK (BLU), 7.5 GPM.	CONTECH
0	2" PVC SLIP PLUG	CONTECH
1	FLOWKIT	CONTECH
1	Ø8" CLEAN OUT ACCESS PLUG	CONTECH
1	FLOATABLES BAFFLE	CONTECH
1	WEIR WALL	CONTECH
1	27 3/4" X 27 3/4" FRAME AND VANED GRATE D&L I1364	CONTRACTOR
1	28" X 28" FRAME AND COVER D&L L-1364	CONTRACTOR
4	25 1/4" X 2" X 11 1/4" CARTRIDGE SUPPORT (2 PER)	CONTECH
1	JOINT SEALANT	CONTRACTOR

3

1. CONTECH TO PROVIDE ALL MATERIALS UNLESS NOTED OTHERWISE.

- 2. FOR FABRICATION DRAWINGS WITH DETAILED STRUCTURE DIMENSIONS AND WEIGHTS, PLEASE CONTACT YOUR CONTECH ENGINEERED SOLUTIONS LLC REPRESENTATIVE. www.ContechES.com
- 3. STORMFILTER WATER QUALITY STRUCTURE SHALL BE IN ACCORDANCE WITH ALL DESIGN DATA AND INFORMATION CONTAINED IN THIS DRAWING. CONTRACTOR TO CONFIRM STRUCTURE MEETS REQUIREMENTS OF PROJECT.
- 4. STRUCTURE SHALL MEET AASHTO HS25 LOAD RATING, ASSUMING EARTH COVER OF 0'-5' AND GROUNDWATER ELEVATION AT, OR BELOW, THE OUTLET PIPE INVERT ELEVATION. ENGINEER OF RECORD TO CONFIRM ACTUAL GROUNDWATER ELEVATION. CASTINGS SHALL MEET AASHTO M306 AND BE CAST WITH THE CONTECH LOGO.
- 5. STORMFILTER STRUCTURE SHALL BE PRECAST CONCRETE CONFORMING WITH ASTM C-857 AND AASHTO LOAD FACTOR DESIGN METHOD.
- 6. MATCH OUTLET PIPE INVERT WITH OUTLET BAY FLOOR.
- 7. CONTRACTOR TO TAKE APPROPRIATE MEASURES TO PROTECT CARTRIDGES FROM CONSTRUCTION-RELATED EROSION RUNOFF.

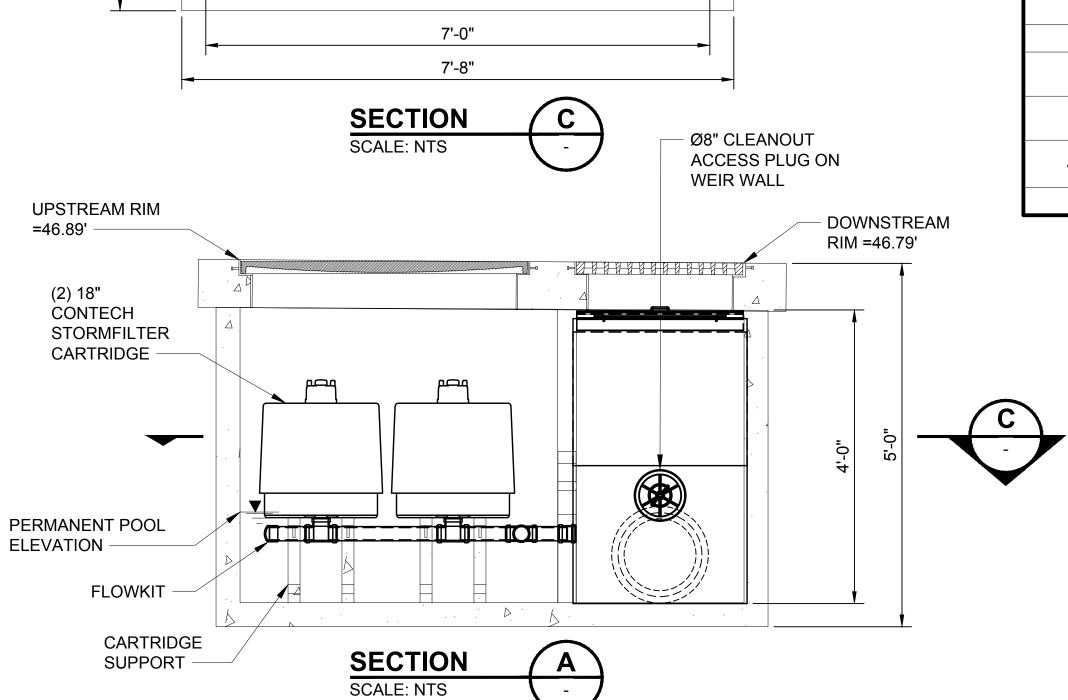

CIVIL PERMIT RESUBMITTAL S. GUJULUVA RAJAN M. VU CHECKED BY: J. MATTHEWS SGR JGM JGM ISSUED FOR CONSTRUCTION APPROVED BY: 12/04/20 J. MATTHEWS





SARA ROBERTS



12/04/2020



REVIEWED BY:

GREG SHIMIZU

PACKAGE #

12/04/2020

FILENAME: S317-F1592-CDD026 SoundTransit CONTRACT No.: RTA/CN 0612-18 DATE: SUBMITTAL DATE:

DP-2

12/04/2020

SITEWORK AND UTILITIES **PUYALLUP STATION PARKING**

PUYALLUP STATION PARKING AND ACCESS

CIVIL DRAINAGE DETAILS

RAWING No.: F1592-CDD026

APPROVED

DATE_ 2/17/2021

THE CITY WILL NOT BE

DETERMINED BY THE

MANAGER.

ENGINEERING SERVICES

NOTE: THIS APPROVAL IS VOID AFTER 180 DAYS FROM APPROVAL

RESPONSIBLE FOR ERRORS AND/ OR OMISSIONS ON THESE PLANS.


FIELD CONDITIONS MAY DICTATE CHANGES TO THESE PLANS AS


Berkey CITY OF PUYALLUP DEVELOPMENT SERVICES


> F1592 31/81

FACILITY ID:

CONTRACT RTA/CN 0612-18 **IMPROVEMENTS**

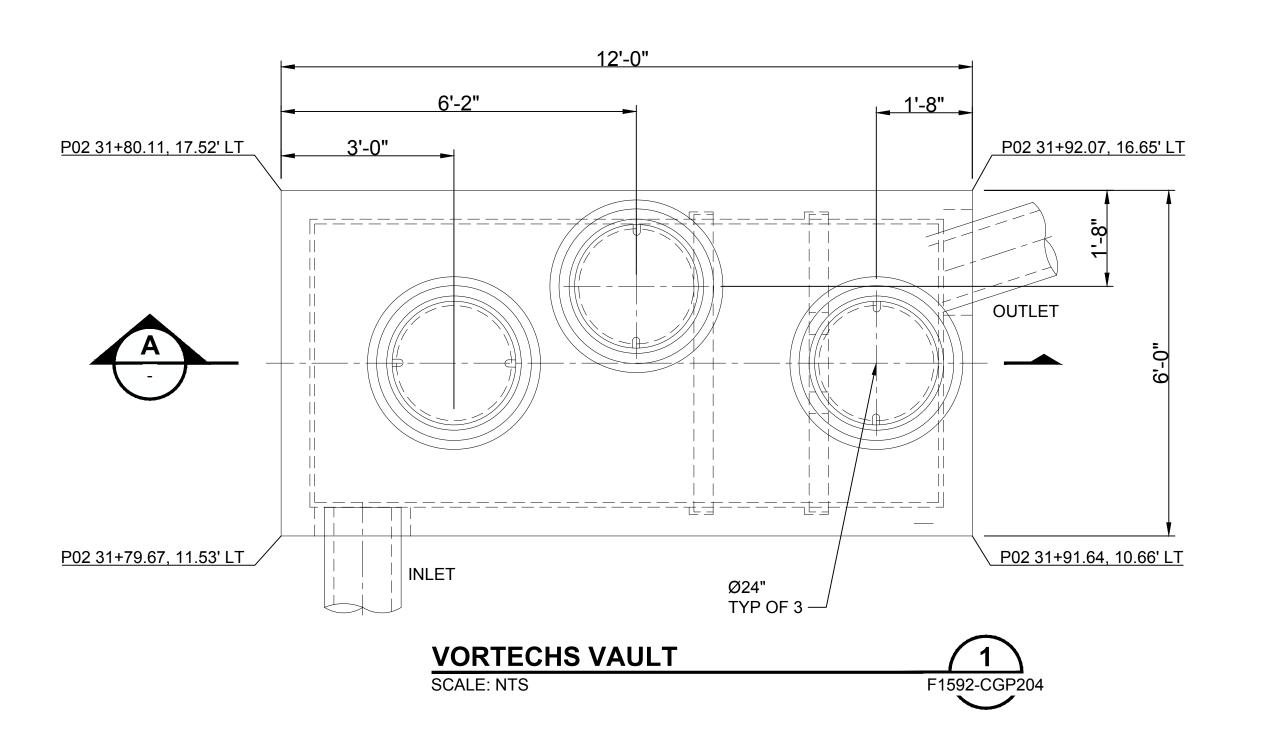

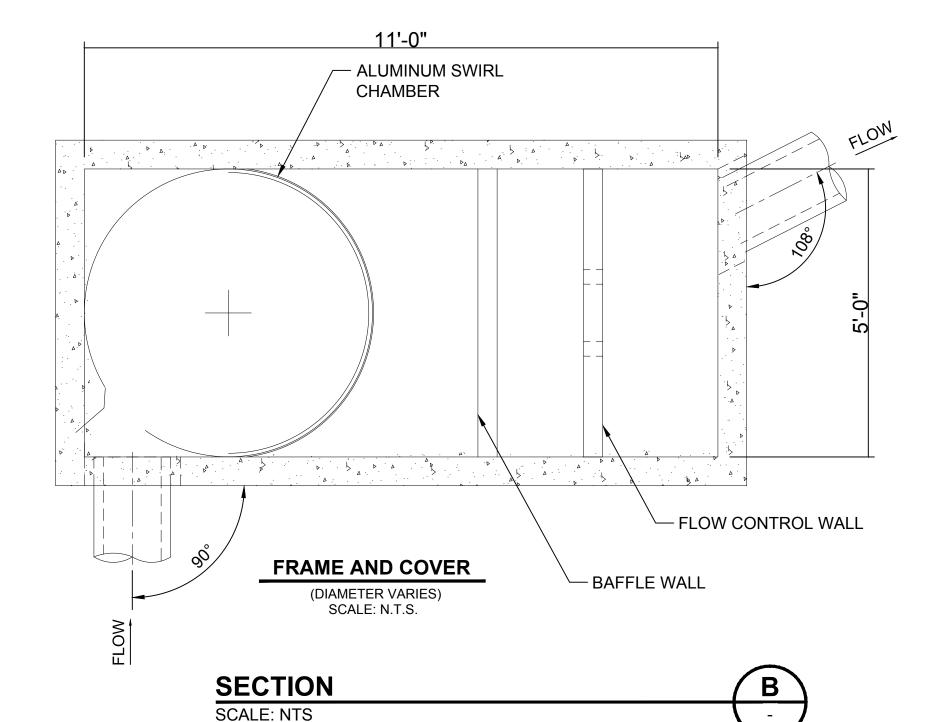

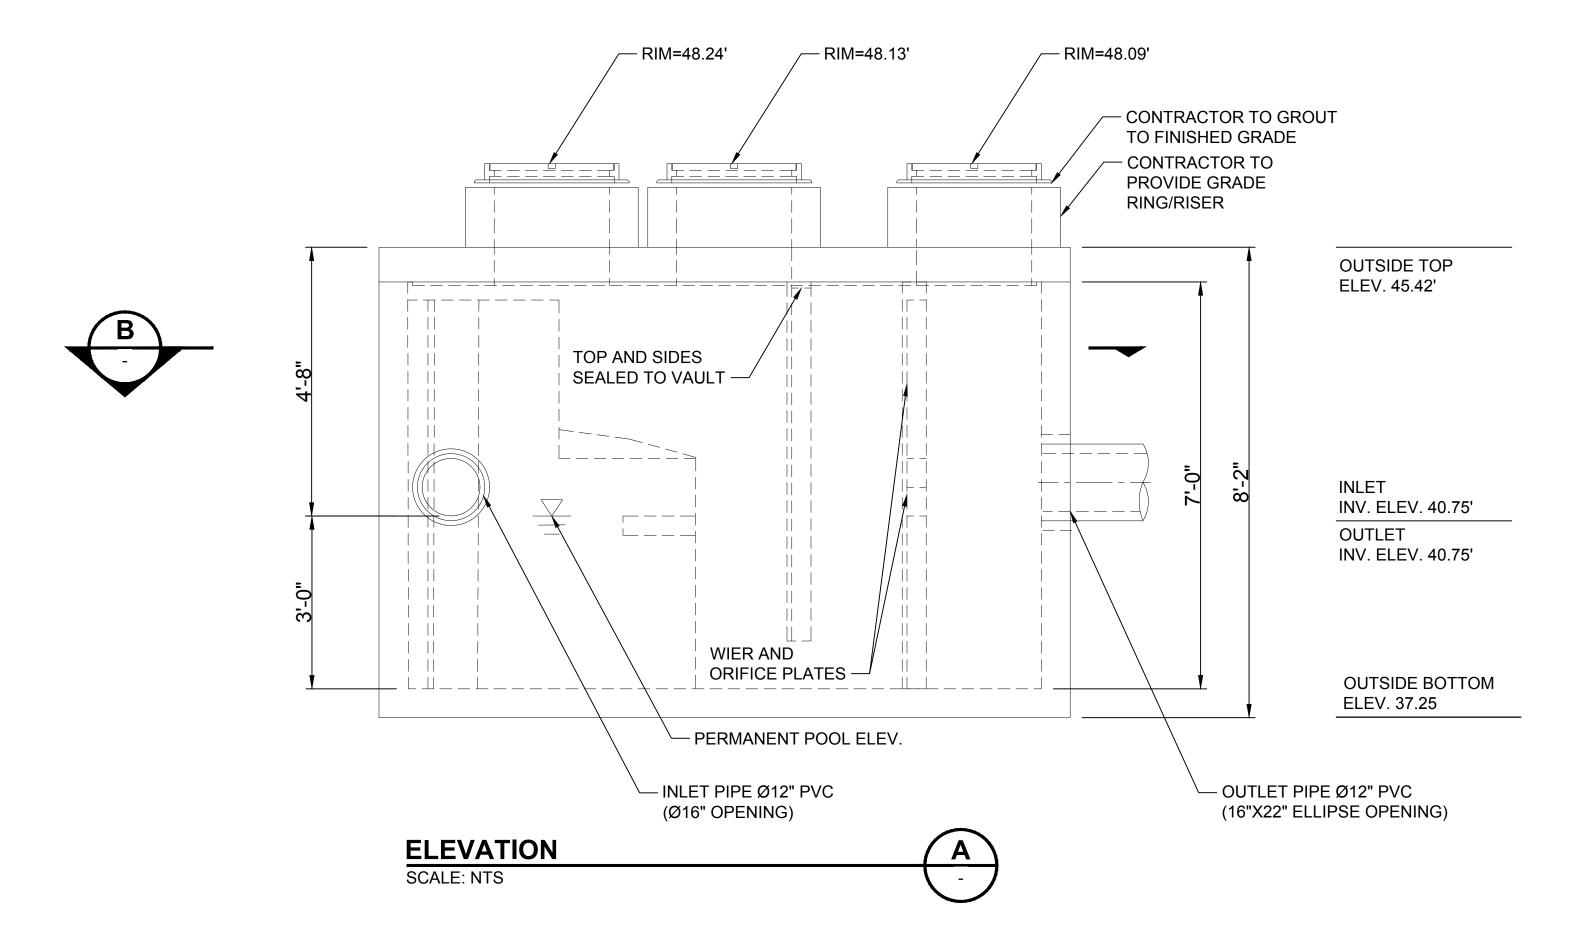

NOTES:

- 1. CONTECH TO PROVIDE ALL MATERIALS UNLESS NOTED OTHERWISE.
- 2. FOR FABRICATION DRAWINGS WITH DETAILED STRUCTURE DIMENSIONS AND WEIGHTS, PLEASE CONTACT YOUR CONTECH ENGINEERED SOLUTIONS LLC REPRESENTATIVE. www.ContechES.com
- 3. VORTECHS WATER QUALITY VAULT SHALL BE IN ACCORDANCE WITH ALL DESIGN DATA AND INFORMATION CONTAINED IN THIS DRAWING. CONTRACTOR TO CONFIRM THAT STRUCTURE MEETS REQUIREMENTS OF
- 4. STRUCTURE SHALL MEET HS-20 LOAD RATING ASSUMING EARTH COVER OF 0'-5', AND GROUNDWATER ELEVATION AT OR BELOW 3'-0" ABOVE STRUCTURE INVERT. ENGINEER OF RECORD TO PROVIDE ACTUAL GROUNDWATER ELEVATION. CASTINGS SHALL MEET AASHTO M306 LOAD RATING AND BE CAST WITH THE CONTECH LOGO.
- 5. WATER SURFACE ELEVATION IN THE VORTECHS STRUCTURE IS EXPECTED TO BE AT OR BELOW TOP OF FLOW CONTROL WALL DURING THE DESIGN
- 6. CONTRACTOR TO PROVIDE, INSTALL, AND GROUT PIPES. INLET PIPE TO BE SET 90° TO STRUCTURE WALL. MATCH PIPE INVERTS WITH ELEVATIONS
- SHOWN. ALL PIPE CENTERLINES TO MATCH PIPE OPENING CENTERLINES. 7. CONTRACTOR TO PROVIDE ANY ETERNAL BYPASS STRUCTURE REQUIRED
- FOR OFFLINE LAYOUT UNLESS OTHERWISE SPECIFIED. 8. CONTRACTOR TO PROVIDE AND INSTALL MANHOLE RISERS, GRADE RINGS OR BLOCK REQUIRED BETWEEN THE TOP OF THE VORTECHS STRUCTURE AND BASE OF THE MANHOLE FRAMES.

MATERIAL LIST PROVIDED BY CONTECH						
COUNT	DESCRIPTION	INSTALLED BY				
1	ALUMINUM SWIRL CHAMBER	CONTECH				
1	SWIRL CHAMBER SEALANT	CONTECH				
1	ALUMINUM ORIFICE PLATE	CONTECH				
1	ALUMINUM WEIR PLATE	CONTECH				
1	BUTYL MASTIC JOINT SEALANT	CONTRACTOR				
3	Ø24" X 4" EJ #41500389 FRAME AND COVER, OR EQUIVALENT	CONTRACTOR				

APPROVED BY Joseph Berkey CITY OF PUYALLUP DEVELOPMENT SERVICES DATE_ 2/17/2021


NOTE: THIS APPROVAL IS VOID AFTER 180 DAYS FROM APPROVAL

THE CITY WILL NOT BE RESPONSIBLE FOR ERRORS AND/ OR OMISSIONS ON THESE PLANS.

FIELD CONDITIONS MAY DICTATE CHANGES TO THESE PLANS AS DETERMINED BY THE ENGINEERING SERVICES MANAGER.

NEW DRAWING

						DESIGNED BY:	
CIVIL PERMIT RESUBMITTAL					S. GUJULUVA RAJAN		
						DRAWN BY:	
						M. VU	
						CHECKED BY:	
						E. MENDEL	No.
0	12/04/20	SGR	JGM	JGM	ISSUED FOR CONSTRUCTION	APPROVED BY:	
	DATE	DSN	CHK	APP	REVISION	J. MATTHEWS	

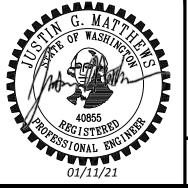





12/04/2020

REVIEWED BY:

GREG SHIMIZU

LINE IS 1" AT	FULL SCALE	Sound
		DATE:

12/04/2020

PACKAGE #

AS NOTED FILENAME: S317-F1592-CDD027 TRANSIT CONTRACT No.: RTA/CN 0612-18 SUBMITTAL DATE:

12/04/2020

DP-2

PUYALLUP STATION PARKING CONTRACT RTA/CN 0612-18


SITEWORK AND UTILITIES

PUYALLUP STATION PARKING AND ACCESS **IMPROVEMENTS**


CIVIL DRAINAGE DETAILS

RAWING No.: F1592-CDD027 FACILITY ID:

F1592 32/81

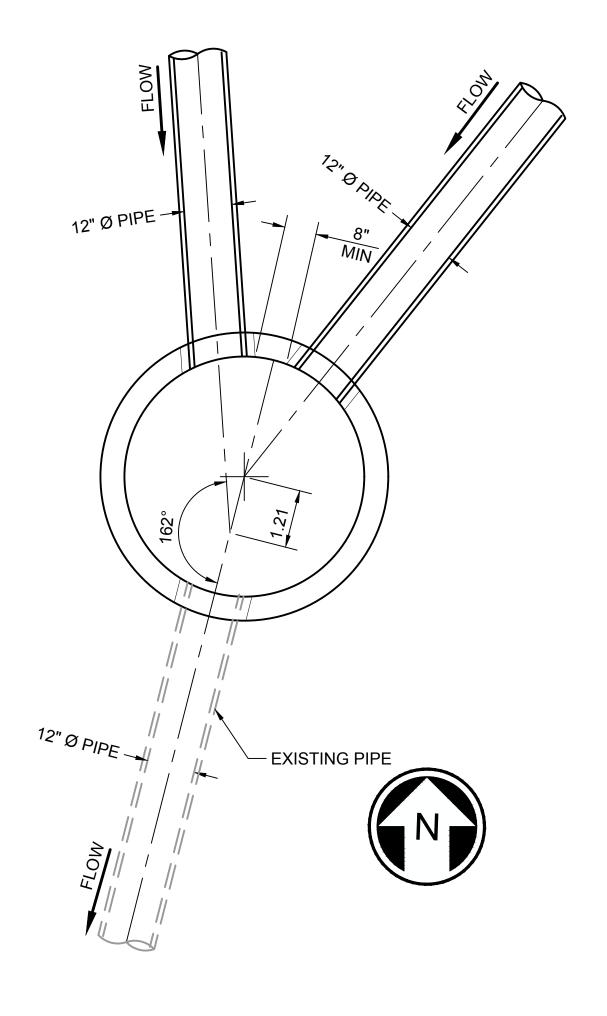

— EXISTING PIPE 16" Ø PIPE 🕌

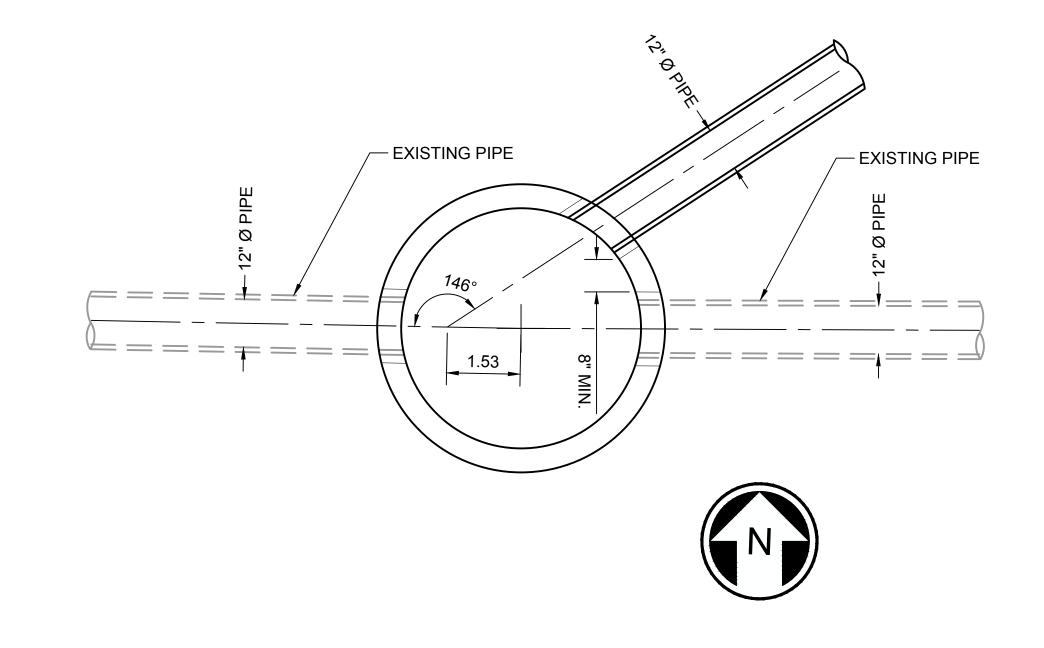

3RD AVE SDMH#1 60" TYPE-2

SCALE: NTS

DSN CHK APP REVISION



J. MATTHEWS

5TH AVE CB#8 60" TYPE-2

SCALE: NTS

F1592-CGP203

- EXISTING PIPE

EAST LOT SDMH#1 60" TYPE-2 SCALE: NTS

(3) F1592-CGP203

> APPROVED BY Joseph Berkey

CITY OF PUYALLUP DEVELOPMENT SERVICES

DATE 2/17/2021

NOTE: THIS APPROVAL IS VOID AFTER 180 DAYS FROM APPROVAL


THE CITY WILL NOT BE RESPONSIBLE FOR ERRORS AND/ OR OMISSIONS ON THESE PLANS.

FIELD CONDITIONS MAY DICTATE

CHANGES TO THESE PLANS AS DETERMINED BY THE ENGINEERING SERVICES MANAGER.

(CIVIL	DESIGNED BY: S. GUJULUVA RAJAN DRAWN BY:	3				
						M. VU	
						CHECKED BY:	1
						J. MATTHEWS	*
0	12/04/20	SGR	JGM	JGM	ISSUED FOR CONSTRUCTION	APPROVED BY:	



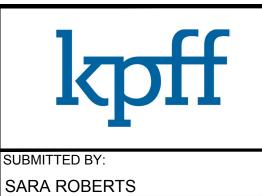



GREG SHIMIZU

12/04/2020

		PACKAGE#
LINE IS 1" AT	FULL SCALE	SoundTrans
	·	DATE:

12/04/2020

SITEWORK AND UTILITIES DP-2 AS NOTED S317-F1592-CDD028 ANSIT CONTRACT No.: RTA/CN 0612-18 SUBMITTAL DATE:

12/04/2020

PUYALLUP STATION PARKING CONTRACT RTA/CN 0612-18

PUYALLUP STATION PARKING AND ACCESS **IMPROVEMENTS**


> CIVIL DRAINAGE DETAILS

F1592-CDD028

DRAWING No.:


FACILITY ID:

F1592 33/81

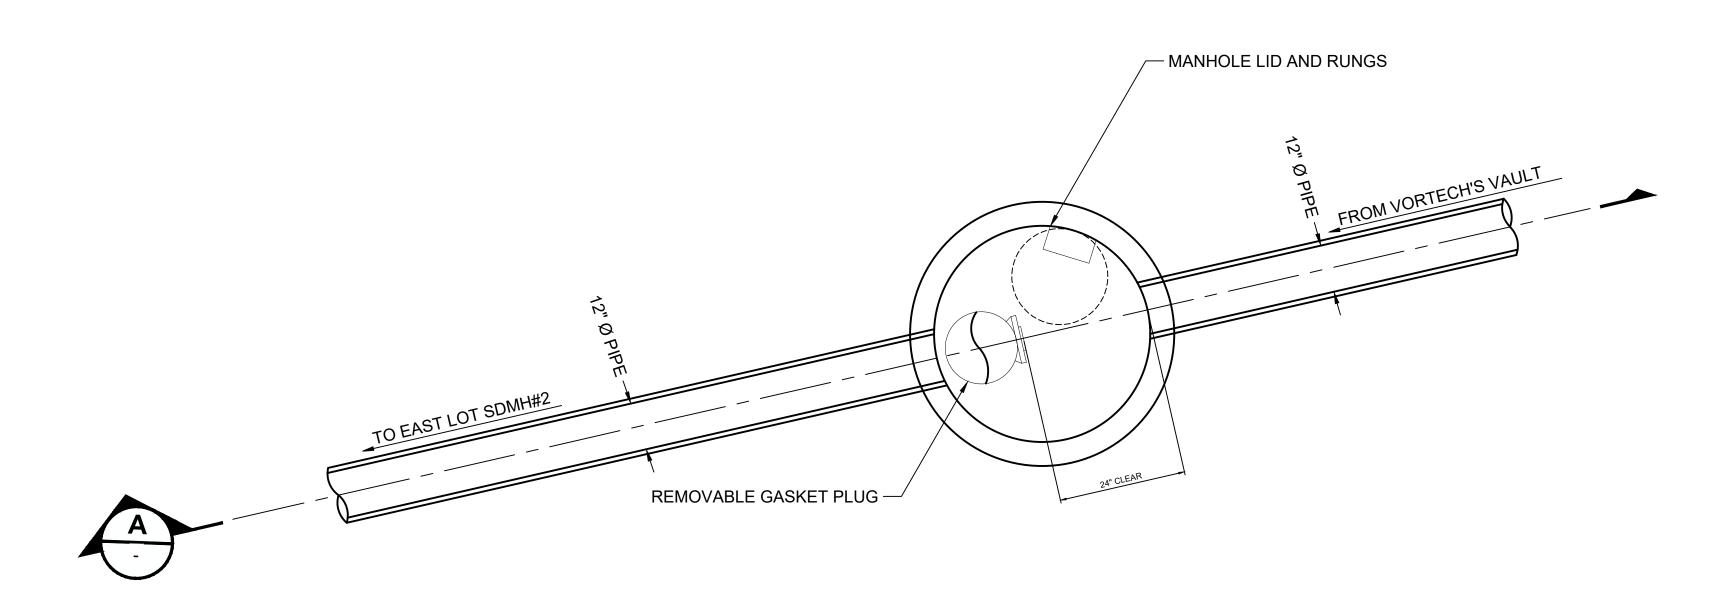


EAST LOT SDMH#5 54" DIA FLOW CONTROL MH W/ FLAT TOP SCALE: NTS F1592-CGP204

6" MIN. EARANCE ─ MANHOLE RING AND COVER - RIM= 47.83 _ 1 1/2" ASPHALT PATCH CAST IRON FRAME AND COVER 6" PVC SLEEVE PRECAST RISER SECTION EL=45.57 -EL=45.15 12-INCH PVC 8.46" ORIFICE OUTLET PIPE EL=44.25 -EAST OF LOT 6.3" DIA ORIFICE SDMH#2 IE = 40.70 — / 12-INCH PVC INLET PIPE FROM VORTECH'S VAULT _FLOW NON-SHRINK - MANHOLE COUPLING GROUT, TYP WITH RUBBER GASKET CONTROL DEVICE AND FITTINGS, SEE COP STD PLAN 02.01.07 REMOVABLE GASKETED END PLUG 18" STANDPIPE - MANHOLE RUNGS 2.7" DIA ORIFICE -**SECTION** SCALE: NTS

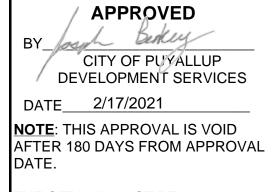

THE CITY WILL NOT BE RESPONSIBLE FOR ERRORS AND/ OR OMISSIONS ON THESE PLANS.

FIELD CONDITIONS MAY DICTATE CHANGES TO THESE PLANS AS DETERMINED BY THE ENGINEERING SERVICES MANAGER.

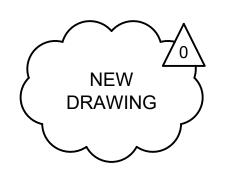

	<u> </u>				AIT DECLIDAMITTAL	DESIGNED BY:	
CIVIL PERMIT RESUBMITTAL						S. GUJULUVA RAJAN DRAWN BY:	
						M. VU	
						CHECKED BY:	
1	1/11/21	SGR	JGM	JGM	REVISIONS FOR CITY PERMIT 0504	J. MATTHEWS	%
)	12/04/20	SGR	JGM	JGM	ISSUED FOR CONSTRUCTION	APPROVED BY:	'



J. MATTHEWS



SARA ROBERTS



12/04/2020

REVIEWED BY:

GREG SHIMIZU

LINE IS 1" AT	FULL SCALE	Sou
		DATE:

FILENAME: S317-F1592-CDD029 OUNDTRANSIT CONTRACT No.: SUBMITTAL DATE:

DP-2

PUYALLUP STATION PARKING CONTRACT RTA/CN 0612-18

SITEWORK AND UTILITIES

PUYALLUP STATION PARKING AND ACCESS **IMPROVEMENTS**

CIVIL

DRAWING No.: F1592-CDD029 FACILITY ID:


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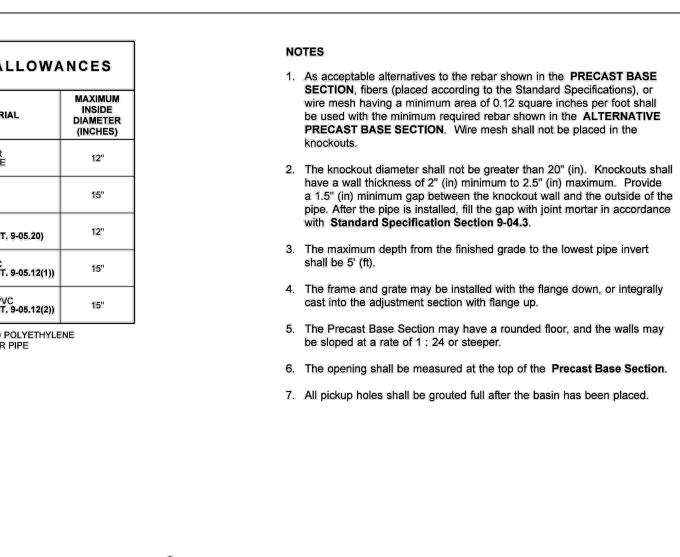
PACKAGE #


12/04/2020

RTA/CN 0612-18 12/04/2020

STORM DETAILS



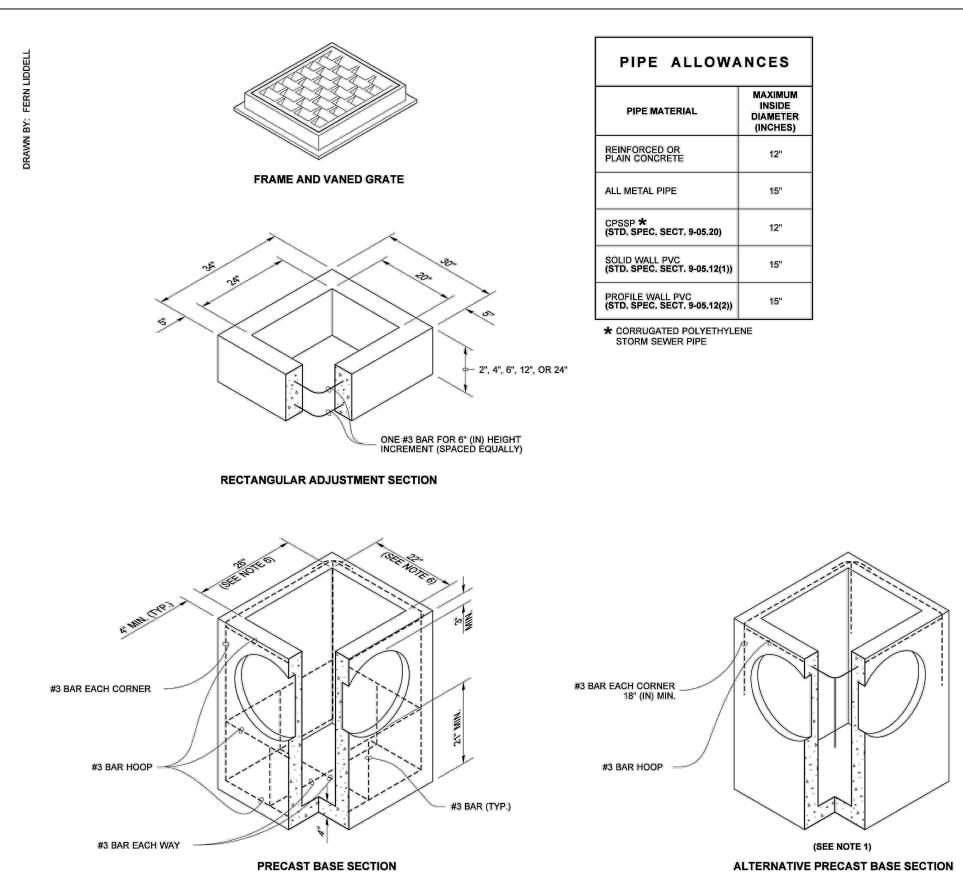

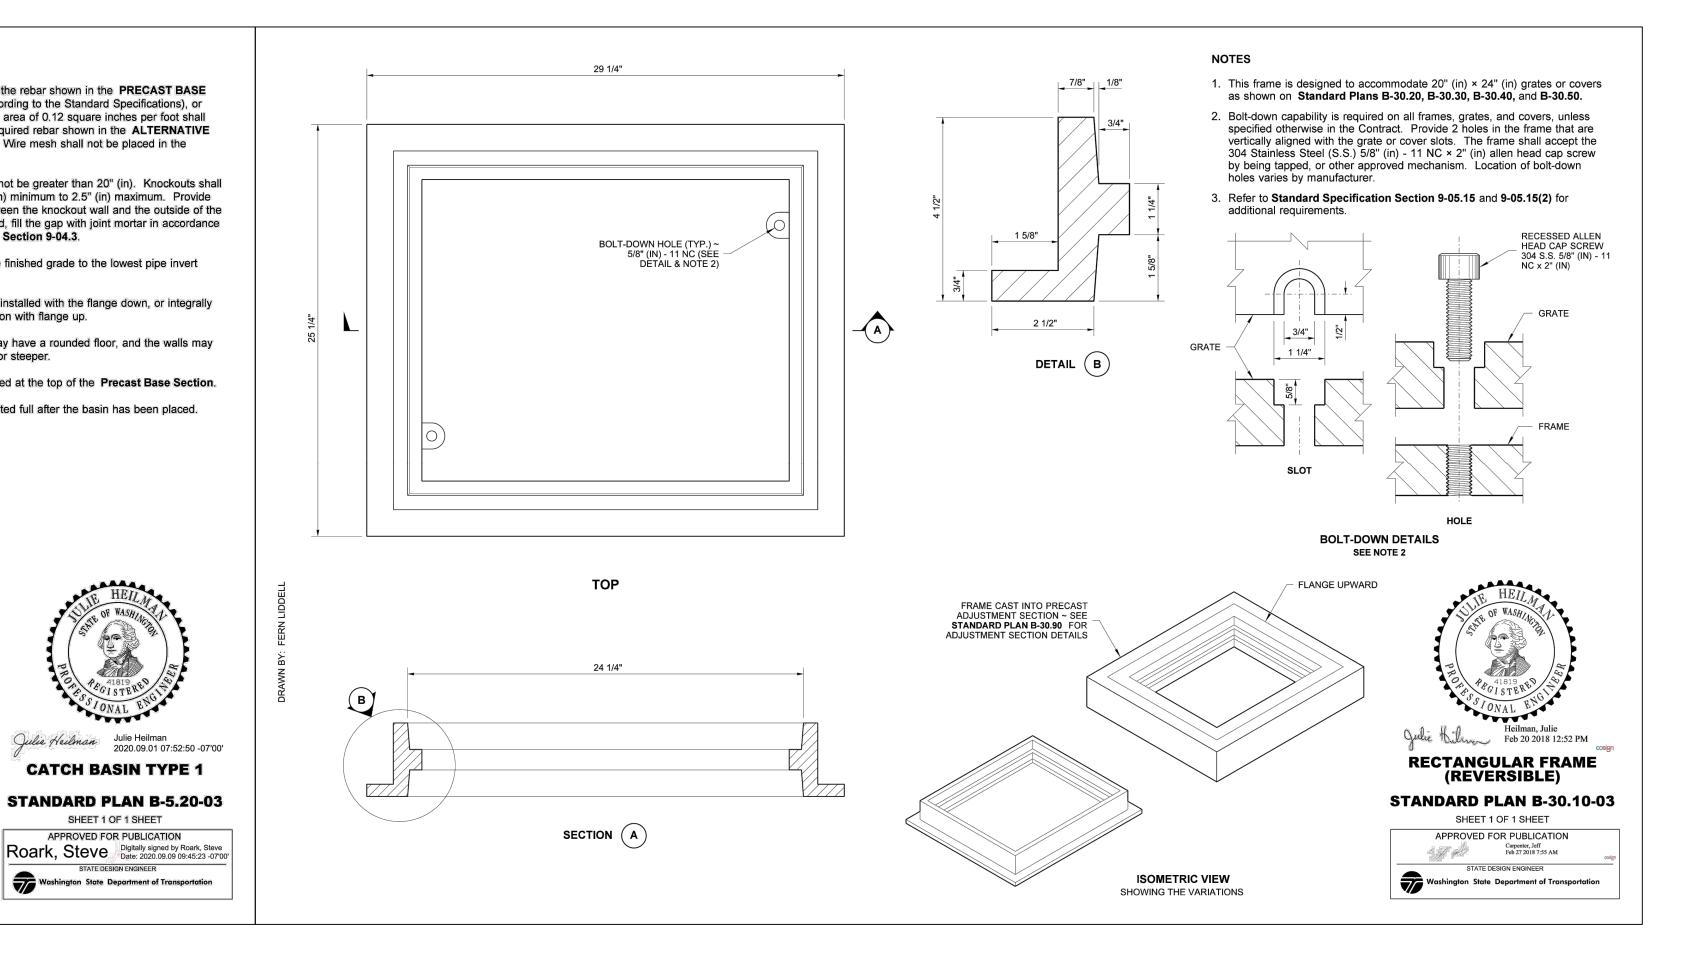




NOTE: THIS APPROVAL IS VOID AFTER 180 DAYS FROM APPROVAL


THE CITY WILL NOT BE RESPONSIBLE FOR ERRORS AND/ OR OMISSIONS ON THESE PLANS.

FIELD CONDITIONS MAY DICTATE CHANGES TO THESE PLANS AS DETERMINED BY THE ENGINEERING SERVICES MANAGER.

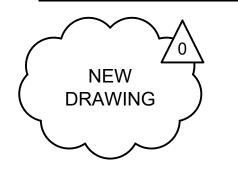

CIVIL PERMIT RESUBMITTAL S. GUJULUVA RAJAN M. VU CHECKED BY: 1/11/21 SGR JGM JGM REVISIONS FOR CITY PERMIT 0504 J. MATTHEWS 12/04/20 SGR JGM JGM ISSUED FOR CONSTRUCTION APPROVED BY: J. MATTHEWS

CHK APP REVISION

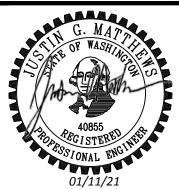



SARA ROBERTS

SHEET 1 OF 1 SHEET

APPROVED FOR PUBLICATION

STATE DESIGN ENGINEER



12/04/2020

REVIEWED BY:

GREG SHIMIZU



DATE:

12/04/2020

PACKAGE # DP-2 NTS FILENAME: S317-F1592-CDD121 SoundTransit CONTRACT No.: RTA/CN 0612-18

SUBMITTAL DATE:

12/04/2020

SITEWORK AND UTILITIES **PUYALLUP STATION PARKING**

CONTRACT RTA/CN 0612-18 PUYALLUP STATION PARKING AND ACCESS **IMPROVEMENTS**


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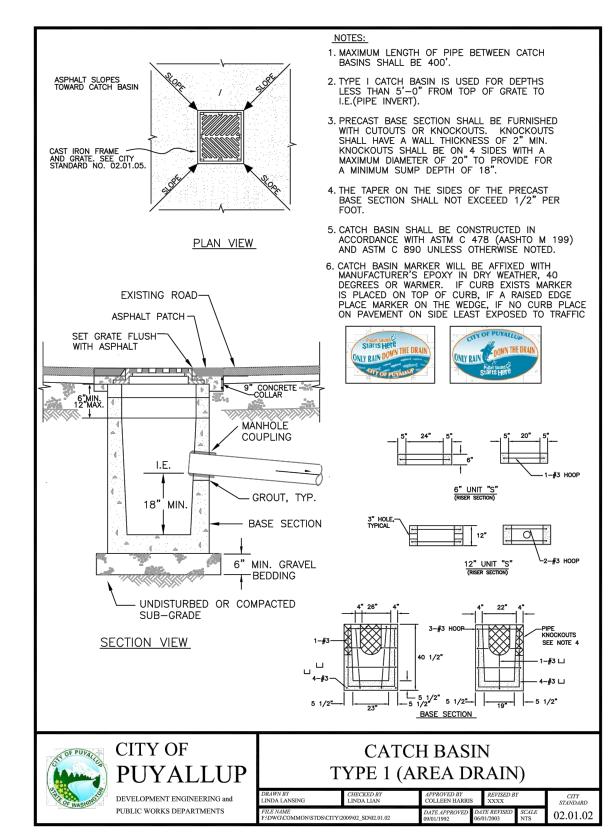
F1592-CDD121


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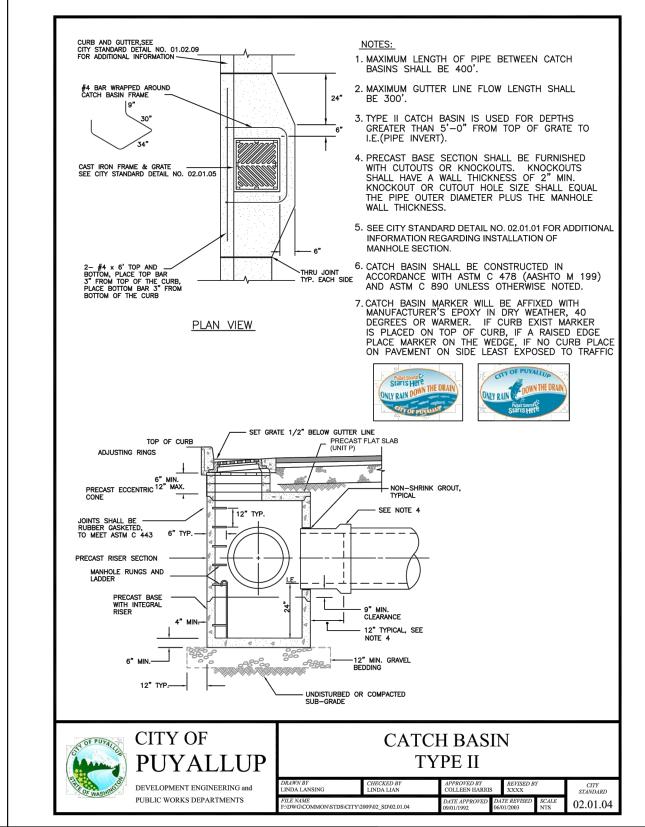
FACILITY ID:


F1592 35/81






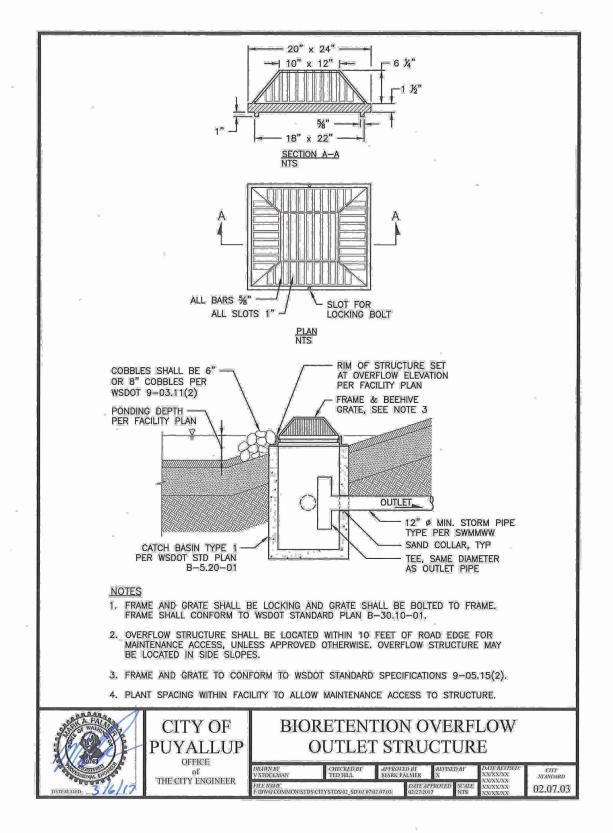


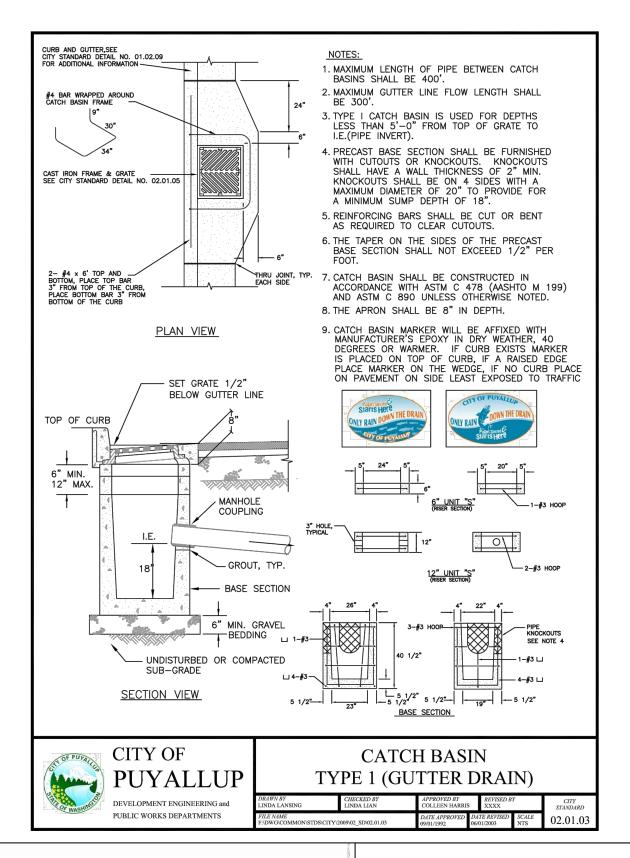

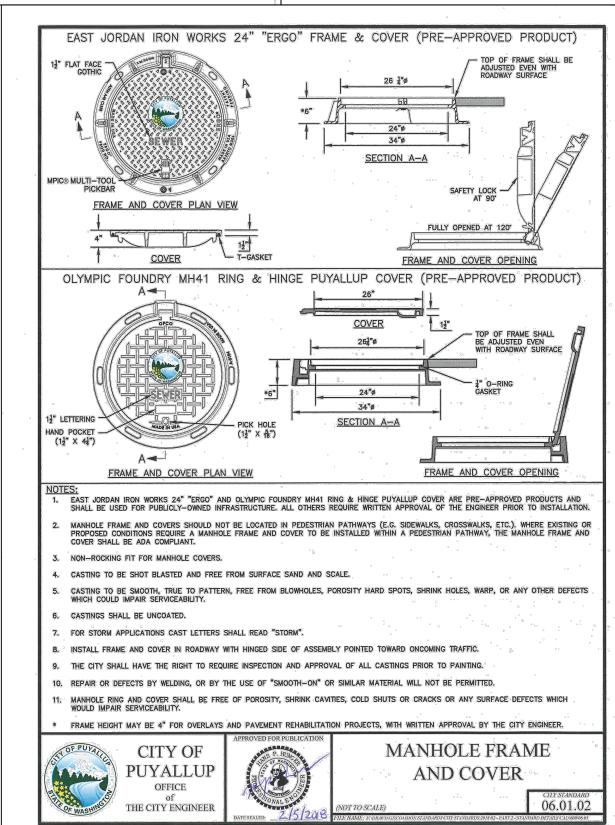

. MATTHEWS

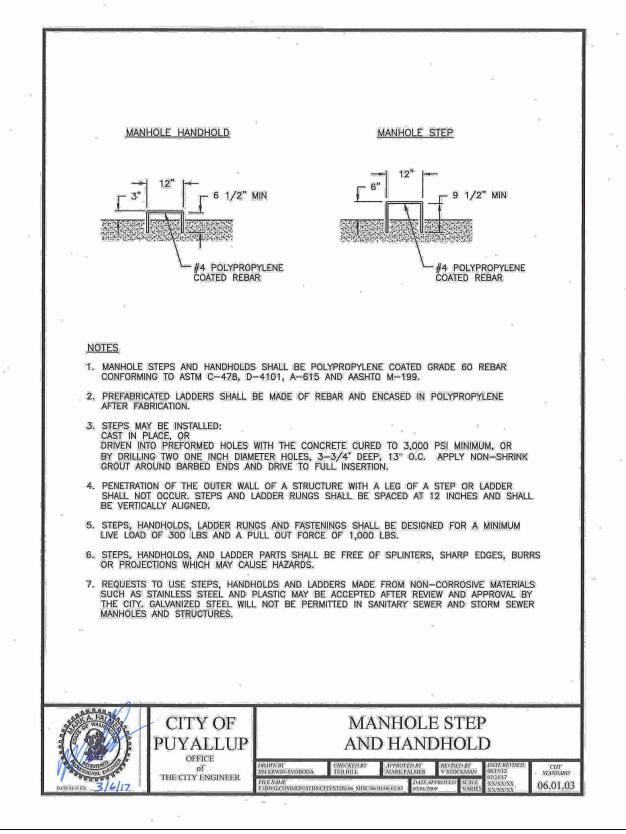

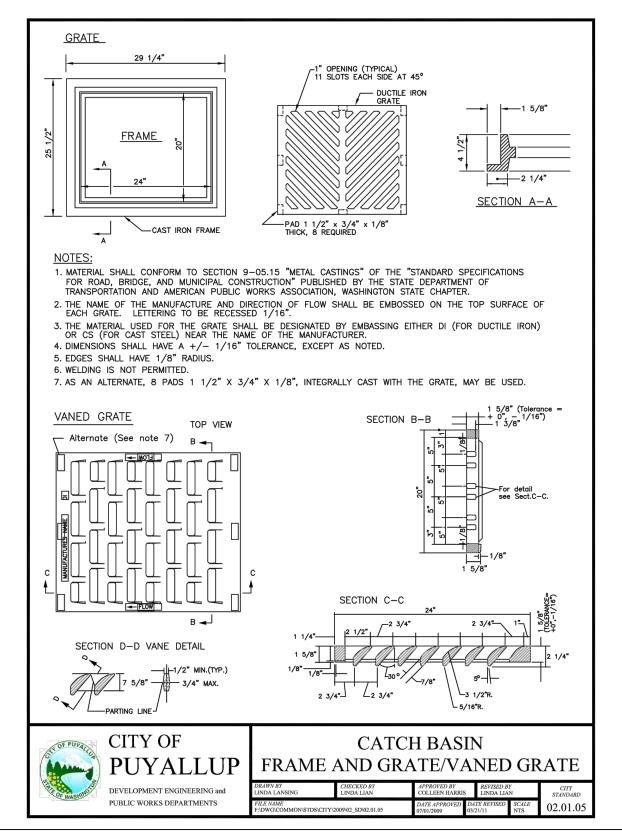


APPROVED - Benkey CITY OF PUYALLUP DEVELOPMENT SERVICES DATE 2/17/2021

NOTE: THIS APPROVAL IS VOID AFTER 180 DAYS FROM APPROVAL

THE CITY WILL NOT BE RESPONSIBLE FOR ERRORS AND/ OR OMISSIONS ON THESE PLANS.

FIELD CONDITIONS MAY DICTATE CHANGES TO THESE PLANS AS DETERMINED BY THE ENGINEERING SERVICES MANAGER.

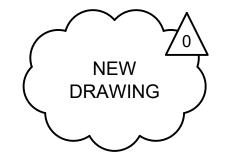

CIVIL PERMIT RESUBMITTAL S. GUJULUVA RAJAN M. VU CHECKED BY . MATTHEWS APPROVED BY SGR JGM JGM ISSUED FOR CONSTRUCTION 12/04/20





12/04/2020



NTS ILENAME: S317-F1592-CDD122 CONTRACT No.

RTA/CN 0612-18

SUBMITTAL DATE:

12/04/2020

DP-2

PUYALLUP STATION PARKING CONTRACT RTA/CN 0612-18 PUYALLUP STATION PARKING AND ACCESS **IMPROVEMENTS**

SITEWORK AND UTILITIES

F1592-CDD122 FACILITY ID:

F1592

RAWING No.:

SARA ROBERTS

KDII REVIEWED BY:

GREG SHIMIZU

DATE: 12/04/2020

CIVIL STORM DETAILS

36/81

NOTES: R06 16+13.74, 31.32' LT R06 16+03.46, 16.91\LT₍₁₂₎₍₂₁₎ xS317-F1592-RPP10 TR06 16+08.53, 31.24' LT END R06 26+09.90, 26.00' LT (CENTER) xS317-F1592-VRX10 R06 15+95.77, 14.07' LT FOR GENERAL NOTES, SEE DRAWING F1592-CZN001. GB-SEAL-JGM40855 **BURLINGTON NORTHERN RAILROAD** R06 16+11.32, 26.91' LT (NW) xGB-TB-Views_x20 FOR SYMBOLS, ABBREVIATIONS, AND LEGENDS, SEE OWS SEE NOTE 9 7 xS317-F1592-CSP10 R06 16+16.13, 33.79' LT (CENTER) xS317-F1592-CDP10 DRAWING F1592-CZN010. xS317-F1592-UPP10 R06 16+03.22, 31.55' LT R06 16+18.52, 37.30' LT (NW) R06 15+96.26, 49.82' RT (CENTER R06 16+01 49, 23.89 L xS317-F1592-UWP10 SEE DP-5 F1592-MPP100 SERIES SHEETS FOR SEWER xGB-TB22x34 xS317-F1592-UCP10 CONNECTIONS xS317-F1592-TSP10 xS317-F1592-SGP01 R06 16+17.35, 46,30' LT (CE SEE DP-5 F1592-MEP100 FOR WATER CONNECTIONS xS317-F1592-TSP100 R06 16+16.74, 108.00' LT xS317-F1592-BNP010 R06 16+21.37, 50.28' LT (NW) SEE DP-2 F1592-LRP103 FOR IRRIGATION 90° DI BEND (MJ) R06 15+91.79, 30.01' RT CONNECTIONS 22 R06 16+16.65, 124.57 LT R06 16+03.00, 40.99' LT 8" X 8" X 6" IEE SEE DP-5 F1592-ESP02 FOR ELECTRICAL 6" GATE VALVE R06 16+16.63, 127.59 LT CONNECTIONS 90° DI BEND (MJ) SEE DP-2 F1592-BNP010 FOR GROUND R06 15+87.11, 30.11' RT **IMPROVEMENTS** R06 15+95.03, 12.66' LT FOR OIL WATER SEPARATOR AND SUMP SEE DP-3 F1592-MPD901 DETAIL 1. SEE F1592-UCV021 FOR FOR OIL WATER SEPARATOR SEE DP-3 F1592-MPD901 6" GATE DETAIL 2. SEE F1592-UCV021 FOR PROFILE VALVE VALVE √R06 16+04\03, 127.31' LT SR06 16+03.08, 37.24 LT (CENTER) 10. 4 INCH VENT FOR ROUTING AND INVERT ELEVATION, R06 16+04.05, 39.01 LT (NW) R06 15+96.47, 117.99 LT SEE DP-5 F1592-MPP100 45° DI BEND (MJ) R06 15+93.66, 107.47' LT 12. FIELD FIT CONDUIT AROUND P15 90° DI BEND (MJ) 13. CUT CENTURYLINK RISER AND ROUTE 4" CONDUIT R06 15+37.00, 26.91 LT TO VAULT, BRING 4" CONDUIT FROM VAULT AND RISER UP P15 R06 15+38.91, 13.54 LT 8" GATE VALVE **CONSTRUCTION NOTES:** CONST 6" PVC SAMPLING TEE PER COP STD 04.03.04 SEE NOTE 4 R06 14+33.63, 0.07' LT DDCVA INSIDE CONST SIDE SEWER MAIN TAP PER COP STD 04.02.01 MECHANICAL\ROOM -3RD AVE NW 王 CONST CLEANOUT PER COP STD 04.03.04 6" DI FIRE LINE TO R04 14+00 S PENETRATE FLOOR 60" ID MH STRUCTURE WITH FLAT TOP AND 48" MH AT CENTERLINE OF OWS SEE NOTE & OPENING, LID SHALL BE RATED FOR HS-20 LOADING PIPE FROM: 1'-2 3" FROM LINE A SEE NOTE 10 -CONST 6" PVC SIDE SEWER SEE NOTE 3 & 7 R05 12+94\94, 35.48' LT CONST 48" MH PER COP STD 04.01.01 SEE NOTE 3 CONST 44" OIL WATER SEPARATOR R05 12+70.16, 39.56' LT R05 12+70.20, 37.56' LT CONST DI 6" RESILIENT WEDGE GATE VALVE DCVA SEE NOTE 5 INSTALL TO GRADE 750KVA PAD MOUNTED ZR05 12+55.20, 33.75' LT (CENTER) R05 12+54.13, 35.21 LT (NW) TRANSFORMER 7'X7'X4' WITH AN 8'X8' LID R05 12+55.20, 29.94' LT PROVIDED BY PSE R05 12+55 20, 7.78' LT CONST 1" WATER SVC PER COP STD 03.03.01 CONST DI 6" FIRE SVC, WRAP IN 8 MIL R06 14+00 POLYTHLENE PER SPECS PROPOSED FDC LOCATION ' R05 <u>13+11.38</u>, <u>35.94' LT</u> R04 15+38.14, 13.04' RT (12) CONST 2" DOM WATER SVC PER COP STD 03.03.02 (15) 20) 6" GATE VALVE CONNECT TO CONST 2" OR SMALLER DCVA PER COP STD 03.04.01 WATER MAIN R05 12+69.92, 1.57' LT (14) CONST 8" DI WATER MAIN PER COP STD 03.01.01 SEE DP-3 FOR PUBLIC ROW STORM WATER IMPROVEMENTS CONST FH PER COP STD 03.05.01 R05 12+00 R04 15+38.48, 24.21' RT CONST THRUST BLK PER COP STD'S 03.03.01-1 & 03.02.01-3 PSE/COMM DUCTBANK CONSTRUCTED IN DP-7 **APPROVED APPROVED CONSTRUCTION NOTES (CONT'D):** CONNECT TO EXIST 8" MAIN WITH TAPPING SLEEVE CITY OF PUYALLUP CITY OF PUYALLUP CONST VALVE PER COP STD 03.01.01 CONNECT TO EXIST 10" MAIN WITH TAPPING SLEEVE DEVELOPMENT SERVICES FIRE CODE OFFICIAL CONTRACTOR TO PROVIDE METER PER COP DATE 2/17/2021 DATE 2/17/2021 (22) CONST PIV PER COP STD 03.10.03 SPEC 301.3 #2 **NOTE**: THIS APPROVAL IS VOID **NOTE**: THIS APPROVAL IS VOID INSTALL TO GRADE 7'X4'8"X4' AFTER 180 DAYS FROM APPROVAL AFTER 180 DAYS FROM APPROVAL **VAULT SUPPLIED BY PSE** -R05 10+00 **INSTALL 4" PVC CONDUIT** THE CITY WILL NOT BE THE CITY WILL NOT BE SUPPLIED BY PSE RESPONSIBLE FOR ERRORS AND/ RESPONSIBLE FOR ERRORS AND/ INSTALL 17"W X 30"L X 24"H VAULT OR OMISSIONS ON THESE PLANS. OR OMISSIONS ON THESE PLANS. INSTALL 4" PVC CONDUIT FIELD CONDITIONS MAY DICTATE FIELD CONDITIONS MAY DICTATE CHANGES TO THESE PLANS AS CHANGES TO THESE PLANS AS CONST DCVA PER COP STD 03.04.01 DETERMINED BY THE DETERMINED BY THE **ENGINEERING SERVICES** ENGINEERING SERVICES SCALE IN FEET CONST 2" COPPER TYPE K WATER LINE MANAGER. PACKAGE # DP-2 **SITEWORK AND UTILITIES** RAWING No. **PUYALLUP STATION PARKING** CIVIL PERMIT RESUBMITTAL **HENSEL PHELPS** HP S. KIRBY 5 1"=20' F1592-UCP203 CONTRACT RTA/CN 0612-18 Plan. Build. Manage. DRAWN BY: ILENAME PUYALLUP STATION PARKING AND ACCESS FACILITY ID: J. CURTIS S317-F1592-UCP203 kpff SOUNDTRANSIT **IMPROVEMENTS** 02/12/21 | SGR | JGM | JGM | REVISIONS FOR CITY PERMIT 0504 CHECKED BY CONTRACT No. F1592 01/11/21 | SGR | JGM | JGM | REVISIONS FOR CITY PERMIT 0504 . MATTHEWS RTA/CN 0612-18 UTILITIES SUBMITTAL DATE: 35 **37/81** SGR JGM JGM ISSUED FOR CONSTRUCTION APPROVED BY REVIEWED BY: COMPOSITE UTILITY PLAN SARA ROBERTS . MATTHEWS 01/27/2021 **GREG SHIMIZU** 01/27/2021 01/27/2021

Xrefs:
xS317-F1592-RPP100
xS317-F1592-VRX100
GB-SEAL-JGM40855
xGB-TB-Views_x20
xS317-F1592-CSP100
xS317-F1592-UPP100
xS317-F1592-UWP100
xS317-F1592-UWP100
xGB-TB22x34 NOTES: W STEWART AVE 1. FOR GENERAL NOTES, SEE DRAWING F1592-CZN001. R01 26+00 R01 25+00 2. FOR SYMBOLS AND LEGENDS, SEE DRAWING F1592-CZN010. **CONSTRUCTION NOTES:** (14) CONST 8" DI WATER MAIN PER COP STD 03.01.01 (16) CONST THURST BLK PER COP STD'S 03.03.01-1 & 03.02.01-3 (20) CONNECT TO EXIST 8" MAIN **BURLINGTON NORTHERN RAILROAD** P02 32+54.71, 5.93' LT SLEEVE CONC WALK APPROVED CITY OF PUYALLUP DEVELOPMENT SERVICES DATE 2/17/2021 NOTE: THIS APPROVAL IS VOID AFTER 180 DAYS FROM APPROVAL THE CITY WILL NOT BE RESPONSIBLE FOR ERRORS AND/ P02 32+50.53, 6.69' LT 11.25° DI BEND (MJ) OR OMISSIONS ON THESE PLANS. FIELD CONDITIONS MAY DICTATE CHANGES TO THESE PLANS AS DETERMINED BY THE ENGINEERING SERVICES MANAGER. SCALE IN FEET SITEWORK AND UTILITIES PACKAGE # DP-2 DRAWING No.: **CIVIL PERMIT RESUBMITTAL PUYALLUP STATION PARKING HENSEL PHELPS** P S. KIRBY 1"=20' F1592-UCP204 CONTRACT RTA/CN 0612-18 Plan. Build. Manage. ILENAME: PUYALLUP STATION PARKING AND ACCESS S317-F1592-UCP204 FACILITY ID: J. CURTIS kpff **SOUNDTRANSIT IMPROVEMENTS** F1592 CHECKED BY: CONTRACT No.: J. MATTHEWS RTA/CN 0612-18 UTILITIES APPROVED BY: 38/81 SGR JGM JGM ISSUED FOR CONSTRUCTION REVIEWED BY: SUBMITTAL DATE:

12/04/2020

GREG SHIMIZU

12/04/2020


12/04/2020

SARA ROBERTS

J. MATTHEWS


COMPOSITE UTILITY PLAN

Xrefs: GB-SEAL-JGM40855 xGB-TB22x34 xS317-F1592-VRX100 NOTES: 1. FOR SYMBOLS ABBREVIATIONS AND LEGENDS SEE DRAWING F1592-CZN010. 2. KEEP 1' CLEAR OF ALL UTILITIES.
3. RISER RINGS WILL BE REQUIRED TO ADJUST TO 4. SEE DRAWING F1592-MPP100 IN DP-5 FOR MORE INFORMATION. 5. PLACE ETHAFOAM BLOCK BETWEEN SEWER AND DUCTBANK. `−4" SS @ 2.00% SEE NOTE 4 SEE NOTE 2 L4 LF 6" SS @ -1.00% L3 LF 6" SS @ 1.00% └3 LF 6" SS @ 0.00% -46 LF 6" SS @ 18.14% EX 18" CONC SS 0+05TH ST NW CROSSING (NORTH) SCALE: H: 1"=20' V: 1"=5' 2ND AVE 8 RIM 45.55 IE (IN) 33.6 IE (OUT) 4 IE (OUT) 4 SEE NOTE __ EX 10" W - DUCT BANK ` 35 LF 6" SS @ 6.28% EX 8" SS SEE NOTE 5 **APPROVED** ^L3 LF 6" SS @ 0.00% 6" SS @ 2.00%-- EX 18" CONC SS └3 LF 6" SS @ 1.00% CITY OF PUYALLUP SEE NOTE 4 DEVELOPMENT SERVICES L3 LF 6" SS @ 1.00% └3 LF 6" SS @ 0.36% ^L2 LF 6" SS @ 0.36% DATE____2/17/2021 -5 LF 6" SS @ 0.00% **NOTE**: THIS APPROVAL IS VOID AFTER 180 DAYS FROM APPROVAL THE CITY WILL NOT BE RESPONSIBLE FOR ERRORS AND/ OR OMISSIONS ON THESE PLANS. FIELD CONDITIONS MAY DICTATE CHANGES TO THESE PLANS AS DETERMINED BY THE ENGINEERING SERVICES LOT & 5TH ST NW (SOUTH) 2ND AVE NW & 5TH ST NW (WEST) SCALE: H: 1"=20' V: 1"=5' SCALE: H: 1"=20' V: 1"=5' PACKAGE # DP-2 SITEWORK AND UTILITIES RAWING No.: **CIVIL PERMIT RESUBMITTAL PUYALLUP STATION PARKING HENSEL PHELPS** P S. GUJULUVA RAJAN AS NOTED F1592-UCV021 **CONTRACT RTA/CN 0612-18** DRAWN BY: Plan. Build. Manage. FILENAME: PUYALLUP STATION PARKING AND ACCESS FACILITY ID: J. CURTIS S317-F1592-UCV021 kpff SoundTransit **IMPROVEMENTS** CHECKED BY: CONTRACT No.: F1592 A 01/11/21 SGR JGM JGM REVISIONS FOR CITY PERMIT 0504 J. MATTHEWS RTA/CN 0612-18 UTILITY 39/81 SGR JGM JGM ISSUED FOR CONSTRUCTION APPROVED BY: REVIEWED BY: SUBMITTAL DATE: COMPOSITE PROFILES **GREG SHIMIZU** J. MATTHEWS SARA ROBERTS 12/04/2020 12/04/2020 12/04/2020 CHK APP REVISION

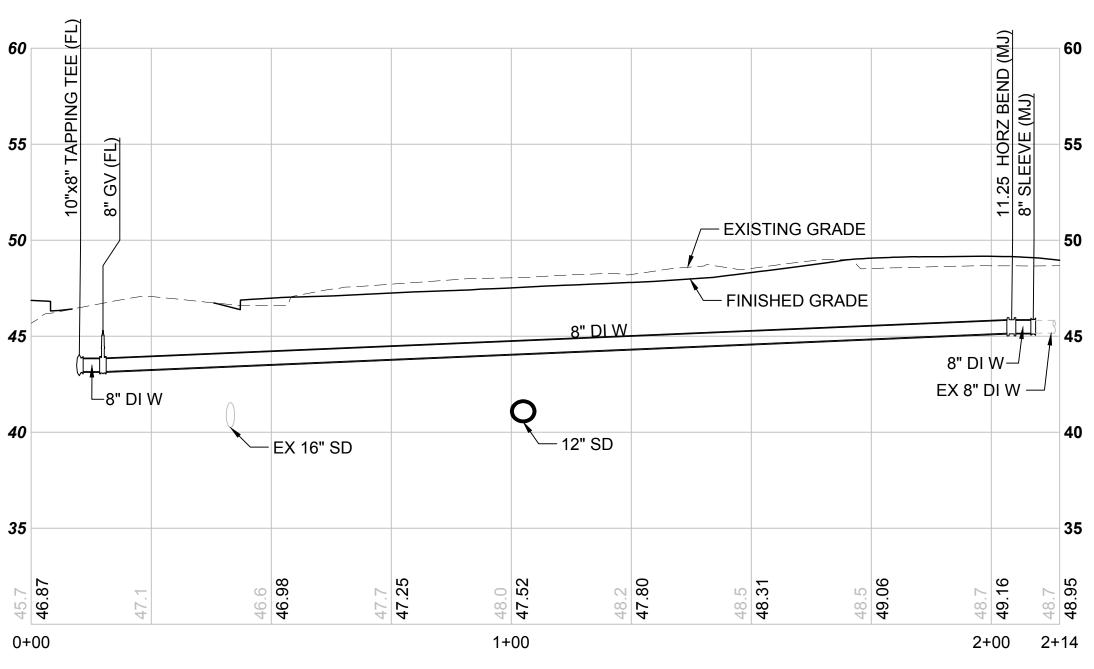

5TH ST NW CROSSING (NORTH)

SCALE: H: 1"=20' V: 1"=5'

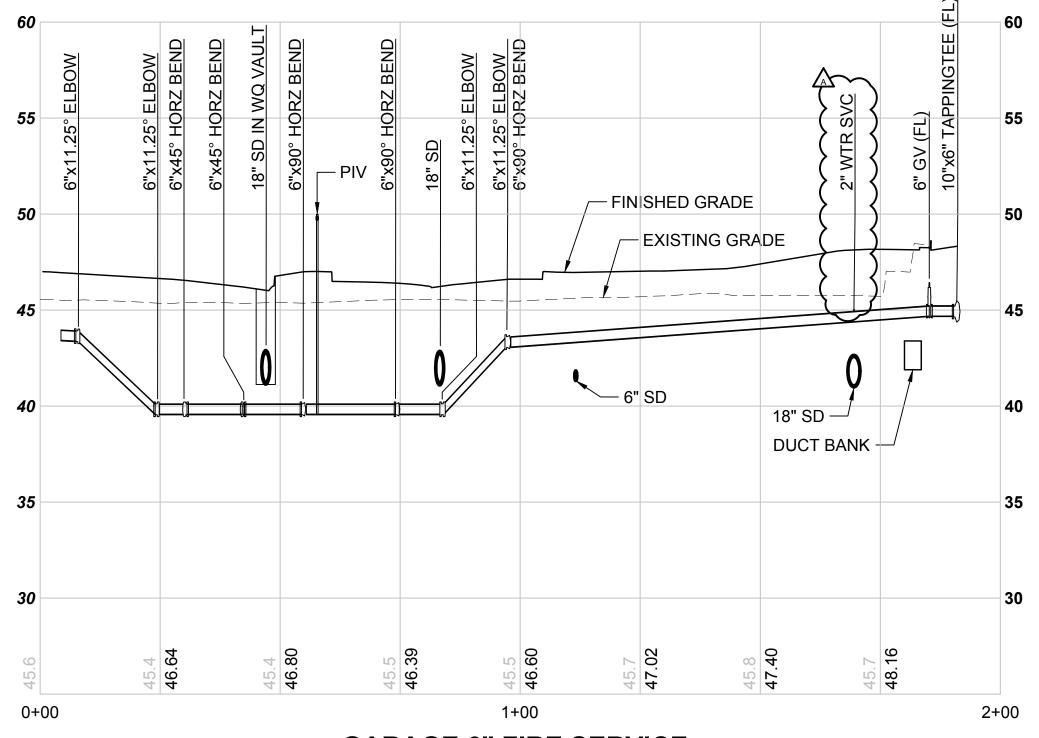

GARAGE 6" FIRE SERVICE

SCALE: H: 1"=20' V: 1"=5'

GREG SHIMIZU

12/04/2020

12/04/2020

ENGINEERING SERVICES

APPROVED

CITY OF PUYALLUP DEVELOPMENT SERVICES

NOTE: THIS APPROVAL IS VOID AFTER 180 DAYS FROM APPROVAL

RESPONSIBLE FOR ERRORS AND/ OR OMISSIONS ON THESE PLANS.

FIELD CONDITIONS MAY DICTATE

DRAWING No.:

FACILITY ID:

F1592-UCV022

F1592

40/81

CHANGES TO THESE PLANS AS

DATE 2/17/2021


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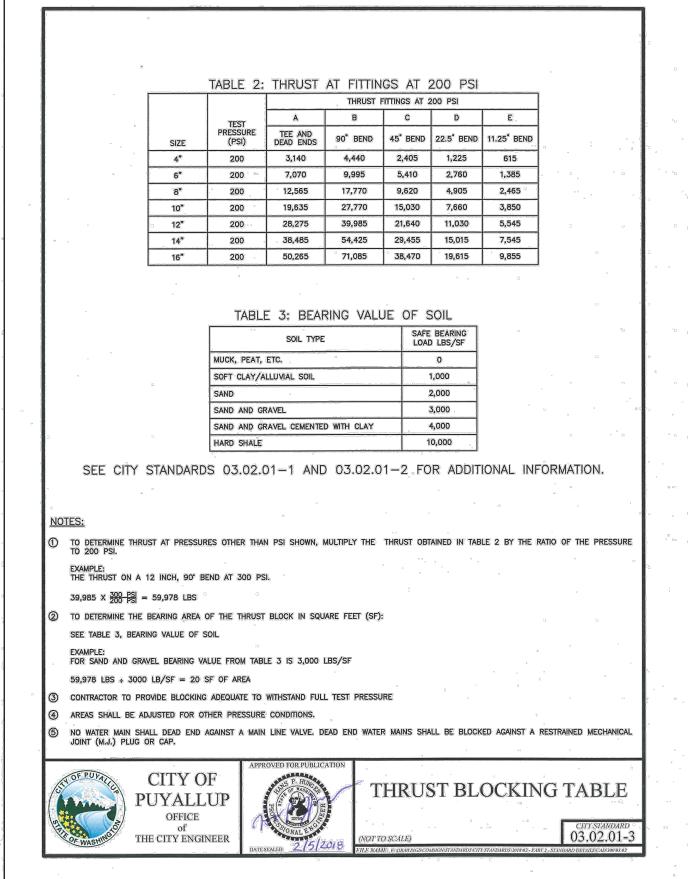
DETERMINED BY THE


PACKAGE # DP-2 SITEWORK AND UTILITIES **CIVIL PERMIT RESUBMITTAL PUYALLUP STATION PARKING HENSEL PHELPS** P S. GUJULUVA RAJAN AS NOTED CONTRACT RTA/CN 0612-18 Plan. Build. Manage. ILENAME: PUYALLUP STATION PARKING AND ACCESS J. CURTIS S317-F1592-UCV022 **kpff SOUNDTRANSIT IMPROVEMENTS** CHECKED BY: CONTRACT No.: A 01/11/21 SGR JGM JGM REVISIONS FOR CITY PERMIT 0504 J. MATTHEWS RTA/CN 0612-18 UTILITIES SUBMITTAL DATE: 12/04/20 SGR JGM JGM ISSUED FOR CONSTRUCTION APPROVED BY: REVIEWED BY: COMPOSITE PROFILES SARA ROBERTS


J. MATTHEWS


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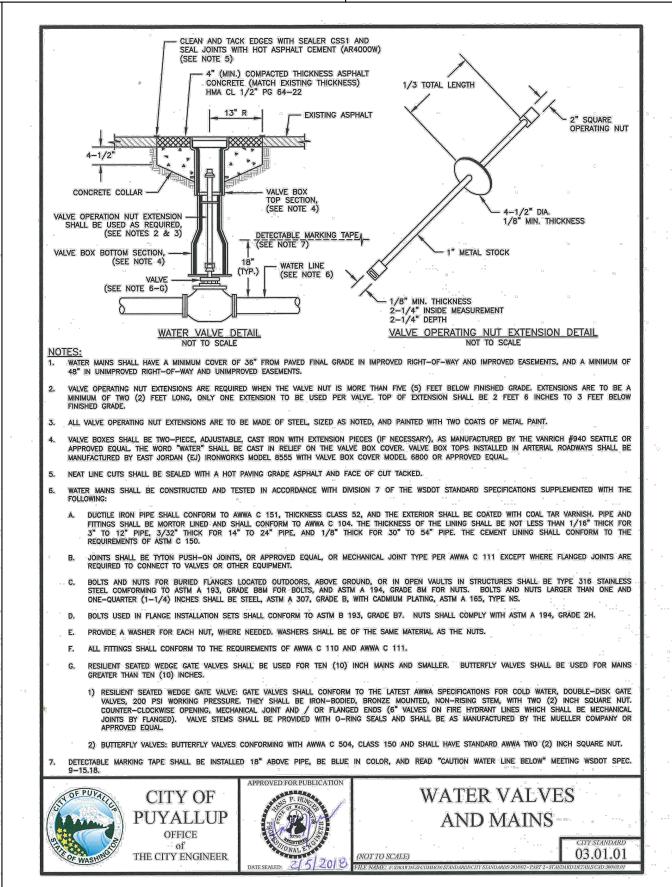





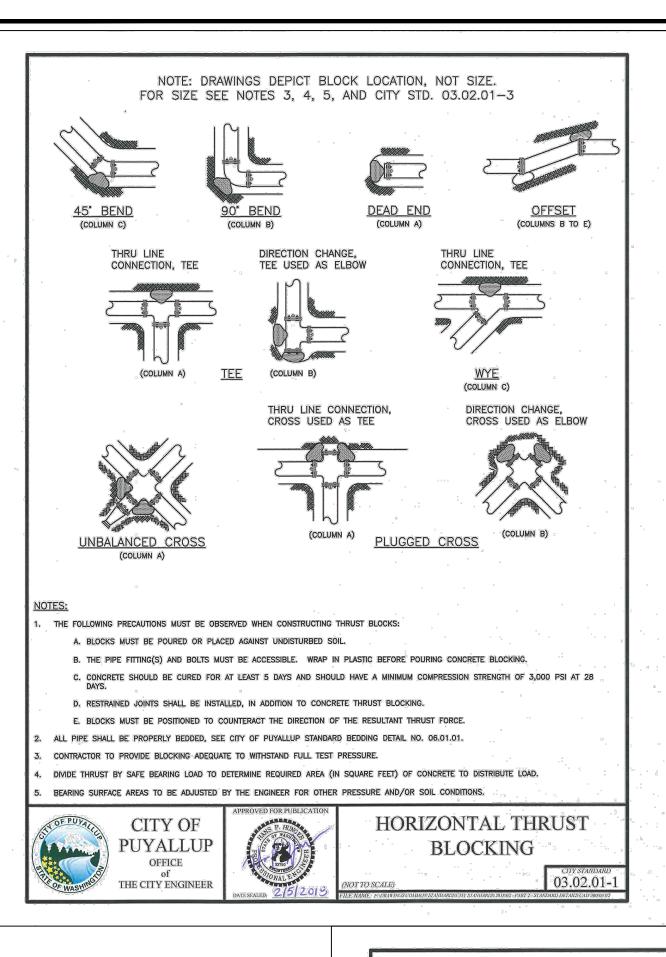

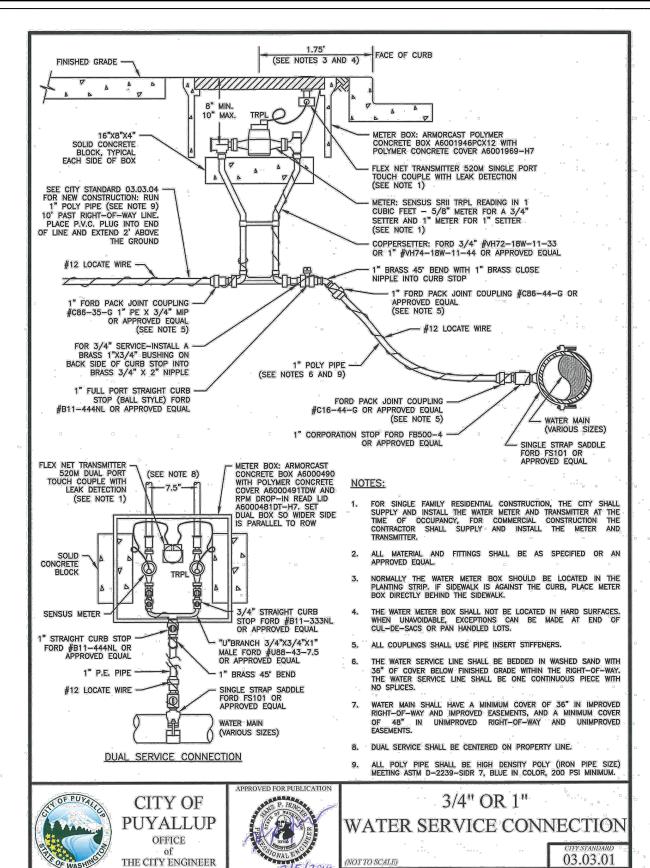

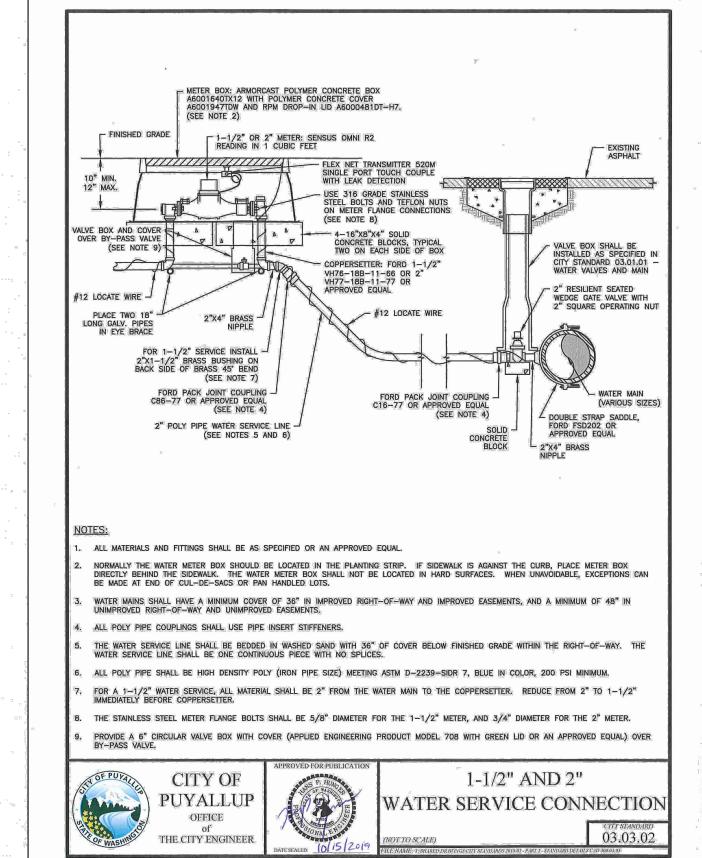

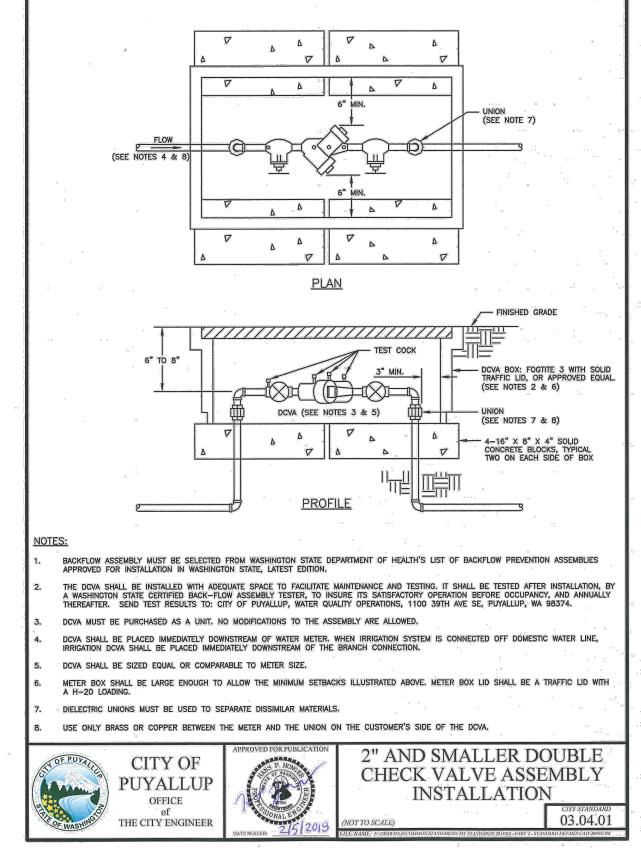

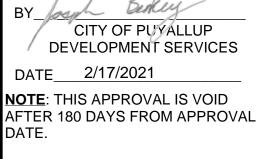

APPROVED

THE CITY WILL NOT BE RESPONSIBLE FOR ERRORS AND/ OR OMISSIONS ON THESE PLANS.


FIELD CONDITIONS MAY DICTATE CHANGES TO THESE PLANS AS

DETERMINED BY THE ENGINEERING SERVICES MANAGER.



CIVIL PERMIT RESUBMITTAL S. GUJULUVA RAJAN

M. VU CHECKED BY 1/11/21 | SGR | JGM | JGM | REVISIONS FOR CITY PERMIT 0504 . MATTHEWS SGR JGM JGM ISSUED FOR CONSTRUCTION APPROVED BY 12/04/20 . MATTHEWS CHK APP

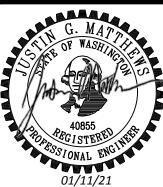






12/04/2020



REVIEWED BY:

GREG SHIMIZU

kpii

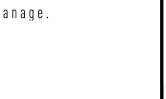

PACKAGE #

12/04/2020

NTS ILENAME: S317-F1592-UCD021 CONTRACT No.

DP-2

12/04/2020

PUYALLUP STATION PARKING CONTRACT RTA/CN 0612-18 PUYALLUP STATION PARKING AND ACCESS

SITEWORK AND UTILITIES

IMPROVEMENTS

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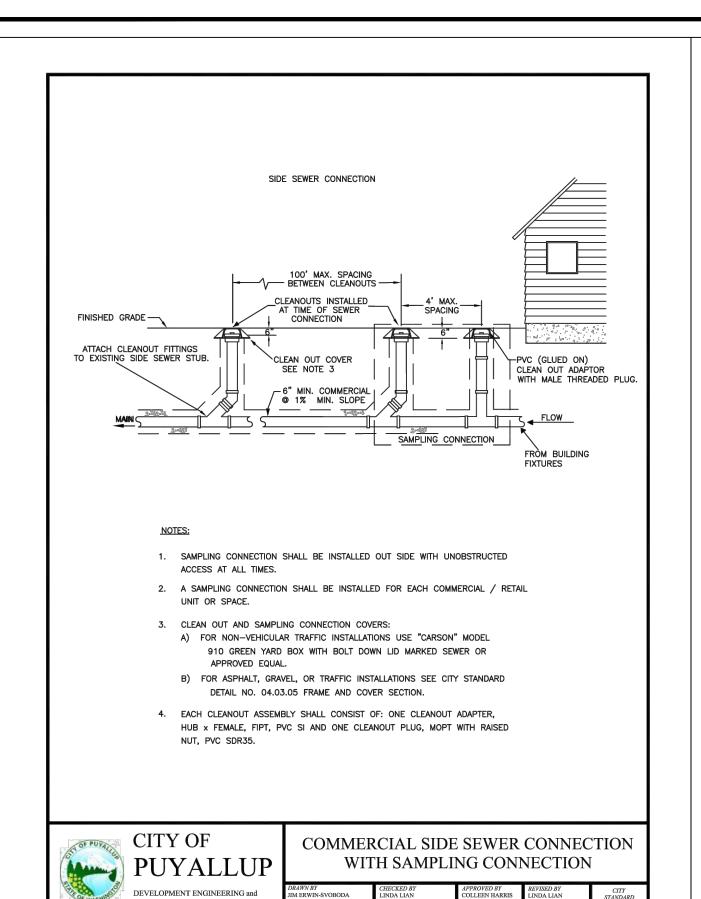
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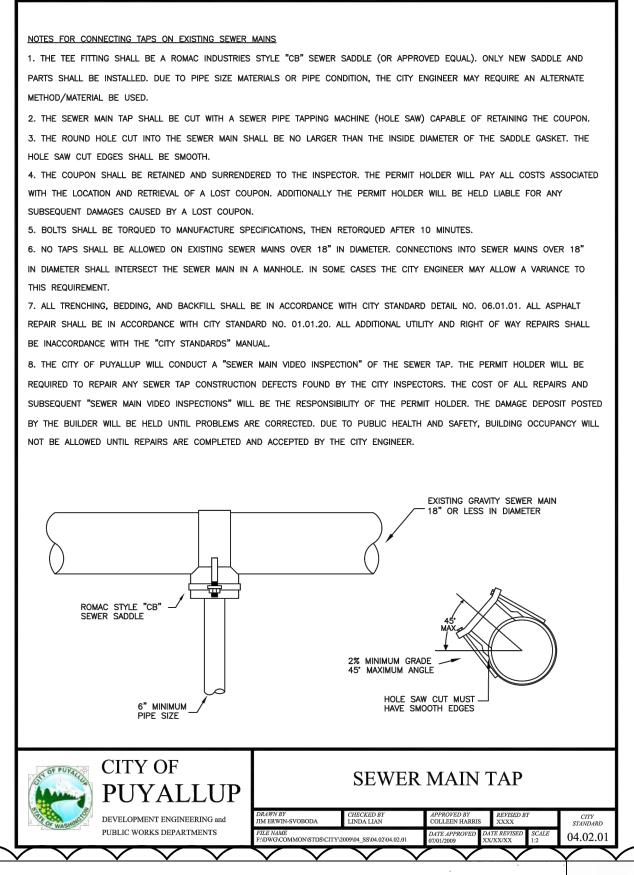
41/81


SARA ROBERTS


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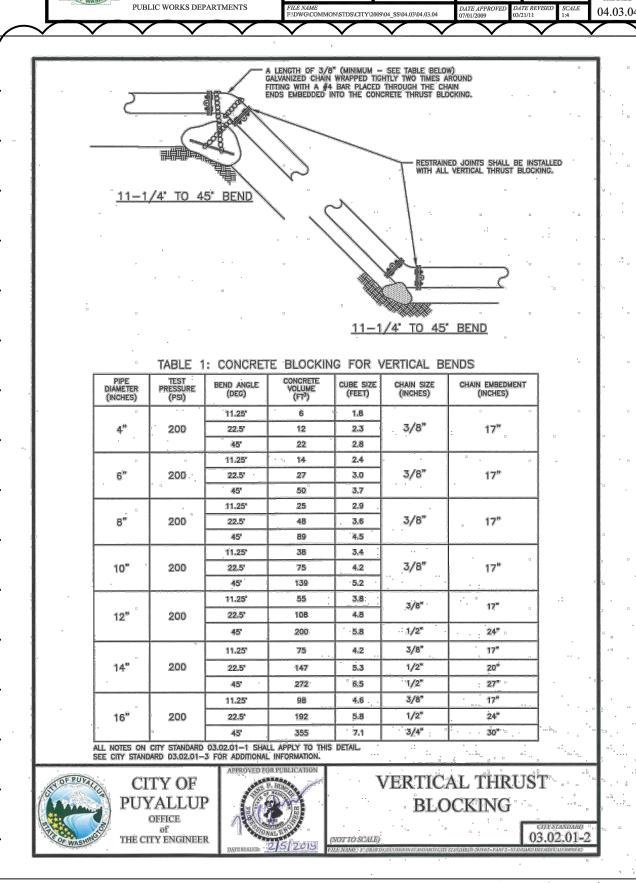
CIVIL UTILITY DETAILS F1592










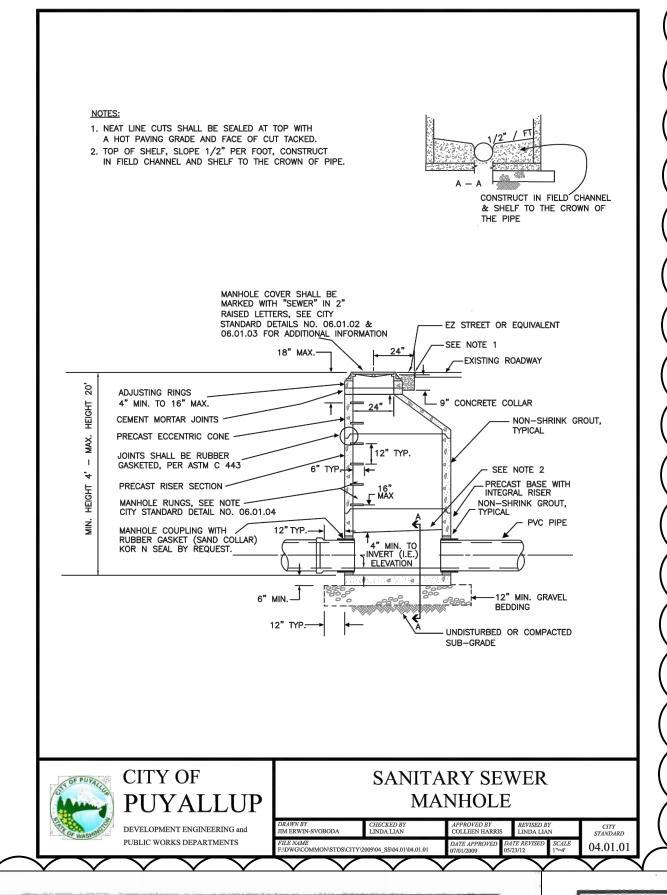


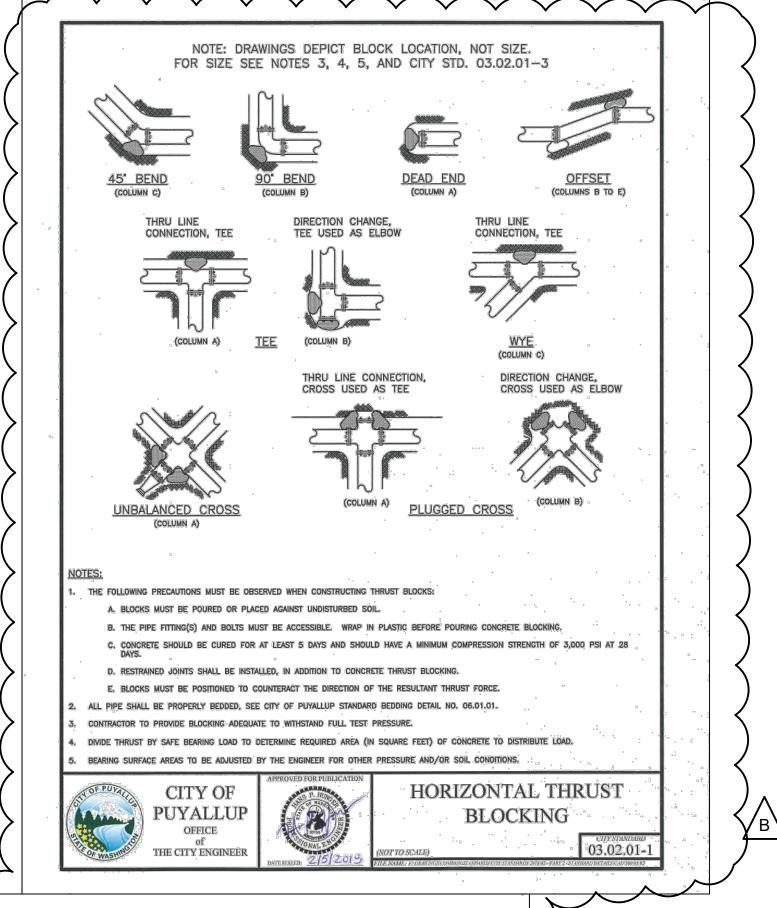


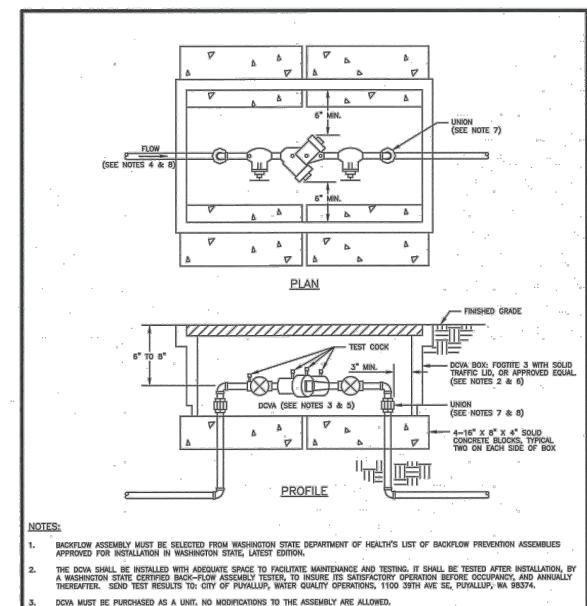

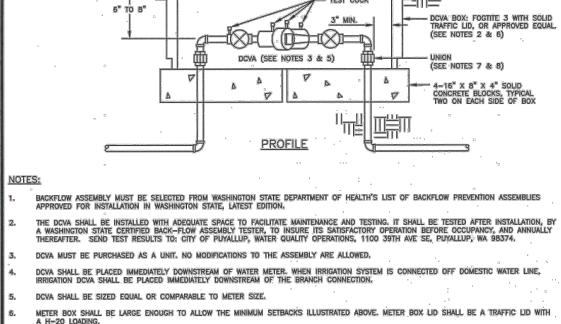

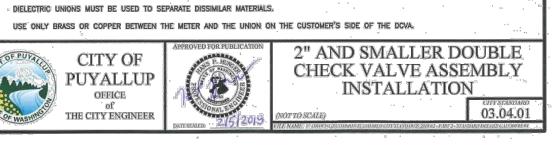

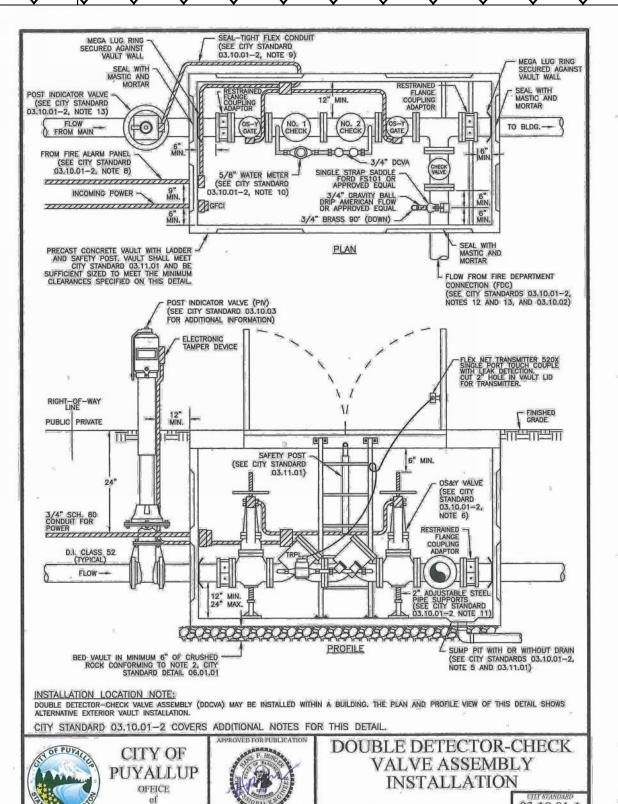

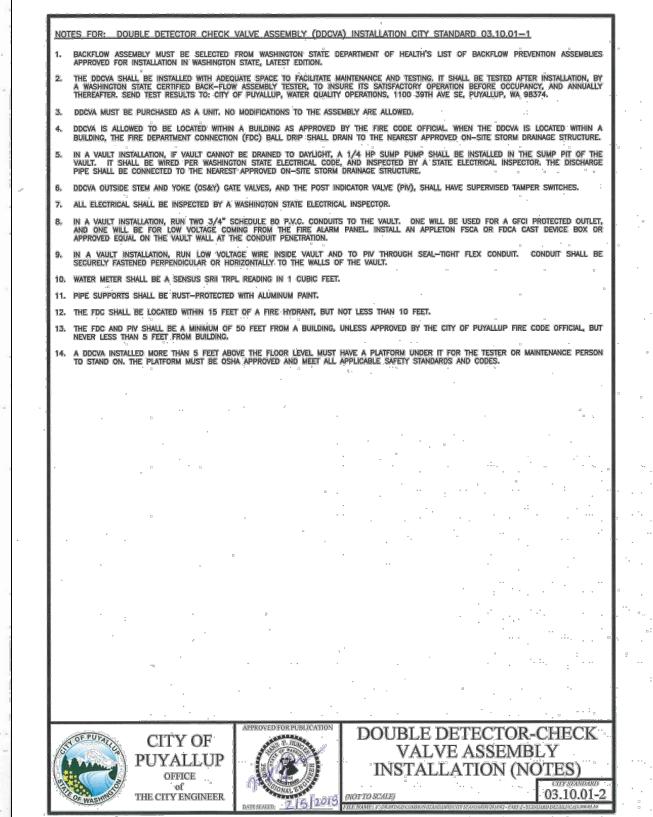

APPROVED CITY OF PUYALLUP DEVELOPMENT SERVICES

DATE 2/17/2021


NOTE: THIS APPROVAL IS VOID AFTER 180 DAYS FROM APPROVAL

THE CITY WILL NOT BE RESPONSIBLE FOR ERRORS AND/ OR OMISSIONS ON THESE PLANS.

FIELD CONDITIONS MAY DICTATE CHANGES TO THESE PLANS AS DETERMINED BY THE ENGINEERING SERVICES MANAGER.

FACILITY ID:

DESIGNED BY CIVIL PERMIT RESUBMITTAL S. KIRBY DRAWN BY: M. VU SGR JGM JGM REVISIONS FOR CITY PERMIT 0504 CHECKED BY SGR JGM JGM REVISIONS FOR CITY PERMIT 0504 . MATTHEWS APPROVED BY: SGR JGM JGM ISSUED FOR CONSTRUCTION . MATTHEWS

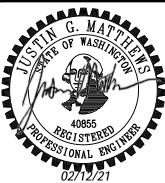

SARA ROBERTS





kpii



NTS ILENAME: CONTRACT No.

DP-2

S317-F1592-UCD022 RTA/CN 0612-18

PUYALLUP STATION PARKING CONTRACT RTA/CN 0612-18

SITEWORK AND UTILITIES

PUYALLUP STATION PARKING AND ACCESS **IMPROVEMENTS**

RAWING No.: F1592-UCD022

F1592

01/27/2021

REVIEWED BY: **GREG SHIMIZU**


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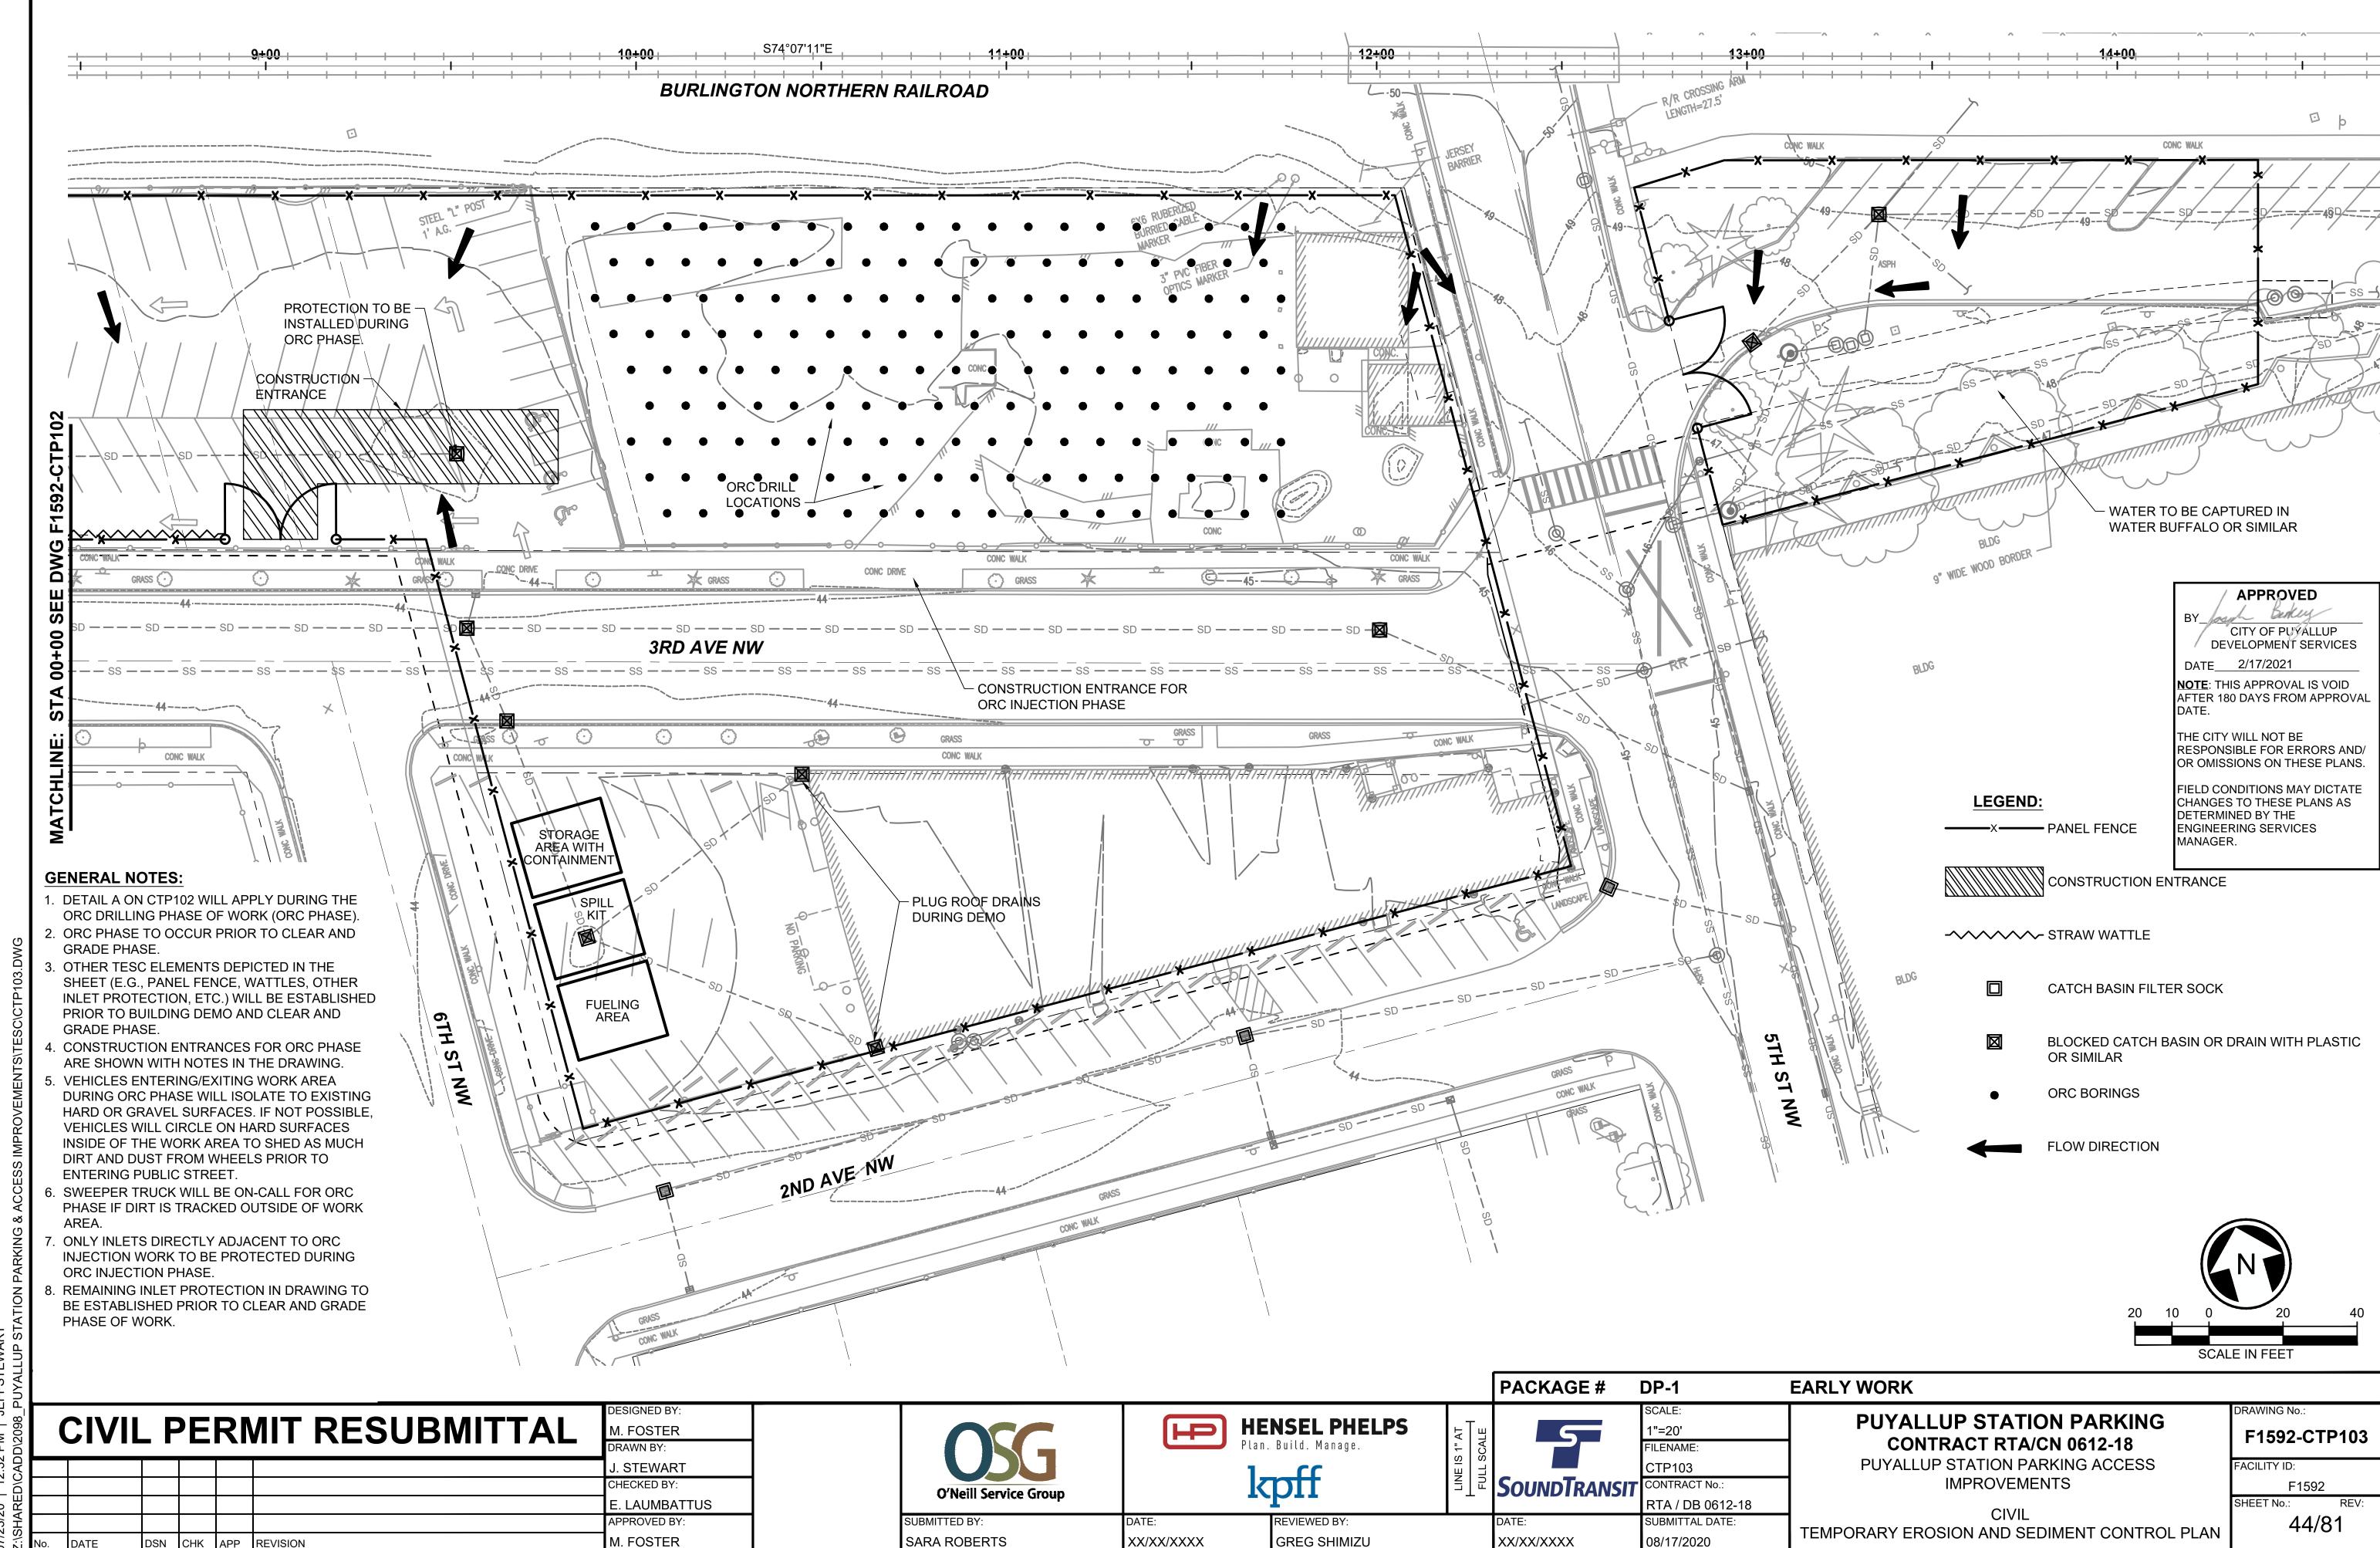
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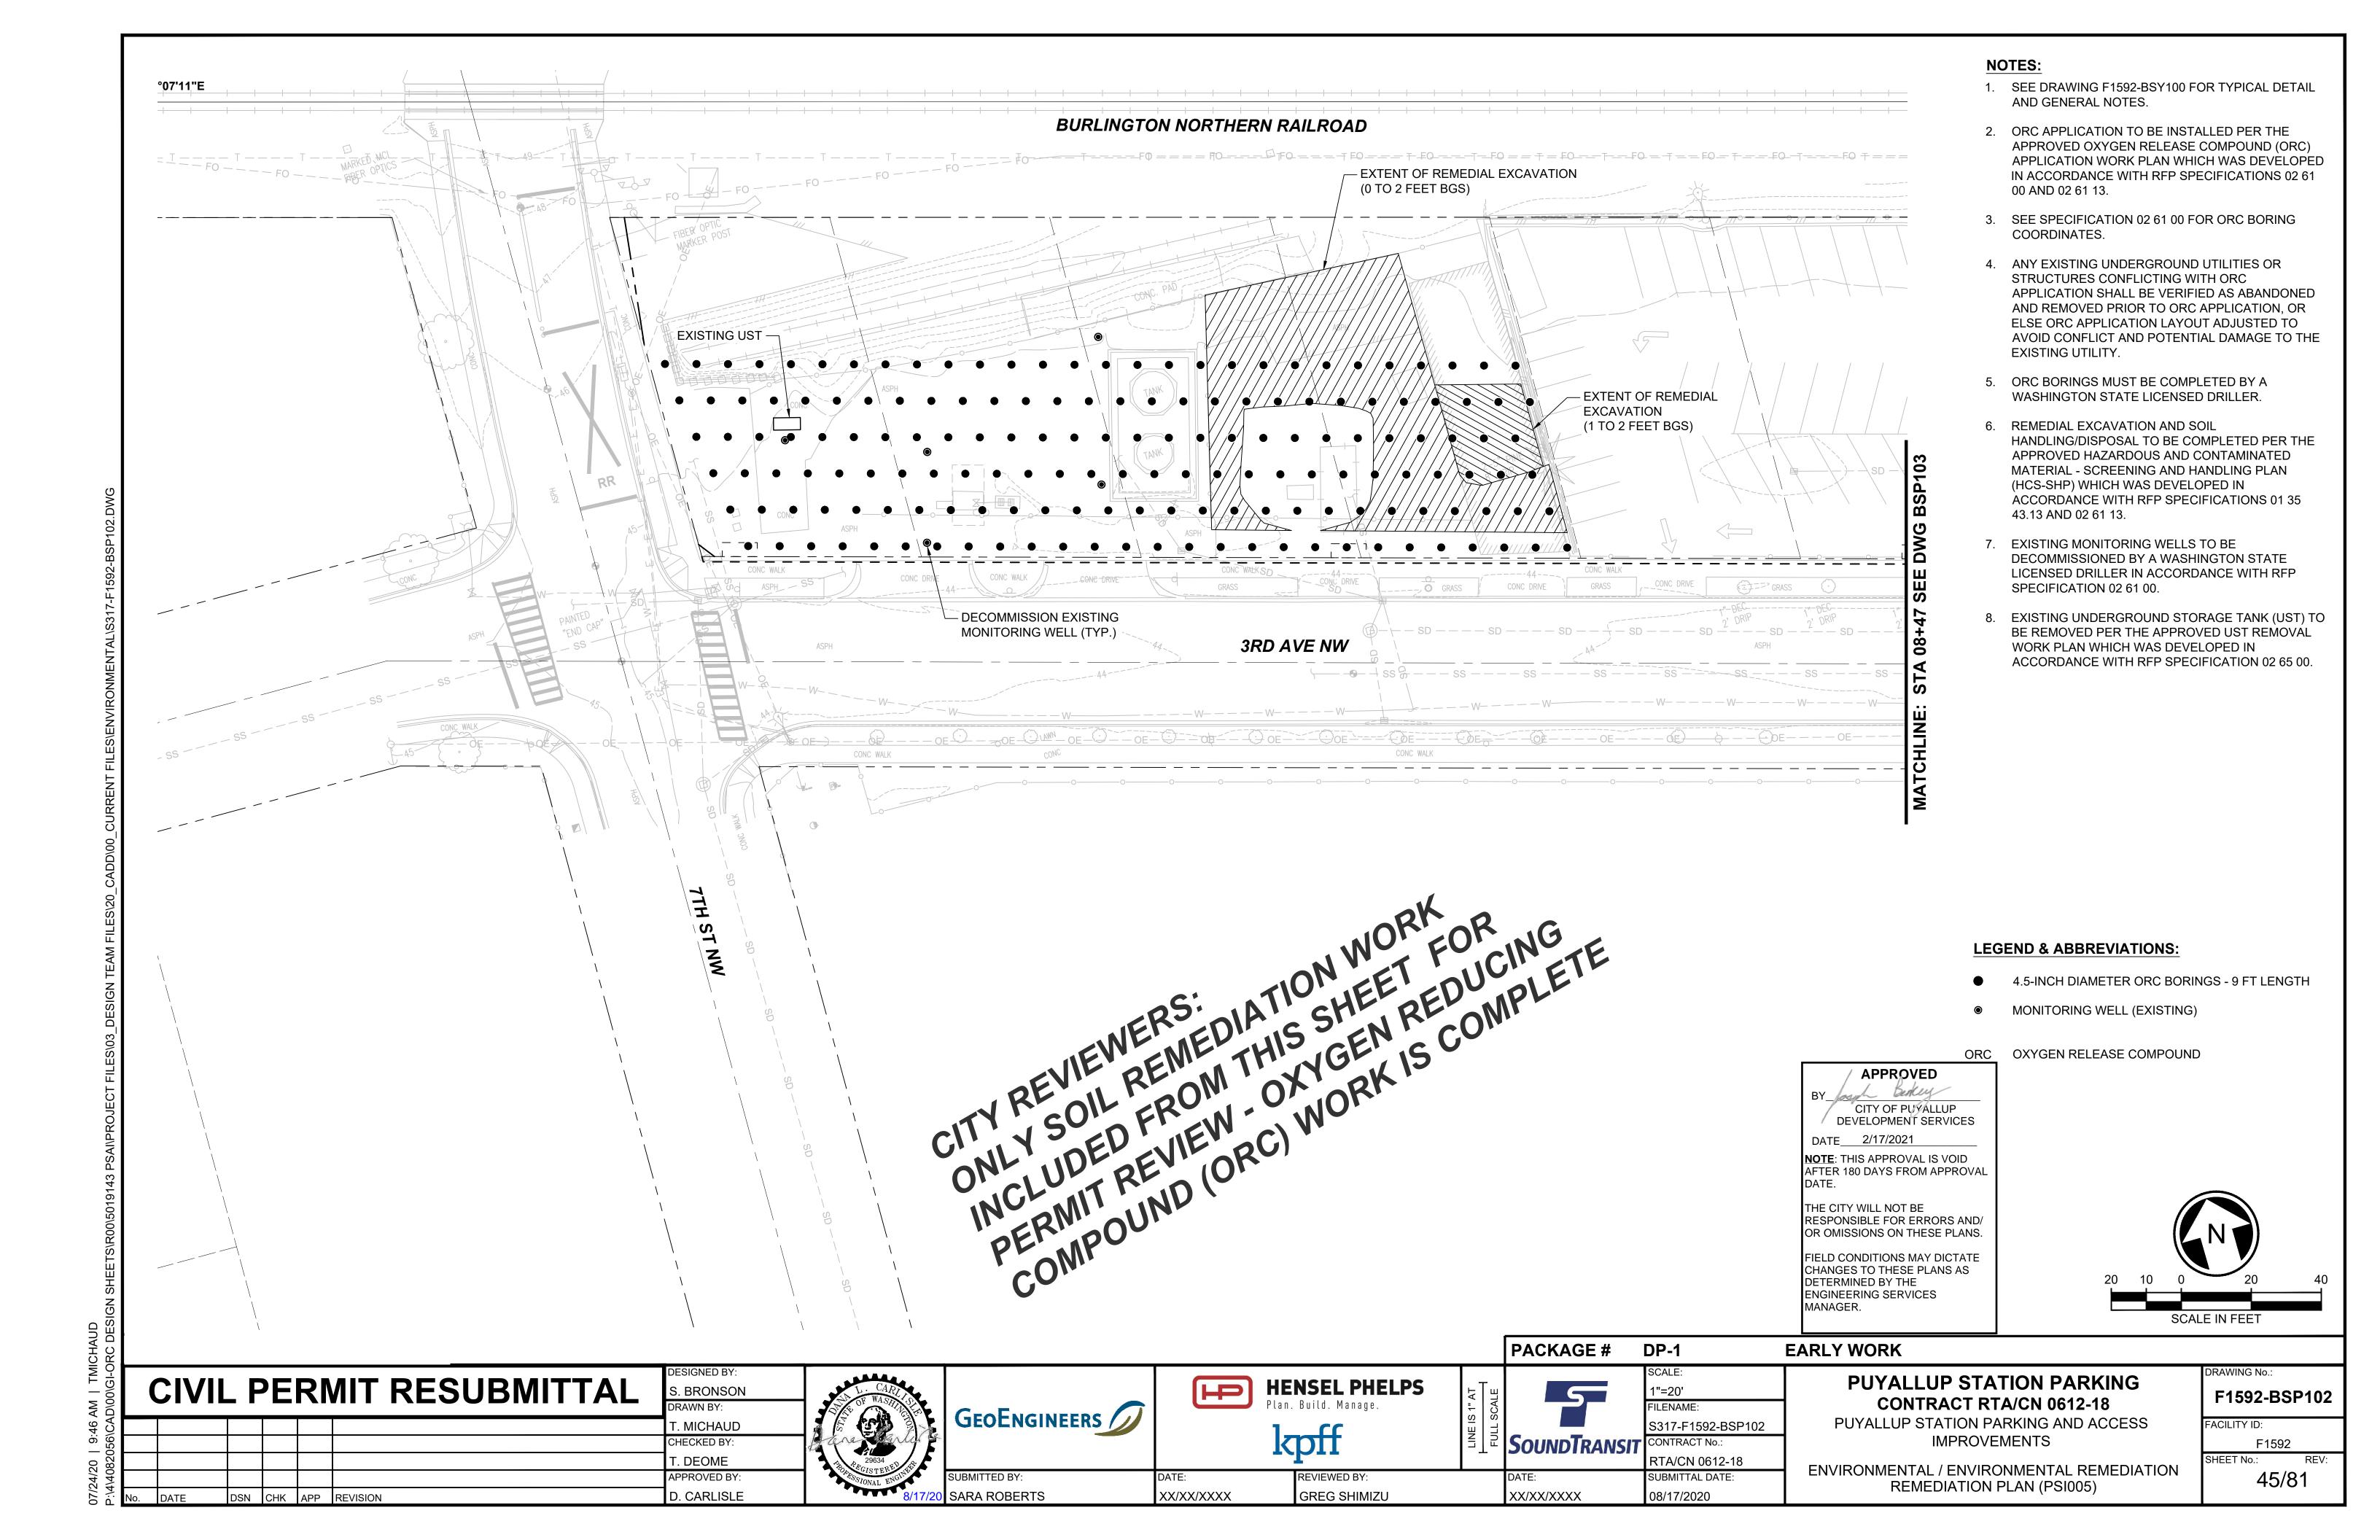
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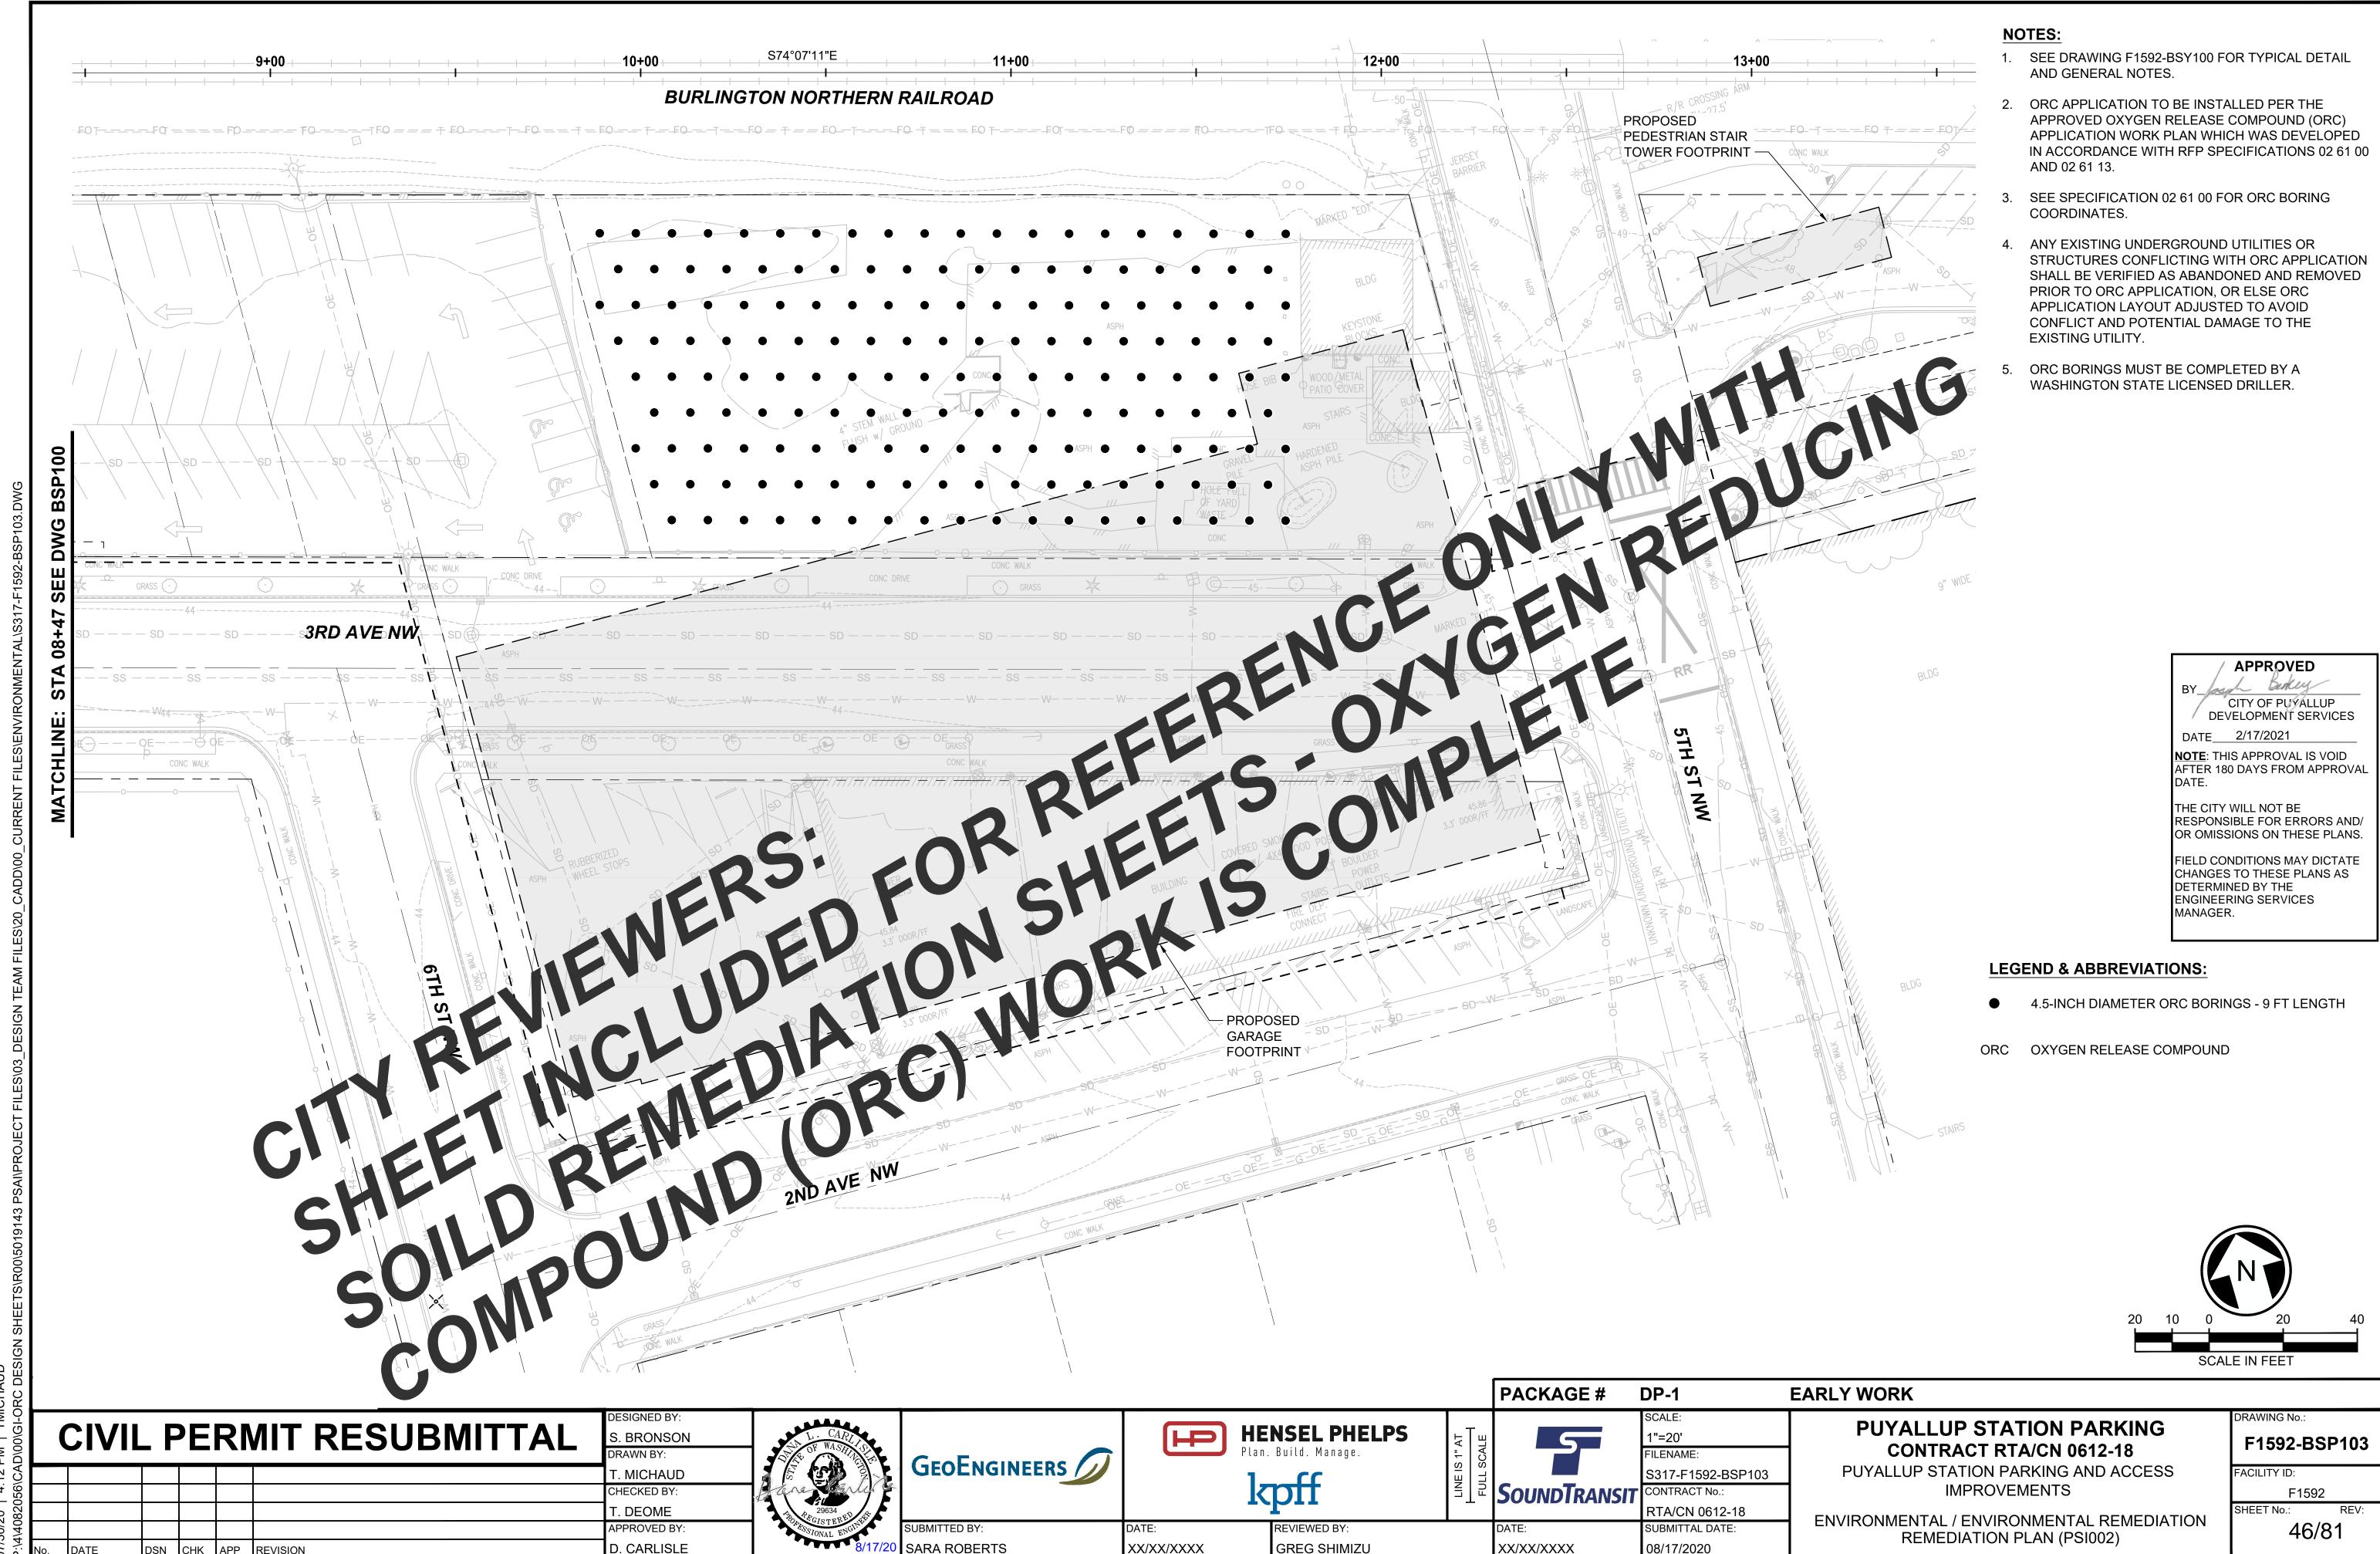
SUBMITTAL DATE 01/27/2021

CIVIL UTILITY DETAILS 40 42/81








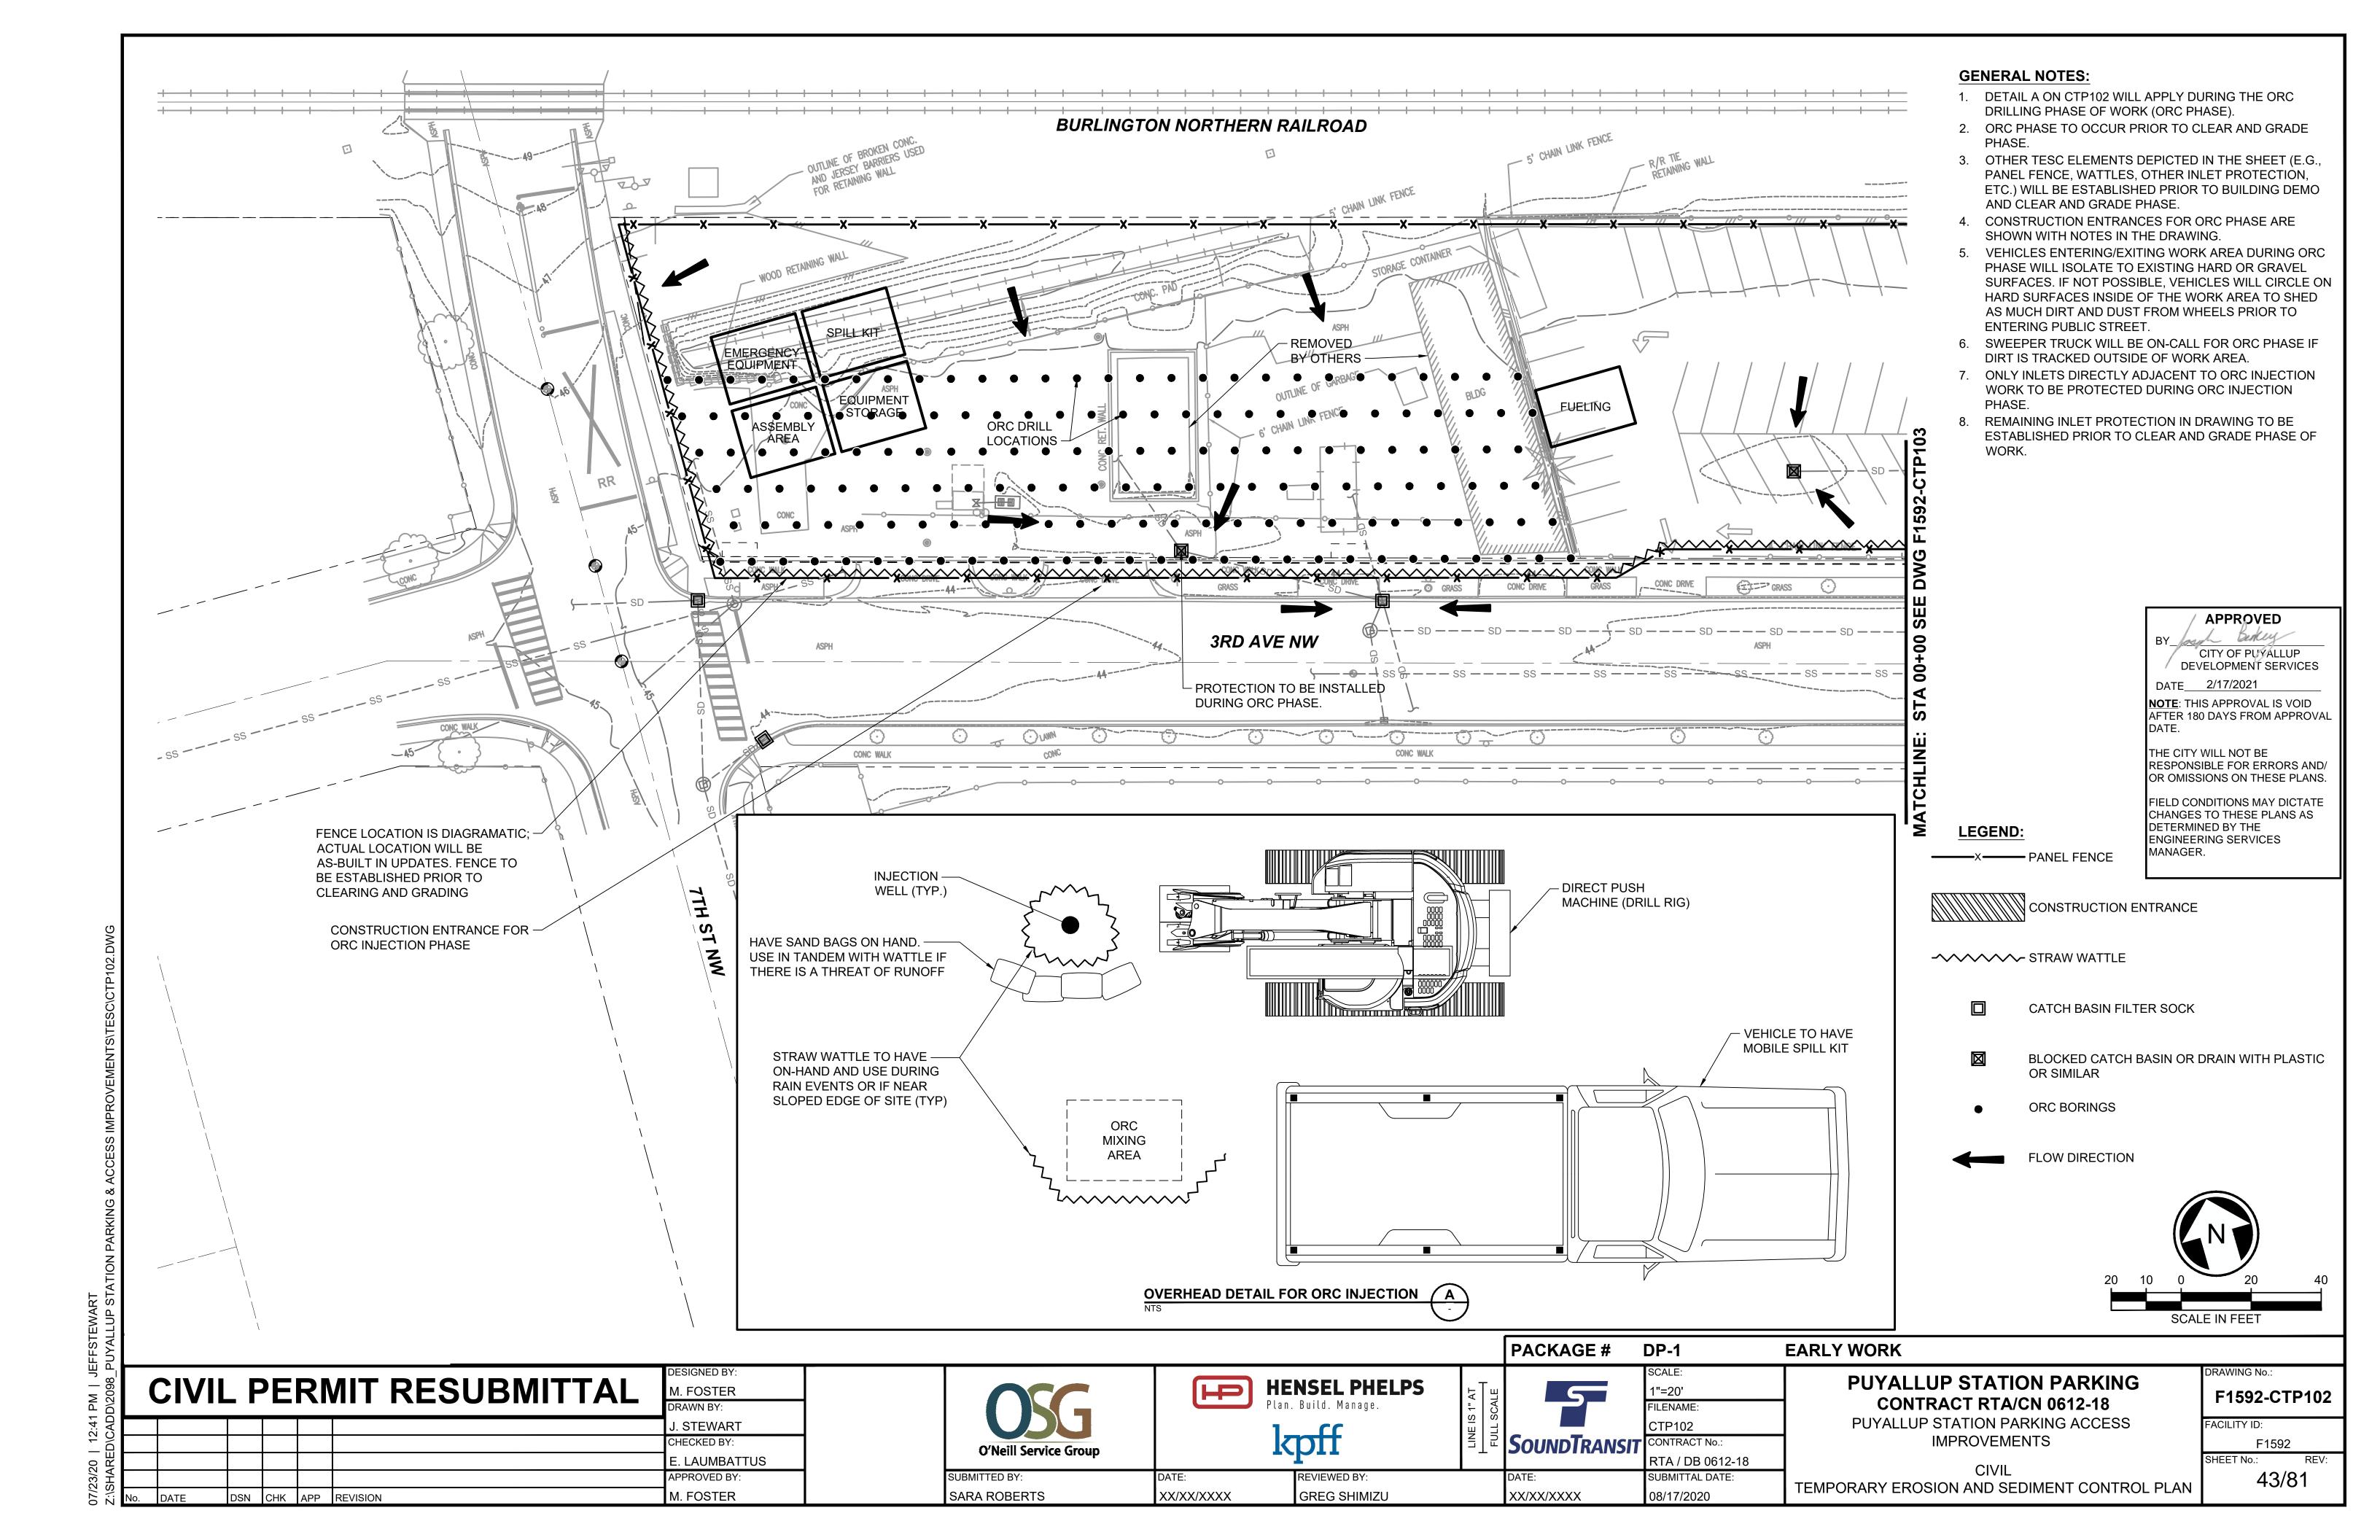

07/30/20 | 4·12 PM | TMICHALID

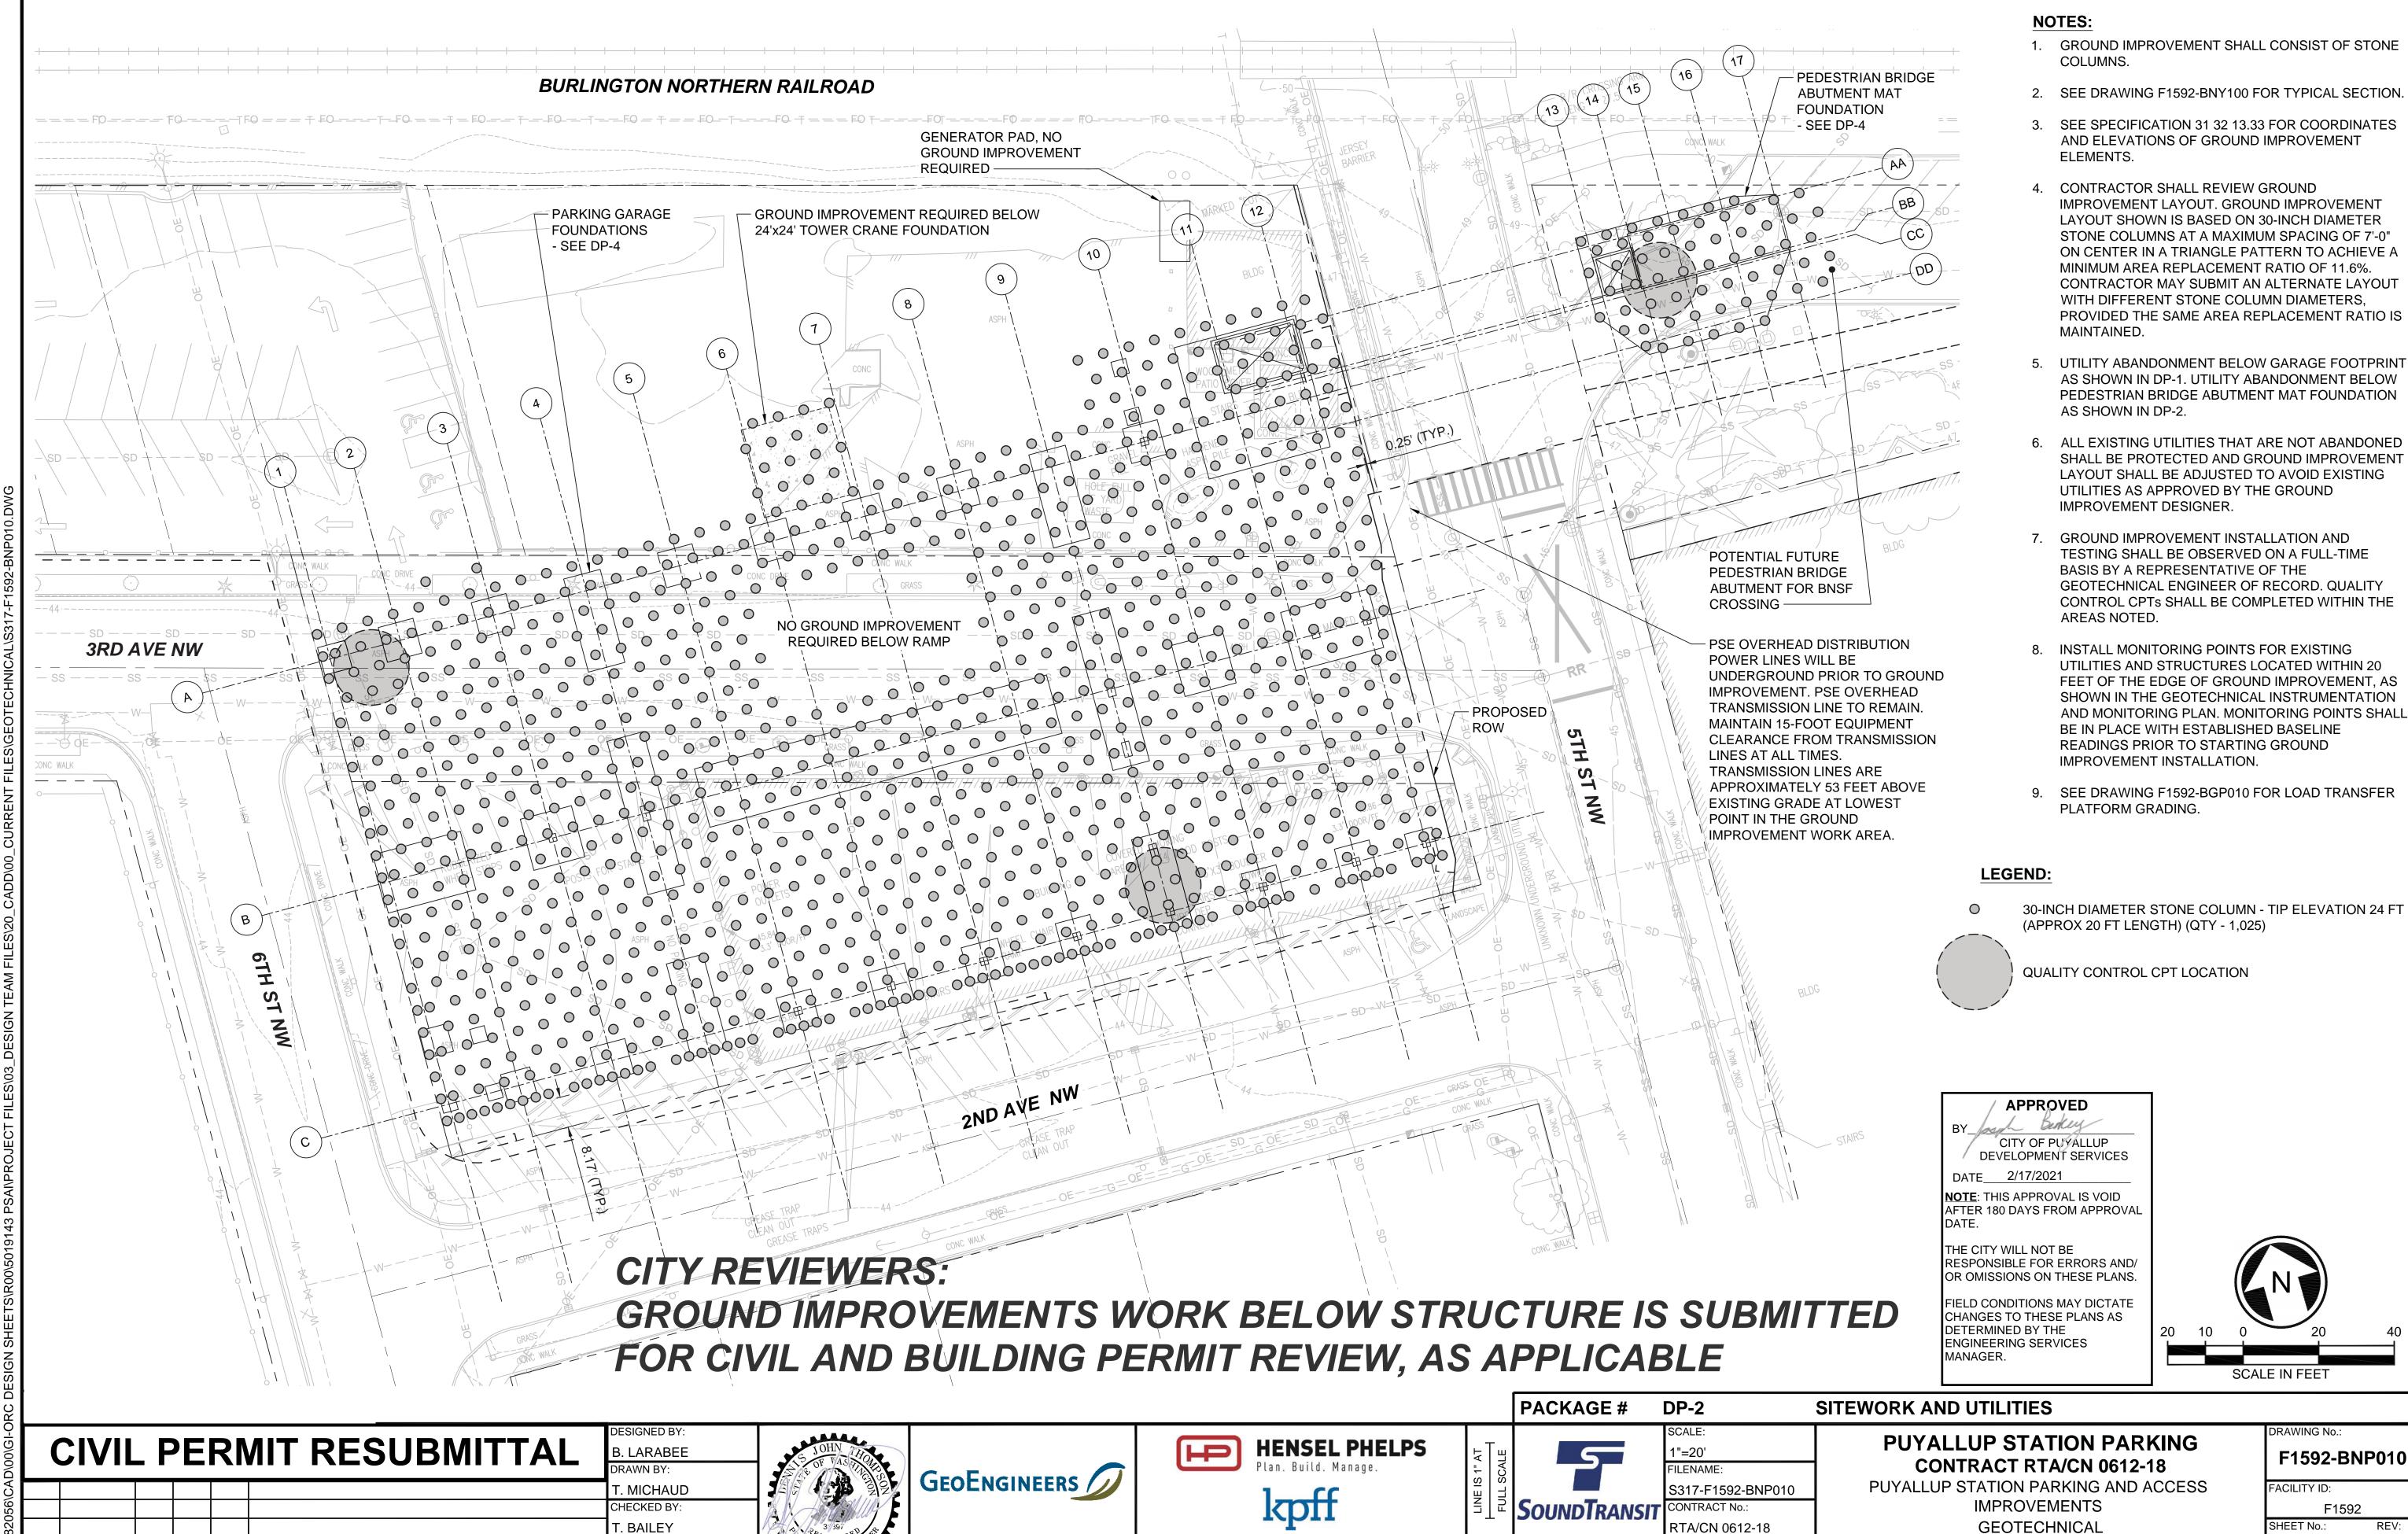

XX/XX/XXXX

GREG SHIMIZU

GROUND IMPROVEMENT LAYOUT

GARAGE AND PEDESTRIAN BRIDGE

SUBMITTAL DATE

XX/XX/XXXX


47/81


08/26/20 | 9:31 AM | TMICHAUD

APPROVED BY

D. THOMPSON

SARA ROBERTS

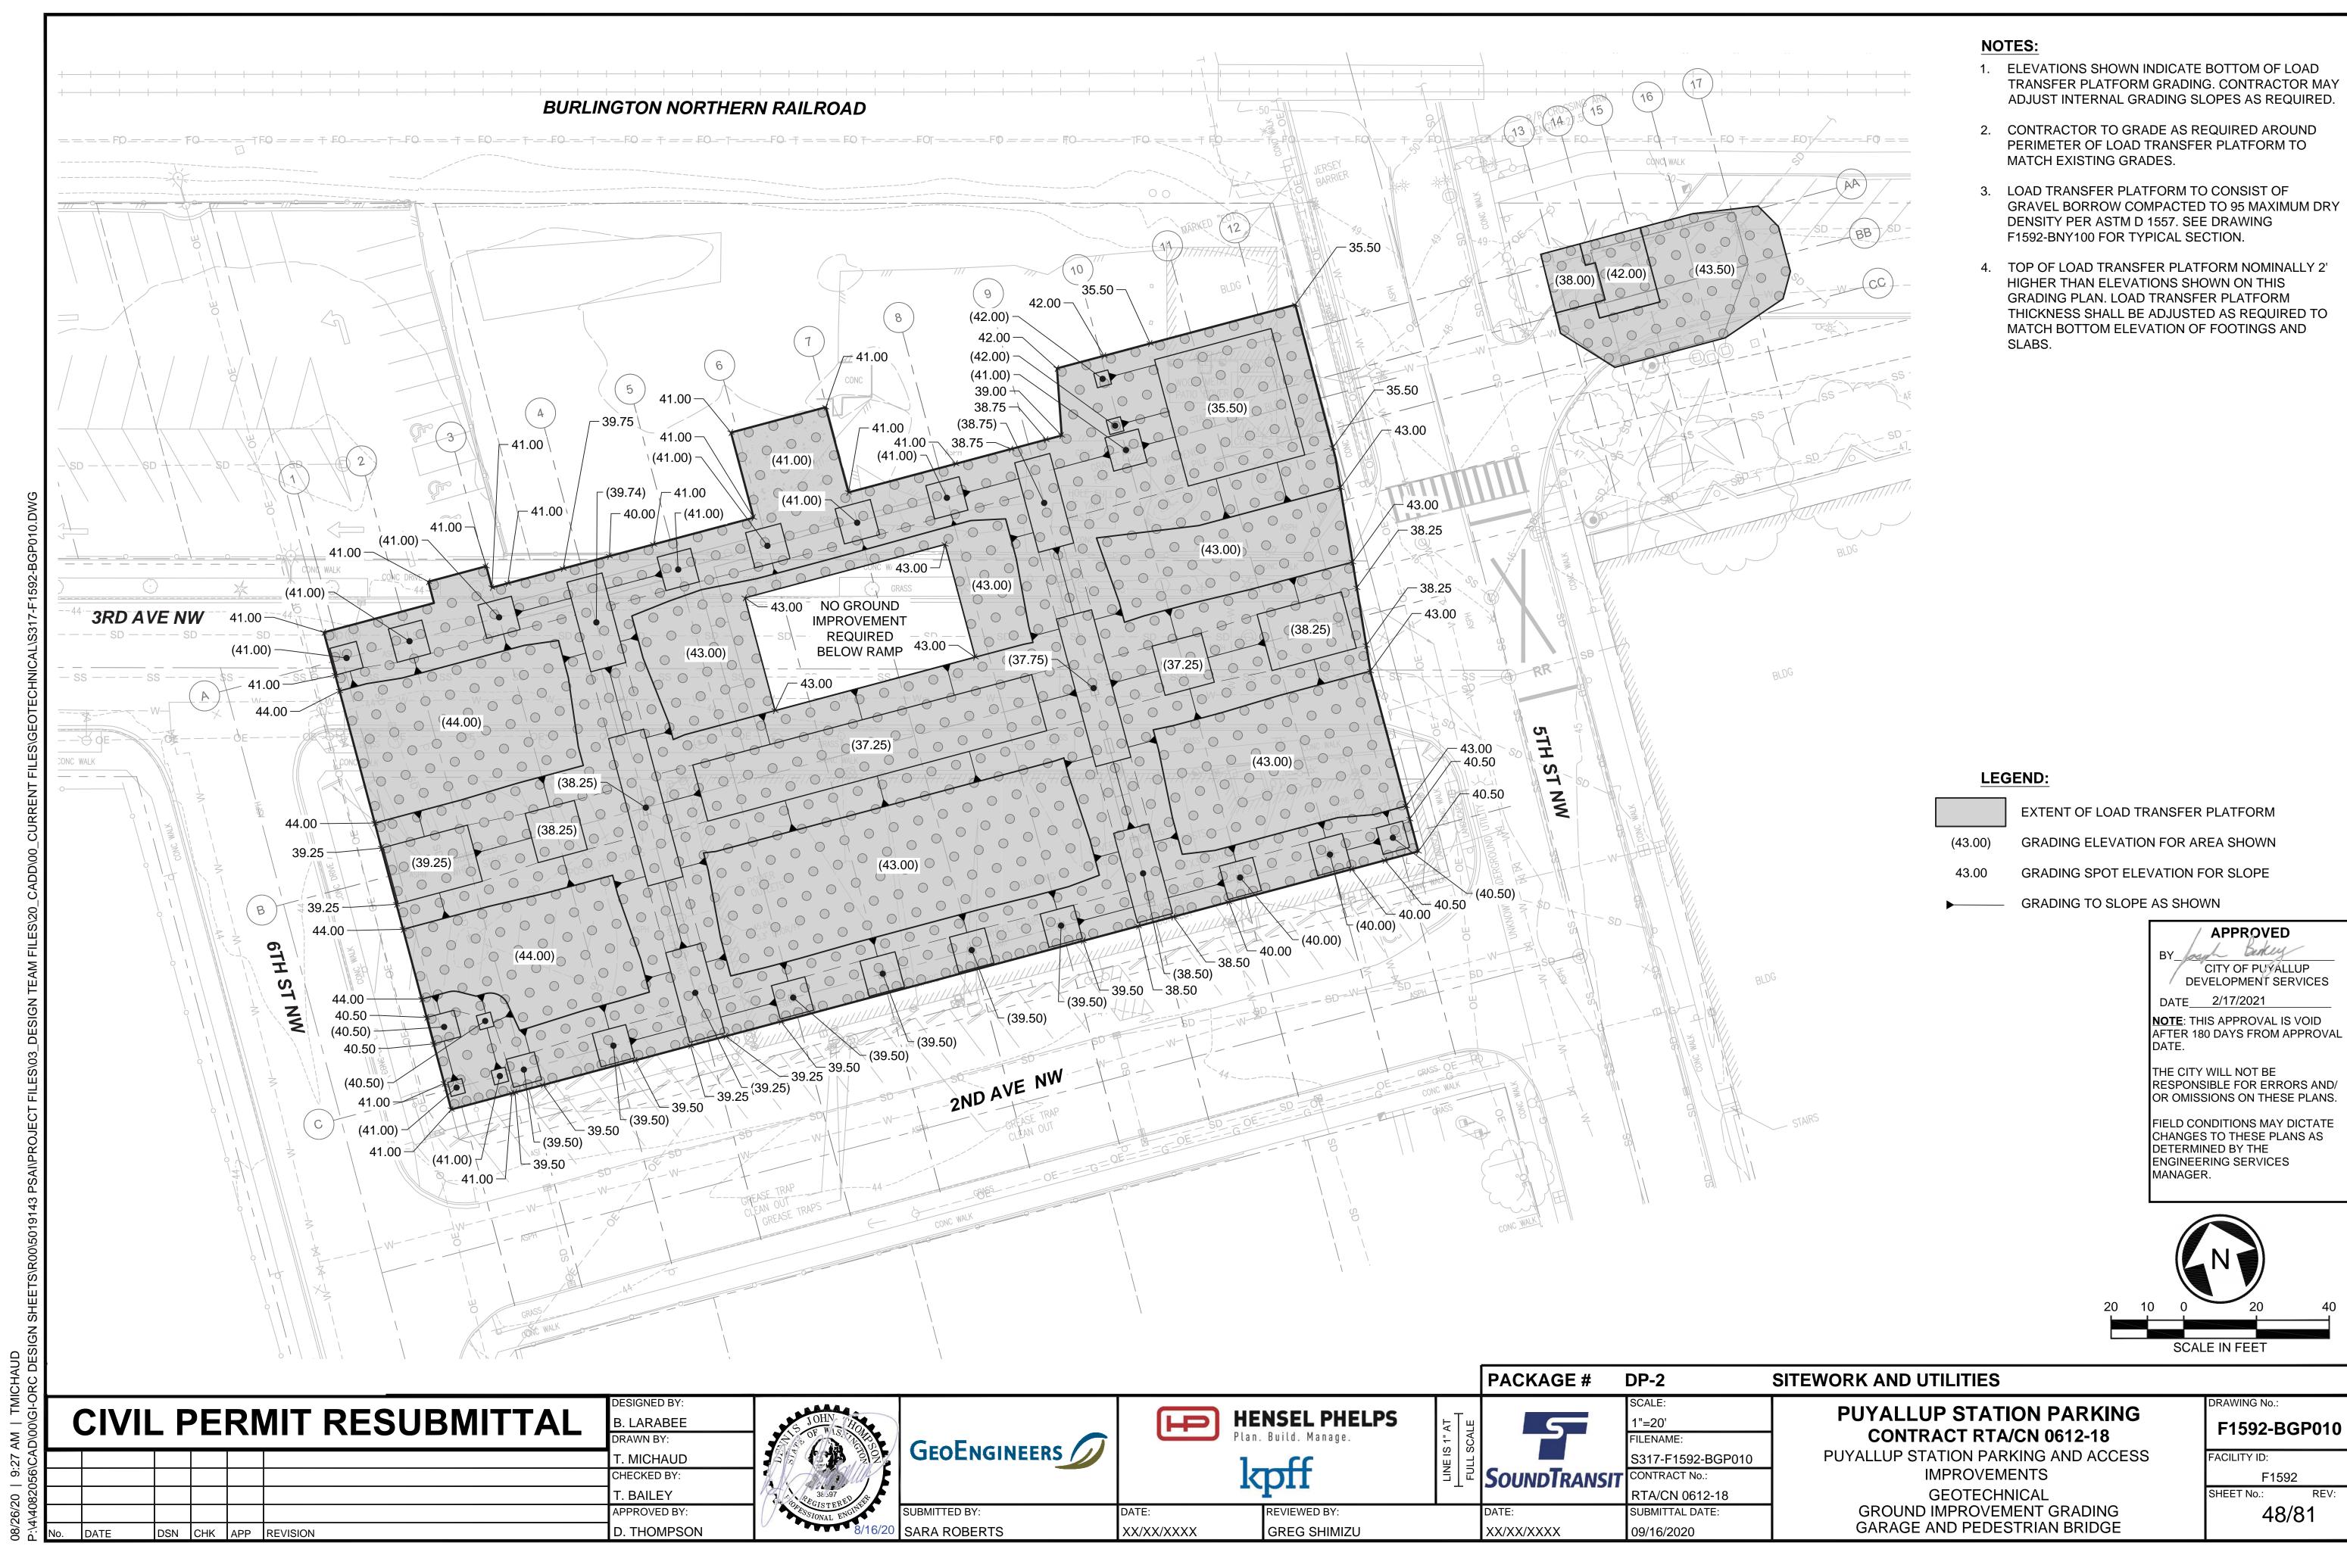

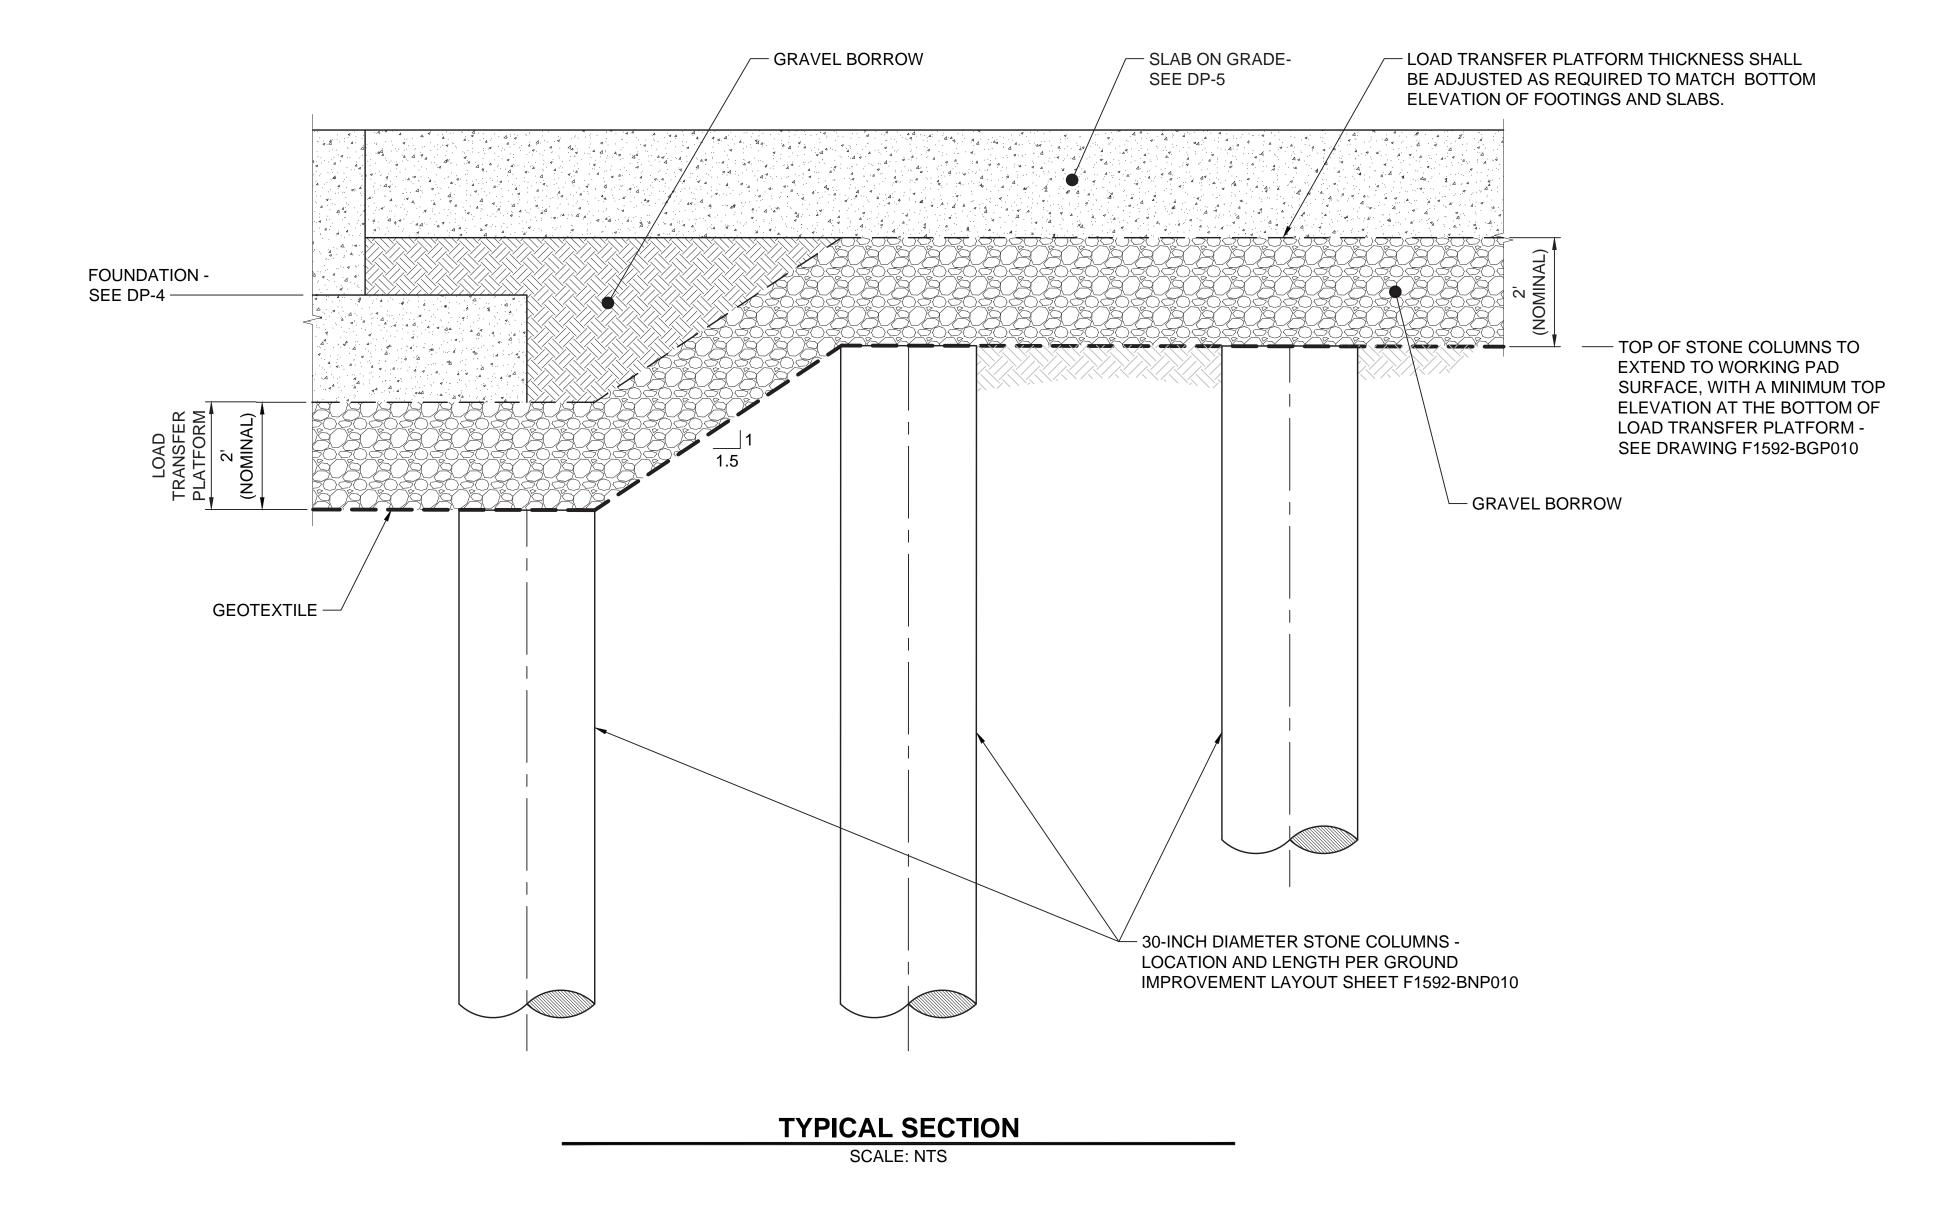

D. THOMPSON

NOTES:

- 1. GROUND IMPROVEMENT SHALL CONSIST OF STONE COLUMNS.
- 2. SEE DRAWING F1592-BNP010 FOR GROUND IMPROVEMENT LAYOUT.
- 3. SEE SPECIFICATION 31 32 13.33 FOR COORDINATES AND ELEVATIONS OF GROUND IMPROVEMENT ELEMENTS.
- 4. CONTRACTOR SHALL COMPACT SUBGRADE SOILS BELOW THE LOAD TRANSFER PLATFORM TO FIRM CONDITIONS PRIOR TO CONSTRUCTING THE LOAD TRANSFER PLATFORM. SEE DRAWING F1592-BGP010 FOR LOAD TRANSFER PLATFORM GRADING.
- 5. ALL EXISTING UTILITIES SHALL BE PROTECTED AND GROUND IMPROVEMENT LAYOUT SHALL BE ADJUSTED TO AVOID EXISTING UTILITIES AS APPROVED BY THE GROUND IMPROVEMENT DESIGNER.

APPROVED CITY OF PUYALLUP DEVELOPMENT SERVICES DATE____2/17/2021

NOTE: THIS APPROVAL IS VOID AFTER 180 DAYS FROM APPROVAL

THE CITY WILL NOT BE RESPONSIBLE FOR ERRORS AND/ OR OMISSIONS ON THESE PLANS.

FIELD CONDITIONS MAY DICTATE CHANGES TO THESE PLANS AS DETERMINED BY THE ENGINEERING SERVICES MANAGER.

PACKAGE # DP-2 SITEWORK AND UTILITIES RAWING No.: **CIVIL PERMIT RESUBMITTAL PUYALLUP STATION PARKING HENSEL PHELPS** H B. LARABEE NTS F1592-BNY100 CONTRACT RTA/CN 0612-18 Plan. Build. Manage. ILENAME: GEOENGINEERS PUYALLUP STATION PARKING AND ACCESS FACILITY ID: Γ. MICHAUD S317-F1592-BNY100 kpff **IMPROVEMENTS** SOUNDTRANSIT CONTRACT No.: CHECKED BY: F1592 RTA/CN 0612-18 T. BAILEY GEOTECHNICAL 49/81 APPROVED BY: REVIEWED BY: SUBMITTAL DATE: GROUND IMPROVEMENT DETAILS GREG SHIMIZU SARA ROBERTS

XX/XX/XXXX

09/16/2020

XX/XX/XXXX

DSN CHK APP REVISION

EQ


EQUAL

HARDSCAPE ABBREVIATIONS

#/NO	NUMBER	EX	EXISTING
%	PERCENT	FG	FINISH GRADE
&	AND	HORIZ	HORIZONTAL
~	APPROXIMATELY	HMA	HOT MIX ASPHALT
@	AT	MAX	MAXIMUM
APPROX	APPROXIMATE	MIN	MINIMUM
CL	CENTERLINE	NTS	NOT TO SCALE
CLR	CLEAR	OC	ON CENTER
CONC	CONCRETE	SPEC(S)	SPECIFICATION(S)
CONT	CONTINUOUS	SS	STAINLESS STEEL
DEG	DEGREE	STA	STATION
DIA	DIAMETER	TYP	TYPICAL
DWG(S)	DRAWING(S)	W/	WITH

HARDSCAPE NOTES

- 1. ANY DISCREPANCIES WITH THE DWGS AND/OR SPECS & SITE CONDITIONS MUST BE BROUGHT TO THE ATTENTION OF RESIDENT ENGINEER PRIOR TO PROCEEDING WITH CONSTRUCTION.
- 2. THE CONTRACTOR IS RESPONSIBLE FOR LOCATING UTILITIES PRIOR TO BEGINNING CONSTRUCTION.
- 3. RESIDENT ENGINEER MUST INSPECT MATERIALS AND STAKING LOCATIONS PRIOR TO INSTALLATION OF ALL HARDSCAPE ELEMENTS.
- 4. CONTRACTOR MUST BE RESPONSIBLE FOR ANY COORDINATION WITH SUB-CONTRACTORS AS REQUIRED TO ACCOMPLISH CONSTRUCTION OPERATIONS.

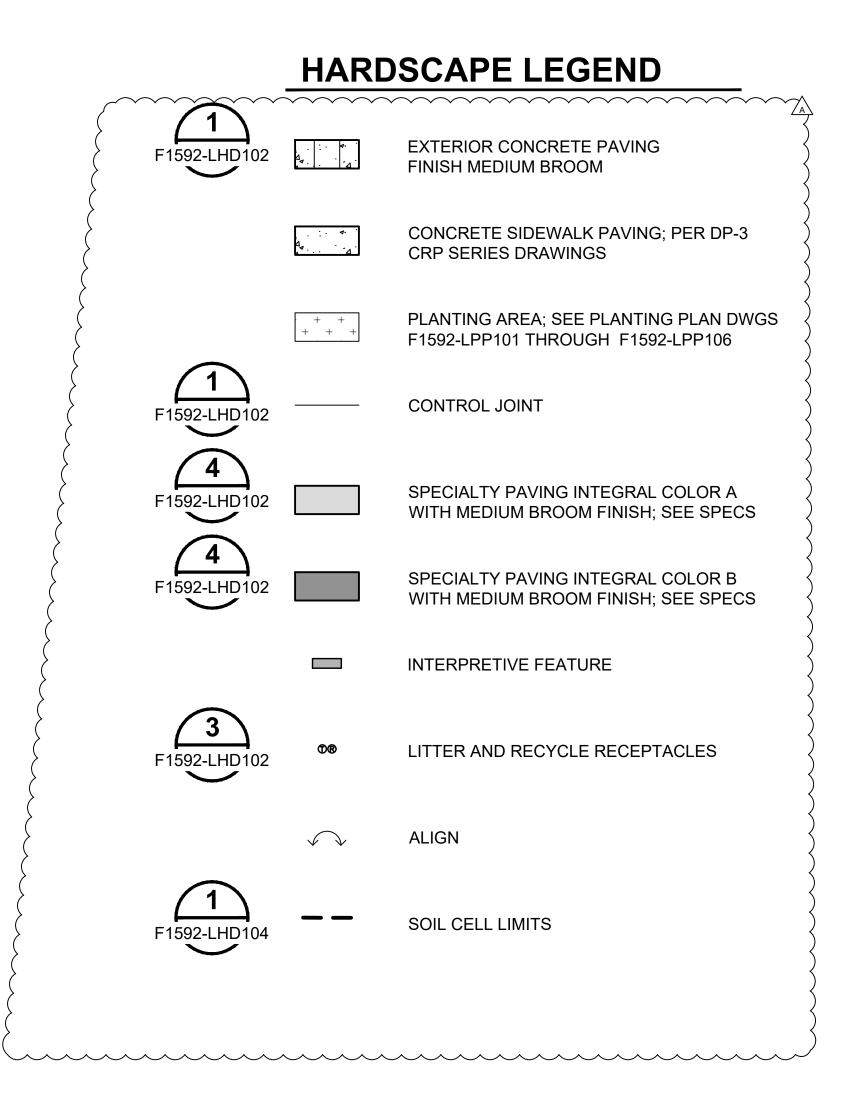


CITY OF PUYALLUP Planning Division Approved Landscape Plan (253) 864-4165

THIS APPROVAL IS VOID AFTER 180 DAYS FROM APPROVAL DATE. THE CITY IS NOT RESPONSIBLE FOR ERRORS OR OMISSIONS ON THESE PLANS. FIELD CONDITIONS MAY DICTATE CHANGES TO THESE PLANS AS DETERMINED BY THE PLANNING DIRECTOR, DESIGNEE, OR PROJECT PLANNER.

NOTE: If street trees are required, Call Planning Division for final inspection: (253) 864-4165 (Option 3) Root barriers are required around street trees in accordance with city standard detail. Top soil shall be installed in accordance with city standards - field verification required. Failure to install top soil and root barriers in accordance with the city standards may result in rejection of installation.

CIVIL PERMIT RESUBMITTAL P. MAGINNITY CHECKED BY . VONG A 01/08/2021 RD JV JV REVISIONS FOR CITY PERMIT E-20-0504 APPROVED BY J. VONG

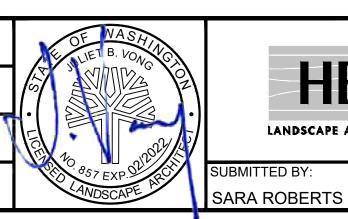

HBB LANDSCAPE ARCHITECTURE



01/08/2021



REVIEWED BY:

GREG SHIMIZU

DATE:

01/08/2021

PACKAGE #

NTS FILENAME: S317-F1592-LHN100 **SOUNDTRANSIT** CONTRACT No.: RTA/CN 0612-18

DP-2

SUBMITTAL DATE:

01/08/2021

PUYALLUP STATION PARKING CONTRACT RTA/CN 0612-18

SITEWORK AND UTILITIES

PUYALLUP STATION PARKING AND ACCESS **IMPROVEMENTS**


LANDSCAPE HARDSCAPE

DRAWING No.: F1592-LHN100

F1592 50/81

FACILITY ID:

GENERAL NOTES, LEGEND, AND ABBREVIATIONS

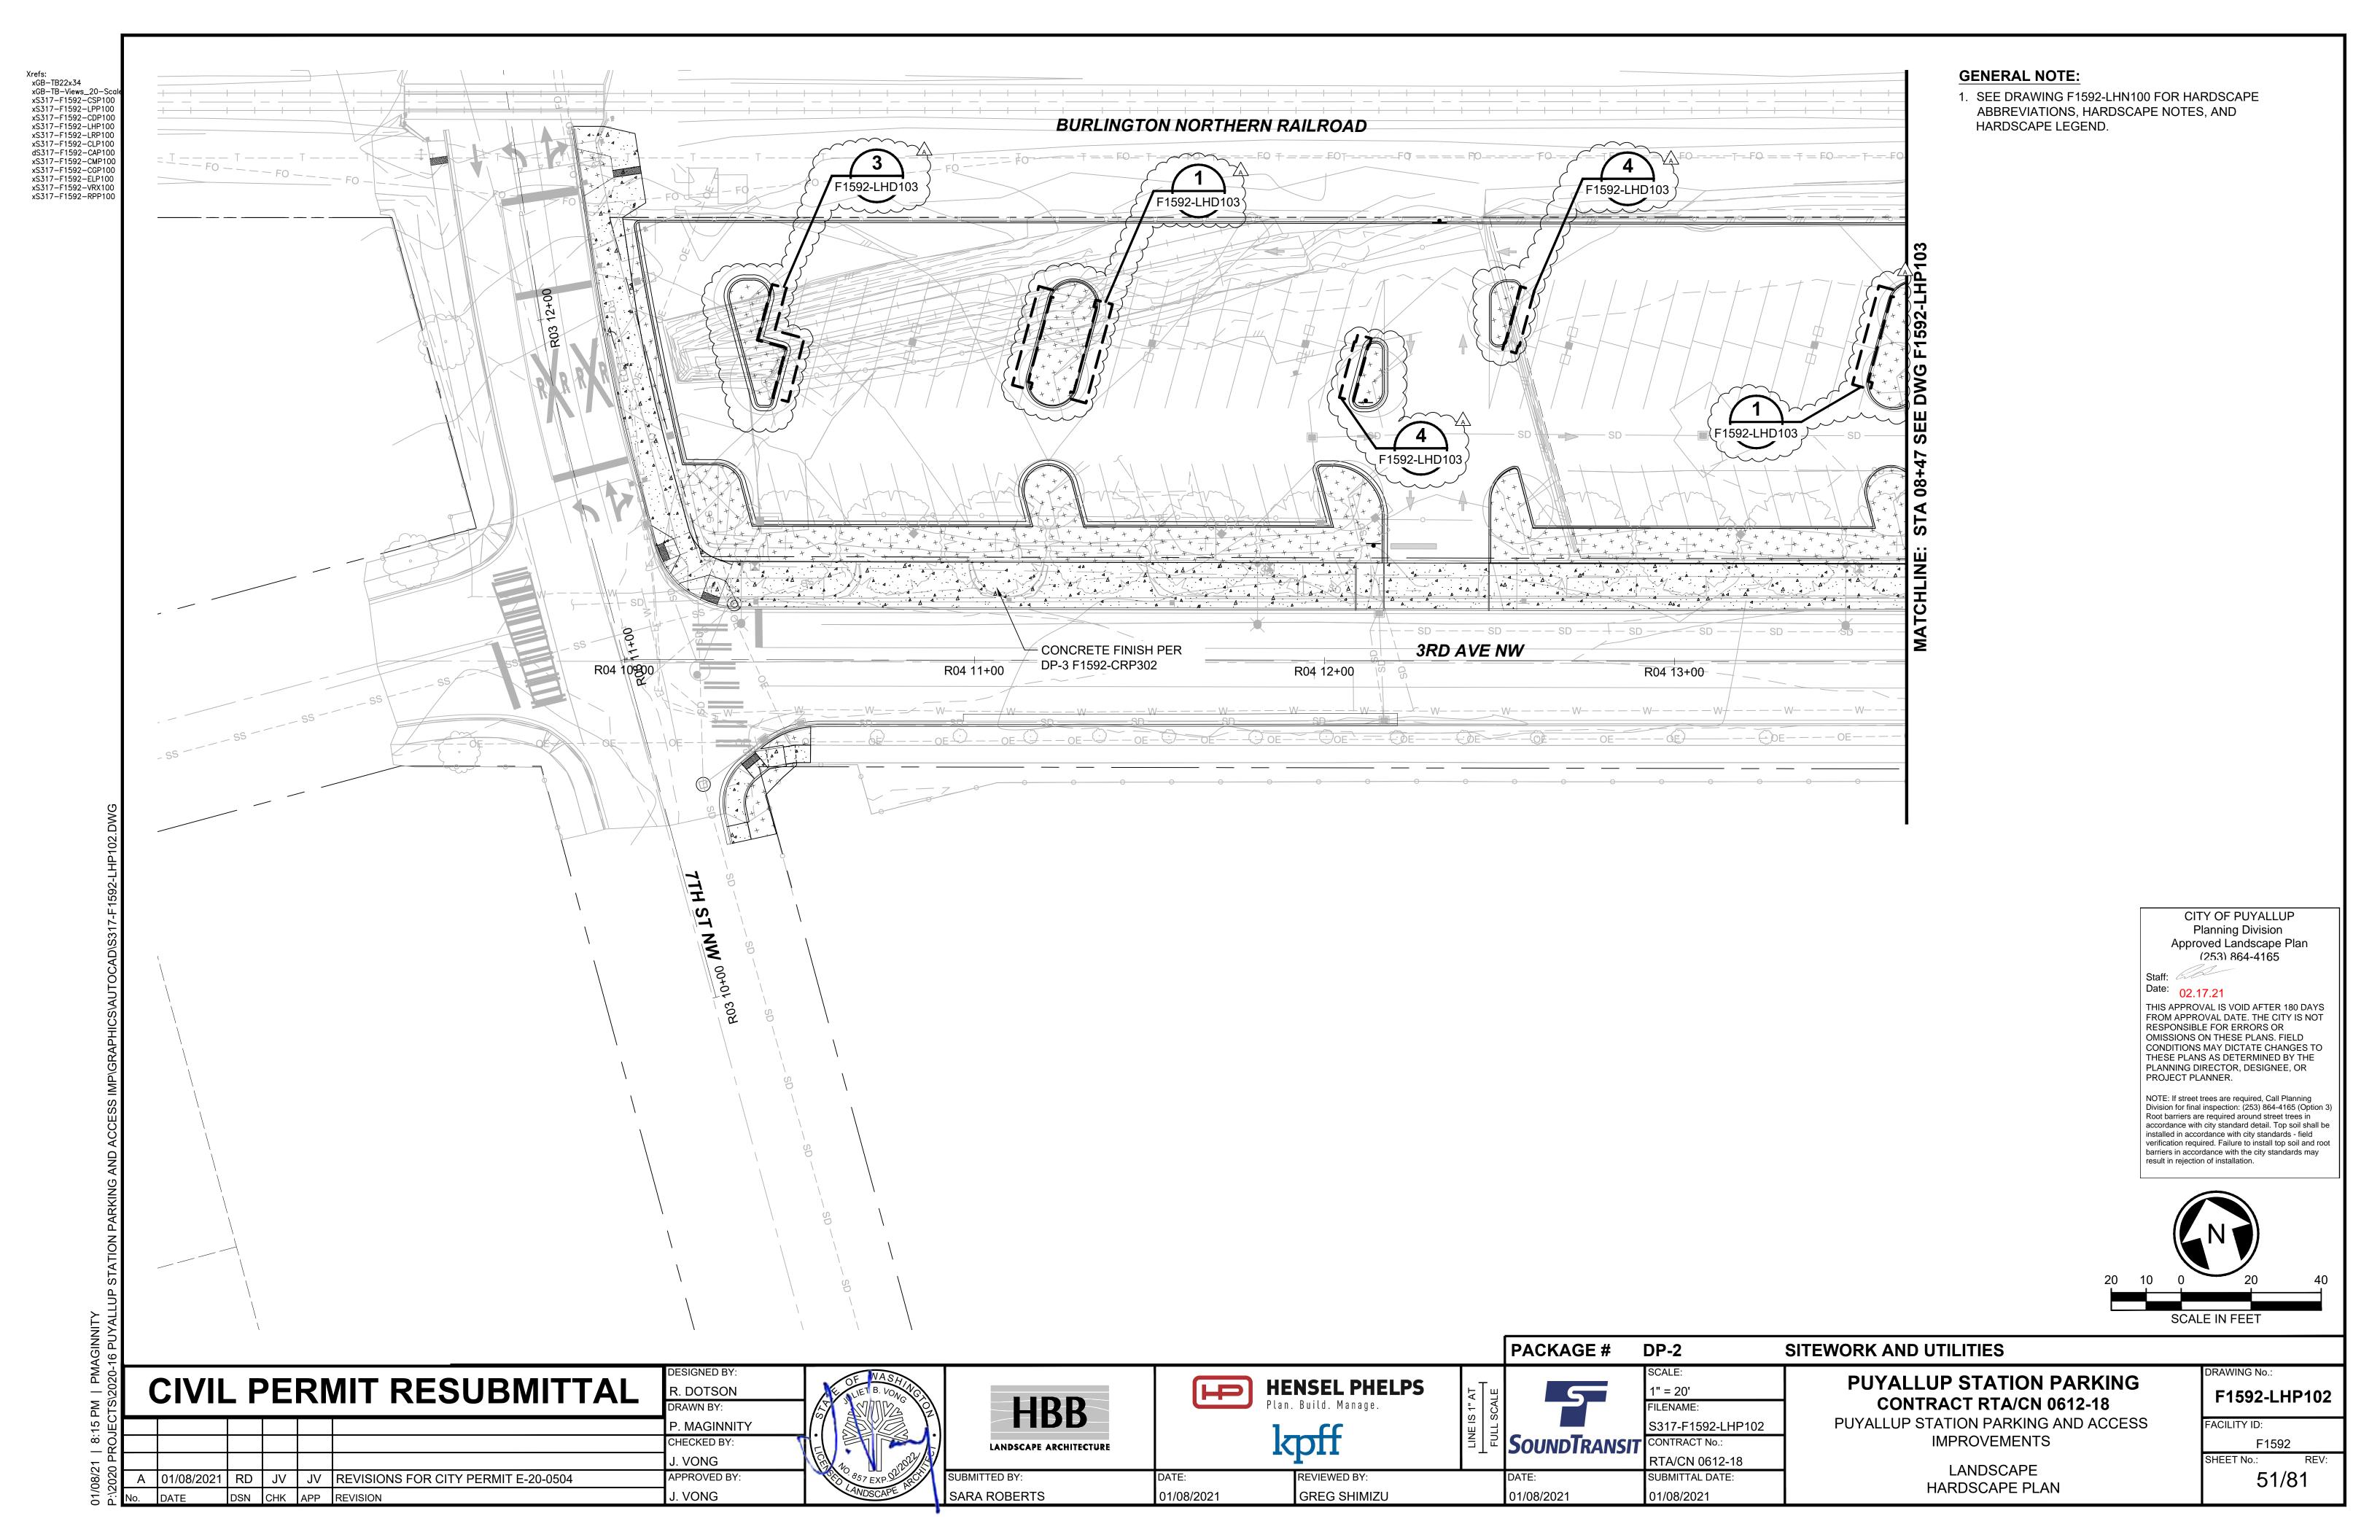

GENERAL NOTES: Xrefs: xGB-TB22x34 xGB-TB-Views_20-S 1. SEE DRAWING F1592-LHN100 FOR HARDSCAPE xS317-F1592-CSP100 xS317-F1592-LPP100 ABBREVIATIONS, HARDSCAPE NOTES, AND F1592-LHD1 xS317-F1592-CDP100 BURLINGTON NORTHERN RAILROAD HARDSCAPE LEGEND. xS317-F1592-LHP100 HEQ xS317-F1592-LRP100 xS317-F1592-CLP100 2. UNLESS OTHERWISE NOTED, ALL ANGLES ARE xS317-F1592-UWP100 90 DEGREES. dS317-F1592-CAP100 xS317-F1592-UCP100 PATTERN IN THIS xS317-F1592-CMP100 CONTINUE CONTROL JOINTS TO EDGE OF ALL F1592-LHD103 xS317-F1592-CGP100 VAULTS, LIGHT POLE BASE, CURBS, PAVERS, xS317-F1592-ELP100 xS317-F1592-TSP100 HANDHOLES, AND FOUNDATIONS. F1592-LHD103 xS317-F1592-CPP100 xS317-F1592-UPP100 ALIGN UTILITY VAULTS, JUNCTION BOXES xS317-F1592-APP101 xS317-F1592-VRX100 F1592-LHD10 SQUARE WITH ADJACENT CURBS AND CONTROL JOINTS. **CONSTRUCTION JOINTS SPACED AT 15'** ON-CENTER MAXIMUM PER CITY OF PUYALLUP STANDARD PLAN 01.02.01. EQ SPACE JOINTS --@-3.00' OC EQSPACE LEQ SPACE JOINTS @ ~3.50' JOINTS @ ~2.50' OC EQ SPACE JOINTS CONCRETE FINISH AND SCORING PER DP-3 F1592-CRP303 3RD AVE NW R04 14+00 BEGIN CONCRETE FINISH AND SCORING PER DP-3 F1592-CRP303 WEST OF THIS LOCATION -INTERPRETIVE FEATURE, TYP **BROOM FINISH DIRECTION** AS SHOWN, TYP CITY OF PUYALLUP Planning Division Approved Landscape Plan ~3.25' SQUARE OC (253) 864-4165 JOINT PATTERN, TYP -Date: 02.17.21 THIS APPROVAL IS VOID AFTER 180 DAYS FROM APPROVAL DATE. THE CITY IS NOT RESPONSIBLE FOR ERRORS OR OMISSIONS ON THESE PLANS. FIELD CONDITIONS MAY DICTATE CHANGES TO THESE PLANS AS DETERMINED BY THE PLANNING DIRECTOR, DESIGNEE, OR R05 12+00 F1592-LHD102 PROJECT PLANNER. NOTE: If street trees are required, Call Planning Division for final inspection: (253) 864-4165 (Option 3) EQ SPACE RAMP PER JOINTS @ Root barriers are required around street trees in accordance with city standard detail. Top soil shall be F1592-CRP303 AND installed in accordance with city standards - field DP-5 F1592-APP101 verification required. Failure to install top soil and root barriers in accordance with the city standards may result in rejection of installation. **ADJUST GRID** PATTERN IN THIS AREA AS NEEDED -~3.25' SQUARE OC JOINT PATTERN, TYP SCALE IN FEET PACKAGE # DP-2 SITEWORK AND UTILITIES RAWING No.: **CIVIL PERMIT RESUBMITTAL PUYALLUP STATION PARKING HENSEL PHELPS** H R. DOTSON 1" = 20' F1592-LHP103 **HBB CONTRACT RTA/CN 0612-18** Plan. Build. Manage. ILENAME: PUYALLUP STATION PARKING AND ACCESS FACILITY ID: P. MAGINNITY S317-F1592-LHP103 **IMPROVEMENTS S**OUND**T**RANSIT CHECKED BY CONTRACT No. F1592 LANDSCAPE ARCHITECTURE . VONG RTA/CN 0612-18 LANDSCAPE JV JV REVISIONS FOR CITY PERMIT E-20-0504 52/81 APPROVED BY REVIEWED BY: SUBMITTAL DATE: RD

01/08/2021

GREG SHIMIZU


01/08/2021

01/08/2021

HARDSCAPE PLAN

J. VONG

SARA ROBERTS

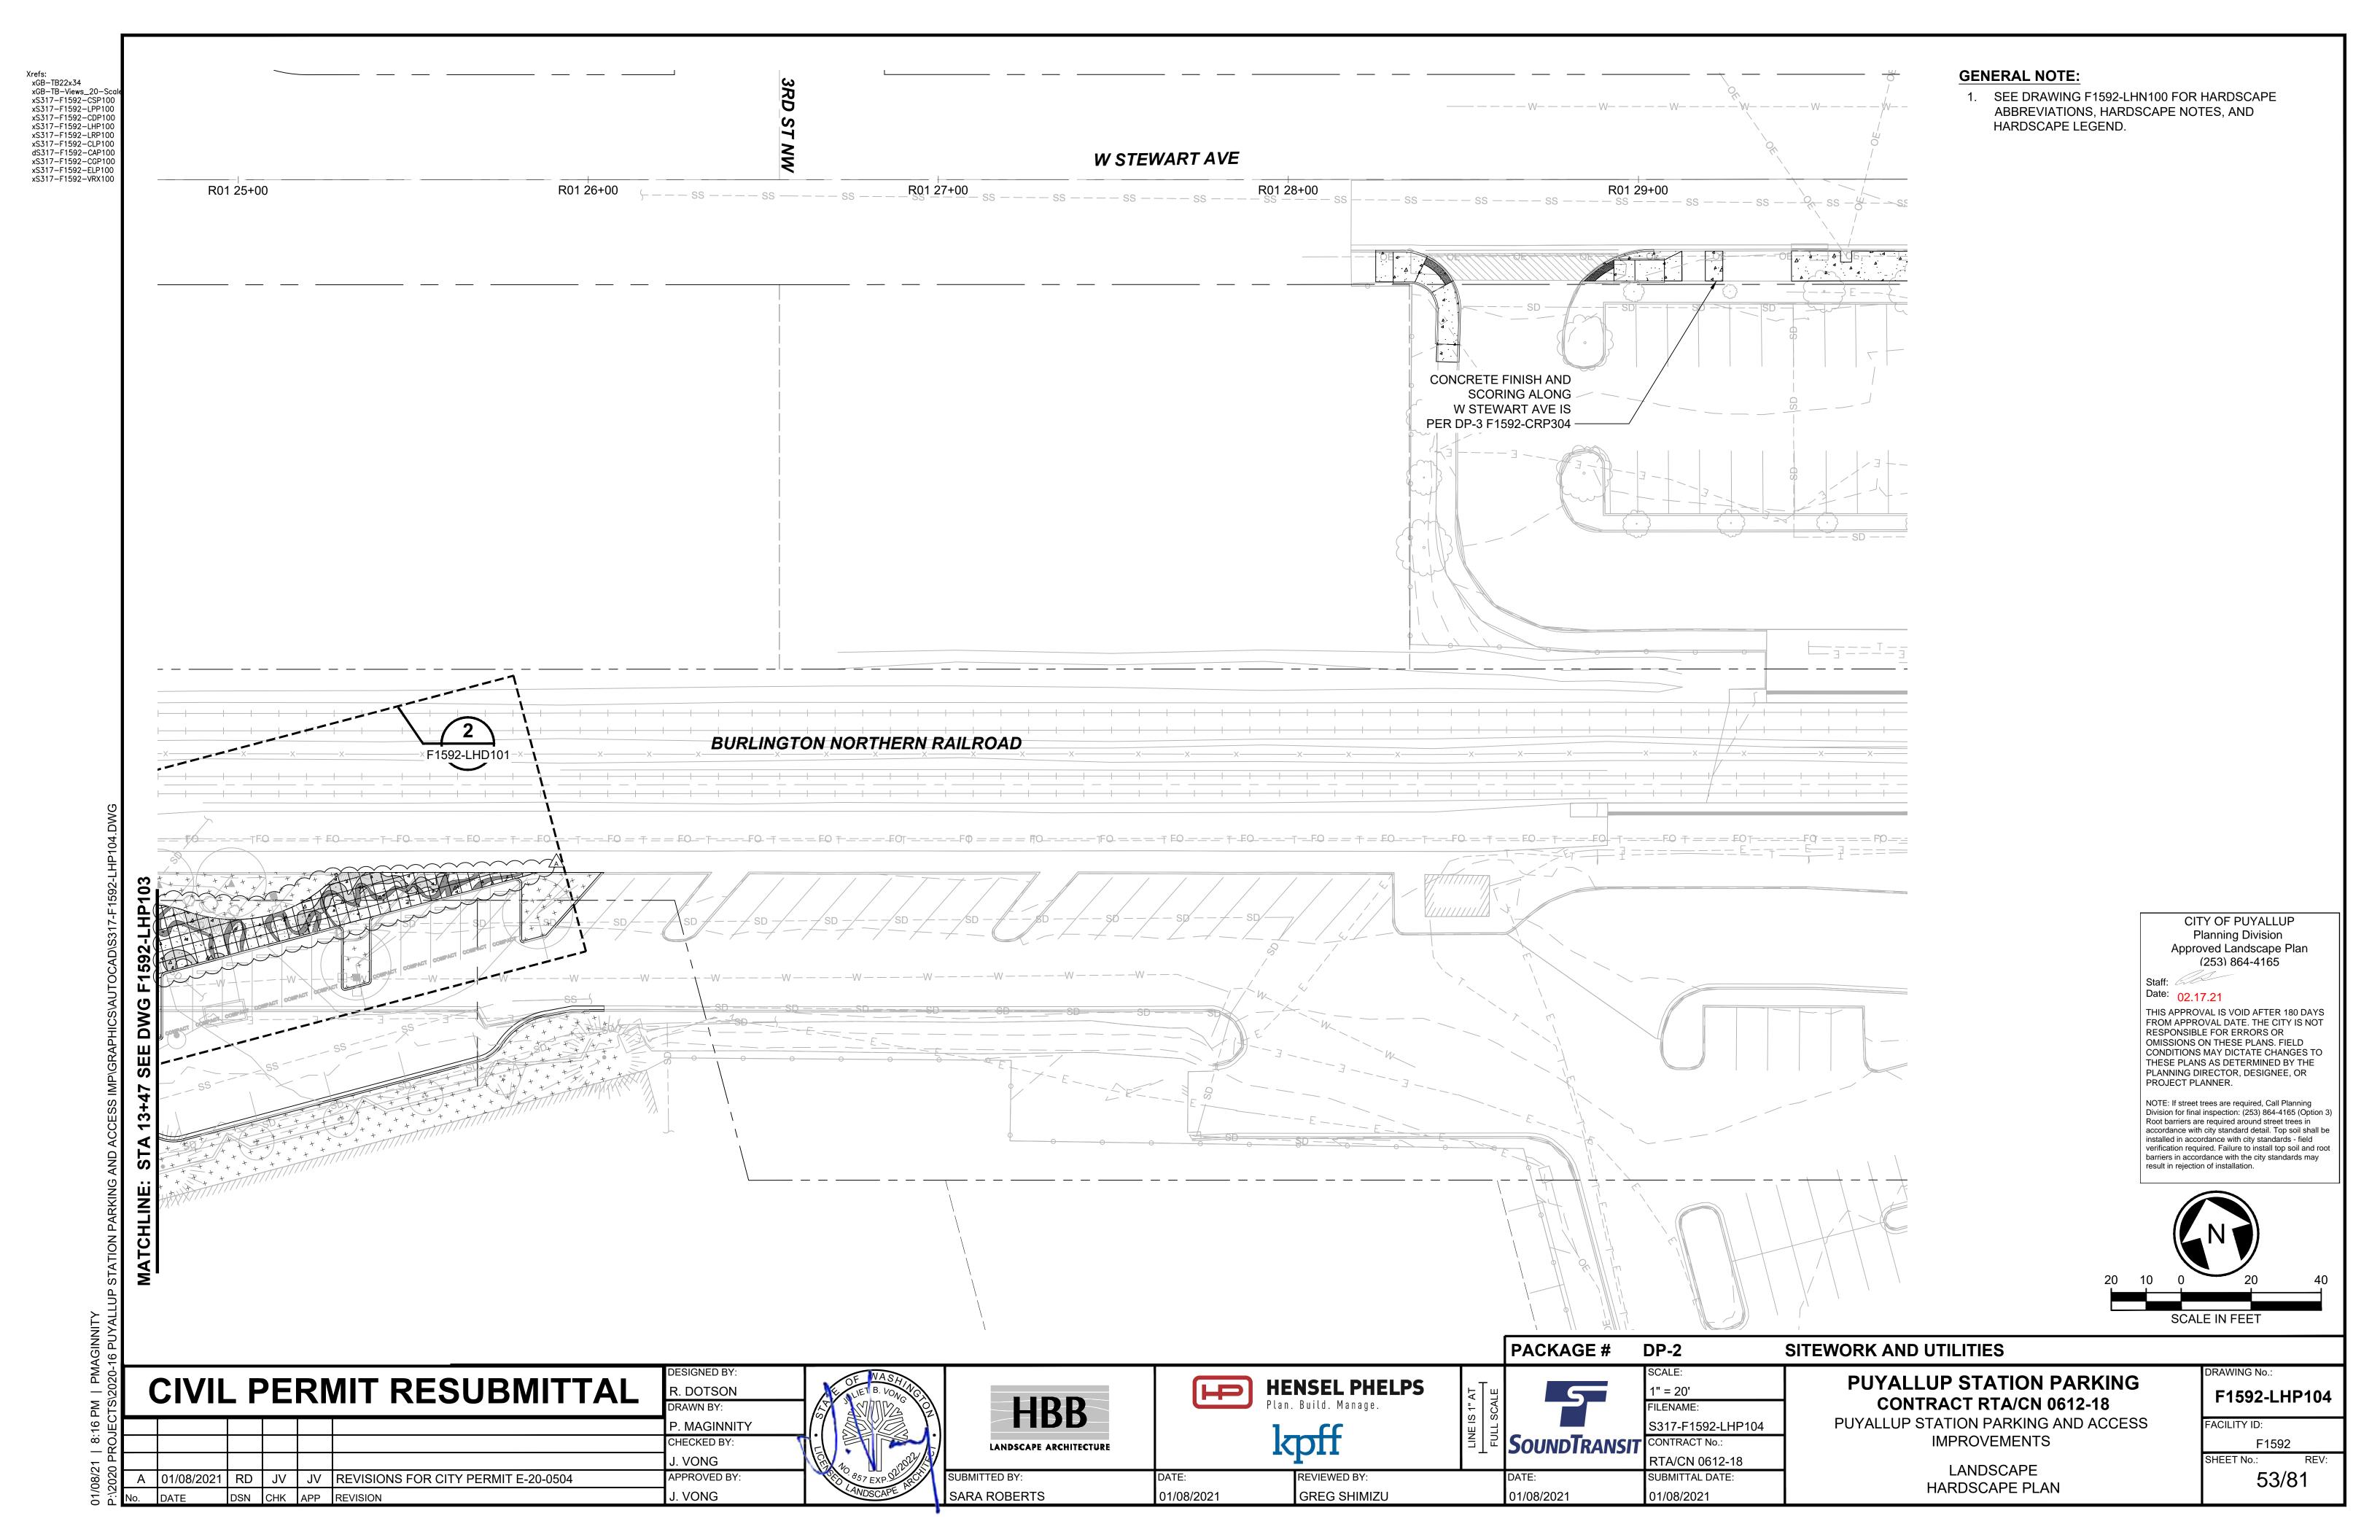

GENERAL NOTE: Xrefs: xGB-TB22x34 EQ | xGB-TB-Views_20-Sc SEE DRAWING F1592-LHN100 FOR xS317-F1592-CSP100 xS317-F1592-CDP100 HARDSCAPE ABBREVIATIONS, xS317-F1592-LPP100 xS317-F1592-LHP100 @~2.75'OC EQ HARDSCAPE NOTES, AND xS317-F1592-CLP100 **SPACE** HARDSCAPE LEGEND. xS317-F1592-UPP100 **EQ SPACE** xS317-F1592-UWP100 **JOINTS** JOINTS @ PŘOVIDĚ SHOP DRÁWING FOR xS317-F1592-TSP100 xS317-F1592-CMP100 EQ SPACE JOINTS @ ~3.00' ~3.00' LAYOUT OF SPECIALTY PAVING ؇ xS317-F1592-UCP100 xS317-F1592-VRX100 FOR ENGINEER REVIEW AND xS317-F1592-APP101 APPROVAL PRIOR TO F1592-APP106 _ @ E CONSTRUCTION, SEE SPECIFICATION 321316. BROOM DIRECTION COMPACT **AS SHOWN SLOPED PAVING** EQ SPACE JOINTS @ ~3.25' SECTION, SEE SLOPED PAVING F1592-CRP203 SECTION, SEE SLOPED PAVING SECTION F1592-CRP203 SEE DP-5 F1592-APP103 **EQ SPACED SCORE EQ SPACED SCORE** JOINTS @ ~3.25 JOINTS @ ~3.50' **EQ SPACE EQ SPACE JOINTS JOINTS** @ @ ~3.50' OC EQ SPACE JOINTS @ ~3.50' OC ~3.75' OC SLOPED PAVING SECTION, SEE F1592-CMP203 F1592-LHD102 BOLLARDS PER DP-5 F1592-APP101-1067 4 1069 4 1071 1073 1075 U 1077 U NORTH GARAGE PLAN ENLARGEMENT RAIL PER F1592-LHP103 SCALE: 1" = 10' F1592-CPD024 **DUCT BANK** VAULT, REFER TO **DRAWING DP-7** F1592-UPP701 EQ SPACE JOINTS @ ~3.00' BURLINGTON NORTHERN RAILROAD - EAST ABUTMENT BIKE LOCKERS, STACKED 2-HIGH, SEE DP-2 F1592-APP102 - EXISTING WALKWAY AND SPEC 129300 AND DP-5 $_{\odot}$ TO REMAIN, TYP CITY OF PUYALLUP - DIRECTIONAL SIGN BY OTHERS Planning Division Approved Landscape Plan - SUBMIT FINISH MOCK-UP (253) 864-4165 PANEL, 9'X9', PER SPECIFICATION 321316 Date: 02.17.21 6" CLR ALL SIDES FROM EDGE OF RECEPTACLE TO THIS APPROVAL IS VOID AFTER 180 DAYS FROM APPROVAL DATE. THE CITY IS NOT EDGE OF PAVING, TYP -RESPONSIBLE FOR ERRORS OR OMISSIONS ON THESE PLANS. FIELD CONDITIONS MAY DICTATE CHANGES TO THESE PLANS AS DETERMINED BY THE PLANNING DIRECTOR, DESIGNEE, OR PROJECT PLANNER. Division for final inspection: (253) 864-4165 (Option 3 Root barriers are required around street trees in EQ installed in accordance with city standards - field verification required. Failure to install top soil and root barriers in accordance with the city standards may EQ result in rejection of installation. F1592-LHD102 F1592-LHD102 F1592-LHD102 **BROOM FINISH DIRECTION** AS SHOWN, TYP **CONCRETE FINISH & SCORING** PER DP-3 F1592-CRP303 **EAST ABUTMENT PLAN ENLARGEMENT** SCALE: 1" = 10' F1592-LHP103 F1592-LHP104 SCALE IN FEET PACKAGE # DP-2 SITEWORK AND UTILITIES RAWING No.: **CIVIL PERMIT RESUBMITTAL PUYALLUP STATION PARKING HENSEL PHELPS** HP R. DOTSON 1" = 10' F1592-LHD101 **HBB CONTRACT RTA/CN 0612-18** Plan. Build. Manage. ILENAME: PUYALLUP STATION PARKING AND ACCESS FACILITY ID: S317-F1592-LHD101 P. MAGINNITY kpff **IMPROVEMENTS S**OUND**T**RANSIT CHECKED BY CONTRACT No. F1592 LANDSCAPE ARCHITECTURE . VONG RTA/CN 0612-18 LANDSCAPE SUBMITTAL DATE 54/81 JV JV REVISIONS FOR CITY PERMIT E-20-0504 APPROVED BY REVIEWED BY: RD HARDSCAPE DETAILS J. VONG SARA ROBERTS 01/08/2021 **GREG SHIMIZU** 01/08/2021 01/08/2021

SS TAMPER RESISTANT TRIGROOVE NUT SITE FURNISHING POINT OF ATTACHMENT CORROSION RESISTANT GASKET, NEOPRENE OR APPROVED EQUAL SS ANCHOR BOLT

MEDIUM BROOM CONCRETE FINISH


SCALE: NTS

SCALE: NTS

F1592-LHN100 F1592-LHP103 F1592-LHD101


ANCHOR BOLT SCALE: NTS



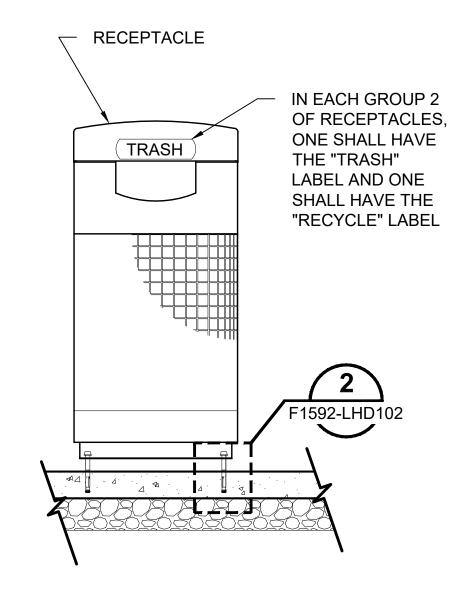

LITTER AND RECYCLE RECEPTACLE 3

F1592-LHN100 F1592-LHD101

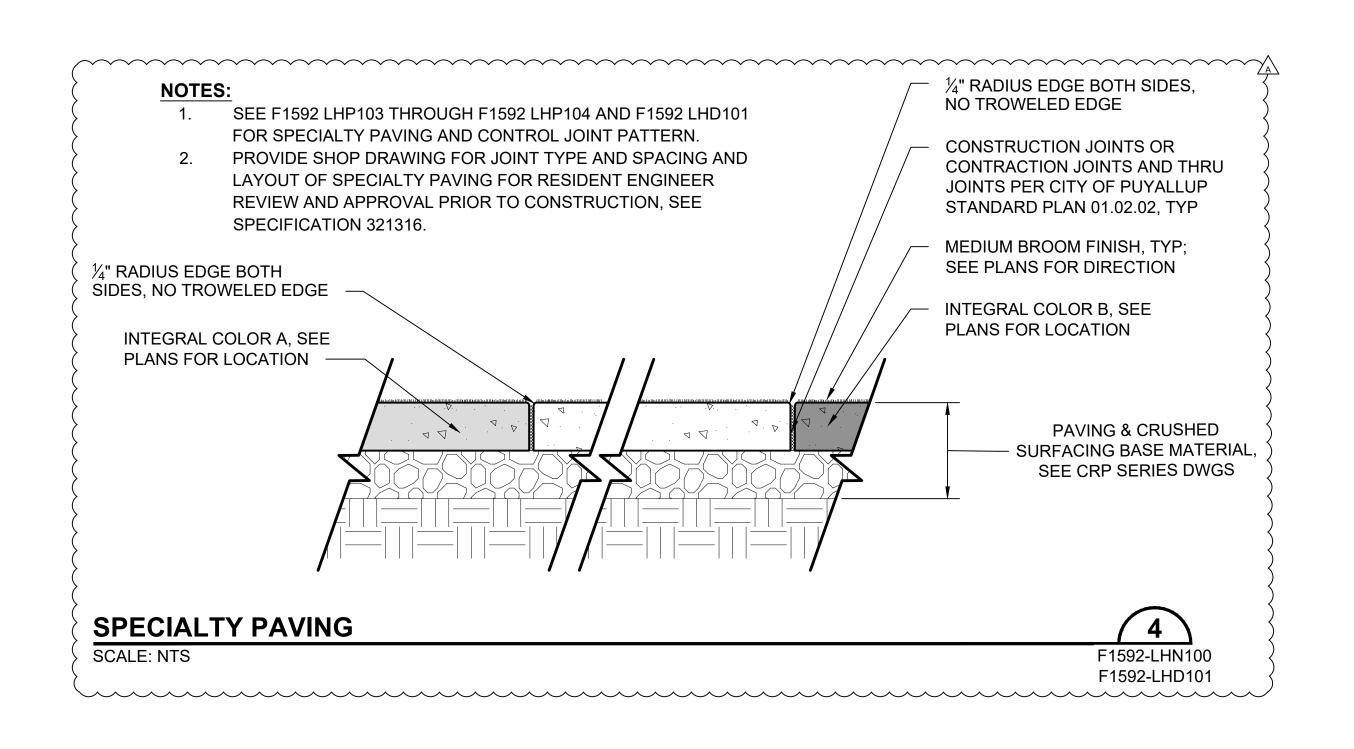

CITY OF PUYALLUP Planning Division Approved Landscape Plan (253) 864-4165

Date: 02.17.21 THIS APPROVAL IS VOID AFTER 180 DAYS

FROM APPROVAL DATE. THE CITY IS NOT RESPONSIBLE FOR ERRORS OR OMISSIONS ON THESE PLANS. FIELD CONDITIONS MAY DICTATE CHANGES TO THESE PLANS AS DETERMINED BY THE PLANNING DIRECTOR, DESIGNEE, OR PROJECT PLANNER.

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RAWING No.:

CIVIL PERMIT RESUBMITTAL R. DOTSON P. MAGINNITY CHECKED BY . VONG RD JV JV REVISIONS FOR CITY PERMIT E-20-0504 APPROVED BY J. VONG



SARA ROBERTS





SOUND**T**RANSIT

NTS ILENAME: S317-F1592-LHD102 CONTRACT No.:

DP-2

SITEWORK AND UTILITIES **PUYALLUP STATION PARKING CONTRACT RTA/CN 0612-18**

PUYALLUP STATION PARKING AND ACCESS **IMPROVEMENTS**

LANDSCAPE

F1592-LHD102 FACILITY ID:

> F1592 55/81

01/08/2021

REVIEWED BY:

GREG SHIMIZU

01/08/2021


PACKAGE #


RTA/CN 0612-18 SUBMITTAL DATE:


01/08/2021

HARDSCAPE DETAILS

PARKING LOT SOIL CELL ENLARGEMENT (1) SCALE: 1" = 10' F1592-LHP102 F1592-LHP103

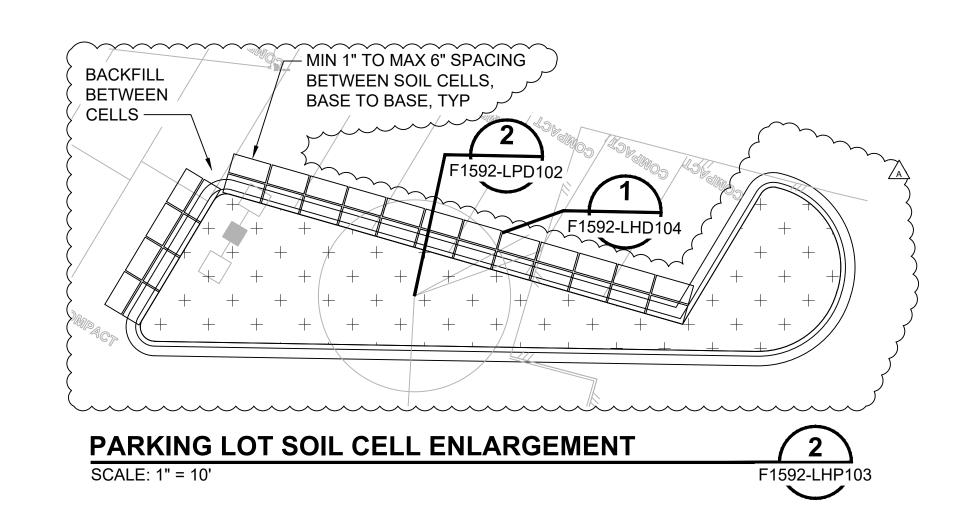


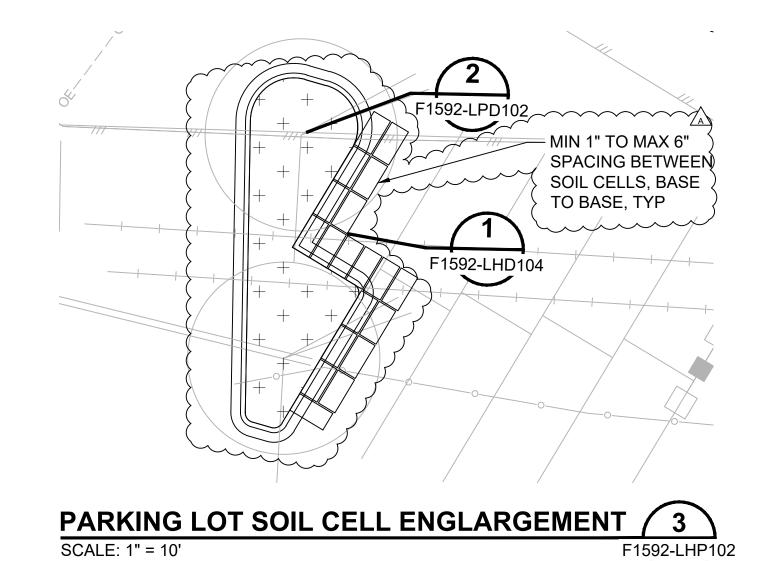

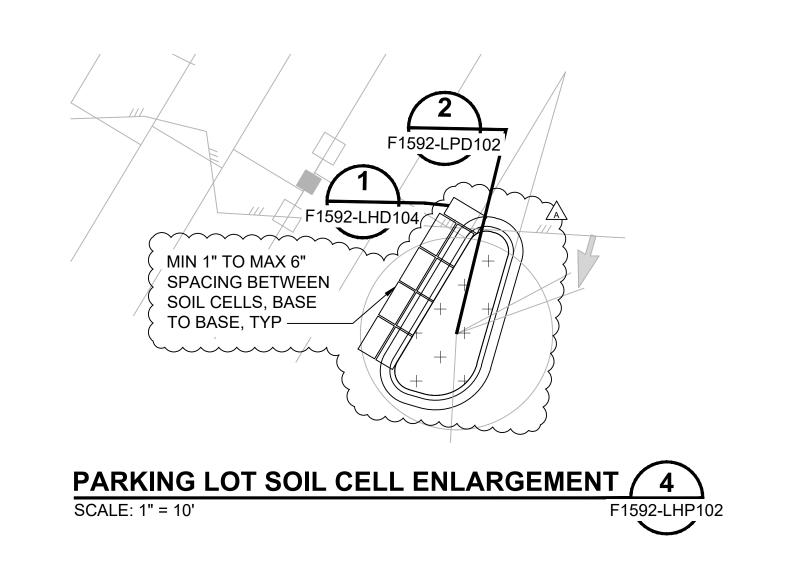

SARA ROBERTS

J. VONG

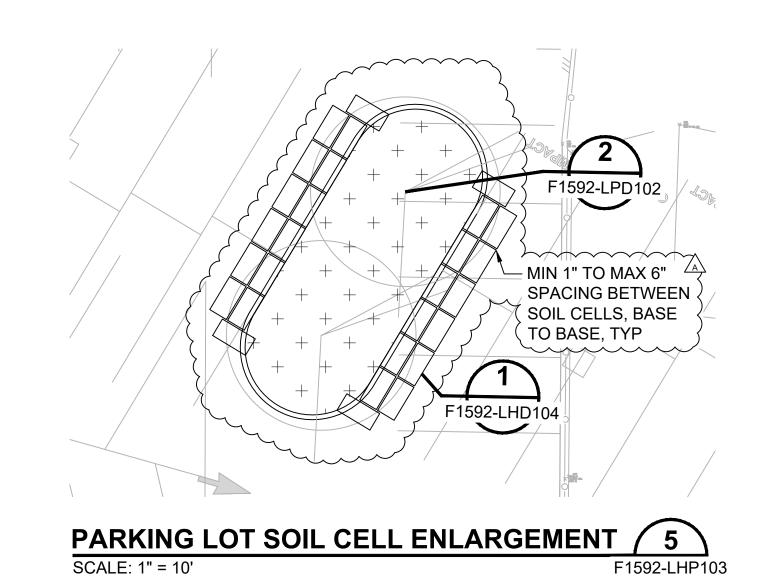

CITY OF PUYALLUP Planning Division Approved Landscape Plan (253) 264-4165

Date: 02.17.21

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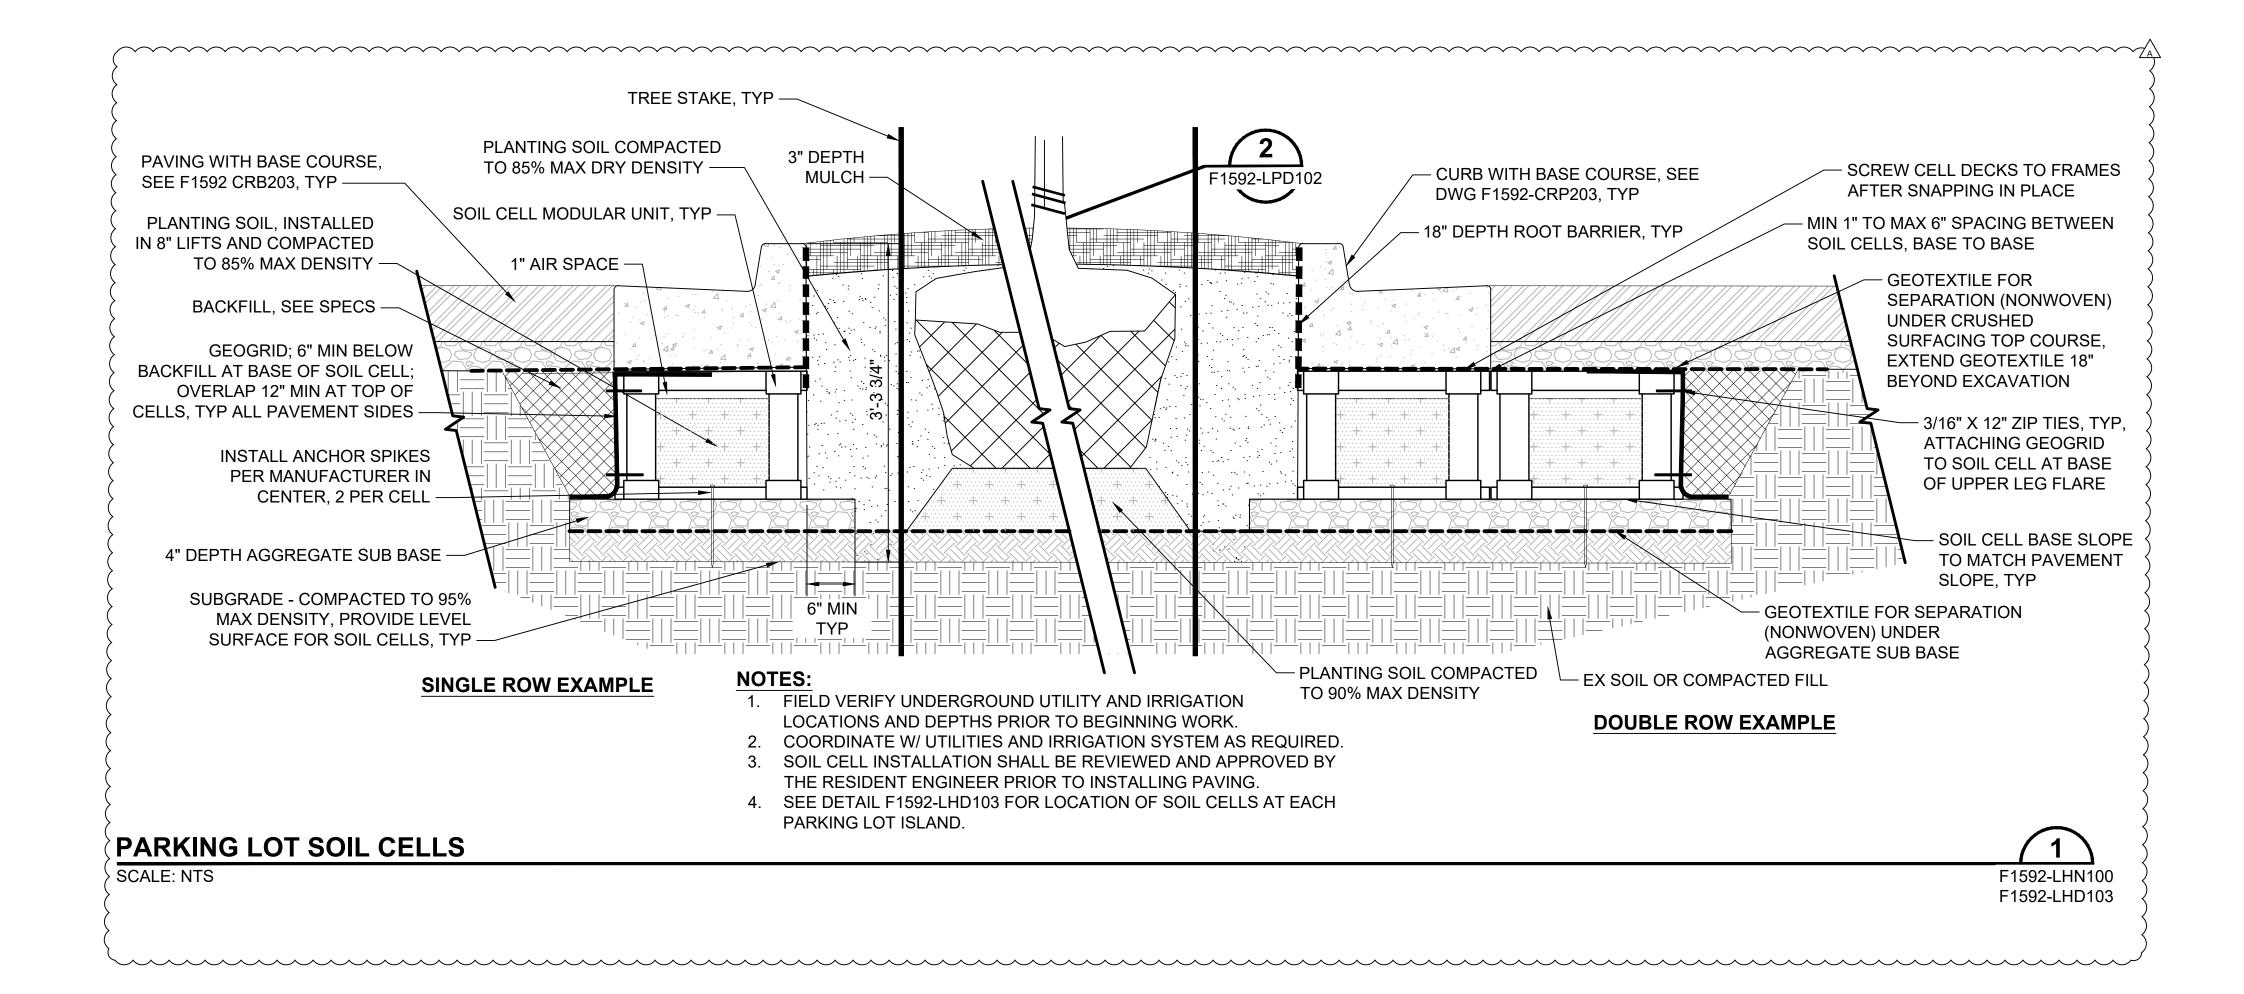
PACKAGE # DP-2 SITEWORK AND UTILITIES RAWING No.: **CIVIL PERMIT RESUBMITTAL PUYALLUP STATION PARKING HENSEL PHELPS** H R. DOTSON 1" = 10' F1592-LHD103 **HBB** CONTRACT RTA/CN 0612-18 Plan. Build. Manage. ILENAME: PUYALLUP STATION PARKING AND ACCESS FACILITY ID: P. MAGINNITY S317-F1592-LHD103 kpff **IMPROVEMENTS SOUNDTRANSIT** CHECKED BY CONTRACT No.: F1592 LANDSCAPE ARCHITECTURE . VONG RTA/CN 0612-18 LANDSCAPE 56/81 A 01/08/2021 RD JV JV REVISIONS FOR CITY PERMIT E-20-0504 APPROVED BY REVIEWED BY: SUBMITTAL DATE: HARDSCAPE DETAILS

01/08/2021

GREG SHIMIZU

01/08/2021

01/08/2021



CITY OF PUYALLUP Planning Division Approved Landscape Plan (253) 864-4165


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CIVIL PERMIT RESUBMITTAL R. DOTSON P. MAGINNITY CHECKED BY . VONG APPROVED BY RD JV JV REVISIONS FOR CITY PERMIT E-20-0504 J. VONG

SUBMITTED BY: SARA ROBERTS





01/08/2021

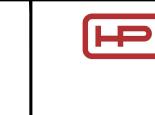HENSEL PHELPS Plan. Build. Manage. kpff

REVIEWED BY:

GREG SHIMIZU



DATE:

01/08/2021

NTS ILENAME: SoundTransit

DP-2

SUBMITTAL DATE:

01/08/2021

PACKAGE #

PUYALLUP STATION PARKING S317-F1592-LHD104 CONTRACT No.: RTA/CN 0612-18

CONTRACT RTA/CN 0612-18 PUYALLUP STATION PARKING AND ACCESS **IMPROVEMENTS**

HARDSCAPE DETAILS

SITEWORK AND UTILITIES

LANDSCAPE

DRAWING No.: F1592-LHD104

FACILITY ID:

F1592 57/81 ____

#3 LANDSCAPE BOULDER

#5 LANDSCAPE BOULDER

ROOT BARRIER

SEE SPEC 329000 46" - 60" TALL AND WIDE;

30" - 42" TALL AND WIDE;

SEE SPEC 329000

8' LENGTH UNLESS OTHERWISE NOTED; CENTERED AT TREE LOCATION; 18" DEPTH @ PARKING LOT ISLANDS AND ADJ TO SOIL CELLS.

24" DEPTH AT ALL OTHER PAVING EDGES PER CITY OF PUYALLUP STANDARD DETAIL 01.02.03

PLANTING ABBREVIATIONS

#/NO	NUMBER	GAL	GALLON
Ø	DIAMETER	HT	HEIGHT
%	PERCENT	MAX	MAXIMUM
&	AND	MFR	MANUFACTURER
@	AT	MIN	MINIMUM
ADJ	ADJACENT	NTS	NOT TO SCALE
B&B	BALLED & BURLAPPED	OC	ON CENTER
CAL	CALIPER	QTY	QUANTITY
CL	CENTERLINE	SPEC(S)	SPECIFICATION(S)
CONT	CONTAINER	ST	SOUND TRANSIT
DIA	DIAMETER	STA	STATION
DWG(S)	DRAWING(S)	SYM	SYMBOL
ENG	ENGINEER	TYP	TYPICAL
EX	EXISTING	VAR	VARIETY

PLANTING NOTES

- 1. BRING ANY DISCREPANCIES WITH THE DWGS AND/OR SPECS & SITE CONDITIONS TO THE ATTENTION OF RESIDENT ENGINEER PRIOR TO PROCEEDING WITH CONSTRUCTION.
- 2. LOCATE UTILITIES PRIOR TO BEGINNING CONSTRUCTION.
- 3. RESIDENT ENGINEER MUST INSPECT PLANT MATERIALS AND STAKING LOCATIONS PRIOR TO INSTALLATION TO ASSURE THE APPROPRIATE LAYOUT AND PLANT CHARACTERISTICS ARE MET.
- 4. COORDINATE PLANT MATERIAL LOCATIONS WITH DRIP TUBING LOCATIONS TO AVOID ANY CONFLICTS.
- 5. ALL EXISTING PLANTING OR LAWN AREAS DISTURBED BY CONSTRUCTION NOT SHOWN ON PLANTING PLANS SHALL BE RESTORED TO MEET AND MATCH EXISTING CONDITIONS.
- 6. TREE LOCATIONS SHOWN ON PLANTING PLANS ARE APPROXIMATE; IF FIELD ADJUSTMENTS ARE NECESSARY THE FOLLOWING MIN SETBACKS FOR CENTERLINE OF TREE TRUNKS TO THE FOLLOWING APPLY:

	i oleowiito /ii i e i .	
A.	STREET LIGHTS	10'
B.	DRIVEWAYS	7.5'
C.	INTERSECTIONS	30'
D.	PARKING LOT LIGHTS	20'
E.	FRONT OF STREET SIGNS	30'
F.	BACK OF STREET SIGNS	10'
G.	FIRE HYDRANTS	(10'
H.	UNDERGROUND WATER, SANITARY SEWER AND STORM SEWER LINES	(10'
I.	UNDERGROUND GAS OR POWER LINES	3'
J.	UTILITY/POWER POLES	10'
K.	UNDERGROUND FIBER CABLE	2'
L.	BACK OF CURB OR ADJ WHEELSTOP	2.5'

LIMIT OF PLANTING EQUALS LIMIT OF SITE DISTURBANCE INCLUDING CLEAR & GRUB, GRADING, & STAGING AREAS. PLANTING AREAS INCLUDE FULL SOIL PREPARATION AND IRRIGATION UNLESS NOTED OTHERWISE ON PLANS. RESTORE ALL AREAS DISTURBED DUE TO CONSTRUCTION ACTIVITIES TO PRE CONSTRUCTION CONDITIONS. MEET & MATCH EX CONDITIONS WITH A SMOOTH TRANSITION.


CITY OF PUYALLUP Planning Division Approved Landscape Plan (253) 864-4165

Date: 02.17.21

THIS APPROVAL IS VOID AFTER 180 DAYS FROM APPROVAL DATE. THE CITY IS NOT RESPONSIBLE FOR ERRORS OR OMISSIONS ON THESE PLANS. FIELD CONDITIONS MAY DICTATE CHANGES TO THESE PLANS AS DETERMINED BY THE PLANNING DIRECTOR, DESIGNEE, OR PROJECT PLANNER.

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CIVIL PERMIT RESUBMITTAL R. DOTSON P. MAGINNITY CHECKED BY J. VONG RD JV JV REVISIONS FOR CITY PERMIT E-20-0504 APPROVED BY J. VONG

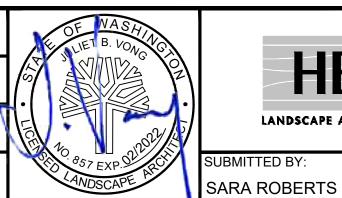

HBB LANDSCAPE ARCHITECTURE



01/08/2021

HENSEL PHELPS Plan. Build. Manage. kpff



NTS FILENAME: S317-F1592-LPN100 SoundTransit CONTRACT No.: RTA/CN 0612-18

DP-2

PUYALLUP STATION PARKING CONTRACT RTA/CN 0612-18 PUYALLUP STATION PARKING AND ACCESS

SITEWORK AND UTILITIES

IMPROVEMENTS LANDSCAPE PLANTING DRAWING No.: F1592-LPN100

F1592 58/81

FACILITY ID:

SUBMITTED BY:

REVIEWED BY: **GREG SHIMIZU** DATE: SUBMITTAL DATE: 01/08/2021 01/08/2021

PACKAGE #

GENERAL NOTES, LEGEND, AND ABBREVIATIONS

PLANTING SCHEDULE

CITY OF PUYALLUP Planning Division Approved Landscape Plan (253) 864-4165

Date: 02.17.21


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RAWING No.:

FACILITY ID:

CIVIL PERMIT RESUBMITTAL R. DOTSO DRAWN BY:								
						P. MAGINNITY	1	
						CHECKED BY:	1,	
						J. VONG	1	
	01/08/2021	RD	JV	JV	REVISIONS FOR CITY PERMIT E-20-0504	APPROVED BY:	`	
	DATE	DSN	CHK	APP	REVISION	J. VONG		





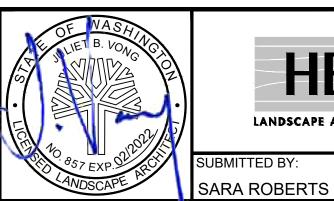



NTS ILENAME: S317-F1592-LPS100 SoundTransii CONTRACT No.

PUYALLUP STATION PARKING CONTRACT RTA/CN 0612-18 PUYALLUP STATION PARKING AND ACCESS

SITEWORK AND UTILITIES

IMPROVEMENTS LANDSCAPE

F1592-LPS100

F1592 59/81

01/08/2021

KpH REVIEWED BY:

GREG SHIMIZU

DATE:

01/08/2021

PACKAGE #

RTA/CN 0612-18 SUBMITTAL DATE: 01/08/2021

DP-2

PLANTING SCHEDULE

SIZE/REMARKS

CURB OR PAVING

CURB OR PAVING

WELL ROOTED

WELL ROOTED

WELL ROOTED

2 GAL CONT; FULL, WELL BRANCHED & WELL

1 GAL CONT; FULL, WELL BRANCHED & WELL

ROOTED: MIN 36" OFFSET FROM EDGE OF

2 GAL CONT; FULL, WELL BRANCHED &

1 GAL CONT; FULL & WELL ROOTED

1 GAL CONT; FULL & WELL ROOTED;

12" OFFSET FROM EDGE OF PAVING

2 GAL CONT; FULL, WELL BRANCHED &

5 GAL CONT; FULL, WELL BRANCHED &

1 GAL CONT; FULL & WELL ROOTED

EXISTING LAWN AREAS TO BE RESTORED


WITH SOD; SEE DETAIL 1/F1592-LPD101

EXISTING PLANTED AREAS TO BE

SEE DETAIL 1/F1592-LPD101

RESTORED WITH 3" MULCH DEPTH;

ROOTED; MIN 36" OFFSET FROM EDGE OF

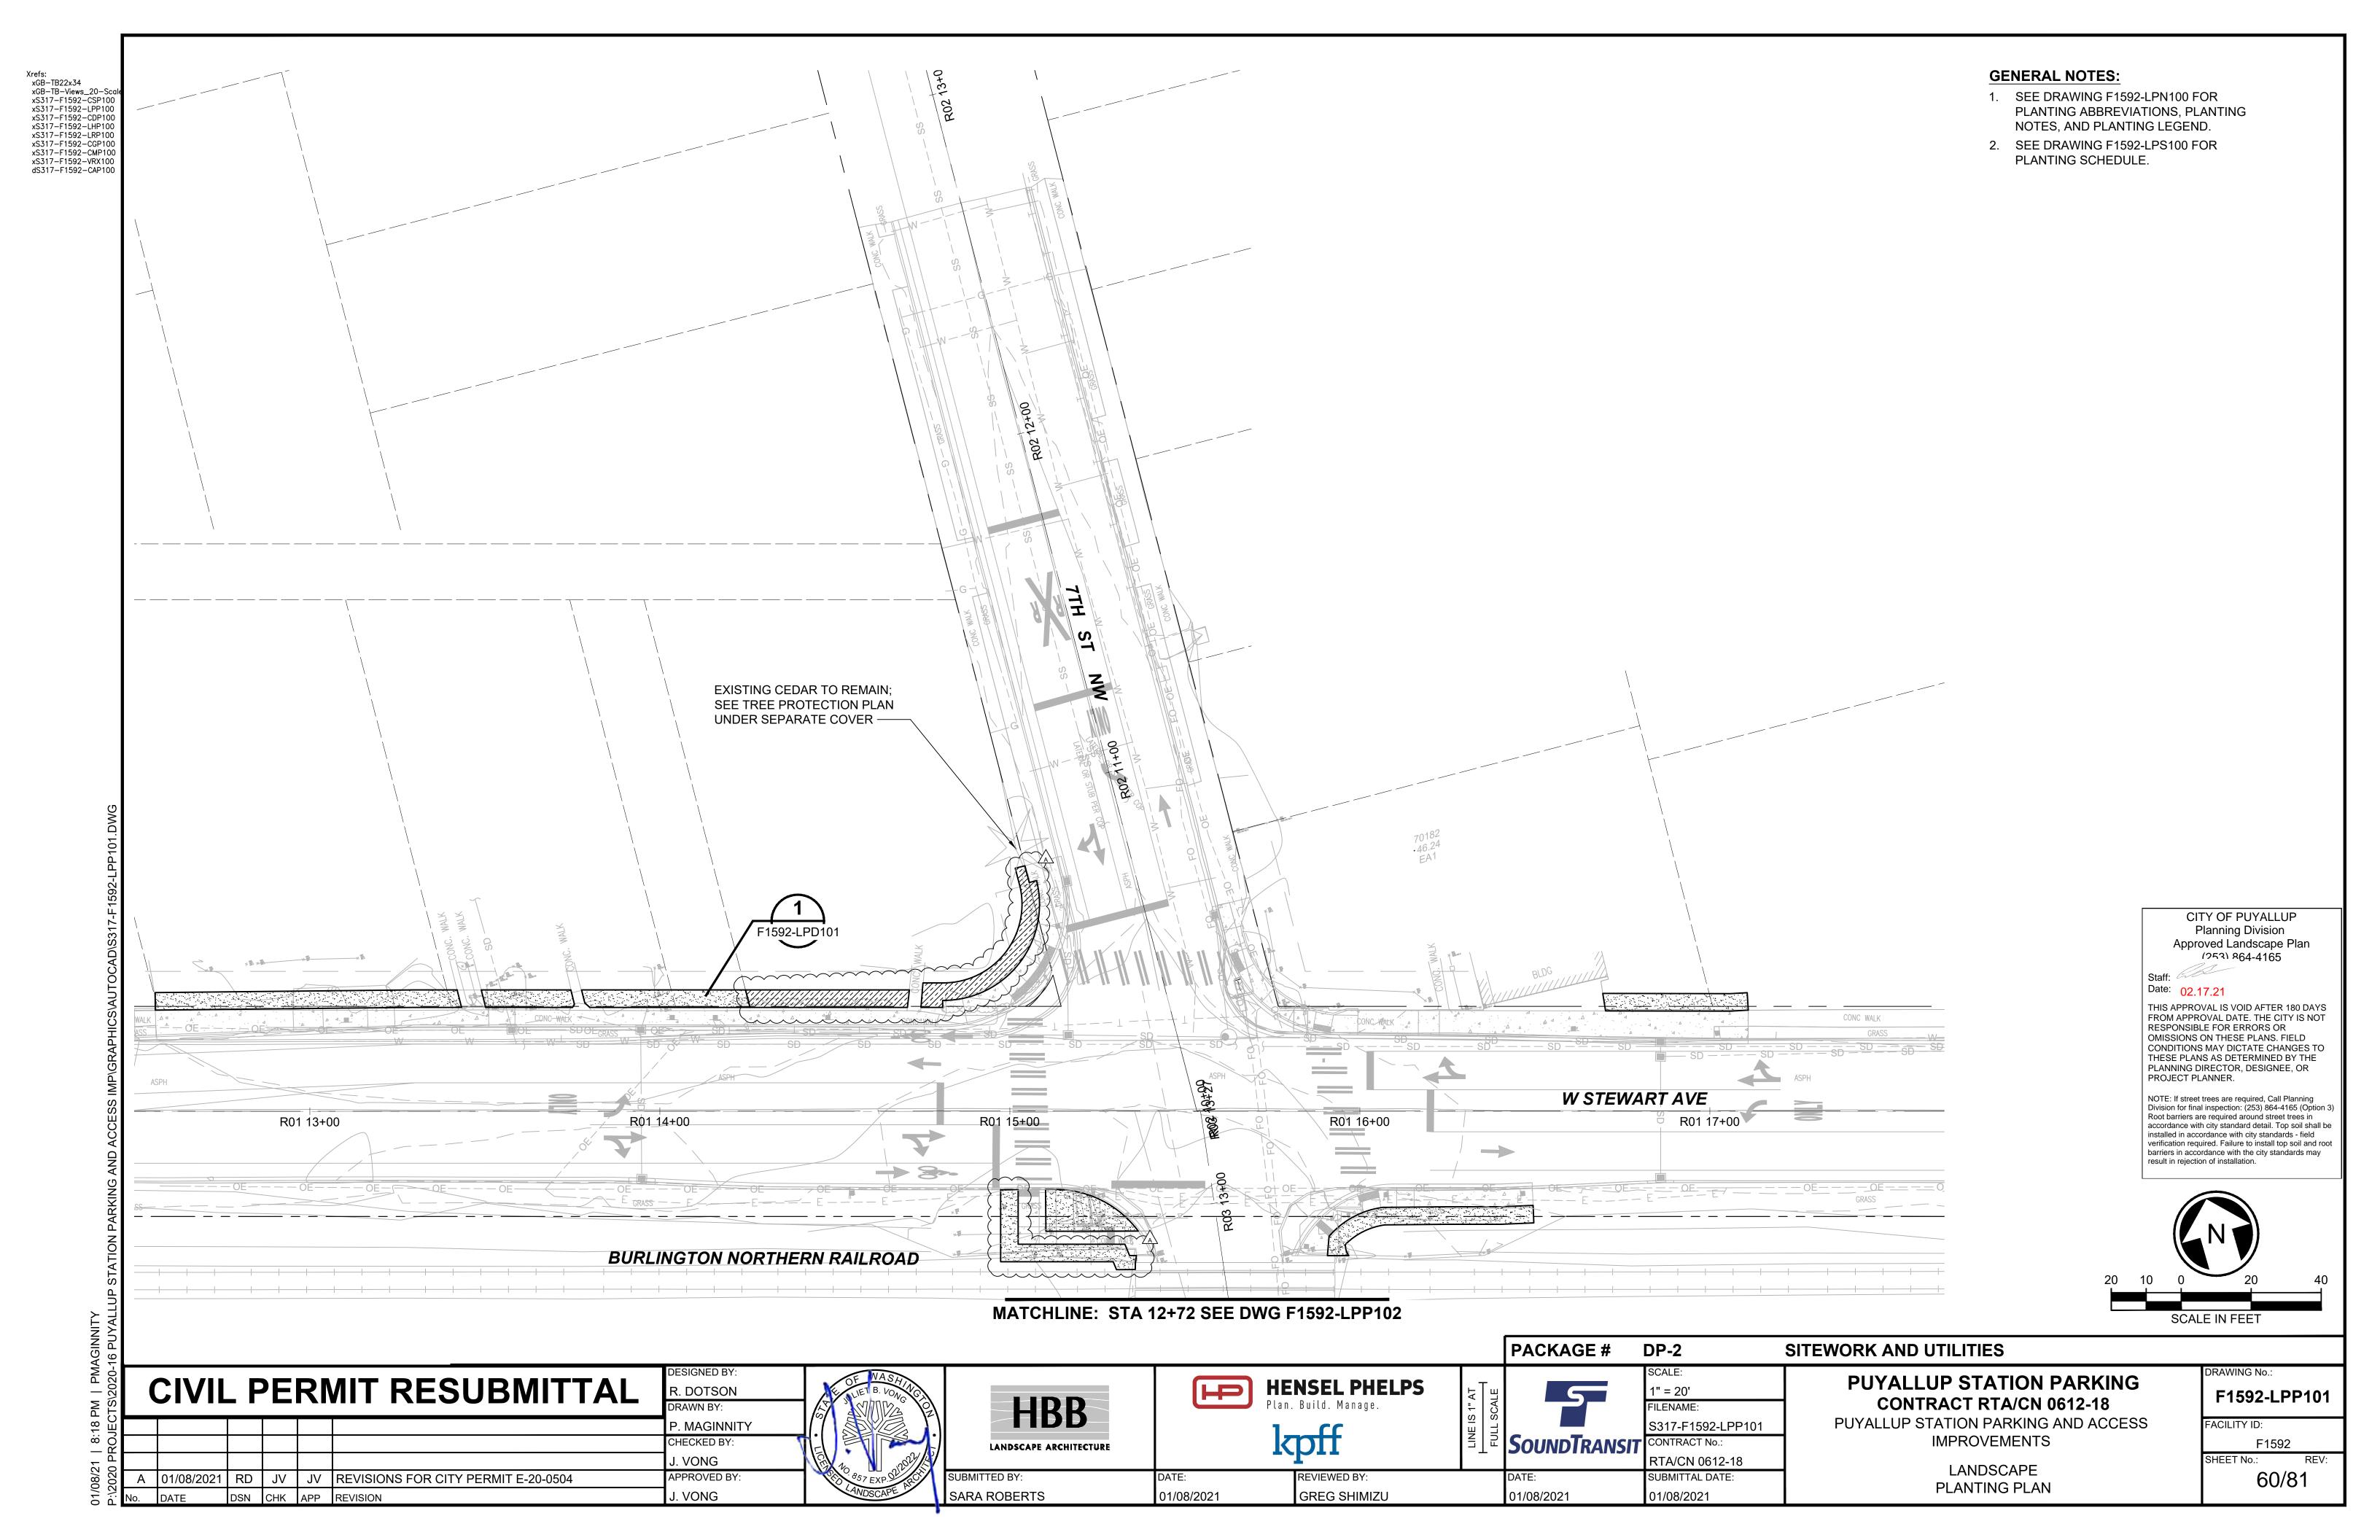

MATCHLINE: STA 12+72 SEE DWG F1592-LPP101 Xrefs: xGB-TB22x34 **GENERAL NOTES:** xGB-TB-Views_20-Sc 1. SEE DRAWING F1592-LPN100 FOR xS317-F1592-CSP100 xS317-F1592-LPP100 xS317-F1592-CDP100 xS317-F1592-LHP100 PLANTING ABBREVIATIONS, PLANTING BURLINGTON NORTHERN RAILROAD NOTES, AND PLANTING LEGEND. xS317—F1592—CHP100 xS317—F1592—CGP100 xS317—F1592—TSP100 xS317—F1592—ELP100 xS317—F1592—VRX100 xS317—F1592—CLP100 dS317—F1592—CAP100 2. SEE DRAWING F1592-LPS100 FOR PLANTING SCHEDULE. **INSTALL MULCH THROUGHOUT** PLANTING AREA LIGHT POLE, TYP INSTALL CONTINUOUS 6" 1592-LPD102 HT CROWN ALONG CL OF PLANTING AREAS, TYP F1592-LPD10 INSTALL CONTINUOUS 6" HT CROWN ALONG - BULB PLANTINGS THE CL OF SIDEWALK PLANTING STRIP BULB PLANTINGS THROUGHOUT THIS THROUGHOUT THIS PERIMETER PERIMETER LANDSCAPE ISLAND; LANDSCAPE ISLAND; QTY 276 20.50' 26.00' 3RD AVE NW R04 11+00 R04 12+00 R04 13+00 F1592-LPD101 INSTALL CONTINUOUS 6" HT CROWN ALONG CITY OF PUYALLUP THE CL OF SIDEWALK PLANTING STRIP Planning Division Approved Landscape Plan (253) 864-4165 Date: 02.17.21 THIS APPROVAL IS VOID AFTER 180 DAYS FROM APPROVAL DATE. THE CITY IS NOT RESPONSIBLE FOR ERRORS OR OMISSIONS ON THESE PLANS. FIELD CONDITIONS MAY DICTATE CHANGES TO THESE PLANS AS DETERMINED BY THE PLANNING DIRECTOR, DESIGNEE, OR PROJECT PLANNER. NOTE: If street trees are required, Call Planning Division for final inspection: (253) 864-4165 (Option 3) Root barriers are required around street trees in accordance with city standard detail. Top soil shall be installed in accordance with city standards - field verification required. Failure to install top soil and root barriers in accordance with the city standards may result in rejection of installation. SCALE IN FEET PACKAGE # DP-2 SITEWORK AND UTILITIES RAWING No.: **CIVIL PERMIT RESUBMITTAL PUYALLUP STATION PARKING HENSEL PHELPS** P 1" = 20' F1592-LPP102 **HBB** CONTRACT RTA/CN 0612-18 Plan. Build. Manage. ILENAME: PUYALLUP STATION PARKING AND ACCESS FACILITY ID: P. MAGINNITY S317-F1592-LPP102 kpff **IMPROVEMENTS SOUNDTRANSIT** CHECKED BY: CONTRACT No.: F1592 LANDSCAPE ARCHITECTURE . VONG RTA/CN 0612-18 LANDSCAPE RD JV JV REVISIONS FOR CITY PERMIT E-20-0504 61/81 APPROVED BY REVIEWED BY: SUBMITTAL DATE: A 01/08/2021 PLANTING PLAN J. VONG SARA ROBERTS 01/08/2021 **GREG SHIMIZU** 01/08/2021 01/08/2021

GENERAL NOTES: Xrefs: xGB-TB22x34 **BULB PLANTINGS** xGB-TB-Views_20-Sc SEE DRAWING F1592-LPN100 FOR THROUGHOUT THESE xS317-F1592-CSP100 xS317-F1592-LPP100 PLANTING ABBREVIATIONS, PLANTING PERIMETER LANDSCAPE xS317-F1592-CDP100 BURLINGTON NORTHERN RAILROAD EAST ABUTMENT xS317-F1592-LHP100 NOTES, AND PLANTING LEGEND. ISLANDS; QTY 207 xS317-F1592-UWP100 xS317-F1592-CGP100 SEE DRAWING F1592-LPS100 FOR BULB PLANTINGS xS317-F1592-TSP100 PLANTING SCHEDULE. xS317-F1592-UCP100 THROUGHOUT F1592-LPD102 xS317-F1592-CMP100 xS317-F1592-UPP100 THESE PERIMETER xS317-F1592-ELP100 LANDSCAPE xS317-F1592-APP10 xS317-F1592-VRX100 ISLANDS; QTY 165 dS317-F1592-CAP100 xS317-F1592-CLP100 1592-LPD103 F1592-LPD102 LIGHT POLE, TYP - INSTALL CONTINUOUS 6" PEDESTRIAN HT CROWN ALONG CL OF **BRIDGE** PLANTING AREAS, TYP F1592-LPD10 BULB PLANTINGS \neq BULB PLANTINGS THROUGHOUT THIS DWG ▼ VAULTS; SEE CIVIL THROUGHOUT THIS PERIMETER DWG F1592-UCP103 -PERIMETER LANDSCAPE ISLAND; - BULB PLANTINGS LANDSCAPE ISLAND; QTY 52 THROUGHOUT THIS QTY 267 BULB PLANTINĞŠ PERIMETER LANDSCAPE THROUGHOUT THESE ISLAND; QTY 25 1592-LPD102 PERIMETER 08+, F1592-LPD102 F1592-LPD102 ackslash LANDSCAPE ISLANDS; QTY 171-NORTH ELEVATOR AND STAIR **BULB PLANTINGS** THROUGHOUT F1592-LPD103 THESE PERIMETER LANDSCAPE ISLANDS; QTY 134 -3RD AVE NW OFFSET SHRUBS 18" R04 14+00 FROM CENTERLINE INSTALL 12" WIDE BY 18" DEEP OF SWALE; SEE igsquare INSTALL CONTINUOUS 6" HT BY 9'-0" LENGTH GRAVEL VALLEY LINE IN DWG CROWN ALONG THE CL OF TRENCH DRAIN ALONG F1592-CGP204 SIDEWALK PLANTING STRIP PAVEMENT EDGE **OFFSET GINKGO TREES 3'** CITY OF PUYALLUP FROM SIDEWALK EDGE, TYP F1592-LPX10 Planning Division Approved Landscape Plan (253) 864-4165 6TH **OFFSET TILIA TREES 3'** Date: 02.17.21 FROM SIDEWALK EDGE, TYP THIS APPROVAL IS VOID AFTER 180 DAYS FROM APPROVAL DATE. THE CITY IS NOT ROCKBERM AND FLOWPATH; RESPONSIBLE FOR ERRORS OR OMISSIONS ON THESE PLANS. FIELD SEE DWG F1592-CDD021 CONDITIONS MAY DICTATE CHANGES TO THESE PLANS AS DETERMINED BY THE PLANNING DIRECTOR, DESIGNEE, OR PROJECT PLANNER. NOTE: If street trees are required, Call Planning Division for final inspection: (253) 864-4165 (Option 3 Root barriers are required around street trees in accordance with city standard detail. Top soil shall be EXISTING OAK TREE TO REMAIN; installed in accordance with city standards - field SEE TREE PROTECTION UNDER verification required. Failure to install top soil and root barriers in accordance with the city standards may SEPARATE COVER BIORETENTION CELL, TYP; result in rejection of installation. SEE CIVIL DWG F1592-CDD021 OFFSET SPIREA ON SOUTH SIDE OF THE BUILDING 30" FROM FACE OF BUILDING WALL 3" DEPTH MULCH IN **BIORETENTION CELLS PER** F1592-CDD021, TYP ROCKBERM AND FLOWPATH; SEE DWG F1592-CDD021 SCALE IN FEET PACKAGE # DP-2 SITEWORK AND UTILITIES RAWING No.: **CIVIL PERMIT RESUBMITTAL PUYALLUP STATION PARKING HENSEL PHELPS** H R. DOTSON 1" = 20' F1592-LPP103 **HBB CONTRACT RTA/CN 0612-18** Plan. Build. Manage. ILENAME: PUYALLUP STATION PARKING AND ACCESS FACILITY ID: S317-F1592-LPP103 P. MAGINNITY **IMPROVEMENTS** SoundTransit CHECKED BY CONTRACT No. F1592 LANDSCAPE ARCHITECTURE . VONG RTA/CN 0612-18 LANDSCAPE 62/81 JV JV REVISIONS FOR CITY PERMIT E-20-0504 APPROVED BY REVIEWED BY: SUBMITTAL DATE: RD PLANTING PLAN

01/08/2021


GREG SHIMIZU


01/08/2021

01/08/2021

J. VONG

SARA ROBERTS

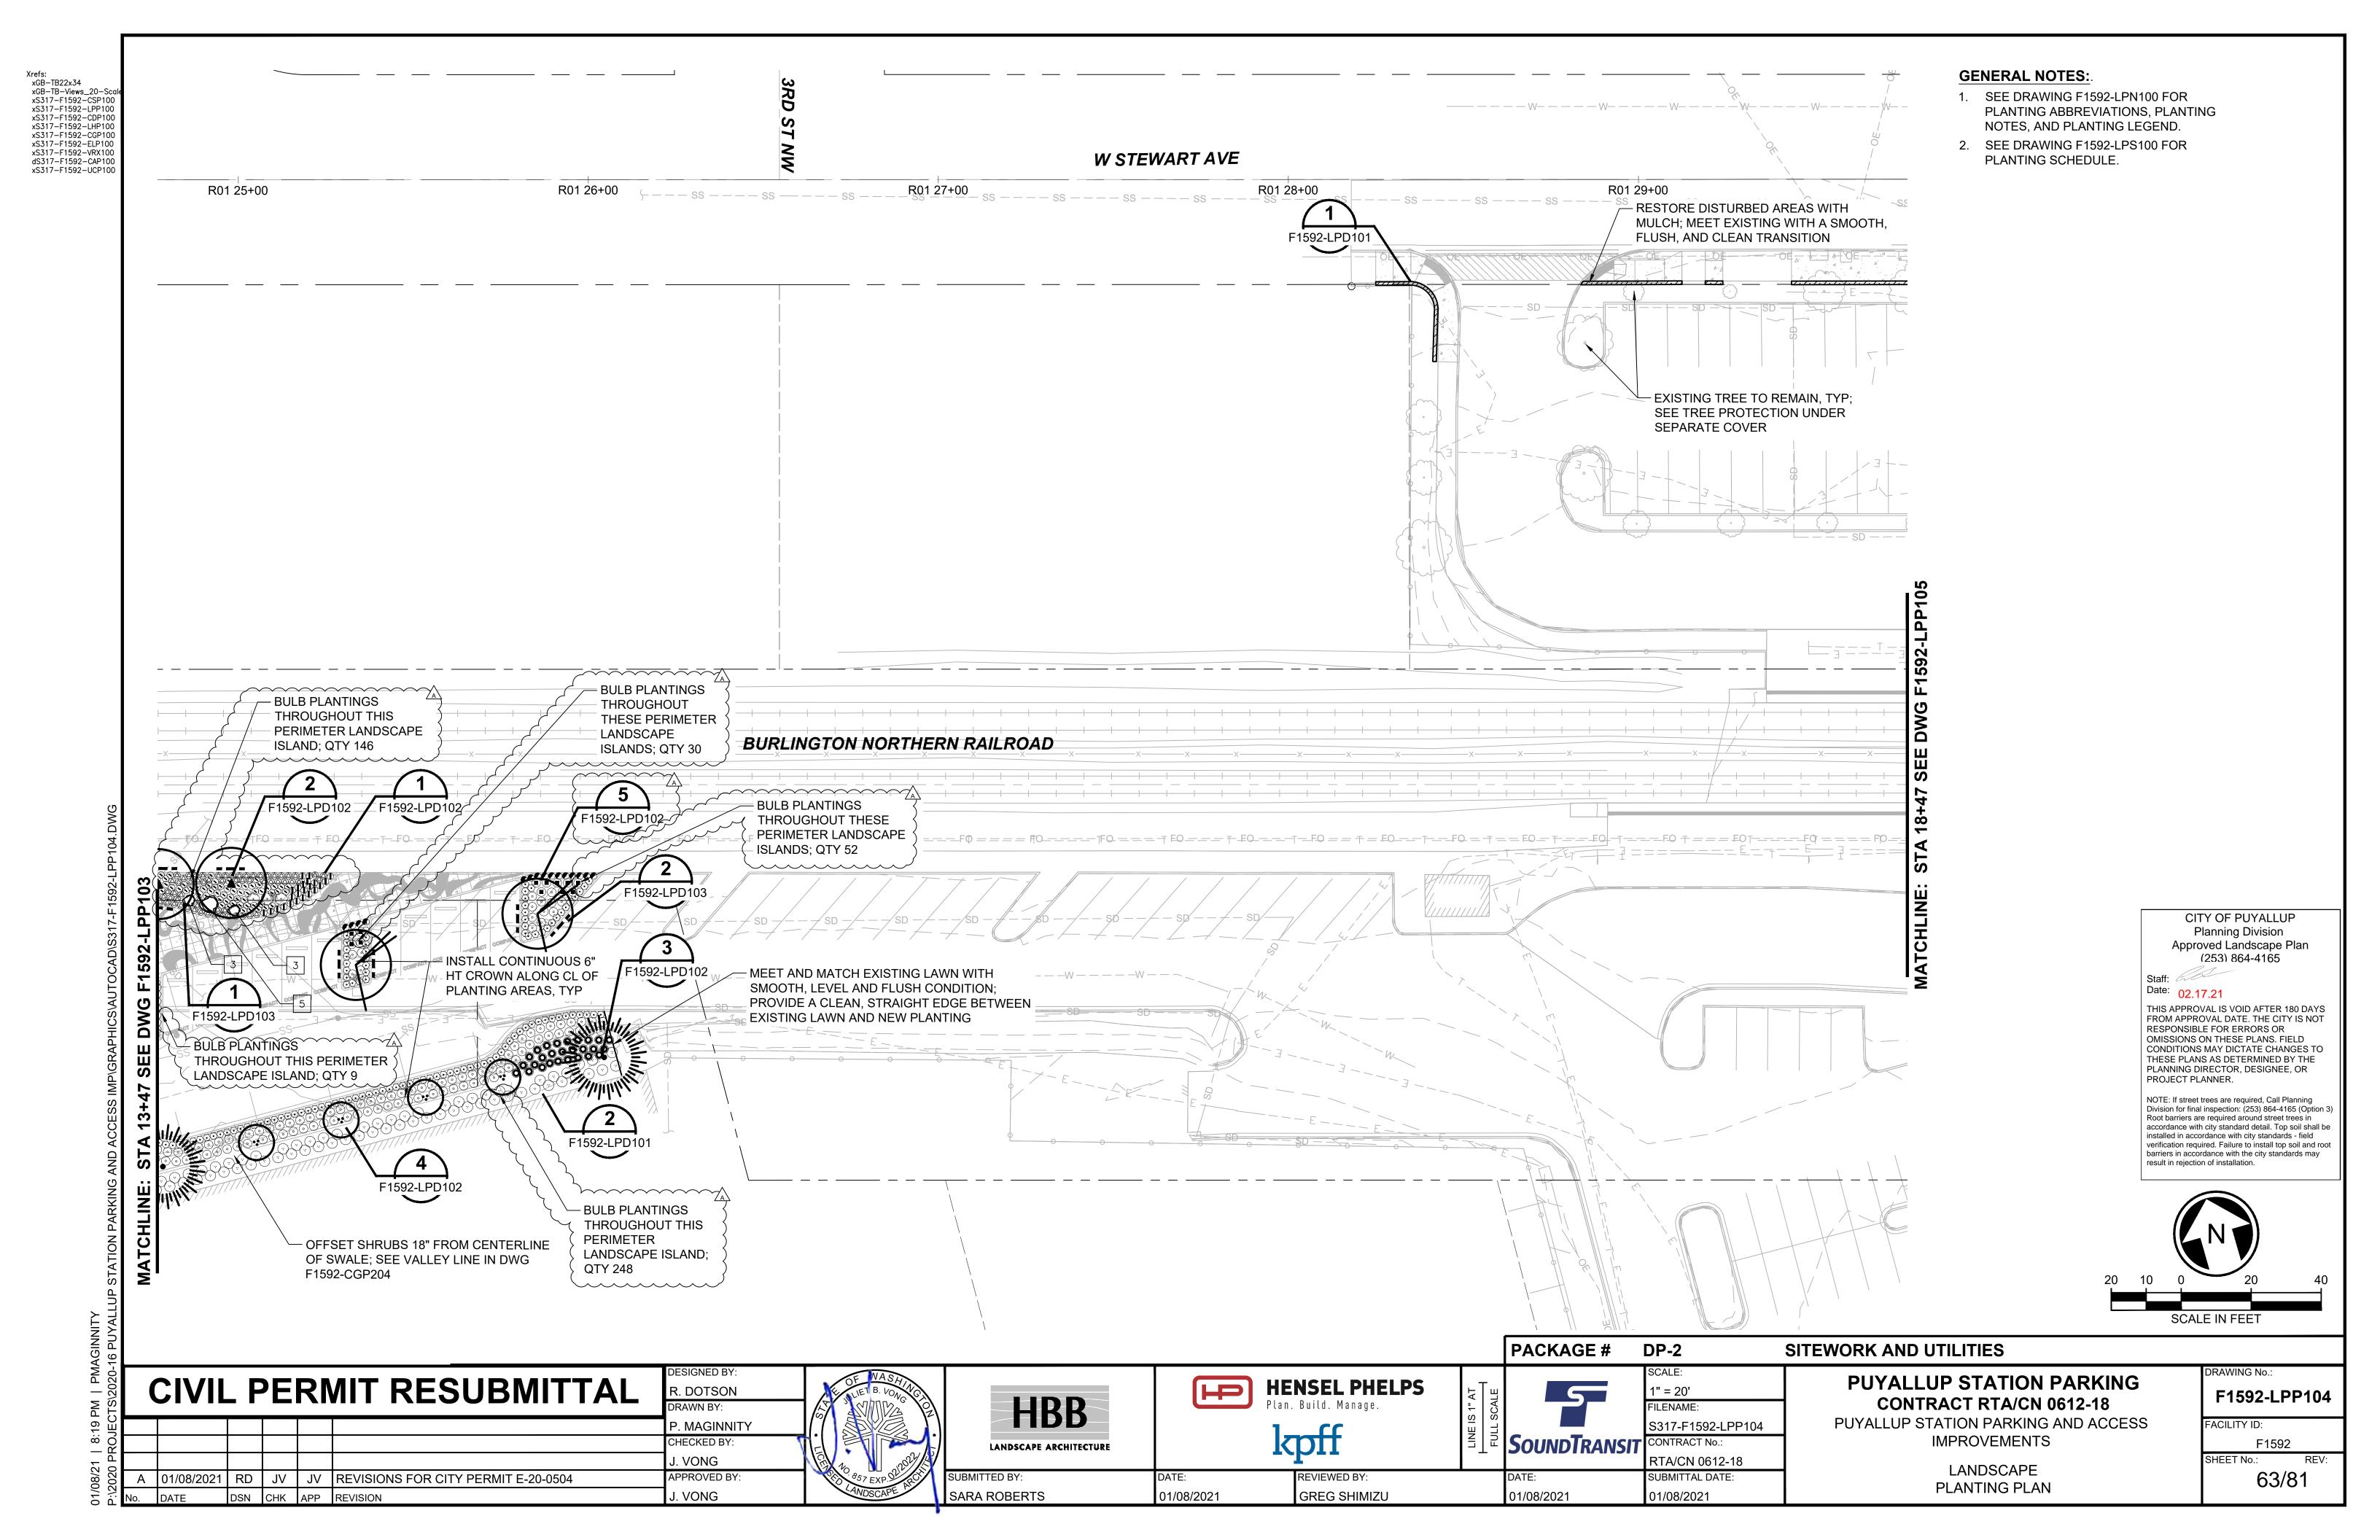

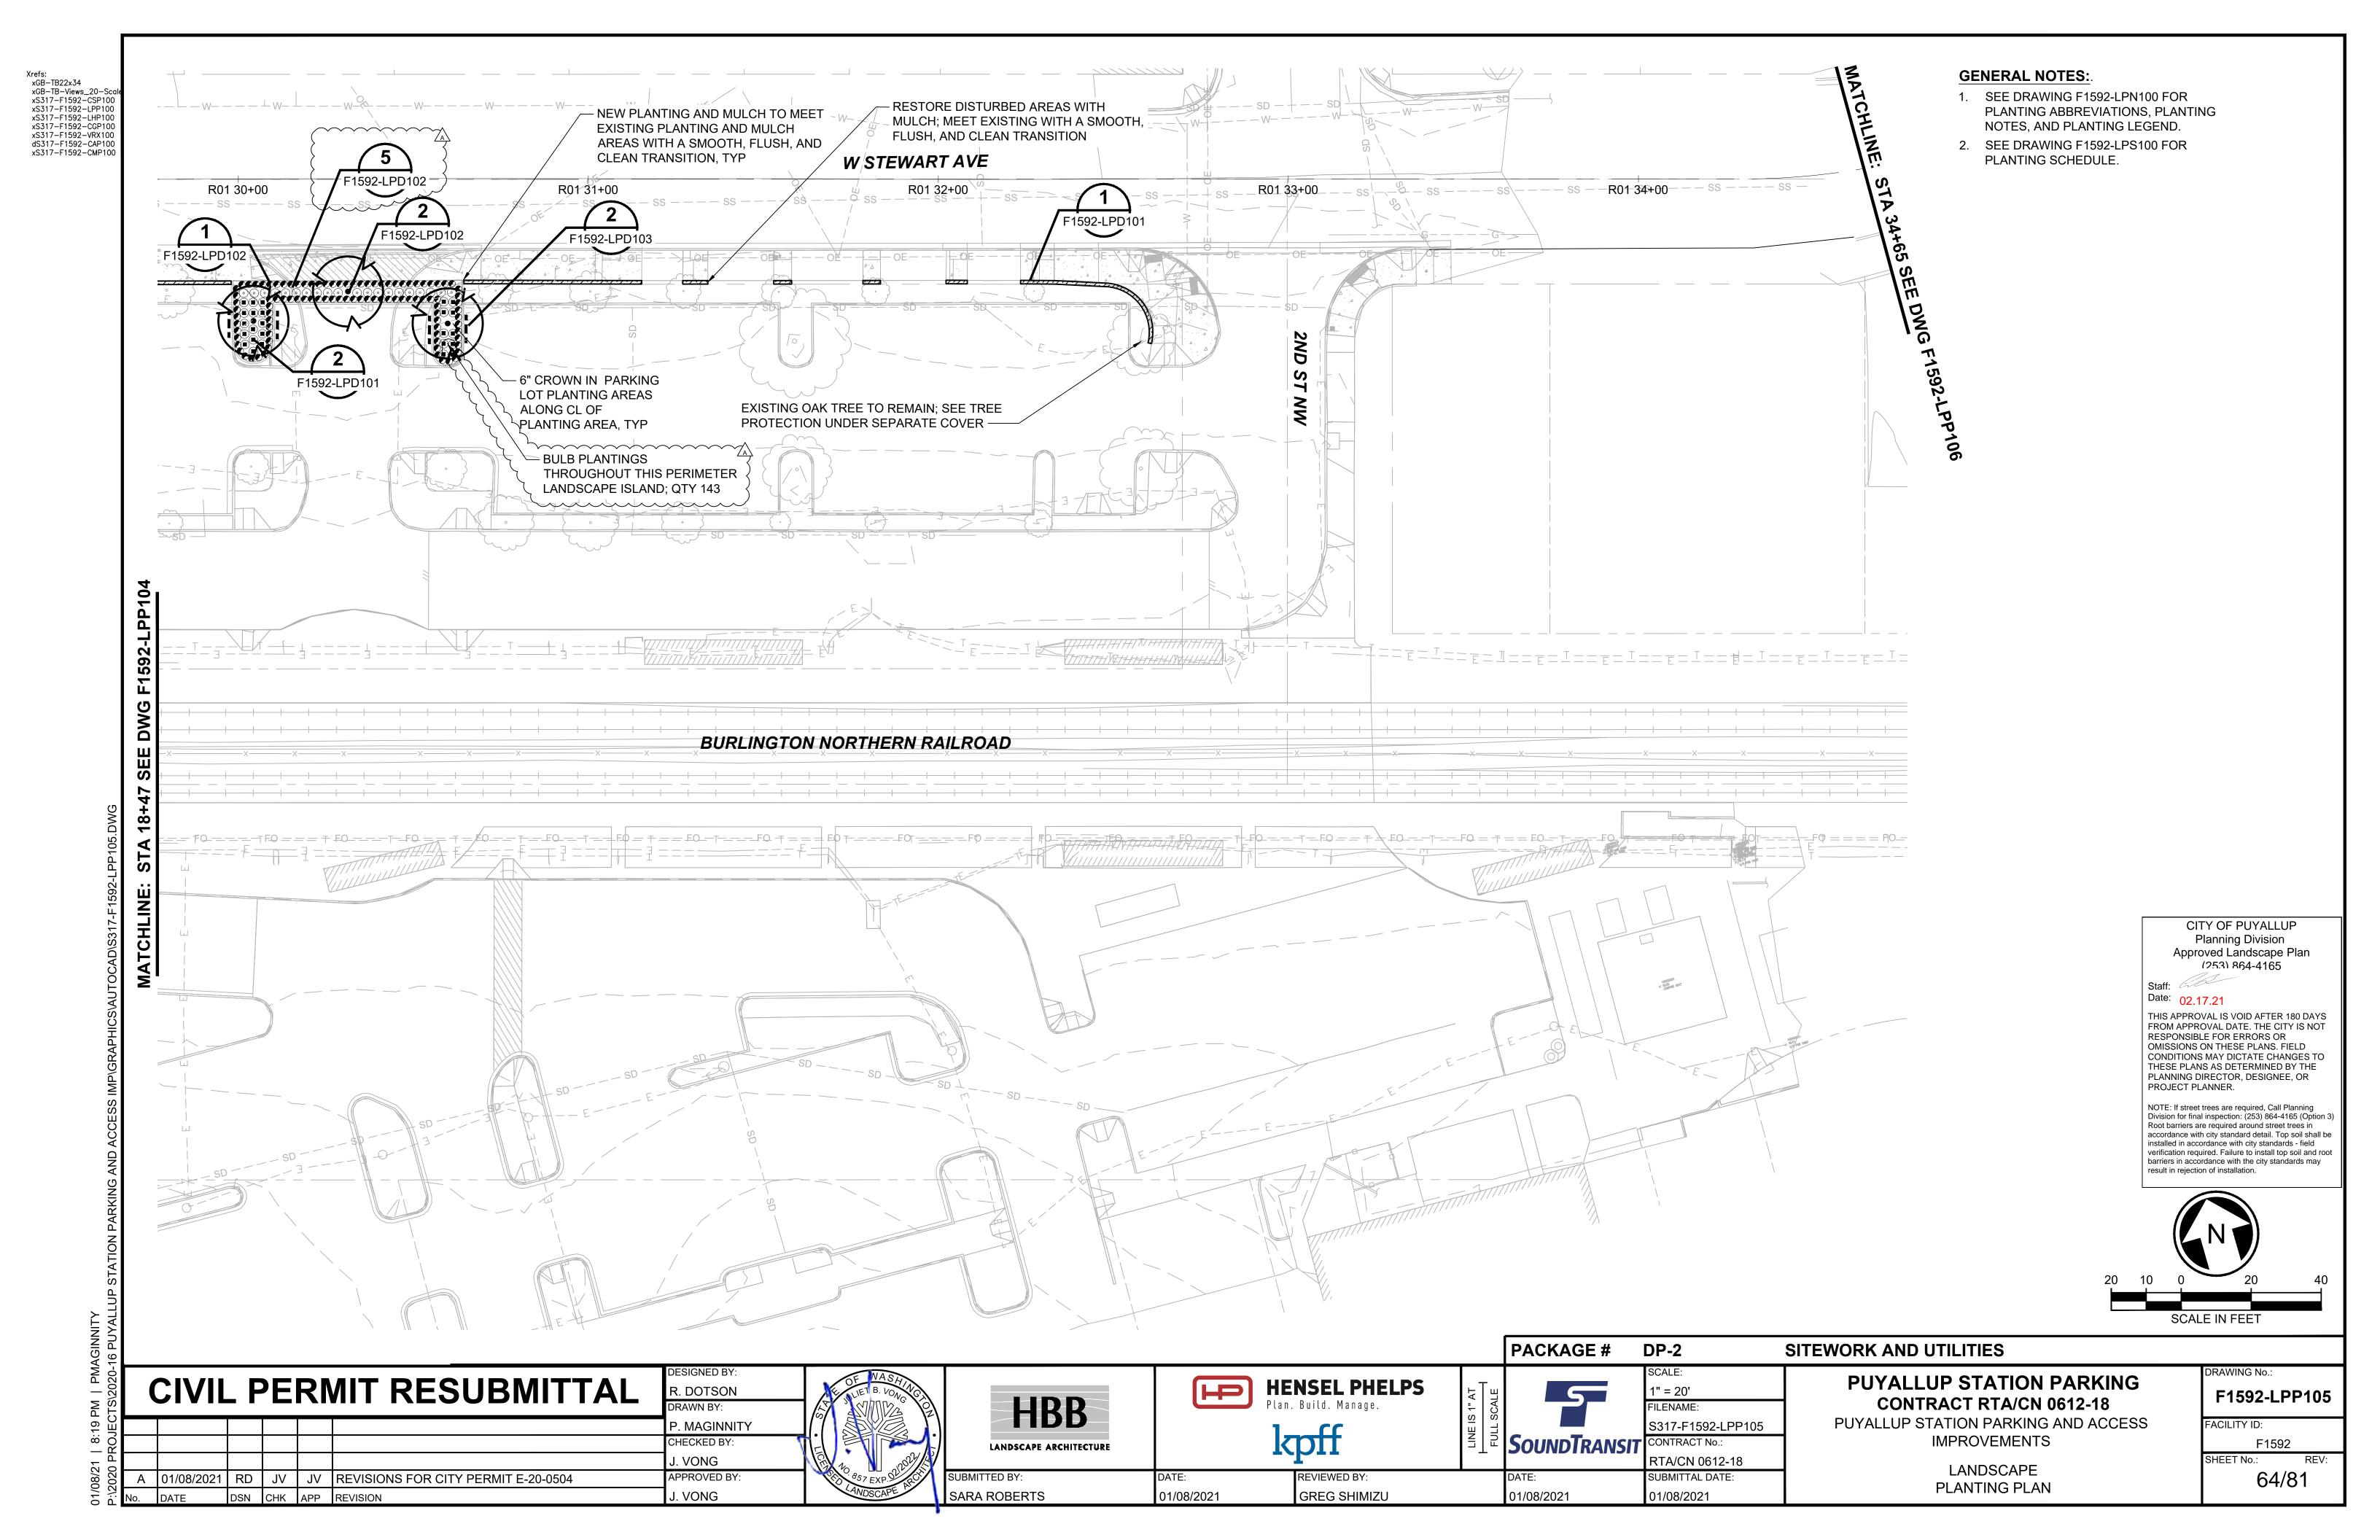

F1592-LPD102

F1592-LPD101

BULB PLANTINGS IN SIGNLE ROW AT PERIMETER OF PLANTING AREA, 6" OC &

9" CLR OF PAVING OR CURB EDGE; QTY 44 —/

GENERAL NOTES:


- SEE DRAWING F1592-LPN100 FOR PLANTING ABBREVIATIONS, PLANTING NOTES, AND PLANTING LEGEND.
- 2. SEE DRAWING F1592-LPS100 FOR PLANTING SCHEDULE.

CITY OF PUYALLUP
Planning Division
Approved Landscape Plan
(253) 864-4165

Staff: Date: 02.17.21

THIS APPROVAL IS VOID AFTER 180 DAYS FROM APPROVAL DATE. THE CITY IS NOT RESPONSIBLE FOR ERRORS OR OMISSIONS ON THESE PLANS. FIELD CONDITIONS MAY DICTATE CHANGES TO THESE PLANS AS DETERMINED BY THE PLANNING DIRECTOR, DESIGNEE, OR PROJECT PLANNER.

NOTE: If street trees are required, Call Planning Division for final inspection: (253) 864-4165 (Option 3) Root barriers are required around street trees in accordance with city standard detail. Top soil shall be installed in accordance with city standards - field verification required. Failure to install top soil and root barriers in accordance with the city standards may result in rejection of installation.

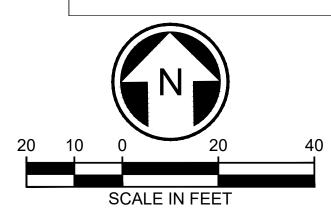

PACKAGE # DP-2 SITEWORK AND UTILITIES DRAWING No.: **PUYALLUP STATION PARKING CIVIL PERMIT RESUBMITTAL HENSEL PHELPS** H 1" = 20' F1592-LPP106 HBB CONTRACT RTA/CN 0612-18 Plan. Build. Manage. ILENAME: PUYALLUP STATION PARKING AND ACCESS S317-F1592-LPP106 FACILITY ID: P. MAGINNITY **IMPROVEMENTS SOUNDTRANSIT** CHECKED BY: CONTRACT No.: F1592 LANDSCAPE ARCHITECTURE RTA/CN 0612-18 J. VONG LANDSCAPE A 01/08/2021 RD JV JV REVISIONS FOR CITY PERMIT E-20-0504 65/81 APPROVED BY: REVIEWED BY: SUBMITTAL DATE: PLANTING PLAN SARA ROBERTS **GREG SHIMIZU** J. VONG 01/08/2021 01/08/2021 01/08/2021

E STEWART AVE

P:\2020 PROJECTS\2020-16 PUYALLUP STATION PA

NOTES:

STEP 1. AFTER CONCRETE AND OTHER INFRASTRUCTURE WORK IS COMPLETED, ESTABLISH TOP OF SCARIFIED SUBGRADE 4" BELOW ADJACENT CURB OR PAVING IN SOD AREAS AND(6" BĚLOW 🛝 ADJACENT CURB OR PAVING IN MULCH AREAS.

STEP 2. REMOVE ALL DEBRIS INCLUDING STUMPS, STICKS, ROOTS AND ROCKS OVER 1" AND DISPOSE OFF SITE, RESIDENT ENGINEER SHALL REVIEW AND APPROVE EXISTING SUBGRADE PRIOR TO INSTALLING PLANTING SOIL. VERIFY POSITIVE DRAINAGE.


STEP 3. INSTALL 3" DEPTH OF COMPACTED PLANTING SOIL. COMPACT TO 85% MAXIMUM DRY DENSITY. RESIDENT ENGINEER SHALL REVIEW AND APPROVE PLANTING SOIL INSTALLATION PRIOR TO

INSTALLING SOD OR MULCH.
STEP 4. INSTALL SOD OR 3" DEPTH MULCH. INSTALLING SOD OR MULCH.

RESTORATION AREA SOIL PREPARATION

SCALE: NTS

F1592-LPP101 F1592-LPP102 F1592-LPP106

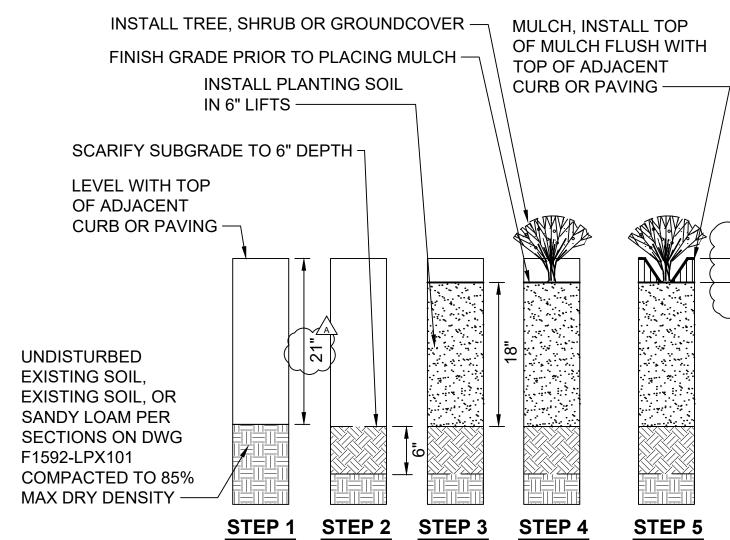

NOTES:

- 1. ALL DIMENSIONS INDICATE COMPACTED DEPTHS. COMPOST AND PLANTING SOIL SHALL BE COMPACTED TO 85% MAX DRY DENSITY.
- 2. COORDINATE SOIL PREPARATION WITH UTILITY LOCATIONS TO AVOID ANY CONFLICT. PROTECT EXISTING UTILITIES AS NEEDED.
- 3. REFER TO DRAWING F1592-CGP203 FOR SOIL PREPARATION IN BIORENTENTION CELLS.

STEP 1:

EXCAVATE EXISTING SOIL TO DEPTH REQUIRED BELOW ADJACENT CURB OR PAVING. AVOID UNDERMINING ADJACENT CURB OR PAVING BASE COURSE MATERIAL. PROVIDE TREE PIT DRAINAGE TEST PER SPECS, PRIOR TO PROCEEDING TO STEP 2.

STEP 2:

SCARIFY SUBGRADE TO 6" DEPTH.

STEP 3:

NSTALL AND SETTLE MIN 18" DEPTH PLANTING SOIL IN 6" LIFTS. INSTALL PLANTING SOIL & REVIEW FINISH GRADE WITH RESIDENT ENG PRIOR TO PLANTING. ADDITIONAL DEPTH OF PLANTING SOIL MAY BE REQUIRED TO PROVIDE MOUNDING OR CROSS SLOPE WHERE SHOWN ON DWGS.

STEP 4:

INSTALL PLANTS PER DETAILS.

STEP 5: INSTALL MULCH TO A 3" DEPTH.

PLANTING AREA SOIL PREPARATION

SCALE: NTS

F1592-LPP102 F1592-LPP103 F1592-LPP104 F1592-LPP105 F1592-LPX101

> CITY OF PUYALLUP Planning Division Approved Landscape Plan (253) 864-4165

Date: 02.17.21

THIS APPROVAL IS VOID AFTER 180 DAYS FROM APPROVAL DATE. THE CITY IS NOT RESPONSIBLE FOR ERRORS OR OMISSIONS ON THESE PLANS. FIELD CONDITIONS MAY DICTATE CHANGES TO THESE PLANS AS DETERMINED BY THE PLANNING DIRECTOR, DESIGNEE, OR PROJECT PLANNER.

NOTE: If street trees are required, Call Planning Division for final inspection: (253) 864-4165 (Option 3) Root barriers are required around street trees in accordance with city standard detail. Top soil shall be installed in accordance with city standards - field verification required. Failure to install top soil and root barriers in accordance with the city standards may result in rejection of installation.

CIVIL PERMIT RESUBMITTAL R. DOTSON P. MAGINNITY CHECKED BY . VONG RD JV JV REVISIONS FOR CITY PERMIT E-20-0504 APPROVED BY J. VONG

HBB LANDSCAPE ARCHITECTURE SUBMITTED BY:

SARA ROBERTS



01/08/2021

HENSEL PHELPS Plan. Build. Manage.



NTS ILENAME: S317-F1592-LPD101 SoundTransit CONTRACT No.: RTA/CN 0612-18 SUBMITTAL DATE:

DP-2

01/08/2021

PUYALLUP STATION PARKING

SITEWORK AND UTILITIES

CONTRACT RTA/CN 0612-18 PUYALLUP STATION PARKING AND ACCESS

IMPROVEMENTS LANDSCAPE

F1592-LPD101 FACILITY ID:

RAWING No.:

F1592 66/81

kpff REVIEWED BY:

GREG SHIMIZU

DATE: 01/08/2021

PACKAGE #


PLANTING DETAILS

SHRUB AND GROUNDCOVER PLANTING

SCALE: NTS

F1592-LPP102 F1592-LPP103 F1592-LPP104 F1592-LPP105

TO 85% MAX DRY DENSITY

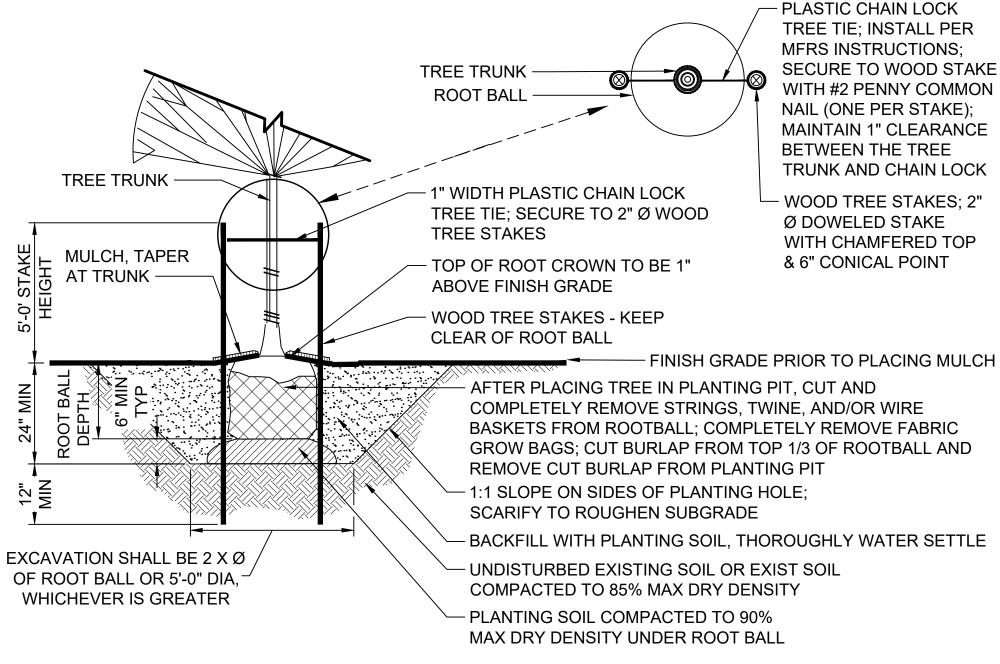

NOTES:


- ROTATE TREES IN PLANTING AREAS ADJACENT TO VEHICULAR ZONES SO THAT THE DOMINANT BRANCHES ALIGN PARALLEL TO THE VEHICULAR ZONES.
- 2. ONE STAKE PER TREE ON WINDWARD SIDE; SECOND STAKE ON LEEWARD SIDE. WHEN TREE IS ADJACENT TO SIDEWALK PLACE TREE STAKES PARALLEL TO SIDEWALK.

TREE TRUNK WOOD TREE STAKES; 2" Ø DOWELED STAKE WITH - PLASTIC CHAIN LOCK TREE TIE; INSTALL **CHAMFERED TOP & 6" CONICAL POINT** PER MFRS INSTRUCTIONS; SECURE TO WOOD STAKE WITH #2 PENNY COMMON NAIL (ONE PER STAKE); MAINTAIN 1" TREE TRUNK CLEARANCE BETWEEN THE TREE TRUNK AND CHAIN LOCK - ROOT BALL MULCH, TAPER 1" WIDTH PLASTIC CHAIN LOCK TREE TIE; AT TRUNK -SECURE TO 2" Ø WOOD TREE STAKES WOOD TREE STAKES - KEEP CLEAR OF ROOT BALL TOP OF ROOT CROWN TO BE 1" ABOVE FINISH GRADE - FINISH GRADE PRIOR TO PLACING MULCH AFTER PLACING TREE IN PLANTING PIT, CUT AND COMPLETELY REMOVE STRINGS, TWINE, AND/OR WIRE BASKETS FROM ROOTBALL; COMPLETELY REMOVE FABRIC GROW BAGS: CUT BURLAP FROM TOP 1/3 OF ROOTBALL AND REMOVE CUT BURLAP FROM PLANTING PIT - 1:1 SLOPE ON SIDES OF PLANTING HOLE, SCARIFY TO ROUGHEN SUBGRADE UNDISTURBED EXISTING SOIL **EXCAVATION SHALL** - BACKFILL WITH PLANTING SOIL; OR EXIST SOIL COMPACTED BE 2 X Ø OF ROOT THOROUGHLY WATER SETTLE TO 85% MAX DRY DENSITY BALL OR 5'-0" DIA, - PLANTING SOIL COMPACTED TO 90% WHICHEVER IS MAX DRY DENSITY UNDER ROOT BALL GREATER

NOTES:

CONIFER TREE PLANTING


1. ONE STAKE PER TREE ON WINDWARD SIDE; SECOND STAKE ON LEEWARD SIDE.

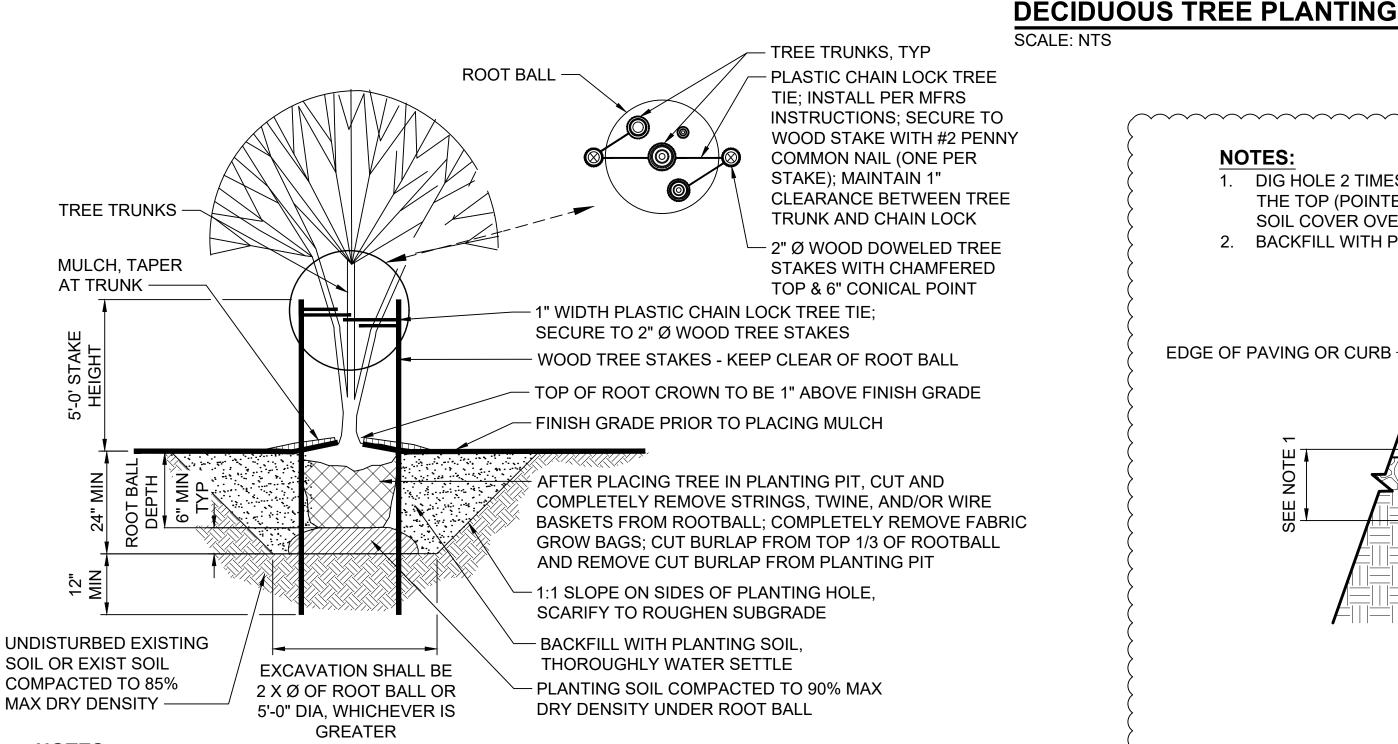


NOTES:

1. ONE STAKE PER TREE ON WINDWARD SIDE; SECOND STAKE ON LEEWARD SIDE. WHEN TREE IS ADJACENT TO SIDEWALK PLACE TREE STAKES PARALLEL TO SIDEWALK.

MULTI-TRUNK DECIDUOUS TREE PLANTING SCALE: NTS

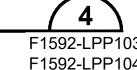



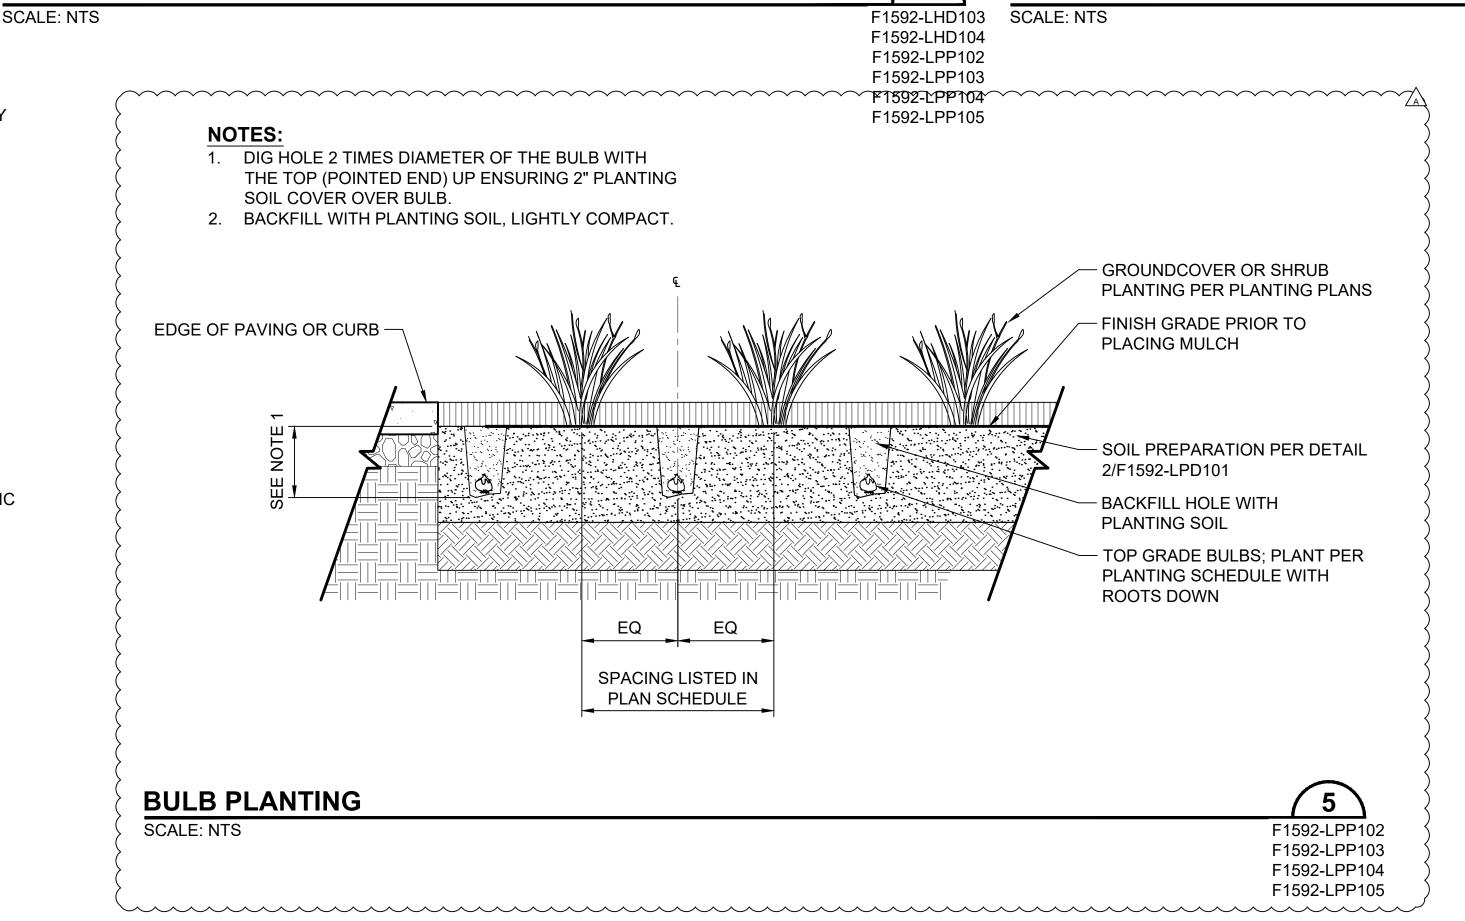

CIVIL PERMIT RESUBMITTAL R. DOTSON P. MAGINNITY CHECKED BY . VONG RD JV JV REVISIONS FOR CITY PERMIT E-20-0504 APPROVED BY A 01/08/2021 J. VONG





SARA ROBERTS







NTS ILENAME: S317-F1592-LPD102 CONTRACT No. RTA/CN 0612-18

SUBMITTAL DATE:

01/08/2021

DP-2

SITEWORK AND UTILITIES PUYALLUP STATION PARKING

CONTRACT RTA/CN 0612-18 PUYALLUP STATION PARKING AND ACCESS

IMPROVEMENTS LANDSCAPE PLANTING DETAILS RAWING No.: F1592-LPD102

CITY OF PUYALLUP

Planning Division

Approved Landscape Plan

(253) 864-4165

THIS APPROVAL IS VOID AFTER 180 DAYS

FROM APPROVAL DATE. THE CITY IS NOT

CONDITIONS MAY DICTATE CHANGES TO THESE PLANS AS DETERMINED BY THE

RESPONSIBLE FOR ERRORS OR

OMISSIONS ON THESE PLANS. FIELD

PLANNING DIRECTOR, DESIGNEE, OR

NOTE: If street trees are required, Call Planning Division for final inspection: (253) 864-4165 (Option 3)

Root barriers are required around street trees in

nstalled in accordance with city standards - field erification required. Failure to install top soil and root

barriers in accordance with the city standards may

FACILITY ID:

accordance with city standard detail. Top soil shall be

Date: 02.17.21

PROJECT PLANNER.

3

F1592-LPP10

F1592-LPP104

F1592 67/81

01/08/2021


kpff REVIEWED BY:

GREG SHIMIZU

01/08/2021

PACKAGE #


- LOCATE LANDSCAPE BOULDERS PER RESIDENT ENG FIELD DIRECTIVE.
- 2. RESIDENT ENG TO REVIEW CRUSHED SURFACING BASE COURSE PRIOR TO BOULDER PLACEMENT.

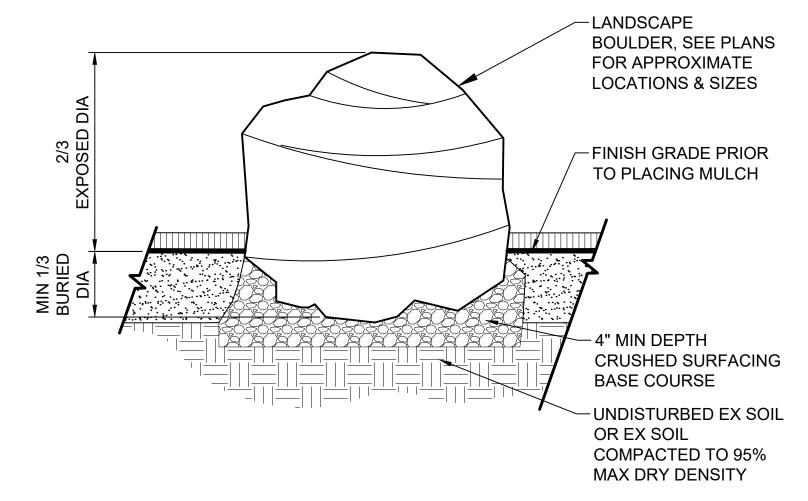

LANDSCAPE BOULDER SCALE: NTS

F1592-LPP104

F1592-LPP103

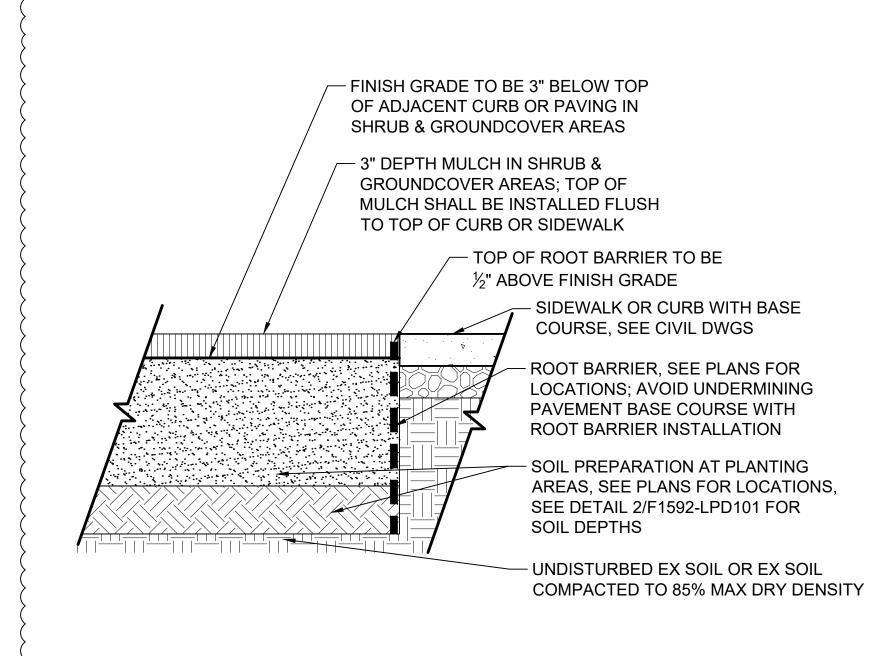

- FINISH GRADE TO BE 3" BELOW TOP OF ADJACENT CURB OR PAVING IN SHRUB & **GROUNDCOVER AREAS** — 3" DEPTH MULCH IN SHRUB & GROUNDCOVER AREAS; INSTALL TOP OF MULCH FLUSH TO TOP OF CURB OR SIDEWALK SIDEWALK OR CURB WITH BASE COURSE. SEE CIVIL DWGS - 1:1 SLOPE EA SIDE EXCEPT AT ROOT BARRIER LOCATIONS, TYP; AVOID UNDERMINING BASE COURSE - SOIL PREPARATION AT PLANTING AREAS, SEE PLANS FOR LOCATIONS, SEE DETAIL 2/F1592-LPD101 FOR SOIL DEPTHS - UNDISTURBED EX SOIL OR EX SOIL COMPACTED TO 85% MAX DRY DENSITY

NOTES:

- 1. VERTICAL RIBS OF ROOT BARRIER SHALL FACE THE ROOTBALL OF THE TREE.
- 2. ROOT BARRIER TO BE 18" DEPTH AT PARKING LOT ISLANDS & ADJACENT TO SOIL CELLS AND 24" DEPTH AT ALL OTHER PAVING EDGES PER CITY OF PUYALLUP STANDARD DETAIL 01.02.03.

SCALE: NTS

F1592-LPP102 F1592-LPP103 F1592-LPP104 F1592-LPP105

(253) 864-4165 Date: 02.17.21

THIS APPROVAL IS VOID AFTER 180 DAYS FROM APPROVAL DATE. THE CITY IS NOT RESPONSIBLE FOR ERRORS OR OMISSIONS ON THESE PLANS. FIELD CONDITIONS MAY DICTATE CHANGES TO THESE PLANS AS DETERMINED BY THE PLANNING DIRECTOR, DESIGNEE, OR PROJECT PLANNER.

CITY OF PUYALLUP Planning Division Approved Landscape Plan

NOTE: If street trees are required, Call Planning Division for final inspection: (253) 864-4165 (Option 3 Root barriers are required around street trees in accordance with city standard detail. Top soil shall be installed in accordance with city standards - field verification required. Failure to install top soil and root barriers in accordance with the city standards may result in rejection of installation.

SOIL PREP AT PLANTING EDGE

	CIVIL	DESIGNED BY: R. DOTSON						
CIVIL PERMIT RESUBMITTAL R. DOTSO								
						P. MAGINNITY		
						CHECKED BY:		
						J. VONG		
	01/08/2021	RD	JV	JV	REVISIONS FOR CITY PERMIT E-20-0504	APPROVED BY:		
	DATE	DSN	CHK	APP	REVISION	J. VONG		

SARA ROBERTS

HBB LANDSCAPE ARCHITECTURE







SOUNDTRANSIT

PACKAGE #

ILENAME: S317-F1592-LPD103 CONTRACT No.:

PUYALLUP STATION PARKING CONTRACT RTA/CN 0612-18 PUYALLUP STATION PARKING AND ACCESS

SITEWORK AND UTILITIES

IMPROVEMENTS LANDSCAPE

DRAWING No.: F1592-LPD103

F1592

FACILITY ID:

P

01/08/2021

kpff

REVIEWED BY: **GREG SHIMIZU**

DATE:

01/08/2021


RTA/CN 0612-18 SUBMITTAL DATE:


01/08/2021

DP-2

PLANTING DETAILS


68/81

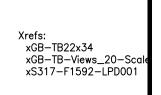

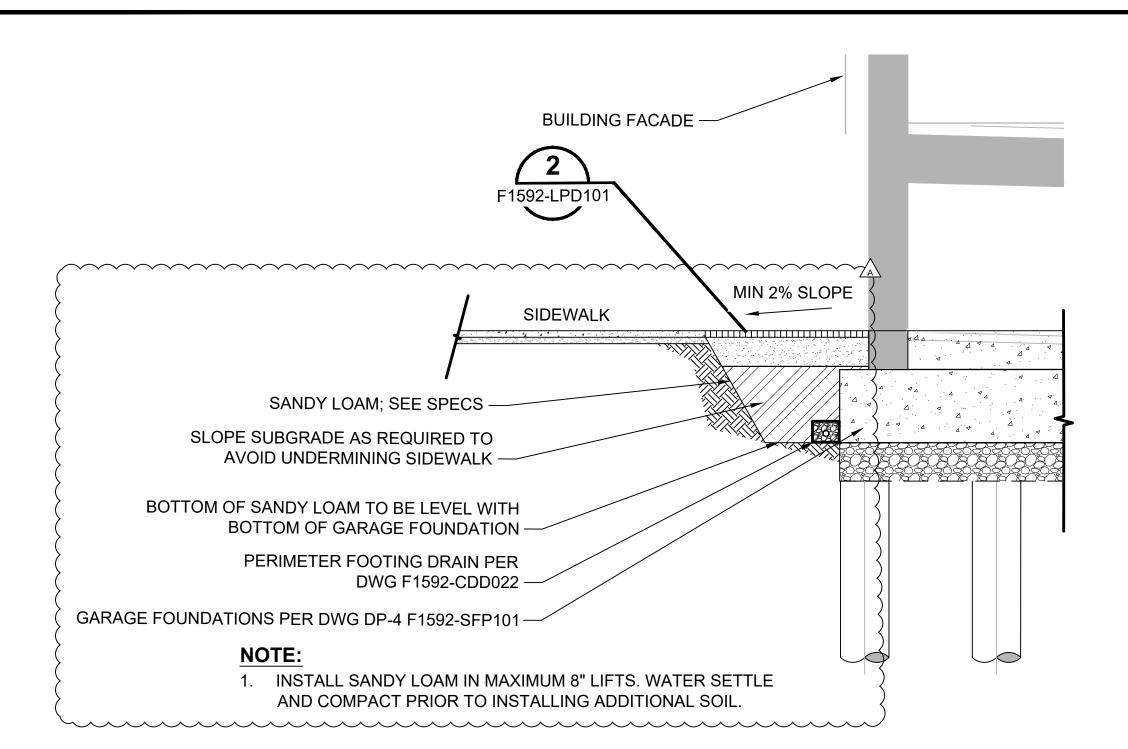

WEST SECTION

SCALE: 1"=5'-0"

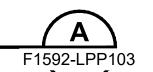


SCALE: 1"=5'-0"

(253) 864-4165 THIS APPROVAL IS VOID AFTER 180 DAYS **BUILDING FACADE** FROM APPROVAL DATE. THE CITY IS NOT RESPONSIBLE FOR ERRORS OR OMISSIONS ON THESE PLANS. FIELD CONDITIONS MAY DICTATE CHANGES TO THESE PLANS AS DETERMINED BY THE PLANNING DIRECTOR, DESIGNEE, OR PROJECT PLANNER. NOTE: If street trees are required, Call Planning Division for final inspection: (253) 864-4165 (Option 3) MIN 2% SLOPE Root barriers are required around street trees in accordance with city standard detail. Top soil shall be SIDEWALK installed in accordance with city standards - field verification required. Failure to install top soil and root barriers in accordance with the city standards may result in rejection of installation. SANDY LOAM; SEE SPECS SLOPE SUBGRADE AS REQUIRED TO AVOID UNDERMINING SIDEWALK BOTTOM OF SANDY LOAM TO BE LEVEL WITH **BOTTOM OF GARAGE FOUNDATION** PERIMETER FOOTING DRAIN PER DWG F1592-CDD022 GARAGE FOUNDATIONS PER DWG DP-4 F1592-SFP101 NOTE: 1. INSTALL SANDY LOAM IN MAXIMUM 8" LIFTS. WATER SETTLE AND COMPACT PRIOR TO INSTALLING ADDITIONAL SOIL.

NORTH SECTION

F1592-LPP103

CITY OF PUYALLUP Planning Division Approved Landscape Plan

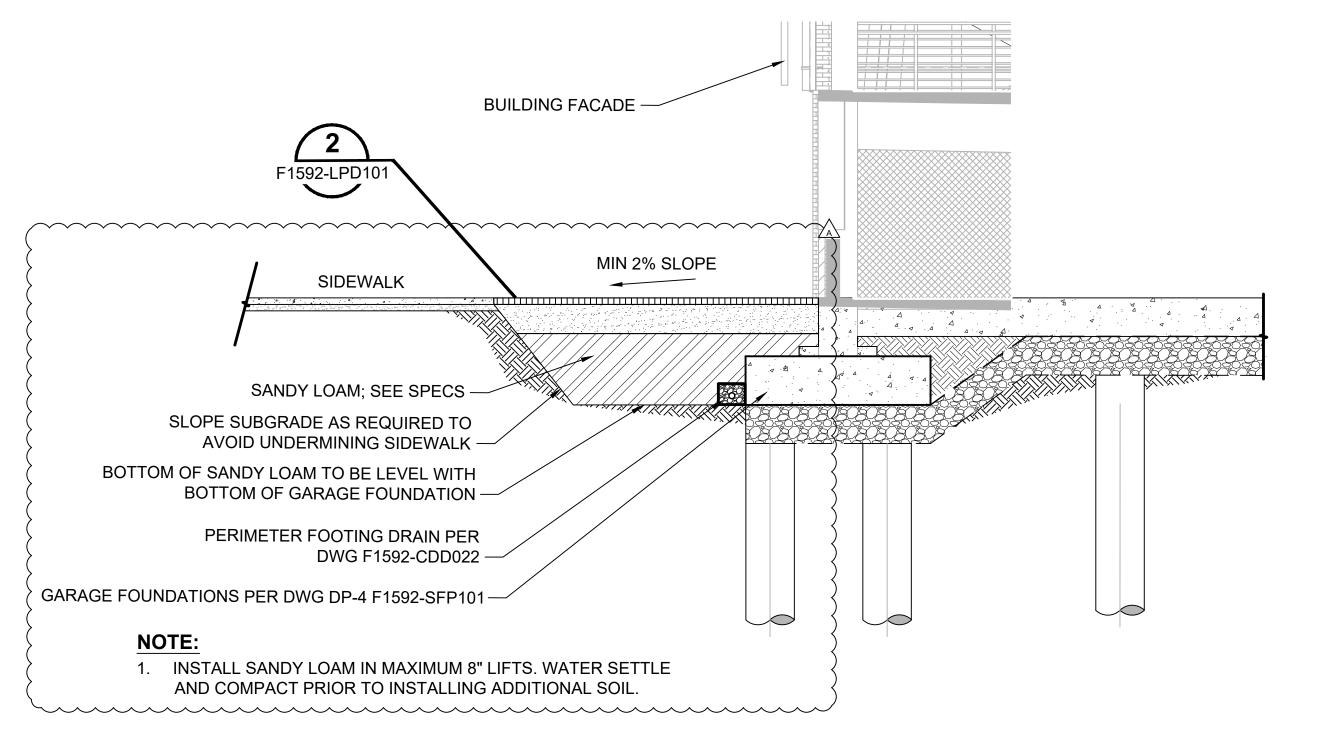

J. VONG

BUILDING FACADE MIN 2% SLOPE SIDEWALK DUCT BANK PER DWG DP-7 F1592-UPP701-SANDY LOAM; SEE SPECS -SLOPE SUBGRADE AS REQUIRED TO AVOID UNDERMINING SIDEWALK BOTTOM OF SANDY LOAM TO BE LEVEL WITH **BOTTOM OF GARAGE FOUNDATION -**PERIMETER FOOTING DRAIN PER DWG F1592-CDD022 -GARAGE FOUNDATIONS PER DWG DP-4 F1592-SFP101-1. INSTALL SANDY LOAM IN MAXIMUM 8" LIFTS. WATER SETTLE AND COMPACT PRIOR TO INSTALLING ADDITIONAL SOIL.

EAST SECTION

SCALE: 1"=5'-0"

D) F1592-LPP103

SOUTH SECTION

SCALE: 1"=5'-0"

F1592-LPP103

CIVIL PERMIT RESUBMITTAL R. DOTSON P. MAGINNITY CHECKED BY . VONG APPROVED BY



SARA ROBERTS





PACKAGE #

DP-2 1"=5'-0" ILENAME: S317-F1592-LPX101 CONTRACT No. RTA/CN 0612-18

SITEWORK AND UTILITIES **PUYALLUP STATION PARKING CONTRACT RTA/CN 0612-18** PUYALLUP STATION PARKING AND ACCESS

> **IMPROVEMENTS** LANDSCAPE

RAWING No.: F1592-LPX101

FACILITY ID:

69/81

F1592

A | 01/08/2021 | RD | JV | JV | REVISIONS FOR CITY PERMIT E-20-0504

LANDSCAPE ARCHITECTURE

01/08/2021

REVIEWED BY: **GREG SHIMIZU**

SUBMITTAL DATE: 01/08/2021 01/08/2021

PLANTING SECTIONS

NEW AUTOMATIC IRRIGATION SYSTEM TO MEET, MATCH, AND CONTINUE EXISTING ADJACENT IRRIGATION SYSTEM CONTRACTOR SHALL DESIGN NEW IRRIGATION SYSTEM AND SUBMIT SHOP DRAWING FOR RESIDENT ENG REVIEW & APPROVAL PRIOR TO BEGINNING CONST, SEE SPECS

NEW PLANTING AREA TO RECEIVE HAND WATERING THROUGH ESTABLISHMENT PERIOD


IRRIGATION ABBREVIATIONS

#/NO	NUMBER	IRR	IRRIGATION
%	PERCENT	MAX	MAXIMUM
&	AND	MFRS	MANUFACTURERS
ABBV	ABBREVIATIONS	MIN	MINIMUM
BKF	BACKFILL	OC	ON CENTER
CF	CUBIC FEET	POC	POINT OF CONNECTION
CLR	CLEAR	PVC	POLYVINYL CHLORIDE
DIA	DIAMETER	PSI	POUNDS PER SQUARE INCH
DWG(S)	DRAWING(S)	SCH	SCHEDULE
ENG	ENGINEER	STA	STATION
EX	EXISTING	SPEC(S)	SPECIFICATION(S)
GPM	GALLONS PER MINUTE	TYP	TYPICAL

IRRIGATION NOTES

- 1. LOCATE IRRIGATION POINT OF CONNECTION, QUICK COUPLING VALVE & AUTOMATIC CONTROL VALVES IN SHRUB/ GROUNDCOVER AREAS AT POINT OF EASY ACCESS. ENG TO REVIEW & APPROVE FINAL LOCATION OF ALL VALVES PRIOR TO INSTALLATION. ^
- 2. EX STATIC PSI AT IRRIGATION METER IS 58 PSI. PRIOR TO INSTALLATION OF IRRIGATION SYSTEM, CONTRACTOR SHALL FIELD VERIFY EX PSI NOTIFY RESIDENT ENG OF ANY DISCREPANCIES BETWEEN THE DESIGN PSI & EX PSI PRIOR TO PROCEEDING WITH WORK.
- 3. DRAWING IS SCHEMATIC. ACTUAL LOCATIONS MAY VARY DUE TO PLANT MATERIALS, UTILITIES OR EX CONDITIONS. CONTRACTOR IS RESPONSIBLE FOR LOCATING UTILITIES PRIOR TO BEGINNING CONSTRUCTION.
- 4. OPEN DRIP FLUSH VALVES AND AIR BLOW IRRIGATION SYSTEM THROUGH QUICK COUPLERS TO WINTERIZE IRRIGATION SYSTEM.

CIVIL PERMIT RESUBMITTAL R. DOTSON P. MAGINNITY CHECKED BY: J. VONG A 01/08/2021 RD JV JV REVISIONS FOR CITY PERMIT E-20-0504 APPROVED BY: DSN CHK APP REVISION J. VONG

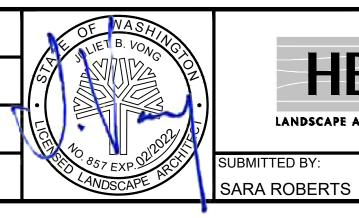





01/08/2021



REVIEWED BY:

GREG SHIMIZU



DATE:

01/08/2021

PACKAGE #

5 FILENAME: SOUNDTRANSIT CONTRACT No.:

DP-2

S317-F1592-LRN100 RTA/CN 0612-18 SUBMITTAL DATE: 01/08/2021


SITEWORK AND UTILITIES **PUYALLUP STATION PARKING**

CONTRACT RTA/CN 0612-18 PUYALLUP STATION PARKING AND ACCESS **IMPROVEMENTS**

LANDSCAPE IRRIGATION GENERAL NOTES, LEGEND, AND ABBREVIATIONS DRAWING No.: F1592-LRN100

F1592 70/81

FACILITY ID:

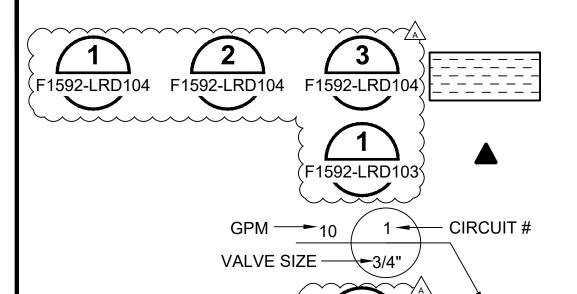

NETAFIM TECHLINE CV DRIPPER TUBING MODEL TLCV4-18)

NETAFIM MANUAL FLUSH VALVE(TLŠOV)

AUTOMATIC CONTROL VALVE KIT WITH PRESSURE REGULATOR AND DISC FILTER: RAINBIRD XCZ-PRB-COM


F1592-LRD103


F1592-LRD102

DRIP LINE OPERATION INDICATOR, NETAFIM 10-CV-01

4 F1592-LRD103

3/4" HEADER CONNECTION ON SUPPLY OR EXHAUST HEADER (SCH 40 PVC)

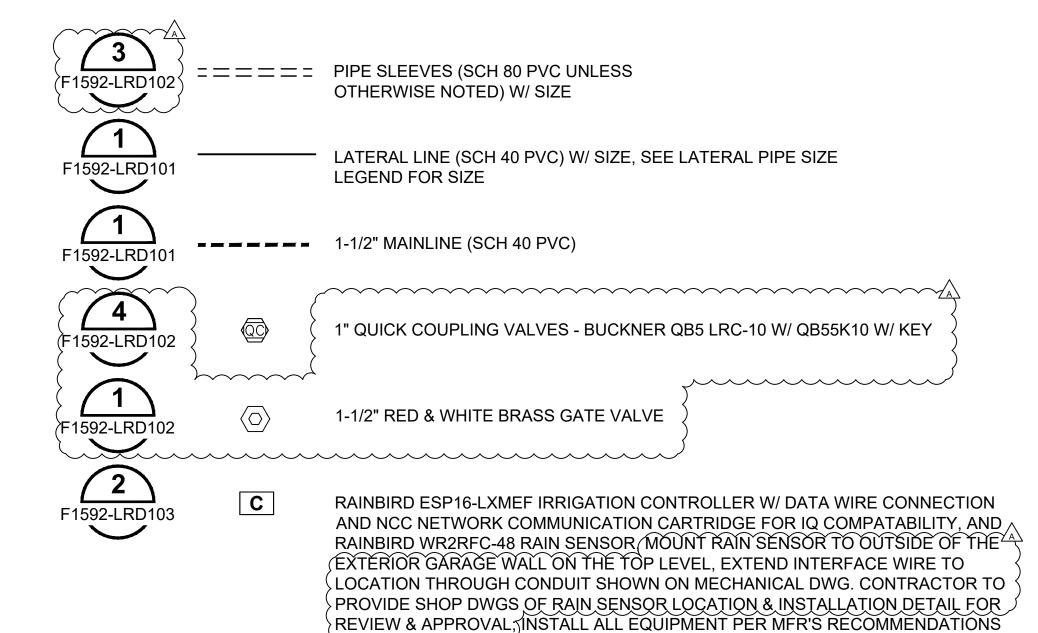

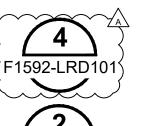



M

WEATHERMATIC 8200 CR SERIES (NORMALLY CLOSED) MASTER CONTROL VALVE 1 1/2" SIZE

(1")İRRIGATION WATER METER- SEE DWG F1592-UCP203



1" DATA INDUSTRIAL FLOW SENSOR MODEL # IR220P





POINT OF CONNECTION



1" WILKENS 950 XL DOUBLE CHECK VALVE ASSEMBLY

F1592-LRD101

1-1/2" MUELLER ORISEAL II CURB STOP VALVE

CIVIL PERMIT RESUBMITTAL R. DOTSON P. MAGINNITY CHECKED BY . VONG A 01/08/2021 RD JV JV REVISIONS FOR CITY PERMIT E-20-0504 APPROVED BY J. VONG





SARA ROBERTS



01/08/2021



REVIEWED BY:

GREG SHIMIZU



PACKAGE #

01/08/2021

FILENAME: S317-F1592-LRS100 SOUNDTRANSIT CONTRACT No.: RTA/CN 0612-18

DP-2

SUBMITTAL DATE:

01/08/2021

SITEWORK AND UTILITIES **PUYALLUP STATION PARKING** CONTRACT RTA/CN 0612-18


> **IMPROVEMENTS** LANDSCAPE IRRIGATION SCHEDULE

PUYALLUP STATION PARKING AND ACCESS

RAWING No.: F1592-LRS100


FACILITY ID:

F1592 71/81

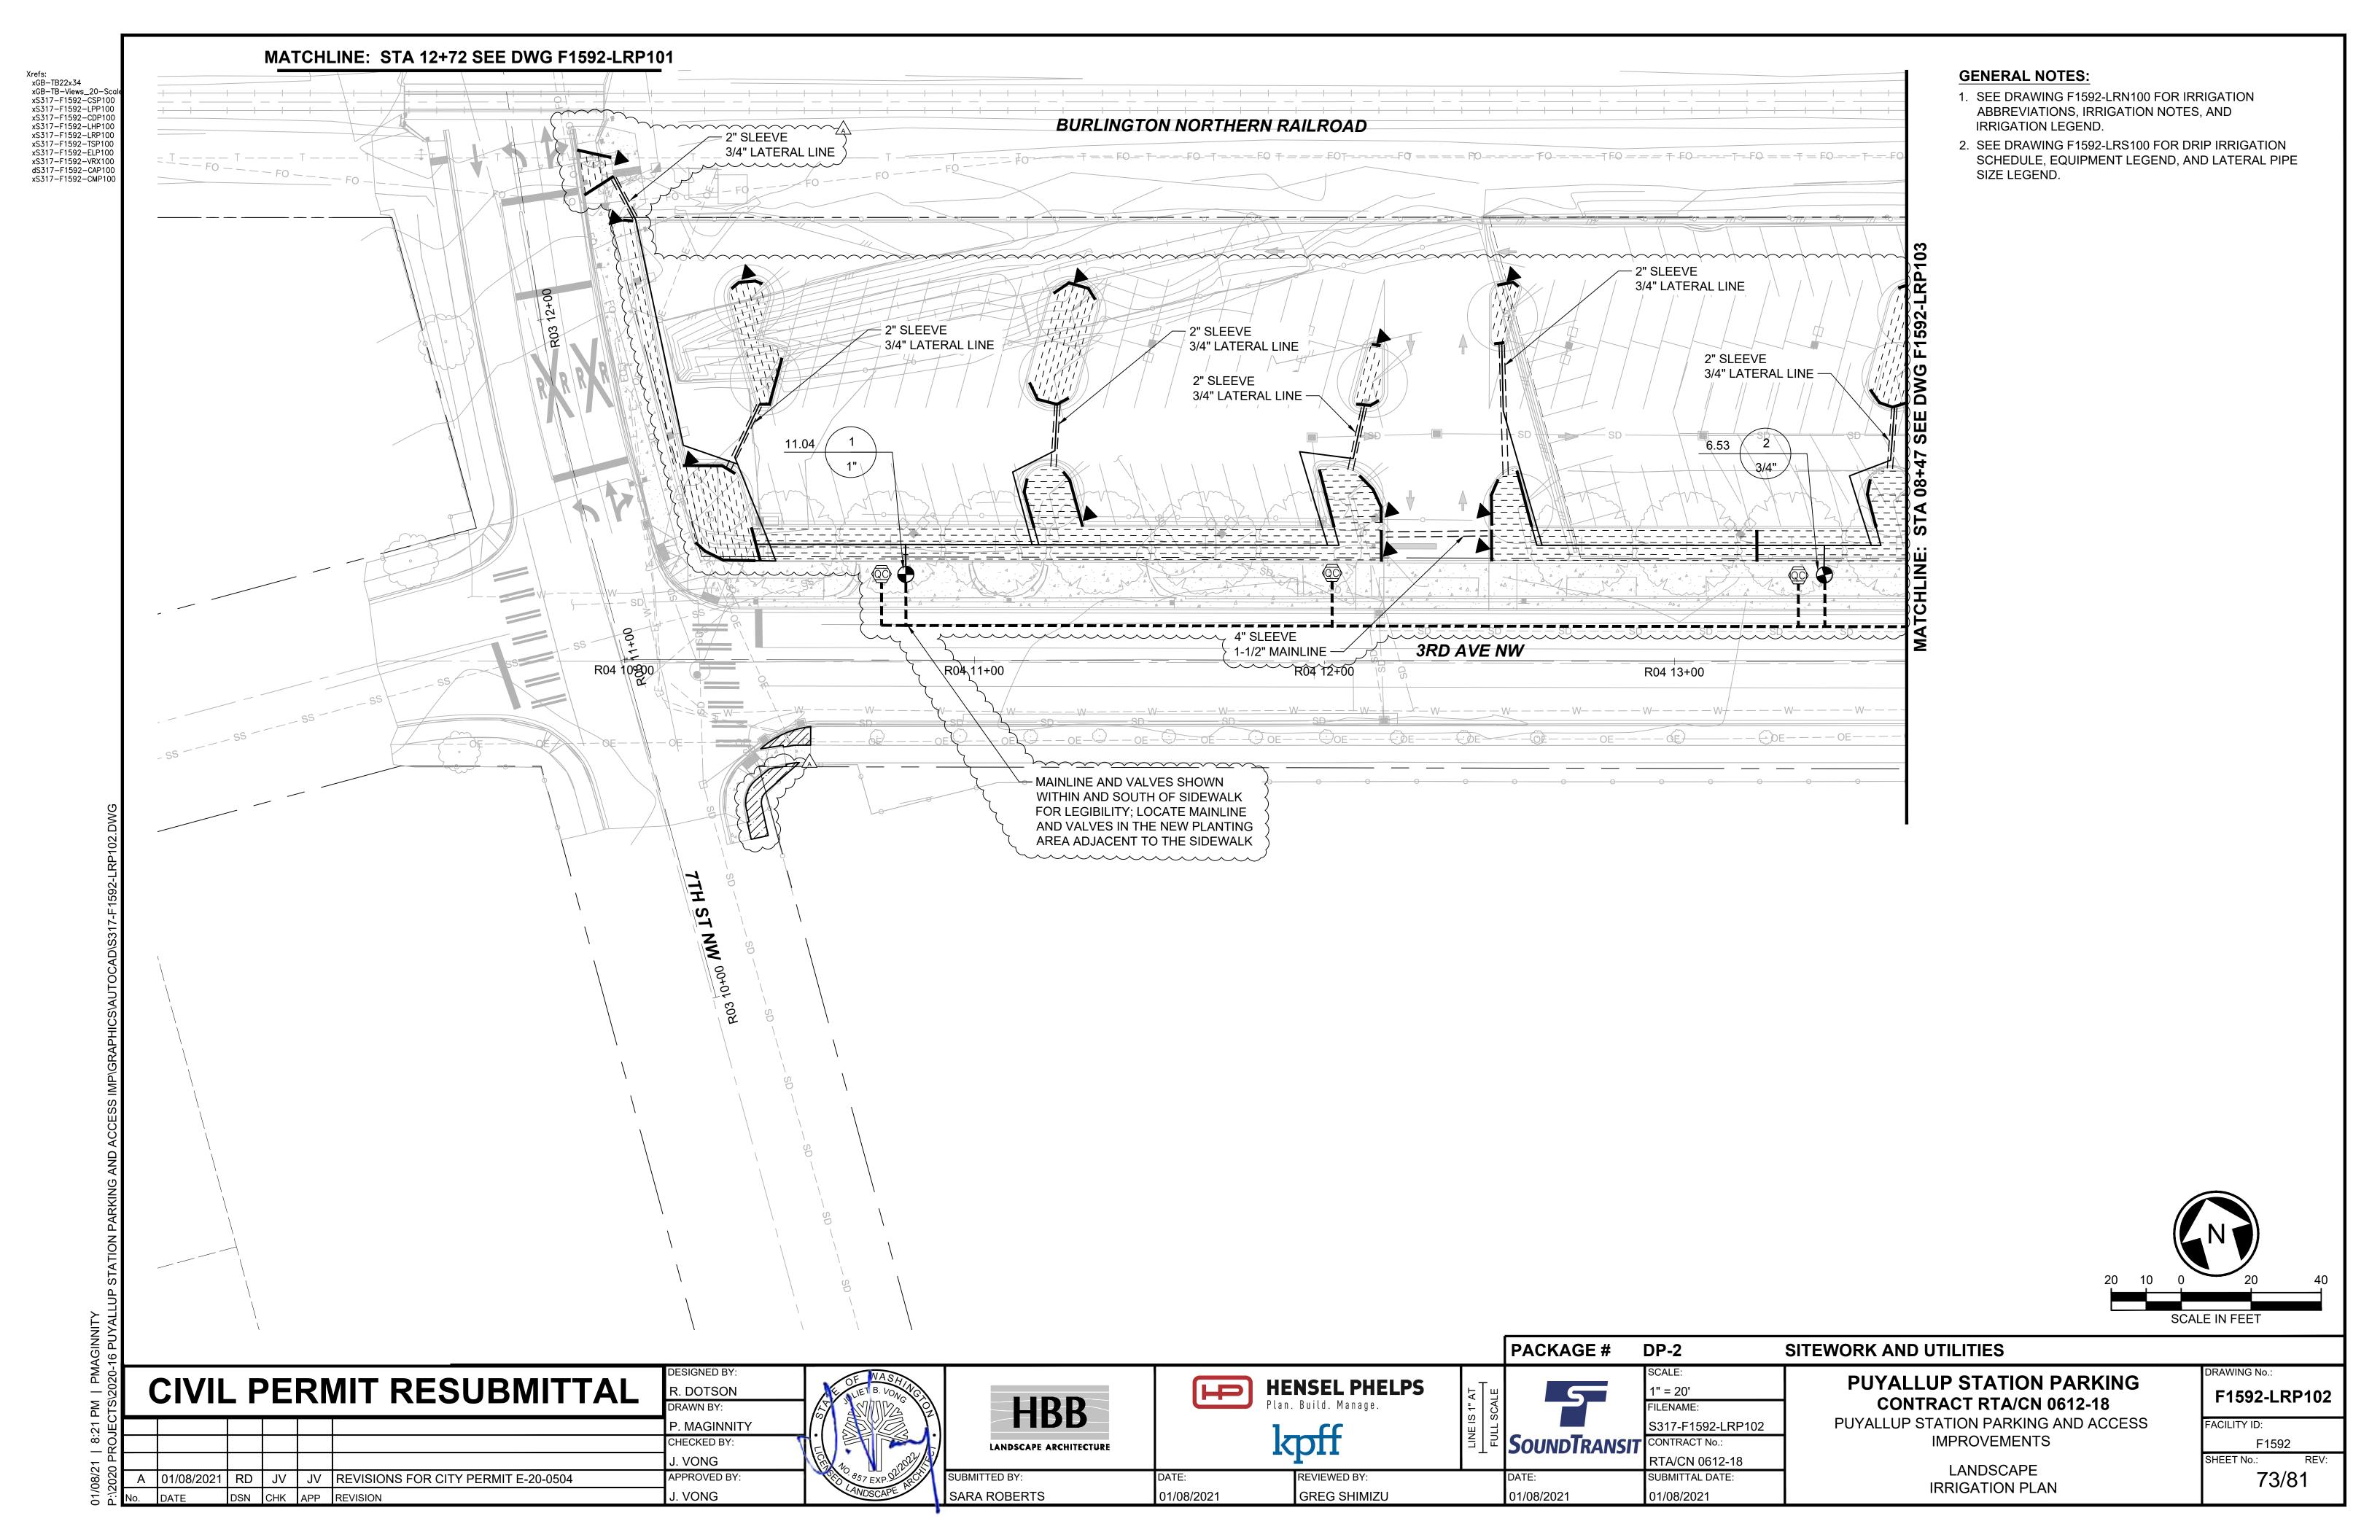


Xrefs: xGB-TB22x34 **GENERAL NOTES:** xGB-TB-Views_20-Sc 1. IRRIGATION CONTROLLER TO BE LOCATED IN xS317-F1592-CSP100 xS317-F1592-LPP100 MECHANICAL ROOM; REFER TO DP-5 F1592-EPD830 xS317-F1592-CDP100 xS317-F1592-LHP100 BURLINGTON NORTHERN RAILROAD FOR EXACT LOCATION AND CONDUIT. xS317-F1592-LRP100 xS317-F1592-UWP100 2. SEE DRAWING F1592-LRN100 FOR IRRIGATION xS317-F1592-UCP100 ABBREVIATIONS, IRRIGATION NOTES, AND xS317-F1592-TSP100 xS317-F1592-ELP100 IRRIGATION LEGEND. xS317-F1592-APP101 xS317-F1592-VRX100 3. SEE DRAWING F1592-LRS100 FOR DRIP IRRIGATION dS317-F1592-CAP100 xS317-F1592-CMP100 SCHEDULE, EQUIPMENT LEGEND, AND LATERAL PIPE SIZE LEGEND. 2" SLEEVE 3/4" LATERAL LINE 2" SLEEVE 3/4" LATERAL LINE 2" SLEEVE 3/4" LATERAL LINE -2" SLEEVE 3/4" LATERAL LINE -2" SLEEVE 1" LATERAL LINE 1" LATERAL LINE IRRIGATION CONTROLLER AND RAIN SENSOR CONTROLLER INTERFACE -CONDUIT FOR CONTROL WIRES; SEE DP-5 EPP SERIES DWGS -3RD AVE NW R04 14+00 2" SLEEVE 3/4" LATERAL LINE 4" SLEEVE 1-1/2" MAINLINE -**CONTRACTOR TO PROVIDE** SHOP DWG OF RAIN POINT OF CONNECTION; SENSOR LOCATION AND FIELD VERIFY LOCATION W/ INSTALLATION DETAIL FOR 3/4" ENG PRIOR TO INSTALLATION REVIEW AND APPROVAL 6" SLEEVE 1-1/2" MAINLINE MAINLINE AND VALVES SHOWN 1.09 WITHIN AND OUTSIDE OF PATH FOR LEGIBILITY; LOCATE MAINLINE AND VALVES IN THE NEW PLANTING AREA ADJACENT TO THE PATH -EXISTING OAK TREE TO REMAIN; SEE TREE PROTECTION UNDER SEPARATE COVER — - 6" SLEEVE 1-1/2" MAINLINE 3/4" LATERAL LINE SCALE IN FEET PACKAGE # DP-2 SITEWORK AND UTILITIES DRAWING No.: **CIVIL PERMIT RESUBMITTAL PUYALLUP STATION PARKING HENSEL PHELPS** P R. DOTSON 1" = 20' F1592-LRP103 **HBB** CONTRACT RTA/CN 0612-18 Plan. Build. Manage. ILENAME: PUYALLUP STATION PARKING AND ACCESS S317-F1592-LRP103 FACILITY ID: P. MAGINNITY **kpff SOUNDTRANSIT IMPROVEMENTS** F1592 CHECKED BY CONTRACT No. LANDSCAPE ARCHITECTURE . VONG RTA/CN 0612-18 LANDSCAPE RD JV JV REVISIONS FOR CITY PERMIT E-20-0504 74/81 APPROVED BY REVIEWED BY: SUBMITTAL DATE: IRRIGATION PLAN SARA ROBERTS **GREG SHIMIZU** J. VONG 01/08/2021 01/08/2021 01/08/2021

Xrefs:
xGB-TB22x34
xGB-TB-Views_20-Scal
xS317-F1592-CSP100
xS317-F1592-LPP100
xS317-F1592-LPP100
xS317-F1592-LHP100
xS317-F1592-LRP100
xS317-F1592-LP100
xS317-F1592-VRX100
dS317-F1592-CAP100 **GENERAL NOTES:** 1. SEE DRAWING F1592-LRN100 FOR IRRIGATION ABBREVIATIONS, IRRIGATION NOTES, AND IRRIGATION LEGEND. INSIDE DASHED LINE PROTECT AND 2. SEE DRAWING F1592-LRS100 FOR DRIP IRRIGATION RESTORE EXISTING IRRIGATION W STEWART AVE SCHEDULE, EQUIPMENT LEGEND, AND LATERAL PIPE SYSTEM TO REMAIN; SEE SPECS -SIZE LEGEND. _R01_27+00_ ss ---- ss ---- ss ---- ss ---- ss ---- ss ----R01 29+00 R01 25+00 -- ss -- - ss -<u>-</u> -- ss - MAINLINE AND VALVES SHOWN WITHIN AND CONNECT IRRIGATION CONTROL VALVE TO - NORTH OF SIDEWALK FOR LEGIBILITY; EXISTING CONTROL WIRES AND EXISTING LOCATE MAINLINE AND VALVES IN THE NEW IRRIGATION CONTROLLER PLANTING AREA ADJACENT TO THE SIDEWALK ← 6" SLEEVE 19.24 __ 1-1/2" MAINLINE BURLINGTON NORTHERN RAILROAD 1-1/2"/ ×– 1" LATERAL LINE 6" SLEEVE EXISTING IRRIGATION MAIN LINE - 1-1/2" MAINLINE WITH 2 CONTROL WIRES TO REMAIN; 3/4" LATERAL LINE FIELD VERIFY CUT EX MAINLINE AND CONTROL WIRES AND INSTALL NEW GATE VALVE; GATE VALVE SHOWN IN PAVING FOR LEGIBILITY; LOCATE GATE VALVE IN THE ADJACENT NEW PLANTING AREA **EXISTING IRRIGATION** CONTROLLER LOCATED INSIDE 1-1/2" MAINLINE 1" LATERAL LINE BUILDING; FIELD VERIFY 3/4" LATERAL LINE PACKAGE # DP-2 SITEWORK AND UTILITIES DRAWING No.: **PUYALLUP STATION PARKING CIVIL PERMIT RESUBMITTAL HENSEL PHELPS** P R. DOTSON 1" = 20' F1592-LRP104 **HBB** CONTRACT RTA/CN 0612-18 Plan. Build. Manage. ILENAME: PUYALLUP STATION PARKING AND ACCESS FACILITY ID: S317-F1592-LRP104 P. MAGINNITY kpff **SOUNDTRANSIT IMPROVEMENTS** F1592 CHECKED BY LANDSCAPE ARCHITECTURE . VONG RTA/CN 0612-18 LANDSCAPE RD JV JV REVISIONS FOR CITY PERMIT E-20-0504 75/81 APPROVED BY REVIEWED BY: SUBMITTAL DATE: IRRIGATION PLAN SARA ROBERTS **GREG SHIMIZU** J. VONG 01/08/2021 01/08/2021 01/08/2021

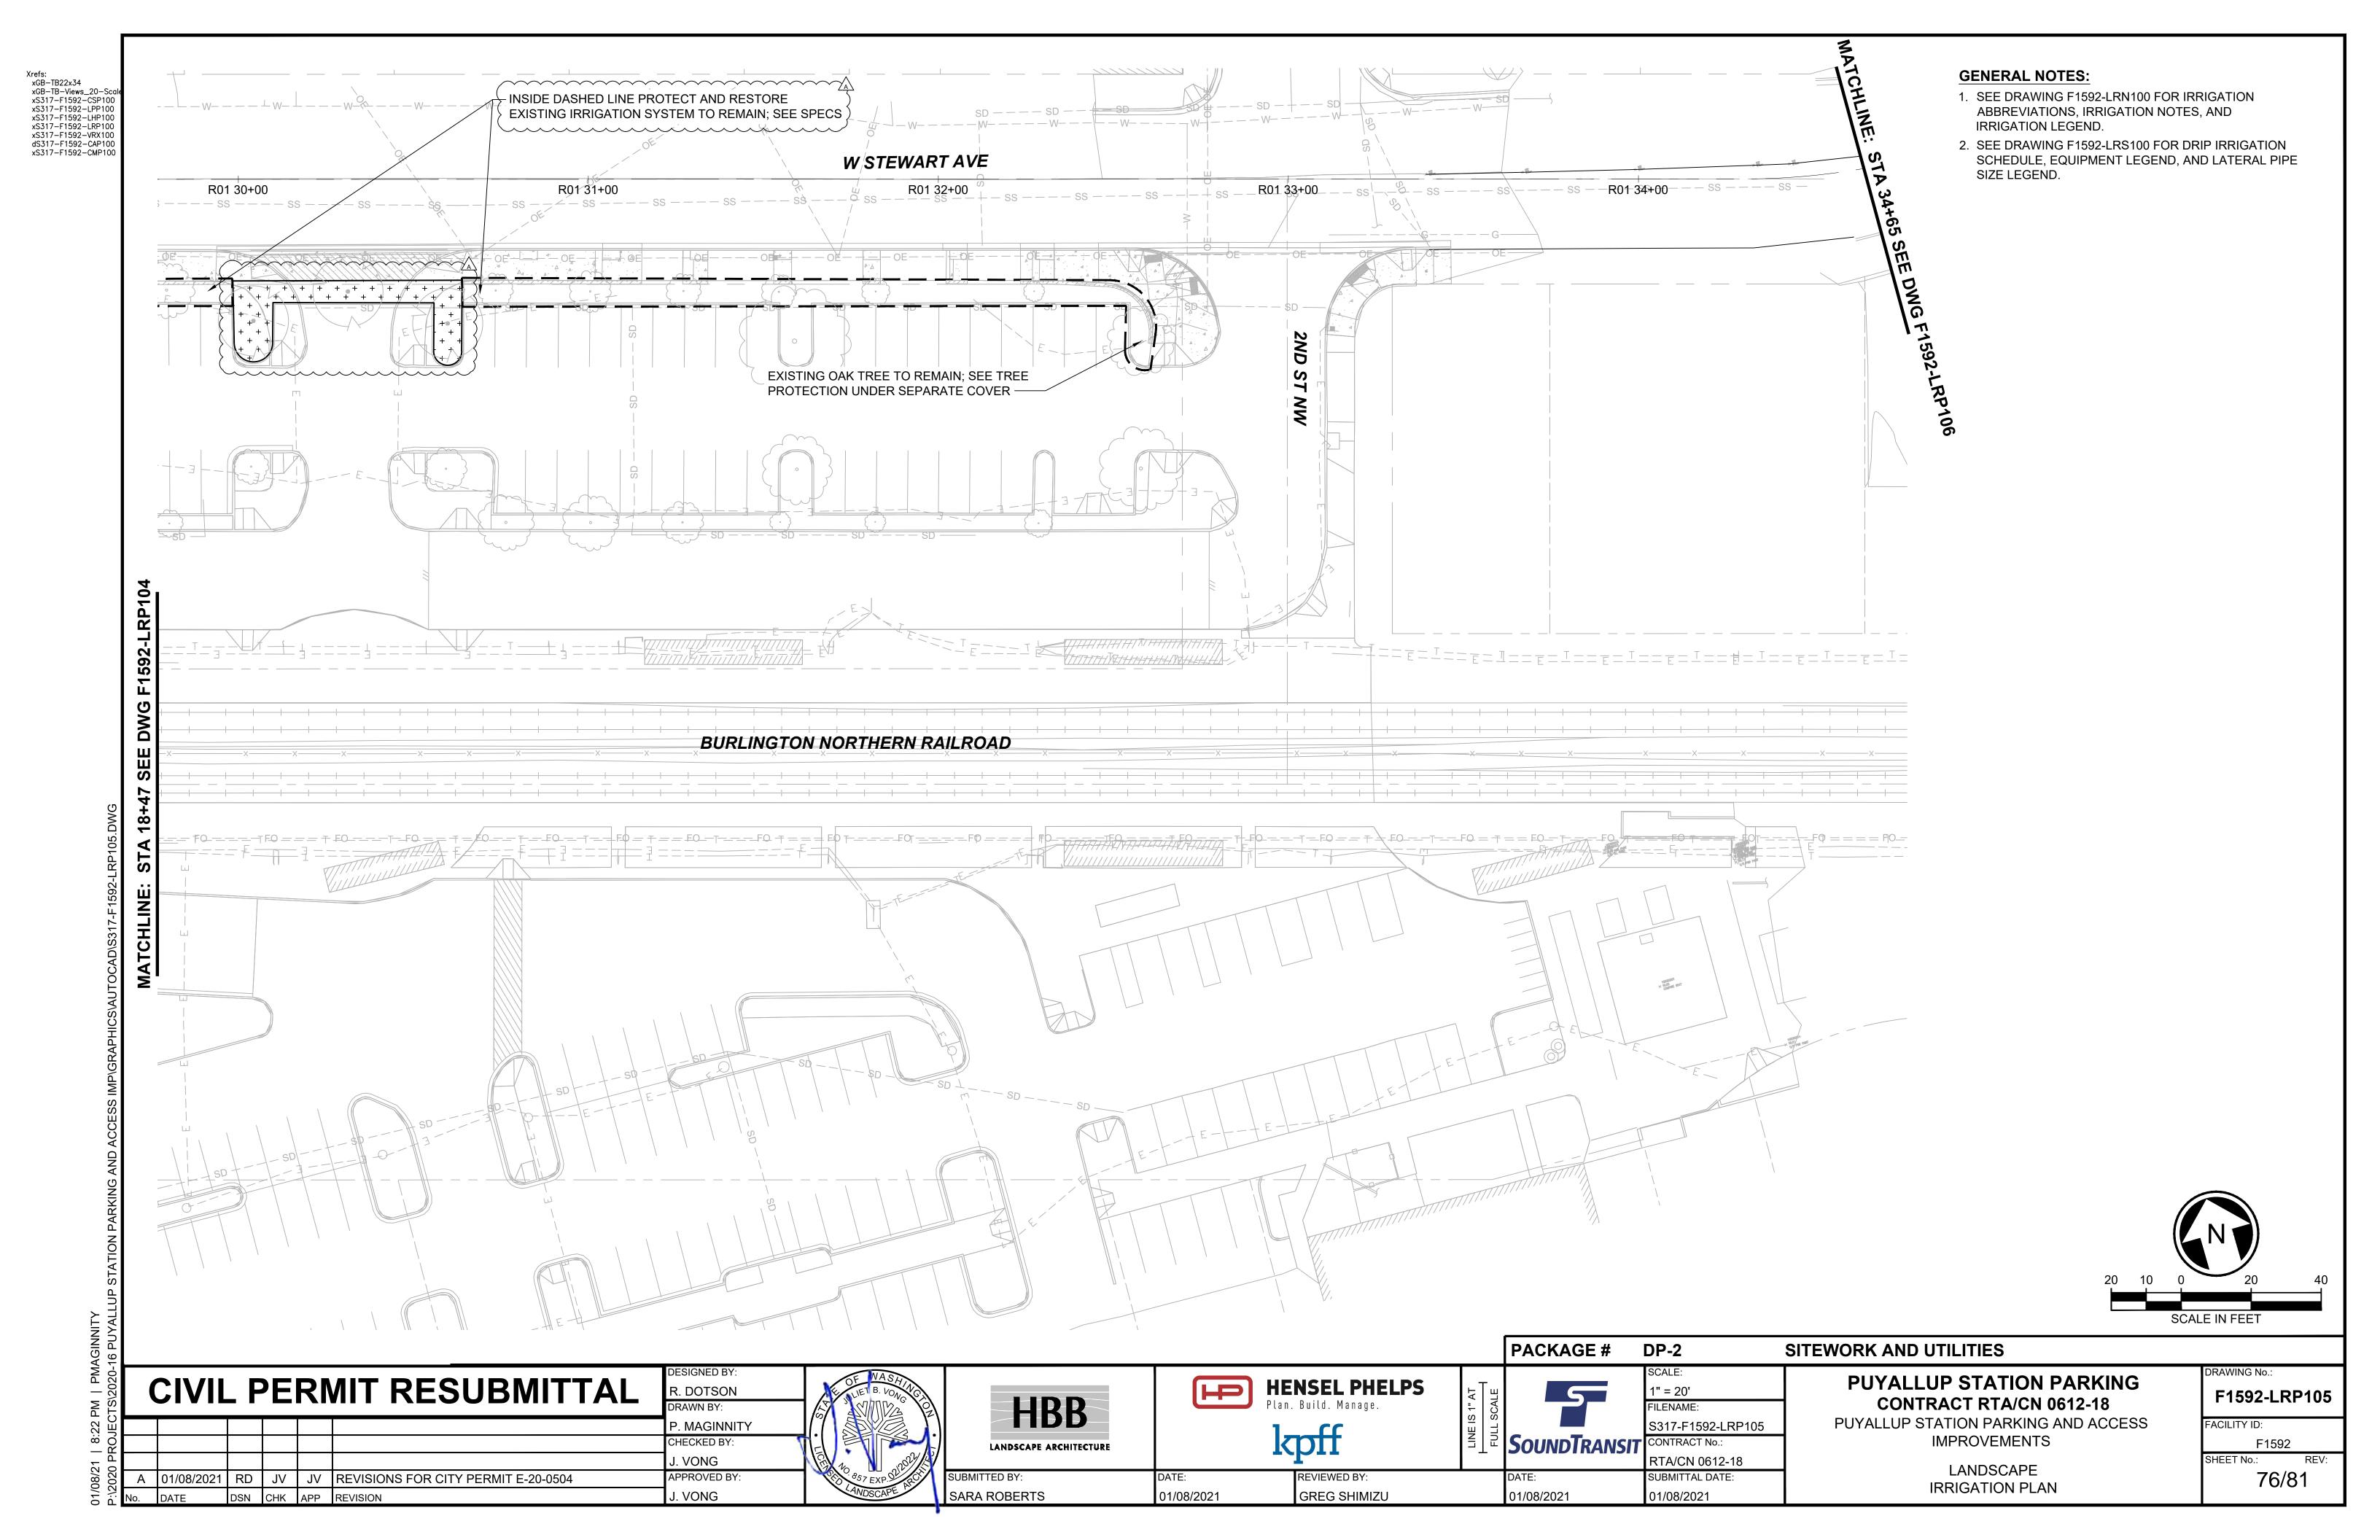


GENERAL NOTES:

- SEE DRAWING F1592-LRN100 FOR IRRIGATION ABBREVIATIONS, IRRIGATION NOTES, AND IRRIGATION LEGEND.
- SEE DRAWING F1592-LRS100 FOR DRIP IRRIGATION SCHEDULE, EQUIPMENT LEGEND, AND LATERAL PIPE SIZE LEGEND.

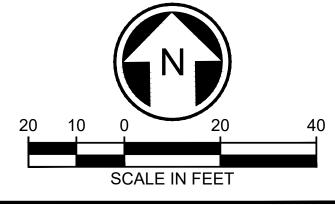


AGINN 16 PU								PACKAGE#	DP-2	SITEWORK AND UTILITIES	
PM PM. :TS\2020-	CIVIL PERMIT RESUBMITTAL	DESIGNED BY: R. DOTSON DRAWN BY:	F NASHING S	HBB		NSEL PHELPS . Build. Manage.	S 1" AT SCALE	5	SCALE: 1" = 20' FILENAME:	PUYALLUP STATION PARKING CONTRACT RTA/CN 0612-18	F1592-LRP106
8:22 OJEC		P. MAGINNITY CHECKED BY:		LANDSCAPE ARCHITECTURE	1,	aff	LINE IS	SoundTransit	S317-F1592-LRP106 CONTRACT No.:	PUYALLUP STATION PARKING AND ACCESS IMPROVEMENTS	FACILITY ID: F1592
21 3 PR		J. VONG	15/2009/10	LANDSCAPE ARCHITECTORE	1	PII		JUUNDIKANSII	RTA/CN 0612-18	LANDSCAPE	SHEET No.: REV:
08/2 202(A 01/08/2021 RD JV JV REVISIONS FOR CITY PERMIT E-20-0504	APPROVED BY:	857 EXP. ST. RECT	SUBMITTED BY:	DATE:	REVIEWED BY:	I	DATE:	SUBMITTAL DATE:	IRRIGATION PLAN	77/81
01/ P:\7	lo. DATE DSN CHK APP REVISION	J. VONG	ANDSCAPE	SARA ROBERTS	01/08/2021	GREG SHIMIZU		01/08/2021	01/08/2021	IIXIGATION PLAN	

20-16 PUYALLUP STATION PARKING AND ACCESS IMP\GRAPHICS\AUTOCAD\S

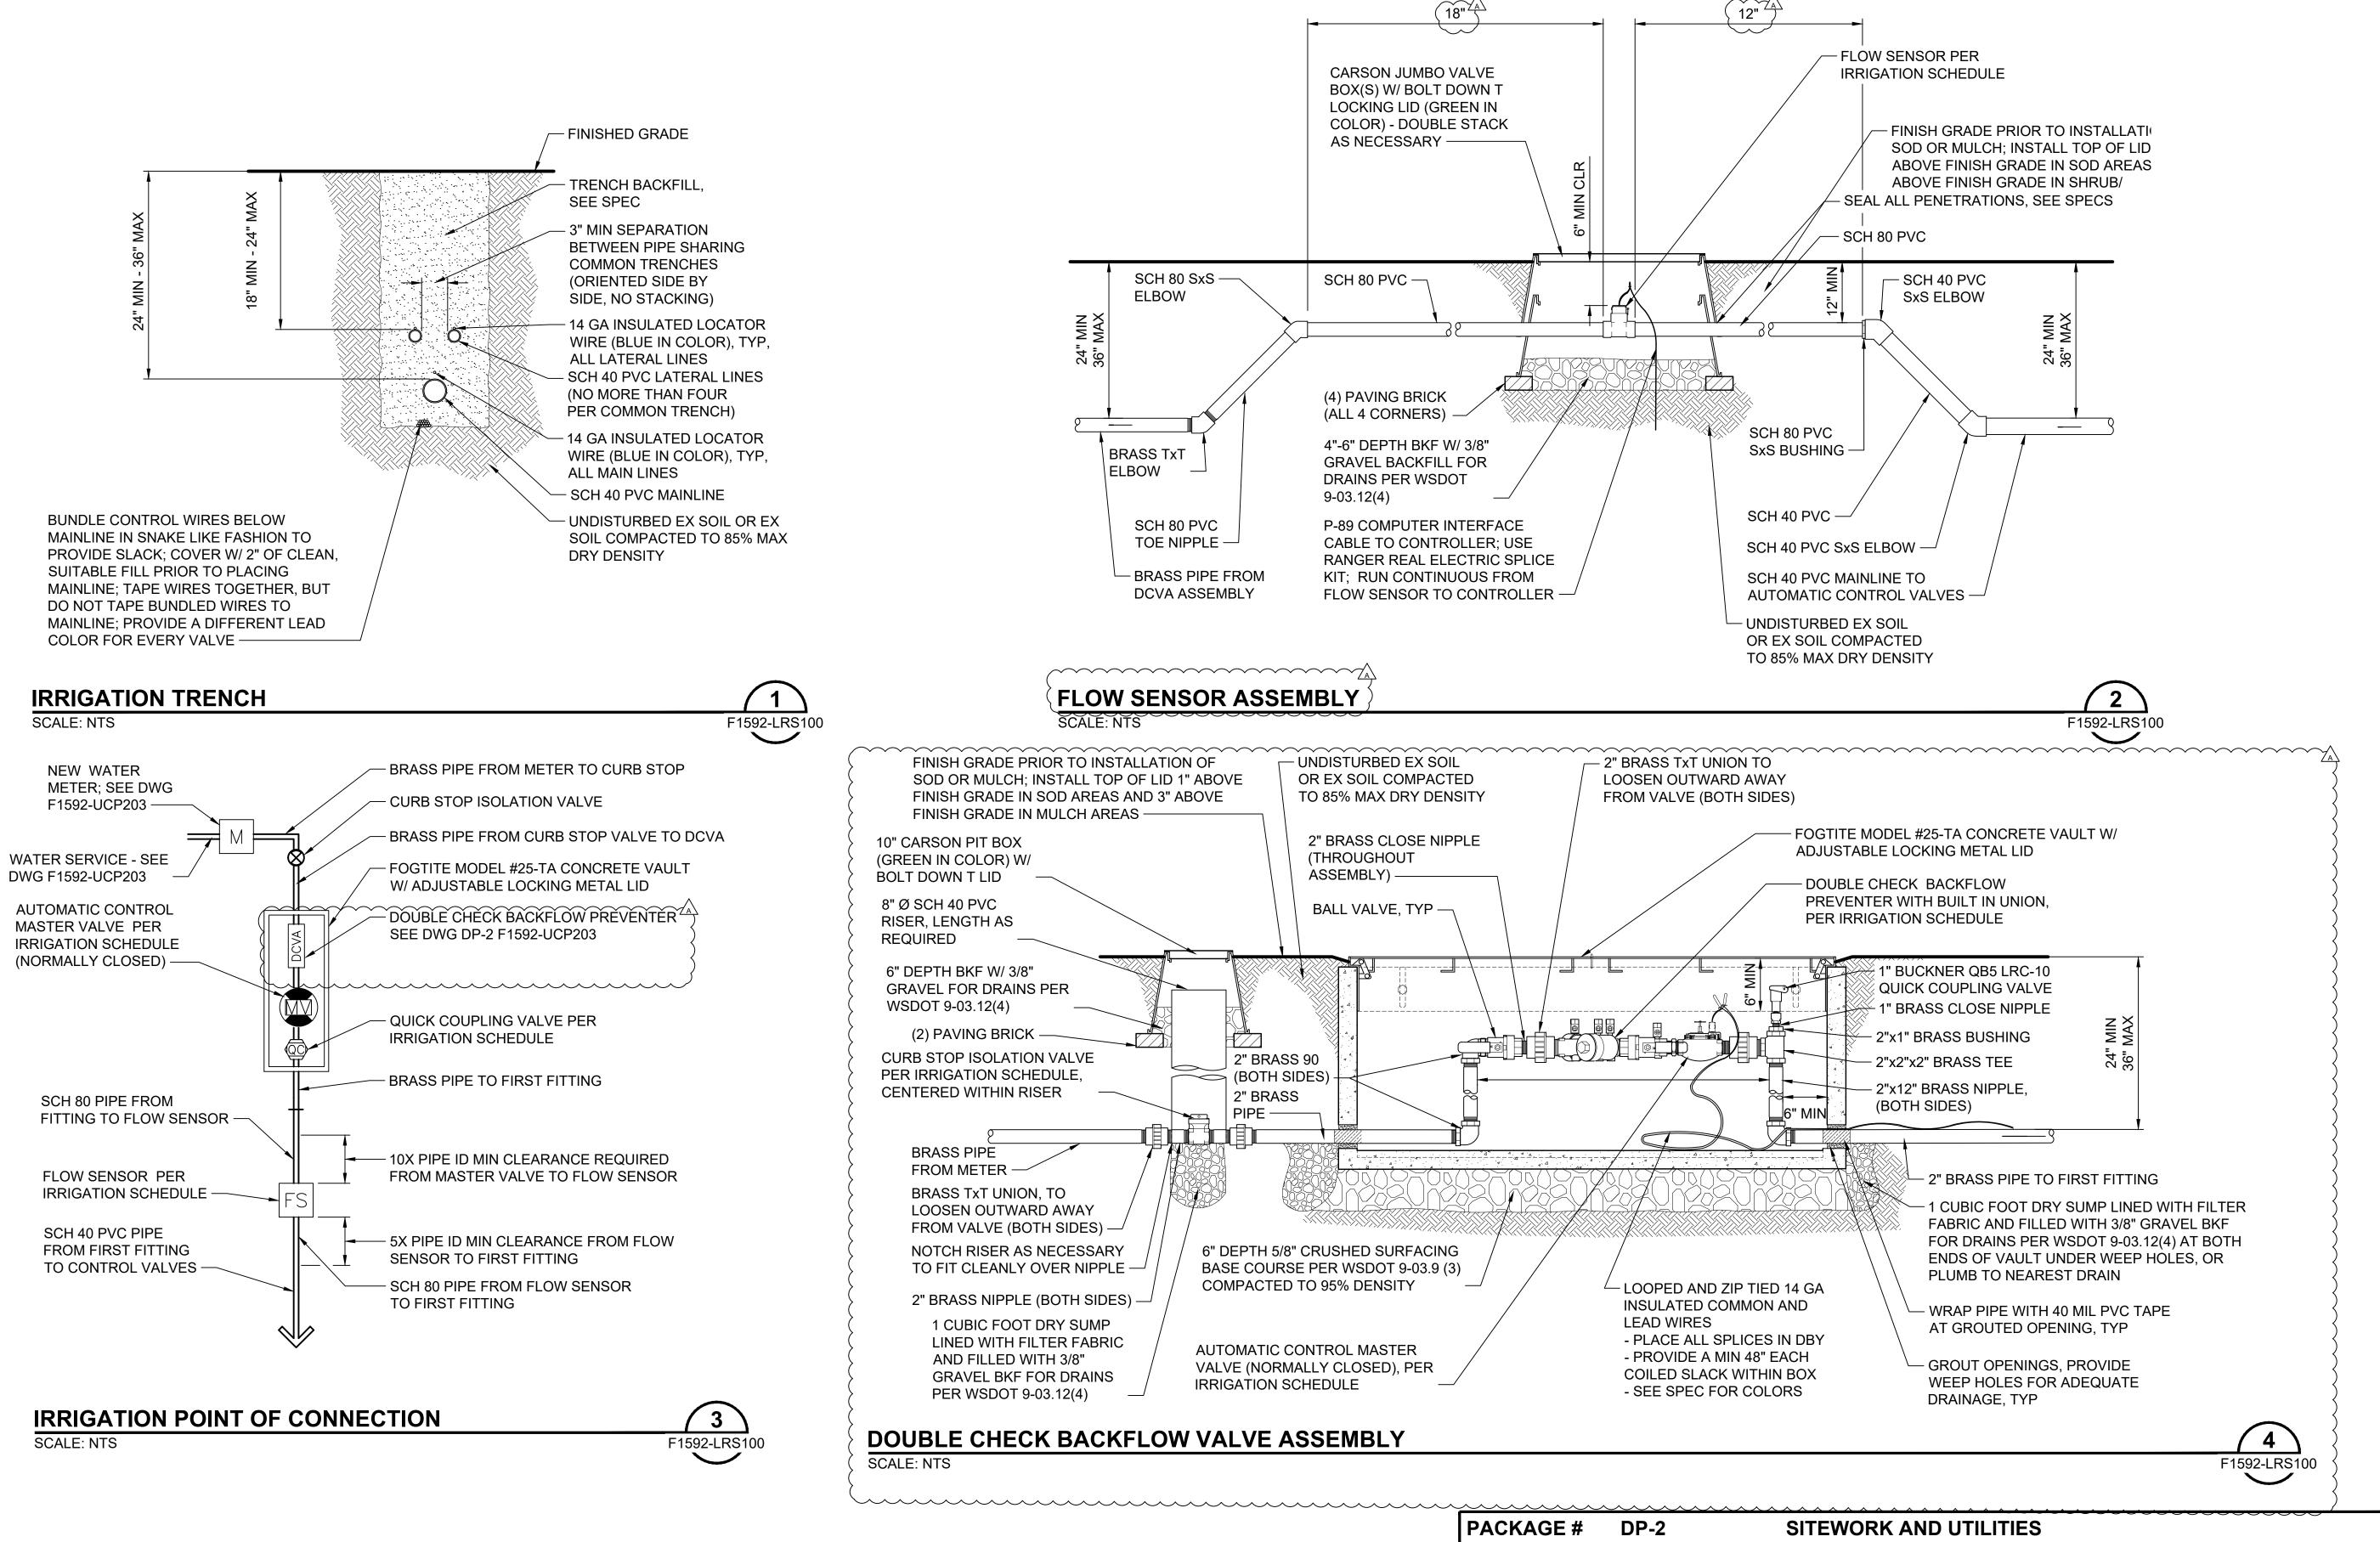


CIVIL PERMIT RESUBMITTAL R. DOTSON DRAWN BY: P. MAGINNITY CHECKED BY . VONG RD JV JV REVISIONS FOR CITY PERMIT E-20-0504 APPROVED BY A 01/08/2021 J. VONG CHK APP REVISION

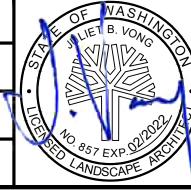



SARA ROBERTS

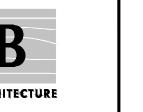

01/08/2021



REVIEWED BY:

GREG SHIMIZU



01/08/2021

NTS ILENAME: S317-F1592-LRD101 CONTRACT No. RTA/CN 0612-18

SUBMITTAL DATE:

01/08/2021

PUYALLUP STATION PARKING CONTRACT RTA/CN 0612-18 PUYALLUP STATION PARKING AND ACCESS **IMPROVEMENTS**

FACILITY ID: F1592 78/81

RAWING No.:

F1592-LRD101

LANDSCAPE **IRRIGATION DETAILS** DRIP AUTOMATIC CONTROL VALVE WITH PRESSURE REGULATING BASKET FILTER & GATE VALVE

SCALE: NTS



FINISH GRADE

PAVEMENT

COMPACTED CSTC OR CONTROLLED

DENSITY FILL PER WSDOT 2-09.3(1)E,

OR AS DIRECTED BY CITY INSPECTOR

UNDISTURBED NATIVE MATERIAL

SCH 40 PVC LATERAL LINE WITH

LOCATOR WIRE IN SLEEVE, SEE NOTES

RUN CONTROL WIRES SEPARATELY
IN MIN 2" ELECTRICAL CONDUIT, (NOT

SHOWN ON PLANS), TYP

NOTES:

- 1. SLEEVING MATERIAL SHALL BE SIZE AND TYPE AS SHOWN ON CONTRACT DRAWINGS AND SHALL BE LARGE ENOUGH TO ALLOW IRRIGATION PIPE AND ASSOCIATED COUPLINGS TO EASILY SLIP THROUGH SLEEVING MATERIAL, TYPICALLY 2x DIAMETER OF IRRIGATION PIPE, UNLESS OTHERWISE SHOWN.
- 2. EXTEND SLEEVING MATERIAL 12" BEYOND EDGE OF PAVEMENT.

IRRIGATION TRENCH UNDER PAVEMENT SCALE: NTS





01/08/2021

~~~~~~~^^\ OFFSET DRIPPER TUBING MIN 3" AND MAX 12" FROM ADJACENT PLANT ROW. FINISH GRADE PRIOR TO PLACING MULCH -DRIPPER TUBING -MAX 20" OC 3" DEPTH COMPACTED MULCH **PLANTING SOIL** SEE SPECS - 6" WIRE STAPLES INSTALLED **EVERY 2'-0" OC ALONG DRIPPER** TUBING AND TWO STAPLES AT EACH CHANGE OF DIRECTION (TEE, ELBOW, OR CROSS), TYP

DRIPPER TUBING

SCALE: NTS

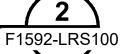

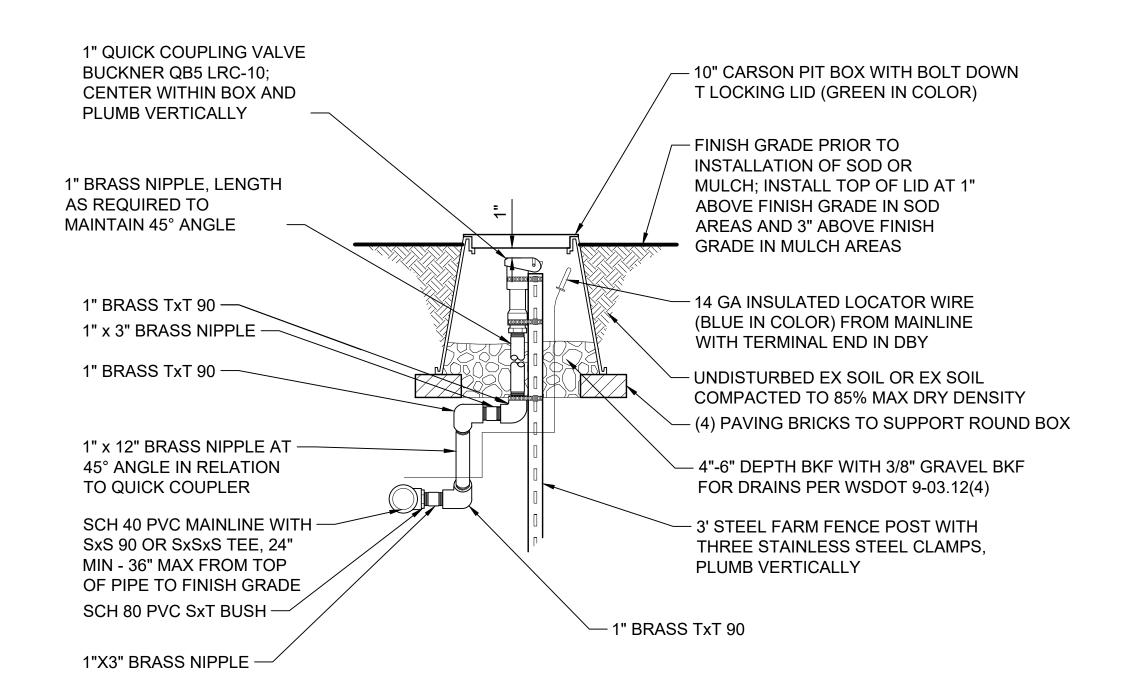

SITEWORK AND UTILITIES

QUICK COUPLING VALVE

SCALE: NTS

01/08/2021



P:\2020 PROJECTS\2020-16 PUYALLUP STATION P.

| CIVIL PERMIT RESUBMITTAL | R. DOTSON | DRAWN BY: | R. MAGINNITY | P. MAGINNITY | CHECKED BY: | J. VONG | A | 01/08/2021 | RD | JV | JV | REVISIONS FOR CITY PERMIT E-20-0504 | APPROVED BY: | J. VONG | J. V






SARA ROBERTS



REVIEWED BY:

**GREG SHIMIZU** 

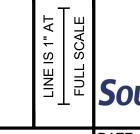

SOUNDTRANSIT

SCALE:

NTS

FILENAME:

S317-F1592-LRD102

CONTRACT No.:

RTA/CN 0612-18

SUBMITTAL DATE:

01/08/2021

PUYALLUP STATION PARKING
CONTRACT RTA/CN 0612-18
PUYALLUP STATION PARKING AND ACCESS
IMPROVEMENTS

F1592-LRD102
FACILITY ID:

LANDSCAPE IRRIGATION DETAILS F1592 SHEET No.: RE **79/81**  MANUAL FLUSH SHUT-OFF VALVE SCALE: NTS





MAX DRY DENSITY

- PVC TEE TO 3/4" MPT BARBED ADAPTER, TYP - PVC SUPPLY HEADER, TYP - FINISH GRADE PRIOR TO PLACING MULCH, TYP - MULCH, SEE PLANTING DETAILS, TYP - DRIPPER TUBING ON TOP OF FINISH GRADE, TYP PVC TEE, TYP -PVC, TYP -DRIPPER TUBING, TYP PVC ELL, TYP -PVC CROSS W/ 3/4" MPT LATERAL LINE FLOW BARBED ADAPTERS TO FROM VALVE, TYP -DRIPPER TUBING, TYP

- 2. DRIPPER TUBING SHALL BE INSTALLED FLAT ON FINISH GRADE & APPROVED BY RESIDENT ENGINEER PRIOR TO INSTALLATION OF MULCH.

## TYPICAL HEADER CONNECTIONS

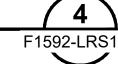

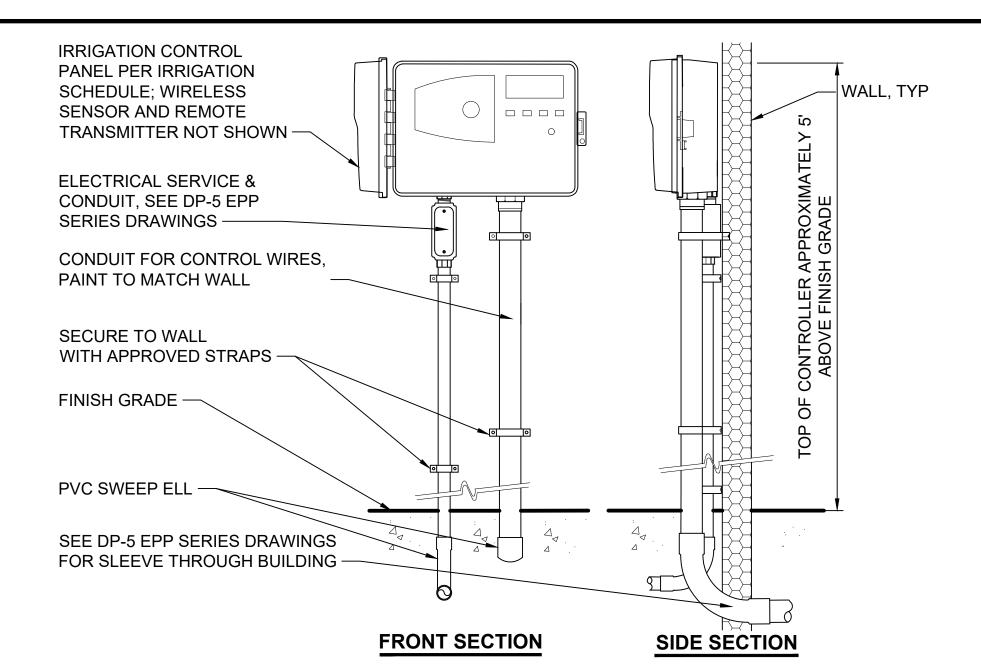


#### NOTES:

- INSTALLATION TO BE COMPLETED PER MFRS RECOMMENDATIONS.
- 2. SEE IRRIGATION SCHEDULE FOR SPECIFIC NUMBER OF VALVES AND TYPE/SIZE OF CONTROLLER.
- 3. PROVIDE ETHERNET CONNECTION TO; SEE DP-5 EPP SERIES DRAWINGS.
- 4. CONTRACTOR SHALL PROVIDE ALL CONDUIT, WIRES, MOUNTING BRACKETS, WEATHERHEADS, AND ALL OTHER MISC EQUIPMENT REQUIRED FOR INSTALLATION.
- 5. SEE SPECIFICATIONS FOR ADDITIONAL REQUIREMENTS.

## WALL MOUNTED IRRIGATION CONTROLLER

SCALE: NTS



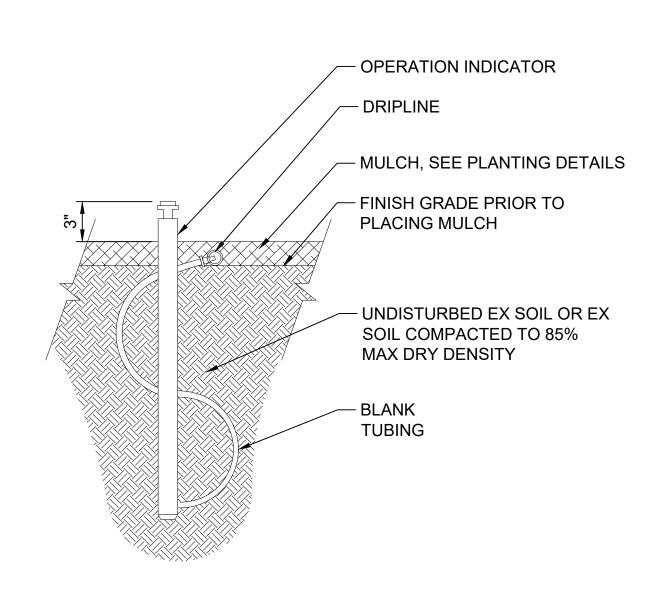


DRIPLINE OPERATION INDICATOR (3) SCALE: NTS

## **NOTES:**

- SEE PLANS, LEGENDS, AND SPECS FOR ALL DIMENSIONS AND LATERAL SPACING.

SCALE: NTS

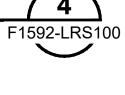



- PVC EXHAUST HEADER

- PVC SUPPLY HEADER

#### NOTES:


- 1. INSTALL ONE DRIPLINE OPERATION INDICATOR PER VALVE. LOCATE ON DRIPPER TUBING CLOSEST TO CONTROL VALVE.
- 2. SEE DETAIL 4 IN DWG F1592-LRD103 FOR TYPICAL SUPPLY/ EXHAUST HEADER CONNECTIONS.

## DRIP CENTER FEED LAYOUT

SCALE: NTS



2. SEE DETAIL 4 IN DWG F1592-LRD103 FOR TYPICAL SUPPLY/ EXHAUST

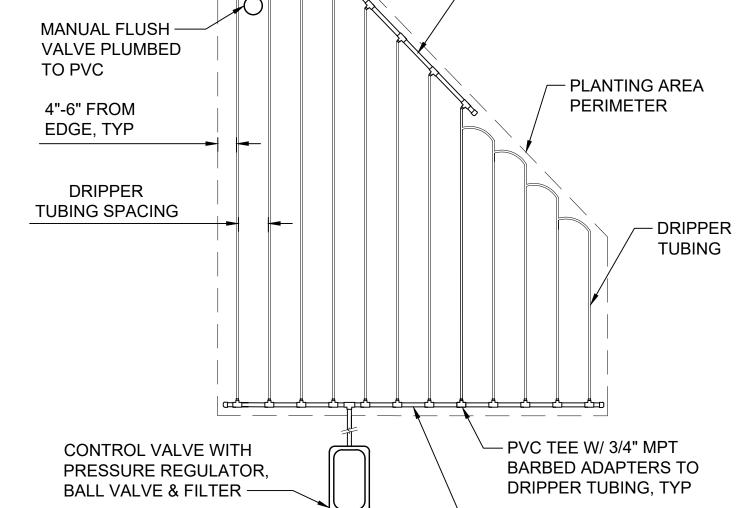




## NOTES:

- 1. INSTALL ONE DRIPLINE OPERATION INDICATOR PER VALVE. INSTALL ON DRIPPER TUBING CLOSEST TO VALVE.
- HEADER CONNECTIONS.

DRIP IRREGULAR FEED LAYOUT

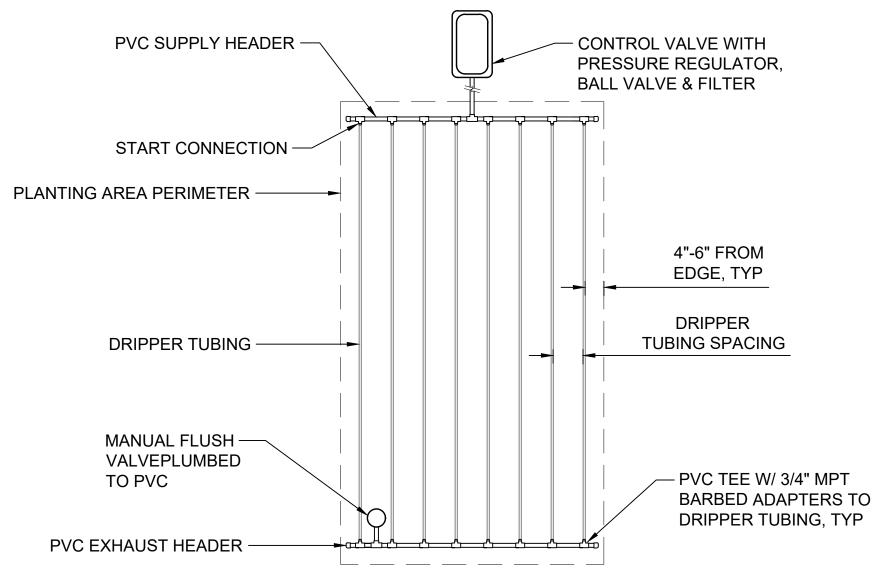

#### **NOTES:**

SCALE: NTS

- 1. INSTALL ONE DRIPLINE OPERATION INDICATOR PER VALVE. LOCATE ON DRIPPER TUBING CLOSEST TO CONTROL VALVE.
- 2. SEE DETAIL 4 IN DWG F1592-LRD103 FOR TYPICAL SUPPLY/ EXHAUST HEADER CONNECTIONS.


DRIP END FEED LAYOUT

F1592-LRS100

F1592-LRS100

SCALE: NTS

**CIVIL PERMIT RESUBMITTAL** R. DOTSON P. MAGINNITY CHECKED BY . VONG A 01/08/2021 RD JV JV REVISIONS FOR CITY PERMIT E-20-0504 APPROVED BY J. VONG

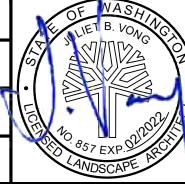



SARA ROBERTS



01/08/2021



REVIEWED BY:

**GREG SHIMIZU** 



SOUNDTRANSIT CONTRACT No.: RTA/CN 0612-18

DP-2

SUBMITTAL DATE:

01/08/2021

PACKAGE #

01/08/2021

**PUYALLUP STATION PARKING** FILENAME: S317-F1592-LRD104

CONTRACT RTA/CN 0612-18 PUYALLUP STATION PARKING AND ACCESS **IMPROVEMENTS** 

SITEWORK AND UTILITIES

LANDSCAPE IRRIGATION DETAILS RAWING No.: F1592-LRD104

F1592 81/81

FACILITY ID: