



## RETAIL FIRE SPRINKLER PLAN

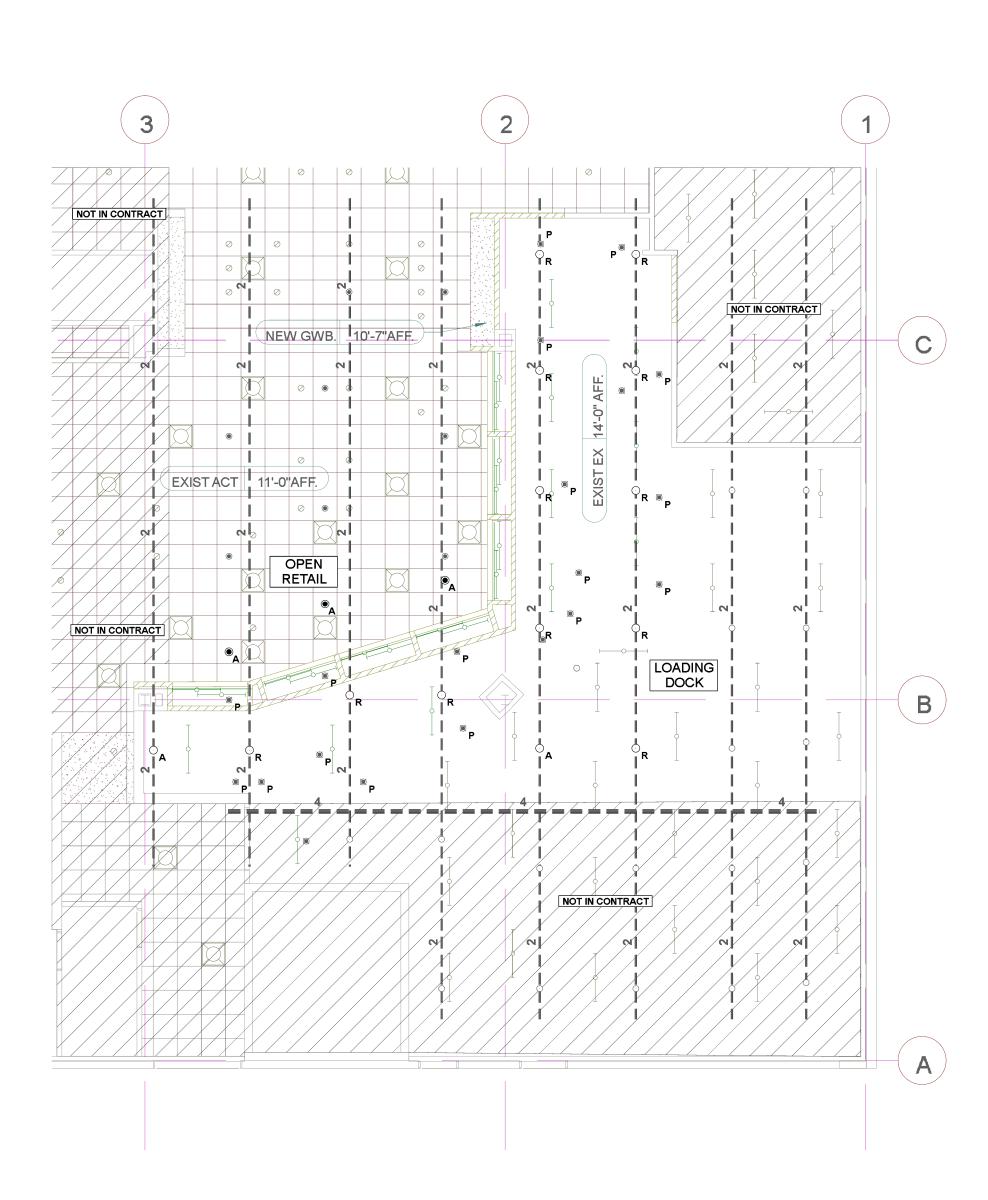

1/8" = 1'-0"





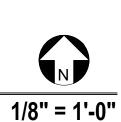

**UPRIGHT W/ SPRIG DETAIL** — UPRIGHT SPRINKLER <sup>1</sup> X 1/2" R.C. 1" SCH.40 SPRIG → 1" WELDED OUTLET **→** BRANCHLINE PIPING **INSTALL SPRINKLER 1"-12" BELOW DECK** 


FLEXIBLE DROP TO SPRINKLER


VICFLEX™ STAINLESS STEEL BRAIDED HOSE


NEW 1" 90° ELBOW

HOSE BRACKET
ATTACHMENT

DROP CEILING TILE OR SUSPENDED GYP SYSTEM

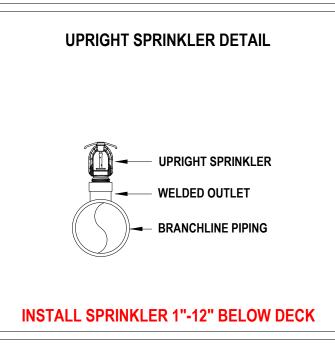

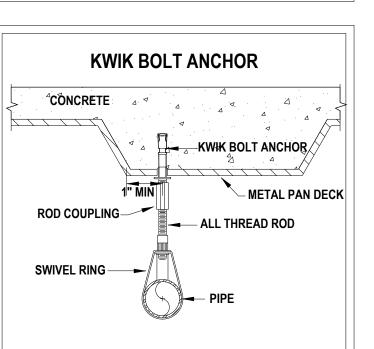

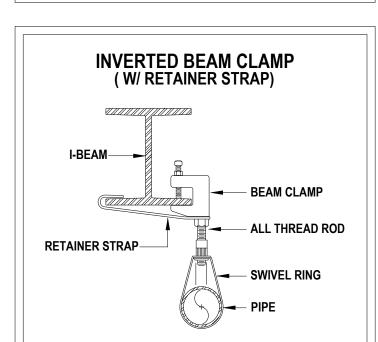

PENDENT SPRINKLER

- DROP CEILING TILE

FLEXIBLE DROP TO SPRINKLER

### PROJECT INFORMATION

MACY'S, INC. 151 WEST 34TH STREET SUITE 1300 NEW YORK, NY 10001

GENERAL CONTRACTOR JBC GENERAL CONSTRUCTION 2319 S 126TH STREET SEATTLE, WA 98168

#### **BUILDING INFORMATION**

NON-COMBUSTIBLE CONSTRUCTION STRUCTURAL MEMBERS - STEEL I-BEAM FLOORS - 3" 4,000 PSI CONCRETE ON 3" CORRUGATED METAL DECI WALLS - STEEL STUD FRAME AND CMU

#### CODE REFERENCES

NFPA 13 2016 EDITION 2018 INTERNATIONAL FIRE CODE CITY OF PUYALLUP FIRE CODE

#### GENERAL PROJECT DESCRIPTION

1. ADDING AND RELOCATING SPRINKLERS DUE TO MODIFICATION OF EXISTING RETAIL SPACE TO ENLARGE LOADING DOCK AREA. 2. RELOCATING SPRINKLERS AROUND EXISTING RETAIL DISPLAY WALL TO BE REMOVED.

#### DESIGN CRITERIA

1. LOADING DOCK - ORDINARY HAZARD GROUP I 2. RETAIL SPACES - ORDINARY HAZARD GROUP II

#### GENERAL NOTES

1. THREADED PIPE TO BE SCHEDULE 40 REGARDLESS OF SIZE. 2. ROLL GROOVED PIPE TO BE SCHEDULE 10 REGARDLESS OF

3. DRY SYSTEM PIPE TO BE BLACK, C FACTOR = 100 PER NFPA 13 REQUIREMENTS.

4. ALL PIPING SHALL BE TESTED AT 200 PSI OR 50 PSI IN EXCESS OF SYSTEM WORKING PRESSURE, WHICHEVER IS

5. EARTHQUAKE BRACING TO BE PROVIDED IN ACCORDANCE WITH NFPA 13.

6. JOINING OF PIPE AND FITTINGS, THREADED AND WELDED, SHALL BE IN ACCORDANCE WITH NFPA 13.

7. ALL COMPONENTS SHALL BE UL LISTED. 8. ALL ELECTRICAL WIRING SHALL BE PERFORMED BY OTHERS. 9. ALL FLEXHOSES TO BE VICTAULIC AH2 72" IN LENGTH. 10. ALL HANGERS TO BE IN ACCORDANCE WITH NFPA 13. 11. STRUCTURAL ADEQUACY OF THE BUILDING TO SUPPORT THE SPRINKLER PIPING IS THE RESPONSIBILITY OF THE OWNER AND THEIR STRUCTURAL REPRESENTATIVE. 12. OWNER IS RESPONSIBLE FOR PROVIDING ADEQUATE HEAT TO PREVENT WATER IN PIPES FROM FREEZING FOR AREAS

PROTECTED BY WET PIPE SPRINKLER SYSTEMS. 13. OWNER IS RESPONSIBLE FOR ALL MAINTENANCE AND 14. PAINTING OF SPRINKLER PIPE AND PROTECTION OF PIPE FROM PAINT OR CONSTRUCTION ACTIVITIES (SUCH AS FIRE PROOFING) IS BY OTHERS AND EXCLUDED FROM THIS

15. THE FIRE SPRINKLER SYSTEMS SHALL BE MONITORED 24 HOURS A DAY BY A CENTRAL STATION AND IS EXCLUDED FROM THIS CONTRACT.



14690 NE 95TH ST, UNIT 101

REDMOND, WA 98052

TEL. 425.881.0100

WWW.WSFP.COM STATE LICENSE #WESTESF785LH

OWNERSHIP OF DOCUMENTS

ARE INSTRUMENTS OF SERVICE FOR THIS PROJECT ONLY AND SHALL REMAIN THE PROPERTY OF THE ENGINEER WHETHER THE PROJECT IS COMPLETED OR NOT. RESIDE OF ANY OF THE PROJECT WITHOUT WRITTEN PERMISSION OF THE PROJECT WITHOUT WRITTEN PERMISSION OF THE ENGINEER SHALL BE AT THE OWNERS RISK AND THE OWNER AGREES TO DEFEND, INDEMNIFY, AND HOLD HARMLESS THE ENGINEER FROM ALL CLAIMS, DAMAGES AND EXPENSES INCLUDING ATTORNEYS FEES ARISING OUT OF UNAUTHORIZED REUSE OF THE ENGINEER'S RISK THE ENGINEER'S INSTRUMENTS OF SERVICE BY THE OWNER OR BY OTHERS ACTING THROUGH THE OWNER

# REVISIONS

NO.	DATE	DESCRIPTION
	01/12/23	FOR APPROVAL
1		
2		
3		
4		
<u>/</u> 5		
6		

DRAWN BY

WSFP PROJECT NUMBER

KG3378 PRINT DATE

01/12/23

SYMBOL LEGEND

FHW -INDICATES FULL HEIGHT WALL

**PERMIT DOCUMENTS** 


## MACY'S @ SOUTH HILL MALL


3500 S MERIDIAN ST, SUITE 985 PUYALLUP, WA 98373

SHEET DESCRIPTION

**LEVEL 01 FIRE SPRINKLER PLAN** 

Sprinkler Legend - Total For Project Quantity K-Factor Type Size Response Finish Temperature Note 5.6 Upright 1/2 Quick

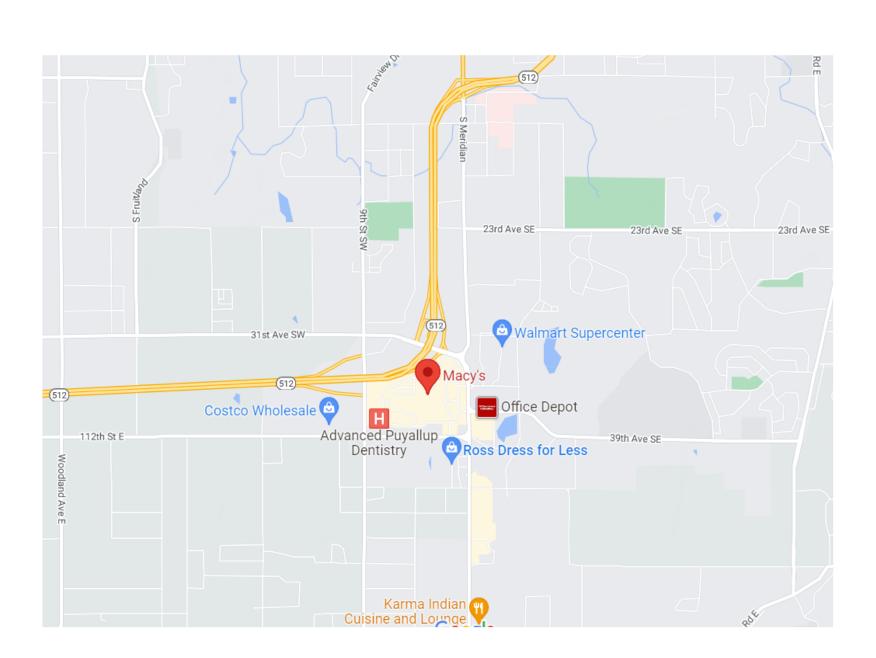

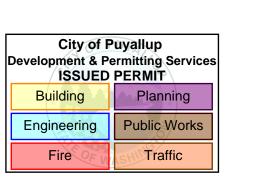

MUST BE POSTED ON THE JOB AT ALL INSPECTIONS IN A VISIBLE AND **COMPLIANCE** READILY ACCESSIBLE LOCATION. DDrake 02/15/2023 7:13:23 AM

City of Puyallup Fire

**REVIEWED** 

Approval of submitted plans is not an approval of omissions or oversight by this office or noncompliance with any applicable regulations of local government. The contractor is responsible for making

THE APPROVED CONSTRUCTION

PLANS AND ALL ENGINEERING

sure that the building complies with all applicable building codes and regulations of the local government.

**VICINITY MAP** 

