See Site Plan Sheet 2 of 42

for engineering comments

City of Puyallup

Building

REVIEWED

FOR COMPLIANCE

DLeahy

02/15/2023 10:01:54 AM

FERRUCCI JUNIOR HIGH ADDITION


EXTERIOR & INTERIOR SIGNAGE

ISSUE DATE: DECEMBER 30, 2022


6th Issue Date: November 14, 2022 5th Issue Date: November 2, 2022 4th Issue Date: September 28, 2022

3rd Issue Date: July 19, 2022 2nd Issue Date: May 27, 2022 1st Issue Date: May 12, 2022


SITE ADDRESS | 3213 WILDWOOD PARK DR. PUYALLUP, WA 98374

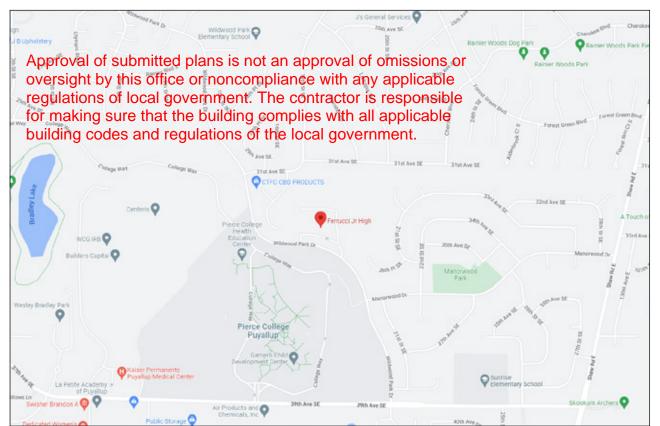



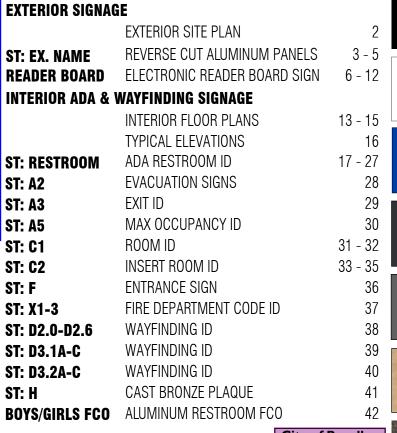



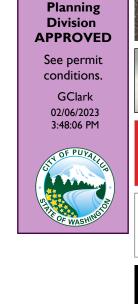









SATIN BLACK

BRIGHT WHITE

ADA ACCESSIBILITY BLUE Pantone 293C

10 PART SATIN BLACK / 3 PART WHITE

Matthews Paint

MP10206 LEAD PIPE Matthews Paint

SATIN BRONZE

DURANODIC BRONZE PEBBLE

BRUSHED ALUMINUM Vertical Brush

3M 220-12 BLACK High Performance Cast Vinyl

PANTONE 201C Matched w/ Matthews Paint

1513 Central Ave South Kent, Washington 98032

253-852-1354

www.evergreensign.com

DATE: 05-12-2022

Project Manager: CHZ

Drawn By: NST

Checked By:

Administrator

Revision Dates

① 05-27-2022 ② 06-13-2022

③ 09-28-2022

4 11-02-2022

⑤ 11-14-2022 **⑥ 12-30-2022**

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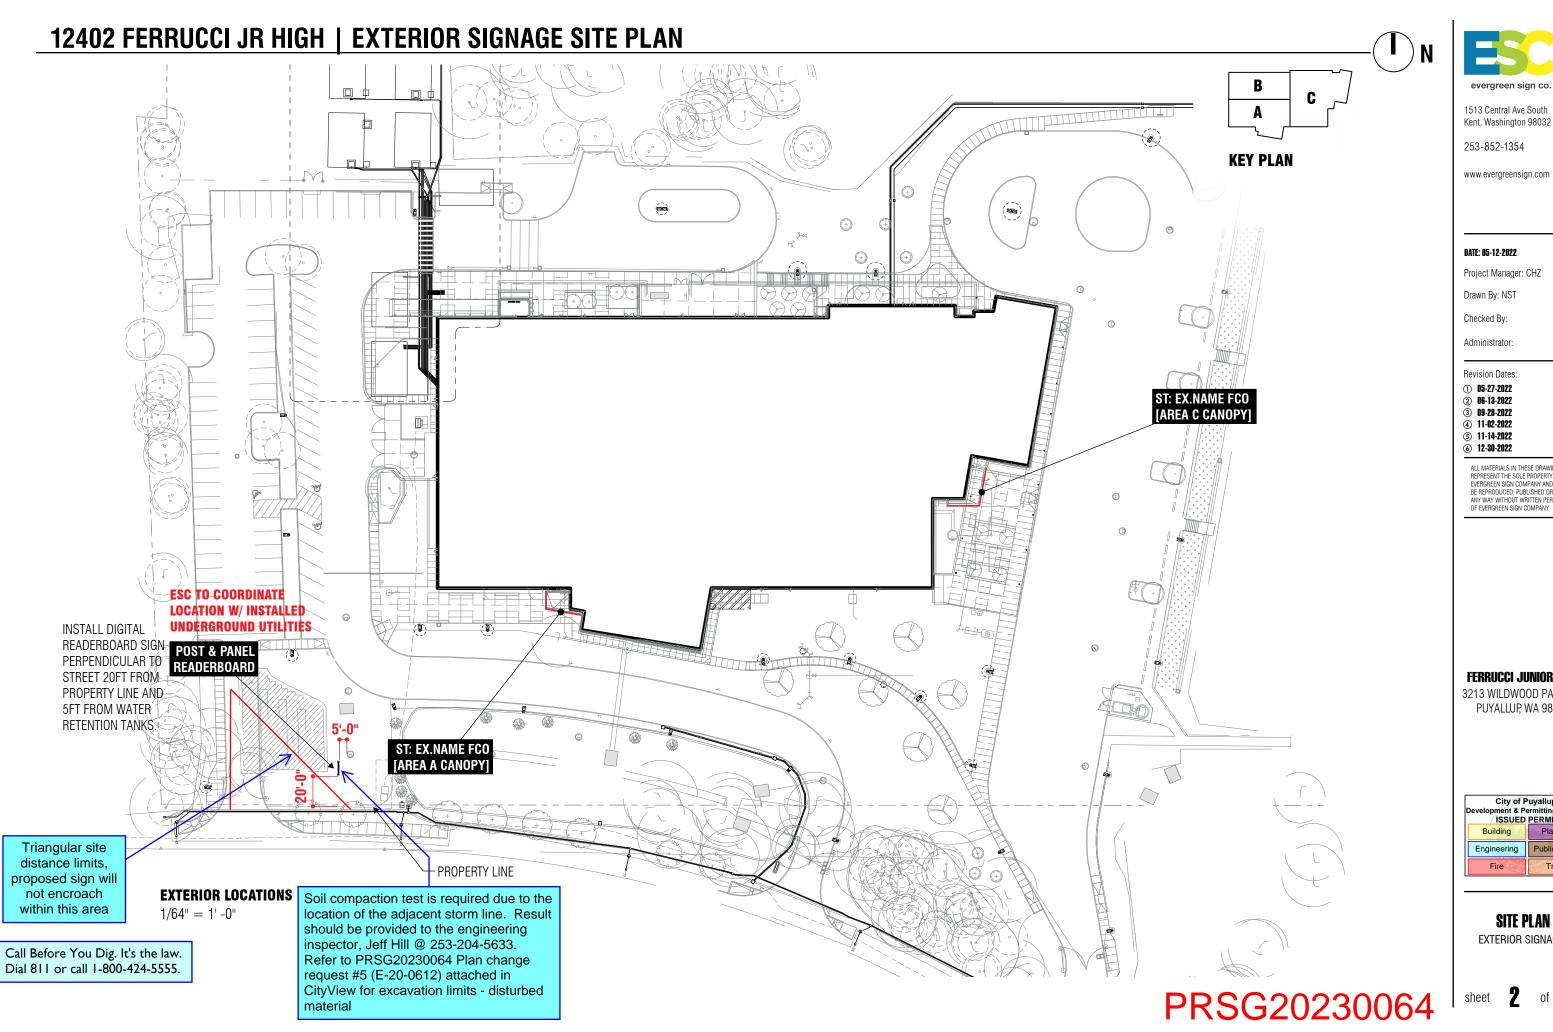
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City of Puyallup Public Works

COVER







1513 Central Ave South

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Development & Pe	City of Puyallup relopment & Permitting Services ISSUED PERMIT				
Building	Planning				
Engineering	Public Works				
Fire OF V	Traffic				

SITE PLAN

EXTERIOR SIGNAGE

1'-7"

6"

0

GRADE LEVEL

SIDE VIEW

1/2" = 1'-0"

FERRUCCI JUNIOR HIGH SCHOOL

READER BOARD PERSPECTIVE

Not to Scale

QUANTITY: [1] ONE

SPECIFICATIONS

7'-9"

6'-9"

FERRUCCI JUNIOR HIGH SCHOOL

87" CENTER TO CENTER

(5) #5 VERTICAL

CONCRETE PIER

17" DIAMETER X 4'-0"

#3 TIES @ 12" O.C.

-(3) AT TOP @ 3" O.C.

LED READER BOARD FRONT ELEVATION - BOTH FACES IDENTICAL

EQUALLY SPACED

FLEX CONDUIT INSIDE HSS

6"x6" STEEL

HSS COLUMNS

Ç

-O

12:-6"

6"

Ç

<u>1</u>

(A)

POWER BY OTHERS

1/2" = 1'-0"

ALUMINUM BACKLIT LED CABINET

9" DEEP DOUBLE-FACED ALUMINUM CABINET W/ 3/16" THICK SIGN WHITE ACRYLIC PANELS BACKLIT BY INTERNALLY MOUNTED LED STRIP LIGHTING. RETAINER AND RETURNS PAINTED TO MATCH STEEL SUPPORT FRAME - PAINT COLOR



PANTONE 201C

Matched w/ Matthews Paint

STEEL COLUMNS & CROSSBARS

(2) 6" x 6" x 3/16" STEEL HSS COLUMNS AND (2) 3" x 5" STEEL HSS HORIZONTAL SUPPORT BEAMS, FLEXIBLE CONDUIT INSIDE HSS COLUMN FOR ROUTING WIRING TO LED BACKLIT PANEL AND DAKTRONIX DISPLAY. ALL GALVANIZED STEEL TO BE PAINTED:



PANTONE 201C

Matched w/ Matthews Paint

MESSAGE TEXT

4" TALL 1ST SURFACE APPLIED VINYL CUT LETTERING, COLOR:



3M BLACK 220-12

HIGH PERFORMANCE EXTERIOR CAST VINYL

FONT: ARIAL BOLD

• GALAXY GS6 DOUBLE FACE LED DISPLAY 32x100 pixels at 19.81mm pitch

SEE SHEETS 7 - 8 FOR PRODUCT DETAILS

MOUNTING PLATES

(2) 12"x 12"x 1/2" THICK STEEL MOUNTING PLATES WELDED TO 6"SQUARE STEEL POSTS W/ 3/4" DIA. HOLES FOR (4) 5/8" BOLTS - TOTAL OF (8)

◯ CONCRETE PIERS W/ REBAR CAGE

(2) 17" DIA. X 4' -0" TALL POURED IN PLACE CONCRETE PIERS WITH INTERNAL REBAR SUPPORT CAGE

INSTALLATION

CABINET MOUNTED TO CONCRETE PIERS USING (8) 5/8"-11 X 21" LONG L-ANCHOR 316 SS - 4" HOOK AND 6" THREAD.

(2) 120V CIRCUITS FOR LED DISPLAY AND **CABINET - PULLED BY OTHERS**

PRSG20230064



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253-852-1354

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LED READERBOARD

POST & PANEL SIGN

5

1/2" = 1' - 0"

0

-GRADE LEVEL

SEE SEPARATE ENGINEERING DOCUMENTS DATED

2/13/2023 FOR MORE DETAILED AND DIFFERENT FOOTING

DETAILS. MUST BE ON SITE FOR INSPECTORS AT TIME OF

POWER BY OTHERS

SITE POWER AND DATA

CONNECTION PULLED BY OTHERS

ALL INSPECTIONS. DL.

ភ្ន

LED LAYOUT

6" x 6" x .1875" wall CAPPED

MOUNTING PLATE DETAIL

PAINTED STEEL SQUARE TUBE FRAME

I 3"x 5" x .250"

1'-0"

1" = 1' - 0"

Z Z

...9

44

1'-5"

6'-9"

FERRUCCI JUNIOR HIGH SCHOOL

CABINET DETAIL - IDENTICAL ON BOTH FACES

6'-9" OPENING

87" CENTER TO CENTER

POWER

40 1/2"

FRAME DETAIL

1/2" = 1' - 0"

Δ

POWER

BINET

FOOTING PLAN VIEW

1/2" = 1' - 0"

2'-0 1/4"

3/16"

1'-7"

9"

5


31"

SIDE ELEVATION

1/2" = 1'-0"

3"x5"

WALL

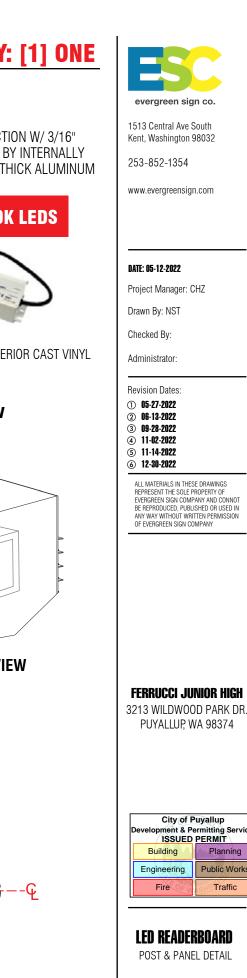



<u>"</u>

SIDE SECTION VIEW

1-1/2" = 1' - 0"

Ç

⚠ INTERNALLY ILLUMINATED CABINET

D/F CABINET OF ALL-ALUMINUM CONSTRUCTION W/ 3/16" THICK SIGN WHITE ACRYLIC FACES BACKLIT BY INTERNALLY MOUNTED WHITE LED STRIP LIGHTING. 1/8" THICK ALUMINUM RETAINERS AND RETURNS.

ILLUMINATED w/ WHITE 6500K LEDS






3M BLACK 220-12

HIGH PERFORMANCE EXTERIOR CAST VINYL

FONT: ARIAL BOLD

DAKTRONICS | GS6-32X100-19.8-A-2V

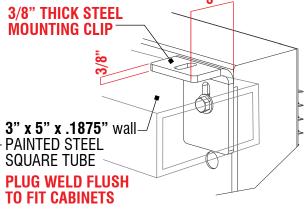

ISOMETRIC VIEW Not to Scale

PRSG20230064

6" x 6" x .1875" wall PAINTED **STEEL SQUARE TUBE SUPPORTS**

PLUG WELD FLUSH TO FIT CABINETS

17" DIAMETER

CONCRETE PIERS

87" ON CENTER

SUBSURFACE

oment & Permitting Se ISSUED PERMIT Building Engineering

LED READERBOARD

POST & PANEL DETAIL

Public Works

12402 FERRUCCI JR HIGH | ST: EX. POST & PANEL READERBOARD INSTALL LOCATION







DIRT MOUNDS MUST BE MOVED

PRIOR TO SIGN INSTALLATION

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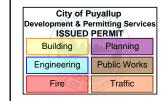
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FERRUCCI JUNIOR HIGH

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LED READERBOARD

POST & PANEL LOCATION

12402 FERRUCCI JR HIGH | LED READERBOARD GALAXY GS6 19.8MM AMBER SPECIFICATIONS

QUANTITY: [1] ONE



5-11/16" [144] 2-7/16" [62]

0" [0]

[185]

LEFT SIDE

OF

REAR VIEW

[0]

ST: LED READER BOARD DISPLAY

Model: GS6-32X100-19.8-AMBER-2V

2V - TWO ONE SIDED DISPLAYS - SAME CONTENT **Display Configuration:**

Cabinet Color: SEMI-GLOSS BLACK

Led Color: MONOCHROME AMBER (4,096 SHADES)


Communication Method: FIBER ETHERNET (SEE DRAWING 3119568) BY OTHERS


DISPLAY CONFIGURATION




TWO-VIEW (2V)

INSTALL NOTES GROUND LUG FOR GROUND CONNECTION SIGNAL INPUT AT QUICK CONNECT. PRIMARY/SINGLE FACE DISPLAY SHOWN. TWO 1" CONDUIT KNOCKOUTS FOR OPTIONAL SIGNAL ENTRANCE CLIP ANGLE FOR MOUNTING. CLIP ANGLES CAN BE ADJUSTED VERTICALLY AS NEEDED DURING INSTALLATION. CLIP ANGLE CAN BE WELDED OR **BOLTED TO STRINGER.** POWER ENTRANCE. SEE SIZE SPECIFIC DRAWING FOR POWER RATING. SIGNAL INTERCONNECT MECHANICAL AND SIGNAL CONNECTIONS OCCUR EXTERNAL TO DISPLAY. ALL CLIP ANGLES OR THEIR RESPECTIVE LOCATIONS MUST BE USED FOR MOUNTING. ALLOWABLE NUTSERT TENSION IS 1000 LBS. PRYING SHOULD BE CONSIDERED.

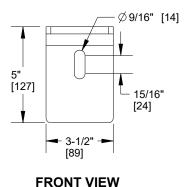

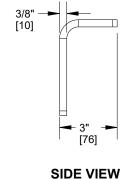


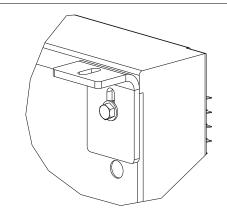


CLIP ANGLE DETAILS

ISOMETRIC VIEW

SCALE 1/5

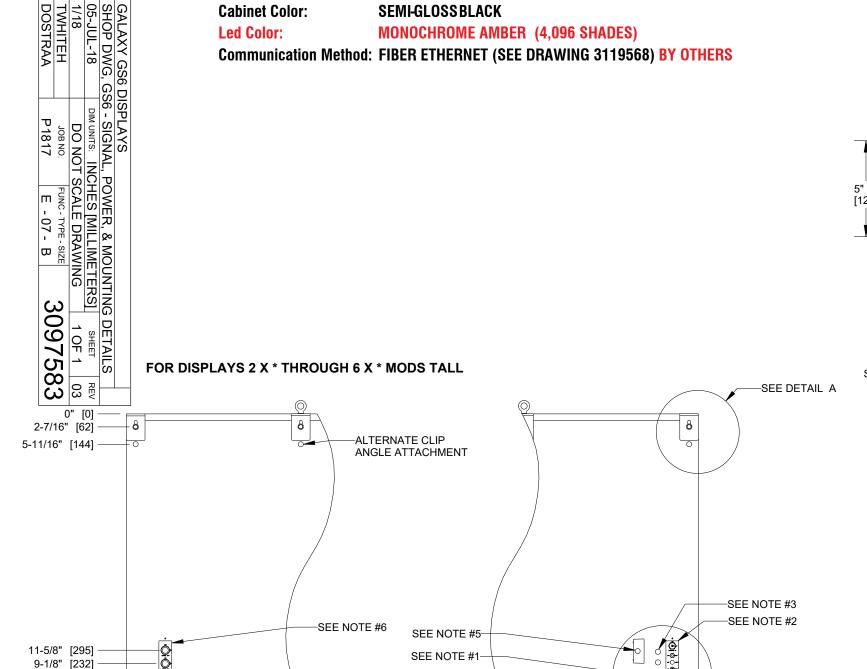

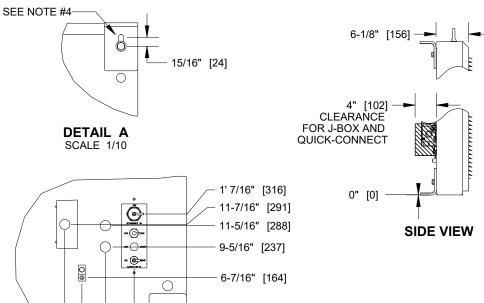

0" [0]

0

0

.

DETAIL B SCALE 1/9

[193] [249]

7-5/8"

[124]

-SEE DETAIL B

RIGHT SIDE

OF

REAR VIEW

FERRUCCI JUNIOR HIGH

1513 Central Ave South

Kent, Washington 98032

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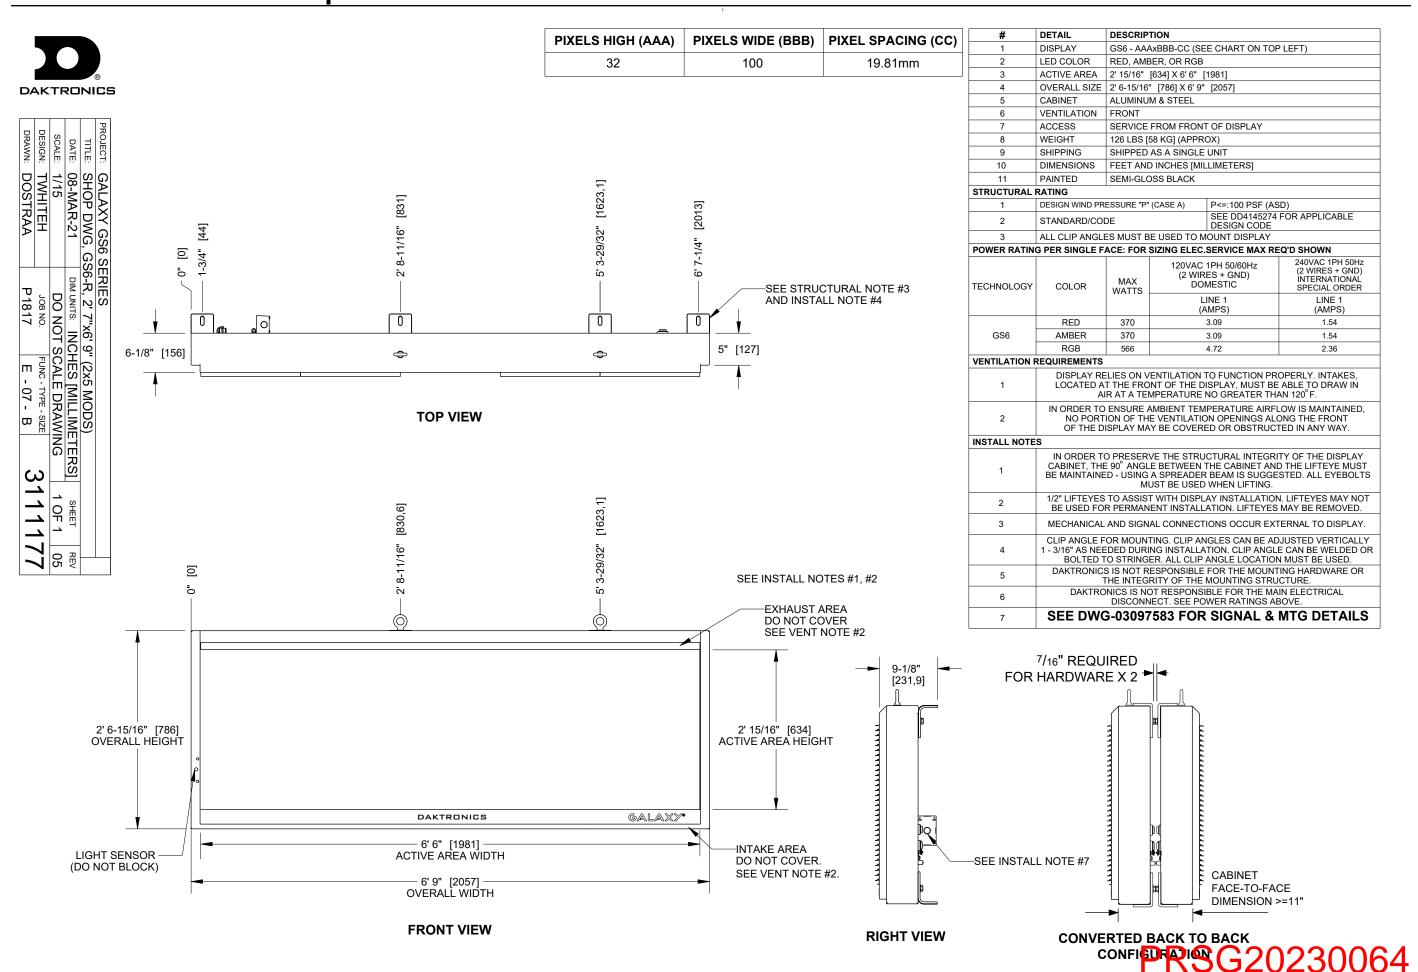
3213 WILDWOOD PARK DR. PUYALLUP, WA 98374



LED READERBOARD

MOUNTING DETAILS

12402 FERRUCCI JR HIGH | LED READERBOARD GALAXY GS6 19.8MM AMBER SPECIFICATIONS





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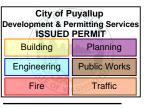
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LED READERBOARD

LED DISPLAY SPECS


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f 42

12402 FERRUCCI JR HIGH | LED READERBOARD GALAXY GS6 COMMUNICATION METHOD - FIBER ETHERNET



				•		
0	00200		R-01-A	P1817	DRAWN: LSOPER	DRAWN:
٥	2002600		FUNC - TYPE - SIZE	JOB NO.	DESIGN: LSOPER	DESIGN:
91	1 OF 1 01	G	DO NOT SCALE DRAWING	DO NOT S	SCALE: NONE	SCALE:
REV	SHEET	ERS]	DIM UNITS: INCHES [MILLIMETERS]	DIM UNITS: INCH	DATE: 07 JUL 15	DATE:
	/IM BOX	IET CON	BER ETHERN	R DIAGRAM, FI	TITLE: SYSTEM RISER DIAGRAM, FIBER ETHERNET COMM BOX	TITLE:
				GS6	PROJECT: SMALL MATRIX GS6	PROJECT:

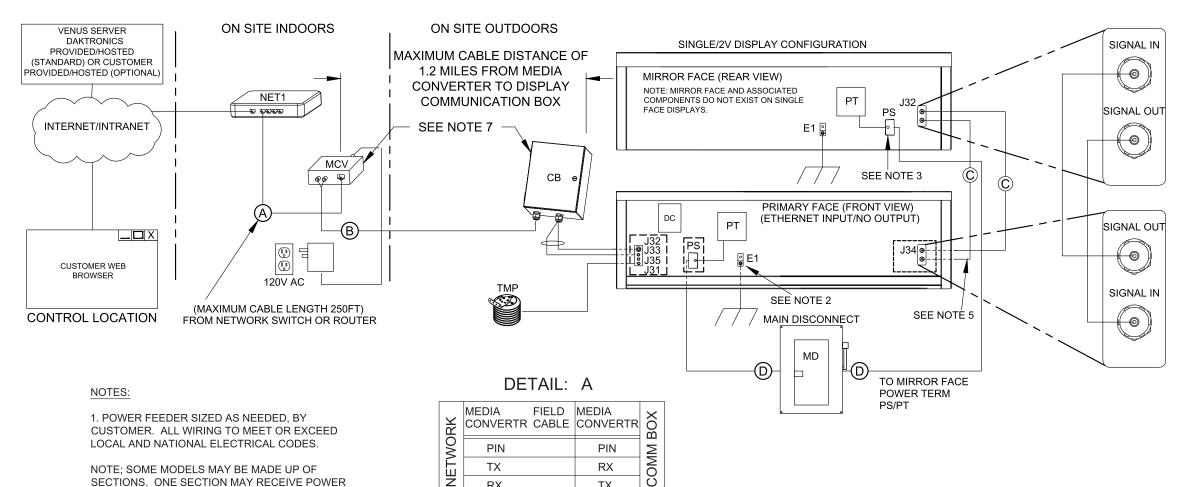

TX

RX

COMPONENT IDENTIFICATION TABLE						
COMPONENT	DESCRIPTION	DAKTRONICS #	PROVIDED BY	INSTALLED BY		
СВ	FIBER ETHERNET COMMUNICATION BOX, INCL 25FT CABLE	0A-1327-1124	DAKTRONICS	CUSTOMER		
DC	DISPLAY CONTROLLER	-	DAKTRONICS	FACTORY		
MD	MAIN DISCONNECT	-	CUSTOMER	CUSTOMER		
MCV	ETHERNET MEDIA CONV., 10/100BASE-TX TO 100BASSE-FX	A-2826	DAKTRONICS	CUSTOMER		
NET1	NETWORK ROUTHER OR SWITCH	-	CUSTOMER	CUSTOMER		
PS	POWER JUNCTION BOX (EXTERNAL POWER TERMINATION)	-	DAKTRONICS	FACTORY		
PT	INTERNAL POWER TERMINATION PANEL	-	DAKTRONICS	FACTORY		
TMP	TEMP SENSOR (OPTIONAL, INCLUDES 25 FT CABLE	0A-1151-0010	DAKTRONICS	CUSTOMER		

CABLE IDENTIFICATION TABLE						
ID TAG	CABLE TYPE	DAKTRONICS PART NUMBER	MANUFACTURE (PART NUMBER)	PROVIDED BY	INSTALLED BY	
(A)	CAT5E ETHERNET CABLE	W-1384	BELDEN (1592A)	CUSTOMER	CUSTOMER	
B	4 FIBER CABLE, 62.5/125 GRADE, MULTIMODE	W-1376	SEE NOTE "6"	CUSTOMER	CUSTOMER	
(C)	CABLE; 26' FIBER OPTIC, INDUSTRIAL LC-LC DUPLEX	W-2030	-	DAKTRONICS	CUSTOMER	
(D)	POWER FEEDER SEE NOTE "1"	-	-	CUSTOMER	CUSTOMER	

NOTE; SOME MODELS MAY BE MADE UP OF SECTIONS. ONE SECTION MAY RECEIVE POWER FOR SEVERAL SECTIONS. A SINGLE DISPLAY MAY INCLUDE MULTIPLE POWER ENTRANCES REQUIRING ADDITIONAL POWER FEEDS.

- 2. GROUND ROD CONNECTION LOCATED ON BACK OF DISPLAY. ALL DISPLAYS MUST BE GROUNDED PER ARTICLE 250 AND 600 OF THE NATIONAL ELECTRICAL CODE WITH NO MORE THAN 10 OHMS GROUND RESISTANCE.
- 3. POWER JUNCTION BOX LOCATED ON BACK OF DISPLAY. THE JUNCTION BOX IS ONLY LOCATED ON DISPLAYS THAT REQUIRE LESS THAN TWO 20 AMP CIRCUITS.
- 4. ACTUAL LOCATION OF JUNCTION BOX AND GROUND LUG VARIES. REFER TO SHOP DRAWING FOR LOCATION ON SPECIFIC MODEL.
- 5. QUICK CONNECT INTERCONNECT CABLE DOES NOT EXIST ON PRIMARY/PRIMARY CONFIGURATIONS. EACH PRIMARY DISPLAY REQUIRES A NETWORK CONNECTION.
- 6. MANUFACTURE PART NUMBER. OPTICAL CABLE CORP. BX04-080D-WLS-900-OFNR
- 7. ST FIBER MANUFACTURE PART NUMBER. AFL/FAST-ST-MM-62.5-100



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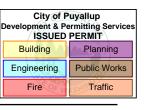
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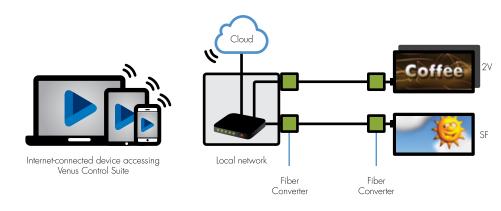


LED READERBOARD

12402 FERRUCCI JR HIGH | LED READERBOARD FIBER ETHERNET PRODUCT SPECIFICATIONS



Fiber Ethernet is a communication interface allowing an ethernet network to communicate with the display via a Local Area Network (LAN).



When should Fiber Ethernet be used as a communication interface?

- > The highest reliability is required
- > For most outdoor applications
- > When electromagnetic interference is present
- > For communication distances greater than 100 m
- > It is designed to control the display from multiple computers

ADVANTAGES

- > Extend Network Distance: Two 10BASE-T to 10BASE-FL Media Converters used back-to-back extend the distance between two 10BASE-T devices up to 2 km (1.2 mi) using multi-mode fiber without a repeater
- Integrate mixed cabling environments using either switched or shared Ethernet
- > Automatic Link Restoration re-establishes link in all network conditions
- > Automatically detects and configures the twisted pair port on the converter to the correct MDI or MDI-X configuration
- > Troubleshooting feature allowing the media converter to monitor both the fiber and copper RX ports for loss of signal

TECHNICAL SPECIFICATIONS

STANDARDS

IEEE Std 802.3™ 10BASE-T; 10BASE-FL

FIBER OPTIC CONNECTOR ST

Min TX PWR:

-19.0 dBm

Max TX PWR:

-14.0 dBm

RX Sensitivity:

-32.5 dBm

Max In PWR:

-7.2 dBm

Link Budget:

13.5 dB

LINK ALERT SWITCH

S1:

Enables/disables Link Pass Through The Link Alert switch allows the user to enable or disable the Link Alert feature. Link Alert allows the media converter to monitor both the fiber and the copper Rx ports for loss of signal. When signal loss occurs, the media converter notifies the far end device of the link loss, which prevents the loss of valuable data unknowingly transmitted over an invalid link.

STATUS LED'S

PWR (Power):

On indicates connection to external AC power

Link:

On indicates unit is receiving link pulses from a compliant device

RX (Receive):

On indicates packets are being received

POWER

12VDC, 0.5A; Unregulated

PHYSICAL PROPERTIES

Size:

Outdoor device: 12"L x 8"W x 5"H Indoor device: 4.5" L x 3" W x 1" H

Operating Temperature:

Outdoor device: -30 - 50 C; Indoor device: 0 – 50 C; 5% – 90% humidity non-condensing

CERTIFICATIONS

Wall Mount Power Supply; UL Listed, C-UL Listed (Canada) FCC Class A, CISPR22/EN55022 Class A, EN55024, EN61000 CE Mark



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LED READERBOARD

FIBER ETHERNET SPECS