





CITY OF PUYALLUP DOWNTOWN BANNER POLE PROJECT 700 BLOCK OF N MERIDIAN AVENUE

PROJECT NUMBER XX-XXX **MARCH 2021**

Added to this document are the City Standards for a Commercial Approach and Curb Cut.


Call Cheryl Trimble, City Inspector, at 253-290-9834 prior to starting any work.

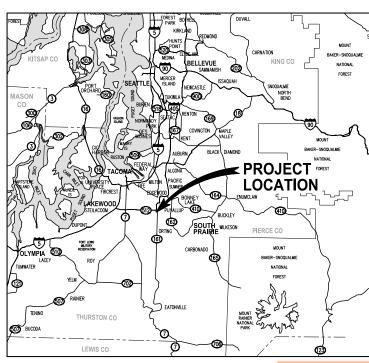

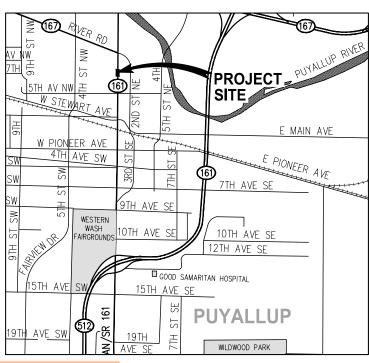

DRAWING INDEX SHEET DRAWING TITLE **GENERAL SHEETS** COVER SHEET
LEGEND & ABBREVIATIONS, GENERAL NOTES &
SURVEY CONTROL
SUMMARY OF QUANTITIES TYPICAL DETAILS TYPICAL DETAILS SITE PREPARATION AND TESC PLAN 700 BLOCK OF N MERIDIAN AVE BANNER POLE RESTORATION PLAN 700 BLOCK OF N MERIDIAN AVE SITE ELECTRICAL BANNER POLE RECEPTACLE BANNER POLE RECEPTACLE CITY OF PUYALLUP STANDARD DETAILS STANDARD DETAILS

LOCATION MAP NTS

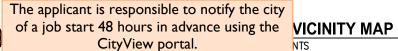

The permit and traffic control plans shall be posted at the job site and available to inspectors at all times.

Applicant must provide 48hr. notification to residents within 300 feet of the work area either via door hanger, message board or signs posted visibly along the right-of-way.

CALL 3 DAYS BEFORE YOU DIG 811

CLOSURE ALLOWED: Monday - Thursday 9AM - 2PM

Call communications center at 253-287-4456 on day of closure.

No Exceptions

This permit (E-21-0365) allows for 2 potholes to obtain depth and location for the City of Puyallup banner pole project.

NO.	DATE	BY	APPR.	REVISIONS	Approved By		19080COVR.dwg	
] ''		FILENAME	
							TD	3/2021
					ENGINEERING MANAGER	DATE	DESIGNED BY	DATE
							TD	3/2021
					PROJECT MANAGER	DATE	DRAWN BY	DATE
							NIM	3/2021
					PROJECT ENGINEER	DATE	CHECKED BY	DATE



KP	G
Interdisciplina	ry Design
TACOMA	Seattle
2502 Jefferson Ave	Wenatchee
WA 98402	Bellevue
(253) 627 0720	www.kpg.com






CITY OF PUYALLUP DOWNTOWN BANNER POLE **PROJECT**

COVER SHEET	

CITY OF PUYALLUF

ield conditions may dictate changes these plans as determined by the City

KPG PROJECT No. 19080 SHT _

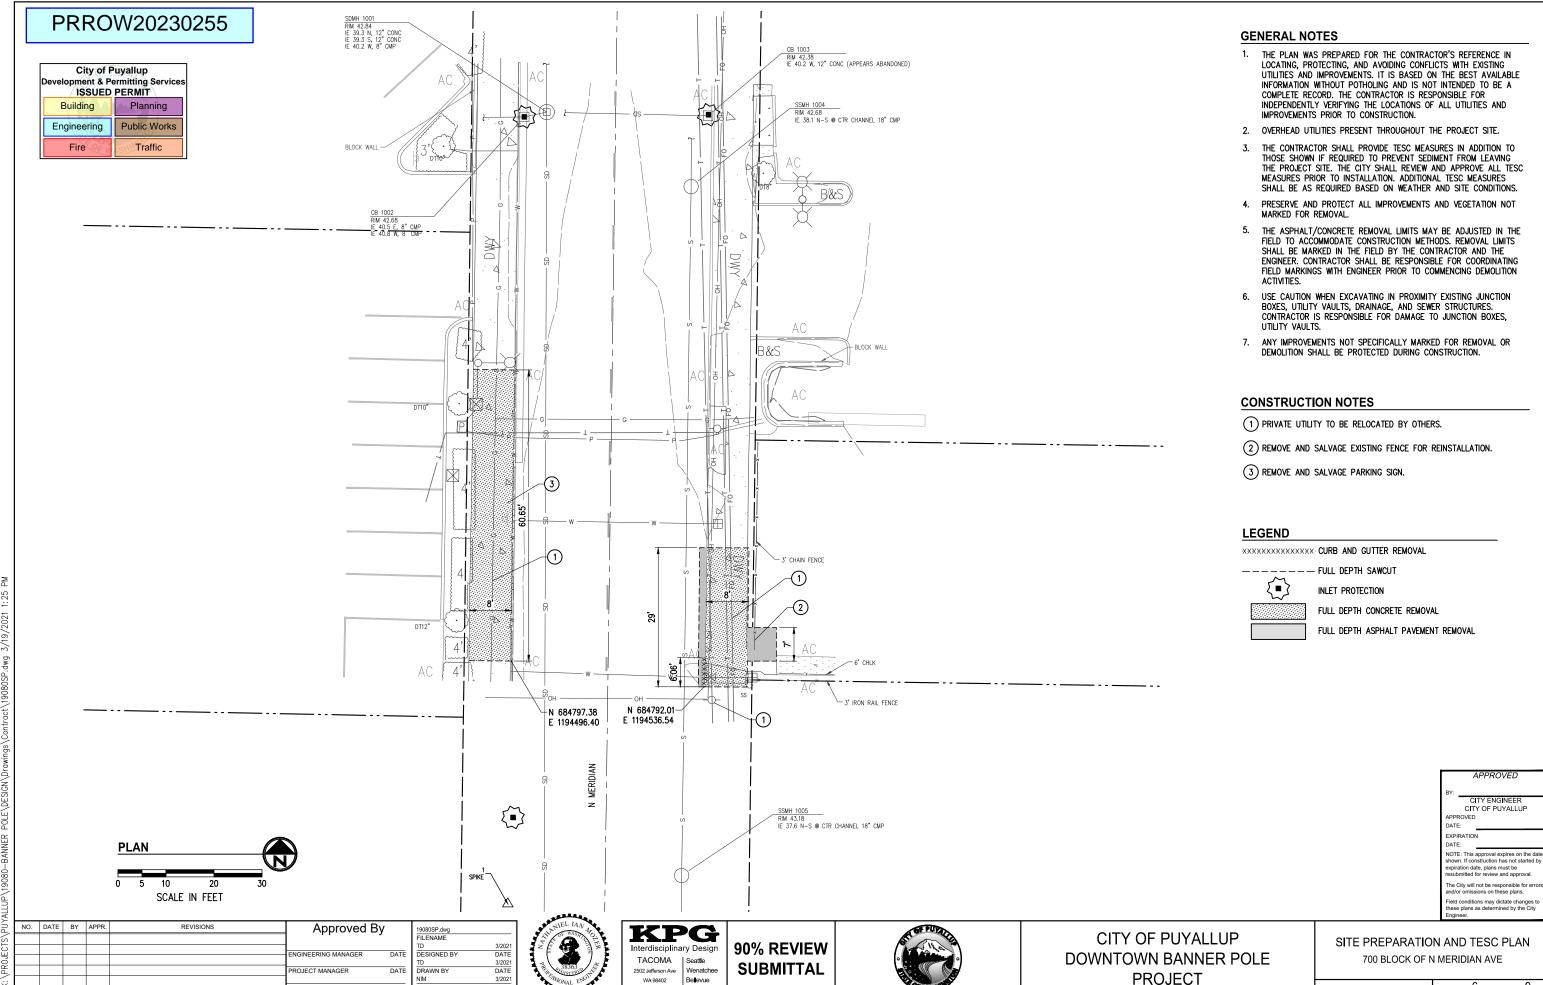

ROJECT ENGINEER


CHECKED BY

KPG PROJECT No. 19080 SHT <u>6</u> OF <u>9</u>



Call Cheryl Trimble, City Inspector, at 253-290-9834 prior to starting any work.

PARKING LOT

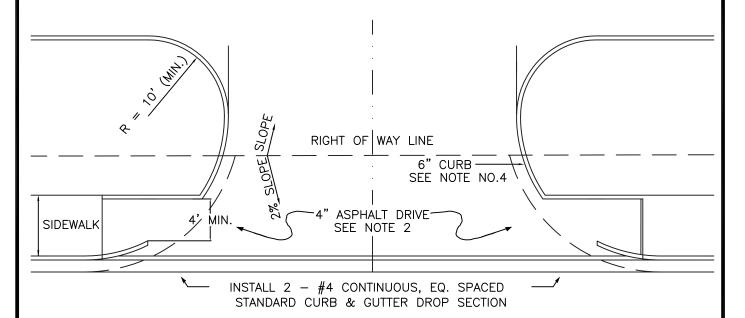

NOTES:

- TYPICAL COMMERCIAL APPROACHES SHALL BE 30' WIDE AND INCLUDE 35' CURB RADII. IF TRUCKS ARE EXPECTED TO USE
 THE APPROACH, DRIVEWAY WIDTH, CHANNELIZATION, AND CURB RADII SHALL BE BASED ON AN APPROVED TURNING
 MOVEMENT ANALYSIS
- 2. ALL ASPHALT PAVEMENT MUST CONFORM TO CITY STANDARD NO. 01.01.01.
- 3. APPROACH SHALL BE ASPHALT WITH STANDARD CURB AND GUTTER PLACED ON EACH SIDE OF THE APPROACH.
- 4. WHEEL CHAIR RAMPS SHALL BE INSTALLED IN ACCORDANCE TO ALL APPLICABLE STANDARDS. DETECTABLE WARNING PATTERNS SHALLBE CONSTRUCTED AT A DRIVEWAY ONLY WHEN IT WILL BE SIGNALIZED. CURB RAMP SLOPE SHALL NOT EXCEED 8.3%, AS MEASURE BY A SMART LEVEL, UNLESS RAMP LENGTH IS EXTENDED TO 15'. SEE DETAIL 01.02.19 FOR ADDITIONAL ADA RAMP INFORMATION.
- 5. SPACING OF COMMERCIAL APPROACHES ON PRINCIPAL AND MINOR ARTERIALS SHALL BE MINIMUM 300' AND SPACING ON COLLECTORS SHALL BE MINIMUM 150', MEASURED BETWEEN THE CLOSEST EDGES OF EACH DRIVEWAY. THIS REQUIREMENT IS ALSO APPLICABLE TO THE DRIVEWAYS THAT ARE ACROSS THE STREET.
- 6. SPACING OF COMMERCIAL APPROACHES FROM PRINCIPAL AND MINOR ARTERIALS SHALL BE MINIMUM 300' AND SPACING FROM A COLLECTOR SHALL BE MINIMUM 150', MEASURED FROM NEAREST ROW LINE TO APPROACH PAVEMENT EDGE. THE CITY MAY BE MORE RESTRICTIVE THAN SPECIFIED HEREIN IF DEEMED NECESSARY BASED ON TRAFFIC VOLUMES, CHANNELIZATION AND SIGNALIZATION.
- 7. THIS COMMERCIAL APPROACH STANDARD SHALL BE USED ON ARTERIALS AND COLLECTORS WITH SPEED LIMITS OF 35 MPH OR GREATER, AND/OR WHEN TRUCK TRAFFIC WILL BE USING THE APPROACH.




PUBLIC WORKS DEPARTMENTS

STANDARD COMMERCIAL APPROACH

DRAWN BY CHECKED BY LINDA LIAN APPROVED BY COLLEEN HARRIS LINDA LIAN COLLEEN HARRIS LINDA LIAN STANDARD

FILE NAME FÖDWGICOMMONISTDSICITY\2009\01_STR\01.02\01.02.16 DATE APPROVED DATE REVISED SCALE 02/19/14 1"=20' 01.02.16

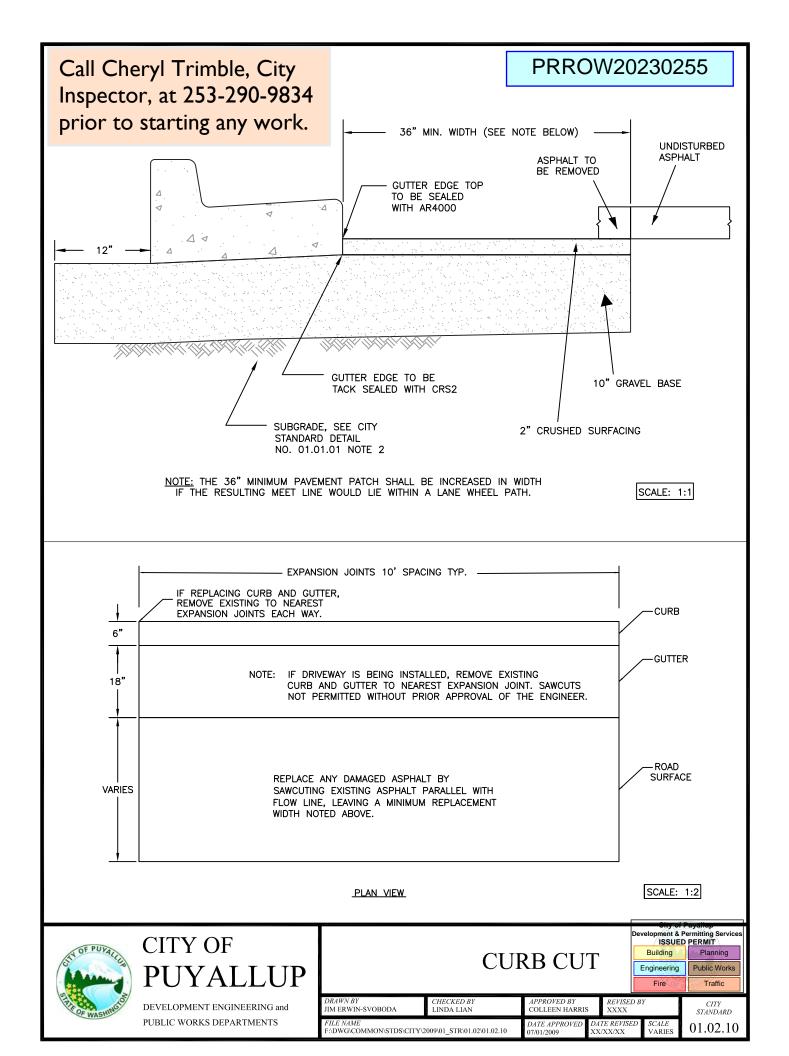

LEGEND

DWY

DRIVEWAY

BARK AND SHRUB

EXISTING PROPOSED MAG NAIL/SPIKE xxxxxxxxxxxxxxx CATCH BASIN STORM DRAIN MANHOLE \bigcirc SEWER MANHOLE SEWER CLEAN-OUT POWER POLE POWER POLE W/UG CONNECT Р POWER RISER \boxtimes JUNCTION BOX Δ STREET LIGHT (LUMINAIRE) ₩-LOT LIGHT WATER VALVE WATER METER STAND-PIPE (GENERIC/UNKNOWN) DECIDUOUS TREE, DIAMETER (# OF TRUNKS) PAINTED POWER PAINTED TELEPHONE PAINTED TV PAINTED WATER PAINTED GAS OVERHEAD UTILITY LINE SEWER FENCE HEDGE (HEIGHT NOTED) PAINTED SKIP STRIPE EDGE OF PAVEMENT CONTOUR CONCRETE GRAVEL GRASS ASPHALT/CONCRETE CHAINLINK CHI K

ARRREVIATIONS

CURB AND GUTTER REMOVAL

FULL DEPTH CONCRETE REMOVAL

FULL DEPTH PAVEMENT REMOVAL

CEMENT CONC SIDEWALK

CEMENT CONC DRIVEWAY

HMA PAVEMENT

FULL DEPTH SAWCUT

CURB & GUTTER

INLET PROTECTION

<u>ABBRE</u>	VIATIONS				
AC	ASPHALT/CONCRETE PAVEMENT	LP	LOW POINT	SSMH	SANITARY SEWER MANHOLE
ADA	AMERICANS WITH DISABILITIES ACT	LT	LEFT	ST	STREET
ALT	ALTERNATE	MAX	MAXIMUM	STA	STATION
AP	ANGLE POINT	MDD	MAXIMUM DRY DENSITY	STD	STANDARD
APPROX	APPROXIMATE	MIC	MONUMENT IN CASE	T	TANGENT LENGTH
AVE	AVENUE	MIL	MILLIMETER	TEMP	TEMPORARY
BLDG	BUILDING	MIN	MINIMUM	TOC	TOP OF CURB
BOW	BACK OF WALK	MH	MANHOLE	TOG	TOP OF GRATE
B & S	BARK AND SHRUB	MISC	MISCELLANEOUS	TOW	TOP OF WALK
CB	CATCH BASIN	MJ	MECHANICAL JOINT	TYP	TYPICAL
CDF	CONTROLLED DENSITY FILL	MON	MONUMENT	UG	UMDERGROUND
CHAN	CHANNELIZATION	MSE	MECHANICALLY STABILIZED EARTH	UNK	UNKNOWN
CHLK	CHAINLINK	N	NORTHING/NORTH	VC	VERTICAL CURVE
C ,CL, Q	CENTERLINE	NO,#	NUMBER	VERT	VERTICAL
CL _	CLASS	NTS	NOT TO SCALE	W	WATER, WEST
CO	CLEANOUT	0.C.	ON CENTER	W/	WITH
CONC	CONCRETE	O.D.	OUTSIDE DIAMETER	WSDOT	WASHINGTON STATE
C.O.P.	CITY OF PUYALLUP	PC	POINT OF CURVATURE		DEPARTMENT OF
CSBC	CRUSHED SURFACING BASE COURSE	PCC	POINT OF CURVE ON CURVE		TRANSPORTATION
CSTC	CRUSHED SURFACING TOP COURSE	PCC	PORTLAND CEMENT CONCRETE	Δ	DELTA
DET	DETAIL	PE	POLYETHYLENE		
DIA, Ø	DIAMETER	PI	POINT OF INTERSECTION		
DIP	DUCTILE IRON PIPE	POC	POINT OF CURVE		
DW	DRIVEWAY	PRC	POINT OF REVERSE CURVATURE		
Ε	EASTING/EAST	PT	POINT OF TANGENCY		
EL/ELEV	ELEVATION	PVC	POLYVINYL CHLORIDE		
EOP	EDGE OF PAVEMENT	PVI	POINT OF VERTICAL		
ex/exist	EXISTING	R	RADIUS		
FL	FLANGE/FLOWLINE	REQ'D	REQUIRED		
FOC	FACE OF CURB	RP	RADIUS POINT		
H, HOR	HORIZONTAL	RT	RIGHT		
HMA	HOT MIX ASPHALT	R/W, ROW	RIGHT OF WAY		
HP	HIGH POINT	S	SLOPE/SOUTH		
D	INSIDE DIAMETER	SD	STORM DRAIN		
E	INVERT ELEVATION	SS	SANITARY SEWER		
L	LENGTH	SHT	SHEET		
LF	LINEAR FEET	SPEC	SPECIFICATIONS		

GENERAL NOTES

- 1. ALL WORK IN CITY RIGHT-OF-WAY REQUIRES A PERMIT FROM THE C.O.P. PRIOR TO ANY WORK COMMENCING, THE GENERAL CONTRACTOR SHALL ARRANGE FOR A PRECONSTRUCTION MEETING WITH THE C.O.P. TO BE ATTENDED BY ALL GENERAL CONTRACTORS, SUB-CONTRACTORS, AND REPRESENTATIVES OF INVOLVED UTILITIES.
- 2. AFTER COMPLETION OF ALL ITEMS SHOWN ON THESE PLANS AND BEFORE ACCEPTANCE OF THE PROJECT, THE CONTRACTOR SHALL OBTAIN A "PUNCH LIST" PREPARED BY THE C.O.P. INSPECTOR DETAILING REMAINING ITEMS OF WORK TO BE COMPLETED. ALL ITEMS OF WORK SHOWN ON THESE PLANS SHALL BE COMPLETED TO THE SATISFACTION OF THE CITY PRIOR TO ACCEPTANCE OF THE PROJECT.
- 3. ALL MATERIALS AND WORKMANSHIP SHALL CONFORM TO THE STANDARD SPECIFICATIONS FOR ROAD, BRIDGE, AND MUNICIPAL CONSTRUCTION (HEREINAFTER REFERRED TO AS THE STANDARD SPECIFICATIONS'), PUBLISHED BY THE WASHINGTON STATE DEPARTMENT OF TRANSPORTATION AND THE AMERICAN PUBLIC WORKS ASSOCIATION, WASHINGTON STATE CHAPTER, LATEST EDITION, UNLESS SUPERCEDED OR AMENDED BY THE PROJECT SPECIAL PROVISIONS OR C.O.P. STANDARDS FOR PUBLIC WORKS ENGINEERING AND CONSTRUCTION (HEREINAFTER REFERRED TO AS THE "CITY STANDARDS").
- 4. A COPY OF THESE APPROVED PLANS AND APPLICABLE CITY SPECIFICATIONS AND DETAILS SHALL BE ON SITE DURING CONSTRUCTION.
- 5. ANY REVISIONS MADE TO THESE PLANS MUST BE REVIEWED AND APPROVED BY THE CITY ENGINEER OR HIS DESIGNEE PRIOR TO ANY IMPLEMENTATION IN THE FIELD.
- 6. THE CONTRACTOR SHALL HAVE ALL UTILITIES VERIFIED AND MARKED ON THE GROUND PRIOR TO ANY CONSTRUCTION. CALL (1-800-424-5555) AT LEAST 48 HOURS IN ADVANCE OF CONSTRUCTION ACTIVITIES. THE ENGINEER SHALL BE CONTACTED IMMEDIATELY IF A CONFLICT EXISTS.
- 7. THE CONTRACTOR SHALL SUBMIT TRAFFIC CONTROL PLANS TO THE TRAFFIC ENGINEER PRIOR TO ANY LANE CLOSURES OR TRAFFIC IMPACTS.
- 8. ALL EXISTING UTILITY INFORMATION INCLUDING EXISTING MATERIAL, DEPTH. AND HORIZONTAL LOCATION ARE BASED ON BEST AVAILABLE INFORMATION WITHOUT POTHOLING AND ARE SOLELY FOR THE CONTRACTOR'S BENEFIT. INVERT ELEVATIONS FOR UTILITY CROSSINGS SHOWN WITHIN THE PROFILE VIEW ARE ESTIMATED BASED ON RECORD DRAWINGS/GIS/OTHER DATA AND MAY NOT BE ACCURATE. CONTRACTOR SHALL POTHOLE THE UTILITY CROSSING AND CONNECTION POINTS AT THE LOCATIONS SPECIFIED HEREIN A MINIMUM OF FIVE (5) WORKING DAYS PRIOR TO BEGINNING UTILITY IMPROVEMENTS TO VERIFY HORIZONTAL/VERTICAL LOCATION AND MATERIAL OF THE EXISTING UTILITIES. CONTRACTOR SHALL NOTIFY THE ENGINEER IMMEDIATELY IN THE EVENT OF UTILITY CONFLICTS.

SURVEY NOTES

- THE PURPOSE OF THIS TOPOGRAPHIC SURVEY IS FOR CIVIL ENGINEERING DESIGN. THIS IS NOT A BOUNDARY SURVEY. SOURCES OF BOUNDARY INFORMATION AS SHOWN INCLUDE FIELD—TIED MONUMENTATION, PLATS, COUNTY RECORDS OF SURVEY, AND AUDITOR
- 2. THE LOCATIONS OF EXISTING UNDERGROUND UTILITY SYSTEMS, AS SHOWN HEREON, ARE TAKEN FROM UTILITY LOCATE PAINT MARKS OR AS-BUILT PLANS AND ARE SHOWN IN AN APPROXIMATE WAY ONLY.

THE CONTRACTOR SHALL DETERMINE THE EXACT LOCATION OF ALL EXISTING UTILITIES BEFORE COMMENCING WORK, AND AGREES TO BE FULLY RESPONSIBLE FOR ANY AND ALL DAMAGES WHICH MIGHT BE OCCASIONED BY THE CONTRACTOR'S FAILURE TO EXACTLY LOCATE AND PRESERVE ANY AND ALL UNDERGROUND UTILITIES. ALL LOCATOR SERVICES SHOULD BE CONTACTED PRIOR TO ANY CONSTRUCTION OR SUBSURFACE EXPLORATION. CALL 1-800-424-5555

- 3. FIELD SURVEY: KPG, MAY, 2020. LICENSEE MICHAEL R. BOWEN, P.L.S. NO. 29294/RONALD D. REICHEL, P.L.S. NO. 38015.
- CONTOUR INTERVAL = 1 FOOT, ±0.5 FOOT PER NATIONAL MAPPING STANDARDS. CONTOURS DERIVED FROM DIRECT FIELD OBSERVATIONS.
- 5. STORM AND SEWER CONNECTIONS HAVE BEEN DRAWN FROM CENTER
- 6. THE LOCATIONS AND DIMENSIONS OF UNDERGROUND VAULTS HAVE NOT BEEN VERIFIED AND ARE APPROXIMATE.
- 7. DUCTS ARE NOTED AS INDICATED IN THE FIELD BY UTILITY LOCATORS. MULTIPLE LINES AND/OR UTILITIES MAY SHARE DUCT RUNS; THIS MAY NOT BE SHOWN IN THE DRAWING.

HORIZONTAL AND VERTICAL DATUM

HORIZONTAL DATUM: NAD 83/11

VERTICAL DATUM

HORIZONTAL AND VERTICAL DATUMS ESTABLISHED BY RTK GPS OBSERVATION UTILIZING WSRN (WASHINGTON STATE REFERENCE NETWORK)

NAVD 88

CONTROL POINT LIST								
PT # DESCRIPTION NORTHING EASTING ELEVATION								
1	SPIKE	684746.79	1194495.68	43.38'				
2	SPIKE	684996.89	1194491.72	43.05'				

ALL REFERENCES TO "STANDARD SPECIFICATIONS" PERTAIN TO THE 2021 WSDOT STANDARD SPECIFICATIONS FOR ROAD, BRIDGE, AND MUNICIPAL CONSTRUCTION.

ALL REFERENCES TO "SPECIAL PROVISIONS" PERTAIN TO THE PROJECT MANUAL.

City of F Development & Po ISSUED	
Building	Planning
Engineering	Public Works
Fire OF V	Traffic

CITY OF PUYALLUP EXPIRATION NOTE: This approval expires on the date shown. If construction has not started by he City will not be responsible for erro nd/or omissions on these plans.

LEGEND & ABBREVIATIONS, GENERAL

NO.	DATE	BY	APPR.	REVISIONS	Approved By		19080COVR.dwg	
							FILENAME	
							TD	3/202
					ENGINEERING MANAGER	DATE	DESIGNED BY	DAT
							TD	3/202
					PROJECT MANAGER	DATE	DRAWN BY	DAT
							NIM	3/202
					PROJECT ENGINEER	DATE	CHECKED BY	DATI





90% REVIEW **SUBMITTAL**



CITY OF PUYALLUP DOWNTOWN BANNER POLE **PROJECT**



		SUMMARY OF QUANTITIES					
ITEM NO.	ITEM	LINIT	TOTAL OLIANITITY	QUANTITY PER SHEET			
HEMINO.	ITEM	UNIT	UNIT TOTAL QUANTITY		SHEET 6	SHEET 7	
100	100 Minor Change		1		1		
101	Construction Surveying	LS	1		1		
102	Record Drawings, (Min. Bid \$250)	LS	1		1		
103	SPCC Plan	LS	1		1		
104	Mobilization	LS	1		1		
105	Project Temporary Traffic Control	LS	1		1		
106	Removal of Structures and Obstructions	LS	1	1			
107	Asphalt Conc. Pavement Removal	SY	11	11			
108	Cement Conc. Sidewalk Removal	SY	82	82			
109	Curb Removal	LF	7		7		
110	Adjust Existing Utility to Grade	EA	1	1			
111	Potholing	EA	3		3		
112	Crushed Surfacing Top Course	TN	25		25		
113	Crushed Surfacing Base Course	TN	24		24		
114	Commerical HMA	TN	11	11			
115	Erosion Control and Water Pollution Prevention	LS	1	1			
116	Inlet Protection	EA	3		3		
117	Cement Conc. Traffic Curb and Gutter	LF	6		6		
118	Commercial Cement Conc. Driveway Entrance	SY	19		19		
119	Cement Conc. Sidewalk	EA	82		82		
120	Remove and Reinstall Sign	SY	1		1		
121	Banner Pole System, Complete	LS	1			1	

CITY ENGINEER CITY OF PUYALLUP

EXPIRATION

DATE:

NOTE: This approval expires on the date shown. If construction has not started by expiration date, plans must be resubmitted for review and approval.

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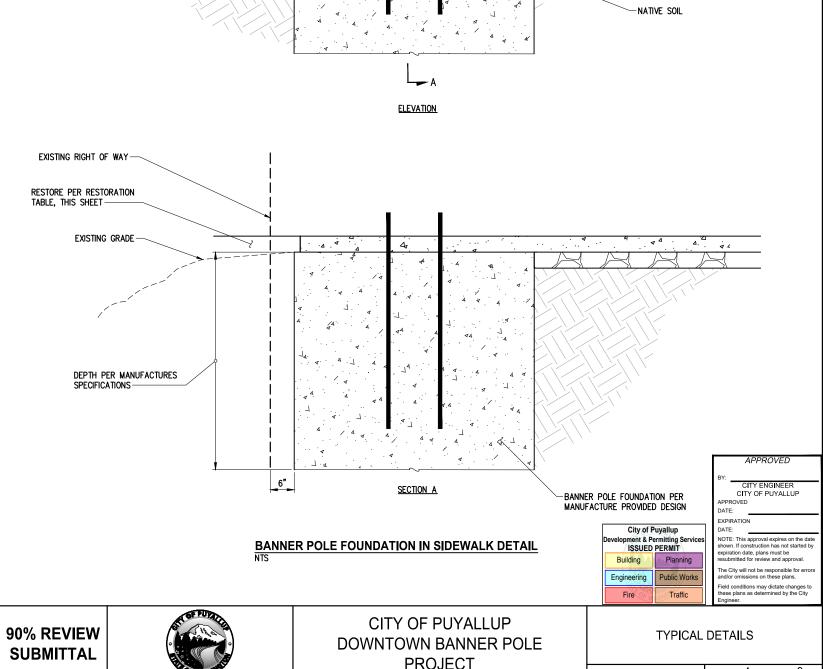
SUMMARY OF QUANTITIES

NO. DATE BY APPR. Approved By KPG CITY OF PUYALLUP 90% REVIEW 3/2021 DATE 3/2021 DATE 3/2021 DATE DATE DESIGNED BY DOWNTOWN BANNER POLE TACOMA Seattle
2502 Jefferson Ave Wenatchee
WA 98402 Bellevue SUBMITTAL DRAWN BY DATE PROJECT MANAGER **PROJECT** DATE CHECKED BY KPG PROJECT No. 19080 SHT <u>3</u> OF <u>9</u>

REVISIONS

	RESTORATION TABLE					
RESTORATION TYPE	RESTORATION	COMMENTS				
PRIVATE LANDSCAPE AREAS	3" BARK MULCH OVER 4" TOPSOIL TYPE A	FINISH GRADE SHALL BE SMOOTH AND CONSISTENT WITH EXISTING GRADE.				
HMA AT BACK OF WALK	3" HMA OVER 2" CSTC	MATCH PRECONSTRUCTION EXTENTS AND CONFIGURATION. FINISHED GRADE SHALL BE SMOOTH AND CONSISTENT WITH EXISTING				

<u>NOTE:</u> LOCATIONS OF RESTORATION ARE TYPICAL AND MAY BE REVISED BASED ON PROPERTY OWNER'S PREFERENCE AND APPROVAL BY THE CITY. FINAL RESTORATION TYPE SHALL BE DETERMINED BY THE CITY.



NO. DATE BY APPR. Approved By DESIGNED BY DRAWN BY DATE ROJECT MANAGER NIM CHECKED BY









PROJECT


ANCHOR BOLTS

TYPICAL SIDEWALK SECTION

SIDEWALK

KPG PROJECT No. 19080 SHT 4



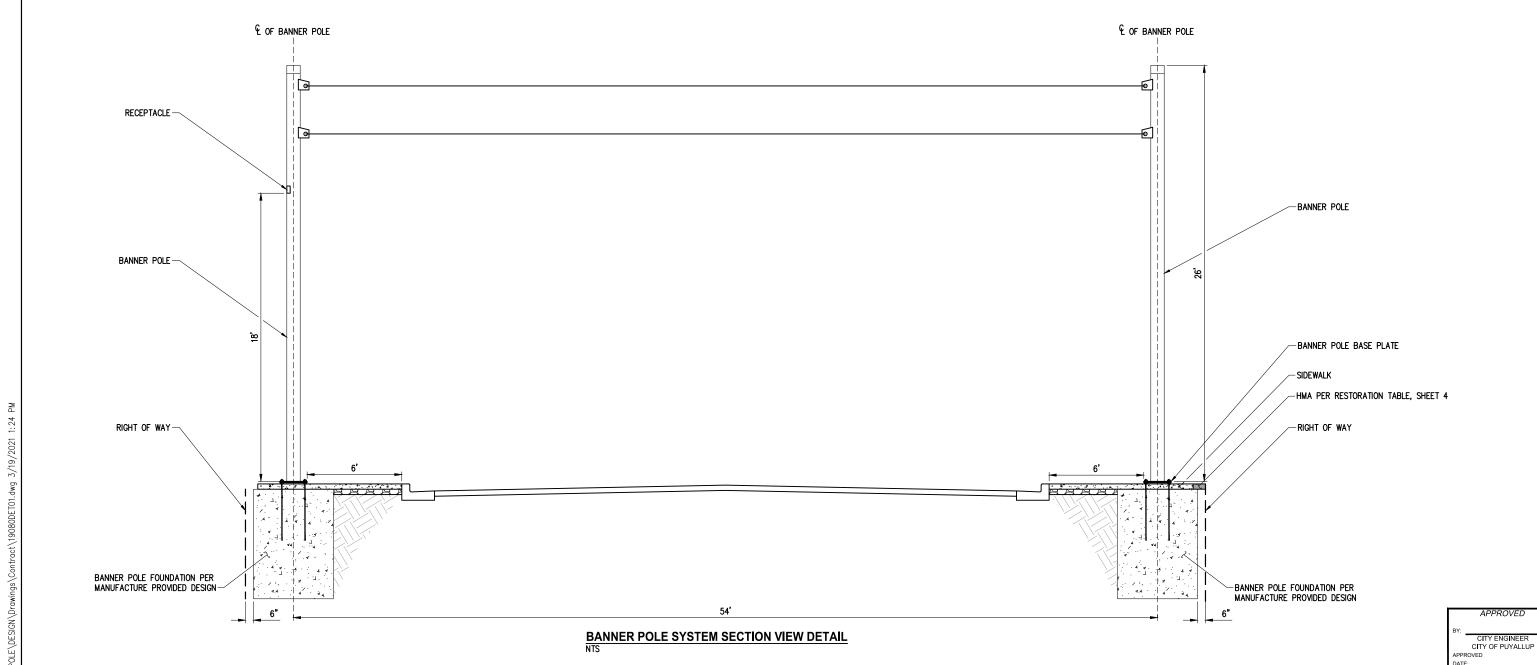

2	NO.	DATE	BY	APPR.	REVISIONS	Approved By		19080DET01.dwg	
ńΙ								FILENAME	
5								TD	3/2021
ĺ						ENGINEERING MANAGER	DATE	DESIGNED BY	DATE
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90% REVIEW

SUBMITTAL



CITY OF PUYALLUP DOWNTOWN BANNER POLE PROJECT


BANNER POLE SECTION VIEW


KPG PROJECT No. 19080 SHT <u>5</u> OF <u>9</u>

14: V 160EO 13 V 0 17/EEO 1 130O


WINDLY OLD GLOTION VIEW


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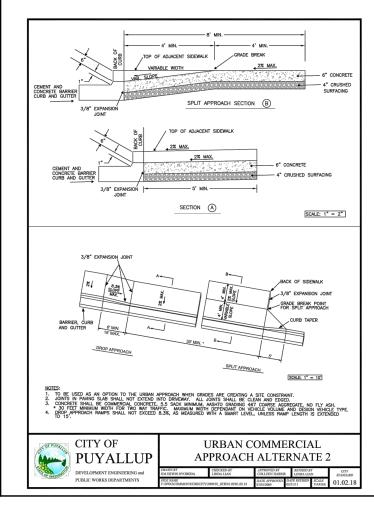


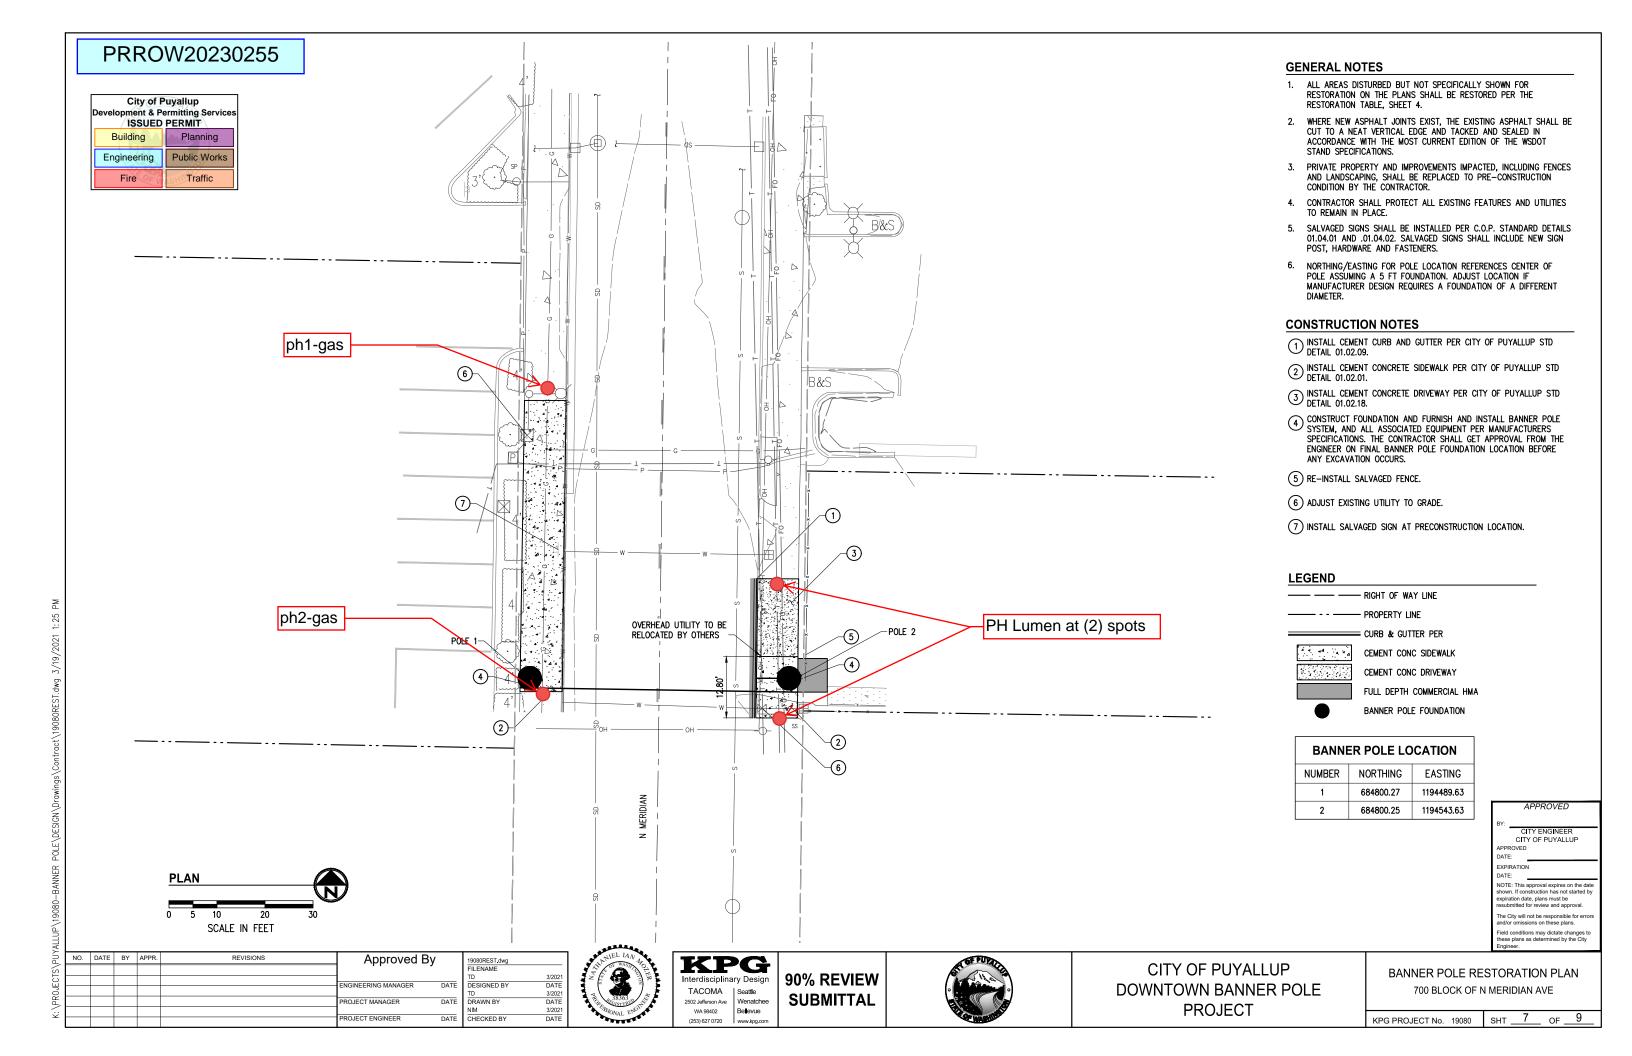


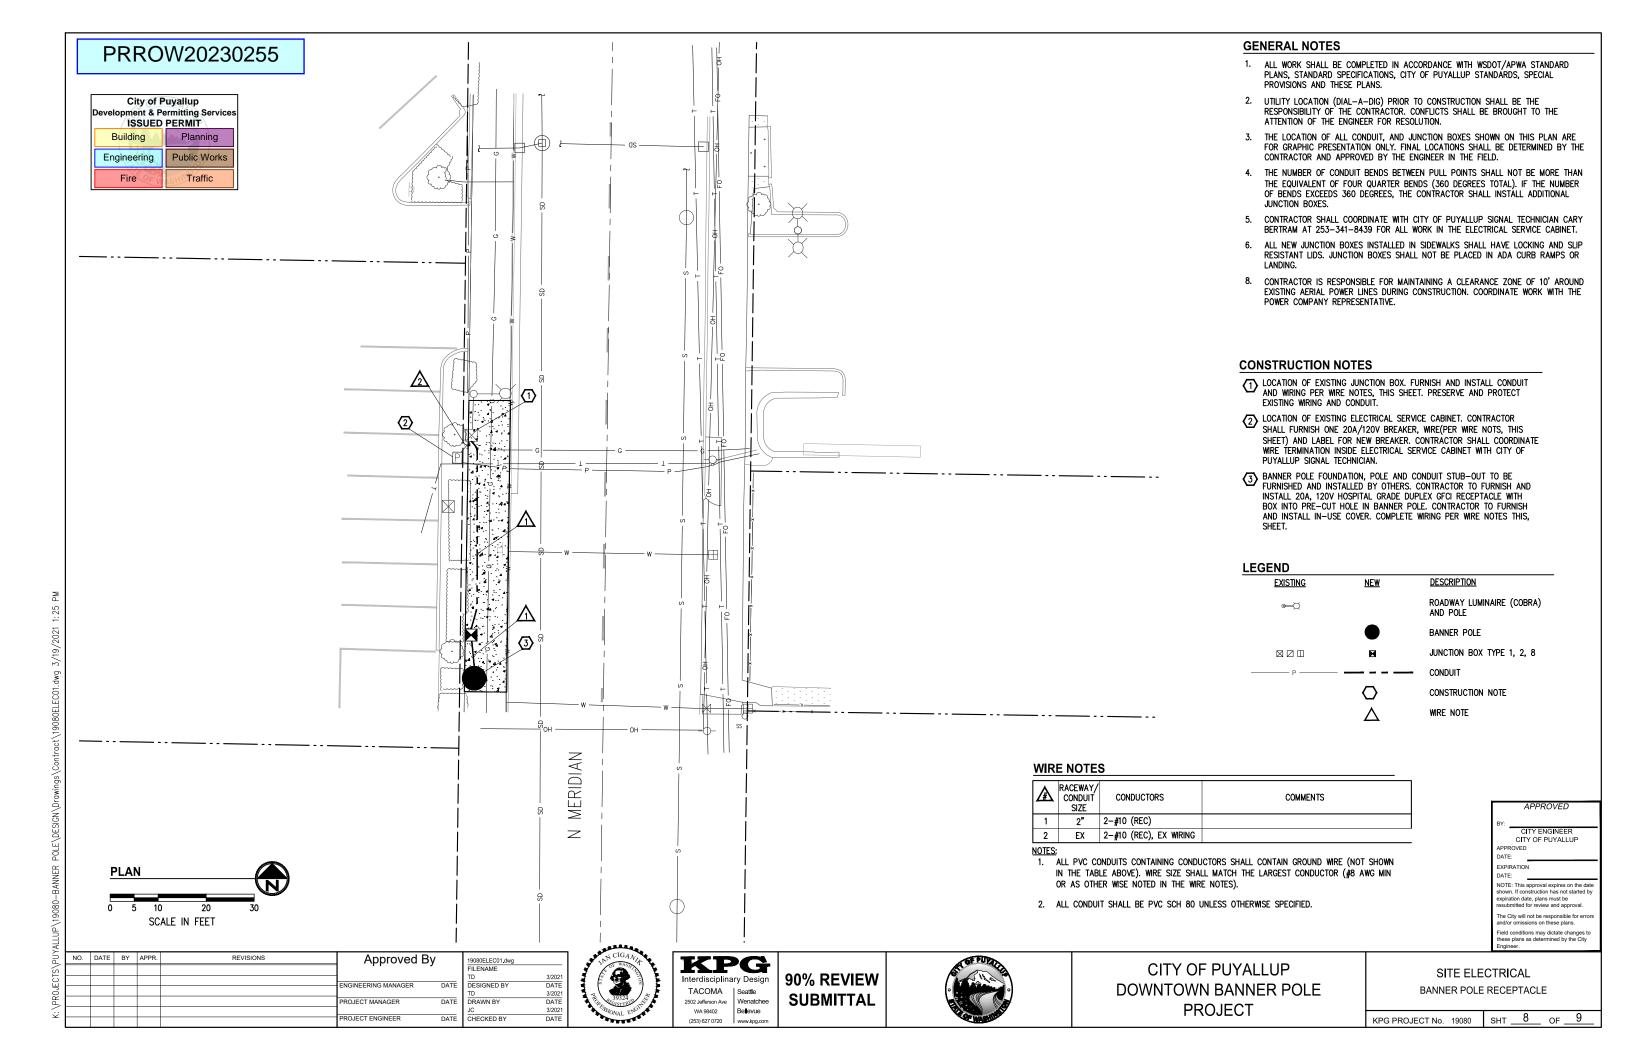




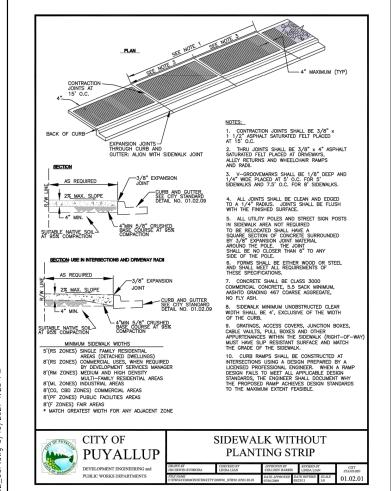

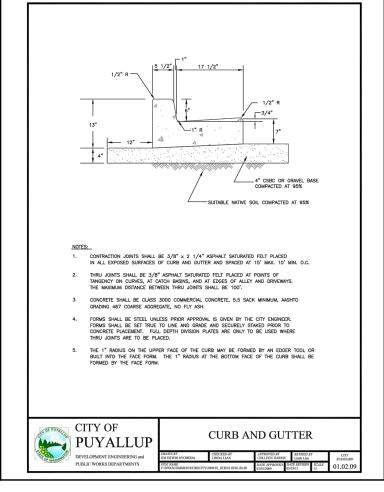

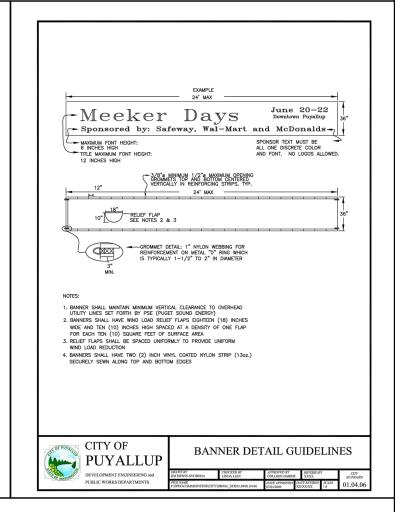

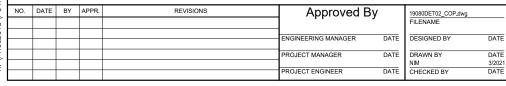









CITY OF PUYALLUP **DOWNTOWN BANNER POLE PROJECT**

CITY OF PUYALLUP STANDARD DETAILS

KPG PROJECT No. 19080 SHT 9 OF 9

CITY OF PUYALLUP

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DATE: EXPIRATION DATE: