CENTRAL PIERCE FIRE & RESCUE TENANT IMPROVEMENT

AGENCY NOTES

CONSTRUCTION TYPE: OCCUPANCY: SEISMIC DESIGN CAT.: SEISMIC SITE CLASS: **OCCUPANCY CAT: ZONING:**

B (OFFICE), A3

MP - BUSINESS PARK (PER CITY ZONING MAP) B OCCUPANCY; TENANT FINISH OUT OF SHELL BUILDING **EXISTING SHELL BUILDING PERMIT** B-19-1093

TYPE II-B (SPRINKLED)

APPLICABLE CODES

2018 IBC W/ WA STATE AMENDMENTS 2018 INTERNATIONAL FIRE CODE 2018 INTERNATIONAL EXISTING BUILDING CODE 2018 UNIFORM PLUMBING CODE 2018 WASHINGTON STATE ENERGY CODE WA STATE VENTILATION AND INDOOR AIR QUALITY CODE 2016 NFPA STANDARD 72 2016 NFPA STANDARD 13, 13-D, AND 13-R

NO. OF STORIES 4 ALLOWED; 2 PROVIDED

BUILDING AREA

FIRST FLOOR: 90,721 GSF (EXISTING/ NOT ALTERED) SECOND FLOOR: 91,774 GSF (EXISTING/ NOT ALTERED) TOTAL: 182,495 GSF (EXISTING/ NOT ALTERED)

PROJECT DESCRIPTION

TENANT IMPROVEMENT AND FINISH OUT OF THE NORTH SIDE OF LEVEL 1. IMPROVEMENTS INCLUDE OFFICES, MEETING ROOMS, EXERCISE AREA AND BREAK ROOMS. THE INTERIOR ALTERATIONS DO NOT INCREASE THE BUILDINGS AREA. NOR DO THEY ALTER THE BUILDING EGRESS AND/OR CIRCULATION OUTSIDE THE RENOVATED SPACE.

LEGAL DESCRIPTION

PIERCE COUNTY ASSESSOR'S PARCEL #. 0419034038 A PORTION OF REVISED PARCEL 1, CITY OF PUYALLUP BOUNDARY LINE REVISION NO. P-12-0044, RECORDED UNDER RECORDING NO. 201211145004. IN PIERCE COUNTY, WASHINGTON: EXPECT THAT PORTION THEREOF DEDICATED TO THE CITY OF PUYALLUP BY DEED RECORDED UNDER RECORDING NO. 201212200909, LYING IN THE SOUTHEAST QUARTER OF SECTION 3, TOWNSHIP 19 NORTH, RANGE 4 EAST, W.M., PIERCE COUNTY, WASHINGTON, DESCRIBED AS FOLLOWS COMMENCING AT THE STONE MONUMENT MARKING THE SOUTH QUARTER CORNER OF SAID SECTION 3, WHICH MONUMENT IS NORTH 86°31'42" WEST, 2621.06 FEET FROM THE SOUTHEAST CORNER OF SAID SECTION 3: THENCE ALONG SAID SOUTH SECTION LINE. SOUTH 86°31'42" EAST. A DISTANCE OF 1.310.53 FEET TO THE SOUTH SIXTEENTH CORNER OF SAID SECTION 3: THENCE ALONG THE NORTH-SOUTH CENTER LINE OF THE SOUTHEAST QUARTER OF SAID SECTION 3

NORTH 00°13'45" EAST, A DISTANCE OF 53.05 FEET TO A POINT ON THE NORTHERLY RIGHT-OF-WAY OF 39TH **AVENUE SOUTHEAST;**

THENCE CONTINUING ALONG SAID NORTH-SOUTH CENTER LINE, NORTH 00°13'45" EAST, A DISTANCE OF 332.49 FEET TO THE NORTH LINE OF THAT PARCEL DESCRIBED IN THE INSTRUMENT RECORDED UNDER AUDITOR'S NO.

THENCE ALONG SAID NORTH LINE, SOUTH 86°31'42" EAST, A DISTANCE OF 295.47 FEET TO THE EAST LINE OF LARGE LOT SEGREGATION UNDER AUDITOR'S NO. 200704305001

THENCE NORTH 00°13'45" EAST, ALONG SAID EAST LINE A DISTANCE OF 1,625.81 FEET;

THENCE SOUTH 89°59'00" WEST, A DISTANCE OF 579.05 FEET TO THE POINT OF BEGINNING;

THENCE SOUTH 00°00'36" WEST, A DISTANCE OF 815,64 FEET THENCE SOUTH 89°59'00" WEST, A DISTANCE OF 547.26 FEET

THENCE NORTH 00°00'36" EAST. A DISTANCE OF 489.96 FEET:

THENCE NORTH 89°59'00" EAST, A DISTANCE OF 80.33 FEET;

THENCE NORTH 00°15'12" WEST, A DISTANCE OF 225.75 FEET

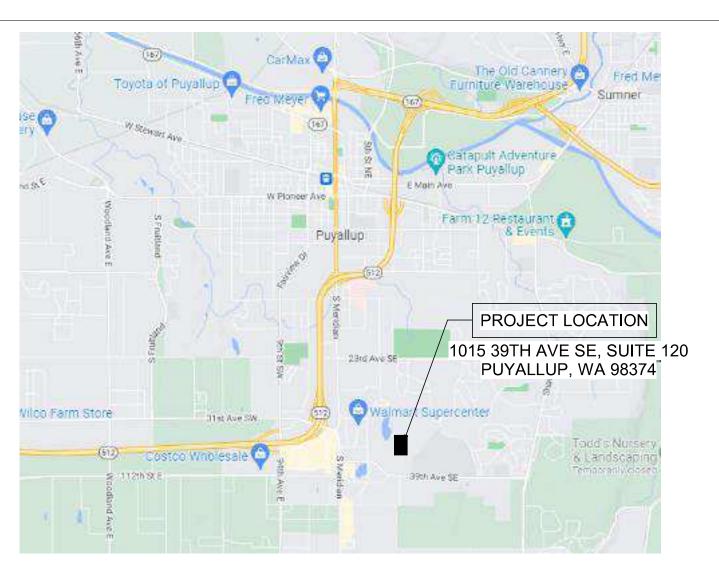
THENCE NORTH 37°10'59" EAST, A DISTANCE OF 186.48 FEET;

THENCE SOUTH 52°49'01" EAST, A DISTANCE OF 80.41 FEET TO A POINT WHICH BEARS SOUTH 89°59'00" WEST FROM THE POINT OF BEGINNING:

THENCE NORTH 89°59'00" EAST, A DISTANCE OF 291.22 FEET TO THE POINT OF BEGINNING.

(ALSO KNOWN AS LOT 3, CITY OF PUYALLUP BOUNDARY LINE REVISION NO. P-18-0145, RECORDED UNDER AUDITOR'S FILE NO. 201905225002, RECORDS OF PIERCE COUNTY, WASHINGTON)

VICINITY MAP



PROJECT DIRECTORY

OWNER:

BENAROYA COMPANY 9675 SE 36TH STREET, SUITE 115 MERCER ISLAND. WA 98040 **CONTACT: DAVE VRANIZAN** EMAIL: davev@benaroya.com TEL: (425) 440-6711 CELL: (206) 619-5341

INTERIOR DESIGNER/PROJECT MANAGER:

MARSHALL DESIGN + MANAGEMENT 12400 SE 38TH #50766 BELLEVUE, WA 98105 **CONTACT: MIA MARSHALL** EMAIL: Mia@marshalldm.com TEL: (206) 890-1570

ARCHITECT

WJA DESIGN COLLABORATIVE 617 WESTERN AVENUE SEATTLE, WA 98104 **CONTACT: RYAN WHITE** EMAIL: rwhite@wja-dc.com TEL: (206) 946-9746

STRUCTURAL:

QUANTUM CONSULTING ENGINEERS 1511 THIRD AVENUE, SUITE 323 SEATTLE, WA 98103 **CONTACT: SCOTT TINKER** EMAIL: scotttinker@guantumce.com TEL: (206) 957-3900 DIRECT: (206) 957-3916

MECHANICAL

MACDONALD-MILLER FACILITY SOLUTIONS 2801 PACIFIC AVE. TACOMA. WA 98402 **CONTACT: STEVE FLINK** EMAIL: steve.flink@macmiller.com TEL: (253) 680-3172 CELL: (206) 396-8657

ELECTRICAL

EVERGREEN ELECTRIC 3849 1ST AVENUE SOUTH SEATTLE. WA 98134 CONTACT: MIKE MILLS EMAIL: mmills@evergreenps.net TEL: (206) 423-2421

FIRE ALARM:

ADT COMMERCIAL 21312 30TH DRIVE SE, SUITE 103 BOTHELL, WA 98021 CONTACT: KENT FOBIAN EMAIL: kentfobian@adt.com TEL: (425) 287-7729

FURNITURE AND SPECIALTY SYSTEMS:

WORKPOINTE (DEMOUNTABLE PARTITIONS) 9877 40TH AVE SOUTH SEATTLE, WA 98118 **CONTACT: CHAD ELSTROM** EMAIL: chad@workpointe.com TEL: (206) 390-6300

(FURNITURE) 1285 122ND AVE NE, FLOOR 2 BELLEVUE, WA 98005 **CONTACT: KAREN NELSON** EMAIL: Knelson@catalystactivation.com TEL: (253) 740-2754

CATALYST WORKPLACE ACTIVATION

ENVELOPE SUMMARY (EXISTING TO REMAIN)

BUILDING ENVELOPE WILL NOT BE ALTERED AS PART OF THIS PROJECT EXCEPT FOR ADDING A LAYER OF 5/8" GWB TO COVER ANY EXPOSED INSULATION AT EXTERIOR WALLS.

BUILDING ENVELOPE REQUIREMENTS AT TIME OF WORK:

2015 WASHINGTON STATE ENERGY CODE **CLIMATE ZONE 4C, PIERCE COUNTY, WA** ROOFS - INSULATION ENTIRELY ABOVE ROOF DECK

ROOFS - ATTIC & OTHER; INSULATION BELOW DECK & ATTIC VENTING WALLS - ABOVE GRADE WALLS - BELOW GRADE

FLOORS - OVER UNCONDITIONED SPACE SLAB-ON GRADE-FLOORS - UNHEATED SLAB-ON-GRADE-FLOORS - HEATED

OPAQUE DOORS - SWINGING (INSULATED HM)

VERTICAL FENESTRATION -30% MAX. OF ABOVE GRADE WALL

METAL FRAMING ENTRANCE DOOR METAL FRAMING - FIXED (INCLUDES CURTAIN WALL & STOREFRONT) **NON-METAL FRAMING - ALL**

VERTICAL FENESTRATION

MINIMUM INSULATION R-VALUES

N/A R-13 + R-10 CI R-10 FOR 24" BELOW

ASSEMBLY MAX, U-FACTORS

U-0.60 U-0.38

U-0.37

ASSEMBLY MAX. SHGC

CODE COMPLIANCE

FIRE RESISTANCE RATING REQUIREMENTS FOR BUILDING ELEMENTS

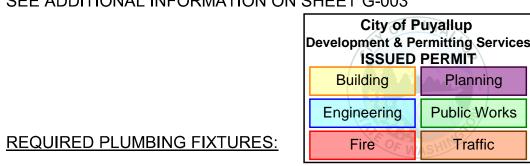
STRUCTURAL FRAME **BEARING WALLS EXT BEARING WALLS INT** NON-BEARING WALLS & PARTITIONS INTERIOR FLOOR CONSTRUCTION **ROOF CONSTRUCTION**

FIRE RESISTANCE RATING FOR EXTERIOR WALLS BASED ON FIRE SEPARATION DISTANCE (TABLE 602) - ALL EXISTING

FIRE SEPARATION DISTANCE < 5 FT 1 HOUR FIRE SEPARATION DISTANCE 5 TO < 10 FT 1 HOUR FIRE SEPARATION DISTANCE 10 TO < 30 FT NON RATED

*NOTE:THE EXISTING BUILDING AREA LOCATED ON GRIDS 1-6 WERE FORMALLY DESIGNATED AS AN "A" (ASSEMBLY) OCCUPANCY WITH AN ASSOCIATED BUILDING AREA SEPARATION WALL. A MINIMAL PORTION OF THE AREA SEPARATION WALL WILL BE DEMOLISHED UNDER THIS WORK. THE NEW WALLS INSTALLED IN THOSE DEMOLISHED AREAS WILL CARRY A 1-HR RATING. THE PROPOSED BUILDING OCCUPANCY THROUGHOUT (BOTH FLOORS) WILL BE, AND IS, "B" (OFFICE)

SEE ADDITIONAL INFORMATION ON SHEET G-003



376 OCCUPANTS / 2 = 188 MEN, 188 WOMEN

WATER CLOSETS REQUIRED: 4 MEN, 4 WOMEN WATER CLOSETS PROVIDED: 3 MEN, 5 WOMEN, 4 UNISEX (12 TOTAL) URINALS PROVIDED: 2

LAVATORIES REQUIRED: 4 MEN, 4 WOMEN LAVATORIES PROVIDED: 2 MEN, 2 WOMEN, 4 UNISEX (8 TOTAL)

DRINKING FOUNTAINS REQUIRED: 4 DRINKING FOUNTAINS PROVIDED: *4

*NOTE: TWO DRINKING FOUNTAINS WILL BE PROVIDED AS PART OF THIS PROJECT. THERE ARE TWO EXISTING DRINKING FOUNTAINS IN THE BUILDING LOBBY. PER IBC SECTION 2902.5 DRINKING FOUNTAINS, "DRINKING FOUNTAINS SHALL NOT BE REQUIRED TO BE LOCATED IN INDIVIDUAL TENANT SPACES PROVIDED THAT PUBLIC DRINKING FOUNTAINS ARE LOCATED WITHIN A DISTANCE OF TRAVEL OF 500 FEET OF THE MOST REMOTE LOCATION IN THE TENANT SPACE AND NOT MORE THAN ONE STORY ABOVE OR BELOW THE TENANT SPACE." THE ADDITIONAL 2 DRINKING FOUNTAINS IN THE BUILDING LOBBY ARE LOCATED UNDER 350 FEET AWAY.

(TABLE 601) - TYPE II-B

NON RATED NON RATED

NON RATED * NON RATED NON RATED NON RATED

APPROVED See permit for additional requirements. **JMontgomery** 03/21/2023 2:59:27 PM

City of Puyallup

THE APPROVED CONSTRUCTION PLANS, DOCUMENTS AND ALL ENGINEERING MUST BE POSTED ON THE JOB AT ALL INSPECTIONS IN A VISIBLE AND READILY

PERMITEE ON SITE FOR INSPECTION

ACCESSIBLE LOCATION. FULL SIZED LEDGIBLE COLOR PLANS ARE REQUIRED TO BE PROVIDED BY THE

TP0.01 SCHEDULES PLUMBING TP0.02 SCHEDULES PLUMBING FOUNDATION PARTIAL PLAN PLUMBING DP1.01 FOUNDATION PARTIAL DEMO PLAN PLUMBING TP2.01 1ST FLOOR PARTIAL PLAN PLUMBING DP2.01 1ST FLOOR PARTIAL DEMO PLAN PLUMBING TP2.02 2ND FLOOR PARTIAL PLAN PLUMBING DP2.02 2ND FLOOR PARTIAL DEMO PLAN PLUMBING RISERS & DIAGRAMS PLUMBING

SHEET INDEX

LIFE SAFETY EGRESS PLAN

GENÉRAL STRUCTURAL NOTES

TYPICAL LIGHT GAUGE DETAILS

ACCESSIBILITY DIAGRAMS

ACCESSIBILITY DIAGRAMS

FIRST FLOOR PLAN

ENLARGED EAST PLAN

ENLARGED WEST PLAN

ENLARGED EAST RCP

ENLARGED WEST RCP

SEISMIC CEILING DETAILS

SEISMIC CEILING DETAILS

INTERIOR ELEVATIONS

INTERIOR ELEVATIONS

FINISH SCHEDULE

SCHEDULES HVAC

SCHEDULES HVAC

DETAILS HVAC

SYMBOLS & LEGEND

WIRING INFORMATION

WALL AND CEILING TYPES LEGEND

WINDOW SCHEDULE AND LEGEND

CASEWORK SECTIONS AND DETAILS

CASEWORK SECTIONS AND DETAILS

WIRING DETAILS. RISER DIAGRAM CALCS

1ST FLOOR PARTIAL DEMO PLAN HVAC

FIRE ALARM FLOOR PLAN LAYOUT

1ST FLOOR PARTIAL PLAN HVAC

2ND FLOOR PARTIAL PLAN HVAC

ROOF PARTIAL PLAN HVAC

DOOR SCHEDULE AND LEGEND

REFLECTED CEILING PLAN

FIRST FLOOR DEMOLITION PLAN

FURNITURE PLAN - FOR REFERENCE ONLY

PENLARGED RESTROOM PLAN AND MOUNTING

FINISHED FLOOR PLAN AND EQUIPMENTLIST

ARCHITECTURAL GENERAL NOTES &

Sheet Name

Sheet Number

01 GENERAL

S2.0

S3.0

S4.0

A-003

AD-101

A-101

A-112√

A-502

A-503

A-601

A-602

I-100

I-400

I-401

I-500

I-501

I-600

FA-0.0

FA-0.1

FA-0.2

TM0.02

TM2.01

TM2.03

TM6.01

07 PLUMBING

04 INTERIORS

05 FIRE ALARM

06 MECHANICAL

TM0.01S | SITE PLAN

02 STRUCTURAL

03 ARCHITECTURE/

COVER SHEET

LEGENDS

HEIGHTS

DETAILS

CODE ANALYSIS

PARTIAL FLOOR PLAN

TP4.01 TP6.02 DETAILS PLUMBING 08 ELECTRICAL

E0.00 COVER SHEET SYMBOLS & ABBREVIATIONS E0.01 LIGHTING CALCULATIONS E0.02 ELETRICAL SITE PLAN ELECTRICAL SITE DETAILS E1.01 1ST FLOOR LIGHTING PLAN E2.01 1ST FLOOR POWER PLAN 1ST FLOOR MECHANICAL POWER PLAN ONE-LINE DIAGRAM E6.01 PANEL SCHEDULES

PANEL SCHEDULES

NEW

REVISIONS - REPLACE PLANS WITH PREIOUSLY APPROVED PLANS OR ADD NEW SHEET WHEN

NO WORK THIS AREA



LOCATION

DESIGNER

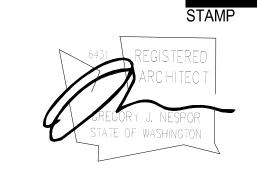
Benaroya

BENAROYA SOUTH HILL BUSINESS AND TECHNOLOGY CENTER 1015 39TH AVE SE PUYALLUP, WA 98374



CENTRAL PIERCE FIRE AND RESCUE 1015 39TH AVE SE, SUITE 120 PUYALLUP. WA 98374

design collaborative WJA DESIGN-COLLABORATIVE 617 WESTERN AVE SEATTLE, WA 98104




ISSUE DATE 02/17/2023 DRAWN BY: WJA **CHECKED BY:** WJA

3 | 03/08/23 | POST CD'S REVISIONS

REVISION LIST NO. DATE DESCRIPTION 01/30/23 PERMIT SET 02/17/23 | 100% CONSTRUCTION DOCS

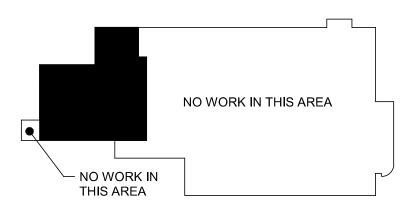KEY PLAN



COVER SHEET

SHEET NUMBER


ALLOWABLE BUILDING AREAS (EXISTING TO REMAIN AND WILL NOT BE ALTERED)

*ALLOWABLE AREA CALCULATIONS BASED ON 2012 IBC, CHAPTER !

CONSTRUCTION TYPE	IIB	
ALLOWABLE NUMBER OF STORIES	4	
MAXIMUM FLOOR AREA (MEASURED)	90,738	
IBC 2012 REFERENCE	ALLOWABLE AREA	CALCULATED AREA
TABLE 503	23,000	
SECTION 506.3	46,000	23,000 x 200%
EQUATION 5-2	22,151	23,000 x 96.31%
TOTAL ALLOWABLE AREA PER FLOOR	91,151	(23,000 + 46,000 + 22,151)
EQUATION 5-2 VARIABLE	VALUE	CALCULATED AREA
F	1101.646 FEET	MEASUREMENT
P	1505.92 FEET	MEASUREMENT
W	*60	EQUATION 5-3 INCLUDING EXCEPTION
I_F (FRONTAGE INCREASE % VALUE)	0.960387	[(1101.646/1505.92) - 0.25]x[60/2]
*ALL OF VALUE F IS OPEN FRONTAGE C	OF 60' OR GREATER W	/ITH ACCESS FROM A FIRE LANE

AREA OF WORK NO WORK THIS AREA

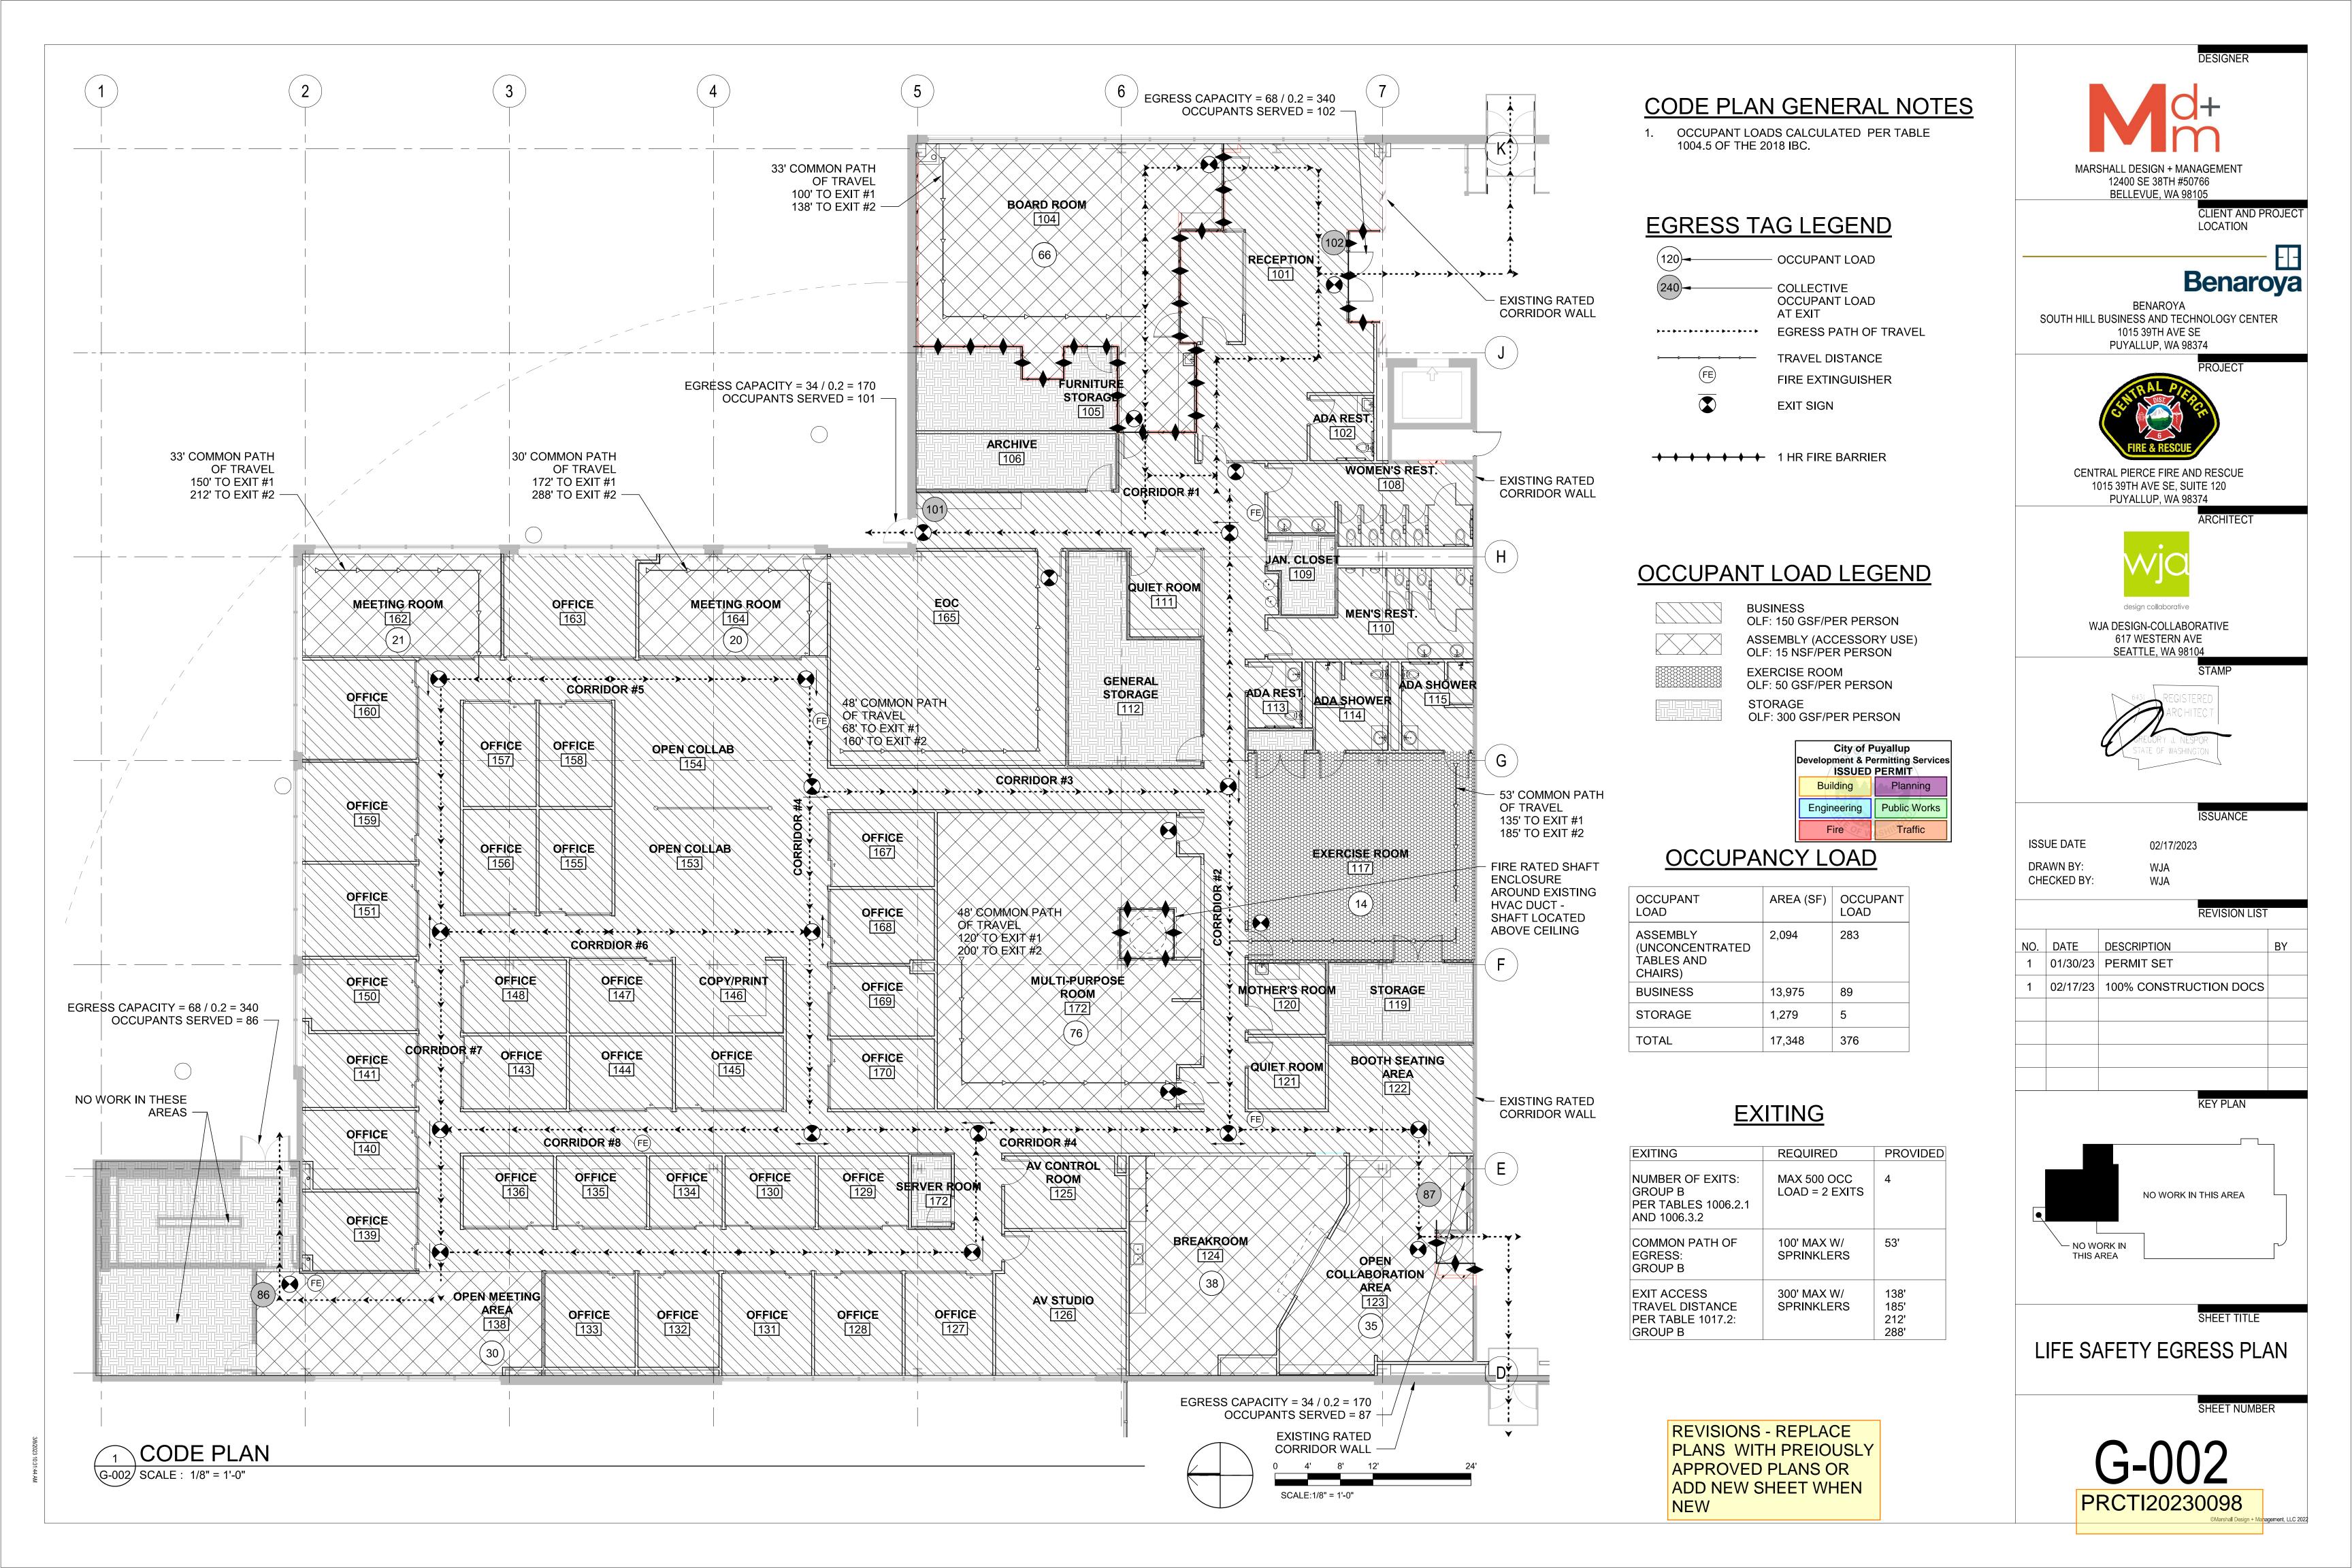KEY PLAN:



IBC CHAPTER 3 - USE AND OCCUPANCY CLASSIFICATION

302.1 CLASSIFICATION, GENERAL

THE PROPOSED BUILDING IS CLASSIFIED IN OCCUPANCY GROUPS A-3 (ASSEMBLY) AND B (BUSINESS) AND COMPLIES WITH IBC SECTION 508.4 FOR SEPARATED OCCUPANCIES.

303.1.2 SMALL ASSEMBLY SPACES

THE BUILDING COMPLIES WITH NOT HAVING TO CLASSIFY CERTAIN ROOMS AS ASSEMBLY OCCUPANCIES. THOSE ROOMS WITH AN OCCUPANT LOAD OF LESS THAN 50 PERSONS AND ACCESSORY TO ANOTHER OCCUPANCY SHALL BE CLASSIFIED AS A GROUP B OCCUPANCY OR AS PART OF THAT OCCUPANCY.

IBC CHAPTER 5 - GENERAL BUILDING HEIGHTS AND AREAS (EXISTING TO REMAIN AND NOT ALTERED)

THE PROPOSED BUILDING:

CONSISTS OF TYPE IIB CONSTRUCTION THROUGHOUT;

506.2 ALLOWABLE AREA DETERMINATION (EXISTING TO REMAIN AND NOT ALTERED)

508.2.3 ALLOWABLE BUILDING AREA

"AGGREGATE ACCESSORY OCCUPANCIES SHALL NOT OCCUPY MORE THAN 10 PERCENT OF THE FLOOR AREA OF THE STORY IN WHICH THEY ARE LOCATED AND SHALL NOT EXCEED THE TABULAR VALUES FOR NONSPRINKLERED BUILDINGS IN TABLE 506.2 FOR EACH ACCESSORY OCCUPANCY."

THE PROPOSED DESIGN IS PROVIDING A 1-HR SEPARATION AT BOARD ROOM 104. WITH THIS SEPARATION, THE MULTI PURPOSE ROOM 172 BECOMES LOWER THAN THE 10 PERCENT THRESHOLD FOR THE ENTIRE SPACE AND THEREFORE DOES NOT REQUIRE A 1-HR SEPARATION.

508.4 SEPARATED OCCUPANCIES, ALLOWABLE BUILDING AREA AND HEIGHT

THE BUILDING COMPLIES WITH SECTION 508.4 FOR SEPARATED OCCUPANCIES. IT CONTAINS GROUP A-3, GROUP B, AND GROUP S-1 OCCUPANCIES.

IBC CHAPTER 6 - TYPES OF CONSTRUCTION

601 GENERAL

THE PROPOSED BUILDING IS CLASSIFIED IN CONSTRUCTION TYPE IIB. BUILDING ELEMENTS, INCLUDING EXTERIOR WALLS, SHALL BE NONCOMBUSTIBLE AND SHALL HAVE THE FIRE-RESISTANCE RATING SHOWN IN THE FOLLOWING TABLE:

BUILDING ELEMENT	REQUIRED FIRE-RESISTANCE RATING FOR TYPE IIB CONSTRUCTION
STRUCTURAL FRAME	0
BEARING WALLS, EXTERIOR	0
BEARING WALLS, INTERIOR	0
NONBEARING WALLS, EXTERIOR	FIRE SEPARATION DISTANCE < 10 = 1 HOUR FIRE SEPARATION DISTANCE ≥ 10 = 0 HOURS
NONBEARING WALLS & PARTITIONS, INTERIOR	0
FLOOR CONSTRUCTION, INCLUDING SUPPORTING BEAMS AND JOISTS	0
ROOF CONSTRUCTION, INCLUDING SUPPORTING BEAMS AND JOISTS	0

603.1 COMBUSTIBLE MATERIALS IN TYPES I AND II CONSTRUCTION - ALLOWABLE MATERIALS

COMBUSTIBLE MATERIALS ARE PERMITTED IN BUILDINGS OF TYPE II CONSTRUCTION IN THE APPLICATIONS LISTED IN THIS SECTION. THESE APPLICATIONS INCLUDE, BUT ARE NOT LIMITED TO, THE FOLLOWING: FIRE-RETARDANT-TREATED WOOD IN LIMITED APPLICATIONS, THERMAL AND ACOUSTICAL INSULATION, FOAM PLASTICS, ROOF COVERINGS, INTERIOR FINISHES, BLOCKING, AND MASTICS AND CAULKING.

IBC CHAPTER 7 - FIRE AND SMOKE PROTECTION FEATURES

THE FOLLOWING TABLE SUMMARIZES THE REQUIREMENTS FOR FIRE-RESISTANCE-RATED BUILDING ELEMENTS:

BUILDING ELEMENT	CODE REFERENCE	REQUIRED FIRE- RESISTANCE RATING	PROVIDED FIRE- RESISTANCE RATING	REQUIRED FIRE DOOR RATING	PROVIDED FIRE DOOR RATING
OCCUPANCY 'A' - OCCUPANCY 'S'	IBC TABLE 508.4	1 HOUR WITH AUTOMATIC EXTINGUISHING SYSTEM	1 HOUR	45 MIN	45 MIN
OCCUPANCY 'A' - OCCUPANCY 'B'	IBC TABLE 508.4	1 HOUR WITH AUTOMATIC EXTINGUISHING SYSTEM	1 HOUR	45 MIN	0 HOURS
OCCUPANCY 'B' - OCCUPANCY 'S'	IBC TABLE 508.4	0 HOURS	0 HOURS	0 HOURS	0 HOURS

CHAPTER 10 - MEANS OF EGRESS

CODE PROVISION	CODE SECTION	ALLOWED / REQUIRED	PROPOSED
EXIT ACCESS CORRIDOR SEPARATION	TABLE 1020.1	0 HOURS	0 HOURS
OCCUPANT LOAD	TABLE 1004.5	FLOOR AREA DIVIDED BY OCCUPANT LOAD FACTOR FOR ITS USE	OCCUPANT LOADS ARE SHOWN ON SHEET G-002
EGRESS CAPACITY	1005.3.2	0.2 INCHES PER PERSON	EGRESS CAPACITIES ARE SHOWN ON SHEET G-002
NUMBER OF MEANS OF EGRESS	1006.2	TWO	FOUR
EXIT ACCESS	1016.2	EXIT ACCESS IS PERMITTED THROUGH ADJOINING/INTERVENING ROOMS	EXITING THROUGH MAIN LOBBY AND EGRESS STAIR

City of Puyallup
Development & Permitting Services
ISSUED PERMIT
Building Planning
Engineering Public Works
Fire Traffic

REVISIONS - REPLACE PLANS WITH PREIOUSLY APPROVED PLANS OR ADD NEW SHEET WHEN NEW MARSHALL DESIGN + MANAGEMENT
12400 SE 38TH #50766
BELLEVUE, WA 98105

Benaroya

LOCATION

CLIENT AND PROJECT

BENAROYA SOUTH HILL BUSINESS AND TECHNOLOGY CENTER 1015 39TH AVE SE PUYALLUP, WA 98374



1015 39TH AVE SE, SUITE 120 PUYALLUP, WA 98374 ARCHITE



WJA DESIGN-COLLABORATIVE 617 WESTERN AVE SEATTLE, WA 98104



ISSUANCE

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NO.	DATE	DESCRIPTION	BY
1	01/30/23	PERMIT SET	
1	02/17/23	100% CONSTRUCTION DOCS	

KEY PLAN

SHEET TITI

CODE ANALYSIS

SHEET NUMBER

G-003 PRCTI20230098

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CRITERIA

I. <u>ALL MATERIALS, WORKMANSHIP, DESIGN, AND CONSTRUCTION</u> SHALL CONFORM TO THE DRAWINGS, SPECIFICATIONS, THE 2018 EDITION OF THE INTERNATIONAL BUILDING CODE (IBC).

2. <u>DESIGN LOADING CRITERIA</u>
PARTITION LIVE LOAD HORIZONTAL

5 PSF

- 3. <u>STRUCTURAL DRAWINGS</u> SHALL BE USED IN CONJUNCTION WITH ARCHITECTURAL DRAWINGS FOR BIDDING AND CONSTRUCTION. CONTRACTOR SHALL VERIFY DIMENSIONS AND CONDITIONS FOR COMPATIBILITY AND SHALL NOTIFY ARCHITECT OF ANY DISCREPANCIES PRIOR TO CONSTRUCTION.
- 4. <u>CONTRACTOR</u> SHALL VERIFY ALL EXISTING DIMENSIONS, MEMBER SIZES, AND CONDITIONS PRIOR TO COMMENCING ANY WORK. ALL DIMENSIONS OF EXISTING CONSTRUCTION SHOWN ON THE DRAWINGS ARE INTENDED AS GUIDELINES ONLY AND MUST BE VERIFIED.
- 5. <u>CONTRACTOR</u> SHALL PROVIDE TEMPORARY BRACING FOR THE STRUCTURE AND STRUCTURAL COMPONENTS UNTIL ALL FINAL CONNECTIONS HAVE BEEN COMPLETED IN ACCORDANCE WITH THE PLANS.
- 6. <u>CONTRACTOR</u> SHALL BE RESPONSIBLE FOR ALL SAFETY PRECAUTIONS AND THE METHODS, TECHNIQUES, SEQUENCES OR PROCEDURES REQUIRED TO PERFORM THEIR WORK. THE STRUCTURAL ENGINEER HAS NO OVERALL SUPERVISORY AUTHORITY OR ACTUAL AND/OR DIRECT RESPONSIBILITY FOR THE SPECIFIC WORKING CONDITIONS AT THE SITE AND/OR FOR ANY HAZARDS RESULTING FROM THE ACTIONS OF ANY TRADE CONTRACTOR. THE STRUCTURAL ENGINEER HAS NO DUTY TO INSPECT, SUPERVISE, NOTE, CORRECT, OR REPORT ANY HEALTH OR SAFETY DEFICIENCIES OF THE OWNER, CONTRACTORS, OR OTHER ENTITIES OR PERSONS AT THE PROJECT SITE.
- CONTRACTOR-INITIATED CHANGES SHALL BE SUBMITTED IN WRITING TO THE ARCHITECT AND STRUCTURAL ENGINEER
 FOR APPROVAL PRIOR TO FABRICATION OR CONSTRUCTION. CHANGES SHOWN ON SHOP DRAWINGS ONLY WILL NOT
 SATISFY THIS REQUIREMENT.
- 8. <u>DRAWINGS</u> INDICATE GENERAL AND TYPICAL DETAILS OF CONSTRUCTION. WHERE CONDITIONS ARE NOT SPECIFICALLY INDICATED BUT ARE OF SIMILAR CHARACTER TO DETAILS SHOWN, SIMILAR DETAILS OF CONSTRUCTION SHALL BE USED, SUBJECT TO REVIEW AND APPROVAL BY THE ARCHITECT AND THE STRUCTURAL ENGINEER. WHERE INFORMATION ON THE DRAWINGS IS IN CONFLICT WITH THE SPECIFICATIONS, THE MORE STRINGENT SHALL APPLY, SUBJECT TO REVIEW AND APPROVAL BY THE ARCHITECT AND THE STRUCTURAL ENGINEER. DO NOT SCALE THE DRAWINGS.
- 9. <u>ALL STRUCTURAL SYSTEMS</u> WHICH ARE COMPOSED OF FIELD ERECTED COMPONENTS SHALL BE SUPERVISED BY THE SUPPLIER DURING MANUFACTURING, DELIVERY, HANDLING, STORAGE AND ERECTION IN ACCORDANCE WITH INSTRUCTIONS PREPARED BY THE SUPPLIER.
- 10. <u>SHOP DRAWINGS</u> STRUCTURAL STEEL SHALL BE SUBMITTED TO THE ARCHITECT AND STRUCTURAL ENGINEER FOR REVIEW PRIOR TO FABRICATION OF THESE ITEMS.
- II. SHOP DRAWING REVIEW: DIMENSIONS AND QUANTITIES ARE NOT REVIEWED BY THE ENGINEER OF RECORD, AND THEREFORE MUST BE VERIFIED BY THE CONTRACTOR. CONTRACTOR SHALL REVIEW AND STAMP DRAWINGS PRIOR TO REVIEW BY ENGINEER OF RECORD. CONTRACTOR SHALL REVIEW DRAWINGS FOR CONFORMANCE WITH THE MEANS, METHODS, TECHNIQUES, SEQUENCES AND OPERATIONS OF CONSTRUCTION, AND ALL SAFETY PRECAUTIONS AND PROGRAMS INCIDENTAL THERETO. A MINIMUM OF TWO WEEKS SHALL BE ALLOWED FOR REVIEW.
- 12. SHOP DRAWING SUBMITTALS PROCESSED BY THE ENGINEER ARE NOT CHANGE ORDERS. THE PURPOSE OF SHOP DRAWING SUBMITTALS BY THE CONTRACTOR IS TO DEMONSTRATE TO THE ENGINEER THAT THE CONTRACTOR UNDERSTANDS THE DESIGN CONCEPT, BY INDICATING WHICH MATERIAL IS INTENDED TO BE FURNISHED AND INSTALLED AND BY DETAILING THE INTENDED FABRICATION AND INSTALLATION METHODS. IF DEVIATIONS, DISCREPANCIES, OR CONFLICTS BETWEEN SHOP DRAWING SUBMITTALS AND THE CONTRACT DOCUMENTS ARE DISCOVERED EITHER PRIOR TO OR AFTER SHOP DRAWING SUBMITTALS ARE PROCESSED BY THE ENGINEER, THE DESIGN DRAWINGS AND SPECIFICATIONS SHALL CONTROL AND SHALL BE FOLLOWED.
- 13. <u>SPECIAL INSPECTION</u>: STRUCTURAL STEEL FABRICATION AND ERECTION (INCLUDING FIELD WELDING), EXPANSION ANCHORS AND SCREW ANCHORS SHALL BE SUPERVISED IN ACCORDANCE WITH IBC SECTIONS 1704 & 1705 AND THE PROJECT SPECIFICATIONS BY A QUALIFIED TESTING AGENCY DESIGNATED BY THE OWNER. THE TESTING AGENCY SHALL SEND COPIES OF ALL STRUCTURAL TESTING AND INSPECTION REPORTS DIRECTLY TO THE OWNER, ARCHITECT, STRUCTURAL ENGINEER, CONTRACTOR AND BUILDING OFFICIAL. ANY MATERIALS WHICH FAIL TO MEET PROJECT SPECIFICATIONS SHALL BE BROUGHT TO THE ATTENTION OF THE ARCHITECT.

RENOVATION

14. DEMOLITION:

A. ALL NEW OPENINGS THROUGH EXISTING WALLS, SLABS AND BEAMS SHALL BE ACCOMPLISHED BY SAW CUTTING WHEREVER POSSIBLE.

B. VERIFY ALL EXISTING CONDITIONS AND LOCATION OF MEMBERS PRIOR TO CUTTING ANY OPENINGS.
C. SMALL ROUND OPENINGS SHALL BE ACCOMPLISHED BY CORE DRILLING, IF POSSIBLE.

D. WHERE NEW REINFORCING TERMINATES AT EXISTING CONCRETE, REBAR DOWELS EPOXIED INTO THE EXISTING CONCRETE SHALL BE PROVIDED TO MATCH HORIZONTAL REINFORCING, UNLESS OTHERWISE NOTED ON PLANS.

CONCRETE

15. <u>CONCRETE</u> SHALL BE MIXED, PROPORTIONED, CONVEYED AND PLACED IN ACCORDANCE WITH ACI 301. CONSTRUCTION TOLERANCES SHALL NOT EXCEED THOSE LISTED IN ACI IIT. CONCRETE SHALL ATTAIN A 28-DAY STRENGTH OF I'C = 2,500 PSI. MIX SHALL CONTAIN NOT LESS THAN 5-I/2 SACKS OF CEMENT PER CUBIC YARD AND SHALL BE PROPORTIONED TO PRODUCE A SLUMP OF 5" OR LESS (BEFORE THE ADDITION OF ADMIXTURES). THE WATER/CEMENT RATIO SHALL NOT EXCEED 0.45 FOR ALL SLABS.

THE MINIMUM AMOUNT OF CEMENT AND THE MAXIMUM SLUMP MAY BE CHANGED IF A CONCRETE PERFORMANCE MIX IS SUBMITTED TO THE STRUCTURAL ENGINEER AND THE BUILDING DEPARTMENT FOR APPROVAL TWO WEEKS PRIOR TO PLACING ANY CONCRETE. (THE W/C RATIO LIMITS STILL APPLY). THE PERFORMANCE MIX SHALL INCLUDE THE AMOUNTS OF CEMENT, CEMENTITIOUS MATERIAL, FINE AND COARSE AGGREGATE, WATER AND ADMIXTURES AS WELL AS THE WATER CEMENT RATIO, SLUMP, CONCRETE YIELD AND SUBSTANTIATING STRENGTH DATA IN ACCORDANCE WITH ACI 301. CHEMICAL ADMIXTURES AND FLY ASH SHALL CONFORM TO ASTM C494 AND C618 RESPECTIVELY. FLY ASH PERCENTAGE OF TOTAL CEMENTITIOUS MATERIAL SHALL NOT EXCEED 20%. THE USE OF A PERFORMANCE MIX REQUIRES BATCH PLANT INSPECTION, THE COST OF WHICH SHALL BE BROUGHT TO THE ATTENTION OF THE OWNER. REVIEW OF MIX SUBMITTALS BY THE ENGINEER OF RECORD INDICATES ONLY THAT INFORMATION PRESENTED CONFORMS GENERALLY TO CONTRACT DOCUMENTS. CONTRACTOR MAINTAINS FULL RESPONSIBILITY FOR SPECIFIED PERFORMANCE.

ALL CONCRETE WITH SURFACES EXPOSED TO STANDING WATER SHALL BE AIR-ENTRAINED WITH AN AIR-ENTRAINING AGENT CONFORMING TO ASTM C260. TOTAL AIR CONTENT FOR FROST-RESISTANT CONCRETE SHALL BE IN ACCORDANCE WITH ACI 318-14 TABLE 19.3.3.1. ALL CONCRETE TO RECEIVE A STEEL TROWELED FINISH SHALL NOT BE AIR-ENTRAINED.

- 16. REINFORCING STEEL SHALL CONFORM TO ASTM A615 (INCLUDING SUPPLEMENT SI), GRADE 60, Fy = 60,000 PSI.
- 17. <u>REINFORCING STEEL</u> SHALL BE DETAILED (INCLUDING HOOKS AND BENDS) IN ACCORDANCE WITH ACI 315 AND 318. LAP ALL CONTINUOUS REINFORCEMENT #5 AND SMALLER 60 BAR DIAMETERS, 2'-0" MINIMUM.
- 18. CONCRETE PROTECTION (COVER) FOR REINFORCING STEEL SHALL BE AS FOLLOWS:

FOOTINGS AND OTHER UNFORMED SURFACES CAST AGAINST EARTH

FORMED SURFACES EXPOSED TO EARTH (i.e. WALLS BELOW GROUND) OR WEATHER

SLABS

19. <u>NON-SHRINK GROUT</u> SHALL BE NON-METALLIC CONFORMING TO ASTM CIIOT AND BE FURNISHED BY AN APPROVED MANUFACTURER AND SHALL BE MIXED AND PLACED IN STRICT ACCORDANCE WITH THE MANUFACTURER'S PUBLISHED RECOMMENDATIONS. GROUT STRENGTH SHALL BE AT LEAST EQUAL TO THE MATERIAL ON WHICH IT IS PLACED (5000 PSI MINIMUM).

ANCHORAGE

- 20. EXPANSION BOLTS INTO CONCRETE SHALL BE "STRONG-BOLT 2 WEDGE ANCHOR", AS MANUFACTURED BY SIMPSON STRONG-TIE ANCHOR SYSTEMS. INSTALL IN STRICT ACCORDANCE WITH I.C.C. REPORT NO. ESR-3037 INCLUDING STANDARD EMBEDMENT REQUIREMENTS U.O.N. PROPOSED SUBSTITUTIONS SHALL BE SUBMITTED FOR REVIEW WITH I.C.C. OR IAPMO UES REPORTS INDICATING EQUIVALENT OR GREATER LOAD CAPACITIES. SPECIAL INSPECTION IS REQUIRED FOR ALL EXPANSION BOLT INSTALLATION.
- 21. <u>SCREW ANCHORS</u> INTO CONCRETE SHALL BE "TITEN HD", AS MANUFACTURED BY SIMPSON STRONG-TIE ANCHOR SYSTEMS. INSTALL IN STRICT ACCORDANCE WITH I.C.C. REPORT NO. ESR-2713 INCLUDING STANDARD EMBEDMENT REQUIREMENTS U.O.N. PROPOSED SUBSTITUTIONS SHALL BE SUBMITTED FOR REVIEW WITH I.C.C. OR IAPMO UES REPORTS INDICATING EQUIVALENT OR GREATER LOAD CAPACITIES. SPECIAL INSPECTION IS REQUIRED FOR ALL SCREW ANCHOR INSTALLATION.
- 22. <u>DRIVE PINS</u>, SHOT PINS AND OTHER POWDER-ACTUATED FASTENERS SHALL BE LOW VELOCITY TYPE FASTENERS AS MANUFACTURED BY HILTI CORPORATION. WHEN CALLED FOR IN THE DRAWINGS, PROVIDE THE APPROPRIATE FASTENER AS NOTED IN THE TABLE BELOW FOR EACH GIVEN APPLICATION. INSTALL IN STRICT ACCORDANCE WITH I.C.C. REPORTS NO. ESR-2269 FOR THE X-U FASTENERS AND ESR-2379 FOR THE X-CP FASTENERS. MINIMUM EMBEDMENT IN CONCRETE SHALL BE I" UNLESS OTHERWISE NOTED. MAINTAIN AT LEAST 3" TO NEAREST CONCRETE EDGE AND 4" CENTER TO CENTER SPACING. PROPOSED SUBSTITUTIONS SHALL BE SUBMITTED FOR REVIEW WITH I.C.C. OR IAPMO UES REPORTS INDICATING EQUIVALENT OR GREATER LOAD CAPACITIES.

ALLOWABLE APPLICATION	ALLOWABLE FASTENER TYPE	SHEAR CAPACITY (LBS) TENSION CAPACITY (LBS)
LIGHT GAUGE STEEL 33 MILS (20 GA.) MIN. TO CONCRETE (2000 PSI MIN.)	X-U 27 P8 515	190	165

23. <u>EPOXY-GROUTED ITEMS</u> (THREADED RODS OR REINFORCING BAR) INTO CONCRETE SHALL BE INSTALLED USING "SET-3G" ADHESIVE ANCHOR AS MANUFACTURED BY SIMPSON STRONG-TIE ANCHOR SYSTEMS. INSTALL IN STRICT ACCORDANCE WITH I.C.C. REPORT NO. ESR-4057, INCLUDING STANDARD EMBEDMENT REQUIREMENTS U.O.N. PROPOSED SUBSTITUTIONS SHALL BE SUBMITTED FOR REVIEW WITH I.C.C. OR IAPMO UES REPORTS INDICATING EQUIVALENT OR GREATER LOAD CAPACITIES. SPECIAL INSPECTION OF INSTALLATION IS REQUIRED.

STEEL

- 24. <u>STRUCTURAL STEEL DESIGN, FABRICATION, AND ERECTION</u> SHALL BE BASED ON THE LATEST EDITIONS OF THE A.I.S.C. SPECIFICATIONS AND CODES:
 - A. AISC STEEL CONSTRUCTION MANUAL, 15TH EDITION
 - B. AISC 303-16 CODE OF STANDARD PRACTICE FOR STEEL BUILDINGS AND BRIDGES.
- 25. STRUCTURAL STEEL, WIDE FLANGE (W AND WT) SHAPES SHALL CONFORM TO ASTM A992, Fy = 50 KSI; ALL OTHER ROLLED SHAPES SHALL CONFORM TO ASTM A36, Fy = 36 KSI. STRUCTURAL TUBING SHALL CONFORM TO ASTM A500, GRADE C, Fy = 50 KSI. CONNECTION BOLTS SHALL CONFORM TO ASTM FI554 GRADE 36, Fy = 36 KSI.

SUBSTITUTION OF MEMBER SIZES OR STEEL GRADE SHALL NOT BE ALLOWED WITHOUT PRIOR APPROVAL OF THE ENGINEER ALL OTHER STEEL SHALL HAVE ONE COAT OF APPROVED SHOP PAINT.

ALL MEMBERS ARE TO BE ERECTED WITH THE NATURAL MILL CAMBER OR INDUCED CAMBER UP, UNLESS OTHERWISE NOTED ON THE DRAWINGS. BEAM CAMBER ON THE DRAWINGS IS THE UPWARD CAMBER REQUIRED IN THE BEAM AS DELIVERED TO THE JOBSITE. CONTRACTOR TO CONSIDER CAMBER LOSS, IF ANY, DUE TO SHIPPING AND HANDLING.

THE CONTRACTOR SHALL BE RESPONSIBLE FOR ALL ERECTION AIDS AND JOINT PREPARATIONS THAT INCLUDE, BUT ARE NOT LIMITED TO, ERECTION ANGLES, LIFT HOLES, AND OTHER AIDS, WELDING PROCEDURES, REQUIRED ROOT OPENINGS, ROOT FACE DIMENSIONS, GROOVE ANGLES, BACKING BARS, COPES, SURFACE ROUGHNESS VALUES AND UNEQUAL PARTS.

- 26. <u>ALL A307 CONNECTION BOLTS</u> SHALL BE PROVIDED WITH LOCK WASHERS UNDER NUTS OR SELF-LOCKING NUTS. ALL BOLT HOLES SHALL BE STANDARD SIZE UNLESS OTHERWISE NOTED.
- 27. <u>ALL WELDING</u> SHALL BE IN CONFORMANCE WITH A.I.S.C. AND A.W.S. STANDARDS AND SHALL BE PERFORMED BY W.A.B.O. CERTIFIED WELDERS USING ETO XX ELECTRODES. ONLY PREQUALIFIED WELDS (AS DEFINED BY A.W.S.) SHALL BE USED. WELDING WITHIN 4" OF COLD BENDS IN REINFORCING STEEL IS NOT PERMITTED. SEE REINFORCING NOTE FOR MATERIAL REQUIREMENTS OF WELDED BARS. ALL WELDING SHALL BE PERFORMED BY WELDERS WITH AWS / W.A.B.O. CERTIFICATION WITH THE MATERIAL AND METHOD REQUIRED.

SHOP DRAWINGS SHALL SHOW ALL WELDING WITH AWS A2.4 SYMBOLS. WELDS SHOWN ON DRAWINGS ARE MINIMUM SIZES. INCREASE WELD SIZE TO AWS MINIMUM SIZES BASED ON PLATE THICKNESS. MINIMUM WELDING SHALL BE 3/16-INCH. THE WELDS SHOWN ARE FOR THE FINAL CONNECTIONS. FIELD WELD ARROWS ARE SHOWN WHERE A FIELD WELD IS RECOMMENDED BY THE STRUCTURAL DESIGN; THE CONTRACTOR IS RESPONSIBLE FOR DETERMINING IF A WELD SHOULD BE SHOP OR FIELD WELDED IN ORDER TO FACILITATE THE STRUCTURAL STEEL DELIVERY AND ERECTION.

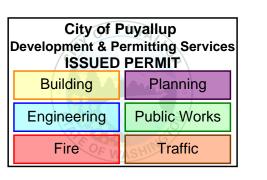
- 28. COLD-FORMED STEEL FRAMING NOTES THE FOLLOWING APPLY UNLESS OTHERWISE SHOWN ON THE PLANS:
 - A. <u>COLD-FORMED STEEL FRAMING MEMBERS</u> SHALL BE OF THE SHAPE, SIZE, AND GAUGE SHOWN ON THE PLANS. ALL FRAMING MEMBERS SHALL COMPLY WITH I.C.C. REPORT NO. ESR-3064P. NOTATIONS ON THE DRAWINGS, RELATING TO MEMBER TYPES AND SIZES OR MISCELLANEOUS FRAMING ITEMS, REFER TO CATALOG NUMBERS OF MEMBERS MANUFACTURED BY THE STEEL STUD MANUFACTURERS ASSOCIATION (SSMA). PRODUCTS BY OTHER MANUFACTURERS MAY BE SUBSTITUTED FOR FRAMING SHOWN, PROVIDED THEY ARE EQUIVALENT IN SHAPE, SIZE, STIFFNESS, AND STRENGTH. ALTERNATE FRAMING SHALL BE SUBJECT TO REVIEW BY THE ARCHITECT AND STRUCTURAL ENGINEER PRIOR TO FABRICATION. ALL COLD-FORMED STEEL FRAMING SHALL CONFORM TO THE A.I.S.I. "SPECIFICATION FOR THE DESIGN OF COLD-FORMED STEEL STRUCTURAL MEMBERS."
 - B. MATERIAL:

. <u>MATENIAL:</u> METAL FRAMING SHALL BE GALVANIZED UNLESS OTHERWISE NOTED, CONFORMING AS FOLLOWS:

ASTM A653 SS GRADE 33

Fy = 33 KSI 43 AND 33 MIL

- C. <u>WELDING</u> OF COLD-FORMED METAL FRAMING SHALL CONFORM TO AWS DI.3 AND SHALL BE PERFORMED BY WELDERS QUALIFIED TO PRODUCE THE SPECIFIED CLASSES OF WELD.
- D. <u>MALL FRAMING</u>: ALL STUD WALLS SHOWN AND NOT OTHERWISE NOTED SHALL BE 3585125-43 @ 16" O.C. AT INTERIOR WALLS UP TO 16'-O" TALL AND 3585162-54 AT 16" O.C. AT INTERIOR WALLS UP TO 20'-O" TALL. TWO STUDS MINIMUM SHALL BE PROVIDED AT THE END OF ALL WALLS AND AT EACH SIDE OF ALL OPENINGS. PROVIDE CONTINUOUS FULL WIDTH BLOCKING AT 1/3 POINTS OF ALL STUD WALLS UNLESS NOTED OTHERWISE. MAXIMUM GAP BETWEEN STUD AND TRACK AT ANY POINT SHALL NOT EXCEED 1/16-INCH. NO SPLICES ARE PERMITTED IN STUDS
- ALL STUD WALLS SHALL HAVE THEIR BOTTOM TRACKS ATTACHED TO FRAMING BELOW WITH #8 SCREWS AT 16" O.C. OR ATTACHED TO CONCRETE WITH 5/32" DIAMETER DRIVE-PINS @ 16" O.C. UNLESS INDICATED OTHERWISE. INDIVIDUAL MEMBERS OF BUILT-UP POSTS SHALL BE WELDED OR SCREWED TO EACH OTHER IN ACCORDANCE WITH THE DETAILS. WHEN NOT OTHERWISE NOTED, PROVIDE GYPSUM WALLBOARD ON INTERIOR SURFACES AND GYPSUM SHEATHING ON EXTERIOR SURFACES SCREWED TO ALL STUDS, TOP AND BOTTOM TRACKS, AND BLOCKING WITH SCREWS AT 12" O.C. ALL SCREWS SHALL BE "GRABBER" TYPE FASTENERS COMPLYING WITH I.C.C. REPORT NO. ESR-1271 ALL SPECIFIED PNEUMATIC FASTENERS SHALL BE ET&F, COMPLYING WITH I.C.C. REPORT NO. ESR-1777 TRACK SECTIONS SHALL BE UNPUNCHED AND HAVE AT LEAST I" FLANGES AND MATCH STUD THICKNESS.



REVISIONS - REPLACE PLANS WITH PREIOUSLY APPROVED PLANS OR ADD NEW SHEET WHEN NEW

PRCTI20230098

PROJECT NAME

CENTRAL PIERCE FIRE AND RESCUE T.I.

PROJECT ADDRESS

1015 - 39TH AVENUE SE PUYALLUP. WA

BENAROYA

2/24/2023 2/17/2023 1/27/2023

DELTA 1 REVISIONS
CONSTRUCTION SET
PERMIT SUBMITTAL

T: 206-890-1570

No. Date Revision Description

REVISIONS CONSULTANTS

DESIGN ARCHITECT

MARSHALL DESIGN +
MANAGEMENT

STRUCTURAL ENGINEER
QUANTUM CONSULTING

QUANTUM CONSULTING
ENGINEERS
1511 THIRD AVE, SUITE 323
SEATTLE, WA 98101
T: 206-957-3900

MECHANICAL/ ELECTRICAL ENGINEER

LIFE SAFETY CODE CONSULTANT

INTERIOR DESIGN

LANDSCAPE ARCHITECT

DRAWING STATUS **REVISIONS**

Discrepancies must be reported to the Architect before proceeding. Only figured dimensions are to be used.


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DRAWING TITLE

GENERAL STRUCTURAL NOTES

DRAWN
SC
MDW

SCALE
DATE
2/23/2023

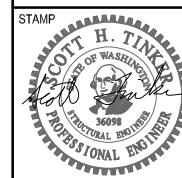REVISION NO.

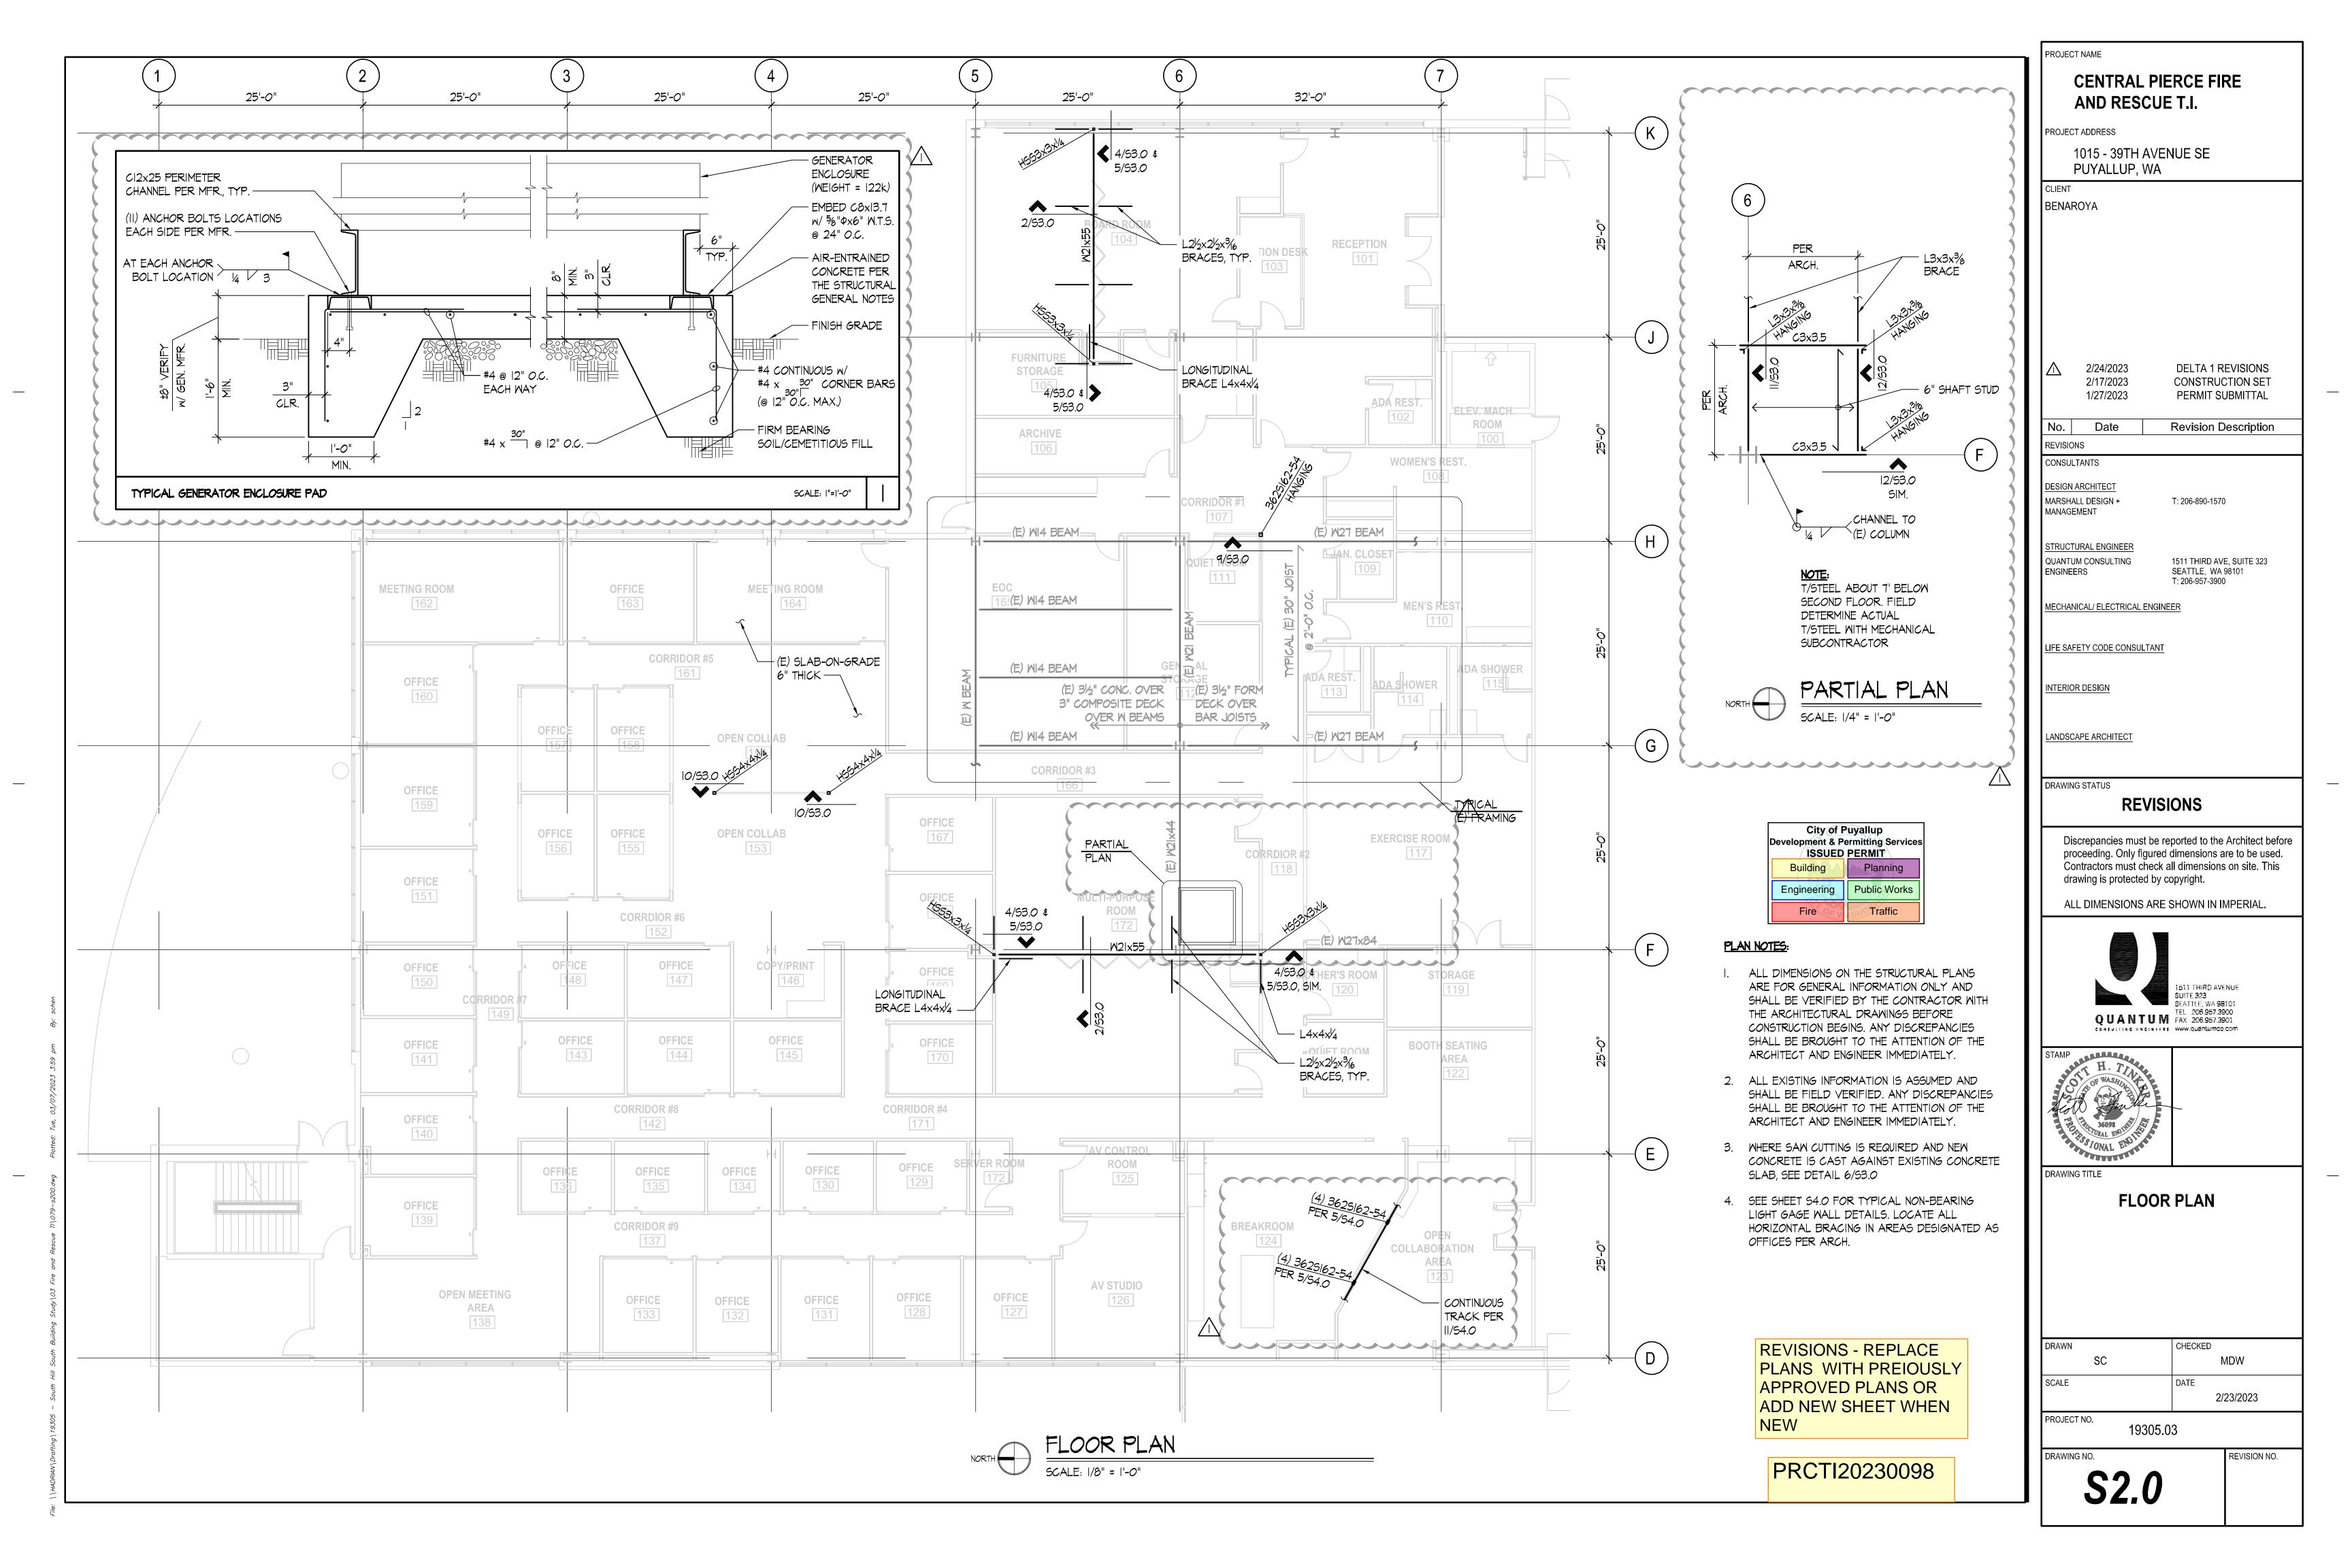
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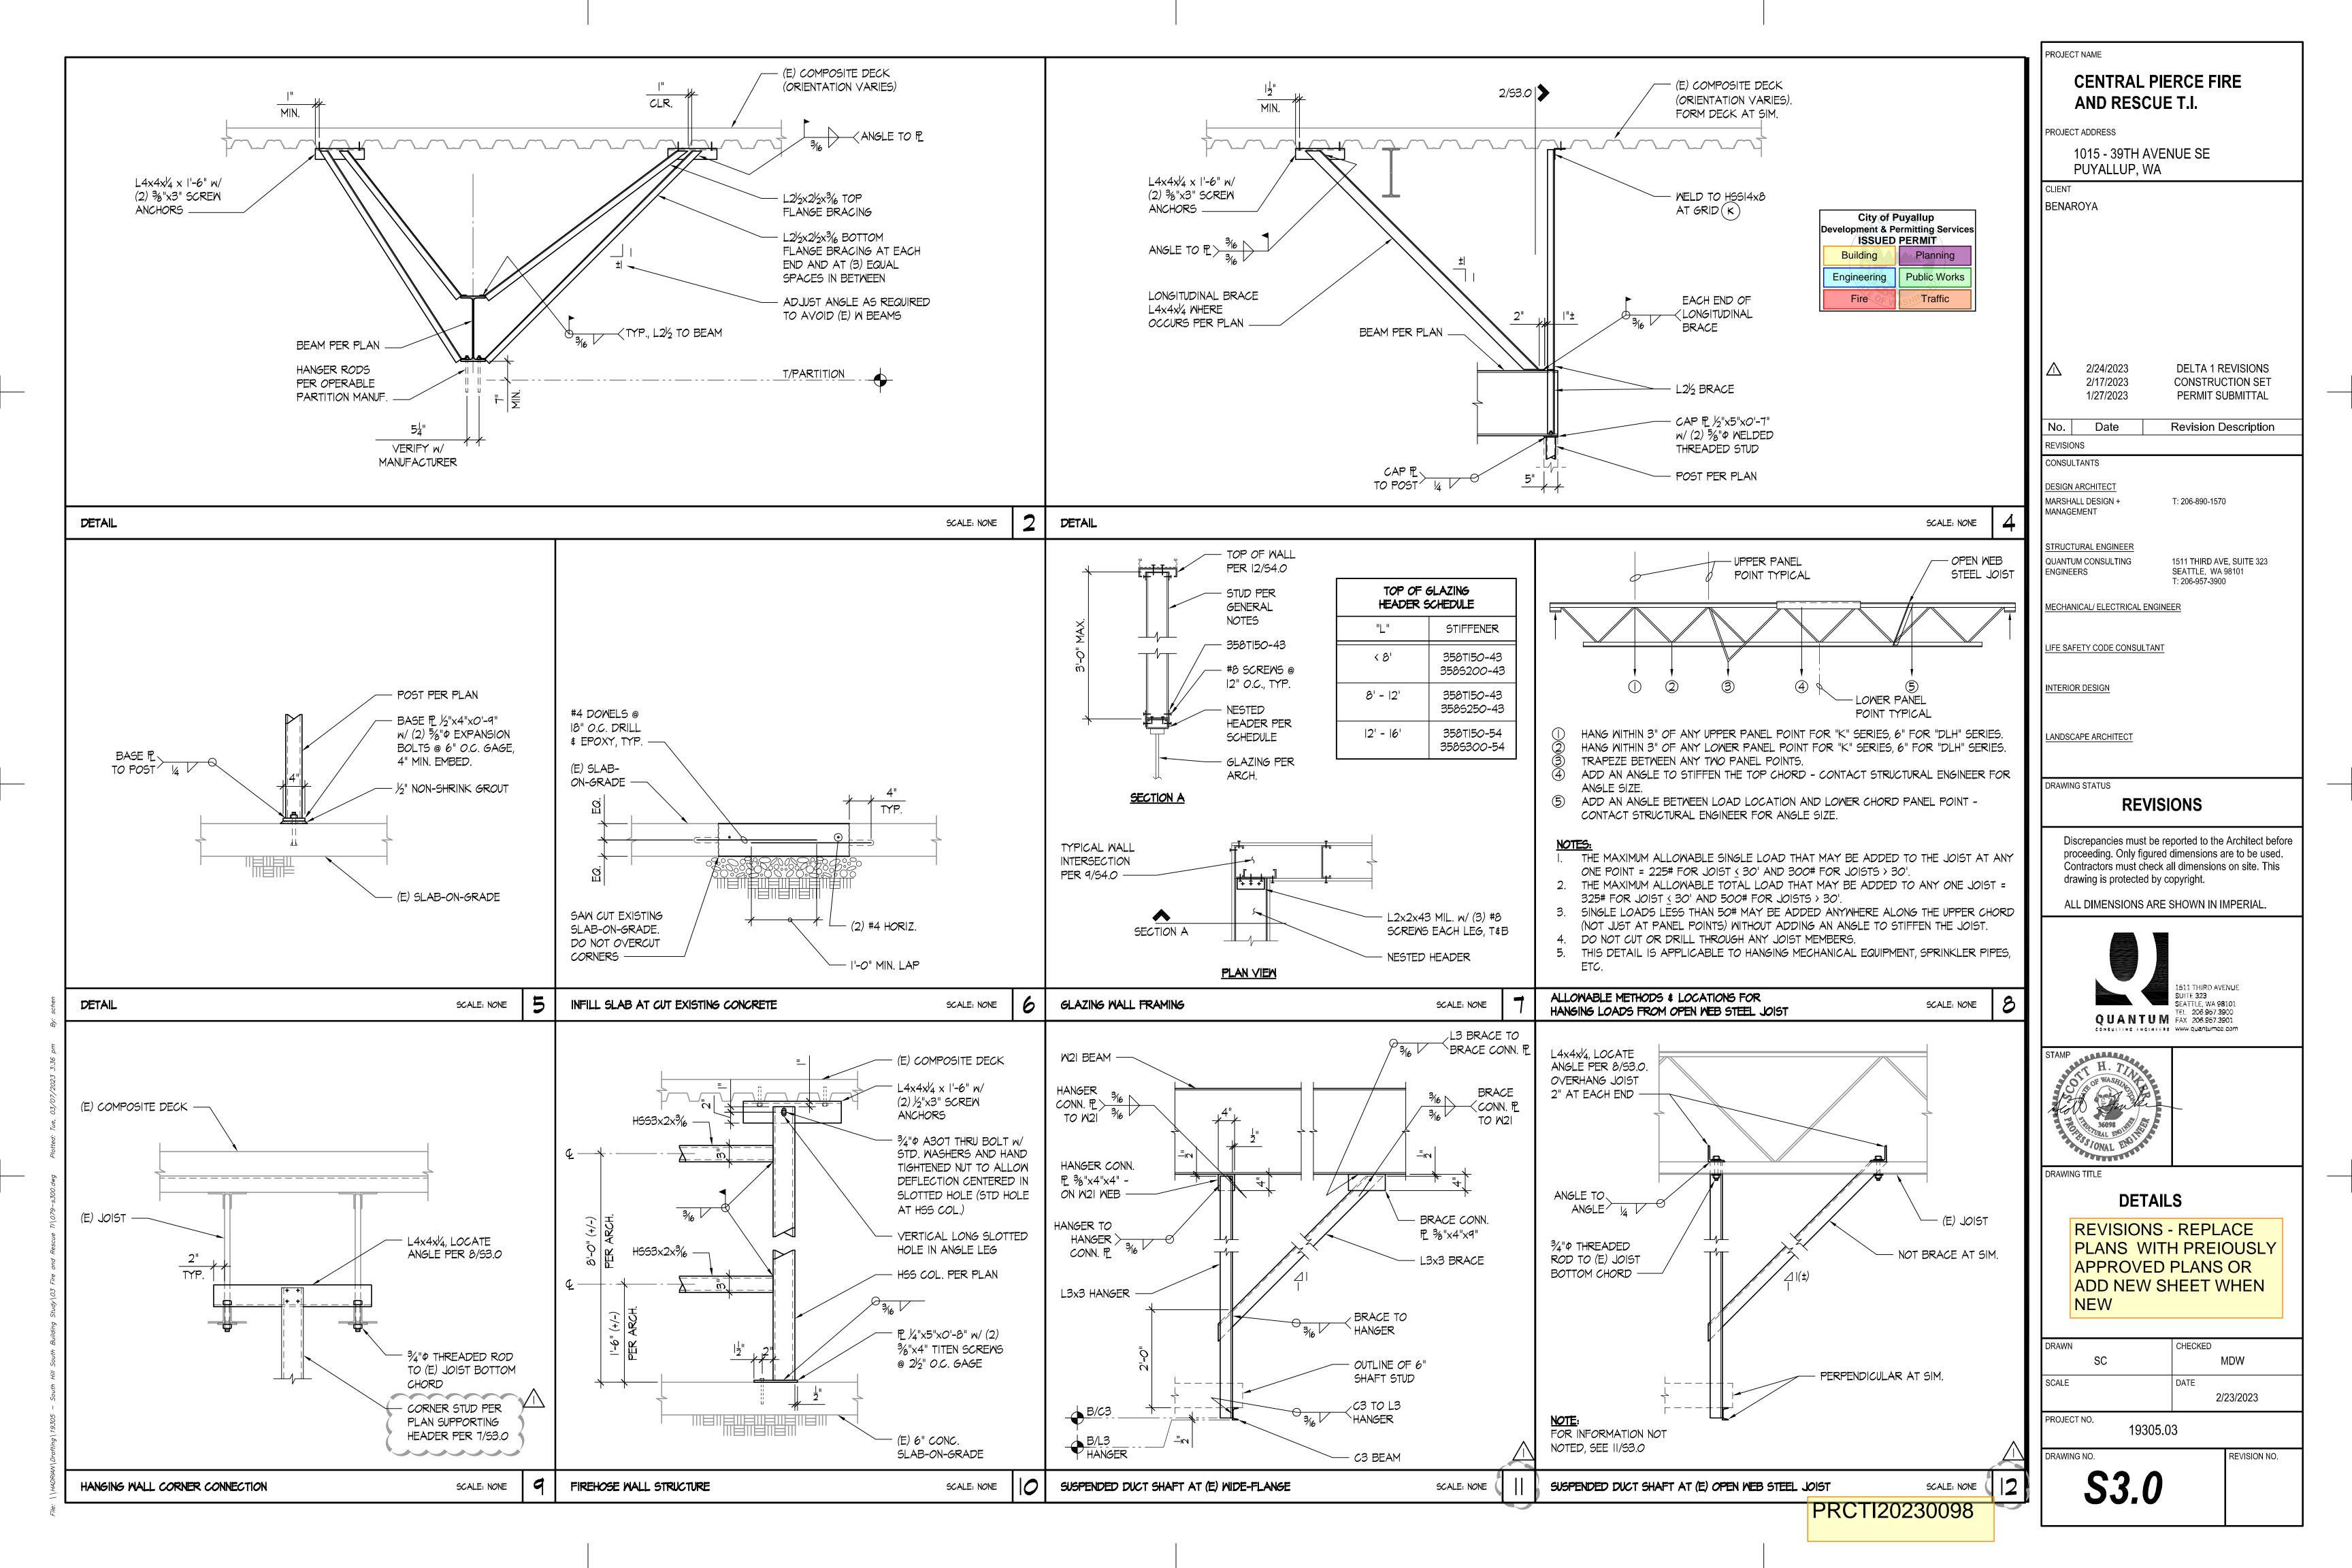
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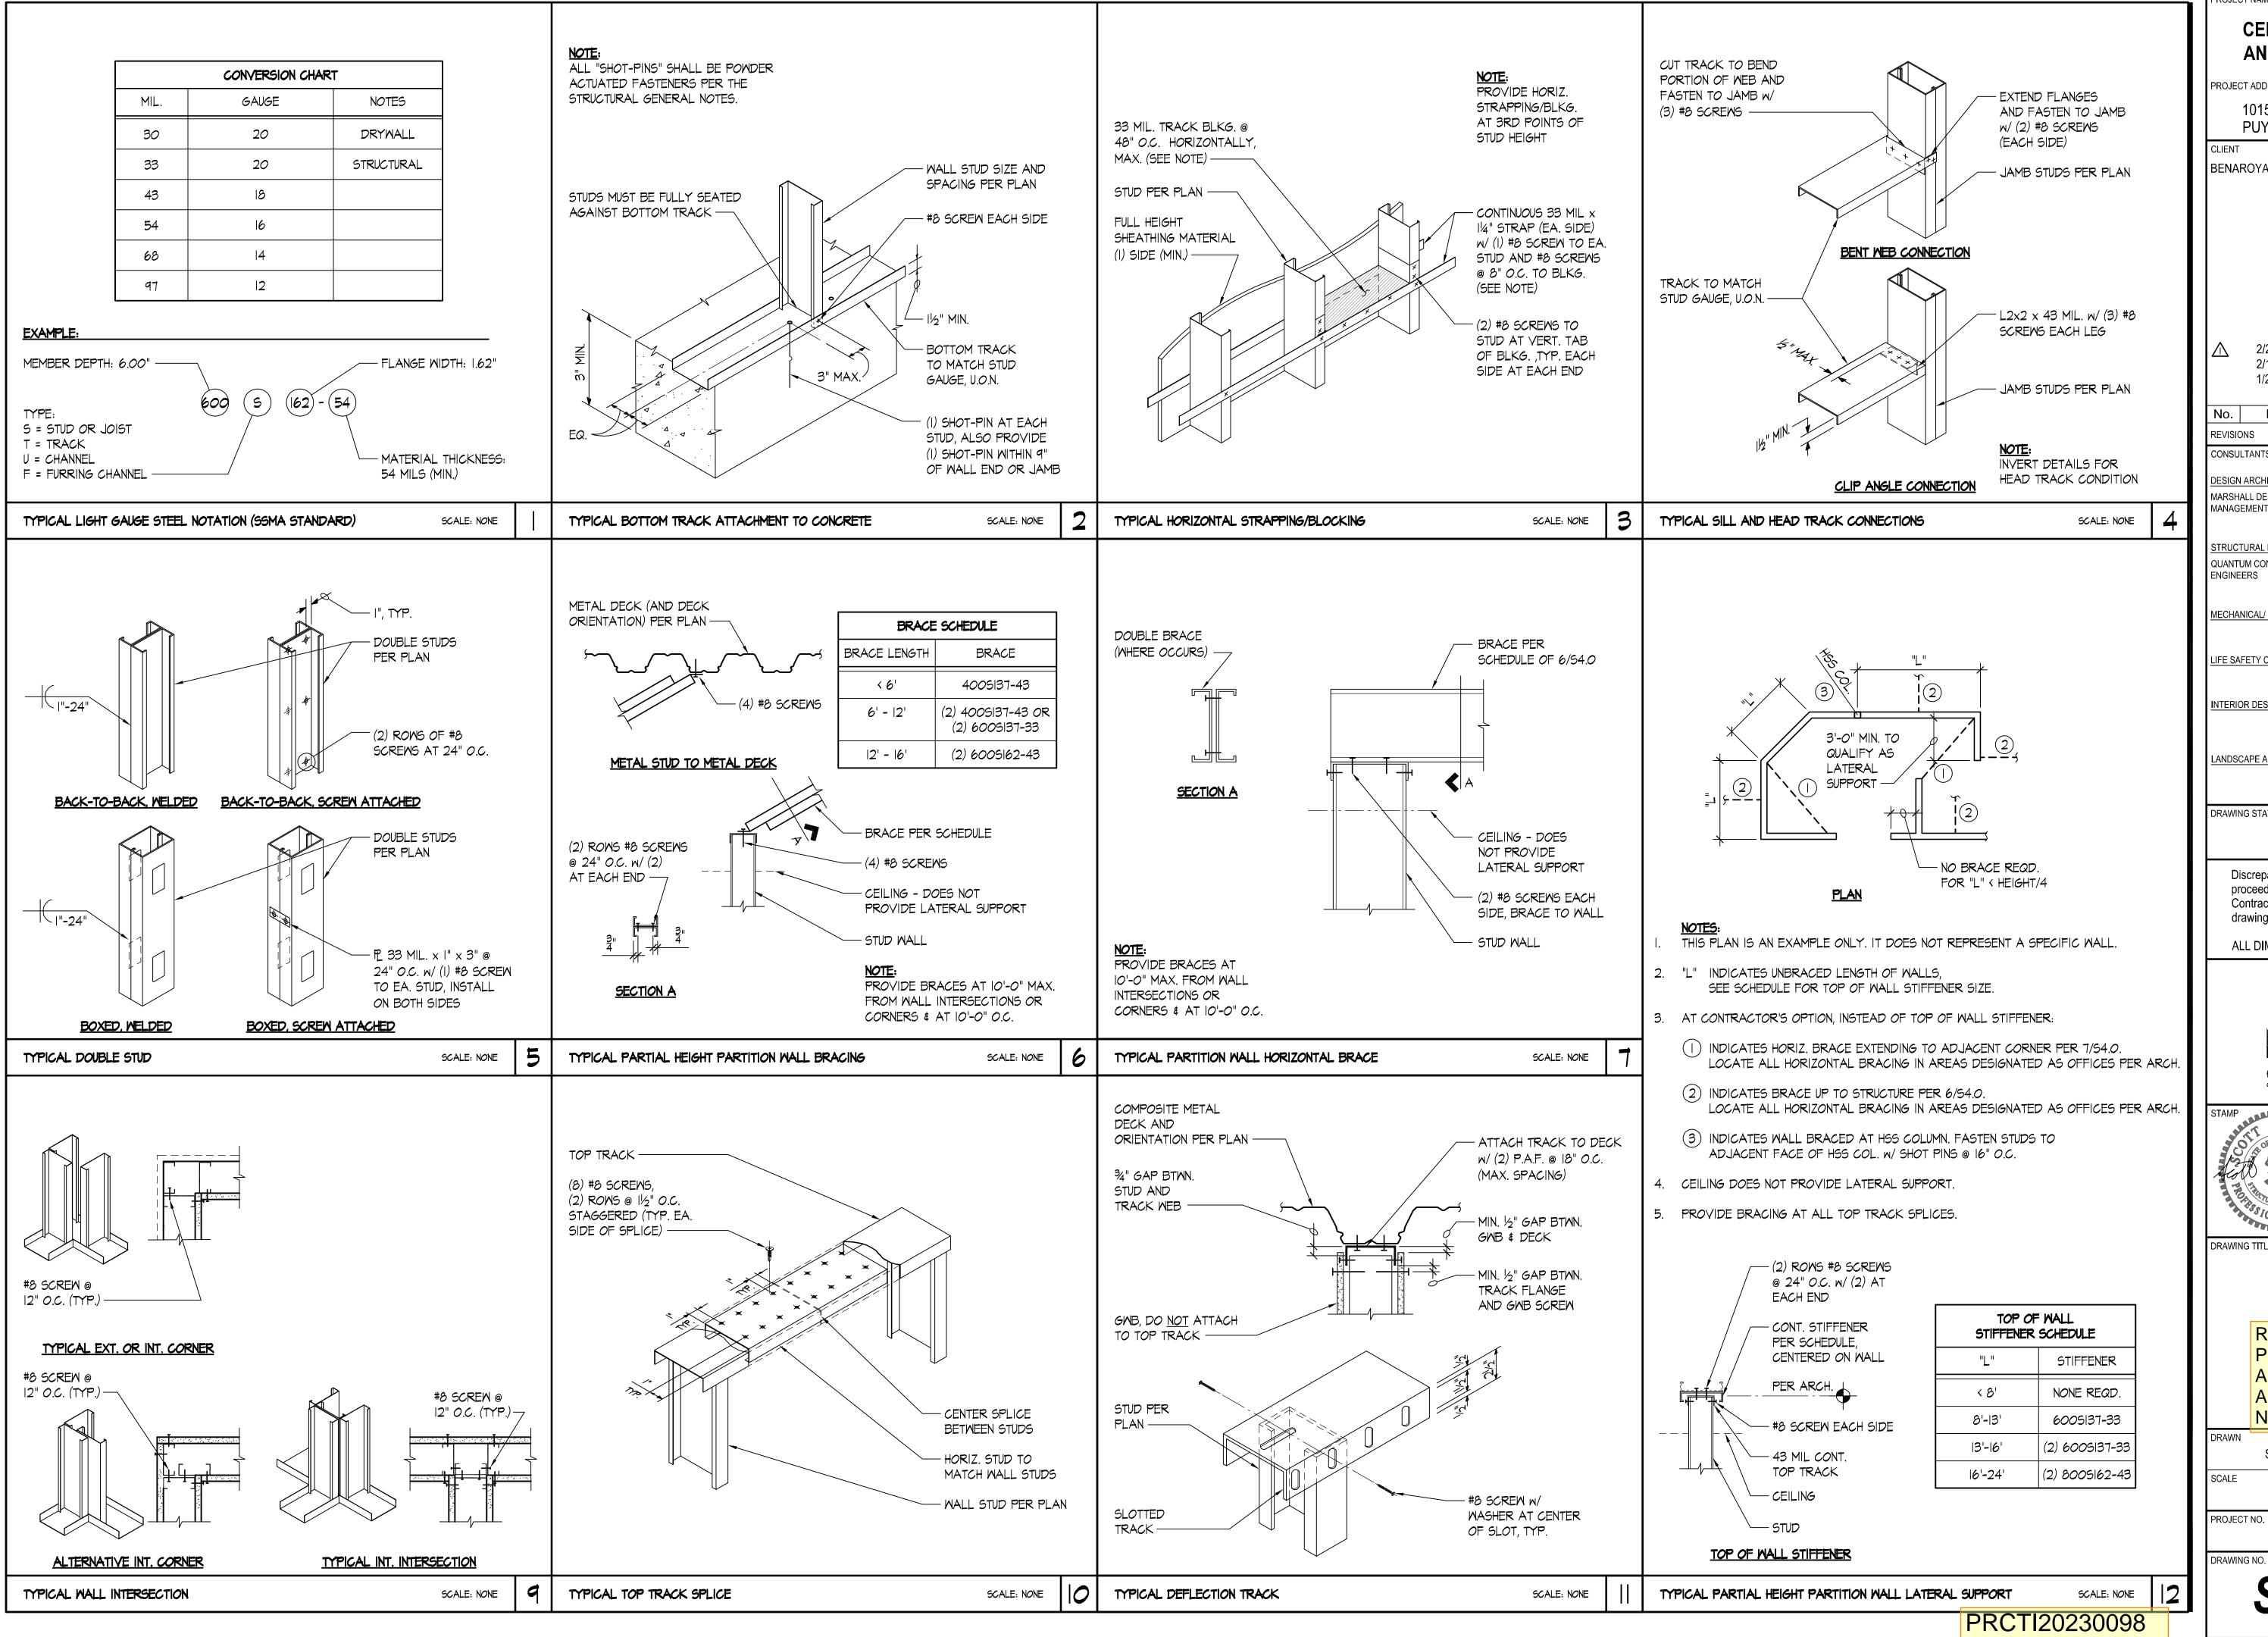
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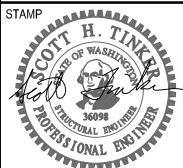


PROJECT NAME **CENTRAL PIERCE FIRE** AND RESCUE T.I. PROJECT ADDRESS 1015 - 39TH AVENUE SE PUYALLUP, WA BENAROYA City of Puyallup evelopment & Permitting Services **ISSUED PERMIT** Planning **Public Works** Engineering Fire Traffic DELTA 1 REVISIONS 2/24/2023 CONSTRUCTION SET 2/17/2023 1/27/2023 PERMIT SUBMITTAL Revision Description Date REVISIONS **CONSULTANTS** DESIGN ARCHITECT MARSHALL DESIGN + T: 206-890-1570 MANAGEMENT STRUCTURAL ENGINEER QUANTUM CONSULTING 1511 THIRD AVE, SUITE 323 **ENGINEERS** SEATTLE, WA 98101 T 206-957-3900 MECHANICAL/ ELECTRICAL ENGINEER LIFE SAFETY CODE CONSULTANT INTERIOR DESIGN LANDSCAPE ARCHITECT DRAWING STATUS **REVISIONS** drawing is protected by copyright. ALL DIMENSIONS ARE SHOWN IN IMPERIAL

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1511 THIRD AVENUE SUITE 323 SEATTLE, WA 98101 QUANTUM TEL 206.957.3900 FAX 206.957.3901 NEULTING ENGINEERS WWW.quantumce.com



DRAWING TITLE

TYPICAL LIGHT **GAUGE DETAILS**

REVISIONS - REPLACE PLANS WITH PREIOUSLY APPROVED PLANS OR ADD NEW SHEET WHEN NEW

CHECKED

REVISION NO.

SC SCALE	MDW DATE
JOALL	2/23/2023

19305.03


DRAWING NO.

S4.0


ABBREVIATIONS

A		OFOI	OWNER FURNISHED OWNER
ABB	ABBREVIATION	OTO	INSTALLED OPEN TO STRUCTURE
ACT	ACOUSTICAL CEILING TILE	OTS	OPEN TO STRUCTURE
AFF	ABOVE FINISHED FLOOR	Р	
AHU	AIR HANDLING UNIT	PERP	PERPENDICULAR DIAGRIC LAMINATE
ALUM	ALUMINUM	PLAM PLYWD	PLASTIC LAMINATE PLYWOOD
ARCH	ARCHITECT (URAL)	PREFIN	PREFINISHED
В	DOADD	PKEFIN	
BD	BOARD	PTDWR	PAINT; PRESSURE TREATED PAPER TOWEL DISPENSER/ WAST
BLDG	BUILDING	PIDWK	RECEPTACLE
ВО	BOTTOM OF	PTL	PORCELAIN TILE
C	OFMENITIFICATION OF BACKED BOARD	R	1 011022 1122
CBB	CEMENTITIOUS BACKER BOARD	RB	RUBBER BASE
CFCI	CONTRACTOR FURNISHED CONTRACTOR INSTALLED	RCP	REFLECTED CEILING PLAN
CFOI	CONTRACTOR FURNISHED OWNER	REF	REFERENCE
OI OI	INSTALLED	REQ'D	REQUIRED
CG	CORNER GUARD	REST	RESTROOM
CI	CONTINUOUS INSULATION	REV	REVISION
CJ	CONTROL JOINT	RO	ROUGH OPENING
CLG	CEILING	S	
CLR	CLEAR/ CLEARANCE	S	SOUTH
CMU	CONCRETE MASONRY UNIT	SCWD	SOLID CORE WOOD DOOR
COL	COLUMN	SD	SOAP DISPENSER
CPT	CARPET	SE	SOUTHEAST
СТ	CERAMIC TILE	SF	SQUARE FOOT (FEET)
D.		SIM	SIMILAR
DET	DETAIL	SND	SANITARY NAPKIN & TAMPON
DF	DRINKING FOUNTAIN		DISPOSAL RECEPTACLE
DIA	DIAMETER	SPEC	SPECIFICATION
E		SS	SOLID SURFACE
E	EAST	SST	STAINLESS STEEL
EA	EACH	STC	SOUND TRANSMISSION CLASS
ELEC		Т	
EQ	EQUAL	T & G	TONGUE AND GROOVE
EQUIP	EQUIPMENT	TBD	TO BE DETERMINED
EXIST	EXISTING	TO	TOP OF
EXT	EXTERIOR	TOS	TOP OF SLAB OR STEEL
F		TPD	TOILET PAPER DISPENSER
FA	FIRE ALARM	TS	TUBE STEEL
FCO	FLOOR CLEANOUT	TSCD	TOILET SEAT COVER DISPENSER
FD	FLOOR DRAIN	TV	TELEVISION
FE	FIRE EXTINGUISHER	TYP	TYPICAL
FEB	FIRE EXTINGUISHER BRACKET	U	
FEC	FIRE EXTINGUISHER CABINET	UNO	UNLESS NOTED OTHERWISE
FF	FINISHED FLOOR	V	
FLR	FLOOR (ING)	VERT	VERTICAL
FP	FIRE PROTECTION	W	
FT	FEET	W	WEST
G		W/	WITH
GA	GAUGE	WD	WOOD
GALV	GALVANIZED	WP	WALL PANEL
GL	GRID LINE	WRB	WEATHER RESISTIVE BARRIER
GWB	GYPSUM WALL BOARD	WT	WINDOW TREATMENT
GYP	GYPSUM		
Н			
НМ	HOLLOW METAL		
HW	HARDWARE		
l			
INSUL	INSULATION		
INT	INTERIOR		
J			
JAN	JANITOR		
M			
MAT	MATERIAL		
MAX	MAXIMUM		
MECH	MECHANICAL		
MEP	MECHANICAL, ELECTRICAL,		
	PLUMBING		
MFR	MANUFACTURER		
MIN	MINIMUM		
MTD	MOUNTED		
MTL	METAL		
N			
N	NORTH		
NE	NORTH EAST		
NIC	NOT IN CONTRACT		
NTS	NOT TO SCALE		
NW	NORTHWEST		
0			
OC	ON CENTER		
OFCI	OWNER FURNISHED CONTRACTOR		
	INSTALLED		

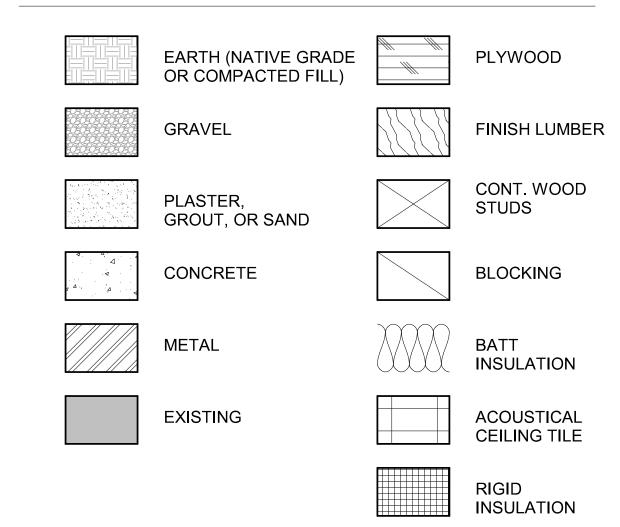HATCH SYMBOLS



DETAIL IDENTIFICATION

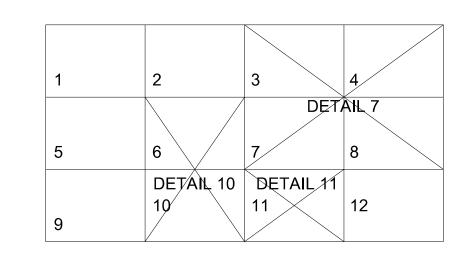

- DETAIL NUMBERS ARE BASED ON LOCATION OF THE DETAIL DRAWING ON THE DETAIL SHEET AND MAY NOT BE SEQUENTIAL.
- 2. DETAIL IDENTIFICATION NUMBER IS THE NUMBER OF THE LOWEST LEFT HAND MODULE OCCUPIED BY THE DETAIL.

GENERAL NOTES

- 1. REPETITIVE FEATURES NOT NOTED ON THE DRAWINGS SHALL BE COMPLETELY PROVIDED AS IF DRAWN IN FULL.
- 2. DO NOT SCALE THE DRAWINGS
- 3. DIMENSIONS ON DRAWINGS ARE TAKEN TO/FROM THE LOCATIONS LISTED BELOW UNLESS OTHERWISE INDICATED:

GRID LINES CENTER OF WALL UNLESS NOTED OTHERWISE

I. DIMENSIONS ON INTERIOR ELEVATIONS ARE TAKEN TO/FROM THE:

CENTERLINES OF DOORS IN METAL STUD WALLS

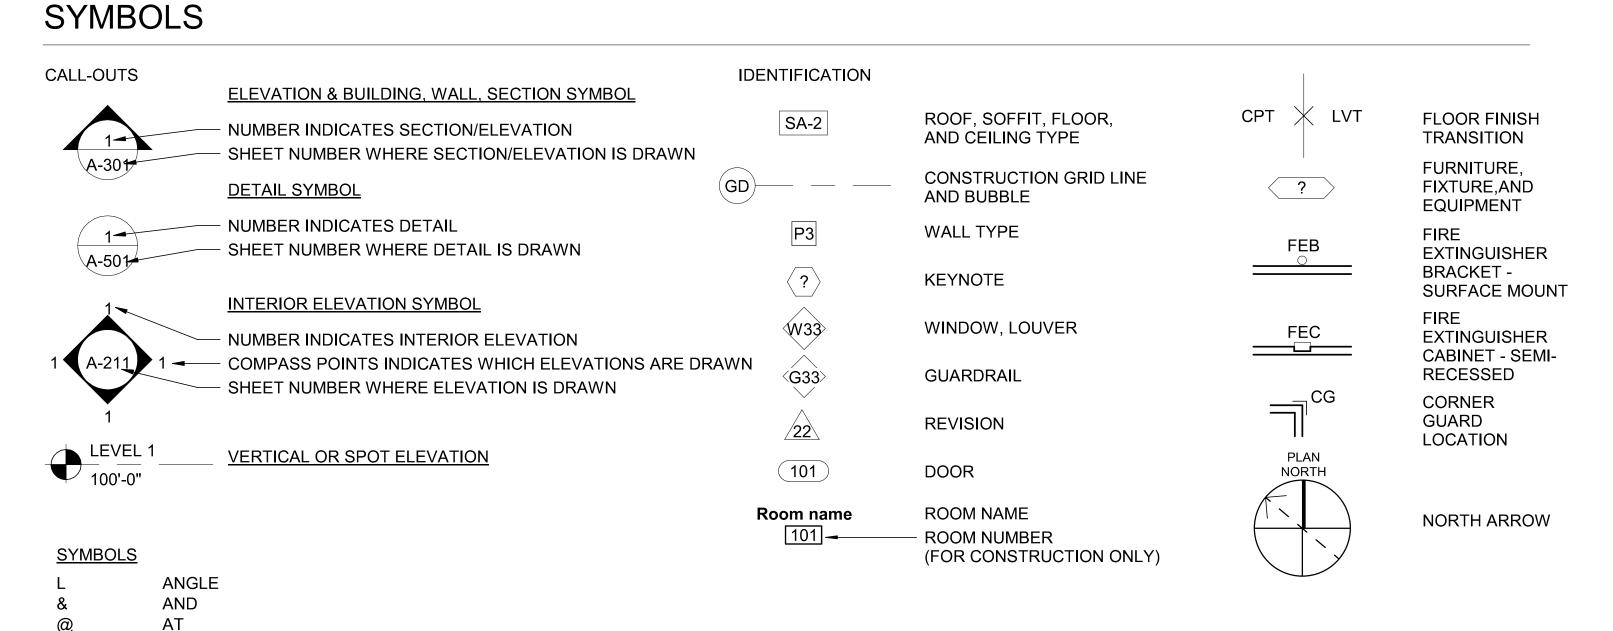
FINISHED GYPSUM WALLBOARD CABINETRY CENTERLINES OF FIXTURES

- 5. PLAN VIEWS ARE CUT AT 4'-0" AFF WITH CERTAIN PLAN REGIONS SHOWN BEING CUT HIGHER FOR COORDINATION PURPOSES.
- 6. GRID LINES INDICATE THE CENTERLINE OF PRIMARY COLUMNS. COLUMNS ARE EXISTING.
- 7. MECHANICAL AND ELECTRICAL INFORMATION SHOWN ON THE ARCHITECTURAL DRAWINGS ARE PROVIDED FOR CLARITY AND/OR LOCATION PURPOSES ONLY. SEE MECHANICAL AND ELECTRICAL DRAWINGS.
- 8. BUILDING HEIGHTS AND ELEVATIONS ARE BASED UPON PROJECT FINISH ELEVATION OF 100'-0" AT THE FIRST FLOOR.
- 9. ALL WORK SHALL COMPLY WITH 2018 INTERNATIONAL BUILDING CODE (IBC) AND INTERNATIONAL FIRE CODE (IFC) 2018.
- 10. ALL DOORS IN STUD WALLS NOT LOCATED BY DIMENSION ON PLANS OR DETAILS SHALL BE 4" FROM FACE OF ADJACENT PERPENDICULAR WALL TO EDGE OF DOOR OPENING.
- 11. ROOM AND DOOR NUMBERS SHOWN ON DRAWINGS ARE FOR CONSTRUCTION PURPOSES ONLY.
- 12. VERIFY FIELD DIMENSIONS PRIOR TO COMMENCEMENT OF WORK.
- 13. BUILDING STANDARD TENANT IMPROVEMENT SYSTEMS, MATERIALS, AND FINISHES ARE TO BE PROVIDED UNLESS REQUIRED BY TENANT STANDARDS OUTLINE IN THE LEASE.
- 14. THE CONTRACTOR IS REQUIRED TO FIELD VERIFY ALL EXISTING CONDITIONS AND DIMENSIONS.

DIAMETER

CENTER LINE

DEGREE



REVISIONS - REPLACE PLANS WITH PREIOUSLY APPROVED PLANS OR ADD NEW SHEET WHEN NEW

elopment & Permitting Services

Public Works

ISSUED PERMIT

Building

Engineering

Fire

MARSHALL DESIGN + MANAGEMENT
12400 SE 38TH #50766
BELLEVUE, WA 98105

CLIENT AND PROJECT LOCATION

Benaroya

BENAROYA SOUTH HILL BUSINESS AND TECHNOLOGY CENTER 1015 39TH AVE SE PUYALLUP, WA 98374



1015 39TH AVE SE, SUITE 120 PUYALLUP, WA 98374



WJA DESIGN-COLLABORATIVE 617 WESTERN AVE SEATTLE, WA 98104



ISSUANCE

ISSUE DATE 02/17/2023

DRAWN BY: WJA


CHECKED BY: WJA

		REVISION LIST	
NO.	DATE	DESCRIPTION	BY
1	01/30/23	PERMIT SET	
1	02/17/23	100% CONSTRUCTION DOCS	
		KEY PLAN	

ARCHITECTURAL GENERAL NOTES & LEGENDS


A-001
PRCTI20230098

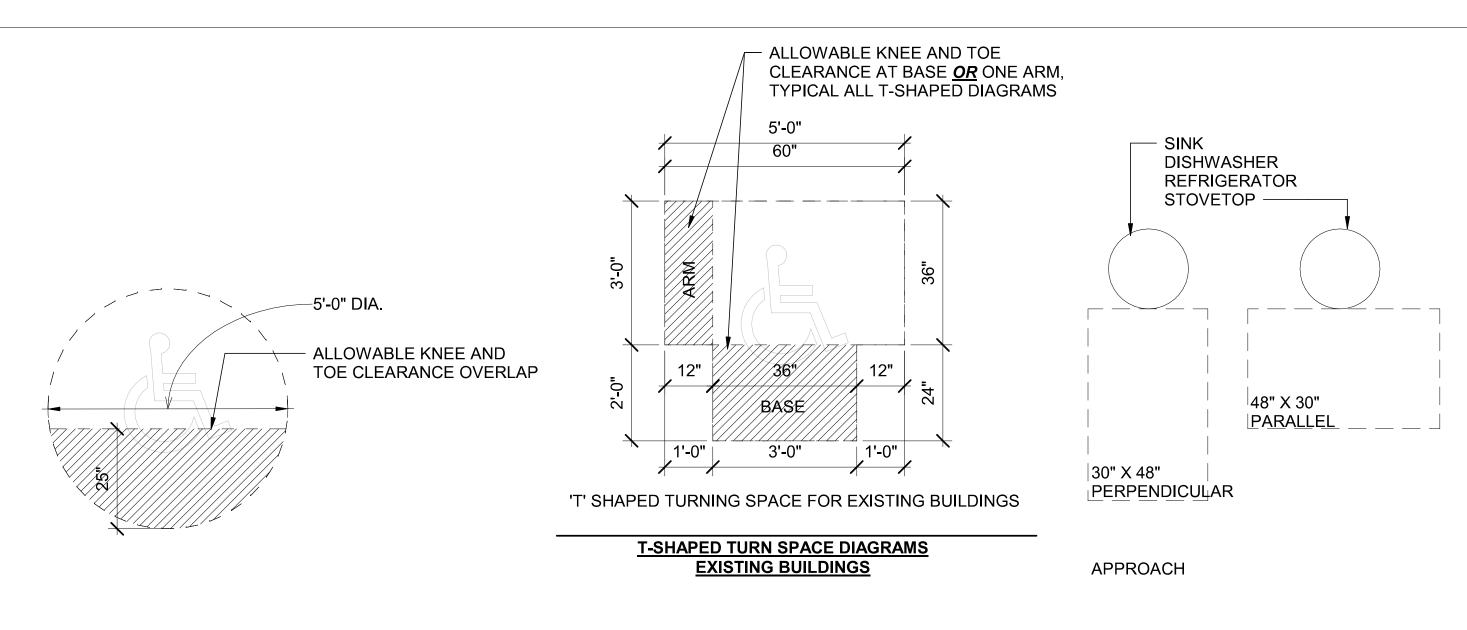SHEET NUMBER



ACCESSIBLE MANEUVERING CLEARANCE AND APPROACH (PLAN VIEW)

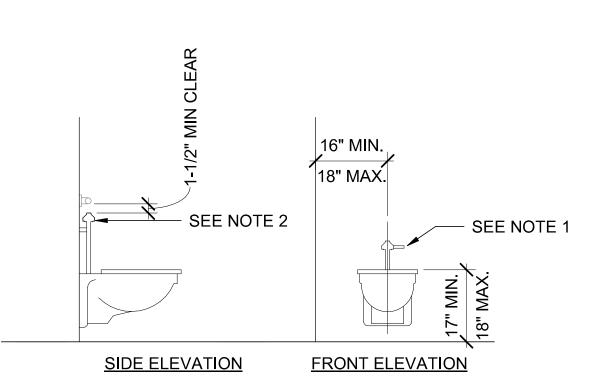SCALE: 1/2" = 1'-0"




ACCESSIBLE WATER CLOSETS MOUNTING HEIGHTS **AND CLEARANCES**


- LOCATE MANUAL FLUSH CONTROLS ON OPEN SIDE
- (NON-WALL SIDE) OF THE WATER CLOSET. MAINTAIN A MINIMUM OF 1-1/2" CLEAR BETWEEN FLUSH VALVE AND GRAB BARS.

SEE NOTE 3 39" MIN. 42" MIN. 41" MAX. 6" MAX. 12" MAX.+ **PROJECTING** ~1-1/2" CLEAR> OBJECTS SEE NOTE 2. 42" MIN. **SIDE ELEVATION** FRONT ELEVATION **ENLARGED SECTION** (NOT TO SCALE)

GRAB BAR (GB) MOUNTING DIAGRAMS FOR ACCESSIBLE WATER CLOSETS

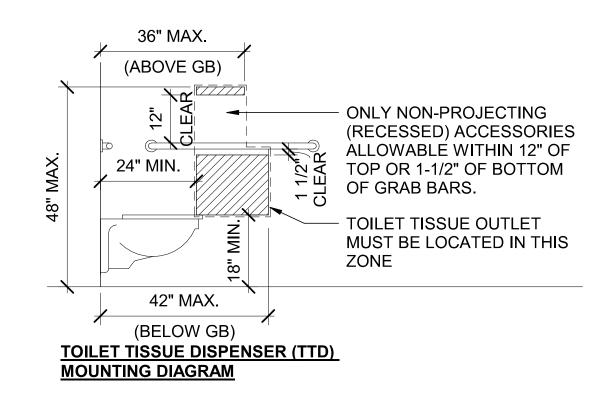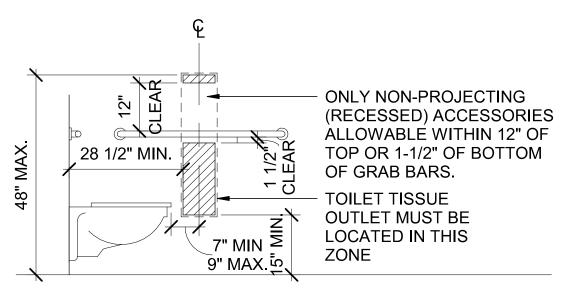- CONTRACTOR IS RESPONSIBLE FOR FIELD COORDINATION OF APPLICABLE CLEARANCES WITH PLUMBING FIXTURES AND TOILET ACCESSORIES.
- GRAB BARS WITH A ROUND CROSS-SECTION SHALL HAVE A MINIMUM DIAMETER OF 1-1/4" AND MAXIMUM OF 2".
- PROJECTING OBJECTS OTHER THAN ADJACENT GRAB BARS SHALL BE A MINIMUM OF 1-1/2" CLEAR OF THE BOTTOM AND 12" CLEAR OF THE TOP OF HORIZONTAL GRAB BARS.
- PROVIDE VERTICAL GRAB BAR WHERE REQUIRED BY AHJ.
- MOUNT ALL ADJACENT HORIZONTAL GRAB BARS AT THE SAME ELEVATION.
- IT IS RECOMMENDED TO PROVIDE BLOCKING IN WALL ACCOMMODATING ALL RANGES OF SHOWN FOR THE GREATEST FLEXIBILITY FOR FIELD COORDINATION.





TOILET TISSUE DISPENSER (TTD) ALTERNATE MOUNTING DIAGRAM

TTD SPECIFICATION MUST MEET THE REQUIREMENTS OF *ICC* A117.1 SECTION 607.1 - EXCEPTION 1. THE TOILET TISSUE DISPENSER MAY ACCOMMODATE A MAXIMUM OF 2 TOILET PAPER ROLLS NOT MORE THAN 5" IN DIAMETER EACH..

LOCATION **ABOVE GRAB BAR ALLOWABLE** ONLY FOR RECESSED TSCD SEE NOTE 3 **SIDE ELEVATION** FRONT ELEVATION

TOILET SEAT COVER DISPENSERS (TSCD) AT ACCESSIBLE WATER CLOSETS

- MINIMUM AND MAXIMUM DIMENSIONS ARE FOR THE TOILET SEAT COVER OUTLET. PROJECTING/SURFACE-MOUNTED ACCESSORIES MUST MAINTAIN MINIMUM CLEARANCES FROM ABOVE AND BELOW GRAB BARS.
 - COORDINATE LOCATION FROM BACK WALL WITH LOCATION OF TOILET TISSUE

DISPENSERS AND SANITARY NAPKIN DISPOSAL WHERE APPLICABLE.

ACCESSIBILITY REFERENCES

PER ICC A117.1 2017 LAWS:

SCALE: 1/2" = 1'-0"

404.2.4 THRESHOLDS IF PROVIDED, THRESHOLDS AT DOORWAYS SHALL BE 1/2" MAXIMUM IN HEIGHT. RAISED THRESHOLDS AND CHANGES IN LEVEL DOORWAYS SHALL COPY WITH SECTIONS 302 AND 303.

ACCESSIBLE WATER CLOSET MOUNTING DIAGRAMS

404.2.9 DOOR AND GATE SURFACES

FIRE DOORS AND GATES REQUIRED TO BE EQUIPPED WITH PANIC HARDWARE, BREAK AWAY FEATURES OR OTHER FACTORS REQUIRING HIGHER OPENING FORCE FOR SAFETY REASONS SHALL HAVE THE MINIMUM OPENING FORCE ALLOWABLE IN SCOPING PROVISIONS ADOPTED BY THE APPROPRIATE ADMINISTRATIVE AUTHORITY. FOR OTHER DOORS AND GATES, THE FORCE FOR PUSHING OR PULLING OPEN DOORS OR GATES SHALL BE AS FOLLOWS:

1. INTERIOR HINGED DOOR: 5.0 POUNDS MAXIMUM

2. SLIDING OR FOLDING DOOR: 5.0 POUNDS MAXIMUM

606.6 EXPOSED PIPES AND SURFACES

WATER SUPPLY AND DRAINPIPES UNDER LAVATORIES AND SINKS SHALL BE INSULATED OR OTHERWISE CONFIGURED TO PROTECT AGAINST CONTACT. THERE SHALL BE NO SHARP OR ABRASIVE SURFACES UNDER LAVATORIES OR SINKS.

703.6.2 FINISH AND CONTRAST

SYMBOLS OF ACCESSIBILITY AND THEIR BACKGROUNDS SHALL HAVE A NONGLARE FINISH. SYMBOLS OF ACCESSIBILITY SHALL CONTRAST WITH THEIR BACKGROUNDS, WITH EITHER A LIGHT SYMBOL ON A DARK BACKGROUND OR A DARK SYMBOL ON A LIGHT BACKGROUND.

703.6.3 INTERNATIONAL SYMBOL OF ACCESSIBILITY THE INTERNATIONAL SYMBOL OF ACCESSIBILITY SHALL COMPLY WITH FIGURE 703.6.3.1.

ACCESSIBILITY GENERAL NOTES

1. ALL LISTED ACCESSIBILITY STANDARD ARE REQUIRED.

8" MIN.

11" MIN.

-8" MIN

CONTROL

MAX.

SCALE: 1 1/2" = 1'-0"

2'-0"

Ç 1'-9"

CONTROL WALL

SCALE: 1/2" = 1'-0"

ACCESSIBLE SINK

- NO EXCEPTIONS FOR ACCESSIBILITY REQUIREMENTS PROVIDED. ALL ELEMENTS OF THE PROJECT MUST CONFORM TO 2010 ADA AND ICC A117.1 2017 LAWS. IF ACCESSIBILITY STANDARDS ARE IN CONFLICT THE PROJECT MUST COMPLY WITH THE MORE RESTRICTIVE STANDARD.
- 3. DIAGRAMS ON SHEETS A-002 AND A-003 ARE FROM ICC/ANSI A117.1

KNEE CLEARANCE

TOE CLEARANCE

CONTROL

ACCESSIBLE KNEE AND TOE CLEARANCE



CLIENT AND PROJEC

Benaroya

LOCATION

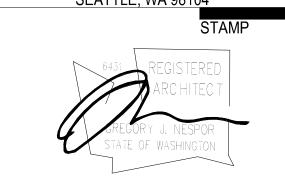
BENAROYA SOUTH HILL BUSINESS AND TECHNOLOGY CENTER 1015 39TH AVE SE PUYALLUP, WA 98374



1015 39TH AVE SE, SUITE 120 PUYALLUP, WA 98374



WJA DESIGN-COLLABORATIVE 617 WESTERN AVE SEATTLE, WA 98104



ISSUE DATE 02/17/2023 DRAWN BY: WJA CHECKED BY: WJA

REVISION LIST NO. DATE DESCRIPTION 1 01/30/23 PERMIT SET 1 02/17/23 100% CONSTRUCTION DOCS **KEY PLAN**

> City of Puyallup elopment & Permitting Services **ISSUED PERMIT** Planning Engineering Public Works Traffic Fire


SHEET NUMBER

ACCESSIBILITY DIAGRAMS

PRCTI20230098

REVISIONS - REPLACE PLANS WITH PREIOUSLY APPROVED PLANS OR ADD NEW SHEET WHEN NEW

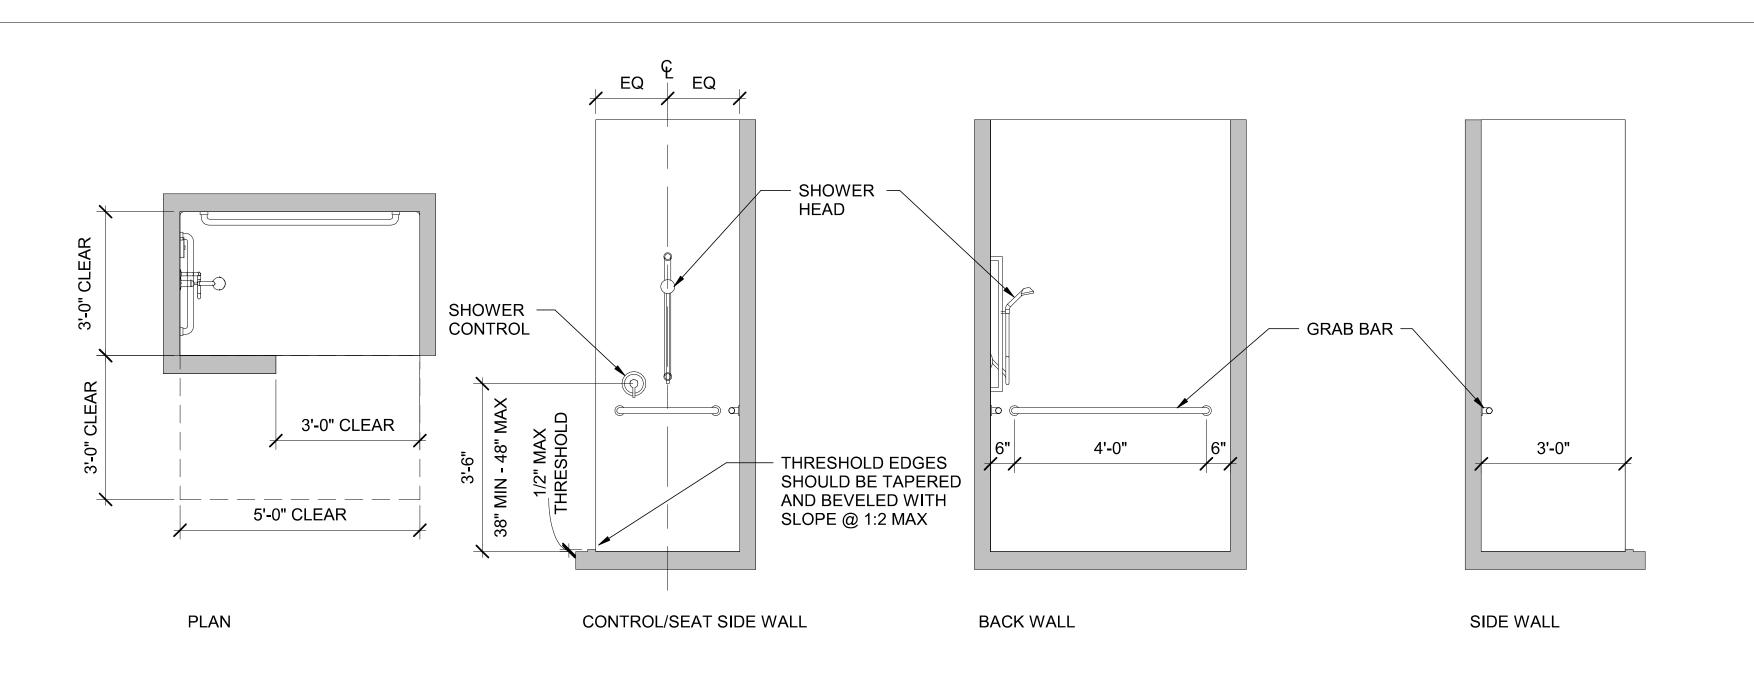PLAN



ACCESSIBLE ROLL-IN SHOWER COMPARTMENT

SCALE: 1/2" = 1'-0"



Benaroya


BENAROYA SOUTH HILL BUSINESS AND TECHNOLOGY CENTER 1015 39TH AVE SE PUYALLUP, WA 98374



CENTRAL PIERCE FIRE AND RESCUE 1015 39TH AVE SE, SUITE 120 PUYALLUP, WA 98374



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KEY PLAN

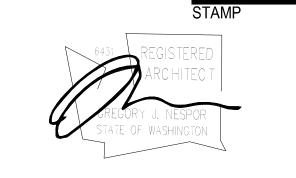City of Puyallup
Development & Permitting Services
ISSUED PERMIT
Building Planning
Engineering Public Works
Fire Traffic

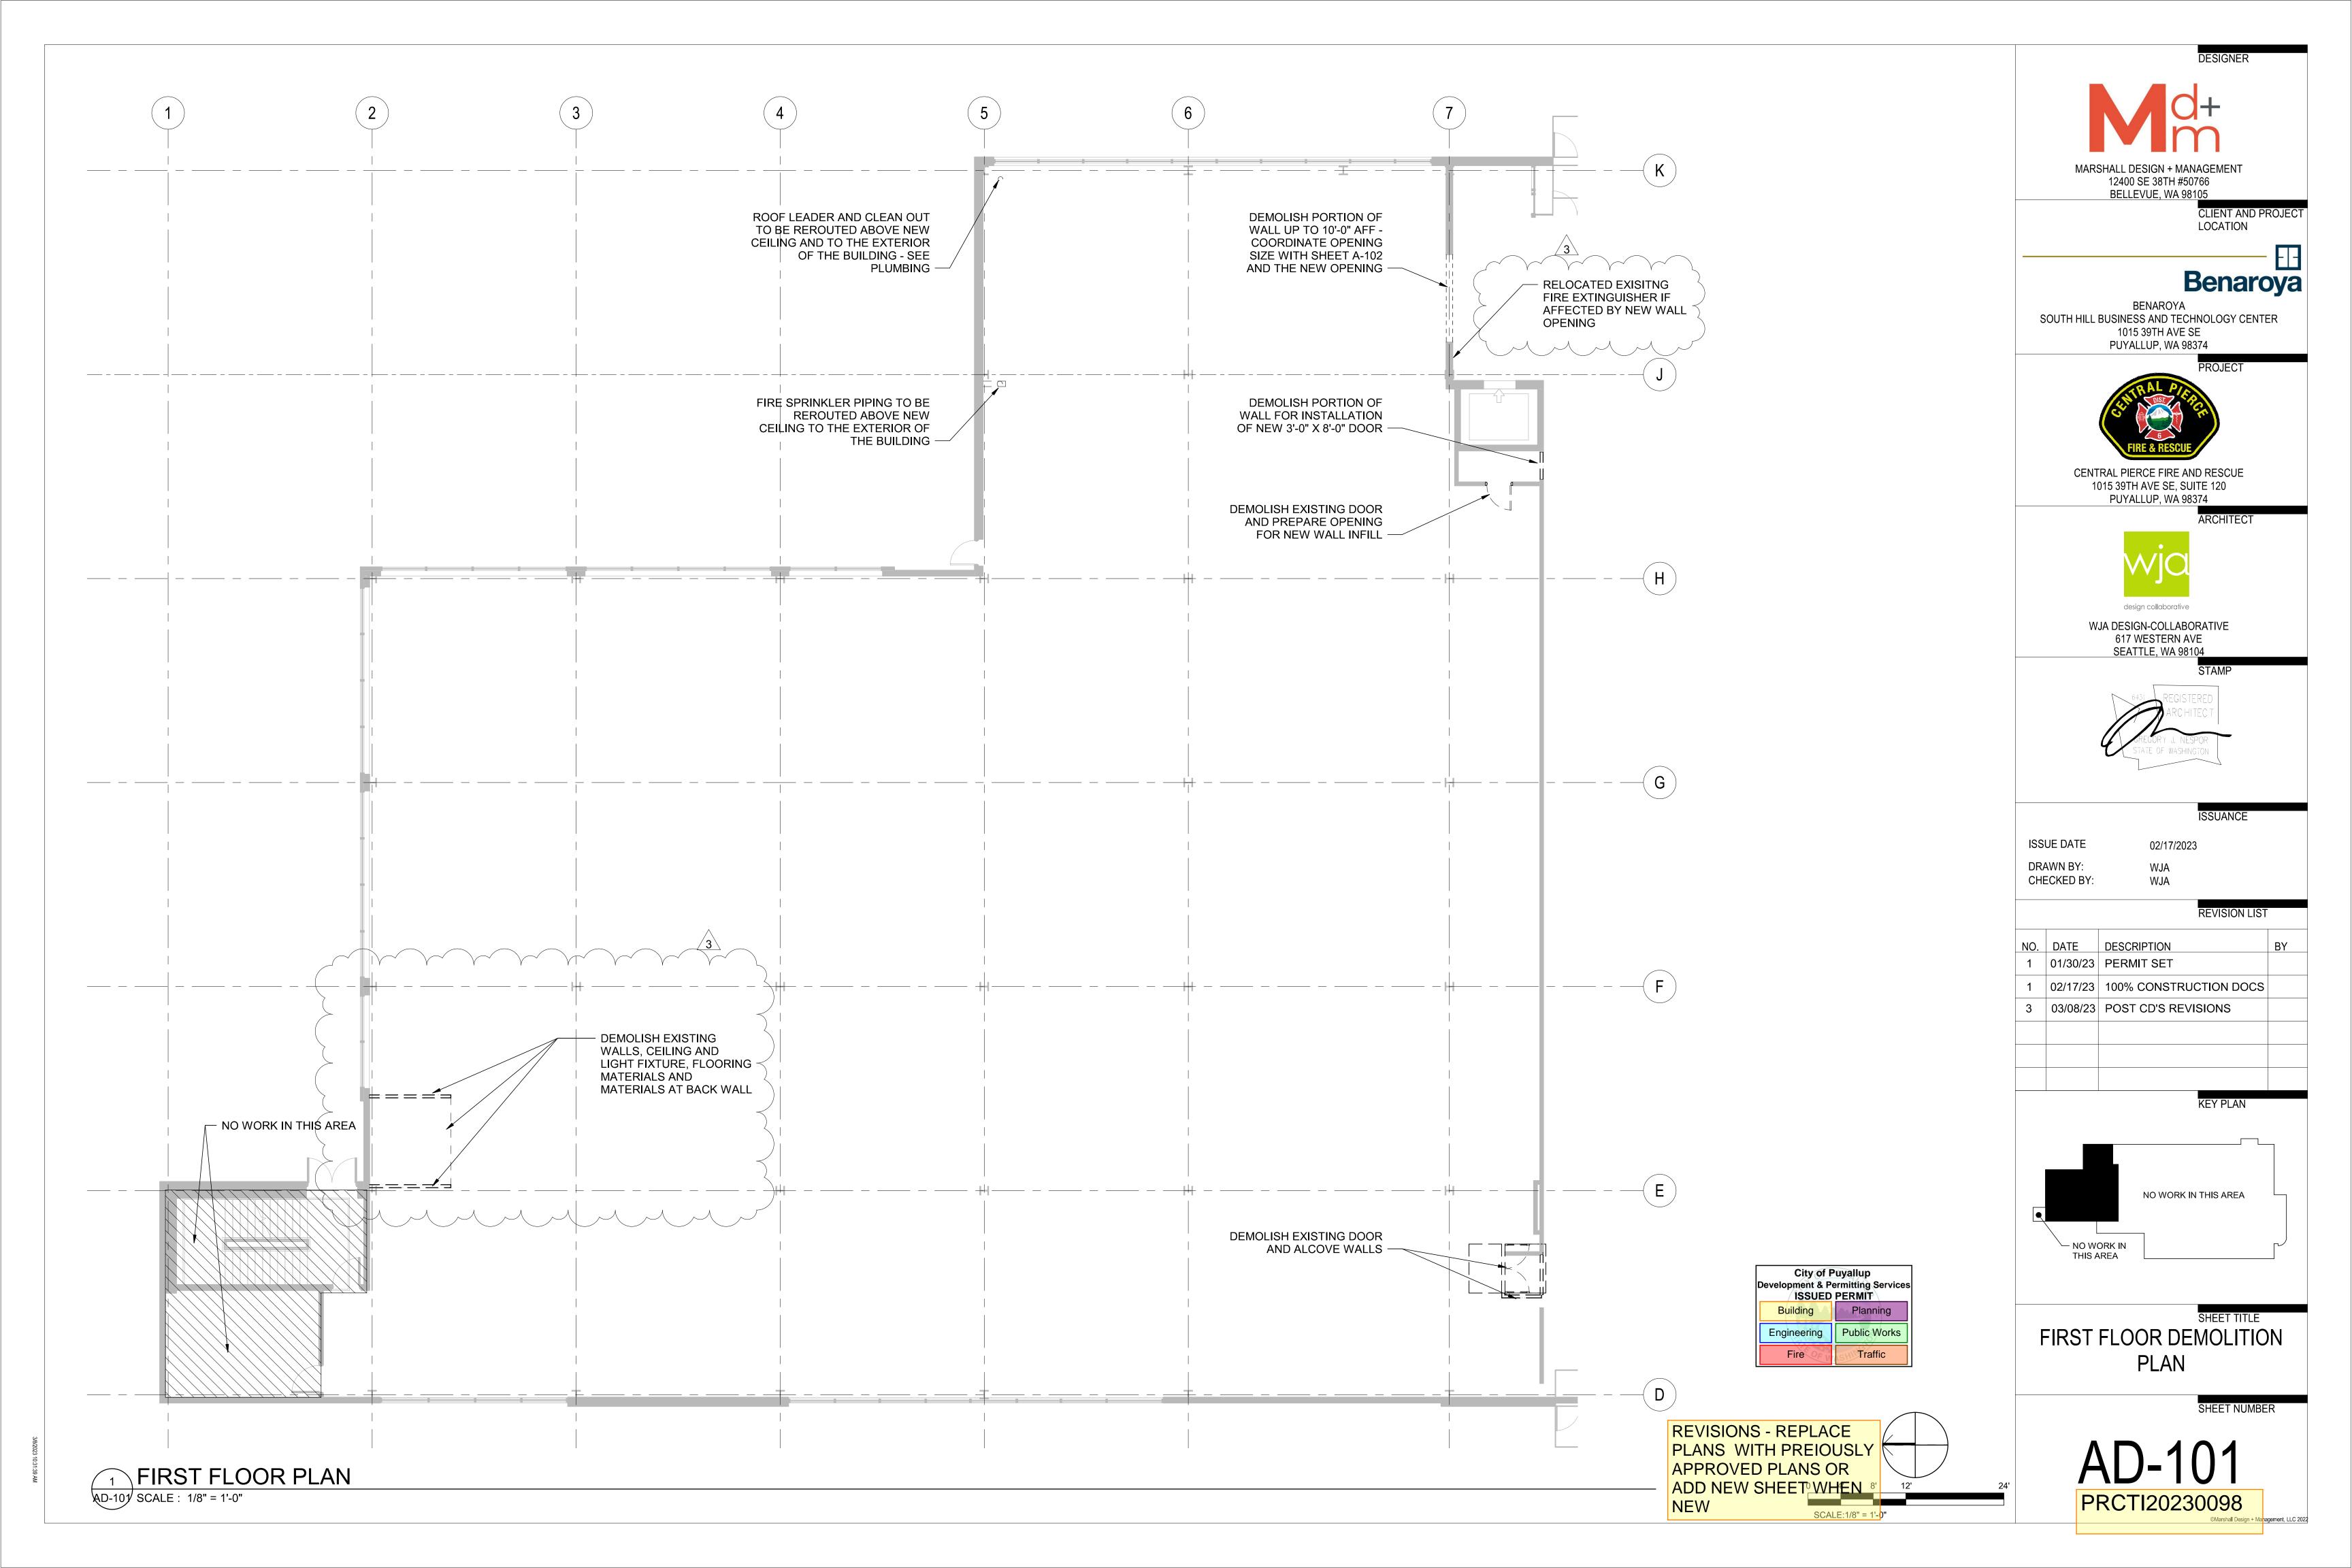
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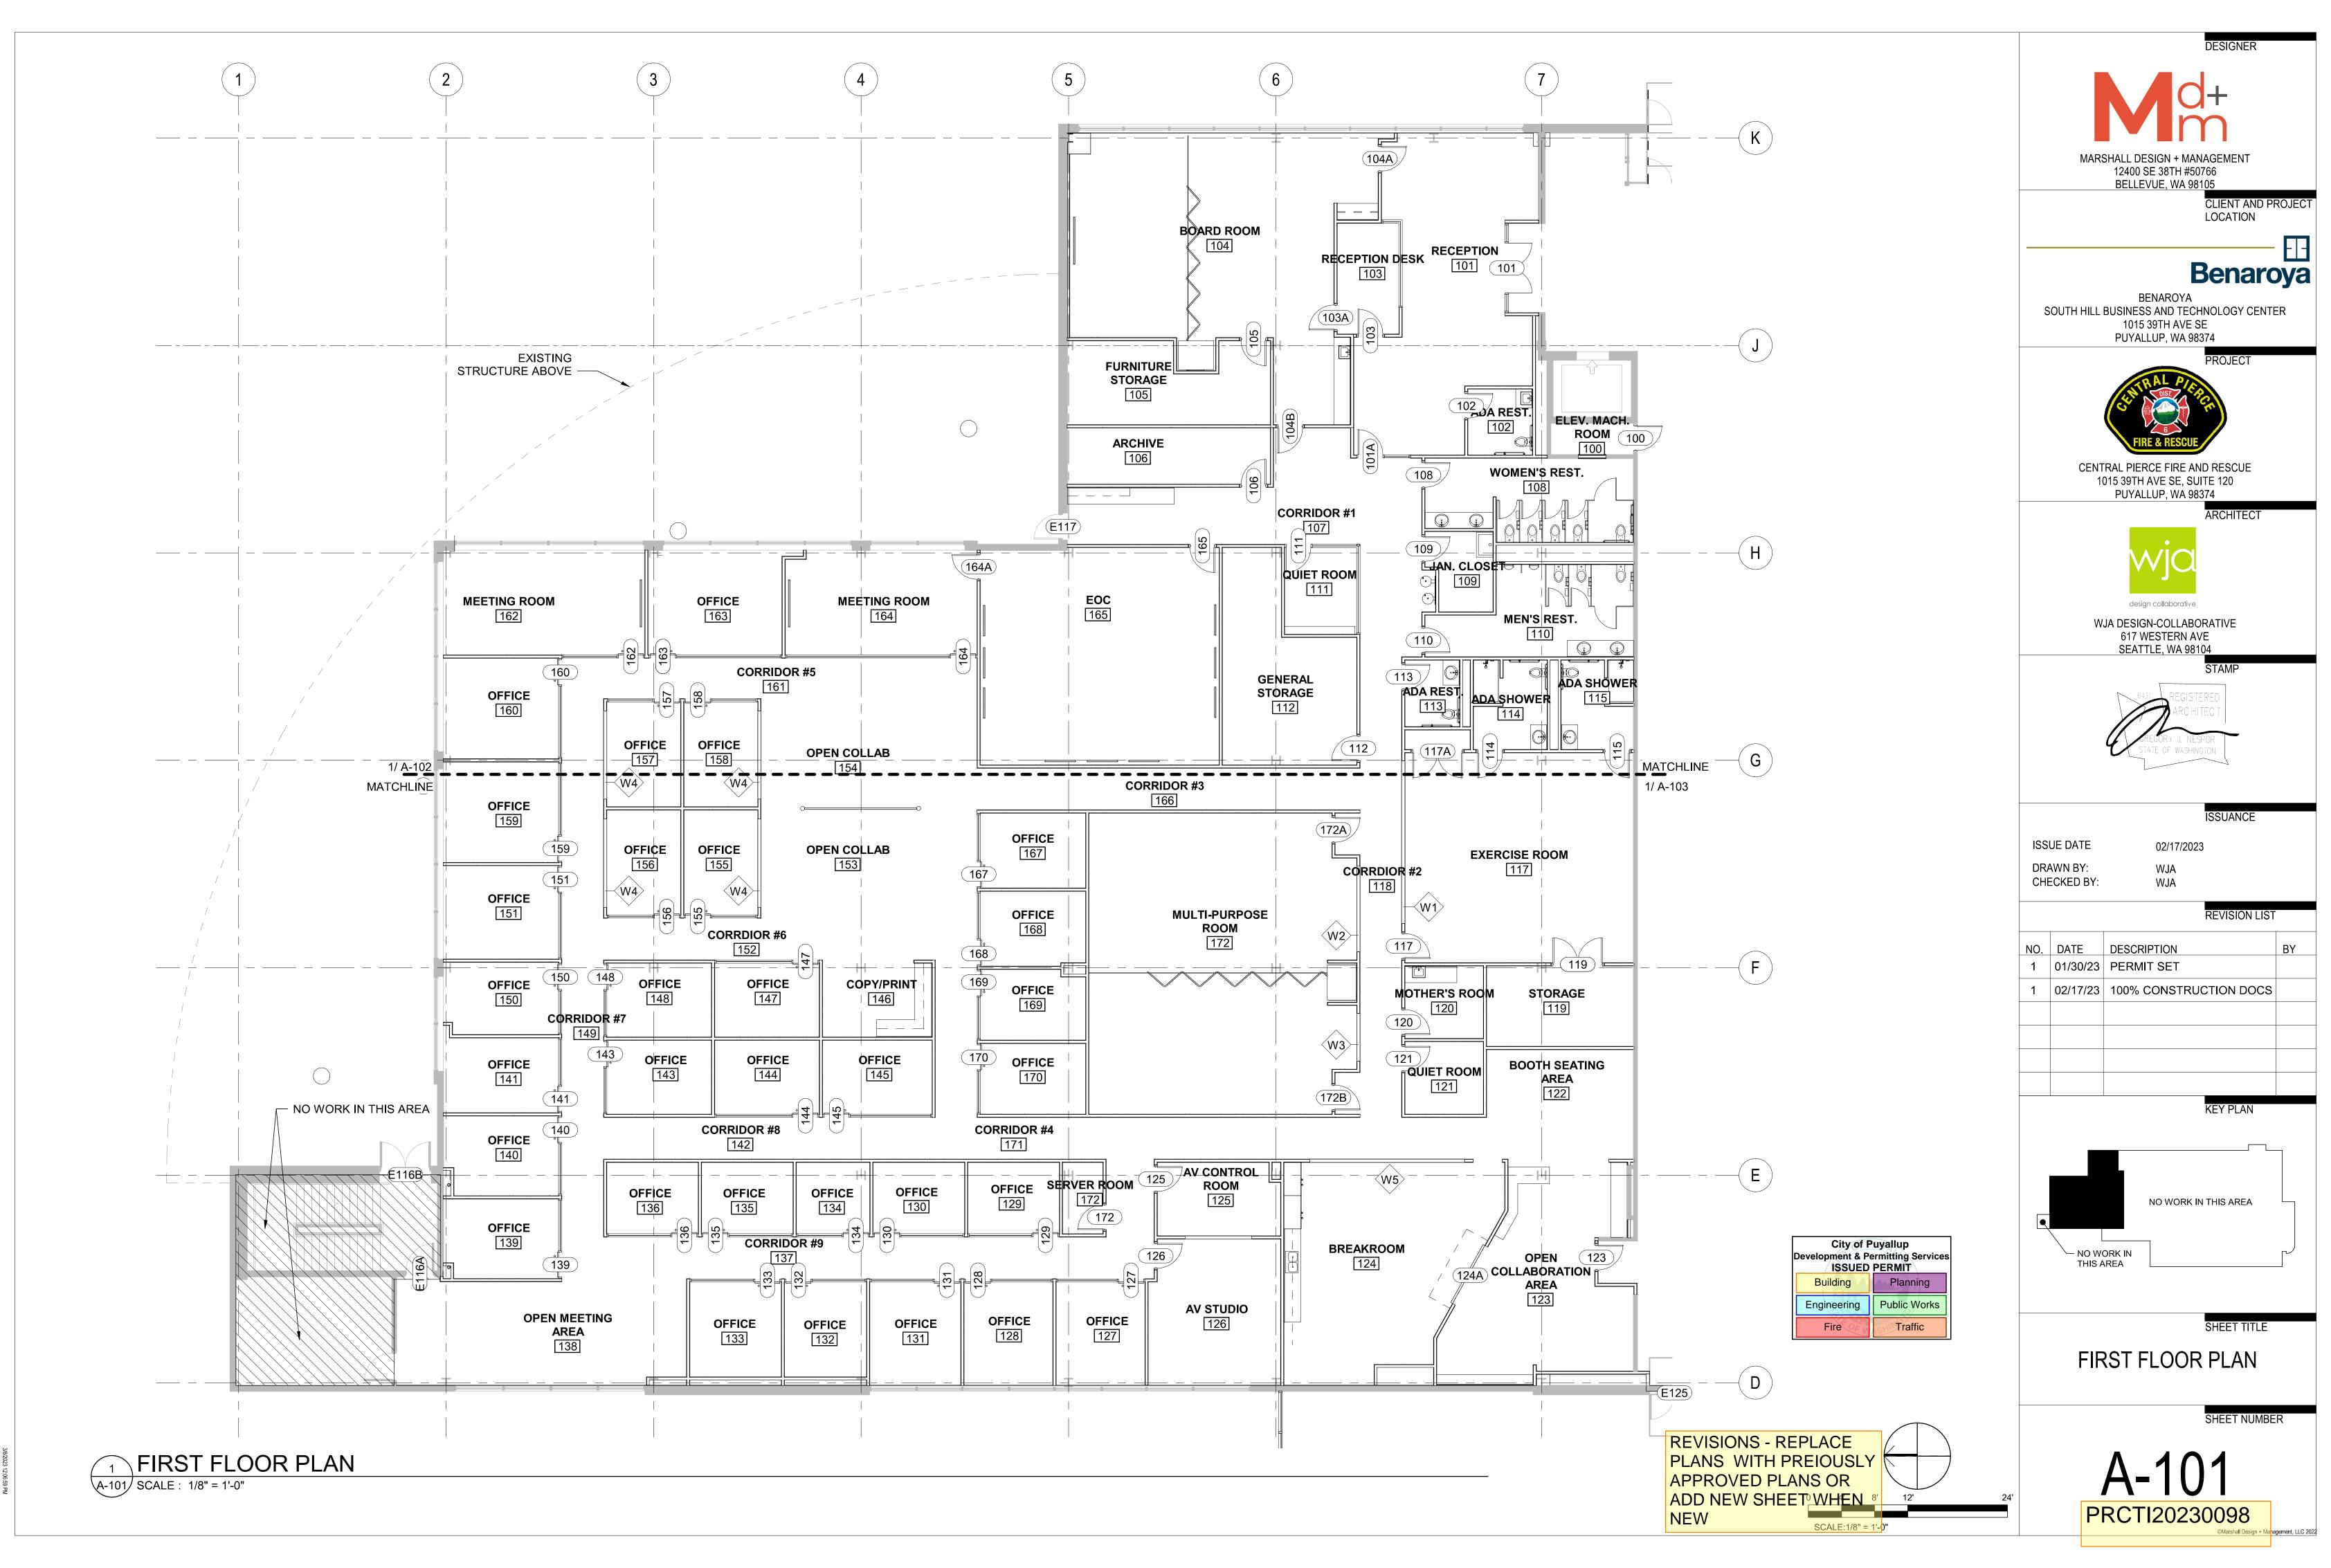
ACCESSIBILITY DIAGRAMS

SHEET NUMBER

A-003
PRCTI20230098

REVISIONS - REPLACE PLANS WITH PREIOUSLY APPROVED PLANS OR ADD NEW SHEET WHEN NEW





City of Puyallup velopment & Permitting Services **ISSUED PERMIT** Building Planning Engineering Public Works

Traffic

Fire

FLOOR PLAN GENERAL NOTES

- REFERENCE SHEET A-001 FOR ABBREVIATIONS, SYMBOL LEGENDS, ADDITIONAL DRAWING CONVENTIONS AND GENERAL NOTES.
- REFERENCE SHEET A-601 FOR WALL AND CEILING TYPES, SHEET A-602 FOR DOOR TYPES, AND SHEET A-603 FOR WINDOW TYPES.
- PLAN VIEWS ARE CUT AT 4'-0" AFF.
- ALL INTERIOR DOORS TO BE CENTERED IN ROOM OR 4" FROM ADJACENT FACE OF WALL AS SHOWN UNLESS OTHERWISE NOTED.
- SEE SHEET A-002 AND A-003 FOR ACCESSIBLE DETAILS.
- ALL WALLS TO BE TYPE 'S1' UNO.

- EXISTING EXTERIOR WALLS WITH EXPOSED INSULATION ARE TO BE COVERED WITH WALL TYPE
- ALL PARTITION WALLS NOT EXTENDING TO DECK ARE TO TERMINATE 6" ABOVE CEILING UNO.
- DEMOUNTABLE PARTITION WALL SYSTEMS ARE TO EXTEND FROM PARTITION WALL TO PARTITION WALL. CONTRACTOR TO FIELD VERIFY EXISTING EXTERIOR WINDOW MULLIONS AND ARE TO COORDINATE IN THE FIELD THE LOCATIONS OF PERPENDICULAR PARTITION WALLS AND CORRESPONDING DEMOUNTABLE PARTITION WALLS.
- 10. INSTALL WALL BLOCKING AT ALL MIRROR AND MONITOR LOCATIONS.
- 11. BUILDING STANDARD WINDOW BLINDS TO BE PROVIDED AT ALL EXTERIOR WINDOWS.



Benaroya

LOCATION

BENAROYA SOUTH HILL BUSINESS AND TECHNOLOGY CENTER 1015 39TH AVE SE PUYALLUP, WA 98374



CENTRAL PIERCE FIRE AND RESCUE 1015 39TH AVE SE, SUITE 120 PUYALLUP, WA 98374



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01/30/2023 WJA


NO. DATE DESCRIPTION 1 01/30/23 PERMIT SET 1 02/17/23 100% CONSTRUCTION DOCS 3 03/08/23 POST CD'S REVISIONS KEY PLAN

NO WORK IN THIS AREA

ENLARGED EAST PLAN

PRCTI20230098

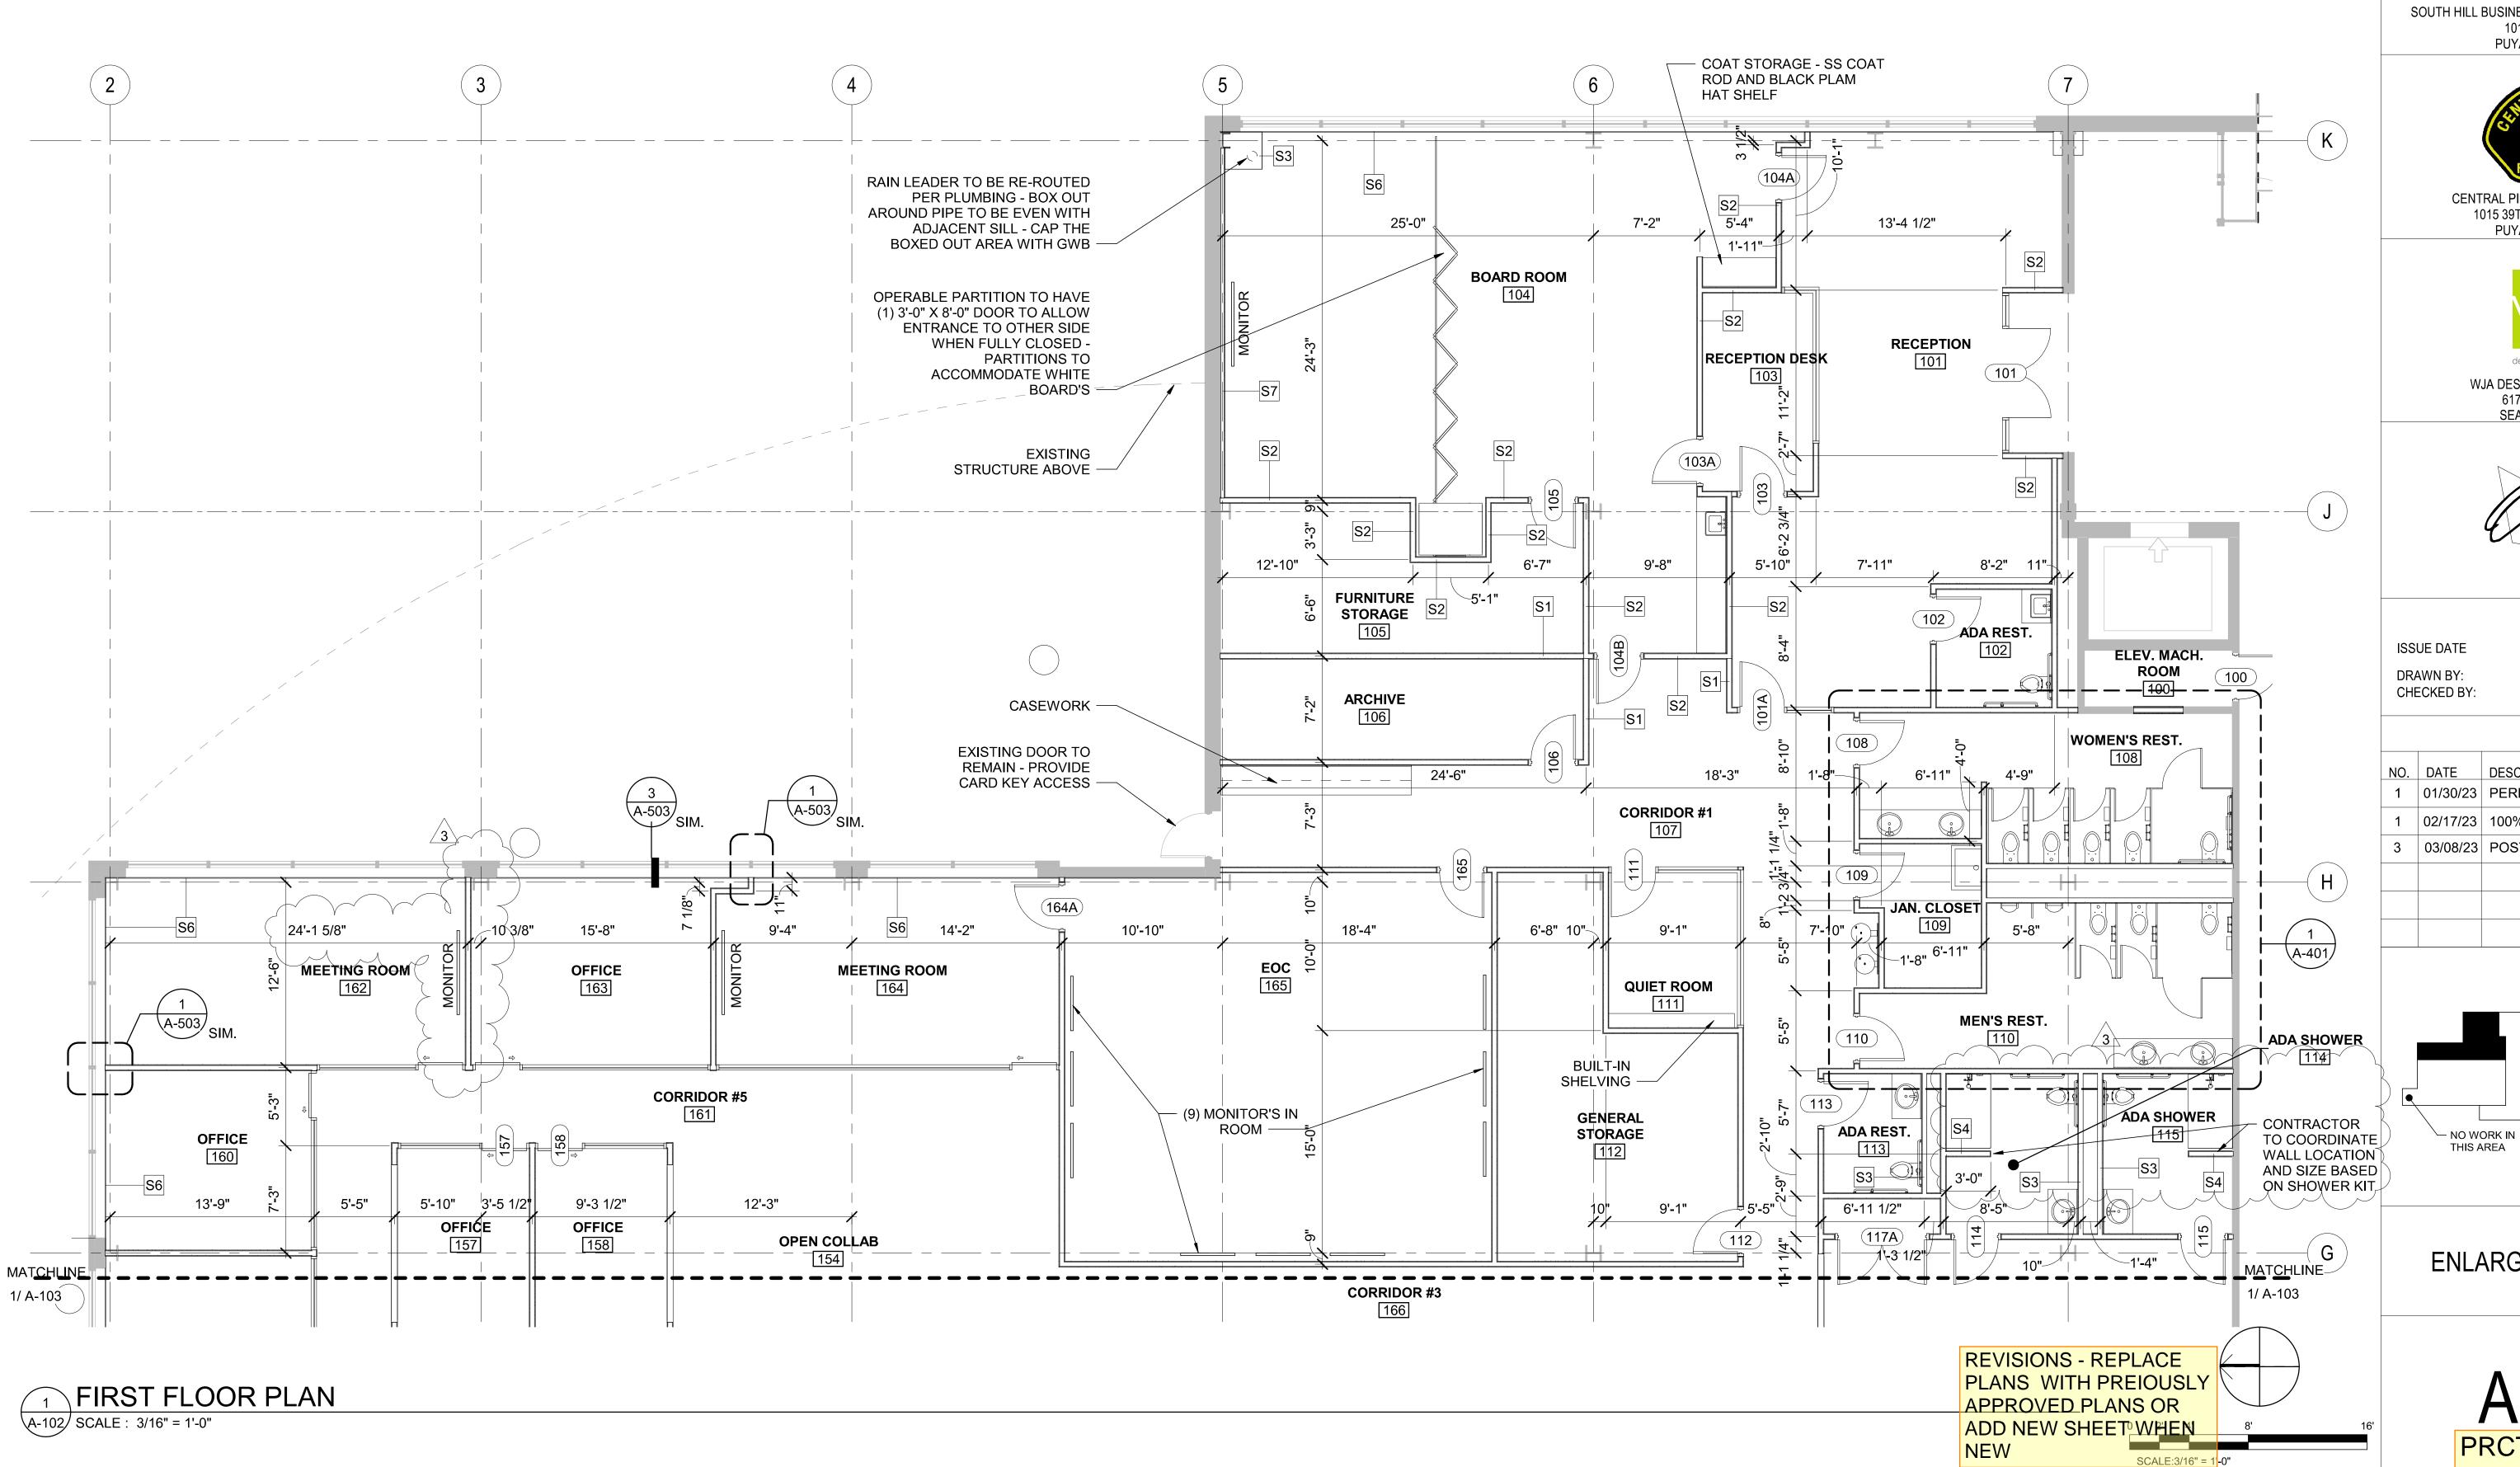SHEET NUMBER



FLOOR PLAN GENERAL NOTES

- REFERENCE SHEET A-001 FOR ABBREVIATIONS, SYMBOL LEGENDS, ADDITIONAL DRAWING CONVENTIONS AND GENERAL NOTES.
- REFERENCE SHEET A-601 FOR WALL AND CEILING TYPES, SHEET A-602 FOR DOOR TYPES, AND SHEET A-603 FOR WINDOW TYPES.
- PLAN VIEWS ARE CUT AT 4'-0" AFF.

City of Puyallup

ISSUED PERMIT

Building

Engineering

Fire

lopment & Permitting Services

Planning

Public Works

Traffic

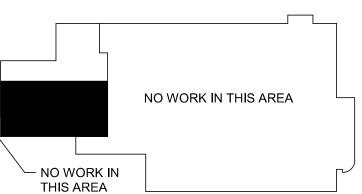
- ALL INTERIOR DOORS TO BE CENTERED IN ROOM OR 4" FROM ADJACENT FACE OF WALL AS SHOWN UNLESS OTHERWISE NOTED.
- SEE SHEET A-002 AND A-003 FOR ACCESSIBLE DETAILS.
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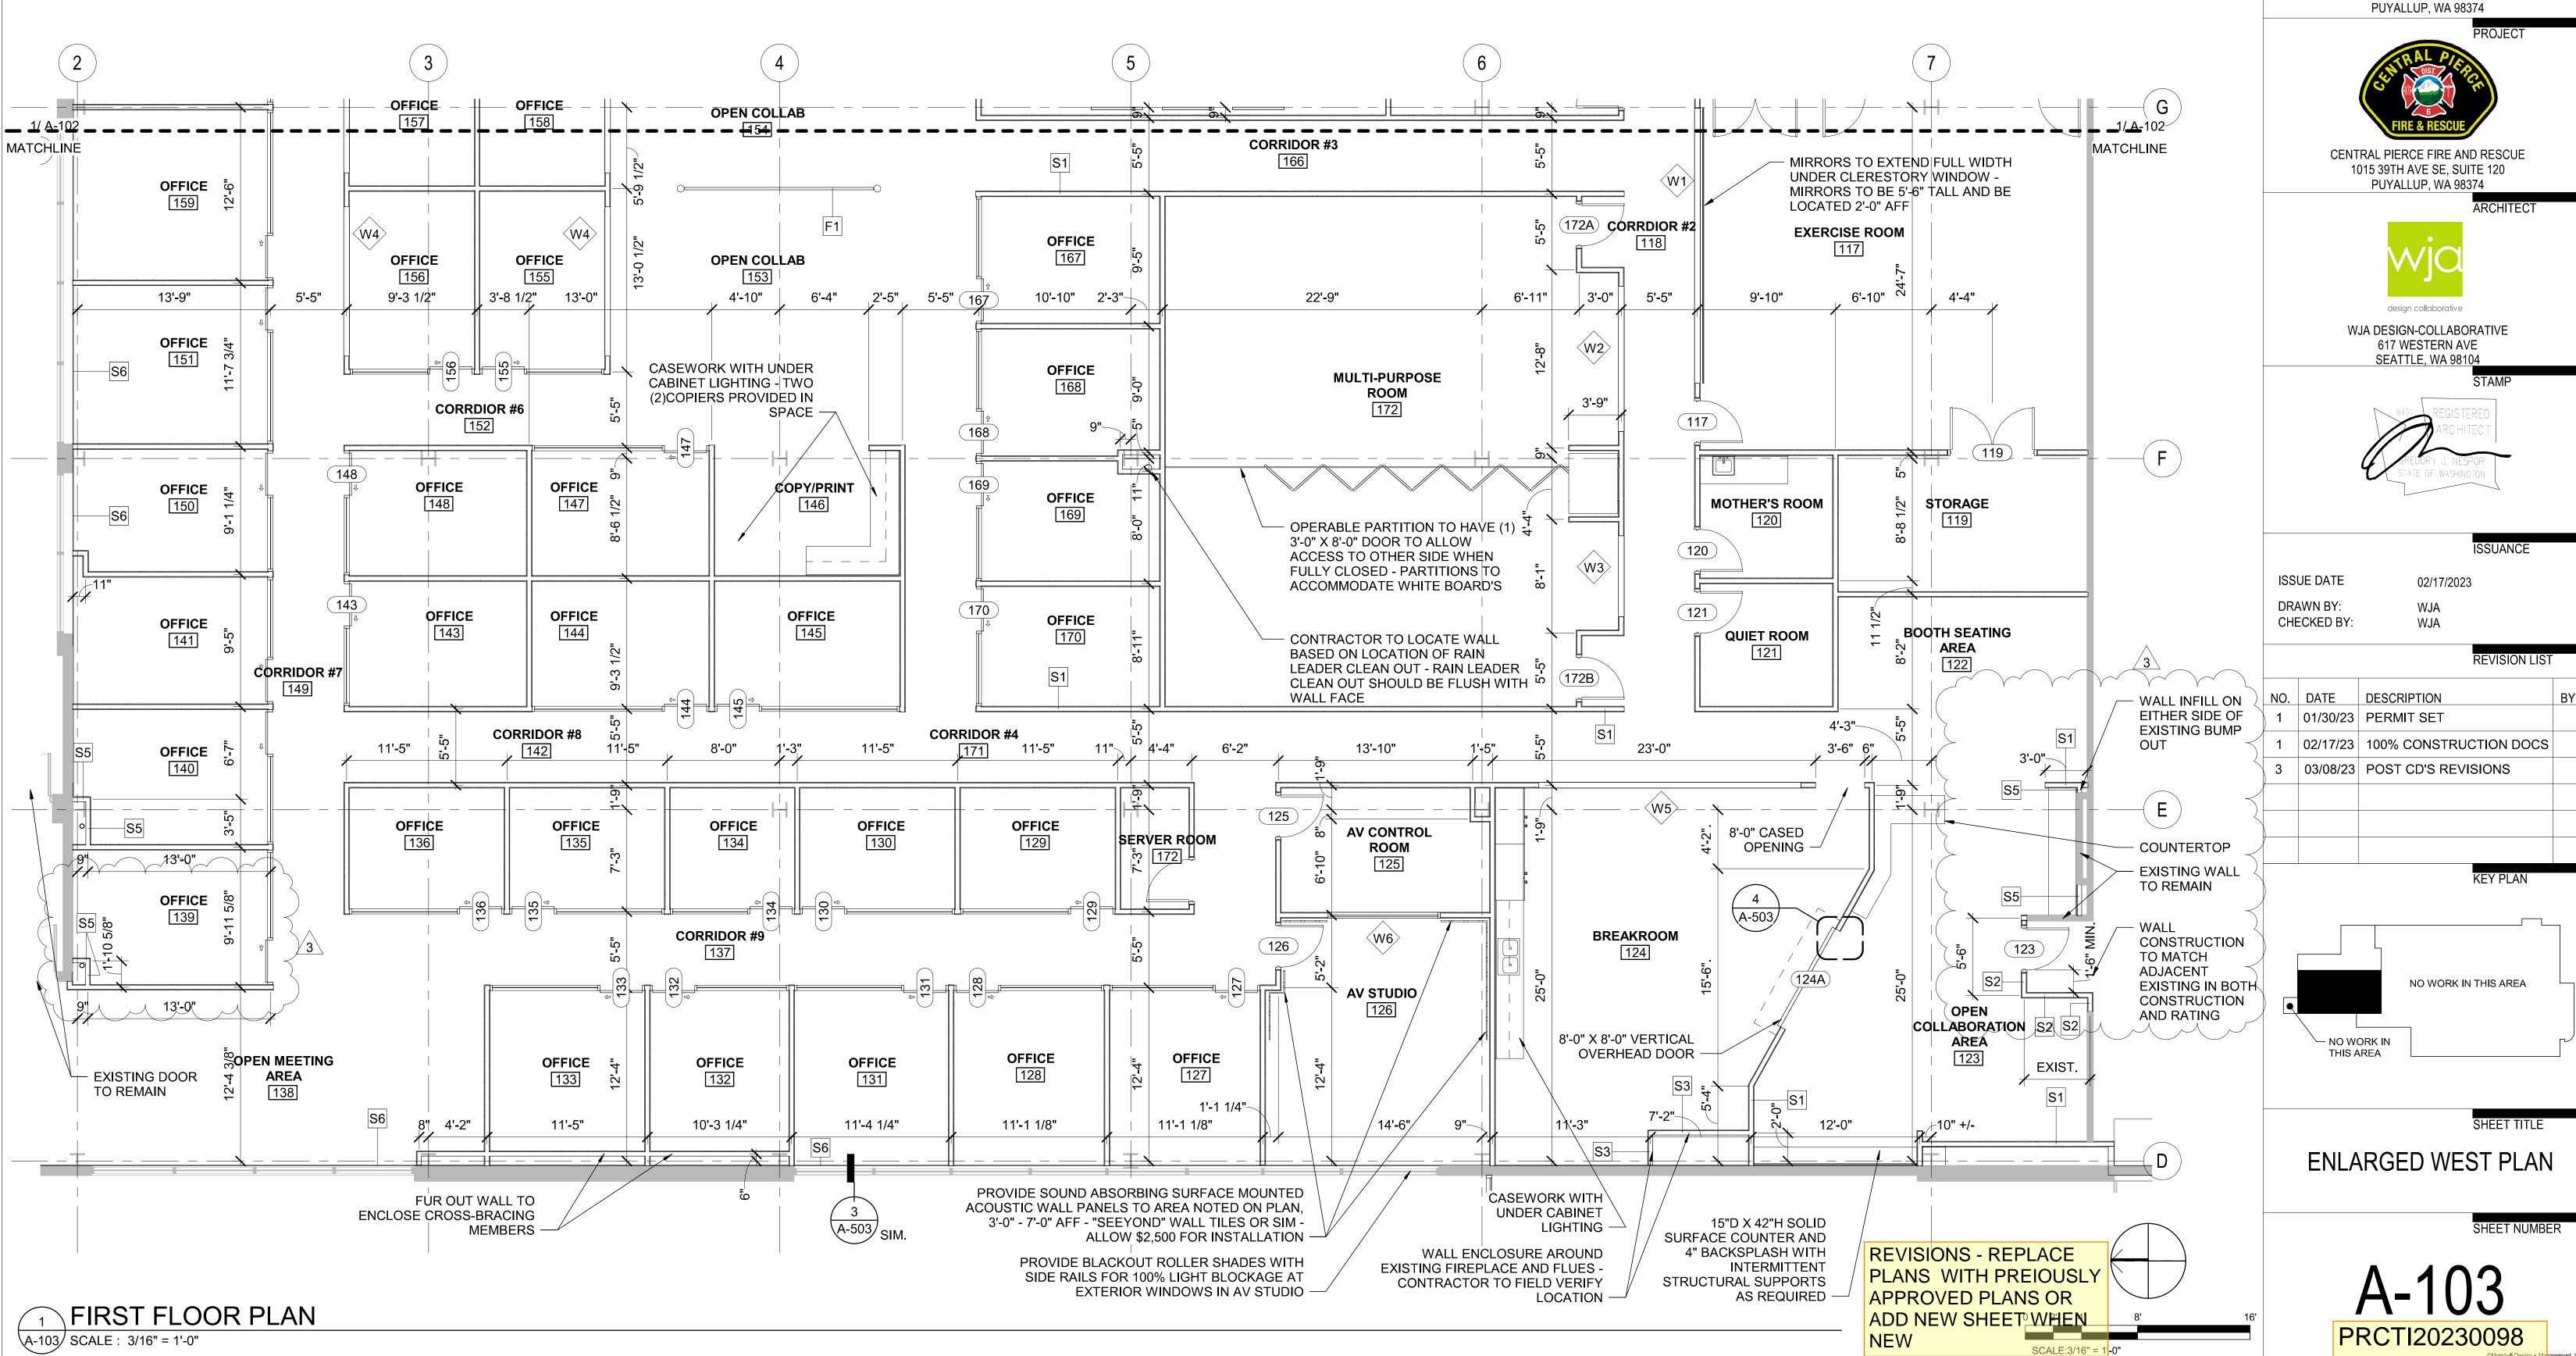
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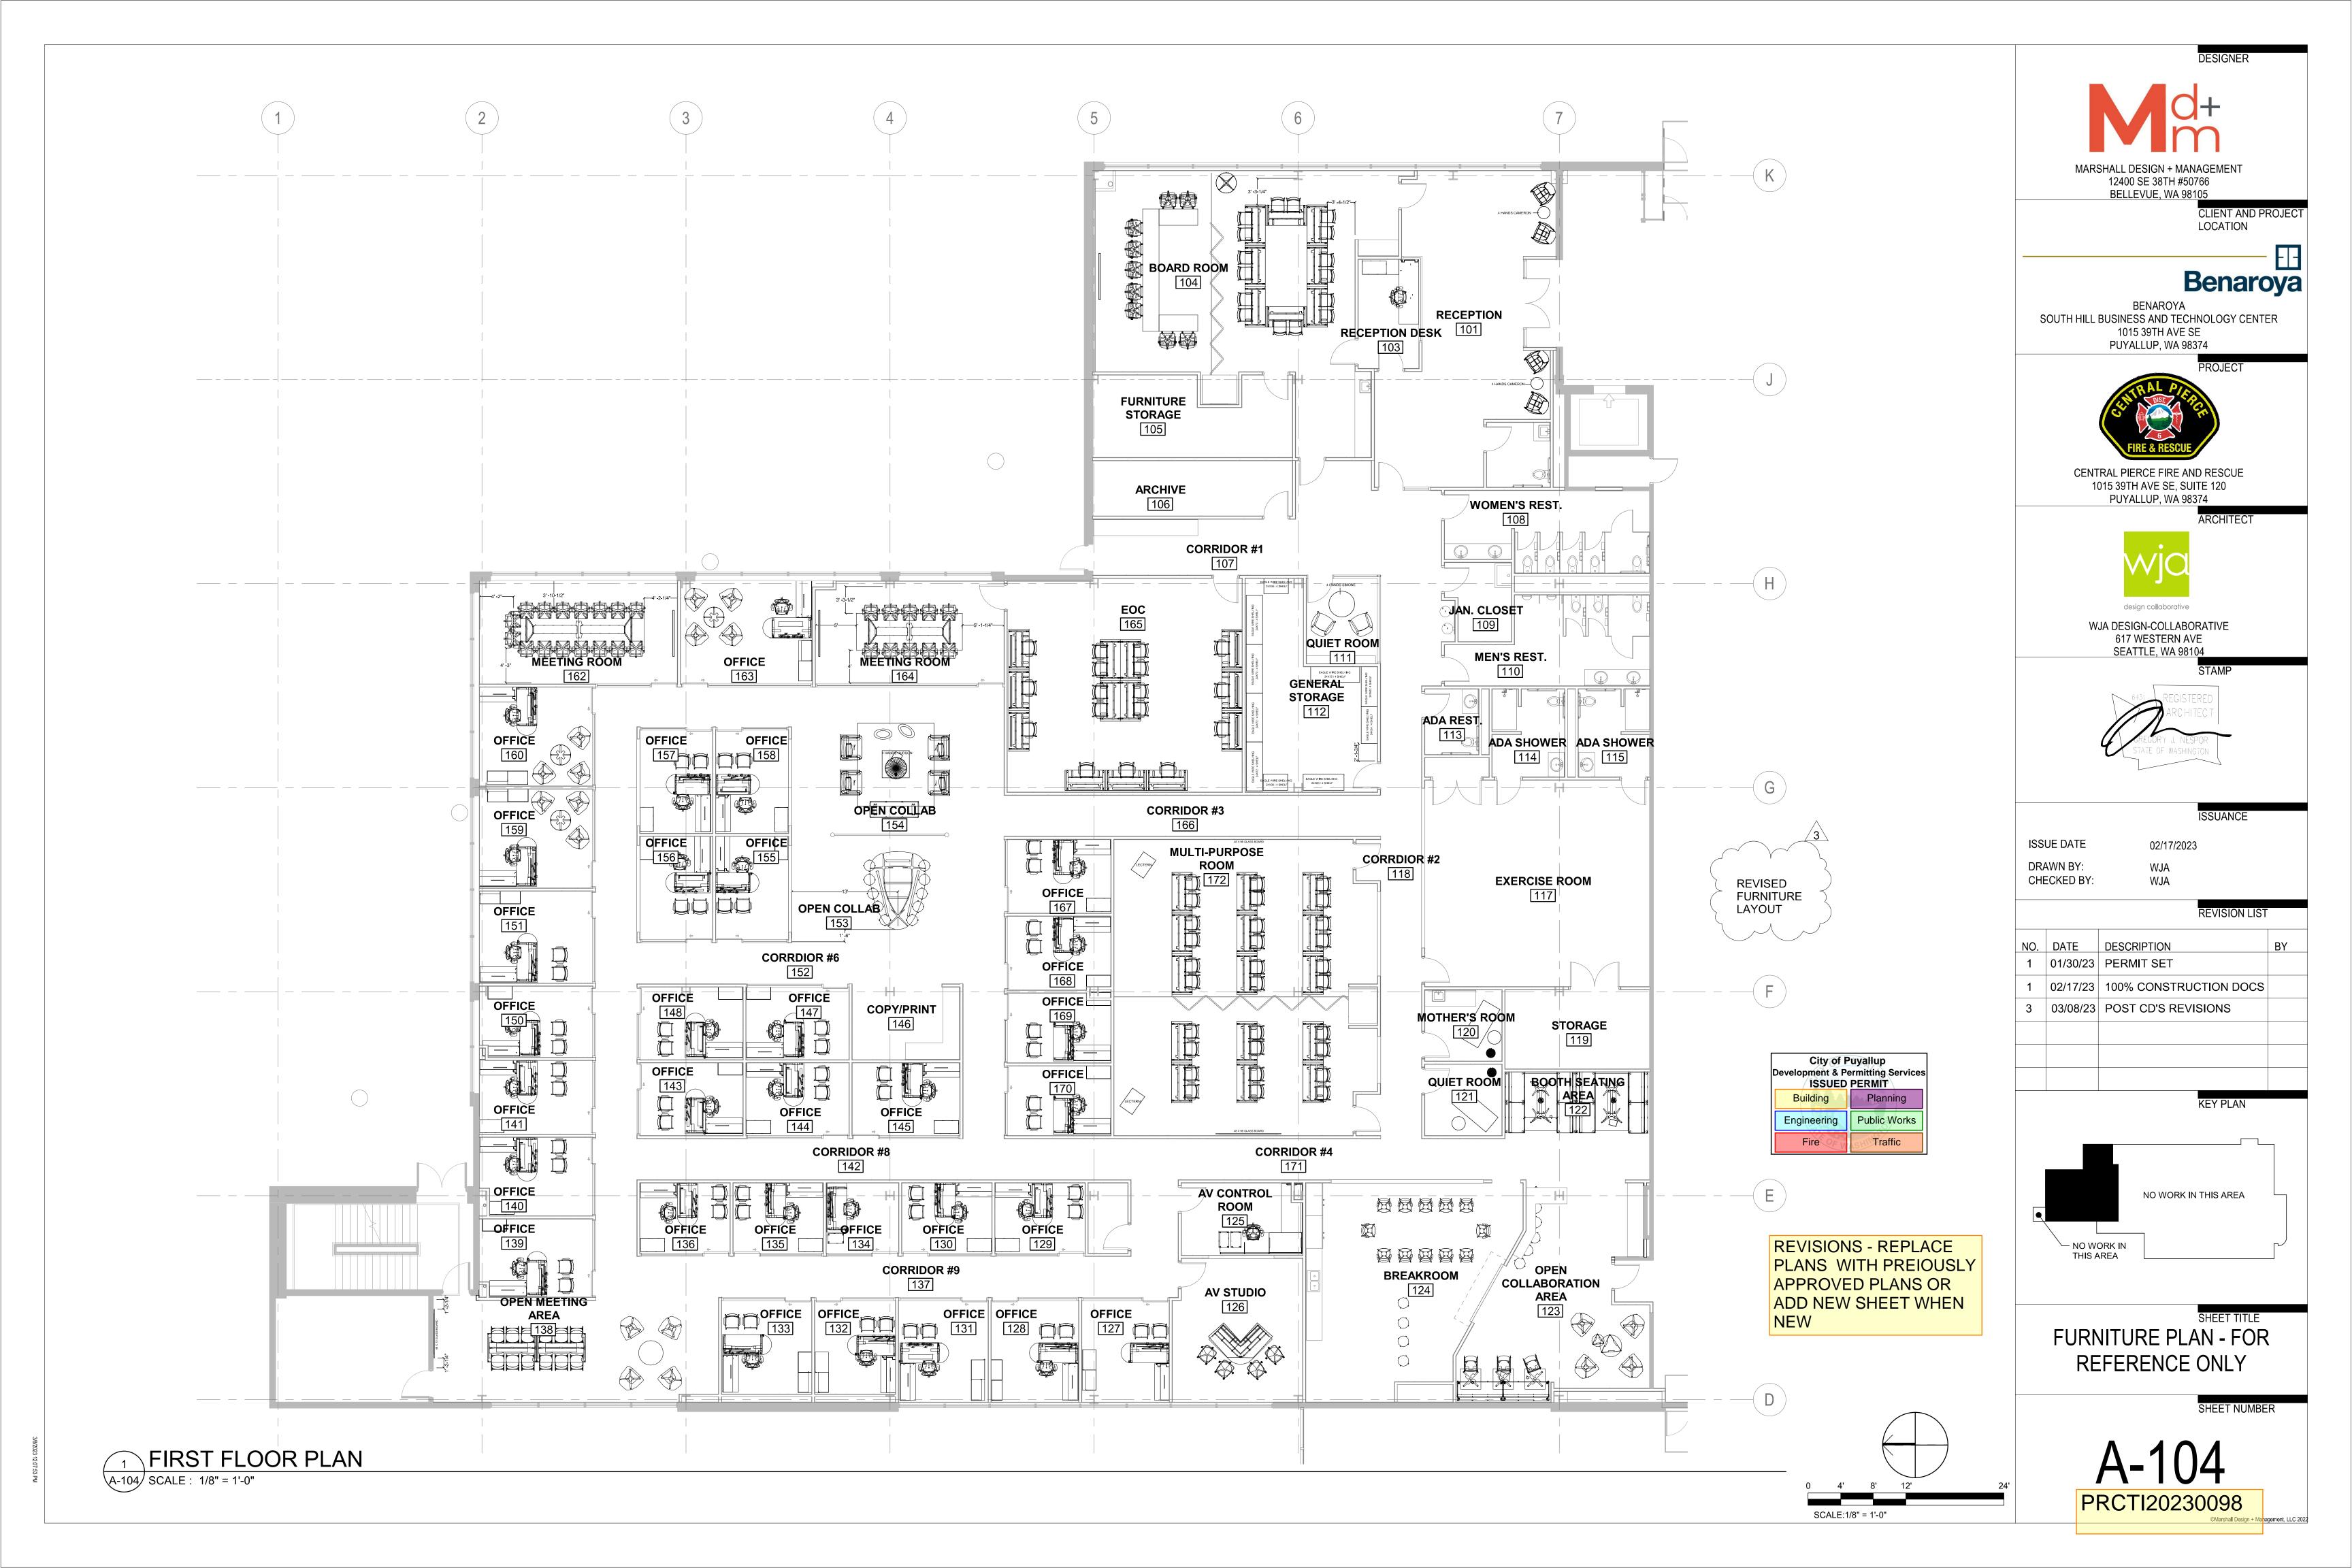





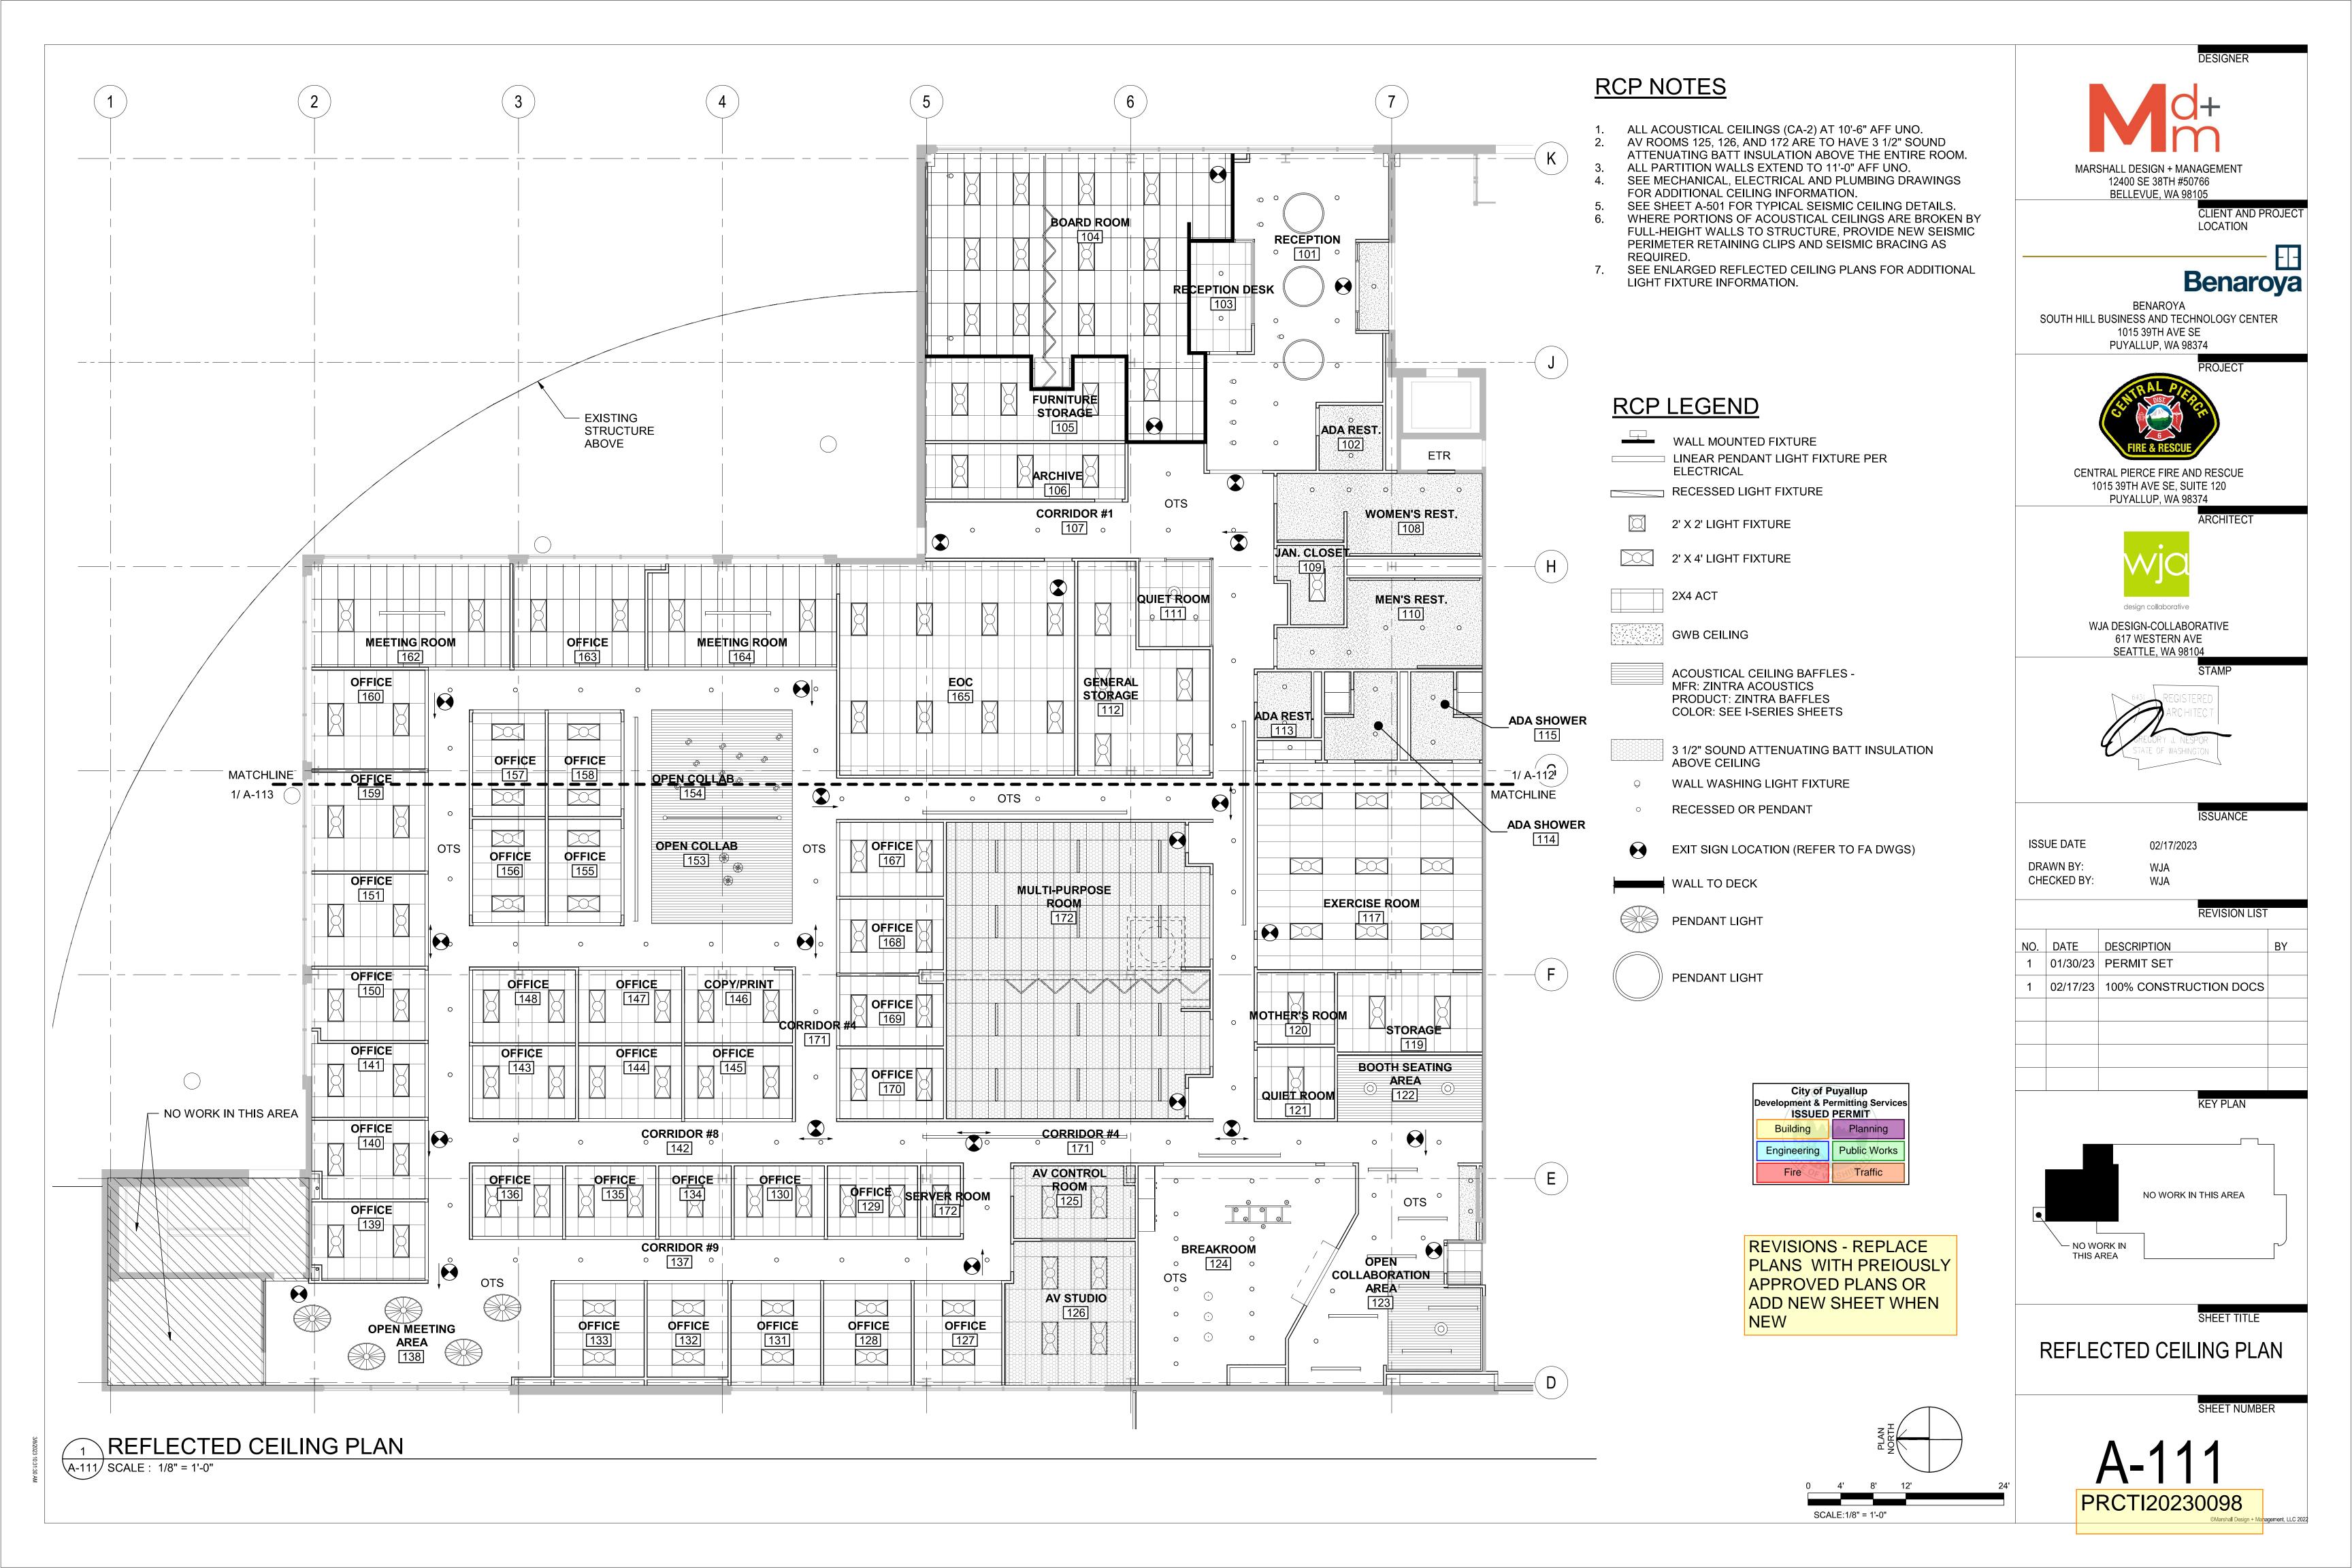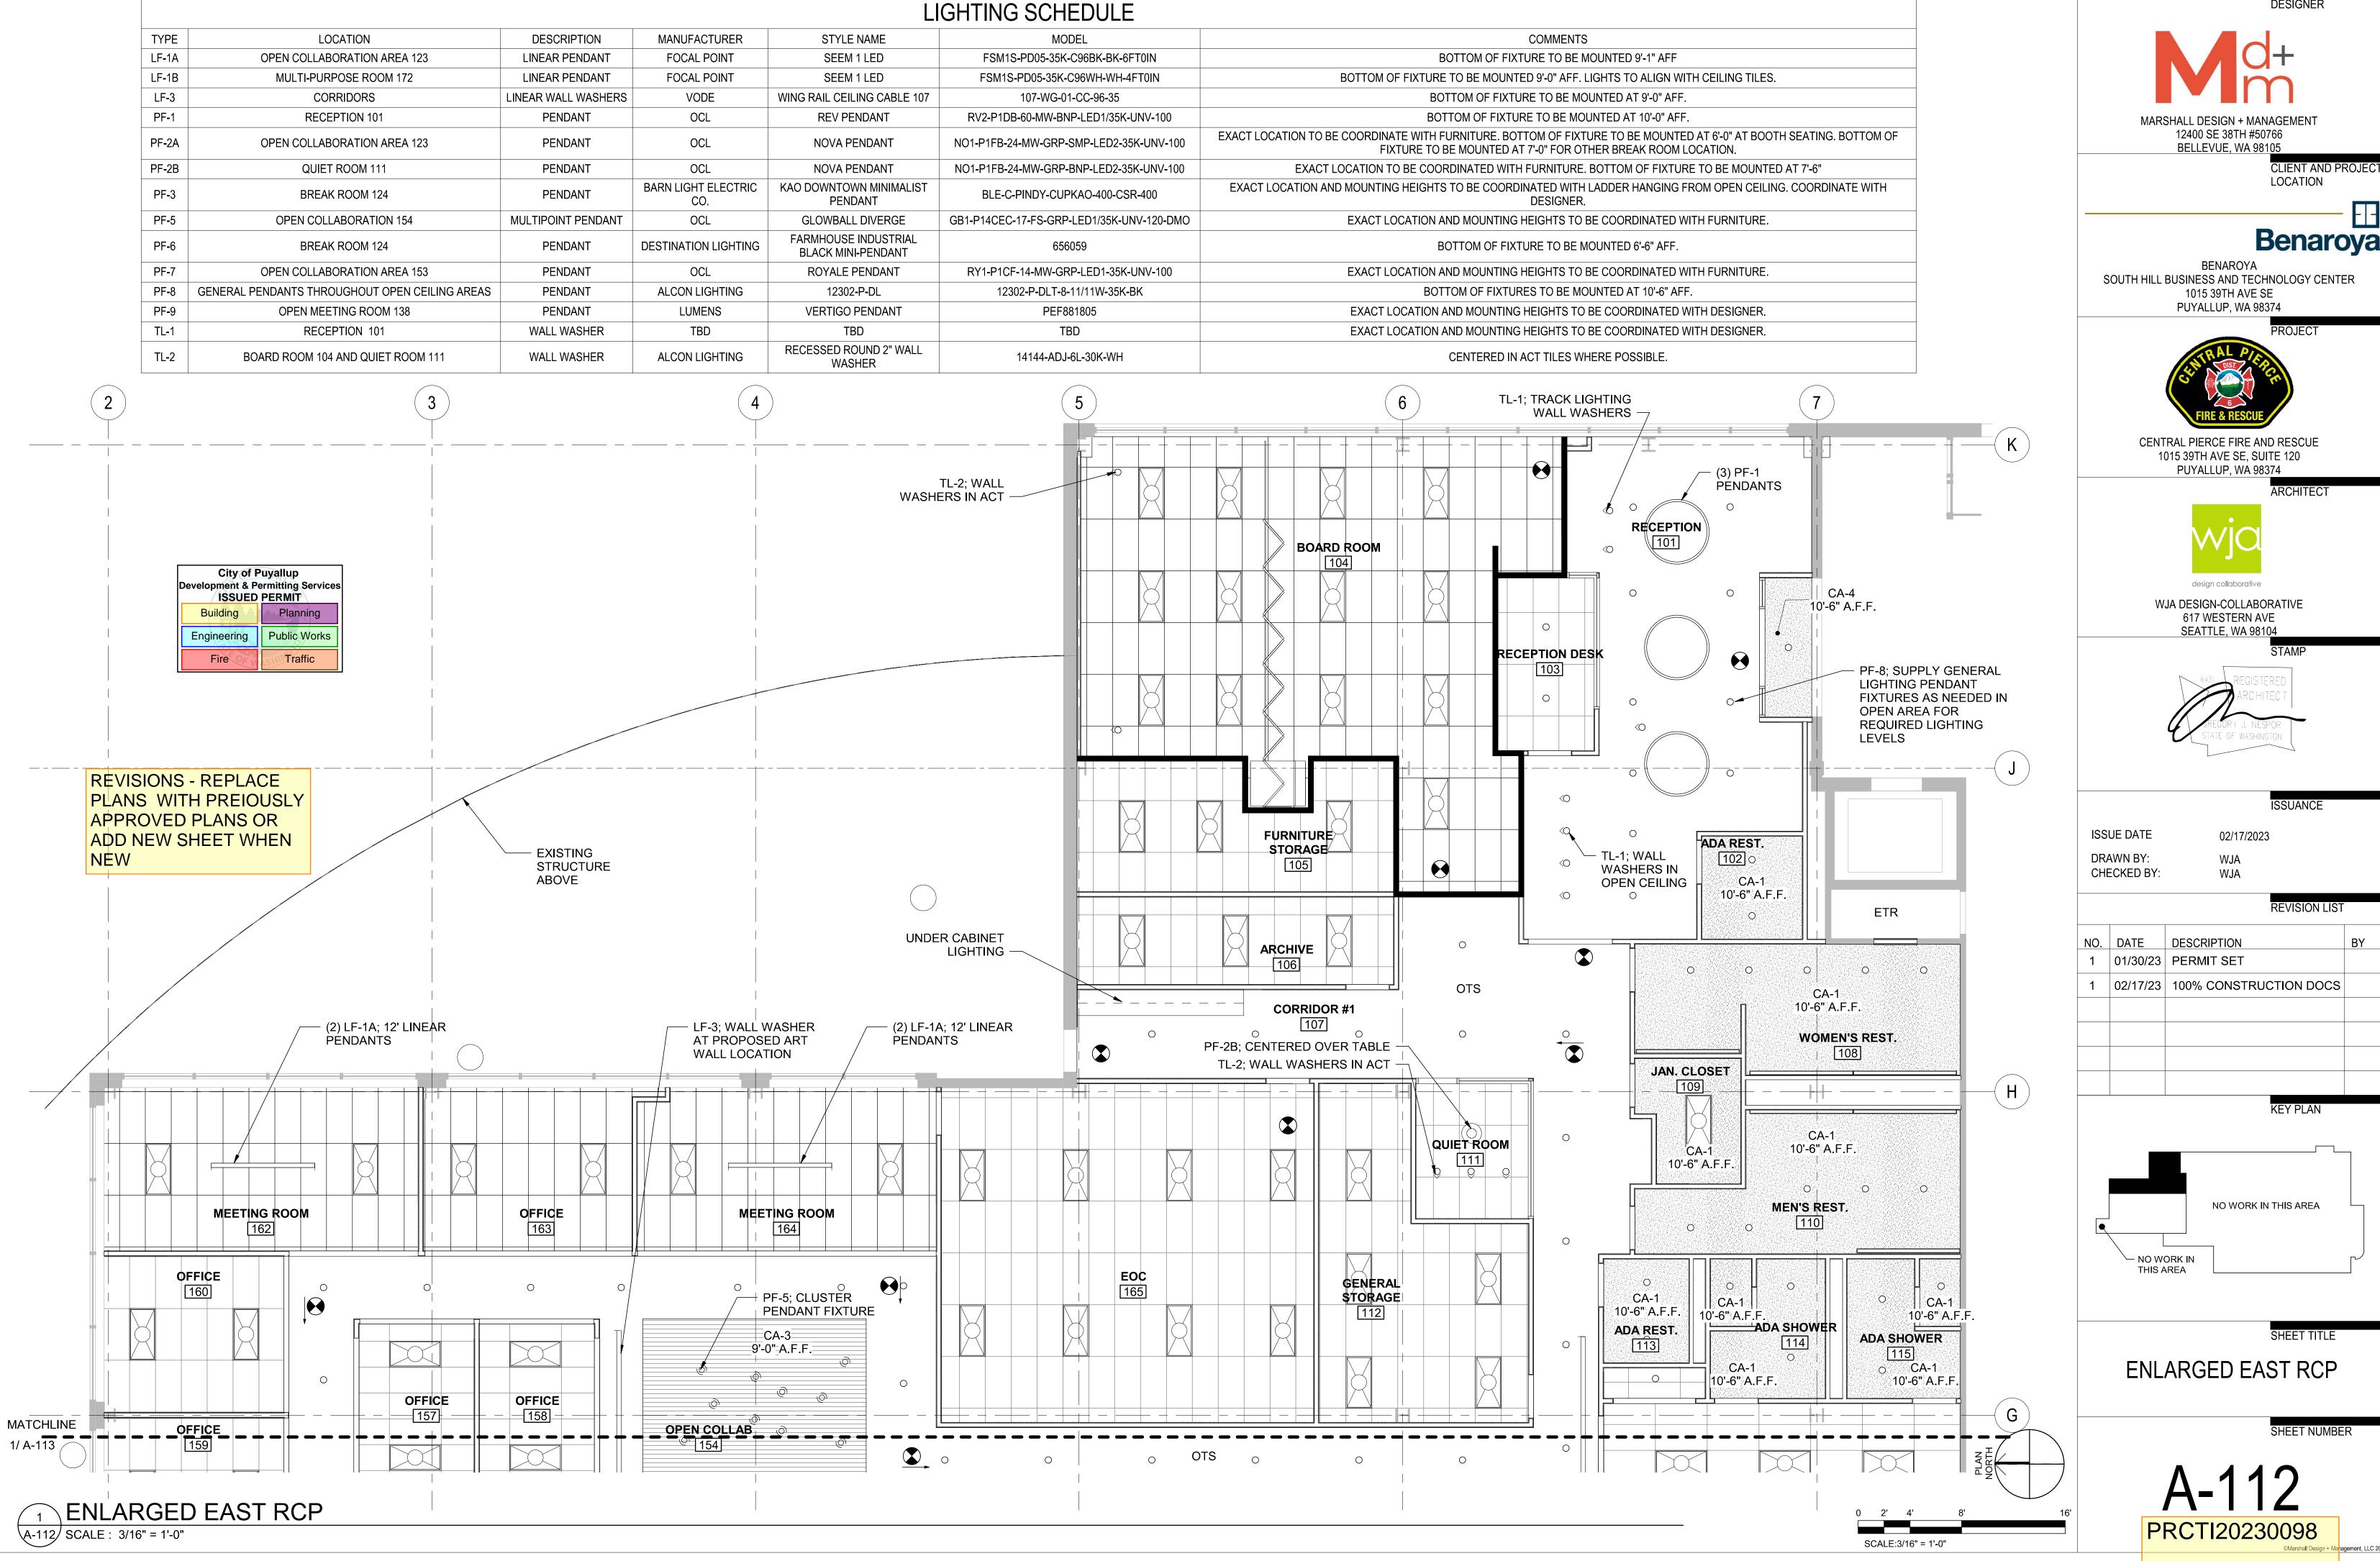
BENAROYA SOUTH HILL BUSINESS AND TECHNOLOGY CENTER 1015 39TH AVE SE

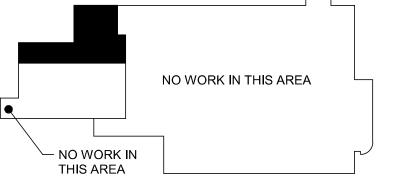


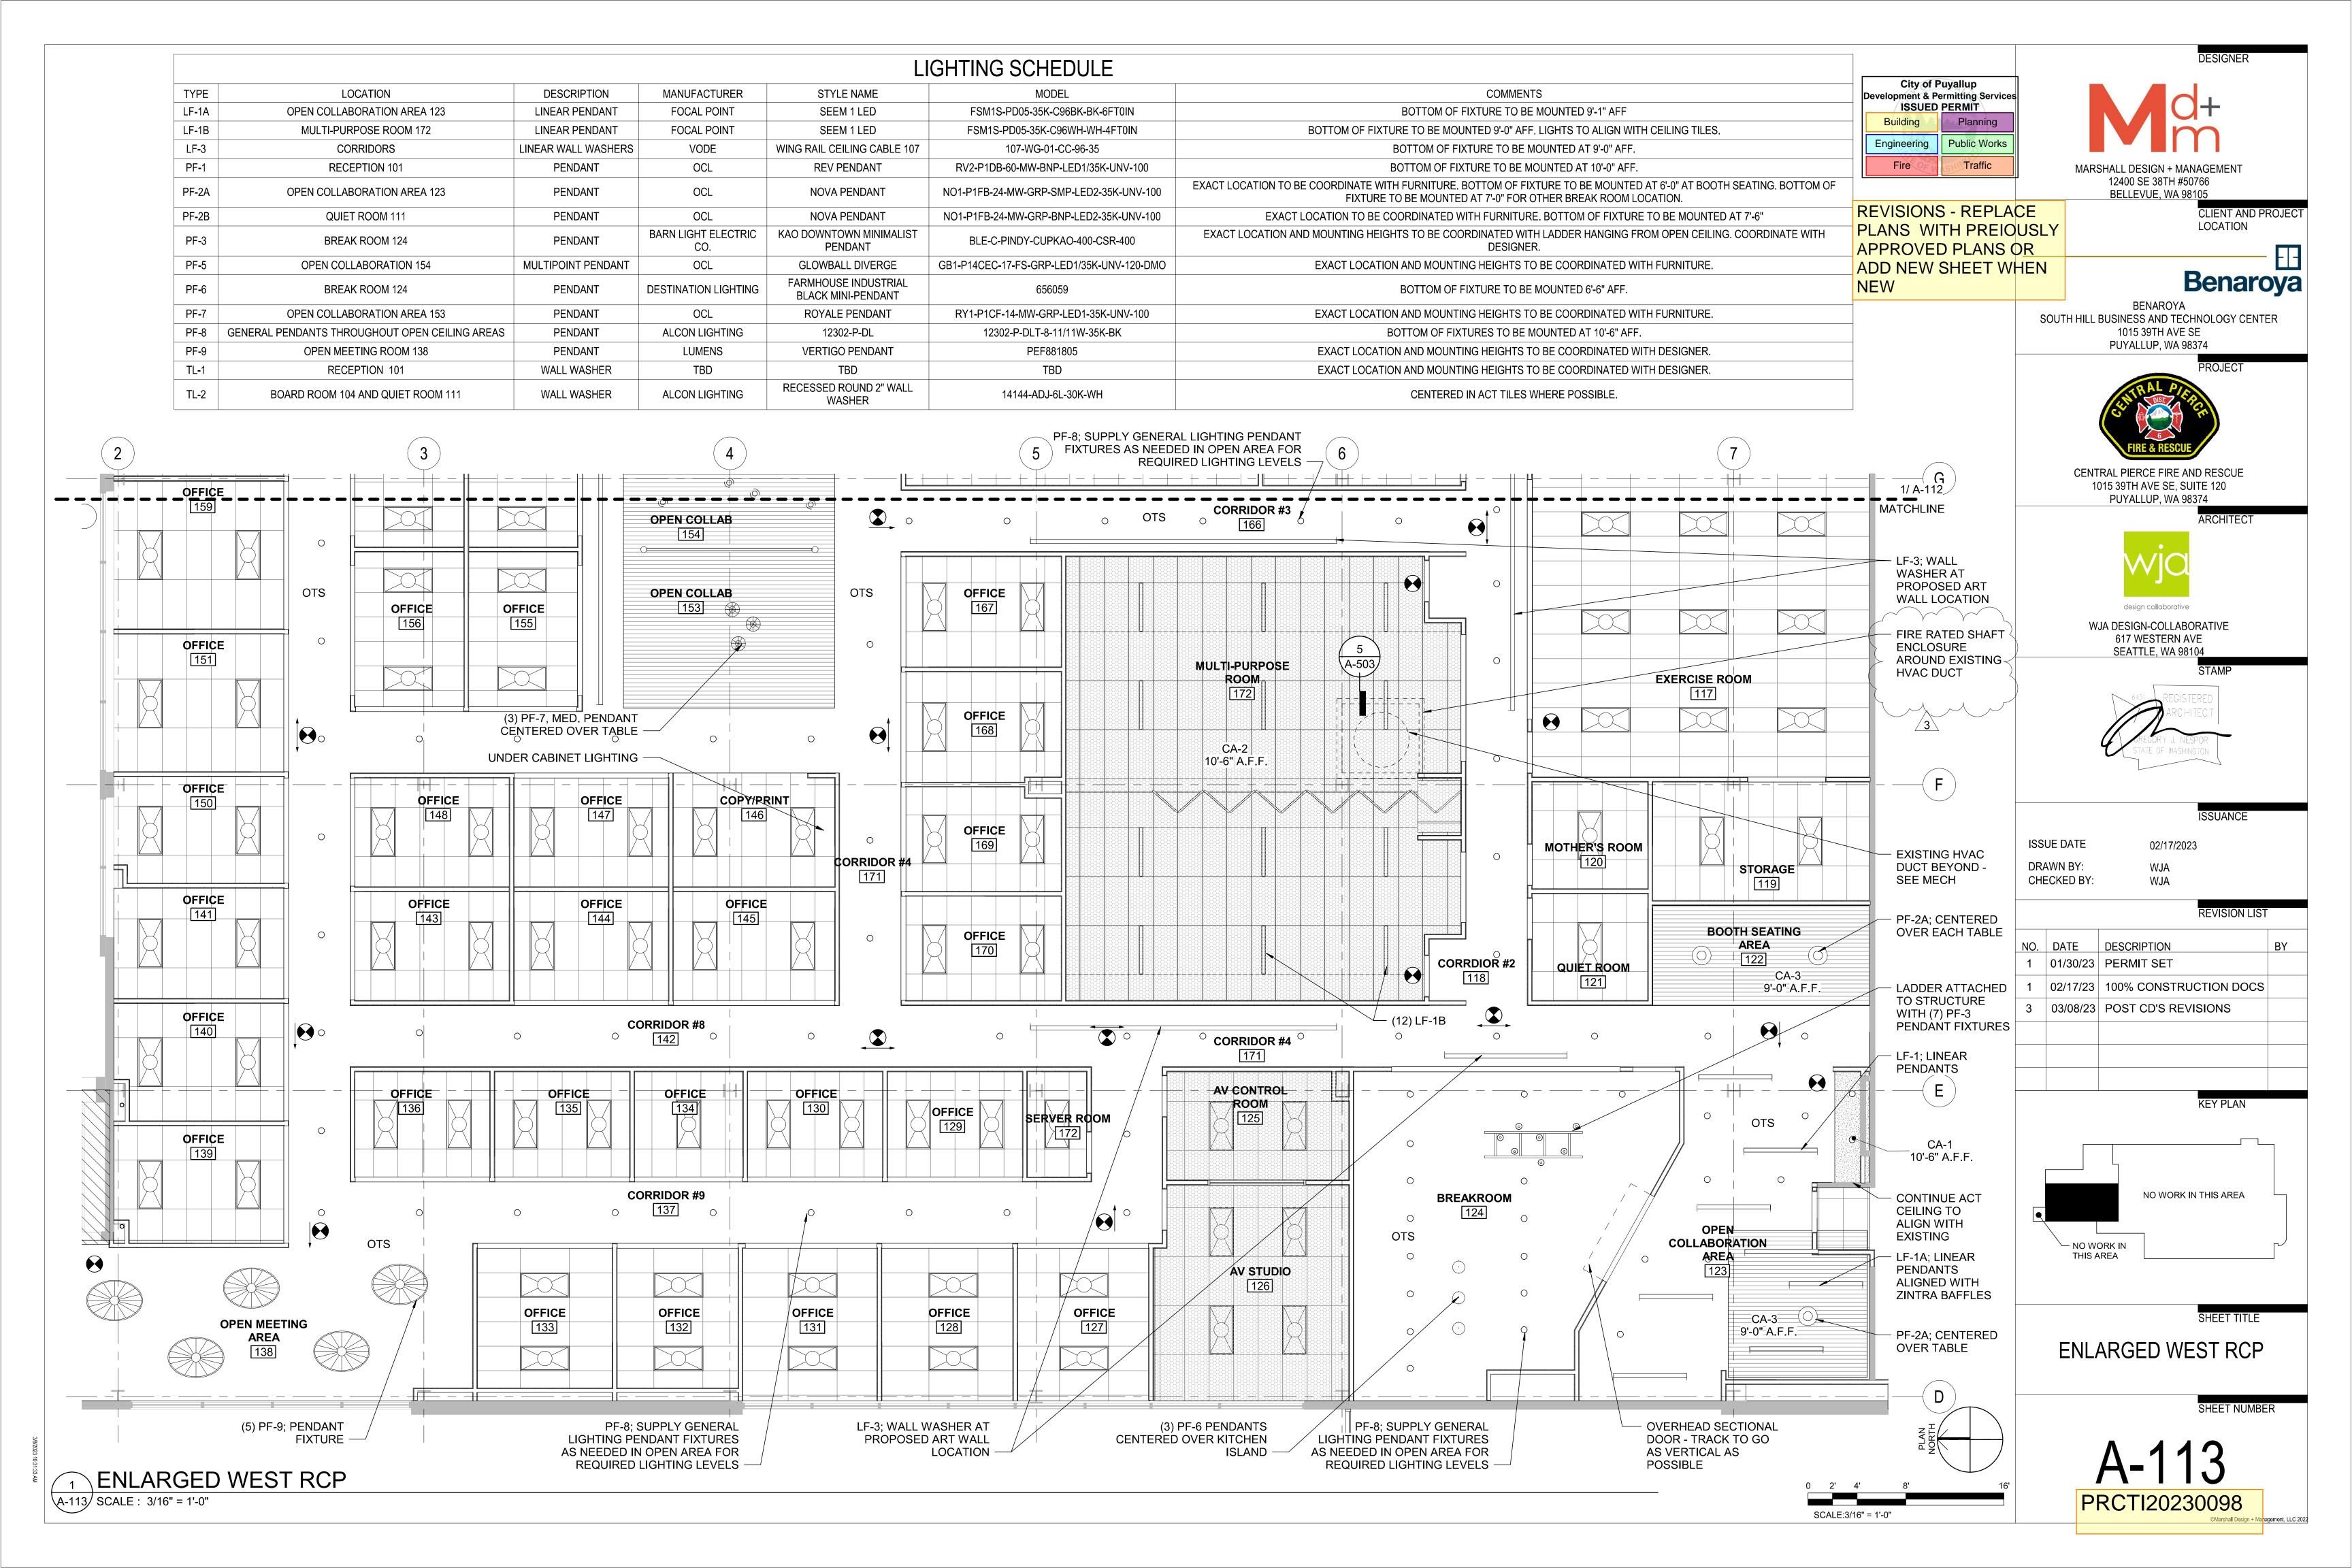


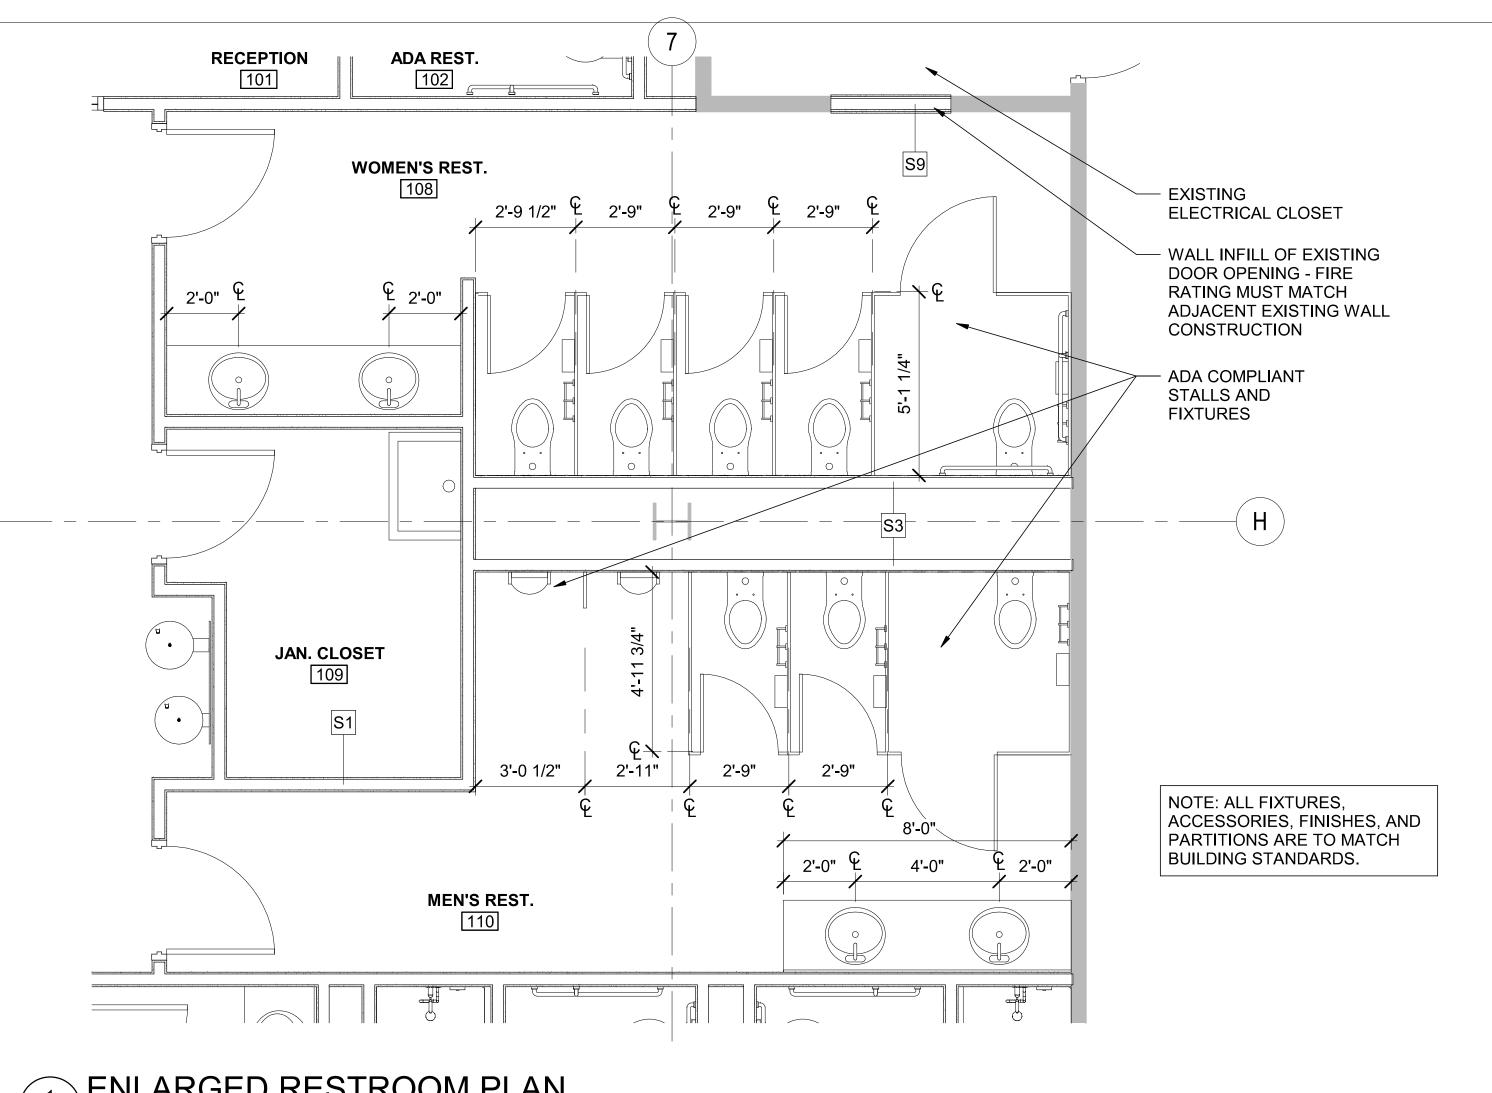












GRAB ·

/ SCALE : 1/2" = 1'-0"

BARS (GB)

SEE SHEET A-002

FOR TOILET TISSUE DISPENSER (TTD)

MOUNTING RANGE

MOP RACK/SHELF COMBO TOWEL DISPENSER (MRS) (TD)

MOUNTING HEIGHTS

SANITARY

NAPKIN DISPOSAL

TOWEL BAR (TB)

(SND)

RECESSED TOILET SEAT COVER

DISPENSERS (TSCD)

MIRROR

- WATER CLOSETS (REGULAR AND ADA)



- ALL MOUNTING HEIGHTS APPLY THROUGHOUT UNO.
- 2. SEE SHEET A-002 FOR ACCESSIBILITY REQUIREMENTS
- SEE SHEET A-002 FOR TOILET PAPER DISPENSER MOUNTING RANGE



CLIENT AND PROJECT

Benaroya

LOCATION

BENAROYA SOUTH HILL BUSINESS AND TECHNOLOGY CENTER 1015 39TH AVE SE PUYALLUP, WA 98374



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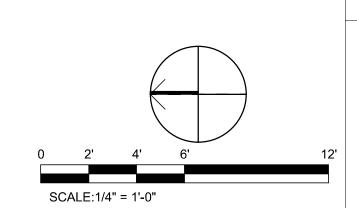
KEY PLAN


ENLARGED RESTROOM PLAN AND MOUNTING HEIGHTS

> SHEET NUMBER PRCTI20230098

City of Puyallup evelopment & Permitting Services
ISSUED PERMIT Building Public Works Engineering Fire Traffic

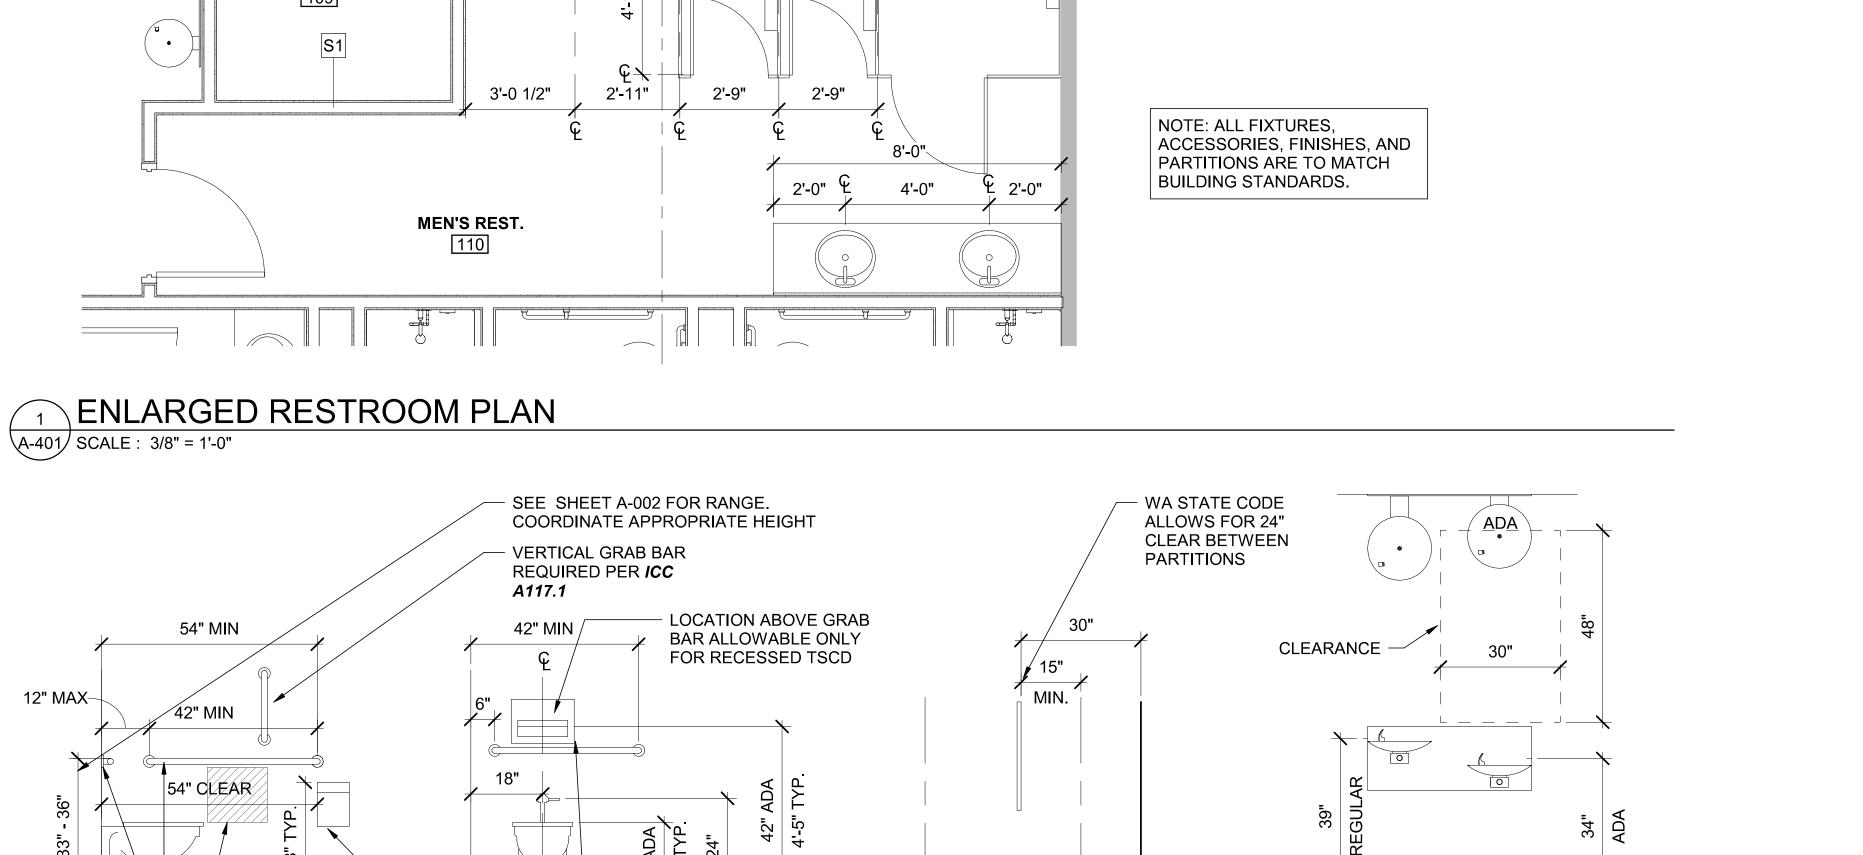REVISIONS - REPLACE PLANS WITH PREIOUSLY APPROVED PLANS OR ADD NEW SHEET WHEN NEW





URINALS (REGULAR AND ADA)

WASTE RECEPTACLE

NOTE: WHERE URINAL PARTITION DEPTH

IS GREATER THAN 2'-0", A CLEAR WIDTH OF 3'-0" MUST BE MAINTAINED.

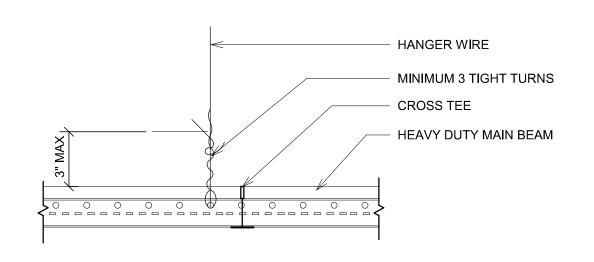
DRINKING FOUNTAINS (DF)

ELECTRIC HAND DRYER HOOK STRIP '3 HOOKS' ADA DOOR (EHD) (HS) PUSH BUTTON


36" MIN/

LIGHT SWITCH


- OUTLET



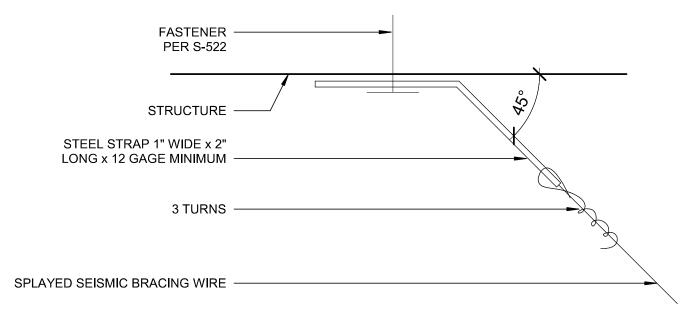
HANGER WIRE CONNECTION \A-501/ SCALE : 3" = 1'-0"



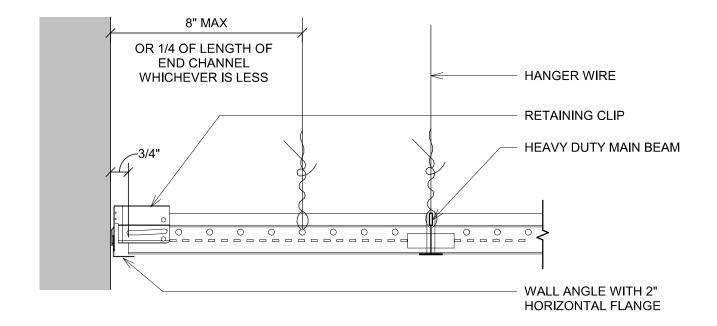3 SPLAYED SEISMIC BRACING WIRE ATTACHMENT1



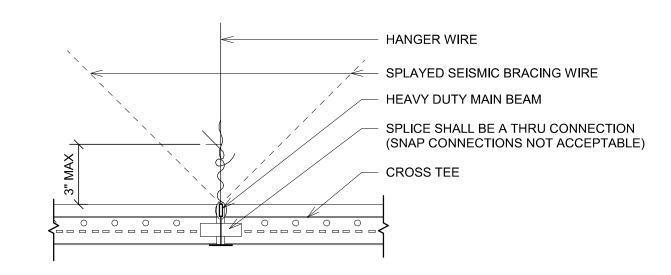RETAINING CLIP @ PERIMETER CROSS TEES \A-501\ SCALE : 3" = 1'-0"



4 RUNNER SPLICE \A-501/ SCALE : 3" = 1'-0"

GENERAL NOTES:

\A-501/ SCALE : 12" = 1'-0"

ALL COMPONENTS OF CEILING GRID SHALL BE CLASSIFIED "HEAVY DUTY" AT THE PERIMETER OF THE CEILING AREA, WHERE MAIN OR CROSS RUNNERS ARE NOT CONNECTED TO THE ADJACENT WALL, PROVIDE INTERCONNECTION BETWEEN THE RUNNERS TO PREVENT LATERAL SPREADING. WHERE THE PERPENDICULAR DISTANCE FROM THE WALL TO THE FIRST PARALLEL RUNNER IS 8" OR LESS, THIS INTERLOCK IS NOT REQUIRED.

COMPRESSION STRUTS:

- COMPRESSION STRUTS SHALL NOT REPLACE HANGER WIRES.
- ATTACH COMPRESSION STRUTS TO MAIN BEAMS WITHIN 2" OF CROSS TEE. THE ATTACHMENT AT THE TOP SHALL BE CAPABLE OF SUPPORTING FOUR TIMES THE WEIGHT OF THE STRUT.

	6'-0" MAX	12'-0" MAX	/	2'-0" IAX	6'-0" MAX	
6'-0" MAX						ADDITIONAL CROSS TEES WHERE 2'-0" X 2'-0" GRID OCCURS
12'-0" MAX						CROSS TEES @ 2'-0" OC
					0	MAIN BEAMS @ 4'-0" OC 12 GAUGE VERTICAL
12'-0" MAX					0	HANGER WIRES @ 4'-0" OC MAX TYP REF. ISOMETRIC
6'-0" MAX					•	DIAGRAM (RIGHT) —— 12 GAUGE HANGER WIRES @ PERIMETER
8	8" MA LENG BEAN	X OR 1/4 THE TH OF THE M/CROSS TEE CHEVER IS	WI GF	DIAGONAL BR IRES @ 12'-0" X RID MAX, SEE D	ACE 12'-0" DETAIL	TYP


<u>PLAN</u>

STEEL SECTION WITH L/R RATION OF 200 MAXIMUM. ATTACH TO MAIN RUNNERS WITH 1/4" M.B. AND TO STRUCTURE. COMPRESSION STRUT SHALL NOT REPLACE HANGER WIRE

_	LENGTH	REQ	STRUT	R	SUPP.			
	4'	0.24 IN	158IU20	0.410				
4.4/4"			_ 250IU20 350IU20	0.399 0.382				
1 1/4"	6'	0.36 IN	400IU20	0.380				
	8'	0.48 IN	C3 5/8xC20	0.594				
1 5/8"	10'	0.60 IN	C3 5/8xC20	0.594				
1 5/0	* STUDS & PROPERTIES AS LISTED BY STEEL STUD							

TYPICAL
12 GA. VERTICAL HANGAR WIRE @ 4'-0" EA. WAY W/ MIN. 3 TIGHT TURNS IN 1 1/2" BOTH ENDS OF WIRE

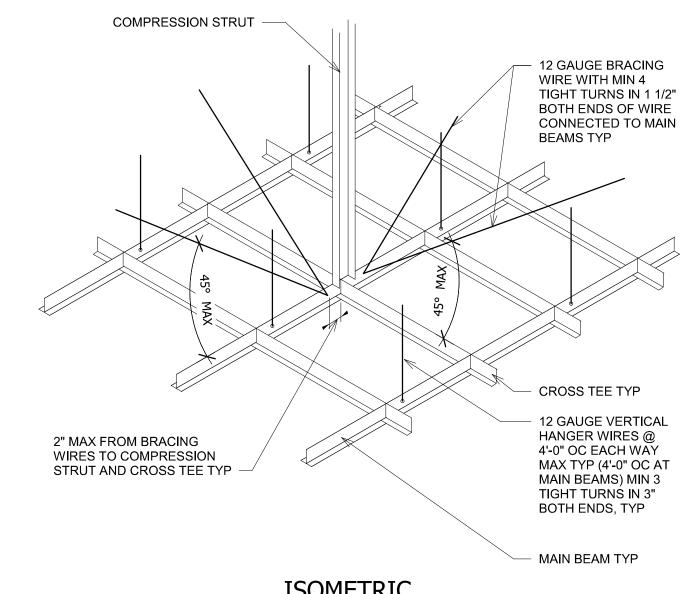MANUFACTURER'S ASSOCIATION



VERTICAL HANGAR WIRE ATTACHMENT

FASTENER

PER S-522

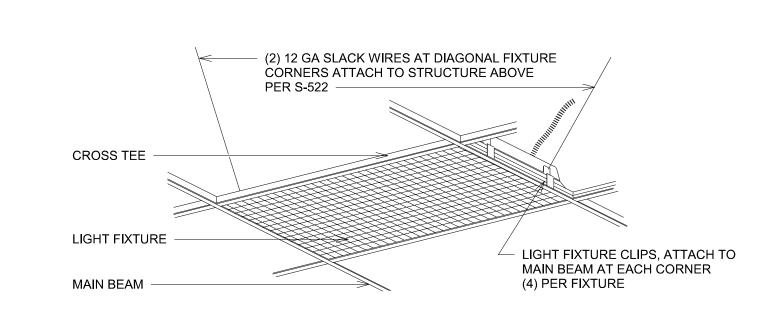
STRUCTURE

CEILING CLIP

VERTICAL HANGAR WIRE

A-501/ SCALE : 12" = 1'-0"

3 TURNS



SEISMIC SUPPORT @ LIGHT FIXTURE A-501 SCALE: 12" = 1'-0"

SUSPENDED CEILING NOTES:

NOTE: SEISMIC REQUIREMENTS FOR SUSPENDED CEILINGS. REFERENCE 2018 INTERNATIONAL BUILDING CODE SECTION 808. ACOUSTICAL TILE OR LAY-IN PANEL CEILINGS SHALL BE DESIGNED AND INSTALLED IN ACCORDANCE WITH ASTM C 635, C 636 AND ASTM E 580.

- A. A HEAVY DUTY T-BAR GRID SYSTEM SHALL BE USED.
- THE WIDTH OF THE PERIMETER CLOSURE ANGLE SHALL BE NOT LESS THAN 2". WHERE PERIMETER SUPPORTING CLIPS ARE USED, THEY SHALL BE QUALIFIED IN ACCORDANCE WITH APPROVED TEST CRITERIA. IN EACH ORTHOGONAL HORIZONTAL DIRECTION, ONE END OF THE CEILING GRID SHALL BE ATTACHED TO THE CLOSURE ANGLE. THE OTHER END IN EACH HORIZONTAL DIRECTION SHALL HAVE A 3/4" CLEARANCE FROM THE WALL AND SHALL REST UPON AND BE FREE TO SLIDE ON A CLOSURE ANGLE.
- FOR CEILING AREAS EXCEEDING 1000 SQUARE FEET, HORIZONTAL RESTRAINT OF THE CEILING TO THE STRUCTURAL SYSTEM SHALL BE PROVIDED. THE TRIBUTARY AREAS OF THE HORIZONTAL RESTRAINTS SHALL BE APPROXIMATELY EQUAL. RIGID BRACES ARE PERMITTED TO BE USED INSTEAD OF DIAGONAL SPLAY WIRES. BRACES AND ATTACHMENTS TO THE STRUCTURAL SYSTEM ABOVE SHALL BE ADEQUATE TO LIMIT RELATIVE LATERAL DEFLECTIONS AT POINT OF ATTACHMENT OF CEILING GRID TO LESS THAN 1/4" FOR THE LOADS PRESCRIBED IN ASCE 7-10 SECTION 13.3.1
- FOR CEILING AREAS EXCEEDING 2500 SQUARE FEET, A SEISMIC SEPARATION JOINT OR FULL HEIGHT PARTITION THAT BREAKS THE CEILING UP INTO AREAS NOT EXCEEDING 2500 SQUARE FEET, EACH WITH A RATIO OF THE LONG TO SHORT DIMENSION LESS THAN OR EQUAL TO 4, SHALL BE PROVIDED UNLESS STRUCTURAL ANALYSES ARE PERFORMED OF THE CEILING BRACING SYSTEM FOR THE PRESCRIBED SEISMIC FORCES THAT DEMONSTRATE CEILING SYSTEM PENETRATIONS AND CLOSURE ANGLES PROVIDE SUFFICIENT CLEARANCE TO ACCOMMODATE THE ANTICIPATED LATERAL DISPLACEMENT. EACH AREA SHALL BE PROVIDED WITH CLOSURE ANGLES OR CHANNELS IN ACCORDANCE WITH ITEM B AND HORIZONTAL RESTRAINTS OR BRACING.
- PENETRATIONS IN SUSPENDED CEILINGS SHALL HAVE A 2" OVERSIZED RING, SLEEVE OR ADAPTER THROUGH THE CEILING TILE TO ALLOW FOR FREE MOVEMENT OF AT LEAST 1" IN ALL HORIZONTAL DIRECTIONS.
- CHANGES IN CEILING PLAN ELEVATION SHALL BE PROVIDED WITH POSITIVE BRACING.
- CABLE TRAYS AND ELECTRICAL CONDUITS SHALL BE SUPPORTED INDEPENDENTLY OF THE CEILING.
- SUSPENDED CEILINGS SHALL BE SUBJECT TO THE SPECIAL INSPECTION REQUIREMENTS OF ASCE 7-16 SECTION 11A.1.3.9 WHICH REQUIRE PERIODIC SPECIAL INSPECTIONS DURING THE ANCHORAGE OF SUSPENDED

City of Puyallup evelopment & Permitting Services

ISSUED PERMIT

REVISIONS - REPLACE

APPROVED PLANS OR

ADD NEW SHEET WHEN

PLANS WITH PREIOUSLY

Planning

Public Works

Traffic

Building

Engineering

Fire

NEW

DESIGNER MARSHALL DESIGN + MANAGEMENT 12400 SE 38TH #50766

BELLEVUE, WA 98105

Benaroya

LOCATION

CLIENT AND PROJECT


BENAROYA SOUTH HILL BUSINESS AND TECHNOLOGY CENTER 1015 39TH AVE SE PUYALLUP, WA 98374



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design collaborative WJA DESIGN-COLLABORATIVE 617 WESTERN AVE SEATTLE, WA 98104



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SEISMIC CEILING DETAILS

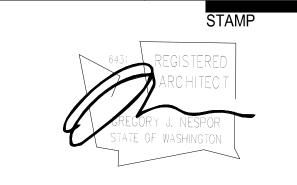SHEET NUMBER

PRCTI20230098

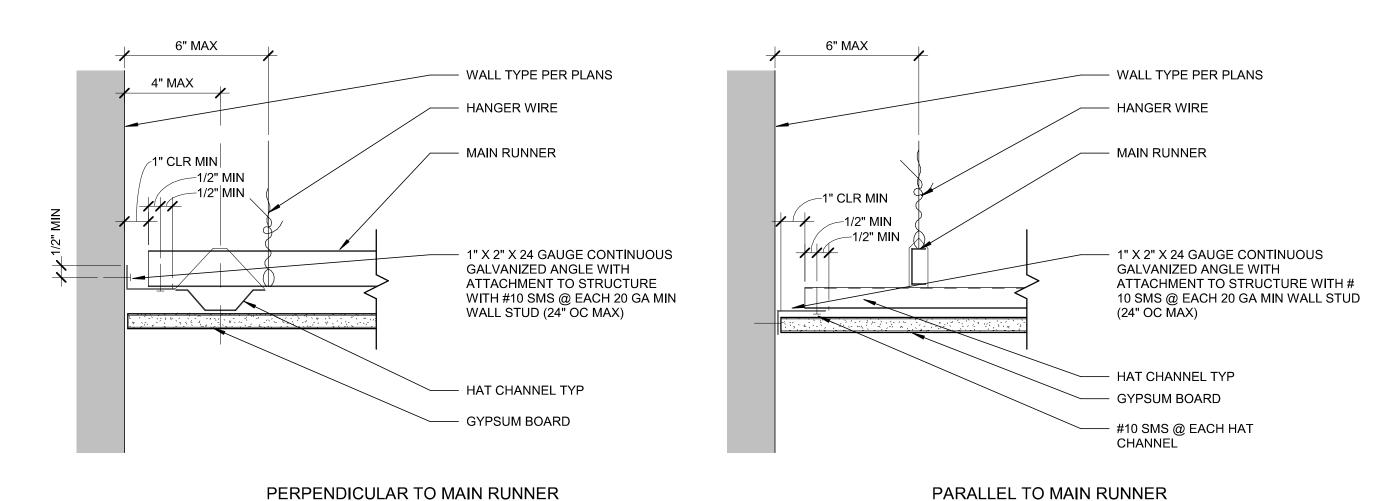
ISOMETRIC (NOT TO SCALE)

5 ACOUSTICAL CEILING SUSPENSION SYSTEM A-501 SCALE : 1/8" = 1'-0"


GYPSUM BOARD CEILING SUSPENDED SYSTEM

A-502 SCALE : 1/8" = 1'-0"

A-502 SCALE : 3" = 1'-0"



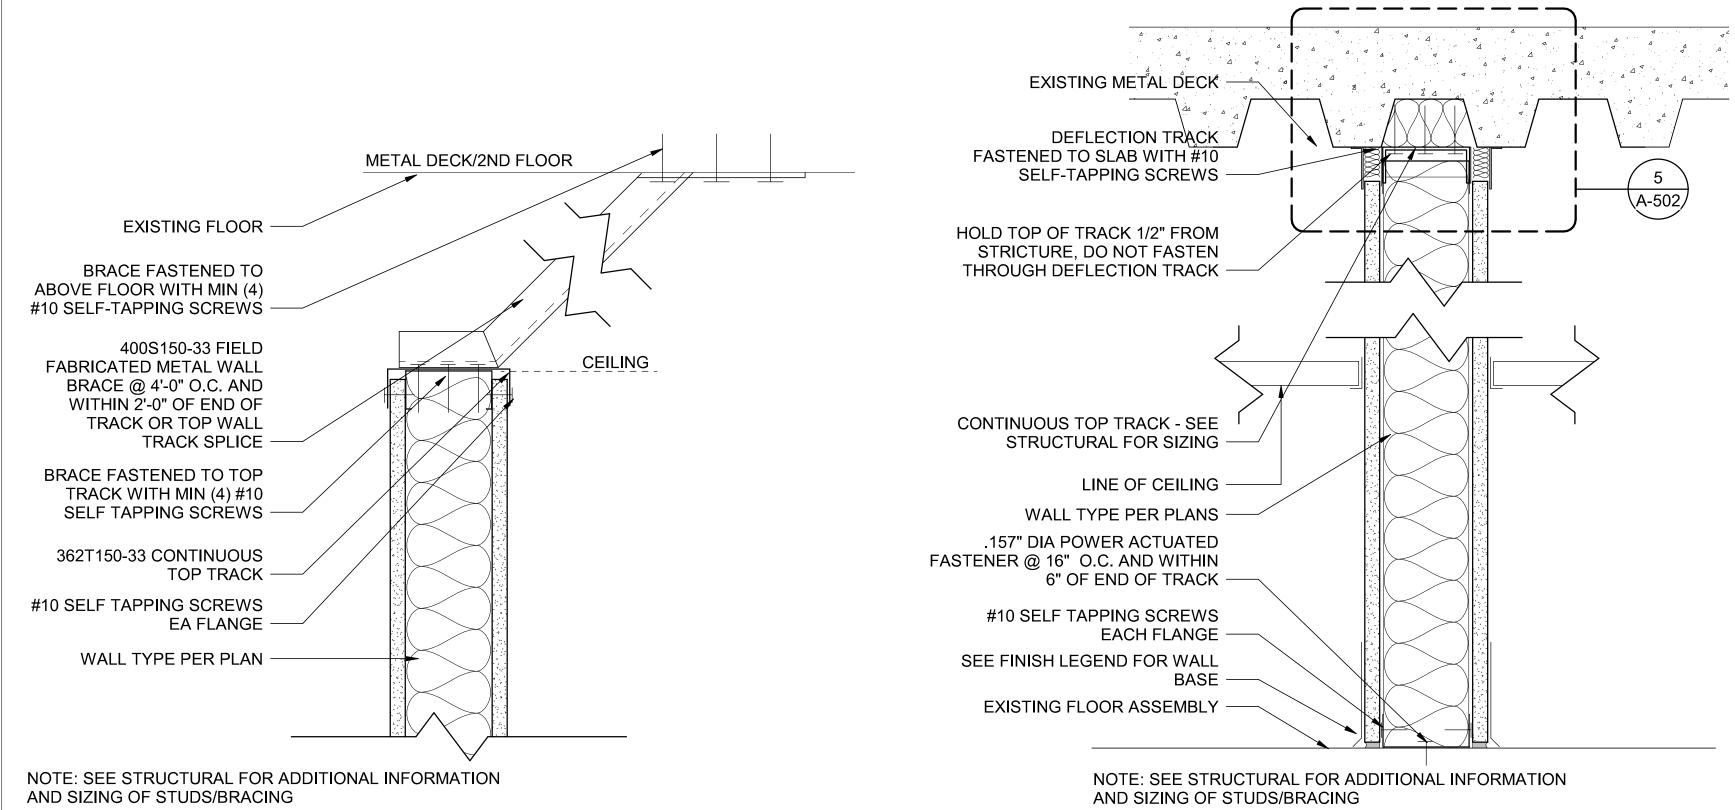² GYPSUM CEILING PERIMETER (ATTACHED WALL)



SUSPENDED GYPSUM BOARD NOTES:
GYPSUM BOARD CEILING SUSPENSION CONVENTIONAL CONSTRUCTION - ONE LAYER

GENERAL

GYPSUM BOARD SUSPENDED CEILING SYSTEMS SHALL BE DESIGNED AND CONSTRUCTED IN ACCORDANCE WITH PROVISIONS OF THE IBC 2018 EDITION AND INTERPRETATIONS MAY BE USED AS ADDITIONAL GUIDELINES

1. MATERIALS:

MATERIALS SHALL COMPLY WITH APPLICABLE IBC, ICC AND ASTM STANDARDS. GYPSUM BOARD IS EITHER ONE LAYER OF 1/2" OR 5/8" IN THICKNESS.

2. DESIGN:

THESE REQUIREMENTS SHALL ONLY APPLY TO A CEILING THAT IS NOT ACCESSIBLE, HAS A SINGLE LAYER OF GYPSUM BOARD NOT EXCEEDING 5/8" IN THICKNESS, AND HAS A TOTAL CEILING WEIGHT NOT TO EXCEED 4 POUNDS PER SQUARE FOOT (PSF). ACCESSIBLE CEILINGS SHALL BE DESIGNED TO MEET THE APPLICABLE REQUIREMENTS OF THE SBC 2012 EDITION.

3. DETAILS ON CONSTRUCTION:

3.1 GENERAL: GYPSUM BOARD CEILINGS SHALL NOT SUPPORT BUILDING COMPONENTS OTHER THAN HVAC DIFFUSERS OR LIGHT FIXTURES.

3.2 VERTICAL SUPPORT SYSTEM: ANY VARIATIONS OF MAIN RUNNER SIZES, SPACING AND SPANS LISTED IN ASTM C754 ARE ACCEPTABLE PROVIDED THE MAIN RUNNER SPACING DOES NOT EXCEED 4'-0" OC AND THE CEILING AREA SUPPORTED BY A HANGER WIRE DOES NOT EXCEED 16 SQUARE FEET. OTHER COMPONENTS SHALL MEET OR EXCEED THE FOLLOWING:

3.2.1 MAIN RUNNERS SHALL BE SPACED NO MORE THAN 4'-0" OC WITH HANGER WIRE SPACING NOT TO EXCEED 4'-0" OC AND NO MORE THAN 6" FROM EACH END OF THE MAIN RUNNER.

3.2.2 VERTICAL WIRE HANGERS SHALL BE #12 GAUGE AND GALVANIZED, SOFT-ANNEALED STEEL.

3.2.3 CROSS FURRING SHALL BE 7/8" GALVANIZED STEEL HAT SECTIONS, DESIGNATED 087F125-18, AT 2'-0" OC MAXIMUM.

3.3 CONNECTING HANGER WIRES, STEEL FRAMING AND FURRING:

3.3.1 HANGER WIRES SHALL BE SADDLE-TIED TO THE MAIN RUNNERS.

3.3.2 CROSS FURRING SHALL BE SADDLE-TIED TO THE MAIN RUNNERS WITH ONE STRAND OF #16 GAUGE OR TWO STRANDS OF #18 GAUGE TIE WIRE.

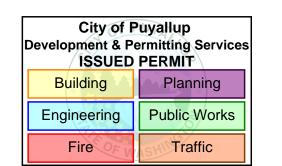
3.3.3 MAIN RUNNERS SHALL BE SPLICED BY LAPPING AND INTERLOCKING FLANGES AND TYING NEAR EACH END WITH DOUBLE LOOPS OF #16 GAUGE WIRE. THE LAP SHALL BE 12" IN LENGTH MINIMUM.

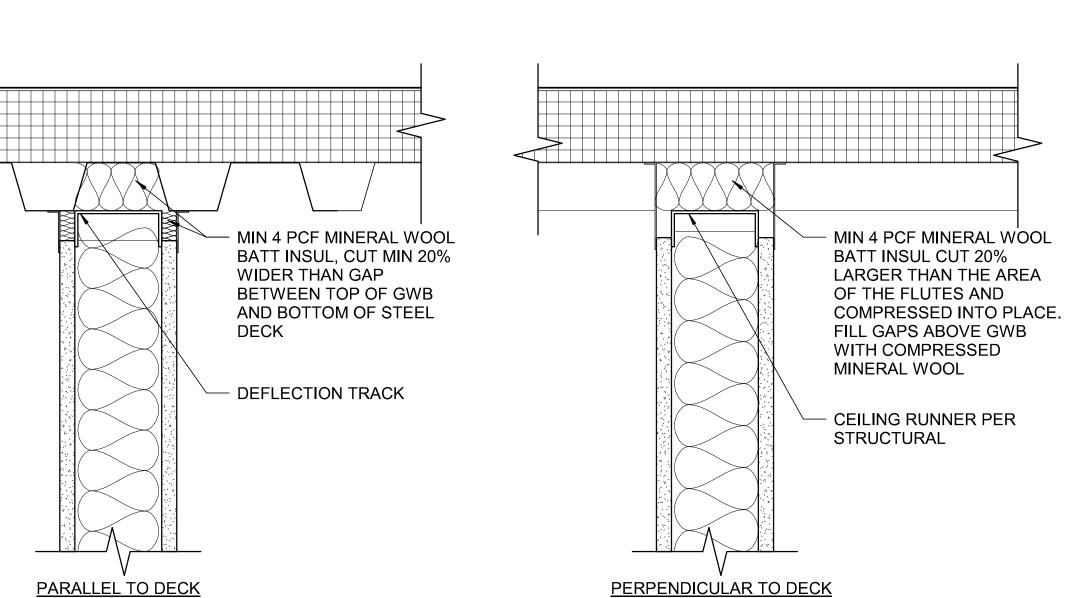
3.3.4 CROSS FURRING SHALL BE SPLICED BY LAPPING AND INTERLOCKING THE PIECES AND TYING NEAR EACH END WITH DOUBLE LOOPS OF #16 GAUGE WIRE. THE LAP SHALL BE 8" IN LENGTH MINIMUM.

4. LIGHT FIXTURES AND MECHANICAL SERVICES:

4.1 ALL RECESSED OR DROP-IN LIGHT FIXTURES, AS WELL AS CEILING-MOUNTED MECHANICAL AIR TERMINALS AND SERVICES, SHALL BE SUPPORTED DIRECTLY BY THE MAIN RUNNERS OR BY SUPPLEMENTAL FRAMING WHICH IS SUPPORTED BY THE MAIN RUNNERS AND POSITIVELY ATTACHED WITH SCREWS OR OTHER APPROVED CONNECTORS.

4.2 SURFACE-MOUNTED FIXTURES SHALL BE ATTACHED TO A MAIN RUNNER WITH A POSITIVE CLAMPING DEVICE MADE OF MATERIAL WITH A MINIMUM OF #14 GAUGE. ROTATIONAL SPRING CLAMPS DO NOT COMPLY.





5 FIRE RATED PARTITION HEAD
A-502 SCALE: 3" = 1'-0"

0 3" 6"

SCALE:3' = 1'-0"

MARSHALL DESIGN + MANAGEMENT
12400 SE 38TH #50766
BELLEVUE, WA 98105

Benaroya

LOCATION

CLIENT AND PROJECT

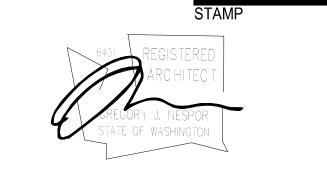
BENAROYA SOUTH HILL BUSINESS AND TECHNOLOGY CENTER 1015 39TH AVE SE PUYALLUP, WA 98374



CENTRAL PIERCE FIRE AND RESCUE 1015 39TH AVE SE, SUITE 120 PUYALLUP, WA 98374



WJA DESIGN-COLLABORATIVE 617 WESTERN AVE SEATTLE, WA 98104



ISSUANCE 02/17/2023

DRAWN BY: WJA
CHECKED BY: WJA

ISSUE DATE

		REVISION LIST						
NO.	DATE	DESCRIPTION	BY					
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1	02/17/23	100% CONSTRUCTION DOCS						

KEY PL/

REVISIONS - REPLACE PLANS WITH PREIOUSLY APPROVED PLANS OR ADD NEW SHEET WHEN NEW

SHEET TITL

SEISMIC CEILING DETAILS

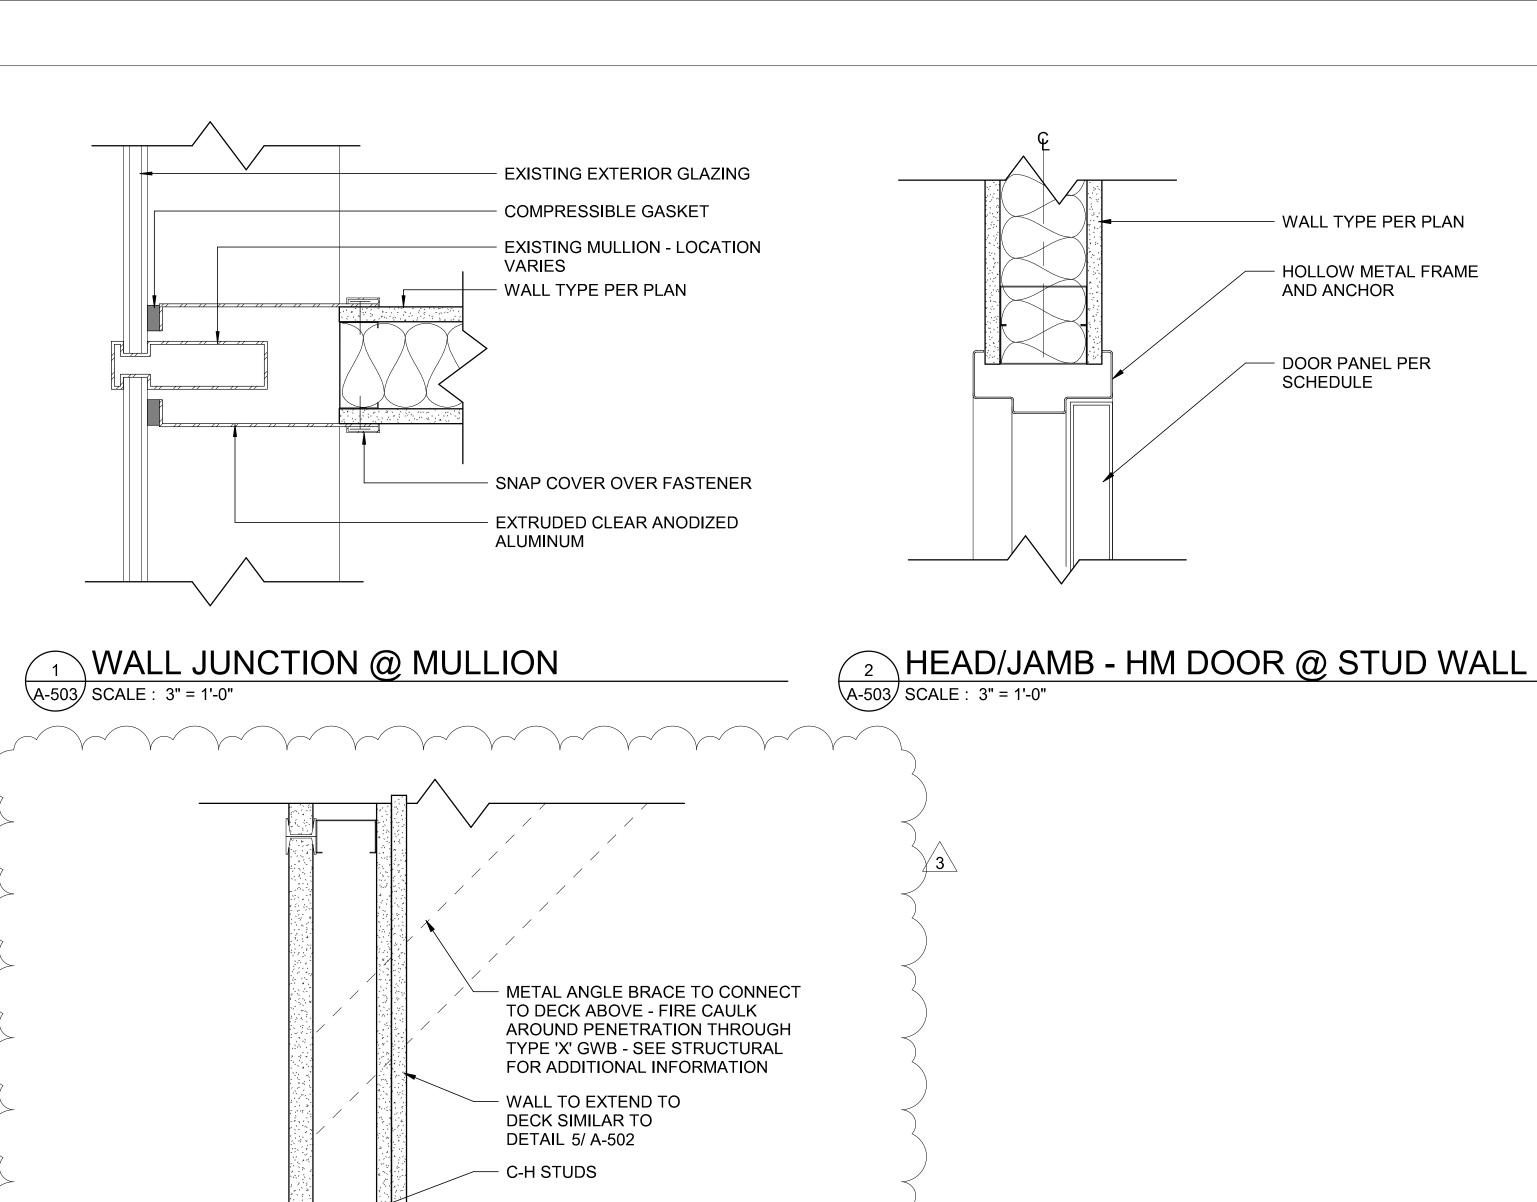
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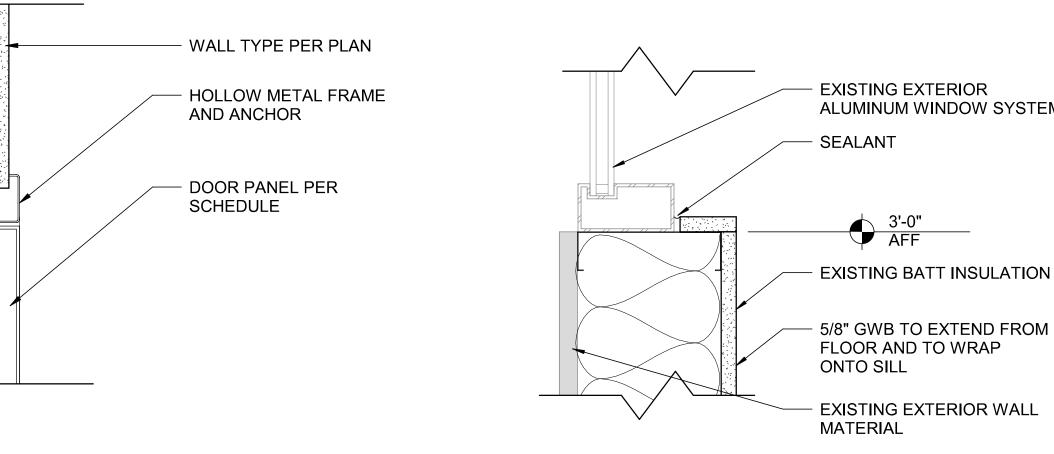
A-502 PRCTI20230098


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3 BRACING DETAIL @ PARTIAL HEIGHT WALLS
A-502 SCALE: 3" = 1'-0"

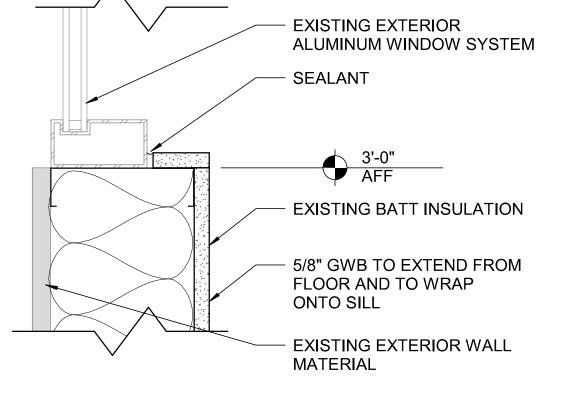
4 TYPICAL FRAMING DETAIL
A-502 SCALE: 3" = 1'-0"







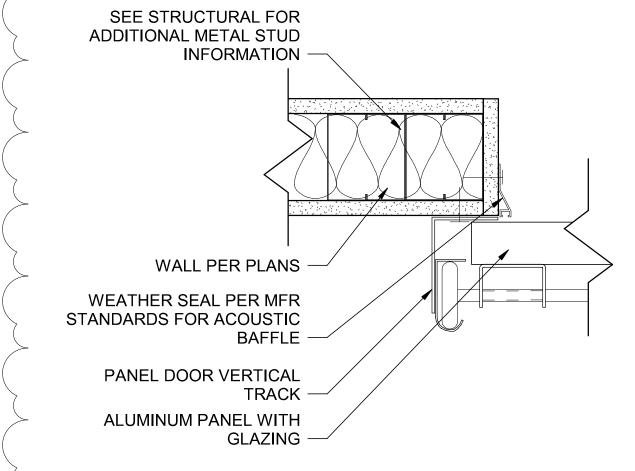3 SILL @ EXISTING EXTERIOR WALL A-503/ SCALE : 3" = 1'-0"



NOTE: ADDITIONAL WALL REINFORCEMENT PER MFR'S STANDARDS, SEE STRUCTURAL FOR ADDITIONAL INFORMATION.

4 ROLL-UP DOOR JAMB

A-503 SCALE: 3" = 1'-0"

MARSHALL DESIGN + MANAGEMENT 12400 SE 38TH #50766 BELLEVUE, WA 981<u>05</u> CLIENT AND PROJECT LOCATION

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WJA WJA **REVISION LIST**

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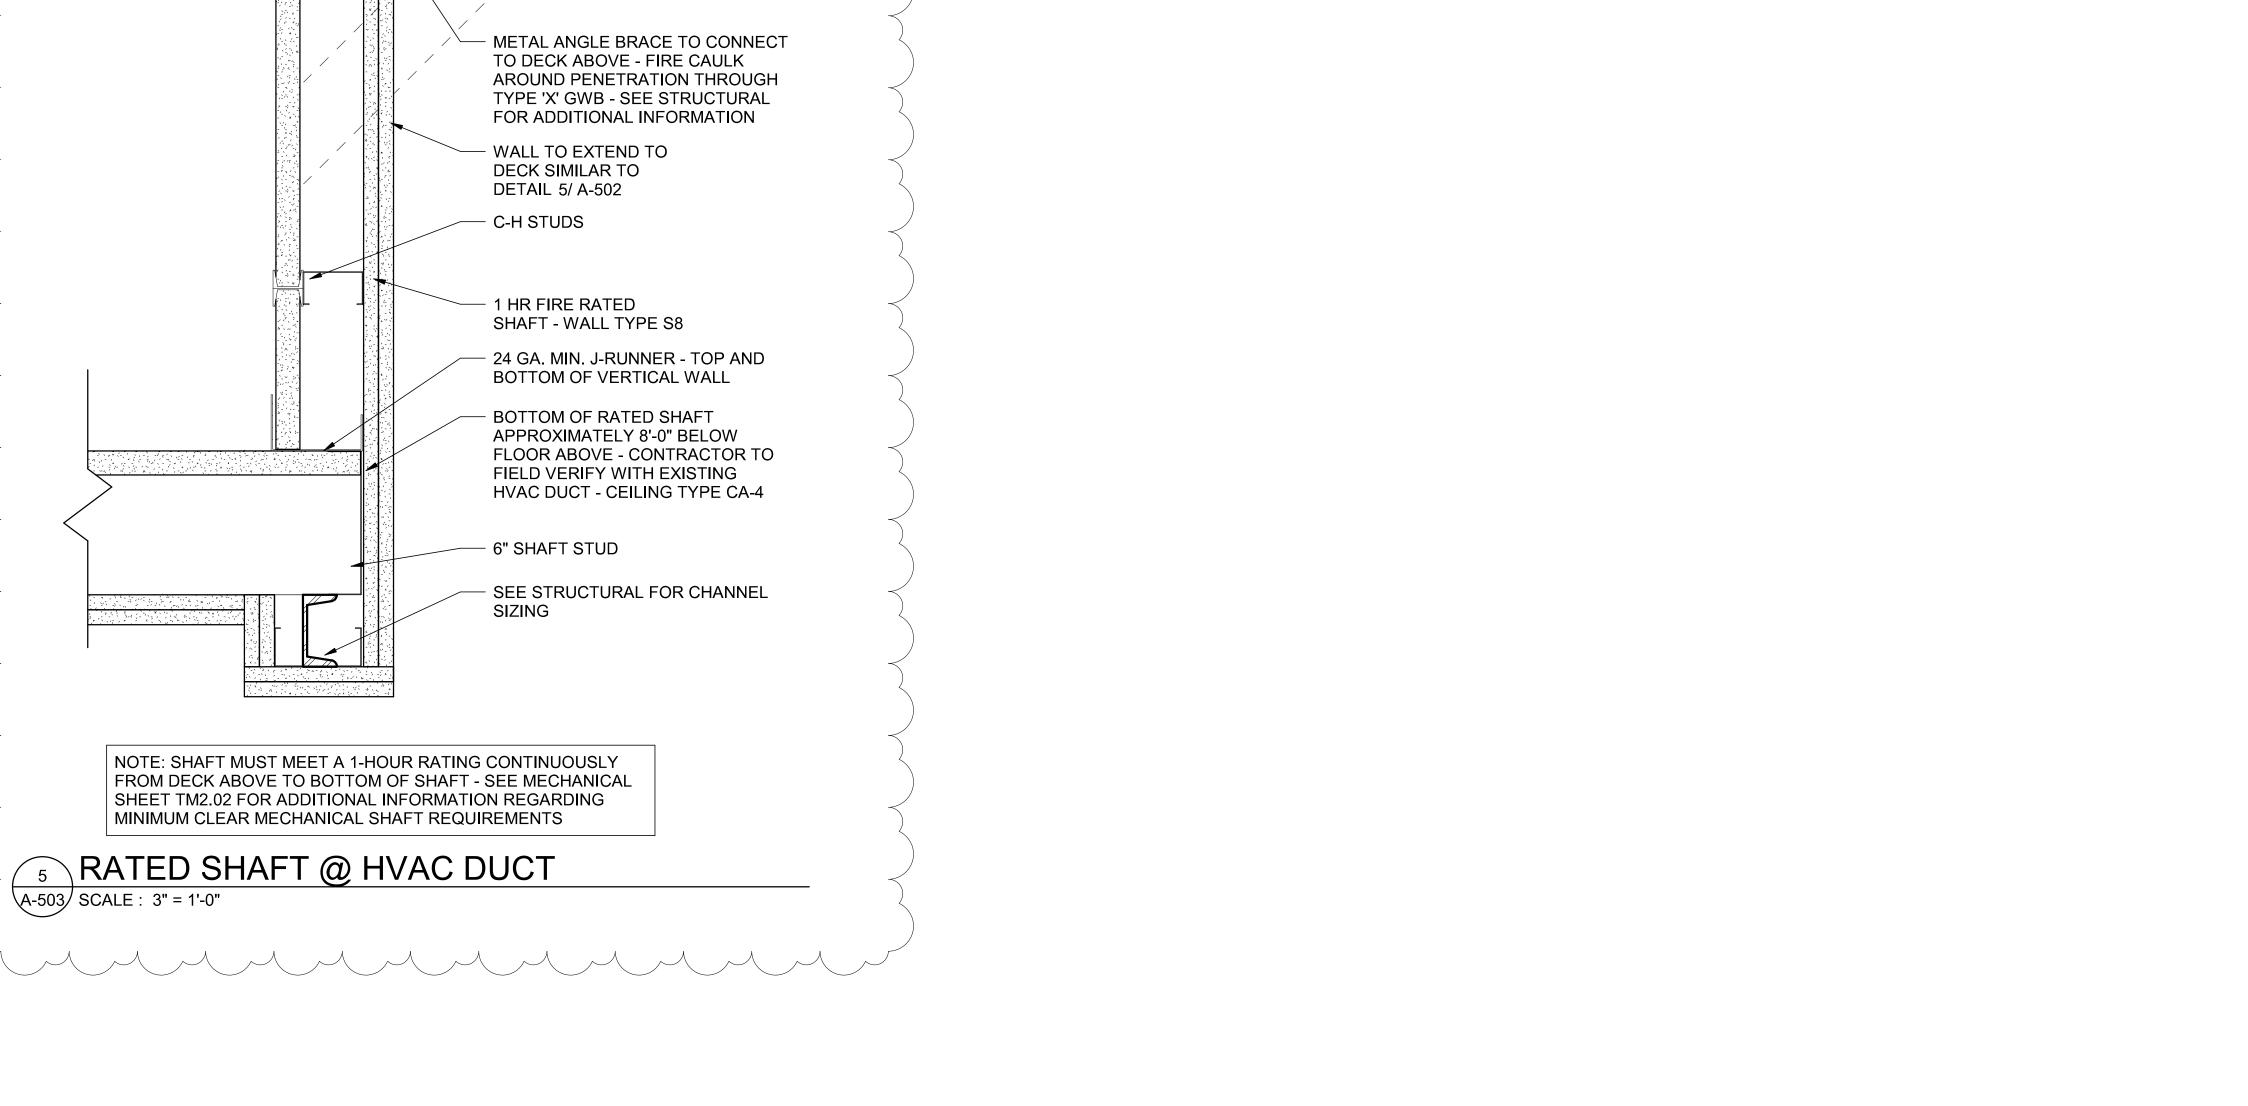
KEY PLAN

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DETAILS


SHEET NUMBER

PRCTI20230098



City of Puyallup evelopment & Permitting Services ISSUED PERMIT Building Planning Public Works Engineering Fire Traffic

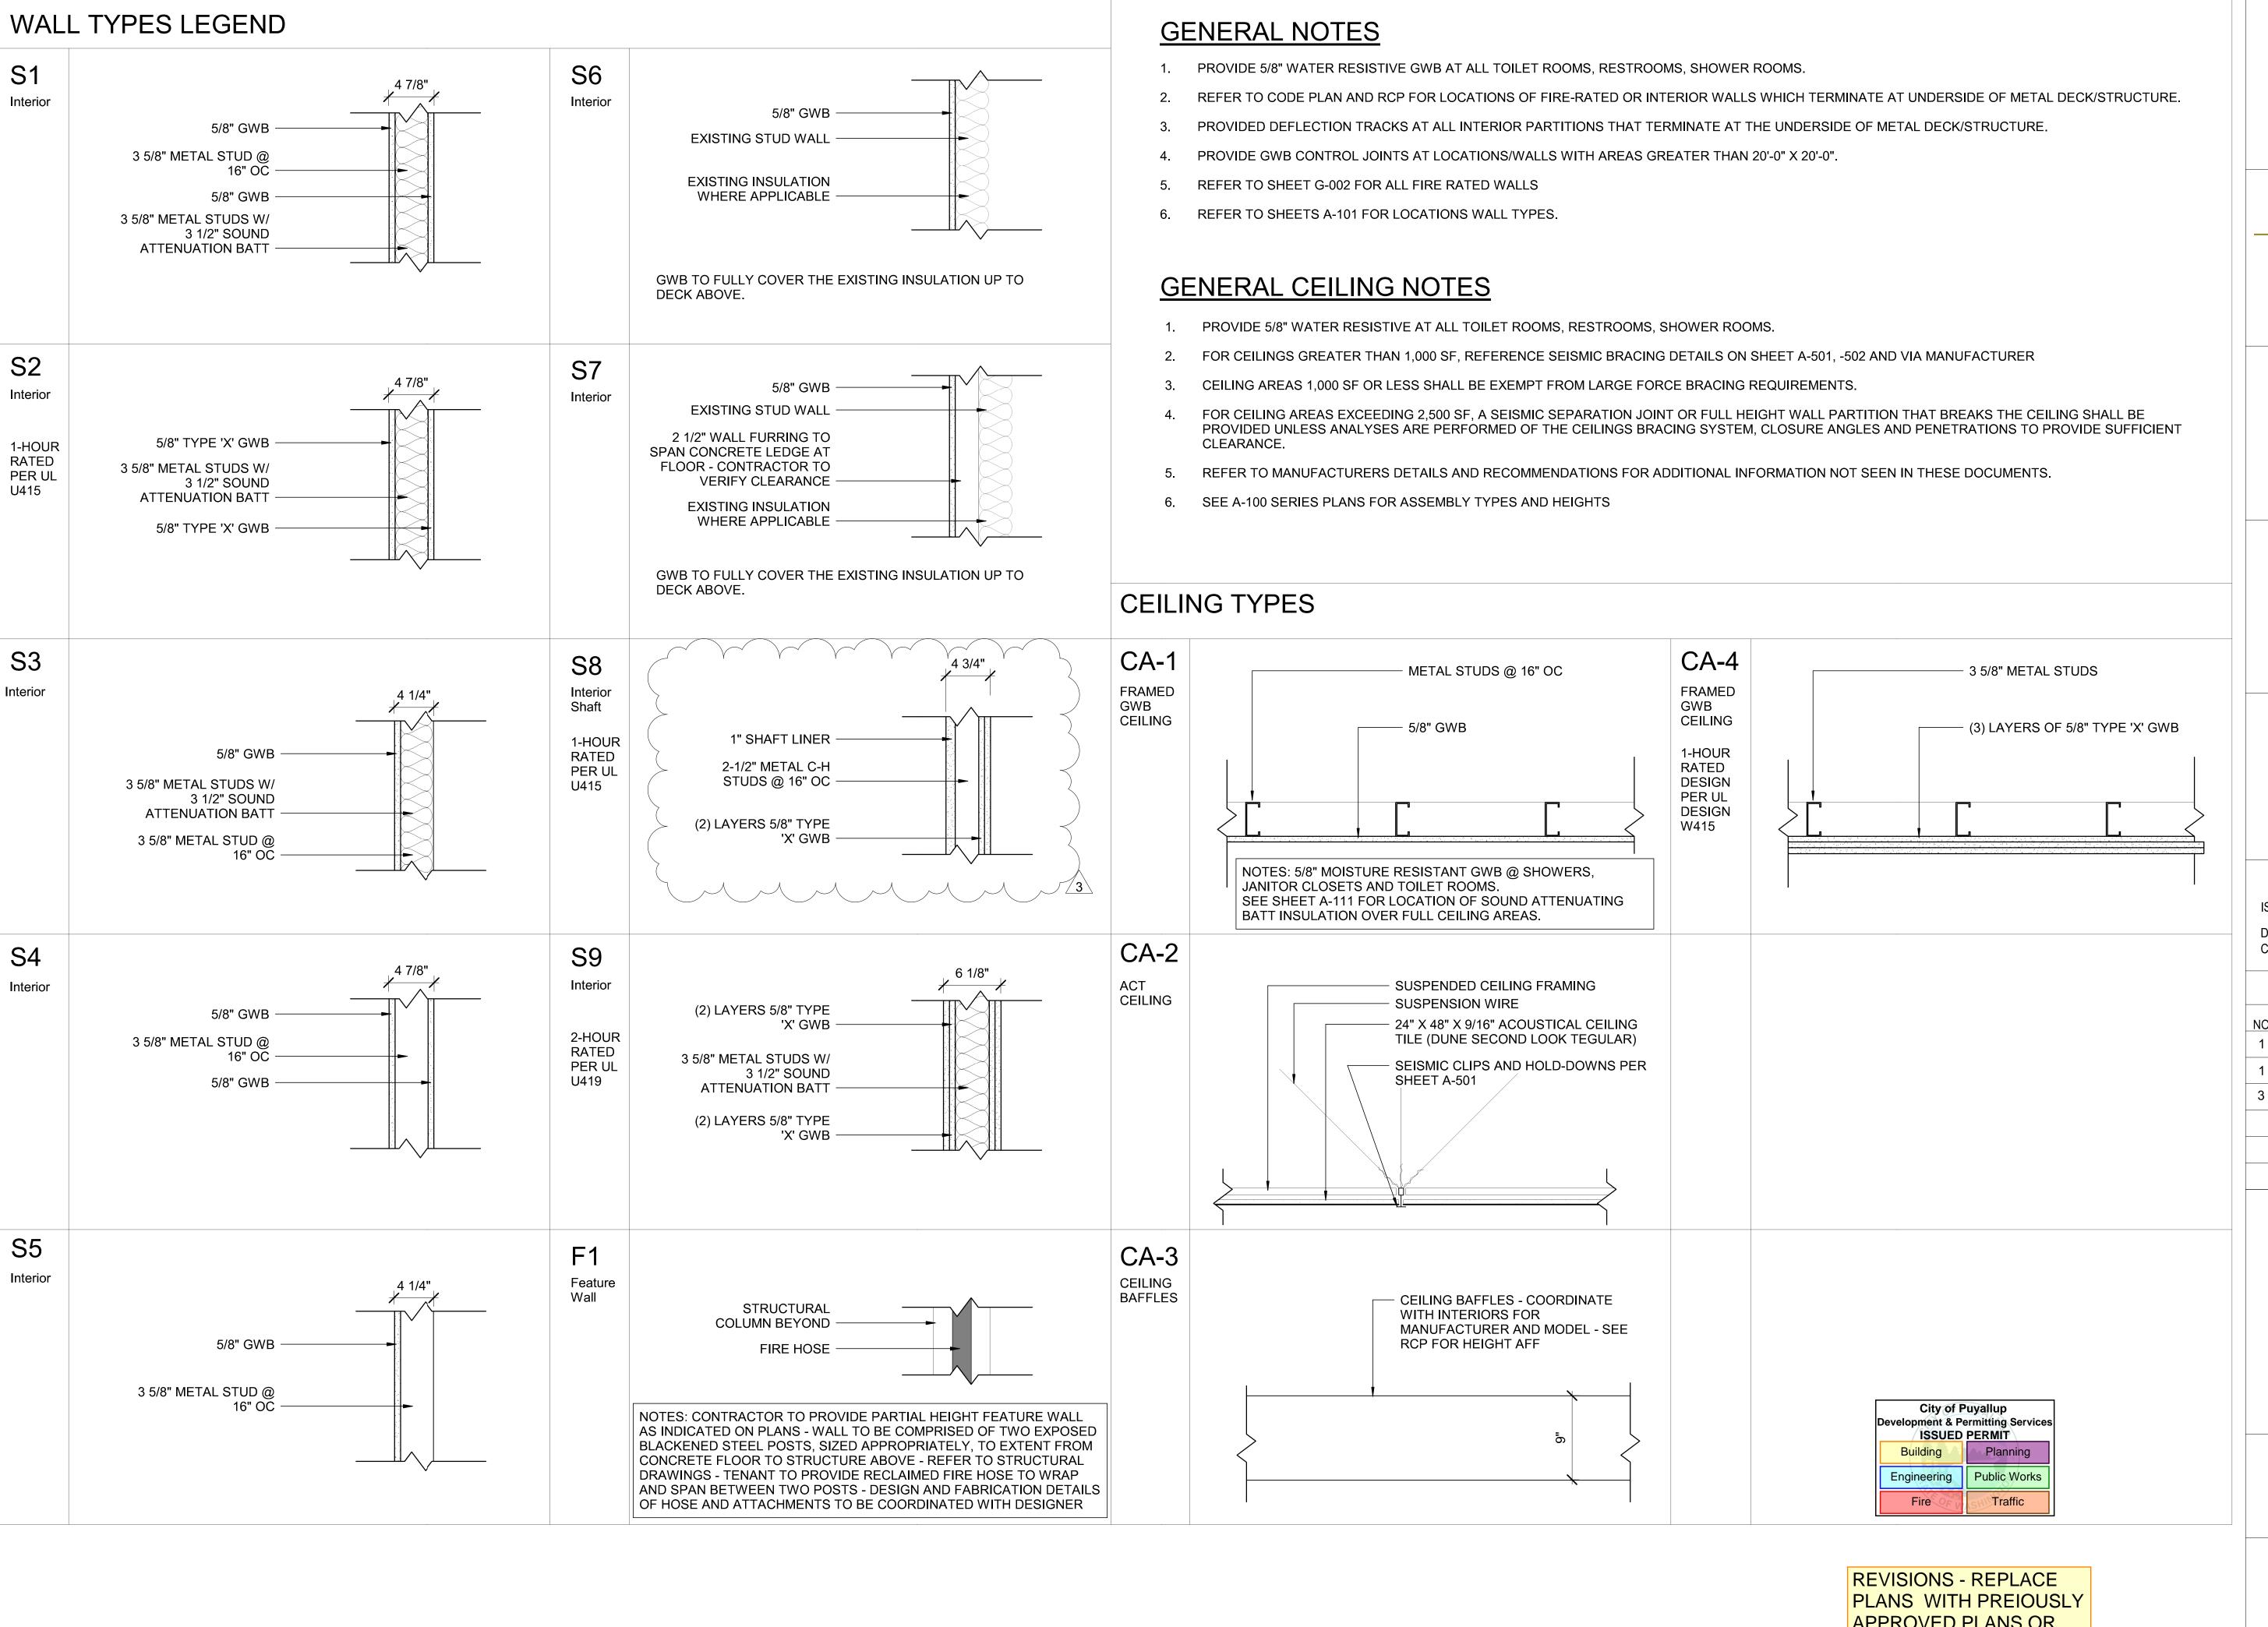SCALE:3' = 1'-0"



APPROVED PLANS OR ADD NEW SHEET WHEN NEW

12400 SE 38TH #50766 BELLEVUE, WA 98105

CLIENT AND PROJECT LOCATION

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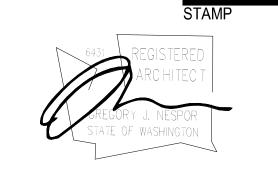
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REVISION LIST NO. DATE DESCRIPTION 1 01/30/23 PERMIT SET 1 | 02/17/23 | 100% CONSTRUCTION DOCS 3 03/08/23 POST CD'S REVISIONS **KEY PLAN**

WALL AND CEILING TYPES LEGEND

> SHEET NUMBER PRCTI20230098

		SIZE			Door Schedule DOOR PANEL DOOR FRAME								
	\ \ \ \ \ \ \ \ \ \ \ \ \ \ \ \ \ \ \			Door	Door		Frame	Frame	Frame		Door Fire		
/lark	VVidth	Height	Thicknes	s Type	Material	Door Finish	Туре	Material	Finish	Туре	Rating	Hardware	Comments
00	3'-0"	8'-0"	1 3/4"	А	WD	BLDG STANDAR D	1	НМ	BLDG STANDAR D	-	90 MIN	HW-04	DOOR AND FRAME RATING MUST MATCH THE EXISTING DOOR THAT WAS REMOVED
)1	6'-0"	8'-0"	1 3/4"	D	WD	WD	2	BLDG STANDA RD	BLDG STANDAR D	GL-3	45 MIN	HW-05	FULL GLASS RELITE INSET IN BUILDING STANDARD CHERRY WOOD DOOR. CARD KEY ACCESS
1A	3'-0"	8'-0"	1 3/4"	С	WD	WD	3	ALUM	ANODIZED			HW-03	CARD KEY ACCESS.
2	3'-0"	8'-0"	1 3/4"	Α	WD	WD	1	НМ	PT	-		HW-03	THUMB LATCH
3	3'-0"	8'-0"	1 3/4"	A	WD	WD	1	HM	PT	-	45 84181	HW-03	CARD KEY ACCESS.
3A 4A	3'-0"	8'-0" 8'-0"	1 3/4"	A B	WD WD	WD WD	1 1	HM HM	PT PT	GL-2	45 MIN 45 MIN	HW-03	CARD KEY ACCESS.
4B	3'-0"	8'-0"	1 3/4"	В	WD	WD	<u>'</u> 1	HM	PT	GL-2	45 MIN	HW-02	CARBINET AGGEGG.
5	3'-0"	8'-0"	1 3/4"	Α	WD	WD	1	НМ	PT	-		HW-04	
6	3'-0"	8'-0"	1 3/4"	Α	WD	WD	1	НМ	PT	-		HW-06	
3	3'-0"	8'-0"	1 3/4"	A	WD WD	WD WD	1	HM HM	PT PT	-		HW-02	KEYED DOOR LOCK
9)	3'-0"	8'-0" 8'-0"	1 3/4" 1 3/4"	A	WD	WD	1	HM	PT	_		HW-04 HW-02	RETED DOOR LOCK
<u>. </u>	3'-0"	8'-0"	1 3/4"	-	ALUM	ANODIZED	2	ALUM	ANODIZED	GL-1		HW-03	
2	3'-0"	8'-0"	1 3/4"	Α	WD	WD	1	НМ	PT	-		HW-04	
3	3'-0"	8'-0"	1 3/4"	Α	WD	WD	1	НМ	PT	-		HW-03	THUMB LATCH
4	3'-0"	8'-0"	1 3/4"	A	WD	WD	1	HM	PT	-		HW-03	THUMB LATCH
5 7	3'-0" 3'-0"	8'-0" 8'-0"	1 3/4" 1 3/4"	A B	WD WD	WD WD	1	HM HM	PT PT	- GL-1		HW-03	THUMB LATCH
7 7A	6'-0"	8'-0"	1 3/4"	E	WD	WD	1	НМ	PT	GL-I		HW-01	
9	6'-0"	8'-0"	1 3/4"	E	WD	WD	1	HM	PT			HW-04	
:0	3'-0"	8'-0"	1 3/4"	Α	WD	WD	1	НМ	PT	-		HW-03	THUMB LATCH
:1	3'-0"	8'-0"	1 3/4"	Α	WD	WD	1	НМ	PT	-		HW-03	THUMB LATCH
23	3'-0"	8'-0"	1 3/4"	A	WD	BLDG STANDAR D	1	BLDG STANDA RD	BLDG STANDAR D	-	45 MIN	HW-06	FULL GLASS RELITE INSET IN BUILDING STANDARD CHERRY WOOD DOOR. CARD KEY ACCESS
4A	8'-0"	8'-0"	2"	F	ALUM	ANODIZED	-	-	-	GL-1		PER MFR	OVERHEAD GLASS GARAGE DOOR. FRAME AND TRACK SHOULD BE INSTALLED AS VERTICAL AS POSSIBLE IN SPACE. TRACK STYLE TO BE "HIGH LIFT WITH STRAIGHT INCLINE AND STANDARD BREAKWAY TRACK". INSTALL PER MFR'S
5	3'-0"	8'-0"	1 3/4"	В	WD	WD	1	ALUM	PT	GL-1		HW-03	STANDARDS. CARD KEY ACCESS.
.5 :6	3'-0"	8'-0"	1 3/4"	В	WD	WD	1	HM	PT	GL-1		HW-03	CARD KEY ACCESS.
7	3'-0"	8'-0"	1 3/4"	M	ALUM	ANODIZED	4	ALUM	ANODIZED	_			
8	3'-0"	8'-0"	1 3/4"	-	ALUM	ANODIZED	4	ALUM	ANODIZED	GL-1			
9	3'-0"	8'-0"	1 3/4"	-	ALUM	ANODIZED		ALUM	ANODIZED				
0	3'-0"	8'-0"	1 3/4"	-	ALUM	ANODIZED		ALUM	ANODIZED				
1 2	3'-0"	8'-0" 8'-0"	1 3/4" 1 3/4"		ALUM ALUM	ANODIZED ANODIZED		ALUM ALUM	ANODIZED ANODIZED				
_ 3	3'-0"	8'-0"	1 3/4"		ALUM	ANODIZED		ALUM	ANODIZED				
4	3'-0"	8'-0"	1 3/4"	-	ALUM	ANODIZED	4	ALUM	ANODIZED	GL-1			
5	3'-0"	8'-0"	1 3/4"	-	ALUM	ANODIZED		ALUM	ANODIZED				
6	3'-0"	8'-0"	1 3/4"	-	ALUM	ANODIZED		ALUM	ANODIZED				
9 0	3'-0"	8'-0" 8'-0"	1 3/4" 1 3/4"	L _	ALUM ALUM	ANODIZED ANODIZED		ALUM ALUM	ANODIZED ANODIZED				
<u>0</u> 1	3'-0"	8'-0"	1 3/4"	-	ALUM	ANODIZED		ALUM	ANODIZED				
3	3'-0"	8'-0"	1 3/4"	-	ALUM	ANODIZED		ALUM	ANODIZED				
4	3'-0"	8'-0"	1 3/4"	-	ALUM	ANODIZED		ALUM	ANODIZED				
5	3'-0"	8'-0"	1 3/4"	-	ALUM	ANODIZED		ALUM	ANODIZED				
7	3'-0"	8'-0"	1 3/4"	-	ALUM	ANODIZED		ALUM	ANODIZED				
8 0	3'-0"	8'-0" 8'-0"	1 3/4" 1 3/4"	-	ALUM	ANODIZED ANODIZED		ALUM ALUM	ANODIZED ANODIZED				
50 51	3'-0"	8'-0"	1 3/4"	- K	ALUM ALUM	ANODIZED		ALUM	ANODIZED				
55	3'-0"	8'-0"	1 3/4"	-	ALUM	ANODIZED		ALUM	ANODIZED				
6	3'-0"	8'-0"	1 3/4"	_	ALUM	ANODIZED		ALUM	ANODIZED				
57	3'-0"	8'-0"	1 3/4"	-	ALUM	ANODIZED		ALUM	ANODIZED				
8	3'-0"	8'-0"	1 3/4"	-	ALUM	ANODIZED		ALUM	ANODIZED				
9 :0	3'-0" 3'-0"	8'-0" 8'-0"	1 3/4"	-	ALUM	ANODIZED		ALUM	ANODIZED				
2	3'-0"	8'-0"	1 3/4" 1 3/4"	-	ALUM ALUM	ANODIZED ANODIZED		ALUM ALUM	ANODIZED ANODIZED				
3	3'-0"	8'-0"	1 3/4"	-	ALUM	ANODIZED		ALUM	ANODIZED				
4	3'-0"	8'-0"	1 3/4"	-	ALUM	ANODIZED		ALUM	ANODIZED				
4A	3'-0"	8'-0"	1 3/4"	В	WD	WD	1	НМ	PT	GL-1		HW-03	CARD KEY ACCESS.
5	3'-0"	8'-0"	1 3/4"	В	WD	WD	1	НМ	PT	GL-1		HW-04	CARD KEY ACCESS.
57	3'-0"	8'-0"	1 3/4"	-	ALUM	ANODIZED		ALUM	ANODIZED				CARD KEY ACCESS.
88 80	3'-0"	8'-0" 8'-0"	1 3/4" 1 3/4"	-	ALUM	ANODIZED ANODIZED		ALUM	ANODIZED ANODIZED				
69 70	3'-0"	8'-0"	1 3/4"	-	ALUM ALUM	ANODIZED		ALUM ALUM	ANODIZED		_		
	3'-0"	8'-0"	1 3/4"	- A	WD	WD	1	HM	PT	-		HW-04	
72			1 3/4"	В	WD	WD	1	НМ	PT	GL-1		HW-01	
72A	3'-0"	8'-0"	1 0/7			1			<u> </u>	$\Gamma^{\mathcal{I}}$.		\	

HARDWARE TYPES

HW-01 PASSAGE FUNCTION WITH LEVER AND LATCH

MORTISE LEVER AND LATCH SET

- HINGES, BUTTS, SILENCERS, AND DOOR STOPS AS REQUIRED
- CLOSER

W-02 PASSAGE FUNCTION WITHOUT LEVER AND LATCH

- PUSH PLATE AT PUSH SIDE
- PULL LEVER AT PULL SIDE
- OVERHEAD CLOSER
 HINGES, BUTTS, SILENCERS, AND DOOR STOPS AS REQUIRED

HW-03 OFFICE FUNCTION

- MORTISE LEVER AND LOCK SET WITH THUMB TURN
- HINGES, BUTTS, SILENCERS, AND DOOR STOPS AS REQUIRED

HW-04 STOREROOM FUNCTION

MORTISE LEVER AND LOCK SET

HINGES, BUTTS, SILENCERS, AND DOOR STOPS AS REQUIRED

SECURE ENTRY FUNCTION WITH CARD READER AT DOUBLE DOOR

- ELECTRIC MORTISE LEVER AND LOCK SET WITH TRANSFER HINGE
 OVERHEAD CLOSER
- CARD READER PER ELECTRICAL DRAWINGS
- HINGES, BUTTS, SILENCERS, AND DOOR STOPS AS REQUIRED
- CONNECTION TO RECEPTION DESK 103
- DOOR STOP, FLOOR TYPE
- ELECTRONIC ACCESS CONTROL BY OTHERS
- PULL HANDLE-PUSH BAR SET

<u>HW-06</u> EXIT FUNCTION

- EXIT HARDWARE AND PUSH BAR
- ASTRAGAL
- OVERHEAD CLOSER
- HINGES, BUTTS, SILENCERS, AND DOOR STOPS AS REQUIRED

NOTES:

- DOOR HARDWARE TO BE COORDINATED WITH BUILDING STANDARDS

 SEE DOOR SCHEDULE FOR FIRE BATING
- SEE DOOR SCHEDULE FOR FIRE RATING
 SEE ELECTRICAL DRAWINGS FOR CARD READER COORDINATION
- DOOR HARDWARE TO BE COORDINATED WITH DOOR HARDWARE

SPECIALIST

GLAZING TYPES

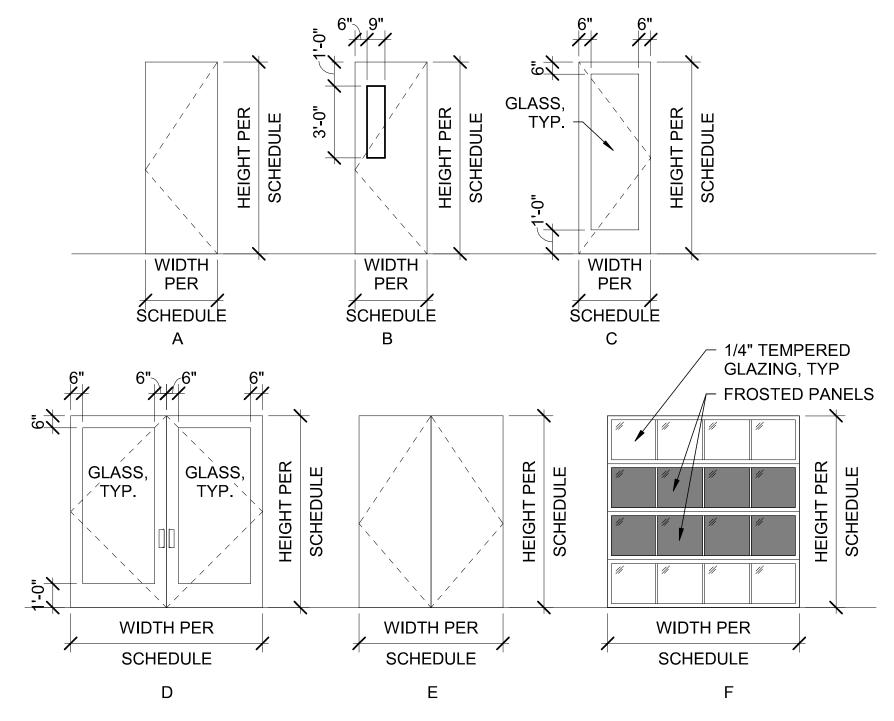
GL-1 1/4" CLEAR GLASS

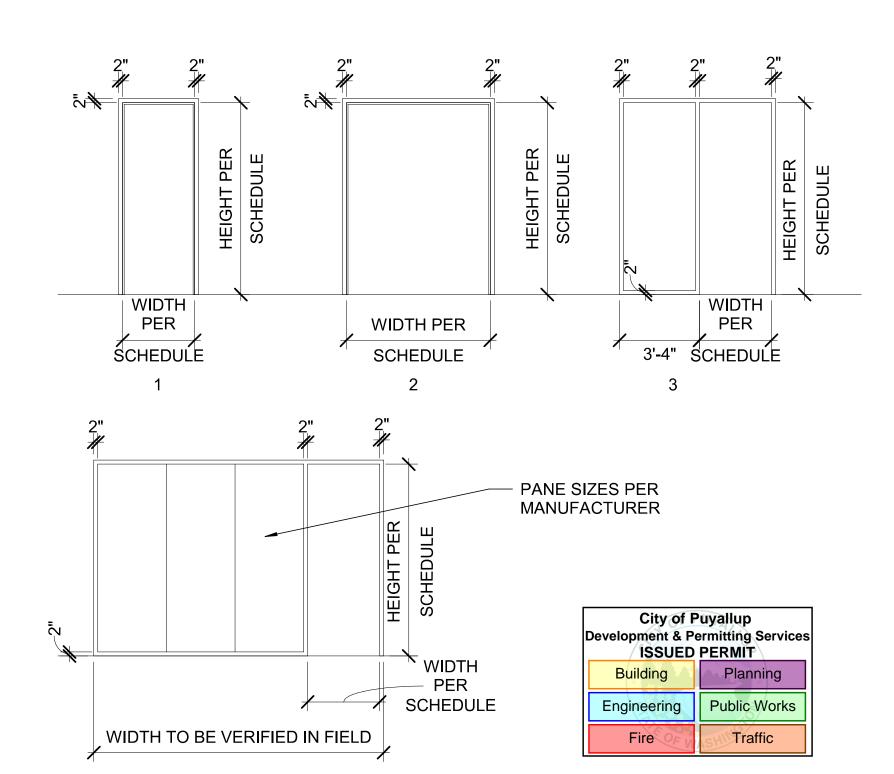
L-2 1HR RATED GLASS

GL-3 1/4" TEMPERED SAFETY GLASS

DOOR GENERAL NOTES

- 1. REFERENCE SHEET A-001 FOR ABBREVIATIONS, SYMBOLS, LEGENDS, ADDITIONAL DRAWING CONVENTIONS AND GENERAL NOTES.
- 2. FIELD VERIFY ROUGH OPENINGS.
- 3. EGRESS DOORS SHALL BE READILY OPERABLE FROM EGRESS SIDE WITHOUT USE OF KEY OR ANY SPECIAL KNOWLEDGE OR EFFORT.
- 4. ALL HM DOORS SHALL HAVE INSULATED CORE (U-VALUE 0.37 AT GLASS DOORS, U-VALUE 0.48 AT OPAQUE DOORS.
- 5. ALL EXTERIOR SWING DOORS SHALL HAVE A MAXIMUM AIR RATE OF 0.20 CFM/SQ FT PER NFRC 400 OR AAMA/WDMA/CSA101/I,S,2/A440
- 6. ALL WOOD DOORS TO BE SOLID AND PAINTED.
- 7. DOOR TYPES IN DEMOUNTABLE PARTITION SYSTEMS PER THE DEMOUNTABLE PARTITION SYSTEMS MFR. CONTRACTOR TO COORDINATE WITH USER AND DESIGNER MARSHALL DESIGN + MANAGEMENT.
- 8. OVERHEAD GARAGE DOOR AT BREAK ROOM 124 SHOULD BE SIMILAR TO THE PARAMETRIC GLASS GARAGE DOOR.





DOOR FRAME LEGEND

SCALE: 1/4" = 1'-0"

DESIGNER

MARSHALL DESIGN + MANAGEMENT
12400 SE 38TH #50766
BELLEVUE, WA 98105

WA 98105

CLIENT AND PROJECT
LOCATION

Benaroya

BENAROYA SOUTH HILL BUSINESS AND TECHNOLOGY CENTER 1015 39TH AVE SE PUYALLUP, WA 98374

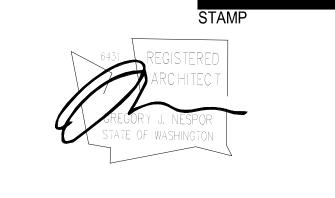


CENTRAL PIERCE FIRE AND RESCUE 1015 39TH AVE SE, SUITE 120 PUYALLUP, WA 98374



design collaborative

WJA DESIGN-COLLABORATIVE
617 WESTERN AVE
SEATTLE, WA 98104



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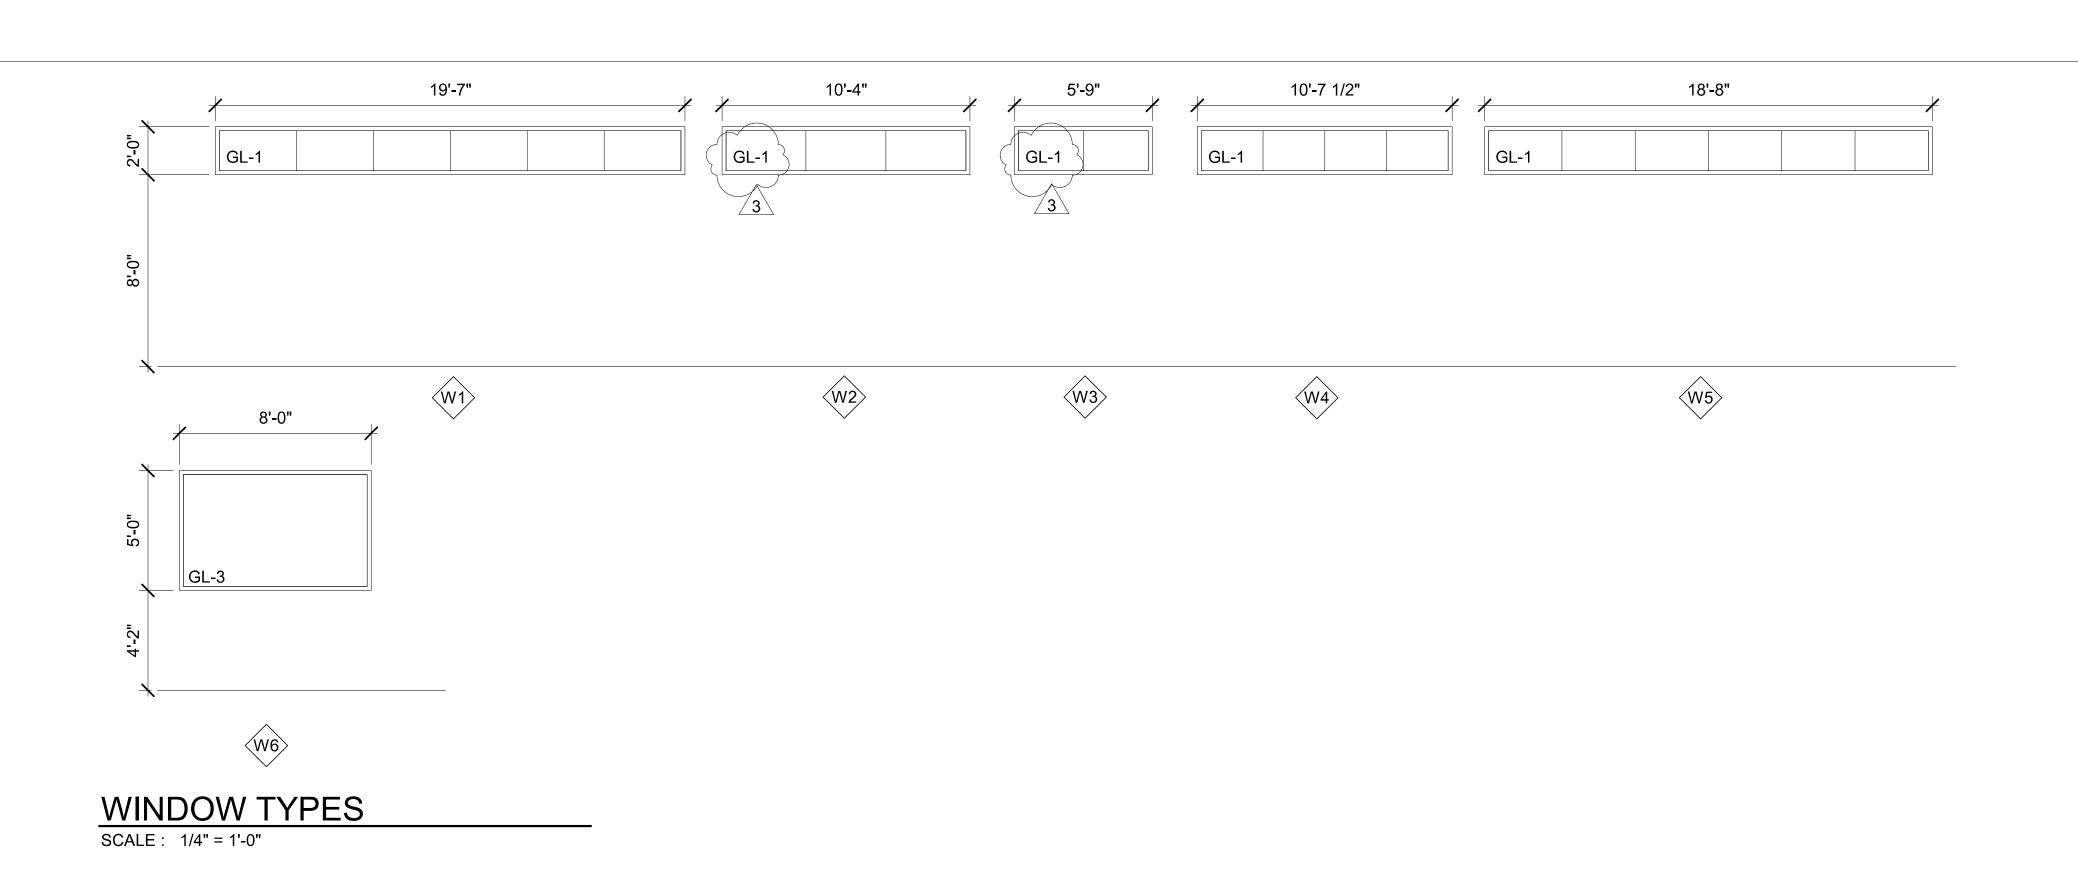
| NO. | DATE | DESCRIPTION | BY | 1 | 01/30/23 | PERMIT SET | 1 | 02/17/23 | 100% CONSTRUCTION DOCS | 3 | 03/08/23 | POST CD'S REVISIONS | KEY PLAN

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DOOR SCHEDULE AND LEGEND

SHEET NUMBER

A-602 PRCTI20230098



WINDOW LEGEND GENERAL NOTES

- 1. FIELD VERIFY ALL ROUGH OPENINGS.
- 2. BUTT GLAZING, TYP. AT CLERESTORY WINDOWS.
- 3. CLERESTORY DESIGN BY CONTRACTOR, WORKPOINTE/TEKNION.
- 4. GLASS PANE SIZING BY CONTRACTOR, WORKPOINTE/TEKNION.

GLAZING TYPES

GL-1 1/4" CLEAR GLASS

GL-2 1HR RATED GLASS

GL-3 1/4" TEMPERED SAFETY GLASS



CLIENT AND PROJECT LOCATION




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WJA DESIGN-COLLABORATIVE 617 WESTERN AVE SEATTLE, WA 98104



02/17/2023

WJA WJA

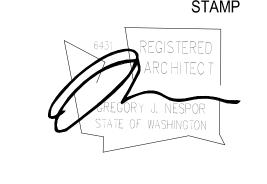ISSUANCE

KEY PLAN

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CHECKED BY:


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WINDOW SCHEDULE AND LEGEND

SHEET NUMBER

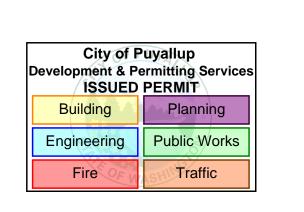A-603
PRCTI20230098



SCALE:1/4" = 1'-0"