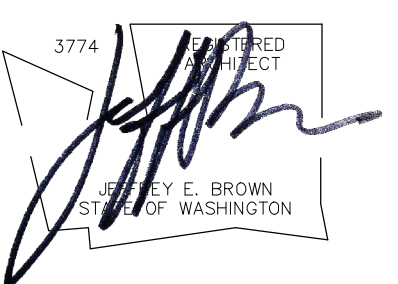


JEFF BROWN ARCHITECTURE

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PROJECT LEAD

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PROJECT NAME/ADDRESS

STEP BY STEP GREENHOUSE
3603 8TH AVE SE
PUYALLUP, WA 98372

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PROJECT NUMBER

22002

DRAWING TYPE

PERMIT DOCUMENTS

SHEET TITLE

03.07.22	PERMIT	
11.09.22	REV-CITY	⚠
03.06.23	REV-CITY	⚠
03.24.23	REV-CITY	⚠

SHEET #

PROJECT INFORMATION

SHEET #

G1.1

PROJECT SCOPE & INFORMATION

PROJECT NAME: SBS - GREENHOUSE
PROJECT ADDRESS: 3308 8TH STREET SE PUYALLUP, WA 98372
PARCEL NUMBER: 0420253070, 0420253071

LEGAL DESCRIPTION

THE LAND REFERRED TO IS SITUATED IN THE COUNTY OF PIERCE, CITY OF PUYALLUP, STATE OF WASHINGTON, AND IS DESCRIBED AS FOLLOWS:
LOT 1:
THAT PORTION OF THE WEST ONE-THIRD OF THE SOUTH HALF OF THE SOUTHWEST QUARTER OF SECTION 25, TOWNSHIP 20 NORTH, RANGE 4 EAST, WILLAMETTE MERIDIAN, MORE PARTICULARLY DESCRIBED AS FOLLOWS;
BEGINNING AT THE INTERSECTION OF THE EAST LINE OF SAID WEST ONE-THIRD OF THE SOUTH HALF AND THE NORTH MARGIN OF 80TH STREET EAST;
THENCE NORTH 08°40'46" WEST, 49.23 FEET ALONG SAID NORTH MARGIN TO AN ANGLE POINT;
THENCE NORTH 74°06'46" WEST, 333.37 FEET ALONG SAID NORTH MARGIN;
THENCE NORTH 00°44'18" EAST, 607.11 FEET;
THENCE NORTH 08°23'27" WEST, 501.42 FEET TO THE EAST MARGIN OF 134TH AVENUE EAST;
THENCE NORTH 00°44'18" EAST, 627.35 FEET ALONG SAID EAST MARGIN TO THE NORTH LINE OF SAID SOUTH HALF ;
THENCE NORTH 08°40'46" EAST, 812.71 FEET ALONG SAID NORTH LINE TO THE SAID EAST LINE OF THE WEST ONE-THIRD;
THENCE SOUTH 00°44'55" WEST, 1,316.43 FEET ALONG SAID EAST LINE TO THE POINT OF BEGINNING.
LOT 2:
THAT PORTION OF THE WEST ONE-THIRD OF THE SOUTH HALF OF THE SOUTHWEST QUARTER OF SECTION 25, TOWNSHIP 20 NORTH, RANGE 4 EAST, WILLAMETTE MERIDIAN, MORE PARTICULARLY DESCRIBED AS FOLLOWS;
BEGINNING AT THE INTERSECTION OF THE EAST LINE OF SAID WEST ONE-THIRD OF THE SOUTH HALF AND THE NORTH MARGIN OF 80TH STREET EAST;
THENCE NORTH 08°40'46" WEST, 49.23 FEET ALONG SAID NORTH MARGIN TO AN ANGLE POINT;
THENCE NORTH 74°06'46" WEST, 333.37 FEET ALONG SAID NORTH MARGIN TO THE TRUE POINT OF BEGINNING;
THENCE NORTH 00°44'18" EAST, 607.11 FEET;
THENCE NORTH 08°23'27" WEST, 501.42 FEET TO THE EAST MARGIN OF 134TH AVENUE EAST;
THENCE SOUTH 00°44'18" WEST, 478.99 FEET ALONG SAID EAST MARGIN TO SAID NORTH MARGIN;
THENCE SOUTH 74°06'46" EAST, 519.41 FEET ALONG SAID NORTH MARGIN TO THE TRUE POINT OF BEGINNING.

GOVERNING CODE

2018 WASHINGTON STATE BUILDING CODE
2018 WASHINGTON STATE MECHANICAL CODE
2018 WASHINGTON STATE PLUMBING CODE
2018 WASHINGTON STATE ENERGY CODE
CITY OF PUYALLUP ZONING CODE

ZONING

ARO-AGRICULTURE, RECREATION, AND OPEN SPACE
MAXIMUM LOT COVERAGE: 45% / 50%
PROPERTY SET BACKS:
FRONT: 30'
REAR: 30'
SIDE: 25'
STREET 25'
MAXIMUM HEIGHT: PROPOSED HEIGHT 28'-10"

PROPOSED BUILDING SQFT: 4,320 SQFT (FOR NEW BLDG)
CONDITIONED SPACE: 4,320 SQFT (FOR NEW BLDG)


OCCUPANCY GROUP
OCCUPANCY AS U (GREENHOUSE) WITH A-3 OCCUPANCY UNDER "OPERATIONAL PERMIT" WITH CENTRAL PIERCE FIRE DISTRICT.
ANNUAL RENEWAL OF OPERATIONAL PERMIT IS REQUIRED

BUILDING TYPE

II-B
FIRE SPRINKLER SYSTEM: NOT REQUIRED
FIRE-ALARM SYSTEM: *INSTALL FIRE-ALARM SYSTEM FOR SEASONAL OCCUPANCY USE FOR BOTH EXISTING AND NEW GREENHOUSES ALONG WITH "OPERATIONAL PERMIT" WITH CENTRAL PIERCE FIRE DISTRICT.
FINAL LETTER REQUIREMENTS: ARCHITECT & ENGINEER OF RECORD (STRUCTURE OBSERVATION)
DEFERRED SUBMITTAL: MECH, FIRE ALARM, PLUMBING

The exiting building and the new building are considered one space; related to fire alarm system installation.

VICINITY MAP

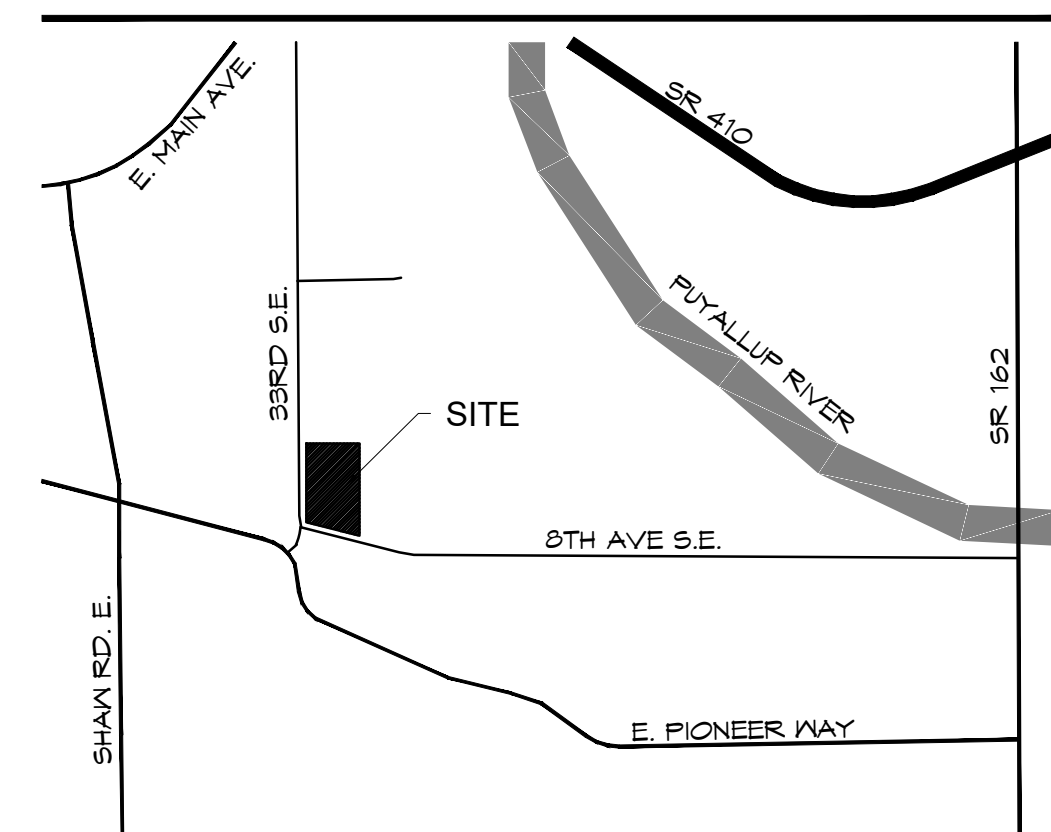

NO.

03.07.22	PERMIT	
11.09.22	REV-CITY	⚠
03.06.23	REV-CITY	⚠
03.24.23	REV-CITY	⚠

SHEET #

PROJECT INFORMATION

SHEET #

G1.1

LIST OF DRAWINGS

GENERAL
G1.1 PROJECT INFORMATION
ARCHITECTURAL
A1.1 SITE PLAN
A2.1 FLOOR PLAN

CONTACTS

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jasoncornell@stepbystepfamily.org

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JEFF BROWN ARCHITECTURE
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TACOMA, WA 98444
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509.432.4651
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TACOMA, WA 98409
CONTACT: PROJECT MANAGER
JEREMY PATNOI
253.284.0416
jeremy@mountainconst.com

CIVIL ENGINEERING
BARSHAUSEN CONSULTING ENGINEERS
18215 12ND AVE S
KENT, WA 98032
CONTACT: ZAYIN WALLI
425.251.6222
zuwall@barhausen.com


MECHANICAL CONSULTANT
NORTHWEST MOUNTAIN AIR
2316 INTER AVE #1
PUYALLUP, WA 98372
CONTACT: RYAN HEGLAND
253.261.4046
ryanenunmtrain.com

Final Letter Requirements:
Architect of Record
Engineer of Record

Deferred Submittal:
Separate Mechanical permit
Separate Fire Alarm permit
Separate Plumbing permit.

ABBREVIATIONS

<	AND	FND	FOUNDATION
∠	ANGLE	GWB	GYPNUM WALL BOARD
⊕	AT	HDR	HEADER
°	DEGREE	INT.	INTERIOR
∅	DIAMETER	MNF	MANUFACTURE
B/W	BETWEEN	NTS	NOT TO SCALE
BLCK	BLOCKING	O.C.	ON CENTER
CL	CENTERLINE	RC	RAIN CHAIN
APP	APPROXIMATE (LY)	FA	FLY WOOD
CLR.	CLEAR(ANCE)	REF	REFRIGERATOR
C.O.	CLEAR OPENING	SCHD	SCHEDULE
COL.	COLUMN	SHTG	SHEATHING
CONC.	CONCRETE	S.D.	SMOKE DETECTOR
C.J.	CONTROL JOINT	TEM	TEMPER/SAFETY GLASS
DEMO	DEMOLISH (ION)	T.O.BM	TOP OF BEAM
DN	DOWN	T.O.P.	TOP OF PLATE
DIM	DIMENSION	T.O.S.	TOP OF STEEL
D/W	DISH WASHER	TYP.	TYPICAL
ELEC.	ELECTRIC (AL)	UN.O.	UNLESS NOTICED OTHERWISE
E.Q.	EQUAL		
E.J.	EXPANSION JOINT	VIF	VERIFY IN FIELD
EXT.	EXTERIOR	WIN	WINDOW
F.O.F.	FACE OF FINISH	W.T.	WEATHER THRESHOLD
F.F.	FINISH FLOOR	W/	WITH
FT	FOOT (FEET)	W/O	WITHOUT
FTG	FOOTING	WD	WOOD

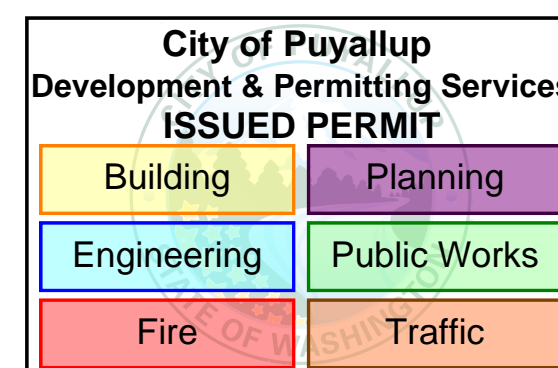

GENERAL NOTES

- CODE CONFLICTS**
ALL CONSTRUCTION SHALL BE DONE IN ACCORDANCE WITH MOST CURRENT APPLICABLE CODE AND ORDINANCES OF CITY OF PUYALLUP
- DISCREPANCY**
IT IS THE CONTRACTOR'S RESPONSIBILITY TO REPORT DISCREPANCIES FOUND WITHIN THESE DOCUMENTS TO THE ARCHITECT AS SOON AS THEY ARE DISCOVERED
- SCALING DRAWINGS**
DO NOT SCALE THE DRAWINGS. CONTACT ARCHITECT WITH ANY CONFLICTS
- DIMENSIONS**
DIMENSIONS ARE TO FACE OF STUD AND FACE OF CONG. U.N.O. CONTRACTOR SHALL VERIFY ALL DIMENSIONS, EXISTING CONDITIONS, AND MEMBER SIZES PERTAINING TO THE WORK PRIOR TO PROCEEDING. ALL DIMENSIONS OF EXISTING CONDITIONS SHOWN ON THE DRAWINGS ARE INTENDED AS GUIDELINES ONLY AND MUST BE VERIFIED. THE ARCHITECT MUST BE NOTIFIED IN WRITING OF ANY VARIATION FROM THE DIMENSIONS AND/OR CONDITIONS SHOWN ON THESE DRAWINGS.
- DOORS AND WINDOWS**
ALL WINDOW AND DOOR SIZES SHALL BE VERIFIED AND FIELD MEASURED PRIOR TO FABRICATION
- EXISTING CONDITIONS**
THE CONTRACTOR SHALL NOTIFY ARCHITECT IMMEDIATELY OF ANY UNCERTAINTIES OR DISCREPANCIES WITHIN THESE DOCUMENTS. CONTRACTOR SHALL PROTECT THE EXISTING SITE WORK, LANDSCAPING, AND AREAS OF THE SITE NOT IN THE SCOPE OF WORK
- DEMOLITION**
CONTRACTOR SHALL VERIFY ALL EXISTING CONDITIONS BEFORE COMMENCING ANY DEMOLITION. DEMOLITION DEBRIS SHALL NOT BE ALLOWED TO DAMAGE OR OVERLOAD THE EXISTING STRUCTURE.
PROTECT EXISTING STRUCTURE TO REMAIN
- HEALTH AND SAFETY**
CONTRACTOR SHALL BE RESPONSIBLE FOR SAFETY PRECAUTIONS AND THE MEANS AND METHODS TO PERFORM THE WORK.
CONTRACTOR SHALL PROVIDE TEMPORARY BRACING FOR THE STRUCTURE AND STRUCTURAL COMPONENTS UNTIL ALL FINAL CONNECTIONS HAVE BEEN COMPLETED IN ACCORDANCE WITH THE PLANS.
- QUALITY STANDARDS**
ALL CONSTRUCTION SHALL MEET OR EXCEED INDUSTRY STANDARDS. DETAILS ARE PROVIDED FOR MINIMUM QUALITY AND TO GIVE STANDARDS OF CONSTRUCTION. IF CONDITION IS NOT SPECIFICALLY DETAILED, SUBMIT A DETAIL FOR GUIDANCE AND REVIEW FOR ACCEPTANCE.
CONTRACTOR SHALL PROVIDE BLOCKING AS REQUIRED FOR ALL CASEWORK, FIXTURE, AND SPECIALTY ITEMS

Glass and Glazing to comply with the IBC provisions of chapter 24.

SYMBOLS LEGEND

ROOM IDENTIFICATION	XXX ###
DOOR NUMBER	###
WINDOW NUMBER	XX
EQUIPMENT NUMBER	#
WALL TYPE	X#
CENTERLINE	⊕
NORTH ARROW	⊕
HOSE BIB	⊥
DATUM	⊕
REVISION	⊕
COLUMN GRID/LINE	#
ENLARGED DETAIL MARK	# A#.#
BUILDING SECTION MARK	X AXX
DETAIL MARK	# X#.#
EXTERIOR ELEVATIONS SYMBOL	X X#.#
INTERIOR ELEVATION SYMBOL	N W(AXX) E S

2018 INTERNATIONAL BUILDING CODE

CHAPTER 3 USE AND OCCUPANCY CLASSIFICATION
OCCUPANCY AS U AND A-3 UNDER SPECIAL PERMIT (SEE NOTE "OCCUPANCY GROUP" UNDER PROJECT SCOPE & INFORMATION ON 01.1)

CHAPTER 5 GENERAL BUILDING HEIGHTS AND AREAS
FOR ALLOWABLE HEIGHT, STORIES, AND BLDG AREA, OCCUPANCY: A-3
CONSTRUCTION TYPE: II-B
NON-SPRINKLER

TABLE 504.3 ALLOWABLE BUILDING HEIGHT AND AREA HEIGHT = 5B --> PROVIDE 28'-10"

TABLE 504.4 ALLOWABLE # OF STORIES # OF STORIES = 2 --> PROVIDE 1 STORY

TABLE 506 ALLOWABLE BUILDING AREA FACTOR (A₁)

NS: 9,500 SQFT

506.2.1 SINGLE-OCCUPANCY, ONE-STORY BUILDINGS

A₁ = A_r + (NS^{1/2})

A_r = 9,500 SQFT | NS = 9,500 SQFT

I_r = 0.81

I_h = (F/P - 0.25)(W/30)

F = 344.75 FT | P = 401.75 FT

W = 30'(344.75)/344.75 = 30

I_h = [(344.75/401.75)-0.25](30/30) = 0.61

A₁ = 9,500 + (9,500*0.61)

= 15,295 SQFT --> PROVIDE 8640 SQFT FOR BOTH EXIST-NEW GREENHOUSE

CHAPTER 6 TYPES OF CONSTRUCTION

TABLE 601 FIRE-RESISTANCE RATING REQUIREMENTS FOR TYPE II-B

STRUCTURAL FRAME: 0 HOUR

BEARING WALLS (ALL):

EXTERIOR: 0 HOUR

INTERIOR: 0 HOUR

NONBEARING WALLS:

EXTERIOR: 0 HOUR (30' SEPARATION DI PER TABLE 602)

INTERIOR: 0 HOUR

FLOOR CONSTRUCTION: 0 HOUR

ROOF CONSTRUCTION: 0 HOUR

602.2 TYPES I AND II

TYPES...II CONSTRUCTION ARE...NONCOMBUSTIBLE MATERIALS

CHAPTER 7 FIRE AND SMOKE PROTECTION

705.3 BUILDINGS ON THE SAME LOT

"EXCEPTIONS": 1. TWO BUILDINGS ON THE SAME LOT SHALL BE...CONSIDERED AS PORTIONS OF ONE BUILDING IF THE AGGREGATE AREA OF SUCH BUILDINGS IS WITHIN THE LIMITS SPECIFIED IN CHAPTER 5 FOR A SINGLE BUILDING

CHAPTER 9 FIRE PROTECTION AND LIFE SAFETY SYSTEMS

906.2.1.3 GROUP A-3
NONE OF THE (3) CONDITIONS EXISTS, THIS FIRE-SPRINKLER IS NOT REQUIRED. BELOW IS THE CONDITION OF THE BUILDING

1. THE FIRE AREA DOES NOT EXCEEDS 12,000 SQFT

2. THE FIRE AREA HAS LESS THAN 300 OCCUPANT LOAD

3. THE FIRE AREA IS LOCATED ON A LEVEL OF EXIST DISCHARGE FLOOR

906.3 SIZE & DISTRIBUTION: LIGHT HAZARD OCCUPANCY | 2-A:10-B

DISTANCE OF TRAVEL TO EXTINGUISHER: 50' (2-A FOR 75', 10-B FOR 50')

CHAPTER 10 MEANS OF EGRESS

TABLE 1004.5 MAX FLOOR AREA ALLOWANCES PER OCCUPANT

TABLE 1004.5 STATES THAT THE NET OCCUPANT LOAD FACTOR FOR UNCONCENTRATED AREA IS 1 OCC PER 15 NET SQFT

* HOWEVER, THE OWNER HAS AGREED TO POST 299 AS MAX OCCUPANT LOAD FOR THE NEW STRUCTURE TO USE AS A-3 UNDER OPERATIONAL PERMIT WITH CENTRAL PIERCE FIRE DISTRICT. THE EXISTING GREENHOUSE WILL REMAIN AS U OCCUPANCY.

CHAPTER 10 MEANS OF EGRESS

1006.2.1 EGRESS

TWO EXITS FROM ANY SPACE IS PROVIDED

MAX EGRESS TRAVEL DI W/O SPRINKLER SYS. = 100 FT

SINCE TRAVEL DISTANCE IS > 100 FT, PROVIDE (2) EXITS

1007.1.1 TWO EXITS

WHERE TWO EXITS...ARE REQUIRED...THEY SHALL BE PLACED A DISTANCE APART EQUAL TO NOT LESS THAN 1/2 OF THE LENGTH OF THE MAX OVERALL DIAGONAL DIM

1008.2 ILLUMINATION REQUIRED

1010.1.10 PANIC AND EXIT HARDWARE

SWINGING DOORS SERVING WITH AN OCCUPANT LOAD MORE THAN 50 IN GROUP A SHALL PROVIDE PANIC HARDWARE

1013.1 EXIT SIGNS REQUIRED

CHAPTER 29 PLUMBING SYSTEMS

TABLE 2902.1 MIN # OF REQ'D PLUMBING FIXTURES

A-3

MALE 1 PER 125 1 PER 200

FEMALE 1 PER 65 1 PER 200

SINCE 299 MAX OCC FOR GREENHOUSES, THIS REQUIRES 1 WC FOR MALE, AND 2 WC FOR FEMALE & 1 LAVATORY EACH. THIS IS PROVIDED IN COMMON'S BUILDING. SEE "PLUMBING NOTE" BELOW AND A1.1

2902.3.3 LOCATION OF TOILET

THE REQUIRED PUBLIC AND EMPLOYEE TOILET FACILITIES SHALL BE PROVIDED ON THE SAME PROPERTY, AND THE PATH OF TRAVEL TO SUCH FACILITIES SHALL NOT EXCEED A DISTANCE OF 500 FT PROVIDED TRAVEL DISTANCE: -235'

2902.5 DRINKING FOUNTAIN LOCATION

DRINKING FOUNTAINS SHALL BE LOCATED WITHIN A DISTANCE OF TRAVEL OF 500 FEET...EXCEPTIONS - DRINKING FOUNTAIN NEED NOT BE PROVIDED IN A DRINKING OR DINING ESTABLISHMENT WITHIN 141' TRAVEL DISTANCE, DRINKING FACILITY IS PROVIDED.

PLUMBING NOTE:

COMMON'S BUILDING HAS A-2 OCCUPANCY AND TOTAL OCCUPANTS OF 860 (RESULT IN 430 MALE AND 430 FEMALE). SEE BELOW TABLE FOR WHAT IS REQUIRED AND PROVIDED AS AN EXISTING CONDITION.

(REFERS TO SUPPLEMENTARY DOCUMENT "SBS GH-Rev01_Supp Drawing-Commons Code Sheet.pdf")

WATER CLOSET REQUIRED PROVIDED EXTRA

MALE 6 WC 3 WC, 7 URINALS 1 WC, 3 URINAL

FEMALE 6 WC 8 WC 2 WC

LAVATORIES

MALE 3 LAV 5 LAV 2 LAV

FEMALE 3 LAV 7 LAV 4 LAV

FOR GREENHOUSE, 150 MALE AND 150 FEMALE REQUIRES (1) WATER CLOSET FOR MALE (1 PER 125), AND (2) WATER CLOSET FOR FEMALE (1 PER 65). ALSO, (1) LAV FOR MALE (1 PER 200), AND (1) LAV FOR FEMALE.

THUS, COMMONS DOES HAVE CAPACITY TO SERVE 1 WC FOR MALE, 2 WC FOR FEMALE, AND 1 LAV EA. FOR GREENHOUSES.

The occupancy classification of U occupancy for use as a greenhouse is allowable. The A-3 occupancy is limited to banquet operations in conjunction with the Annual Operational Permit provisions of the International Fire Code (IFC). The assembly events may not be held in the greenhouse without the issuance and inspection approval of the IFC annual operational permit(s).

Response from Jeff Brown Architecture dated March 06, 2023

This is a greenhouse for cultivating and selling plants for most of the year. But also, during the summer season, this will have no more than 300 people occupied to use as A-3 occupancy under "Operational Permit" with Central Pierce Fire District. A revised code study and exit lighting are added. Also, Mountain Construction is procuring a fire-alarm system for seasonal occupancies.

Per our conversation with building official, permit B-17-0271 will be finalized in conjunction with the current greenhouse addition permit PRCA20220482.

THE APPROVED CONSTRUCTION PLANS, DOCUMENTS AND ALL ENGINEERING MUST BE POSTED ON THE JOB AT ALL INSPECTIONS IN A VISIBLE AND READILY ACCESSIBLE LOCATION.

FULL SIZED LEDGIBLE COLOR PLANS ARE REQUIRED TO BE PROVIDED BY THE PERMITEE ON SITE FOR INSPECTION


Approval of submitted plans is not an approval of omissions or oversights by this office or noncompliance with any applicable regulations of local government. The contractor is responsible for making sure that the building complies with all applicable codes and regulations of the local government.

City of Puyallup Building Accepted

JMontgomery
04/05/2023
10:47:15 AM



Annual operational permit prescribed the International Fire Code will be required each year prior to the greenhouse transition to the banquet events

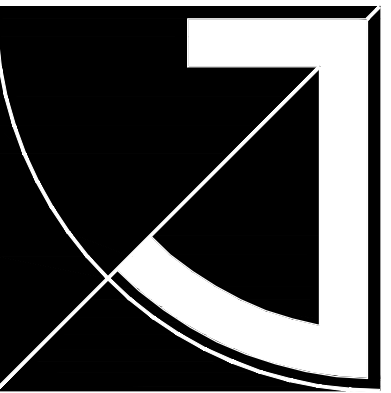


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PROJECT LEAD

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PROJECT NAME/ADDRESS

STEP BY STEP GREENHOUSE
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PROJECT NUMBER

22002

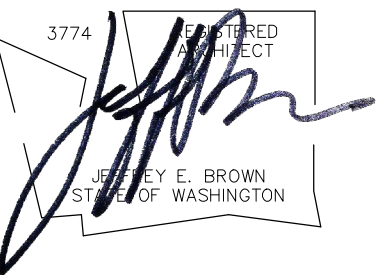DRAWING TYPE

PERMIT DOCUMENTS


ISSUE DATE	ISSUE DESCRIP.	NO.
03.07.22	PERMIT	
11.09.22	REV-CITY	
03.06.23	REV-CITY	
03.24.23	REV-CITY	

SHEET TITLE

GREENHOUSE SITE PLAN


SHEET #

GA1.1


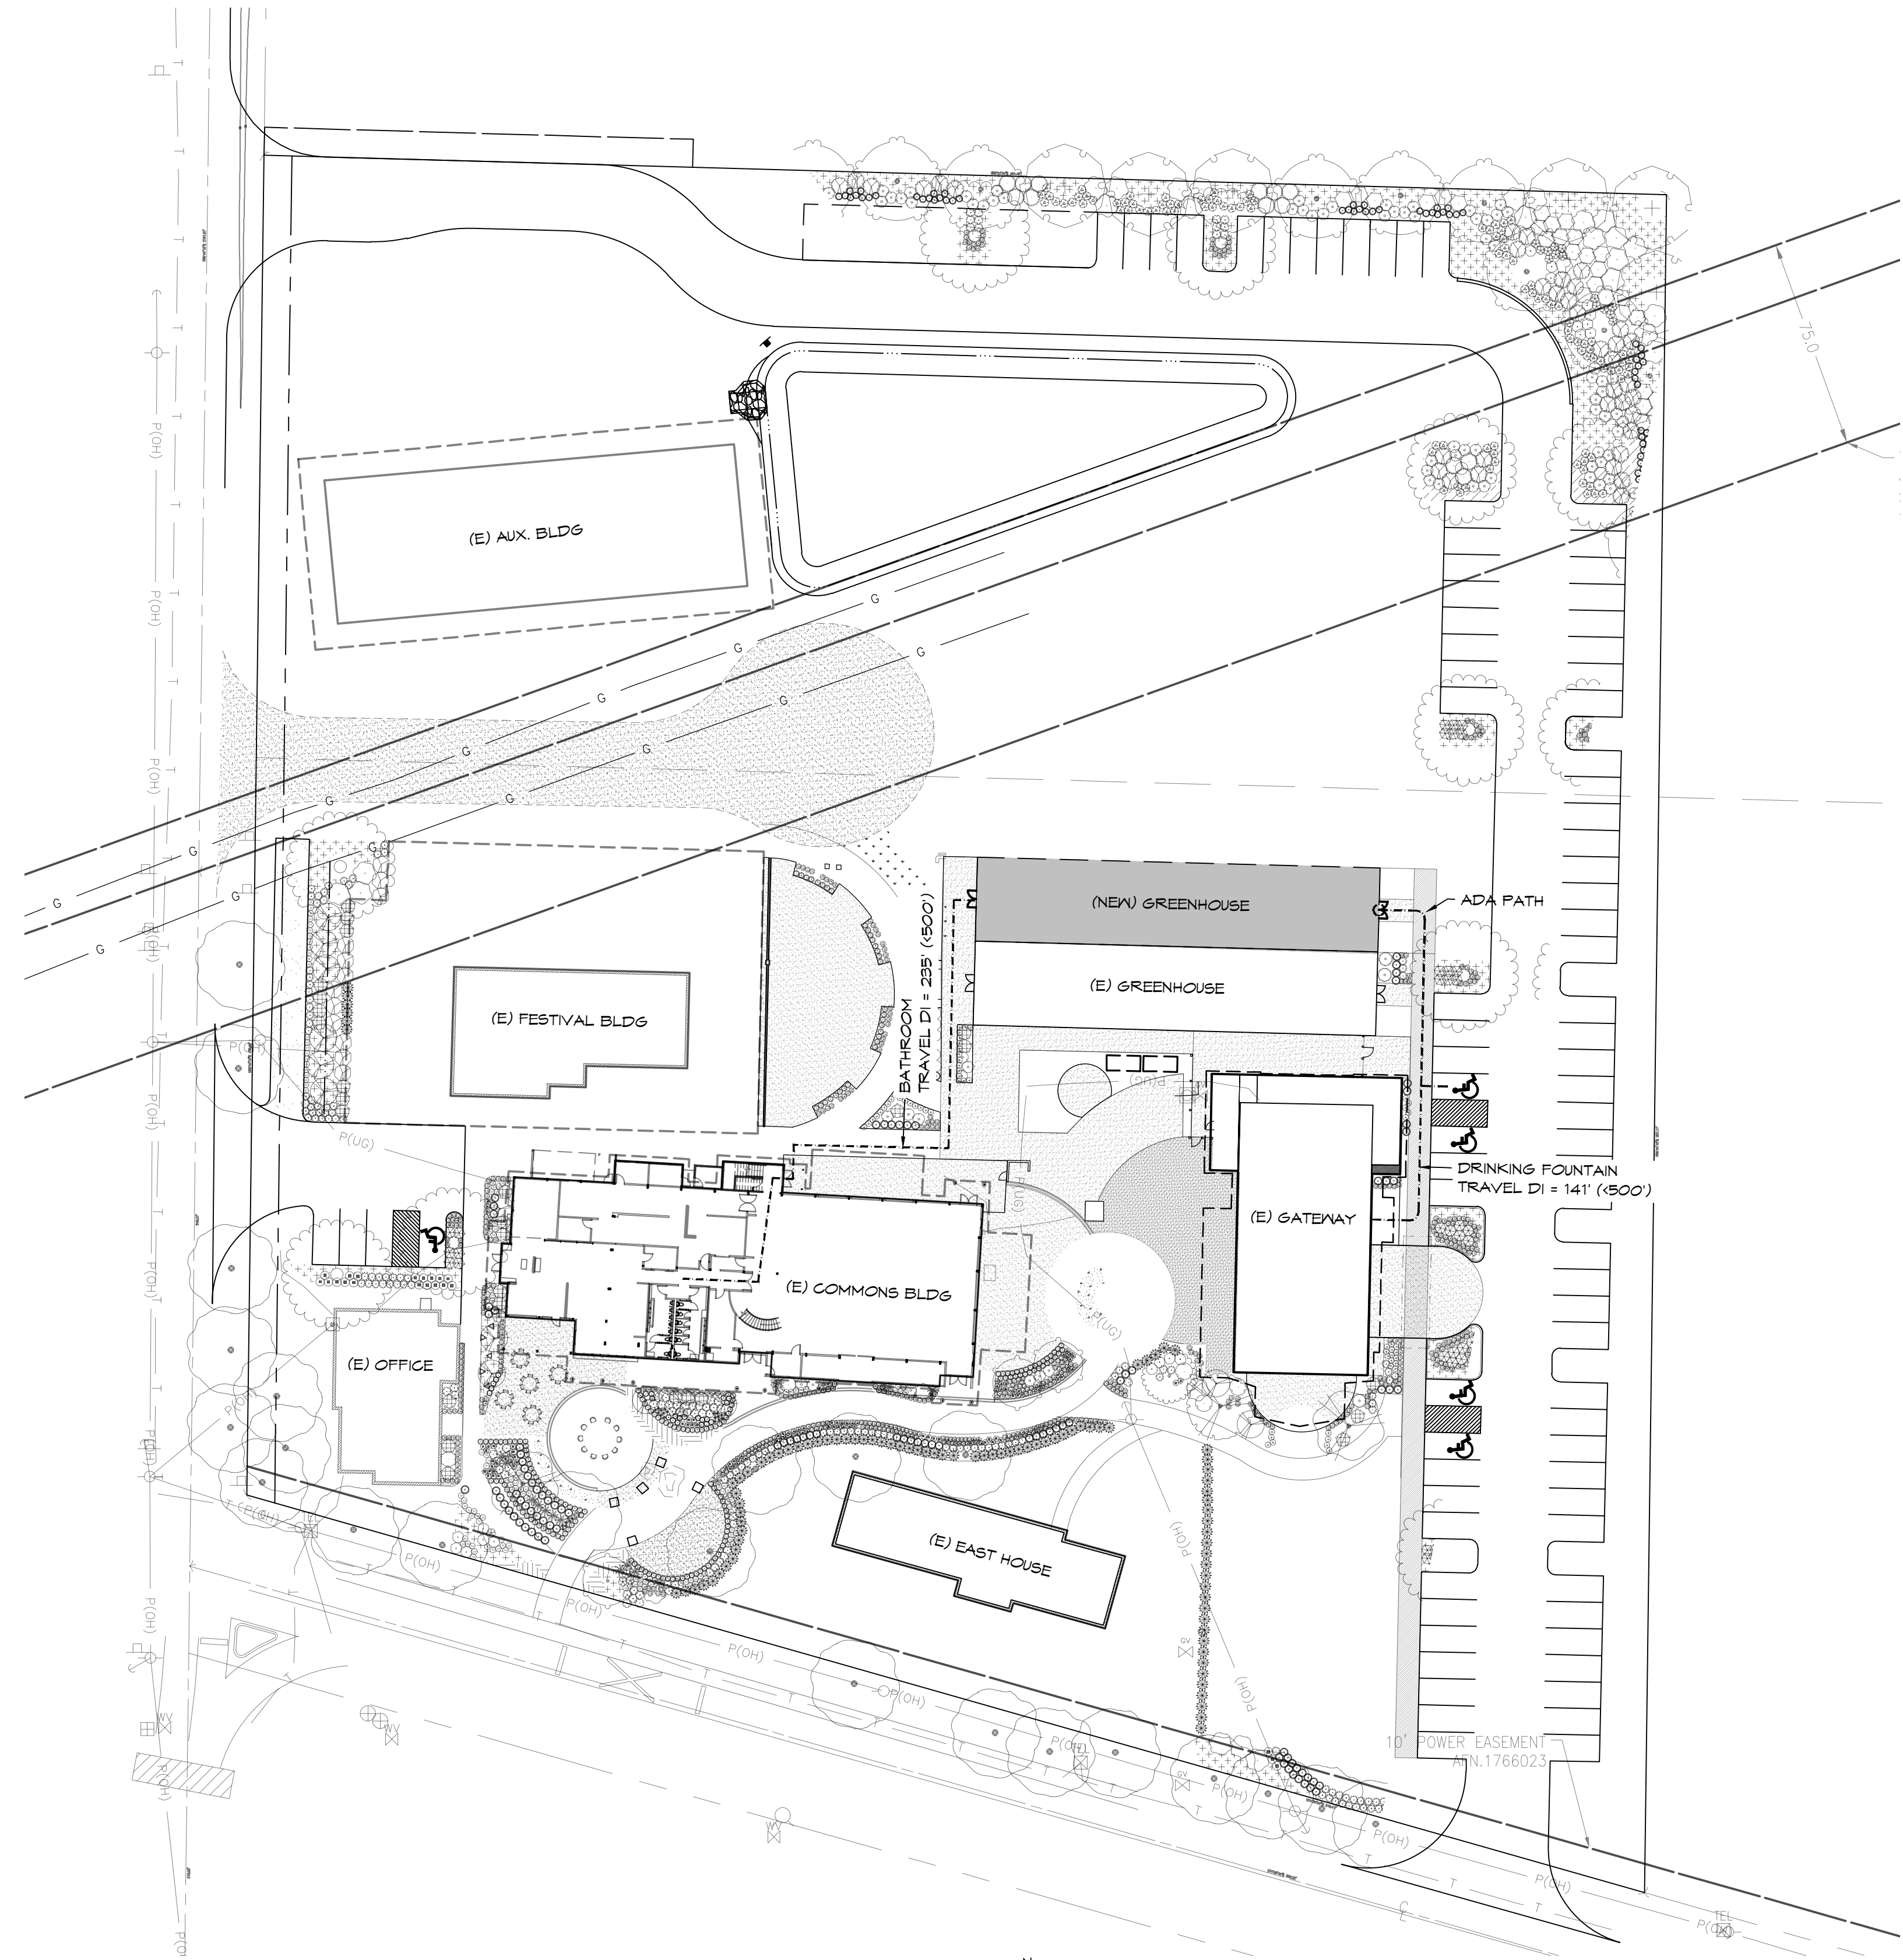


GREENHOUSE ADDITION

(11x17) SCALE: 1" = 80'
(22x34) SCALE: 1" = 40'

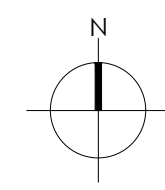


City of Puyallup Development & Permitting Services ISSUED PERMIT	
Building	Planning
Engineering	Public Works
Fire	Traffic

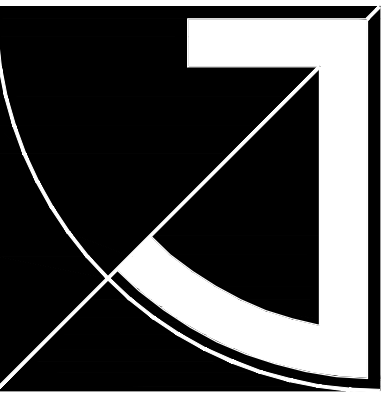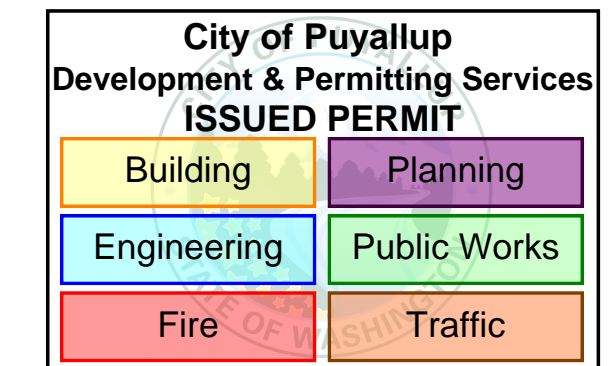

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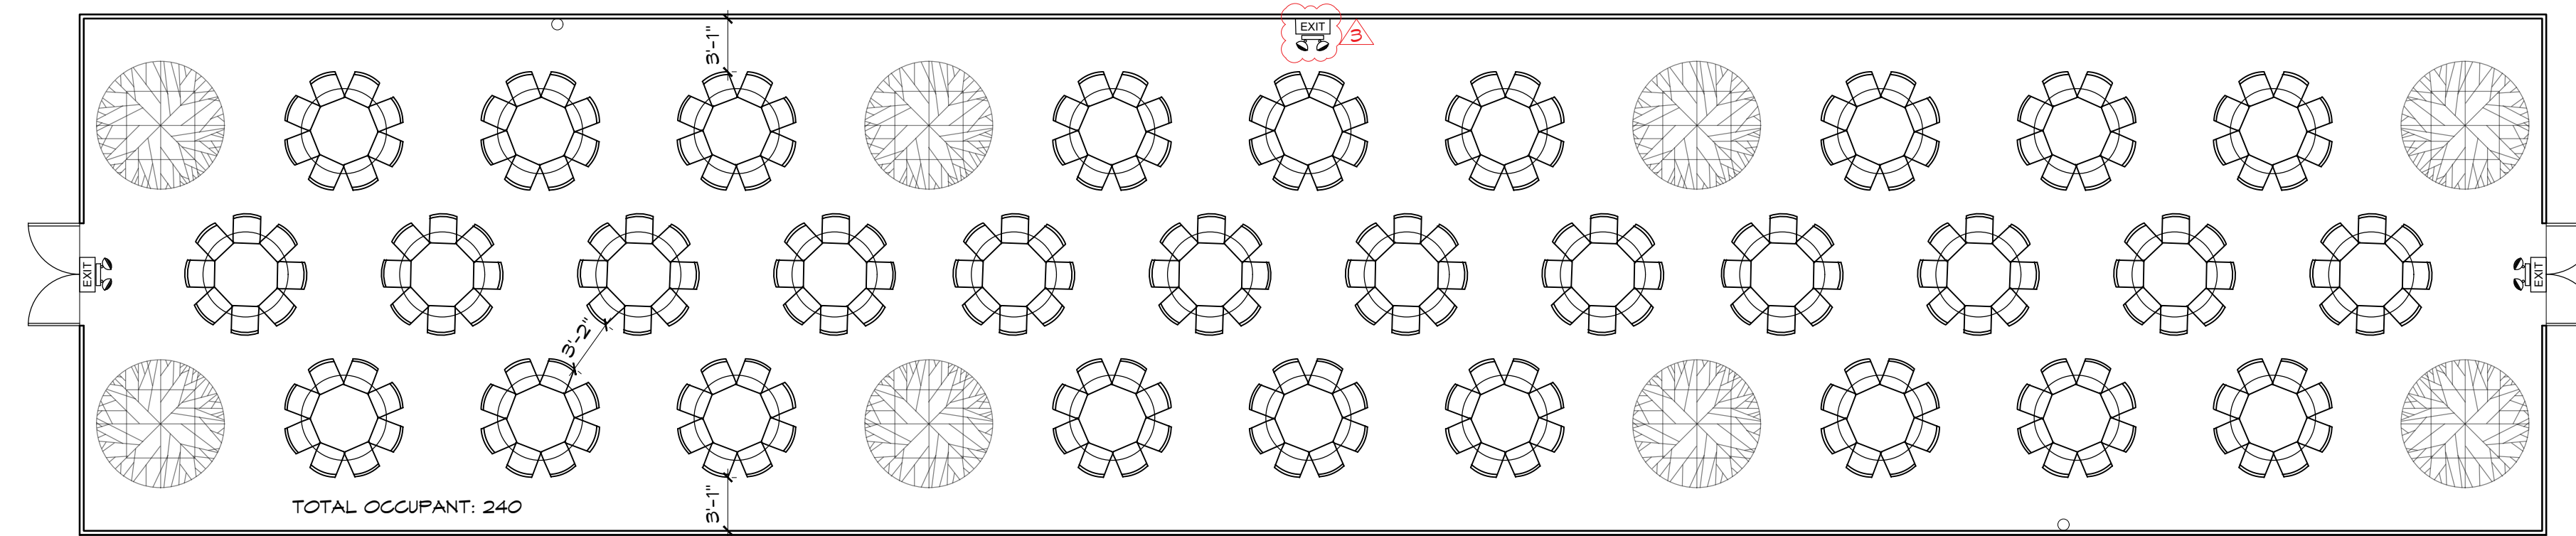
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03.07.22	PERMIT	
11.09.22	REV-CITY	
03.06.23	REV-CITY	2
03.24.23	REV-CITY	3

SHEET TITLE

LAYOUT OPTIONS FLOOR PLAN

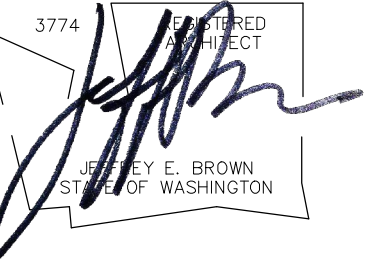SHEET #


A2.1



TOTAL OCCUPANT: 240

EXISTING GREENHOUSE


3 OPTION 02
11X17 SCALE: 1/16" = 1'-0"
22X34 SCALE: 1/8" = 1'-0"

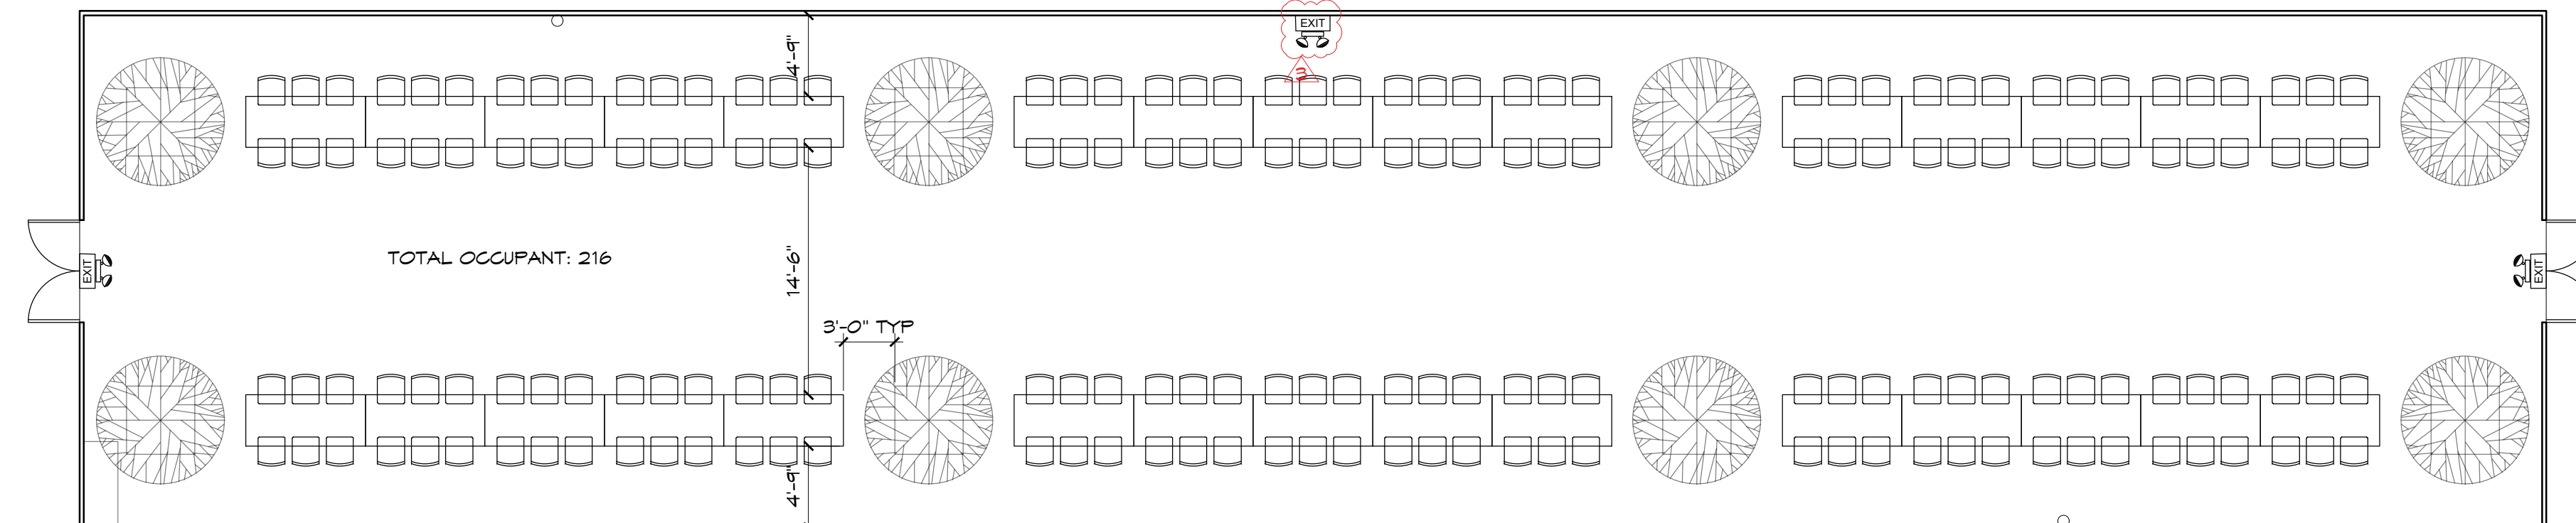

TOTAL OCCUPANT: 216

EXISTING GREENHOUSE

2 OPTION 01
11X17 SCALE: 1/16" = 1'-0"
22X34 SCALE: 1/8" = 1'-0"

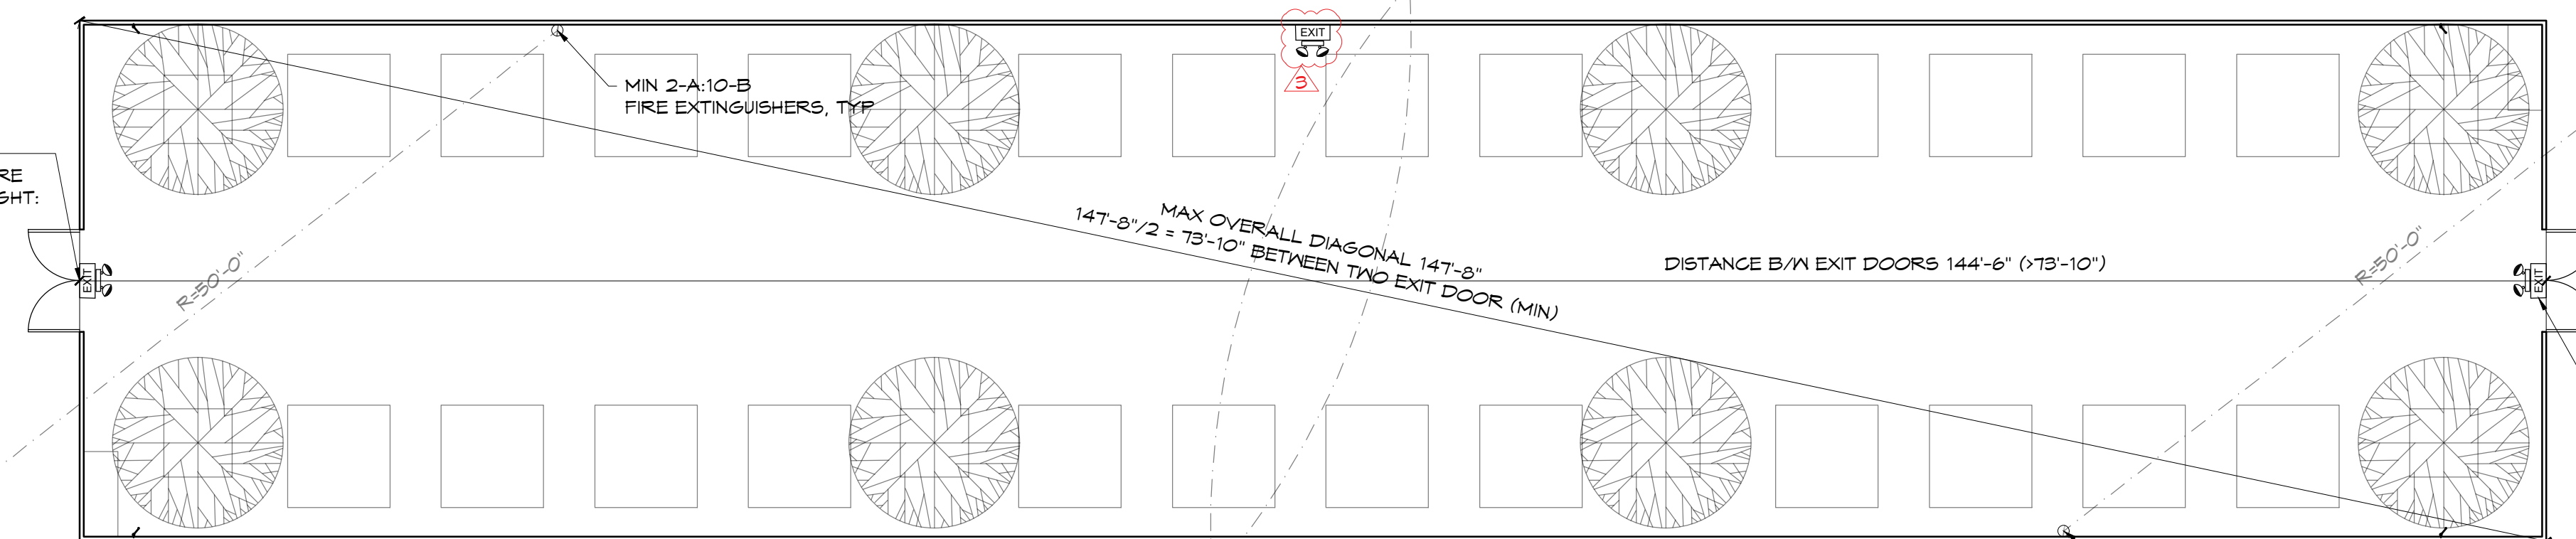

MIN 2-A-10-B FIRE EXTINGUISHERS, TYP

MAX OVERALL DIAGONAL 147'-8"
147'-8"/2 = 73'-10" BETWEEN TWO EXIT DOOR (MIN)

DISTANCE B/W EXIT DOORS 144'-6" (>73'-10")

EXIT DOOR:
- PROVIDE PANIC HARDWARE
- EXIT SIGN & EMERGENCY LIGHT
- BATTERY BACKUP
- DAMPED LABEL

MIN 2-A-10-B FIRE EXTINGUISHERS, TYP

EXIT DOOR:
- PROVIDE PANIC HARDWARE
- EXIT SIGN & EMERGENCY LIGHT
- BATTERY BACKUP
- DAMPED LABEL

NOTE: EXISTING GREENHOUSE REMAIN AS GREENHOUSE THROUGHOUT YEARS TYP

1 PLANT GROWING SEASON LAYOUT
11X17 SCALE: 1/16" = 1'-0"
22X34 SCALE: 1/8" = 1'-0"