


The applicant shall request a sediment control and erosion inspection with a City Engineering Inspector through the CityView portal least 48 hours in advance of job start.

Refer to the Stormwater Fact Sheet and City standard details 02.03.02 & 05.02.01 for typical erosion and sedimentation control methods. Attached in CityView

Attached to this site plan is Standard Detail 04.03.04 for the installation of the required sewer sampling tee

PRUSR20230614

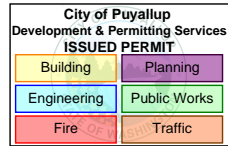

EXISTING PIPE LINE
(APPROX. LOCATION)


PROJECT SCOPE CONSIST OF PROVIDING A 'T'
AND REMOVING AND PROVIDING A NEW CLEAN
OUT 4" FROM THE 'T'.

PROJECT ADDRESS:
1601 INDUSTRIAL PARK WAY, SUITE #100
PUYALLUP, WA 98371

PARCEL NUMBER: 0420212076


Project no: 22.0243.00	Location: PUYALLUP 1	Issued to: CITY OF PUYALLUP	Revision: -	Date: 05.05.23
Title: PUYALLUP 1 SITE PLAN 1601 INDUSTRIAL PARK WAY, SUITE 100 PUYALLUP, WA 98371			Drawn by: MK	Scale: NTS
All reproduction & intellectual property rights reserved c2023			Sketch No.:	SITE

SIDE SEWER CONNECTION

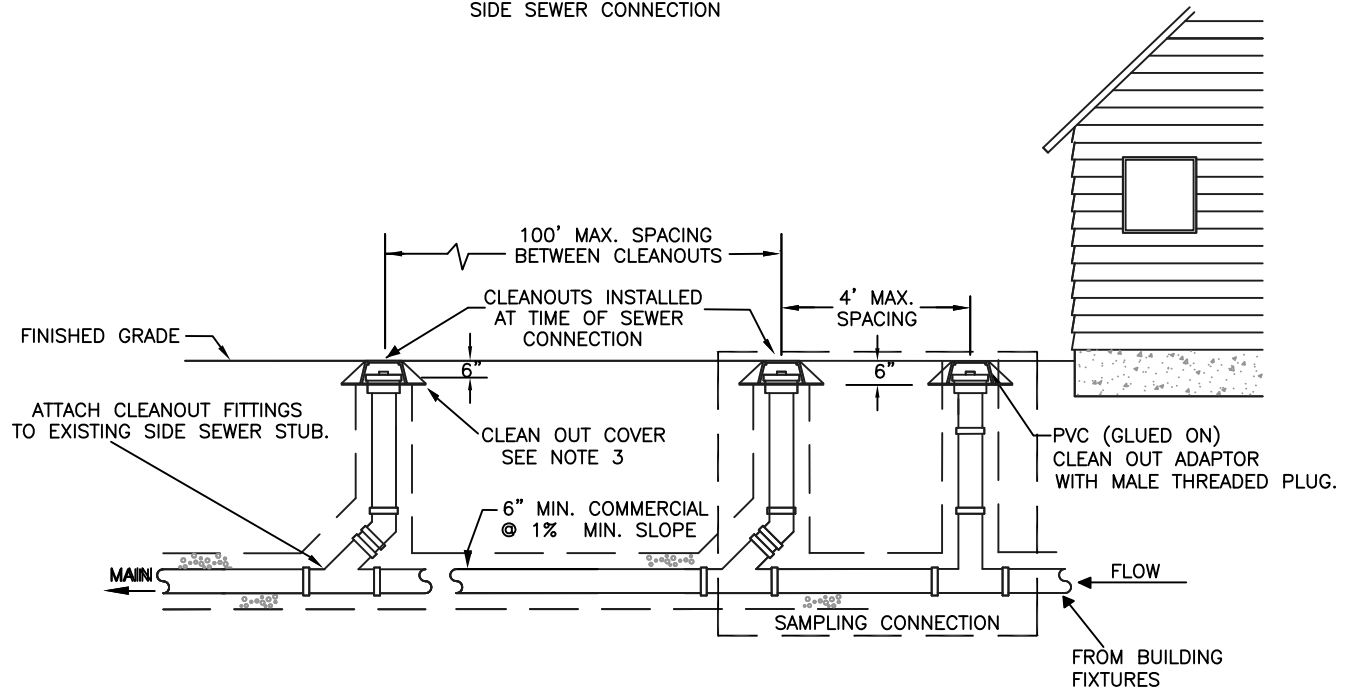

NOTES:

1. SAMPLING CONNECTION SHALL BE INSTALLED OUT SIDE WITH UNOBSTRUCTED ACCESS AT ALL TIMES.
2. A SAMPLING CONNECTION SHALL BE INSTALLED FOR EACH COMMERCIAL / RETAIL UNIT OR SPACE.
3. CLEAN OUT AND SAMPLING CONNECTION COVERS:
 - A) FOR NON-VEHICULAR TRAFFIC INSTALLATIONS USE "CARSON" MODEL 910 GREEN YARD BOX WITH BOLT DOWN LID MARKED SEWER OR APPROVED EQUAL.
 - B) FOR ASPHALT, GRAVEL, OR TRAFFIC INSTALLATIONS SEE CITY STANDARD DETAIL NO. 04.03.05 FRAME AND COVER SECTION.
4. EACH CLEANOUT ASSEMBLY SHALL CONSIST OF: ONE CLEANOUT ADAPTER, HUB x FEMALE, FIPT, PVC SI AND ONE CLEANOUT PLUG, MOPT WITH RAISED NUT, PVC SDR35.

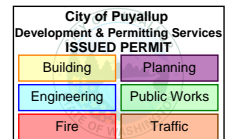

**CITY OF
PUYALLUP**

DEVELOPMENT ENGINEERING and
PUBLIC WORKS DEPARTMENTS

COMMERCIAL SIDE SEWER CONNECTION WITH SAMPLING CONNECTION

DRAWN BY
JIM ERWIN-SVOBODA

CHECKED BY
LINDA LIAN

APPROVED BY
COLLEEN HARRIS

REVISED BY
LINDA LIAN

CITY
STANDARD

FILE NAME
F:\DWG\COMMON\STD\SCITY\2009\04_SS\04.03\04.03.04

DATE APPROVED
07/01/2009

DATE REVISED
03/21/11

SCALE
1:4

04.03.04