DRAWING DIRECTORY

SHEET #:	SHEET TITLE:
FA-01	COVER SHEET, BILL OF MATERIALS AND GENERAL INFORMATION
FA-02	DEVICE LAYOUT & BATTERY CALCULATIONS


MONITORING COMPANY INFORMATION

COMPANY NAME	ALARM CENTER INC.
PHONE NUMBER	1-800-752-2490
ADDRESS	4500 3RD AVE SE #1, LACEY, WA 98503
ACCOUNT NUMBER	T.B.D.
RECEIVER NUMBER 1	N/A
RECEIVER NUMBER 2	N/A

CONSULTANTS

PROJECT NAME: PUYALLUP RIVER ROAD 1002 N. MERIDIAN ST. PUYALLUP, WA 98371 FIRE ALARM SUPPLIER: NORTHWEST FIRE SYSTEMS 22645 83RD AVE S. KENT, WA 98032 PHONE: (206)772-7502 WWW.NWFIRESYSTEMS.COM REFERENCES: NFPA 70 NATIONAL ELECTRICAL CODE (2020) NFPA 72 NATIONAL FIRE CODE (2020) UL-864 AND OTHER APPLICABLE STANDARDS COMPLETE FIRE PROTECTION SYSTEM, UL LISTED CONFORM TO REQUIREMENTS OF NFPA APPLICABLE SECTIONS THE AMERICAN DISABILITIES ACT (ADA) CITY OF PUYALLUP FIRE CODE (2021) ALL MANUFACTURER GUIDELINES AND REQUIREMENTS

EQUIPMENT MOUNTING HIGHTS

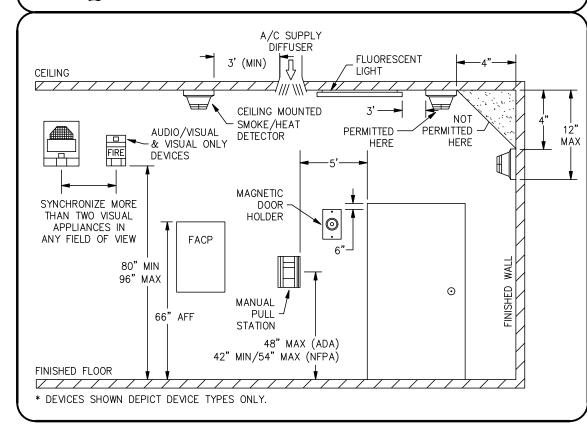

GENERAL FIRE ALARM NOTES

- 1. FIRE ALARM SYSTEM IS POWER LIMITED.
- 2. ALL RACEWAYS MUST BE FREE OF MOISTURE.
- 3. REFER TO DATA SHEETS FOR PROPER TYPE AND SIZES OF REQUIRED DEVICE MOUNTING ELECTRICAL BOXES.
- 4. AC VOLTAGE IS NOT PERMITTED IN THE SAME RACEWAY AS FIRE ALARM WIRING.
- 5. UNRELATED (NON-FIRE ALARM) WIRE SHALL NOT BE IN THE SAME RACEWAY AS FIRE ALARM WIRE.
- 5. ALL CONTRACTOR FIELD WIRING MUST ENTER ALARM CONTROL PANEL BACKBOX FOLLOWING POWER—LIMITING AND NON POWER—LIMITING WIRING REQUIREMENTS. REFER TO INSTALLATION INSTRUCTIONS FOR MORE INFORMATION.
- ZONE CIRCUITS AND SIGNAL CIRCUITS ARE ELECTRICALLY SUPERVISED.

 BRANCH CIRCUITS SHALL BE LOOPED TO MAINTAIN INTEGRITY OF SUPERVISED CIRCUITS. T—TAPPING OF ZONE AND SIGNAL CIRCUITS IS NOT PERMITTED.
- 8. REFER TO FACP MODULE DIAGRAMS, INCLUDED WITH FACP, FOR SPECIFICATIONS AND INFORMATION ON INDIVIDUAL PANEL MODULES.
- 9. ALL FIRE ALARM WIRING SHALL TEST FREE OF OPENS, SHORTS, AND GROUNDS.
- 10. ALL WIRING SHALL BE LABELED AND TAGGED.
- 11. ALL WIRING SHALL MEET ALL APPLICABLE NATIONAL ELECTRICAL CODE ARTICLES FOR FIRE ALARM AND LOW—VOLTAGE WIRING.
- 12. DO NOT USE FIRE ALARM CABINET AS TERMINAL CABINET.

PUYALLUP RIVER ROAD FIRE ALARM SYSTEM TI 1002 N. MERIDIAN ST. PUYALLUP, WA 98371

SCOPE OF WORK:

NORTHWEST FIRE SYSTEMS WILL BE REPLACING THE EXITING MALFUNCTIONING CONVENTIONAL FIRE ALARM PANEL WITH A NEW CONVENTIONAL FIRE ALARM PANEL. THE EXISTING AES RADIO WILL ALSO BE REPLACED WITH A NEWER MODEL TO ENSURE CONTINUES MONITORING OF THE FIRE ALARM SYSTEM. ONE MANUAL PULL STATION WILL BE INSTALLED IN THE NAIL & SPA SUITE. ALL EXISTING NOTIFICATION AND INITIATING DEVICES WILL REMAIN AS IS. CURRENT READINGS HAVE BEEN TAKEN OF THE EXISTING SYSTEM TO PROVIDE BATTERY CALCULATIONS FOR THE NEW FACP.

NOTE THE BUILDING HAS COMPLETE SPRINKLER COVERAGE.

INPUT CONDITION

STANDBY CONDITION (NORMAL)

COMM. FAULT/AES TROUBLE

SPRINKLER TAMPER SWITCH

FIRE ALARM PULL STATION

SPRINKLER WATERFLOW SWITCH

NOTE: NOT ALL OF THE MATRIX IS NECESSARILY USED FOR THIS PROJECT

SMOKE DETECTOR

HEAT DETECTOR

, ANY CIRCUIT - OPEN, SHORT, GROUND

BATTERY FAULT - LOW/HIGH VOLTAGE

AC POWER FAILURE

ZONE TROUBLE

THIS DRAWING CONTAINS CONFIDENTIAL PROPRIETARY INFORMATION OF NORTHWEST FIRE SYSTEMS.

ALL RIGHTS ARE EXPRESSLY RESERVED. IT IS SUBMITTED UNDER A TRUST RELATIONSHIP FOR YOUR

USE IN CONSIDERING THE PURCHASE OF THE EQUIPMENT DESCRIBED HEREON FROM NORTHWEST FIRE

SYSTEMS. THIS DRAWING IS NOT TO BE USED FOR ANY OTHER PURPOSE NOR COPIED IN WHOLE OR

PART NOR ITS DESIGN FEATURES USED IN OTHER PRODUCTS WITHOUT OUR WRITTEN CONSENT.

IT IS TO BE RETURNED WHEN NO LONGER REQUIRED, OR UPON REQUEST.

DESCRIPTION

LEGEND	PART NUMBER	QTY.	DESCRIPTION
FACP	SK-5802	1	FIRE ALARM CONTROL PANEL
	12V8AH	2	12VDC 8AHR BATTERIES
AES	AES-7707	1	AES RADIO COMMUNICATOR
	12V10AH	1	12VDC 10AHR BATTERIES
F	BG-12	1	CONVENTIONAL DOUBLE ACTION PULL STATION

	ABBREVIATIONS
FACP	FIRE ALARM CONTROL PANEL
AFF	ABOVE FINISHED FLOOR
BFF	BELOW FINISHED FLOOR
WP	WEATHER PROOF
H/S	HORN STROBE
S	SMOKE DETECTOR
Р	MANUAL PULL
Н	HEAT DETECTOR
WF	WATERFLOW SWITCH
SCM	SUPERVISED CONTROL MODULE
MM	MONITOR MODULE
Т	TAMPER SWITCH

SYSTEM
ANNUNCIATION &
TRANSMISSION

SEQUENCE OF


OPERATIONS

STATION MONITORIN

FIRE ALARM
CONTROL PANEL

City of Puyallup
Development & Permitting Services
ISSUED PERMIT
Building Planning
Engineering Public Works


Traffic

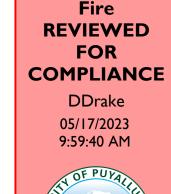

City of Puyallup

THE APPROVED CONSTRUCTION PLANS AND ALL ENGINEERING MUST BE POSTED ON THE JOB AT ALL INSPECTIONS IN A VISIBLE AND READILY ACCESSIBLE LOCATION.

Approval of submitted plans is not an approval of omissions or oversight by this office or noncompliance with any applicable regulations of local government. The contractor is responsible for making sure that the building complies with all applicable building codes and regulations of the local government.

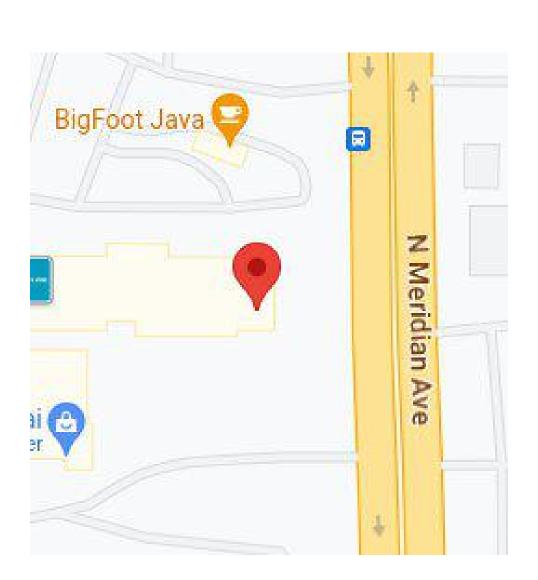





DRAWN BY: DATE:
JOE SHELDON 4/15/23

DESIGNED BY: DATE:
JOE SHELDON 4/15/23

APPROVED BY: DATE:

MIKE REGAN 4/18/23

Michael Regan, ET

Michael Regan, ET

NICET Level III Fire Alarm
Technician ID: 144327


PROJECT NUMBER: 05165L


Expires: 03/01/2026

SHEET TITLE: COVER PAGE & GENERAL INFORMATION

> FA - 01 OF 02

SHEET NUMBER:

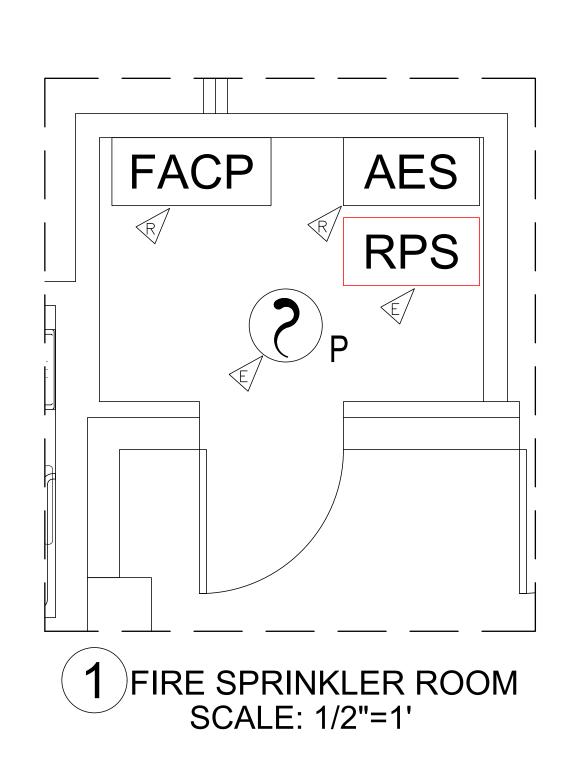

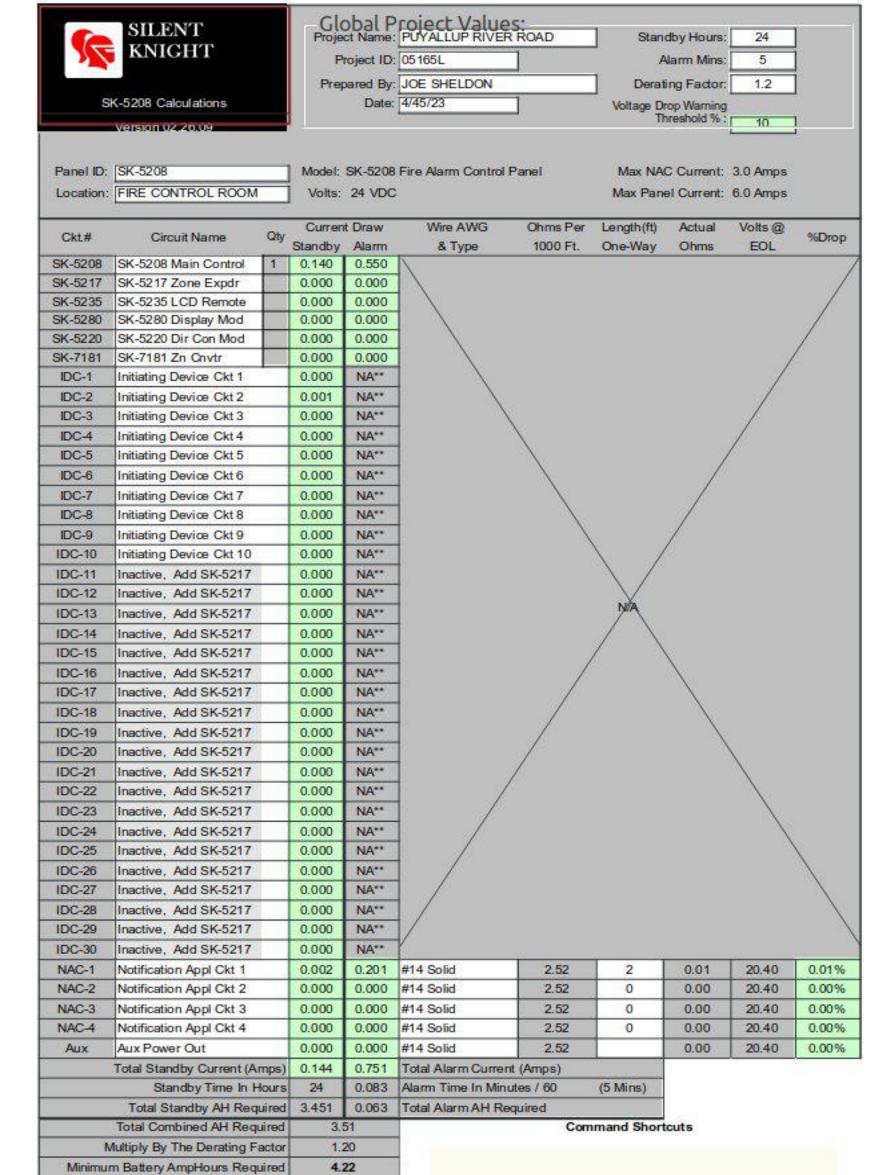

FACP	FIRE ALARM VOICE EVACUATION CONTROL PANEL
RPS	NOTIFICATION POWER SUPPLY (EXISTING)
F	CONVENTIONAL FIRE ALARM PULL STATION (EXISTING)
S ^b	CONVENTIONAL SMOKE DETECTOR (EXISTING)
F	CONVENTIONAL HEAT DETECTOR (EXISTING)
<u> </u>	CONVENTIONAL DUCT DETECTOR (EXISTING)
	HORN/STROBES(CEILING MOUNT) (EXISTING)
	STROBES(CEILING MOUNT) (EXISTING)
	STROBES(WALL MOUNT) (EXISTING)
	HORN/STROBES(WALL MOUNT) (EXISTING)

(FLAG	DESCRIPTIONS
FLAG SYMBOL	DESCRIPTION
A	DEVICE TO BE ADDED
AB	DEVICE IS LOCATED ABOVE CEILING
	DEVICE TO BE REMOVED
E	EXISTING DEVICE
M	EXISTING MEZZANINE DEVICE
R	DEVICE TO BE REPLACED
(

NOTES

(1) ALL INITIATING AND NOTIFICATION DEVICES ARE EXISTING AND WILL REMAIN AS IS.

(2) EXISTING CIRCUIT INTEGRITY SHALL BE MAINTAINED.

(3) THE NEW PULL STATION IN THE LE BELLE NAIL & SPA SUITE WILL BE LOCATED ON THE WEST WALL CLOSEST TO THE FRONT DOORS. THE EXTERIOR WALL IS ALL GLASS.

		Minimum Battery Amprious Required 4.22		
F	F (3)	F	F	WP F
THE UPS STORE	D _P LA BELLE NAILS & SPA SUBWAY AB D _P	GREAT CLIPS Op GREAT CLIPS Op AB Op GENTS		Op 5 GUYS BURGERS & FRIES
AB AB	AB AB	AB OP	OP AB OP — —	
AB	AB AB		Op Op	⊕ F
O P AB	OP OF FAC	AB AB	2 P P P P P P P P P P P P P P P P P P P	P P P P P P P P P P P P P P P P P P P
F	P P P P P P P P P P P P P P P P P P P	P D S	2 ₽ 3 ₽	⊗
	SCOPE OF WORK —	DEVICE LAYOUT		

SCALE: 1/8"=1'

City of Puyallup Development & Permitting Services ISSUED PERMIT				
Building	Planning			
Engineering	Public Works			
Fire OF W	Traffic			



	THE		Pro		
REVISION DESCRIPTION					
DATE	4/15/23				
ВУ	J.S.				
NO.	0				
			<u></u>) !	
	NO. BY DATE REVISION DESCRIPTION	DATE REVISION DESCRIPTION 4/15/23 SUBMITTAL DRAWINGS	NO. BY DATE REVISION DESCRIPTION 0 J.S. 4/15/23 SUBMITTAL DRAWINGS	NO. BY DATE REVISION DESCRIPTION 0 J.S. 4/15/23 \$UBMITTAL DRAWINGS	DATE REVISION DESCRIPTION 4/15/23 SUBMITTAL DRAWINGS

DRAWN BY: DATE:

JOE SHELDON 4/15/23 DESIGNED BY: DATE:

JOE SHELDON 4/15/23 APPROVED BY DATE: MIKE REGAN 4/18/23

NICET STAMP Michael Regan, ET Michael Regard NICET Level III Fire Alarm

Technician ID: 144327 Expires: 03/01/2026

PROJECT NUMBER: 05165L

SHEET TITLE: DEVICE LAYOUT & BATTERY CALCULATIONS SHEET NUMBER:

FA - 02 OF 02