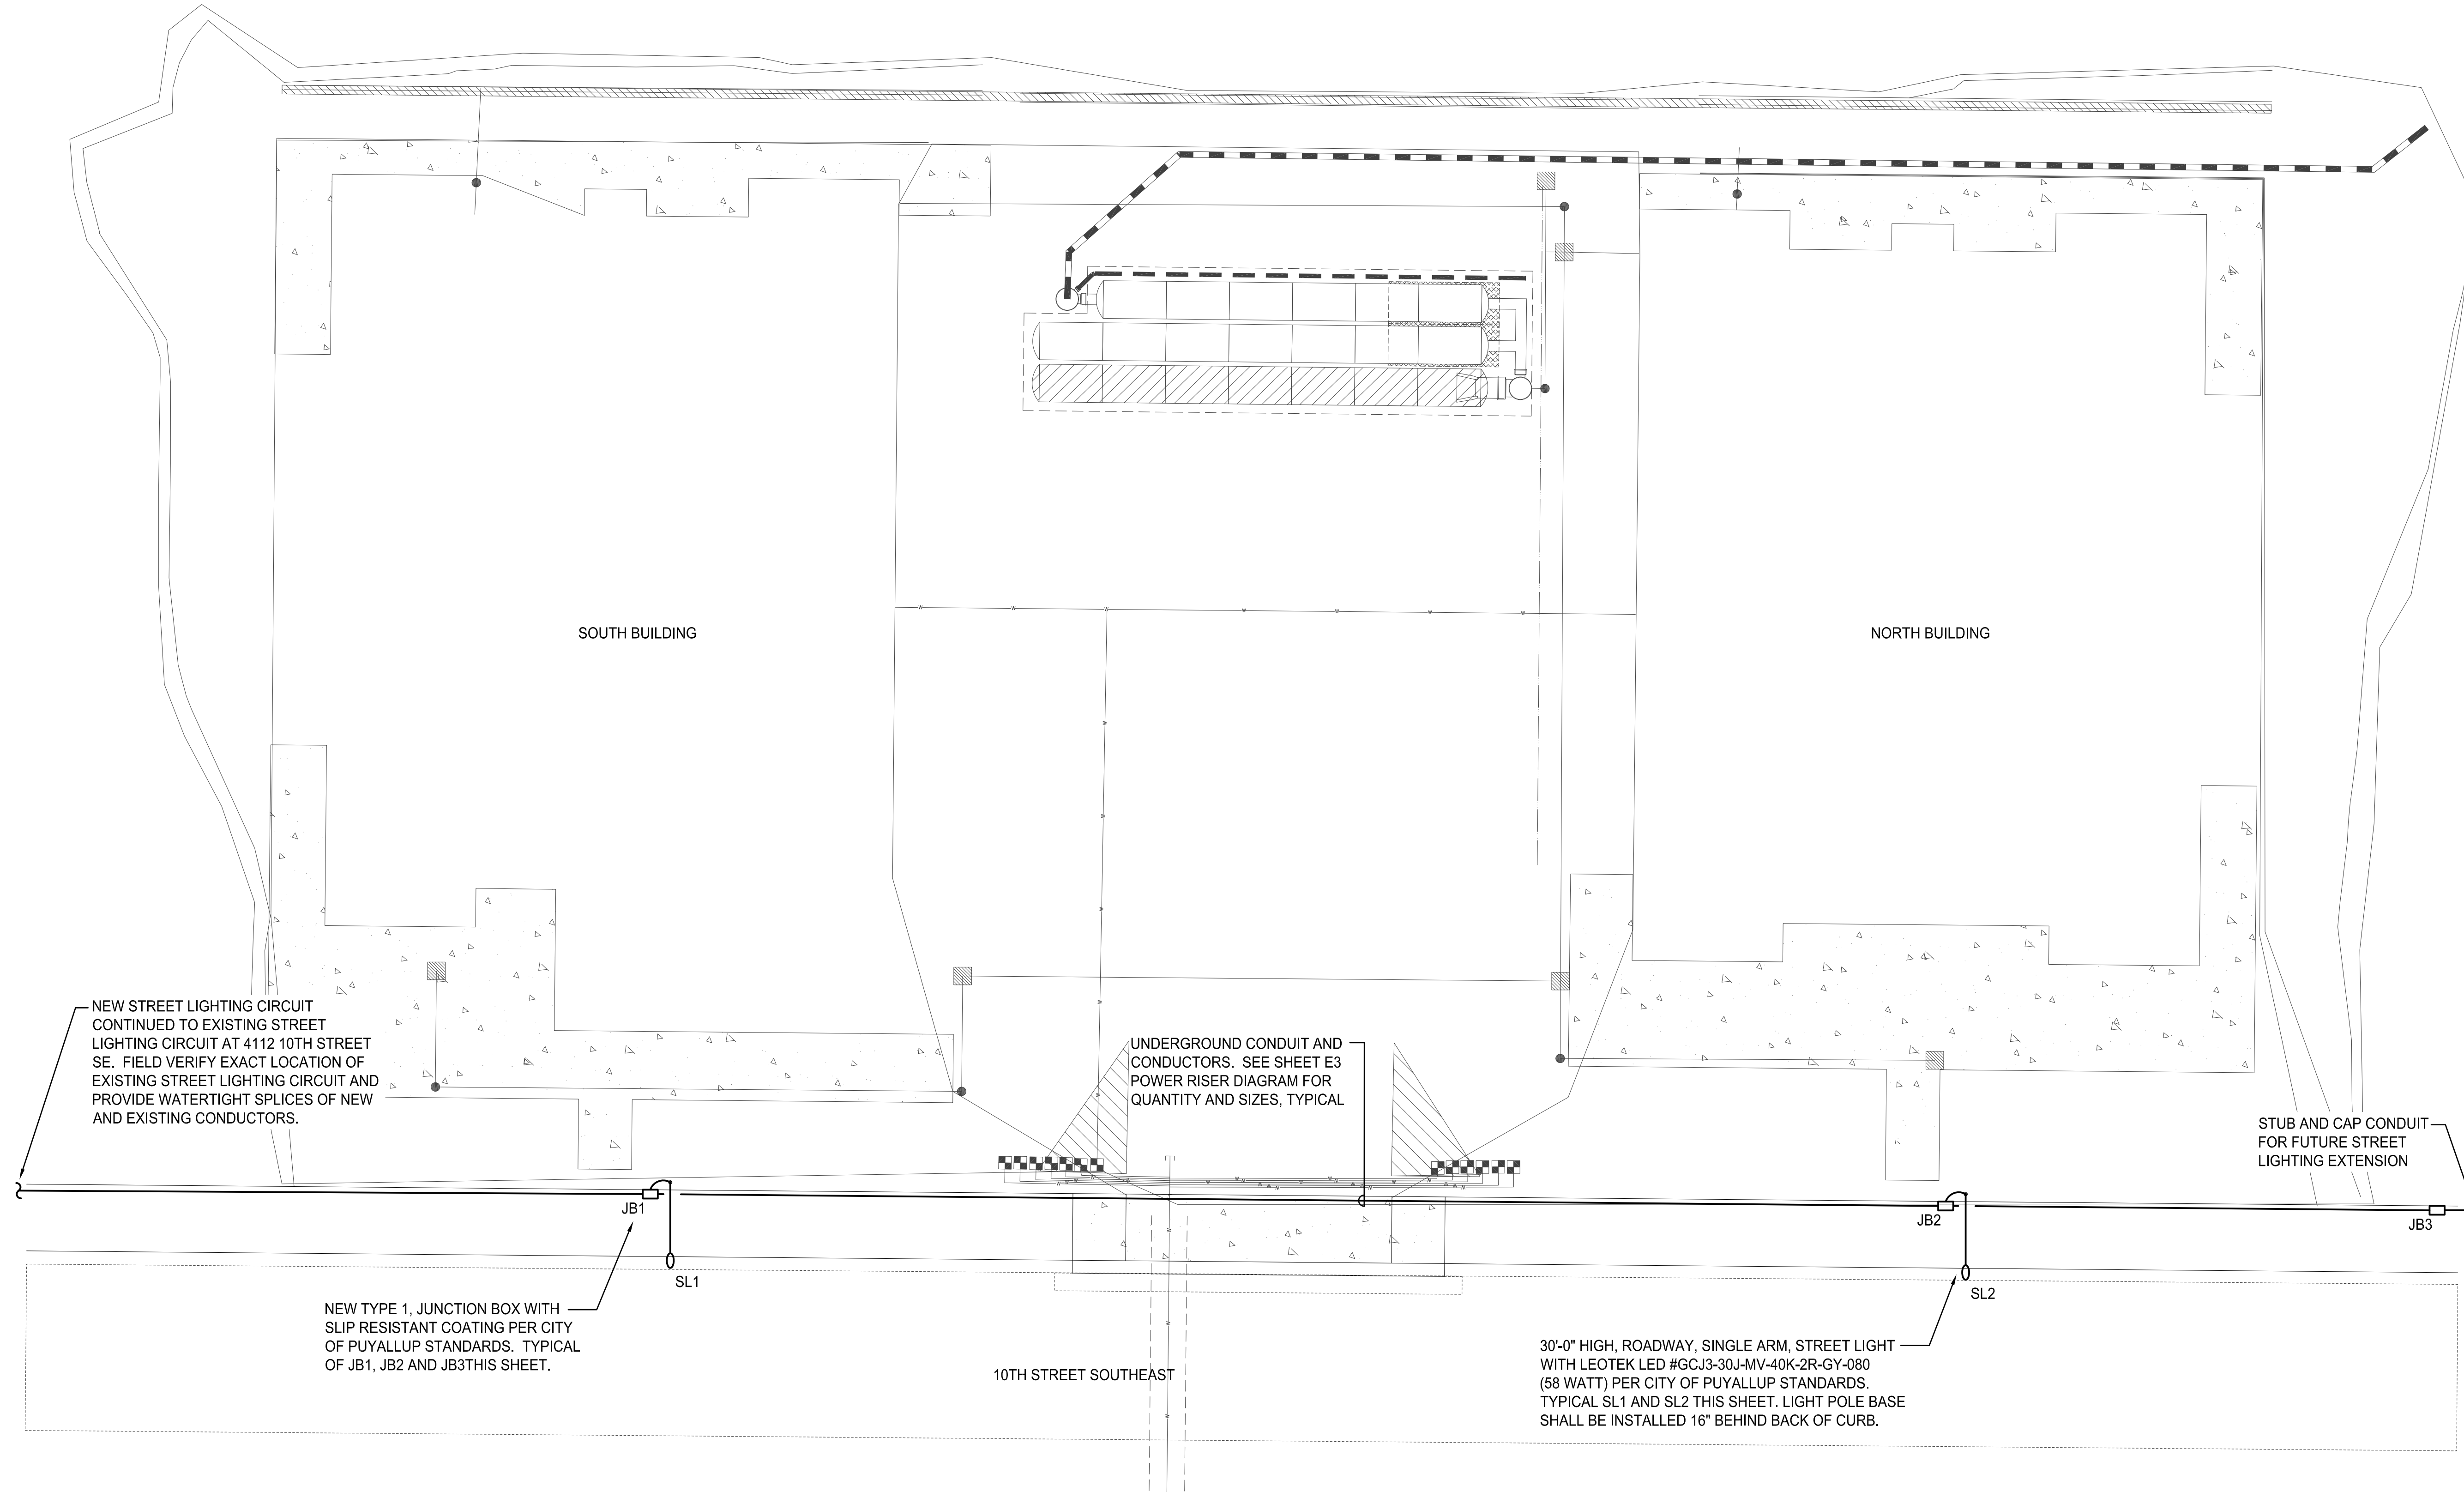


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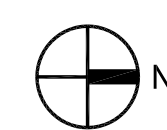
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- INSTALL PHOTOCCELL ON LUMINAIRE POLE PER CITY STANDARD DETAIL 01.05.10.

Plotted: Jun 27, 2023 - 1:37pm File: C:\Users\scottk.CROSSENGINEERS\AppData\Local\Temp\AcPublish_11184\23-101-E1.dwg By: SCOTTK

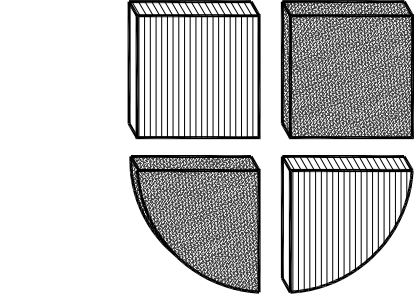


STREET LIGHTING ELECTRICAL SITE PLAN

SCALE: 1"=10'-0"



PERMIT SUBMITTAL



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 info@crossengineers.com
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 Job Number: 23-101

COOPERBERRY STREET LIGHTING
4018 10TH STREET EAST
PUYALLUP, WA 98374


STREET LIGHTING ELECTRICAL SITE PLAN

REVISIONS:




SCALE: AS NOTED	SHEET
DATE: 6-27-2023	E1
DRAWN BY: SJK	
CHECKED BY: SLH	
JOB NO.: 23-101	OF -

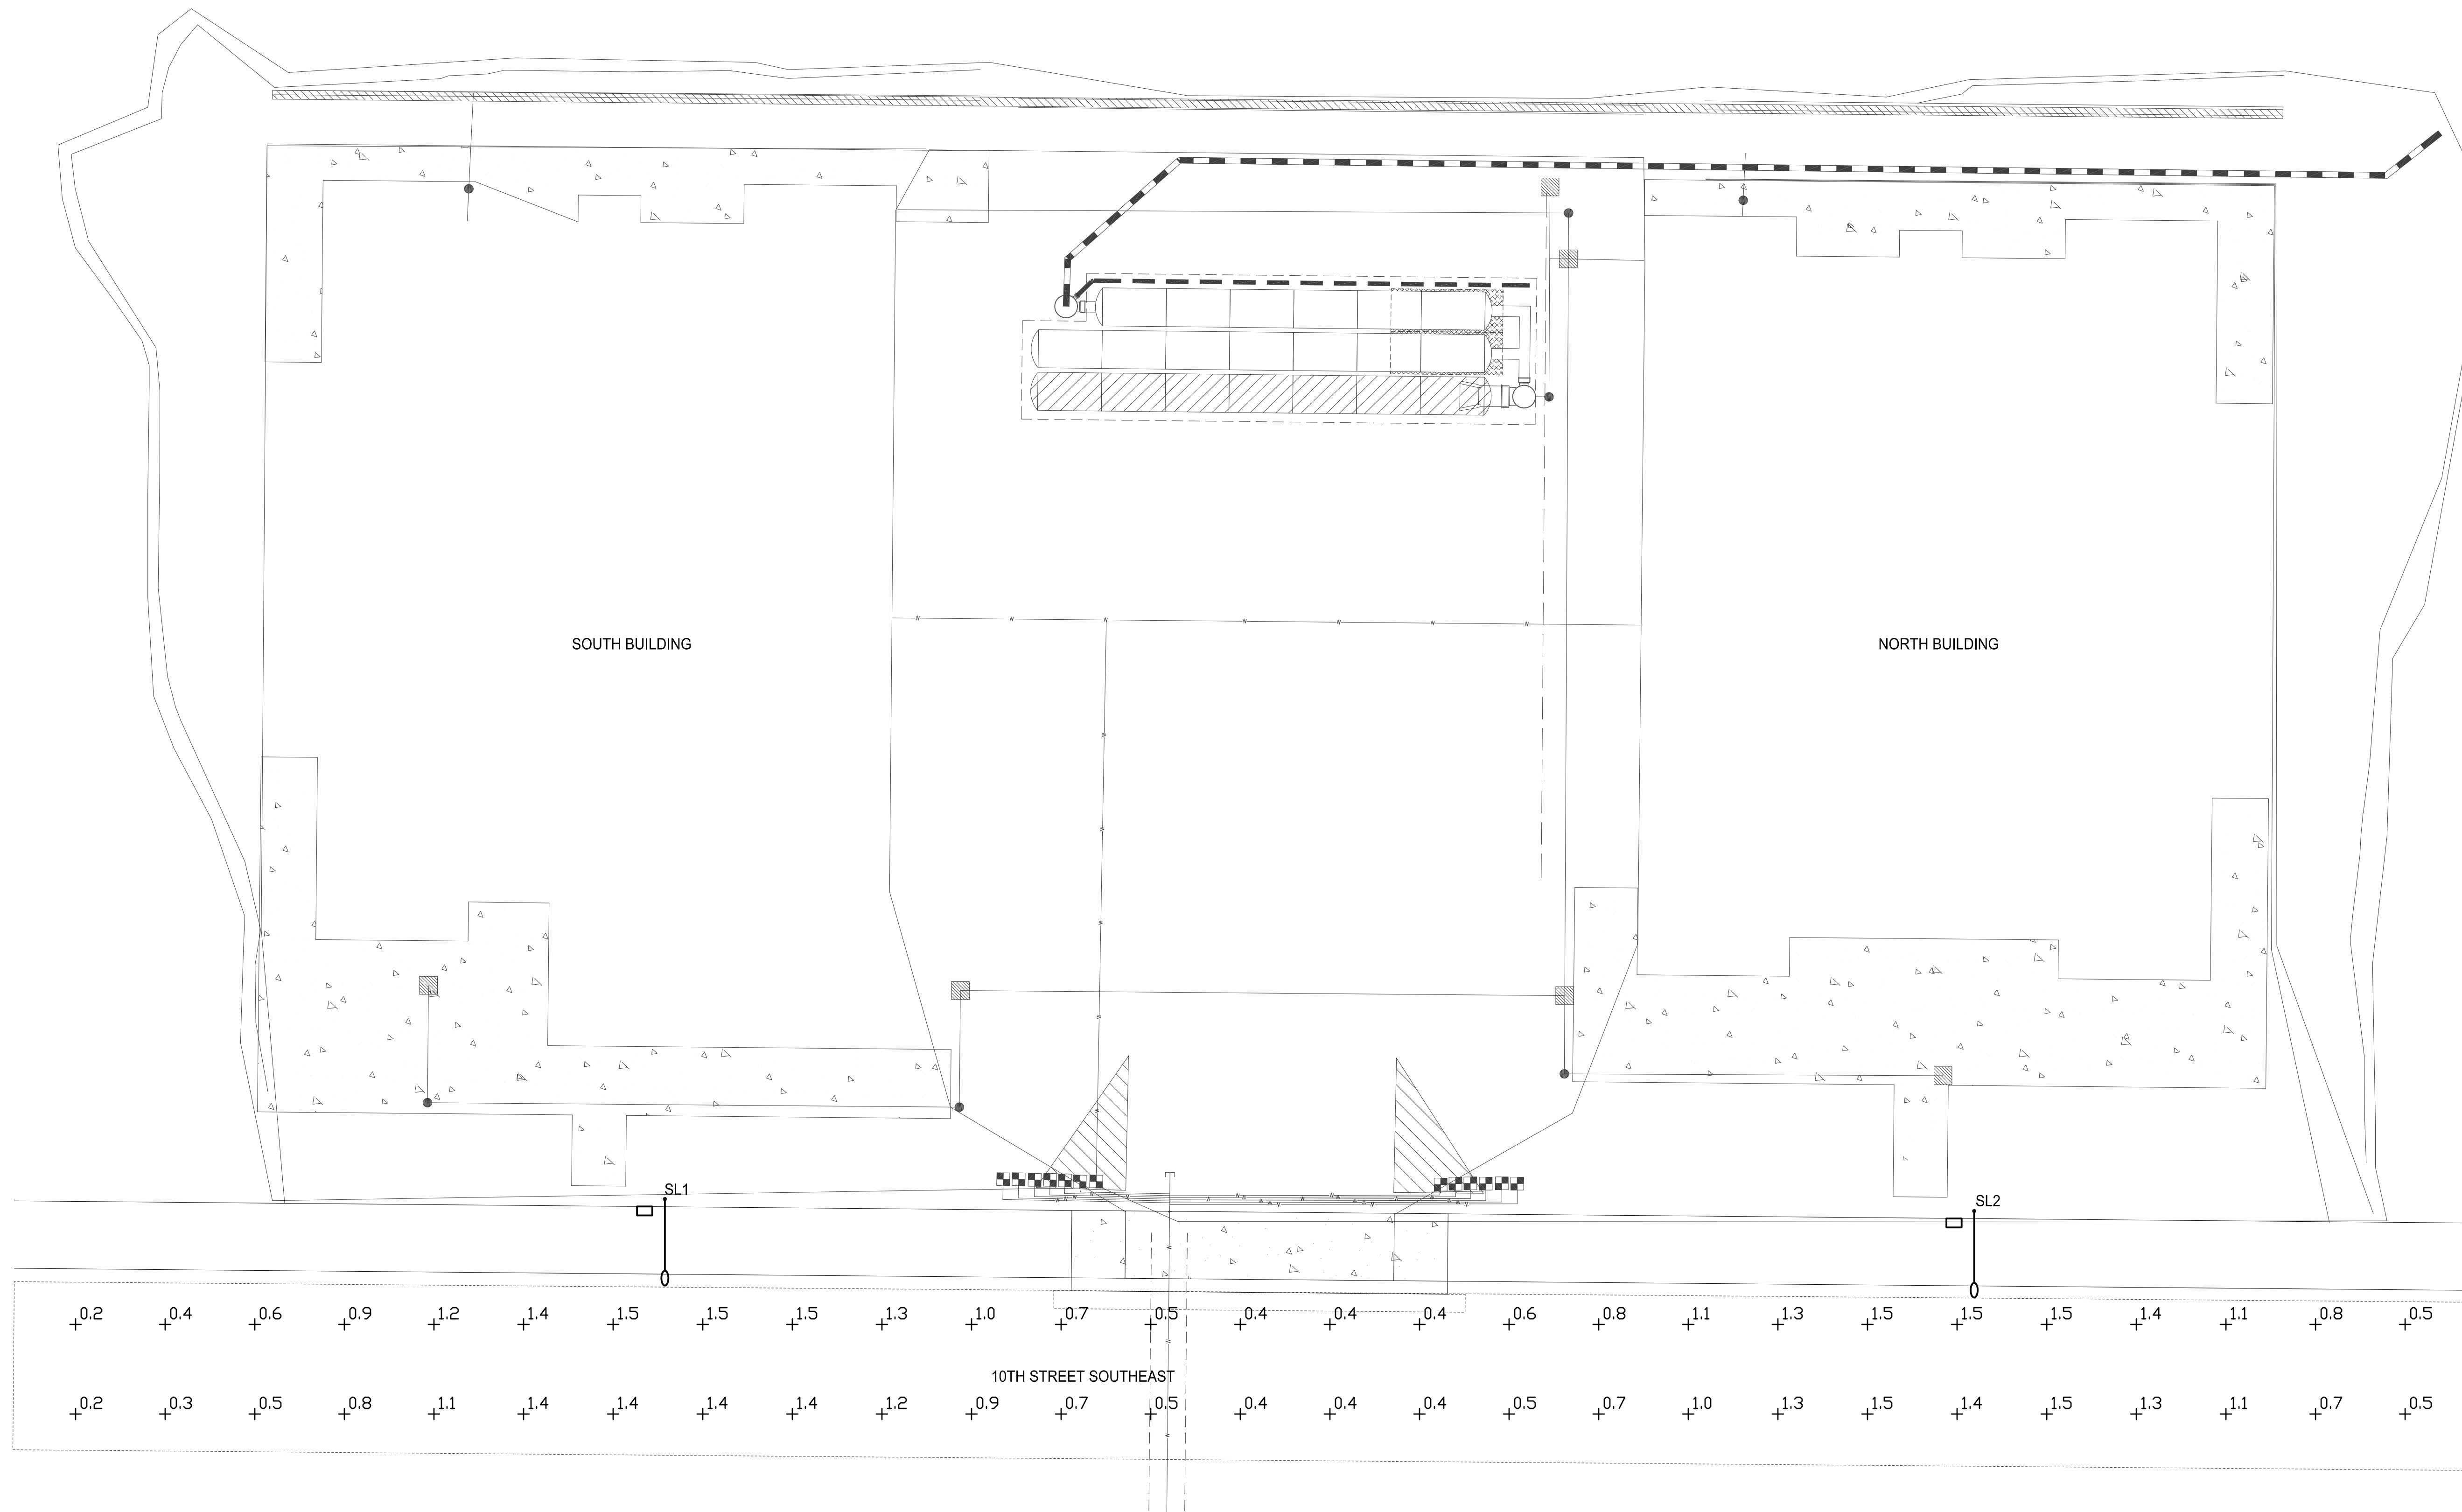Plotted: Jun 27, 2023 - 1:37pm File: C:\Users\scottk.CROSSENGINEERS\AppData\Local\Temp\AcPublish_11184\23-101-E2.dwg By: SCOTTK



PHOTOMETRIC LIGHTING SUMMARY:

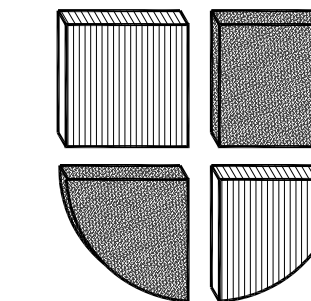10TH STREET SOUTHEAST
 AVERAGE FOOTCANDLES = 0.9 FC
 MAXIMUM FOOTCANDLES = 1.5 FC
 MINIMUM FOOTCANDLES = 0.2 FC
 MAX:MIN. = 7.5:1
 AVG.:MIN. = 4.5:1




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STREET LIGHTING ELECTRICAL SITE PLAN

REVISIONS:



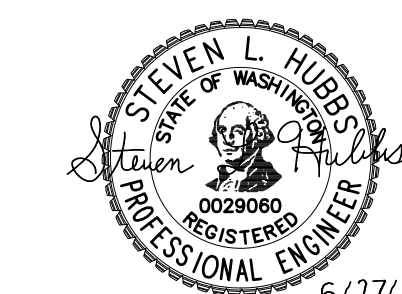6/27/23

SCALE: AS NOTED

DATE: 6-27-2023

DRAWN BY: SJK

CHECKED BY: SLH

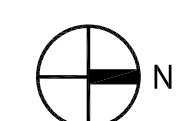
JOB NO.: 23-101

SHEET

E1

OF

STREET LIGHTING PHOTOMETRIC SITE PLAN
 SCALE: 1"=10'-0"



PERMIT SUBMITTAL

LUMINAIRE #	STATION	LUMINAIRE TYPE	MOUNTING HEIGHT	BASE	MAST ARM LENGTH	CITY LUMINAIRE #	COMMENTS
SL1	-	LEOTEK LED #GCJ3-30J-MV-40K-2R-GY-080 (58 WATT)	30'-0"	FIXED	8'-0"	-	
SL2	-	LEOTEK LED #GCJ3-30J-MV-40K-2R-GY-080 (58 WATT)	30'-0"	FIXED	8'-0"	-	


12' mast arm length
E3

GENERAL NOTES:


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- INSTALL PHOTOCCELL ON LUMINAIRE POLE PER CITY STANDARD DETAIL 01.05.10.

CONDUIT AND WIRE SCHEDULE:

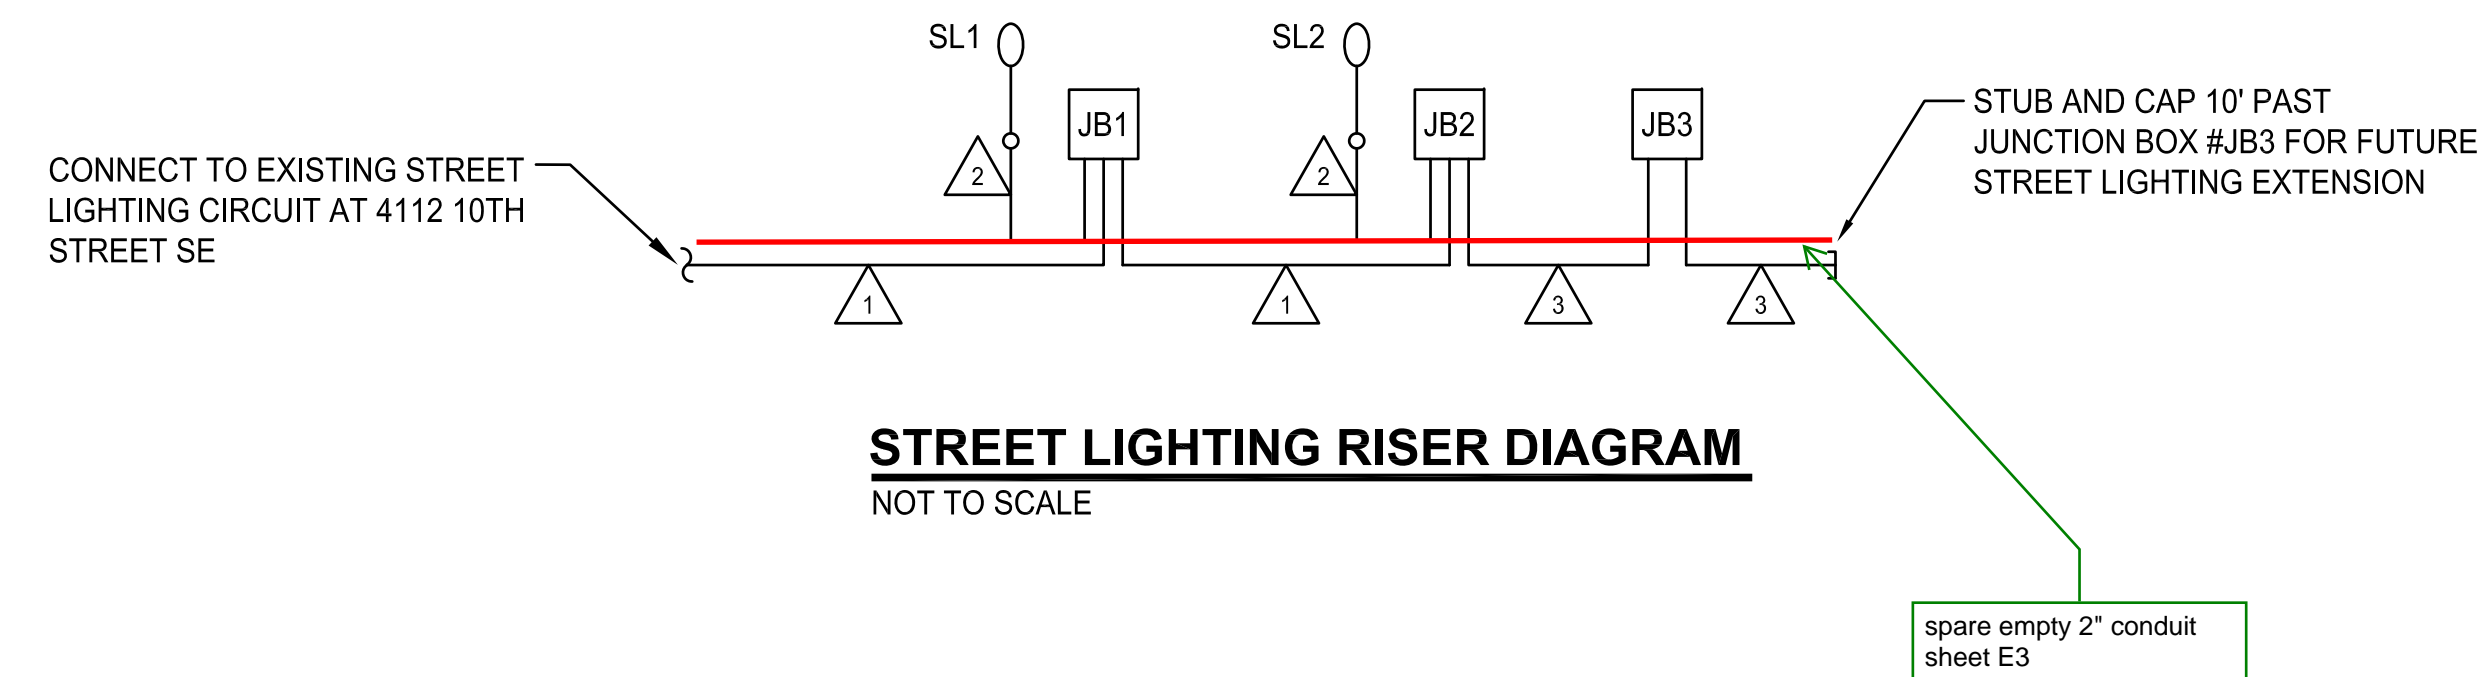- 1 2" PVC SCHEDULE 80 - (2)#8 CU & (1)#8 CU GRD (CONDUIT FILL = 4%)
- 2 1-1/2" PVC SCHEDULE 80 - (2)#8 CU & (1)#8 CU GRD (CONDUIT FILL = 4%)
- 3 2" PVC SCHEDULE 80 - EMPTY WITH PULLSTRING




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COOPERBERRY STREET LIGHTING
4018 10TH STREET EAST
PUYALLUP, WA 98374
 STREET LIGHTING RISER DIAGRAM/ SCHEDULES

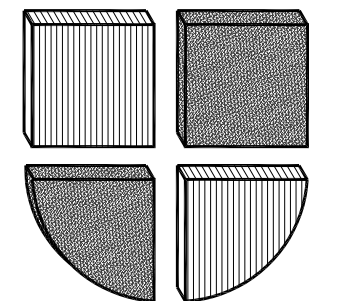REVISIONS:



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DATE:	6-27-2023	E3
DRAWN BY:	SJK	
CHECKED BY:	SLH	
JOB NO.:	23-101	
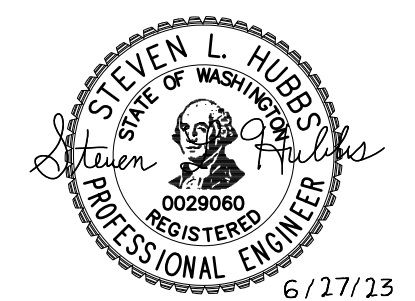
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STREET LIGHTING SPECIFICATIONS

1. 30-FOOT STEEL STREETLIGHT STANDARD

a. DIMENSIONS

STREETLIGHT STANDARDS SHALL PROVIDE A FIXTURE MOUNTING HEIGHT OF 30'0" PLUS OR MINUS 6" WITH A TYPICAL 12 FOOT MAST ARM WITH A THREE FOOT OVERHANG.

BASE PLATE SHALL HAVE SLOTTED HOLES TO ACCOMMODATE 1-INCH ANCHOR BOLTS, AND 1 1/2" BOLT CIRCLE WITH MINIMUM CLEARANCE OF 1" BETWEEN BOLT AND POLE.

HANDHOLE CENTER SHALL BE LOCATED APPROXIMATELY 12 INCHES FROM THE BASE PLATE, ROTATED 270 DEGREES FROM MAST ARM SO AS THE HANDHOLE IS LOCATED ON THE SIDE OPPOSING ONCOMING TRAFFIC.

b. STRENGTH

POLES SHALL MEET ALL STRENGTH REQUIREMENTS OF AASHTO FOR 90 MPH ISOTACH WHEN USED WITH A LUMINAIRE WEIGHING 48 POUNDS WITH A E.P.A. OF 1.1 SQUARE FEET. ALL ATTACHING BOLTS AND SCREWS THAT ARE NOT GALVANIZED SHALL BE STAINLESS STEEL.

c. FINISH

THE POLES AND ALL HARDWARE SHALL BE HOT DIPPED GALVANIZED, MINIMUM 3 MIL THICKNESS.

d. MAST ARM ATTACHMENT SHALL BE SECURED BY 3 BOLTS.

e. EACH POLE SHALL HAVE HANDHOLE (WITH COVER), GROUND LUG AND REMOVABLE POLE CAP.

f. EACH CITY POLE SHALL HAVE A BLACK 4" TO 6" LETTER C STENCILED ON ROADWAY SIDE OF POLE 16" ABOVE GRADE.

2. ANCHORAGE

a. POLES SHALL BE ANCHORED WITH 4 BOLTS, 1"x3/8"x4" #8UNC WITH HOT DIPPED GALVANIZING AFTER THREADS ARE CUT. GALVANIZED AREA SHALL EXTEND FROM THREADED END FOR A MINIMUM OF 12 INCHES. BOLTS SHALL BE PROVIDED WITH 2 GALVANIZED NUTS AND FLAT WASHERS FOR LEVELING. SHIMS WILL NOT BE USED.

b. A NON-SHRINKING GROUT SHALL BE INSTALLED WITH ONE 1/2" DRAIN HOLE UNDER THE BASE PLATE AFTER THE ENGINEER HAS APPROVED THE POLE INSTALLATION.

3. CONDUIT

ALL CONDUIT SHALL BE BURIED A MINIMUM OF 24 INCHES DEEP. ALL ROADWAY CROSSINGS SHALL BE RIGID METALLIC OR SCHEDULE 80 PVC. CONDUIT SHALL CONFORM TO SECTION 9-29 OF WSDOT STANDARD SPECIFICATIONS. SCHEDULE 80 PVC MAY BE USED IN LOCATIONS OTHER THAN ROADWAY CROSSINGS.

 CITY OF PUYALLUP DEVELOPMENT ENGINEERING and PUBLIC WORKS DEPARTMENTS	STREET LIGHT SPECIFICATIONS				CITY STANDARD SCALE: 1" = 10'-0" DATE: 01.05.01
	DRAWN BY: JIM BRYAN/SYBODA CHECKED BY: LINDA LIAN APPROVED BY: COLLEEN HARRIS REVISION BY: LINDA LIAN	FILE NAME: P:\DWG\CORPORATE\STREETLIGHT\STREETLIGHT.DWG DATE APPROVED: 01/05/01 SCALE: 1" = 10'-0"	DATE: 01.05.01	SCALE: 1" = 10'-0"	

(STR LIGHT SPECS CONTINUED)

4. JUNCTION BOXES (WHEN REQUIRED)

JUNCTION BOXES SHALL BE INSTALLED AT LOCATIONS AS SHOWN ON THE PLANS. THEY WILL CONFORM TO WSDOT STANDARD PLAN J-40.10-02, TYPE 1. THEY SHALL BE LEVEL WITH THE SIDEWALK GRADE AND FIRMLY BEDDED TO PREVENT FUTURE SETTLING. JUNCTION BOXES ARE PREFERRED NOT TO BE INSTALLED IN THE SIDEWALK. THE COVER SHALL BE GALVANIZED AND GROUNDED. THE LETTERS "JT" SHALL BE ETCHED ON THE COVER. (SEE CITY STANDARD DETAIL NO. 01.06.01). IF THE JUNCTION BOX IS NOT IN THE SIDEWALK THEN IT SHALL HAVE A CONCRETE COLLAR. IF THE JUNCTION BOX IS IN THE SIDEWALK THEN IT SHALL HAVE A NON-SLIP SURFACE TREATMENT. SEE CITY STANDARD DETAIL NO. 01.06.01.

5. CONDUCTORS, WIRES, ETC.

WIRE CONDUCTORS FOR UNDERGROUND FEEDER RUNS AND FOR CIRCUITRY FROM THE IN-LINE FUSE IN THE POLES TO THE JUNCTION BOX SHALL BE 600 VOLT, SINGLE CONDUCTOR STRANDED COPPER AND INSULATED WITH USE GRADE POLYVINYLS CHLORIDE COMPOUND (XLP) OR APPROVED EQUAL IN ACCORDANCE WITH THE INSULATED POWER CABLE ENGINEER'S ASSOCIATION SPECIFICATIONS. AN AWG NO. 8 GREEN INSULATED STRANDED COPPER WIRE WILL BE RUN TO THE SERVICE GROUND LUG ON EACH POLE. FEEDERS SHALL BE SIZED IN ACCORDANCE WITH THE NATIONAL ELECTRICAL CODE. WIRES INSIDE THE POLE BETWEEN BALLAST AND IN-LINE FUSES SHALL BE ROME 2C AWG 10 STRANDED POLE AND BRACKET WIRE OR APPROVED EQUAL. SPLICES WILL BE ALLOWED IN JUNCTION BOXES AND POLE BASES ONLY. NO MORE THAN 2 CONDUITS WILL BE ALLOWED INSIDE THE STREET POLE.

6. FUSES

LUMINAIRE FUSING AND ELECTRICAL CONNECTIONS AT LIGHT STANDARD BASES SHALL CONFORM TO SECTION 9-28.7 OF THE STATE OF WASHINGTON STANDARD SPECIFICATIONS AND AS SHOWN ON THE UNIFORM LUMINAIRE WIRING DETAIL IN THE APPENDIX. IN-LINE FUSE HOLDERS SHALL BE SEC MODEL 1791-SF WITH FM-5 FUSES OR APPROVED EQUAL. (REFER TO CITY STANDARD DETAIL NO. 01.06.01)

7. LUMINAIRES AND LAMPS

RESIDENTIAL STREETS AND NEIGHBORHOOD COLLECTORS:
 LEOTEK LED GC1-40E-MV-NW-2-530 (67 WATT LED)

ARTERIALS AND COMMERCIAL COLLECTORS:
 GE EVOLVE LED ER52-E-0-HX-EX-5-40 (130 WATT LED)

THE CITY WILL ENERGIZE THE STREET LIGHTS WHEN A HOME IS OCCUPIED ADJACENT TO A STREET LIGHT OR IMMEDIATELY ACROSS THE STREET. AT THE DEVELOPER'S REQUEST, STREET LIGHTS MAY BE ENERGIZED PRIOR TO OCCUPANCY OF HOMES. HOWEVER, THE DEVELOPER OR BUILDER SHALL ASSUME FULL RESPONSIBILITY FOR ELECTRICAL POWER COSTS AND REPAIR COSTS DUE TO VANDALISM, THEFT, OR CONSTRUCTION.

8. SAFE WIRING LABELS

THE CONTRACTOR IS ADVISED THAT SAFE WIRING LABELS REQUIRED BY LABOR AND INDUSTRIES SHALL APPLY ON THIS PROJECT. (ELECTRICAL INSPECTION STICKER)

9. GUARANTEE

THE CONTRACTOR SHALL SURRENDER TO THE CITY OF PUYALLUP ANY GUARANTEE OR WARRANTY ACQUIRED BY HIM AS A NORMAL TRADE PRACTICE IN CONNECTION WITH THE PURCHASE OF ANY MATERIALS OR ITEMS USED IN THE CONSTRUCTION OF THE ILLUMINATION.


10. LOCATION

SEE CITY STANDARD SECTION 01.01 ROADWAY DESIGN.

 CITY OF PUYALLUP DEVELOPMENT ENGINEERING and PUBLIC WORKS DEPARTMENTS	STREET LIGHT SPECIFICATIONS (CONT.)				CITY STANDARD SCALE: 1" = 10'-0" DATE: 01.05.02
	DRAWN BY: JIM BRYAN/SYBODA CHECKED BY: LINDA LIAN APPROVED BY: COLLEEN HARRIS REVISION BY: LINDA LIAN	FILE NAME: P:\DWG\CORPORATE\STREETLIGHT\STREETLIGHT.DWG DATE APPROVED: 01/05/02 SCALE: 1" = 10'-0"	DATE: 01.05.02	SCALE: 1" = 10'-0"	

GENERAL NOTES:


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- INSTALL PHOTOCCELL ON LUMINAIRE POLE PER CITY STANDARD DETAIL 01.05.10.

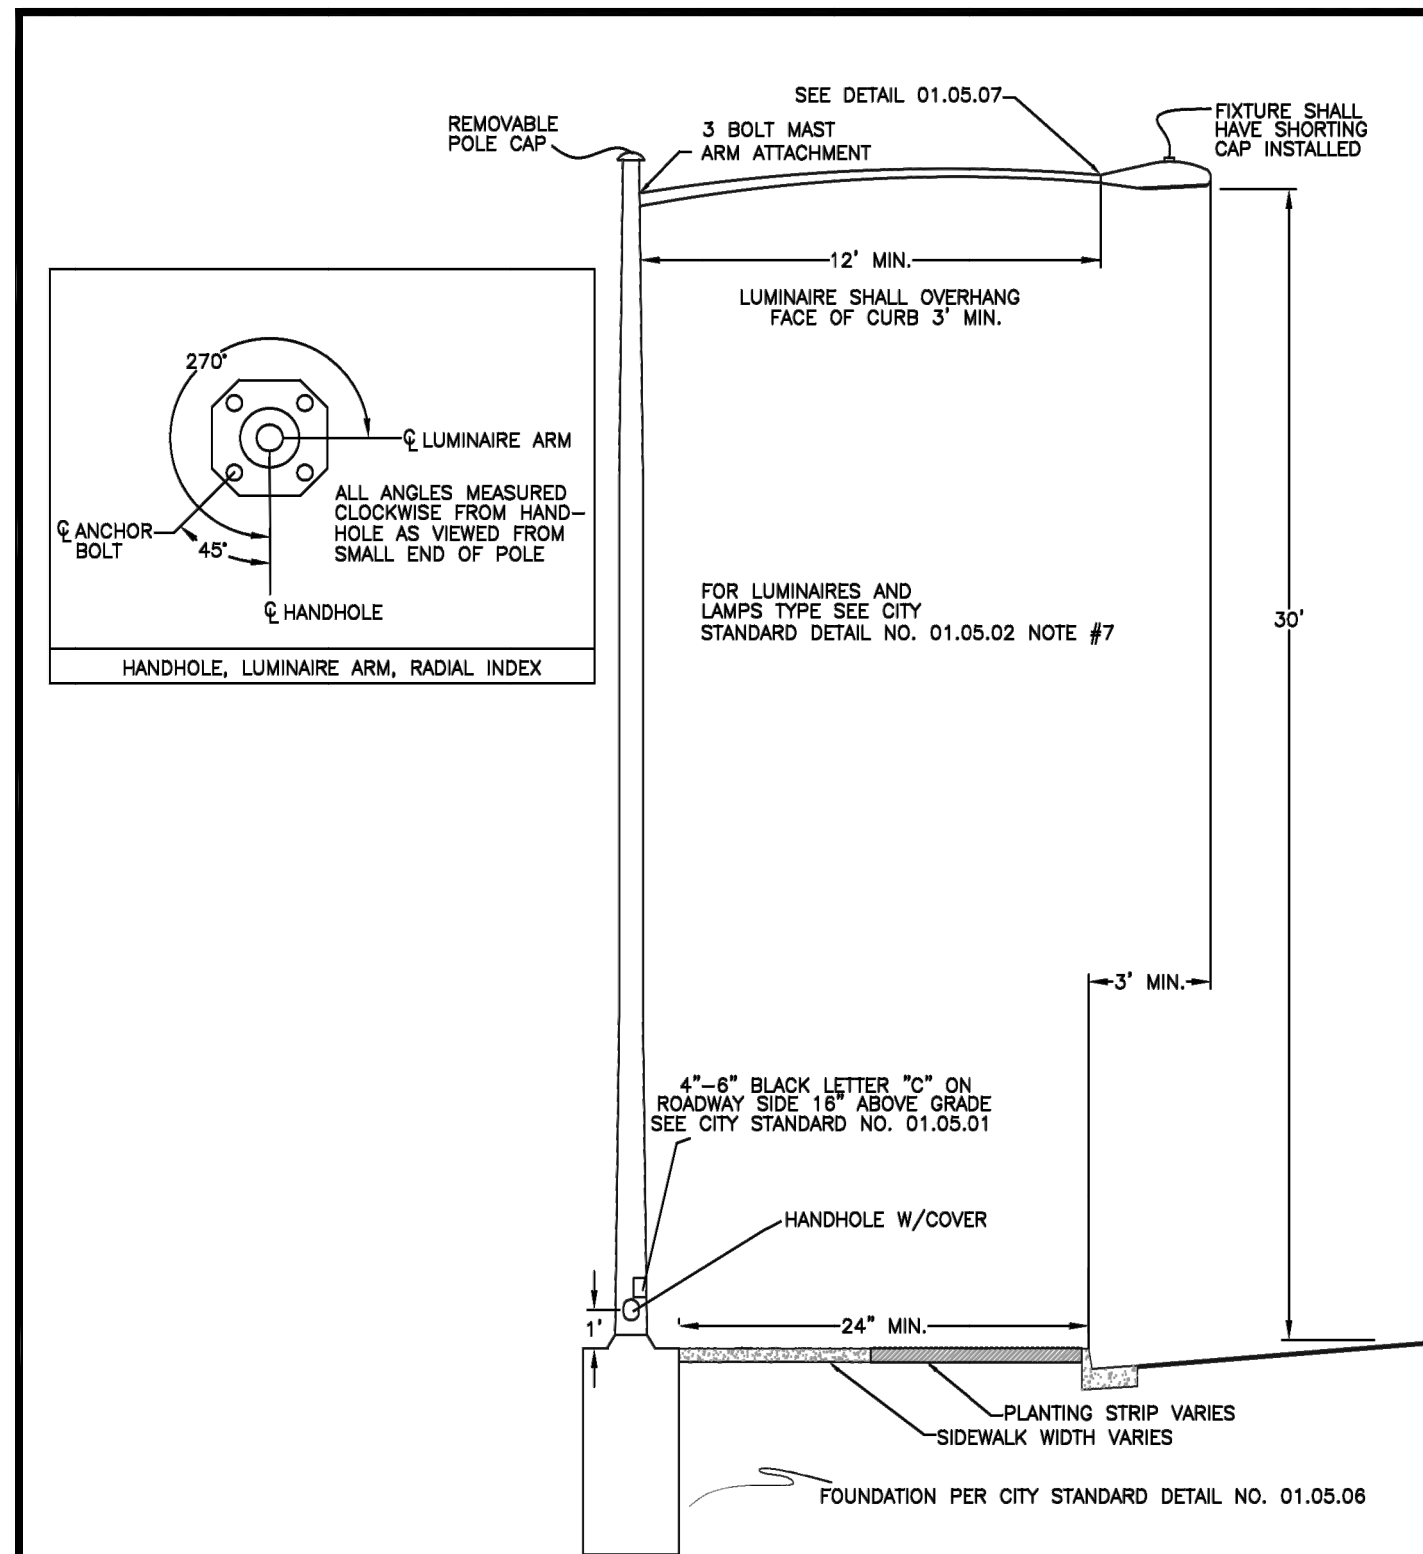

NOTE:

- IT SHALL BE THE CONTRACTOR'S RESPONSIBILITY TO COORDINATE THE INSTALLATION OF THE STREET LIGHT SYSTEM WITH ALL UTILITIES, PRIVATE AND PUBLIC, TO AVOID SCHEDULE AND LOCATION CONFLICTS.
- FOR RESIDENTIAL STREET LIGHTING THE CONTRACTOR SHALL BE RESPONSIBLE TO INSTALL ONE METER FOR THE PLANT'S LIGHTING SYSTEM PER PUGET SOUND ENERGY REQUIREMENTS. ON VERY LARGE PLANTS PUGET SOUND ENERGY MAY REQUIRE MORE THAN ONE METER.
- LUMINAIRE TO BE FLAT LENS GLASS WITH CUT OFF, 150W FOR SIGNALIZED INTERSECTIONS, 150W OR 200W FOR COMMERCIAL AREA AND 100W FOR RESIDENTIAL.


 CITY OF PUYALLUP DEVELOPMENT ENGINEERING and PUBLIC WORKS DEPARTMENTS	STREET LIGHT				CITY STANDARD SCALE: 1" = 10'-0" DATE: 01.05.04
	DRAWN BY: JIM BRYAN/SYBODA CHECKED BY: LINDA LIAN APPROVED BY: COLLEEN HARRIS REVISION BY: LINDA LIAN	FILE NAME: P:\DWG\CORPORATE\STREETLIGHT\STREETLIGHT.DWG DATE APPROVED: 01/05/04 SCALE: 1" = 10'-0"	DATE: 01.05.04	SCALE: 1" = 10'-0"	

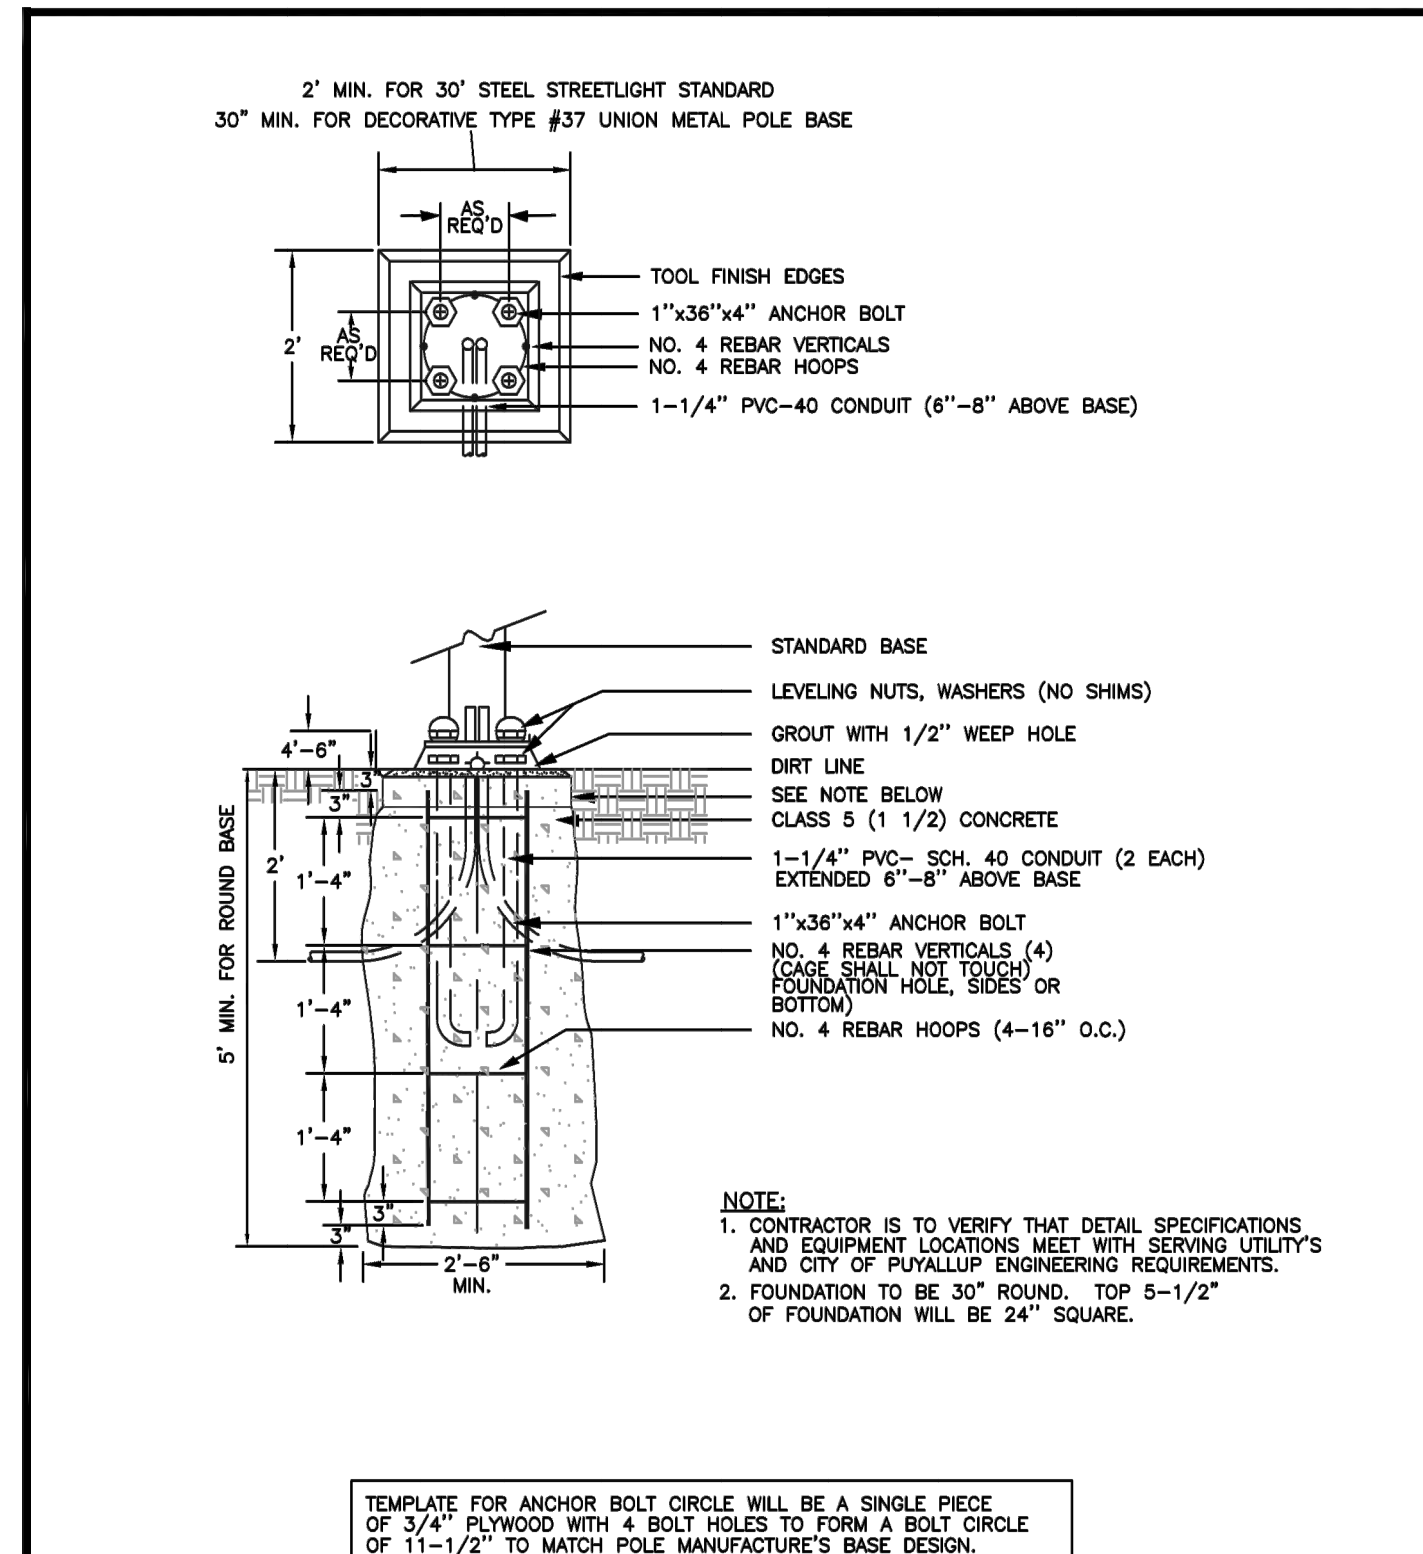

NOTE:

- CONTRACTOR IS TO VERIFY THAT DETAIL SPECIFICATIONS AND EQUIPMENT LOCATIONS MEET WITH SERVING UTILITY'S AND CITY OF PUYALLUP ENGINEERING REQUIREMENTS.
- FOUNDATION TO BE 30" ROUND, TOP 5-1/2" OF FOUNDATION WILL BE 24" SQUARE.

 CITY OF PUYALLUP DEVELOPMENT ENGINEERING and PUBLIC WORKS DEPARTMENTS	CONCRETE STREETLIGHT FOUNDATION TYPICAL				CITY STANDARD SCALE: 1" = 10'-0" DATE: 01.05.06
	DRAWN BY: JIM BRYAN/SYBODA CHECKED BY: LINDA LIAN APPROVED BY: COLLEEN HARRIS REVISION BY: LINDA LIAN	FILE NAME: P:\DWG\CORPORATE\STREETLIGHT\STREETLIGHT.DWG DATE APPROVED: 01/05/06 SCALE: 1" = 10'-0"	DATE: 01.05.06	SCALE: 1" = 10'-0"	

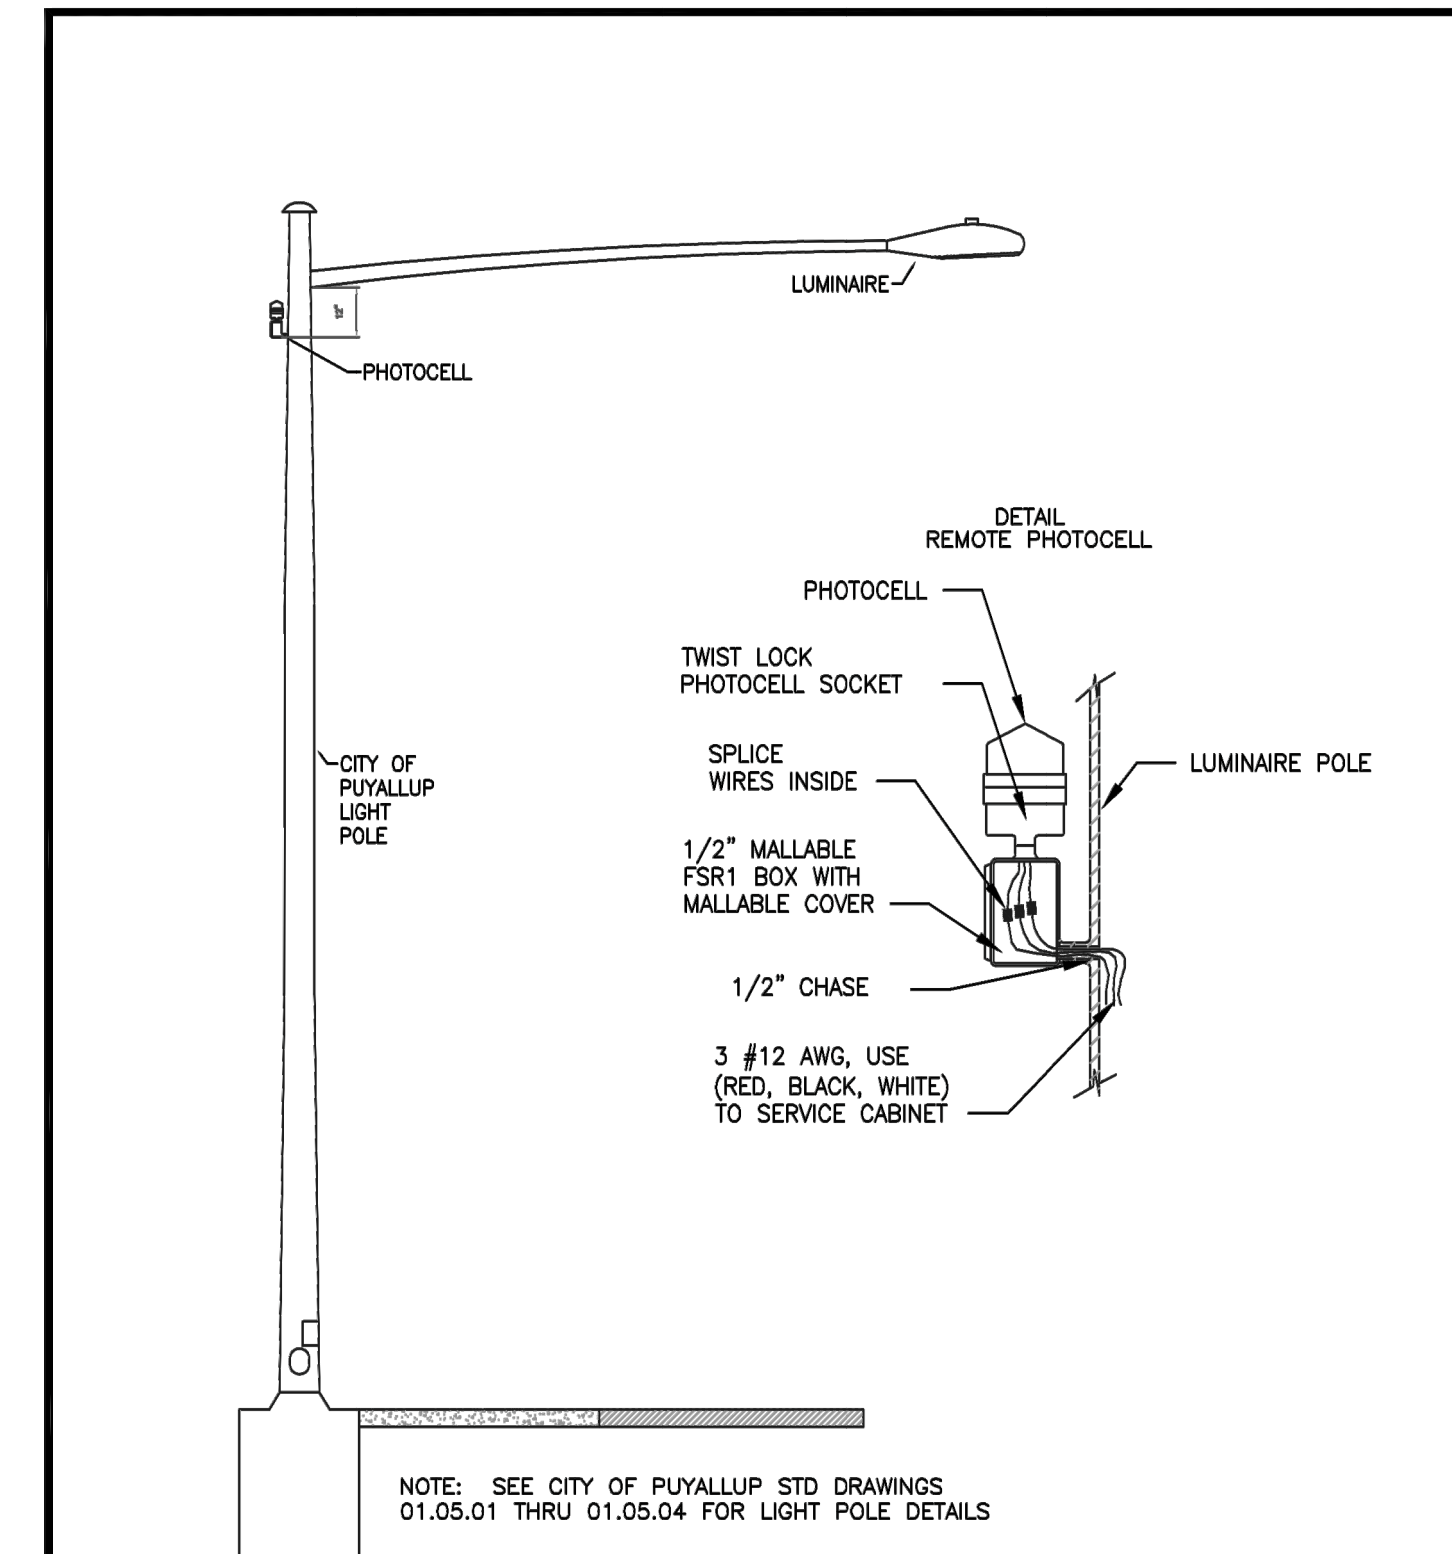


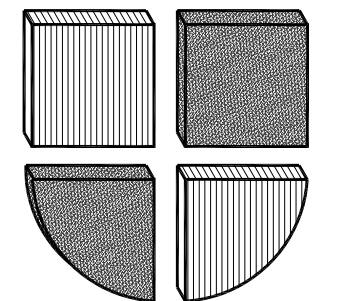NOTE: SEE CITY OF PUYALLUP STD DRAWINGS 01.05.01 THRU 01.05.04 FOR LIGHT POLE DETAILS

 CITY OF PUYALLUP DEVELOPMENT ENGINEERING and PUBLIC WORKS DEPARTMENTS	REMOTE PHOTOCCELL				CITY STANDARD SCALE: 1" = 10'-0" DATE: 01.05.10
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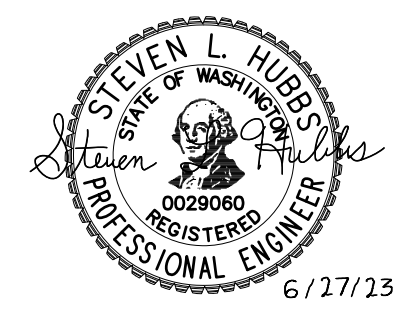
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STREET LIGHTING DETAILS

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