

NIGHT WORK REQUIRED.

CLOSURE ALLOWED: Sunday - Thursday 9PM - 5AM Call communications center at 253-287-4456 on night of closure. Request a job start inspection through the CityView portal and leave a message for the inspectors by calling 253-435-3650 at least 48 hours in advance of job start.

The applicant shall notify all residents and businesses within 300 feet of the work area 48 hours in advance of start date by distributing informational door hangers, displaying work on message boards, or on signs posted visibly along the right-of-way. The City-issued permit packet shall be posted at the job site and available to inspectors at all times.


Splice location 3 on the site plan.

TABLE A									
APPROACH SPEED	TAPER LENGTH (L)*	NO. OF CONES PER TAPER	SPACING OF CONES ALONG TAPER TAPER (FEET)	SIGN SPACING (S) ADVANCE OF TAPER & BETWEEN SIGNS					
25 MPH	125 FT.	6	25 FT.	150 FT.					
30 MPH	180 FT.	7	30 FT.	200 FT.					
35 MPH	245 FT.	8	35 FT.	250 FT.					
40 MPH	320 FT.	9	40 FT.	350 FT.					
45 MPH	540 FT.	13	45 FT.	550 FT.					
50 MPH	600 FT.	13	50 FT.	600 FT.					
55+ MPH	1000 FT.	21	55 FT.	1000 FT.					

(*) NOTE - BASED ON 12-FOOT WIDE LANES COLUMN IS ALSO APPROPRIATE FOR LANE WIDTHS LESS THAN 12 FEET.

GENERAL NOTES:

- ALL "W" SERIES SIGNS SHALL BE 48" FLUORESCENT ORANGE, UNLESS OTHERWISE NOTED.
- NIGHT WORK REQUIRES ADDITIONAL ROADWAY LIGHTING AT FLAGGING STATIONS. 2
- PEDESTRIAN SPOTTERS SHALL CONDUCT PEDESTRIAN TRAFFIC CONTROL AND ARE TO MAINTAIN OPEN SIDEWALKS AND ADA RAMPS.
- NOTIFY TRANSIT AUTHORITY FIVE DAYS PRIOR TO STARTING WORK.
- ALL LANES SHOULD BE A MINIMUM OF 10' IN WIDTH AS MEASURED TO THE NEAR FACE OF THE CHANNELIZING DEVICES.

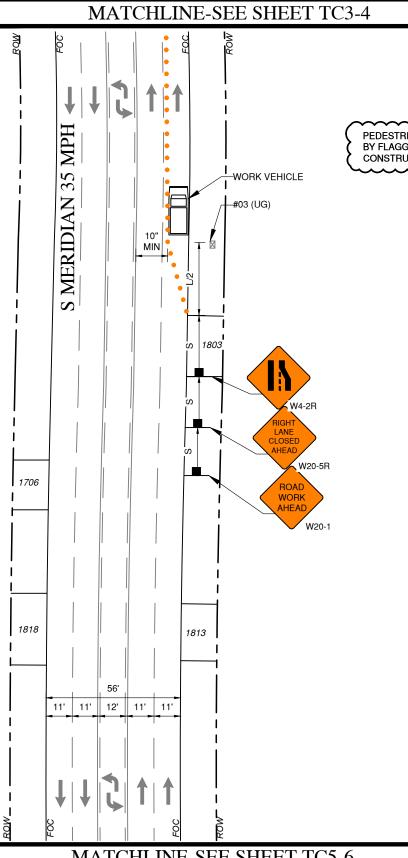

PEDESTRIANS WILL BE ESCORTED BY FLAGGERS THRU THE CONSTRUCTION ZONE

MATCHLINE-SEE SHEET TC5-6

IMPORTANT NOTICE

Section # 4216/4217 of the Government Code requires a Dig Alert Identification Number to be issued before a "Permit to Excavate" will be valid For your Dig Alert I.D.


CALL TOLL FREE **48 HOURS BEFORE YOU DIG** UNDERGROUND SERVICE ALERT 1-800-227-2600

PROJ#: JB0001439980 CONSTRUCTION TYPE: NODE SYSTEM: PIERCE COUNTY NODE:


THIS IS A COMCAST DOCUMENT, PROPRIETARY & CONFIDENTIAL						
DESIGN:	REV	DESCRIPTION	DATE			
DRAWN BY: JEFF	2	ISSUE FOR PERMIT	12/05/2023			
APPROVED:						
APPROVED:						
APPROVED:						

PRFUP20231453 City of Work shall immediately cease in the work zone for a pedestrian spotter, available at all times, to escort pedestrians around the work area. The applicant shall coordinate redundant traffic control devices with other traffic control plans authorized near this site. Lane Taper Length = (width of taper offset) x (speed limit)² (width of taper typically measured as width of lane) -Traffic control devices shall be 28 inch retro-reflective cones. -Taper length equals width of offset times speed limit squared divided by 60. -Sign spacing shall be 100 feet when speed limit is 30 mph or less. -Sign spacing shall be 350 feet when speed limit is greater than 30 mph. -Distance between cones equals speed limit in unit-feet. -Travel lane width must be a minimum of 11 feet at all times. -All flaggers and spotters shall remain in radio contact at all times. A Portable Changeable Message Sign shall be placed on S MERIDIAN 72 hours in advance of construction. SCALE: 1:40 1515 S MERIDIAN, PUYALLUP, WA 98371 TRAFFIC CONTROL TC4-5


SHEET: 5 OF

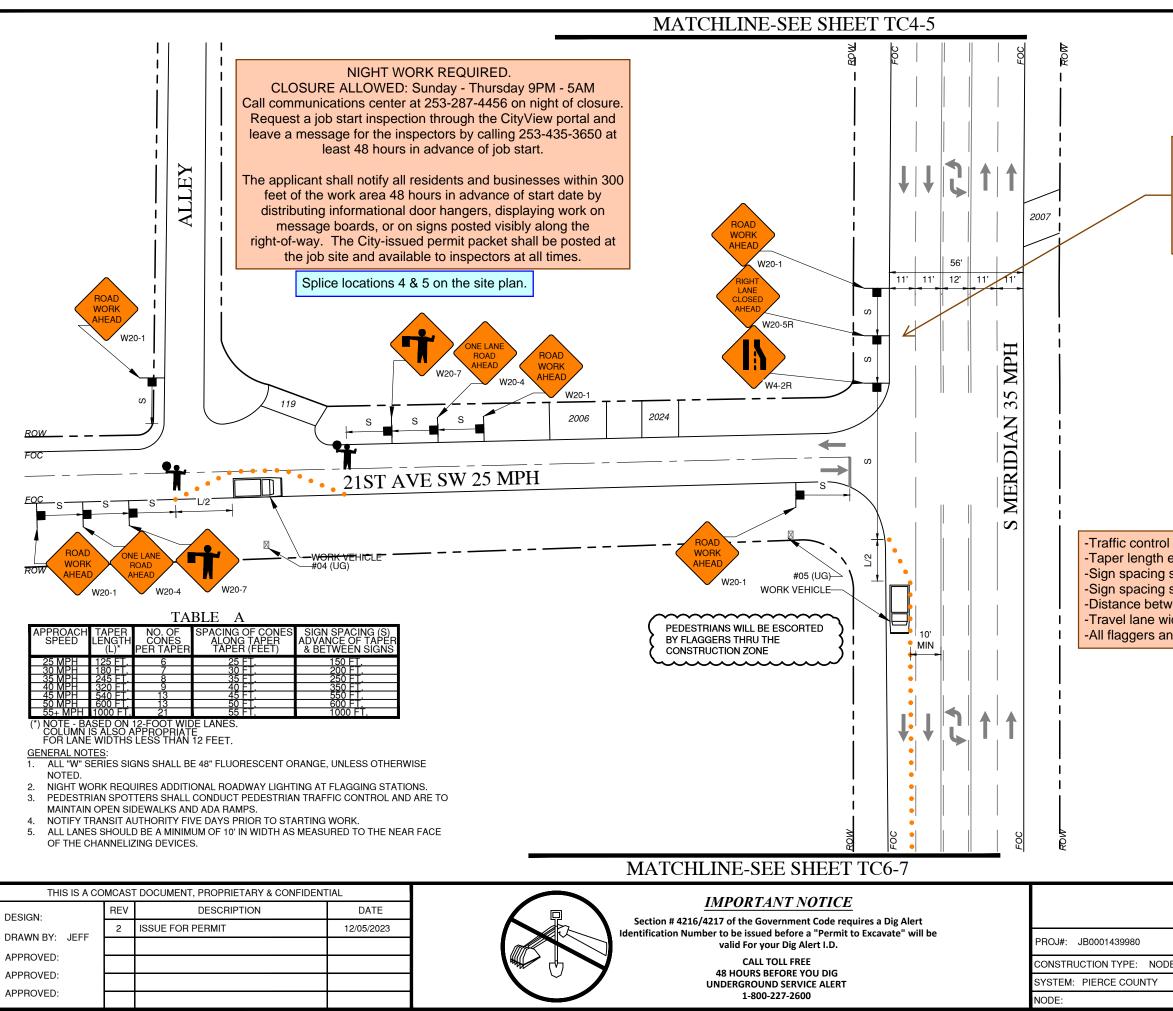

			[PRFUP20231453	
	T	°C		City of Publicup Development & Pomitting Services ISSUED Perkin Building Planning Engineering Public Works Fire Traffic	
Consolidate south lanes on S MERID into a single lane n the 21ST AVE SW intersection. Adjust advanced warning accordingly.	IAN orth of				
			cease for a p spotte times	shall immediately in the work zone bedestrian er, available at all to escort strians around the area.	
	traffic o	control dev	vices w	rdinate redundant vith other traffic d near this site.	
	vidth of t		et) x (sp	n = <u>beed limit)²</u> d as width of lane)	
ol devices shall be 28 inch retro-reflective cones. equals width of offset times speed limit squared divided by 60. shall be 100 feet when speed limit is 30 mph or less. shall be 350 feet when speed limit is greater than 30 mph. ween cones equals speed limit in unit-feet. vidth must be a minimum of 11 feet at all times. and spotters shall remain in radio contact at all times.					
	Sig	in shall be	placed	able Message d on S MERIDIAN e of construction.	
			S	v CALE: 1:40	
1515 S MERIDIAN, F TRAFFIC	PUYALLUP, CONTROL				
DE					
				TC5-6	
				SHEET: 6 OF 9	

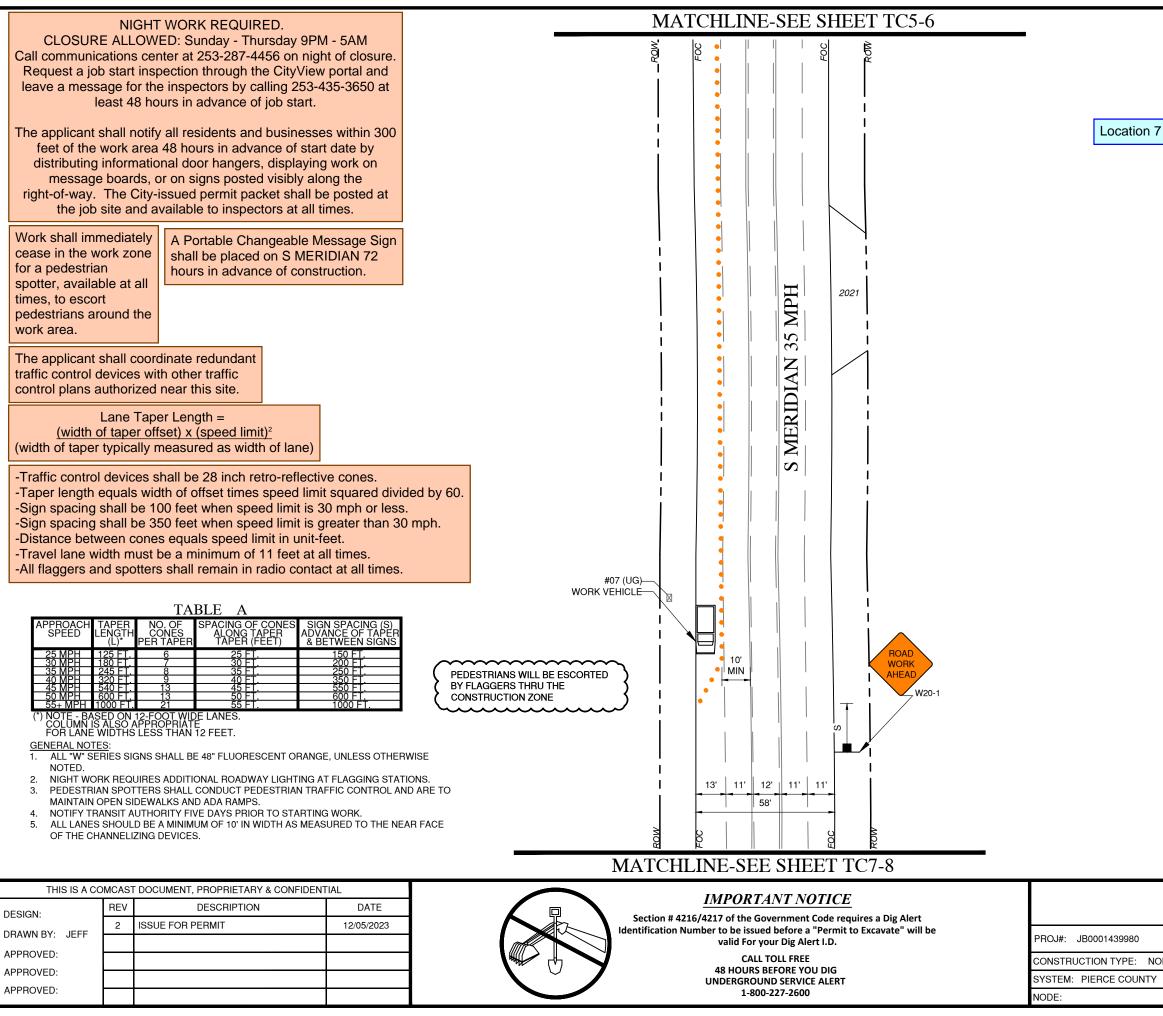

	PRFUP20231453
	City of Puyallur Development & Permitting Services / ISSUED PERMIT Building
	Engineering Public Works
on the site plan. Upgraded ped at 2106 T	O 2216 S MERIDIAN.
	$\langle \rangle$
	SCALE: 1:40
1515 S MERIDIAN, PUYALLUP, WA 98371 TRAFFIC CONTROL	
DE	TC6-7
	SHEET: 7 OF 9

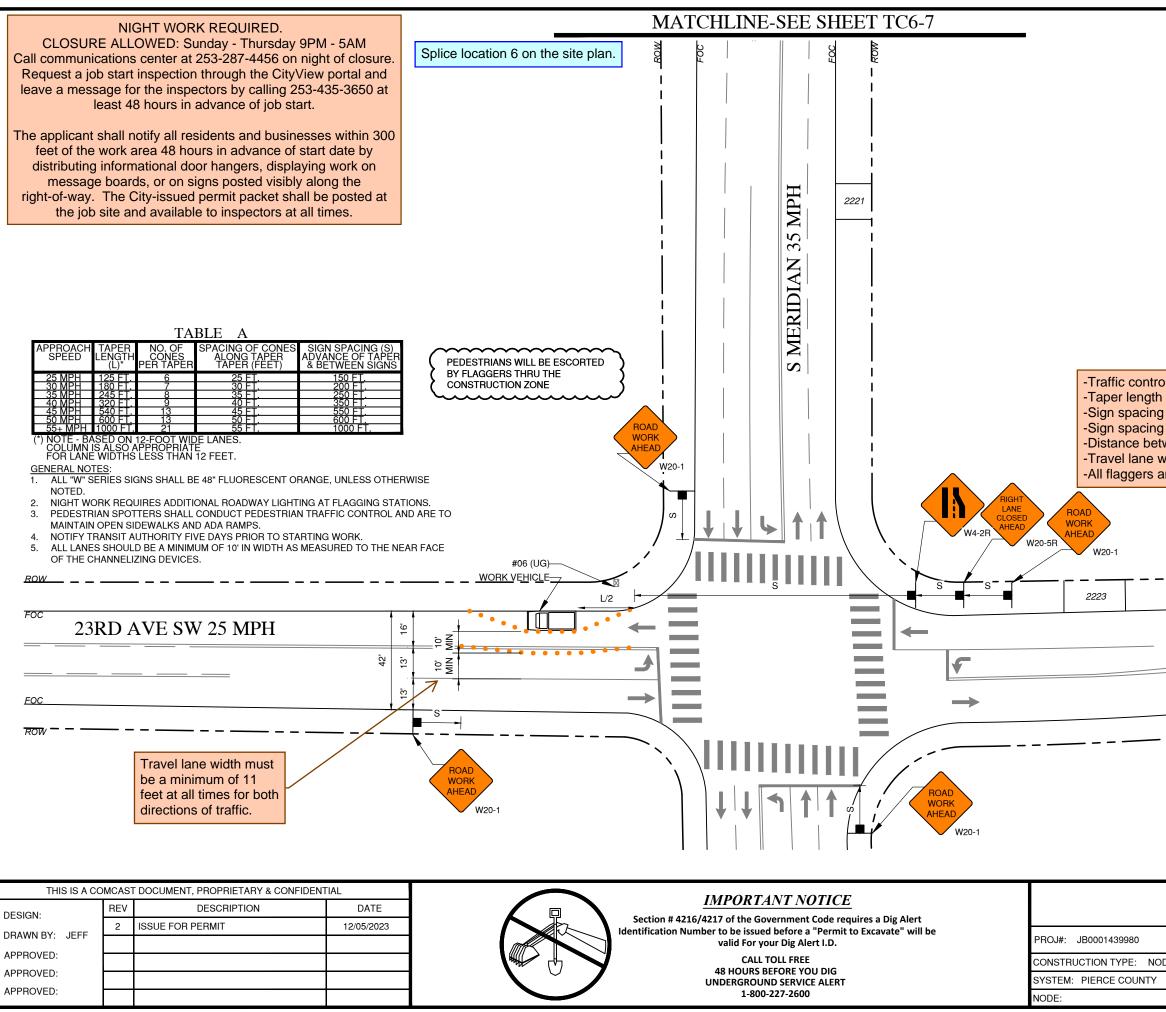

PRFUP20231453

When shifting traffic into a turn lane, use of double cones is required. Traffic device spacing shall be half distance for opposing traffic devices.

Work shall immediately cease in the work zone for a pedestrian spotter, available at all times, to escort pedestrians around the work area.

ROW

The applicant shall coordinate redundant traffic control devices with other traffic control plans authorized near this site.


Lane Taper Length = (width of taper offset) x (speed limit)² (width of taper typically measured as width of lane)

-Traffic control devices shall be 28 inch retro-reflective cones. -Taper length equals width of offset times speed limit squared divided by 60. -Sign spacing shall be 100 feet when speed limit is 30 mph or less. -Sign spacing shall be 350 feet when speed limit is greater than 30 mph. -Distance between cones equals speed limit in unit-feet. -Travel lane width must be a minimum of 11 feet at all times. -All flaggers and spotters shall remain in radio contact at all times.

City of Puyallup Development & Permitting Services ISSUED PERMIT Building Planning Engineering Public Works	A Portable Changeable Message Sign shall be placed on S MERIDIAN 72 hours in advance of construction.
Fire	BOW

	FUC
	FOC ROW SCALE: 1:40
1515 S MERIDIAN, PUYALLUP, WA 98371 TRAFFIC CONTROL	
DE	TC7-8
	SHEEL: & OF 9


<u>LEGEND</u>

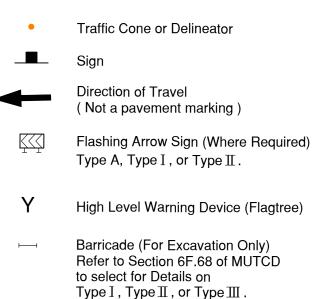

Flagger

NOTES:

- 1. Flaggers will be used to control traffic at non-signalized intersections. Flaggers Will use 2 way radios when a 24' (min) roadway cannot be maintained.
- 2. No Parking/Tow Away signs will be posted 48 hours in advance to clear work zone.
- 3. All construction zone signs/directional signs will conform to WSDOT specs. Signs will be spaced as noted on the plans.
- 4. Use flag trees on all C-18/C-23 signs.

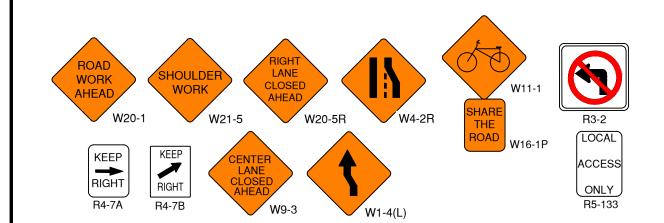

SIGN SPAC	CING = X(1)
FREEWAYS & EXPRESSWAYS	55 / 70 MPH
RURAL HIGHWAYS	60 / 65 MPH
RURAL ROADS	45 / 55 MPH
RURAL ROADS & URBAN ARTERIALS	35 / 40 MPH
RURAL ROADS & URBAN ARTERIALS	25 / 30 MPH
RESIDENTIAL & BUSINESS DISTRICTS	
URBAN STREETS	25 MPH OR LES
(1) ALL SPACING MAY BE ADJUSTED TO	

RAMPS, AT-GRADE INTERSECTIONS AND DRIVEWAYS. (2) THIS SPACING MAY BE REDUCED IN URBAN AREAS TO FI ROADWAY CONDITIONS.

MINIMUM LANE CLOSURE TAPER LENGTH = L (feet)										
LANE WIDTH	Posted Speed (mph)									
(feet)	25	30	35	40	45	50	55	60	65	70
10	105	150	205	270	450	500	550	-	-	-
11	115	165	225	295	495	550	605	660	-	-
12	125	180	245	320	540	600	660	720	780	840

MINIMUM TAPER LENGTH = $L/2$ (FEET)										
LANE WIDTH	Posted Speed (mph)									
(feet)	25	30	35	40	45	50	55	60	65	70
12	80	100	150	180	270	320	360	-	-	-

	MINIMUM SHOULDER TAPER LENGTH = $L/3$ (feet)									
SHOULDER WIDTH		Posted Speed (mph)								
(feet)	25	30	35	40	45	50	55	60	65	70
8'	40	40	60	90	120	130	150	160	170	190
10'	10' 40 60 90 90 150 170 190 200 220 240									
	USE A 3 DEVICES TAPER FOR SHOULDERS LESS THEN 8'									

THIS IS A CO	OMCAS	T DOCUMENT, PROPRIETARY & CONF	IDENTIAL		
DESIGN:	REV	DESCRIPTION	DATE	IMPORTANT NOTICE Section # 4216/4217 of the Government Code requires a Dig Alert	
DRAWN BY: JEFF	2	ISSUE FOR PERMIT	12/05/2023	Identification Number to be issued before a "Permit to Excavate" will be	PROJ#: JB0001439980
APPROVED:				CALL TOLL FREE	CONSTRUCTION TYPE:
APPROVED:				48 HOURS BEFORE YOU DIG UNDERGROUND SERVICE ALERT	SYSTEM: PIERCE COUNT
APPROVED:				1-800-227-2600	NODE:

PRFUP20231453

City of Puyallup Development & Permitting Services ISSUED PERMIT						
Building	Planning					
Engineering	Public Works					
Fire	Traffic					

1500' +/-
800' +/-
500' +/-
350' +/-
200' +/- (2)
S 100' +/- (2)
TERCHANGE
IT

