



PRFUP20231453

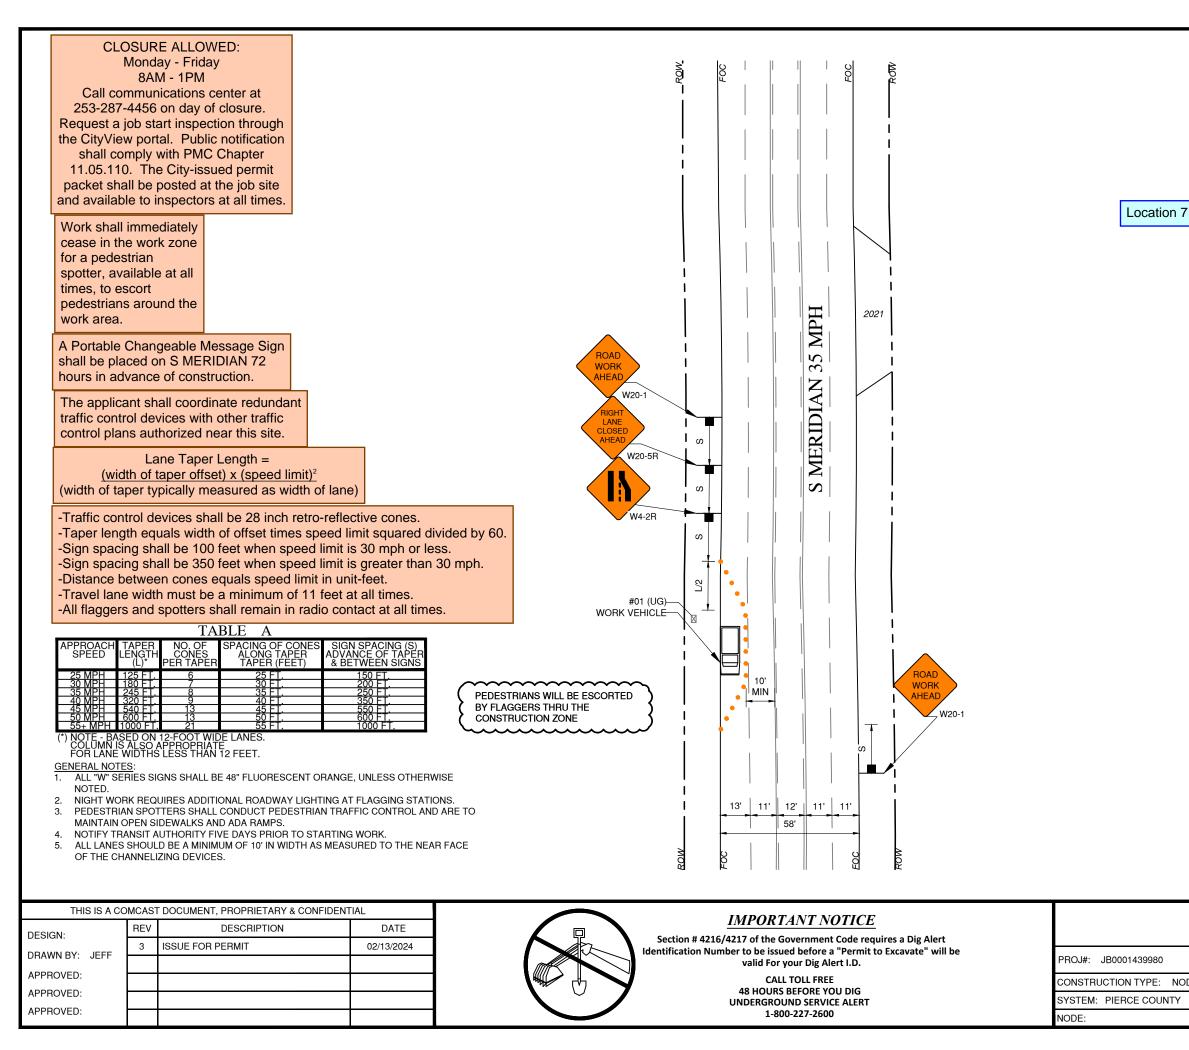

TC1	PRFUP20231453
on the site plan. Up maded and at 2100 TC	
on the site plan. Upgraded ped at 2106 TC	2216 S MERIDIAN.
	SCALE: 1:40
1515 S MERIDIAN, PUYALLUP, WA 98371 TRAFFIC CONTROL	
DE	TC1-2
	SHEET: 2 OF 3

<u>LEGEND</u>

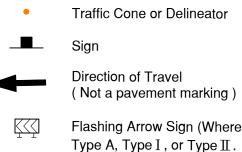

Direction of Travel (Not a pavement marking)



High Level Warning Device (Flagtree)


Barricade (For Excavation Only) **—** Refer to Section 6F.68 of MUTCD to select for Details on Type I, Type Ⅲ, or Type Ⅲ.

Flagger

NOTES:

Y

- 1. Flaggers will be used to control traffic at non-signalized intersections. Flaggers Will use 2 way radios when a 24' (min) roadway cannot be maintained.
- 2. No Parking/Tow Away signs will be posted 48 hours in advance to clear work zone.
- 3. All construction zone signs/directional signs will conform to WSDOT specs. Signs will be spaced as noted on the plans.
- 4. Use flag trees on all C-18/C-23 signs.

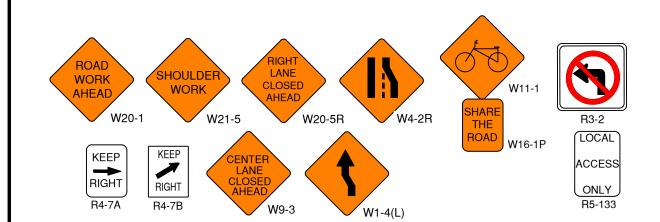

SIGN SPACI	NG = X (1)
FREEWAYS & EXPRESSWAYS	55 / 70 MPH
RURAL HIGHWAYS	60 / 65 MPH
RURAL ROADS	45 / 55 MPH
RURAL ROADS & URBAN ARTERIALS	35 / 40 MPH
RURAL ROADS & URBAN ARTERIALS	25 / 30 MPH
RESIDENTIAL & BUSINESS DISTRICTS	
URBAN STREETS	25 MPH OR LES
(1) ALL SPACING MAY BE ADJUSTED TO	ACCOMMODATE IN

RAMPS, AT-GRADE INTERSECTIONS AND DRIVEWAYS. (2) THIS SPACING MAY BE REDUCED IN URBAN AREAS TO FI ROADWAY CONDITIONS.

MINIMUM LANE CLOSURE TAPER LENGTH = L (feet)										
LANE WIDTH										
(feet)	25	30	35	40	45	50	55	60	65	70
10	105	150	205	270	450	500	550	-	-	-
11	115	165	225	295	495	550	605	660	-	-
12	125	180	245	320	540	600	660	720	780	840

MINIMUM TAPER LENGTH = L/2 (FEET)										
LANE Posted Speed (mph)										
WIDTH (feet)	25	30	35	40	45	50	55	60	65	70
12	80	100	150	180	270	320	360	-	-	-

MINIMUM SHOULDER TAPER LENGTH = $L/3$ (feet)										
SHOULDER WIDTH	Posted Speed (mph)									
(feet)	25	30	35	40	45	50	55	60	65	70
8'	40	40	60	90	120	130	150	160	170	190
10' 40 60 90 90 150 170 190 200 220 240										
USE A 3 DEVICES TAPER FOR SHOULDERS LESS THEN 8'										

THIS IS A CO	MCAS	T DOCUMENT, PROPRIETARY & CONF	IDENTIAL		
DESIGN:	REV	DESCRIPTION	DATE		
DRAWN BY: JEFF	3	ISSUE FOR PERMIT	02/13/2024	Section # 4216/4217 of the Government Code requires a Dig Alert Identification Number to be issued before a "Permit to Excavate" will be valid For your Dig Alert I.D.	PROJ#
APPROVED:				Valid For your Dig Alert I.D. CALL TOLL FREE	CONST
APPROVED:				48 HOURS BEFORE YOU DIG UNDERGROUND SERVICE ALERT	SYSTEM
APPROVED:				1-800-227-2600	NODE:

PRFUP20231453

1500' +	+/-
800' +	-/-
500' +	-/-
350' +	·/-
200' +	·/- (2)
S 100' +	·/- (2)
TERCHANG	E
IT	

