	1	2	3	4
	DRAWING S	YMBOLS	ABBREVIATIONS	S
Η		SECTION NUMBER DRAWING NUMBER SECTION CALLOUT	A AMP AB ANCHOR BOLT AC ALTERNATING CURRENT ACC ACCESSIBLE ACP ACOUSTICAL CEILING PANEL ACT ACOUSTIC CEILING TILE AD AREA DRAIN ADA AMERICANS WITH DISABILITIES ACT ADD ADDENDUM ADDN ADDITION ADDL ADDITIONAL ADJ ADJUSTABLE AFF ABOVE FINISHED FLOOR AGGR AGGREGATE AHJ AUTHORITY HAVING JURISDICTION	F F FARENHEIT FA FIRE ALARM FAB FABRICATE FAC FACILITY FACP FIRE ALARM FAS FIRE ALARM FB FLAT BAR FC FURRING C FCU FAN COIL U FD FLOOR DRA FDC FIRE DEPAR FDN FOUNDATIC FE-X FIRE EXTIN FEC-X FIRE I FGL FIBERGLAS
G	AXXX DRAWING NUMBER DETAIL NUMBER AXXX DRAWING NUMBER DETAIL CALLOUTS DETAIL CALLOUTS MATCH LINE FOR CONTINUATION MATCH LINE	XX DRAWING EXTERIOR ELEVATION CALLOUT ELEVATION CALLOUT ELEVATION XXX DRAWING AXXX DRAWING NUMBER NUMBER INTERIOR ELEVATION CALLOUT ROOM NAME XXXXX XXXX ROOM	AHU AIR HANDLING UNIT AISC AMERICAN INSTITUTE OF STEEL CONSTRUCTION ALT ALTERNATE ALUM ALUMINUM ANCH ANCHOR ANOD ANODIZED AP ACCESS PANEL APPROX APPROXIMATE AR ACID RESISTANT ARCH ARCHITECT, ARCHITECTURAL ASST ASSISTANT ASTM AMERICAN SOCIETY FOR TESTING MATERIALS ASSY ASSEMBLY ATM ATMOSPHERIC ATS AUTOMATIC TRANSFER SWITCH AUTO AUTOMATIC AV AUDIO VISUAL AVE AVENUE AVG AVERAGE AWP ACOUSTICAL WALL PANEL B BAL BALANCE BB BULLETIN BOARD BC BATTERY CABINET BD BOARD BF BARRIER FREE BITM BITUMINOUS	FH FIRE HYDR/ FHC FIRE HOSE FIG FIGURE FIN FINISH, FINI FLASH FLASH FLEX FLEXIBLE FLR FLOOR, FLO FUOR FLUO FO FINISHED O FOIB FURNISHED FOIC FURNISHED FOIC FURNISHED FOIC FURNISHED FOW FACE OF W/ FP FIRE PROO FPM FEET PER S FR FIRE RATED FREQFREQUENC FREQFREQUENC FRTW FIRE ATED FS FLOOR SINI FSD FIRE/SMOKI FT FOOT, FEET FTG FOOTING F TO F FACE FURRFURRING FUT FUTURE FWC FABRIC WAI FXD FIXED
F	1 KEY NOTE CALLOUT A A A A EXISTING NEW GRID COLUMN/BUILDING GRIDS	NUMBER ROOM NAME CALLOUT	BLCK BLOCKING BLDG BUILDING BLVD BOULEVARD BM BENCH MARK BO BOTTOM OF BOF BOTTOM OF FOOTING (FOUNDATION) BOS BOTTOM OF STRUCTURE BOT BOTTOM BR BULLET RESISTIVE BRG BEARING BRID BRIDGE, BRIDGING BRKT BRACKET BRZ BRONZE BS BOTH SIDES BSMT BASEMENT BTUH BRITISH THERMAL UNITS PER HOUR BTW BETWEEN BUR BUILT UP ROOFING C CAB CABINET CAP CAPACITY CB CATCH BASIN CEM CEMENT, CEMENTITIOUS CEM PL CEMENT PLASTER	G GA GAUGE / GY GAL GALUON GALV GALVANIZEI GB GRAB BAR GC GENERAL / GFRCGLASS FIBE GFRG GLASS GI GALVANIZEI GL GLASS OR O GLAMGLUE LAMIN GLP GYPSUM LA GSL GYPSUM LA GSL GYPSUM SH GWB GYPSUM W GYP GYPSUM H H HIGH HB HOSE BIBB HC HOLLOW CO HD HAND DRYEF HDB HARD BOARI HDF HIGH DENSIT HDW HARDWARE HDWDHARDWOOD HM HOLLOW ME HO HOLD OPEN HORIZHORIZONTAL
E	$\begin{bmatrix} 1 & A & 2 & a \end{bmatrix}$ $PARTITION TYPE CALLOUT$ $PARTITION TYPE CALLOUT$ $ELEVATION/DATUM CALLOUT$ $ELEVATION/DATUM CALLOUT$ $EXISTING TO BE REMOVED$ $MEW WORK$	WXXX WINDOW NUMBER $LXXX LOUVER NUMBER$ $E XXXX EQUIPMENT CALLOUT$ $F XXXX FURNITURE CALLOUT$ $F XXXX FINISH CALLOUT$	CER CERAMIC CF CUBIC FEET CFH CUBIC FEET PER HOUR CFLG COUNTERFLASHING CFM CUBIC FEET PER MINUTE CFS CUBIC FEET PER SECOND CG CORNER GUARD / CENTER OF GRAVITY CH COAT HOOK CHAN CHANNEL CHAM CHAMFER CI CAST IRON CIP CAST IN PLACE (CONCRETE) CJ CONSTRUCTION JOINT CL CENTER LINE CLG CEILING CLJ CONTROL JOINT CLOS CLOSET CLR CLEAR, CLEARANCE CLSR CLOSER CMU CONCRETE MASONRY UNIT CMP COMPOSITE METAL PANEL CO CLEAN OUT COL COLUMN COMM COMMUNICATIONS CONC CONCRETE COND CONDITION CONF CONFERENCE CONST CONSTRUCTION CONT CONTINUOUS	HT HEIGHT HZ HERTZ (FREC HT HEIGHT HVAC HEATING, VE IBC INTERNATIOI IC INTERCOM ID INSIDE DIAM IEC INTERNATIOI IFC INTERNATIOI IFC INTERNATIOI INCL INCLUDE, INC INFO INFORMATIO INCL INCLUDE, INC INFO INFORMATIO INSUL INSULATION INT INTERIOR IPC INTERNATIOI J JAN JANITOR JS JANITOR'S SI JT JOINT K KIT KITCHEN KV KILO-VOLT
D	PLAN SYMB Organization Fire extinguisher Fre Fre Fre Fre Fre Fre Fre Fre Fre	SUPPLY AIR DIFFUSER RETURN AIR GRILLE EXHAUST FAN	CONTR CONTRACTOR COORD COORDINATE CORR CORRIDOR CP CENTER POINT CPT CARPET CR CARD READER CRAC COMPUTER ROOM AIR CONDITIONING UNIT CRB CARD READER WITH BIOMETRIC SCAN CRAH COMPUTER ROOM AIR HANDLING UNIT CSK COUNTERSINK, COUNTERSUNK CT CERAMIC TILE CTR COUNTER CTWRCOOLING TOWER CU CONDENSING UNIT CUB CUBIC CW COLD WATER CY CUBIC YARD D d PENNY (NAILS) D DEEP db DECIBLES DBL DOUBLE DC DIRECT CURRENT DEG DEGREE(S) DEMODEMOLISH, DEMOLITION DEPT DEPARTMENT	KVA KILO-VOLT-A KW KILO-WATT L LONG LAM LAMINATE, L/ LAU LAUNDRY LAV LAVATORY LAV LAVATORY LH LEFT HAND LHR LEFT HAND LHR LEFT HAND LHR LEFT HAND KI LT LIGHT LTG LIGHTING MAS MASONRY MATL MATERIAL MAX MAXIMUM MDF MEDIUM DEN MATL MATERIAL MAX MAXIMUM MDF MEDIUM DEN MECH MECH, MED MEDIUM MEMB MEMB MEZZ MEZZANINE MFR MANUFACTU MGMT MANAG MH MANHOLE MIN MINIMUM, MI MTD MOUNTED
С	FXRECESSED TROFFER LIGHTING FIXTUREFXRECESSED CAN LIGHITNG FIXTUREFXRECESSED CAN LIGHITNG FIXTUREFXSURFACE MOUNTED STRIP LIGHITNG FIXTUREFXSURFACE MOUNTED STRIP LIGHITNG FIXTUREFXWALL MOUNTED LIGHITNG FIXTURE	PA ANNOUNCEMENT SPEAKER EPO EMERGENCY POWER OFF SWITCH	DET DETAIL DF DRINKING FOUNTAIN DIA DIAMETER DIAG DIAGONAL DICA DRILLED IN CONCRETE ANCHOR DIFF DIFFUSER DIM DIMENSION(S) DIR DIRECTOR DISC DISCONNECT DISP DISPENSER DIV DIVISION DL DEAD LOAD DMPF DAMP PROOF, DAMP PROOFING DN DOWN DO DITTO DP DEEP DR DOOR/DRAIN DRC DOOR CONTACT DS DOWNSPOUT DW DISHWASHER DWG DRAWING DWL DOWEL DWR DRAWER DWTRDISTILLED WATER E E EAST	MTL METAL MTS MANUAL TRA MP METAL PANE MPOE MINIMUM PO MS METAL STUD MVA MEGA-VOLT- MVBL MOVABLE MW MEGA-WATT NUC NOT IN CONT NEC NATIONAL EL NFPA NATIONAL EL NFPA NATIONAL FIN NIC NOT IN CONT NOM NUMBER NOM NOMINAL NS NO SCALE NTS NOT TO SCALE NTS NOT TO SCALE NTS NOT TO SCALE OC ON CENTER OD OUTSIDE DIA OH OVERHEAD OFD OVERFLOW I OFD OVERFLOW I OFD OVERFLOW I OFD OVERFLOW I
В	SECURITY SECURITY CR CR CARD READER CR COMBINATION CARD READER/BIOMETRIC SCANNER DC	RF RFID READER	EA EXHAUST AIR EB EXPANSION BOLT EF EXHAUST FAN EJ EXPANSION JOINT EL ELEVATION ELEC ELECTRICAL ELEV ELEVATION / ELEVATOR ELIM ELIMINATE EMER EMERGENCY EPWREMERGENCY POWER ENAM ENAMEL(ED) ENCL ENCLOSURE ENG ENGINEER ENT ENTRANCE EP EXPLOSION PROOF EPOXFL EPOXY FLOORING EPOXFL EPOXY FLOORING EPOXFL EPOXY PAINT EQ EQUAL EQUIPEQUIPMENT EPO EMERGENCY POWER OFF ES EMERGENCY SHOWER ESDF ELECTRO STATIC DISSAPATIVE FLOORING EST ESTIMATE(D) ETC ET CETERA ETR EXISTING TO REMAIN	PA PUBLIC ANNO PB PUSH BUTTO PBD PARTICLE BO PC PRECAST PDU PLANTER DR PDU POWER DIST PERP PERPINDICU PIR PASSIVE INF PL PROPERTY L PLAM PLASTIC LAM PLAS PLASTER PLYWD PLYWO PNL PANEL PR PAIR PRK PARK, PARKI PROP PROPERTY POC POINT OF CO PT PAINT, PAINT PTD PAPER TOWE PTN PARTITION PVMT PAVEMENT Q QT QUARRY TILE
A	DCDOOR COUNTNOTDBDURESS BUTTONICINTERCOMICCINTERCOM W/CAMERAICCPASSIVE INFRARED DETECTORMDMOTION DETECTORPINPIN PAD		EVAC EVACUATE, EVACUATION EW EYE WASH EXAM EXAMINATION EXC EXCAVATE, EXCAVATED, EXCAVATION EXH EXHAUST EXIST EXISTING EXP EXPOSED, EXPANSION EXT EXTERIOR EXTR EXTRUDED	R RA RISER RA RETURN AIR RAD RADIUS RAF RAISED ACCI RD ROOF DRAIN REF REFERENCE REFR REFRIGERAT REINF REINFORCE, REQD REQUIRED REV REVISION RF RELIEF FAN RFG ROOFING RH RIGHT HAND RHR RIGHT HAND RHR RIGHT HAND RL RAIN LEADEF RM ROOM RO ROUGH OPE RPM REVOLUTION RPP REMOTE PON RPP REMOTE PON RR RELAY RACK RTU RIGHT RTU ROOF TOP A

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VICINITY MAP

FARENHEIT FIRE ALARM

FAB FABRICATE, FABRICATOR / FABRIC FAC FACILITY FACP FIRE ALARM CONTROL PANEL FAS FIRE ALARM SYSTEM FB FLAT BAR FD FLAT DAN FC FURRING CHANNEL FCU FAN COIL UNIT FD FLOOR DRAIN FDC FIRE DEPARTMENT CONNECTION

FDC FIRE DEFARINE TO CONNECTION FDN FOUNDATION FE-X FIRE EXTINGUISHER, "X" DENOTES TYPE FEC-X______FIRE EXTINGUISHER CABINET, "X" DENOTES TYPE FGL FIBERGLAS FH FIRE HYDRANT FHC FIRE HOSE CABINET

FHC FIRE HOSE CABINET FIG FIGURE FIN FINISH, FINISHED FLASH FLASHING FLEX FLEXIBLE FLR FLOOR, FLOORING FLUOR FLUORESCENT FO FINISHED OPENING FOIB FURNISHED BY OTHERS, INSTALLED BY OTHERS FOIC FURNISHED BY OTHERS, INSTALLED BY CONTRACTOR FOW FACE OF WALL FP FIRE PROOFING, FIRE PROTECTION FPM FEET PER MINUTE FPS FEET PER SECOND FPS FEET PER SECOND FR FIRE RATED, FIRE RATING FREQFREQUENCY FRTW FIRE RETARDANT TREATED WOOD

FRTW FIRE RETARDANT TR FS FLOOR SINK FSD FIRE/SMOKE DAMPER FT FOOT, FEET FTG FOOTING F TO F FACE TO FACE FURRFURRING FUT FUTURE FWC FABRIC WALL COVERING FXD FIXED

GA GAUGE / GYPSUM ASSOCIATION GAL GALLON GALV GALVANIZED GRAB BAR

GC GENERAL CONTRACTOR GEN GENERAL / GENERATOR GFRCGLASS FIBER REINFORCED CONCRETE GLASS FIBER REINFORCED GYPSUM GFRG GALVANIZED IRON GLASS OR GLAZING

GLANGLUE LAMINATED GLP GYPSUM LATH AND PLASTER GSL GYPSUM SHAFT LINER GWB GYPSUM WALLBOARD GYP GYPSUM

H HIGH HB HOSE BIBB HC HOLLOW CORE HD HAND DRYER HDB HARD BOARD HDF HIGH DENSITY FIBERBOARD HDW HARDWARE HDWDHARDWOOD HM HOLLOW METAL HO HOLD OPEN HORIZHORIZONTAL HR HOUR HT HEIGHT

HERTZ (FREQUENCY) HEIGHT HVAC HEATING, VENTILATION AND AIR CONDITIONING

I IBC INTERNATIONAL BUILDING CODE IC INTERCOM ID INSIDE DIAMETER IEC INTERNATIONAL ENERGY CODE IFC INTERNATIONAL FIRE CODE IMC INTERNATIONAL MECHANICAL CODE INCL INCLUDE, INCLUDING INFO INFORMATION INSUL INSULATION

INSUL INSULATION INT INTERIOR IPC INTERNATIONAL PLUMBING CODE

JANITOR JANITOR'S SINK JOINT

KITCHEN KILO-VOLT KV KILO-VOLT KVA KILO-VOLT-AMPERE KW KILO-WATT

LONG LAM LAMINATE, LAMINATED LAWI LAWINATE, LAWINATED LAU LAUNDRY LAV LAVATORY LH LEFT HAND LHR LEFT HAND REVERSED LS LAG SCREW LT LIGHT LTG LIGHTING

MAS MASONRY MATL MATERIAL MAX MAXIMUM MDF MEDIUM DENSITY FIBERBOARD

MDF(T) MECH MECHANICAL MED MEDIUM MEMB MEMBRANE MEZZ MEZZANINE MFR MANUFACTURE, MANUFACTURER MGMT MANAGEMENT MH MANHOLE MIN MINIMUM, MINUTE MTD MOUNTED MTD MOUNTED MTL METAL MTS MANUAL TRANSFER SWITCH MP METAL PANEL MPOE MINIMUM POINT OF ENTRY (TELECOM) MS METAL STUD MVA MEGA-VOLT-AMPERE

MAIN DISTRIBUTION FRAME-TELECOM

NORTH N NORTH NEC NATIONAL ELECTRIC CODE NFPA NATIONAL FIRE PROTECTION ASSOCIATION NIC NOT IN CONTRACT NOM NUMBER NOM NOMINAL NS NO SCALE NTS NOT TO SCALE

ON CENTER OUTSIDE DIAMETER OVERHEAD O OVERFLOW DRAIN O OVERHEAD DOOR OH OVERHEAD OFD OVERFLOV OHD OVERHEAD OPNG OPENING OPP OPPOSITE OFRD OVERFLOW ROOF DRAIN OTS OPEN TO STRUCTURE ABOVE

PA PUBLIC ANNOUNCEMENT SYSTEM PB PUSH BUTTON PBD PARTICLE BOARD PBD PARTICLE BOARD PC PRECAST PDU PLANTER DRAIN PDU POWER DISTRIBUTION UNIT PERP PERPINDICULAR PIR PASSIVE INFRARED DETECTOR PL PROPERTY LINE PL PROPERTY LINE

PLAM PLASTIC LAMINATE PLAS PLASTER PLYWD PLYWOOD PNL PANEL PR PAIR

PRK PARK, PARKING PROP PROPERTY PROPERTY POC POINT OF CONNECTION PT PAINT, PAINTED, POINT, PRESSURE TREATED PTD PAPER TOWEL DISPENSER PTN PARTITION PVMT PAVEMENT

R RISER RA RETURN AIR RAD RADIUS RAF RAISED ACCESS FLOOR SYSTEM RD ROOF DRAIN, ROAD REF REFERENCE REFERENCE

QT QUARRY TILE

REF REFERENCE REFR REFRIGERATOR REINF REINFORCE, REINFORCING REQD REQUIRED REV REVISION RF RELIEF FAN RFG ROOFING RH RIGHT HAND RHR RIGHT HAND REVERSED RL RAIN LEADER RM ROOM RO ROUGH OPENING RPM REVOLUTIONS PER MINUTE RPP REMOTE POWER PANEL RR RELAY RACK RTU RIGHT RTU ROOF TOP AIR CONDITIONING UNIT

SPKLR SPRINKLER SPKR SPEAKER SPKR SPEAKER SPR SINGLE PLY ROOFING SQ SQUARE SR SERVER RACK SS SERVICE SINK SSM SOLID SURFACING MATERIAL SSTL STAINLESS STEEL STC SOUND TRANSMISSION CLASS SOUND TRANSMISSION CLASS STE STEEL STORSTORAGE STRUCT STRUCTURE, STRUCTURAL SVF SHEET VINYL FLOORING SW SIDEWALK SWBD SWITCHBOARD SWG SWITCHGEAR T TREAD TBB TELEPHONE BACKBOARD TBD TILE BACKER BOARD TD TRENCH DRAIN TELEPHONE

TERZ TERRAZZO T&G TONGUE AND GROOVE THK THICK, THICKNESS TO TOP OF TPD TOILET PAPER DISPENSER TS TUBE STEEL TSTAT THERMOSTAT TELEVISION TYP TYPICAL

NC. WD WOOD WF WIDE FLANGE WH WALL HYDRANT WM WATER METER WMP WIRE MESH PARTITION WP WEATHER PROOF, WATER PROOF WWF WELDED WIRE FABRIC

XRAY XRAY PROCESS OR MACHINE XFMR TRANSFORMER YD YARD ZN ZINC

31ST AVE. SE LAKE BRADLEY <u>37TH AVE.</u> SE 39TH AVE/ N NO SCALE

PROJECT INFO

PROJECT ADDRESS 1023 39TH AVENUE SE PUYALLUP, WA 98374-2121

PARCEL NUMBER 0419034037

LEGAL DESCRIPTION SECTION 03 TOWNSHIP 19 RANGE 04 QUART ROS 2007-04-30-5001 (AFF OF MIN OR CORR S 2007102600450) COM AT S ¹/₄ COR OF SEC TH N SEC W 2621.06 FT FROM SE COR TH N OO DEG 676.33 FT TO POB TH CONT N 00 DEG 00 MIN 24 TO A PT S 00 DEG 00 MIN 24 SEC W 30.21 FT TH 17 SEC E 1258.61 FT TH S 00 DEG 13 MIN 45 SE S 42 DEG 55 MIN 23 W 659.07 FT TH S 07 DEG 4 686.42 FT TH N 87 DEG 01 MIN 38 SEC W 169.4 MIN 42 SEC E 672.42 FT TH N 89 DEG 59 MIN 3 TO POB APPROVED SUBD BY CY OF PUYALL 04/03/07 OUT OF 4-028 SEG 2008-0246 10/23/0

CODE INFORMA

APPLICABLE CODES

WASHINGTON BUILDING CODE, 2018 EDITION WASHINGTON FIRE CODE, 2018 EDITION WASHINGTON MECHANICAL CODE, 2018 EDIT WASHINGTON MECHANICAL CODE, 2018 EDIT WASHINGTON PLUMBING CODE, 2018 EDITION NATIONAL ELECTRIC CODE, CURRENT EDITIO WASHINGTON STATE ENERGY CODE, CURREN

LAND USE CODES

PUYALLUP MUNICIPAL CODE EXISTING ZONING DESIGNATION: MP - BUSIN PROPOSED ZONING DESIGNATION: MP - BUSI CHANGE OF USE REQUIRED: NO

BUILDING CODE INFORMATION

BUILDING OCCUPANCY GROUP: TYPE B, DAT TYPE OF CONSTRUCTION: TYPE IIA, FULLY S NO CHANGE TO BUILDING HEIGHT OR AREA LAND USE CODE INFORMATION

EXISTING SITE AREA: 15.77ACRES

GENERAL NOTE

- DO NOT SCALE THE DRAWINGS.
- THE DRAWINGS AND SPECIFICATIONS A WHAT IS SHOWN ON ONE SHALL BE CO **REQUIRED BY BOTH.**
- THE CONTRACTOR SHALL VERIFY ALL F - 3. PRIOR TO COMMENCING ANY WORK. NOTIFY THE ARCHITECT IMMEDIATELY IMPACT THE IMPLEMENTATION OF THE ALL EXISTING ELEMENTS SHOWN ON T ARE INCLUDED WITHOUT ANY GUARAN
- ALL DIMENSIONS ARE SHOWN TO THE 4 OR FINISHED SURFACES, UNLESS NOT
- DETAILS ARE SHOWN ON THE DRAWING OCCURANCE OF THE CONDITION AND A OTHER SIMILAR CONDITIONS.
- PROVIDE A MINIMUM OF 6" FROM AN AD. SURFACE TO THE EDGE OF ANY FINISHE 6

SD SMOKE DETECTOR, STORM DRAIN SECT SECTION SGL SINGLE SHT SHEET SHTGSHEATHING SIM SIMILAR SJ SIESMIC JOINT SMACNA SHEET METAL AND AIRCONDITIONING CONTRACTORS NATIONAL ASSOCIATION SMD SMOKE DAMPER SMR SHEET METAL ROOFING SMP SHEET METAL PANEL SPD SOAP DISPENSER SPEC SPECIFICATION SPKLR SPRINKLER

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SCHED SCHEDULE SCHED SCHEDULE SD SMOKE DETECTOR, STORM DRAIN

SOUTH SUPPLY AIR SOLID CORE

TEMPTEMPERATURE, TEMPORARY

U URINAL UF UNDER FLOOR UL UNDERWRITERS LABORATORIES UNFIN UNFINISHED UNGRD UNDERGROUND UON UNLESS OTHERWISE NOTED UPS UNITERRUPTIBLE POWER SUPPLY

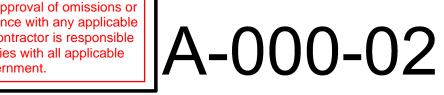
V VOLT VB VAPOR BARRIER VC VIDEO CAMERA VCT VINYL COMPOSITION TILE VERT VERTICAL VEST VESTIBULE VIF VERIFY IN FIELD VNR VENEER VTF VINYL TILE FLOORING VWC VINYL WALL COVERING

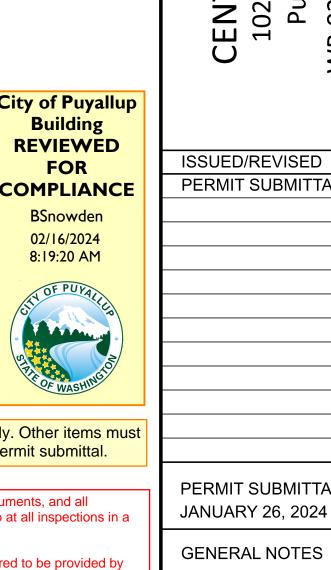
WATT WEST, WIDE WITH WATER CLOSET

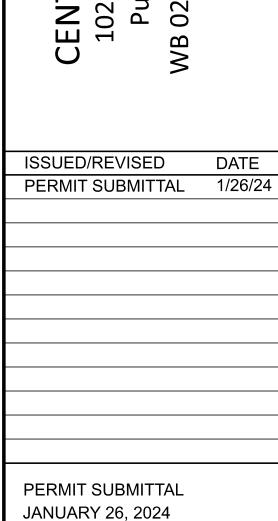
3	9	10		11		12
	PRC	JECT DIR	ECTORY		SHEE	T INDEX
PROJECT SITE	ARCHITECT DAVEV@BEI DAVEV@BEI CASCADE M 6210 36TH A SEATTLE, W MAIN PHONI CONTACT: L PHONE: 206 EMAIL: LEO MISSIONCRI STRUCTURA QUANTUM C 1511 THIRDA SEATTLE, W MAIN PHONI CONTACT: S PHONE: 206	NAROYA.COM ISSION CRITICAL, LLC VENUE N.E. A 98115 E: 206-294-1288 LEONARD A. RUFF, AIA S-294-1288 NARD.RUFF@CASCADE TICAL.COM AVENUE, SUITE 323 A 98101 E: 206-957-3900 SCOTT TINKER, PE			ARCHITECTURA A-000-02 A-101-02 A-102-02 STRUCTURAL S1.0 S1.1 S3.0	L GENERAL INFORMATION OVERALL SITE PLAN ENLARGED SITE PLANS SECTIONS GENERAL STRUCTURAL NOTES DETAILS DETAILS
RMATION	SCO	PE OF WC	DRK			
ER 43 PARCEL "1" OF SURVEY N 86 DEG 31 MIN 42 G OO MIN 24 SEC E 24 SEC E 1923.18 FT H S 87 DEG 44 MIN EC W 1391.90 FT TH 42 MIN 49 SEC E 35 FT TH N 00 DEG 52 36 SEC W 736.66 FT JP PLANNING DEPT 7CL DC11/19/07CL	CONSTRUCT AIR COOLED AREA OF NE	/ORK	ANICAL EQUIPMENT. TOTAL	RS, -		
ΑΤΙΟΝ						
I FION N DN INT EDITION NESS PARK SINESS PARK						
ΞS						
ARE COMPLEMENTARY. NSTRUED TO BE FIELD CONDITIONS IF ANY CONDITIONS DESIGN INTENT. HE DRAWINGS TEE OF ACCURACY. STRUCTURAL GRID ED OTHERWISE. GS FOR THE FIRST ARE TYPICAL FOR ALL DJACENT FINISHED IED OPENING.			The City shall not be held liable for	anv	be approved via	City of Puyallu Building REVIEWED FOR COMPLIANCE BSnowden 02/16/2024 8:19:20 AM OF PUYAL BSNOWDEN BSNOWDEN 02/16/2024 8:19:20 AM
			The City shall not be held liable for a conflicts that arise between the app building plans and approved civil construction plans since the building permits were issued prior to civil app Call before you dig. It's Dial 811 or call 1-800-42 Refer to the City standard deta 02.03.02 & 05.02.01 for typica and sedimentation control met	roved g proval. the law. 24-5555. ails I erosion	engineering must be pos visible and readily access Full sized legible color pl the permitee on site for in Approval of submitted pla oversights by this office of regulations of local gover	ans are required to be provided by ispection. ans is not an approval of omissions or non compliance with any applicat mment. The contractor is responsib puilding complies with all applicable

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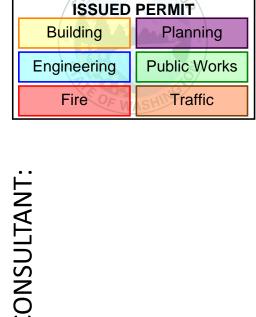


PARK n East n Eas 121 VOLTAGE P Avenue South F WA 98374-21 WA 98374-21 ≺ס Aver WA ₹ Chiller North CENTERIS 1023 39th A allup, Рu 02









City of Puyallup **Development & Permitting Services**

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INFORMATION SITE PLAN D SITE PLANS

PRFO20240140

SITE INFORMATION

PARCEL NO. 0419034037 ADDRESS: 1023 39TH AVENUE S.E. PARCEL AREA: 15.77 ACRES

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С

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LEGAL DESCRIPTION Section 03 Township 19 Range 04 Quarter 42 LOT 2 OF BLR 2022-03-22-5003 A POR OF BLR 2019-05-22-5002 LY IN CY OF PUYALLUP MORE PARTICULARLY DESC AS FOLL COM AT STONE MON MARKING S 1/4 COR OF SEC 3 SD STONE MON LIES N 86 DEG 31 MIN 42 SEC E 2621.06 FT FROM SE COR OF SD SEC 3 TH N 00 DEG 00 MIN 24 SEC E 2599.51 FT TH S 87 DEG 44 MIN 17 SEC E 496.53 FT TO POB TH S 00 DEG 04 MIN W 132.96 FT TH S 16 DEG 29 MIN 57 SEC E 15.96 FT TH S 00 DEG 00 MIN 36 SEC E 335.82 FT TH S 52 DEG 49 MIN 01 SEC E 132.81 FT TH S 89 DEG 15 MIN 41 SEC E 28.82 FT TH S 82 DEG 14 MIN 13 SEC E 58.63 FT TH S 53 DEG 48 MIN 38 SEC E 78.9 FT TH S 89 DEG 41 MIN 48 SEC E 655.79 FT TH S 83 DEG 08 MIN 36 SEC E 199.54 FT TH N 00 DEG 13 MIN 45 SEC E 602.4 FT TH N 87 DEG 44 MIN 17 SEC W 1118.01 FT TO POB EASE OF REC OUT OF 04-19-03-4-031 & 4-034 SEG 2019-0472 05/30/19 JP 20190652DC 03/31/22 JP



Planning Note: Foundation Only, chillers, mechanical equipment and other structures under separate

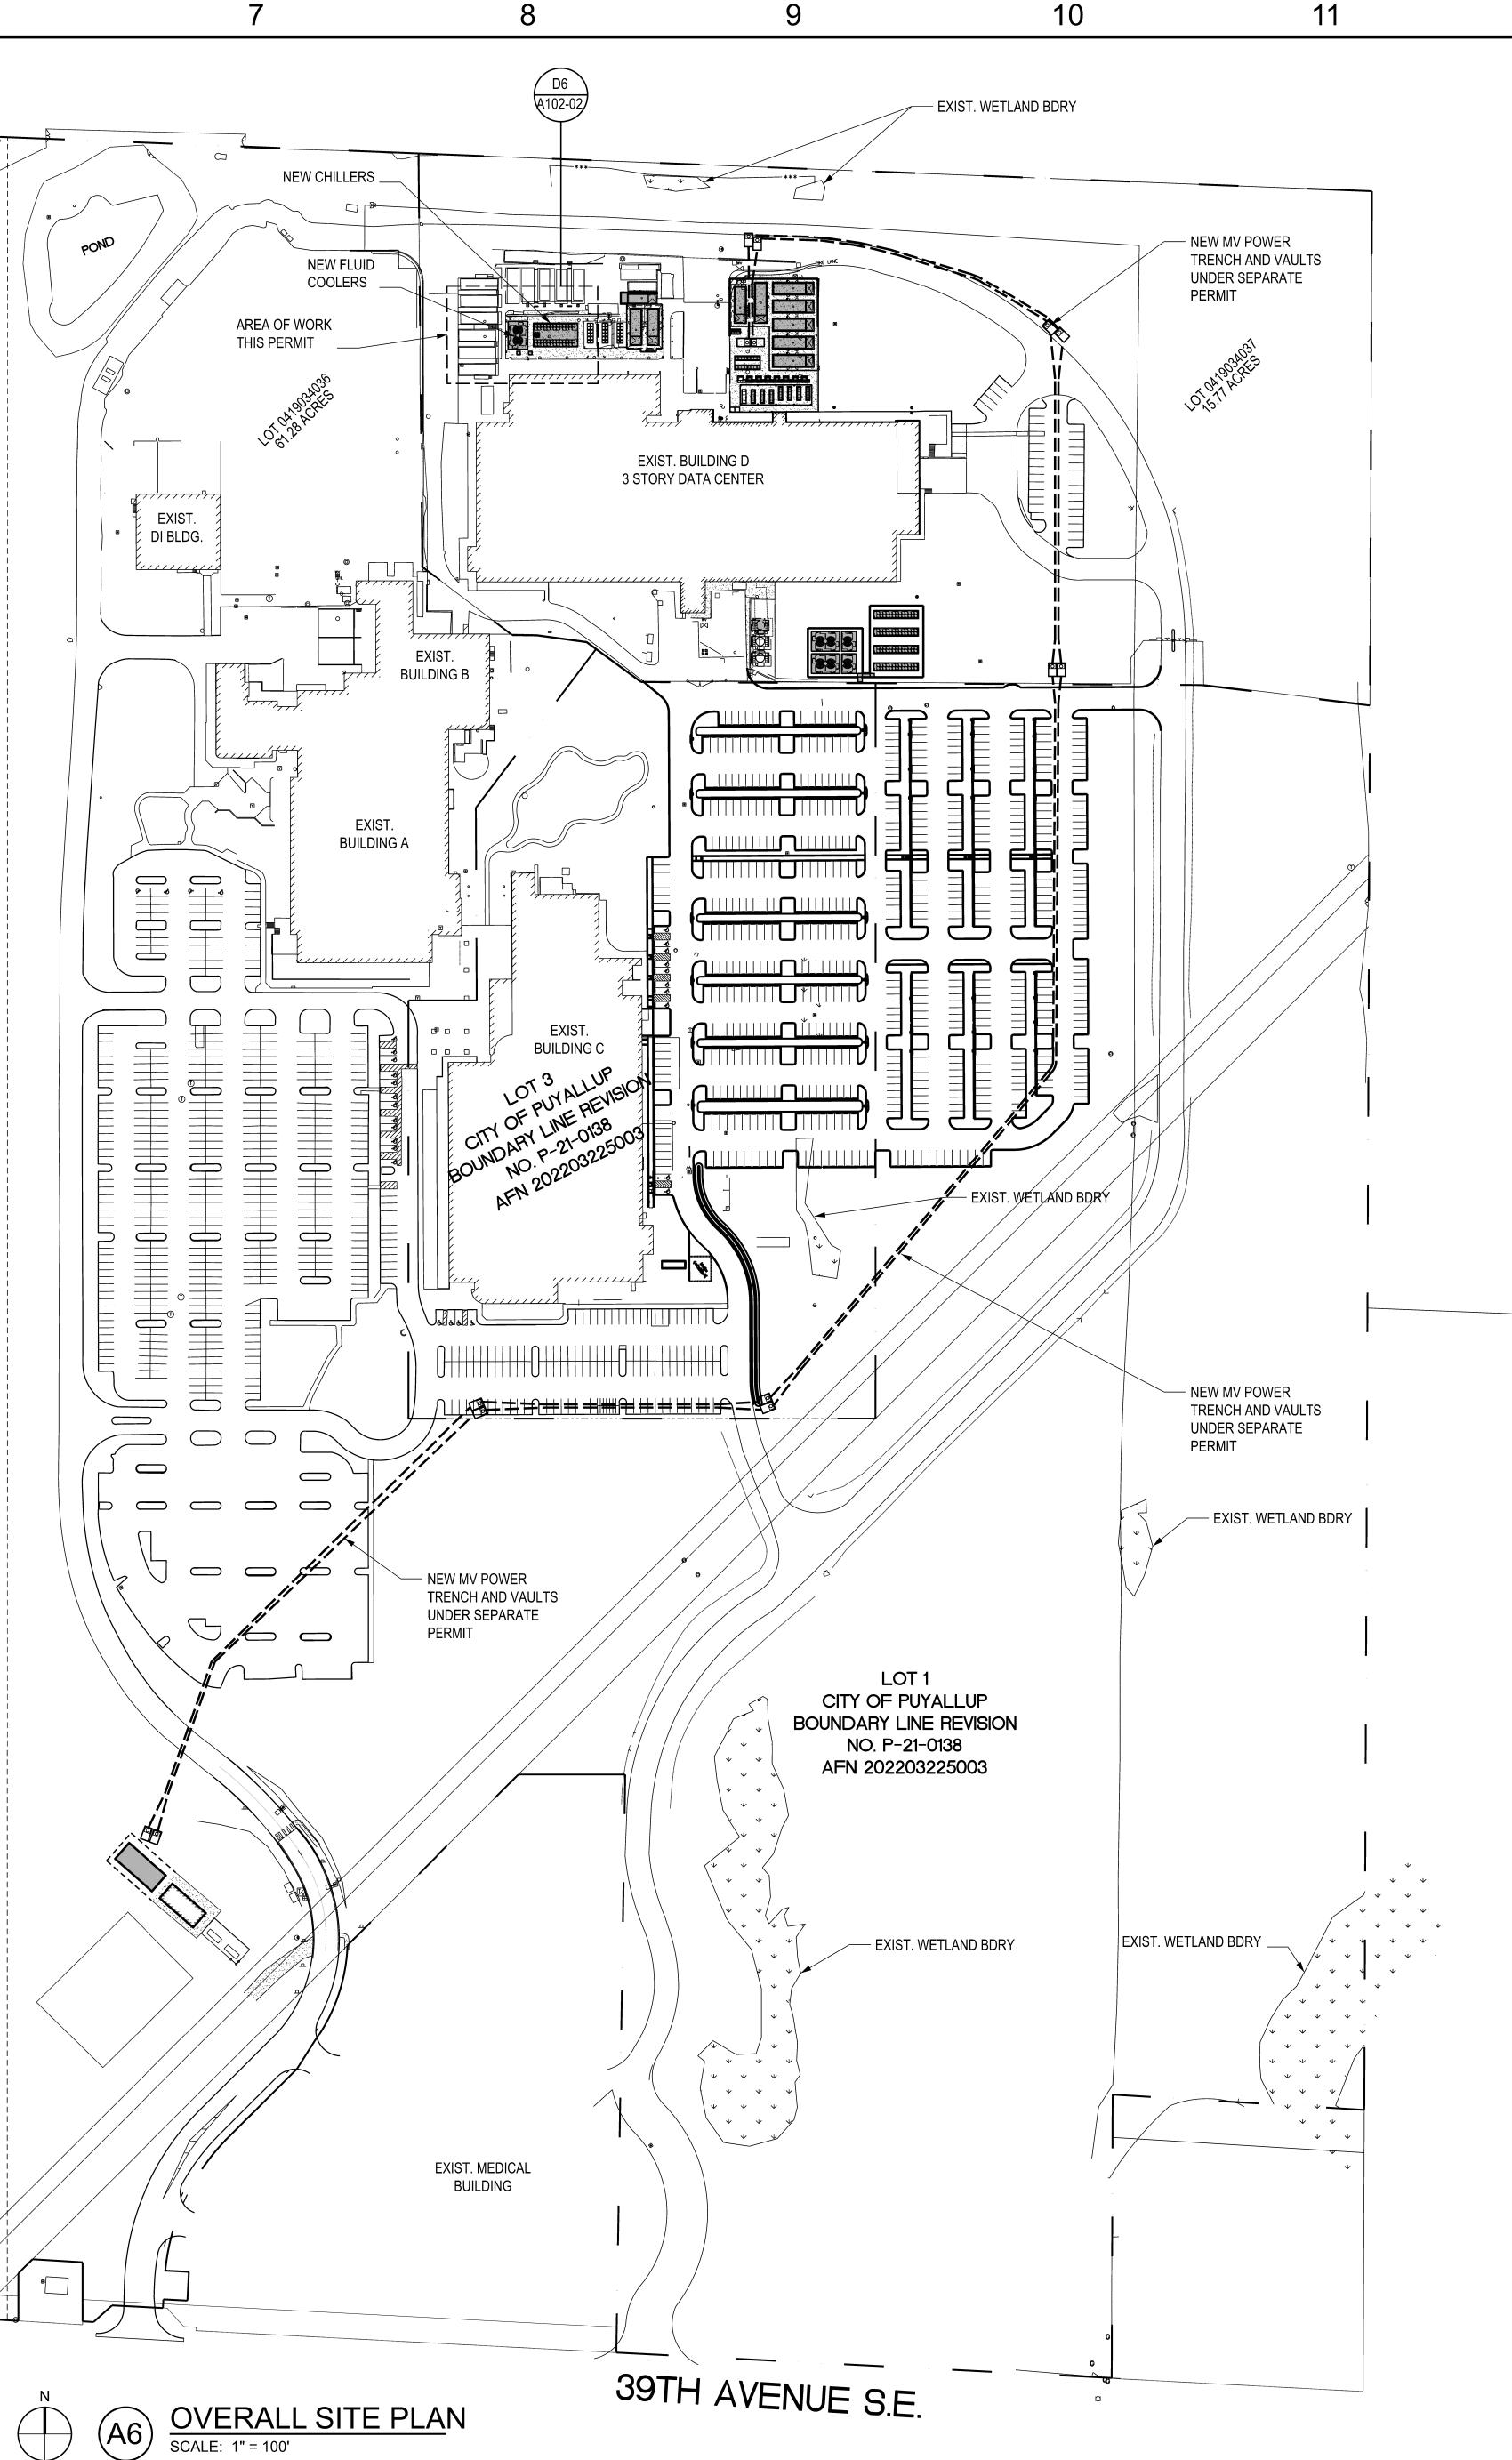
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OVERALL SCOPE OF WORK

INSTALL ONE CONCRETE SLAB FOUNDATION FOR TWO NEW FLUID COOLERS; INSTALL ONE NEW CONCRETE SLAB FOUNDATION FOR TWO NEW AIR COOLED CHILLERS, INSTALL CONCRETE EQUIPMENT PADS FOR MISCELLANEOUS MECHANICAL EQUIPMENT.

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PRFO20240140

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LLC

CASCADE MISSION CRITICAL *Data Center Consulting and Design* 6210 36th Avenue N.E. Seattle, WA 9811 P: 206-294-1288 www.cascademissioncr

PARK

VOLTAGE Avenue South

CENTERIS 1023 39th A

ISSUED/REVISED

PERMIT SUBMITTAL

OVERALL SITE PLAN

A-101-02

JANUARY 26, 2024

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Chiller & Fluid Coo North Utility Yard

DATE

Puyallup, V WB 02: Chiller

PERMIT SUBMITTAL 1/26/24

enue South A 98374-21

Aven , WA

Inters Suite 115 VA 98040

BENARO Centeris 9675 SE Mercer Is +1.253.20

City of Puyallup

Development & Permitting Services

ISSUED PERMIT

5538 REGISTERED ARCHITECT LEONARD A. RUFF

STATE OF WASHINGTON

Planning

Public Works

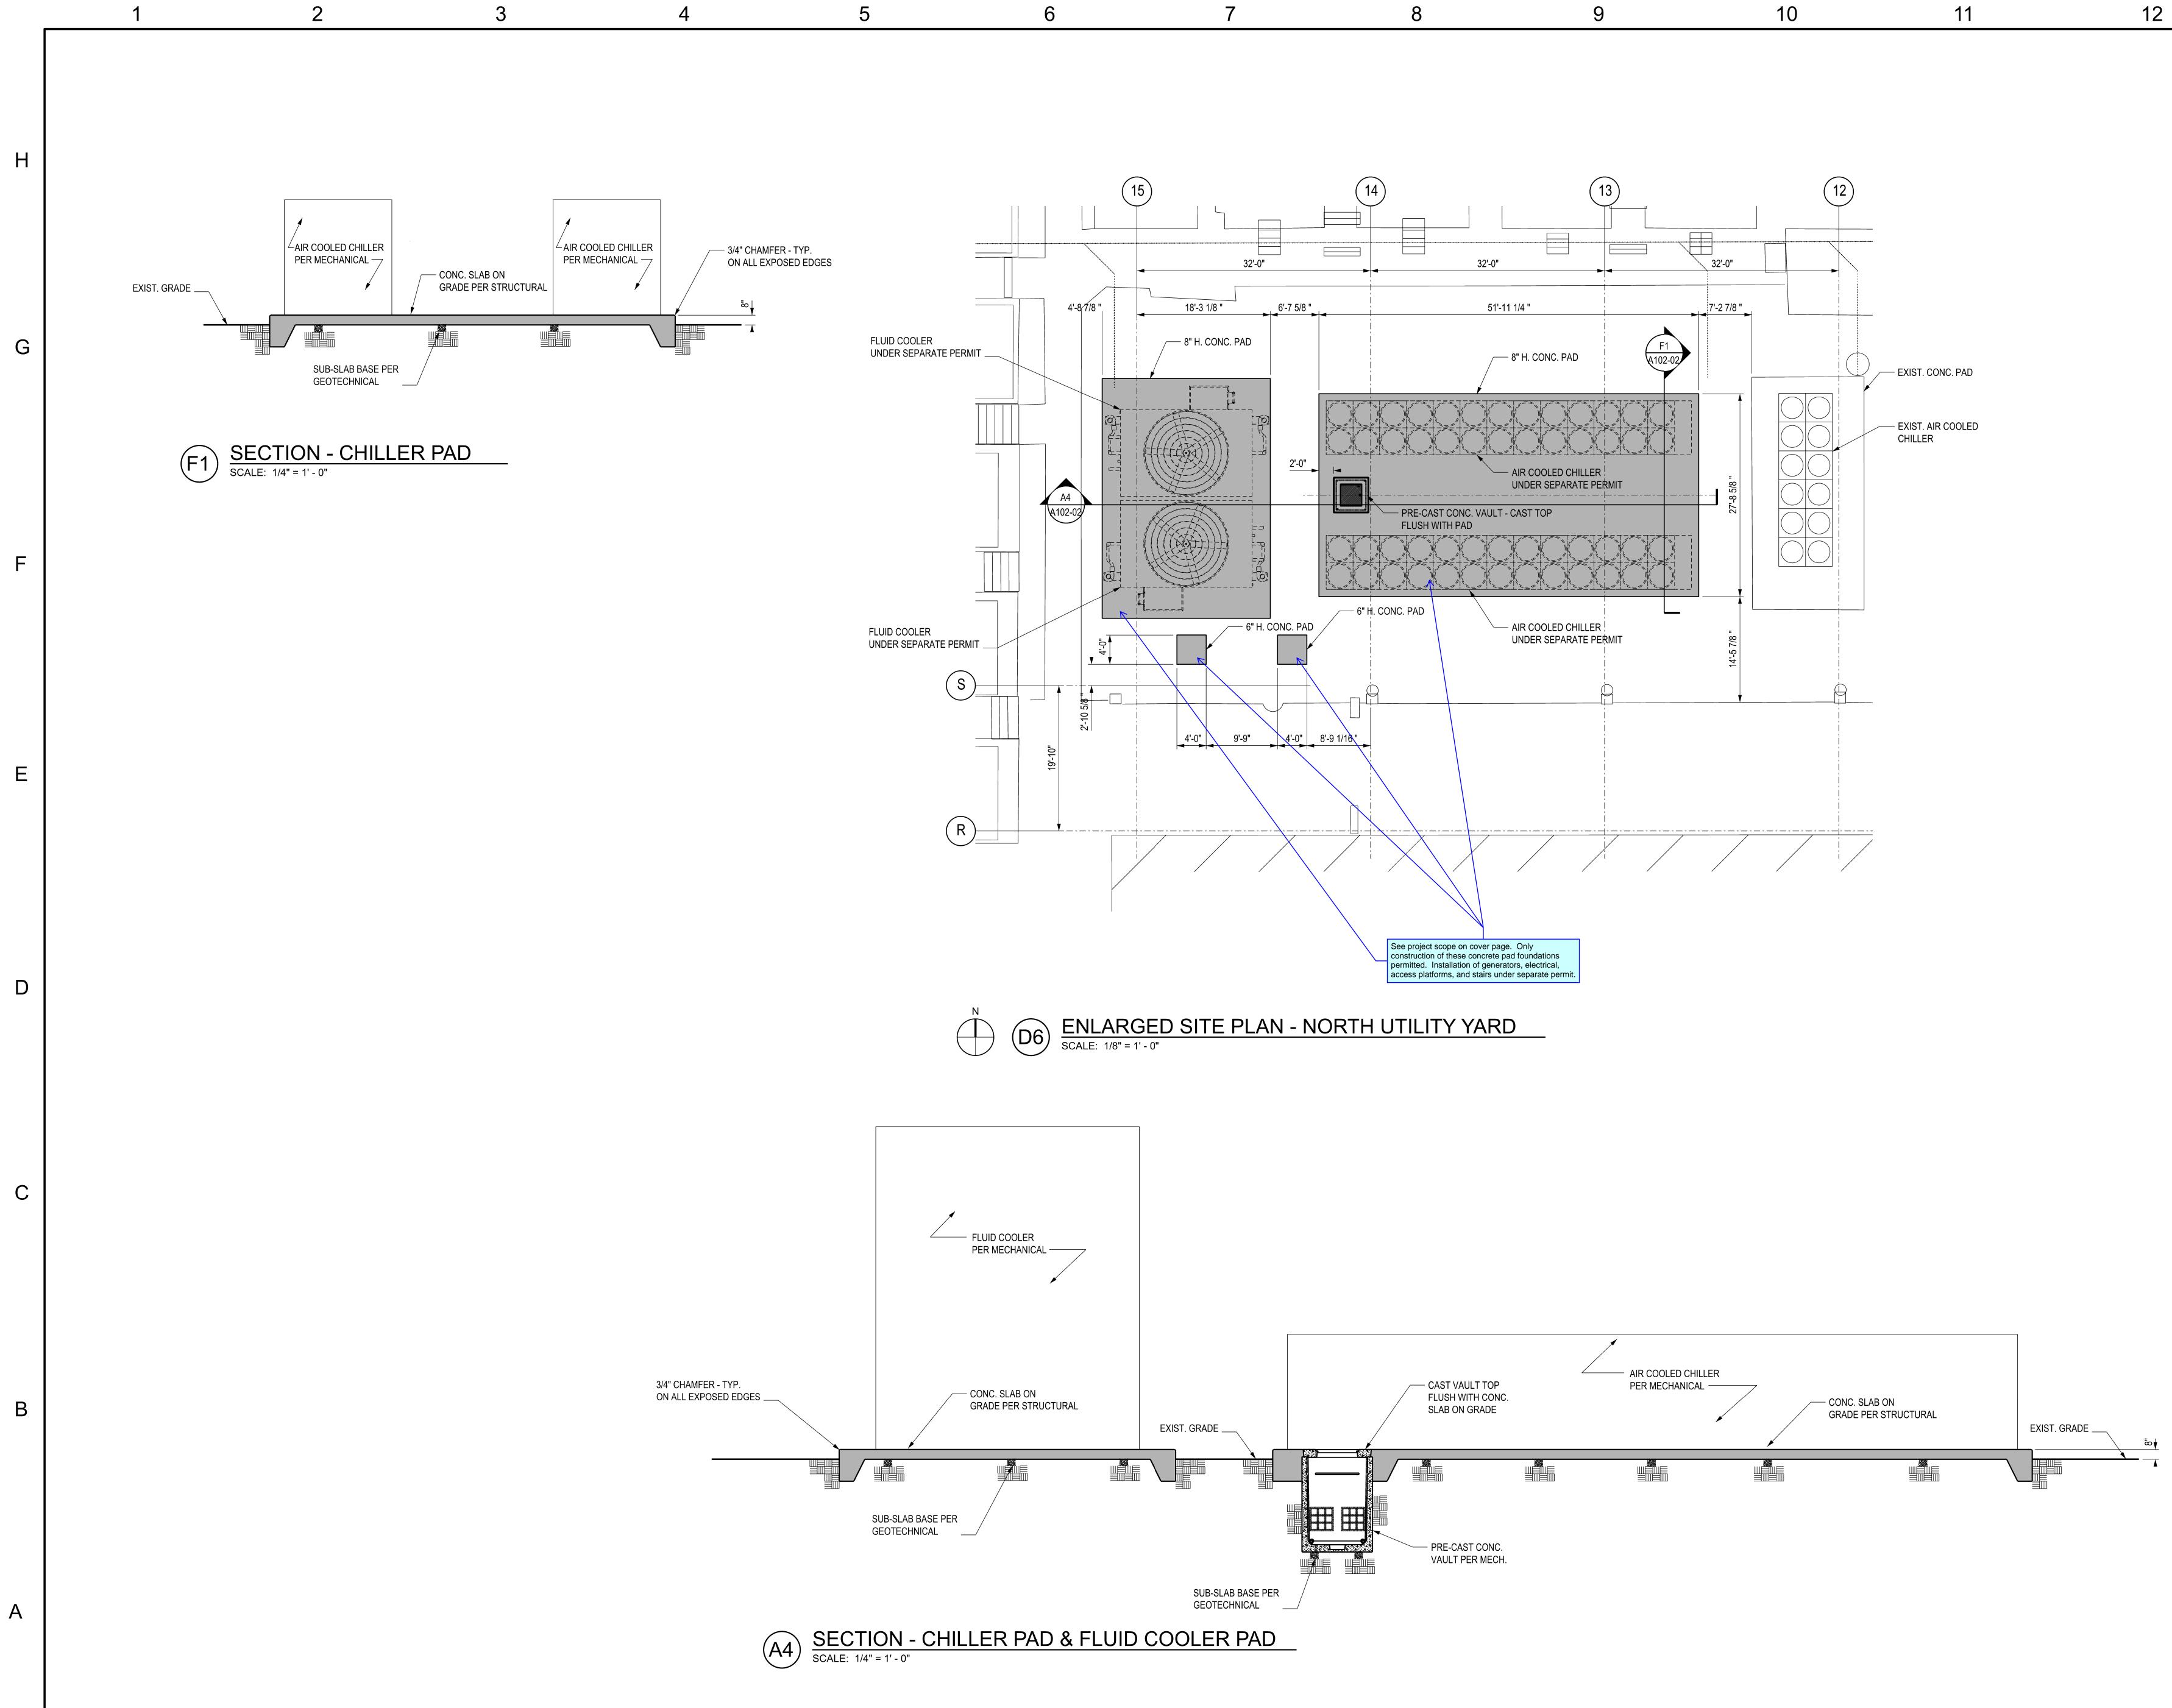
Traffic

Building

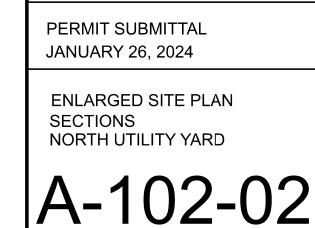
Engineering

Fire





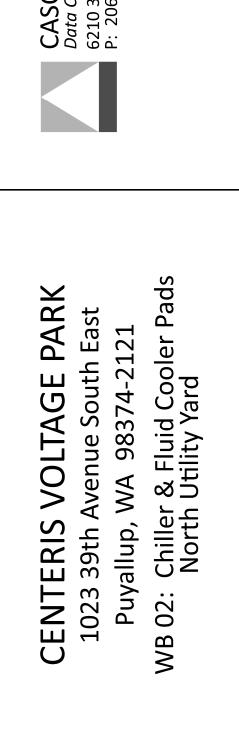




ISSUED/REVISED

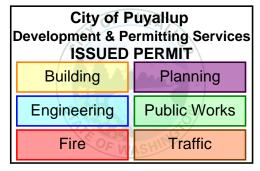
PERMIT SUBMITTAL 1/26/24

DATE



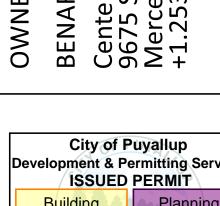








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ENAROYA CAPITAL, LLC	enteris Data Centers 675 SE 36th St, Suite 115 1ercer Island, WA 98040
ENA	ente 675 1erc