

Building Code Summary

APPLICABLE CODES

2018 INTERNATIONAL EXISTING BUILDING CODE-

CHAPTER 6 CLASSIFICATION OF WORK SECTION 604.1 LEVEL 3 ALTERATIONS APPLY WHERE THE WORK AREA EXCEEDS 50 PERCENT OF THE BUILDING AREA. SECTION 604.2 LEVEL 3 ALTERATIONS SHALL COMPLY WITH THE PROVISIONS OF CHAPTER 7 & 8 FOR LEVEL 1 AND LEVEL 2 ALTERATIONS, RESPECTIVELY, AS WELL AS THE PROVISIONS OF CHAPTER 9.

CHAPTER 8 ALTERATIONS LEVEL 2

SECTION 801.3 NEW CONSTRUCTION ELEMENTS, COMPONENTS, SYSTEMS, AND SPACES SHALL COMPLY WITH THE REQUIREMENTS OF THE INTERNATIONAL BUILDING CODE EXCEPTION

4. THE MINIMUM CEILING HEIGHT OF THE NEWLY CREATED HABITABLE AND OCCUPIABLE SPACES AND CORRIDORS SHALL BE 7 FEET.

2018 INTERNATIONAL BUILDING CODE

CHAPTER 9 ALTERATIONS LEVEL 3 SECTION 901.2 IN ADDITION TO THE PROVISIONS OF THIS CHAPTER. WORK SHALL COMPLY WITH ALL THE

REQUIREMENTS OF CHAPTERS 7 & 8. THE REQUIREMENTS OF SECTION 802, 803, 804, AND 805 SHALL APPLY WITHIN ALL WORK AREAS WHETHER OR NOT THEY INCLUDE EXITS AND CORRIDORS SHARED BY MORE THAN ONE TENANT AND REGARDLESS OF OCCUPANT LOAD.

CHAPTER 3 USE AND OCCUPANCY SECTION 303.1.2: SMALL ASSEMBLY SPACES.

1. A ROOM OR SPACE USED FOR ASSEMBLY PURPOSES WITH AN OCCUPANT LOAD OF LESS THAN 50 PERSONS AND ACCESSORY TO ANOTHER OCCUPANCY SHALL BE CLASSIFIED AS GROUP B OCCUPANCY OR AS PART OF THAT OCCUPANCY.

2. A ROOM OR SPACE USED OFR ASSEMBLY PURPOSES THAT IS LESS THAN 750 SF IN AREA AND ACCESSORY TO ANOTHER OCCUPANCY SHALL BE CLASSIFIED AS GROUP B OCCUPANCY OR AS PART OF THAT OCCUPANCY.

SECTION 304.1 BUSINESS GROUP B (CLINIC, OUTPATIENT, ADMIN AREAS)

CHAPTER 6 TYPE OF CONSTRUCTION

SECTION 602 TYPE VB FULLY SPRINKLERED TABLE 602 IF STRUCTURES ARE WITHIN 10 FEET, 1-HR EXTERIOR WALL CONSTRUCTION REQUIRED.

CHAPTER 7 FIRE AND SMOKE PROTECTION

SECTION 705.8.1 ALLOWABLE AREA OF OPENINGS EXCEPTION 2: BUILDINGS WHOSE EXTERIOR BEARING WALLS, EXTERIOR NON-BEARING WALLS AND EXTERIOR PRIMARY STRUCTURAL FRAME ARE NOT REQUIRED TO BE FIRE-RESISTANCE RATED SHALL BE PERMITTED TO HAVE UNLIMITED UNPROTECTED OPENINGS.

SECTION 712 VERTICAL OPENINGS

SECTION 712.1.6 DUCTS PENETRATING FLOOR LINES TO BE PROTECTED PER 717.6.3 SECTION 712.1.9 TWO STORY OPENINGS PERMITTED FOR USES NOT LISTED IN THIS SECTION

SECTION 712.1.12 EXIT ACCESS STAIRWAYS AND RAMPS IN ACCORDANCE WITH 1019 ARE PERMITTED

SECTION 718 CONCEALED SPACES

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SECTION 718.4.3 ATTIC DRAFT STOPPING EXCEPTION: DRAFT STOPPING IS NOT REQUIRED IN BUILDINGS EQUIPPED THROUGHOUT WITH AN AUTOMATIC SPRINKLER SYSTEM IN ACCORDANCE WITH SECTION 903.3.1.1

150 GROSS

CHAPTER 10 MEANS OF EGRESS

ECTION 1004 OCCUPANT LOAD	
ABLE 1004.1.2 MAXIMUM FLOOR AREA ALLOWANCES PER OC	CUPANT:
ACCESSORY STORAGE, MECH, EQUIP:	300 GROSS
ASSEMBLY - CONCENTRATED (CHAIRS ONLY)	7 NET
ASSEMBLY- UNCONCENTRATED (TABLES AND CHAIRS):	15 NET

BUSINESS AREAS:

SECTION 1005 MEANS OF EGRESS SIZING

SECTION 1005.3.1 STAIRWAYS. 0.2" WIDTH PER OCCUPANT WHEN SPRINKLERED; 0.3" IF NONSPRINKLERED. SECTION 1005.3.2 OTHER EGRESS COMPONENTS. 0.15" WIDTH PER OCCUPANT WHEN SPRINKLERED; 0.2" IF

NONSPRINKLERED.

SECTION 1005.7.1 ENCROACHMENT. DOORS SHALL NOT REDUCE REQUIRED WIDTH BY MORE THAN 7" WHEN FULLY OPEN OR BY MORE THAN HALF IN ANY POSITION.

SECTION 1006 NUMBER OF EXITS AND EXIT ACCESS DOORWAYS

TABLE 1006.2.1 SPACES WITH ONE EXIT OR EXIT ACCESS DOORWAY: GROUP A: 49 OCC. MAX: 75' MAX COMMON PATH OF TRAVEL

GROUP B: 49 OCC. MAX; 100' MAX COMMON PATH OF TRAVEL IF SPRINKLERED OR OL < 30;

75' MAX COMMON PATH OF TRAVEL IF NONSPRINKLERED OR OL > 30 SECTION1006.3.1 EGRESS BASED ON OCCUPANT LOAD: TABLE 1006.3.1: 1-500 OCCUPANTS PER STORY = MINIMUM 2 EXITS OR ACCESS TO EXITS FROM STORY

SECTION 1007 EXIT AND EXIT ACCESS DOORWAY CONFIGURATION SECTION 1007.1.1 TWO EXITS OR EXIT ACCESS DOORWAYS. TWO REQUIRED EXITS SHALL BE PLACED NOT LESS THAN 1/2 THE OVERALL DIAGONAL DIMENSION.

EXCEPTION 2. WHERE A BUILDING IS EQUIPPED THROUGHOUT WITH AN AUTOMATIC SPRINKLER SYSTEM THE SEPARATION DISTANCE SHALL NOT BE LESS THAN 1/3 THE LENGTH OF THE MAXIMUM OVERALL DIAGONAL DIMENSION OF THE AREA SERVED.

SECTION 1009 ACCESSIBLE MEANS OF EGRESS

SECTION 1009.1 ACCESSIBLE SPACES SHALL BE PROVIDED WITH NOT LESS THAN ONE ACCESSIBLE MEANS OF EGRESS. WHERE MORE THAN ONE MEANS OF EGRESS IS REQUIRED BY SECTION 1006.2 OR 1006.3 FROM ANY ACCESSIBLE SPACE, EACH ACCESSIBLE PORTION OF THE SPACE SHALL BE SERVED BY NOT LESS THAN TWO ACCESSIBLE MEANS OF EGRESS. SECTION 1009.6 AREAS OF REFUGE (NOT REQUIRED REF. STAIRWAY & ELEVATOR EXCEPTIONS FOR SPRINKLERED

BUILDINGS) SECTION 1009.8 TWO-WAY COMMUNICATION: MUST BE PROVIDED AT EACH ELEVATOR LANDING THAT IS ONE OR MORE STORIES ABOVE OR BELOW THE LEVEL OF EXIT DISCHARGE.

SECTION 1011 STAIRWAYS

SECTION 1011.2 WIDTH AND CAPACITY THE REQUIRED CAPACITY OF STAIRWAYS SHALL BE DETERMINED AS SPECIFIED IN SECTION 1005.1, BUT THE MINIMUM WIDTH SHALL BE NOT LESS THAN 44 INCHES. SEE SECTION 1009.3 FOR MEANS OF EGRESS STAIRWAYS EXCEPTION 1. STAIRWAYS SERVING AN OCCUPANT LOAD OF LESS THAN 50 SHALL HAVE A WIDTH OF NOT LESS THAN 36 INCHES.

SECTION 1011.5 STAIR TREADS AND RISERS

SECTION 1011.5.2 STAIR RISER HEIGHTS SHALL BE 7 INCHES MAXIMUM AND 4 INCHES MINIMUM...RECTANGULAR TREAD DEPTHS SHALL BE 11 INCHES MINIMUM...

SECTION 1011.5.4 DIMENSIONAL UNIFORMITY

STAIR TREADS AND RISERS SHALL BE OF UNIFORM SIZE AND SHAPE. THE TOLERANCE BETWEEN THE LARGEST AND SMALLEST RISER HEIGHT OR BETWEEN THE LARGEST AND SMALLEST TREAD DEPTH SHALL BE 3/8 INCH IN ANY FLIGHT OF STAIRS.

SECTION 1011.6 STAIRWAY LANDINGS

THERE SHALL BE A LANDING AT THE TOP AND BOTTOM OF EACH STAIRWAY. THE WIDTH OF THE LANDINGS SHALL NOT BE LESS THAN THE WIDTH OF THE STAIRWAYS SERVED. EVERY LANDING SHALL HAVE A MINIMUM WIDTH MEASURED PERPENDICULAR TO THE DIRECTION OF TRAVEL EQUAL TO THE WIDTH OF THE STAIRWAY.

SECTION 1016 EXIT ACCESS

SECTION 1016.2 EGRESS THROUGH INTERVENING SPACES. INTERVENING ROOMS MUST BE ACCESSORY TO AN AREA, NOT A HIGH HAZARD OCCUPANCY, WITH A DISCERNABLE PATH OF EGRESS TRAVEL TO AN EXIT.

SECTION 1017 EXIT ACCESS TRAVEL DISTANCE

TABLE 1017.2 EXIT ACCESS TRAVEL DISTANCE: GROUP B: 200' MAX (NONSPRINKLERED); 300; MAX (SPRINKLERED)

SECTION 1017.3.1 MEASUREMENT. TRAVEL DISTANCE ON EXIT ACCESS STAIRWAYS OR RAMPS SHALL BE INCLUDED IN THE EXIT ACCESS TRAVEL DISTANCE MEASUREMENT.

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SECTION 1019 EXIT ACCESS STAIRWAYS AND RAMPS

SECTION 1019.3 EXCEPTION 1: ENCLOSURE NOT REQUIRED IF CONNECTING ONLY TWO STORIES, OTHERWISE PROTECTED PER 713.

SECTION 1020 CORRIDORS

TABLE 1020.1 CORRIDOR FIRE-RESISTANCE RATING: GROUP B: NOT RATED IF SPRINKLERED OR 30 OR FEWER OCCUPANTS;

OTHERWISE 1 HR REQUIRED TABLE 1020.2 MINIMUM CORRIDOR WIDTH = 44" MIN

1020.4 CORRIDOR DEAD ENDS. 25' MAX.

EXCEPTION 2: GROUP B OCCUPANCIES W/ SPRINKLER ALLOWS 50' MAX.; EXCEPTION 3: NOT LIMITED IF LENGTH < 2.5 TIMES LEAST WIDTH

CHAPTER 11 ACCESSIBILITY

CHAPTER 29 PLUMBING FIXTURES

SECTION 2902 MINIMUM PLUMBING FACILITIES TABLE 2902.1 MINIMUM NUMBER OF REQUIRED PLUMBING FIXTURES



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CHC Puyallup -

Puyallup, WA 98371

Cannery

201 W. Main


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Seattle, Washington 98103




CONSULTANT

CONSULTANT'S STAMP

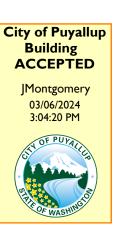

BUILDING DEPARTMENT'S STAMP

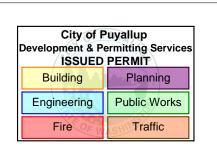

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DATE

05/22/23

REVISIONS


No.	Description	Date
1	PERMIT CORRECTIONS #1	12/29/22
3	GMP ADDENDUM 1	2/24/23
28	PERMIT REVISION #1	1/25/24

SHEET TITLE



SHEET NO.



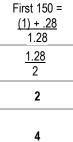


DRINKING

FOUNTAINS

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Building Code Summary APPLICABLE CODES 2018 INTERNATIONAL EXISTING BUILDING CODE-CHC Puyallup -CHAPTER 6 CLASSIFICATION OF WORK SECTION 604.1 LEVEL 3 ALTERATIONS APPLY WHERE THE WORK AREA EXCEEDS 50 PERCENT OF THE BUILDING AREA. Cannery SECTION 604.2 LEVEL 3 ALTERATIONS SHALL COMPLY WITH THE PROVISIONS OF CHAPTER 7 & 8 FOR LEVEL 1 AND LEVEL 2 ALTERATIONS, RESPECTIVELY, AS WELL AS THE PROVISIONS OF CHAPTER 9. 201 W. Main **CHAPTER 8 ALTERATIONS LEVEL 2** Puyallup, WA 98371 SECTION 801.3 NEW CONSTRUCTION ELEMENTS, COMPONENTS, SYSTEMS, AND SPACES SHALL COMPLY WITH THE REQUIREMENTS OF THE INTERNATIONAL BUILDING CODE EXCEPTION 4. THE MINIMUM CEILING HEIGHT OF THE NEWLY CREATED HABITABLE AND OCCUPIABLE SPACES AND CORRIDORS Miller HayashiArchitects SHALL BE 7 FEET. 118 North 35th St. Suite 200 2018 INTERNATIONAL BUILDING CODE Seattle, Washington 98103 Tel: 206 634 0177 **CHAPTER 9 ALTERATIONS LEVEL 3** Fax: 206 634 0167 SECTION 901.2 IN ADDITION TO THE PROVISIONS OF THIS CHAPTER, WORK SHALL COMPLY WITH ALL THE REQUIREMENTS OF CHAPTERS 7 & 8. THE REQUIREMENTS OF SECTION 802, 803, 804, AND 805 SHALL APPLY WITHIN ALL WORK AREAS WHETHER OR NOT THEY INCLUDE EXITS AND CORRIDORS SHARED BY MORE THAN ONE TENANT AND REGARDLESS OF OCCUPANT LOAD. ARCHITECT'S STAMP CHAPTER 3 USE AND OCCUPANCY SECTION 303.1.2: SMALL ASSEMBLY SPACES. 1. A ROOM OR SPACE USED FOR ASSEMBLY PURPOSES WITH AN OCCUPANT LOAD OF LESS THAN 50 PERSONS AND ACCESSORY TO ANOTHER OCCUPANCY SHALL BE CLASSIFIED AS GROUP B OCCUPANCY OR AS PART OF THAT OCCUPANCY. 2. A ROOM OR SPACE USED OFR ASSEMBLY PURPOSES THAT IS LESS THAN 750 SF IN AREA AND ACCESSORY TO ANOTHER OCCUPANCY SHALL BE CLASSIFIED AS GROUP B OCCUPANCY OR AS PART OF THAT OCCUPANCY. SECTION 304.1 BUSINESS GROUP B (CLINIC, OUTPATIENT, ADMIN AREAS) **CHAPTER 6 TYPE OF CONSTRUCTION** SECTION 602 TYPE VB FULLY SPRINKLERED TABLE 602 IF STRUCTURES ARE WITHIN 10 FEET, 1-HR EXTERIOR WALL CONSTRUCTION REQUIRED. CONSULTANT CHAPTER 7 FIRE AND SMOKE PROTECTION SECTION 705.8.1 ALLOWABLE AREA OF OPENINGS EXCEPTION 2: BUILDINGS WHOSE EXTERIOR BEARING WALLS, EXTERIOR NON-BEARING WALLS AND EXTERIOR PRIMARY STRUCTURAL FRAME ARE NOT REQUIRED TO BE FIRE-RESISTANCE RATED SHALL BE PERMITTED TO HAVE UNLIMITED UNPROTECTED OPENINGS. 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SECTION 1005.3.2 OTHER EGRESS COMPONENTS. 0.15" WIDTH PER OCCUPANT WHEN SPRINKLERED; 0.2" IF NONSPRINKLERED. SECTION 1005.7.1 ENCROACHMENT. DOORS SHALL NOT REDUCE REQUIRED WIDTH BY MORE THAN 7" WHEN FULLY OPEN OR BY MORE THAN HALF IN ANY POSITION. SECTION 1006 NUMBER OF EXITS AND EXIT ACCESS DOORWAYS TABLE 1006.2.1 SPACES WITH ONE EXIT OR EXIT ACCESS DOORWAY: GROUP A: 49 OCC. MAX; 75' MAX COMMON PATH OF TRAVEL GROUP B: 49 OCC. MAX; 100' MAX COMMON PATH OF TRAVEL IF SPRINKLERED OR OL < 30; BUILDING DEPARTMENT'S STAMP 75' MAX COMMON PATH OF TRAVEL IF NONSPRINKLERED OR OL > 30 SECTION1006.3.1 EGRESS BASED ON OCCUPANT LOAD: TABLE 1006.3.1: 1-500 OCCUPANTS PER STORY = MINIMUM 2 EXITS OR ACCESS TO EXITS FROM STORY City of Puyallup Development & Permitting Services SECTION 1007 EXIT AND EXIT ACCESS DOORWAY CONFIGURATION ISSUED PERMIT SECTION 1007.1.1 TWO EXITS OR EXIT ACCESS DOORWAYS. TWO REQUIRED EXITS SHALL BE PLACED NOT LESS THAN Building Planning 1/2 THE OVERALL DIAGONAL DIMENSION. EXCEPTION 2. WHERE A BUILDING IS EQUIPPED THROUGHOUT WITH AN AUTOMATIC SPRINKLER SYSTEM THE Engineering Public Works SEPARATION DISTANCE SHALL NOT BE LESS THAN 1/3 THE LENGTH OF THE MAXIMUM OVERALL DIAGONAL DIMENSION Fire Traffic OF THE AREA SERVED. SECTION 1009 ACCESSIBLE MEANS OF EGRESS SECTION 1009.1 ACCESSIBLE SPACES SHALL BE PROVIDED WITH NOT LESS THAN ONE ACCESSIBLE MEANS OF EGRESS. WHERE MORE THAN ONE MEANS OF EGRESS IS REQUIRED BY SECTION 1006.2 OR 1006.3 FROM ANY ACCESSIBLE SPACE, EACH ACCESSIBLE PORTION OF THE SPACE SHALL BE SERVED BY NOT LESS THAN TWO ACCESSIBLE MEANS OF EGRESS. SECTION 1009.6 AREAS OF REFUGE (NOT REQUIRED REF. STAIRWAY & ELEVATOR EXCEPTIONS FOR SPRINKLERED PHASE BUILDINGS) SECTION 1009.8 TWO-WAY COMMUNICATION: MUST BE PROVIDED AT EACH ELEVATOR LANDING THAT IS ONE OR MORE **IFC Set** STORIES ABOVE OR BELOW THE LEVEL OF EXIT DISCHARGE. 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THE WIDTH OF THE LANDINGS SHALL NOT Date Descriptio BE LESS THAN THE WIDTH OF THE STAIRWAYS SERVED. EVERY LANDING SHALL HAVE A MINIMUM WIDTH MEASURED PERMIT CORRECTIONS #1 12/29/22 PERPENDICULAR TO THE DIRECTION OF TRAVEL EQUAL TO THE WIDTH OF THE STAIRWAY. GMP ADDENDUM 1 2/24/23 28 PERMIT REVISION #1 SECTION 1016 EXIT ACCESS 1/25/24 SECTION 1016.2 EGRESS THROUGH INTERVENING SPACES. INTERVENING ROOMS MUST BE ACCESSORY TO AN AREA, NOT A HIGH HAZARD OCCUPANCY, WITH A DISCERNABLE PATH OF EGRESS TRAVEL TO AN EXIT. SECTION 1017 EXIT ACCESS TRAVEL DISTANCE TABLE 1017.2 EXIT ACCESS TRAVEL DISTANCE: GROUP B: 200' MAX (NONSPRINKLERED); 300; MAX (SPRINKLERED) SECTION 1017.3.1 MEASUREMENT. TRAVEL DISTANCE ON EXIT ACCESS STAIRWAYS OR RAMPS SHALL BE INCLUDED IN THE EXIT ACCESS TRAVEL DISTANCE MEASUREMENT. SECTION 1019 EXIT ACCESS STAIRWAYS AND RAMPS SECTION 1019.3 EXCEPTION 1: ENCLOSURE NOT REQUIRED IF CONNECTING ONLY TWO STORIES, OTHERWISE SHEET TITLE PROTECTED PER 713. **CODE PLAN** SECTION 1020 CORRIDORS DRINKING TABLE 1020.1 CORRIDOR FIRE-RESISTANCE RATING: LEVEL 2 FOUNTAINS GROUP B: NOT RATED IF SPRINKLERED OR 30 OR FEWER OCCUPANTS; OTHERWISE 1 HR REQUIRED TABLE 1020.2 MINIMUM CORRIDOR WIDTH = 44" MIN 1 PER 150. 1

1020.4 CORRIDOR DEAD ENDS. 25' MAX. EXCEPTION 2: GROUP B OCCUPANCIES W/ SPRINKLER ALLOWS 50' MAX.; EXCEPTION 3: NOT LIMITED IF LENGTH < 2.5 TIMES LEAST WIDTH

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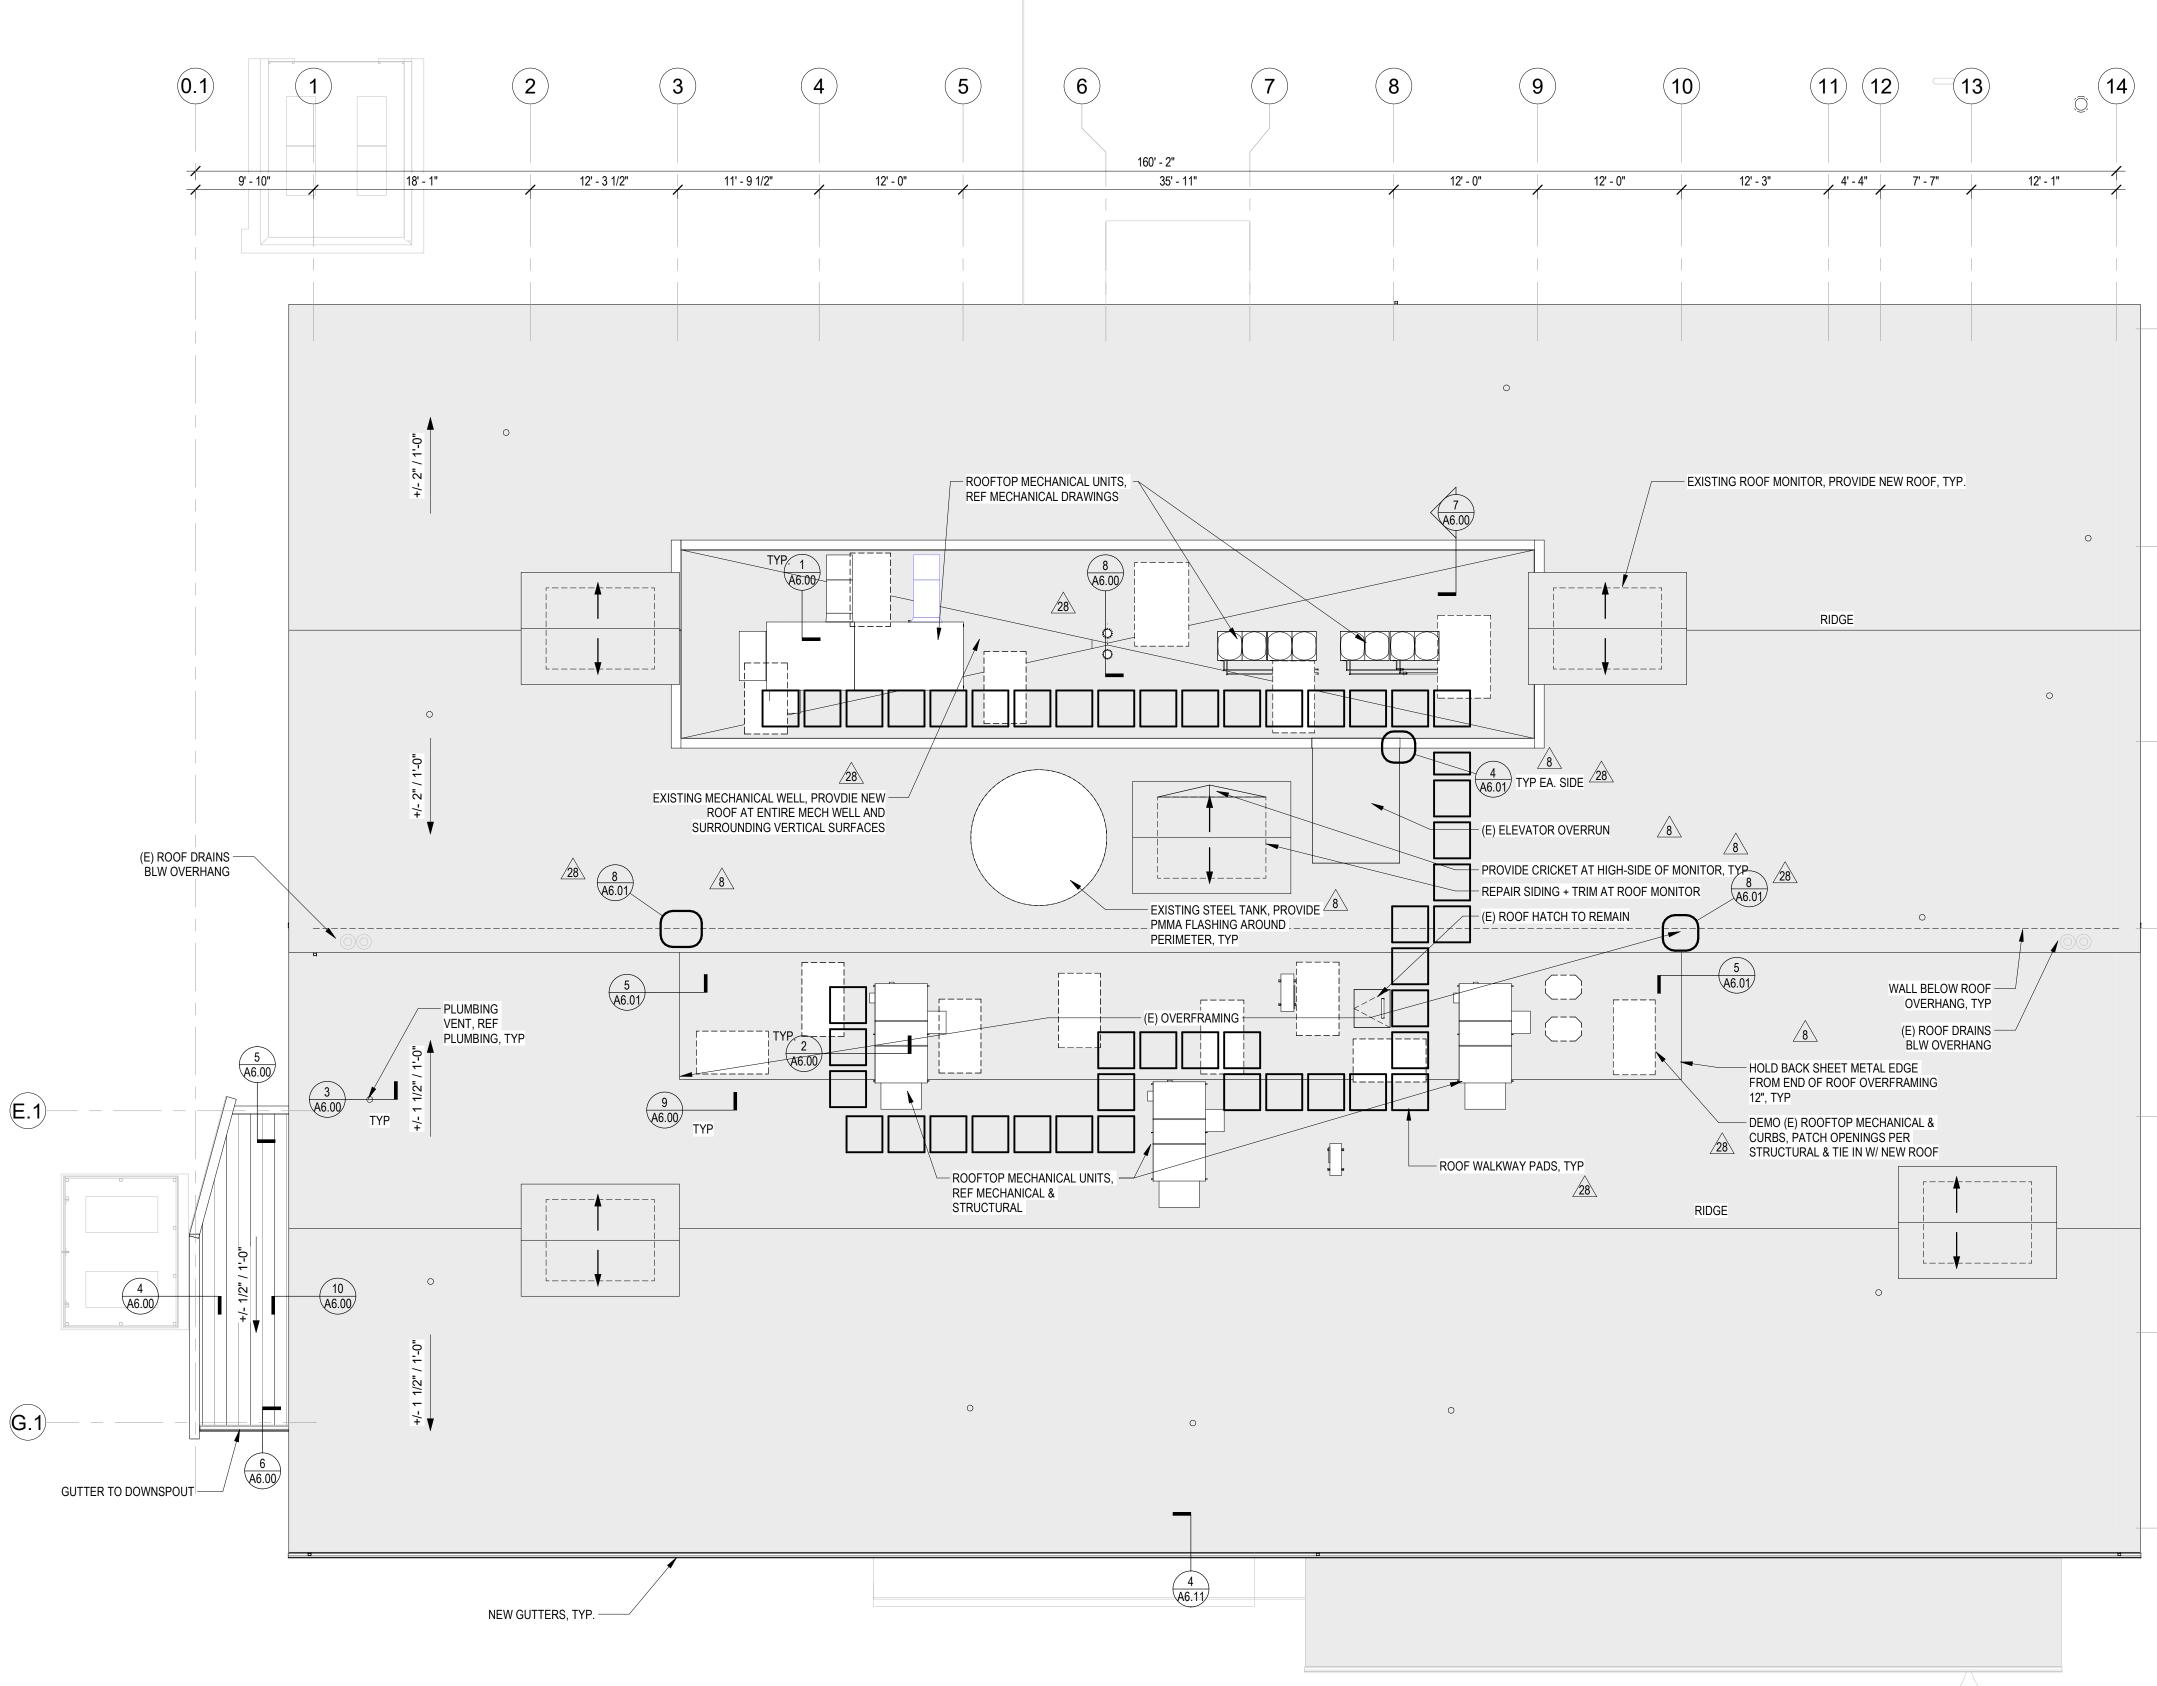
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CHAPTER 11 ACCESSIBILITY

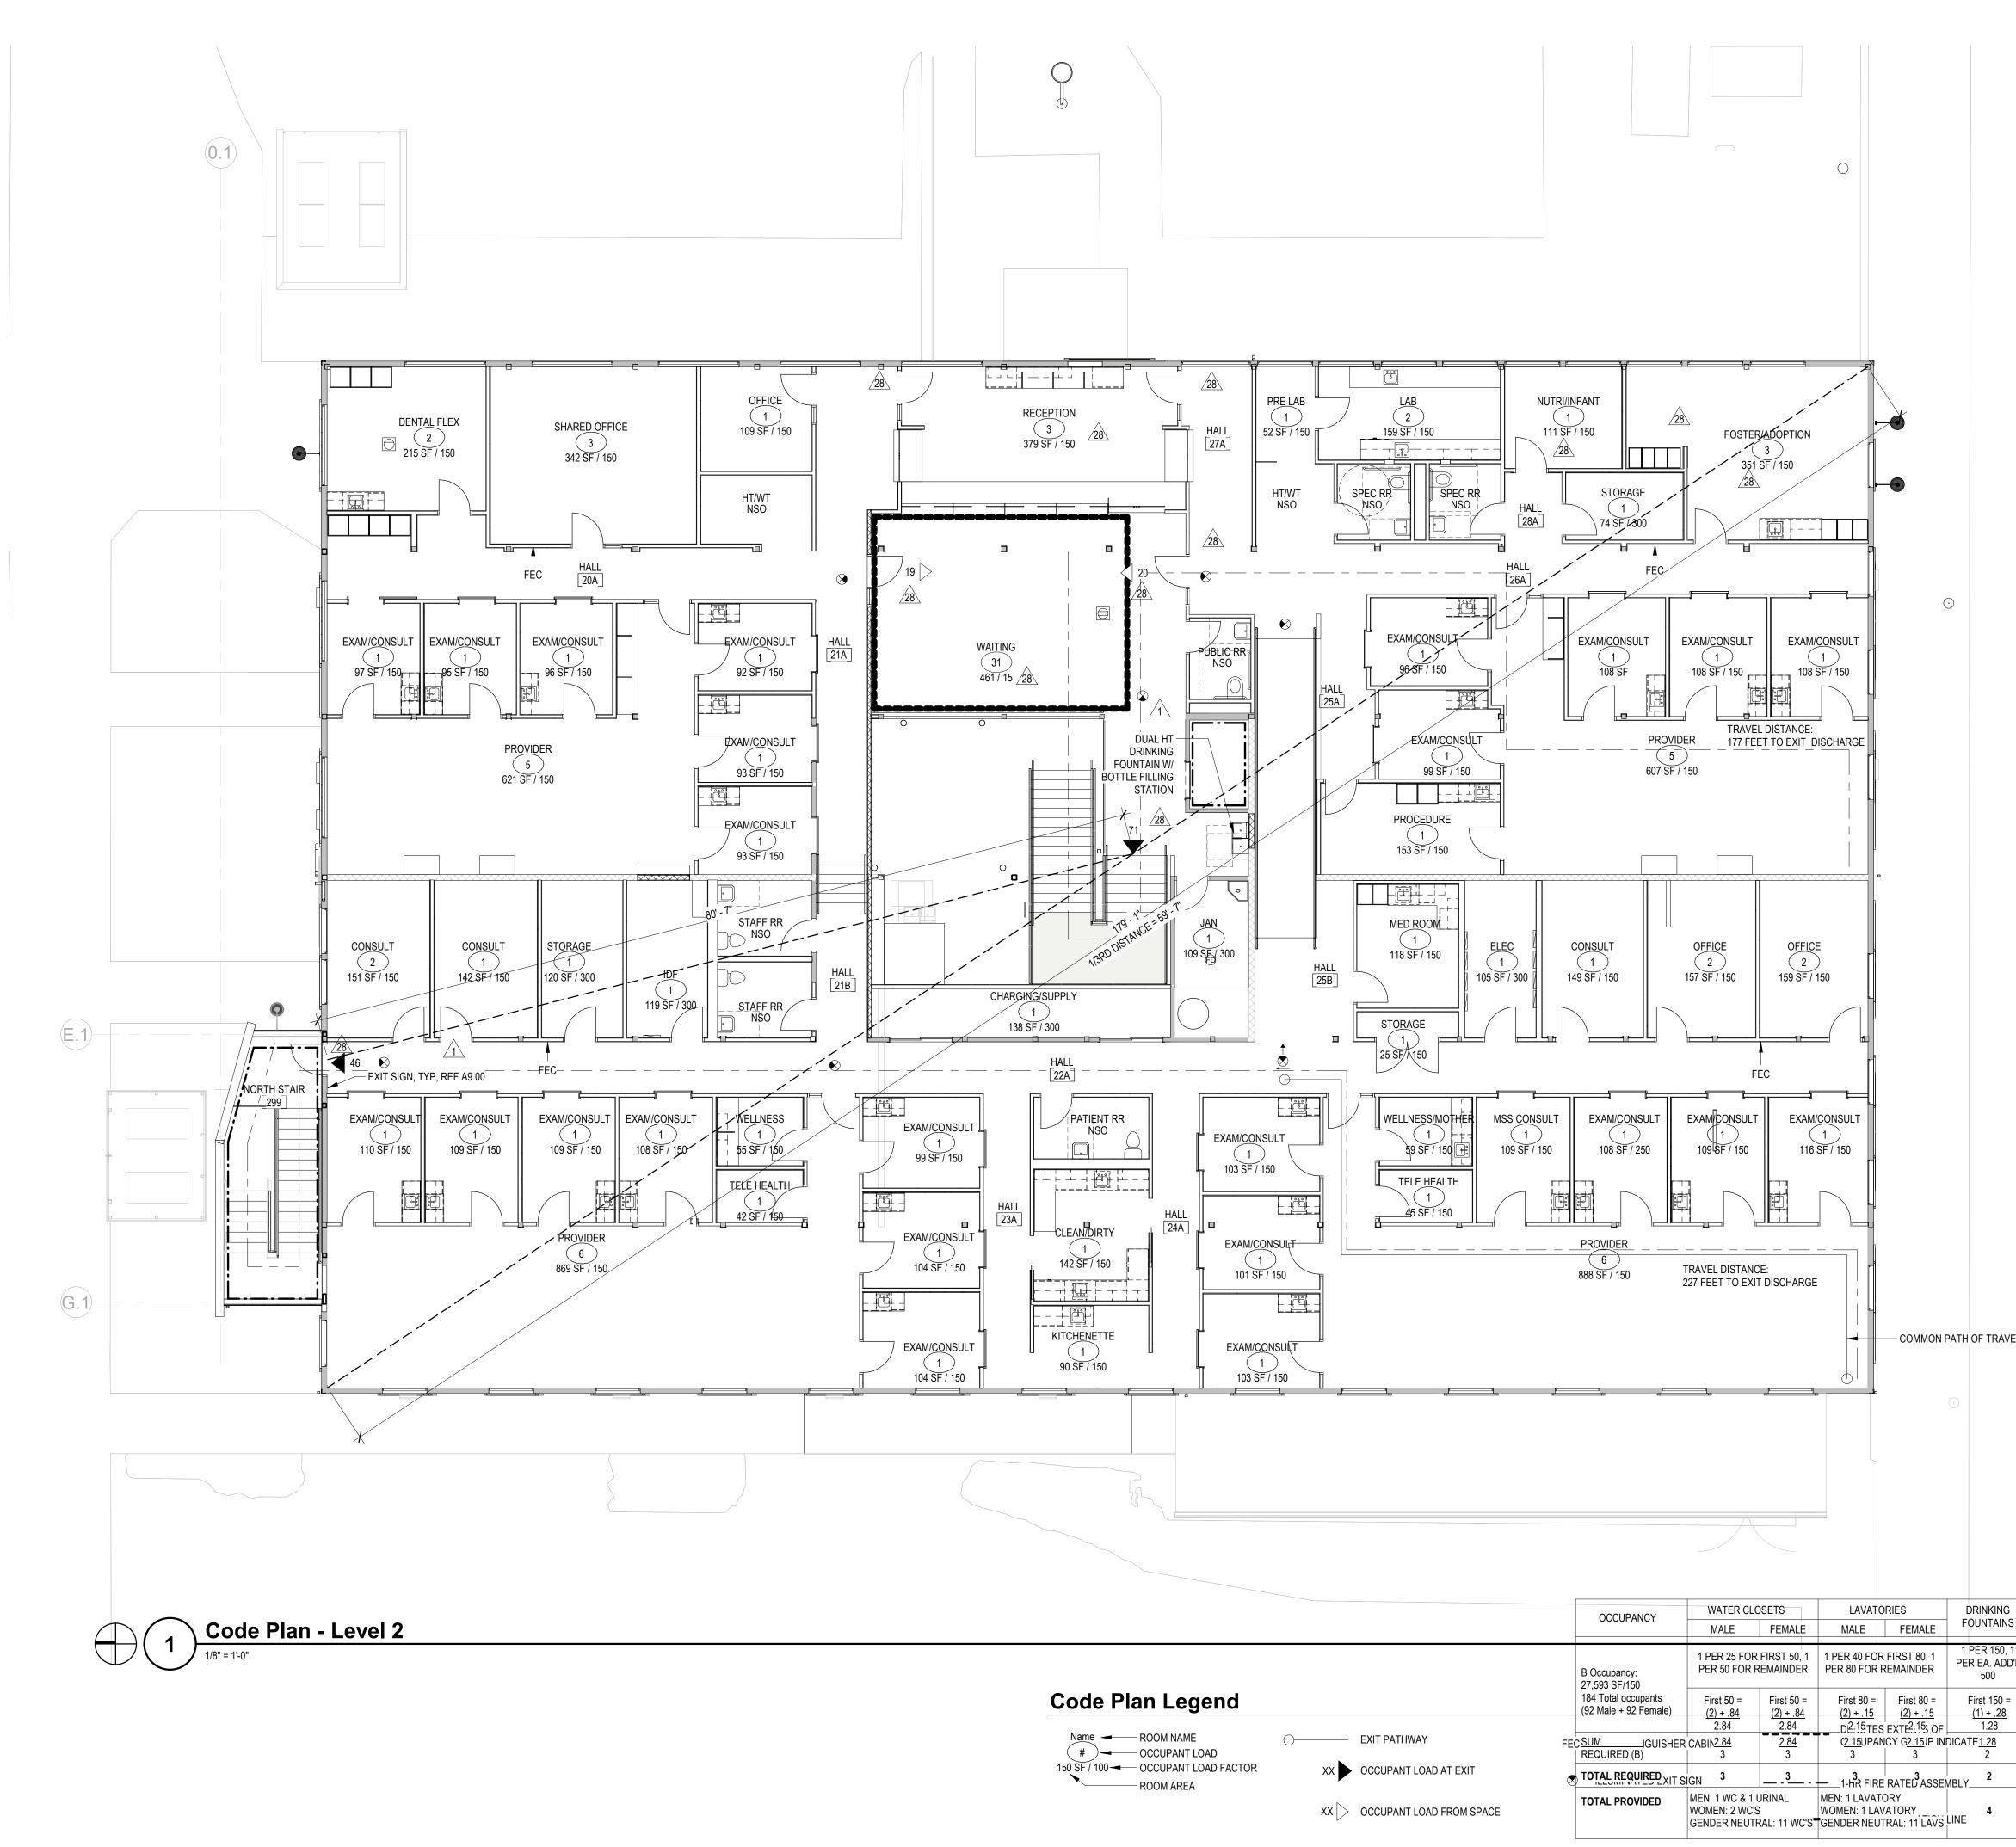CHAPTER 29 PLUMBING FIXTURES SECTION 2902 MINIMUM PLUMBING FACILITIES TABLE 2902.1 MINIMUM NUMBER OF REQUIRED PLUMBING FIXTURES:





Roof Plan 1/8" = 1'-0"

CHC Puyallup -

Puyallup, WA 98371

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ARCHITECT'S STAMP

CONSULTANT

CONSULTANT'S STAMP

Tel: 206 634 0177

Fax: 206 634 0167

Roof Plan General Notes

- REFER TO GENERAL NOTES ON <u>AA1.00</u>.
 REFER TO A4 AND A6 SERIES SHEETS FOR ROOF DECK EDGE
- DIMENSIONS FROM GRIDLINE.
- 3. REFER TO A6 SERIES SHEETS FOR ROOF DETAILS.
- 4. PROTECT EXISTING ROOF TO REMAIN DURING CONSTRUCTION. MAINTAIN EXISTING WARRANTIES. 5. ALL ROOF CONSTRUCTION SHALL PROVIDE POSITIVE SLOPE TO DRAIN IN CONFORMANCE WITH NRCA PUBLISHED RECOMMENDATIONS, MINIMUM OF 1/4" PER FOOT SLOPE, TYPICAL. PROVIDE FIBERGLASS-FACED POLYISOCYANURATE RIGID INSULATION AND TAPERED POLYISOCYANURATE PANELS AT
- CRICKETS AS INDICATED. 6. REFER TO STRUCTURAL, MECHANICAL, ELECTRICAL AND HAZARDOUS MATERIALS SHEETS AND COORDINATE THE WORK .
- 7. ALL ROOF PENETRATIONS SHALL BE LOCATED AWAY FROM ROOF VALLEYS AND OTHER APPURTENANCES AS RECOMMENDED BY NRCA IN THEIR 4TH EDITION ROOFING AND WATERPROOFING MANUAL, AND AS NOTED IN NRCA'S CONSTRUCTION DETAILS
- SECTION OF MANUAL. 8. ALL ROOFS AND PENETRATIONS SHALL BE ROOFED AND FLASHED SO WEATHERPROOF AND WATERTIGHT, OVER MECHANIICALLY-ATTACHED THERMAL BARRIER BOARD, WITH PLIES FULLY ADHERED AND COURSES SEQUENCED IN A WATERSHEDDING MANNER TO DIRECT WATER TO DRAINS, GUTTERS, AND SCUPPERS
- AND PREVENT LEAKAGE. 9. CONTRACTOR SHALL SUBMIT SHOP DRAWINGS FOR REVIEW. SHOP DRAWINGS SHALL INCLUDE ROOF SYSTEM COMPONENTS AND ACCESSORIES INCLUDING ITEMS REQUIRED BUT NOT
- SPECIFICALLY DETAILED. 10. THE ROOF PLAN DRAWINGS ARE DIAGRAMMATIC, AND NOT ALL REQUIRED ROOF PENETRATIONS ARE ILLUSTRATED. REFER TO MECHANICAL AND ELECTRICAL DRAWINGS FOR ADDITIONAL EQUIPMENT AND PIPING PENETRATIONS. PROVIDE CURBS, FLASHINGS, CRICKETS, COLLARS, ETC PER ARCHITECTURAL DETAILS FOR ALL PENETRATIONS AND EQUIPMENT WHETHER SHOWN ON THE ROOF PLAN OR NOT.
- 11. EXTEND EXISTING PLUMBING VENT PIPING TO MINIMUM HEIGHT 8"
- ABOVE FINISHED ROOF. 12. ALL ROOF PATCH AREAS TO BE INSTALLED WEATHERPROOF AND
- WATERTIGHT, AND TO ENSURE PROPER DRAINAGE. 13. PRIOR TO PERFORMING ANY ROOFING WORK, CONTRACTOR SHALL TEST ALL DRAIN LINES AND NOTIFY OWNER OF ANY LINES THAT ARE PLUGGED OR PARTIALLY PLUGGED. ANY DRAIN LINES THAT ARE SLOW DRAINING OR PLUGGED FOLLOWING THE WORK SHALL
- BE CORRECTED AT THE CONTRACTOR'S EXPENSE. 14. REFER TO WALLS SECTIONS FOR TYPICAL ASSEMBLIES AND MINIMUM INSULATION REQUIREMENTS.

Roof Plan Legend

28

	TPO ROOF ASSEMBLY OVER METAL DECK, TYP REF R1 AT A4.00 TPO ROOF ASSEMBLY OVER EXISTING STRUCTURE, TYP REF R4 AT A4.00
$\bigcirc \bigcirc$	ROOF DRAIN AND OVERFLOW DRAIN IN SUMP, REF MECH PER DETAIL, TYP
DS	GUTTER DROP TO DOWNSPOUT, TYP REF DETAIL
< SK# >	SKYLIGHT, TYP REF A2.72 FOR SKYLIGHT TYPES
SSTL BOOT	WELDED SSTL FABRICATION AT PARAPET TRANSITIONS AT LOCATIONS INDICATED, REF DIAGRAMATTIC DETAIL AND FIELD VERIFY EACH CONDITION

City of Puyallup

BUILDING DEPARTMENT'S STAMP

Building	Planning
Engineering	Public Works
Fire OF W	Traffic

PHASE

IFC Set

DATE

05/22/23


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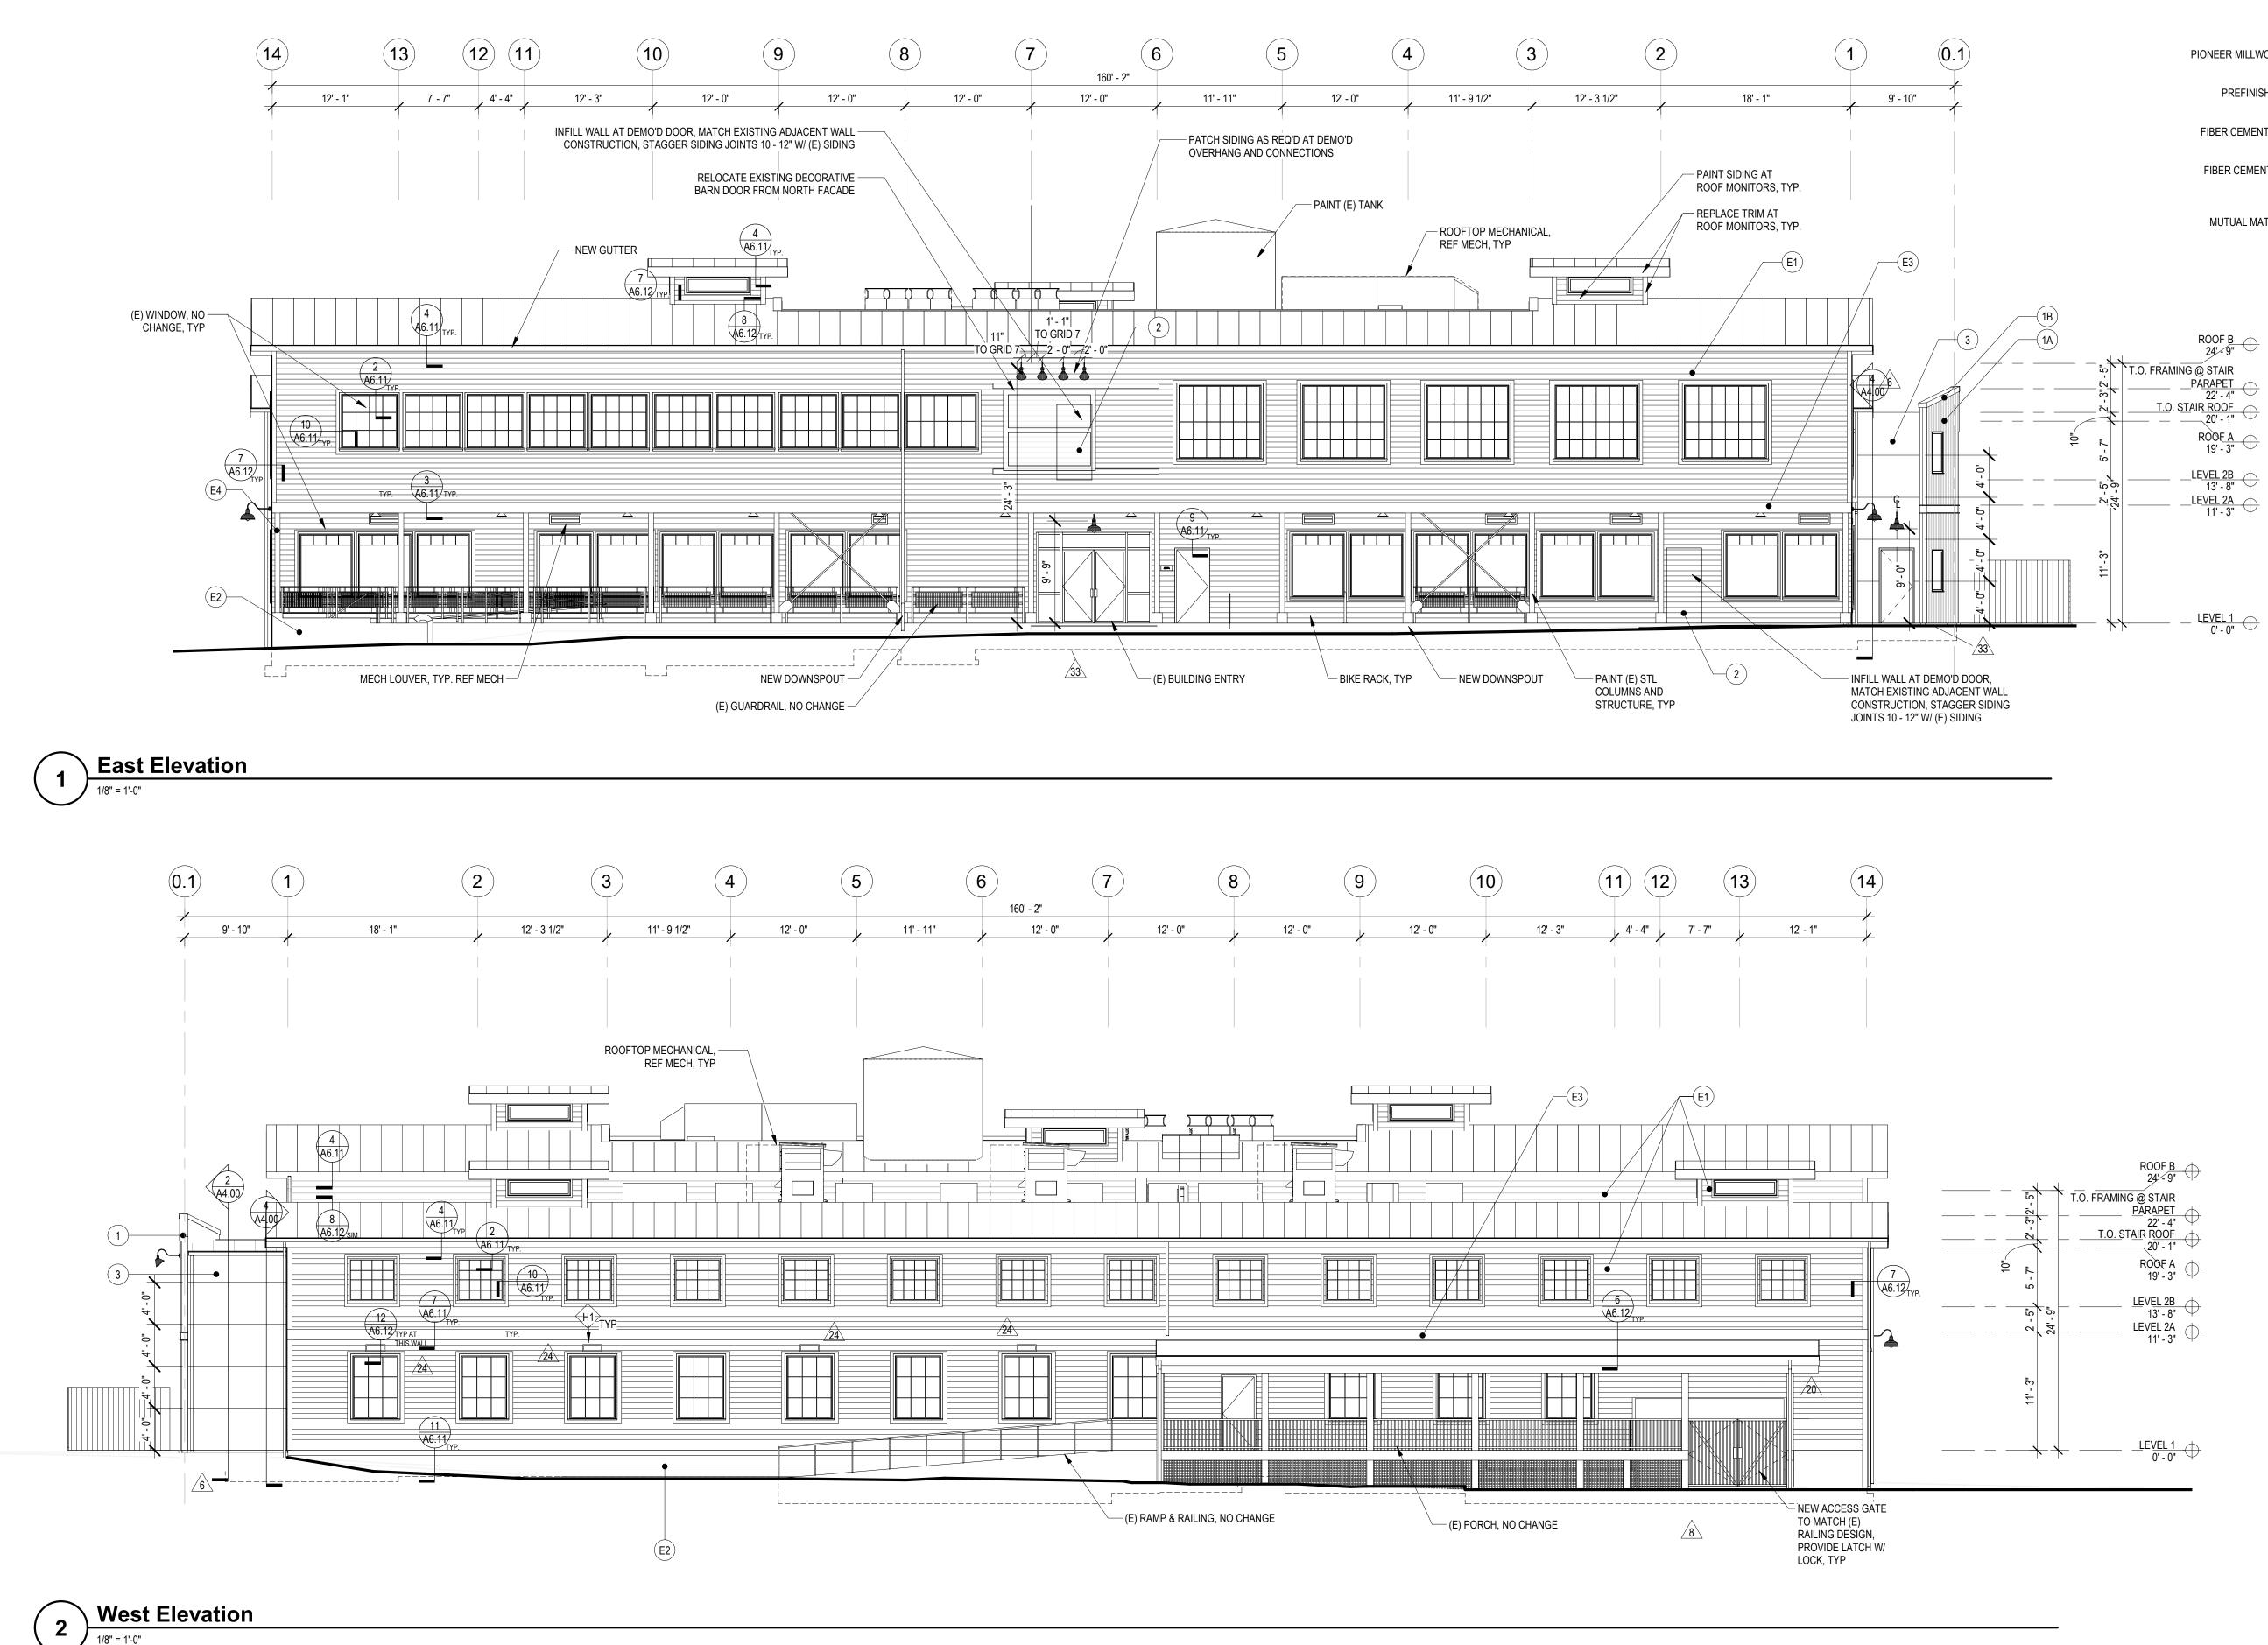
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SHEET TITLE

ROOF PLAN





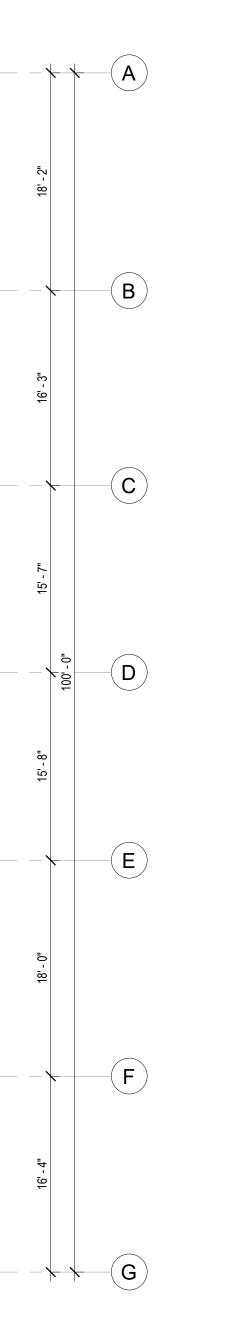

CHC Puyallup -

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Seattle, Washington 98103 Tel: 206 634 0177

ARCHITECT'S STAMP

REGISTERED

Fax: 206 634 0167

CONSULTANT

Exterior Materials Legend

- NEW FIBER CEMENT SIDING & AWRB; TYP NEW PAINT, REFER TO W(E) ON A4.00 (E1)
- EXISTING CONCRETE, (E2) NEW WATER AND GRAFFITI REPELLENT
 - 34 NEW WOOD TRIM, TYP NEW PAINT E3
- EXISTING STEEL STRUCTURE, TYP (E4) NEW PAINT
- VERTICAL WOOD SIDING (1A) PIONEER MILLWORKS, LARCH SHIPLAP "NICKEL-GAP" SIDING, FINISH: FOSSIL, 5" FACE
 - PREFINISHED SHEET METAL FLASHING PANEL, MATCH ADJACENT METAL SIDING, TYP
- FIBER CEMENT BOARD LAP SIDING, PROFILE TO MATCH (E) SIDING, PAINT
- FIBER CEMENT BOARD PANEL SIDING, HIDDEN FASTENER, PAINT ∕5∖
- CMU BLOCK (4) MUTUAL MATERIALS, GROUND FACE, COLOR: CHARCOAL
 - EXISTING LOUVER TO REMAIN LE
 - REF A2.72 FOR LOUVER TYPES
 - WINDOW / ENTRANCE TYPE, REF A2.72 FOR WINDOW TYPES
 - HOOD VENT, REF MECHANICAL, PAINT TO MATCH SIDING, TYP
- CONSULTANT'S STAMP

BUILDING DEPARTMENT'S STAMP

Building	Planning
Engineering	Public Works
Fire	Traffic

PHASE

IFC Set

DATE

05/22/23


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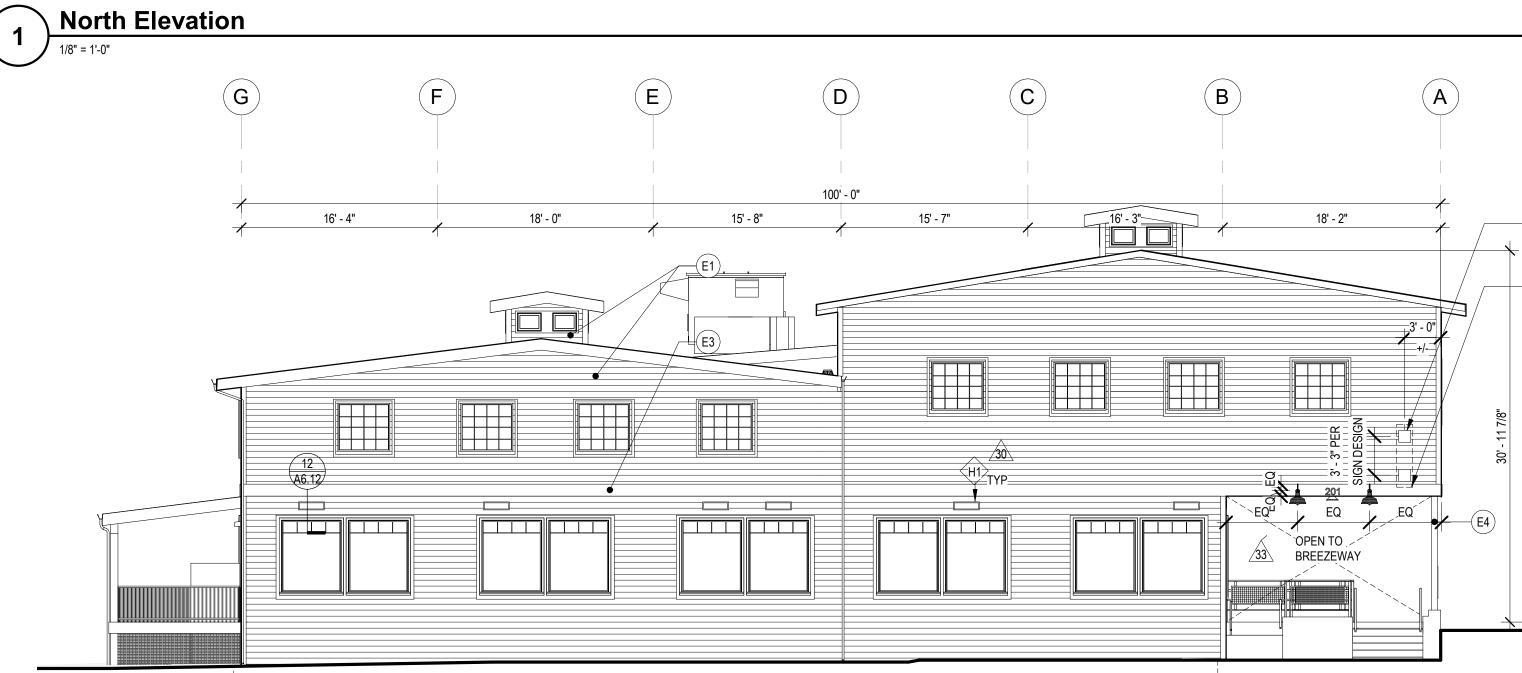
No.	Description	Date
3	GMP ADDENDUM 1	2/24/23
6	PERMIT CORRECTIONS #3	4/13/23
8	ALD GMP ADDENDUM 1	7/7/23
20	CA-ASK-RFI-54	11/11/23
24	CA-ASK-RFI-77	12/4/23
33	ASK-RFI-203	2/12/24


SHEET TITLE

BUILDING **ELEVATIONS**





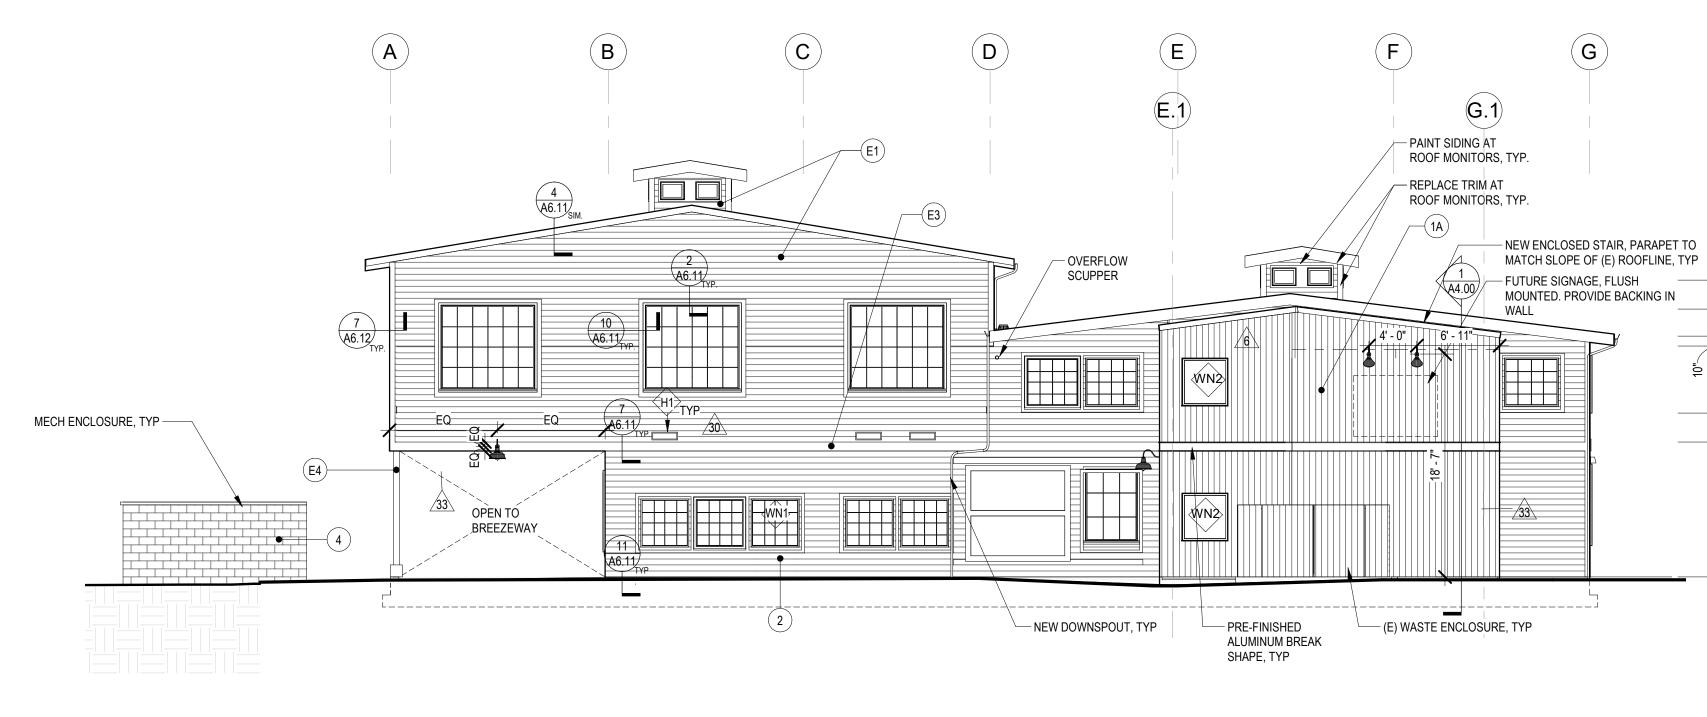

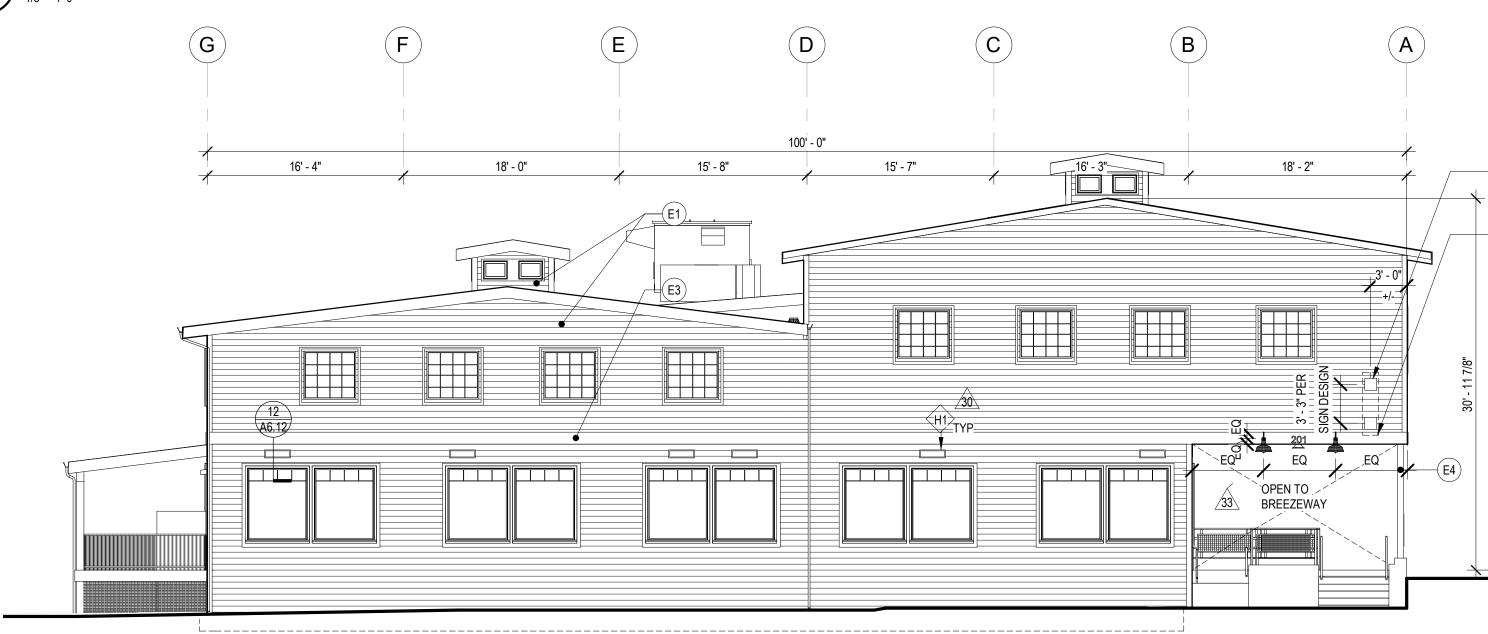




CHC Puyallup -Cannery

201 W. Main Puyallup, WA 98371

Miller HayashiArchitects

118 North 35th St. Suite 200 Seattle, Washington 98103 Tel: 206 634 0177 Fax: 206 634 0167

ARCHITECT'S STAMP

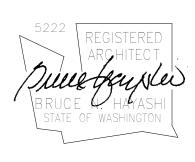


CONSULTANT

CONSULTANT'S STAMP

Exterior Materials Legend

- NEW FIBER CEMENT SIDING & AWRB TYP NEW PAINT, REFER TO W(E) ON A4.00 (E1)
- EXISTING CONCRETE, E2
 - NEW WOOD TRIM, TYP NEW PAINT E3
- EXISTING STEEL STRUCTURE, TYP E4
- VERTICAL WOOD SIDING (1A) PIONEER MILLWORKS, LARCH SHIPLAP "NICKEL-GAP" SIDING, FINISH: FOSSIL, 5" FACE
 - PREFINISHED SHEET METAL FLASHING PANEL, MATCH ADJACENT METAL SIDING, TYP
- FIBER CEMENT BOARD LAP SIDING, PROFILE TO MATCH (E) SIDING, PAINT
- FIBER CEMENT BOARD PANEL SIDING, HIDDEN FASTENER, 3 PAINT ∕5∖
- CMU BLOCK (4) MUTUAL MATERIALS, GROUND FACE, COLOR: CHARCOAL
 - EXISTING LOUVER TO REMAIN (LE)
 - LOUVER TYPE, REF A2.72 FOR LOUVER TYPES
 - WINDOW / ENTRANCE TYPE, REF A2.72 FOR WINDOW TYPES
 - HOOD VENT, REF MECHANICAL, PAINT TO MATCH SIDING, TYP

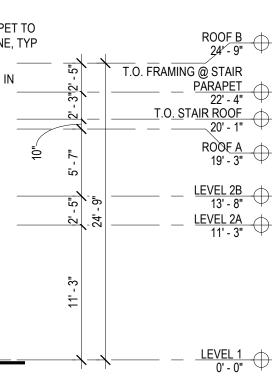

BUILDING DEPARTMENT'S STAMP

Building	Planning
Engineering	Public Works
Fire	Traffic

PHASE

IFC Set

DATE

05/22/23

REVISIONS


No.	Description	Date
3	GMP ADDENDUM 1	2/24/23
1	GMP ADDENDUM 2	3/8/23
6	PERMIT CORRECTIONS #3	4/13/23
17	CA-ASK-ASI-03	10/30/23
30	CA-ASK-RFI-096	Date 30
33	ASK-RFI-203	2/12/24

SHEET TITLE

BUILDING ELEVATIONS


SHEET NO.



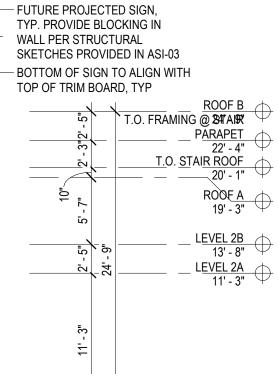


<u>/17</u>

LEVEL 1 0' - 0"

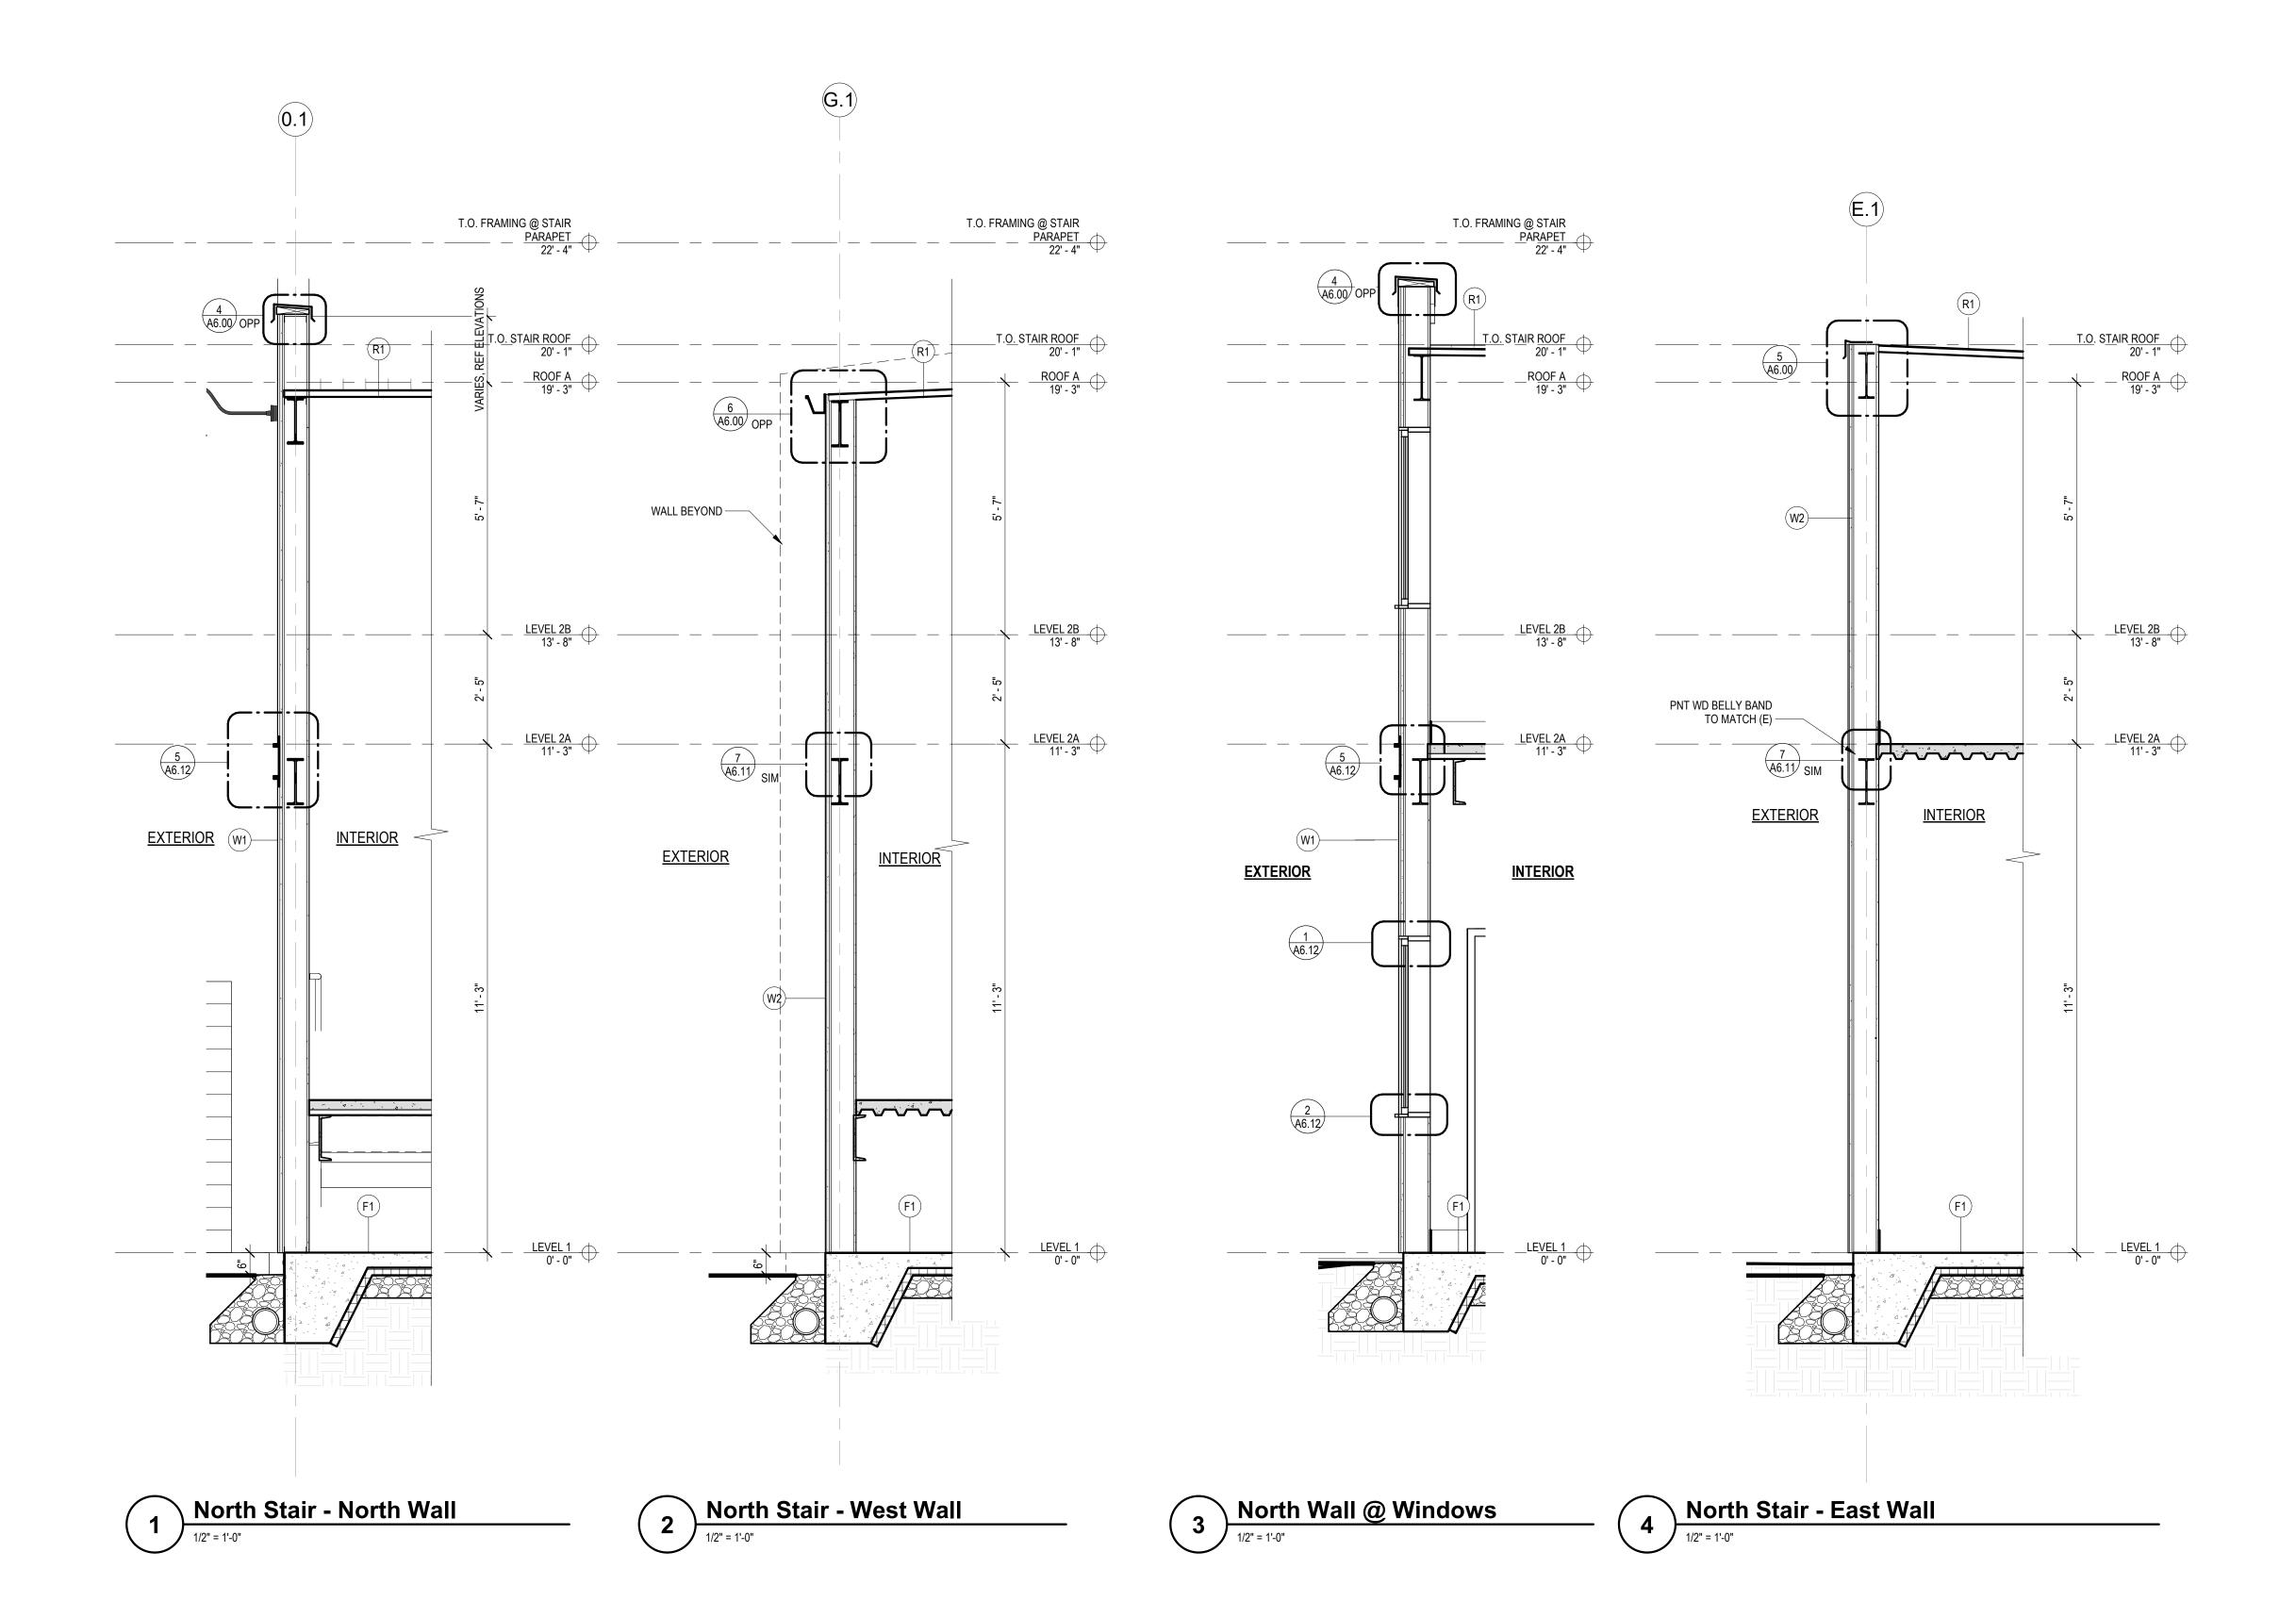


- CHC Puyallup Cannery

201 W. Main Puyallup, WA 98371

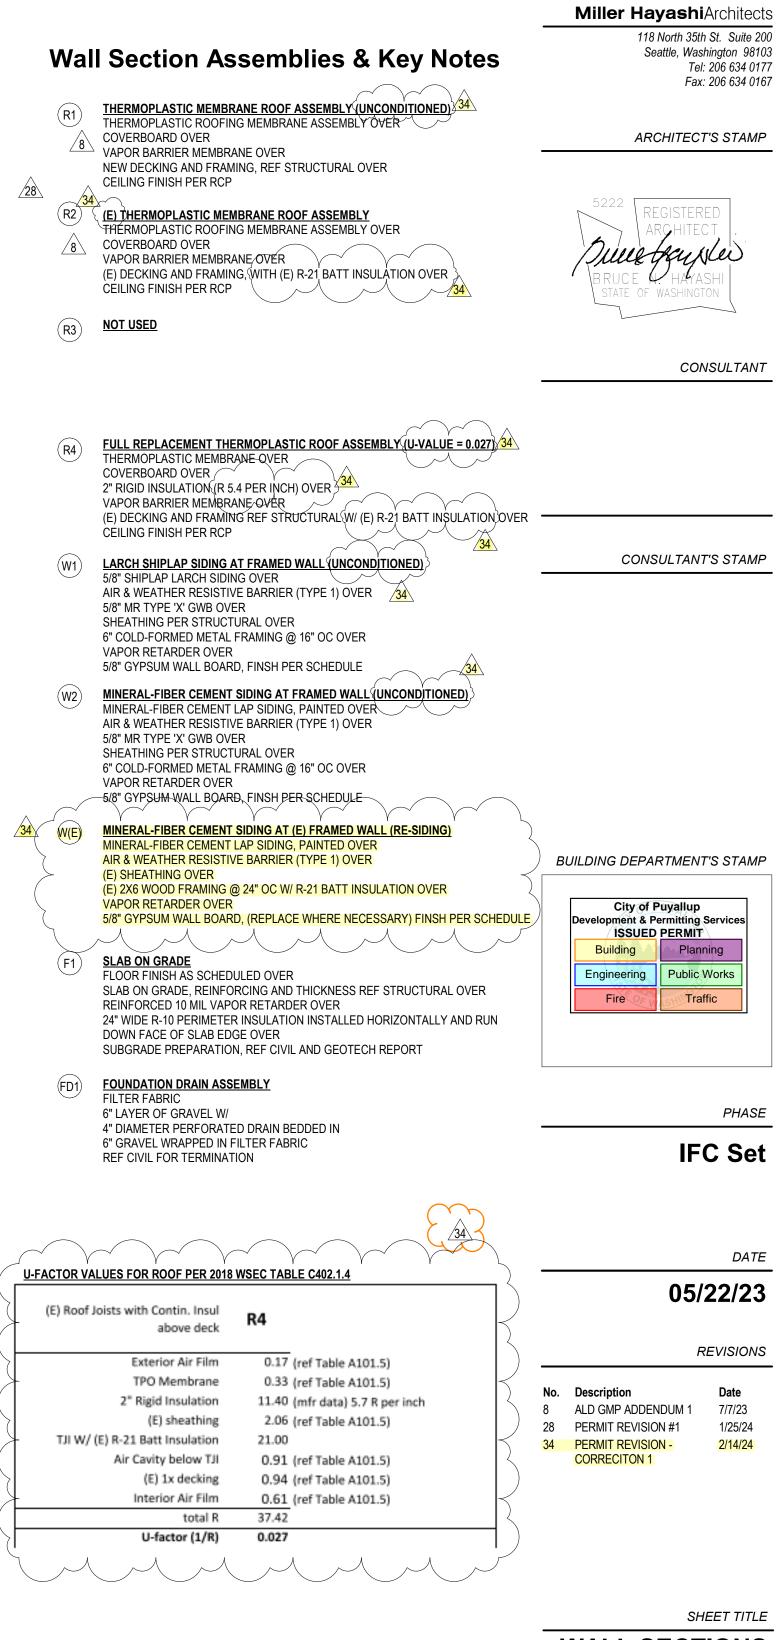


WALL SECTIONS, WALL ASSEMBLIES




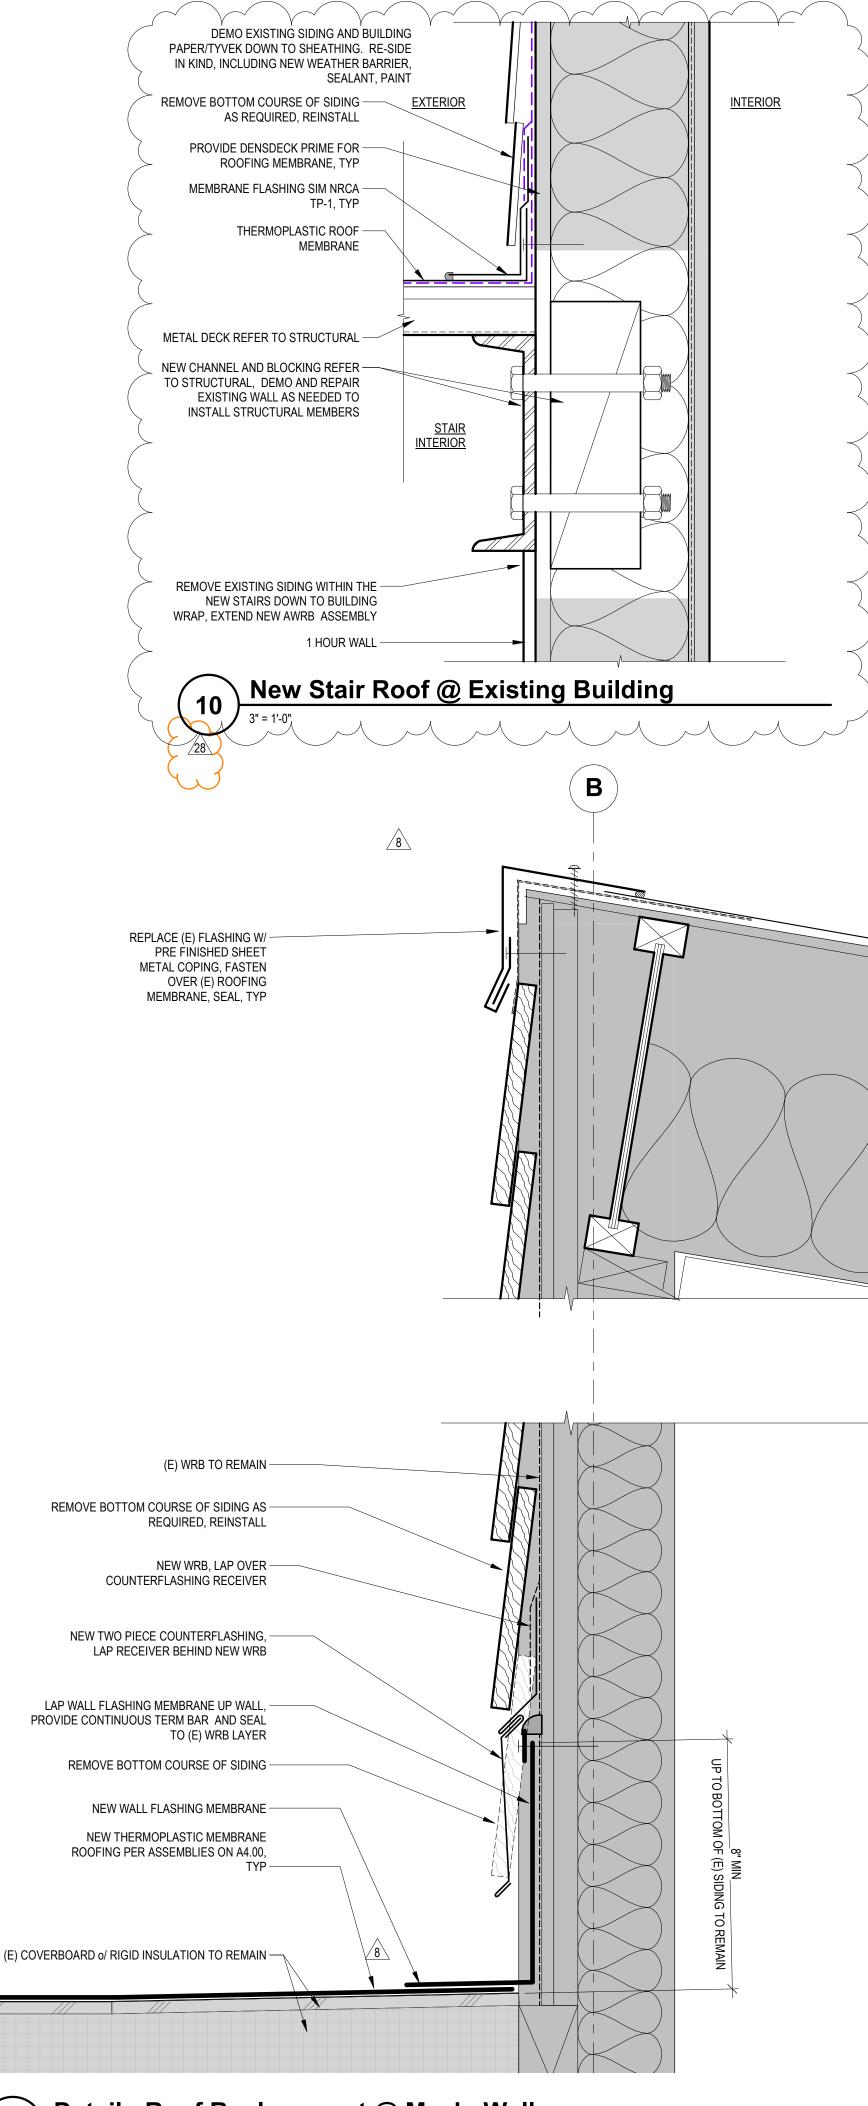

7 3" = 1'-0"

Detail - Roof Replacement @ Mech. Well

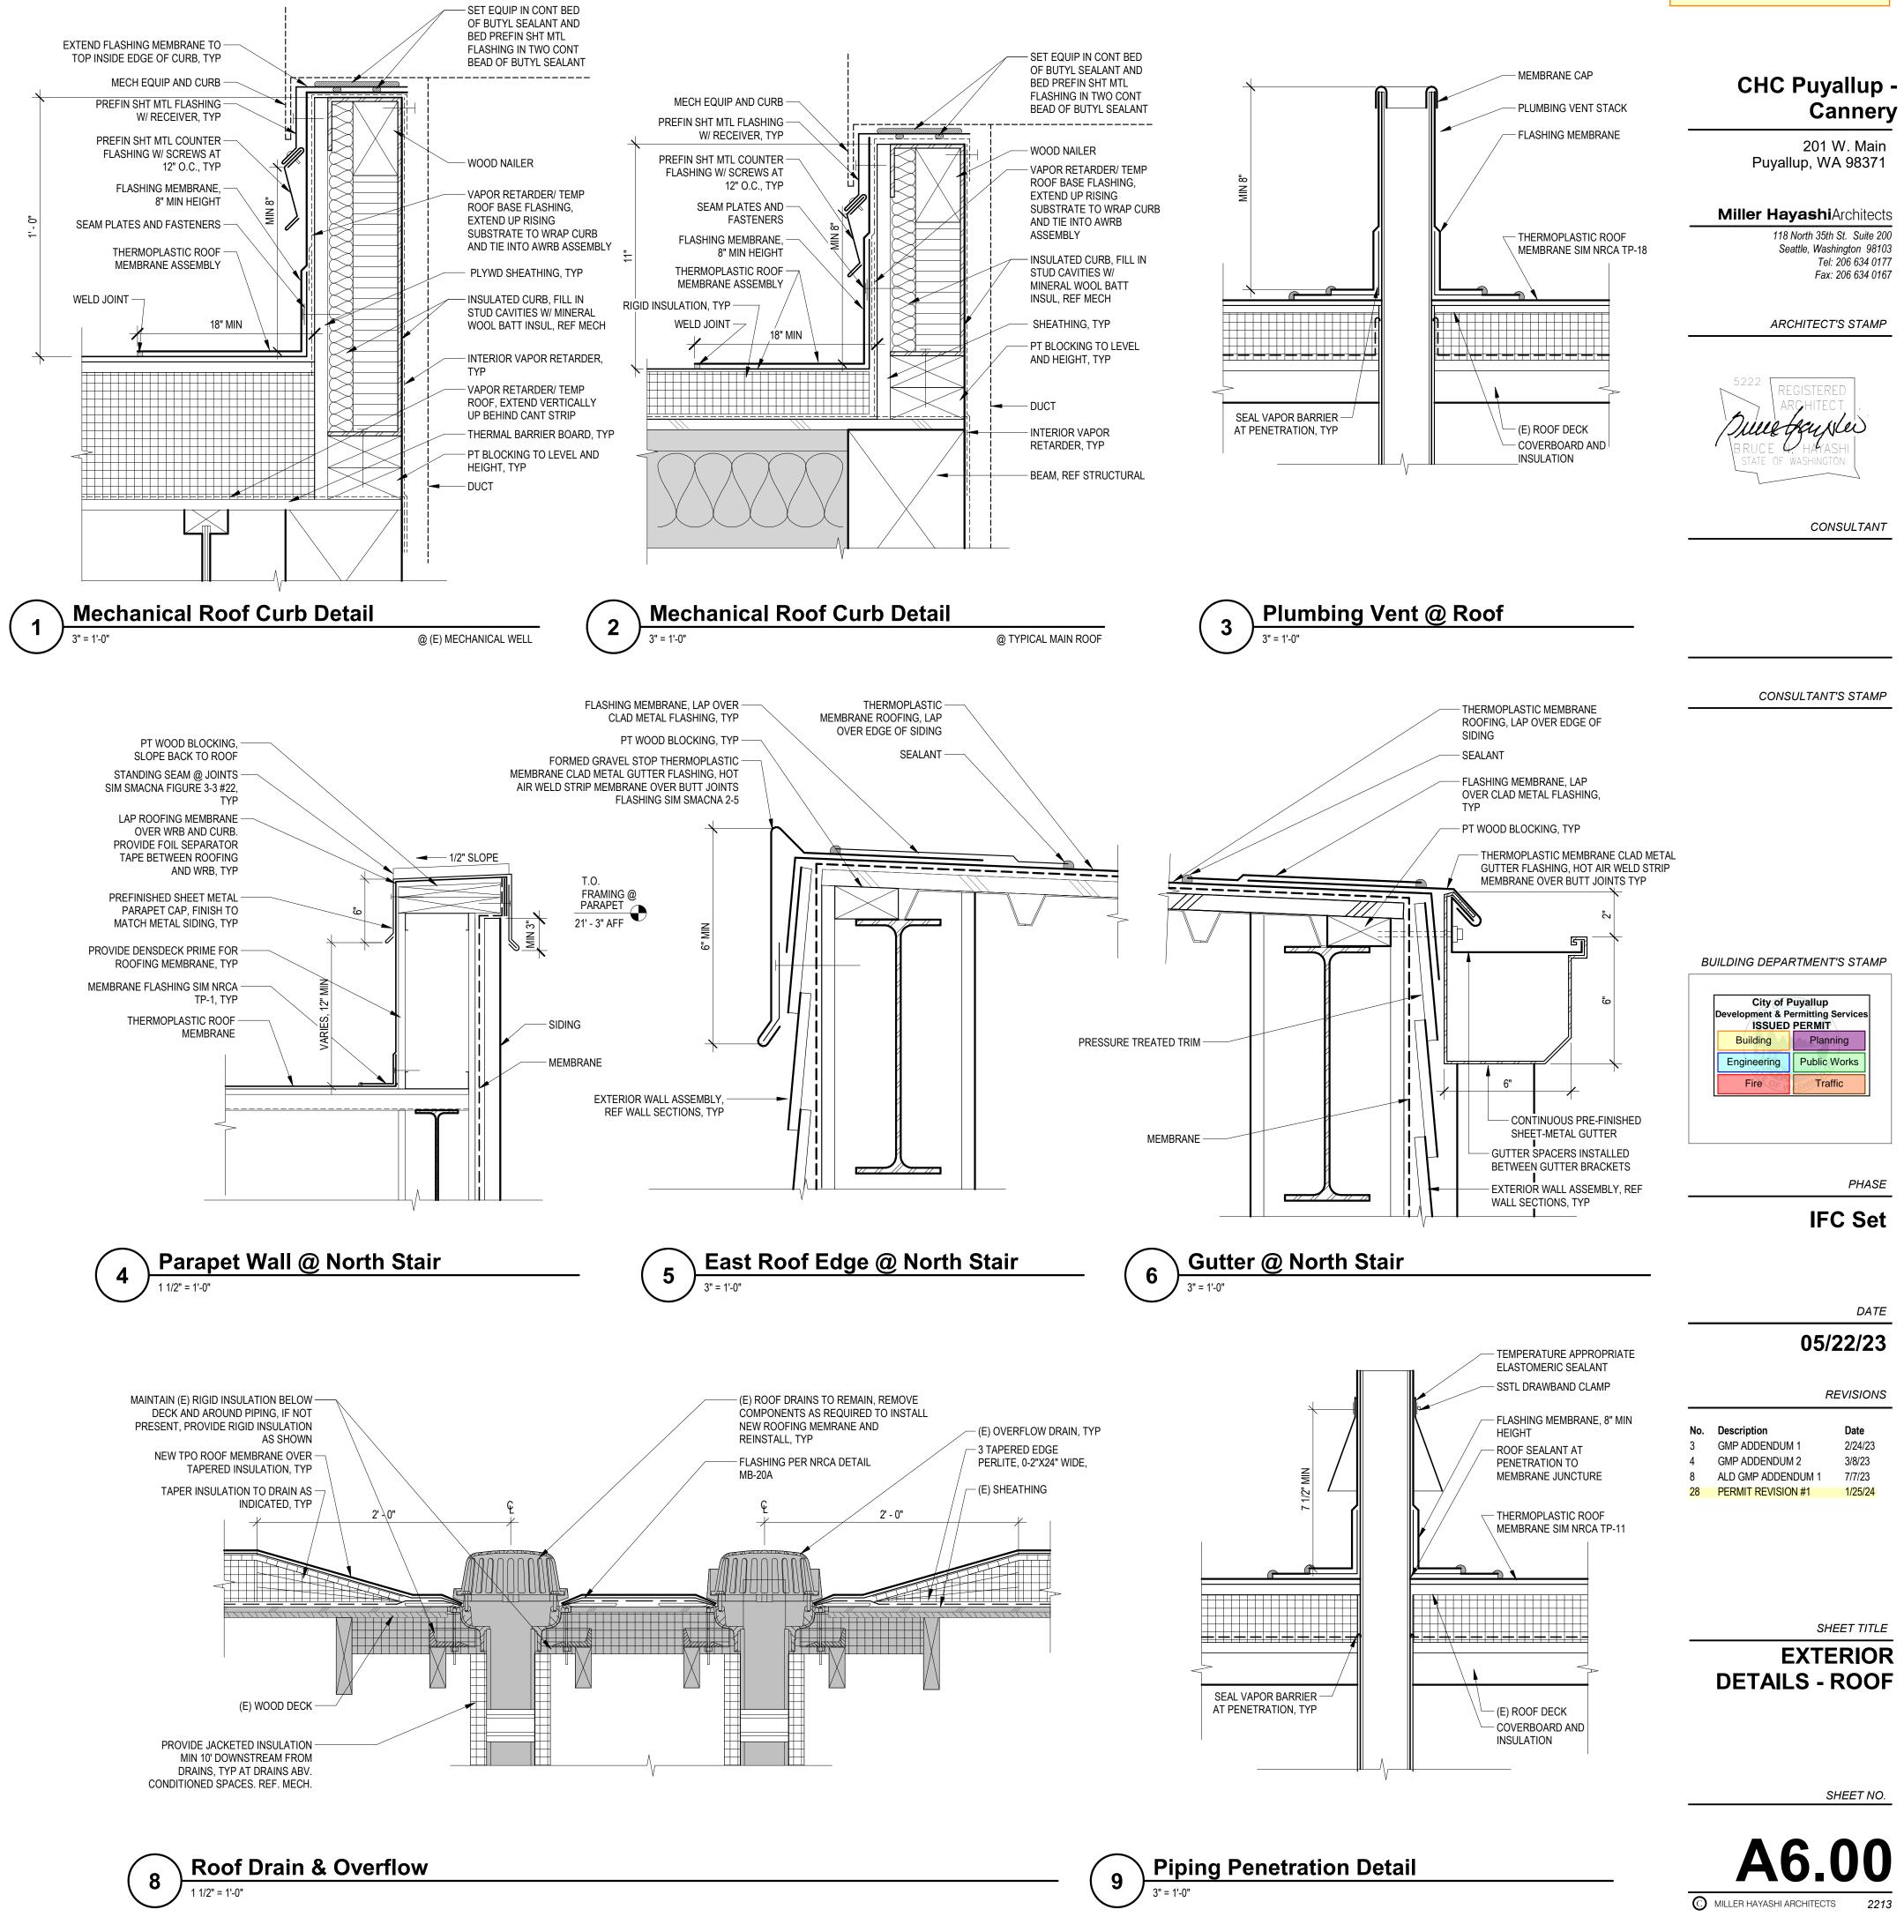

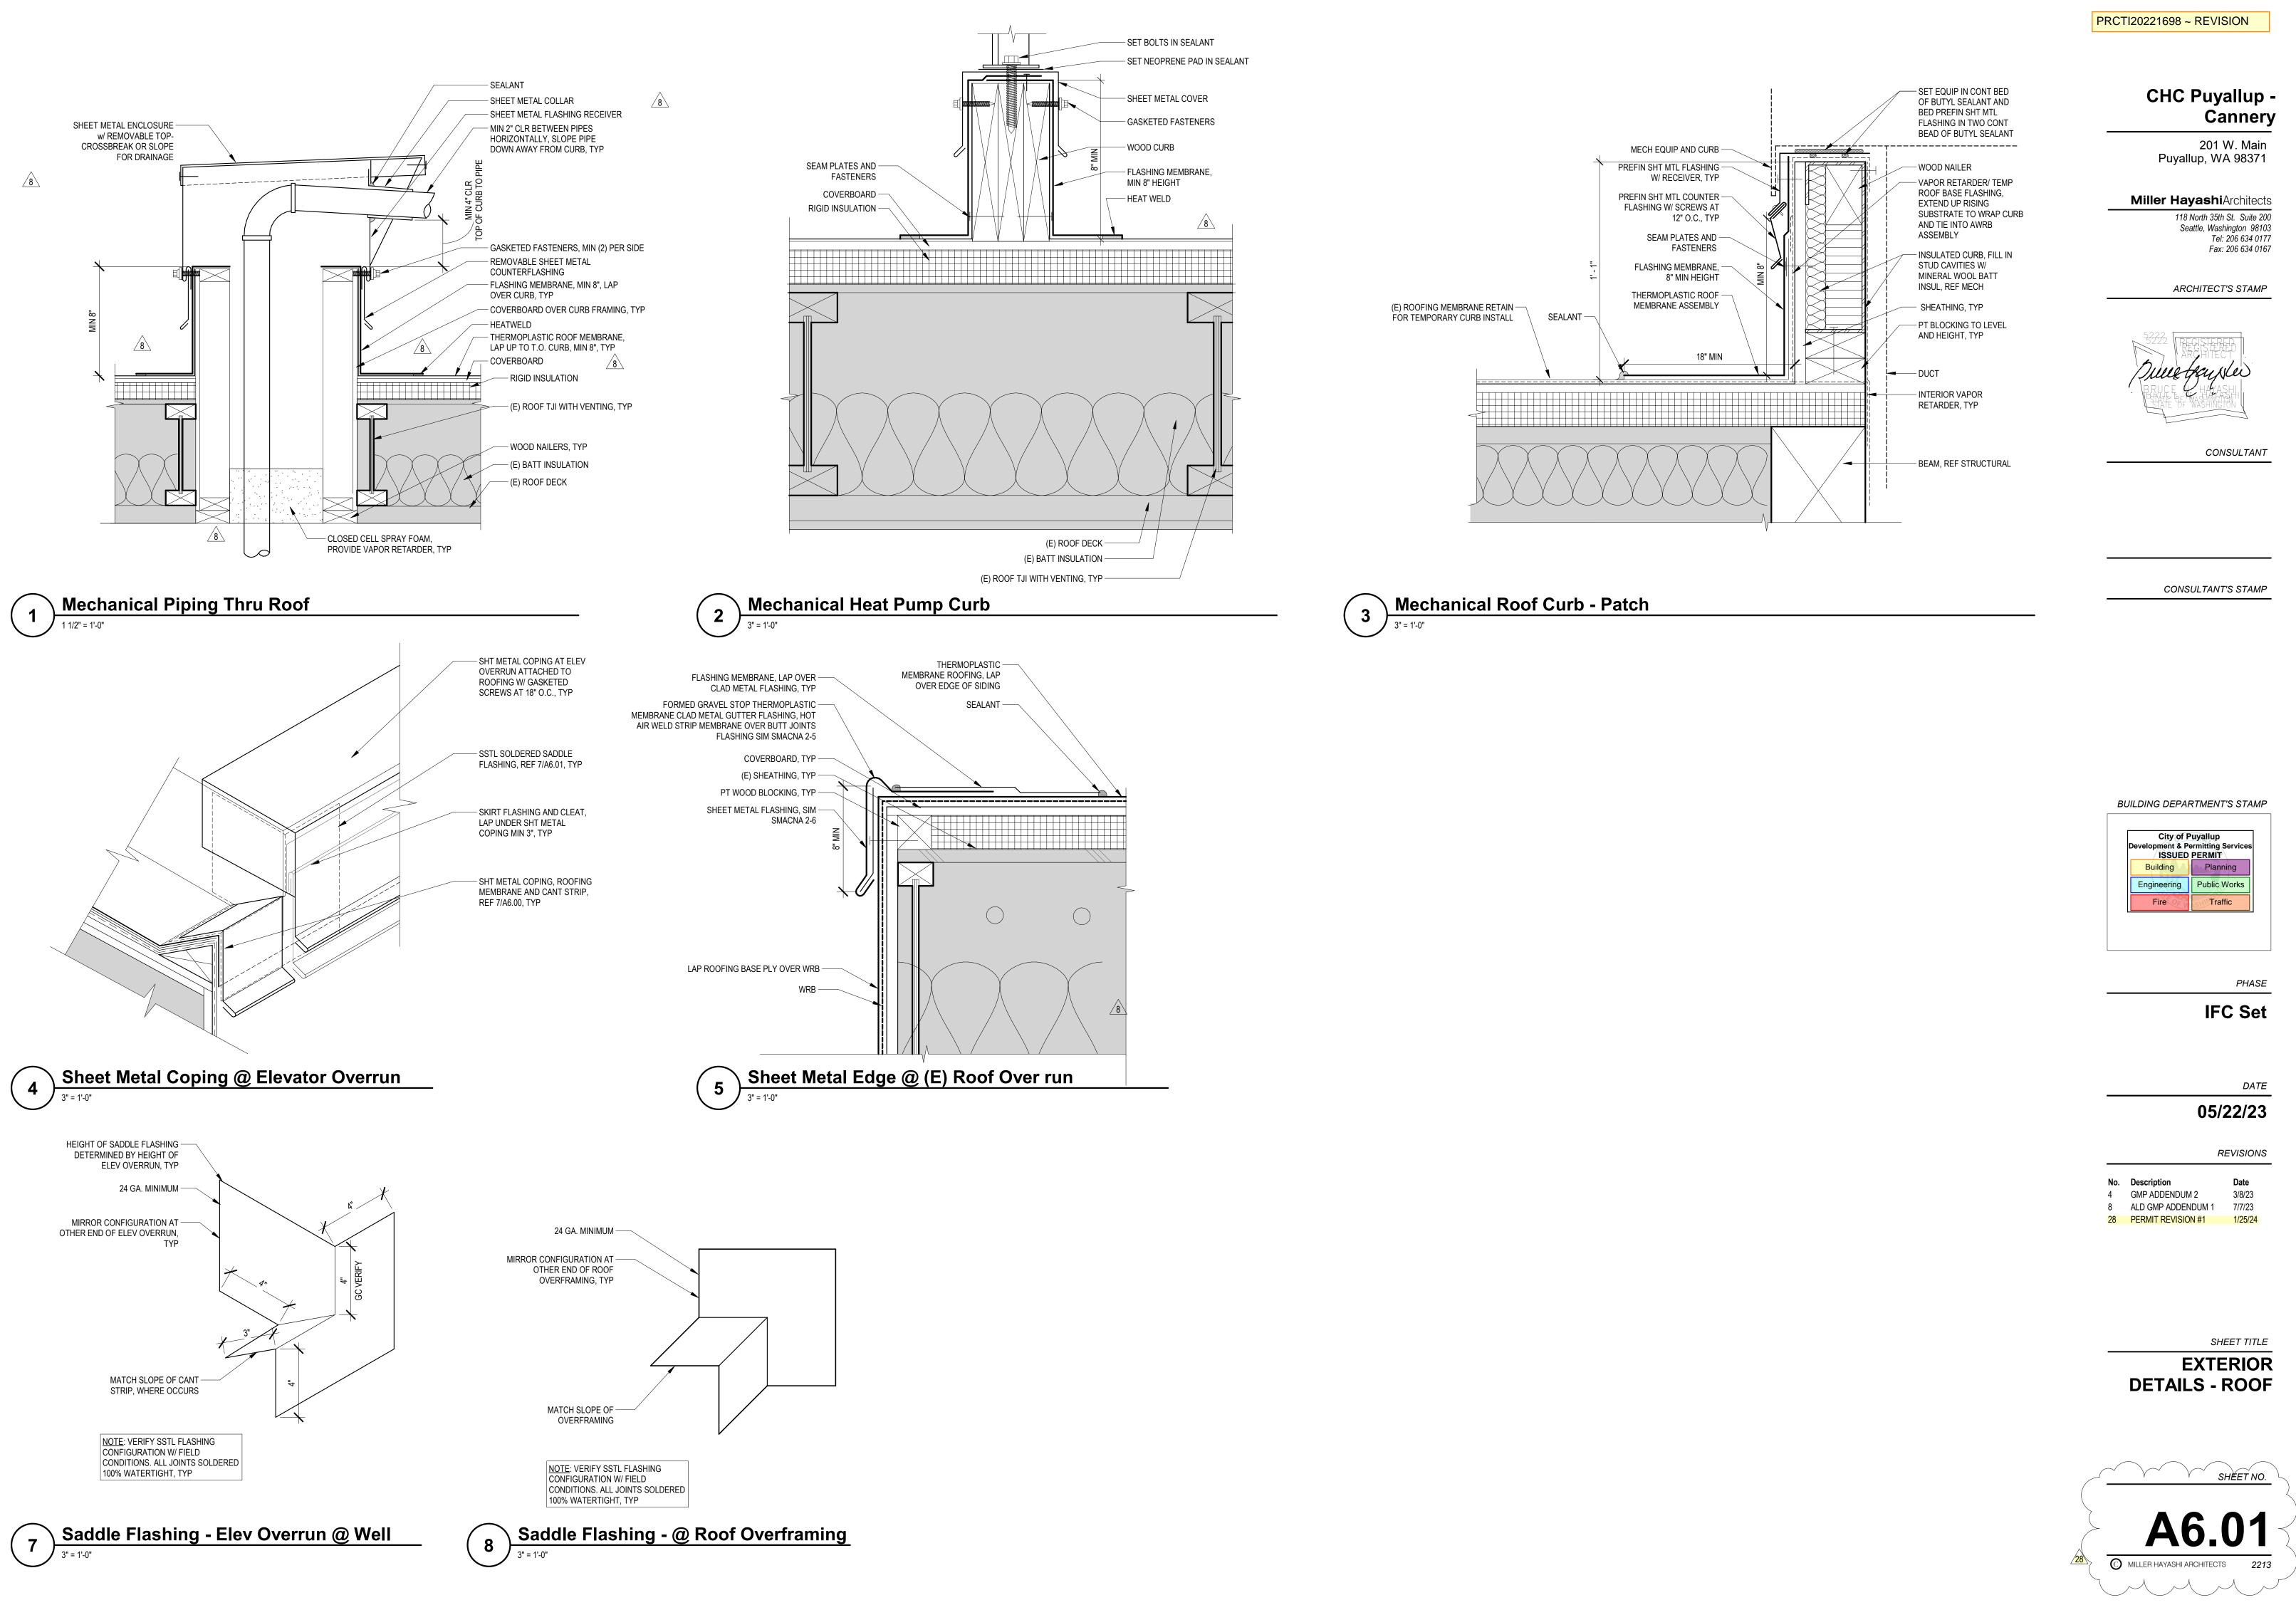

Building	Planning
Engineering	Public Works
Fire	Traffic

No.	Description	Date
4	GMP ADDENDUM 2	3/8/23
8	ALD GMP ADDENDUM 1	7/7/23
28	PERMIT REVISION #1	1/25/24

