

PUYALLUP HAMPTON INN ADDITION

1515 S. Meridian Street, Puyallup, WA 98371

VICINITY MAP

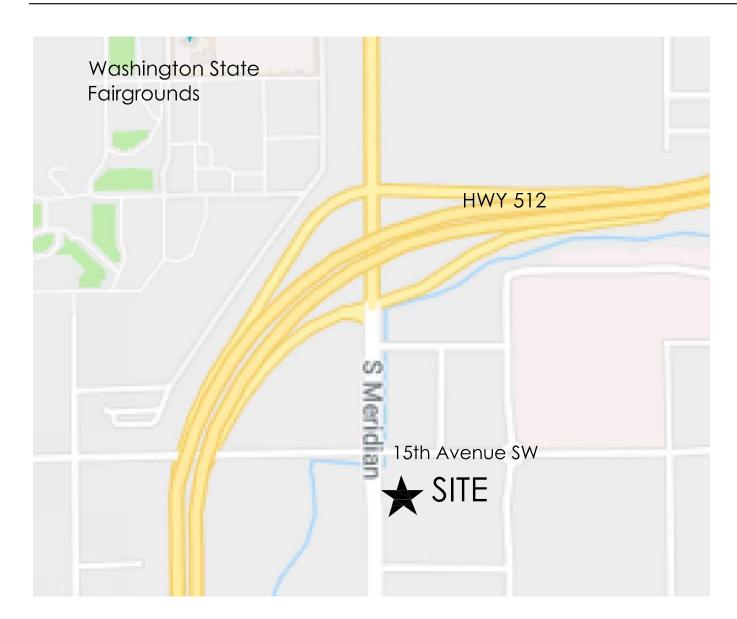

REVISION 2 of 2 (4 pages) B-20-0078

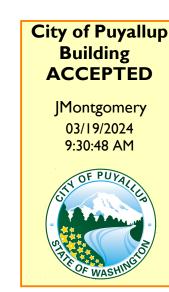

FULL SIZED LEDGIBLE **COLOR** PLANS ARE REQUIRED TO BE PROVIDED BY THE PERMITTEE ON SITE FOR ALL INSPECTIONS (MIN. PLAN SIZE 24" X 36")

City of Puyallup

MECH./ELEC. ENGINEER Abossein Engineering, Inc.

PROJECT TEAM

11010 NE 8th ST SUITE 465

Contact: VICTOR SUNG

PCS Structural Solutions

Tacoma, WA 98402

STRUCTURAL ENGINEER

BELLEVUE, WA 98444

OWNER

PVI, LLC

626-200-5019

253.383.2797

18456 NE 68th Street Redmond, WA 98052 425.462.9441 Elec. Contact: Jay Werner Plumbing Contact: Dennis Grovenburg Mech. Contact: Gary Womack

A2.12 ENLARGED STAIR PLANS & SECTIONS

A3.1 EXTERIOR ELEVATIONS

ARCHITECT

909 S. 336th Street, Suite 107 Federal Way, WA 98003 253-572-551 Contact: Rhonda Gillogly, AIA-Project

CIVIL ENGINEER

Huitt-Zollars 120 Pacific Avenue, Suite 701 1102 Broadway, #301 Tacoma, WA 98402 253.627.9131 Contact Jared Plank, Project Eng. Contact: Darton Riely-Gibbons

LANDSCAPE ARCHITECT

Aspen Design Group P.O. Box 2394 Issaquah, WA 98027 425.292.9845 Contact: Paul Dix

PROJECT DATA SITE ADDRESS:

2012 NON-RESEIDENTIAL ENERGY CODE

1515 MERIDIAN S

PUYALLUP, WA

TAX PARCEL NUMBER: 7790000050 AND 7790000024

SITE AREA: ZONING: 85,977 SF ZONING: CG

SCOPE OF WORK

PARKING AREA EXPANSION BELOW NEW GUEST ROOM WING. NEW GUEST ROOM WING ADDITION OF 3 FLOORS. MINOR DEMOLITION OF ONE EXSTING GUEST ROOM ON EACH FLOOR TO PROVIDE ACCESS TO NEW WING.

APPLICABLE EDITIONS OF BUILDING CODES 2015 I.B.C, STATE AMENDMENTS AND WAC 51-50 2015 INTERNATIONAL MECHANICAL CODE, STDS AND AMENDMENTS - WAC 51-52 2015 INTERNATIONAL FIRE CODE, STDS AND AMENDMENTS - WAC 51-54 2015 UNIFORM PLUMBING CODE, STDS AND AMENDMENTS - WAC 51-56, 51-57 2010 ADA STANDARDS FOR ACCESSIBLE DESIGN & I.C.C. A117.1-2009

NUMBER OF STORIES: OCCUPANCY CLASSIFICATION: R1, S1, B, A3 SPRINKLED YES **CONSTRUCTION TYPE:**

FLOOR	EXISTING AREA	NEW AREA	TOTAL AREA
PARKING GARAGE	15,441 SF	0 SF	15,441 SF
1ST FLOOR	15,189 SF	168 SF	15,357 SF
2ND FLOOR	20,296 SF	4,484 SF	24,780 SF
3RD FLOOR	19,357 SF	4,484 SF	23,841 SF
4TH FLOOR	18,892 SF	4,484 SF	23,376 SF
	89.175 SF	13,620 SF	102,795 SF

Window Type

-Door Number

— Shear Wall Type

Datum, Work, or Control Point

A.B.	ANCHOR BOLT	L.	LENGTH
A.C.P	ACOUSTICAL CEILING PANEL	MDF.	MEDIUM DENSITY FIBERBOARD
AFFLR.	ABOVE FINISH FLOOR	MTL.	METAL
ADD. ALT.	ADDITIVE ALTERNATE	N.I.C.	NOT IN CONTRACT
B.F.	BARRIER FREE	N.T.S.	NOT TO SCALE
B.S.	BACK SPLASH	O.C.	ON CENTER
BM.	BEAM	O.H.	
C.J.	CONTROL/CONSTRUCTION JOINT	OPT.	OPTIONAL
C.L. or C	CENTERLINE	O.S.B.	
CONT.	CONTINUOUS	P.L.B.	
CPT.	CARPET	P.LAM.	
CRM.	CLASSROOM	PLYWD.	
C.T.	Ceramic Tile	PR.	PAIR
D.	DEPTH	PT.	PAINT
D.F.	DRINKING FOUNTAIN	P.T.D.	PAPER TOWEL DISPENSER
D.O.	DEDICATED OUTLET	R.B.	RUBBER BASE
D.S.	DOWN SPOUT	R.D.	ROOF DRAIN
E.C.	EXPOSED CONCRETE	R.I.	ROUGH-IN
EXIST.	EXISTING	R.L.	RAIN LEADER
EXP. BOLT	EXPANSION BOLT	R.S.	ROUGH SAWN
FDN.	FOUNDATION	S & V	STAINED & VARNISHED
F.D.	FLOOR DRAIN	S.C.	SOLID CORE
F.E.	FIRE EXTINGUISHER	S.V.	SHEET VINYL
FIN. FLR.	FINISH FLOOR	SHT. MTL.	SHEET METAL
F.O.I.C.	FURNISHED BY OWNER INSTALLED BY GC.	SIM.	SIMILAR
F.O.I.O	furnished by Owner Installed by Owner	T & G	TONGUE & GROOVE
F.O.P.W	FACE OF PLYWOOD	T.O.C	TOP OF CONCRETE
F.R.P.	FIBERGLASS REINFORCED PANEL	T.O.P.	TOP OF PLATE
G.LAM/GL	GLUE LAMINATED	T.O.W.	TOP OF WALL
GA.	GAUGE OR GAGE	TRT.	TREATED
GALV.	GALVANIZED	T.S.	TUBE STEEL
GWB.	GYPSUM WALL BOARD	T.T.D.	TOILET TISSUE DISPENSER
GYP.	GYPSUM	TYP.	TYPICAL
H.	HEIGHT	U.N.O.	UNLESS NOTED OTHERWISE
H.C.	HOLLOW CORE/HANDICAP	W.O.M.	WALK OFF MAT
H.M.	HOLLOW METAL	W.	WIDE
HDR.	HEADER	W.P.	WATER PROOF
	\wedge	WD.	WOOD
	<u>/5\</u>	WDW.	WINDOW
		S.A.M.	SELF ADHERING MEMBRANE
SYMBOI	_S	ww	

—Interior Elevation Group

– Wall Section Number

— Bldg. Section Number

-Sheet Number

-Sheet Number

-Sheet Number

—Detail Number

— Sheet Number


GENERAL NOTES

- ALL WORK SHALL CONFORM TO APPLICABLE CURRENT FEDERAL, STATE AND LOCAL CODES. THE CONTRACTOR IS TO PROVIDE FOR ALL REQUIRED NOTIFICATION OF AND COORDINATION WITH CITY AND STATE AGENCIES, AND PROVIDE REQUIRED PERMITS. ALL TESTS AND INSPECTIONS ASSOCIATED WITH OBTAINING APPROVALS TO PROCEED WITH AND COMPLETE THE WORK SHALL BE PAID FOR BY THE
- 2. THE CONTRACTOR SHALL COORDINATE ALL OPERATIONS WITH THE OWNER, INCLUDING AREA FOR WORK, MATERIALS STORAGE, AND ACCESS TO AND FROM THE WORK, SPECIAL CONDITIONS OR NOISY WORK, TIMING OF WORK AND INTERRUPTION OF MECHANICAL AND ELECTRICAL SERVICES. NOISY OR DISRUPTIVE WORK SHALL BE SCHEDULED AT LEAST ONE (1) WEEK IN ADVANCE OF THE TIME WORK IS TO COMMENCE.
- ALL WORK SHALL BE PERFORMED IN ACCORDANCE WITH THE HIGHEST STANDARD OF WORKMANSHIP IN GENERAL AND WITH SUCH STANDARDS AS ARE SPECIFIED.
- CONTRACTOR SHALL ADHERE TO ALL BUILDING STANDARDS. ANY CHANGES TO SAME SHALL BE SUBMITTED TO ARCHITECT IN WRITING FOR APPROVAL.
- CONTRACTOR SHALL SUBMIT SAMPLES OF ALL FINISHES OF SUCH SIZE AND NUMBER THAT THEY REPRESENT A REASONABLE DISTRIBUTION OF COLOR RANGES AND PATTERN PRIOR TO INSTALLATION FOR OWNER'S APPROVAL. CONTRACTOR SHALL PROVIDE SHOP DRAWINGS AND PRODUCT DATA FOR ARCHITECT'S APPROVAL ON ALL SPECIAL ITEMS REQUIRING CUSTOM FABRICATION.
- CONTRACTOR IS TO VERIFY ALL DIMENSIONS AND CONDITIONS ON SITE AND NOTIFY ARCHITECT OF ANY DISCREPANCIES. CONTRACTOR IS NOT TO SCALE OFF DRAWINGS.
- CONTRACTOR SHALL PROVIDE BLOCKING/BACKING IN PARTITIONS FOR ALL WALL-MOUNTED FIXTURES AND DEVICES UNLESS INDICATED OTHERWISE ON THE DRAWINGS.
- ALL FLOORS SHOULD BE LEVEL AND NOT VARY MORE THAN 1/4" IN 10'-0". THE CONTRACTOR SHALL NOTIFY ARCHITECT OF ANY CONDITIONS THAT DO NOT MEET THIS STANDARD.
- FLOOR FINISH TRANSITIONS SHALL OCCUR UNDER DOORS, UNLESS SHOWN OR NOTED OTHERWISE.
- 10. MATERIALS, ARTICLES, DEVICES AND PRODUCTS ARE SPECIFIED IN THE DOCUMENTS BY LISTING ACCEPTABLE MANUFACTURERS OR PRODUCTS, BY REQUIRING COMPLIANCE WITH REFERENCED STANDARDS, OR BY PERFORMANCE SPECIFICATIONS. FOR ITEMS SPECIFIED BY NAME, SELECT ANY PRODUCT NAMED. FOR THOSE SPECIFIED BY REFERENCE STANDARDS OR BY PERFORMANCE SPECIFICATIONS SELECT ANY PRODUCT MEETING OR EXCEEDING SPECIFIED CRITERIA. FOR APPROVAL OF AN ITEM NOT SPECIFIED, SUBMIT REQUIRED SUBMITTALS, PROVIDING COMPLETE BACK-UP INFORMATION FOR PURPOSES OF EVALUATION. WHERE BUILDING STANDARD ITEMS ARE CALLED FOR. NO SUBSTITUTE WILL BE ACCEPTED.
- CONTRACTOR SHALL PROVIDE FOR ALL WORK REQUIRED TO MAINTAIN COMPLIANCE WITH LOCAL FIF CODE. PROVIDE FOR ALL REQUIRED SHOP DRAWINGS AND APPROVALS. CONTRACTOR IS RESPONSIBLE FOR PROVIDING FIRE ALARM SYSTEM AUDIBILITY.
- MECHANICAL AND ELECTRICAL FIXTURES, OUTLETS, ETC., WHEN SHOWN ON THE ARCHITECTURAL DRAWINGS, ARE FOR LOCATION INFORMATION ONLY. MECHANICAL AND ELECTRICAL TO BE DESIGNED BY OTHERS. ALL CIRCUITING COORDINATION TO BE BY OTHERS.

~~	INDEX	TO DRAWINGS				
					~~	······································
$\sqrt{6}$		VED SHEETS	A4.1	BUILDING SECTIONS	DILIAI	DINIC.
	A0.4	FIRE RATED PENETRATIONS	A4.2	BUILDING SECTIONS	PLUMI	
	, A2.10	\	A5.1	WALL SECTIONS	P1.0	GENERAL NOTES, SCHEDULES AND LEGEND
_ (A2.11	ENLARGED BATHROOM PLANS	A6.1	DOOR SCHEDULE	P2.0	1ST FLOOR PLAN - PLUMBING
4 . (A2.13	BATHROOM ELEVATIONS	A6.2	WINDOW SCHEDULE	P3.0	2ND FLOOR PLAN - PLUMBING
\sim	A O 1	COVER SHEET AND DROHEST INFORMATION.	A7.1	EXTERIOR DETAILS	P4.0	3RD FLOOR PLAN - PLUMBING
7	• A0.1	COVER SHEET AND PROJECT INFORMATION	A7.2	DETAILS	P5.0	4TH FLOOR PLAN - PLUMBING
	CIVII		A7.3	ROOF DETAILS DETAILS	P6.0 P7.0	ROOF PLAN - PLUMBING RISER DIAGRAMS PLUMBING
\	$\frac{\text{CIVIL}}{\text{C1.0}}$	COVER, VICINITY LEGEND & MAP	A7.4 A7.5	DETAILS	P9.0	PLUMBING SPECIFICATIONS
(C1.0	GENERAL NOTES	ENVEL		ELECT	
7	C1.1	OVERALL SITE PLAN		GENERAL NOTES	E1.0	GENERAL NOTES, SCHEDULES, AND PLAN
7	C2.0	DEMOLITION PLAN	BE1.1	STEGO SLAB	LI.U	INDEX
ì	C3.0	TEMPORARY EROSION AND SEDIMENT	BE2.0	TPO ROOFING	E2.0	1ST FLOOR POWER
~	, 00.0	CONTROL PLAN	BE2.1	TPO ROOFING	E2.1	2ND FLOOR POWER
	C3.1	TESC NOTES AND DETAILS		WINDOW INSTALL	E2.2	3RD FLOOR POWER
(C4.0	GRADING CROSS SECTIONS	BE6.1	EIFS	E2.3	4TH FLOOR POWER
(C4.1	GRADING CROSS SECTIONS	<i>D</i> L0.1		E2.4	1ST FLOOR LIGHTING
(C4.2	GRADING & DRAINAGE PLAN	STRUC	TURAL	E3.0	1ST FLOOR LIGHTING
Ò	C5.0	SITE PAVING & UTILITY PLAN	\$1.0	GENERAL NOTES	E3.1	2ND FLOOR LIGHTING
7	C5.1	SITE PAVING & UTILITY DETAILS	\$1.1	GENERAL NOTES	E3.2	3RD FLOOR LIGHTING
\	C5.2	SITE PAVING & UTILITY DETAILS	\$1.2	GENERAL NOTES	E3.3	4TH FLOOR LIGHTING
(C5.3	SITE PAVING & UTILITY DETAILS	\$1.3	GENERAL NOTES	E4.0	ENLARGED UNIT PLANS ELECTRICAL
7	C6.0	RIGHT-OF WAY/ FRONTAGE IMPROVEMENTS	\$2.0	FOUNDATION PLAN	E5.0	POWER RISER DIAGRAM LEVELS 1-4
~	C.1	RIGHT-OF-WAY/ FRONTAGE IMPROVEMENTS	\$2.1	LEVEL 2 FRAMING PLAN	E5.1	TELECOMMUNICATION RISER DIAGRAM
\	•	DETAILS	\$2.1A	LEVEL 2 BOTTOM & TOP REINFORCING PLANS	E6.0	DETAILS
	\$1.0	SURVEY	\$2.2	LEVEL 3 FRAMING PLAN	E7.0	PANEL SCHEDULES
	•		\$2.3	LEVEL 4 FRAMING PLAN	E7.1	PANEL SCHEDULES
(LANDS	<u>SCAPE</u>	\$2.4	ROOF FRAMING PLAN	E8.0	ENERGY CODE FORMS
(L1.0	LANDSCAPE PLAN	\$3.1	FOUNDATION DETAILS	E8.1	ENERGY CODE FORMS
L2.0 LANDSCAPED DETAILS		\$3.2	FOUNDATION DETAILS	E9.0	MECHANICAL EQUIPMENT SCHEDULES	
	•		\$3.3	FOUNDATION DETAILS	E9.1	FAULT CURRENT & ARC FLASH SCHEDULES
(<u>ITECTURAL</u>	\$3.4	CONCRETE STUD RAIL DETAILS	E10.0	SPECIFICATIONS
(AD1.1		\$3.5	FOUNDATION DETAILS		
(A0.2	CODE INFORMATION	\$4.0	WOOD FRAMING DETAILS		
7	• A0.3	WALL AND FLOOR-CEILING TYPES	\$4.1	WOOD FRAMING DETAILS		
	, A0.4	WALL AND FLOOR-CEILING TYPES	\$4.2	WOOD FRAMING DETAILS		
(A0.5	FIRE PENETRATIONS	\$4.3	WOOD FRAMING DETAILS		014
(' A1.1	OVERALL SITE PLAN	S5.0	WOOD FRAMING DETAILS		City of Puyallup
7	• A2.1	1ST FLOOR PLAN	\$6.0	ROOF FRAMING DETAILS		Development & Permitting Services
(A2.2	2ND FLOOR PLAN	A A COLL	ANIICAI		ISSUED PERMIT
	A2.3	3RD FLOOR PLAN 4TH FLOOR PLAN		ANICAL CENEDAL NICTES SCHEDILLES AND LECENDS		Building Planning
(A2.4	ROOF PLAN	M1.0	GENERAL NOTES, SCHEDULES AND LEGENDS		
	, A2.5 A2.6	1ST FLOOR REFLECTIVE CEILING PLAN	M1.1 M2.1	GENERAL NOTES, SCHEDULES AND LEGEND 1ST LEVEL FLOOR PLAN - HVAC		Engineering Public Works
(A2.6 A2.7	2ND FLOOR REFLECTIVE CEILING PLAN	M2.1 M2.0	2ND LEVEL FLOOR PLAN - HVAC		_ \
(A2.7 A2.8	3RD FLOOR REFLECTIVE CEILING PLAN	M2.0 M3.0	3RD LEVEL FLOOR PLAN - HVAC		Fire Final Traffic
(A2.0 A2.9	4TH FLOOR REFLECTIVE CEILING PLAN	M4.0	4TH LEVEL FLOOR PLAN - HVAC		
Ò	A2.7	ENLARGED BATH PLANS	M5.0	ROOF PLAN - HVAC		
ĺ	, , \		1410.0	AAFOLIAANIOAL DETANIC		

M6.0 MECHANICAL DETAILS

M7.0 SPECIFICATIONS

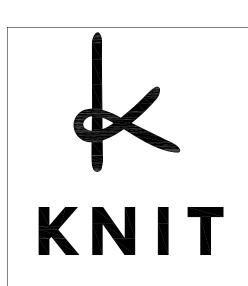

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ISSUE DATE 09/25/23 PROGRESS SET

REV DATE COMMENT **03.03.2023 AC RESPONSE** 08.14.2023 CORRECTIONS **09.25.2023 CORRECTIONS 10.17.2023 CORRECTIONS** 12.21.2023 CORRECTIONS


02.26.2023 CITY REVIEW

COMMENTS



O

JOB NO: **210158**

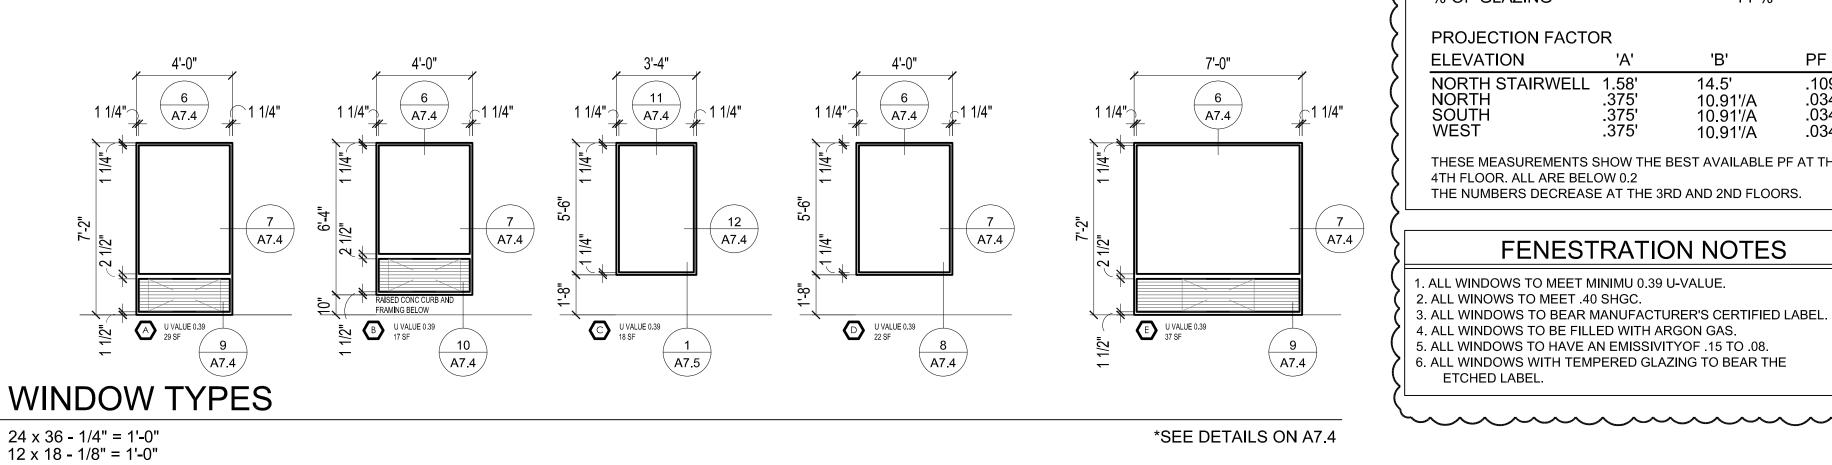

>	GLAZING	WSEC FENESTRATION REQUIREMENTS									
> >	EXTERIOR WALL AREA: 11,094S.F. VERTICAL + OVERHEAD GLAZING: 1,533S.F.	TYPE	MATERIAL	U-FACTOR	DIRECTION	PROJ. FACTOR	T C402.4 SHGC	T C303.1.3(3) VT CLEAR/TINTED	NO. OF UNITS	AREA	TOTAL AREA
>	% OF GLAZING 14 %	А	ALUM	.39	N	<.20	.53	.60/.30	3	29 SF	87 SF
>	PROJECTION FACTOR	А	ALUM	.39	E	<.20	.40	.60/.30	18	29 SF	522 SF
	ELEVATION 'A' 'B' PF	А	ALUM	.39	S	<.20	.40	.60/.30	3	29 SF	87 SF
	NORTH STAIRWELL 1.58' 14.5' .109 NORTH .375' 10.91'/A .034	В	ALUM	.39	E	<.20	.40	.60/.30	3	17 SF	81 SF
	SOUTH .375' 10.91'/A .034 WEST .375' 10.91'/A .034	С	ALUM	.39	N	<.20	.53	.60/.30	3	18 SF	51 SF
	THESE MEASUREMENTS SHOW THE BEST AVAILABLE PF AT THE	D	ALUM	.39	N	<.20	.53	.60/.30	6	22 SF	132 SF
	4TH FLOOR. ALL ARE BELOW 0.2	D	ALUM	.39	E	<.20	.40	.60/.30	3	22 SF	66 SF
إ	THE NUMBERS DECREASE AT THE 3RD AND 2ND FLOORS.	D	ALUM	.39	W	<.20	.40	.60/.30	18	22 SF	396 SF
, 	EENIEGED A TIONI NIGTEO	Е	ALUM	.39	E	<.20	.40	.60/.30	3	37 SF	111 SF
(FENESTRATION NOTES									TOTAL	1,533 SF
\ \	1. ALL WINDOWS TO MEET MINIMU 0.39 U-VALUE.										•

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COMMENTS

RHONDA A. GILLOGLY STATE OF WASHINGTON

SCHEDULE WINDOW

City of Puyallup
Development & Permitting Services
ISSUED PERMIT

Engineering


Fire

Public Works

Traffic

JOB NO: **210158**

A6.2

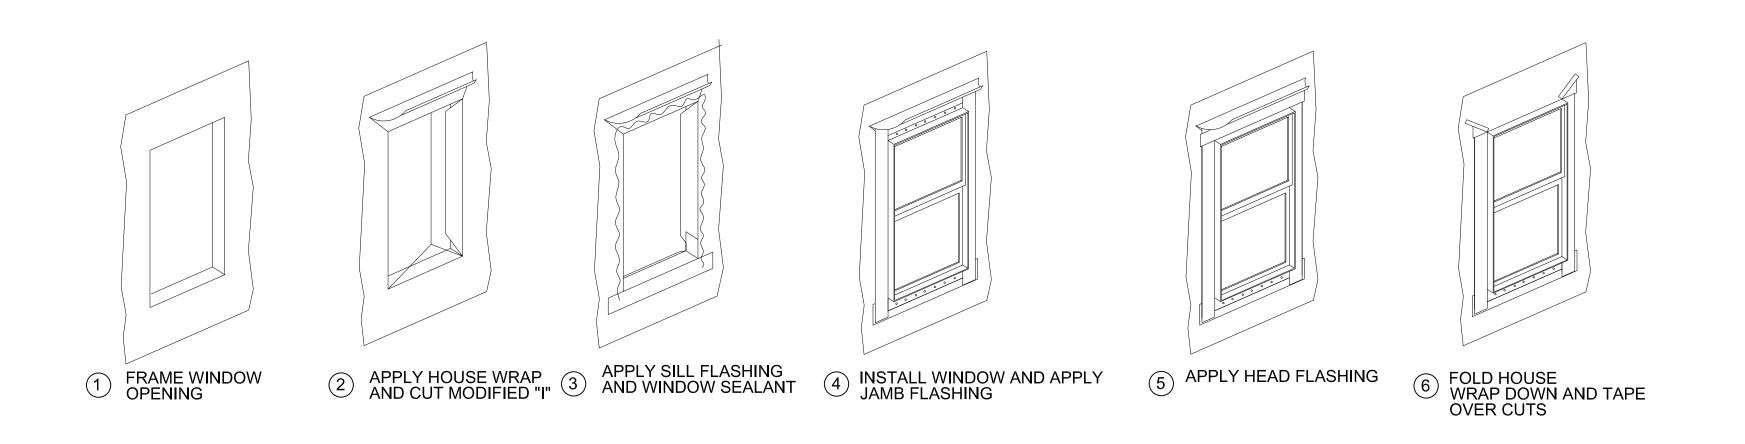

TYP. WINDOW FLASHING APPLICATION FOR STUCCO

REVISION 2 of 2 (4 pages)


B-20-0078


24 x 36 - 1/4" = 1'-0" 12 x 18 - 1/8" = 1'-0"

DETAILS BEING RELOCATED TO A7 SERIES SHEETS

* SEE WEATHERIZATION CONSULTANT SET FOR EIFS FLASHING APPLICATION

ETCHED LABEL.

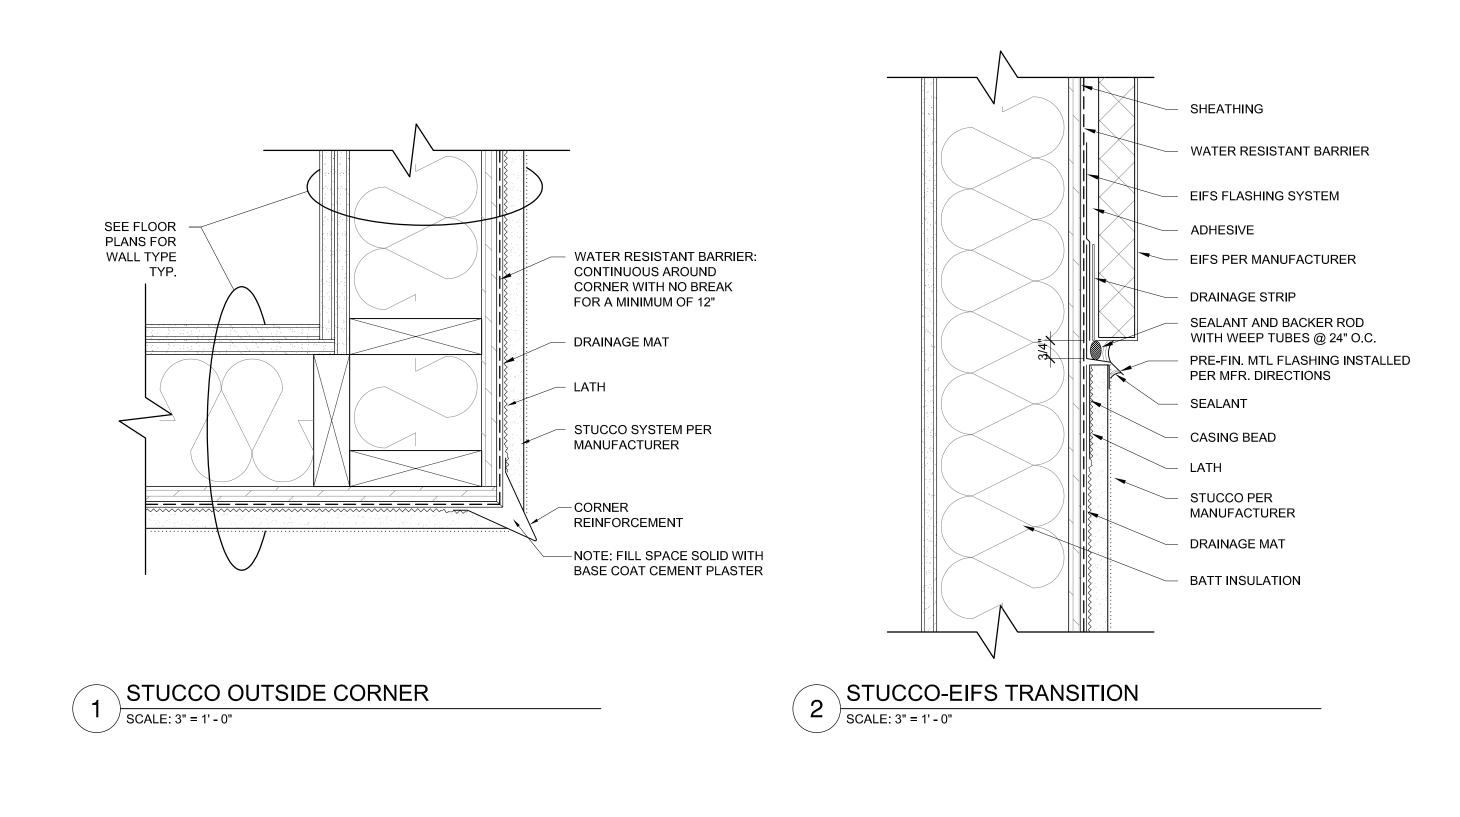


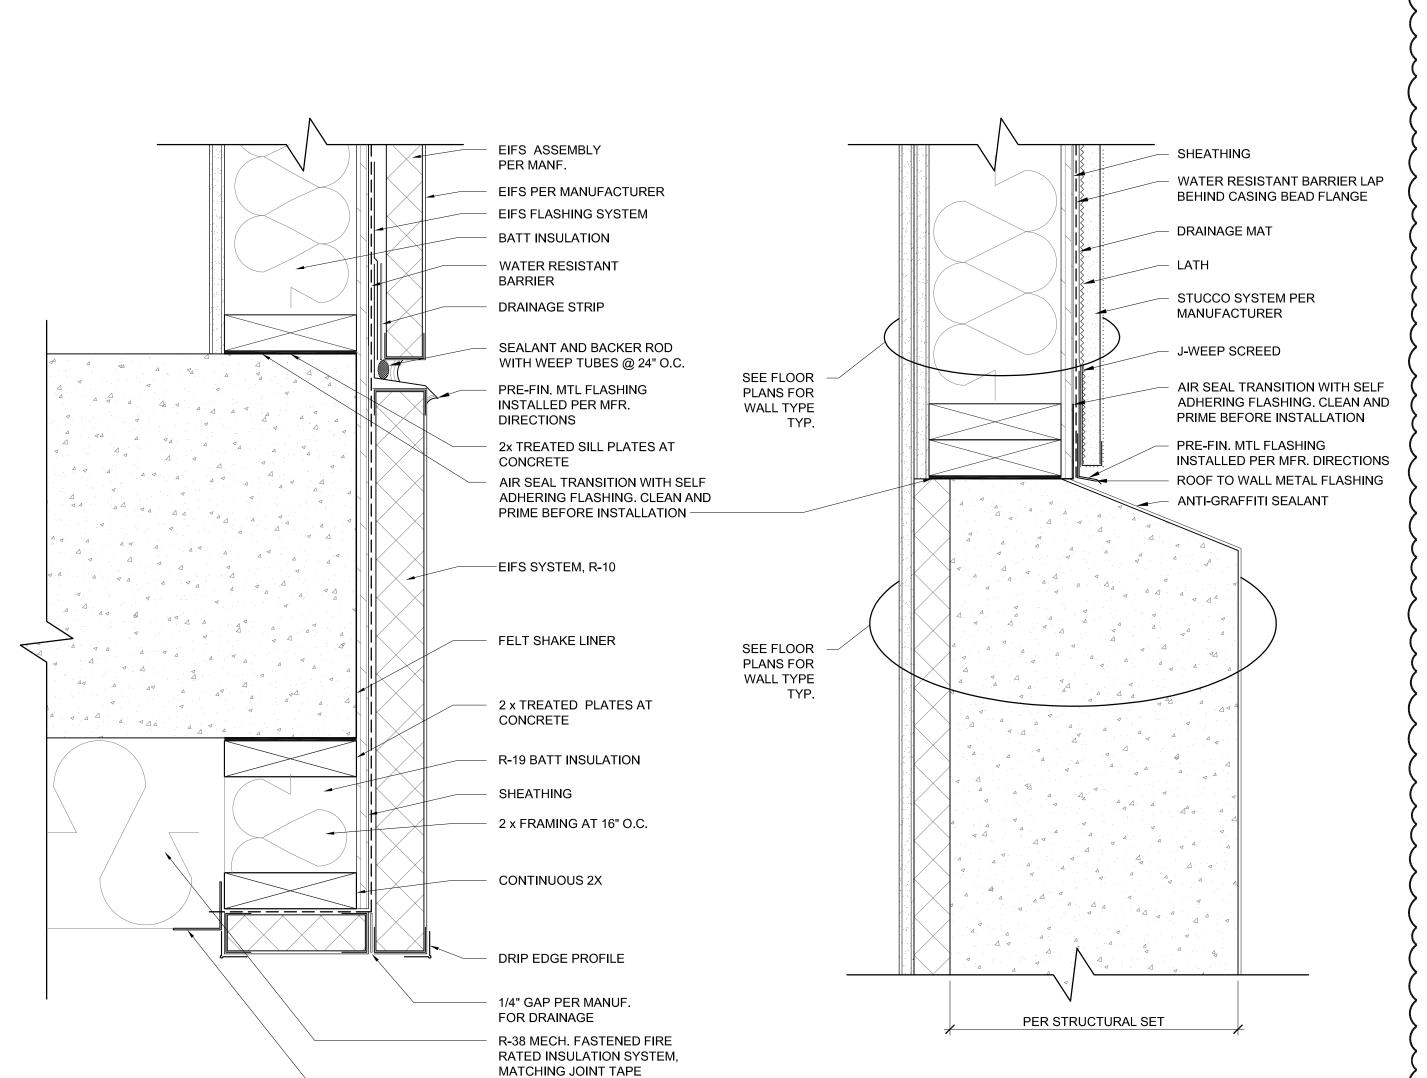


INSULATION FACING

EIFS DRIP @ OVER PARKING

SCALE: 3" = 1' - 0"

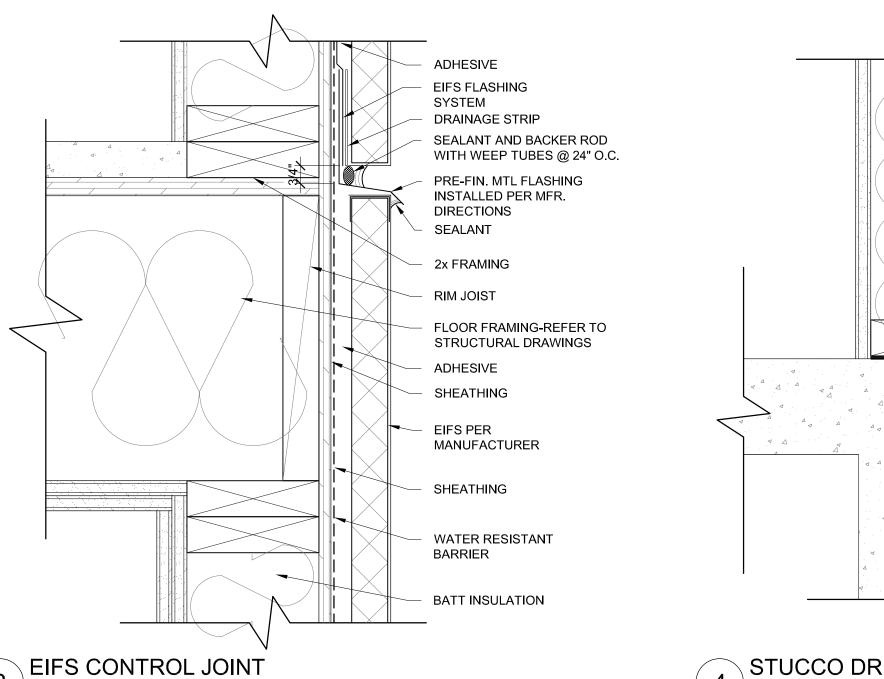

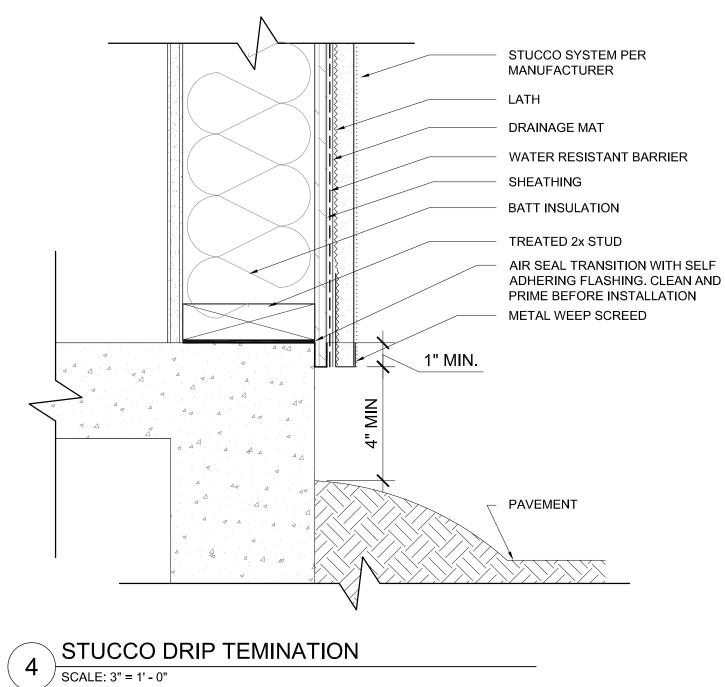

DETAIL REMOVED REFER TO SHEET A7.2

REVISION 2 of 2 (4 pages) B-20-0078

City of Puyallup
Development & Permitting Services
ISSUED PERMIT
Building Planning
Engineering Public Works
Fire Traffic

0 STUCCO @ STAIRS
SCALE: 3" = 1' - 0"

11 ISOMETRIC AT PARAPET

SCALE: 1" = 1'-0"

909 S. 336 TH ST,
SUITE 107
FEDERAL WAY, WA 98003
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4 10.17.2023 CORRECTIONS

5 12.21.2023 CORRECTIONS

6 02.26.2023 CITY REVIEW

COMMENTS



KTERIOR DETAILS
DITION TO HAMPTON INN
SUITES

PROJECT

JOB NO: **210158**

A7.1

