

HealthCare Architecture KL anglois@In sight Design Studio.biz12345 Lake City Way NE #2108 Seattle, WA 98125 206-601-6645

REGISTERED ARCHITECT Larseal Langla's Karsea M. Langlois STATE OF WASHINGTON

MultiCare 🕰 Tacoma General Hospital

OBS Door Relocation

Good Samaritan Hospital 401 15th Ave SE Puyallup, WA 98372

MARK	DATE	DESCRIPTION
	7/20/2023	PERMIT SET


31702

K LANGLOIS

20 JULY 2023

InSight Healthcare Architecture

PROJECT INFO / INDEX / SITE

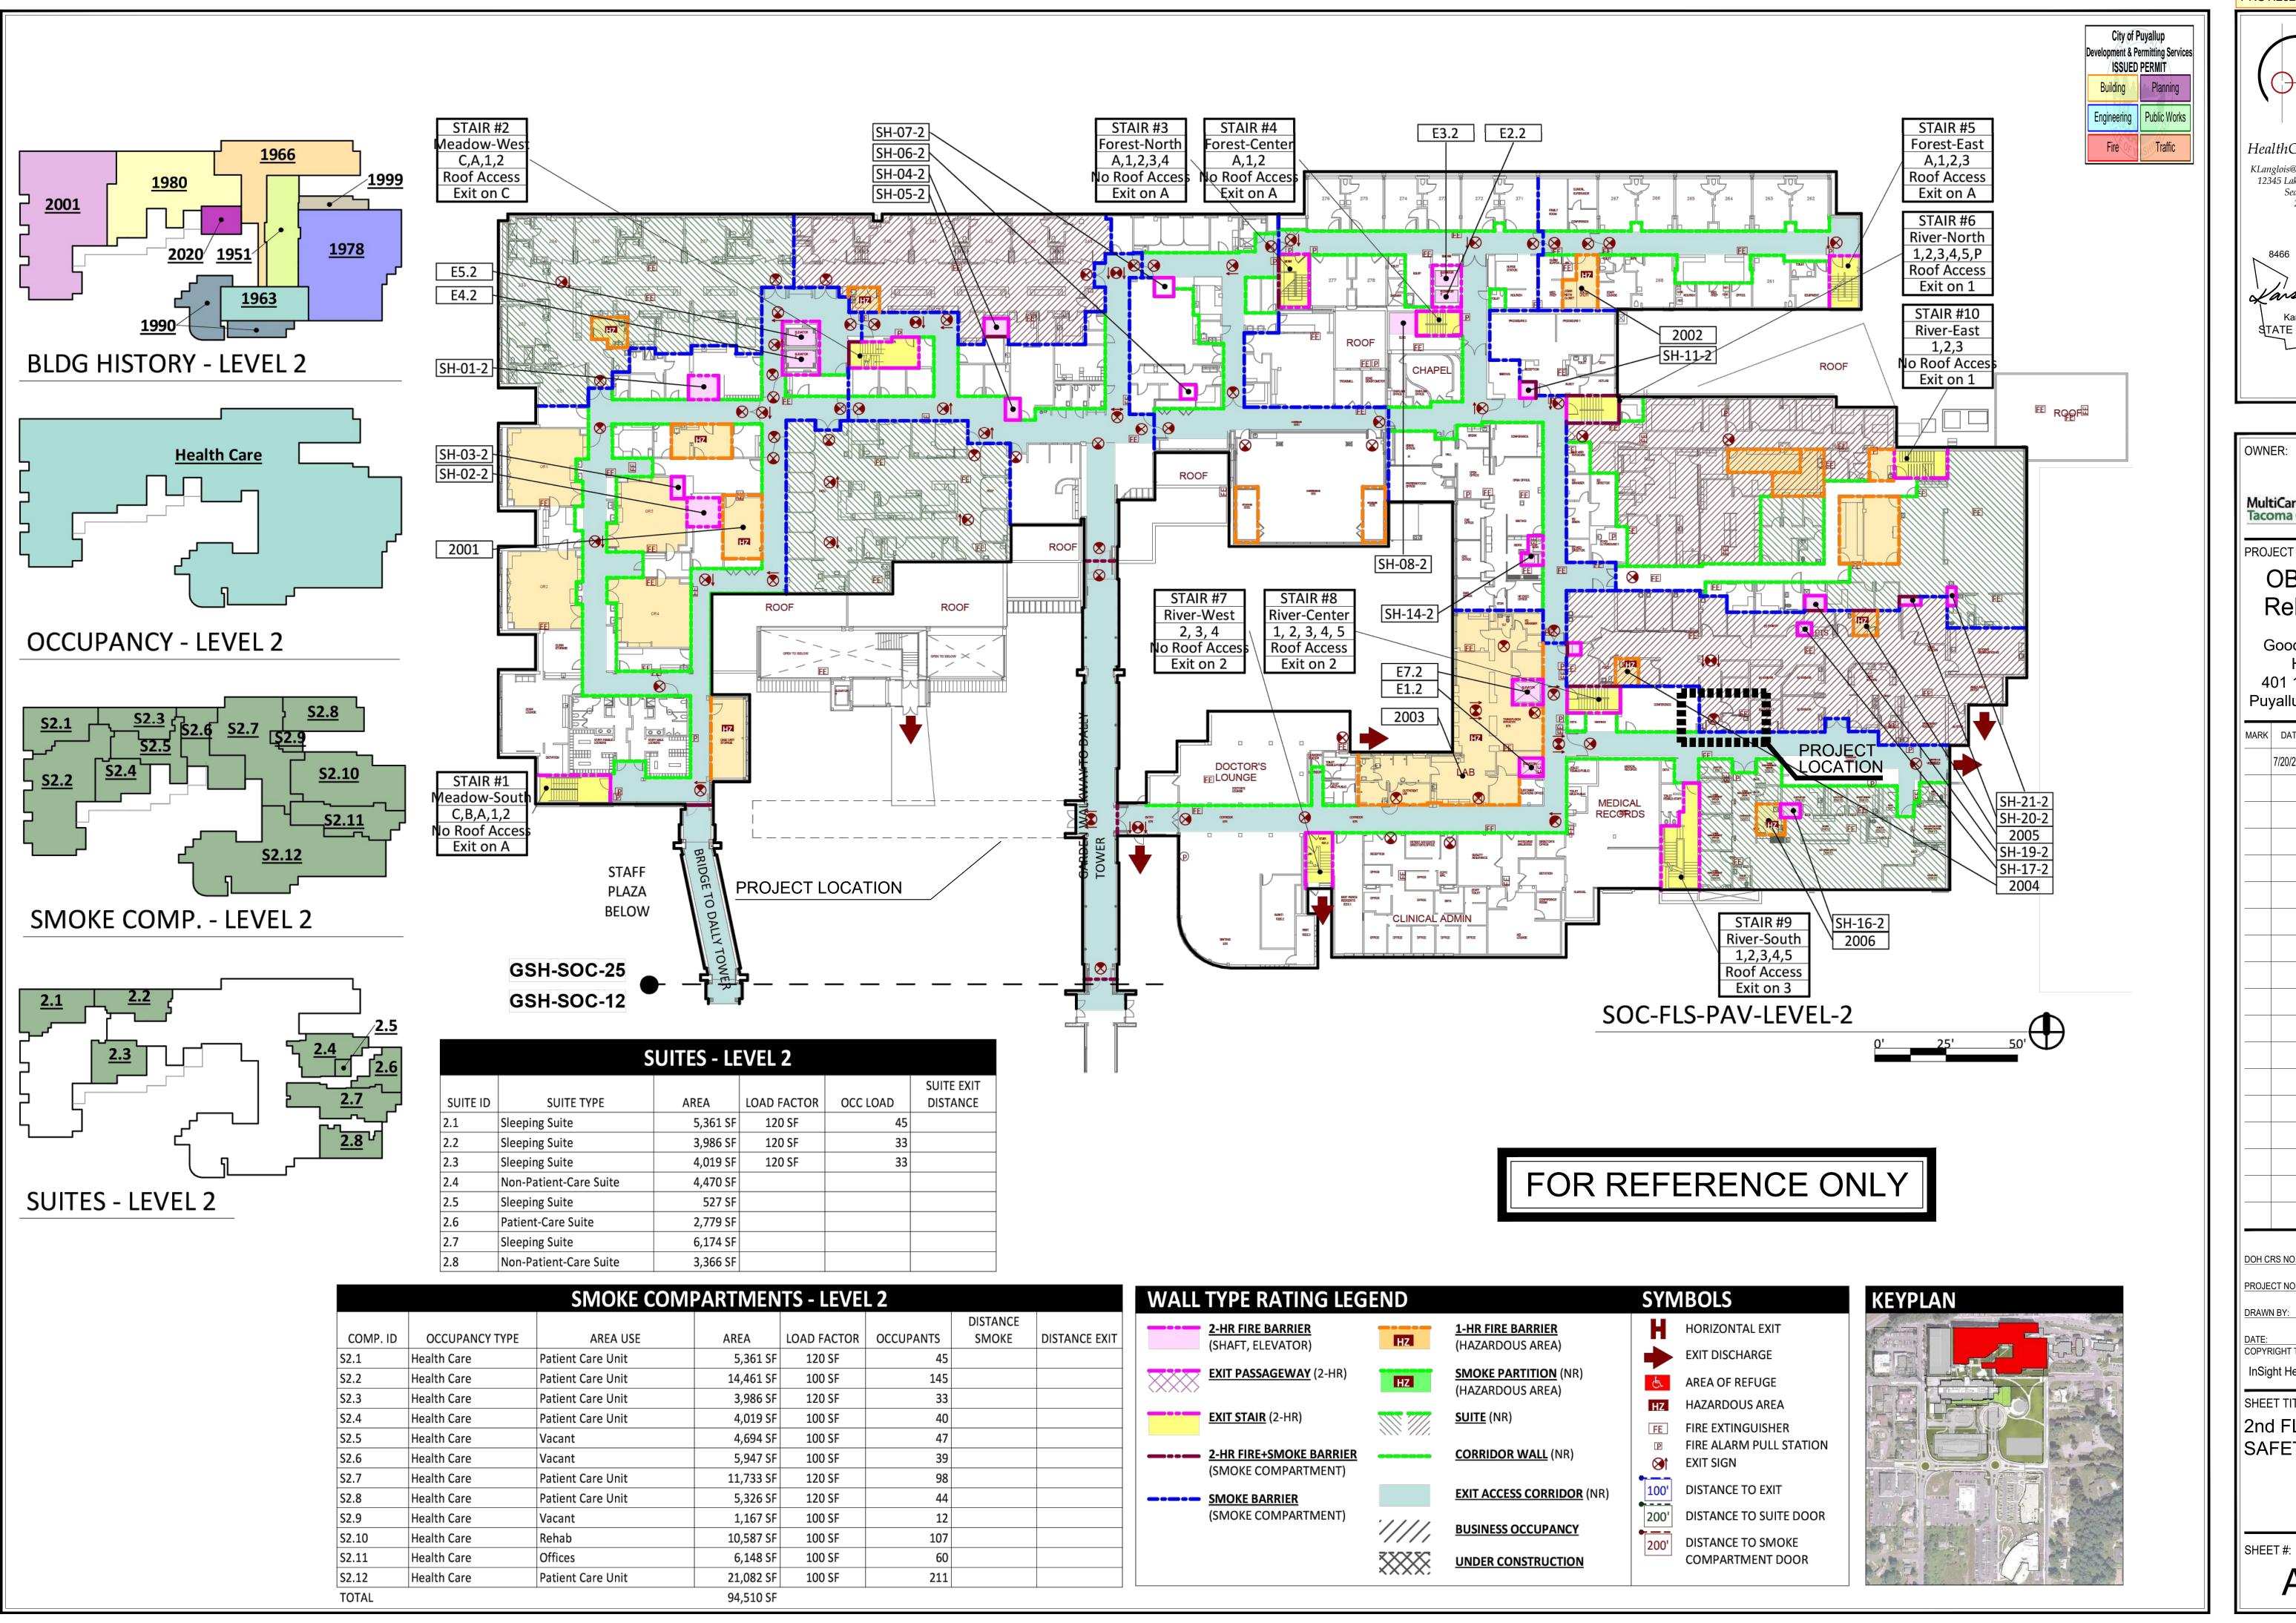




OWNER: MultiCare 🕰 Tacoma General Hospital PROJECT NAME: **OBS** Door Relocation Good Samaritan Hospital 401 15th Ave SE Puyallup, WA 98372 MARK DATE DESCRIPTION PERMIT SET DOH CRS NO. 31702 PROJECT NO. K LANGLOIS DRAWN BY: 20 JULY 2023 DATE: COPYRIGHT TO:

InSight Healthcare Architecture

SHEET TITLE:

2nd FLOOR LIFE SAFETY PLAN

A0.1

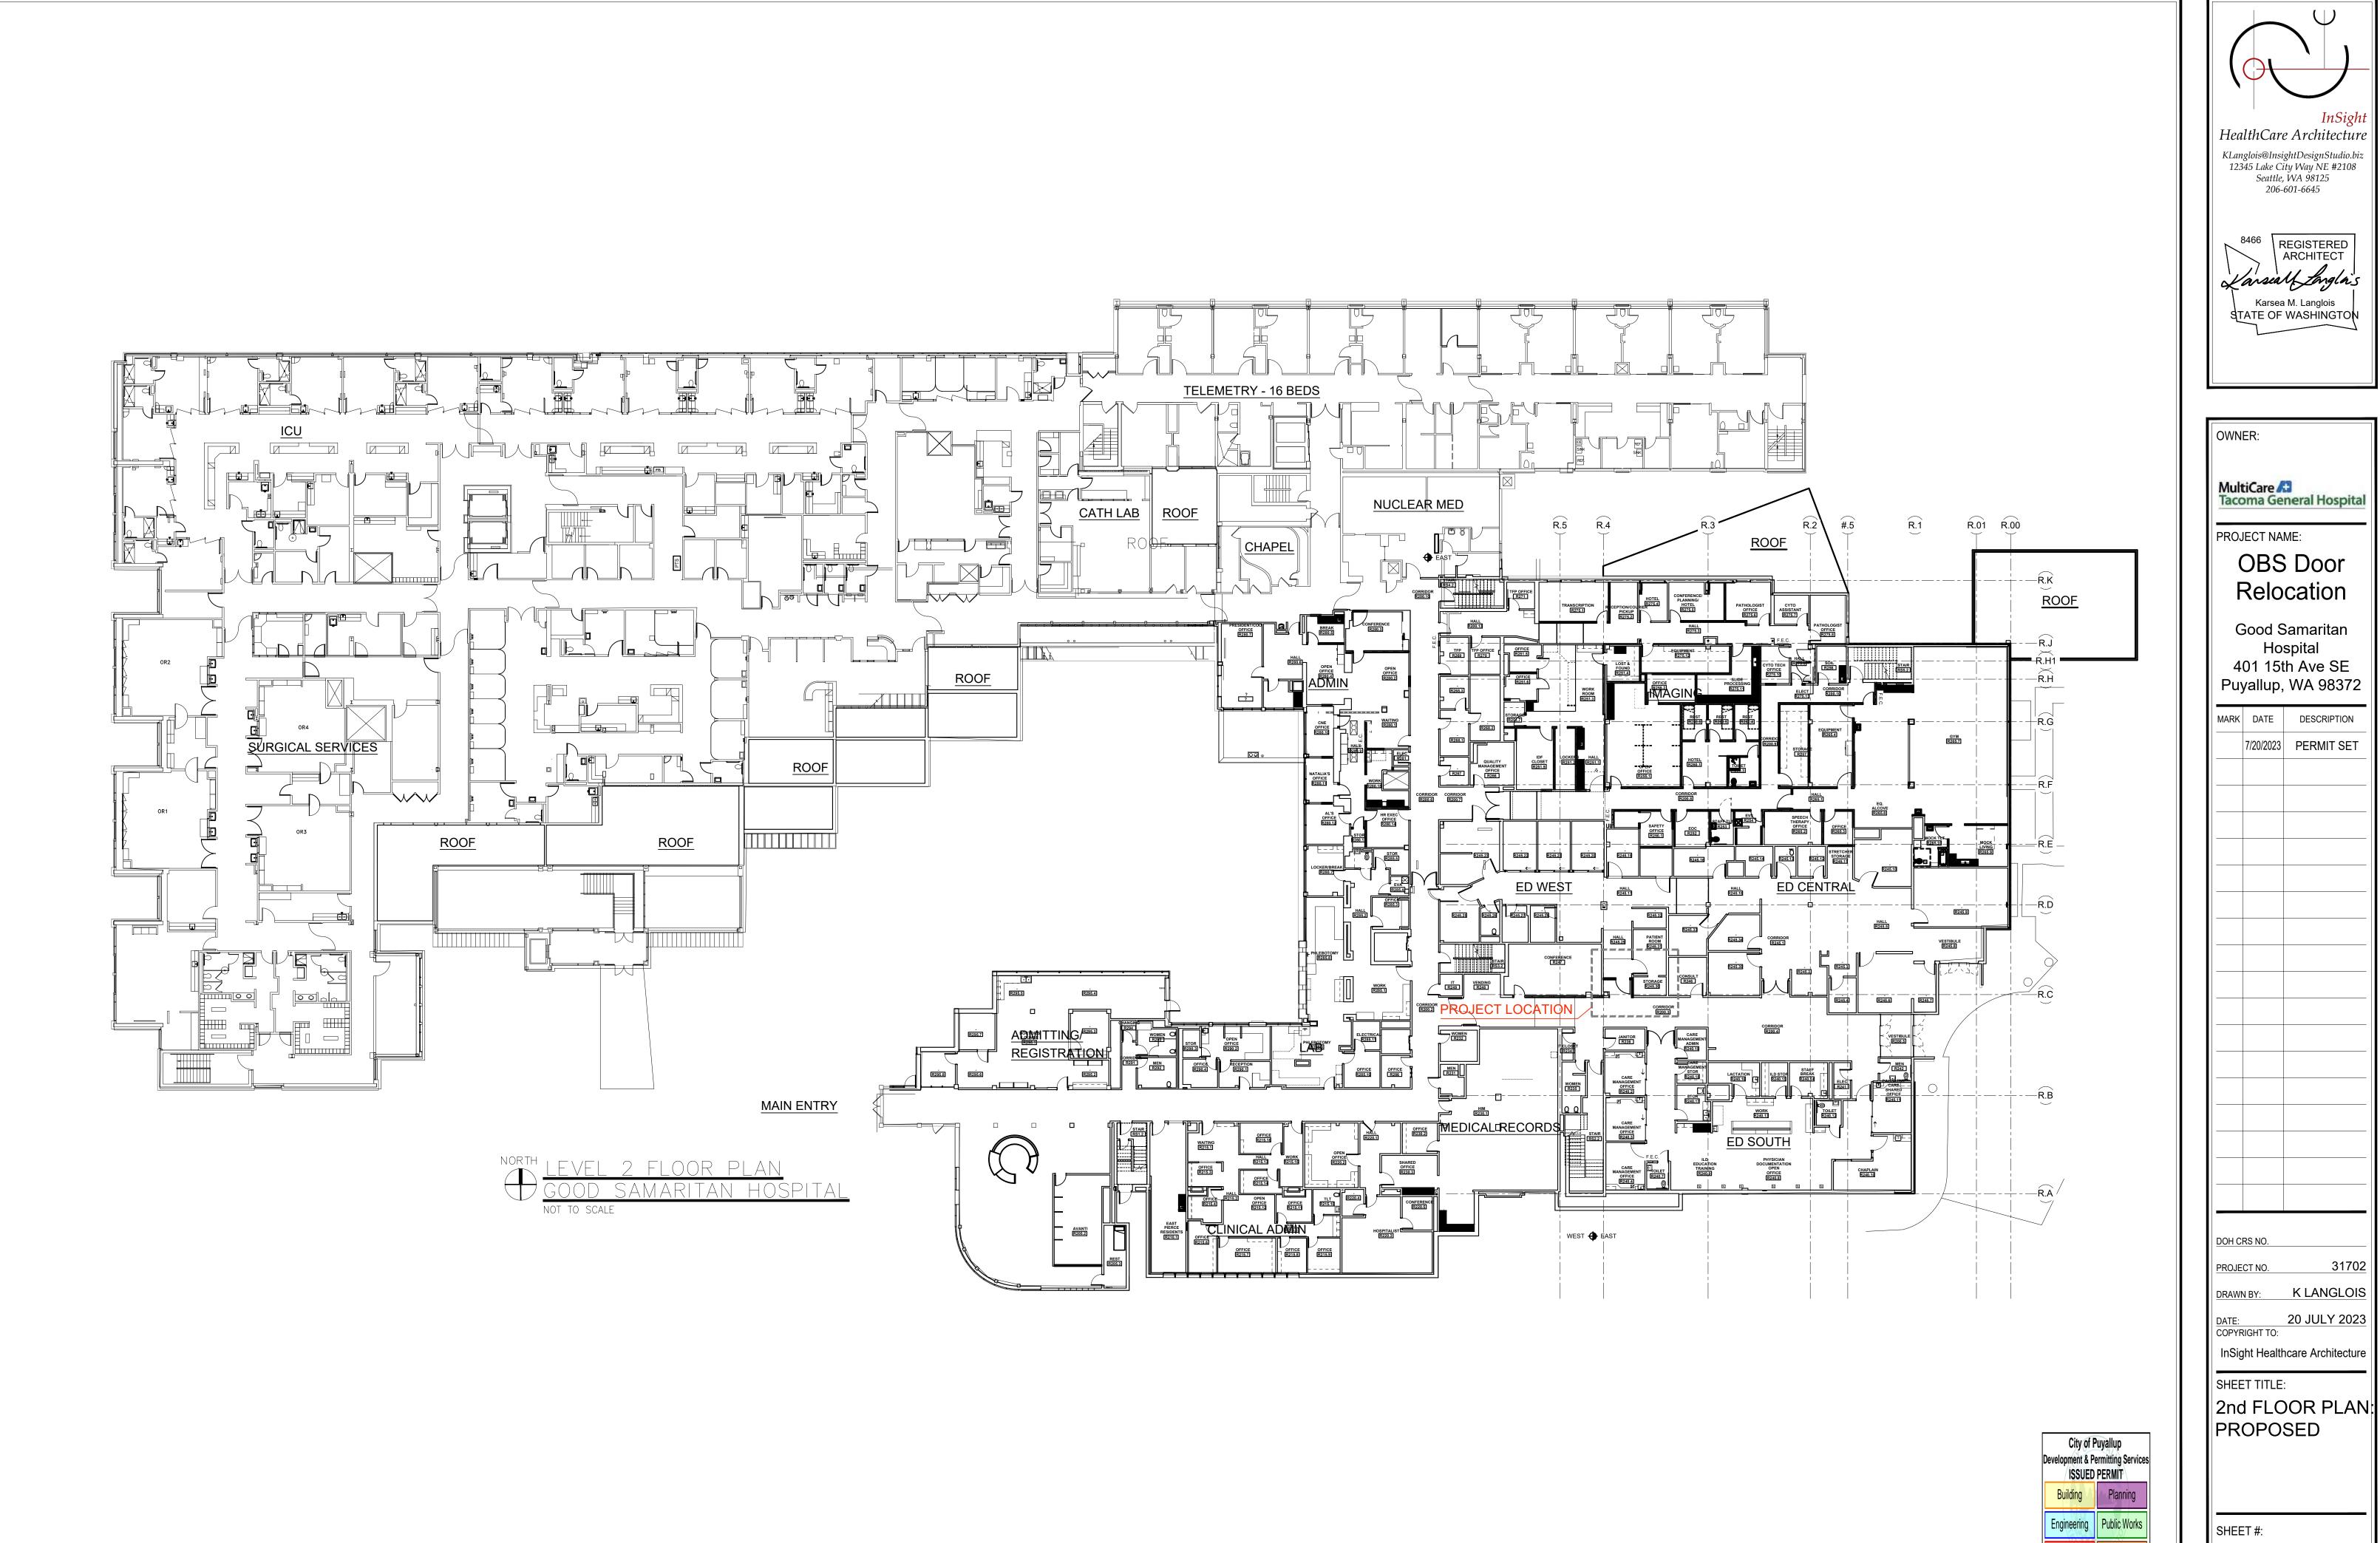



8466 REGISTERED


Karsea M. Langlois STATE OF WASHINGTON

ARCHITECT

OWN	ER:		
PRO.	MultiCare Tacoma General Hospital PROJECT NAME: OBS Door Relocation Good Samaritan		
4		spital :h Ave SE	
Pu	yallup,	WA 98372	
MARK	DATE	DESCRIPTION	
	7/20/2023	PERMIT SET	
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	DOH CRS NO.		
PROJECT NO. 31702			
DRAWN BY: K LANGLOIS			
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SHEET #:

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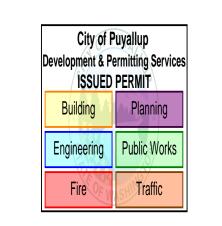


GENERAL NOTES

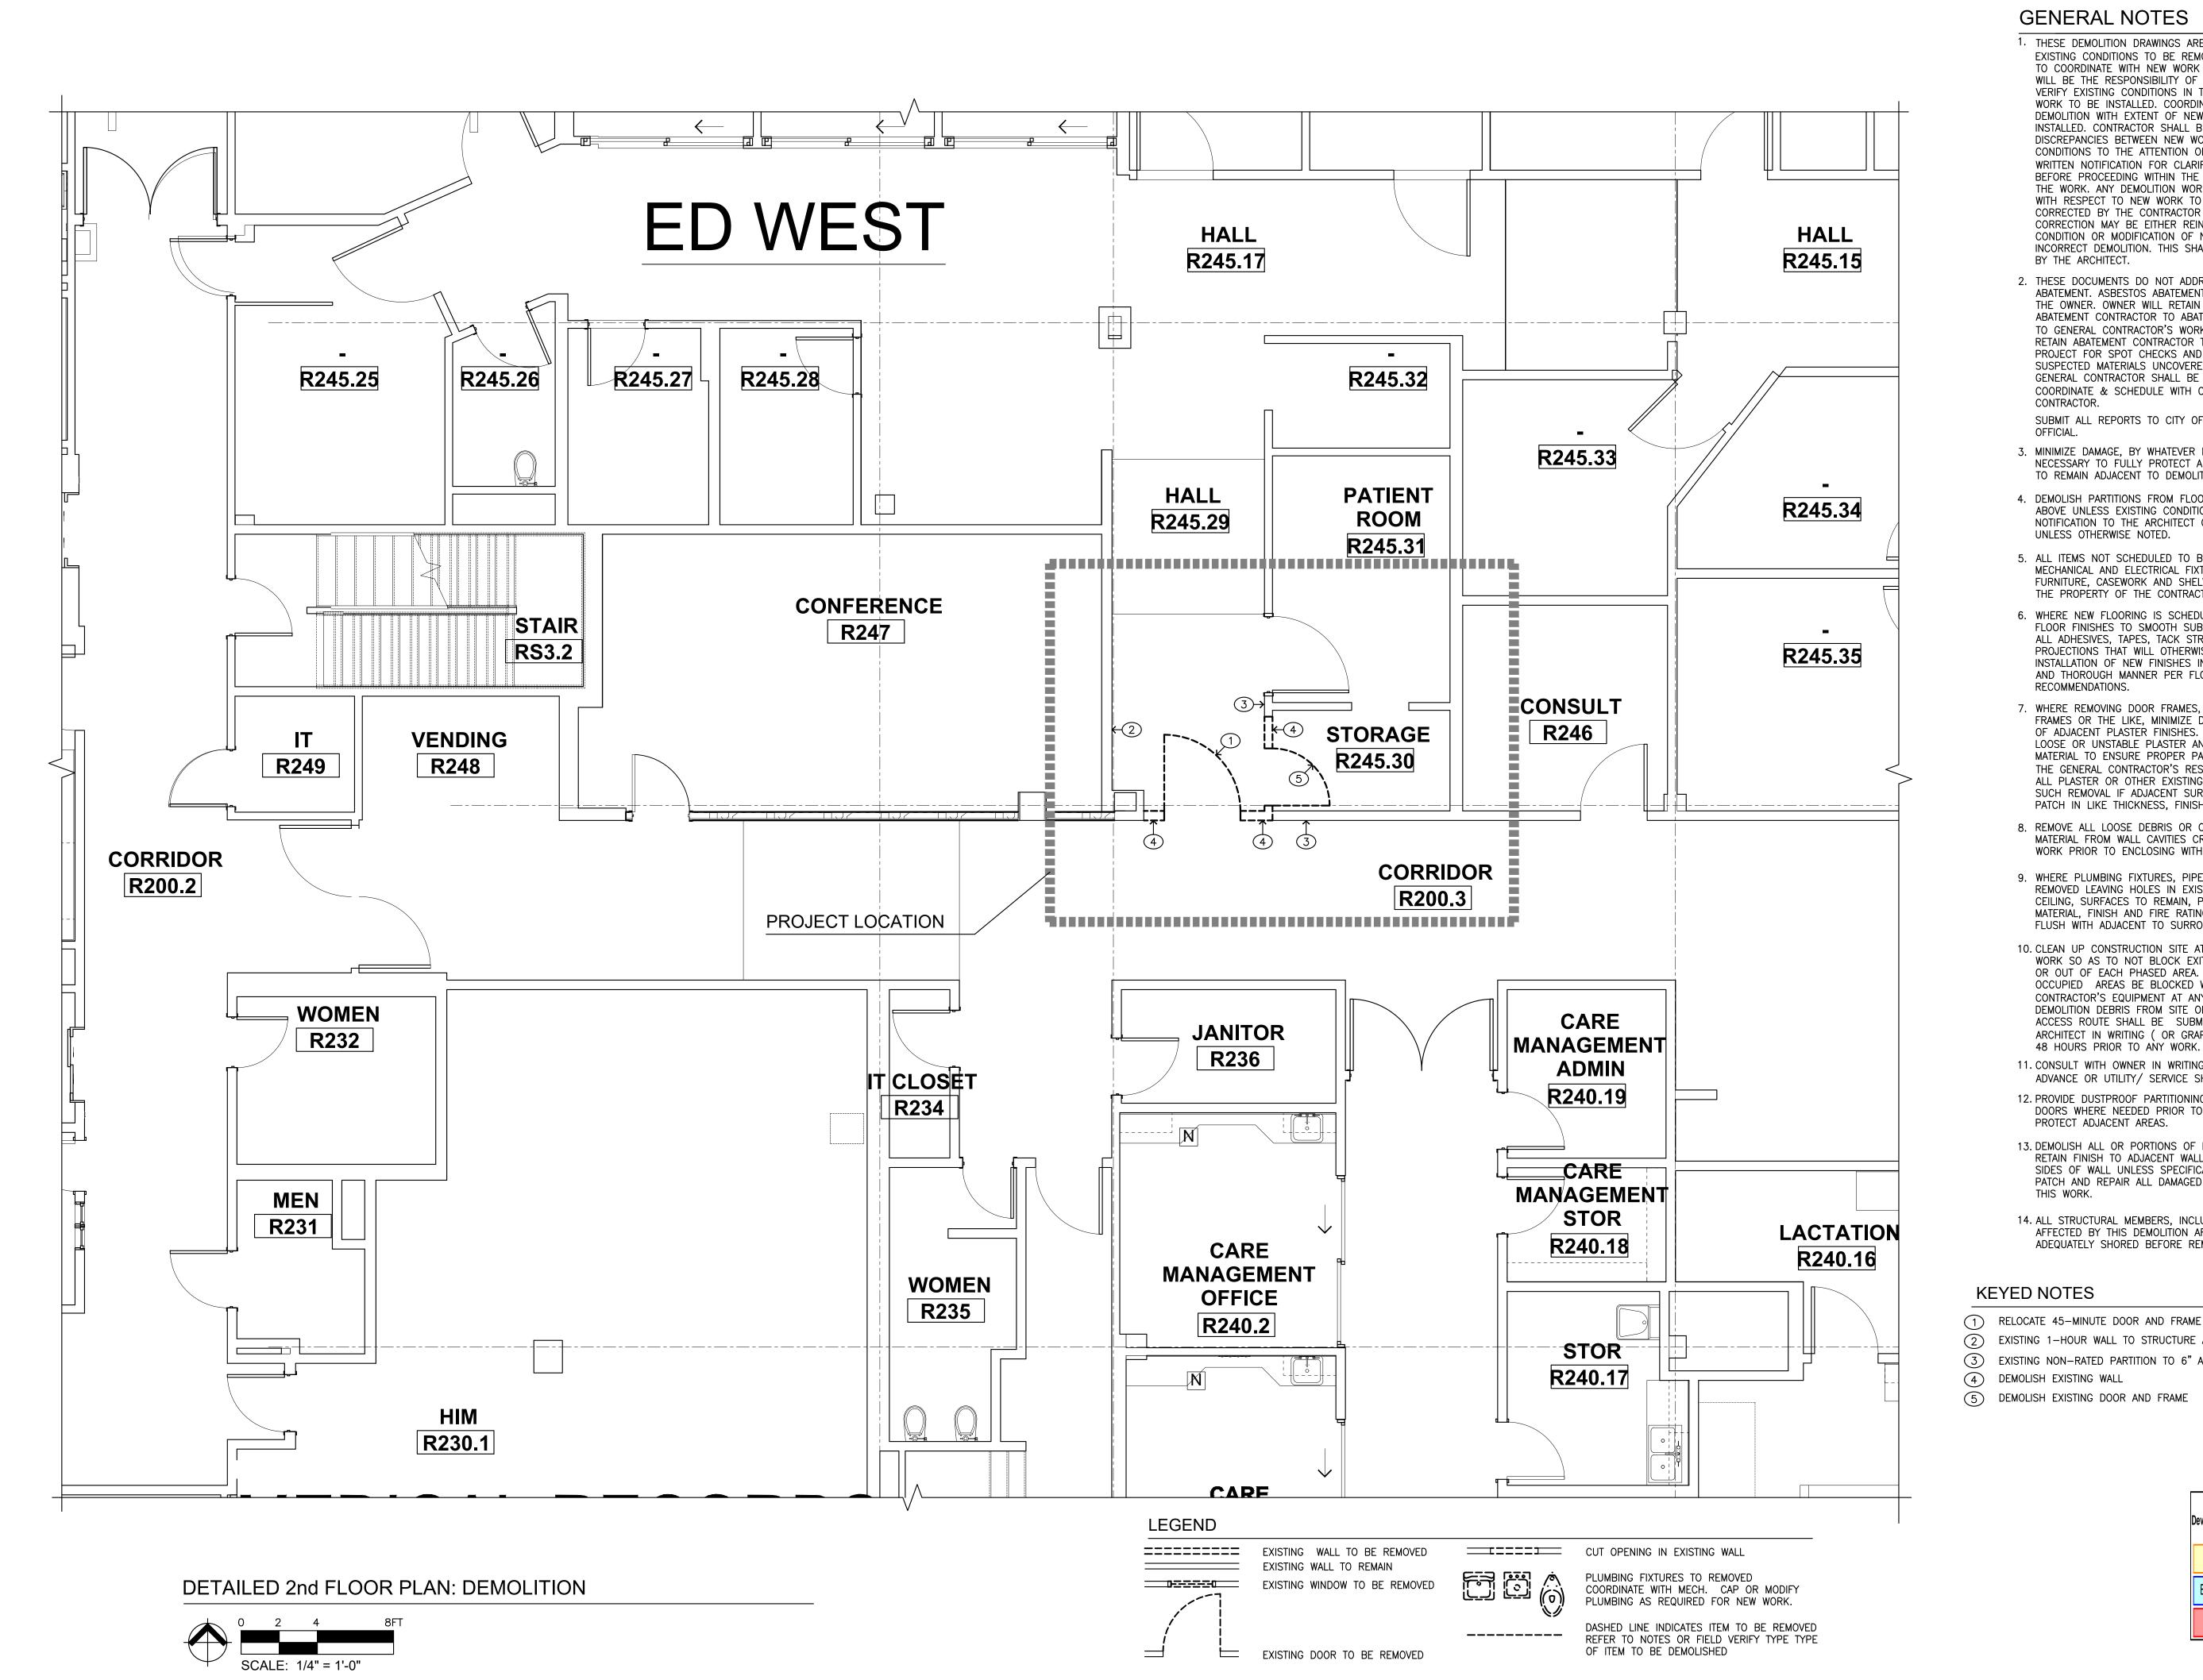- 1. THESE DEMOLITION DRAWINGS ARE INTENDED TO SHOW EXISTING CONDITIONS TO BE REMOVED (OR DEMOLISHED) TO COORDINATE WITH NEW WORK TO BE INSTALLED. IT WILL BE THE RESPONSIBILITY OF THE CONTRACTOR TO VERIFY EXISTING CONDITIONS IN THE FIELD WITH NEW WORK TO BE INSTALLED. COORDINATE ALL EXTENT OF DEMOLITION WITH EXTENT OF NEW WORK TO BE INSTALLED. CONTRACTOR SHALL BRING ALL DISCREPANCIES BETWEEN NEW WORK AND EXISTING CONDITIONS TO THE ATTENTION OF THE ARCHITECT BY WRITTEN NOTIFICATION FOR CLARIFICATION/DECISION BEFORE PROCEEDING WITHIN THE AFFECTED PORTION OF THE WORK. ANY DEMOLITION WORK DONE INCORRECTLY WITH RESPECT TO NEW WORK TO BE DONE SHALL BE CORRECTED BY THE CONTRACTOR AT HIS EXPENSE. CORRECTION MAY BE EITHER REINSTALLATION OF EXISTING CONDITION OR MODIFICATION OF NEW WORK TO REMEDY INCORRECT DEMOLITION. THIS SHALL BE SOLELY JUDGED BY THE ARCHITECT.
- 2. THESE DOCUMENTS DO NOT ADDRESS ASBESTOS ABATEMENT. ASBESTOS ABATEMENT WILL BE HANDLED BY THE OWNER. OWNER WILL RETAIN A CERTIFIED ASBESTOS ABATEMENT CONTRACTOR TO ABATE EACH PHASE PRIOR TO GENERAL CONTRACTOR'S WORK. OWNER WILL ALSO RETAIN ABATEMENT CONTRACTOR THROUGHOUT THE PROJECT FOR SPOT CHECKS AND VERIFICATION OF SUSPECTED MATERIALS UNCOVERED DURING DEMOLITION. GENERAL CONTRACTOR SHALL BE REQUIRED TO COORDINATE & SCHEDULE WITH OWNER'S ABATEMENT

SUBMIT ALL REPORTS TO CITY OF PUYALLUP BUILDING

- 3. MINIMIZE DAMAGE, BY WHATEVER MEANS DEEMED NECESSARY TO FULLY PROTECT ALL EXISTING SURFACES TO REMAIN ADJACENT TO DEMOLITION WORK.
- 4. DEMOLISH PARTITIONS FROM FLOOR TO STRUCTURAL DECK ABOVE UNLESS EXISTING CONDITIONS WARRANT NOTIFICATION TO THE ARCHITECT OF OTHER EXTENT OR UNLESS OTHERWISE NOTED.
- 5. ALL ITEMS NOT SCHEDULED TO BE REUSED SUCH AS MECHANICAL AND ELECTRICAL FIXTURES, EQUIPMENT, FURNITURE, CASEWORK AND SHELVING SHALL BECOME THE PROPERTY OF THE CONTRACTOR.
- 6. WHERE NEW FLOORING IS SCHEDULED REMOVE ALL FLOOR FINISHES TO SMOOTH SUBSTRATE BELOW. REMOVE ALL ADHESIVES, TAPES, TACK STRIPS, AND OTHER PROJECTIONS THAT WILL OTHERWISE PREVENT THE INSTALLATION OF NEW FINISHES IN A NEAT, COMPLETE AND THOROUGH MANNER PER FLOORING MANUFACTURERS RECOMMENDATIONS.
- 7. WHERE REMOVING DOOR FRAMES, WINDOW/ RELITE FRAMES OR THE LIKE, MINIMIZE DAMAGE TO OR REMOVAL OF ADJACENT PLASTER FINISHES. REMOVE, HOWEVER, ALL LOOSE OR UNSTABLE PLASTER AND STRUCTURAL MATERIAL TO ENSURE PROPER PATCH WORK. IT SHALL BE THE GENERAL CONTRACTOR'S RESPONSIBILITY TO PATCH ALL PLASTER OR OTHER EXISTING FINISHES ADJACENT TO SUCH REMOVAL IF ADJACENT SURFACES ARE TO REMAIN. PATCH IN LIKE THICKNESS, FINISH.
- 8. REMOVE ALL LOOSE DEBRIS OR OTHERWISE UNNECESSARY MATERIAL FROM WALL CAVITIES CREATED BY DEMOLITION WORK PRIOR TO ENCLOSING WITH NEW FINISHES.
- 9. WHERE PLUMBING FIXTURES, PIPES OR CONDUITS ARE REMOVED LEAVING HOLES IN EXISTING FLOOR, WALLS OR CEILING, SURFACES TO REMAIN, PATCH HOLES WITH SAME MATERIAL. FINISH AND FIRE RATING. SO AS TO LOOK FLUSH WITH ADJACENT TO SURROUNDING SURFACES.
- 10. CLEAN UP CONSTRUCTION SITE AT END OR EACH DAY'S WORK SO AS TO NOT BLOCK EXIT PATHS OR ACCESS IN OR OUT OF EACH PHASED AREA. IN NO CASE SHALL OCCUPIED AREAS BE BLOCKED WITH TOOLS, DEBRIS OR CONTRACTOR'S EQUIPMENT AT ANYTIME. DISPOSE OF DEMOLITION DEBRIS FROM SITE ON A DAILY BASIS. ACCESS ROUTE SHALL BE SUBMITTED TO OWNER AND ARCHITECT IN WRITING (OR GRAPHICALLY) FOR REVIEW
- 11. CONSULT WITH OWNER IN WRITING TEN (10) DAYS IN ADVANCE OR UTILITY/ SERVICE SHUTDOWNS.
- 12. PROVIDE DUSTPROOF PARTITIONING AND TEMPORARY DOORS WHERE NEEDED PRIOR TO DEMOLITION TO PROTECT ADJACENT AREAS.
- 13. DEMOLISH ALL OR PORTIONS OF EXISTING WALLS SHOWN. RETAIN FINISH TO ADJACENT WALL SURFACES, BOTH SIDES OF WALL UNLESS SPECIFICALLY NOTED TO REMOVE. PATCH AND REPAIR ALL DAMAGED AREAS AFFECTED BY
- 14. ALL STRUCTURAL MEMBERS, INCLUDING BEARING WALLS, AFFECTED BY THIS DEMOLITION ARE TO BE VERIFIED AND ADEQUATELY SHORED BEFORE REMOVAL.
- (1) RELOCATE 45-MINUTE DOOR AND FRAME
- 2 EXISTING 1-HOUR WALL TO STRUCTURE ABOVE
- (3) EXISTING NON-RATED PARTITION TO 6" ABOVE ACT CEILING
- 4) DEMOLISH EXISTING WALL
- (5) DEMOLISH EXISTING DOOR AND FRAME



PRCTI20240555

HealthCare Architecture

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OWNER:

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PROJECT NAME:

OBS Door Relocation

Good Samaritan Hospital 401 15th Ave SE Puyallup, WA 98372

MARK DATE DESCRIPTION

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DOH CRS NO.

31702 PROJECT NO.

K LANGLOIS DRAWN BY:

20 JULY 2023 COPYRIGHT TO:


InSight Healthcare Architecture

SHEET TITLE:

DETAILED 2nd FLOOR PLAN: DEMOLITION

SHEET #:

A1.

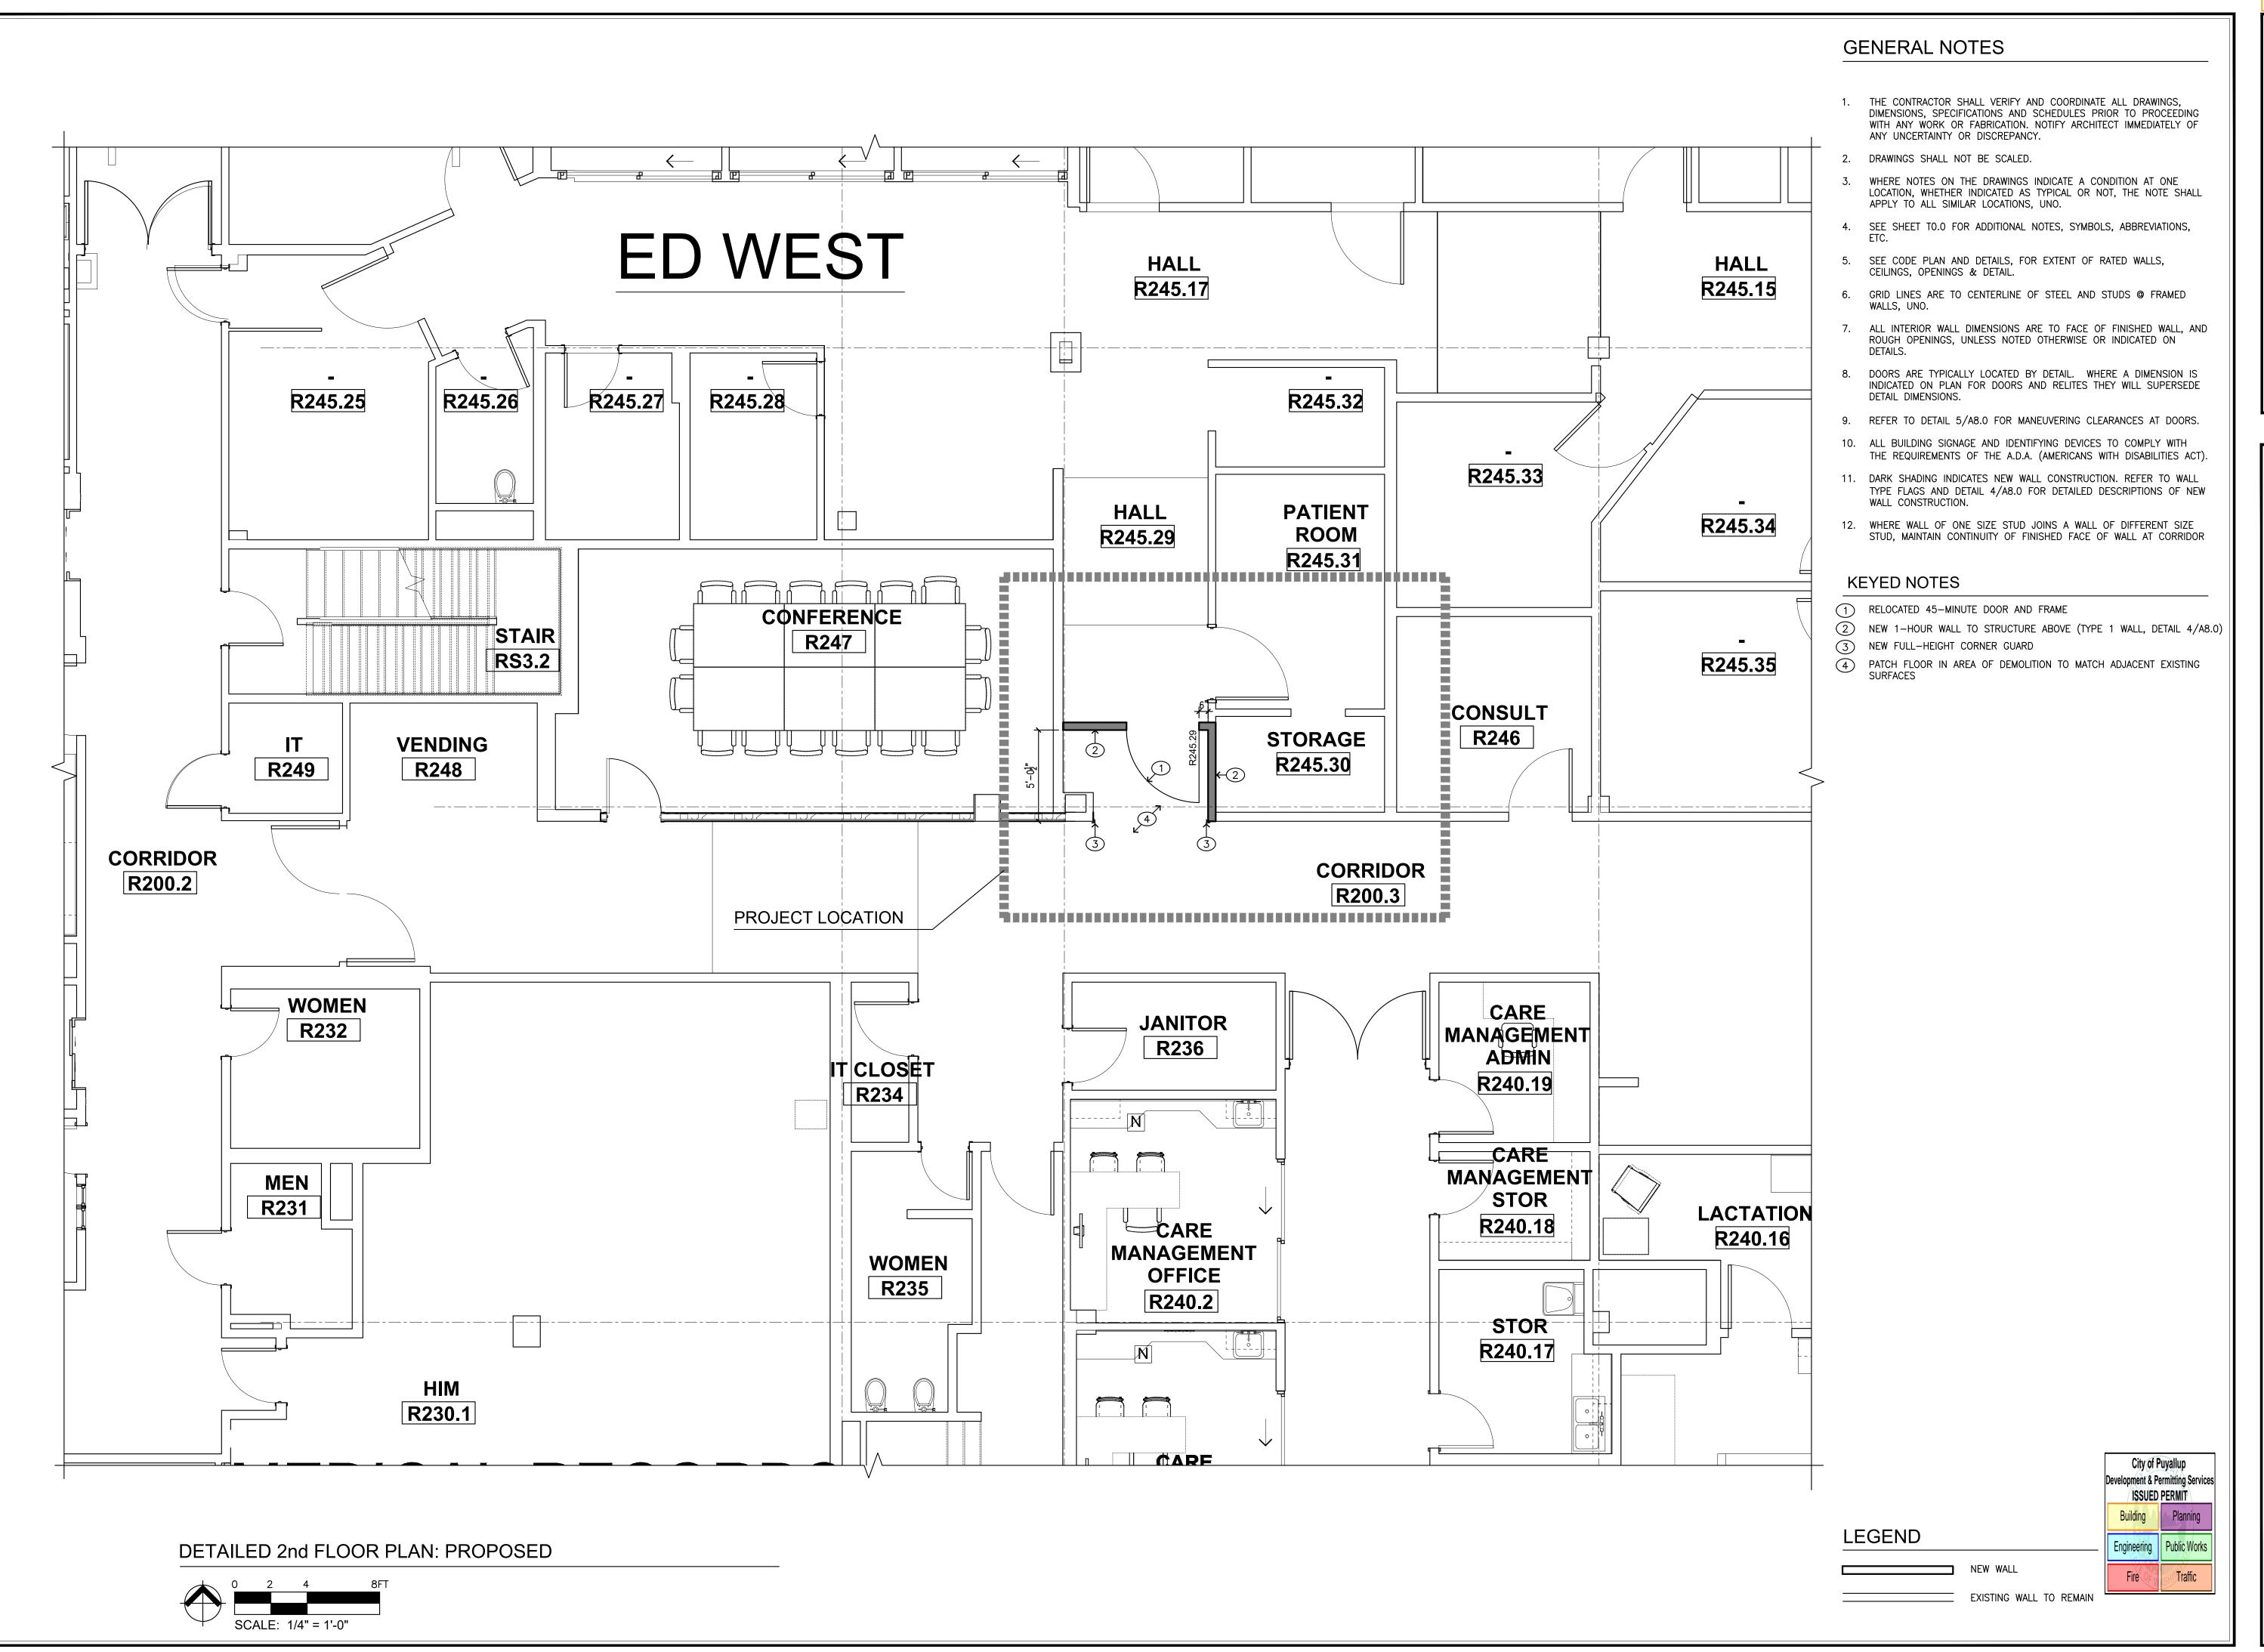

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8466 REGISTERED ARCHITECT Karsea M. Langlois \$TATE OF WASHINGTON

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MARK	DATE	DESCRIPTION
	7/20/2023	PERMIT SET
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	CT NO.	3170

K LANGLOIS


20 JULY 2023 DATE: COPYRIGHT TO:

InSight Healthcare Architecture

SHEET TITLE: DETAILED 2nd FLOOR PLAN: PROPOSED

SHEET #:

A2.1

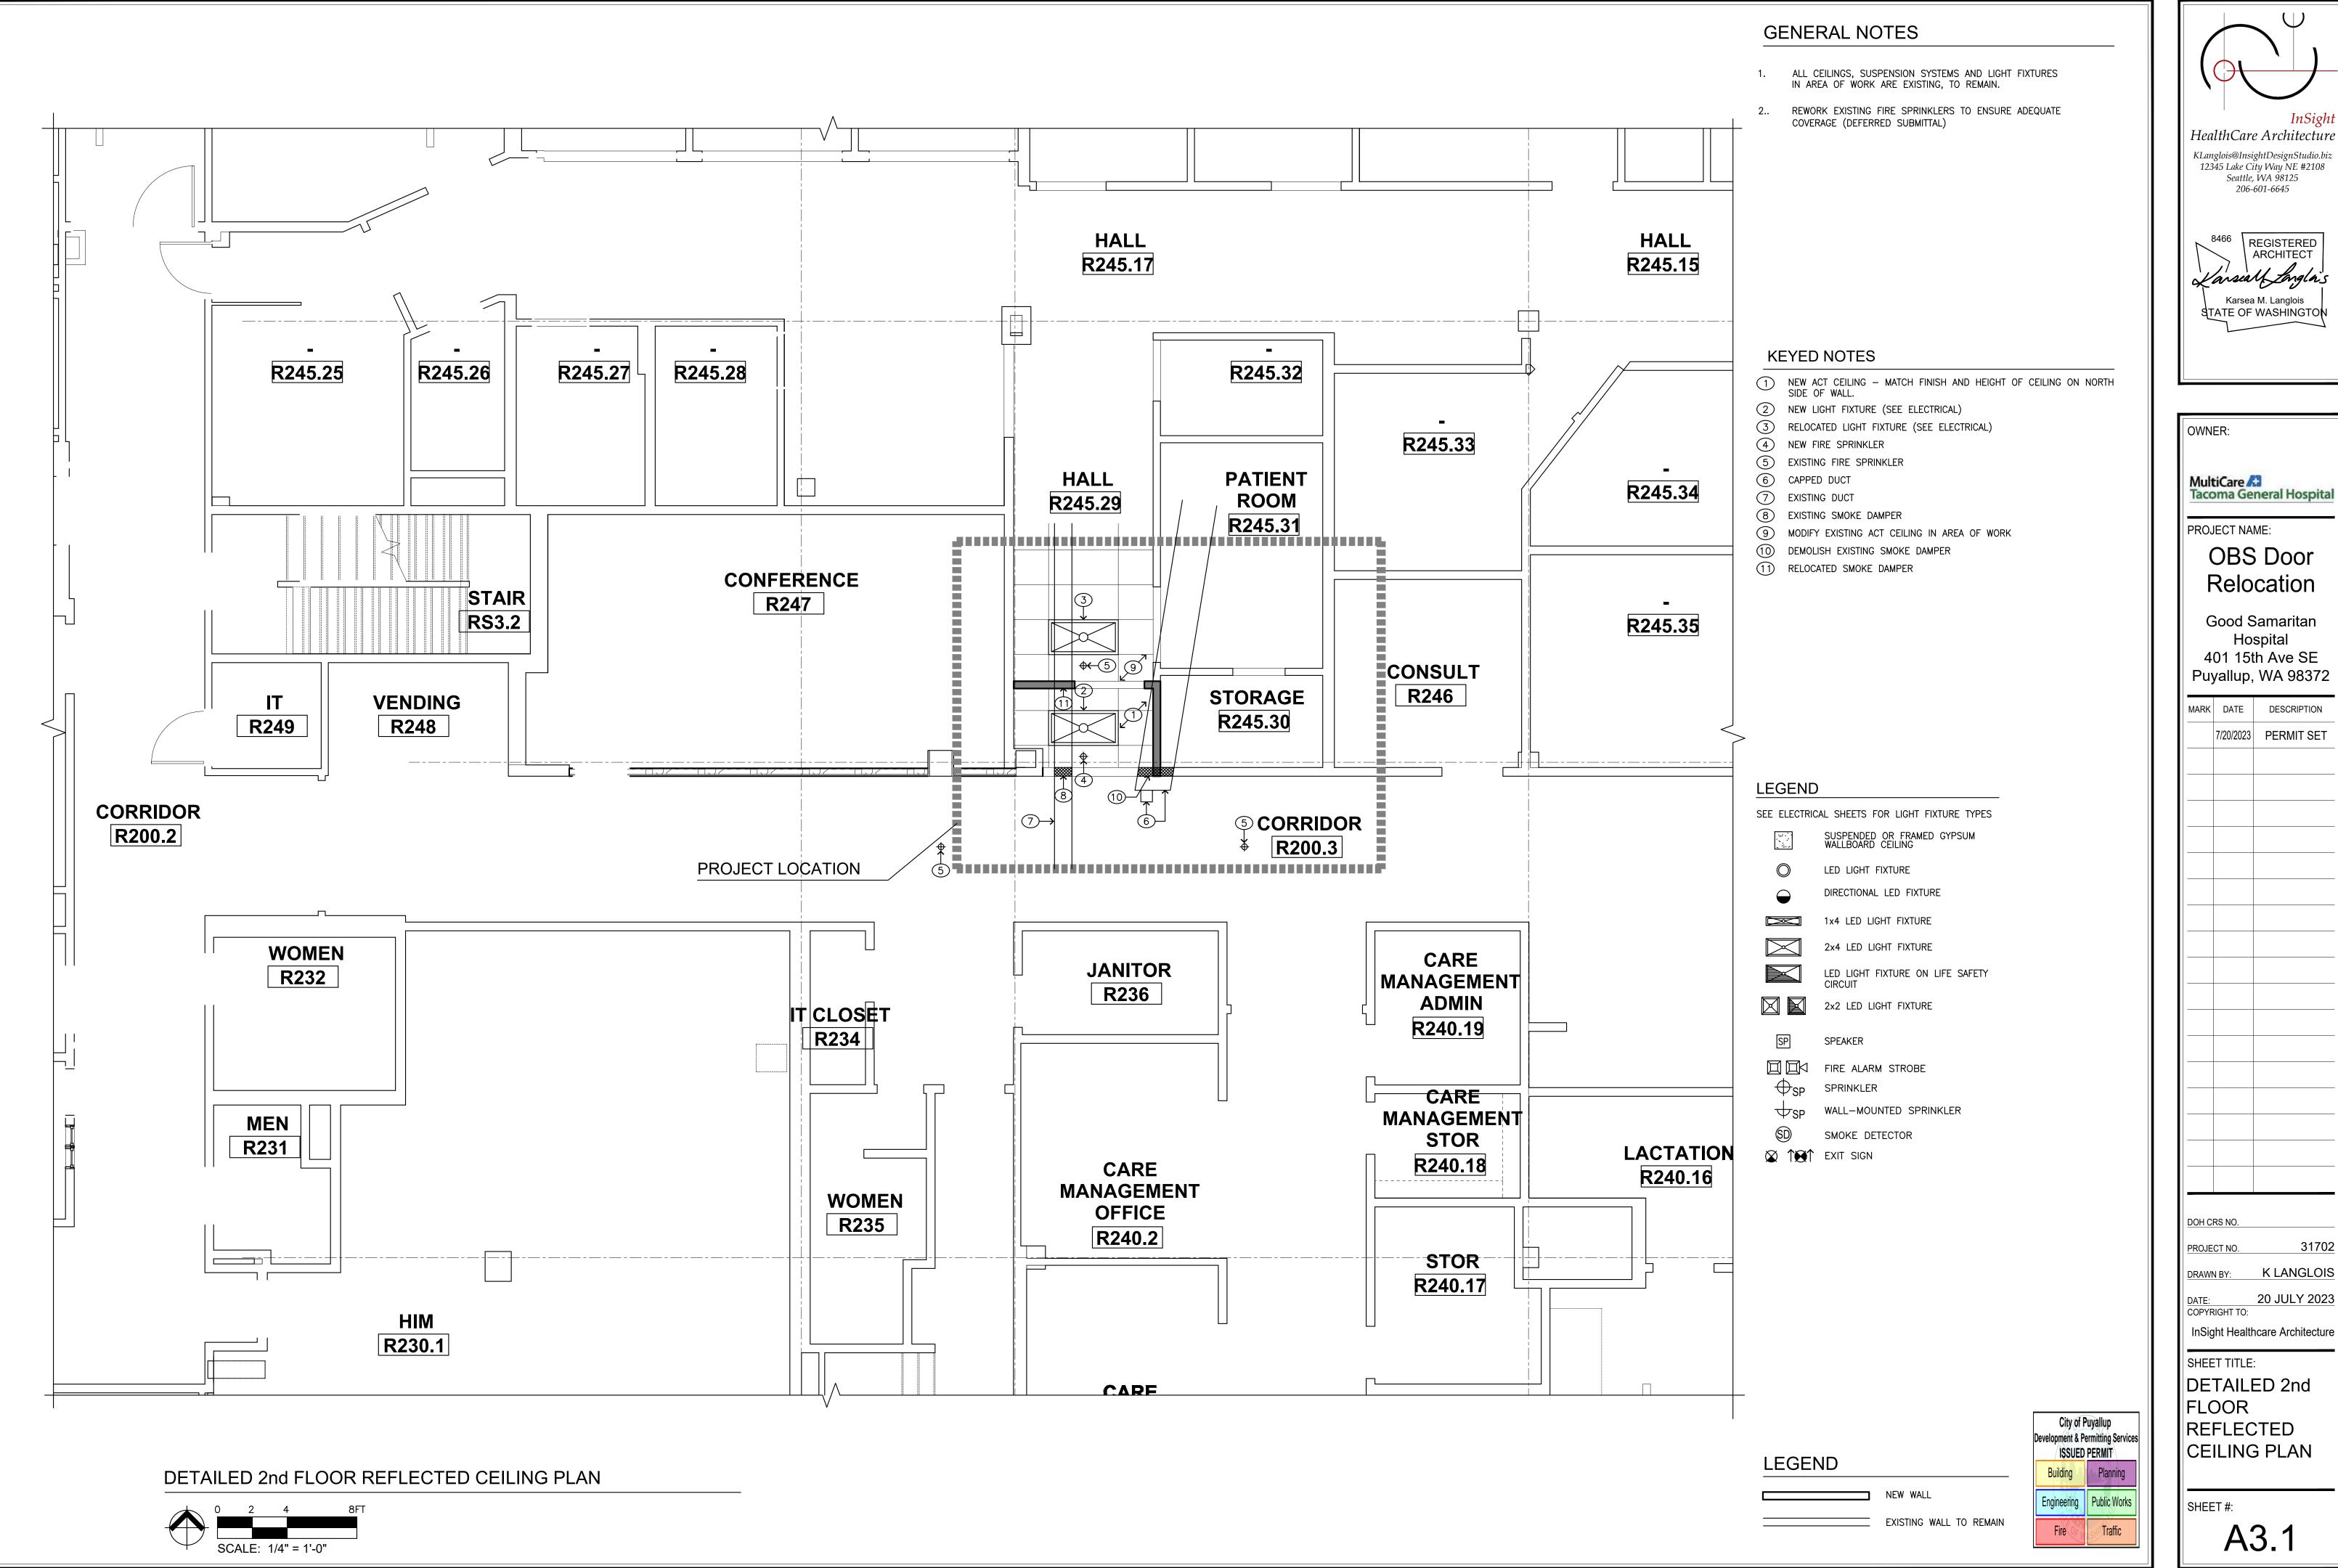

HealthCare Architecture

8466 REGISTERED ARCHITECT Karsea M. Langlois STATE OF WASHINGTON

OBS Door Relocation

Good Samaritan

Hospital 401 15th Ave SE Puyallup, WA 98372		
ARK	DATE	DESCRIPTION
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DH CRS NO.		


31702

K LANGLOIS 20 JULY 2023

InSight Healthcare Architecture

DETAILED 2nd REFLECTED

A3.1

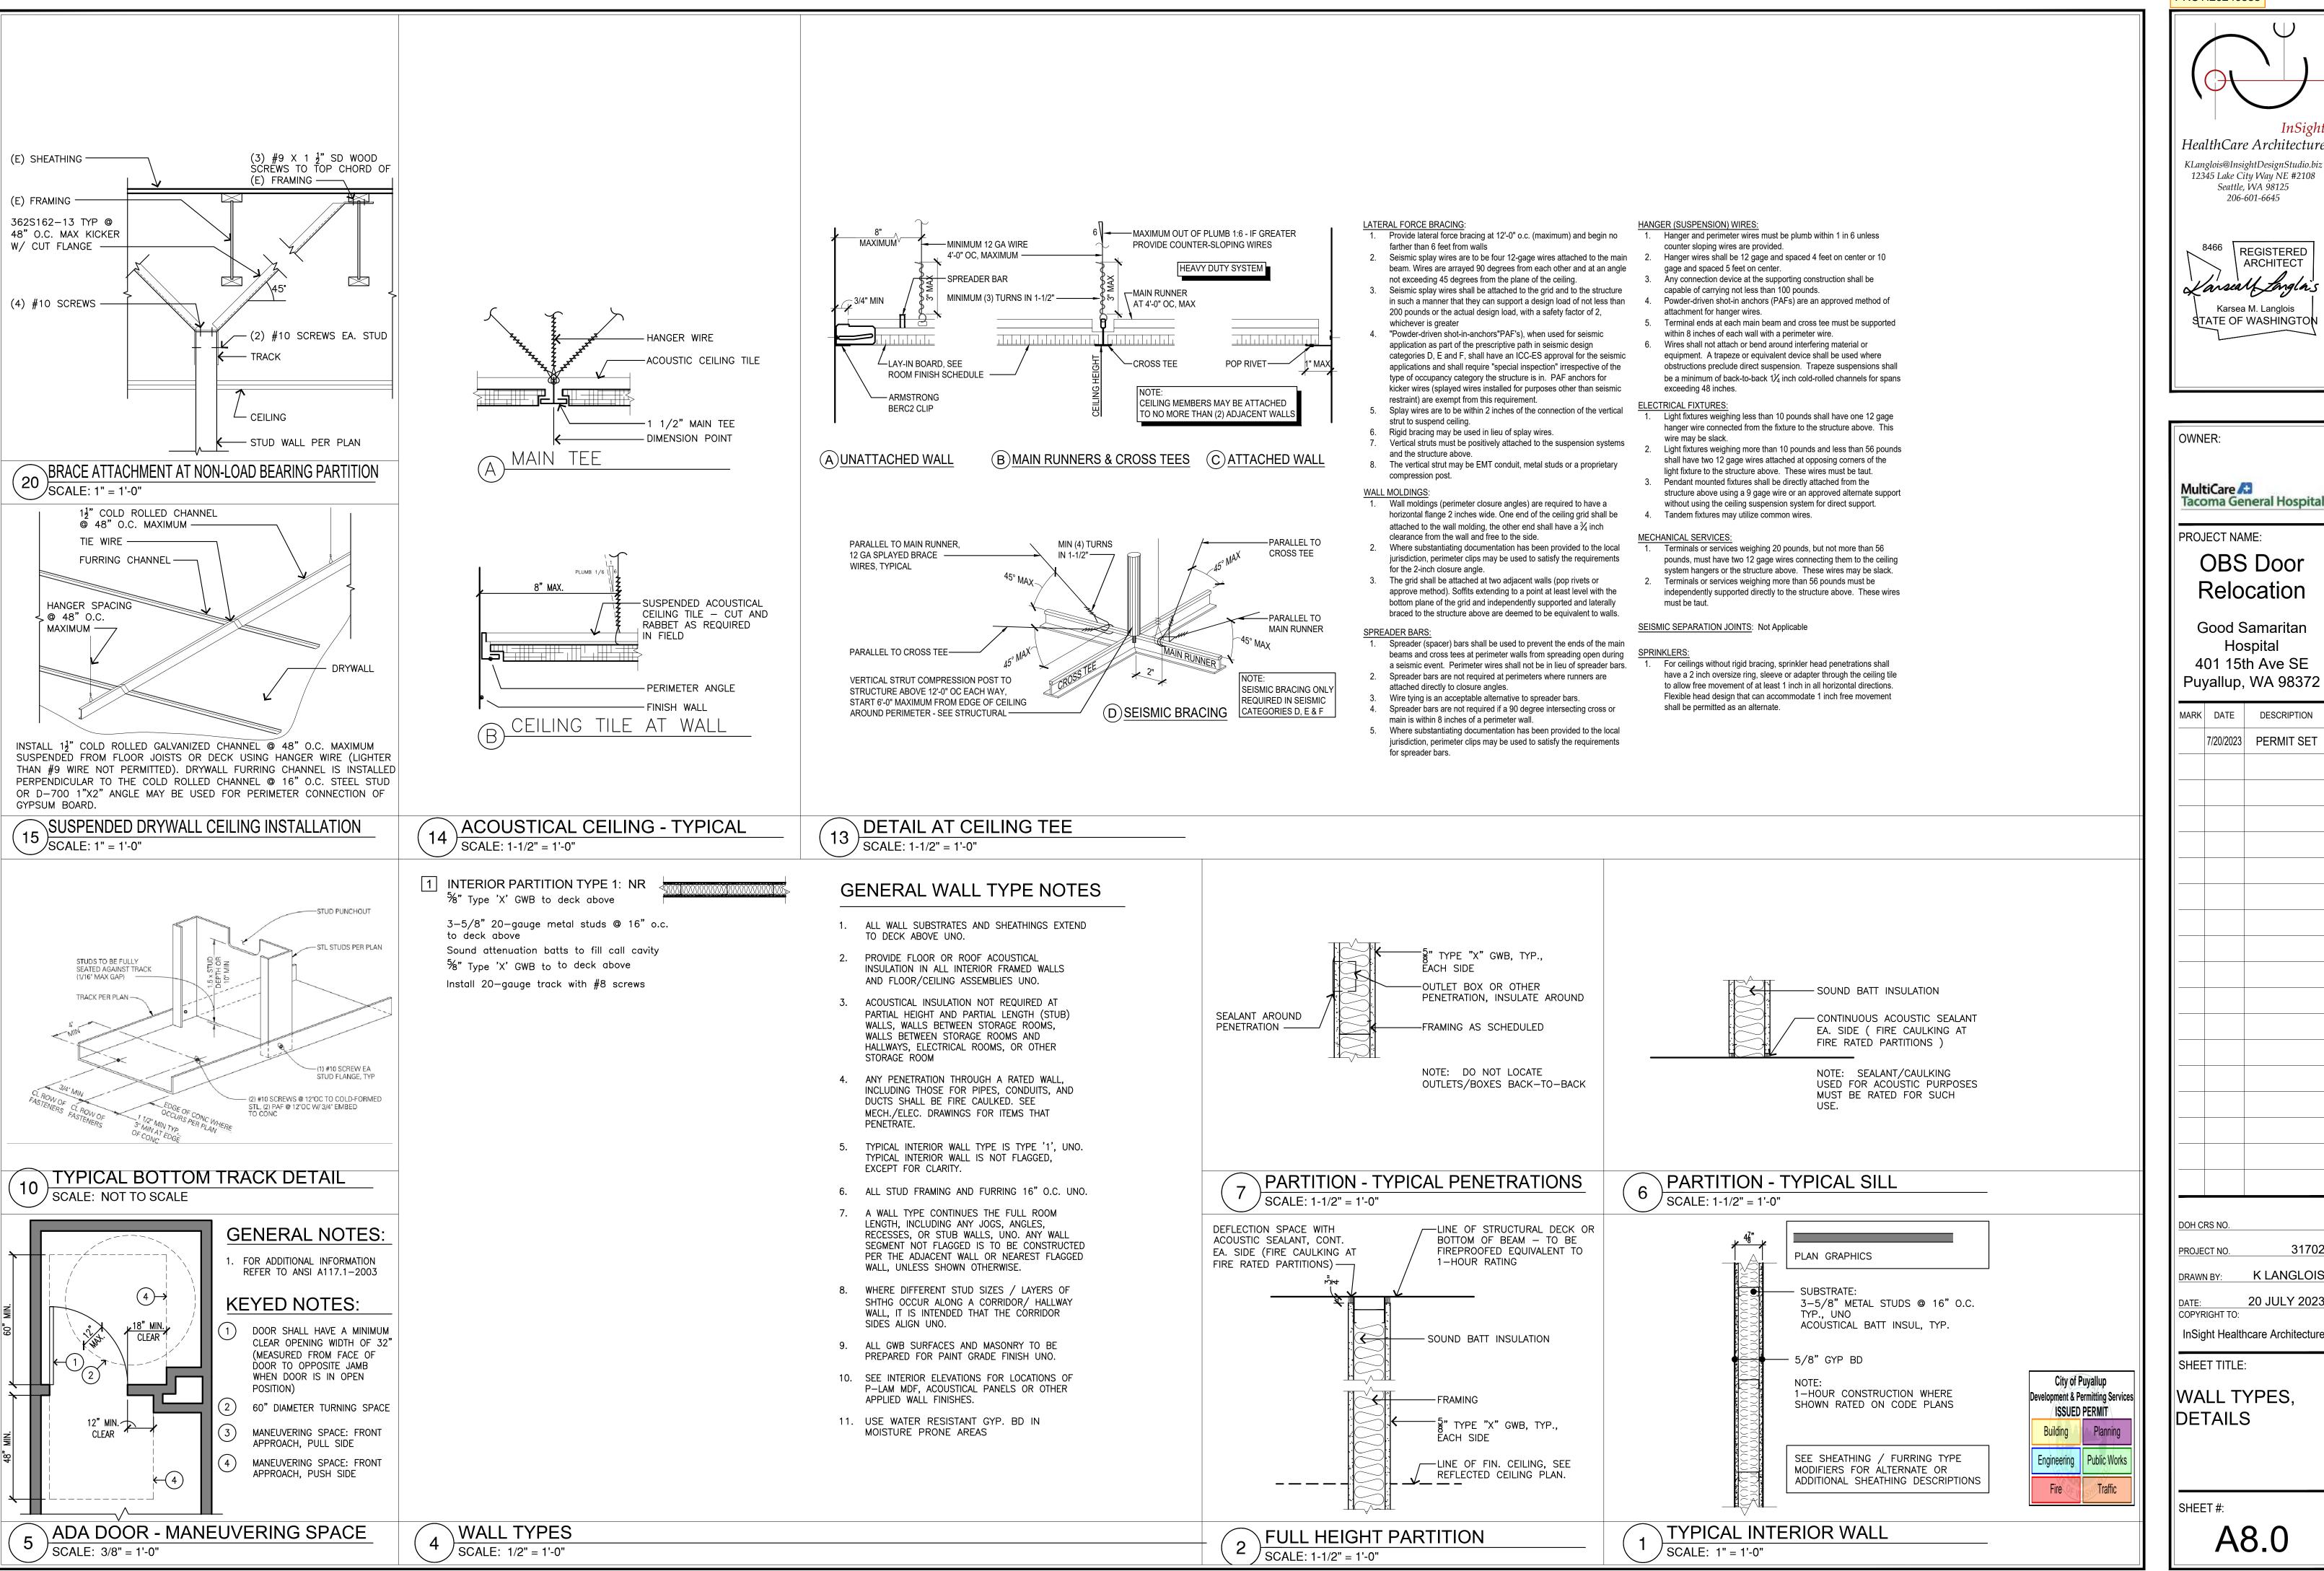

HealthCare Architecture

KLanglois@InsightDesignStudio.biz 12345 *Lake City Way NE #2108*

Seattle, WA 98125 206-601-6645

REGISTERED **ARCHITECT** Karsea M. Langlois STATE OF WASHINGTON

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DETAILS

SHEET #:

A8.0

20 JULY 2023

SECTION 26 05 10 - EXISTING SYSTEMS:

PART 1 - GENERAL

- 1.1 INDICATED EXISTING SYSTEMS
- A. THE ELECTRICAL DRAWINGS SHOW PORTIONS OF THE EXISTING ELECTRICAL SYSTEMS WHICH ARE TO REMAIN, BE REMOVED OR BE MODIFIED. THE EXISTING INFORMATION IS DERIVED FROM RECORD DRAWINGS AND OTHER DATA OBTAINED FROM OR WITH THE PERMISSION OF THE OWNER. WHERE INDICATED, CONCEALED SYSTEMS ARE ALSO DERIVED FROM RECORD DRAWINGS AND THE ENGINEER'S BEST JUDGMENT OF THE CONFIGURATION.
- THE CONTRACTOR SHALL INSPECT THE EXISTING INSTALLATION PRIOR TO BIDDING AND SHALL JUDGE THE WORK REQUIRED. INSPECTION SHALL INCLUDE AREAS WITHIN AND ADJACENT TO THE WORK OF ANY DISCIPLINE OR TRADE PERFORMING WORK FOR THE CONTRACT.
- C. THE COMPLETE EXTENT OF THE EXISTING SYSTEMS COULD NOT BE VERIFIED DURING CREATION OF THE CONSTRUCTION DOCUMENTS. UNLESS THE CONTRACTOR'S INSPECTION OF THE EXISTING SYSTEM DETERMINES A GREATER AMOUNT, THE CONTRACTOR SHALL ASSUME THERE IS 20% MORE EXISTING ELECTRICAL SYSTEMS THAN WHAT IS INDICATED ON THE CONTRACT DRAWINGS.
- 1.1 POWER OUTAGES
- A. IT IS REQUIRED THAT THE CONTRACTOR FULLY SCHEDULE ELECTRICAL SYSTEM(S) OUTAGES WITH THE OWNER. CONTRACTOR SHALL WORK CLOSELY WITH OWNER TO ASSURE THE OWNER FULLY UNDERSTANDS THE EXTENT OF EACH OUTAGE. OWNER MAINTAINS THE RIGHT TO LIMIT THE EXTENT AND LENGTH OF ANY GIVEN OUTAGE. ASSUME ALL OUTAGES TO ELECTRICAL SYSTEM(S) IN OWNER OCCUPIED AREAS WILL REQUIRE PREMIUM TIME AND THAT TEMPORARY ELECTRICAL WORK MAY BE REQUIRED TO LIMIT THE DURATION OF OUTAGES.
- CUTOVERS MUST MAKE ALTERNATIVE ARRANGEMENTS TO DELIVER POWER TO THE LOAD AT ALL TIMES UNLESS OTHERWISE NOTED BY THE OWNER.

PART 2 - PRODUCTS

2.1 EXISTING MATERIALS

A. ALL MATERIALS WHICH ARE A PART OF THE BUILDING SHALL REMAIN THE PROPERTY OF THE OWNER.

2.2 EXISTING MATERIALS TO BE REINSTALLED

EXISTING MATERIALS AND EQUIPMENT (EXCEPT INTERIOR, UNDAMAGED RACEWAYS) THAT ARE REMOVED AS A PART OF THE WORK OR STORED IN SURPLUS SHALL NOT BE REINSTALLED AS A PART OF THE NEW SYSTEMS UNLESS SPECIFICALLY NOTED OR AUTHORIZED IN WRITING BY THE OWNER. FORWARD A COPY OF THE AUTHORIZATION TO THE ENGINEER. THE REQUIREMENTS OF THE SPECIFICATIONS (I.E., CONDITION, INSTALLATION, TESTING, ETC.) SHALL APPLY AS IF THE MATERIALS WERE NEW, FURNISHED BY THE CONTRACTOR.

2.3 EXISTING MATERIALS NOT TO BE REINSTALLED

- A. IN COORDINATION WITH THE ARCHITECT, THESE MATERIALS SHALL BE MADE AVAILABLE FOR INSPECTION AND DECISION AS TO WHETHER THE OWNER WILL RETAIN POSSESSION. ITEMS SELECTED FOR RETENTION SHALL BE TURNED OVER TO THE OWNER. THESE ITEMS SHALL BE DELIVERED TO A LOCATION ON THE PREMISES SELECTED BY THE OWNER. TAKE REASONABLE CARE TO AVOID DAMAGE TO THIS MATERIAL. IF THE CONTRACTOR FAILS TO CONFORM TO THIS REQUIREMENT, CONTRACTOR SHALL PURCHASE AND TURN OVER TO THE OWNER REPLACEMENT MATERIAL OF LIKE KIND AND QUANTITY.
- ALL MATERIAL NOT SELECTED FOR RETENTION BY THE OWNER AND DEBRIS SHALL BE LEGALLY DISPOSED OF BY THE CONTRACTOR.

PART 3 - EXECUTION

3.1 EXISTING CONDITIONS

A. FIELD TRACE ALL EXISTING CIRCUITRY AFFECTED BY THE PROJECT TO DETERMINE:

CONDITIONS SHALL BE PROVIDED TO THE OWNER AND ENGINEER.

- 1. SOURCE OF SUPPLY OR INFORMATION COLLECTION POINT WITHIN THE PROJECT AREA
- 2. LOAD OR TERMINATION WITHIN THE PROJECT AREA
- 3. LOAD OR TERMINATION OUTSIDE THE PROJECT AREA, BUT SUPPLIED FROM OR CONNECTED TO EQUIPMENT WITHIN THE PROJECT AREA
- 4. LOADS SUPPLIED FROM AND LOCATED OUTSIDE OF THE PROJECT AREA BUT HAVE CIRCUITRY WITHIN THE PROJECT AREA.
- 5. PROVIDE UPDATED PANEL SCHEDULES FOR AFFECTED PANELBOARDS ALONG WITH EXISTING CIRCUIT INFORMATION FOR ALL DEVICES/LOADS THAT ARE MAINTAINED IN SERVICE INSIDE THE PROJECT AREA OR FOR DEVICES THAT REQUIRED TEMPORARY SERVICES OUTSIDE THE PROJECT AREA NORMALLY SUPPLIED BY THE AFFECTED PANELBOARD. UPDATED PANEL SCHEDULES AND AS-BUILT MARK-UP DRAWINGS OF EXISTING

EQUIPMENT



EQUIPMENT CONNECTION MOTOR RATED SWITCH

LIGHT FIXTURES DTS=DRAWN TO SCALE NTS=NOT TO SCALE LTS=LENGTH ONLY TO SCALE, REFER TO FIXTURE SCHEDULE

- RECESSED, DTS
- EXIT SIGN, FILLED SIDE ILLUMINATED, DIRECTIONAL ARROWS AS INDICATED, NTS

---- RACEWAY BELOW SLAB OR UNDERGROUND ──────────────────────── RACEWAY UP RACEWAY DOWN RACEWAY STUB-OUT WITH BUSHING CIRCUIT CONTINUATION → HOMERUN JUNCTION BOX PB PULL BOX

CIRCUITS

NURSE CALL


DOME LIGHT, WALL-MOUNTED & CEILING-MOUNTED

SECURITY

- CR CARD READER
- ES ELECTRIC STRIKE

SHEET INDEX		
SHEET #	SHEET NAME	
E0.0	ELECTRICAL SYMBOLS, ABBREVIATIONS, & SPECIFICATIONS	
E1.1	PARTIAL SECOND FLOOR PLAN — ELECTRICAL	

WORK DEFINITION

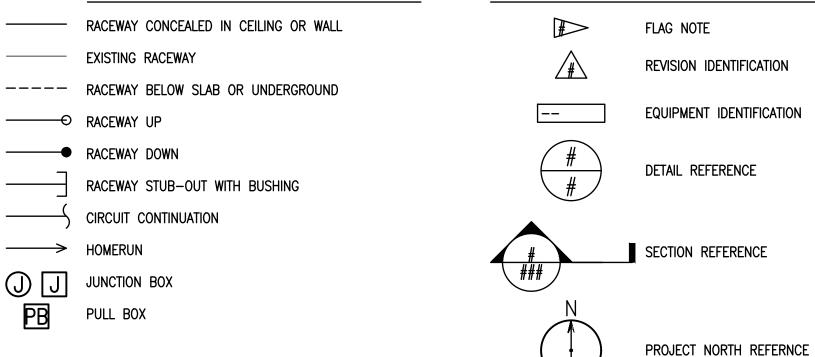

GENERAL NOTES:

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- 1. ALL ELECTRICAL WORK AND MATERIALS ARE TO COMPLY WITH THE LATEST REQUIREMENTS OF ALL APPLICABLE CITY, COUNTY, AND STATE CODES AS WELL AS THE NATIONAL ELECTRICAL CODE AS ADOPTED AND AMENDED BY THE LOCAL AUTHORITY HAVING JURISDICTION.
- 2. FOR EXACT LOCATIONS OF ALL ELECTRICAL DEVICES AND LIGHTING FIXTURES, REFER TO THE ARCHITECTURAL DRAWINGS.

NEW WORK

FUTURE WORK


EXISTING CONDITIONS

DEMOLISH EXISTING

ABBREVIATIONS

A,AMP CKT	AMPERE CIRCUIT	NEMA	NATIONAL ELECTRICAL MANUFACTURERS
CTRL	CONTROL		ASSOCIATION
DEV	DEVICE	NFPA	NATIONAL FIRE PROTECTION
DTS	DRAWN TO SCALE		ASSOCIATION
DWG	DRAWING	NTS	NOT TO SCALE
G,GND	GROUND	PNL	PANEL, PANELBOARD
JB,J-BOX	JUNCTION BOX	PWR	POWER
KV	KILOVOLT	RCP	REFLECTED CEILING PLAN
KVA	KILOVOLT AMPERE	RCPT	RECEPTACLE
LTG	LIGHTING	SPECS	SPECIFICATIONS
LTS	LENGTH ONLY TO SCALE	TYP	TYPICAL
LV	LOW VOLTAGE	٧	VOLT OR VOICE
MAX	MAXIMUM	W	WIRE, WATT, OR WALLPHONE
MIN	MINIMUM	WAP	WIRELESS ACCESS POINT
NEC	NATIONAL ELECTRICAL CODE	XFMR	TRANSFORMER
		Ø	PHASE

Separate Electrical Permit is required with the Washington State Department of https://lni.wa.gov/licensing-permits/electrical/electrical-permits-fees-and-inspections or call for Licensing Information: 1-800-647-0982

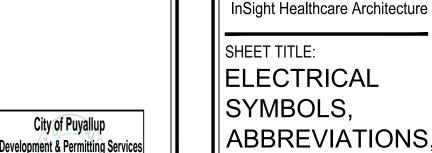

ABBREVIATIONS,

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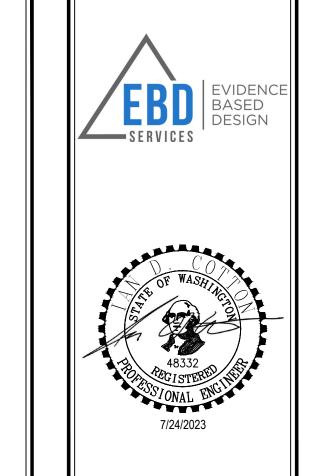
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SPECIFICATIONS

20 JULY 2023

SHEET #:

PRCTI20240555



OWNER: | MultiCare 🙃 **Better**Connected PROJECT NAME: MultiCare **GSMOB Suite 4400**

1450 5th St SE Puyallup, WA 98372 MARK DATE DESCRIPTION

CONSTRUCTION

Door Relocation

07/20/23


	DOCUMENTS
	l .
PROJECT NO.	B23-1031

GENERAL NOTES:

- 1. EXISTING DEVICES TO BE REMOVED AND REINSTALLED IN REVISED LOCATIONS SHALL BE STORED AND PROTECTED DURING CONSTRUCTION. DEVICES SHALL BE CLEANED PRIOR TO REINSTALLATION. TEST FUNCTIONALITY OF DEVICES UPON REINSTALLATION.
- 2. COORDINATE ALL MODIFICATIONS TO RATED DOORS WITH GENERAL CONTRACTOR AND PROVIDE REPAIRS, MODIFICATIONS, AND RE-CERTIFICATIONS AS NEEDED TO MAINTAIN DOOR RATING.


■ FLAG NOTES:

- DEMOLISH ABANDONED ACCESS CONTROL SENSOR MOUNTED IN MIDDLE OF DOOR AND FLEXIBLE CONNECTION AT DOOR HINGE. PATCH AND REPAIR DOOR AFTER DEMOLITION OF EXISTING ACCESS CONTROL DEVICES.
- 2. DISCONNECT EXISTING FIRE SMOKE DAMPER AND MOTOR RATED SWITCH. EXISTING DEVICES SHALL BE RELOCATED TO REVISED DOOR AND WALL LOCATION AND RECONNECTED. MAINTAIN EXISTING CIRCUITS FOR RECONNECTION.
- 3. DISCONNECT EXISTING DEVICE. EXISTING DEVICE SHALL BE RECONNECTED AT REVISED DOOR LOCATION. MAINTAIN EXISTING CIRCUITS FOR RECONNECTION.
- 4. DISCONNECT AND REMOVE EXISTING CARD READER. EXISTING CARD READER SHALL BE RELOCATED AND RECONNECTED AT REVISED DOOR LOCATION.
- 5. REMOVE AND RELOCATE EXISTING LIGHT. MAINTAIN EXISTING CIRCUITS FOR RECONNECTION.
- 6. DISCONNECT AND REMOVE EXISTING NURSE CALL DOME LIGHT. EXISTING DOME LIGHT SHALL BE REINSTALLED AT REVISED LOCATION AND RECONNECTED TO EXISTING CIRCUIT.
- 7. RECONNECT EXISTING FIRE SMOKE DAMPER AT REVISED LOCATION. CONNECT TO RELOCATED MOTOR RATED SWITCHES AND EXISTING CIRCUITS.
- 8. CONNECT EXISTING RELOCATED ELECTRIC STRIKE TO EXISTING ACCESS CONTROL SYSTEM. INTERCEPT AND EXTEND EXISTING CIRCUIT TO REVISED LOCATION.
- INSTALL EXISTING CARD READER AT REVISED LOCATION. INTERCEPT AND EXTEND EXISTING CIRCUIT AND CONNECT.
- 10. INSTALL EXISTING LIGHT IN REVISED LOCATION. CONNECT TO EXISTING CIRCUIT.
- 11. INSTALL EXISTING NURSE CALL DOME LIGHT IN REVISED LOCATION. CONNECT TO EXISTING CIRCUIT. TEST NURSE CALL LIGHT FUNCTIONALITY UPON RECONNECTION.
- 12. PROVIDE 2'X4' RECESSED DIRECT/INDIRECT LED TROFFER LIGHT FIXTURE SIMILAR TO LITHONIA AVANTE TYPE 2AVL4-30LSE-MDR-EZ1-LP835 OR APPROVED LIGHT FIXTURE TO MATCH EXISTING CORRIDOR LIGHT FIXTURES. CONNECT NEW LIGHT TO EXISTING EMERGENCY CIRCUIT IN CORRIDOR R200.3.
- 13. PROVIDE APPROVED FIRE STOPPING MATERIAL AROUND ALL PENETRATIONS THROUGH RATED WALL.

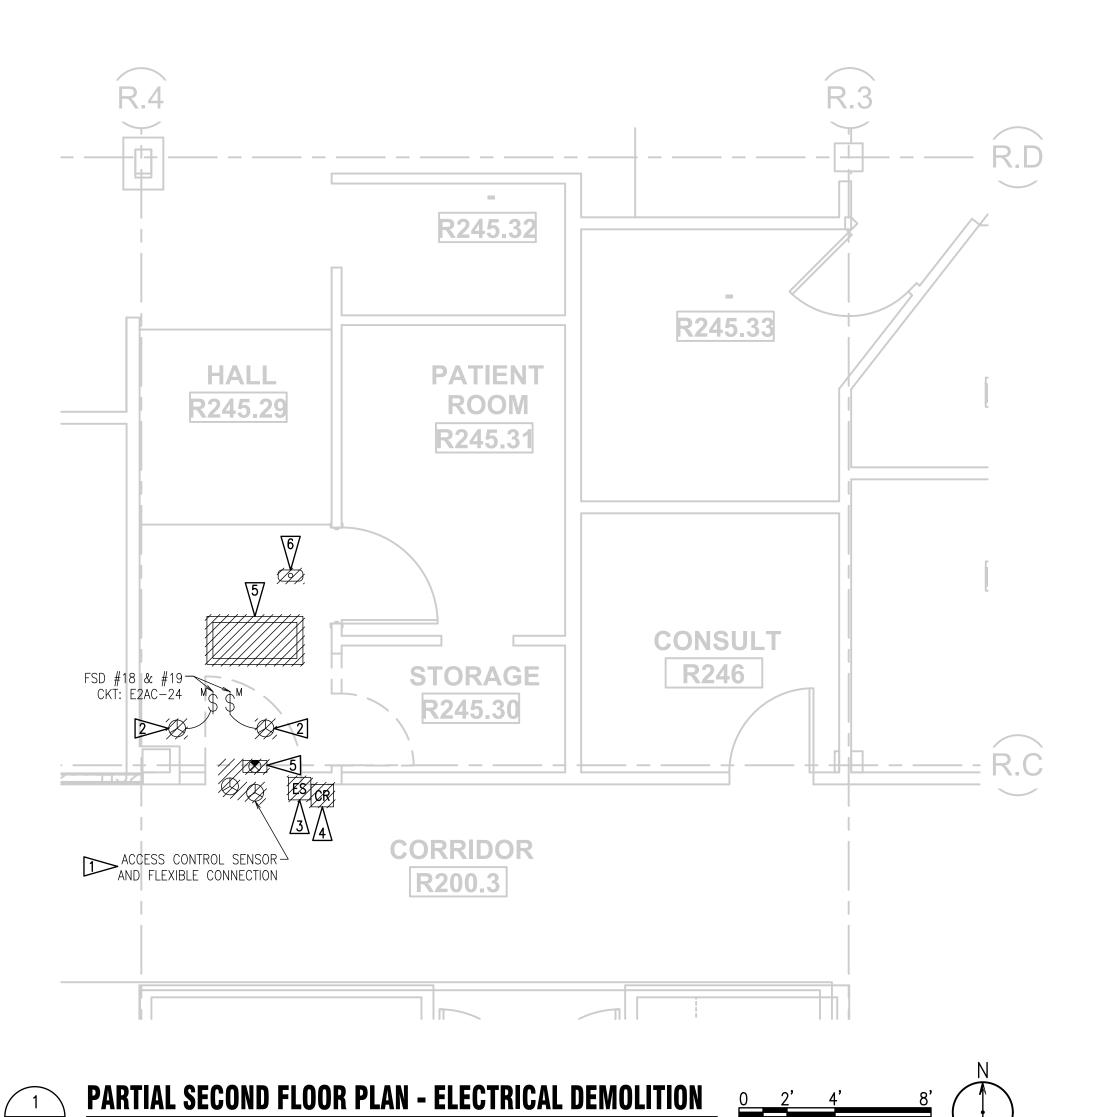

E1.1

 $\frac{1}{\text{SCALE}: 1/4"} = 1'-0"$

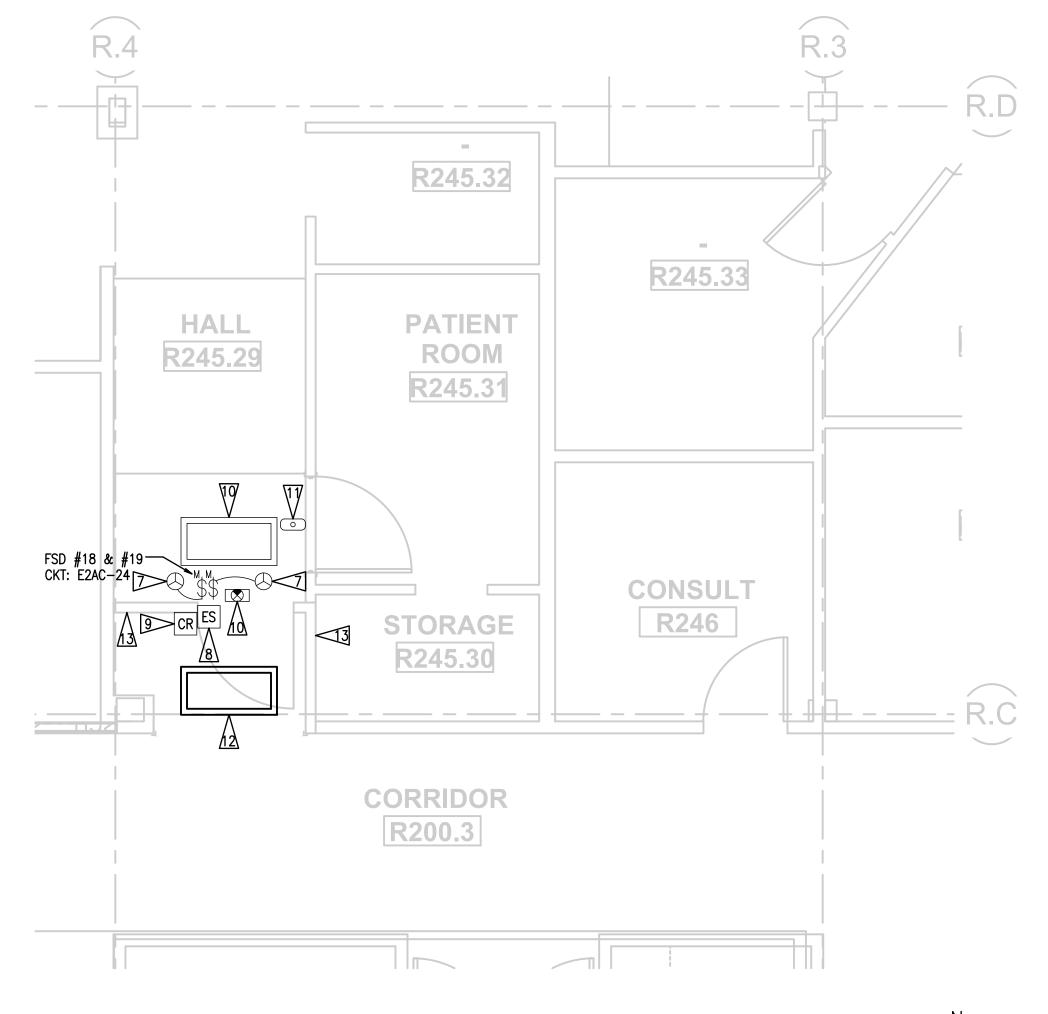




PARTIAL SECOND FLOOR PLAN - ELECTRICAL


SCALE: 1/4" = 1'-0"



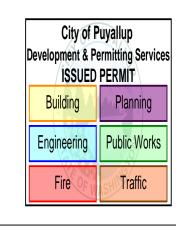

PRCTI20240555



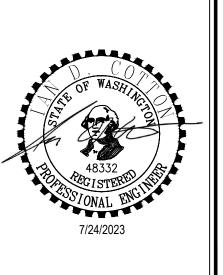

OWNER:

MultiCare And BetterConnected

MultiCare
GSMOB
Suite 4400
Door Relocation

1450 5th St SE Puyallup, WA 98372

DESCRIPTION

MARK DATE

	5,	BLOOK III HOR
	07/20/23	CONSTRUCTION DOCUMENTS
		D00 4004
JECT NO.		B23-1031

DATE: 20 JULY 2023
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SHEET TITLE:
PARTIAL
SECOND
FLOOR PLAN -

ELECTRICAL

SHEET #:

E1.1