

PRCTI20240324

HealthCare Architecture Karsea@InsightArch.us 12345 Lake City Way NE #2108 Seattle, WA 98125 206-601-6645

REGISTERED ARCHITECT Larsial Longla's Karsea M. Langlois STATE OF WASHINGTON

OWNER:

MultiCare 🕰 Tacoma General Hospital

PROJECT NAME:

### Infant Warmer Alterations

**Good Samaritan** Hospital 401 15th Ave SE Puyallup, WA 98372

12/13/23 CRS TA SET 2/9/24 PERMIT SET

61505087 DOH CRS NO. 31260 PROJECT NO.


K LANGLOIS DRAWN BY: DATE: 9 FEBRUARY 2024

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SHEET TITLE:

PROJECT INFO / INDEX / SITE PLAN

SHEET #:



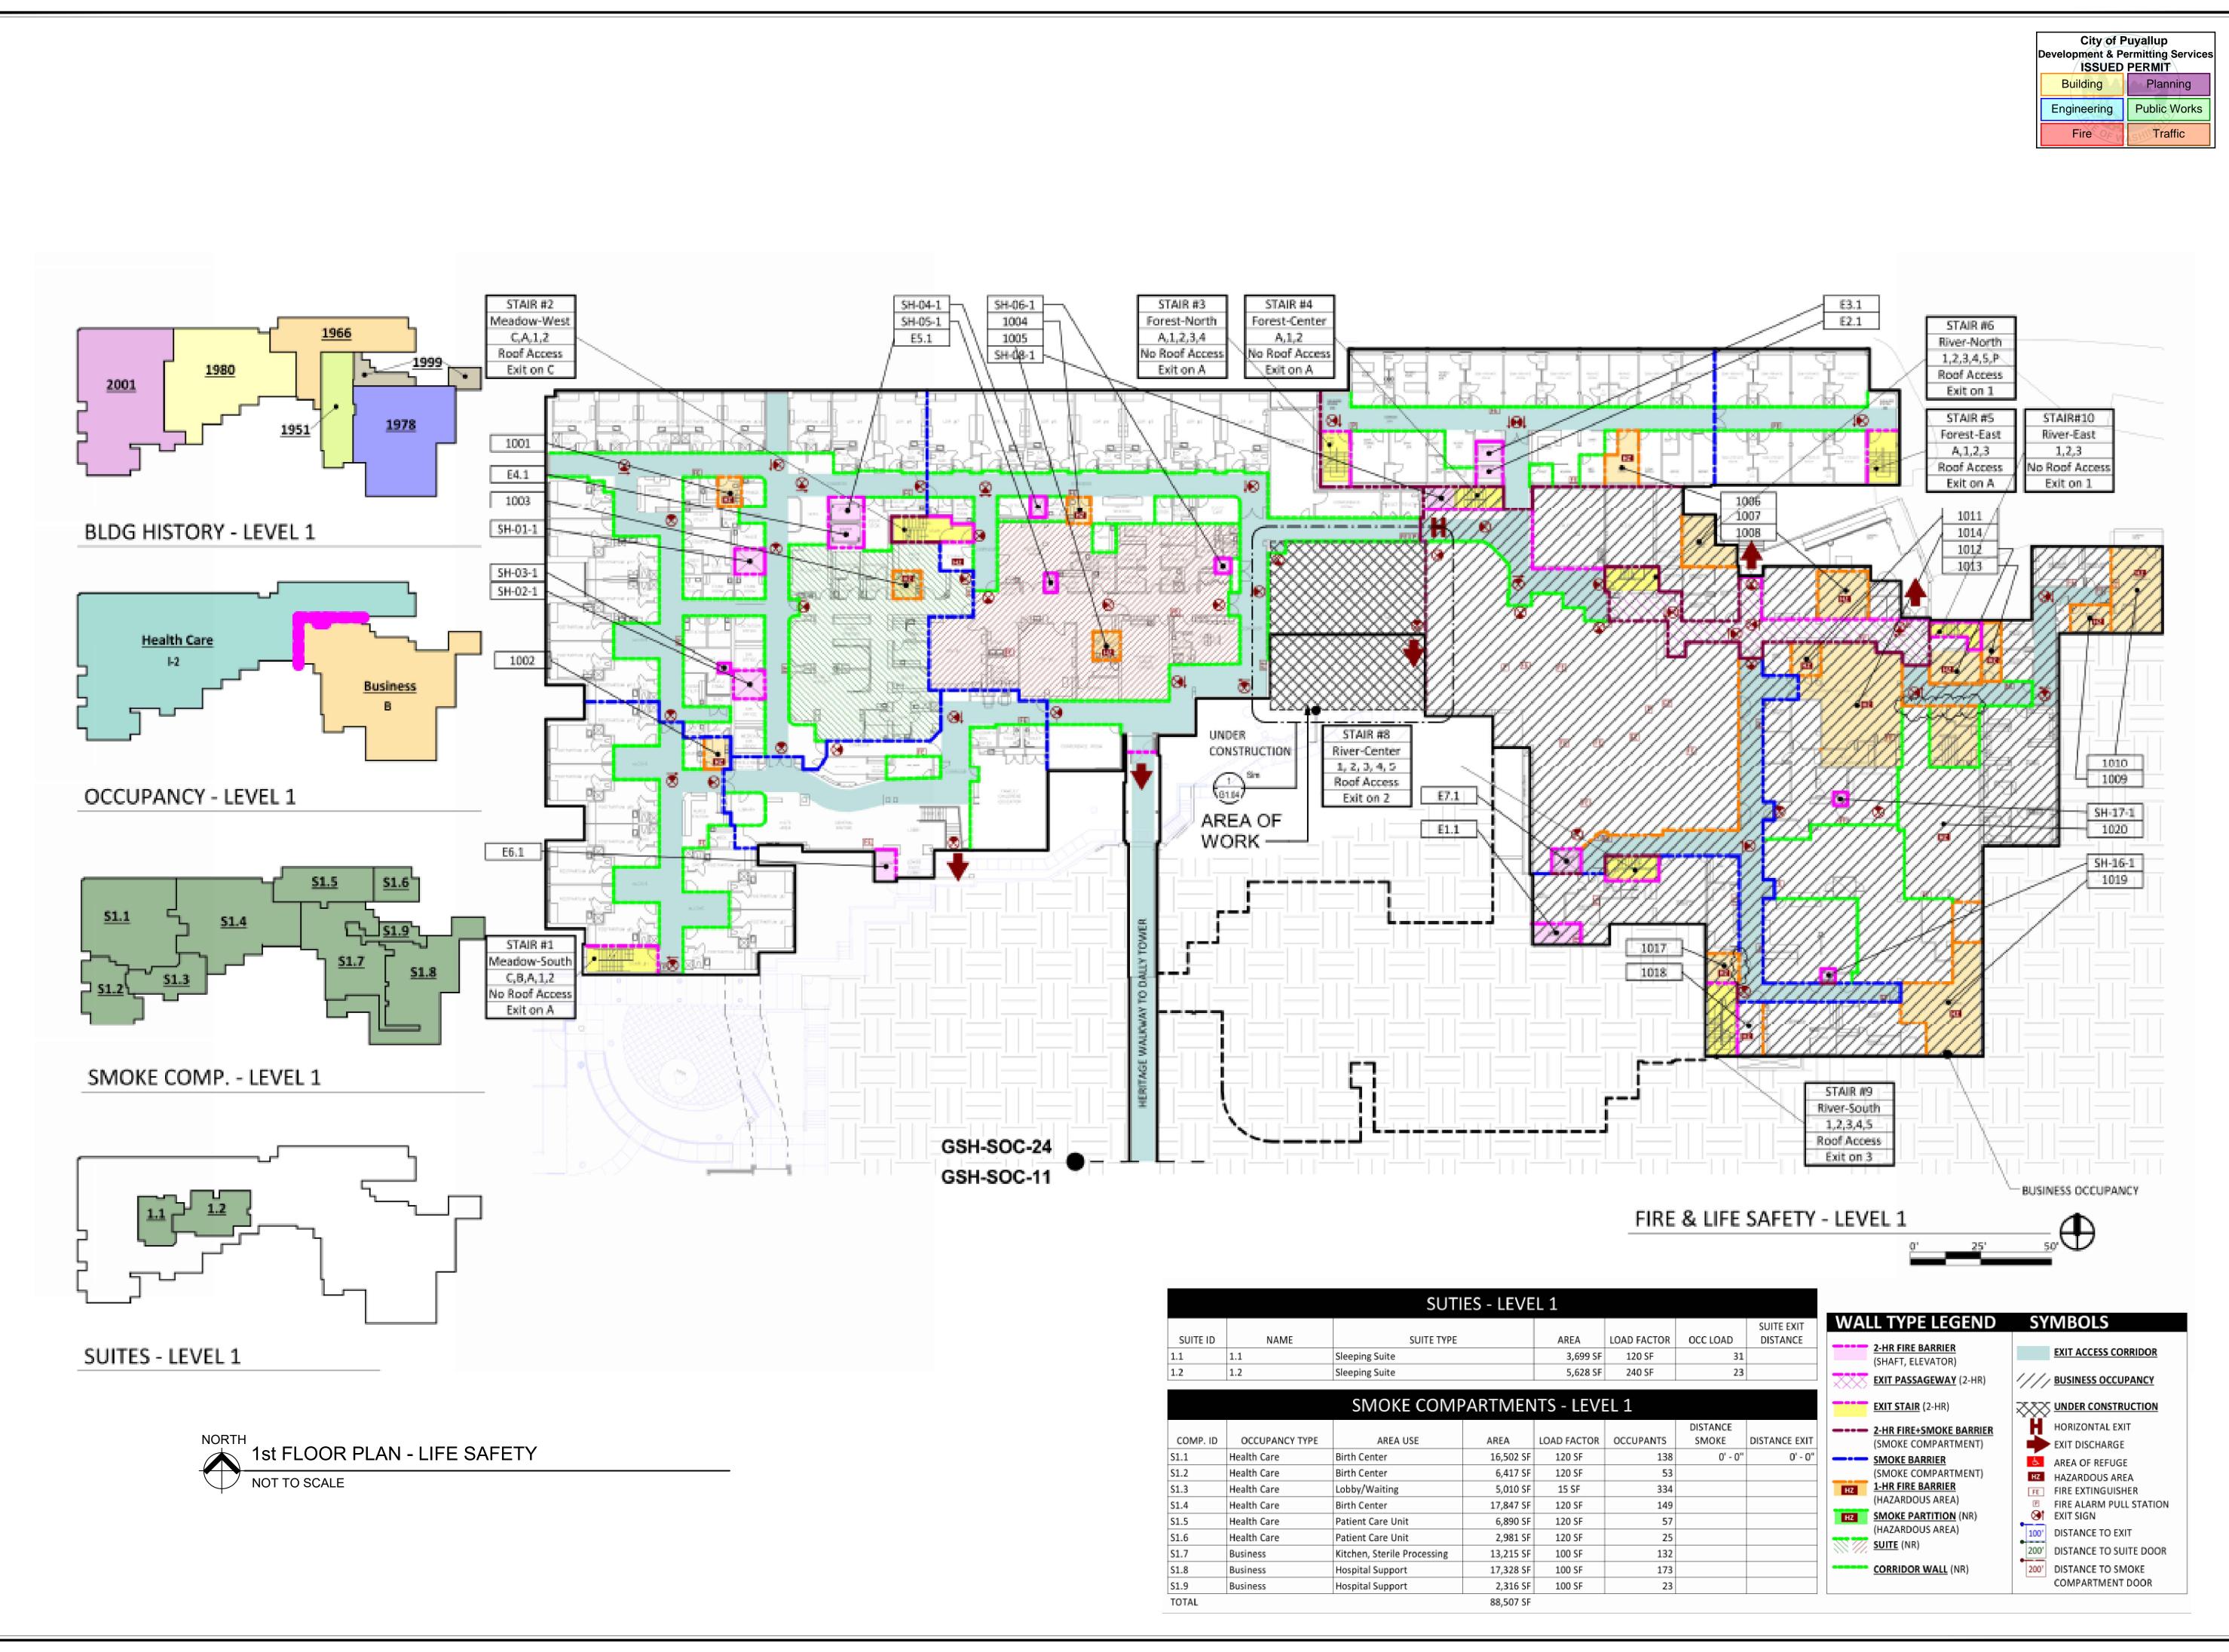

OWNER: MultiCare 🕰 Tacoma General Hospital PROJECT NAME: **Infant Warmer** Alterations Good Samaritan Hospital 401 15th Ave SE Puyallup, WA 98372 MARK DATE DESCRIPTION 12/13/23 CRS TA SET 2/9/24 PERMIT SET 61505087 DOH CRS NO. 31260 PROJECT NO. K LANGLOIS DRAWN BY: DATE: 9 FEBRUARY 2024 COPYRIGHT TO:


InSight Healthcare Architecture

SHEET TITLE:

PARTIAL 1st FLOOR PLAN -LIFE SAFETY

SHEET #:

A0.1

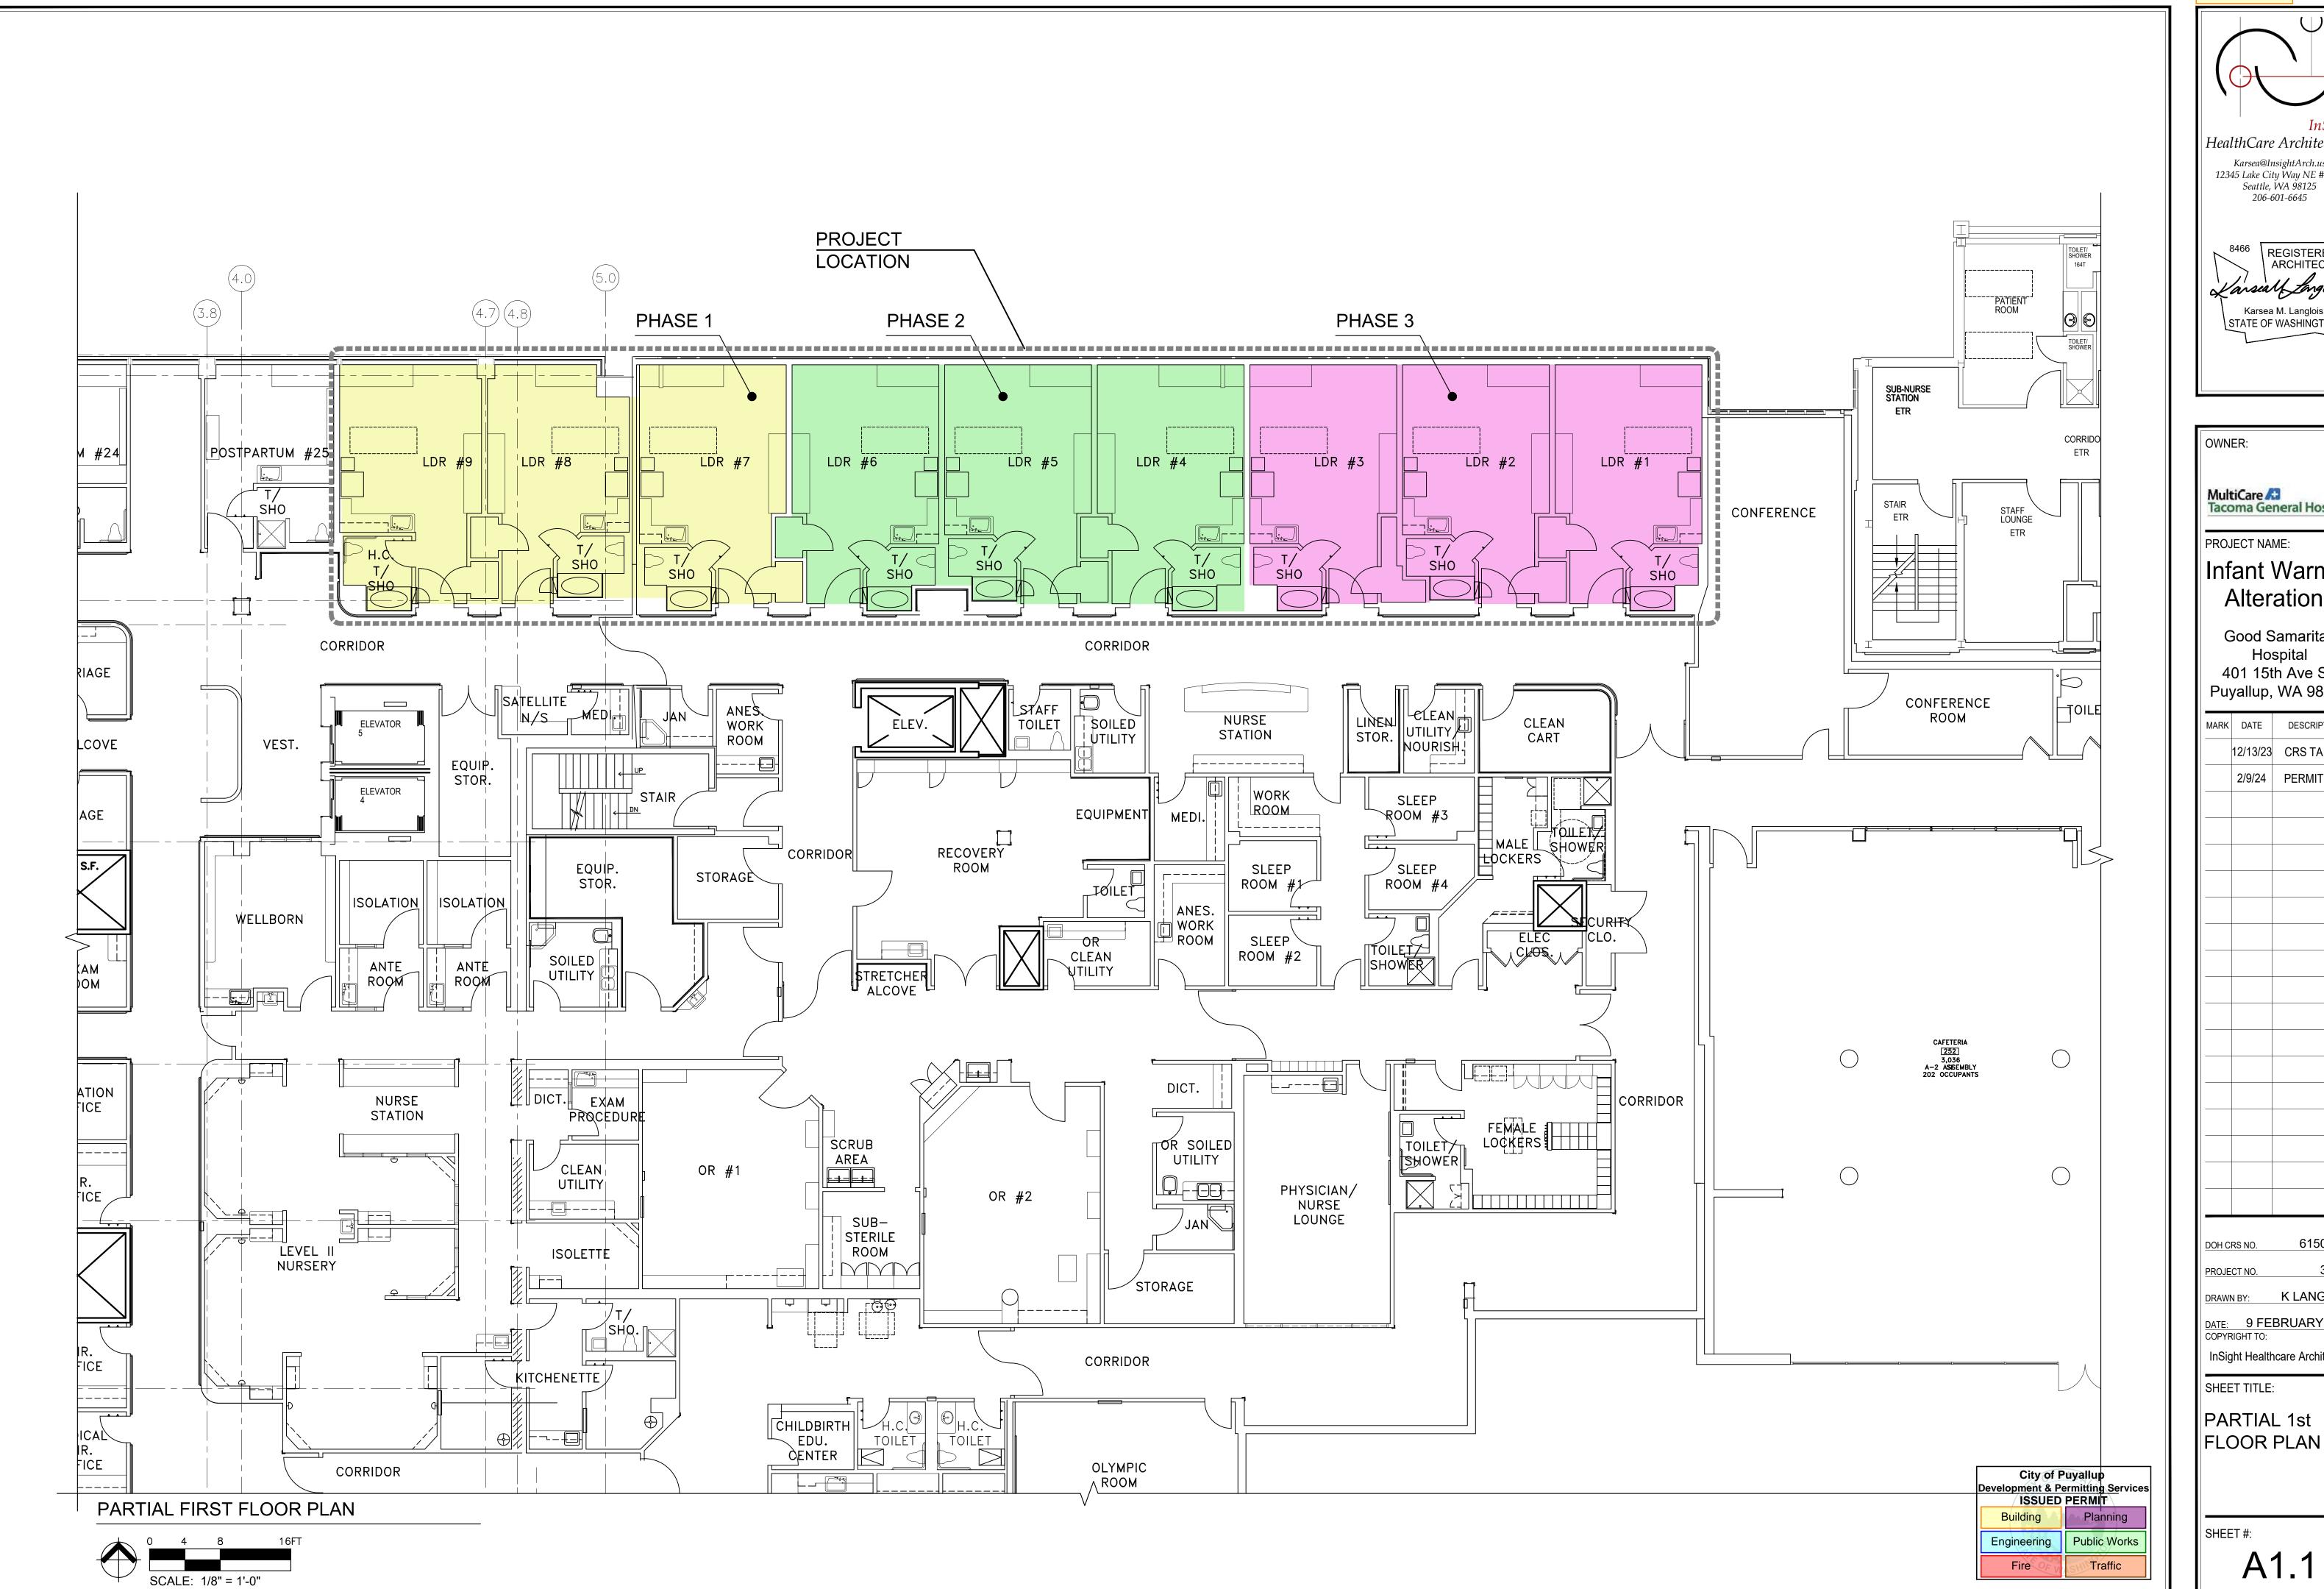




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SHEET #:

SHEET TITLE:

A1.1

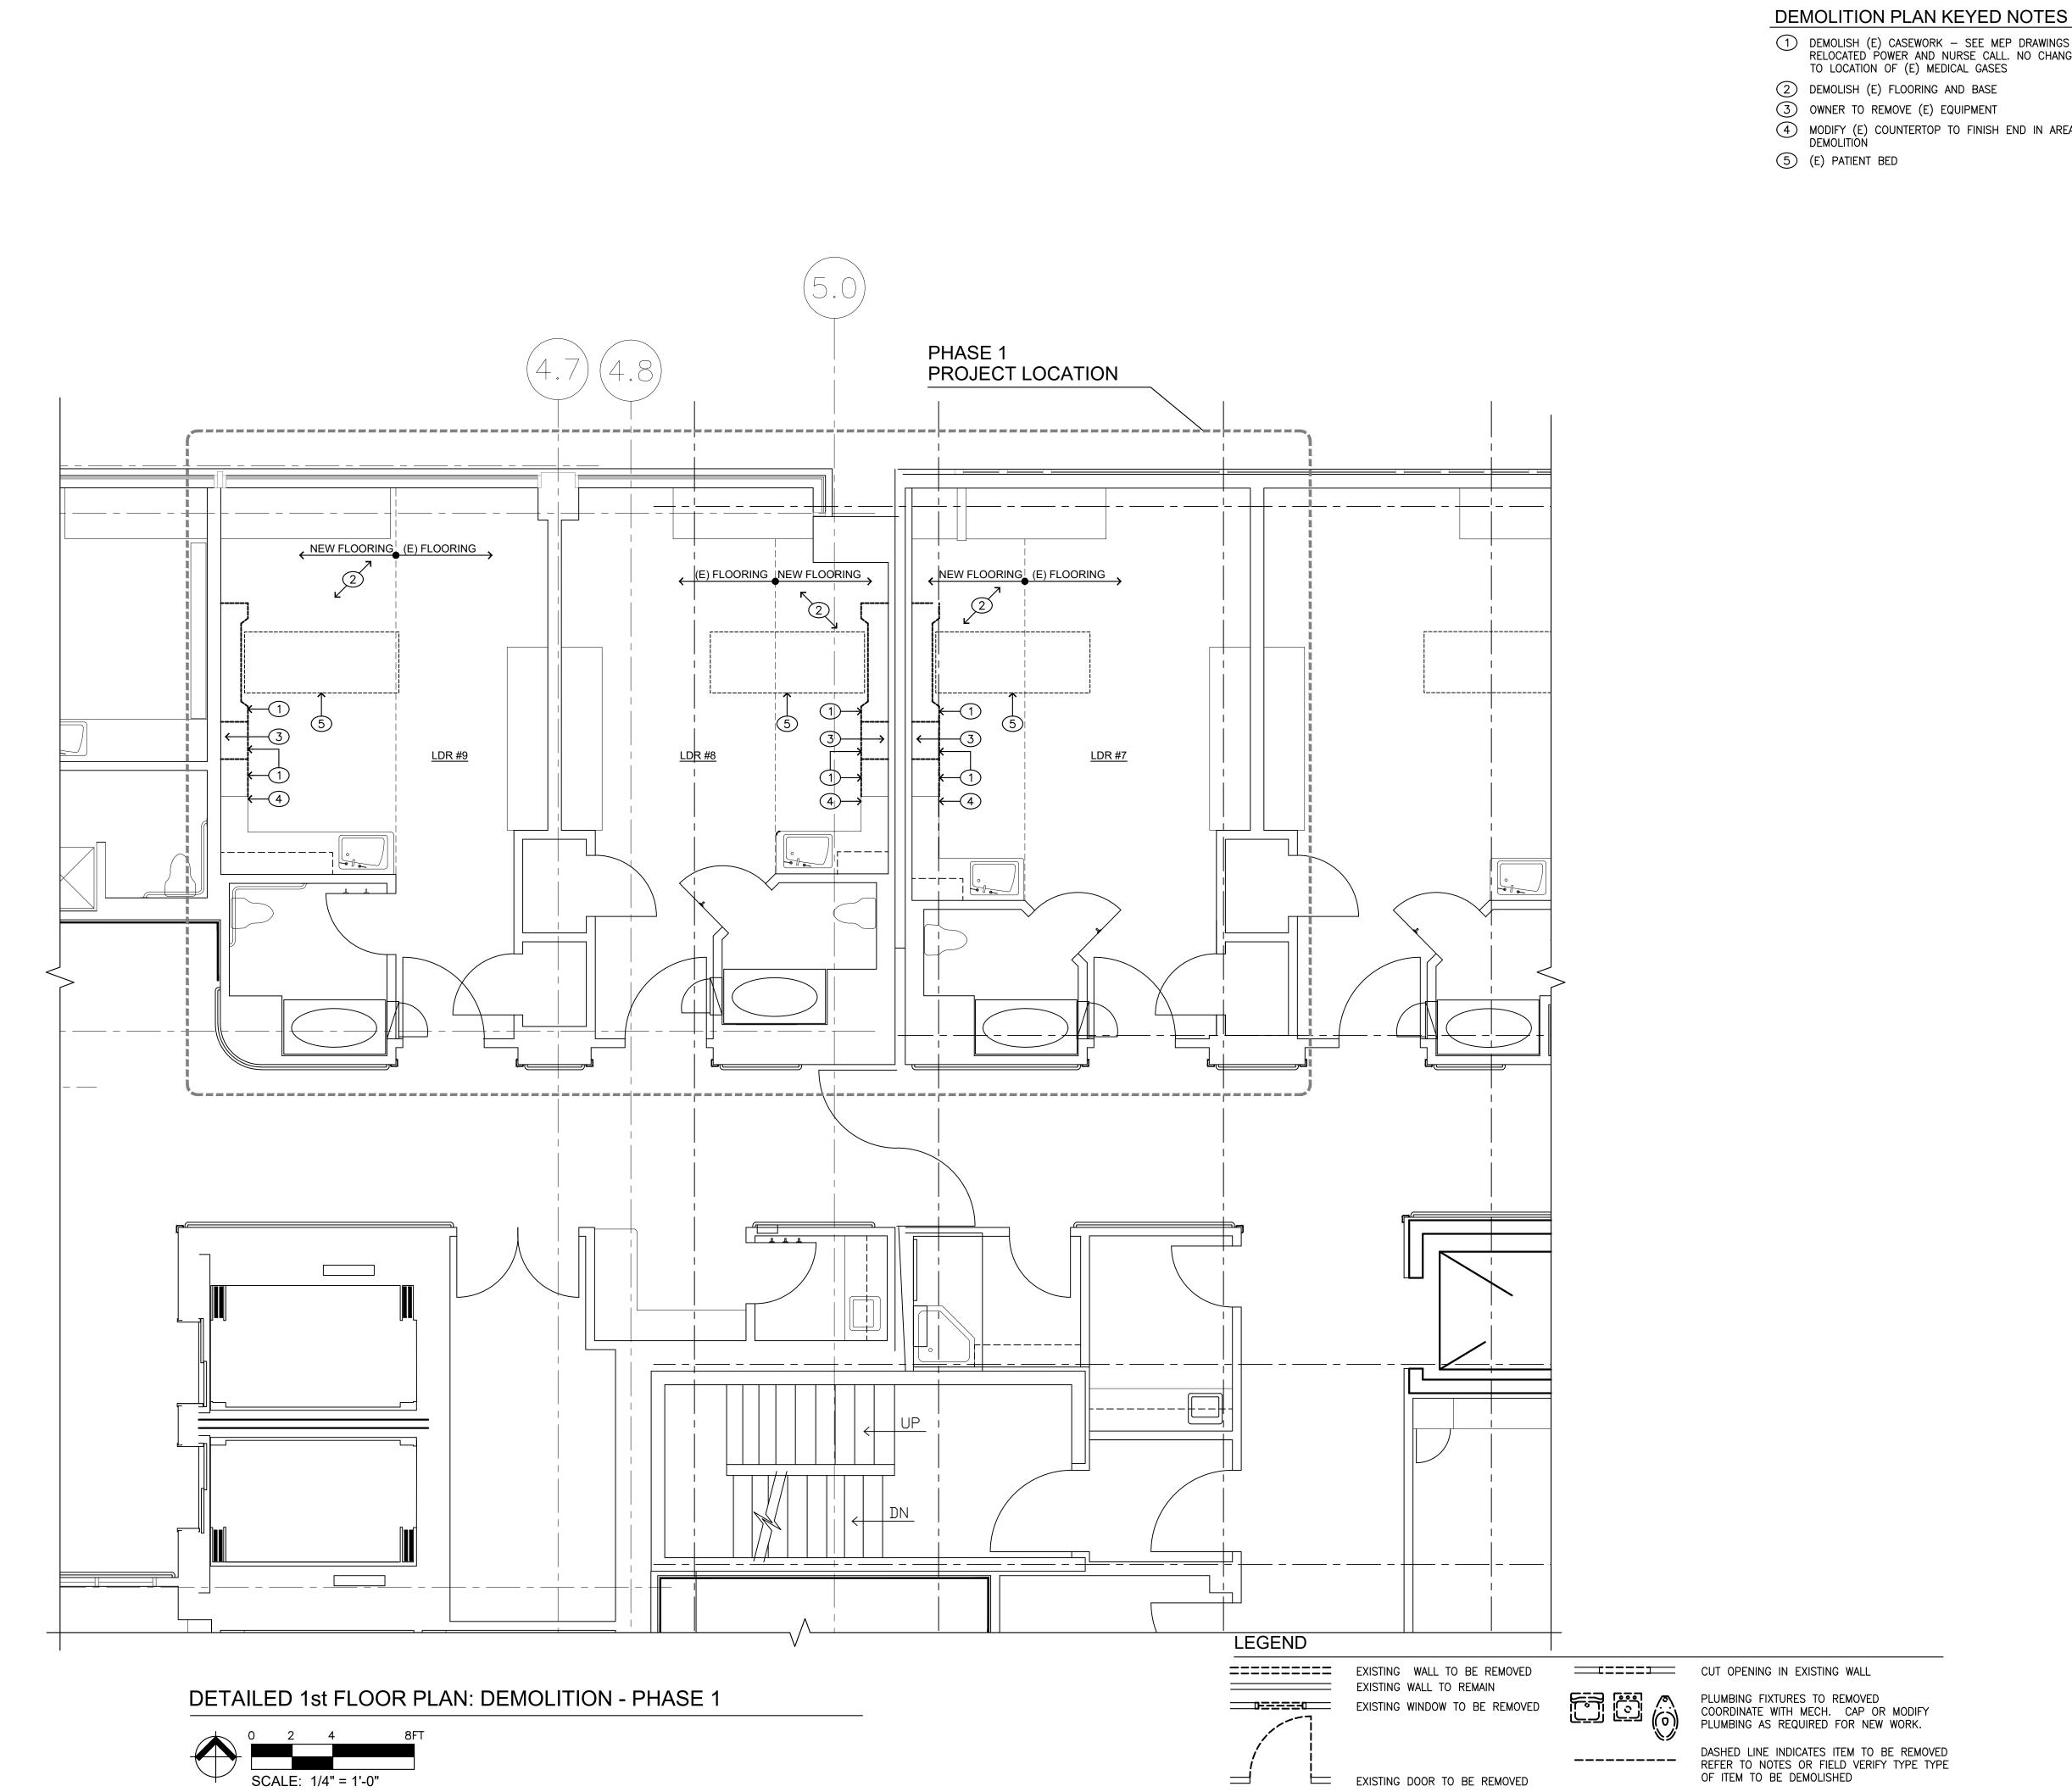

- 1) DEMOLISH (E) CASEWORK SEE MEP DRAWINGS FOR RELOCATED POWER AND NURSE CALL. NO CHANGES
- 4 MODIFY (E) COUNTERTOP TO FINISH END IN AREA OF

- 1. THESE DEMOLITION DRAWINGS ARE INTENDED TO SHOW DEMOLITION WITH EXTENT OF NEW WORK TO BE INSTALLED. CONTRACTOR SHALL BRING ALL DISCREPANCIES BETWEEN NEW WORK AND EXISTING WRITTEN NOTIFICATION FOR CLARIFICATION/DECISION CORRECTED BY THE CONTRACTOR AT HIS EXPENSE. BY THE ARCHITECT.
- 2. THESE DOCUMENTS DO NOT ADDRESS ASBESTOS ABATEMENT. ASBESTOS ABATEMENT WILL BE HANDLED BY THE OWNER. OWNER WILL RETAIN A CERTIFIED ASBESTOS ABATEMENT CONTRACTOR TO ABATE EACH PHASE PRIOR TO GENERAL CONTRACTOR'S WORK. OWNER WILL ALSO RETAIN ABATEMENT CONTRACTOR THROUGHOUT THE PROJECT FOR SPOT CHECKS AND VERIFICATION OF SUSPECTED MATERIALS UNCOVERED DURING DEMOLITION. GENERAL CONTRACTOR SHALL BE REQUIRED TO COORDINATE & SCHEDULE WITH OWNER'S ABATEMENT CONTRACTOR.

SUBMIT ALL REPORTS TO CITY OF PUYALLUP BUILDING OFFICIAL.

- 3. MINIMIZE DAMAGE, BY WHATEVER MEANS DEEMED NECESSARY TO FULLY PROTECT ALL EXISTING SURFACES TO REMAIN ADJACENT TO DEMOLITION WORK.
- 4. ALL ITEMS NOT SCHEDULED TO BE REUSED SUCH AS MECHANICAL AND ELECTRICAL FIXTURES, EQUIPMENT, FURNITURE, CASEWORK AND SHELVING SHALL BECOME THE PROPERTY OF THE CONTRACTOR.
- 5. WHERE NEW FLOORING IS SCHEDULED REMOVE ALL FLOOR FINISHES TO SMOOTH SUBSTRATE BELOW. REMOVE ALL ADHESIVES, TAPES, TACK STRIPS, AND OTHER PROJECTIONS THAT WILL OTHERWISE PREVENT THE INSTALLATION OF NEW FINISHES IN A NEAT, COMPLETE AND THOROUGH MANNER PER FLOORING MANUFACTURERS RECOMMENDATIONS.
- MATERIAL FROM WALL CAVITIES CREATED BY DEMOLITION WORK PRIOR TO ENCLOSING WITH NEW FINISHES.
- REMOVED LEAVING HOLES IN EXISTING FLOOR, WALLS OR CEILING, SURFACES TO REMAIN, PATCH HOLES WITH SAME MATERIAL, FINISH AND FIRE RATING, SO AS TO LOOK FLUSH WITH ADJACENT TO SURROUNDING SURFACES.
- OR OUT OF EACH PHASED AREA. IN NO CASE SHALL DEMOLITION DEBRIS FROM SITE ON A DAILY BASIS. 48 HOURS PRIOR TO ANY WORK.
- DOORS WHERE NEEDED PRIOR TO DEMOLITION TO PROTECT ADJACENT AREAS.

Development & Permitting Services **ISSUED PERMIT** Building **Public Works** Engineering

Traffic

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- 6. REMOVE ALL LOOSE DEBRIS OR OTHERWISE UNNECESSARY
- 7. WHERE PLUMBING FIXTURES, PIPES OR CONDUITS ARE
- 8. CLEAN UP CONSTRUCTION SITE AT END OR EACH DAY'S WORK SO AS TO NOT BLOCK EXIT PATHS OR ACCESS IN OCCUPIED AREAS BE BLOCKED WITH TOOLS, DEBRIS OR CONTRACTOR'S EQUIPMENT AT ANYTIME. DISPOSE OF ACCESS ROUTE SHALL BE SUBMITTED TO OWNER AND ARCHITECT IN WRITING ( OR GRAPHICALLY ) FOR REVIEW
- 9. CONSULT WITH OWNER IN WRITING TEN (10) DAYS IN ADVANCE OR UTILITY/ SERVICE SHUTDOWNS.
- 10. PROVIDE DUSTPROOF PARTITIONING AND TEMPORARY

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HealthCare Architecture

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Seattle, WA 98125 206-601-6645

REGISTERED

ARCHITECT

Karsea M. Langlois

STATE OF WASHINGTON

61505087 DOH CRS NO. 31260

PROJECT NO. K LANGLOIS


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SHEET TITLE: DETAILED 1st FLOOR PLAN: DEMOLITION

SHEET #:

PHASE 1



#### DEMOLITION PLAN KEYED NOTES

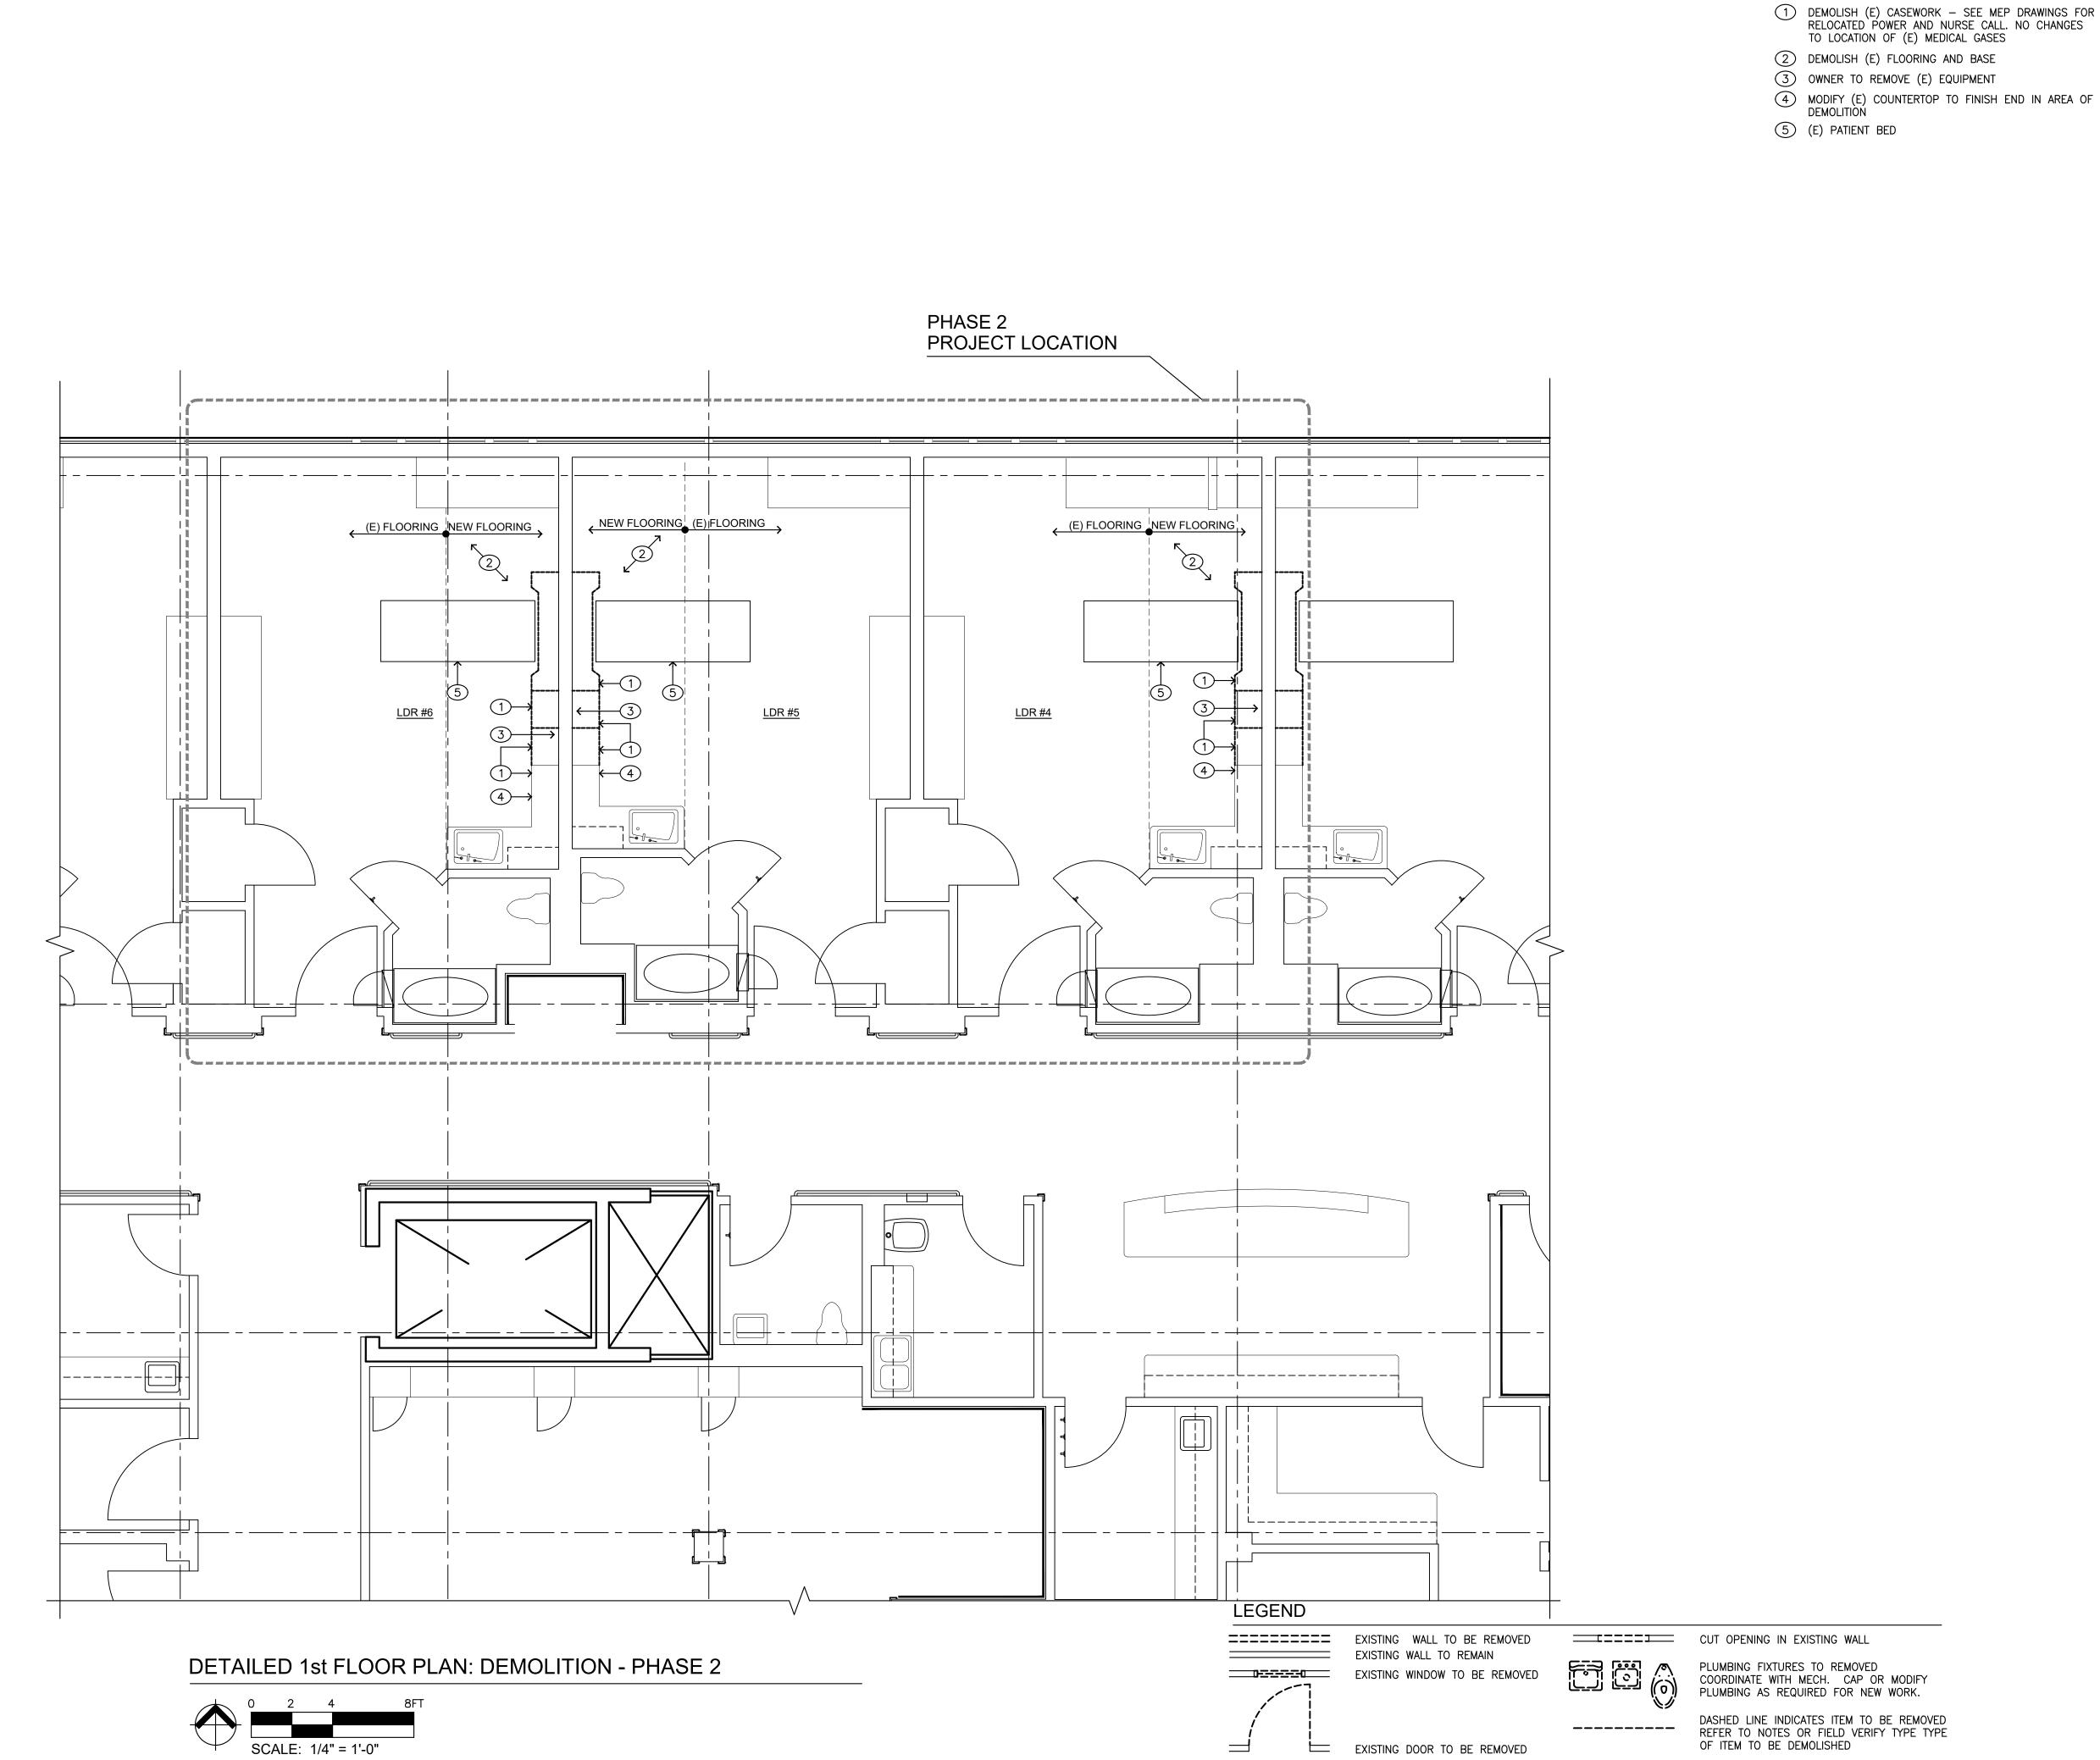- 1) DEMOLISH (E) CASEWORK SEE MEP DRAWINGS FOR RELOCATED POWER AND NURSE CALL. NO CHANGES

#### **GENERAL NOTES**

- 1. THESE DEMOLITION DRAWINGS ARE INTENDED TO SHOW EXISTING CONDITIONS TO BE REMOVED (OR DEMOLISHED) TO COORDINATE WITH NEW WORK TO BE INSTALLED. IT WILL BE THE RESPONSIBILITY OF THE CONTRACTOR TO VERIFY EXISTING CONDITIONS IN THE FIELD WITH NEW WORK TO BE INSTALLED. COORDINATE ALL EXTENT OF DEMOLITION WITH EXTENT OF NEW WORK TO BE INSTALLED. CONTRACTOR SHALL BRING ALL DISCREPANCIES BETWEEN NEW WORK AND EXISTING CONDITIONS TO THE ATTENTION OF THE ARCHITECT BY WRITTEN NOTIFICATION FOR CLARIFICATION/DECISION BEFORE PROCEEDING WITHIN THE AFFECTED PORTION OF THE WORK. ANY DEMOLITION WORK DONE INCORRECTLY WITH RESPECT TO NEW WORK TO BE DONE SHALL BE CORRECTED BY THE CONTRACTOR AT HIS EXPENSE. CORRECTION MAY BE EITHER REINSTALLATION OF EXISTING CONDITION OR MODIFICATION OF NEW WORK TO REMEDY INCORRECT DEMOLITION. THIS SHALL BE SOLELY JUDGED BY THE ARCHITECT.
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City of Puyallup elopment & Permitting Services **ISSUED PERMIT** Public Works Engineering

Traffic

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Seattle, WA 98125

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REGISTERED ARCHITECT Karsea M. Langlois STATE OF WASHINGTON

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## Alterations

Good Samaritan Hospital 401 15th Ave SE Puyallup, WA 98372

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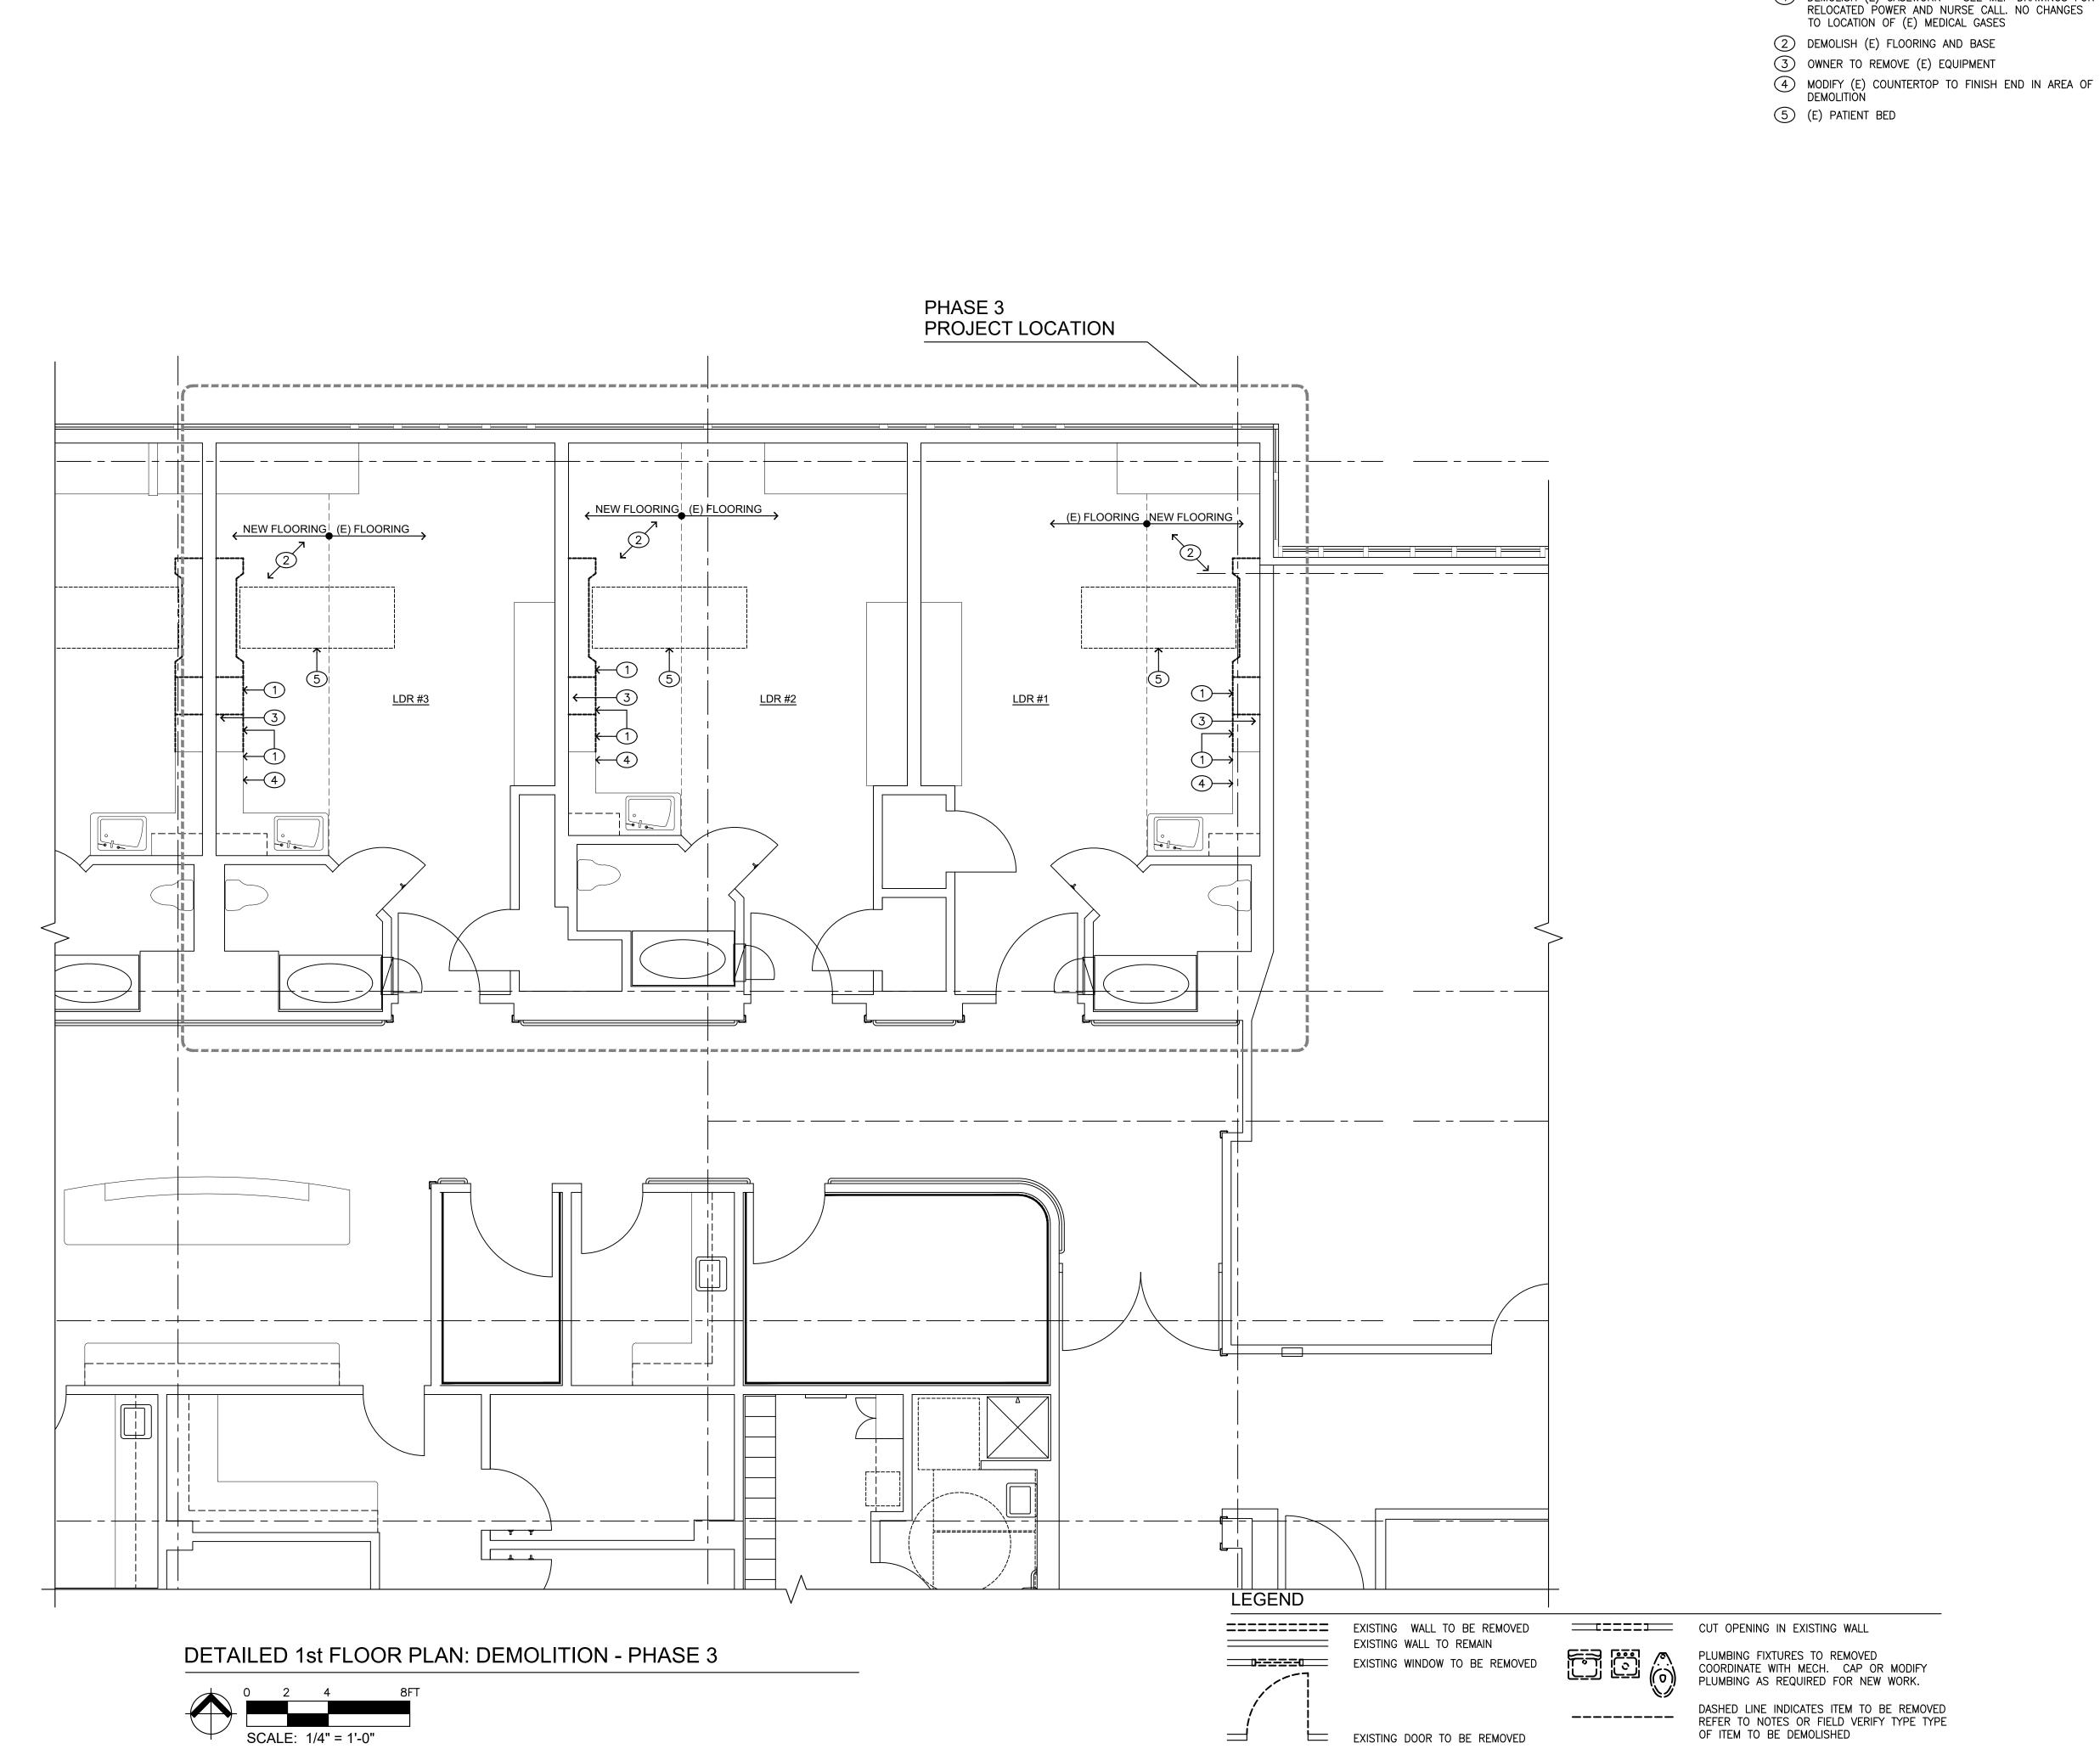
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SHEET TITLE: DETAILED 1st FLOOR PLAN: DEMOLITION

SHEET #:

PHASE 2



#### DEMOLITION PLAN KEYED NOTES


- 1) DEMOLISH (E) CASEWORK SEE MEP DRAWINGS FOR RELOCATED POWER AND NURSE CALL. NO CHANGES TO LOCATION OF (E) MEDICAL GASES
- 2 DEMOLISH (E) FLOORING AND BASE
- 3 OWNER TO REMOVE (E) EQUIPMENT

#### **GENERAL NOTES**

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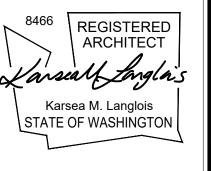
City of Puyallup evelopment & Permitting Services **ISSUED PERMIT** Planning Engineering Public Works

Traffic

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31260 PROJECT NO. K LANGLOIS

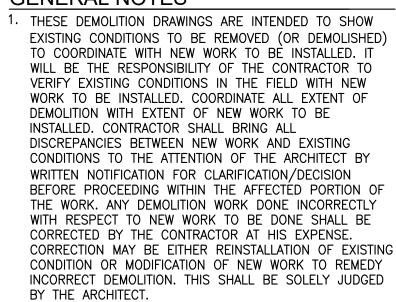DATE: 9 FEBRUARY 2024 COPYRIGHT TO:

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SHEET TITLE: DETAILED 1st FLOOR PLAN: DEMOLITION

SHEET #:

PHASE 3

#### **KEYED NOTES**

- 1 NEW "PANDA" INFANT WARMER
- 2 NEW FLOORING AND INTEGRAL COVED BASE

   TEKNOFLOR CLASSIC CUT HPD SHEET
  VINYL. COLOR TBD.
- 3 NEW MOBILE CART WITH TWO MONITORS, INFANT MONITOR, AND LABEL PRINTER
- MODIFY (E) SOLID SURFACE COUNTER AT AREA OF DEMOLITION. NEW WALL BRACKET SUPPORT AT OPEN END OF COUNTER, RADIUS CORNER OF COUNTER 2"
- (5) EXISTING PATIENT BED AT EXISTING LOCATION


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- 2. DRAWINGS SHALL NOT BE SCALED.
- 3. WHERE NOTES ON THE DRAWINGS INDICATE A CONDITION AT ONE LOCATION, WHETHER INDICATED AS TYPICAL OR NOT, THE NOTE SHALL APPLY TO ALL SIMILAR LOCATIONS, UNO.
- 4. SEE SHEET TO.O FOR ADDITIONAL NOTES, SYMBOLS, ABBREVIATIONS, ETC.
- 5. SEE CODE PLAN AND DETAILS, FOR EXTENT OF RATED WALLS, CEILINGS, OPENINGS & DETAIL.
- 6. GRID LINES ARE TO CENTERLINE OF STEEL AND STUDS @ FRAMED WALLS, UNO.
- 7. ALL INTERIOR WALL DIMENSIONS ARE TO FACE OF FINISHED WALL, AND ROUGH OPENINGS, UNLESS NOTED OTHERWISE OR INDICATED ON DETAILS.

InSight
HealthCare Architecture

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Seattle, WA 98125
206-601-6645

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OWNER:

MultiCare 🕰 Tacoma General Hospital

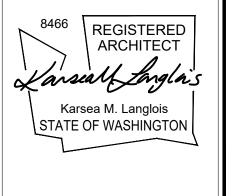PROJECT NAME:

# Infant Warmer Alterations

Good Samaritan Hospital 401 15th Ave SE Puyallup, WA 98372

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DRAWN BY: K LANGLOIS


DATE: 9 FEBRUARY 202 COPYRIGHT TO:

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DETAILED 1st FLOOR PLAN: PROPOSED PHASE 1

SHEET #:

A3.1

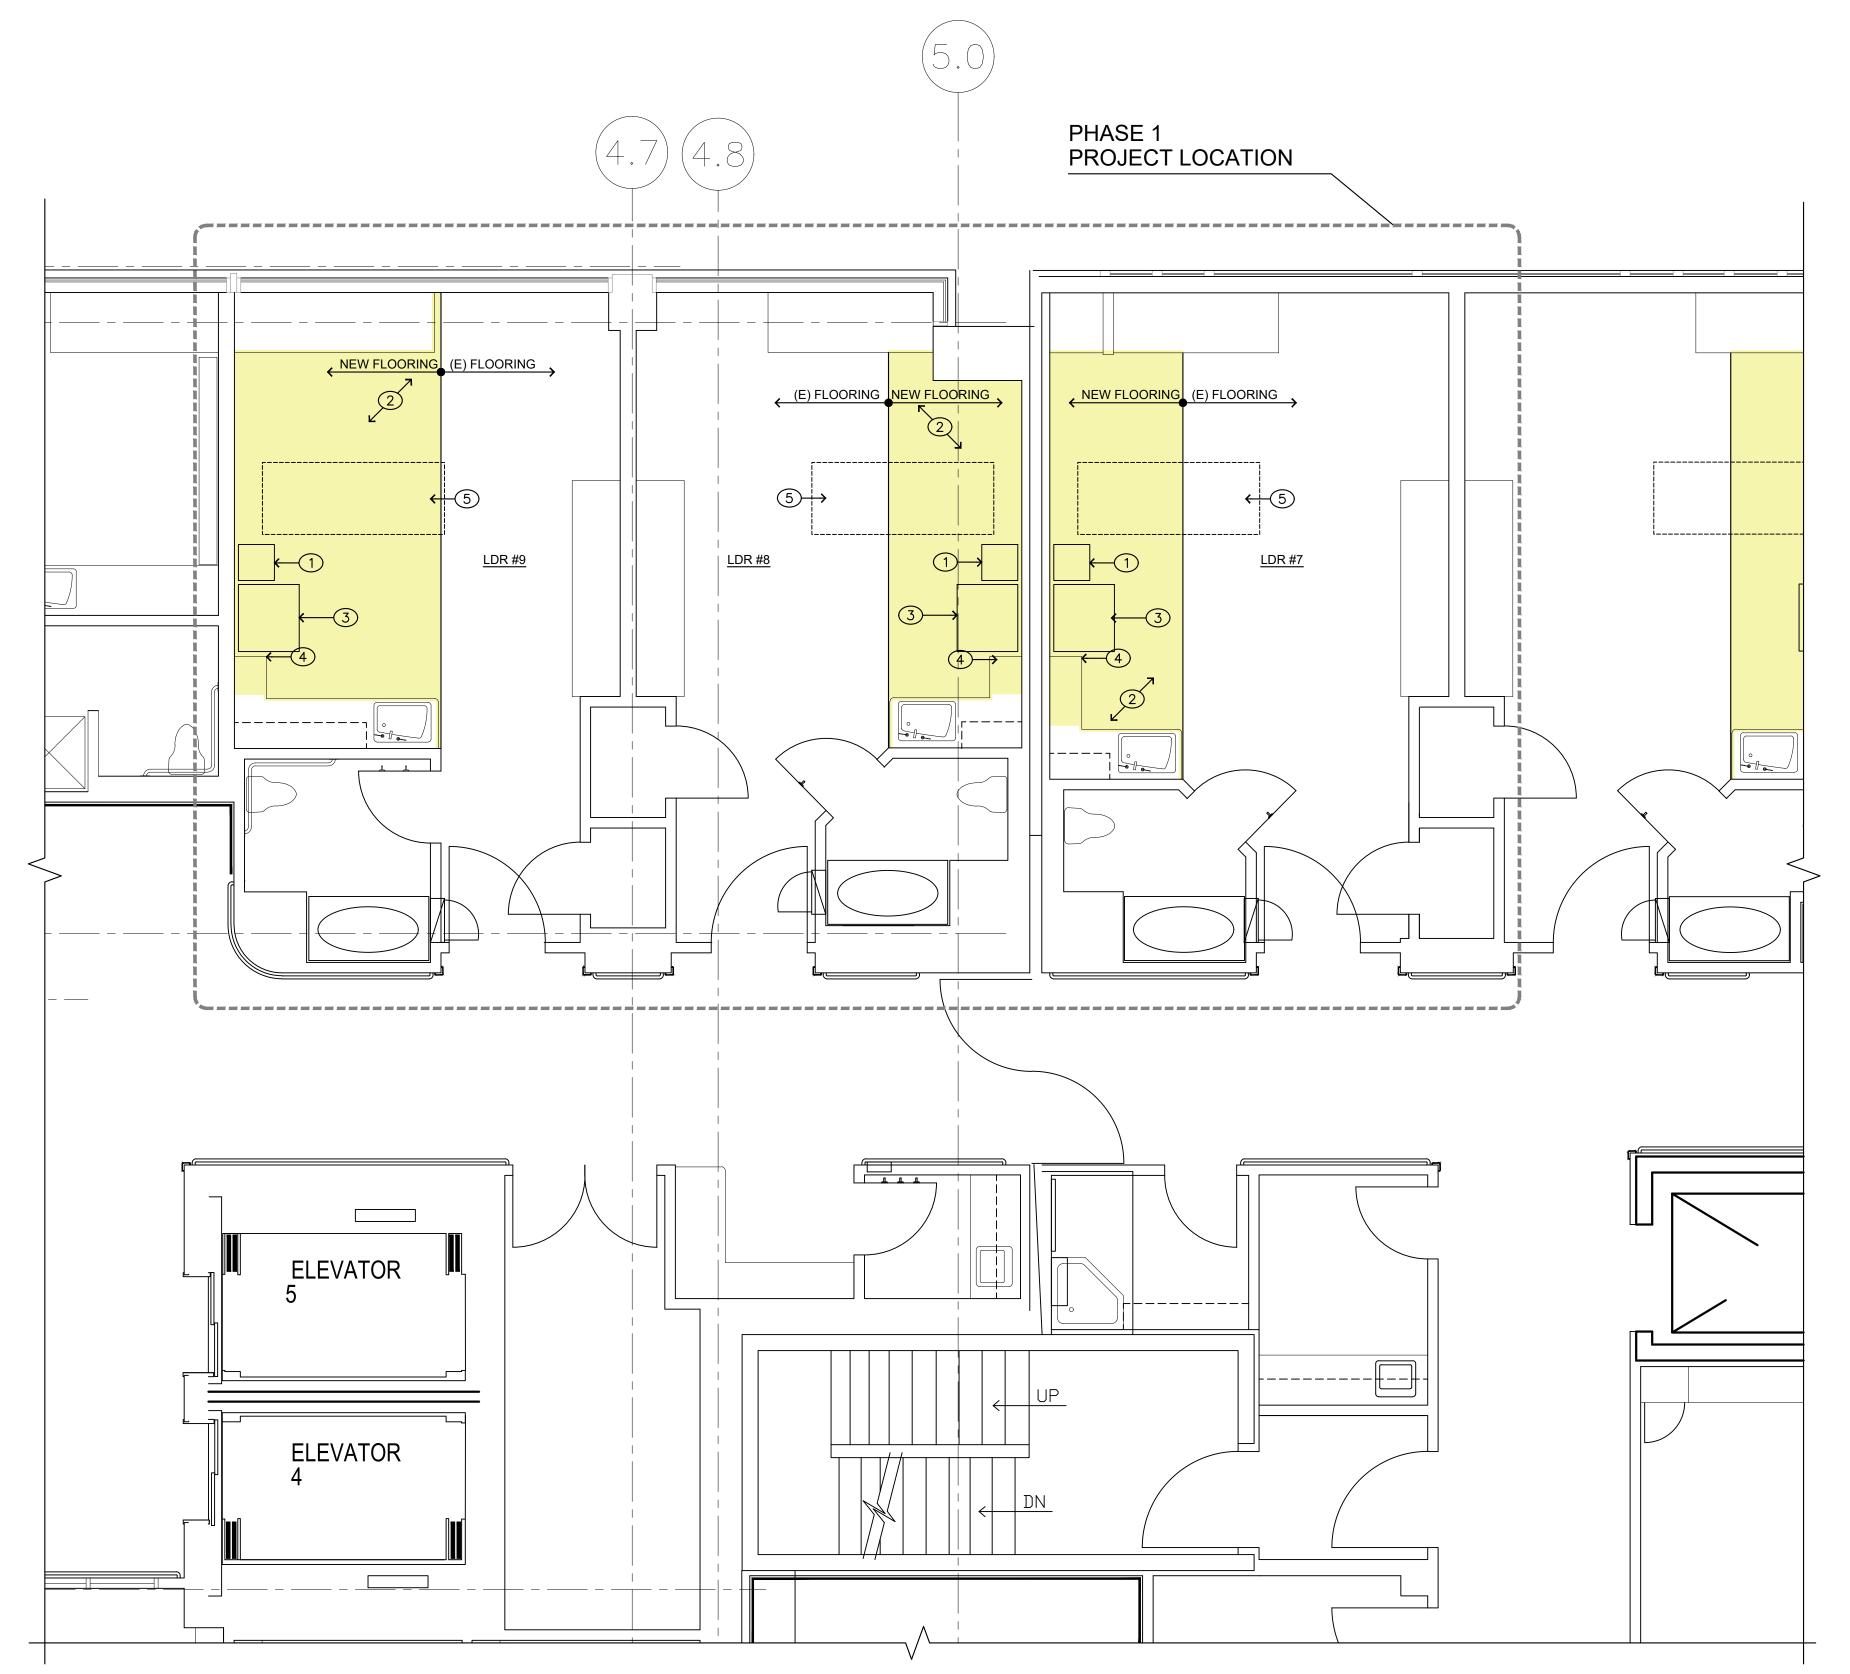

DETAILED 1st FLOOR PLAN: PROPOSED - PHASE 1

City of Puyallup
Development & Permitting Services
ISSUED PERMIT
Building Planning
Engineering Public Works

#### **KEYED NOTES**

- 1) NEW "PANDA" INFANT WARMER
- 2 NEW FLOORING AND INTEGRAL COVED BASE

   TEKNOFLOR CLASSIC CUT HPD SHEET
  VINYL. COLOR TBD.
- 3 NEW MOBILE CART WITH TWO MONITORS, INFANT MONITOR, AND LABEL PRINTER
- MODIFY (E) SOLID SURFACE COUNTER AT AREA OF DEMOLITION. NEW WALL BRACKET SUPPORT AT OPEN END OF COUNTER, RADIUS CORNER OF COUNTER 2"
- 5 EXISTING PATIENT BED AT EXISTING LOCATION

#### GF

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#### **GENERAL NOTES**



PRCTI20240324

REGISTERED ARCHITECT

Lausal Langlais

Karsea M. Langlois
STATE OF WASHINGTON

Seattle, WA 98125

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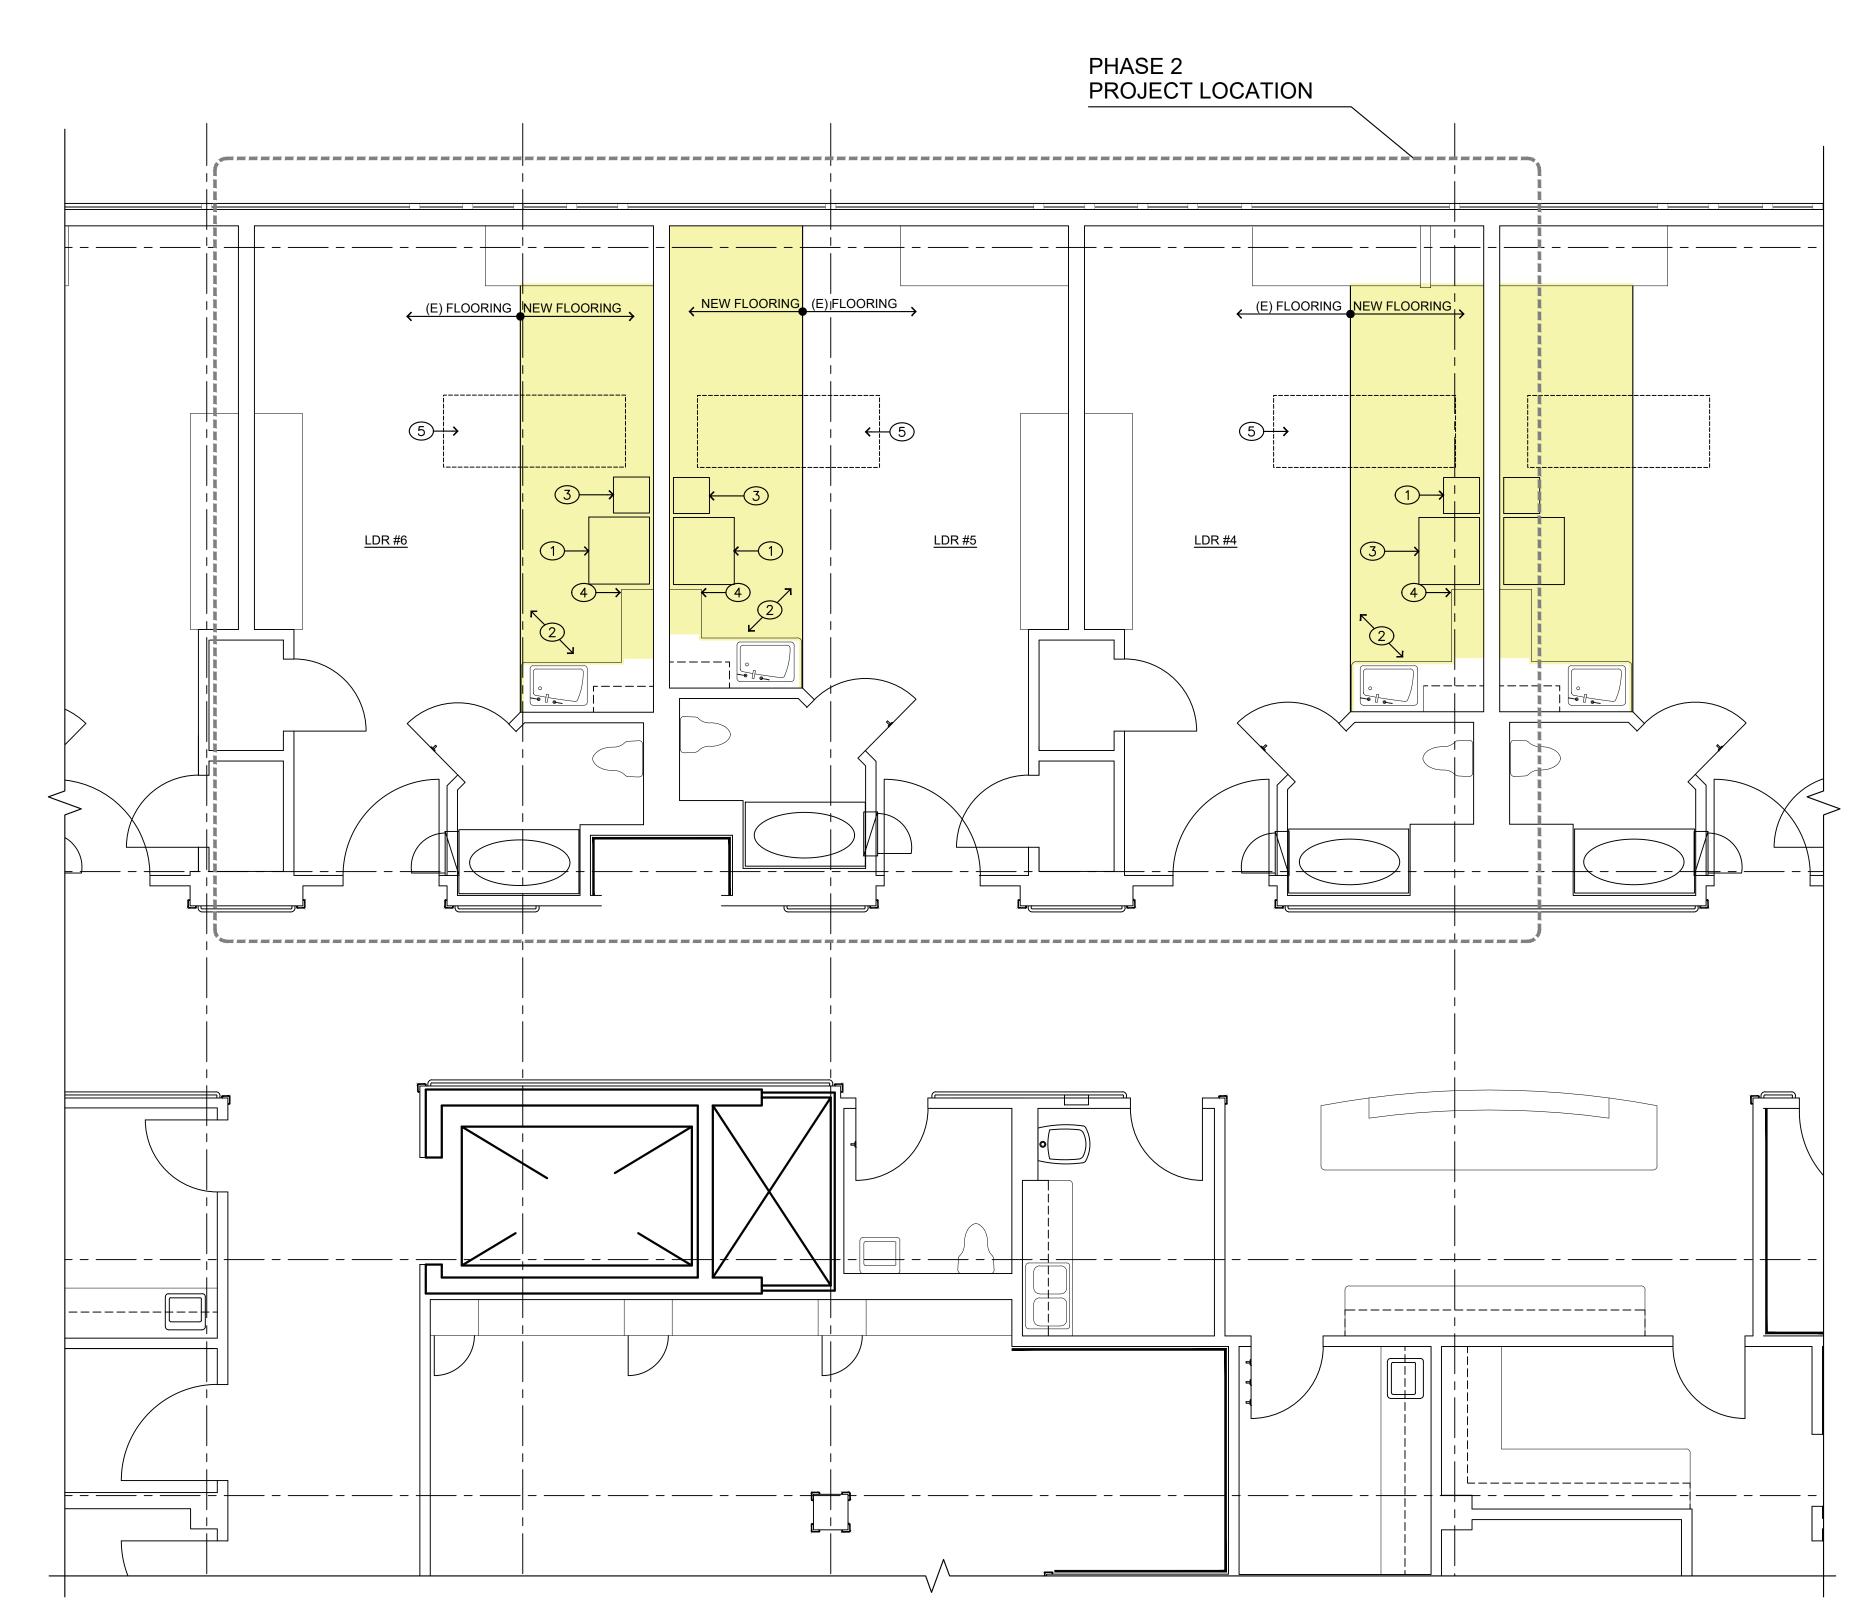
DATE: 9 FEBRUARY 202 COPYRIGHT TO:

InSight Healthcare Architecture
SHEET TITLE:

DETAILED 1st FLOOR PLAN: PROPOSED PHASE 2

SHEET #:

A3.2



City of Puyallup
Development & Permitting Services
ISSUED PERMIT
Building Planning
Engineering Public Works
Fire Traffic

#### **KEYED NOTES**

- 1) NEW "PANDA" INFANT WARMER
- 2 NEW FLOORING AND INTEGRAL COVED BASE - TEKNOFLOR CLASSIC CUT HPD SHEET VINYL. COLOR TBD.
- 3 NEW MOBILE CART WITH TWO MONITORS, INFANT MONITOR, AND LABEL PRINTER
- MODIFY (E) SOLID SURFACE COUNTER AT AREA OF DEMOLITION. NEW WALL BRACKET SUPPORT AT OPEN END OF COUNTER, RADIUS CORNER OF COUNTER 2"
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#### **GENERAL NOTES**



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Seattle, WA 98125

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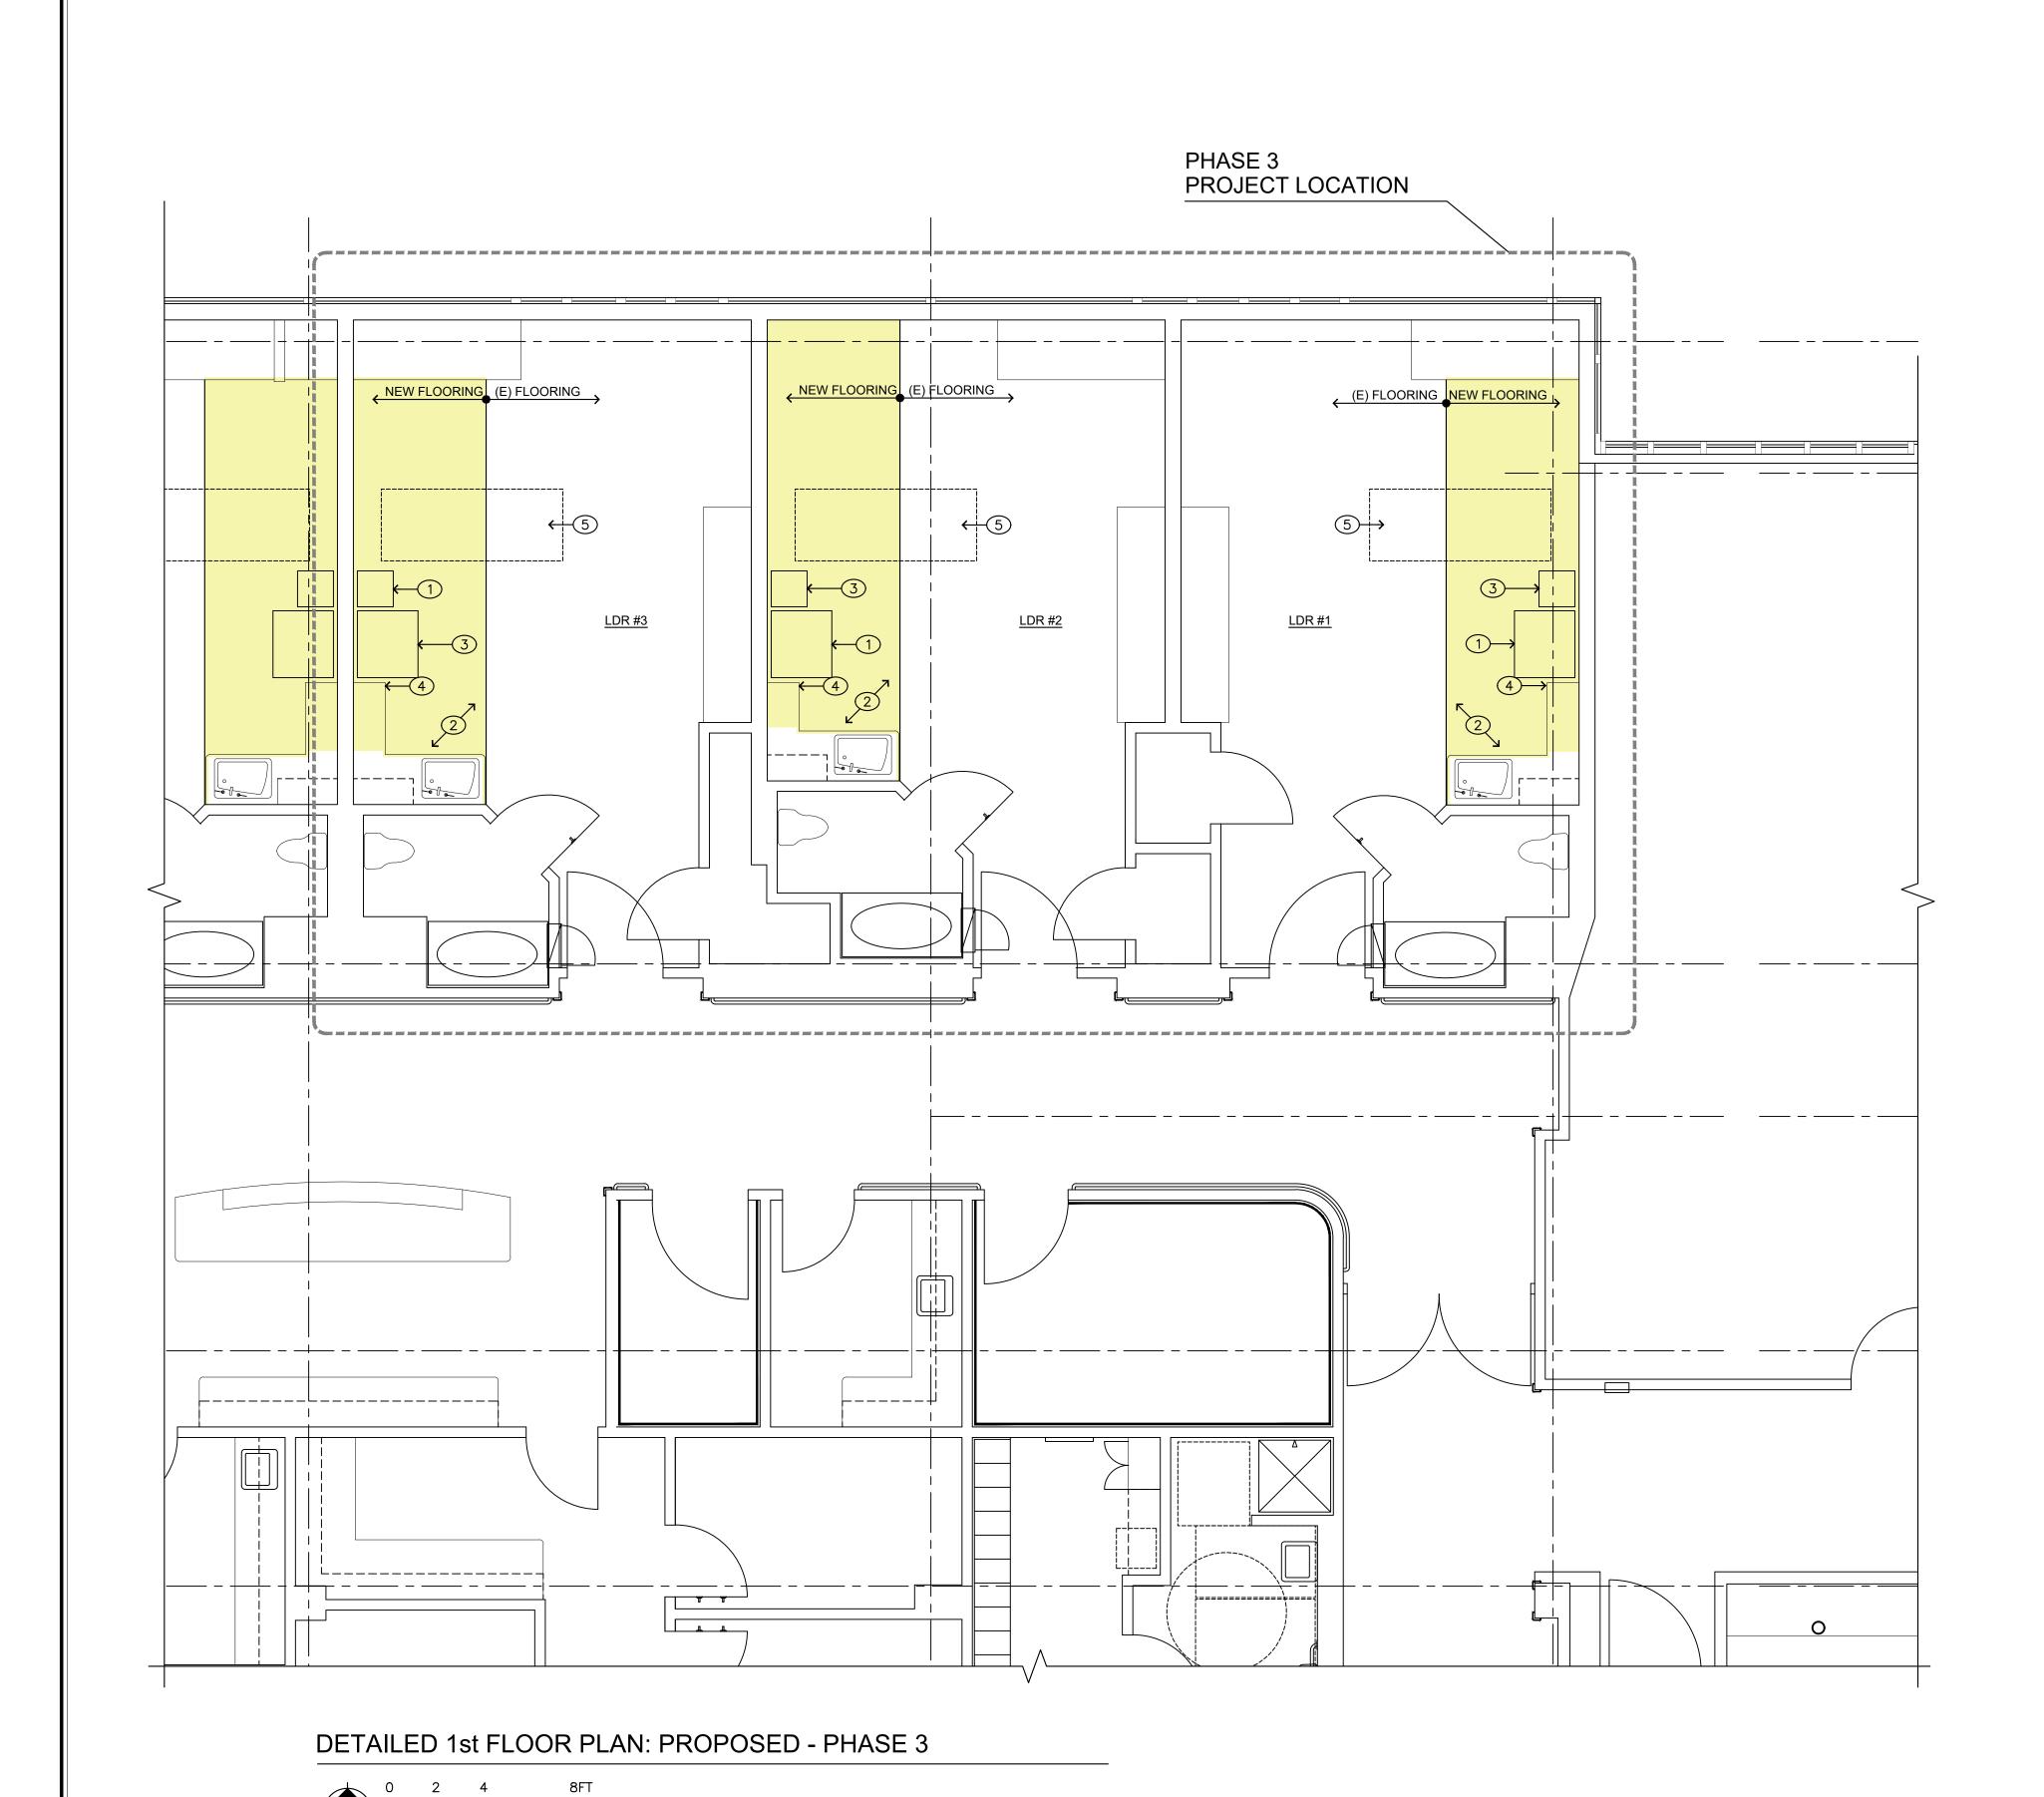
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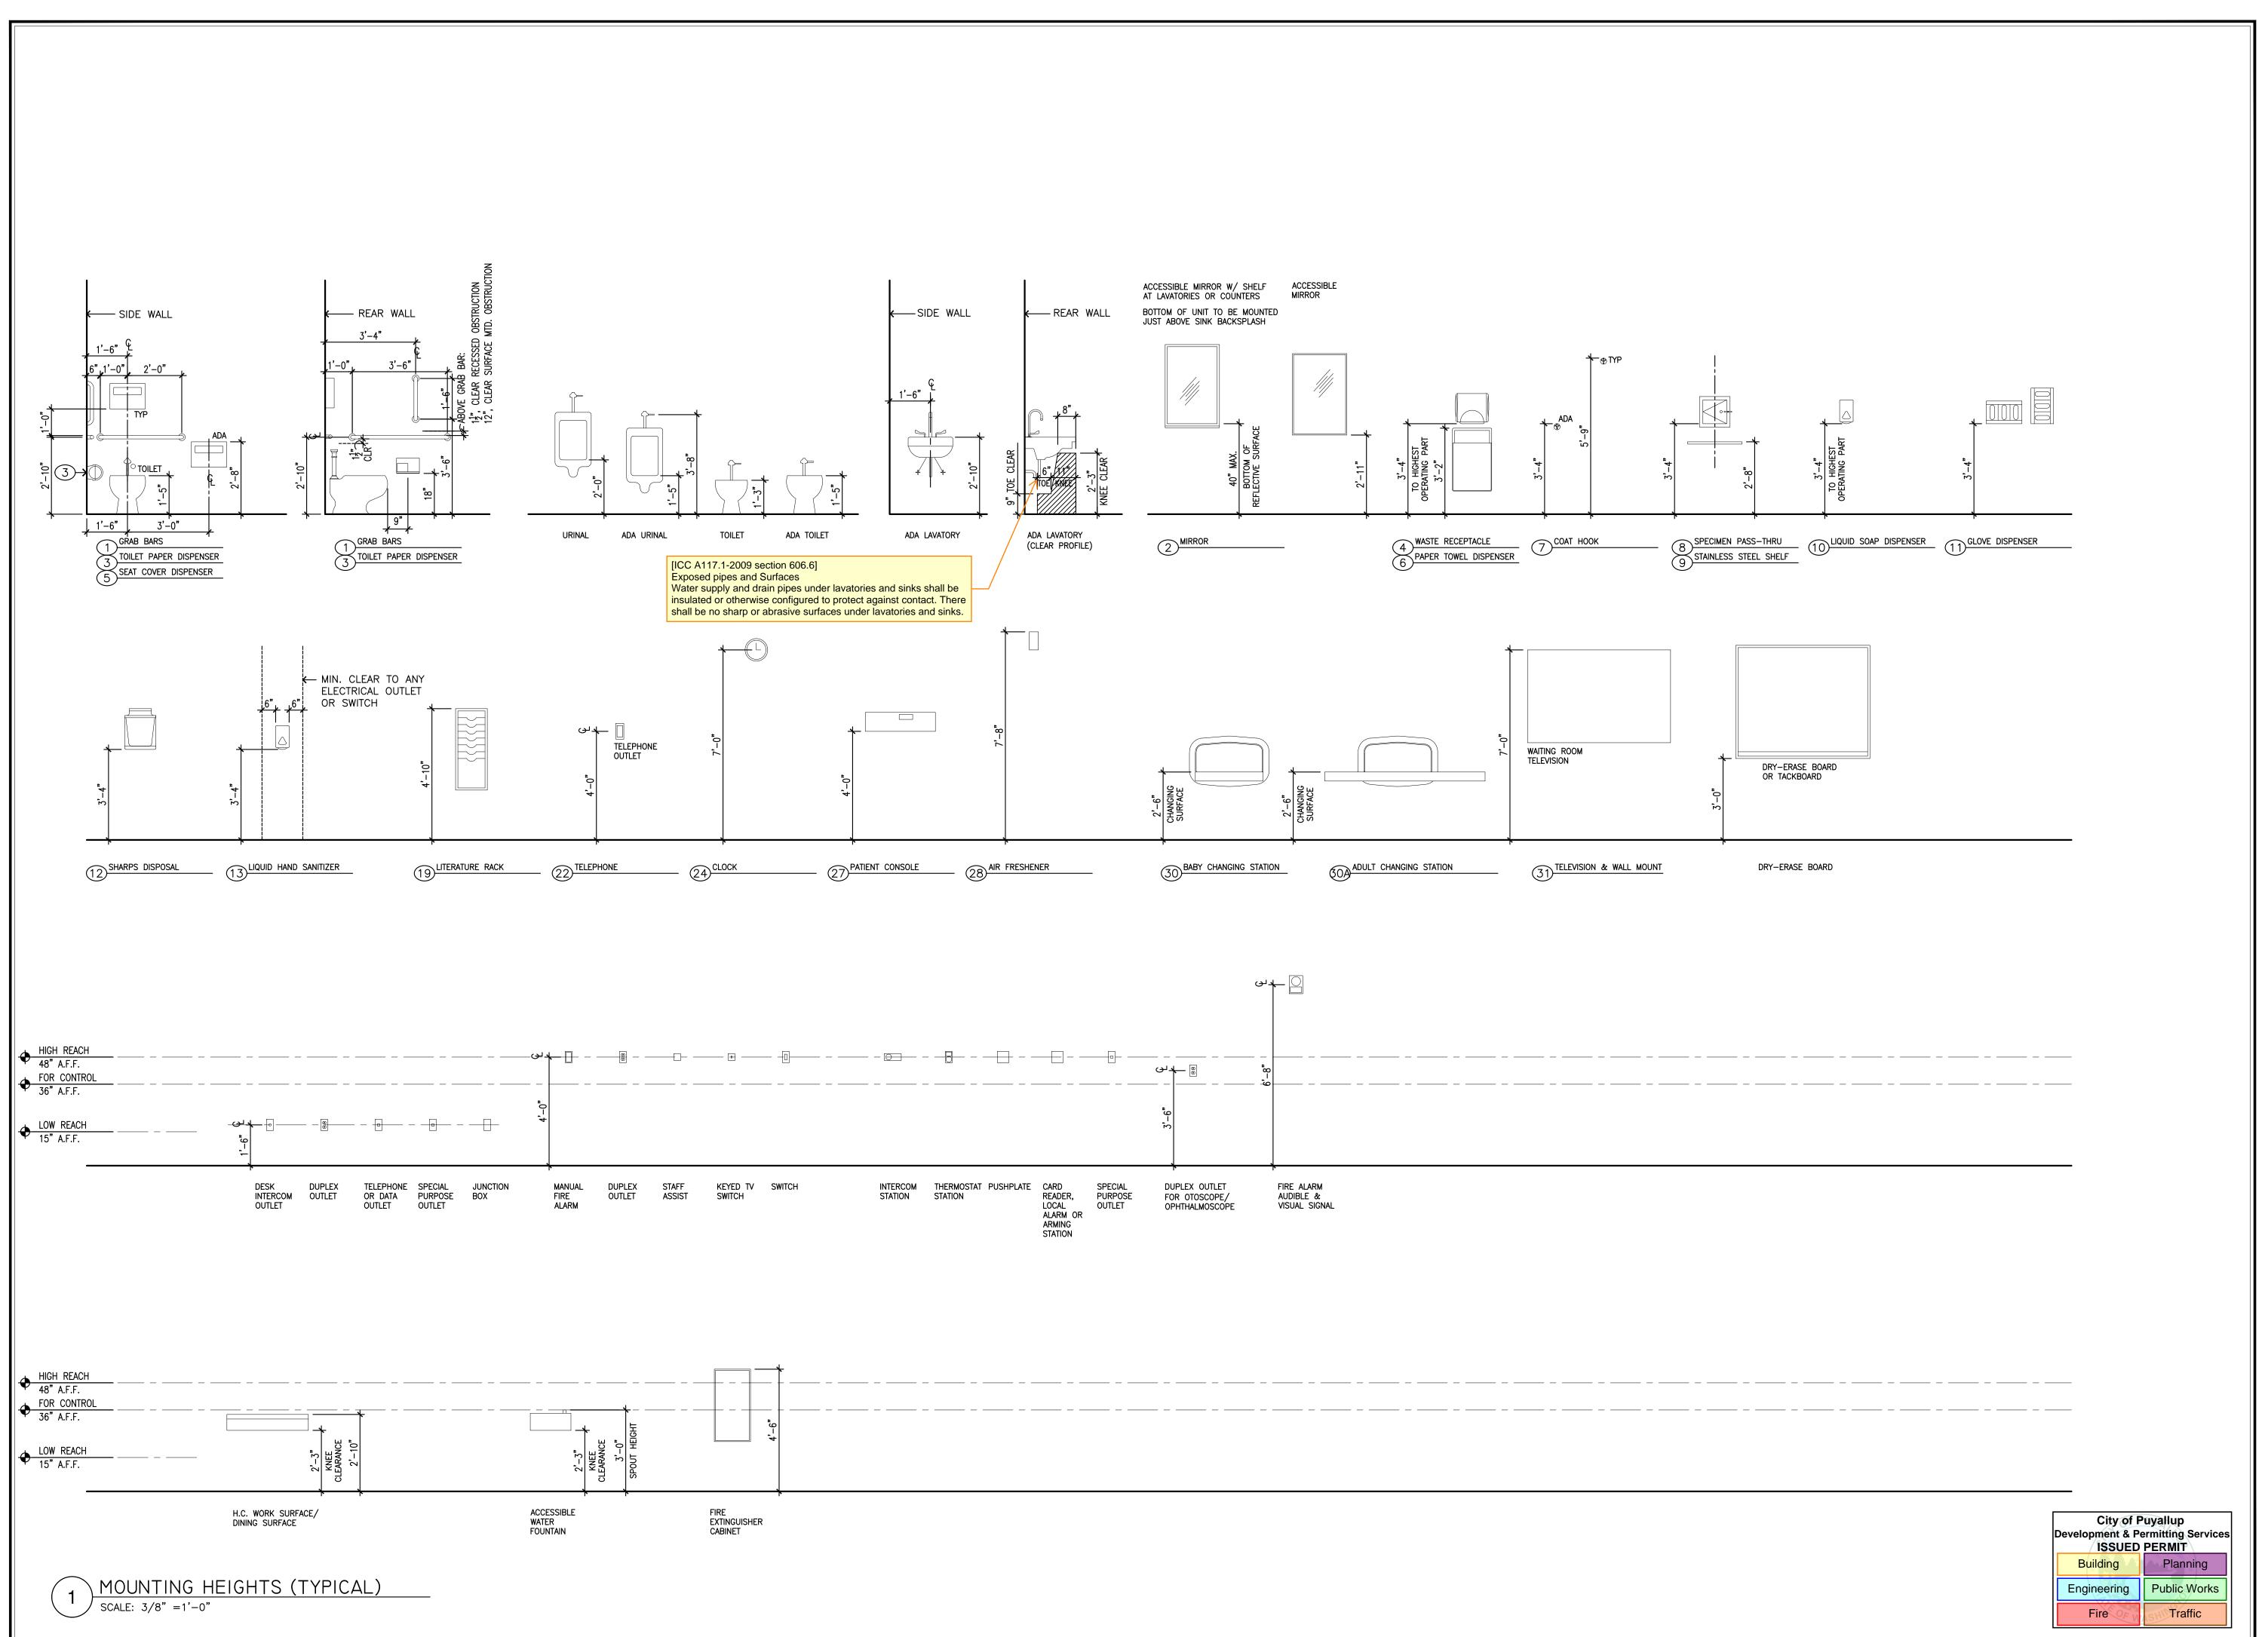
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SHEET TITLE: DETAILED 1st FLOOR PLAN: PROPOSED PHASE 3



City of Puyallup elopment & Permitting Services ISSUED PERMIT Public Works Engineering Traffic



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REGISTERED ARCHITECT

Varsual Langla's

Karsea M. Langlois
STATE OF WASHINGTON

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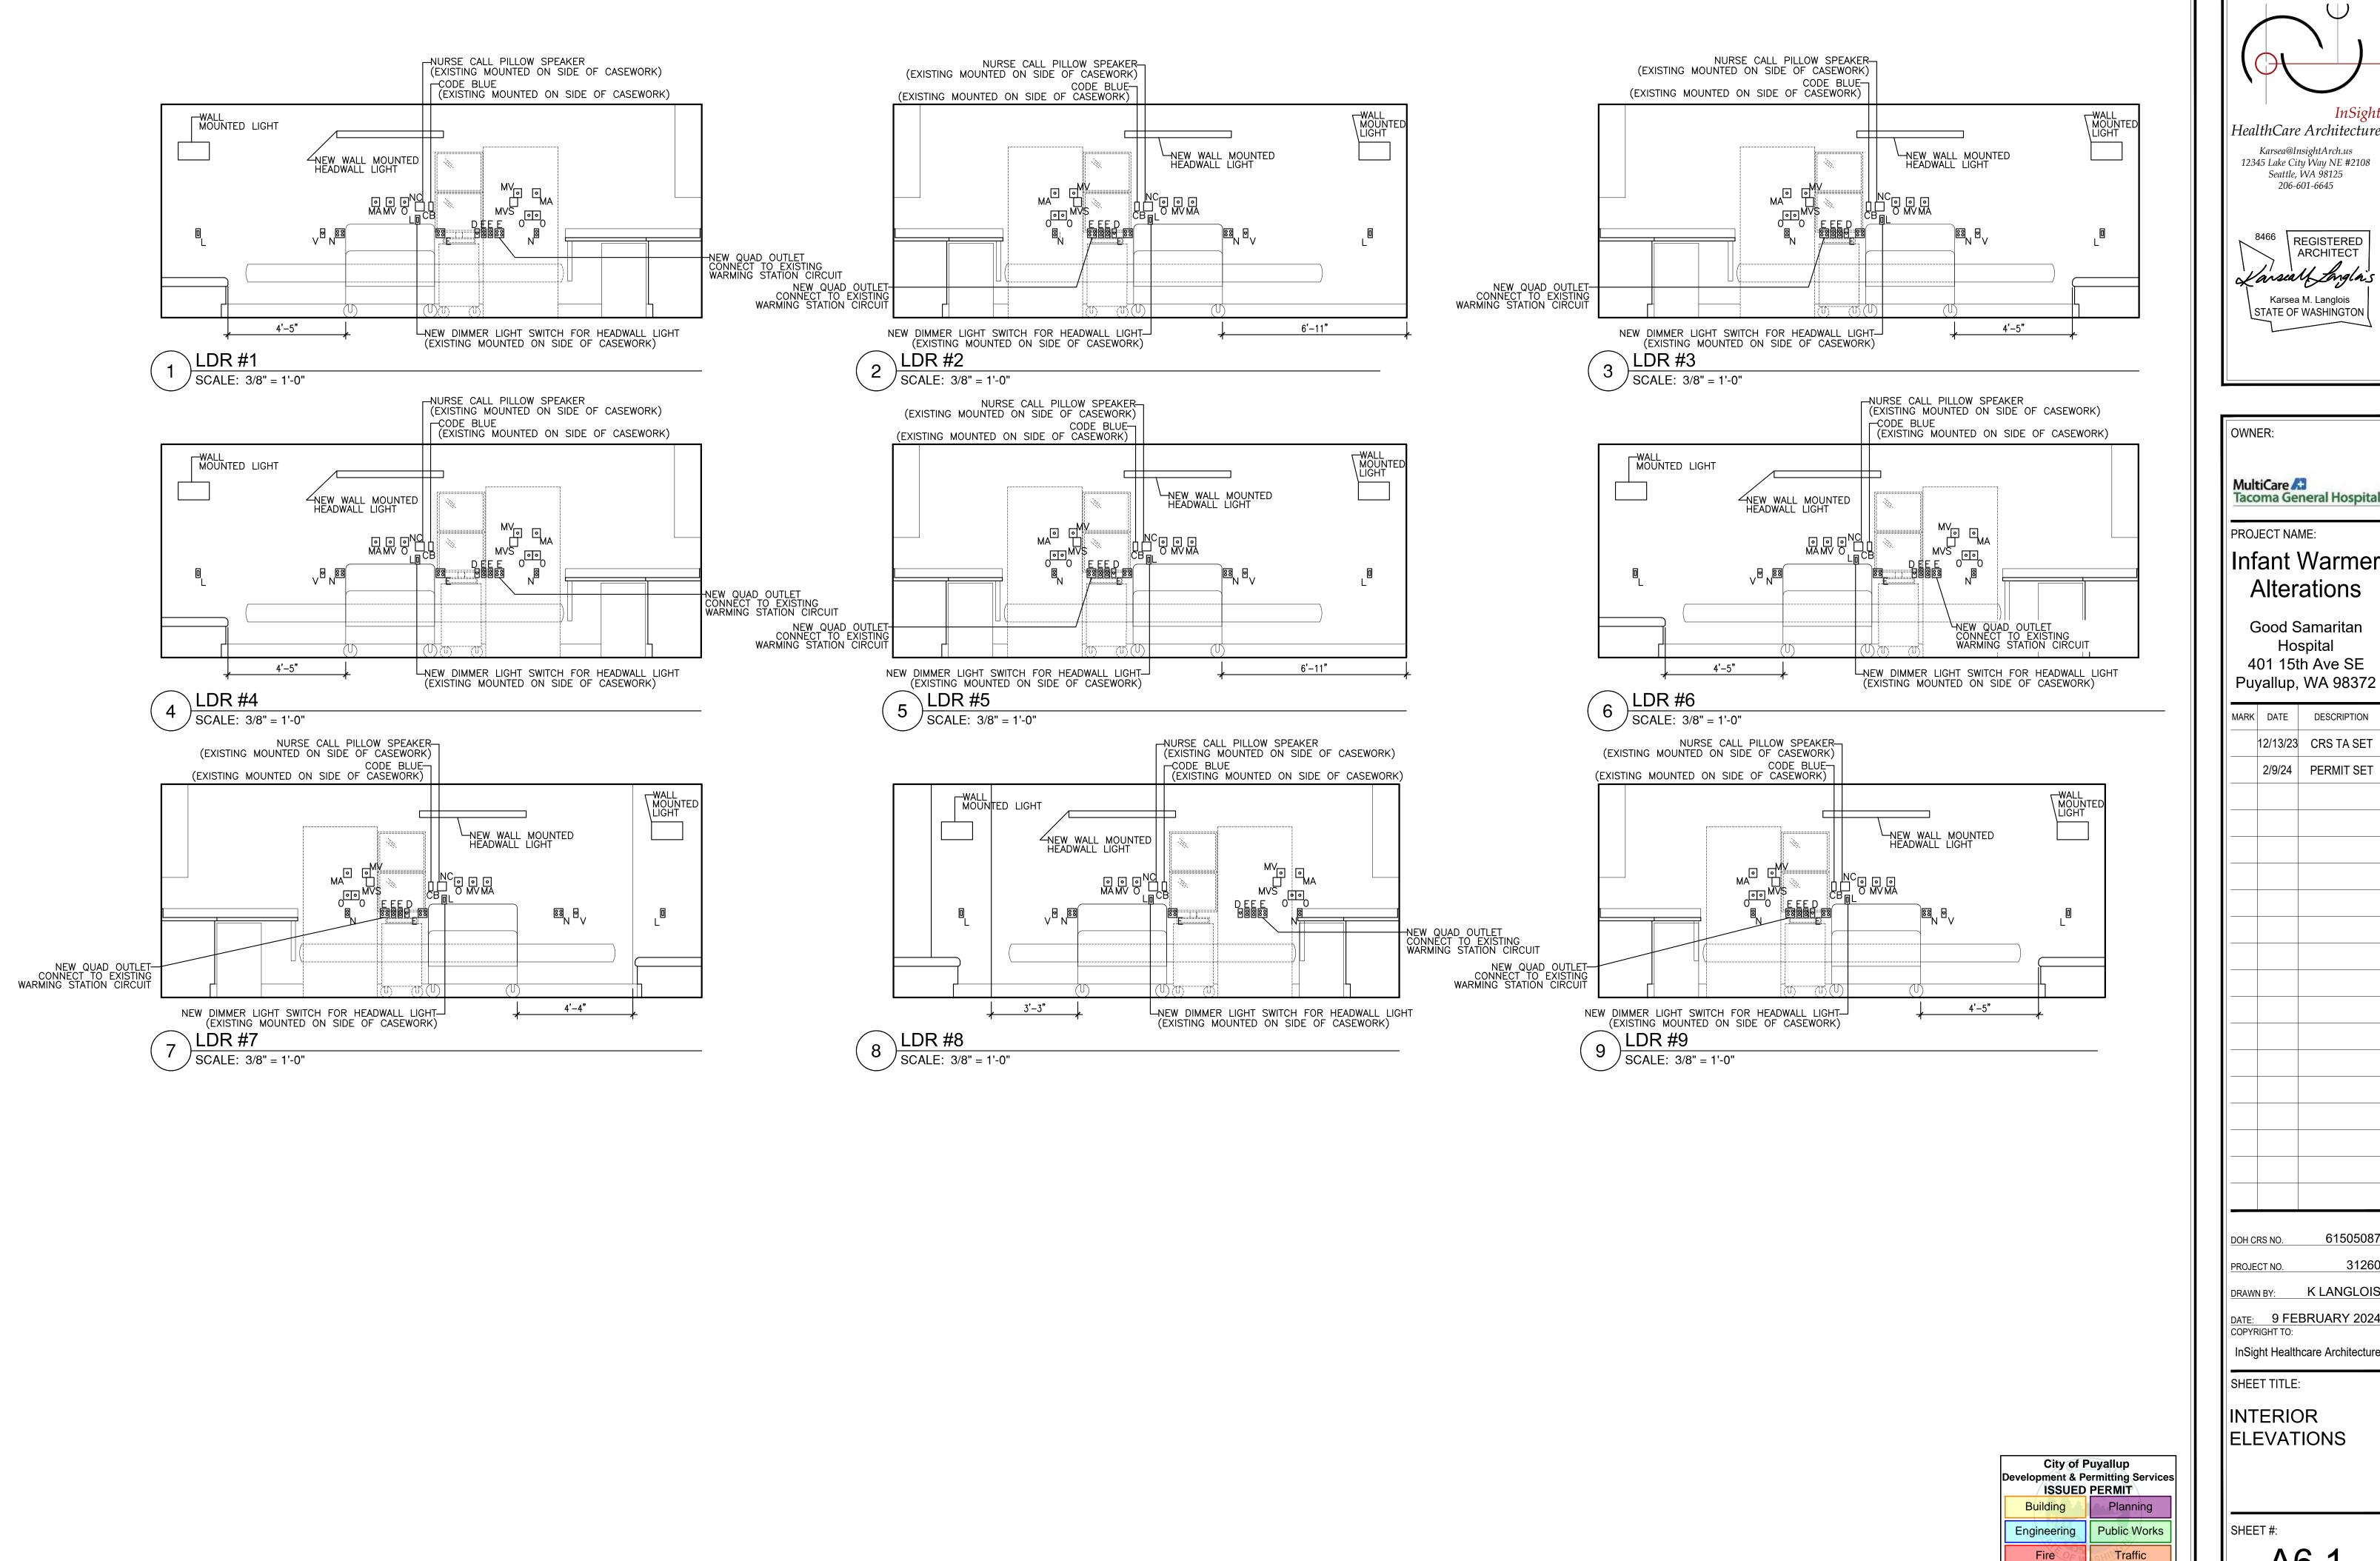
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SHEET TITLE:

TYPICAL MOUNTING HEIGHTS

SHEET #:

A6.0



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InSight Healthcare Architecture SHEET TITLE:

K LANGLOIS

INTERIOR ELEVATIONS

SHEET #:

A6.

## **NURSE CALL**

CODE BLUE BUTTON

PILLOW SPEAKER PATIENT STATION, SINGLE

CIRCUITS LIGHT FIXTURES

DTS-DRAWN TO SCALE NTS-NOT TO SCALE LTS-LENGTH ONLY TO SCALE, REFER TO FIXTURE SCHEDULE ■ a LOWER-CASE LETTER DENOTES SWITCH LEG ₩ ₩ WALL-MOUNTED, LTS

### LIGHTING CONTROLS

- LOWER-CASE LETTER DENOTES CIRCUIT CONTROLLED
- SINGLE-POLE SWITCH DIMMER SWITCH

### **EQUIPMENT**

EQUIPMENT CONNECTION

## CONTROLS

MOTOR-RATED TOGGLE SWITCH

### **TELECOM**

DATA OUTLET VOICE OUTLET

## CIRCUITS RECEPTACLES

DUPLEX, 120V DOUBLE DUPLEX, 120V

#### **CIRCUITS**

RACEWAY CONCEALED IN CEILING OR WALL

EXISTING RACEWAY

---- RACEWAY BELOW SLAB OR UNDERGROUND

──────────────────────── RACEWAY UP

RACEWAY DOWN

RACEWAY STUB-OUT WITH BUSHING

CIRCUIT CONTINUATION

JUNCTION BOX

**ELECTRICAL SHEET LIST** 

SHEET NAME

DETAILED 1ST FLOOR PLAN-ELECTRICAL DEMOLITION-PHASE 1 DETAILED 1ST FLOOR PLAN-ELECTRICAL DEMOLITION-PHASE 2 DETAILED 1ST FLOOR PLAN-ELECTRICAL DEMOLITION-PHASE 3

ELECTRICAL SYMBOLS AND ABBREVIATIONS

PARTIAL 1ST FLOOR PLAN - ELECTRICAL

DETAILED 1ST FLOOR PLAN-ELECTRICAL-PHASE 1 DETAILED 1ST FLOOR PLAN-ELECTRICAL-PHASE 2

DETAILED 1ST FLOOR PLAN-ELECTRICAL-PHASE 3

ELECTRICAL SPECIFICATIONS

SHEET NUMBER

E0.1

E1.1

E3.1

E3.3


PULL BOX


**RECEPTACLES** 

## **WORK DEFINITION**

 $\blacktriangleright$ 



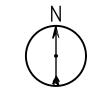

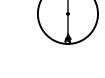



FUTURE WORK

//// ××× DEMOLISH EXISTING


#### **GENERAL NOTES:**

- 1. ALL ELECTRICAL WORK AND MATERIALS ARE TO COMPLY WITH THE LATEST THE LOCAL AUTHORITY HAVING JURISDICTION.
- 2. THE LOCATIONS OF ELECTRICAL DEVICES OR LIGHTING FIXTURES INDICATED ON ARCHITECTURAL PLANS, ELEVATIONS, OR SECTIONS TAKE PRECEDENCE OVER LOCATIONS INDICATED ON THE ELECTRICAL DRAWINGS.
- 3. PROVIDE A #12 GREEN GROUNDING CONDUCTOR (MINIMUM SIZE) FOR ALL 120V AND ALL 277V POWER AND LIGHTING CIRCUITS UNLESS OTHER WISE NOTED OR CODE REQUIRED.

A,AMP	AMPERE	MCC	MOTOR CONTROL CENTER
AC	3" ABOVE COUNTER	MLO	MAIN LUGS ONLY
	BACKSPLASH	MW	MICROWAVE
AFF	ABOVE FINISHED FLOOR	N	NEUTRAL
AHJ	AUTHORITY HAVING	NEC	NATIONAL ELECTRICAL
	JURISDICTION		CODE
AIC	AMPERE INTERRUPTING	NEMA	NATIONAL ELECTRICAL
	CAPACITY		MANUFACTURERS
ATS	AUTOMATIC TRANSFER		ASSOCIATION
	SWITCH	NFPA	NATIONAL FIRE PROTECTION
AWG	AMERICAN WIRE GAUGE		ASSOCIATION
BKR	BREAKER	NTS	NOT TO SCALE
С	CONDUIT	OCPD	OVERCURRENT PROTECTIVE
CB	CIRCUIT BREAKER		DEVICE
CKT	CIRCUIT	PB	PULLBOX
CTRL	CONTROL	PNL	PANEL, PANELBOARD
CU	COPPER	PWR	POWER
D	DATA	RCP	REFLECTED CEILING PLAN
DTS	DRAWN TO SCALE	RCPT	RECEPTACLE
DWG	DRAWING	REF	REFRIGERATOR
FA	FIRE ALARM	SMR	SURFACE MOUNTED
FO	FIBER OPTIC(AL)		RACEWAY
G,GND	GROUND	SPECS	SPECIFICATIONS
GEN	GENERATOR	SW	SWITCH
GFI,GFCI	GROUND FAULT CIRCUIT	SWBD	SWITCHBOARD
·	INTERRUPTER	TELECOM	
HP	HORSEPOWER	TGB	TELECOMMUNICATIONS
HTR	HEATER		GROUNDING BUSBAR
IDF	INDEPENDENT DISTRIBUTION	TMGB	TELECOMMUNICATIONS MAIN
	FRAME		GROUNDING BUSBAR
JB,J-BOX	JUNCTION BOX	TYP	TYPICAL
KV	KILOVOLT	UC	UNDER COUNTER
KVA	KILOVOLT AMPERE	V	VOLT OR VOICE
KW	KILOWATT	W	WIRE, WATT, OR
KWH	KILOWATT HOUR	=	WALLPHONE
LED	LIGHT EMITTING DIODE	WAP	WIRELESS ACCESS POINT
LS	LIFE SAFETY	WP	WEATHERPROOF
LTG	LIGHTING	XFMR	TRANSFORMER
LTS	LENGTH ONLY TO SCALE	Ø	PHASE
MCB	MAIN CIRCUIT BREAKER		

Separate Electrical Permit is required with the Washington State Department of

City of Puyallup Development & Permitting Services ISSUED PERMIT Engineering Public Works Traffic

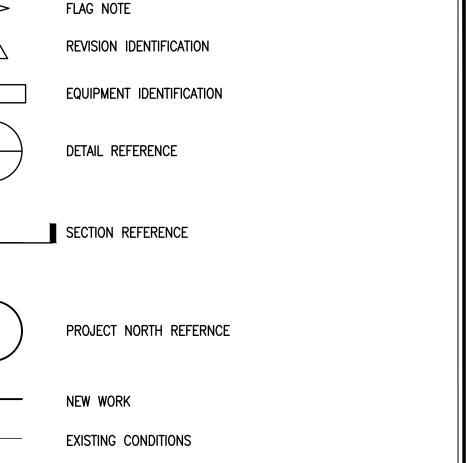

REQUIREMENTS OF ALL APPLICABLE CITY, COUNTY, AND STATE CODES AS WELL AS THE NATIONAL ELECTRICAL CODE AS ADOPTED AND AMENDED BY

#### **ABBREVIATIONS**

A,AMP	AMPERE	MCC	MOTOR CONTROL CENTER
AC	3" ABOVE COUNTER	MLO	MAIN LUGS ONLY
	BACKSPLASH	MW	MICROWAVE
AFF	ABOVE FINISHED FLOOR	N	NEUTRAL
AHJ	AUTHORITY HAVING	NEC	NATIONAL ELECTRICAL
	JURISDICTION		CODE
AIC	AMPERE INTERRUPTING	NEMA	NATIONAL ELECTRICAL
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G,GND	GROUND	SPECS	SPECIFICATIONS
GEN	GENERATOR	SW	SWITCH
GFI,GFCI	GROUND FAULT CIRCUIT	SWBD	SWITCHBOARD
01 1,01 01	INTERRUPTER	TELECOM	TELECOMMUNICATIONS
HP	HORSEPOWER	TGB	TELECOMMUNICATIONS
HTR	HEATER		GROUNDING BUSBAR
IDF	INDEPENDENT DISTRIBUTION	TMGB	TELECOMMUNICATIONS MAIN
151	FRAME		GROUNDING BUSBAR
JB,J-BOX	· · · · · · · · · · · · · · · ·	TYP	TYPICAL
KV KV	KILOVOLT	UC	UNDER COUNTER
KVA	KILOVOLT AMPERE	٧	VOLT OR VOICE
KW	KILOWATT	W	WIRE, WATT, OR
KWH	KILOWATT HOUR		WALLPHONE
LED	LIGHT EMITTING DIODE	WAP	WIRELESS ACCESS POINT
LS	LIFE SAFETY	WP	WEATHERPROOF
LTG	LIGHTING	XFMR	TRANSFORMER
LTS	LENGTH ONLY TO SCALE	Ø	PHASE
MCB	MAIN CIRCUIT BREAKER		
. –			

https://lni.wa.gov/licensing-permits/electrical/electrical-permits-fees-and-inspections or call for Licensing Information: 1-800-647-0982

PRCTI20240324





OWNER:

MultiCare 😂 Tacoma General Hospital

PROJECT NAME:

## Infant Warmer Alterations

Good Samaritan Hospital 401 15th Ave SE Puyallup, WA 98372

MARK DATE DESCRIPTION

	2/9/2024	PERMIT SET
OJE	CT NO.	31260

DATE: 1 NOVEMBER 2023 COPYRIGHT TO: InSight Healthcare Architecture

SHEET TITLE: ELECTRICAL SYMBOLS AND

ABBREVIATIONS

SHEET #:

#### ECTION 26 05 10 - EXISTING SYSTEMS:

#### |Part 1 — General

#### 1 INDICATED EXISTING SYSTEMS

- THE ELECTRICAL DRAWINGS SHOW PORTIONS OF THE EXISTING ELECTRICAL SYSTEMS WHICH ARE TO REMAIN. BE REMOVED OR BE MODIFIED. THE EXISTING INFORMATION IS DERIVED FROM RECORD DRAWINGS AND OTHER DATA OBTAINED FROM OR WITH THE PERMISSION OF THE OWNER. WHERE INDICATED, CONCEALED SYSTEMS ARE ALSO DERIVED FROM RECORD DRAWINGS AND THE ENGINEER'S BEST JUDGMENT OF THE CONFIGURATION.
- THE CONTRACTOR SHALL INSPECT THE EXISTING INSTALLATION PRIOR TO BIDDING AND SHALL JUDGE THE WORK REQUIRED. INSPECTION SHALL INCLUDE AREAS WITHIN AND ADJACENT TO THE WORK OF ANY DISCIPLINE OR TRADE PERFORMING WORK FOR THE CONTRACT.
- THE COMPLETE EXTENT OF THE EXISTING SYSTEMS COULD NOT BE VERIFIED DURING CREATION OF THE CONSTRUCTION DOCUMENTS. UNLESS THE CONTRACTOR'S INSPECTION OF THE EXISTING SYSTEM DETERMINES A GREATER AMOUNT, THE CONTRACTOR SHALL ASSUME THERE IS 20% MORE EXISTING ELECTRICAL SYSTEMS THAN WHAT IS INDICATED ON THE CONTRACT DRAWINGS.

#### POWER OUTAGES

- A. IT IS REQUIRED THAT THE CONTRACTOR FULLY SCHEDULE ELECTRICAL SYSTEM(S) OUTAGES WITH THE OWNER CONTRACTOR SHALL WORK CLOSELY WITH OWNER TO ASSURE THE OWNER FULLY UNDERSTANDS THE EXTENT OF EACH OUTAGE. OWNER MAINTAINS THE RIGHT TO LIMIT THE EXTENT AND LENGTH OF ANY GIVEN OUTAGE. ASSUME ALL OUTAGES TO ELECTRICAL SYSTEM(S) IN OWNER OCCUPIED AREAS WILL REQUIRE PREMIUM TIME AND THAT TEMPORARY ELECTRICAL WORK MAY BE REQUIRED TO LIMIT THE DURATION OF OUTAGES.
- CUTOVERS MUST MAKE ALTERNATIVE ARRANGEMENTS TO DELIVER POWER TO THE LOAD AT ALL TIMES UNLESS OTHERWISE NOTED BY THE OWNER.

#### ||PART 2 - PRODUCTS

#### 2.1 EXISTING MATERIALS

- A. ALL MATERIALS WHICH ARE A PART OF THE BUILDING SHALL REMAIN THE PROPERTY OF THE OWNER.
- 2.2 EXISTING MATERIALS TO BE REINSTALLED
- A. EXISTING MATERIALS AND EQUIPMENT (EXCEPT INTERIOR, UNDAMAGED RACEWAYS) THAT ARE REMOVED AS A PART OF THE WORK OR STORED IN SURPLUS SHALL NOT BE REINSTALLED AS A PART OF THE NEW SYSTEMS UNLESS SPECIFICALLY NOTED OR AUTHORIZED IN WRITING BY THE OWNER. FORWARD A COPY OF THE AUTHORIZATION TO THE ENGINEER. THE REQUIREMENTS OF THE SPECIFICATIONS (I.E., CONDITION, INSTALLATION, TESTING, ETC.) SHALL APPLY AS IF THE MATERIALS WERE NEW, FURNISHED BY THE CONTRACTOR.

#### 2.3 EXISTING MATERIALS NOT TO BE REINSTALLED

- IN COORDINATION WITH THE ARCHITECT, THESE MATERIALS SHALL BE MADE AVAILABLE FOR INSPECTION AND DECISION AS TO WHETHER THE OWNER WILL RETAIN POSSESSION. ITEMS SELECTED FOR RETENTION SHALL BE TURNED OVER TO THE OWNER. THESE ITEMS SHALL BE DELIVERED TO A LOCATION ON THE PREMISES SELECTED BY THE OWNER. TAKE REASONABLE CARE TO AVOID DAMAGE TO THIS MATERIAL. IF THE CONTRACTOR FAILS TO CONFORM TO THIS REQUIREMENT, CONTRACTOR SHALL PURCHASE AND TURN OVER TO THE OWNER REPLACEMENT MATERIAL OF LIKE KIND AND QUANTITY.
- B. ALL MATERIAL NOT SELECTED FOR RETENTION BY THE OWNER AND DEBRIS SHALL BE LEGALLY DISPOSED OF BY THE CONTRACTOR

#### PART 3 - EXECUTION

#### 3.1 EXISTING CONDITIONS

- A. FIELD TRACE ALL EXISTING CIRCUITRY AFFECTED BY THE PROJECT TO DETERMINE:
- 1. SOURCE OF SUPPLY OR INFORMATION COLLECTION POINT WITHIN THE PROJECT AREA
- 2. LOAD OR TERMINATION WITHIN THE PROJECT AREA 3. LOAD OR TERMINATION OUTSIDE THE PROJECT AREA, BUT SUPPLIED FROM OR CONNECTED TO EQUIPMENT
- WITHIN THE PROJECT AREA 4. LOADS SUPPLIED FROM AND LOCATED OUTSIDE OF THE PROJECT AREA BUT HAVE CIRCUITRY WITHIN THE
- PROJECT AREA. 5. PROVIDE UPDATED PANEL SCHEDULES FOR AFFECTED PANELBOARDS ALONG WITH EXISTING CIRCUIT
- INFORMATION FOR ALL DEVICES/LOADS THAT ARE MAINTAINED IN SERVICE INSIDE THE PROJECT AREA OR FOR DEVICES THAT REQUIRED TEMPORARY SERVICES OUTSIDE THE PROJECT AREA NORMALLY SUPPLIED BY THE AFFECTED PANELBOARD. UPDATED PANEL SCHEDULES AND AS-BUILT MARK-UP DRAWINGS OF EXISTING CONDITIONS SHALL BE PROVIDED TO THE OWNER AND ENGINEER.

#### SECTION 26 05 19 - LOW-VOLTAGE ELECTRICAL POWER CONDUCTORS AND CABLES PART 1 - GENERAL

#### 1.1 SUMMARY

#### A. SECTION INCLUDES:

- 1. BUILDING WIRES AND CABLES RATED 600 V AND LESS.
- 2. CONNECTORS, SPLICES, AND TERMINATIONS RATED 600 V AND LESS.

#### PART 2 - PRODUCTS

#### 2.1 CONDUCTORS AND CABLES

- . MANUFACTURERS: SUBJECT TO COMPLIANCE WITH REQUIREMENTS, PROVIDE PRODUCTS BY ONE OF THE
- 1. ALCAN PRODUCTS CORPORATION; ALCAN CABLE DIVISION.
- ALPHA WIRE.
- 3. BELDEN INC. 4. ENCORE WIRE CORPORATION.
- GENERAL CABLE TECHNOLOGIES CORPORATION.
- 6. SOUTHWIRE INCORPORATED.
- B. COPPER CONDUCTORS: COMPLY WITH NEMA WC 70/ICEA S-95-658.
- C. CONDUCTOR INSULATION: COMPLY WITH NEMA WC 70/ICEA S-95-658 FOR TYPE THHN-2-THWN-2 AND TYPE XHHW-2.

#### 2.2 CONNECTORS AND SPLICES

- . MANUFACTURERS: SUBJECT TO COMPLIANCE WITH REQUIREMENTS, PROVIDE PRODUCTS BY ONE OF THE
- FOLLOWING:
- 1. AFC CABLE SYSTEMS, INC. 2. GARDNER BENDER.
- 3. HUBBELL POWER SYSTEMS, INC.
- 4. IDEAL INDUSTRIES, INC. 5. ILSCO; A BRANCH OF BARDES CORPORATION.
- NSI INDUSTRIES LLC.
- 7. O-Z/GEDNEY; A BRAND OF THE EGS ELECTRICAL GROUP.
- 8. 3M: ELECTRICAL MARKETS DIVISION. 9. TYCO ELECTRONICS.
- 10. OR APPROVED EQUIVALENT PRIOR TO BIDDING.
- DESCRIPTION: FACTORY-FABRICATED CONNECTORS AND SPLICES OF SIZE, AMPACITY RATING, MATERIAL, TYPE, AND CLASS FOR APPLICATION AND SERVICE INDICATED

#### PART 3 - EXECUTION

- 3.1 CONDUCTOR MATERIAL APPLICATIONS
- BRANCH CIRCUITS: COPPER. SOLID OR STRANDED FOR NO. 10 AWG AND SMALLER; STRANDED FOR NO. 8 AWG AND LARGER.
- 3.2 CONDUCTOR INSULATION AND MULTICONDUCTOR CABLE APPLICATIONS AND WIRING METHODS
- A. EXPOSED BRANCH CIRCUITS, INCLUDING IN CRAWLSPACES: TYPE THHN-2-THWN-2, SINGLE CONDUCTORS IN RACEWAY.

B. BRANCH CIRCUITS CONCEALED IN CEILINGS, WALLS, AND PARTITIONS: TYPE THHN-2-THWN-2, SINGLE CONDUCTORS IN RACEWAY. BRANCH CIRCUIT HOMERUNS SHALL BE SINGLE CONDUCTORS IN RACEWAY, TYPE MC CABLE NOT PERMITTED FOR BRANCH CIRCUIT

#### <u>SECTION 26 27 26 — WIRING DEVICES</u>

#### PART 1 – GENERAL

#### A. SECTION INCLUDES:

- 1. RECEPTACLES AND ASSOCIATED DEVICE PLATES.
- 2. WALL-BOX DIMMERS.

- 1.2 ADMINISTRATIVE REQUIREMENTS A. RECEPTACLES FOR OWNER-FURNISHED EQUIPMENT: MATCH PLUG CONFIGURATIONS.
- B. SOURCE LIMITATIONS: OBTAIN EACH TYPE OF WIRING DEVICE AND ASSOCIATED WALL PLATE FROM SINGLE SOURCE FROM SINGLE MANUFACTURER.
- 1.3 ACTION SUBMITTALS
- A. PRODUCT DATA: FOR EACH TYPE OF PRODUCT

#### PART 2 - PRODUCTS

- A. MANUFACTURERS' NAMES: SHORTENED VERSIONS (SHOWN IN PARENTHESES) OF THE FOLLOWING MANUFACTURERS' NAMES ARE USED IN OTHER PART 2 ARTICLES:
- 1. COOPER WIRING DEVICES; DIVISION OF COOPER INDUSTRIES, INC. (COOPER). HUBBELL INCORPORATED; WIRING DEVICE—KELLEMS (HUBBELL).
- LEVITON MFG. COMPANY INC. (LEVITON)
- 4. PASS & SEYMOUR/LEGRAND (PASS & SEYMOUR)

#### 2.2 GENERAL WIRING-DEVICE REQUIREMENTS

- A. WIRING DEVICES, COMPONENTS, AND ACCESSORIES: LISTED AND LABELED AS DEFINED IN NFPA 70, BY A QUALIFIED TESTING AGENCY, AND MARKED FOR INTENDED LOCATION AND APPLICATION.
- B. MODULAR PLUG IN CONNECTOR TYPE
- 1. HOSPITAL GRADE (20 AMP): DUPLEX NEMA 5-20R CONFIGURATION (20 AMP, 120 VOLT), NYLON FACE WITH PLUG IN CONNECTOR TO ALLOW RECEPTACLE TO BE REPLACED WITH THE CIRCUIT ENERGIZED. COOPER 8300\_M, HUBBELL SNAP8300I, LEVITON M8300-I, PASS & SEYMOUR PT8300-I.

#### C. BACK AND SIDE WIRED TYPE

1. HOSPITAL GRADE (20 AMP): DUPLEX NEMA 5-20R CONFIGURATION (20 AMP, 120 VOLT), NYLON FACE COOPER 8300I, HUBBELL 8300I, LEVITON 8300-I, PASS & SEYMOUR 8300-HI.

#### 2.3 WALL-BOX DIMMERS

- A. DIMMER SWITCHES: MODULAR, FULL-WAVE, SOLID-STATE UNITS WITH INTEGRAL, QUIET ON-OFF SWITCHES, WITH AUDIBLE FREQUENCY AND EMI/RFI SUPPRESSION FILTERS.
- B. CONTROL: CONTINUOUSLY ADJUSTABLE SLIDER; WITH SINGLE-POLE OR THREE-WAY SWITCHING. COMPLY WITH UL 1472.

#### C. 0-10V DIMMING

- A. SINGLE AND COMBINATION TYPES SHALL MATCH CORRESPONDING WIRING DEVICES.
- 1. PLATE-SECURING SCREWS: METAL WITH HEAD COLOR TO MATCH PLATE FINISH. 2. MATERIAL FOR UNFINISHED SPACES: GALVANIZED STEEL OR SMOOTH, HIGH-IMPACT THERMOPLASTIC.

#### 2.7 FINISHES

- B. DEVICE COLOR: WIRING DEVICES CONNECTED TO NORMAL POWER SYSTEM: IVORY UNLESS OTHERWISE INDICATED OR REQUIRED BY NFPA 70 OR DEVICE LISTING. DEVICES CONNECTED TO EMERGENCY SYSTEMS: RED.
- C. WALL PLATE COLOR: STAINLESS STEEL TO MATCH EXISTING ROOM WALLPLATES.

#### PART 3 - EXECUTION

#### 3.1 INSTALLATION

A. COMPLY WITH NECA 1. INCLUDING MOUNTING HEIGHTS LISTED IN THAT STANDARD, UNLESS OTHERWISE INDICATED.

#### B. COORDINATION WITH OTHER TRADES:

- 1. PROTECT INSTALLED DEVICES AND THEIR BOXES. DO NOT PLACE WALL FINISH MATERIALS OVER DEVICE BOXES AND DO NOT CUT HOLES FOR BOXES WITH ROUTERS THAT ARE GUIDED BY RIDING AGAINST OUTSIDE
- 2. KEEP OUTLET BOXES FREE OF PLASTER, DRYWALL JOINT COMPOUND, MORTAR, CEMENT, CONCRETE, DUST,
- PAINT. AND OTHER MATERIAL THAT MAY CONTAMINATE THE RACEWAY SYSTEM. CONDUCTORS. AND CABLES. 3. INSTALL DEVICE BOXES IN BRICK OR BLOCK WALLS SO THAT THE COVER PLATE DOES NOT CROSS A JOINT
- UNLESS THE JOINT IS TROWELED FLUSH WITH THE FACE OF THE WALL.
- 4. INSTALL WIRING DEVICES AFTER ALL WALL PREPARATION, INCLUDING PAINTING, IS COMPLETE. CONDUCTORS:
- 1. DO NOT STRIP INSULATION FROM CONDUCTORS UNTIL RIGHT BEFORE THEY ARE SPLICED OR TERMINATED ON DEVICES.
- 2. STRIP INSULATION EVENLY AROUND THE CONDUCTOR USING TOOLS DESIGNED FOR THE PURPOSE. AVOID SCORING OR NICKING OF SOLID WIRE OR CUTTING STRANDS FROM STRANDED WIRE.
- 3. THE LENGTH OF FREE CONDUCTORS AT OUTLETS FOR DEVICES SHALL MEET PROVISIONS OF NFPA 70, ARTICLE 300, WITHOUT PIGTAILS.

#### D. DEVICE INSTALLATION:

- 1. REPLACE DEVICES THAT HAVE BEEN IN TEMPORARY USE DURING CONSTRUCTION AND THAT WERE INSTALLED BEFORE BUILDING FINISHING OPERATIONS WERE COMPLETE.
- 2. KEEP EACH WIRING DEVICE IN ITS PACKAGE OR OTHERWISE PROTECTED UNTIL IT IS TIME TO CONNECT CONDUCTORS.
- 3. DO NOT REMOVE SURFACE PROTECTION, SUCH AS PLASTIC FILM AND SMUDGE COVERS, UNTIL THE LAST POSSIBLE MOMENT.
- 4. CONNECT DEVICES TO BRANCH CIRCUITS USING PIGTAILS THAT ARE NOT LESS THAN 6 INCHES (152 MM) IN LENGTH. 5. WHEN THERE IS A CHOICE, USE SIDE WIRING WITH BINDING-HEAD SCREW TERMINALS. WRAP SOLID
- CONDUCTOR TIGHTLY CLOCKWISE, TWO-THIRDS TO THREE-FOURTHS OF THE WAY AROUND TERMINAL SCREW. USE A TORQUE SCREWDRIVER WHEN A TORQUE IS RECOMMENDED OR REQUIRED BY MANUFACTURER. 7. WHEN CONDUCTORS LARGER THAN NO. 12 AWG ARE INSTALLED ON 15- OR 20-A CIRCUITS, SPLICE NO. 12
- AWG PIGTAILS FOR DEVICE CONNECTIONS. 8. TIGHTEN UNUSED TERMINAL SCREWS ON THE DEVICE.
- 9. WHEN MOUNTING INTO METAL BOXES. REMOVE THE FIBER OR PLASTIC WASHERS USED TO HOLD DEVICE-MOUNTING SCREWS IN YOKES, ALLOWING METAL-TO-METAL CONTACT.

#### E. RECEPTACLE ORIENTATION:

- 1. INSTALL GROUND PIN OF VERTICALLY MOUNTED RECEPTACLES UP, AND ON HORIZONTALLY MOUNTED RECEPTACLES TO THE LEFT.
- 2. INSTALL HOSPITAL-GRADE RECEPTACLES IN PATIENT-CARE AREAS WITH THE GROUND PIN OR NEUTRAL BLADE 3. DEVICE PLATES: DO NOT USE OVERSIZED OR EXTRA-DEEP PLATES. REPAIR WALL FINISHES AND REMOUNT

OUTLET BOXES WHEN STANDARD DEVICE PLATES DO NOT FIT FLUSH OR DO NOT COVER ROUGH WALL

#### F. DIMMERS:

OPENING.

- 1. INSTALL DIMMERS WITHIN TERMS OF THEIR LISTING.
- 2. INSTALL UNSHARED NEUTRAL CONDUCTORS ON LINE AND LOAD SIDE OF DIMMERS ACCORDING TO MANUFACTURERS' DEVICE LISTING CONDITIONS IN THE WRITTEN INSTRUCTIONS.
- G. ARRANGEMENT OF DEVICES: UNLESS OTHERWISE INDICATED, MOUNT FLUSH, WITH LONG DIMENSION VERTICAL AND

WITH GROUNDING TERMINAL OF RECEPTACLES ON TOP. GROUP ADJACENT SWITCHES UNDER SINGLE, MULTIGANG WALL PLATES.

#### 3.2 RECEPTACLES

- A. HOSPITAL GRADE: PROVIDE TAMPER RESISTANT HOSPITAL GRADE RECEPTACLES IN ALL PATIENT CARE AREAS, PATIENT CORRIDORS, PATIENT PREPARATION ROOMS, EXAM ROOMS AND WAITING ROOMS OR AREAS. PROVIDE

#### 3.4 IDENTIFICATION

A. IDENTIFY EACH RECEPTACLE WITH PANELBOARD IDENTIFICATION AND CIRCUIT NUMBER. USE HOT, STAMPED, OR ENGRAVED MACHINE PRINTING WITH BLACK (NORMAL POWER) AND RED (EMERGENCY POWER) FILLED LETTERING

#### 3.5 FIELD QUALITY CONTROL

- A. PERFORM THE FOLLOWING TESTS AND INSPECTIONS: IN HEALTHCARE FACILITIES, PREPARE REPORTS THAT COMPLY WITH RECOMMENDATIONS IN NFPA 99.
- 2. TEST INSTRUMENT FOR CONVENIENCE RECEPTACLES: DIGITAL WIRING ANALYZER WITH DIGITAL READOUT OR ILLUMINATED DIGITAL-DISPLAY INDICATORS OF MEASUREMENT.

#### SECTION 26 51 00 - INTERIOR LIGHTING

#### PART 1 – GENERAL 1.1 SUMMARY

#### A. SECTION INCLUDES:

1. INTERIOR LIGHTING FIXTURES, LAMPS, AND BALLASTS.

#### 1.2 ACTION SUBMITTALS

A. PRODUCT DATA: FOR EACH TYPE OF PRODUCT

#### PART 2 – PRODUCTS 2.1 LIGHT FIXTURES

A. MANUFACTURERS: PROVIDE LIGHT FIXTURES PER LIGHTING FIXTURE SCHEDULE AS INDICATED. ALTERNATE LIGHT

PART 3 - EXECUTION 3.1 INSTALLATION

TO OCCUPANCY BY OWNER.

- A. PROVIDE MOUNTING ACCESSORIES AND TRIMS AS REQUIRED FOR WALL TYPES SHOWN IN FINISH SCHEDULE AND ON DRAWINGS.
- C. VERIFY WEIGHT AND MOUNTING METHOD OF FIXTURES AND PROVIDE SUITABLE SUPPORTS. FIXTURE MOUNTING ASSEMBLIES SHALL COMPLY WITH LOCAL SEISMIC CODES AND REGULATIONS.
- D. REFER TO ARCHITECTURAL FOR COORDINATION OF LIGHTING FIXTURE LOCATIONS. WHERE CONFLICTS OCCUR,
- F. BLEMISHED, DAMAGED OR UNSATISFACTORY FIXTURES OR ACCESSORIES SHALL BE REPLACED.
- G. VERIFY MOUNTING PROVISIONS AND OTHER REQUIREMENTS PRIOR TO ORDER OF LIGHT FIXTURES AND PROVIDE AS REQUIRED.
- H. ALL FINISHES SHALL BE UNMARRED UPON PROJECT COMPLETION, REPAIR OR REPLACE DAMAGED FINISHES.
- AFTER CONSTRUCTION WORK, PAINTING AND CLEAN-UP ARE COMPLETED. REMOVE ALL DIRTY LAMPS, REFLECTORS AND DIF-FUSERS; CLEAN AND REINSTALL. WHEN CLEANING "ALZAK" REFLECTORS, USE A
- K. FOR LED FIXTURES. WHETHER SURFACE MOUNTED OR RECESSED. REMOVE ALL CONSTRUCTION DIRT AND DUST FROM HEAT SINK FINS TO ENSURE PROPER DISSIPATION OF HEAT.

L. STARTUP SERVICE: BURN-IN ALL LAMPS THAT REQUIRE SPECIFIC AGING PERIOD TO OPERATE PROPERLY. PRIOR

- HOSPITAL GRADE RECEPTACLES IN ALL OTHER AREAS. PROVIDE 20 AMP RECEPTACLES IN ALL LOCATIONS. B. PROVIDE GFCI RECEPTACLES IN LOCATIONS THAT ARE WITHIN 6 FEET OF SINKS OF WATER BASINS.
- ON FACE OF PLATE, AND DURABLE WIRE MARKERS OR TAGS INSIDE OUTLET BOXES.
- 1. TEST INSTRUMENTS: USE INSTRUMENTS THAT COMPLY WITH UL 1436.
- 3. TESTS FOR CONVENIENCE RECEPTACLES:
- 3.1. LINE VOLTAGE: ACCEPTABLE RANGE IS 105 TO 132 V.
- 3.2. PERCENT VOLTAGE DROP UNDER 15-A LOAD: A VALUE OF 6 PERCENT OR HIGHER IS UNACCEPTABLE. GROUND IMPEDANCE: VALUES OF UP TO 2 OHMS ARE ACCEPTABLE.

OWNER:

FIXTURE SUBMITTALS SHALL BE APPROVED BY THE ENGINEER OF RECORD. PROJECT NAME:

B. LIGHTING FIXTURES: SET LEVEL, PLUMB, AND SQUARE WITH CEILINGS AND WALLS UNLESS OTHERWISE INDICATED.

COORDINATE WITH ARCHITECT PRIOR TO INSTALLING ANY OF THE SYSTEMS. E. INSTALL FIXTURES WITH VENT HOLES FREE OF AIR BLOCKING OBSTACLES.

I. REPLACE ALL BURNED OUT OR INOPERATIVE LAMPS AT THE END OF THE CONSTRUCTION PRIOR TO OWNER OCCUPANCY. J. DIFFUSERS AND ENCLOSURES: REMOVE PROTECTIVE PLASTIC COVERS FROM LIGHTING FIXTURE DIFFUSERS ONLY

MANUFACTURER RECOMMENDED CLEANING SOLUTION. REFLECTORS DAMAGED OR IMPREGNATED WITH FINGERPRINTS SHALL BE REPLACED AT NO COST TO OWNER.


> City of Puyallup Development & Permitting Services ISSUED PERMIT Building Planning Engineering Public Works Fire Traffic



MultiCare 🕰 Tacoma General Hospita Alterations Good Samaritan Hospital 401 15th Ave SE Puyallup, WA 98372 MARK DATE DESCRIPTION PERMIT SET 31260 PROJECT NO. KMD DRAWN BY: DATE: 1 NOVEMBER 2023 COPYRIGHT TO:


InSight Healthcare Architecture SHEET TITLE: ELECTRICAL **I**SPECIFICATIONS

SHEET #:

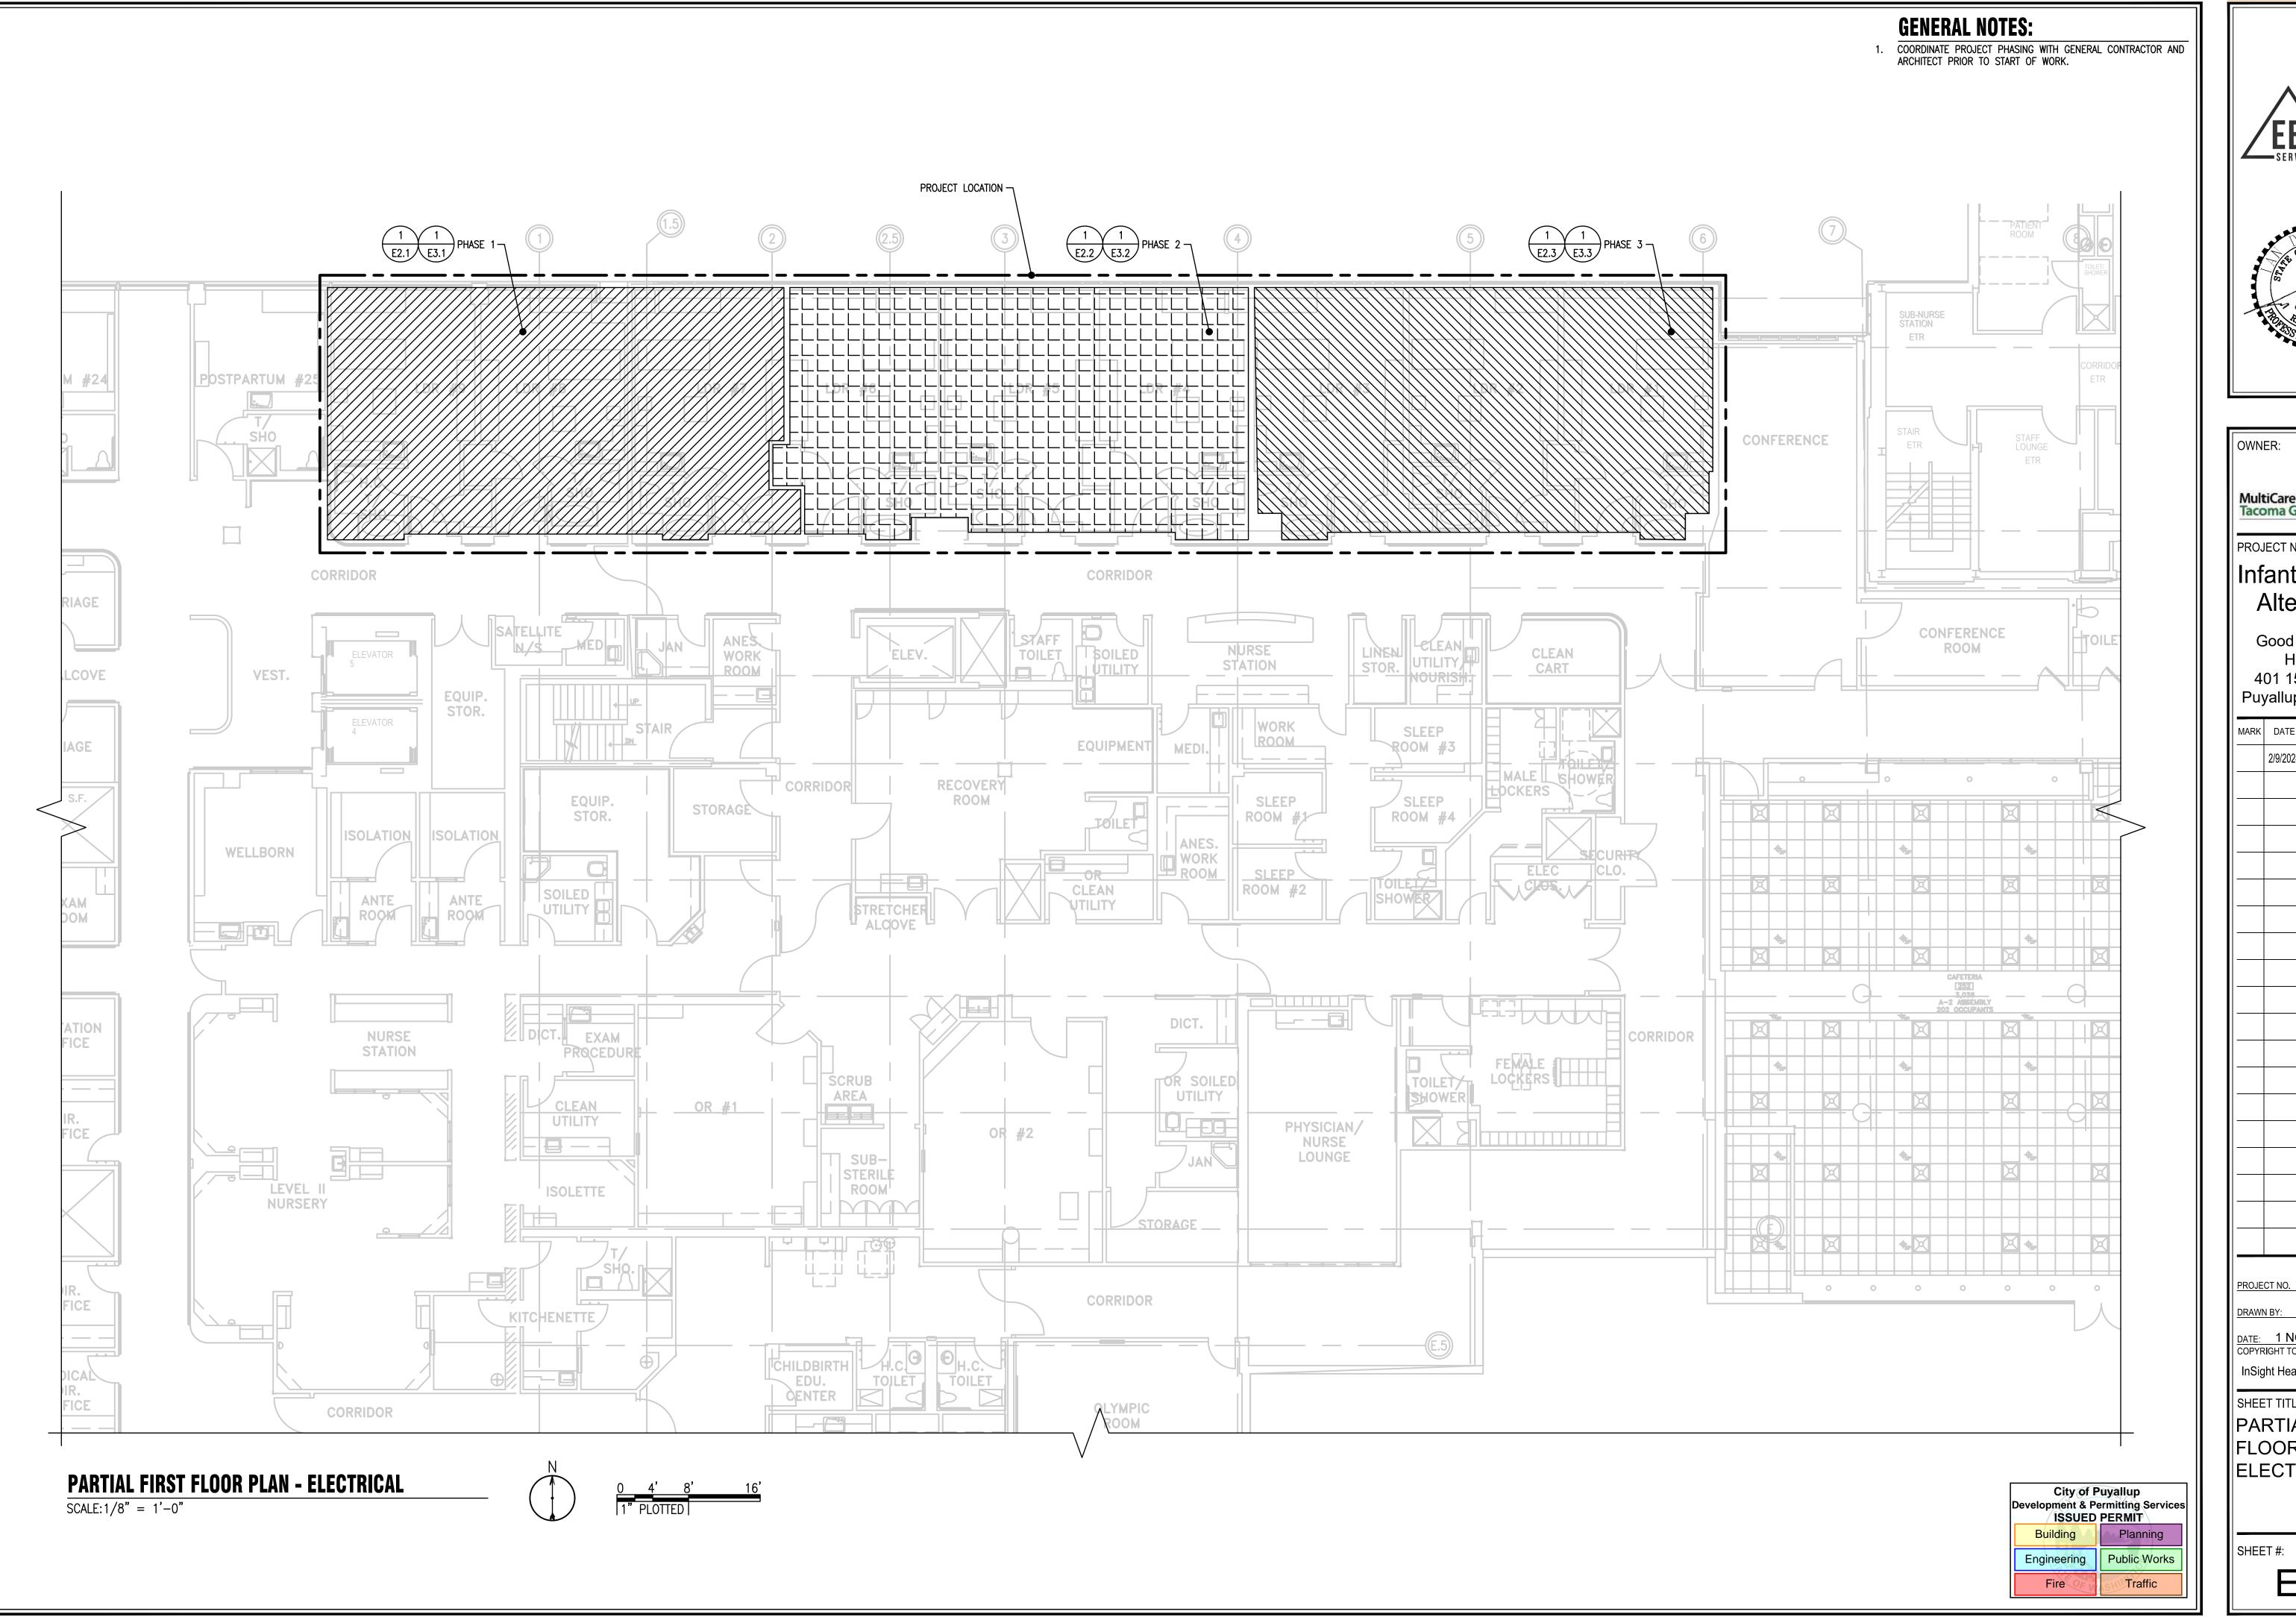

PRCTI20240324

EBD EVIDENCE BASED DESIGN

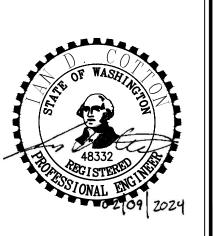

MultiCare 😂 Tacoma General Hospital PROJECT NAME: Infant Warmer **Alterations** Good Samaritan Hospital 401 15th Ave SE Puyallup, WA 98372 MARK DATE DESCRIPTION PERMIT SET 2/9/2024 31260


KMD

DATE: 1 NOVEMBER 2023 COPYRIGHT TO: InSight Healthcare Architecture

SHEET TITLE: PARTIAL 1ST

FLOOR PLAN -ELECTRICAL

E1.1

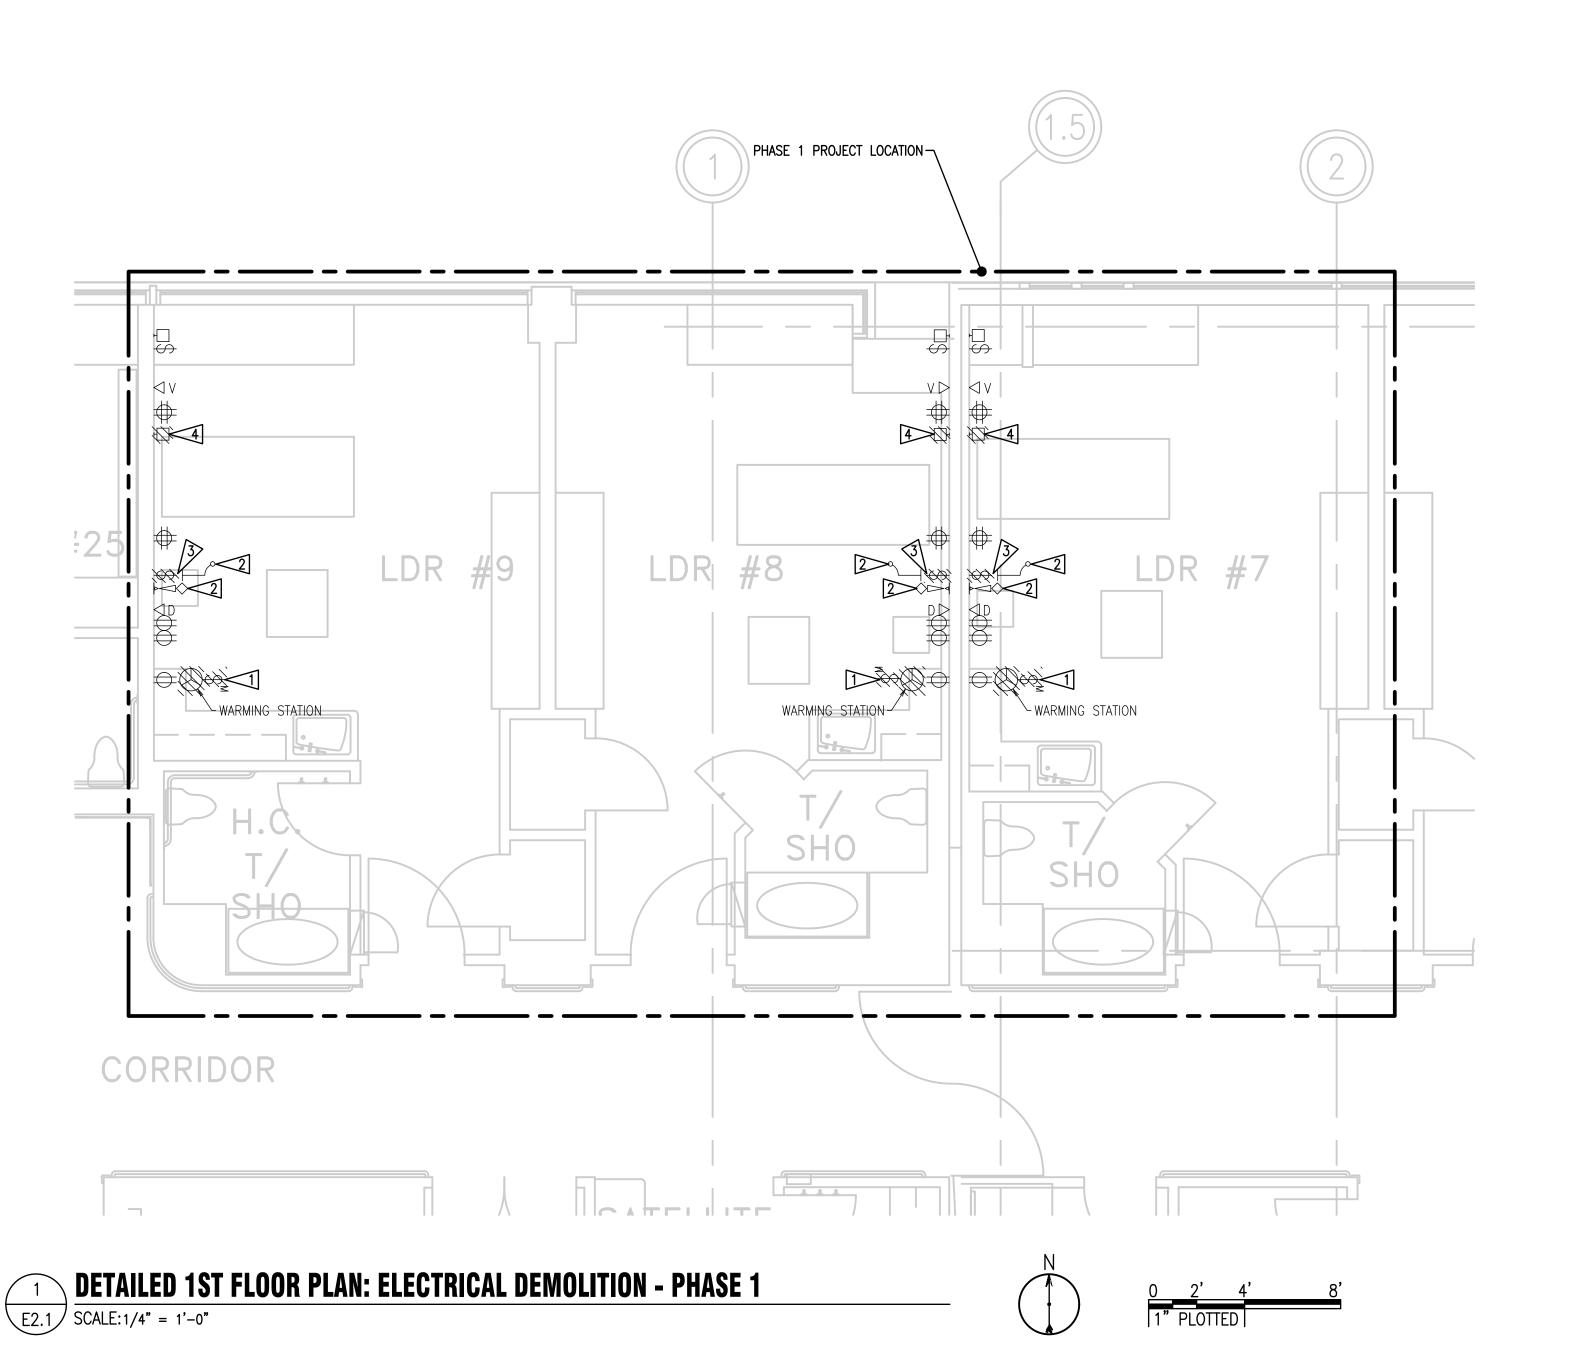

- 1. MAINTAIN EXISTING SYSTEMS NOT IDENTIFIED FOR DEMOLITION. MAINTAINING EXISTING SYSTEMS INCLUDES RELOCATING THE SYSTEMS TO COORDINATE WITH WORK OF THIS CONTRACT, WHEN WORK OF THIS CONTRACT CANNOT BE DONE WHILE THE EXISTING SYSTEM IS IN ITS PRESENT LOCATION.
- 2. ANY EXISTING WIRING SERVING DEVICES TO REMAIN IN SERVICE AND WHICH MAY BE AFFECTED BY WORK PERFORMED UNDER THIS CONTRACT SHALL BE REROUTED TO MAINTAIN CIRCUIT CONTINUITY. CONTRACTOR SHALL ASSUME THE RISK OF MAINTAINING EXISTING SYSTEMS, EXCEPT RELOCATION OF WIRING OF #2 AWG AND ABOVE SHALL BE CONSIDERED AN ADDITIONAL COST IF NOT SHOWN TO BE RELOCATED. IF SUCH WIRING IS FOUND THE CONTRACTOR SHALL NOTIFY ARCHITECT OF WIRING LOCATION, REASON IT MUST BE REMOVED AND COST OF RELOCATION AND RECEIVE THE OWNER'S APPROVAL BEFORE PROCEEDING WITH THE WORK.
- 3. EXAMINE DRAWINGS OF ALL DISCIPLINES TO DETERMINE WHERE WORK OF OTHER TRADES WILL OR IS LIKELY TO REQUIRE RELOCATION OF EXISTING SYSTEMS. REMOVE AND RELOCATE ELECTRICAL EQUIPMENT IN THE WAY OF WORK OF OTHER TRADES. EXACT RELOCATION REQUIREMENT OF EXISTING SYSTEMS TO REMAIN TO BE BASED ON DETAILED COORDINATION WITH OTHER TRADES. CONTRACTOR TO PROVIDE PROPOSED LOCATIONS OF RELOCATED DEVICES TO OWNER FOR APPROVAL PRIOR TO COMMENCEMENT OF WORK.
- 4. RELOCATION OF ANY SYSTEM SHALL BE PERMANENT.
- 5. RE-ROUTE EXISTING CIRCUITS THAT ARE AFFECTED AS A RESULT OF THIS CONTRACT THAT SERVE DEVICES TO REMAIN IN SERVICE.

  POWER CIRCUITS:
  - a. PRIOR TO DEMOLITION WORK, TRACE OUT AND IDENTIFY EACH BRANCH CIRCUIT AND FEEDER CIRCUIT THAT SERVES LOADS IN OCCUPIED AREAS.
  - b. PROVIDE TEMPORARY WIRING, SCHEDULE OUTAGE AND RECONNECT LOADS TO TEMPORARY
  - c. PROVIDE NEW WIRING IN NEW LOCATION.
  - d. SCHEDULE OUTAGE, DISCONNECT TEMPORARY WIRING, AND CONNECT LOADS TO NEW WIRING. REMOVE TEMPORARY WIRING.
  - e. OUTAGE FOR EACH CIRCUIT SHALL NOT BE MORE THAN 20 MINUTES.
- SIGNAL AND COMMUNICATION SYSTEMS:
- a. PRIOR TO DEMOLITION TRACE OUT AND IDENTIFY DEVICE AND SYSTEMS BEING SERVED.b. PROVIDE TEMPORARY WIRING TO MAINTAIN OPERATION OF SYSTEM THROUGHOUT FACILITY.
- c. SCHEDULE OUTAGE AND CONNECT TO TEMPORARY WIRING AND TEST SYSTEM.
- d. PROVIDE NEW WIRING ON NEW LOCATION.
- 6. SCHEDULE OUTAGE, DISCONNECT TEMPORARY WIRING, AND RECONNECT TO NEW WIRING. REMOVE TEMPORARY WIRING.


#### **■ FLAG NOTES:**

- 1. DEMOLISH EXISTING WARMING STATION CONNECTION AND CONTROL SWITCH. PROVIDE BLANK COVER PLATE TO MATCH EXISTING DEVICE COVER PLATES IN ROOM. MAINTAIN EXISTING CIRCUIT FOR CONNECTION TO NEW QUAD RECEPTACLE. REFER TO E3.1.
- 2. REMOVE AND RELOCATE EXISTING NURSE CALL DEVICE MOUNTED IN CASEWORK. REFER TO E3.1 AND ARCHITECTURAL ELEVATIONS ON A6.1 FOR REVISED LOCATION.
- 3. DEMOLISH EXISTING HEADWALL LIGHT SWITCH MOUNTED IN CASEWORK. MAINTAIN EXISTING LIGHTING CIRCUIT AND RECONNECT TO NEW HEADWALL LIGHT AND LIGHT SWITCH. REFER TO E3.1 AND ARCHITECTURAL ELEVATION ON A6.1 FOR LOCATION.
- 4. DEMOLISH EXISTING HEADWALL LIGHT MOUNTED IN CASEWORK. MAINTAIN EXISTING LIGHTING CIRCUIT AND RECONNECT TO NEW HEADWALL LIGHT.
- 5. REMOVE EXISTING DEVICE MOUNTED IN CASEWORK. RELOCATE AND REINSTALL EXISTING DEVICE IN WALL AT SAME ELEVATION.

City of Puyallup
Development & Permitting Services
ISSUED PERMIT
Building Planning
Engineering Public Works
Fire Traffic

PRCTI20240324



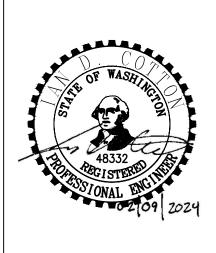

OWNER:

MultiCare 🕰 Tacoma General Hospital

PROJECT NAME:

## Infant Warmer Alterations

Good Samaritan Hospital 401 15th Ave SE Puyallup, WA 98372

MARK DATE DESCRIPTION

	2/9/2024	PERMIT SET
PROJECT NO.		3126
D 4144	1.50/	L∕N/I

DATE: 1 NOVEMBER 2023
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SHEET TITLE:

DETAILED 1ST
FLOOR PLAN ELECTRICAL
DEMOLITION PHASE 1

SHEET #:

E2.1

# PHASE 2 PROJECT LOCATION - $\lor \triangleright \lor \lor$ $\lor \triangleright$ 4 3 3 LDR #5 WARMING STATION CORRIDOR DETAILED 1ST FLOOR PLAN: ELECTRICAL DEMOLITION - PHASE 2

E2.2 SCALE: 1/4" = 1'-0"

#### **GENERAL NOTES:**

- 1. MAINTAIN EXISTING SYSTEMS NOT IDENTIFIED FOR DEMOLITION. MAINTAINING EXISTING SYSTEMS INCLUDES RELOCATING THE SYSTEMS TO COORDINATE WITH WORK OF THIS CONTRACT, WHEN WORK OF THIS CONTRACT CANNOT BE DONE WHILE THE EXISTING SYSTEM IS IN ITS PRESENT LOCATION.
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- 3. EXAMINE DRAWINGS OF ALL DISCIPLINES TO DETERMINE WHERE WORK OF OTHER TRADES WILL OR IS LIKELY TO REQUIRE RELOCATION OF EXISTING SYSTEMS. REMOVE AND RELOCATE ELECTRICAL EQUIPMENT IN THE WAY OF WORK OF OTHER TRADES. EXACT RELOCATION REQUIREMENT OF EXISTING SYSTEMS TO REMAIN TO BE BASED ON DETAILED COORDINATION WITH OTHER TRADES. CONTRACTOR TO PROVIDE PROPOSED LOCATIONS OF RELOCATED DEVICES TO OWNER FOR APPROVAL PRIOR TO COMMENCEMENT OF WORK.
- 4. RELOCATION OF ANY SYSTEM SHALL BE PERMANENT.
- 5. RE-ROUTE EXISTING CIRCUITS THAT ARE AFFECTED AS A RESULT OF THIS CONTRACT THAT SERVE DEVICES TO REMAIN IN SERVICE.

  POWER CIRCUITS:
  - a. PRIOR TO DEMOLITION WORK, TRACE OUT AND IDENTIFY EACH BRANCH CIRCUIT AND FEEDER CIRCUIT THAT SERVES LOADS IN OCCUPIED AREAS.
  - b. PROVIDE TEMPORARY WIRING, SCHEDULE OUTAGE AND RECONNECT LOADS TO TEMPORARY
  - c. PROVIDE NEW WIRING IN NEW LOCATION.
  - d. SCHEDULE OUTAGE, DISCONNECT TEMPORARY WIRING, AND CONNECT LOADS TO NEW WIRING. REMOVE TEMPORARY WIRING.
  - e. OUTAGE FOR EACH CIRCUIT SHALL NOT BE MORE THAN 20 MINUTES.
  - SIGNAL AND COMMUNICATION SYSTEMS:

WIRING.

- a. PRIOR TO DEMOLITION TRACE OUT AND IDENTIFY DEVICE AND SYSTEMS BEING SERVED.b. PROVIDE TEMPORARY WIRING TO MAINTAIN OPERATION OF SYSTEM THROUGHOUT FACILITY.
- c. SCHEDULE OUTAGE AND CONNECT TO TEMPORARY WIRING AND TEST SYSTEM.
- d. PROVIDE NEW WIRING ON NEW LOCATION.
- 6. SCHEDULE OUTAGE, DISCONNECT TEMPORARY WIRING, AND RECONNECT TO NEW WIRING. REMOVE TEMPORARY WIRING.


#### **■ FLAG NOTES:**

- 1. DEMOLISH EXISTING WARMING STATION CONNECTION AND CONTROL SWITCH. PROVIDE BLANK COVER PLATE TO MATCH EXISTING DEVICE COVER PLATES IN ROOM. MAINTAIN EXISTING CIRCUIT FOR CONNECTION TO NEW QUAD RECEPTACLE. REFER TO E3.2.
- 2. REMOVE AND RELOCATE EXISTING NURSE CALL DEVICE MOUNTED IN CASEWORK. REFER TO E3.2 AND ARCHITECTURAL ELEVATIONS ON A6.1 FOR REVISED LOCATION.
- 3. DEMOLISH EXISTING HEADWALL LIGHT SWITCH MOUNTED IN CASEWORK. MAINTAIN EXISTING LIGHTING CIRCUIT AND RECONNECT TO NEW HEADWALL LIGHT AND LIGHT SWITCH. REFER TO E3.2 AND ARCHITECTURAL ELEVATION ON A6.1 FOR LOCATION.
- 4. DEMOLISH EXISTING HEADWALL LIGHT MOUNTED IN CASEWORK. MAINTAIN EXISTING LIGHTING CIRCUIT AND RECONNECT TO NEW HEADWALL LIGHT.
- 5. REMOVE EXISTING DEVICE MOUNTED IN CASEWORK. RELOCATE AND REINSTALL EXISTING DEVICE IN WALL AT SAME ELEVATION.

City of Puyallup
Development & Permitting Services
ISSUED PERMIT
Building Planning
Engineering Public Works

PRCTI20240324

EBD EVIDENCE BASED DESIGN

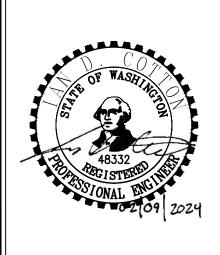

OWNER:

MultiCare

PROJECT NAME:

# Infant Warmer Alterations

Good Samaritan Hospital 401 15th Ave SE Puyallup, WA 98372

MARK DATE DESCRIPTION

	2/9/2024	PERMIT SET
ROJE	CT NO.	3126

DATE: 1 NOVEMBER 2023
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SHEET TITLE:

DETAILED 1ST FLOOR PLAN -ELECTRICAL DEMOLITION -PHASE 2

SHEET #:

E2.2

# PHASE 3 PROJECT LOCATION - $\vee \triangleright$ **\$** LDR #3 LDR #2 ~WARMING STATION WARMING STATION DETAILED 1ST FLOOR PLAN: ELECTRICAL DEMOLITION - PHASE 3 E2.3 SCALE: 1/4" = 1'-0"

#### **GENERAL NOTES:**

- 1. MAINTAIN EXISTING SYSTEMS NOT IDENTIFIED FOR DEMOLITION. MAINTAINING EXISTING SYSTEMS INCLUDES RELOCATING THE SYSTEMS TO COORDINATE WITH WORK OF THIS CONTRACT, WHEN WORK OF THIS CONTRACT CANNOT BE DONE WHILE THE EXISTING SYSTEM IS IN ITS PRESENT LOCATION.
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- 3. EXAMINE DRAWINGS OF ALL DISCIPLINES TO DETERMINE WHERE WORK OF OTHER TRADES WILL OR IS LIKELY TO REQUIRE RELOCATION OF EXISTING SYSTEMS. REMOVE AND RELOCATE ELECTRICAL EQUIPMENT IN THE WAY OF WORK OF OTHER TRADES. EXACT RELOCATION REQUIREMENT OF EXISTING SYSTEMS TO REMAIN TO BE BASED ON DETAILED COORDINATION WITH OTHER TRADES. CONTRACTOR TO PROVIDE PROPOSED LOCATIONS OF RELOCATED DEVICES TO OWNER FOR APPROVAL PRIOR TO COMMENCEMENT OF WORK.
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  POWER CIRCUITS:
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  - c. PROVIDE NEW WIRING IN NEW LOCATION.
  - d. SCHEDULE OUTAGE, DISCONNECT TEMPORARY WIRING, AND CONNECT LOADS TO NEW WIRING. REMOVE TEMPORARY WIRING.
  - e. OUTAGE FOR EACH CIRCUIT SHALL NOT BE MORE THAN 20 MINUTES.
  - SIGNAL AND COMMUNICATION SYSTEMS:
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- 6. SCHEDULE OUTAGE, DISCONNECT TEMPORARY WIRING, AND RECONNECT TO NEW WIRING. REMOVE TEMPORARY WIRING.


## **FLAG NOTES:**

- 1. DEMOLISH EXISTING WARMING STATION CONNECTION AND CONTROL SWITCH. PROVIDE BLANK COVER PLATE TO MATCH EXISTING DEVICE COVER PLATES IN ROOM. MAINTAIN EXISTING CIRCUIT FOR CONNECTION TO NEW QUAD RECEPTACLE. REFER TO E3.3.
- 2. REMOVE AND RELOCATE EXISTING NURSE CALL DEVICE MOUNTED IN CASEWORK. REFER TO E3.3 AND ARCHITECTURAL ELEVATIONS ON A6.1 FOR REVISED LOCATION.
- 3. DEMOLISH EXISTING HEADWALL LIGHT SWITCH MOUNTED IN CASEWORK. MAINTAIN EXISTING LIGHTING CIRCUIT AND RECONNECT TO NEW HEADWALL LIGHT AND LIGHT SWITCH. REFER TO E3.3 AND ARCHITECTURAL ELEVATION ON A6.1 FOR LOCATION.
- 4. DEMOLISH EXISTING HEADWALL LIGHT MOUNTED IN CASEWORK. MAINTAIN EXISTING LIGHTING CIRCUIT AND RECONNECT TO NEW HEADWALL LIGHT.
- 5. REMOVE EXISTING DEVICE MOUNTED IN CASEWORK. RELOCATE AND REINSTALL EXISTING DEVICE IN WALL AT SAME ELEVATION.

City of Puyallup
Development & Permitting Services
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Building Planning
Engineering Public Works
Fire Traffic

PRCTI20240324



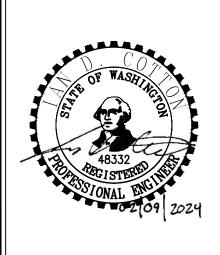

OWNER:

MultiCare 😂 Tacoma General Hospital

PROJECT NAME:

# Infant Warmer Alterations

Good Samaritan Hospital 401 15th Ave SE Puyallup, WA 98372

MARK DATE DESCRIPTION

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ROJE	CT NO.	3126

10. 3126 : KMI

DATE: 1 NOVEMBER 2023
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SHEET TITLE:

DETAILED 1ST
FLOOR PLAN ELECTRICAL
DEMOLITION PHASE 3

SHEET #:

E2.3

1. COORDINATE ALL LOCATIONS AND MOUNTING HEIGHT OF DEVICES WITH ARCHITECTURAL.

#### **■ FLAG NOTES:**

- 1. PROVIDE WALL 4' WALL MOUNTED LED DIRECT/INDIRECT HEADWALL LIGHT WITH THE FOLLOWING OR APPROVED EQUAL REQUIREMENTS: FOCAL POINT SEEM 1 LED DIRECT/INDIRECT, ASYMMETRIC OPTIC TOP/ASYMMETRIC LENS BOTTOM, 250 LUMENS/FOOT UP AND DOWN DISTRIBUTION, 3500K, 90 CRI, SINGLE CIRCUIT, 120/277V, 0-10V DIMMING TO 1%, WHITE FINISH. INTERCEPT AND EXTEND EXISTING LIGHTING CIRCUIT IN ROOM TO NEW LIGHT. FIELD VERIFY EXISTING LIGHTING CIRCUIT.
- 2. PROVIDE 0-10V DIMMER SWITCH AND CONNECT TO NEW HEADWALL LIGHT.
- 3. RELOCATE EXISTING NURSE CALL DEVICE TO WALL. COORDINATE ALL WORK ON NURSE CALL DEVICES AND EQUIPMENT WITH OWNER. REFER TO ELEVATIONS A6.1 FOR LOCATION.
- 4. CONNECT NEW QUAD RECEPTACLE TO EXISTING INFANT WARMER CIRCUIT. FIELD VERIFY EXISTING CIRCUIT. NO NEW LOAD ADDED TO CIRCUIT.
- 5. REINSTALL EXISTING DEVICE IN WALL AT SAME ELEVATION UPON DEMOLITION OF EXISTING CASEWORK.



PRCTI20240324

EBD EVIDENCE BASED DESIGN

SERVICES

Puyallup, WA 98372		
MARK	DATE	DESCRIPTION
	2/9/2024	PERMIT SET
PROJECT NO.		3126
DRAWI	N RY·	KMI

DATE: 1 NOVEMBER 2023 COPYRIGHT TO:

InSight Healthcare Architecture

SHEET TITLE: DETAILED 1ST FLOOR PLAN -ELECTRICAL -PHASE 1

SHEET #:

City of Puyallup velopment & Permitting Services


Public Works

Traffic

ISSUED PERMIT

Engineering

E3.1

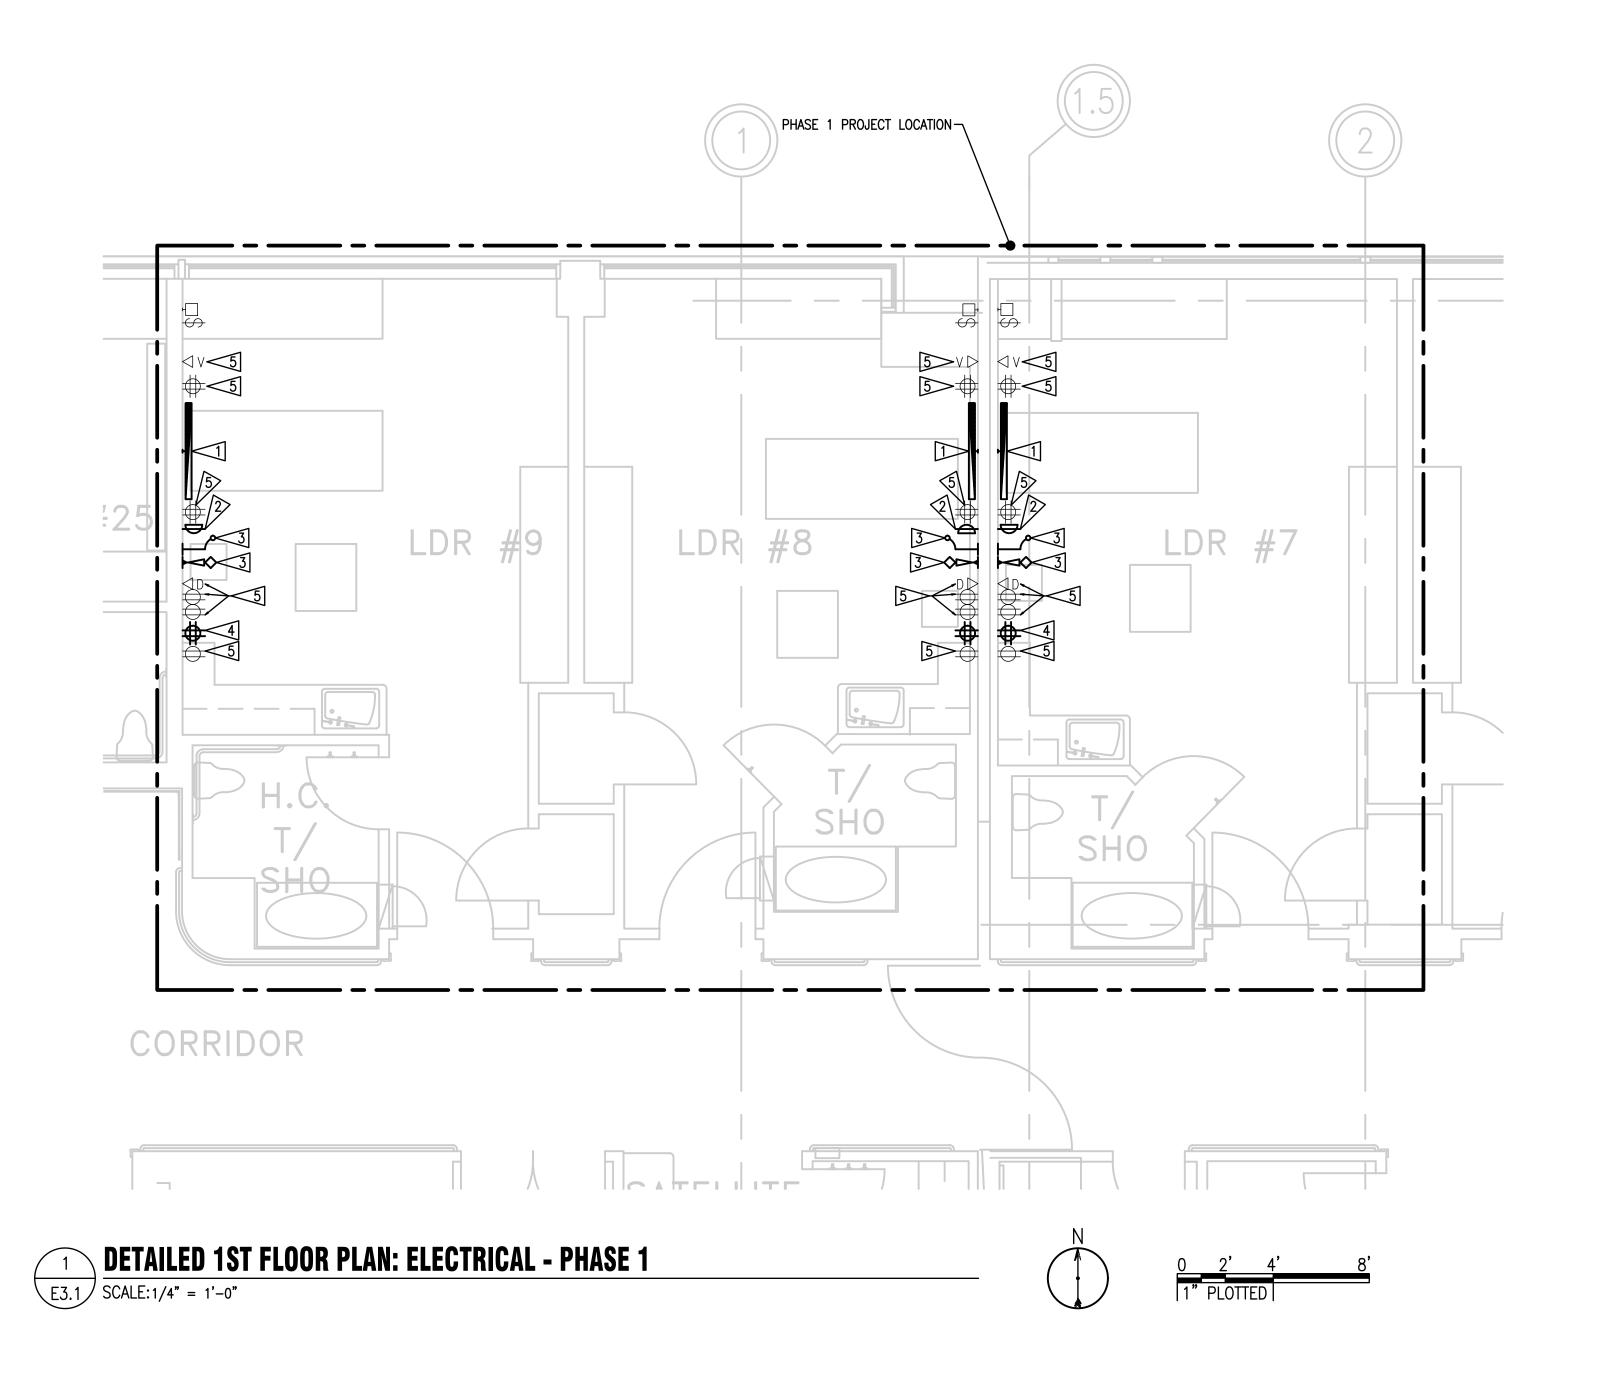

1. COORDINATE ALL LOCATIONS AND MOUNTING HEIGHT OF DEVICES WITH ARCHITECTURAL.

#### **►** FLAG NOTES:

- 1. PROVIDE WALL 4' WALL MOUNTED LED DIRECT/INDIRECT HEADWALL LIGHT WITH THE FOLLOWING OR APPROVED EQUAL REQUIREMENTS: FOCAL POINT SEEM 1 LED DIRECT/INDIRECT, ASYMMETRIC OPTIC TOP/ASYMMETRIC LENS BOTTOM, 250 LUMENS/FOOT UP AND DOWN DISTRIBUTION, 3500K, 90 CRI, SINGLE CIRCUIT, 120/277V, 0-10V DIMMING TO 1%, WHITE FINISH. INTERCEPT AND EXTEND EXISTING LIGHTING CIRCUIT IN ROOM TO NEW LIGHT. FIELD VERIFY EXISTING LIGHTING CIRCUIT.
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PRCTI20240324

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	2/9/2024	PERMIT SET

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SHEET TITLE:

DETAILED 1ST
FLOOR PLAN ELECTRICAL PHASE 2


SHEET #:

City of Puyallup
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Engineering

Public Works


E3.2

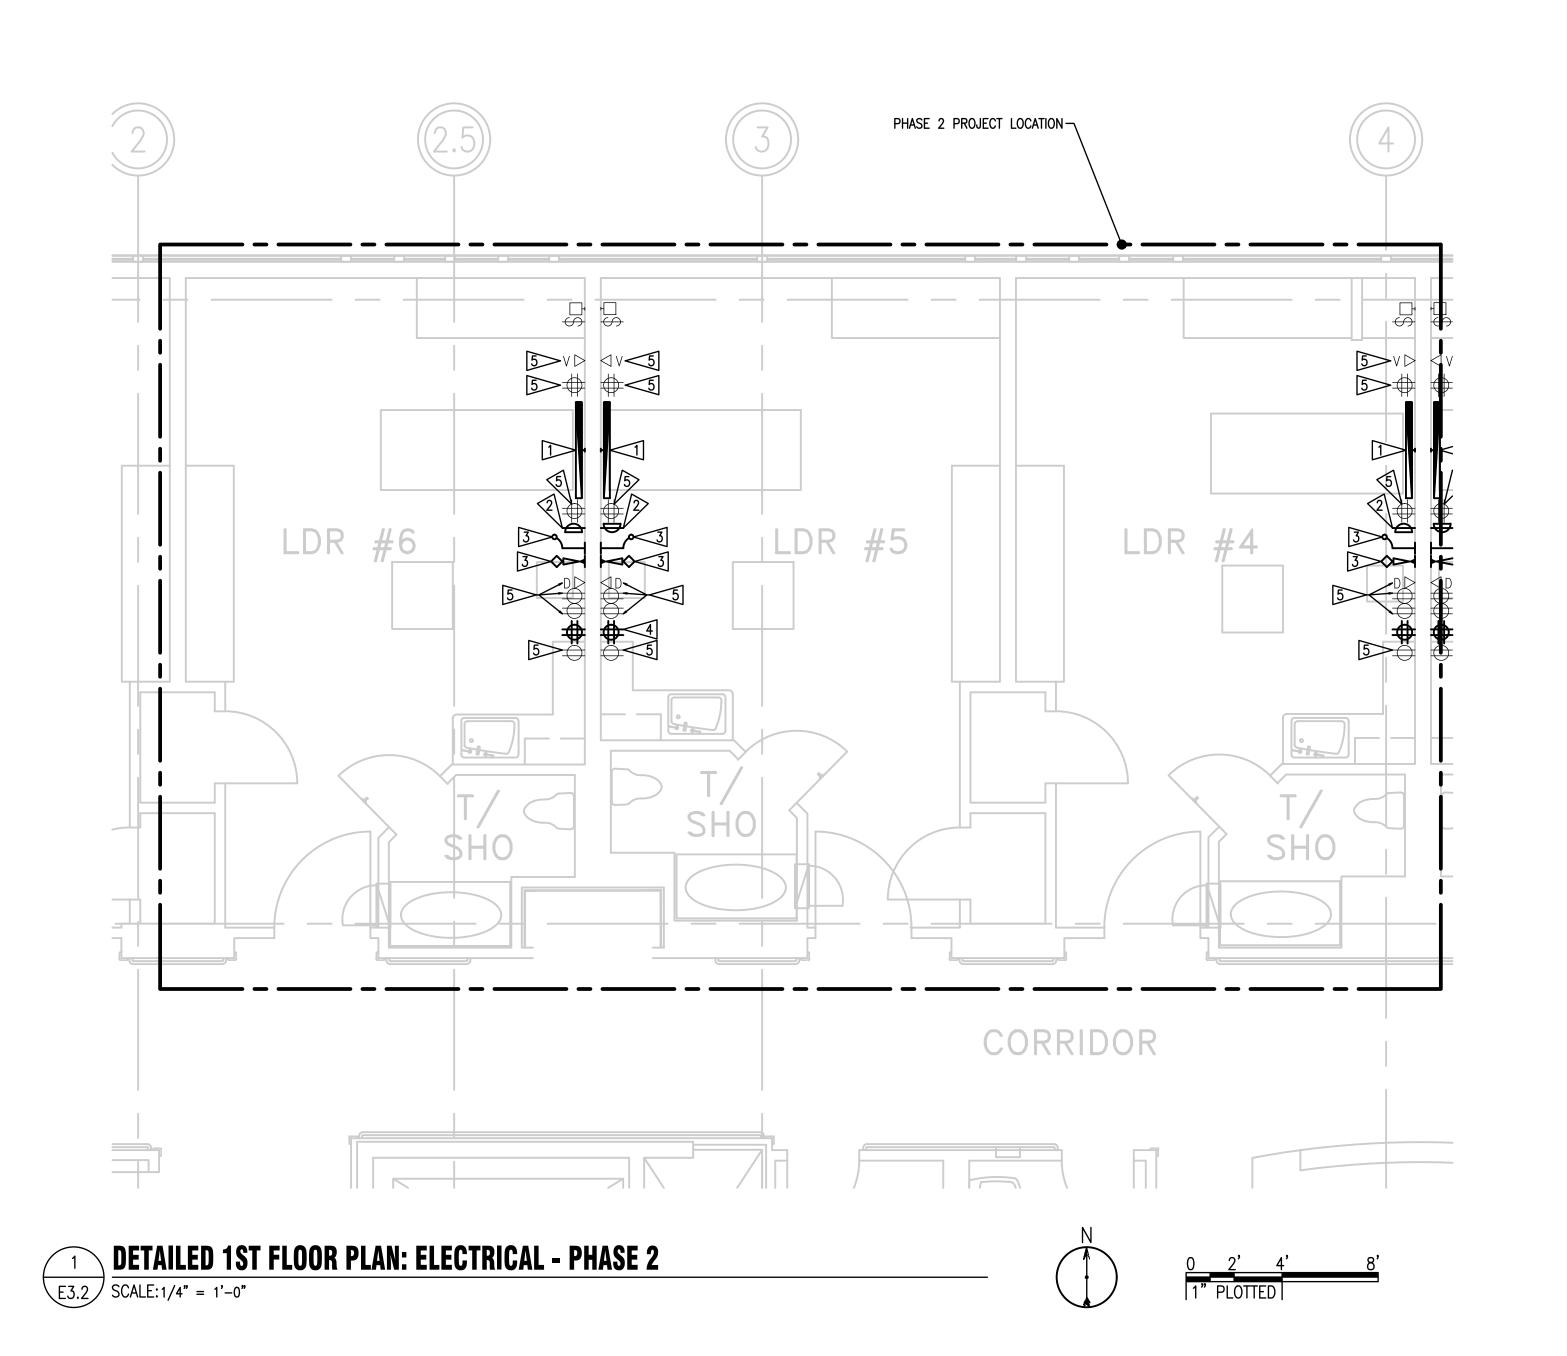

1. COORDINATE ALL LOCATIONS AND MOUNTING HEIGHT OF DEVICES WITH ARCHITECTURAL.

#### **►** FLAG NOTES:

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SHEET TITLE:

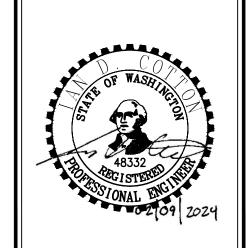DETAILED 1ST
FLOOR PLAN ELECTRICAL PHASE 3

SHEET #:

City of Puyallup elopment & Permitting Services

Public Works

Traffic

ISSUED PERMIT

Engineering

E3.3

