Bradley Park Phase 2 - Brownstone East



PROJECT TEAM

<u>Owner:</u>	Wesley Homes Bradley Park, LLC 707 39th Ave. SE Puyallup, WA 98374
<u>Owner's Developer:</u>	Senior Housing Partners 2823 Hamline Ave. N. Roseville, MN 55113
<u>Architect:</u>	InSite Architects 1000 University Ave. West, Suite 130 St. Paul, MN 55104 Ph: 612-252-4822
<u>Contractor:</u>	Walsh Construction 315 5th Ave. S; Suite 600 Seattle, WA 98104 Ph: 206-547-4008
<u>Civil/ Landscape:</u>	Barghausen 18215 72nd Avenue South Kent, WA 98032 Ph: 425-251-6222 Fx: 425-251-8782
<u>Structural Engineer:</u>	AHBL 2215 N. 30th Street Tacoma, WA 98403 Ph: 253-383-2422
<u>Mechanical,</u> <u>Electrical,</u> <u>Plumbing Engineers:</u>	Steen Engineering 5430 Douglas Drive North Minneapolis, MN 55429-3106 Ph: 763-585-6742
<u>Low Voltage</u> Engineers/Designers:	Collins Electrical Construction Co. 278 State Street St. Paul, MN 55107 Ph: 651-224-2833
Parking Ir	nformation

PROVIDED PARKING: - ALSO SEE SHEET A0.1 FOR PARKING CALCULATIONS

Count Comments

PROVIDED PARKING SCHEDULE

43

72

Description

ELECTRIC CAR STALL

REQUIRED PARKING:

STANDARD STALL

COMPACT PARKING STALL 20

ELECTRIC CAR STALL - ADA 1

67 UNITS @ 1 STALLS/UNIT = 67 STALLS

ADA STALL

Total

UNIT MIX & SQUARE FOOTAGES

	UNIT SCHEDULE - BRC	WNS
	UNIT TYPE	Unit Na
	LEVEL 1 - EAST	
	DECATUR (ADA)	1 BC
	HERON (ADA)	1 BC
	LOPEZ	2 BC
	ORCAS	1 BC
	VANCOUVER	2 BC
	VASHON	1 BC
	WHIDBEY	2 BC
	LEVEL 2 - EAST	
	CAMANO	1 BC
	DECATUR	1 BC
	FOX	1 BC
	LOPEZ	2 BC
	ORCAS	1 BC
	VANCOUVER	2 BC
	VASHON	1 BC
	WHIDBEY	2 BC
مر	LEVEL 3 - EAST	\sim
2	DECATUR	1 BC
2	FIDALGO (ADA)	2 BC
7	FOX	2 DE
7	LOPEZ	2 BC
2	LUMMI	2 DL 1 BL
2	ORCAS	1 BC
2	VANCOUVER	2 BC
2	VASHON	2 BC
۲ ۲	WHIDBEY	2 BC
Ľ	Grand total	m
	Energy Co	bde
	2018 WASHINGTON per Chapter 51-11R V	
	TABLE 402.1.1 INSU Roof: R49	LATI
	Exterior Walls: R21 ir	nt
	Headers: R10	
	Floor (Underside of P	
	Slab on Grade: R10 - Glazing U factor: .20	
	Multifamily R2 Dwelli	ng u
	Heating option: 1. Heat Put	
	Energy Options	
	1. 1.2 Effic	ient E
	2. 2.1 Air L	
	3. 4.1 High 4. 5.1 Effic	
	5. 5.2 Effic	

BROWNSTONE EAST - 1ST FLR 36,145 SF BROWNSTONE EAST - 3RD FLR 35,762 SF BROWNSTONE EAST - 3RD FLR 32,795 SF Grand total: 3 104,701 SF D+ 1 D++ 1 D+++ 2		0	NAME	AREA
U Type N Type N T BROWNSTONE EAST - 2ND FLR BROWNSTONE EAST - 3RD FLR 32,795 SF Grand total: 3 104,701 SF Grand total: 3 104,701 SF Crand total: 3 104,701 S		C		
It Type N BROWNSTONE EAST - 3RD FLR 32,795 SF Grand total: 3 104,701 SF D+ 1 D+ 1 D+ 1 D+ 1 D+ 22 D+ 1 D+ 1 <td></td> <td></td> <td></td> <td></td>				
ame T Grand total: 3 104,701 SF 0^+ 1 1 104,701 SF 0^+ 1 1 1	Tuno			
$ \begin{array}{c} \begin{array}{c} \begin{array}{c} \begin{array}{c} \begin{array}{c} \begin{array}{c} \begin{array}{c} \begin{array}{c}$				
$ \begin{array}{c ccccccccccccccccccccccccccccccccccc$		•		
$ \begin{array}{cccccccccccccccccccccccccccccccccccc$				<u>/1</u>
$ \begin{array}{cccccccccccccccccccccccccccccccccccc$		1		
$ \begin{array}{cccccccccccccccccccccccccccccccccccc$				
$ \begin{array}{cccccccccccccccccccccccccccccccccccc$				
$\begin{array}{c ccccccccccccccccccccccccccccccccccc$				
$ \begin{array}{cccccccccccccccccccccccccccccccccccc$		1		
$\begin{array}{c ccccccccccccccccccccccccccccccccccc$)++	2		
22 22 $2+ 1$ $2+ 1$ $2+ 1$ $2+ 1$ $2+ 1$ $2+ 2$ 23 $2- 23$ $2- 23$ $2- 23$ $2- 23$ $2- 3$ $2- 3$ $2- 3$ $2- 3$ $2- 3$ $2- 3$ $2- 3$ $2- 3$ $2- 3$ $2- 3$ $2- 3$ $2- 3$ $2- 3$ $2- 3$ $2- 3$ $2- 3$ $2- 3$ $2- 3$ $3-$)+	7		
$ \begin{array}{c ccccccccccccccccccccccccccccccccccc$)+	9		
$ \begin{array}{cccccccccccccccccccccccccccccccccccc$		22		
$ \begin{array}{c ccccccccccccccccccccccccccccccccccc$				
$ \begin{array}{c ccccccccccccccccccccccccccccccccccc$)+	1		
$ \begin{array}{c ccccccccccccccccccccccccccccccccccc$				
$ \begin{array}{c ccccccccccccccccccccccccccccccccccc$				
$ \begin{array}{c ccccccccccccccccccccccccccccccccccc$				
$ \begin{array}{c ccccccccccccccccccccccccccccccccccc$				
$ \begin{array}{c ccccccccccccccccccccccccccccccccccc$				
$\begin{array}{c ccccccccccccccccccccccccccccccccccc$				
$ \begin{array}{c ccccccccccccccccccccccccccccccccccc$				
$ \begin{array}{c ccccccccccccccccccccccccccccccccccc$)+			
1 + 1 + <t< td=""><td>\sim</td><td>23</td><td></td><td></td></t<>	\sim	23		
) 1)+ 1)+ 1)+ 1)+ 1)+LIB 1)++ 2			3 ,	
0+ 1 0+ 1 0+ 1 0+LIB 1 0++ 2)+	1	$\frac{1}{\sqrt{1}}$	
0+ 1 0+ 1 0+ 1 0+LIB 1 0++ 2)	1	5	
0+ 1 0+ 1 0+LIB 1 0++ 2)+	1	5	
)+LIB 1 })+	1	3	
)+LIB 1 })+		4	
)++ 2 3			$\boldsymbol{\boldsymbol{\zeta}}$	
			4	
	/ T T		$\left\{ \right.$	
			{	
$\frac{1}{2}$)+	1	2	
22 } 67 }		22	2	

le Compliance Summary

ATE ENERGY CODE RESIDENTIAL PROVISION


TION & FENESTRATION VALUES:

eck): R30 norizontally @ perimeter x (per option 1.2)

unit: 4.5 credits required per Table 406.2:

1 credit

Building Envelope1 creditage Control and Efficient Ventilation1 crediticiency HVAC Distribution.5 creditWater Heating.5 creditWater Heating.5 credit

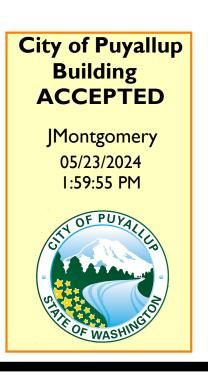

SHEET INDEX


SHEET NUMBER	SHEET NAME	PERMIT 06/02/23	PERMIT RESPONSE 1
GENERAL INFO	DRMATION		
T1.1	TITLE SHEET	•	•
CODE			
AC1.1 AC1.2	ARCHITECTURAL CODE SUMMARY AND CODE PLANS	•	•
AC1.2 AC1.3	ARCHITECTURAL CODE PLANS	•	•
	1	-	
CIVIL - FOR RE C1	FERENCE ONLY*	•	
C2	EXISTING SITE AND TESC PLAN NORTH	•	
C3	EXISTING SITE AND TESC PLAN SOUTH	•	
C4		•	
C5 C6	GRADING PLAN NORTH GRADING PLAN SOUTH	•	
C7	GRADING PLAN - CARE CENTER SOUTH PARKING LOT	•	
C8	GRADING PLAN - CARE CENTER ENTRANCE PAVING	•	
C9 C10	GRADING PLAN - BROWNSTONE NORTHEAST SIDEWALK	•	
C11	DRAINAGE PLAN SOUTH	•	
C12	WATER AND SEWER PLAN NORTH	•	
C13 C14	WATER AND SEWER PLAN SOUTH CONSTRUCTION NOTES	•	
C14 C15	CONSTRUCTION NOTES	•	-
C16	CONSTRUCTION NOTES AND DETAILS	•	
C17 C18	WATER DETAILS	•	
C18 C19	WATER DETAILS SEWER DETAILS	•	
ARCHITECTUR			
A0.1 A1.0	ARCHITECTURAL SITE PLAN GARAGE LEVEL OVERALL PLANS	•	•
A1.0N	GARAGE LEVEL BROWNSTONE B - NORTH	•	•
A1.0S	GARAGE LEVEL BROWSTONE B - SOUTH	•	•
A1.1 A1.1N	FIRST LEVEL OVERALL PLAN - BROWNSTONE B FIRST LEVEL BROWNSTONE B PLAN - NORTH	•	•
A1.1N A1.1S	FIRST LEVEL BROWNSTONE B PLAN - NORTH	•	•
A1.2	SECOND LEVEL OVERALL FLOOR PLANS	•	•
A1.2N	SECOND LEVEL BROWSTONE B PLAN - NORTH	•	•
A1.2S A1.3	SECOND LEVEL BROWSTONE B PLAN - SOUTH THIRD LEVEL OVERALL FLOOR PLANS	•	•
A1.3N	THIRD LEVEL BROWSTONE B PLAN - NORTH	•	•
A1.3S	THIRD LEVEL BROWSTONE B PLAN - SOUTH	•	•
A1.4	ROOF PLANS & DETAILS	•	•
A2.1 A2.2	ENLARGED UNIT PLANS ENLARGED UNIT PLANS	•	•
A2.3	ENLARGED UNIT PLANS	•	•
A2.4	ENLARGED UNIT PLANS - 3RD FLOOR	•	•
A2.5 A3.1	PAVILION PLANS, ELEVATIONS & DETAILS EXTERIOR ELEVATIONS - BROWNSTONE EAST	•	•
A3.2	EXTERIOR ELEVATIONS - BROWNSTONE EAST	•	•
A4.1	BUILDING SECTIONS	•	•
A5.1	WALL SECTIONS	•	•
A5.2 A5.3	WALL SECTIONS WALL SECTIONS	•	•
A5.4	WALL SECTIONS	•	•
A5.5	WALL SECTIONS	•	•
A5.6 A6.1	WALL SECTIONS EXTERIOR DETAILS	•	•
A6.2	EXTERIOR DETAILS	•	•
A6.3	EXTERIOR DETAILS	•	•
A6.4 A6.5	EXTERIOR DETAILS EXTERIOR DETAILS	•	•
A6.6	EXTERIOR DETAILS	•	•
A6.7	EXTERIOR DETAILS	•	•
A7.1	ELEVATOR PLANS & SECTIONS & DETAILS & PAVILION STAIRS	•	•
A7.2	LOBBY STAIR PLANS & SECTIONS & TYP DETAILS	•	•
A7.3	STAIR A PLANS & SECTIONS	•	•
A7.4 A7.5	SOUTH STAIR PLANS & SECTIONS STAIR B PLANS & SECTIONS	•	•
A7.5 A8.1	REFLECTED CEILING PLANS - LEVELS 0 & 1	•	•
A8.2	REFLECTED CEILING PLANS - LEVEL 2	•	•
A8.3	REFLECTED CEILING PLANS - LEVEL 3	•	•
A8.4 A8.5	REFLECTED CEILING PLANS - UNITS REFLECTED CEILING PLANS - UNITS	•	•
A8.6	REFLECTED CEILING PLANS - UNITS	•	•
A8.7	REFLECTED CEILING PLANS - GAME ROOM & CLUB	•	•
A9.1	ROOM INTERIOR ELEVATIONS - MOUNTING HEIGHTS & UNITS	•	•
A9.2	INTERIOR ELEVATIONS - UNITS	•	•
A9.3	INTERIOR ELEVATIONS - COMMON AREAS	•	•
A9.4 A10.1	INTERIOR ELEVATIONS - COMMON AREAS	•	•
		•	•
	INTERIOR DETAILS	-	
A10.2 A10.3	INTERIOR DETAILS	•	•
A10.2		•	•

*FULL CIVIL DRAWINGS TO BE ISSUED UNDER SEPARATE COVER

WESLEY HOMES 707 39TH AVENUE SE, BLDG D PUYALLUP, WA 98374

SHEET NUMBER	SHEET NAME	PERMIT 06/02/23	PERMIT RESPONSE
INTERIORS			
ID0.1 ID1.0N	SCHEDULES AND MATERIALS FINISH FLOOR PLAN	•	
ID1.0S	FINISH FLOOR PLAN	•	
ID1.1N ID1.1S	FINISH FLOOR PLAN FINISH FLOOR PLAN	•	
ID1.2N	FINISH FLOOR PLAN	•	
ID1.2S ID2.1	FINISH FLOOR PLAN INTERIOR ELEVATIONS	•	
ID5.1	FFE PLANS		
STRUCTURAL			
S0.1-B	STRUCTURAL NOTES	•	•
S0.2-B S0.3-B	STRUCTURAL NOTES QUALITY ASSURANCE NOTES	•	•
S0.4-B	QUALITY ASSURANCE NOTES	•	•
S0.5-B S0.6-B	CONCRETE SCHEDULES WOOD SCHEDULES	•	•
S0.7-B	WOOD SCHEDULES	•	•
S0.8-B S0.9-B	TYPICAL DETAILS FRAMING NOTES	•	•
S0.9-В S1.0-BN	LEVEL 0 FOUNDATION PLAN - NORTH	•	•
S1.0-BS	LEVEL 0 FOUNDATION PLAN - SOUTH	•	•
S1.1-BN S1.1-BNM	LEVEL 1 FRAMING PLAN - NORTH LEVEL 1 MILD STEEL PLAN - NORTH	•	•
S1.1-BNP	LEVEL 1 POST-TENSIONING PLAN - NORTH	•	•
S1.1-BS	LEVEL 1 FRAMING PLAN - SOUTH	•	•
S1.1-BSM S1.1-BSP	LEVEL 1 MILD STEEL PLAN - SOUTH LEVEL 1 POST-TENSIONING PLAN - SOUTH	•	•
S1.2-BN	LEVEL 2 FRAMING PLAN - NORTH	٠	•
S1.2-BS S1.3-BN	LEVEL 2 FRAMING PLAN - SOUTH LEVEL 3 FRAMING PLAN - NORTH	•	•
ST.3-BN S1.3-BS	LEVEL 3 FRAMING PLAN - NORTH LEVEL 3 FRAMING PLAN - SOUTH		•
S1.4-BN	ROOF FRAMING PLAN - NORTH	•	•
S1.4-BS S1.5-B	ROOF FRAMING PLAN - SOUTH LEVEL 2 DIAPHRAGM PLAN	•	•
S1.6-B	LEVEL 2 DIAL HIGGONT LAN	•	•
S1.7-B	ROOF DIAPHRAGM PLAN	•	•
S2.1-B S2.2-B	FOUNDATION DETAILS FOUNDATION DETAILS	•	•
S2.3-B	FOUNDATION DETAILS	•	•
S2.4-B	FOUNDATION DETAILS	٠	•
S2.5-B S2.6-B	FOUNDATION DETAILS FOUNDATION DETAILS	•	•
S3.1-B	CONCRETE FLOOR DETAILS	٠	•
S3.2-B S4.1-B	CONCRETE FLOOR DETAILS POST-TENSIONED SLAB DETAILS	•	•
S4.1-В S4.2-В	POST-TENSIONED SLAB DETAILS POST TENTIONED DETAILS	•	•
S5.1-B	CMU WALL DETAILS	•	•
S6.1-B S6.2-B	FLOOR FRAMING DETAILS FLOOR FRAMING DETAILS	•	•
S6.3-B	FLOOR FRAMING DETAILS	•	•
S6.4-B	FLOOR FRAMING DETAILS	•	•
S6.5-B S7.1-B	FLOOR FRAMING DETAILS ROOF FRAMING DETAILS	•	•
S7.2-B	ROOF FRAMING DETAILS	•	•
S7.3-B S7.4-B	ROOF FRAMING DETAILS ROOF FRAMING DETAILS	•	•
S7.4-В S7.5-В	ROOF FRAMING DETAILS ROOF FRAMING DETAILS	•	•
S7.6-B	ROOF FRAMING DETAILS	•	•
S8.1-B S8.2-B	STAIR PLAN STAIR PLAN	•	•
S8.3-B	STAIR DETAILS	•	•
S9.1-B	ELEVATOR PLAN	٠	•
S9.2-B S10.1-B	ELEVATOR DETAILS BALCONY PLANS	•	•
S10.2-B	BALCONY FRAMING DETAILS	•	•
S11.1-B S12.1	CANOPY PLANS AND DETAILS SITE DETAILS	•	•
ity of Puyallu		•	•
Development Engineering APPROVED See permit for additional requirements. Linda Lian	control and erosion inspection with City Engineering Inspector through th CityView portal at least 48 hours in advance of job start. Refer to the Stormwater Fact Sheet and City Standards 02.03.02 & 05.02.01 Call Before You Dig. It's the law.	a ne I	
05/16/2024 8:07:11 AM	Locate all utilities prior to starting wo Dial 811 or call 1-800-424-5555. Refer to approved civil plan: PRCCP20 for sedimentation and erosion control	023	
PIPE OF WASHINGTON	Refer to approved civil plan: PRCCP20 for roof downspout control meth		028

SHEET NUMBER	SHEET NAME	PERMIT 06/02/23	PERMIT RESPONSE 1
MECHANICAL			
M0.0		•	•
M1.0AA M1.0AB	LOWER LEVEL WASTE & VENT PLAN AREA A	•	•
M1.0BA	LOWER LEVEL DOMESTIC WATER & GAS PLAN AREA A	•	•
M1.0BA	LOWER LEVEL DOMESTIC WATER & GAS PLAN AREA B	•	•
M1.1A	LEVEL ONE PLUMBING PLAN AREA A	•	•
M1.1B	LEVEL ONE PLUMBING PLAN AREA B	•	•
M1.2A	LEVEL TWO PLUMBING PLAN AREA A	•	•
M1.2B	LEVEL TWO PLUMBING PLAN AREA B	•	•
M1.3A	LEVEL THREE PLUMBING PLAN AREA A		•
M1.3B	LEVEL THREE PLUMBING PLAN AREA B		•
M2.0A	LOWER LEVEL HVAC PLAN AREA A	•	•
M2.0B	LOWER LEVEL HVAC PLAN AREA B	•	•
M2.1A	LEVEL ONE HVAC PLAN AREA A	•	•
M2.1B	LEVEL ONE HVAC PLAN AREA B	•	•
M2.2A	LEVEL TWO HVAC PLAN AREA A	•	•
M2.2B	LEVEL TWO HVAC PLAN AREA B	•	•
M2.3A	LEVEL THREE HVAC PLAN AREA A		•
M2.3B	LEVEL THREE HVAC PLAN AREA B		•
M3.0	HVAC UNITS	•	•
M3.1	HVAC UNITS	•	•
M3.2	HVAC UNITS	•	•
M3.3	HVAC UNITS		•
M4.0	PLUMBING RISERS	•	•
M4.1	PLUMBING RISERS	•	•
M4.2	PLUMBING RISERS		•
M5.0		•	•
M5.1 ME1.0	MECHANICAL DETAILS MECHANICAL EQUIPMENT SCHEDULES	•	•
ME1.0 ME1.1	MECHANICAL EQUIPMENT SCHEDULES	•	•
ELECTRICAL			
E0.0	ELECTRICAL TITLE SHEET	•	•
E0.1	ELECTRICAL SITE PLAN	•	•
E1.0A	LOWER LEVEL LIGHTING PLAN AREA A	•	•
E1.0B	LOWER LEVEL LIGHTING PLAN AREA B	•	•
E1.1A	LEVEL ONE LIGHTING PLAN AREA A	•	•
E1.1B	LEVEL ONE LIGHTING PLAN AREA B	•	•
E1.2A	LEVEL TWO LIGHTING PLAN AREA A	•	•
E1.2B	LEVEL TWO LIGHTING PLAN AREA B	•	•
E1.3A	LEVEL THREE LIGHTING PLAN AREA A		•
E1.3B	LEVEL THREE LIGHTING PLAN AREA B		•
E2.0A	LOWER LEVEL POWER & SYSTEMS PLAN AREA A	•	•
E2.0B	LOWER LEVEL POWER & SYSTEMS PLAN AREA B	•	•
E2.1A	LEVEL ONE POWER & SYSTEMS PLAN AREA A	•	•
E2.1B	LEVEL ONE POWER & SYSTEMS PLAN AREA B	•	•
E2.2A	LEVEL TWO POWER & SYSTEMS PLAN AREA A	•	•
E2.2B	LEVEL TWO POWER & SYSTEMS PLAN AREA B	•	•
E2.3A	LEVEL THREE POWER & SYSTEMS PLAN AREA A		•
E2.3B	LEVEL THREE POWER & SYSTEMS PLAN AREA B		•
E3.0		•	•
E3.1		•	•
E3.2		•	•
E3.3			•
E4.0		•	•
E5.0	ELECTRICAL PANEL SCHEDULES	•	•

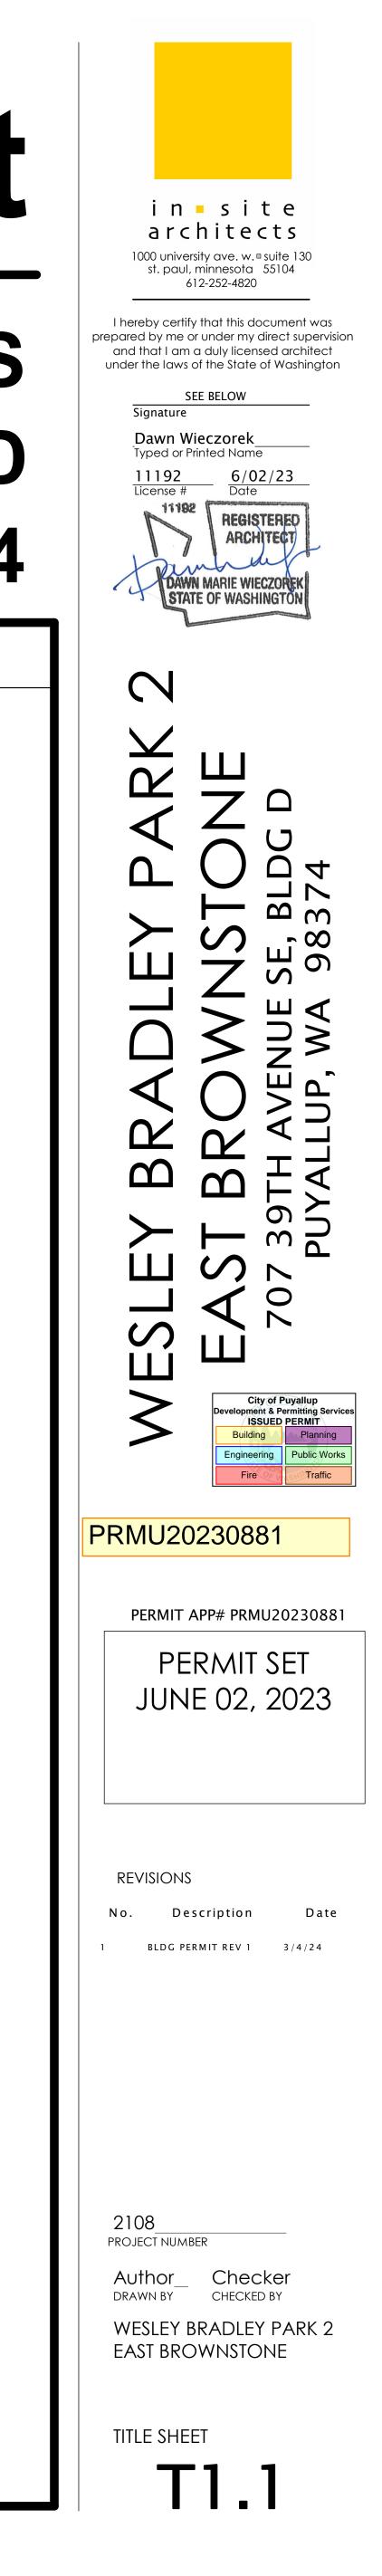

		OCCUPANCY LOAD C				EX	ITING		
NUMBER	ROOM NAME	FUNCTION OF SPACE	OLF	LOAD	MEANS OF EGRESS	ROOM EXITS	MINIMUM EXIT WIDTH		Wesley Bradley Park - PHASE 2 - BRC InSite Project: 2108 Code Review 4/23/23
	PARKING SOUTH PARKING NORTH	Parking Garages Parking Garages	200 200			2	1' - 4 21/32" 3 19/32"		 2018 WA State Building Code - (includes the 2018 International 2018 WA Accessibility Code - C ICC/ANSI A117.1 - 2009 Access
	STORAGE	Accessory Storage Areas, Mechanical Equipment Room	300			1	5/16"		* 2018 WA Residential Energy Co (includes the 2018 IECC) follow
	TRASH ELEV LOBBY	Accessory Storage Areas, Mechanical Equipment Room	300		30	1	5/16"		
	EE	Accessory Storage Areas, Mechanical Equipment Room Accessory Storage Areas,	300 300		30	1	5/32		CHAPTER 3 - USE AND OCCUPANCY
0011	ELECT	Mechanical Equipment Room Accessory Storage Areas, Mechanical Equipment Room	300	1	30	1	5/32"		Occupancy Classifications * Residential Units(IL)
0011A	DATA	Accessory Storage Areas, Mechanical Equipment Room	300	1	30	1	5/32"		 * Non-Dining Common Areas * Parking garage (Basement)
	BIKES	Accessory Storage Areas, Mechanical Equipment Room	300			1	5/32"		Types of Construction (Chapter 6):
	RES STORAGE	Accessory Storage Areas, Mechanical Equipment Room Accessory Storage Areas,	300 300			1	3/4" 5/16"		Fire Protection:Building will be protection
	SERVICE STORAGE	Mechanical Equipment Room Accessory Storage Areas,	300			1	19/32"	<u>,</u>	CHAPTER 4 - SPECIAL REQUIREMEN
	STAIR A STAIR B	Mechanical Equipment Room (none) (none)							429.1 Scope : Group R-2 occupancies re 429.2 Where parking is provided, 5% o
LEVEL 0				155					infrastructure. SEE PARKING SUMMAR 429.5 - Where EV charging infrastructure
	VASHON WHIDBEY	Residential Residential	200 200	7	10	1 1	29/32" 1 1/16"		CHAPTER 5 - GENERAL BUILDING HE Table 504.3 - Allowable building heigh
1005	WHIDBEY WHIDBEY	Residential Residential	200 200	7	10	1	1 1/16" 1 1/16"		Group R-2/Type VA/Sprinklered Group S-2/Type IA/Sprinklered
	WHIDBEY VASHON VASHON	Residential Residential Residential	200 200 200	7 6 6	10	1 1 1	1 1/16" 29/32" 29/32"		Table 504.4 - Allowable stories above • Group R-2/Type VA/Sprinklered
1009	ORCAS	Residential Residential	200 200 200	7	10	1	<u> </u>		Group S-2/Type IA/Sprinklered
1012	WHIDBEY VASHON	Residential Residential	200 200	7		1	1 1/16" 29/32"	1	Section 506: BUILDING AREA Table 506.2 - Allowable area factor / N
1016	HERON (ADA) DECATUR (ADA)	Residential Residential	200 200		10	1 1	3/4" 29/32"	Ę	 Group R-2/Type V/SM Group S-2/Type IA/SM
1018	LOPEZ WHIDBEY	Residential Residential	200 200 200	7 7 6	10	1 1 1	1 1/16" 1 1/16" 29/32"	}	506.2.3 Single occupancy, multistory Aa = [At + (NS x lf] x Sa
	VASHON WHIDBEY VASHON	Residential Residential Residential	200 200 200		10	1 1 1	29/32" 1 1/16" 29/32"	ξ	Aa (R-2) = 36,000 + (12,000 * .7 Aa (R-2) = 36,000 + (12,000 * .7
1022	VASHON WHIDBEY VASHON	Residential Residential	200 200 200	7 6	10	1 1 1	<u> </u>	{	BROWNSTONE EAST OV
1024 1025	VANCOUVER VANCOUVER	Residential Residential	200 200 200	9	10	1 1	1 11/32" 1 3/16"	5	NAME
1030 1031	VESTIBULE LOBBY	(none) (none)						Ş	BROWNSTONE EAST - 1ST FLR BROWNSTONE EAST - 2ND FLR
	ELECT. TRASH	Accessory Storage Areas, Mechanical Equipment Room Accessory Storage Areas,	300 300			1	5/32"	ł	BROWNSTONE EAST - 3RD FLR Grand total: 3
	CLOSET	Mechanical Equipment Room Accessory Storage Areas,	300			1	5/32"	ξ	
1034	CORR N1	Mechanical Equipment Room (none)						ξ	Section 506.3: Frontage Increase If = [F/P0.25]w/30 = .75
	STORAGE	Accessory Storage Areas, Mechanical Equipment Room Assembly - without Fixed Seats -	300			1	5/32" 8 13/32"	C	Section 508: Mixed Use and Occup
1037	TOILET	Unconcentrated (Tables and Chairs) (none)					0 10/02		Section 508.4: Clubroom and Gameroo Table 508.4 Required Separation of O
1039	CORR E1 CORR S1	(none) (none)						\wedge	A to R: 1 hr S to A: 1 hr (per footnote (b)) (3 hours p
	TOILET	Accessory Storage Areas, Mechanical Equipment Room (none)	300	1	30	1	5/32"		WAC 510.2 IS UTILIZED IN THIS PROJ 1. Horizontal assembly (PT Deck) shall b
1042	GAME ROOM	Assembly - without Fixed Seats - Unconcentrated (Tables and Chairs)	15	97	50	2	1' - 2 9/16"	- }	 Building below horizontal separation is Mech and elevator shafts shall be rate Stairs shall be rated 3 hours below
ST A1	OUTDOOR SHED STAIR A1	(none) (none)						5	and 1-hour above construction/p combustible materials per WAC
ST B1 LEVEL 1 - EA	STAIR B1 ST	(none)		305				Ę	4. Building above meets the occupancy of 5. Building below is sprinklered per NFP/
	FOX VASHON	Residential Residential	200 200	6 6		1	29/32" 29/32"		1 1
2004	WHIDBEY WHIDBEY	Residential Residential	200 200	7 7	10	1 1	1 1/16" 1 1/16"		
	WHIDBEY WHIDBEY VASHON	Residential Residential Residential	200 200 200	7 7 6	10	1 1 1	1 1/16" 1 1/16" 29/32"		
2008	VASHON ORCAS	Residential Residential	200 200 200	6	10	1 1 1	29/32" 29/32" 1 1/16"		
2010	WHIDBEY WHIDBEY	Residential Residential	200 200	7	10	1	1 1/16" 1 1/16"		
2014	VASHON CAMANO	Residential Residential	200 200	6 6	10	1 1	29/32" 29/32"		
2017	DECATUR LOPEZ WHIDBEY	Residential Residential Residential	200 200 200	6 7 7	10	1 1 1	29/32" 1 1/16" 1 1/16"		
2019	VASHON WHIDBEY	Residential Residential	200 200 200	6	10	1	29/32" 1 1/16"		
2021	VASHON WHIDBEY	Residential Residential	200 200	6	10	1	29/32" 1 1/16"		
2024	VASHON VANCOUVER	Residential Residential	200 200	9	10	1 1	29/32" 1 11/32"		
	VANCOUVER CORR E2 CORR N2	Residential (none)	200	8	10	1	1 3/16"		
2032	LOBBY TRASH	(none) (none) Accessory Storage Areas,	300	1	30	1	5/32"		
	ELECT/DATA	Mechanical Equipment Room Accessory Storage Areas,	300			1	5/32"		
	CORR S2	Mechanical Equipment Room (none)	005		30		E (0.01)		
	BLDG STORAGE CLUBROOM	Accessory Storage Areas, Mechanical Equipment Room Assembly - without Fixed Seats -	300 15			1 2	5/32" 1' - 0 5/32"		
	CLUB ELECT.	Unconcentrated (Tables and Chairs) Accessory Storage Areas, Mechanical Equipment Room	300			1	5/32"		
	TOILET STAIR A2	Mechanical Equipment Room (none) (none)							
	STAIR B2	(none)		239					
ST A2	ST		\sim		1 0	1	29/32"	3	
ST A2 ST B2 LEVEL 2 - EA 3000	FOX	Residential	200		10	1	29/32"	3	
ST A2 ST B2 LEVEL 2 - EA 3000 3002 3003	FOX VASHON WHIDBEY	Residential Residential	200 200	6 7	10	1	1 1/16"	く	
ST A2 ST B2 LEVEL 2 - EA 3000 3002 3003 3004 3005	FOX VASHON WHIDBEY WHIDBEY WHIDBEY	Residential Residential Residential Residential	200 200 200 200	6 7 7 7 7	10 10 10	1 1 1	1 1/16" 1 1/16"	\$	
ST A2 ST B2 LEVEL 2 - EA 3000 3002 3003 3004 3005 3006 3007	FOX VASHON WHIDBEY WHIDBEY WHIDBEY WHIDBEY VASHON	Residential Residential Residential Residential Residential Residential	200 200 200 200 200 200 200	6 7 7 7 7 7 6	10 10 10 10 10	1 1 1 1 1 1	1 1/16" 1 1/16" 1 1/16" 29/32"	~~~~~~~~~~~~~~~~~~~~~~~~~~~~~~~~~~~~~~~	
ST A2 ST B2 LEVEL 2 - EA 3000 3002 3003 3004 3005 3006 3007 3008 3009 3010	FOX VASHON WHIDBEY WHIDBEY WHIDBEY WHIDBEY VASHON VASHON ORCAS FIDALGO (ADA)	ResidentialResidentialResidentialResidentialResidentialResidentialResidentialResidentialResidentialResidentialResidentialResidential	200 200 200 200 200 200 200 200 200 200	6 7 7 7 7 6 6 6 7 7	10 10 10 10 10 10 10 10 10	1 1 1 1 1 1 1 1 1 1	1 1/16" 1 1/16" 1 1/16" 29/32" 29/32" 1 1/16" 1 1/16"		
ST A2 ST B2 LEVEL 2 - EA 3000 3002 3003 3004 3005 3006 3007 3008 3009 3010 3012 3013	FOX VASHON WHIDBEY WHIDBEY WHIDBEY WHIDBEY VASHON VASHON ORCAS FIDALGO (ADA) LUMMI VASHON	Residential	200 200 200 200 200 200 200 200 200 200	6 7 7 7 6 6 6 7 7 7 6 6 6	10 10 10 10 10 10 10 10 10 10 10	1 1 1 1 1 1 1 1 1 1 1 1	1 1/16" 1 1/16" 1 1/16" 29/32" 29/32" 1 1/16" 1 1/16" 29/32" 29/32"		
ST A2 ST B2 LEVEL 2 - EA 3000 3002 3003 3004 3005 3006 3007 3008 3009 3010 3012 3013 3016 3017	FOX VASHON WHIDBEY WHIDBEY WHIDBEY WHIDBEY VASHON VASHON ORCAS FIDALGO (ADA) LUMMI VASHON DECATUR LOPEZ	Residential	200 200 200 200 200 200 200 200 200 200	6 7 7 7 6 6 6 7 7 6 6 6 6 7	10 10 10 10 10 10 10 10 10 10 10 10	1 1 1 1 1 1 1 1 1 1 1 1 1 1 1	1 1/16" 1 1/16" 1 1/16" 29/32" 29/32" 1 1/16" 1 1/16" 29/32" 29/32" 29/32" 1 1/16"		
ST A2 ST B2 LEVEL 2 - EA 3000 3002 3003 3004 3005 3006 3007 3008 3009 3010 3012 3013 3012 3013 3016 3017 3018 3019	FOX VASHON WHIDBEY WHIDBEY WHIDBEY WHIDBEY VASHON VASHON ORCAS FIDALGO (ADA) LUMMI VASHON DECATUR LOPEZ WHIDBEY VASHON	Residential	200 200 200 200 200 200 200 200 200 200	6 7 7 7 6 6 6 6 6 6 6 7 7 7 6 6	10 10 10 10 10 10 10 10 10 10 10 10 10 1	1 1 1 1 1 1 1 1 1 1 1 1 1	1 1/16" 1 1/16" 1 1/16" 29/32" 29/32" 1 1/16" 1 1/16" 29/32" 29/32" 29/32" 1 1/16" 1 1/16" 1 1/16" 29/32"		
ST A2 ST B2 LEVEL 2 - EA 3000 3002 3003 3004 3005 3006 3007 3008 3009 3010 3012 3013 3016 3017 3018 3017 3018 3019 3020 3021	FOX VASHON WHIDBEY WHIDBEY WHIDBEY WHIDBEY VASHON VASHON ORCAS FIDALGO (ADA) LUMMI VASHON DECATUR LOPEZ WHIDBEY	Residential	200 200 200 200 200 200 200 200 200 200	6 7 7 7 6 6 6 7 7 6 6 6 7 7 6 7 6 7 6	10 10	1 1 1 1 1 1 1 1 1 1 1 1 1 1 1 1 1	1 1/16" 1 1/16" 1 1/16" 29/32" 29/32" 1 1/16" 1 1/16" 29/32" 29/32" 29/32" 29/32" 1 1/16" 1 1/16" 1 1/16"		
ST A2 ST B2 LEVEL 2 - EA 3000 3002 3003 3004 3005 3006 3007 3008 3009 3010 3012 3013 3016 3017 3018 3017 3018 3019 3020 3021	FOX VASHON WHIDBEY WHIDBEY WHIDBEY WHIDBEY VASHON VASHON ORCAS FIDALGO (ADA) LUMMI VASHON DECATUR LOPEZ WHIDBEY VASHON WHIDBEY VASHON WHIDBEY VASHON WHIDBEY VASHON WHIDBEY VASHON	Residential	200 200 200 200 200 200 200 200 200 200	6 7 7 7 6 6 6 7 7 6 6 6 7 7 6 7 6 7 6 9	10 10	1 1	1 1/16" 1 1/16" 1 1/16" 29/32" 29/32" 1 1/16" 1 1/16" 29/32" 29/32" 29/32" 1 1/16" 1 1/16" 1 1/16" 29/32" 1 1/16" 29/32"		
ST A2 ST B2 LEVEL 2 - EA 3000 3002 3003 3004 3005 3006 3007 3008 3007 3008 3009 3010 3012 3013 3010 3012 3013 3016 3017 3018 3017 3018 3019 3020 3021 3022 3023 3024 3025 3030	FOX VASHON WHIDBEY WHIDBEY WHIDBEY WHIDBEY VASHON VASHON ORCAS FIDALGO (ADA) LUMMI VASHON DECATUR LOPEZ WHIDBEY VASHON WHIDBEY VASHON WHIDBEY VASHON WHIDBEY VASHON WHIDBEY VASHON WHIDBEY VASHON WHIDBEY VASHON WHIDBEY VASHON	Residential	200 200 200 200 200 200 200 200 200 200	6 7 7 7 6 6 6 6 6 6 6 6 7 7 6 7 7 6 7 7 6 7 8 8 8	10 10	1 1	1 1/16" 1 1/16" 1 1/16" 29/32" 29/32" 1 1/16" 1 1/16" 29/32" 29/32" 29/32" 1 1/16" 1 1/16" 1 1/16" 29/32" 1 1/16" 1 1/16" 29/32" 1 1/16" 1 1/16" 29/32" 1 1/16" 1 1/16" 29/32" 1 1/16" 20/32" 1 1/16" 20/32" 1 1/16" 2 1/16" 1 1/16		
ST A2 ST B2 LEVEL 2 - EA 3000 3002 3003 3004 3005 3006 3007 3008 3007 3008 3009 3010 3012 3013 3010 3012 3013 3016 3017 3018 3017 3018 3019 3020 3021 3022 3023 3024 3025 3030 3030A	FOX VASHON WHIDBEY WHIDBEY WHIDBEY WHIDBEY VASHON VASHON ORCAS FIDALGO (ADA) LUMMI VASHON DECATUR LOPEZ WHIDBEY VASHON WHIDBEY VASHON WHIDBEY VASHON WHIDBEY VASHON WHIDBEY VASHON WHIDBEY VASHON WHIDBEY VASHON WHIDBEY VASHON WHIDBEY VASHON WHIDBEY VASHON WHIDBEY TRASH	Residential	200 200 200 200 200 200 200 200 200 200	6 7 7 7 6 6 6 6 6 6 6 6 7 7 6 7 7 6 7 7 6 7 8 8 8	10 10	1 1	1 1/16" 1 1/16" 1 1/16" 29/32" 29/32" 1 1/16" 1 1/16" 29/32" 29/32" 29/32" 1 1/16" 29/32" 1 1/16" 29/32" 1 1/16" 29/32" 1 1/16" 29/32" 1 1/16"		
ST A2 ST B2 LEVEL 2 - EA 3000 3002 3003 3004 3005 3006 3007 3008 3009 3010 3012 3013 3016 3017 3018 3016 3017 3018 3019 3020 3021 3022 3023 3024 3025 3030 3030A 3031	FOX VASHON WHIDBEY WHIDBEY WHIDBEY WHIDBEY VASHON VASHON ORCAS FIDALGO (ADA) LUMMI VASHON DECATUR LOPEZ WHIDBEY VASHON WHIDBEY VASHON WHIDBEY VASHON WHIDBEY VASHON WHIDBEY VASHON WHIDBEY VASHON WHIDBEY VASHON WHIDBEY VASHON	Residential	200 200 200 200 200 200 200 200 200 200	6 7 7 7 7 6 6 6 6 6 6 6 6 7 7 6 7 7 6 7 6 9 9 8 8 7	10 30	1 1	1 1/16" 1 1/16" 1 1/16" 29/32" 29/32" 1 1/16" 1 1/16" 29/32" 29/32" 29/32" 1 1/16" 1 1/16" 1 1/16" 29/32" 1 1/16" 1 1/16" 29/32" 1 1/16" 1 1/16" 29/32" 1 1/16" 1 1/16" 29/32" 1 1/16" 20/32" 1 1/16" 20/32" 1 1/16" 2 1/16" 1 1/16		
ST A2 ST B2 LEVEL 2 - EA 3000 3002 3003 3004 3005 3006 3007 3008 3007 3008 3009 3010 3012 3012 3013 3010 3012 3013 3016 3017 3018 3017 3018 3017 3018 3017 3018 3017 3022 3023 3021 3022 3023 3024 3025 3030 3030A 3031 3031A 3032 3033	FOX VASHON WHIDBEY WHIDBEY WHIDBEY WHIDBEY VASHON VASHON ORCAS FIDALGO (ADA) LUMMI VASHON DECATUR LOPEZ WHIDBEY VASHON WHIDBEY VASHON WHIDBEY VASHON WHIDBEY VASHON WHIDBEY VASHON WHIDBEY VASHON WHIDBEY VASHON WHIDBEY VASHON WHIDBEY CORR N3 MECH CORR E3 RESIDENT	Residential	200 200 200 200 200 200 200 200 200 200	6 7 7 7 6 6 6 6 7 7 6 6 7 7 6 7 6 7 6 7	10 30	1 1	1 1/16" 1 1/16" 1 1/16" 29/32" 29/32" 1 1/16" 1 1/16" 29/32" 29/32" 29/32" 1 1/16" 29/32" 1 1/16" 29/32" 1 1/16" 29/32" 1 1/16" 29/32" 1 1/16" 29/32" 1 3/16" 5/32"		
ST A2 ST B2 LEVEL 2 - EA 3000 3002 3003 3004 3005 3006 3007 3008 3009 3010 3012 3013 3010 3012 3013 3016 3017 3018 3017 3018 3017 3018 3017 3018 3017 3018 3017 3020 3021 3022 3023 3024 3022 3023 3024 3025 3030 3030A	FOX VASHON WHIDBEY WHIDBEY WHIDBEY WHIDBEY VASHON VASHON ORCAS FIDALGO (ADA) LUMMI VASHON DECATUR LOPEZ WHIDBEY VASHON WHIDBEY VASHON WHIDBEY VASHON WHIDBEY VASHON WHIDBEY VASHON WHIDBEY VASHON WHIDBEY VASHON WHIDBEY VASHON WHIDBEY CORR N3 MECH CORR E3	Residential	200 200 200 200 200 200 200 200 200 200	6 7 7 7 7 6 6 6 6 6 7 7 7 6 6 7 7 6 6 7 7 6 8 8 8 8	10 30 30 30	1 1	1 1/16" 1 1/16" 1 1/16" 29/32" 29/32" 1 1/16" 1 1/16" 29/32" 29/32" 29/32" 1 1/16" 1 1/16" 29/32" 1 1/16" 20/32" 20/32" 1 1/16" 20/32"		
ST A2 ST B2 LEVEL 2 - EA 3000 3002 3003 3004 3005 3006 3007 3008 3009 3010 3012 3013 3010 3012 3013 3016 3017 3018 3017 3018 3017 3018 3017 3018 3017 3018 3017 3018 3021 3022 3023 3024 3025 3023 3024 3025 3030 3030A 3031 3031 3031 3031 3032 3033	FOX VASHON WHIDBEY WHIDBEY WHIDBEY WHIDBEY VASHON VASHON ORCAS FIDALGO (ADA) LUMMI VASHON DECATUR LOPEZ WHIDBEY VASHON WHIDBEY VASHON WHIDBEY VASHON WHIDBEY VASHON WHIDBEY VASHON WHIDBEY VASHON WHIDBEY VASHON WHIDBEY VASHON WHIDBEY CORR N3 MECH CORR E3 RESIDENT STORAGE	Residential	200 200 200 200 200 200 200 200 200 200	6 7 7 7 6 6 7 6 6 7 6 7 6 7 6 7 6 7 6 7 6 7 6 7 6 7 6 9 8 1 1 2 1 2 1 2 1	10 30 30 30 30 30	1 1	1 1/16" 1 1/16" 1 1/16" 29/32" 29/32" 1 1/16" 1 1/16" 29/32" 29/32" 29/32" 1 1/16" 29/32" 1 1/16" 29/32" 1 1/16" 29/32" 1 1/16" 29/32" 1 1/16" 29/32" 1 1/16" 29/32" 1 1/16" 29/32" 5/32"		
ST A2 ST B2 LEVEL 2 - EA 3000 3002 3003 3004 3005 3006 3007 3008 3007 3008 3007 3008 3007 3010 3012 3012 3013 3010 3012 3013 3016 3017 3018 3017 3018 3017 3018 3017 3018 3017 3018 3021 3022 3023 3021 3022 3023 3024 3025 3030 3030A 3030A 3031 3031A 3031A 3032 3033 3034	FOX VASHON WHIDBEY WHIDBEY WHIDBEY WHIDBEY VASHON VASHON ORCAS FIDALGO (ADA) LUMMI VASHON DECATUR LOPEZ WHIDBEY VASHON WHIDBEY VASHON WHIDBEY VASHON WHIDBEY VASHON WHIDBEY VASHON WHIDBEY VASHON WHIDBEY VASHON WHIDBEY VASHON WHIDBEY CORR N3 MECH CORR N3 MECH CORR E3 RESIDENT STORAGE/ELEC CORR S2	Residential	200 200 200 200 200 200 200 200 200 200	6 7 7 7 6 6 7 6 6 7 6 7 6 7 6 7 6 7 6 7 6 7 6 7 6 7 6 9 8 1 2 1 2 1 1 1 1	10 30 30 30 30 30 30	1 1	1 1/16" 1 1/16" 1 1/16" 29/32" 29/32" 1 1/16" 1 1/16" 29/32" 29/32" 29/32" 1 1/16" 1 1/16" 29/32" 1 1/16" 29/32" 1 1/16" 29/32" 1 1/16" 29/32" 1 1/16" 29/32" 1 1/16" 29/32" 1 1/16" 29/32" 1 1/16" 29/32" 5/32" 5/32"		
ST A2 ST B2 LEVEL 2 - EA 3000 3002 3003 3004 3005 3006 3007 3008 3009 3010 3012 3013 3010 3012 3013 3016 3017 3018 3017 3018 3017 3018 3017 3018 3017 3018 3017 3018 3021 3022 3023 3024 3025 3023 3024 3025 3030 3024 3025 3030 3031 3032 3031 3031A 3031 3031A 3031 3031A 3032 3033 3034	FOX VASHON WHIDBEY WHIDBEY WHIDBEY WHIDBEY VASHON VASHON ORCAS FIDALGO (ADA) LUMMI VASHON DECATUR LOPEZ WHIDBEY VASHON WHIDBEY VASHON WHIDBEY VASHON WHIDBEY VASHON WHIDBEY VASHON WHIDBEY VASHON WHIDBEY VASHON WHIDBEY CORR N3 MECH CORR E3 RESIDENT STORAGE/ELEC CORR S2 MECH	Residential	200 200 200 200 200 200 200 200 200 200	6 7 7 7 6 6 7 6 6 7 6 7 6 7 6 7 6 7 6 7 6 7 6 7 6 7 6 9 8 1 2 1 2 1 1 1 1	10 30 30 30 30 30 30	1 1	1 1/16" 1 1/16" 1 1/16" 29/32" 29/32" 1 1/16" 1 1/16" 29/32" 29/32" 29/32" 1 1/16" 1 1/16" 29/32" 1 1/16" 29/32" 1 1/16" 29/32" 1 1/16" 29/32" 1 1/16" 29/32" 1 1/16" 29/32" 1 1/16" 5/32" 5/32"		

853

SE 2 - BROWNSTONE EAST	CHAPTER 6 - TYPES OF CONSTRU	CTION		
	Table 601 Fire Resistance Rating Re		ents	
	<u>Typ</u> Structural frame	<u>e VA - Rating (in hours) T</u> 1 3	ype 1A	
ing Code - Chapter 51-50 WAC ternational Building Code) ty Code - Chapter 51, 50, 005 WAC	Exterior Bearing walls	1* 3 1 3		
ty Code - Chapter 51-50-005 WAC 009 Accessible and Usable Buildings and Facilities I Energy Code - Chapter 51-11R WAC	Interior Bearing walls Non- Bearing Exterior	1 3		
CC) following the prescriptive compliance path.	Walls and Partitions	1* *		
	Non- Bearing Interior Walls and Partitions	0 0		
CUPANCY CLASSIFICATION	Floors and floor-ceilings	1 2		
	Roofs and roof-ceilings	1 1	.5	
R-2 Areas A-3	*based on fire separation distance f		5.5 the 1 hour	
sement) S-2	rating is only required from the inter			
pter 6): Type VA - Wood framing above garage Type 1A - Lower level garage	Shaft and stair enclosures = 1 HR (s Corridor walls and walls separating Partitions below)			
I be protected per IBC 903.3.1.1 (NFPA 13) with dry system in attic	Table 602 Fire Resistive Rating Req Separation Distance:	uirements for Exterior Walls-	Based on Fire	
QUIREMENTS BASED ON USE vehicle charging infrastructure	<u>Type VA (A, R Occur</u> Less than 5 ft	ancies) 1 HR		
vencie charging infrastructure supancies required electric vehicle charging infrastructure. rided, 5% of parking spaces shall be provided with electric vehicle charging	5 ft to less than 10 ft 10 ft to less than 30 f	1 HR		
G SUMMARY ON SHEET A0.1	30 ft and over	0 HR		
ILDING HEIGHTS AND AREAS	CHAPTER 7 - FIRE-RESISTIVE RAT			
ding height above grade plane	705.8.5 Vertical separation of openin Exception #2.	igs: 3' vertical separation is no	t required per	
Sprinklered = 70 feet prinklered = Unlimited				
ies above grade plane	Section 708 Fire Partitions 708.3 Fire Partitions Fire-resistance	rating: Includes corridor and d	emising walls (per 420.2)	
Sprinklered = 4 stories, 3 provided prinklered = Unlimited; 1 provided	Corridors = 1 HR Demising walls = 1 HR			
EA CONTRACTOR OF	711.2.4.1 Floor and Roof Assemblies	Fire Resistance Rating: 1 H	R separation is required per IBC	
factor / Non-sprinklered factor (NS)	508.4 Section 713 Shaft Enclosures			
A = 36,000 sf / NS = 12,000 M = Unlimited	713.4 Shaft Enclosure Fire Resistan of 1 HR when connecting less than for		all have a fire- resistance rating	
nultistory J Sa	713.5 Continuity: Constructed as fire	barrier.		
$(12,000 * .75) \times 1 = 45,000 \text{ sf allowed per story}$	713.7 Shaft openings: Openings (do	ors) shall be protected according	g to Table 716.5 (see below).	
(12,000 * .75) x 3 = 135,000 sf allowed per building	713.11 Enclosure at the bottom: Shafire rating as the lowest floor through w			
AREA	shaft enclosure.	and a state of the state of the	notion of some first it	
FLR 36,145 SF	713.12 Enclosure at the top: Shall be Elevator shaft lid must be same rating		uction of same fire rating.	
D FLR 35,762 SF	713.13.3 Refuse and laundry chute a HR with openings (doors) of $\frac{3}{4}$ HR.	ccess rooms: Rooms must be	e enclosed by <u>fire barriers</u> of 1	
DFLR 32,795 SF 32,795 SF 104,701 SF < 135,000 (COMPLIANT)	713.13.4 Termination room: Trash c	nutes shall terminate into rooms	enclosed by fire barriers of the	
}	same rating as the shaft.			
crease	Section 716 Opening Protectives			
- mununul	Fire Door Ratings per Table 716.5: 1 HR fire barriers (exit enclosures, sha	fts, trash chute discharge room	s) = 60 MIN	
and Occupancy nd Gameroom are separated uses.	1 HR fire barriers (occupancy and incid	lental separations, trash access	$rooms) = \frac{3}{4}$ HR doors	
ration of Occupancies: Sprinklered occupancies:	3 HR fire partitions (corridors) = 20 MH 3 HR fire barriers (with req'd rating gre	ater than 1 hr) = 3 HR (180 min	قر ا	
) (3 hours per WAC 510.2, see this section for further information)	Section 718 Concealed Spaces			
THIS PROJECT.	718.4 Draftstopping in attics:			
eck) shall be rated 3 hours. eparation is Type 1A construction.	Exception: Buildings equipped with NF	PA 13 sprinkler system do not r	equire attic subdivision.	
hall be rated 2 hours above and below the horizontal assembly. 3 hours below the horizontal assembly w/ 3HR(180 min) opening protectives)			
nstruction/protectives above. Stair run construction is therefore allowed to be of s per WAC 510.2 (3) Exceptions.				
occupancy criteria - Group R. ed per NFPA 13)			
ן ובשן ובשן	ן זָ			
			۶.	
			//	
				STOR
	KING SOUTH		PATH OF TRAVEL	
	0001		DISTANCE: 183'-T"	
	(22,031 SF)			
	22,031 SF S-2 200 111			

EGRESS FB PER IBC 1009.2 (2), 19 P 1009.3 - 1009.3.2 EX. 1009.3.3 EX. 2, 1023 TRASH 2-WAY COMM 0005 316 SF 17 00 Req'd Door Width 12"/32" MIN Req'd Stair Width 15"/44" MIN _____ || _______====== `L_____]

CHAPTER 8 - INTERIOR FINISHES

(Exception 1).

(sprinklered)

per Exception 2.

Group R = 1 hr

BIKES

44

• S occupancy = 29 / 100'

Table 803.13 Interior	wall and ceiling finish requirements b	y occupancy - sprinklered:	
Group	Exit Enclosures & passageways	Corridors	Rooms
and enclosed spaces			
A-2, A-3	В	В	С
R-2	С	С	С
S	С	С	С

CHAPTER 9 - FIRE PROTECTION SYSTEMS 905.3.1 Standpipe Systems: Class I standpipe system are allowed in sprinklered buildings

905.4 Location of Class I standpipe hose connections: In every required interior exit stairway at the intermediate floor landing between floors

Section 907.5 Occupant Notification Systems:

907.5.2.3.3 - Group R-2: ALL units shall be provided with the *capability* to support visible alarm notification appliances in accordance with ICC A117.1.

CHAPTER 10 - MEANS OF EGRESS

1004 Occupant Loads See Code plans for occupant loads.

1004.1.2 Areas without fixed seating: Where approved by the building official, the actual number of occupants for whom each space is designed, although less than those determined by calculation, shall be permitted to be used in the determination of the design occupant load.

1005.3 Egress Width based on occupant load

1005.3.1 (ex.1) - Stairways: 0.2

1005.3.2 (ex-1) - Other egress components: 0.15 EXIT AND EXIT ACCESS DOORWAYS:

Table 1006.2.1 Spaces with one means of egress: Two means of egress are required where the occupant load exceeds / max common path of egress travel

• A occupancy = 49 / 75' • R-2 occupancy = 10 / 125'

1009.1 Accessible means of egress required: <u>2 accessible means of egress are required</u> and are provided by:

1009.2 Continuity and components: Accessible means of egress shall be continuous to a public way and consist 1. Interior exit stairways

1009.3 Exit stairways: An area of refuge is NOT required at exit stairways of fully sprinklered buildings (NFPA 13)

1009.8 Two-Way Communication: Shall be provided at the elevator landing on each accessilble floor that is one or more stories above the exit discharge.

Section 1017 Exit Access Travel Distance Table 1017.2 Exit access travel distance

A, R-2 occupancy (sprinklered) = 250' S-2 occupancy (sprinklered) = 400'

Section 1020 Corridors

Table 1020.1 - Corridor rating (sprinklered): Group A, S = 0 hr

1020.4 Dead Ends - 50' per exception 2 @ Group S & R occupancies;

CHAPTER 11 - ACCESSIBILITY

1105.1 Public Entrances: In addition to accessible entrances (1105.1.1 - 1105.1.6) at least 60% of public entrances shall be accessible. (Public Entrance: an entrance that is not a service entrance or restricted entrance). Note: all entrances are accessible.

Section 1107 - Dwelling Units 1107.3 Accessible spaces: Spaces available for use by residents and serving "Type A" and "Type B" units shall be accessible. Accessible spaces shall include toilet and bathing rooms, kitchen, living and dining, and exterior spaces.

See also Section 907 above for units requiring visible & audible communication devices.

WAC 1107.6.2.2.1 - Group R-2 - All units on a site shall be considered to determine the total number of units and the required number of Type A units. 5% OF TOTAL UNITS SHALL MEET ACCESSIBILITY GUIDELINES PER FOR GROUP R-2 Lodge building: 99 units/5 Type 'A'

L	1 PH2 Bro	ownstone: 67 units/3 Type /	<u>A'</u>	\sim	
	R-2: 19	8 total units = 10 Type 'A' re	quired/10 units provide	d J	
ملكم	UNITS LISTE	D BELOW SHALL MEET A	NSI A117.1 FOR ACCE	ESSIBILITY AS TYPE '	A' UNITS.
		Type A UN	IT SCHEDULE		
ξ	Number	UNIT NAME	Unit Type	COUNT	5

1016	DECATUR (ADA)	1 BD+	1
1014	HERON (ADA)	1 BD	1
3010	FIDALGO (ADA)	2 BD	1
Grand	total		3

ALL OTHER UNITS SHALL MEET ANSI A117.1 AS TYPE 'B' UNITS.

CHAPTER 14 - EXTERIOR WALLS

1406.3 Balconies and similar projections: Balconies of combustible construction shall be fire-resistance rated in accordance with Table 601 for floor construction (1 HR), OR sprinkler protection shall be extended to these areas.

Level 3: Smoke Draft Curtain complying w/#3.

CHAPTER 30 - ELEVATORS Section 3006.2 Hoistway opening protection required: Exception 2: Protection of the hoistway door openings is not required at level(s) of discharge with NFPA 13 sprinkler system. For this project, Level 1 shall

be the level of discharge.

Section 3006.2.1 Rated Corridors: Where corridors are required to be rated per Section 1020.1, elevator hoistway openings shall be protected per Section 3006.3

Section 3006.3 Hoistway opening protection: Protection for this project shall be as follows: Level 0: Enclosed Lobby per #2 - smoke partitions; Doors "S" rated Level 1: Not required per 3006.2 EX. 2 Level 2: Smoke Draft Curtain complying w/#3.

Section 3009.1 Exception 1 - Hoistway venting required when connecting 4 or more stories. Therefore, not required at this building.

CODE ROOM TAG


OCCUPANCY GROUP GROUP AREA OCCUPANT LOAD FACTOR OCCUPANT LOAD


CODE WALL RATING PATTERNS

1 HOUR 1 2 HOUR 3 HOUR

FB-FB-FB-FB-FB-FIRE BARRIER - 1 & 2 HR SEE PLANS -SP-SP-SP-SP-SP- SMOKE PARTITION NOTES:

1. STAIR, ELEVATOR, AND SHAFT WALLS ARE FIRE BARRIERS. FIRE BARRIER WALLS SHALL EXTEND FROM FLOOR TO UNDERSIDE OF FLOOR OR ROOF SHEATHING ABOVE, UNO.

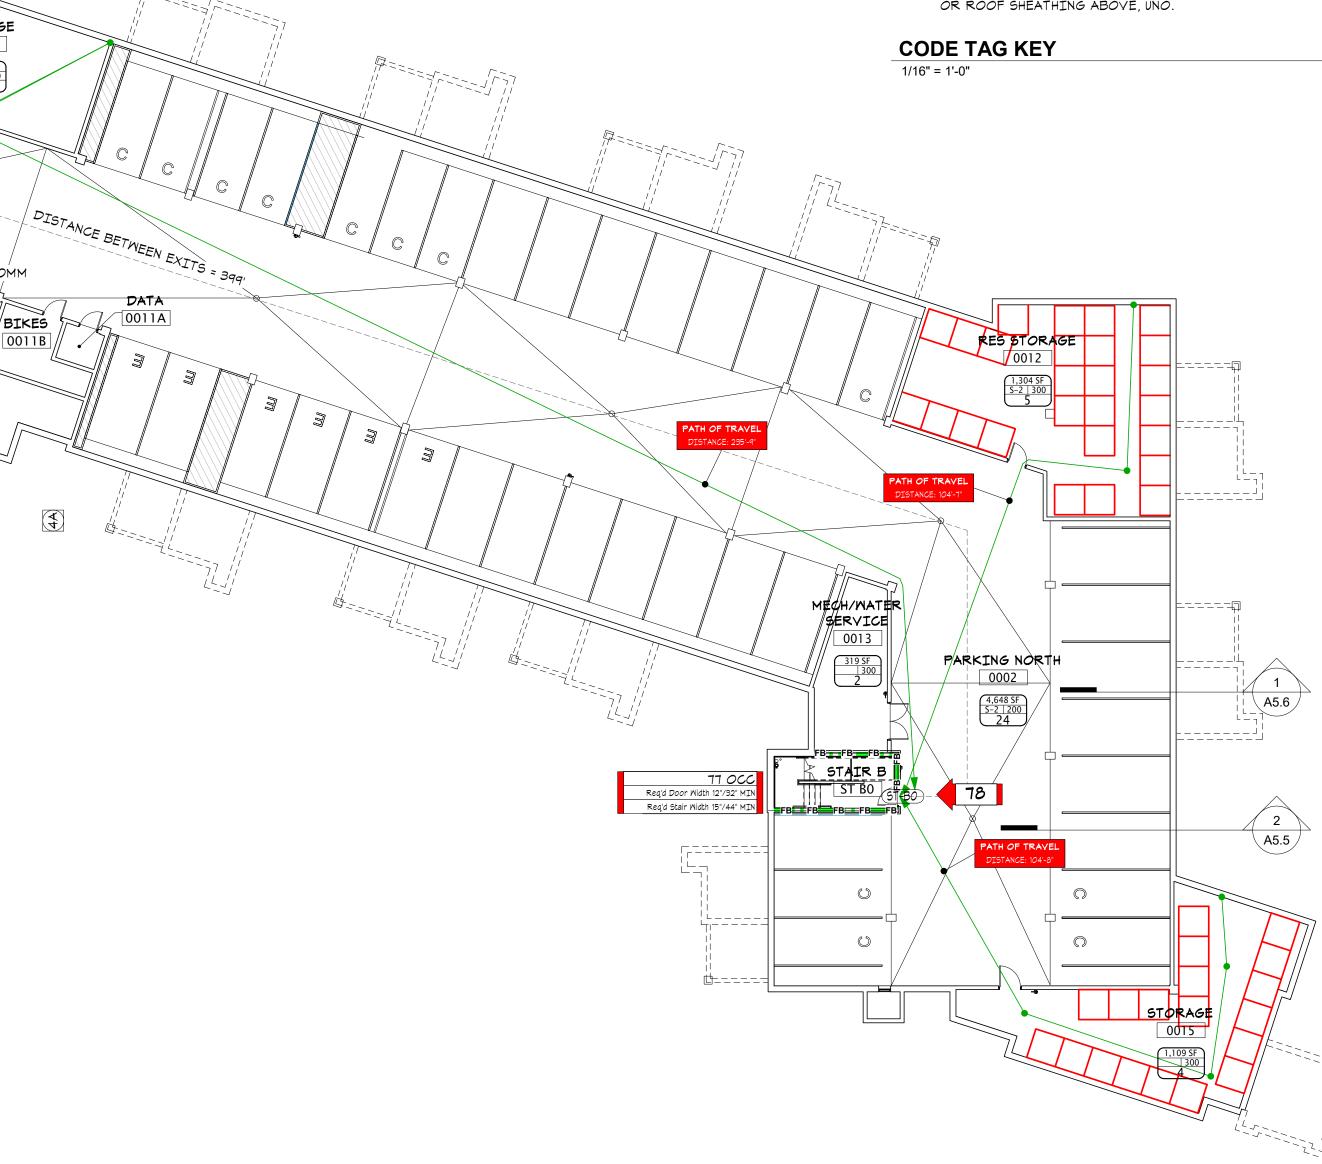

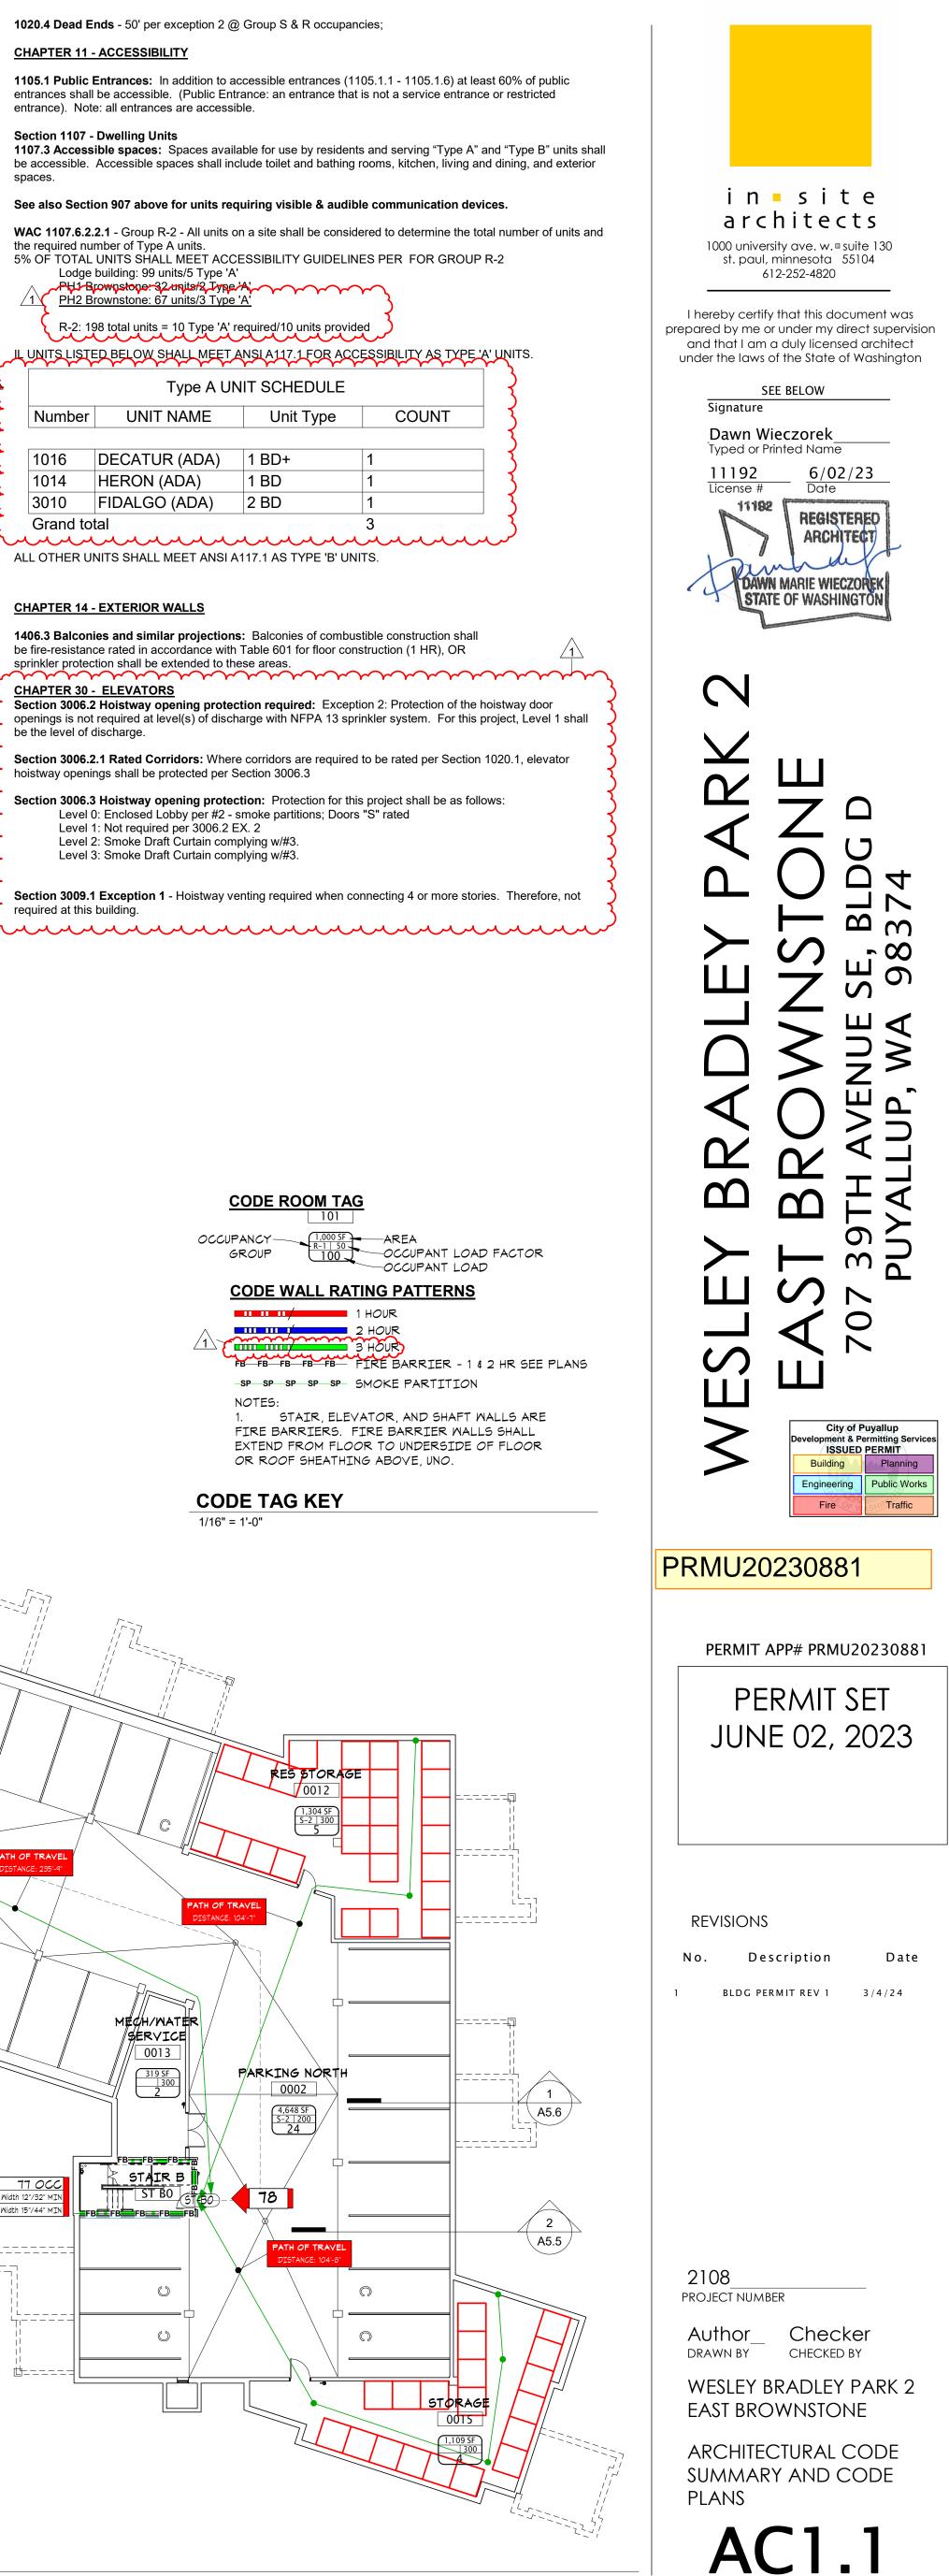









CODE ROOM TAG

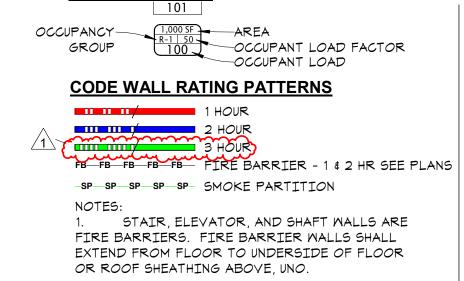

CODE TAG KEY

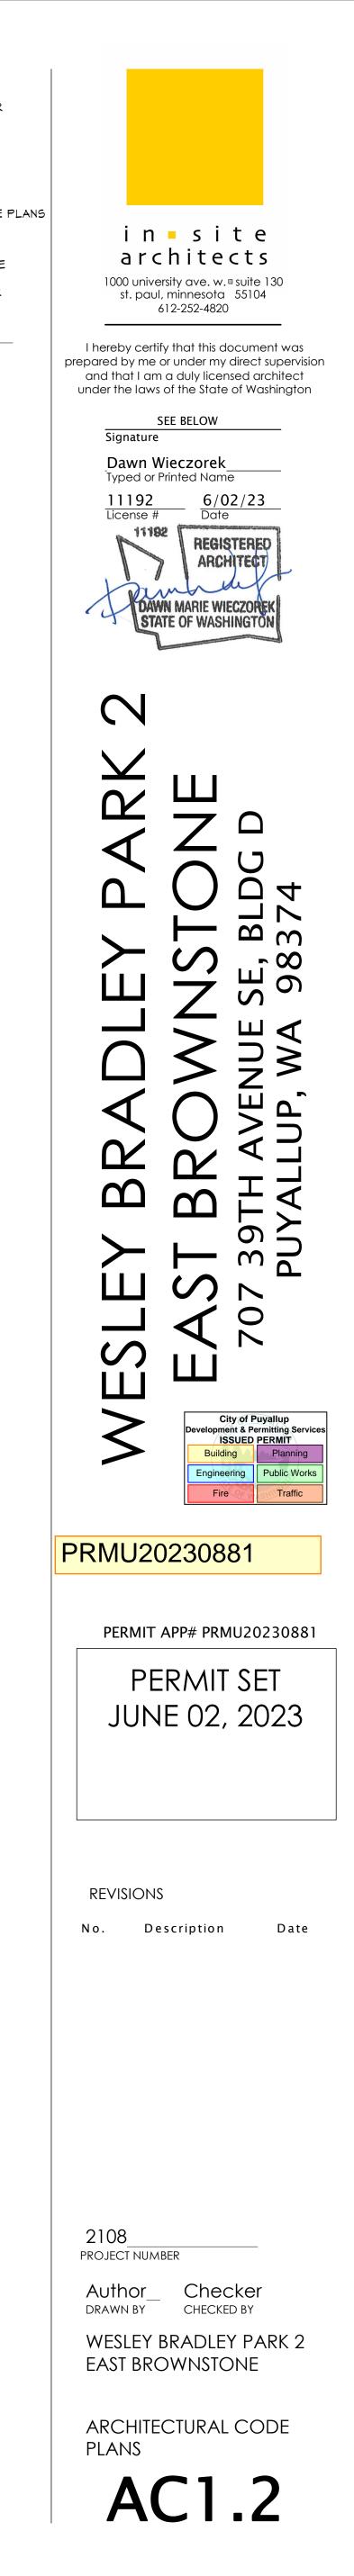



CODE ROOM TAG


CODE WALL RATING PATTERNS


1 HOUR 2 HOUR


-SP-SP-SP-SP-SP- SMOKE PARTITION NOTES:


1. STAIR, ELEVATOR, AND SHAFT WALLS ARE FIRE BARRIERS. FIRE BARRIER WALLS SHALL EXTEND FROM FLOOR TO UNDERSIDE OF FLOOR OR ROOF SHEATHING ABOVE, UNO.


CODE TAG KEY 1/16" = 1'-0"

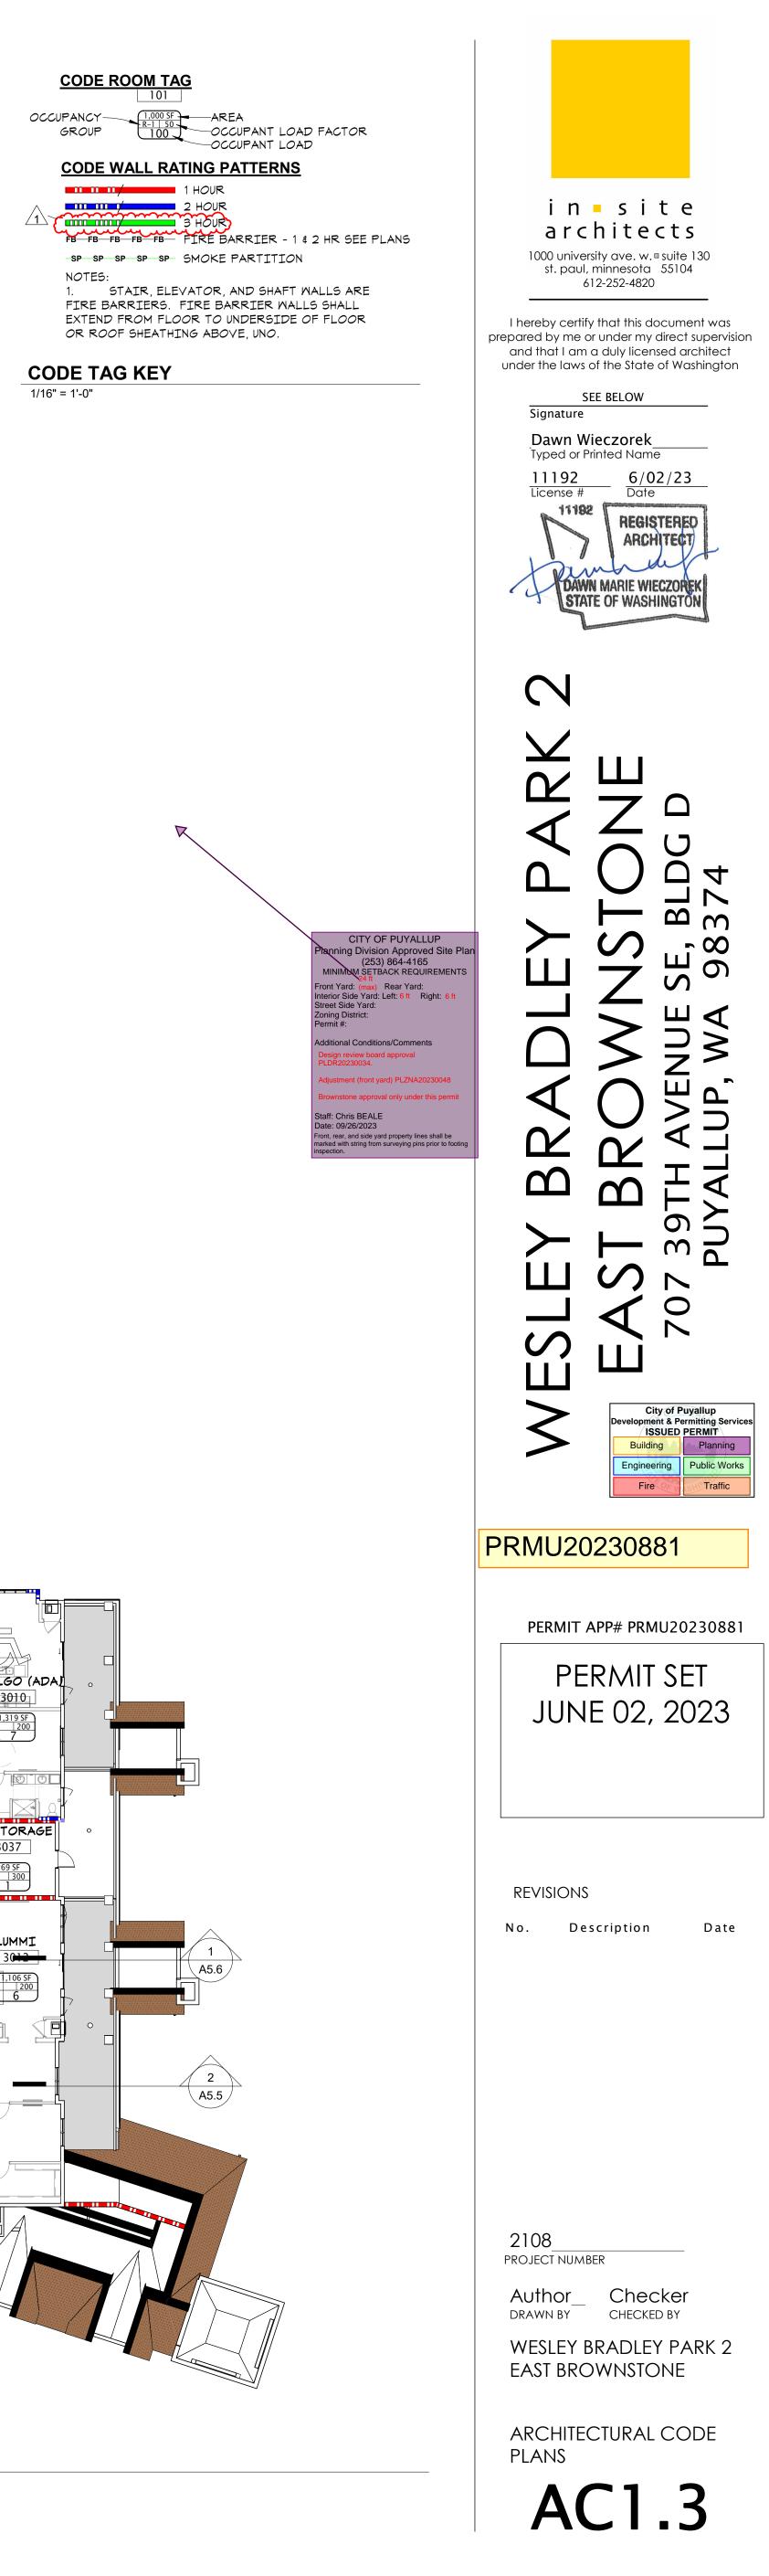

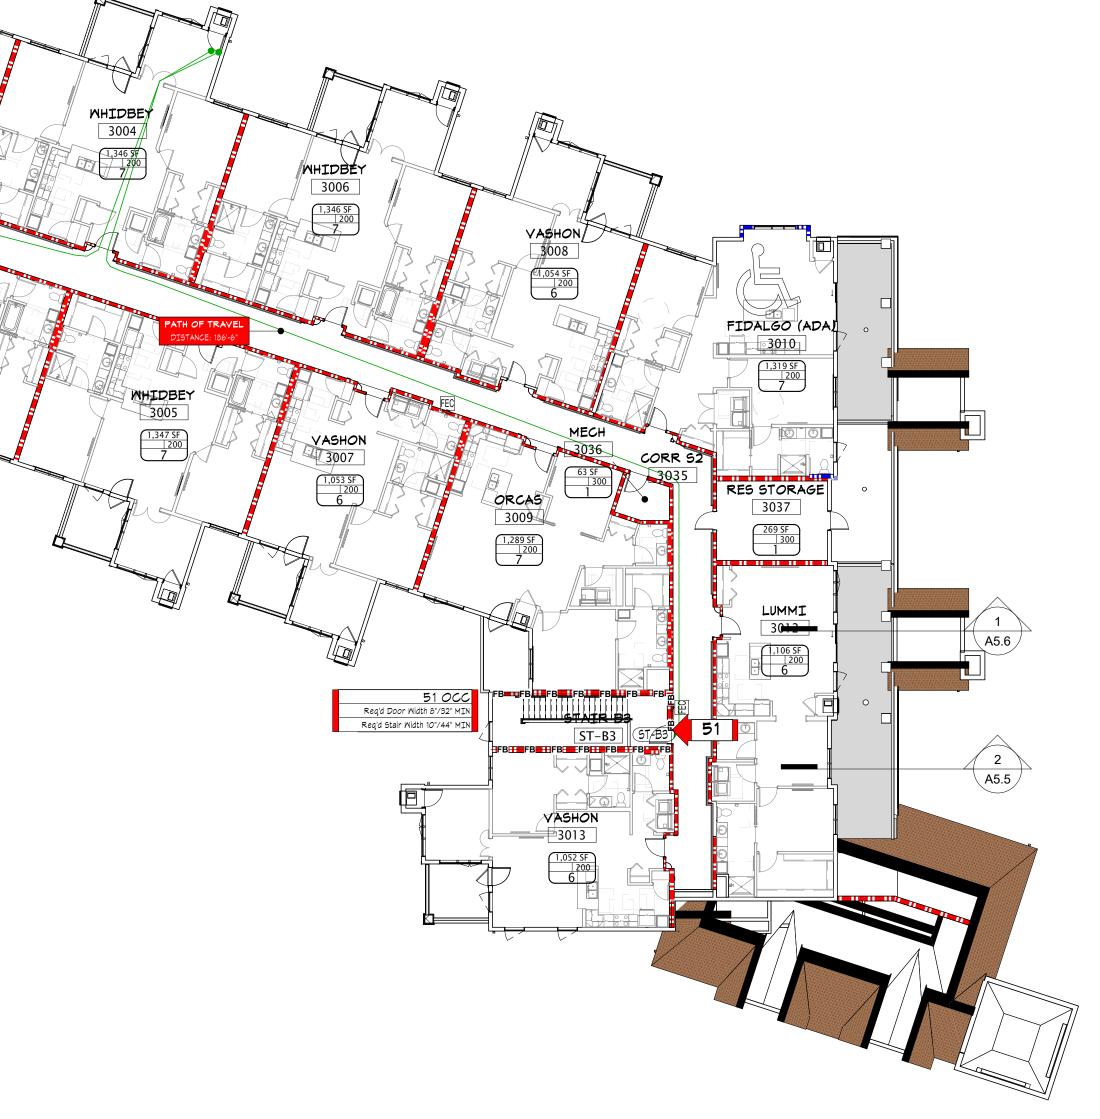


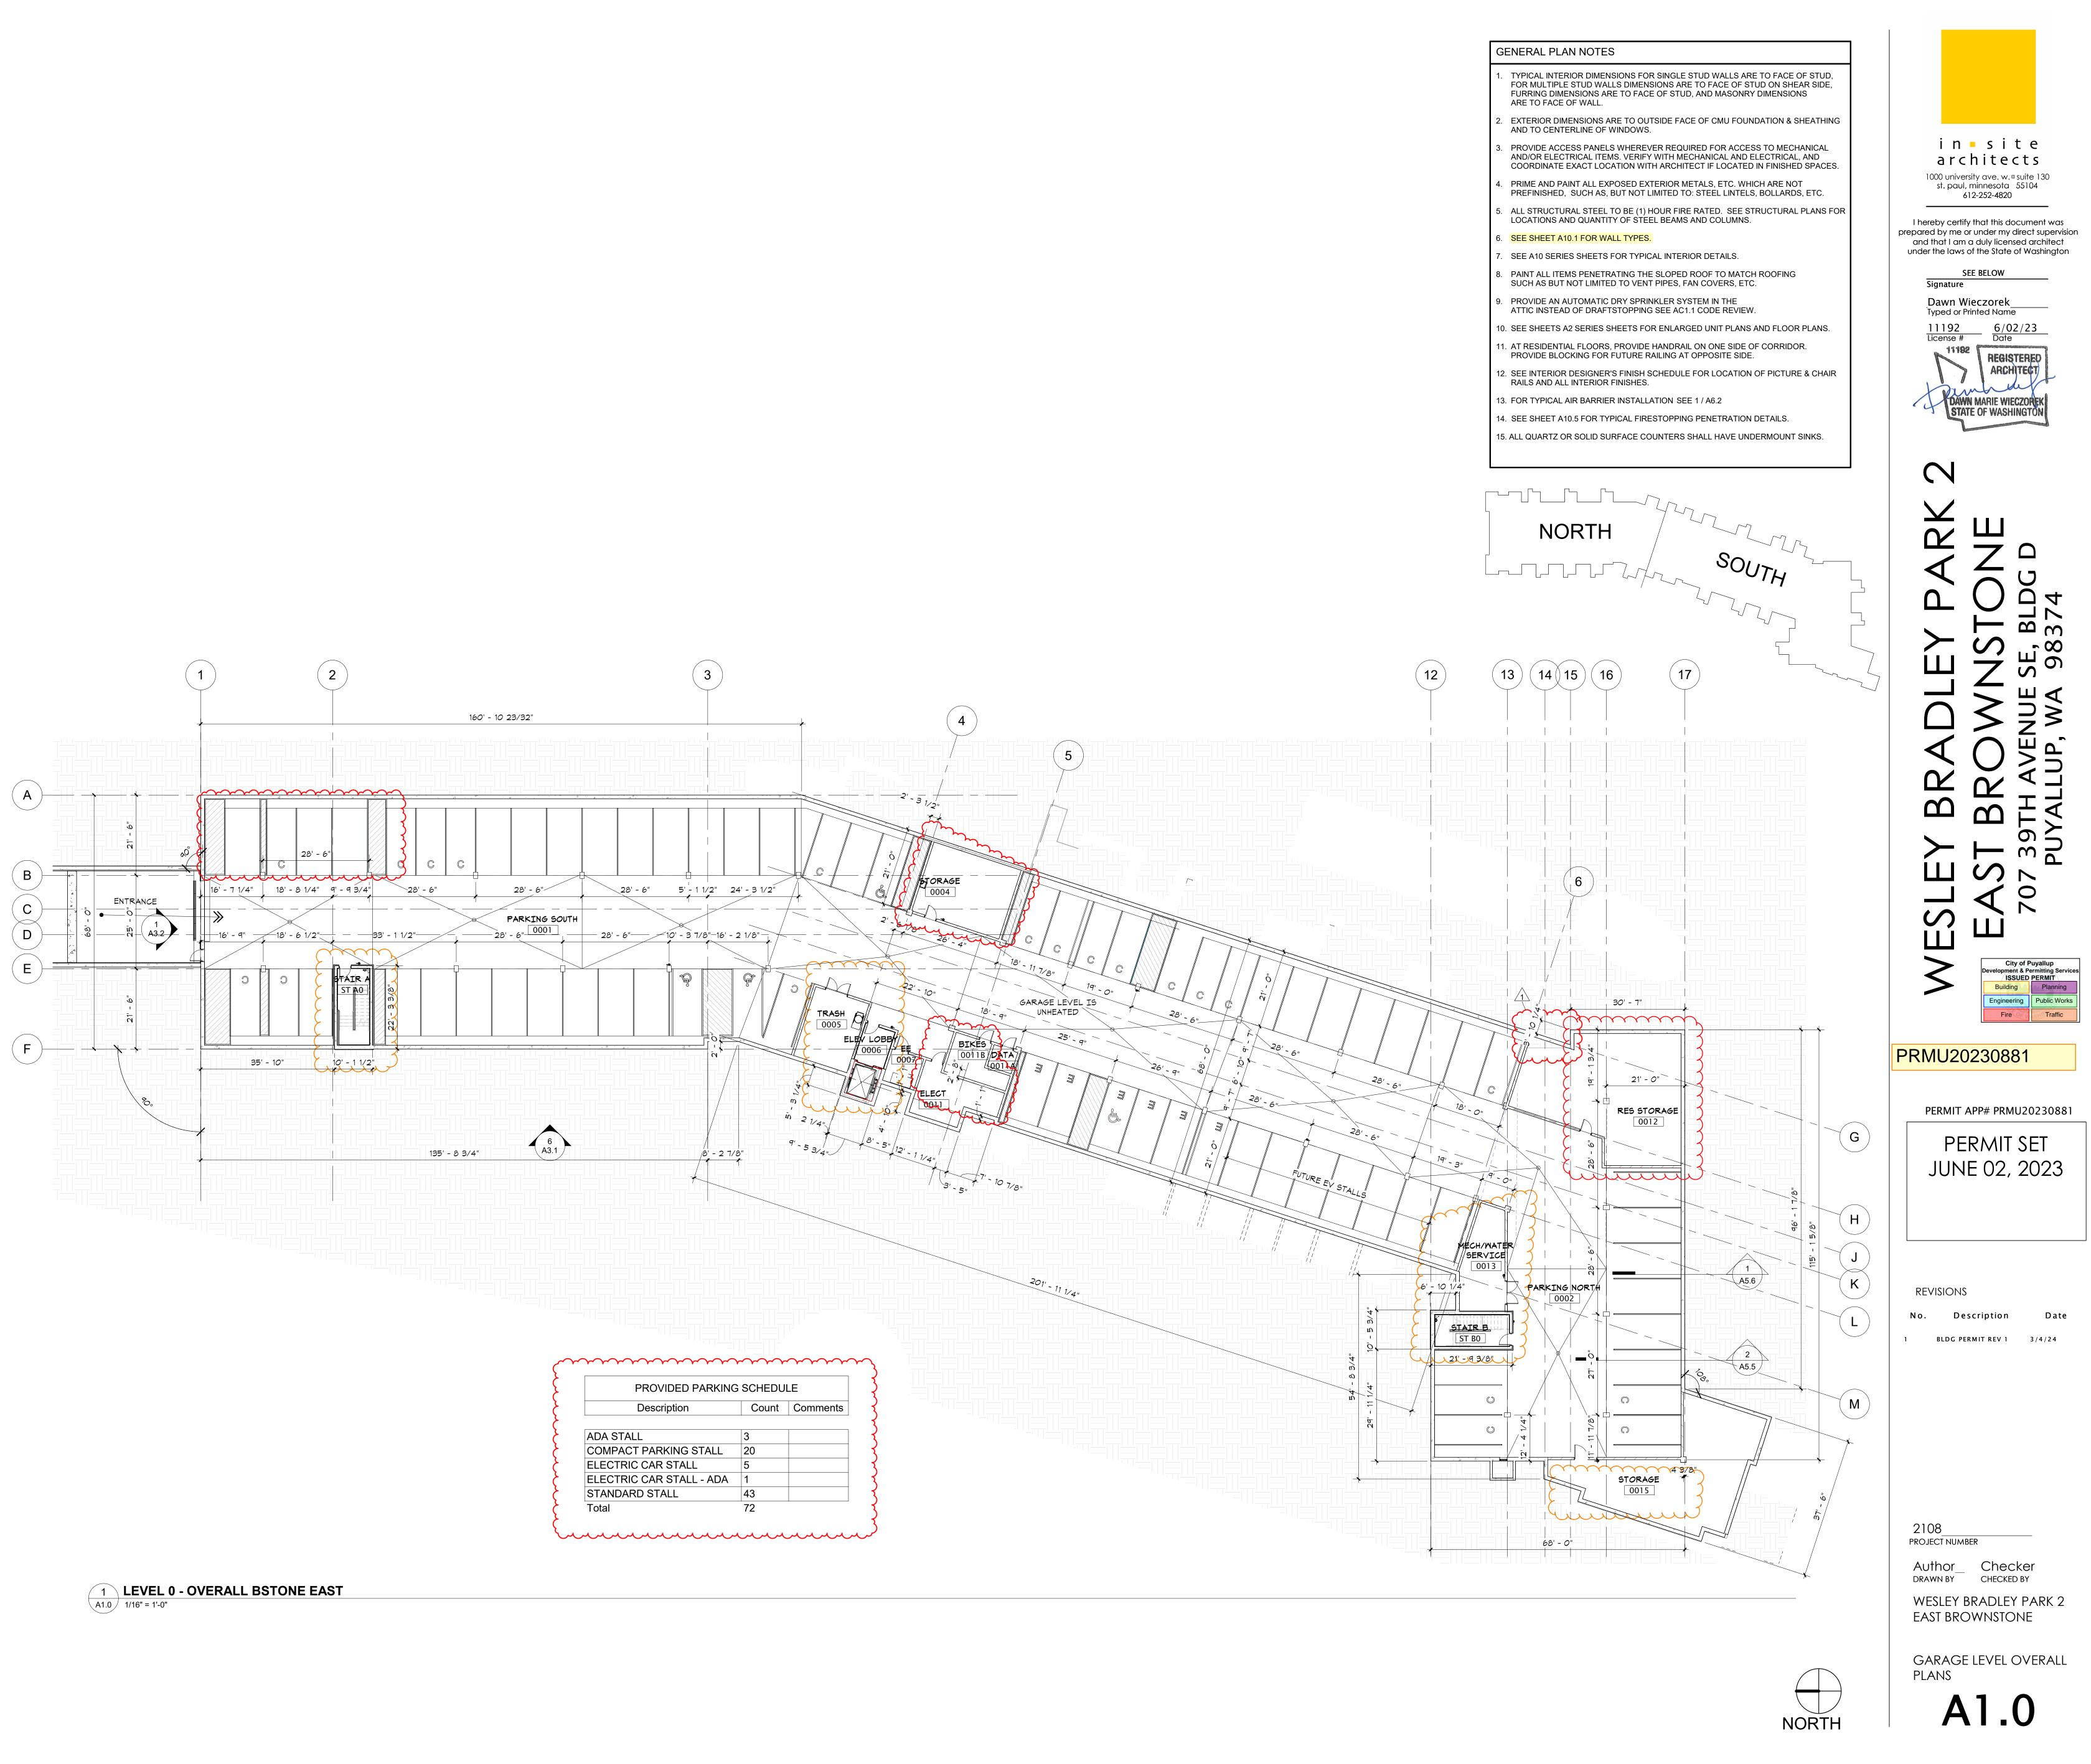

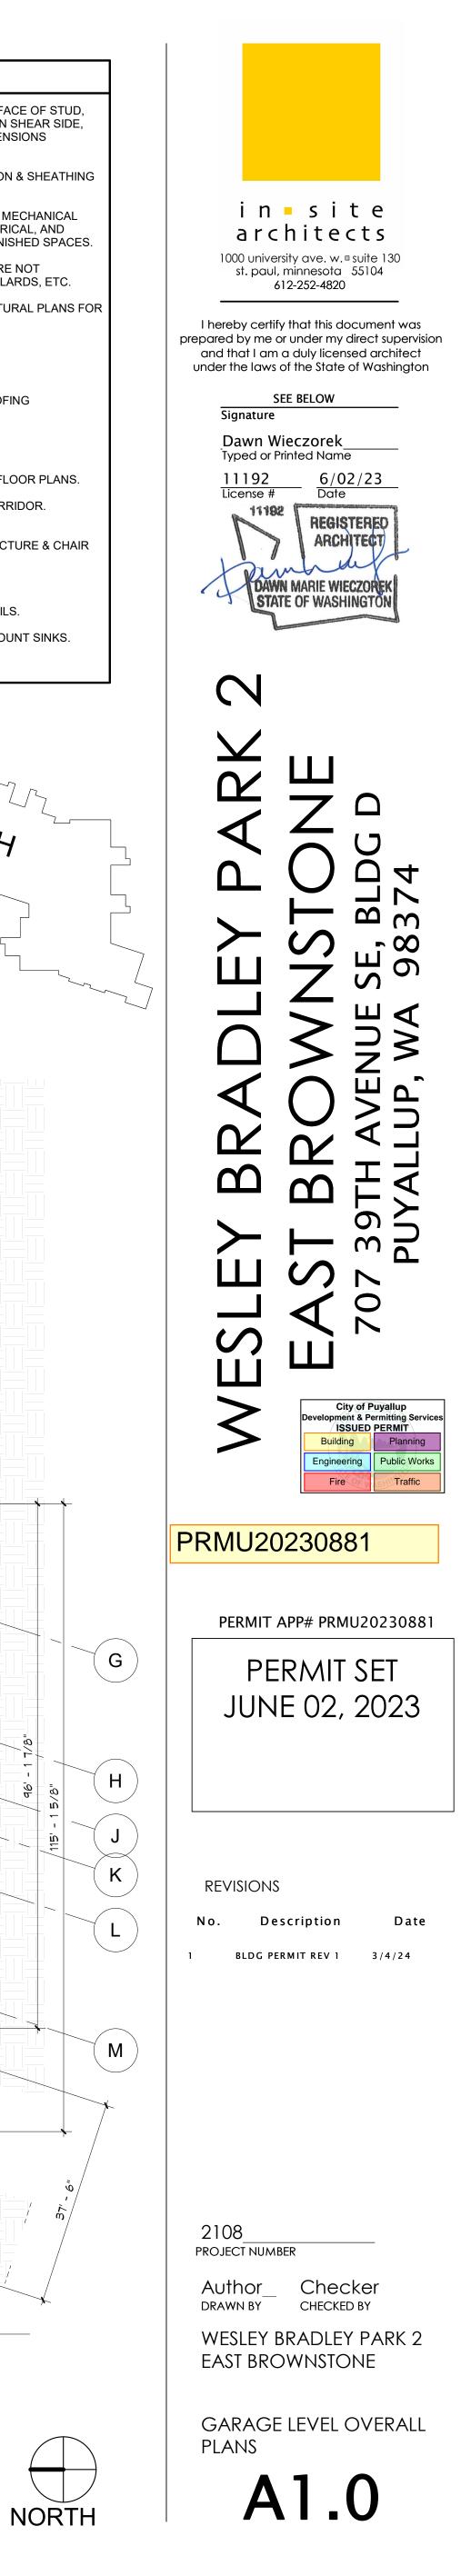


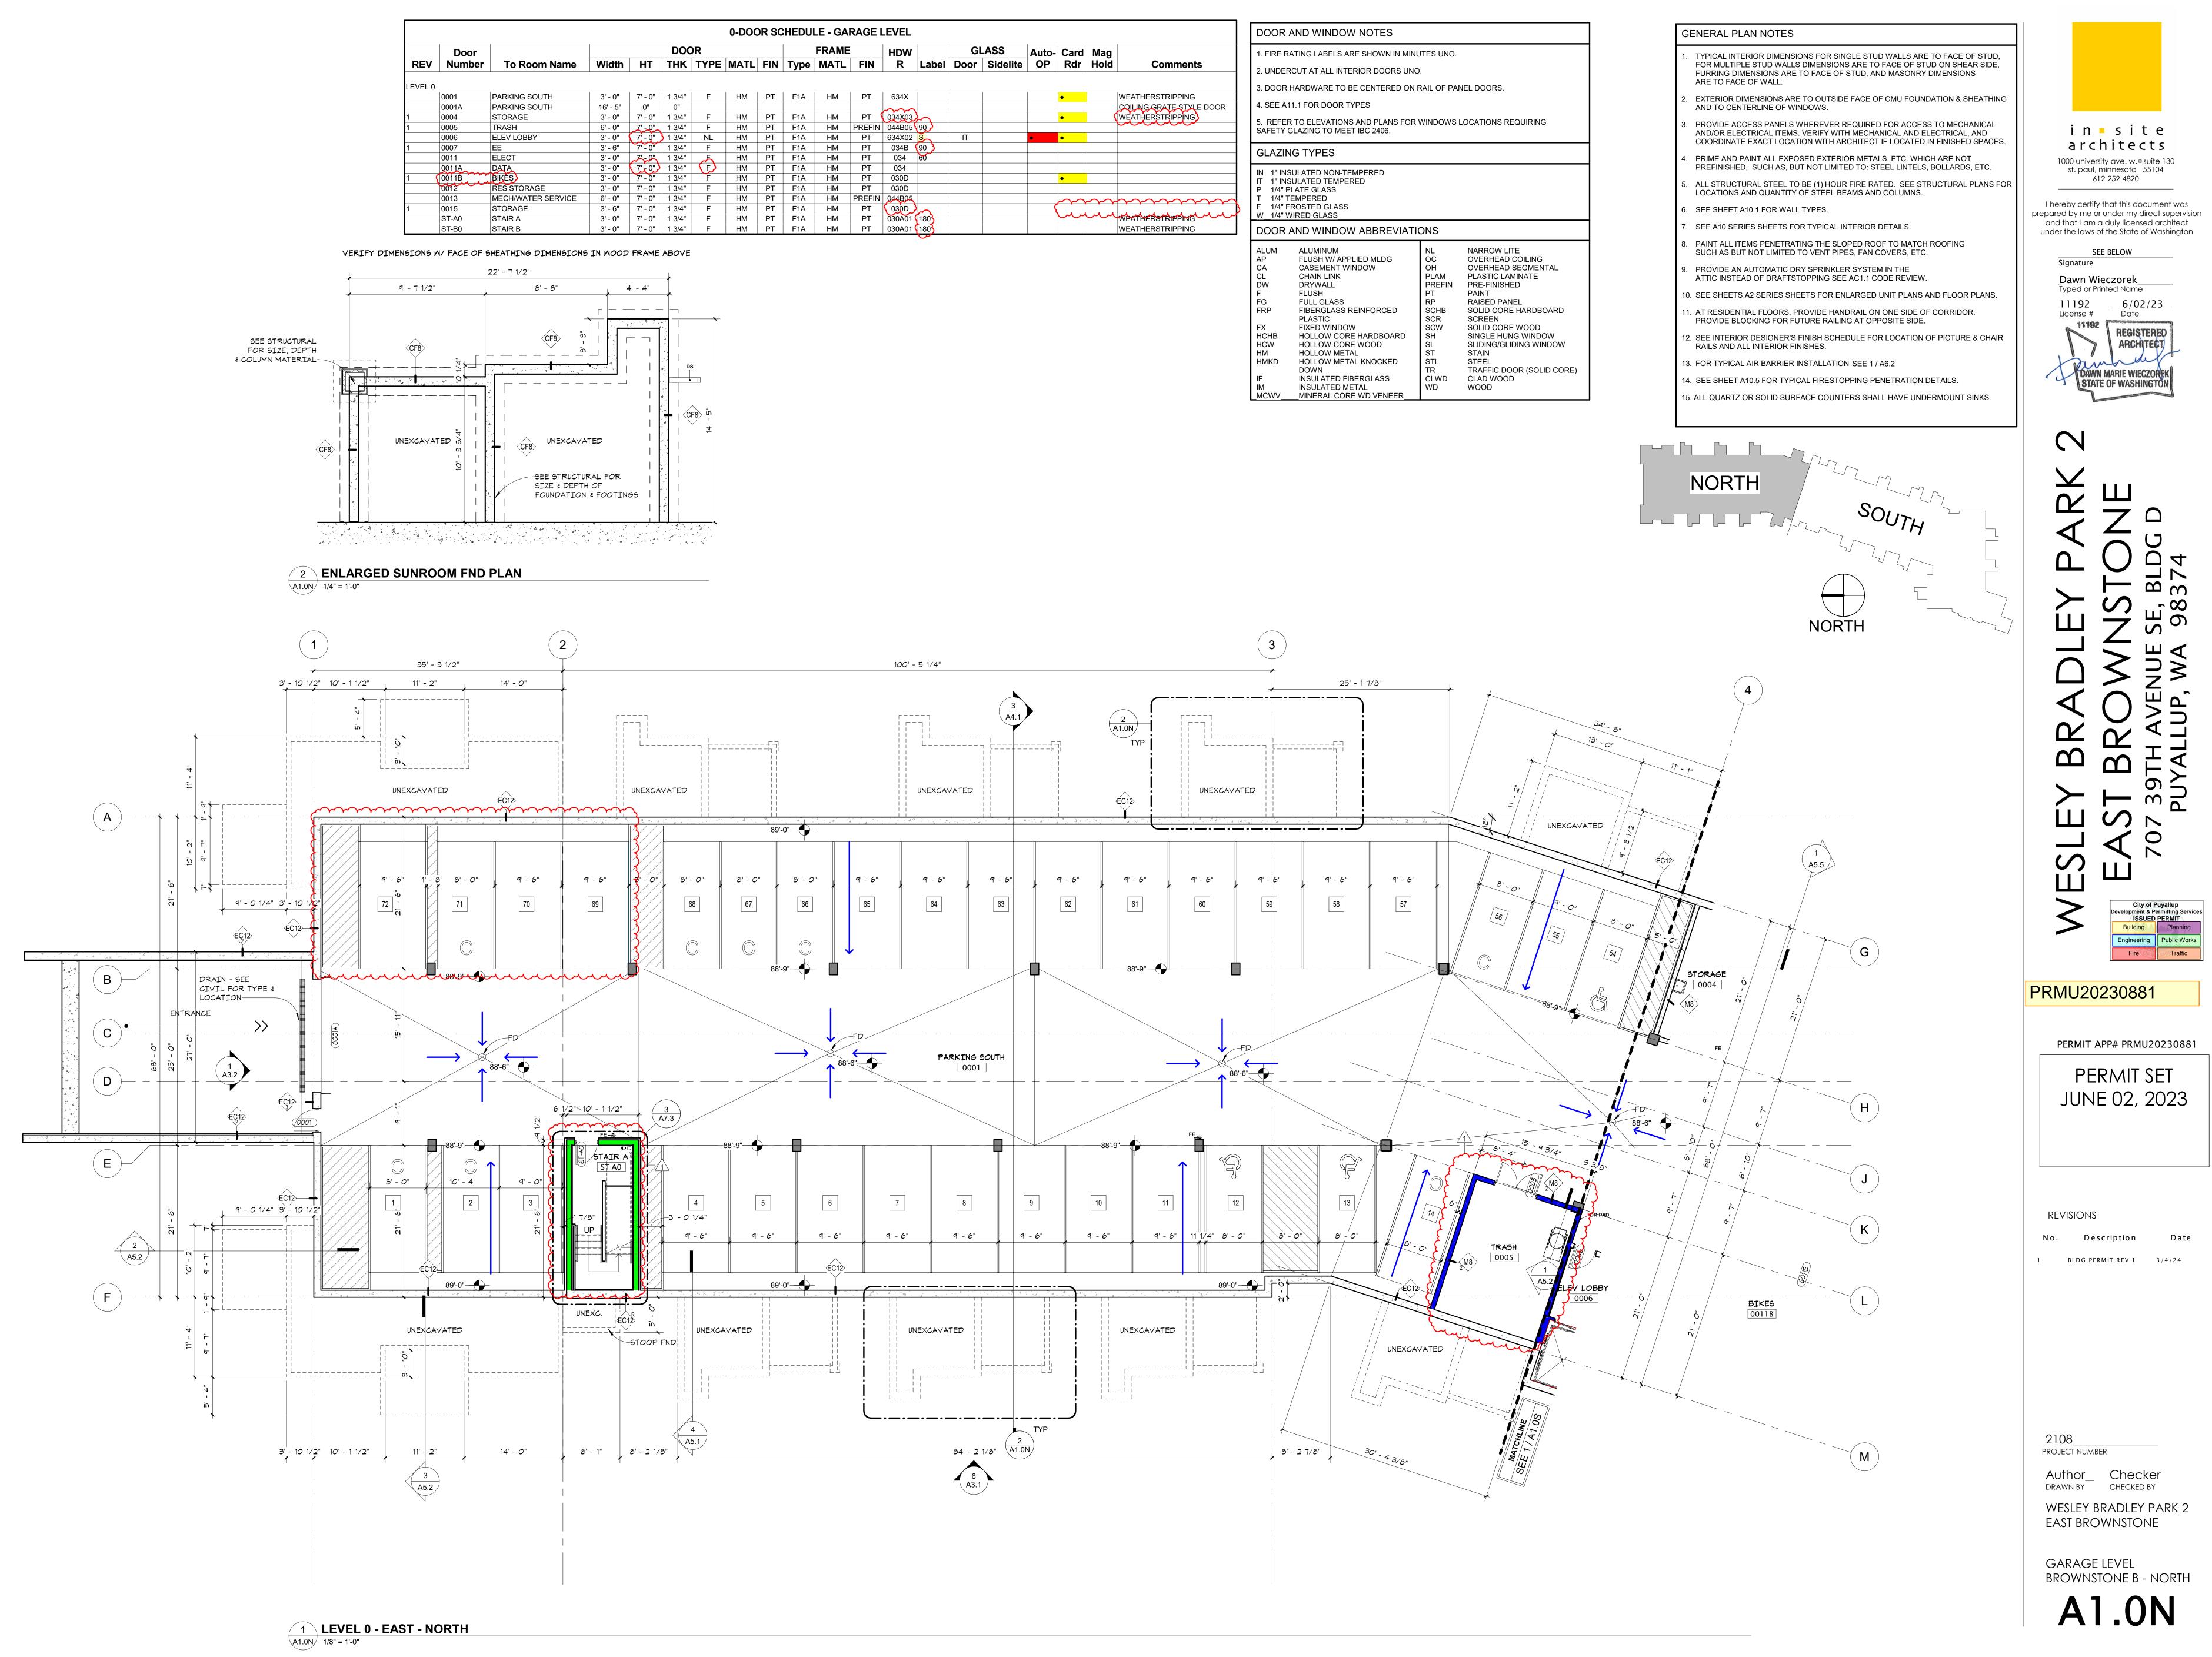



Name			DOC)R				FRAME		HDW		Gl	GLASS		Card	Mag	
	Width	HT	THK	TYPE	MATL	FIN	Туре	MATL	FIN	R	Label	Door	Sidelite	OP	Rdr	Hold	Comments
	3' - 0"	7' - 0"	1 3/4"	F	HM	PT	F1A	HM	PT	634X					•		WEATHERSTRIPPING
	16' - 5"	0"	0"							\sim							COILING GRATE STYLE DOOF
	3' - 0"	7' - 0"	1 3/4"	F	HM	PT	F1A	HM	PT 🤇	034X03	\sim				•	(WEATHERSTRIPPING
	6' - 0"	<u> </u>	1 3/4"	F	HM	PT	F1A	HM	PREFIN	044B05							
	3' - 0"	7' - 0"	1 3/4"	NL	HM	PT	F1A	HM	PT	634X02	S	IT		•	•		
	3' - 6"	7' - 0"	1 3/4"	F	HM	PT	F1A	HM	PT	034B	90						
	3' - 0"	<u> </u>	1 3/4"	Æ	HM	PT	F1A	HM	PT	034	60						
	3' - 0"	7', 0"	1 3/4"	(F)	HM	PT	F1A	HM	PT	034							
	3' - 0"	7' - 0"	1 3/4"	F	HM	PT	F1A	HM	PT	030D					•		
	3' - 0"	7' - 0"	1 3/4"	F	HM	PT	F1A	HM	PT	030D							
VICE	6' - 0"	7' - 0"	1 3/4"	F	HM	PT	F1A	HM	PREFIN	044B05					\sim	\sim	
	3' - 6"	7' - 0"	1 3/4"	F	HM	PT	F1A	HM	PT	030D	\sim						
	3' - 0"	7' - 0"	1 3/4"	F	HM	PT	F1A	HM	PT	030A01	(180)				<u>u</u>	m	WEATHERSTRIPPING
	3' - 0"	7' - 0"	1 3/4"	F	HM	PT	F1A	HM	PT	030A01	180						WEATHERSTRIPPING

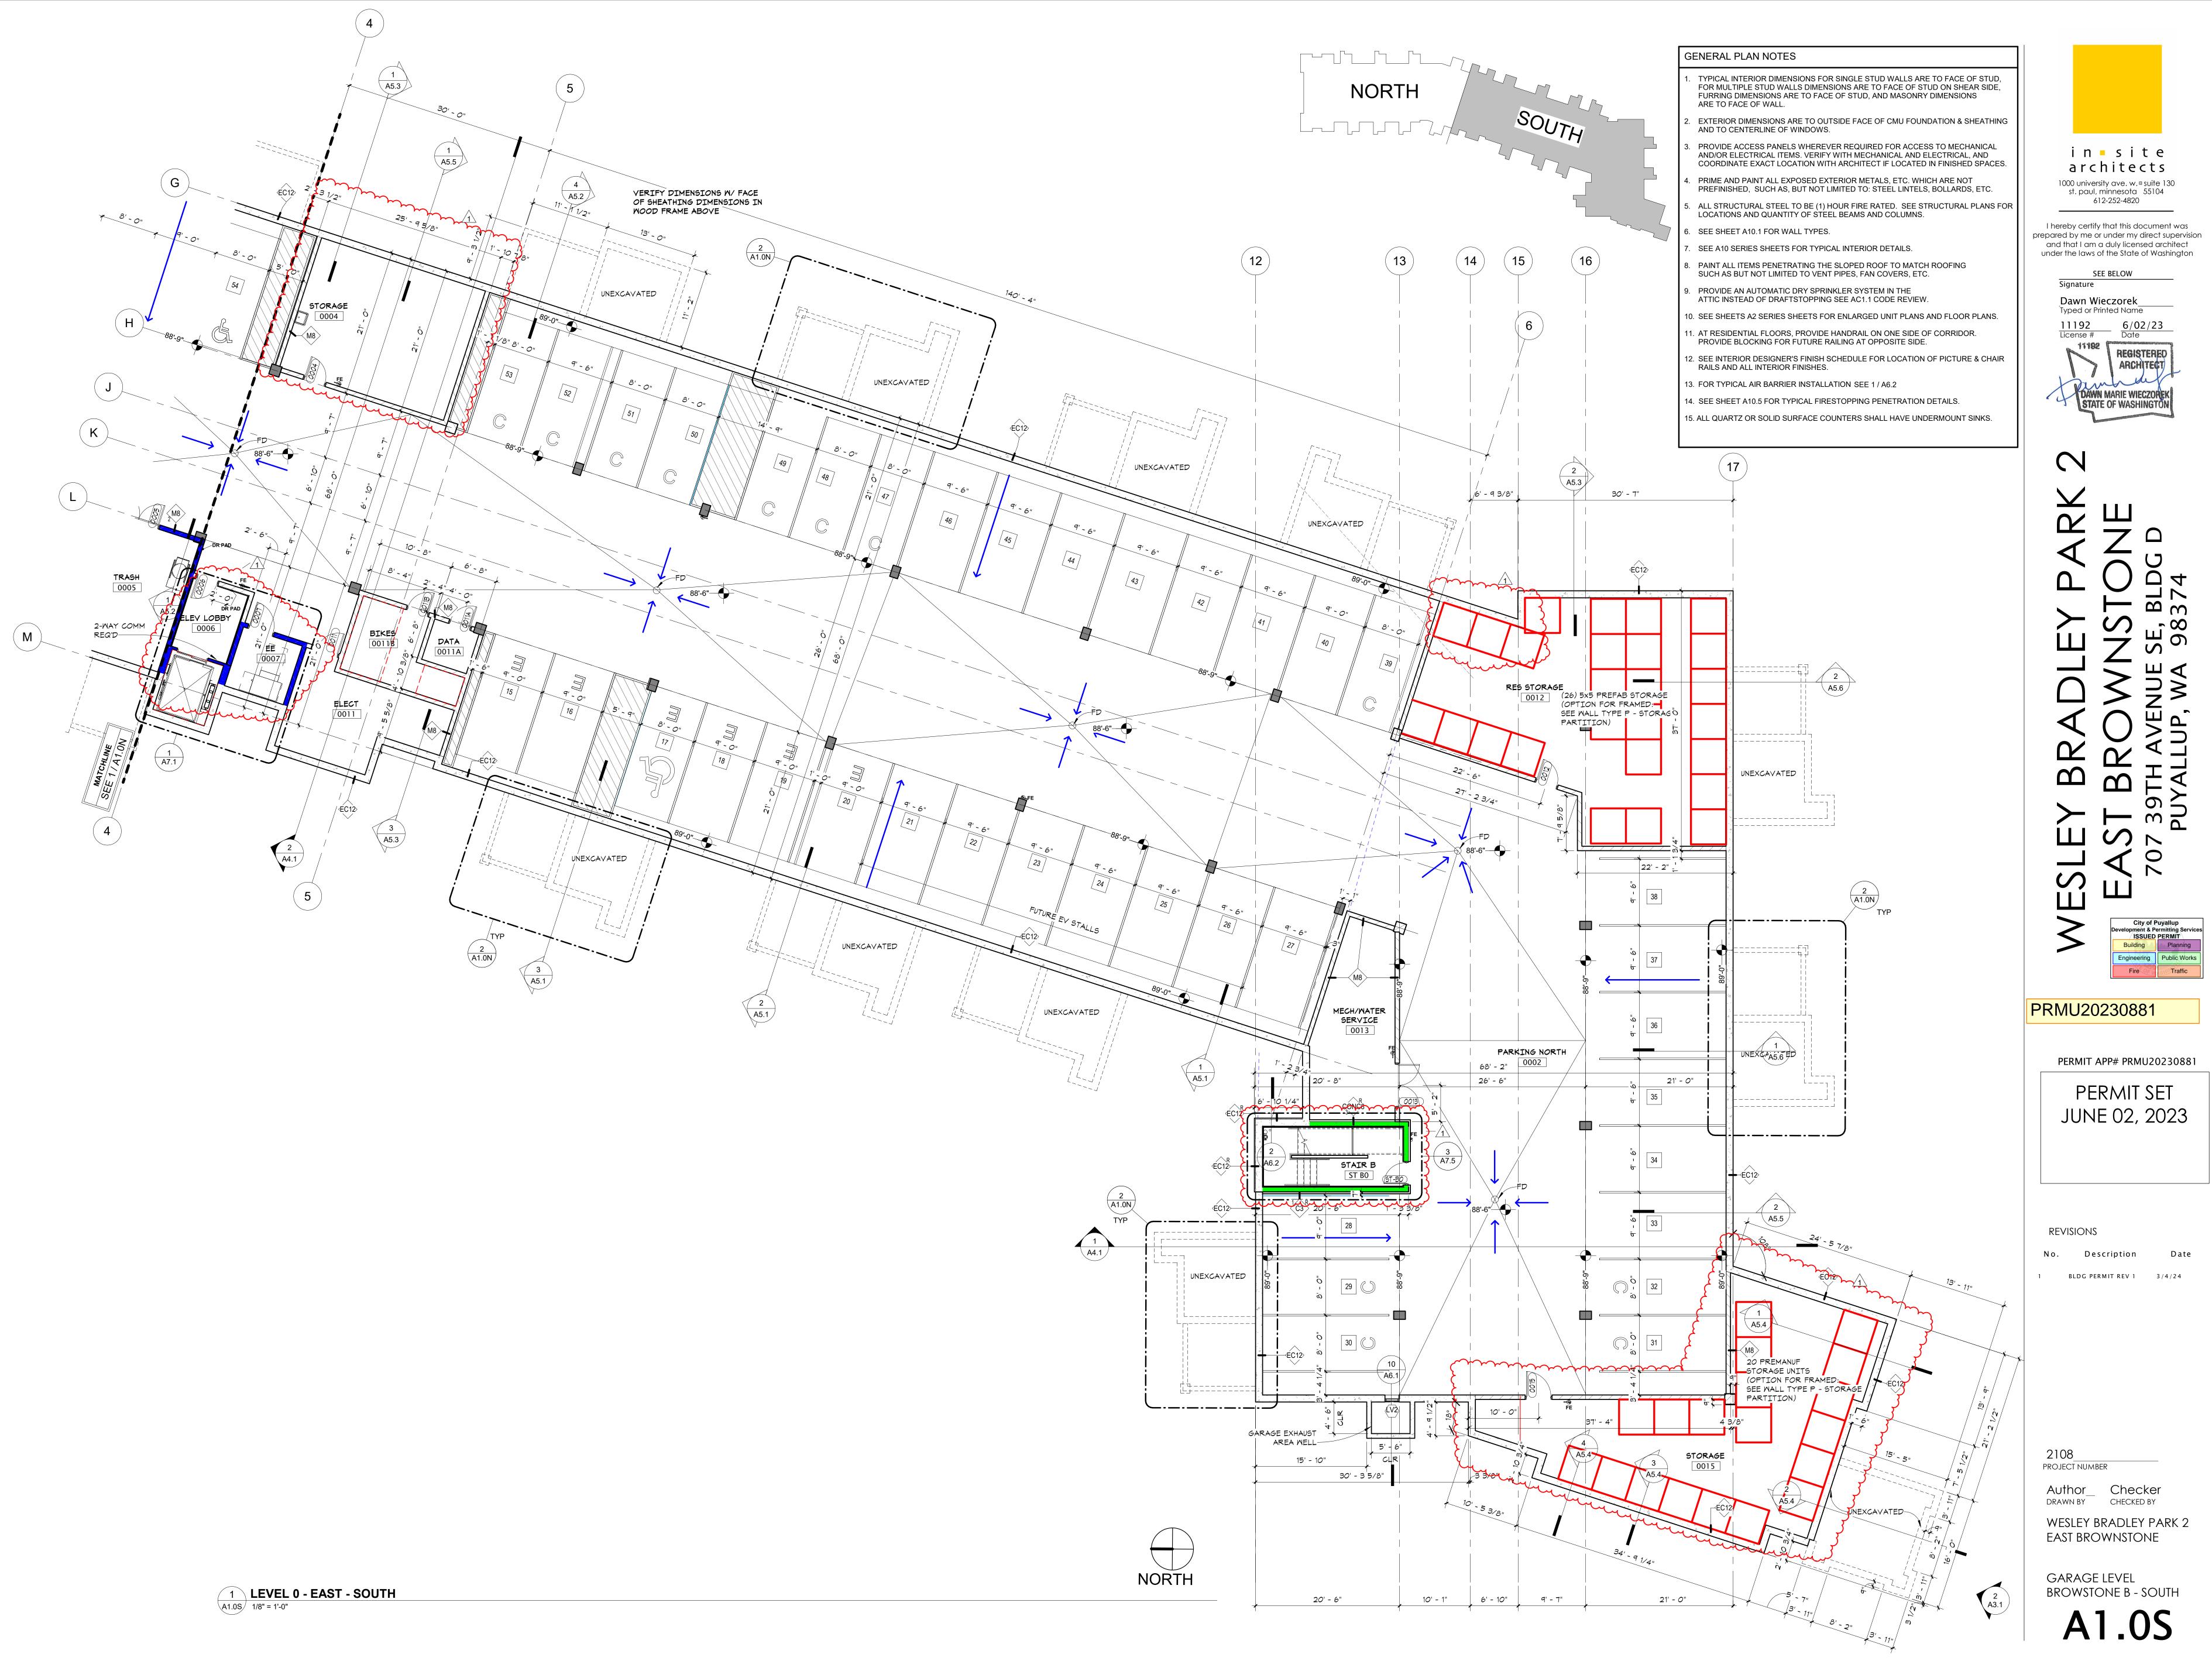




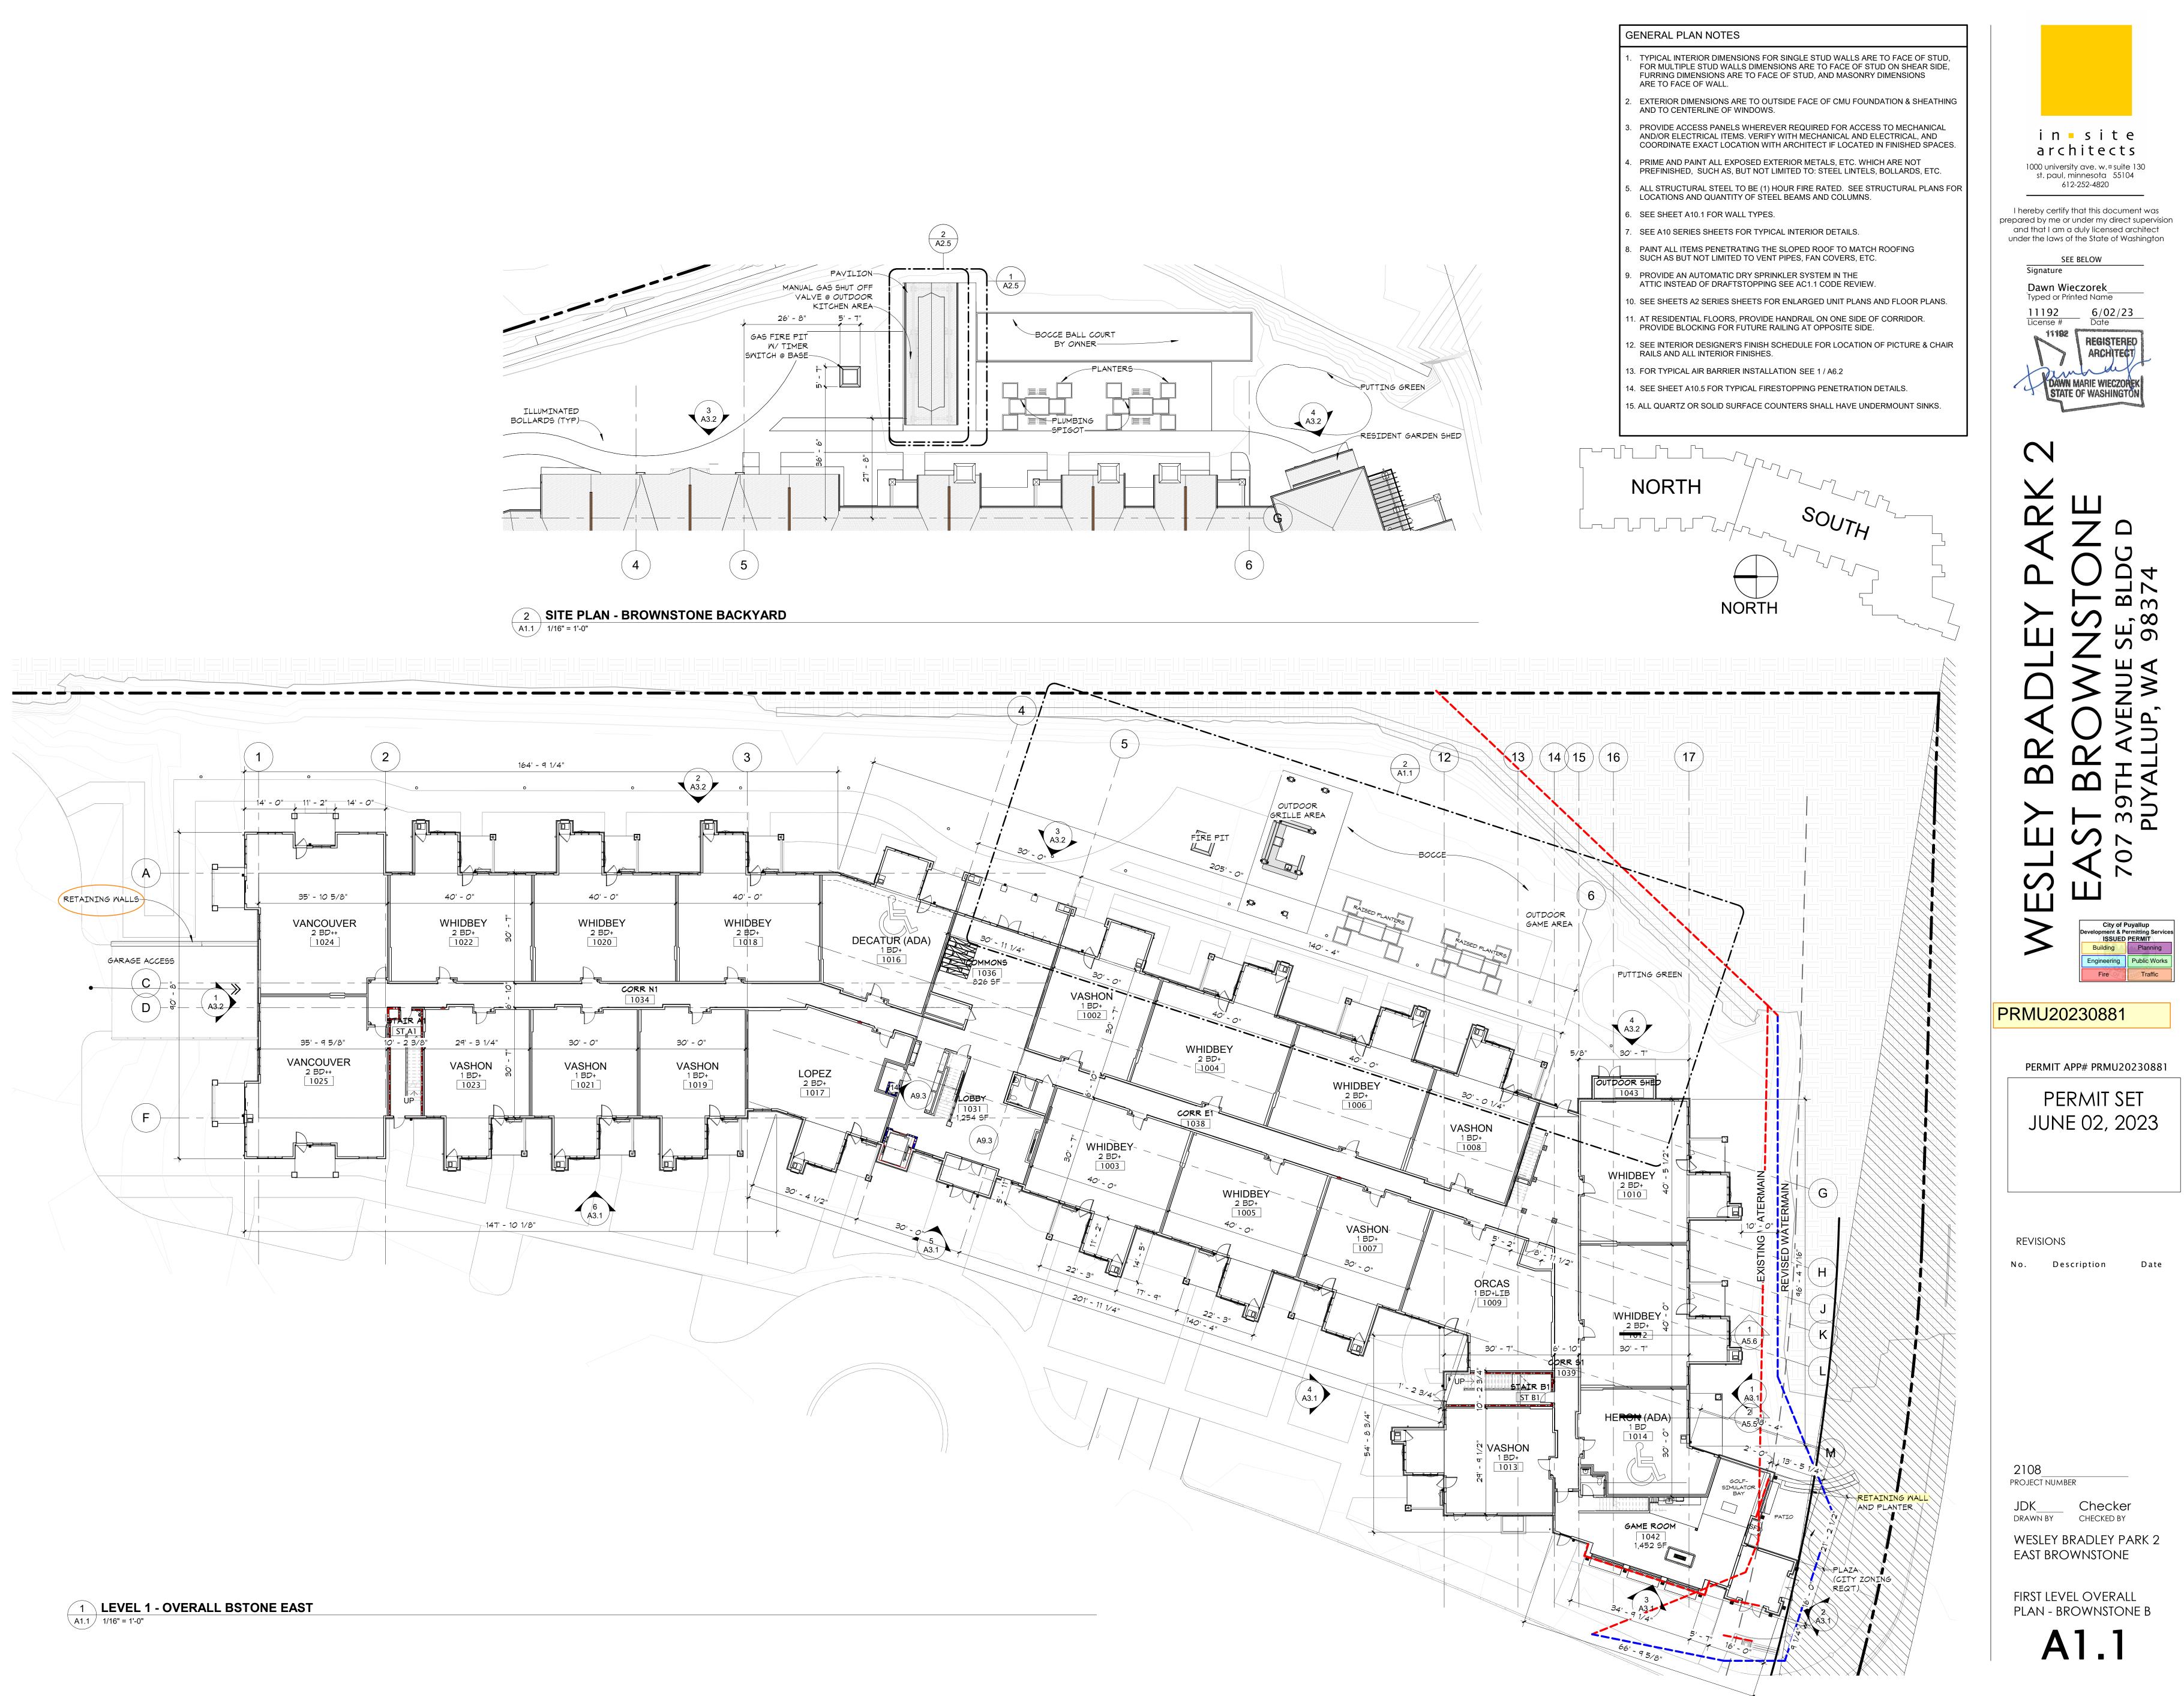

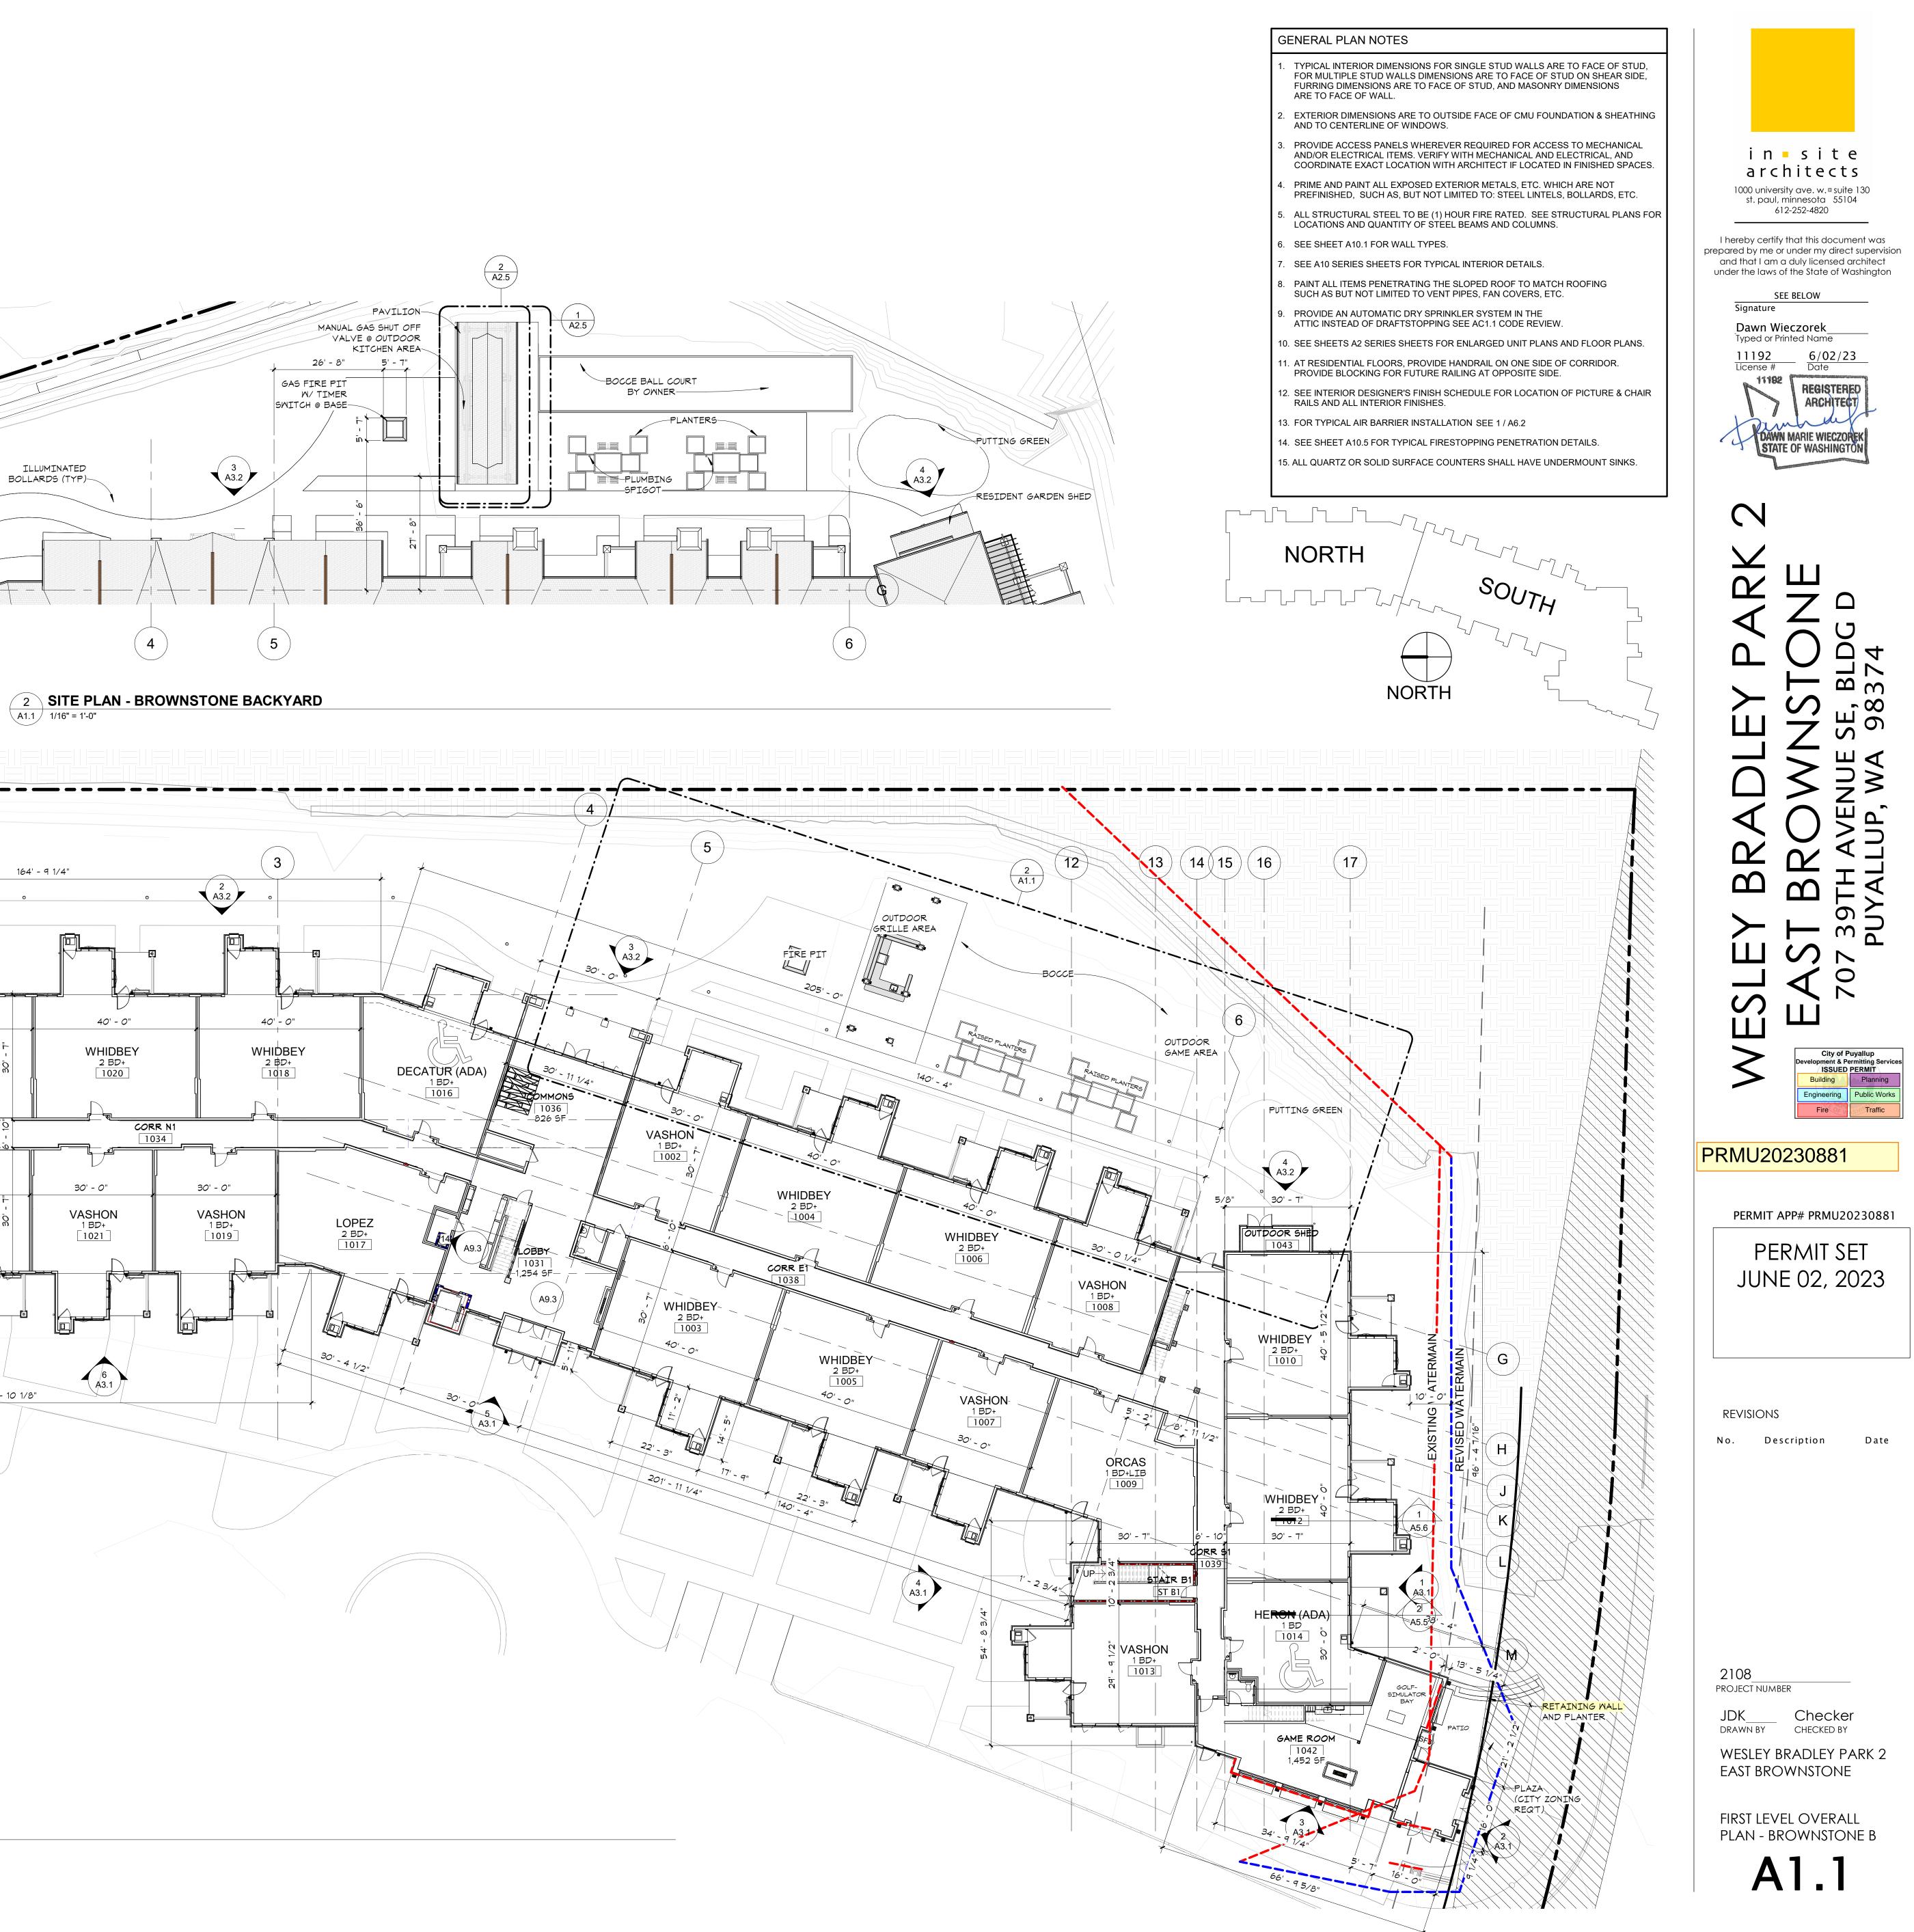


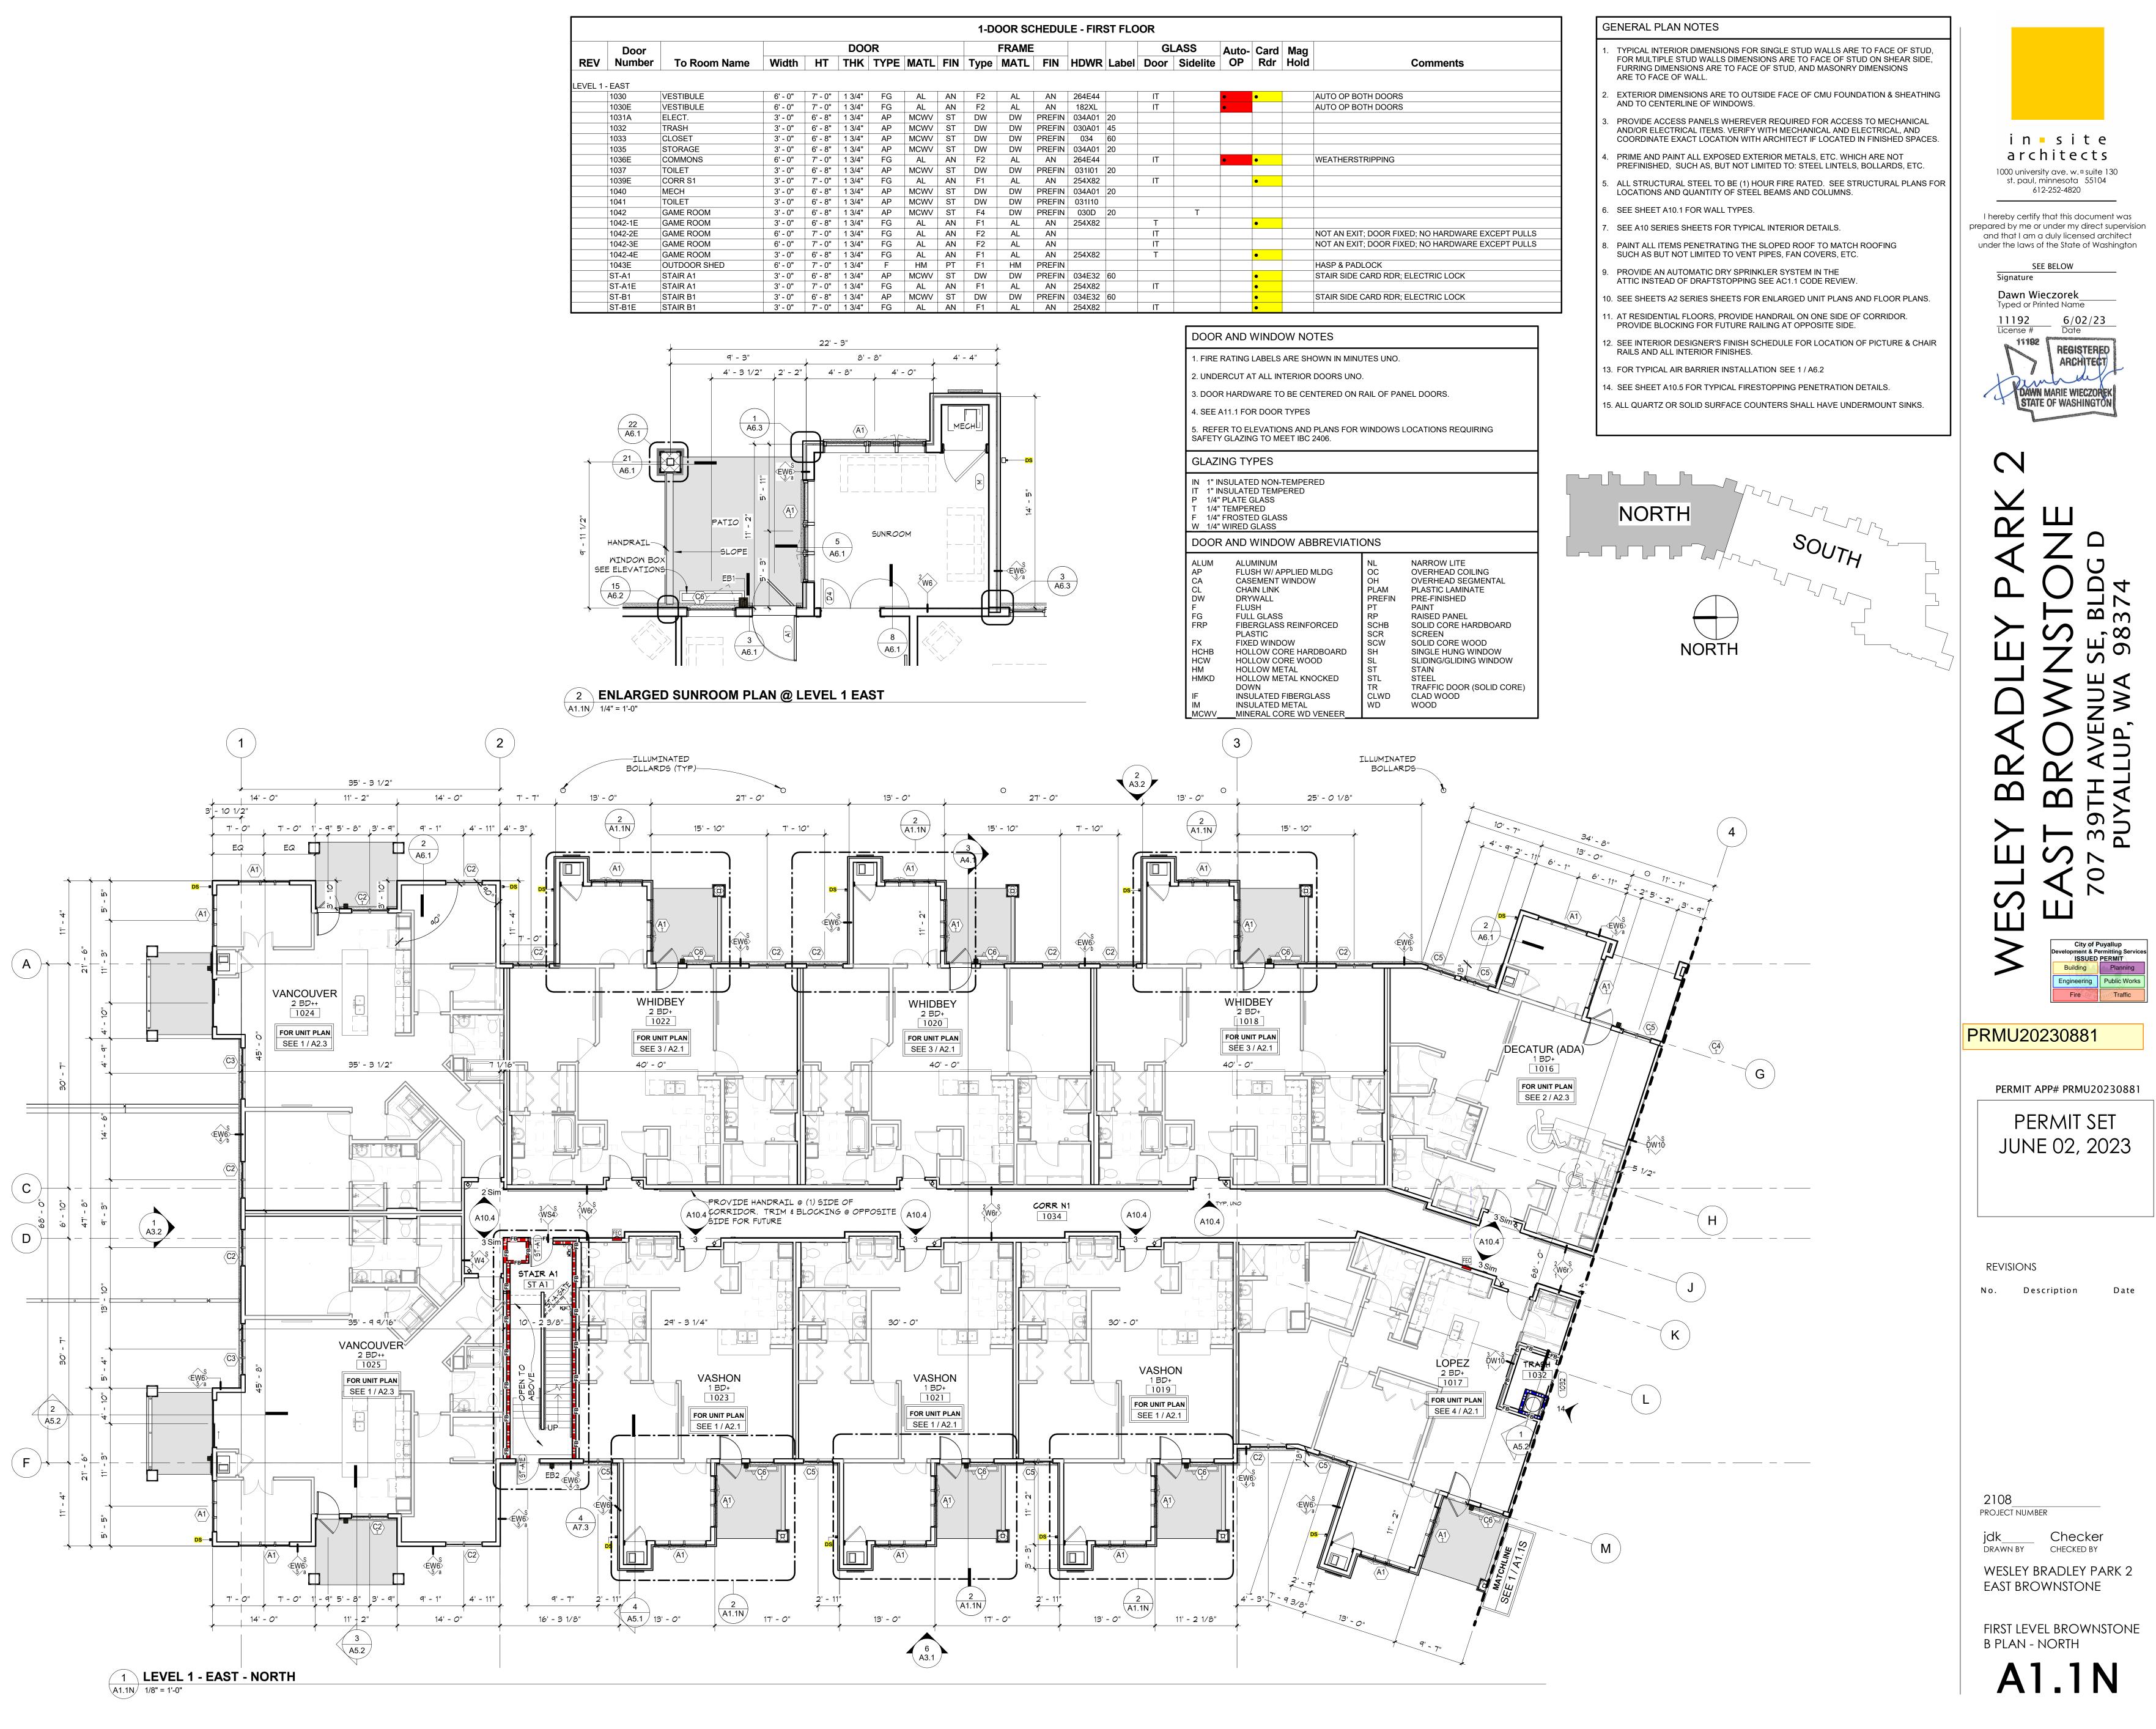


									1-D	OOR SC	HEDUL	E - FIR	ST FLO	OR	
	Door				DOC)R				FRAME				GL	
REV	Number	To Room Name	Width	HT	THK	TYPE	MATL	FIN	Туре	MATL	FIN	HDWR	Label	Door	
EVEL 1	- EAST														
	1030	VESTIBULE	6' - 0"	7' - 0"	1 3/4"	FG	AL	AN	F2	AL	AN	264E44		IT	•
	1030E	VESTIBULE	6' - 0"	7' - 0"	1 3/4"	FG	AL	AN	F2	AL	AN	182XL		IT	
	1031A	ELECT.	3' - 0"	6' - 8"	1 3/4"	AP	MCWV	ST	DW	DW	PREFIN	034A01	20		
	1032	TRASH	3' - 0"	6' - 8"	1 3/4"	AP	MCWV	ST	DW	DW	PREFIN	030A01	45		
	1033	CLOSET	3' - 0"	6' - 8"	1 3/4"	AP	MCWV	ST	DW	DW	PREFIN	034	60		
	1035	STORAGE	3' - 0"	6' - 8"	1 3/4"	AP	MCWV	ST	DW	DW	PREFIN	034A01	20		
	1036E	COMMONS	6' - 0"	7' - 0"	1 3/4"	FG	AL	AN	F2	AL	AN	264E44		IT	
	1037	TOILET	3' - 0"	6' - 8"	1 3/4"	AP	MCWV	ST	DW	DW	PREFIN	031101	20		
	1039E	CORR S1	3' - 0"	7' - 0"	1 3/4"	FG	AL	AN	F1	AL	AN	254X82		IT	
	1040	MECH	3' - 0"	6' - 8"	1 3/4"	AP	MCWV	ST	DW	DW	PREFIN	034A01	20		
	1041	TOILET	3' - 0"	6' - 8"	1 3/4"	AP	MCWV	ST	DW	DW	PREFIN	031110			
	1042	GAME ROOM	3' - 0"	6' - 8"	1 3/4"	AP	MCWV	ST	F4	DW	PREFIN	030D	20		
	1042-1E	GAME ROOM	3' - 0"	6' - 8"	1 3/4"	FG	AL	AN	F1	AL	AN	254X82		Т	
	1042-2E	GAME ROOM	6' - 0"	7' - 0"	1 3/4"	FG	AL	AN	F2	AL	AN			IT	
	1042-3E	GAME ROOM	6' - 0"	7' - 0"	1 3/4"	FG	AL	AN	F2	AL	AN			IT	
	1042-4E	GAME ROOM	3' - 0"	6' - 8"	1 3/4"	FG	AL	AN	F1	AL	AN	254X82		Т	
	1043E	OUTDOOR SHED	6' - 0"	7' - 0"	1 3/4"	F	HM	PT	F1	HM	PREFIN				
	ST-A1	STAIR A1	3' - 0"	6' - 8"	1 3/4"	AP	MCWV	ST	DW	DW	PREFIN	034E32	60		
	ST-A1E	STAIR A1	3' - 0"	7' - 0"	1 3/4"	FG	AL	AN	F1	AL	AN	254X82		IT	
	ST-B1	STAIR B1	3' - 0"	6' - 8"	1 3/4"	AP	MCWV	ST	DW	DW	PREFIN	034E32	60		
	ST-B1E	STAIR B1	3' - 0"	7' - 0"	1 3/4"	FG	AL	AN	F1	AL	AN	254X82		IT	

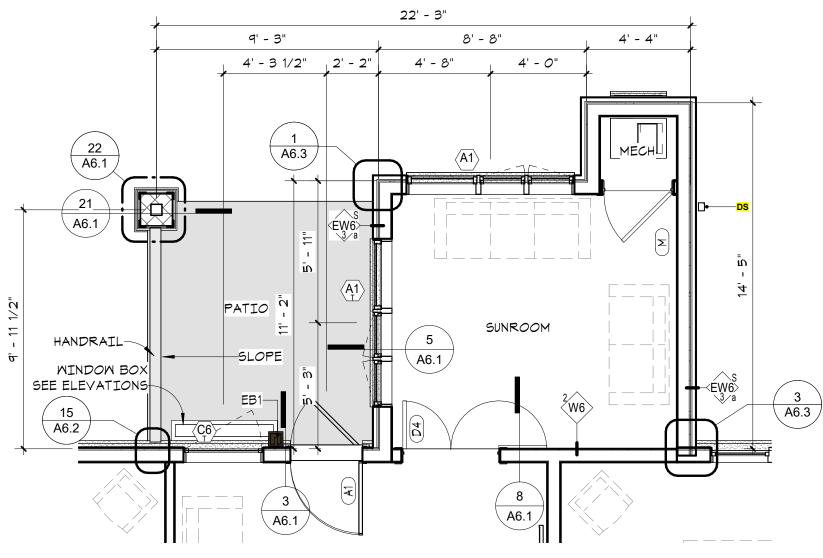



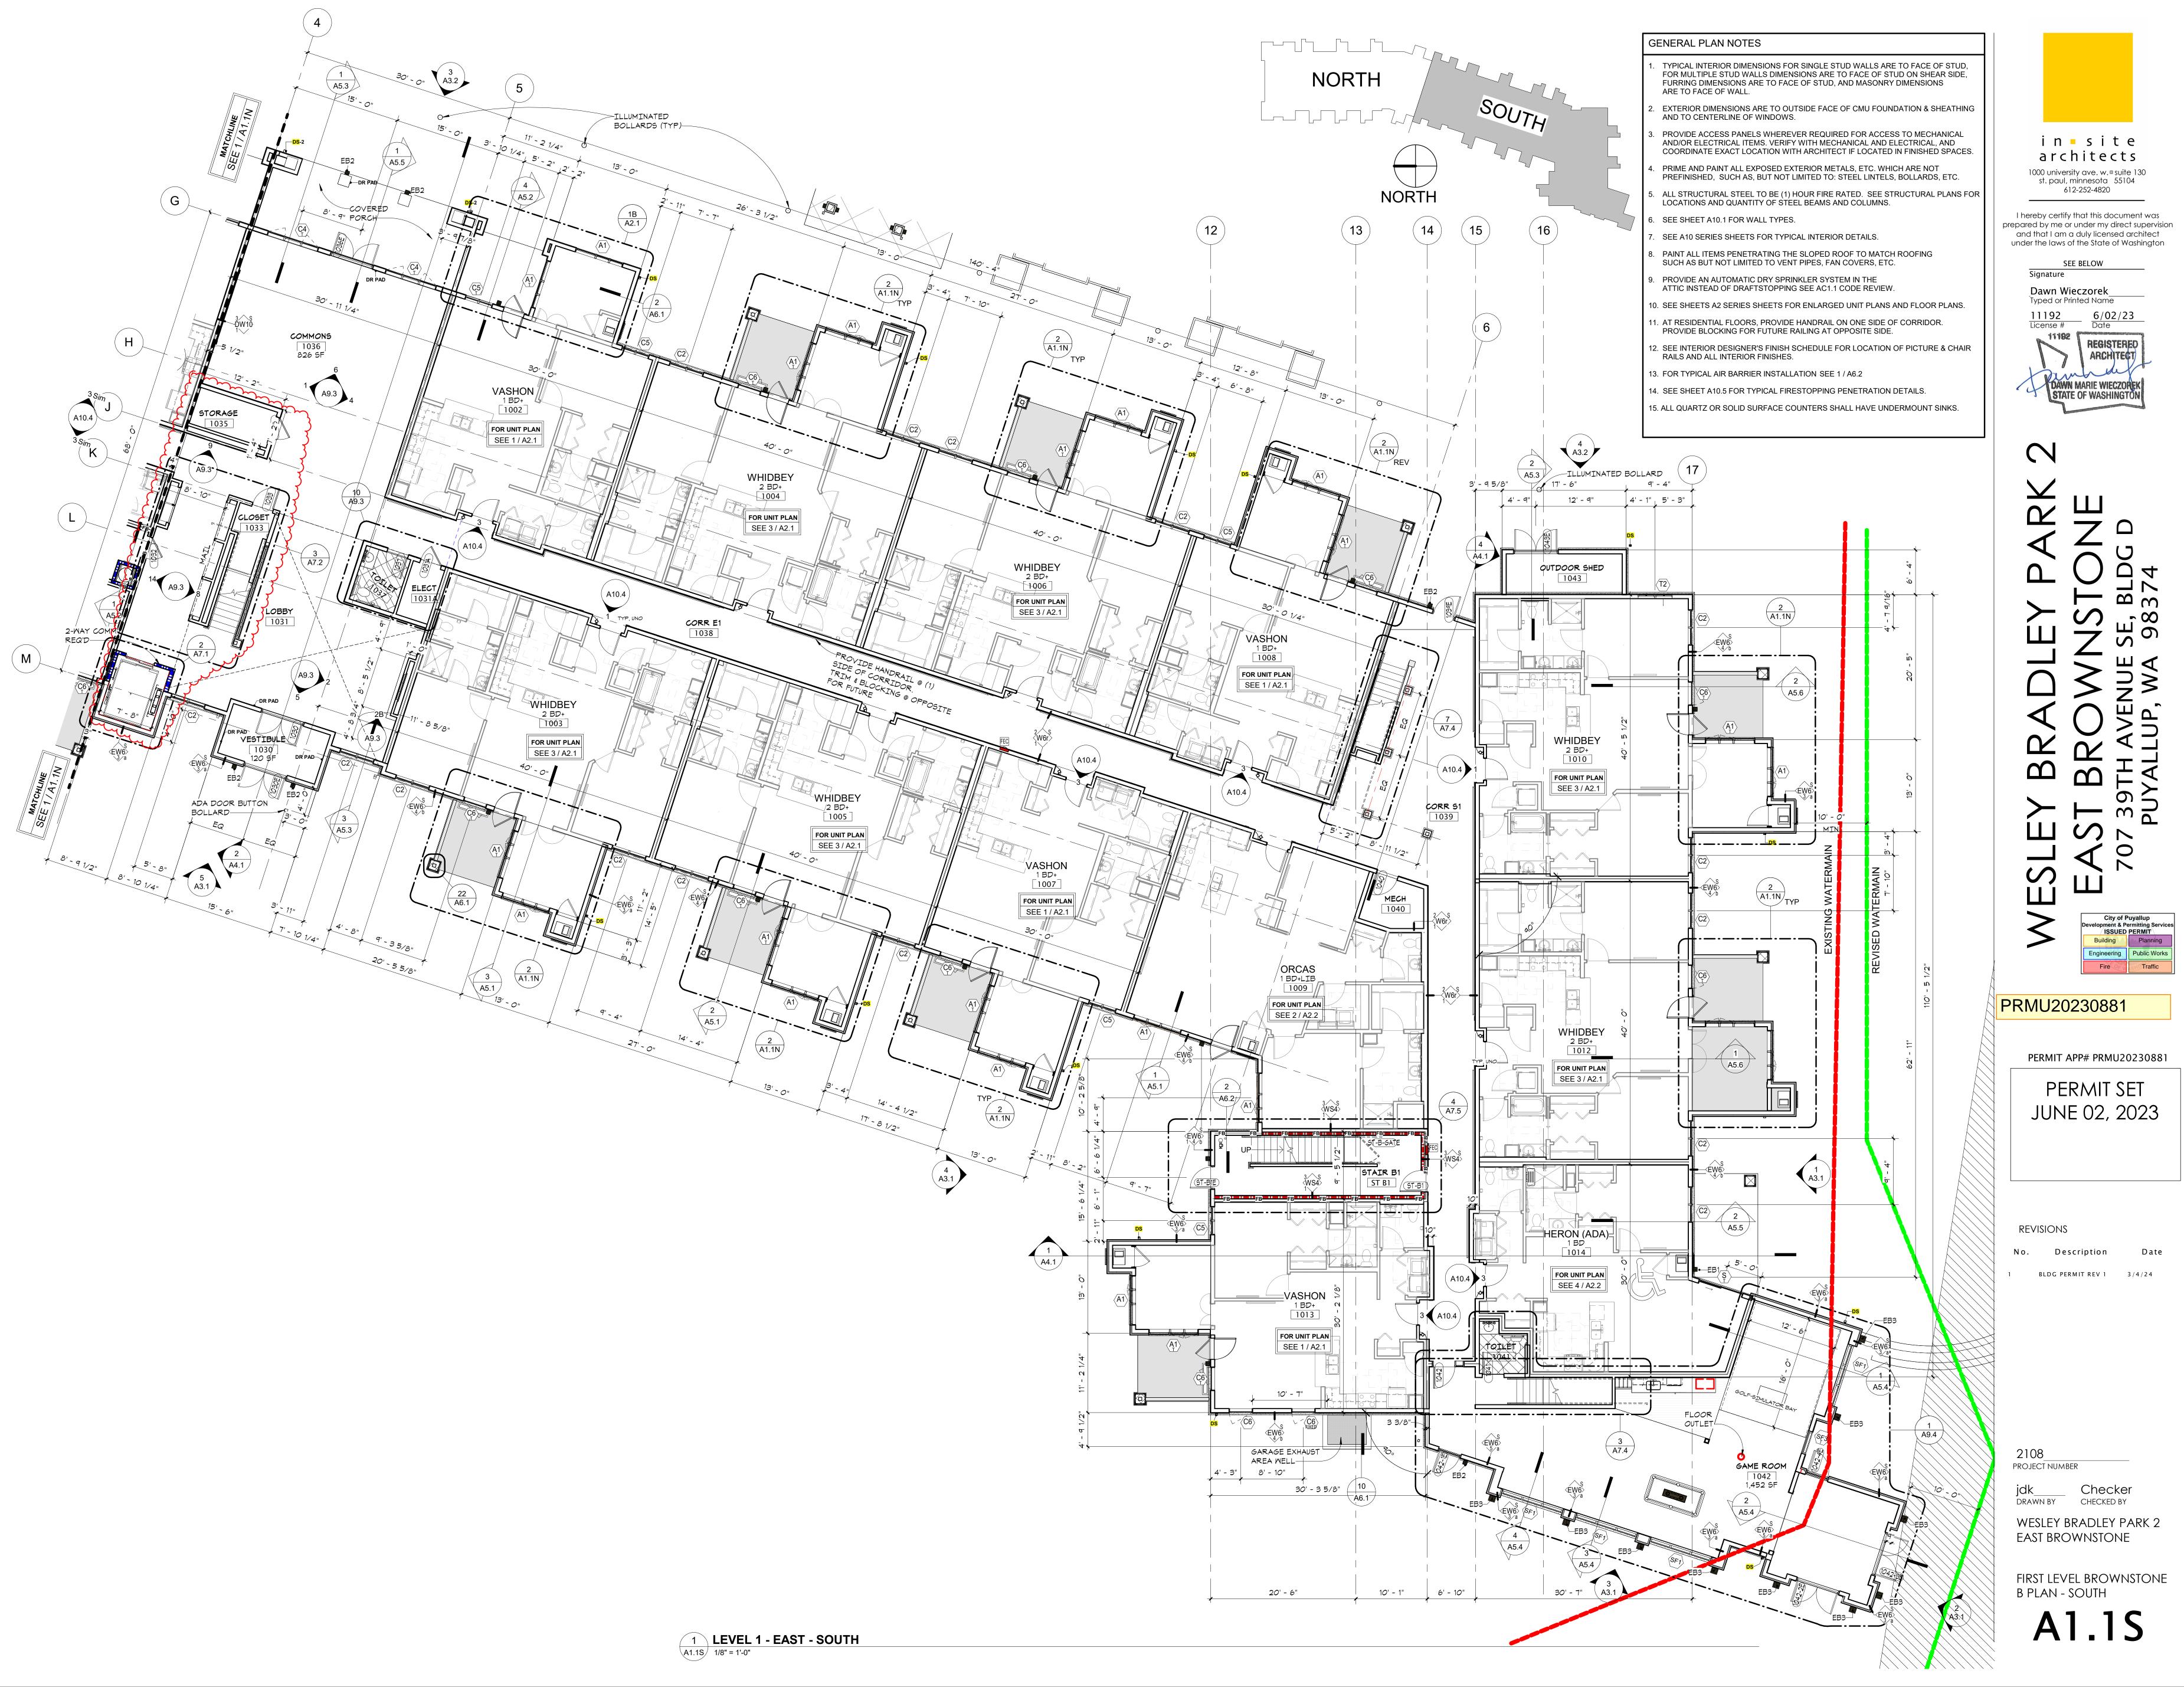

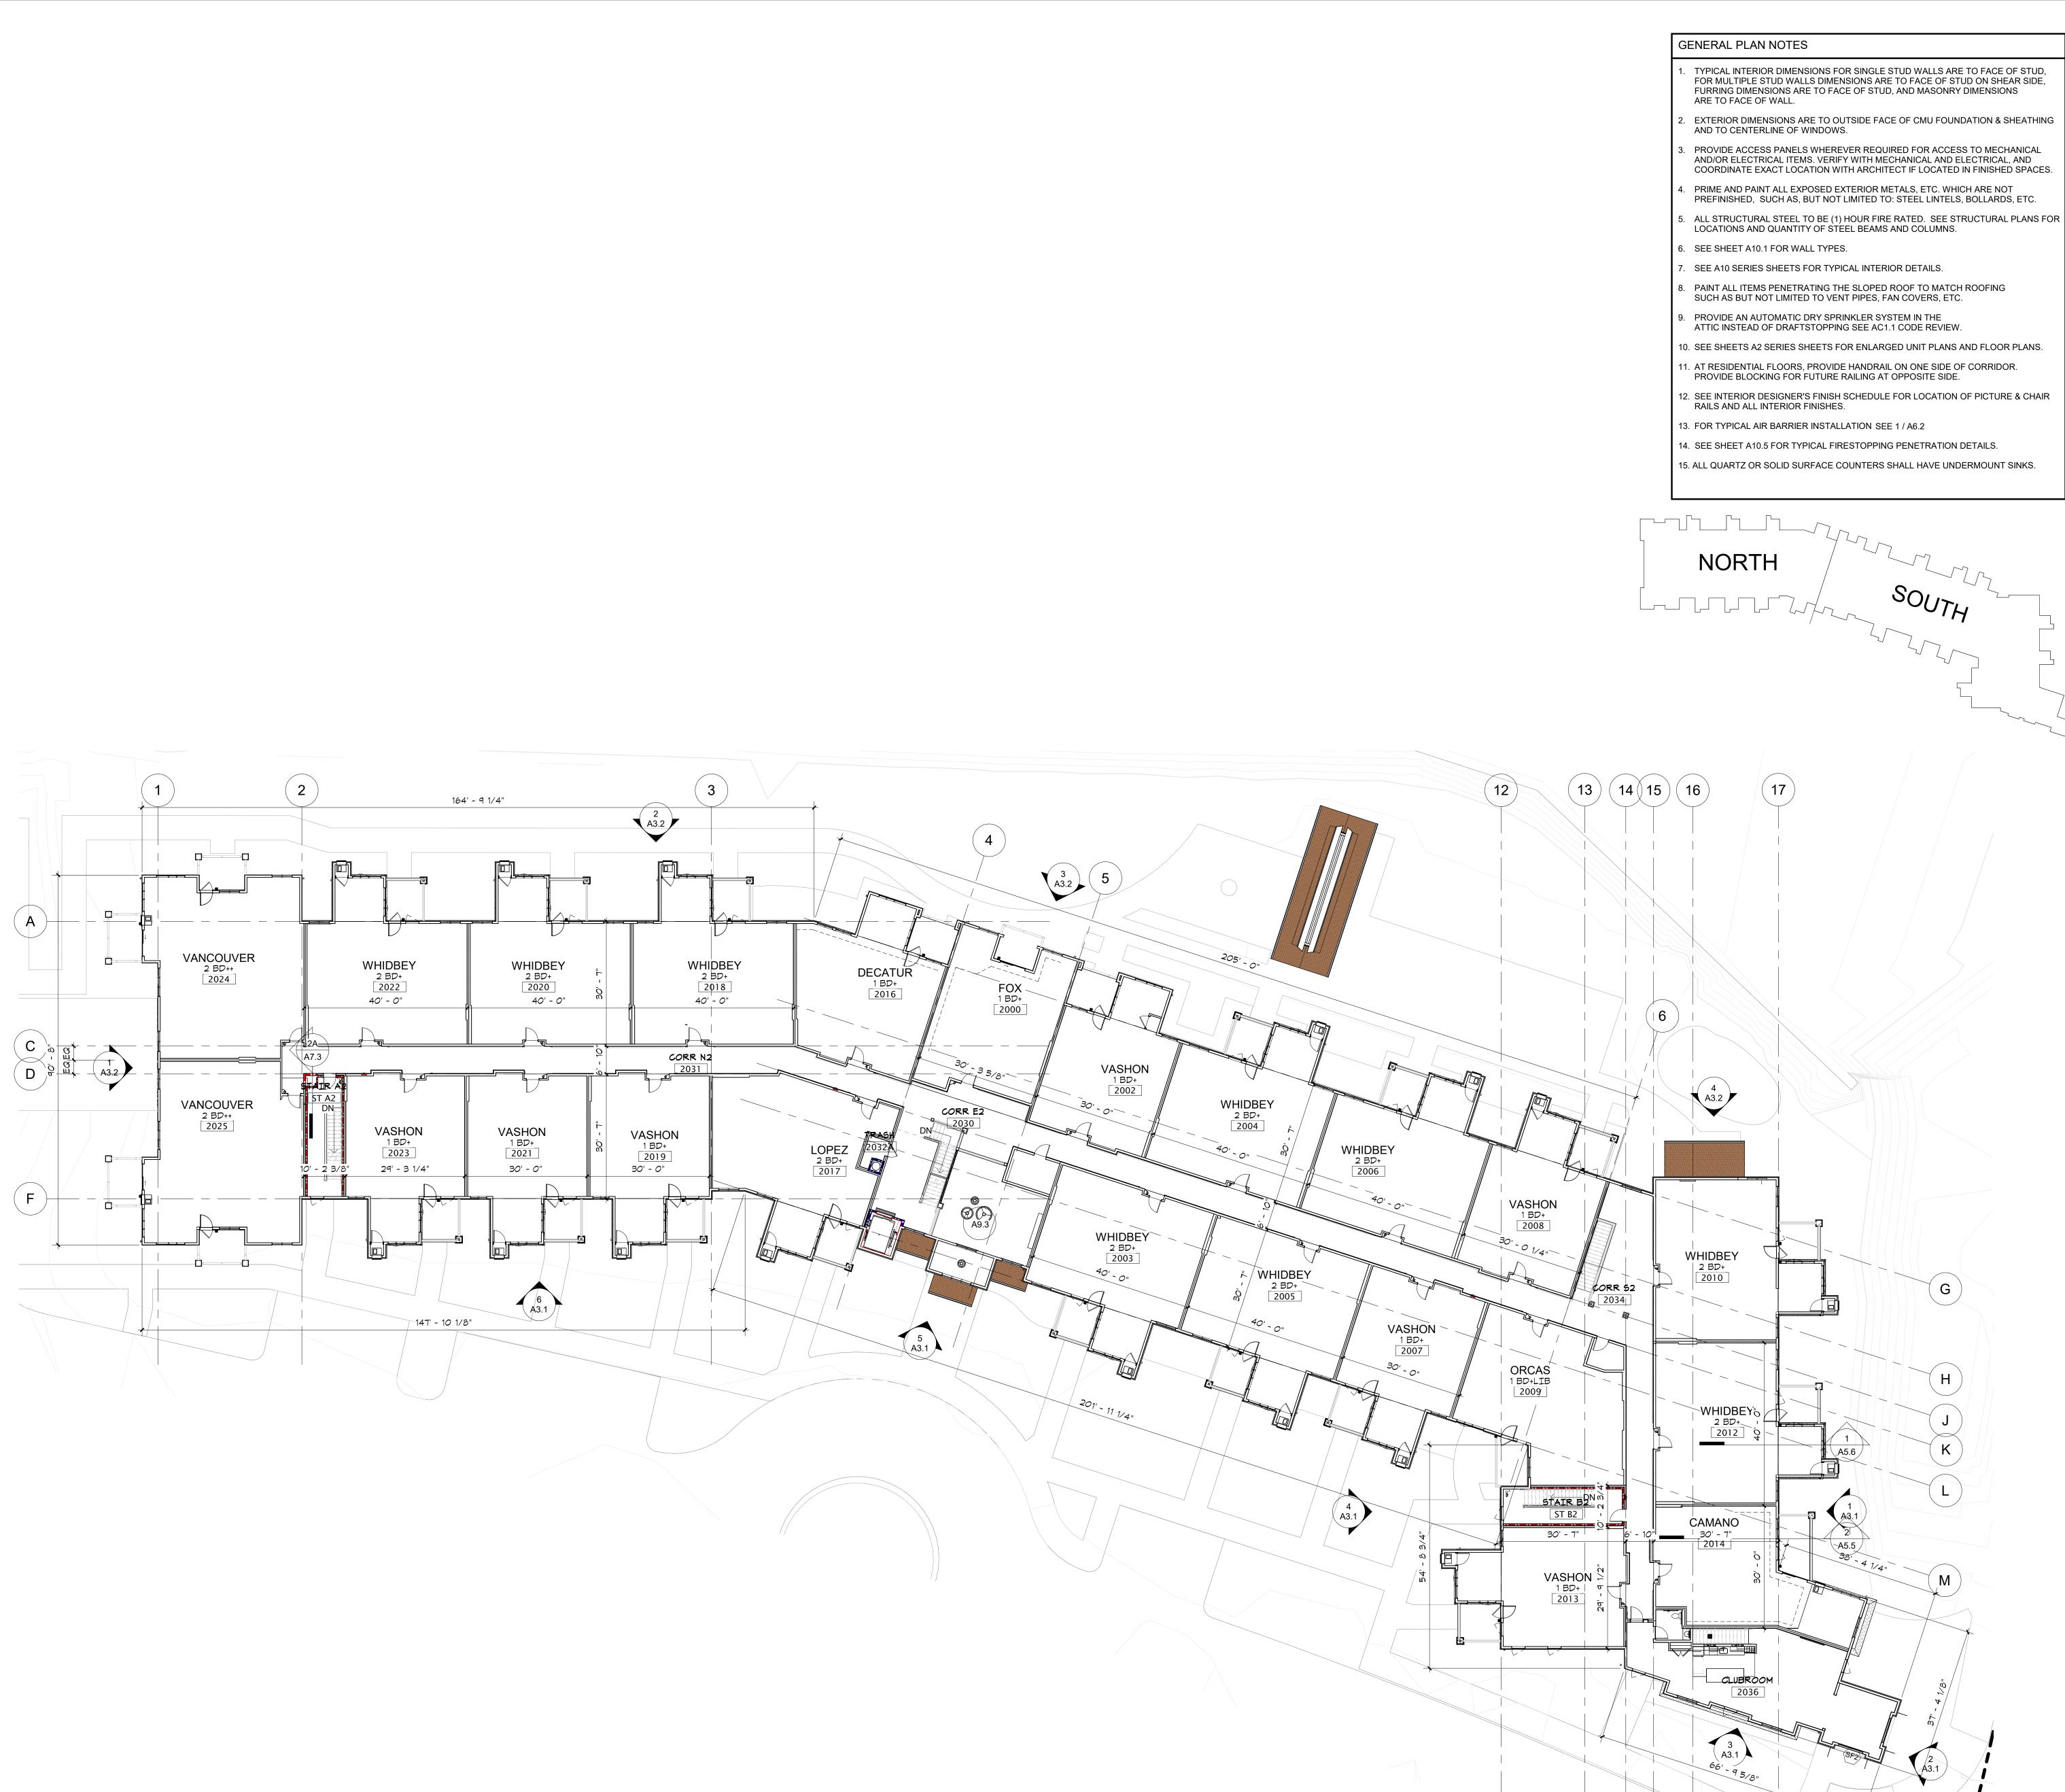


NORTH


in site architects 1000 university ave. w.∎suite 130 st. paul, minnesota 55104 612-252-4820 I hereby certify that this document was prepared by me or under my direct supervision and that I am a duly licensed architect under the laws of the State of Washington SEE BELOW Signature Dawn Wieczorek Typed or Printed Name 11192 6/02/23 License # Date 11192 REGISTEREC ARCHITECT N \Box 4 Ω m <u>, г</u> ОО ШŐ \square $\supset \geq$ z >UP UP $\mathbf{\mathcal{C}}$ Δ \mathbf{m} 39 PUN \mathcal{O} 0 \mathbf{N} Ш S City of Puyallup evelopment & Permitting Service: ISSUED PERMIT Building Planning
 Engineering
 Public Works

 Fire
 Traffic
 PRMU20230881 PERMIT APP# PRMU20230881 PERMIT SET JUNE 02, 2023 REVISIONS No. Description Date 2108 PROJECT NUMBER Checker CHECKED BY JDK_ DRAWN BY WESLEY BRADLEY PARK 2 EAST BROWNSTONE SECOND LEVEL OVERALL FLOOR PLANS A1.2

7

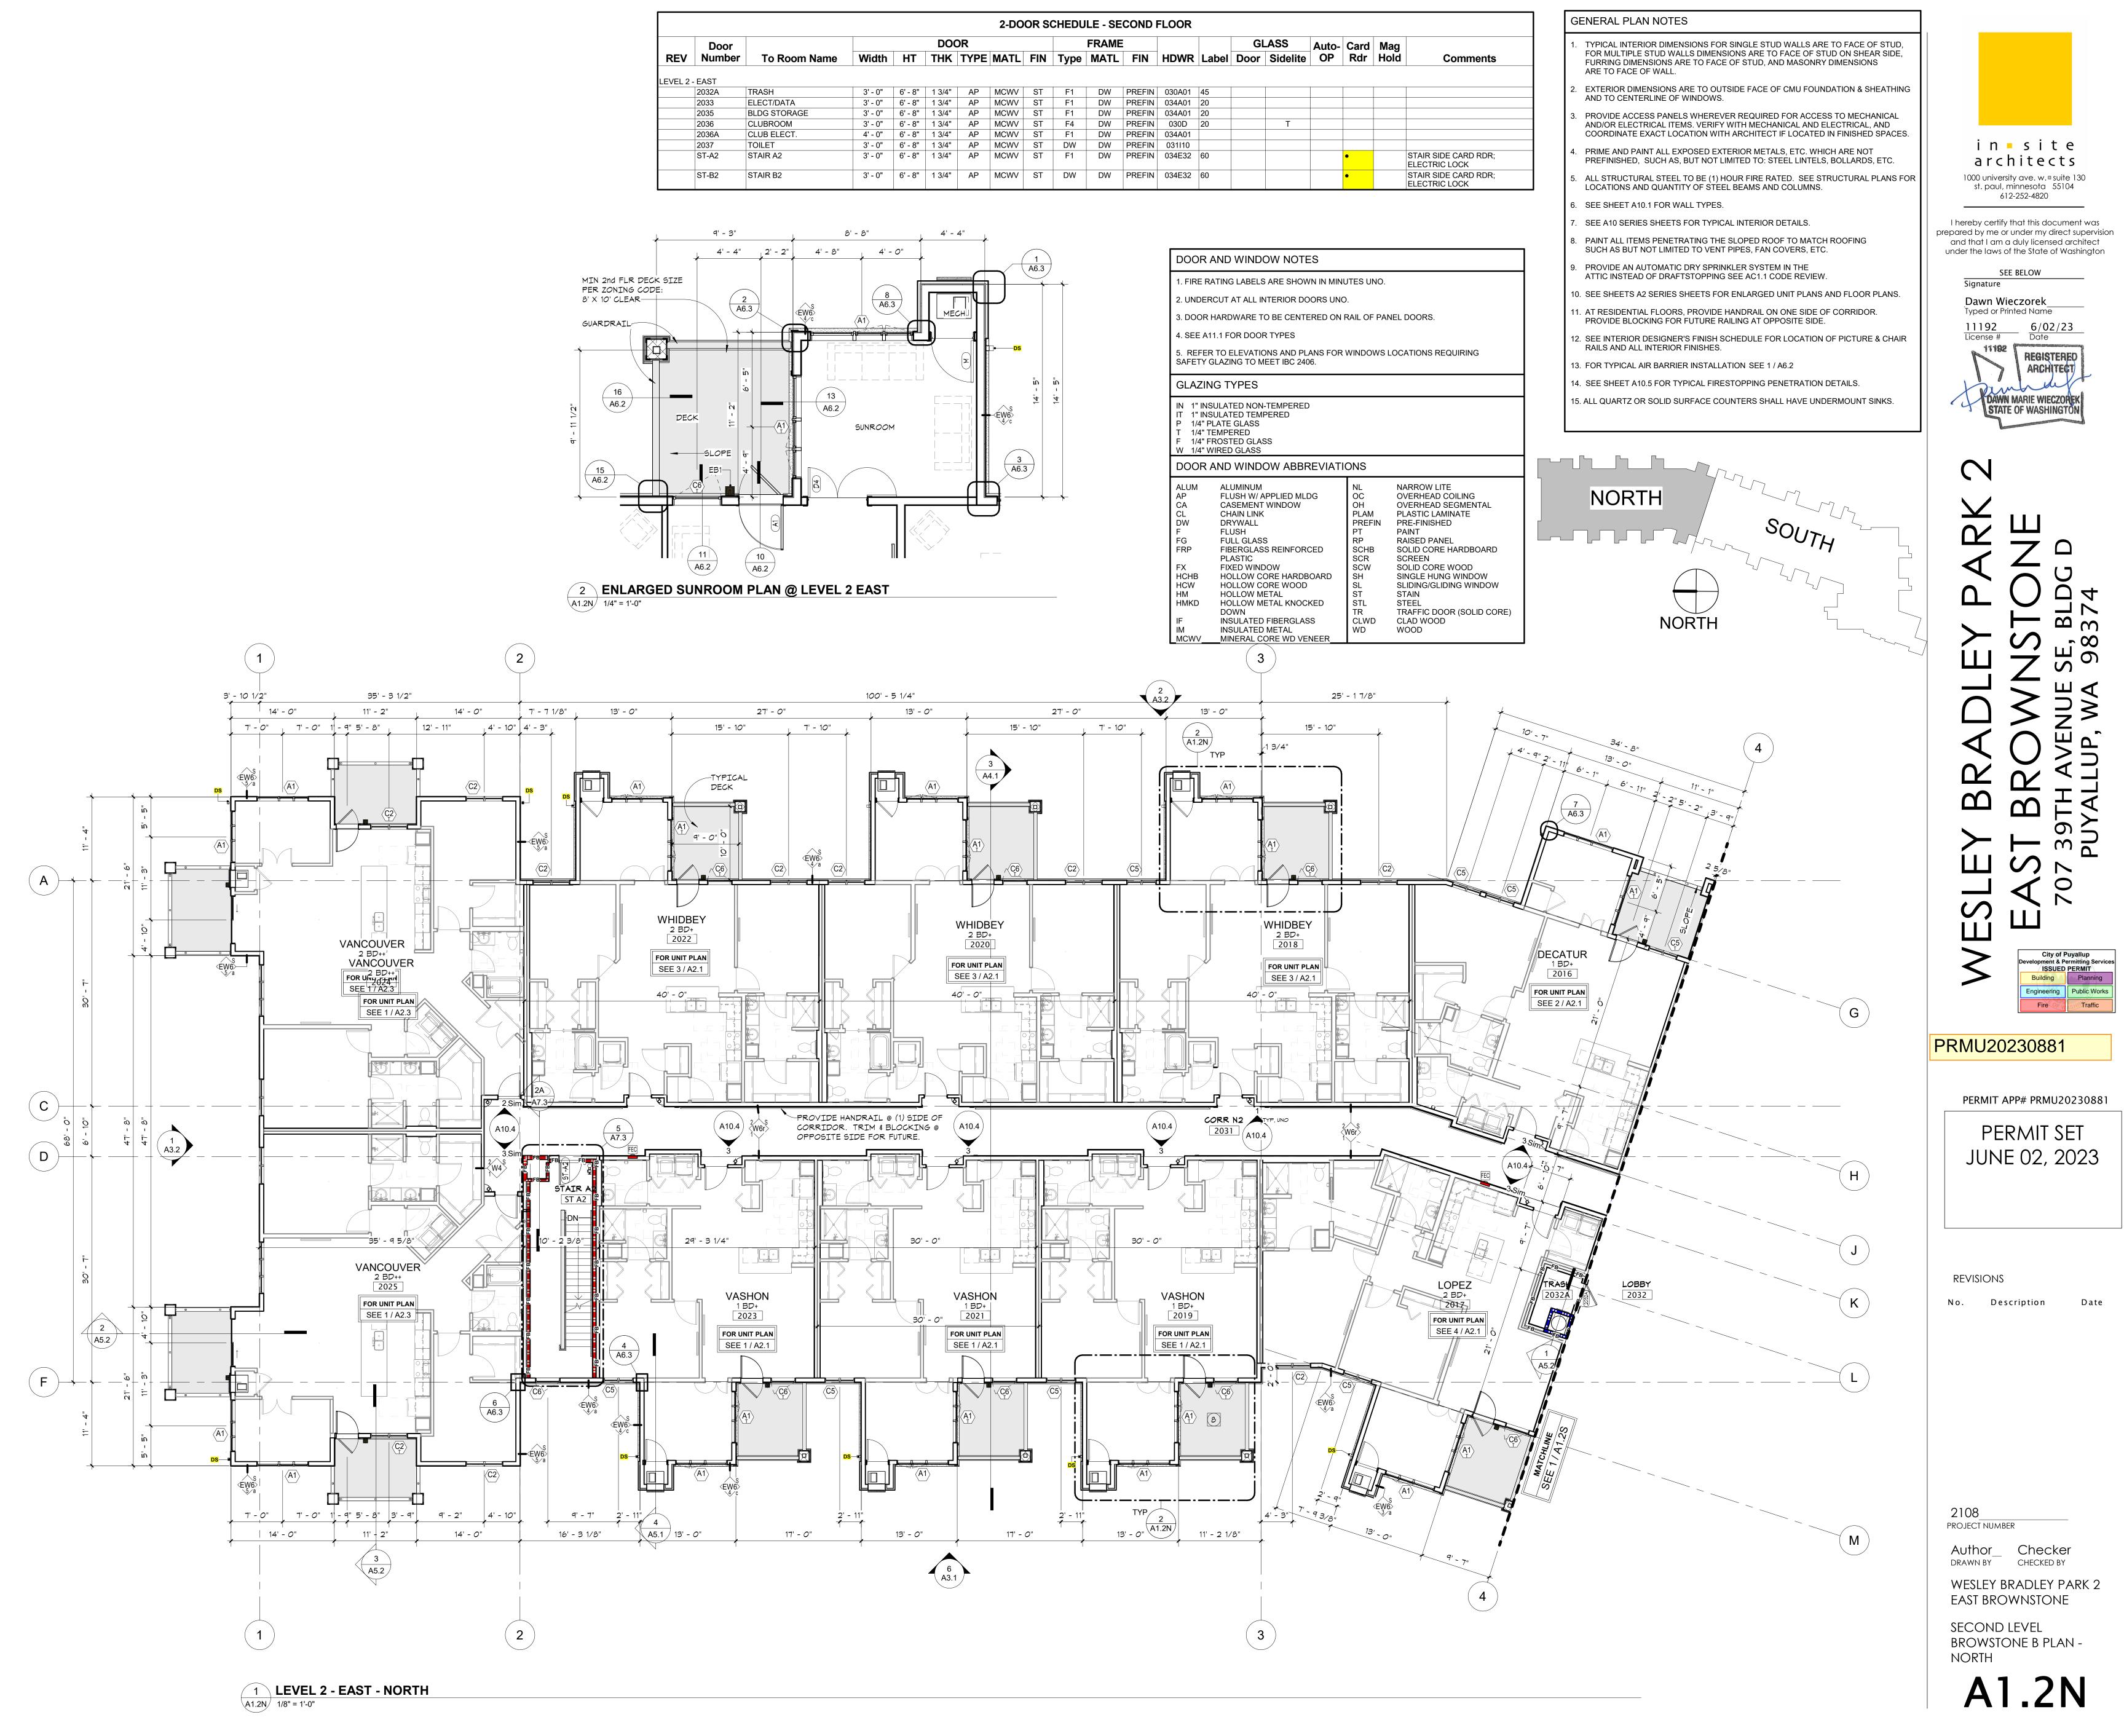


							2-DO	OR SO	CHEDU	LE - SE	CON
	Door				DOC	OR				FRAME	
REV	Number	To Room Name	Width	HT	THK	TYPE	MATL	FIN	Туре	MATL	FI
_EVEL 2 -	EAST										
	2032A	TRASH	3' - 0"	6' - 8"	1 3/4"	AP	MCWV	ST	F1	DW	PRE
	2033	ELECT/DATA	3' - 0"	6' - 8"	1 3/4"	AP	MCWV	ST	F1	DW	PRE
	2035	BLDG STORAGE	3' - 0"	6' - 8"	1 3/4"	AP	MCWV	ST	F1	DW	PRE
	2036	CLUBROOM	3' - 0"	6' - 8"	1 3/4"	AP	MCWV	ST	F4	DW	PRE
	2036A	CLUB ELECT.	4' - 0"	6' - 8"	1 3/4"	AP	MCWV	ST	F1	DW	PRE
	2037	TOILET	3' - 0"	6' - 8"	1 3/4"	AP	MCWV	ST	DW	DW	PRE
	ST-A2	STAIR A2	3' - 0"	6' - 8"	1 3/4"	AP	MCWV	ST	F1	DW	PRE
	ST-B2	STAIR B2	3' - 0"	6' - 8"	1 3/4"	AP	MCWV	ST	DW	DW	PRE

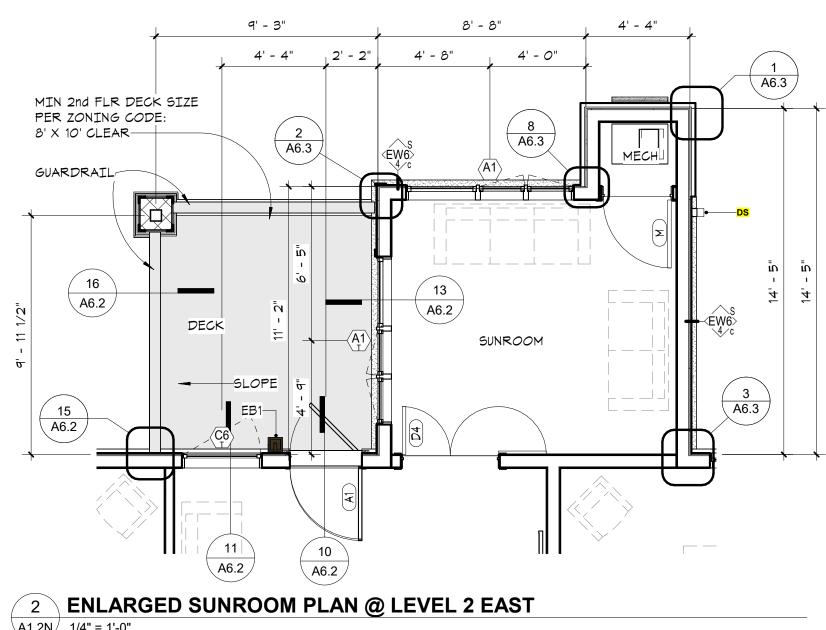







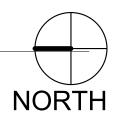

in site architects 1000 university ave. w. 🛛 suite 130 st. paul, minnesota 55104 612-252-4820 I hereby certify that this document was prepared by me or under my direct supervision and that I am a duly licensed architect under the laws of the State of Washington SEE BELOW Signature Dawn Wieczorek Typed or Printed Name 6/02/23 11192 License # Date 11192 REGISTERE ARCHITECT Δ m $r \infty$ ШŐ ШA $\supset \geq$ ~ > UP UP $\mathbf{\mathcal{L}}$ Ω Ω 39 PU \mathcal{O} 70 С Ш City of Puyallup Development & Permitting Services ISSUED PERMIT Building Planning Engineering Public Works Fire Traffic PRMU20230881 PERMIT APP# PRMU20230881 PERMIT SET JUNE 02, 2023 REVISIONS Date No. Description 1 BLDG PERMIT REV 1 3/4/24 2108 PROJECT NUMBER JDK_____ Checker DRAWN BY CHECKED BY WESLEY BRADLEY PARK 2 EAST BROWNSTONE $\overline{}$ THIRD LEVEL OVERALL FLOOR PLANS A1.3 2 Munn

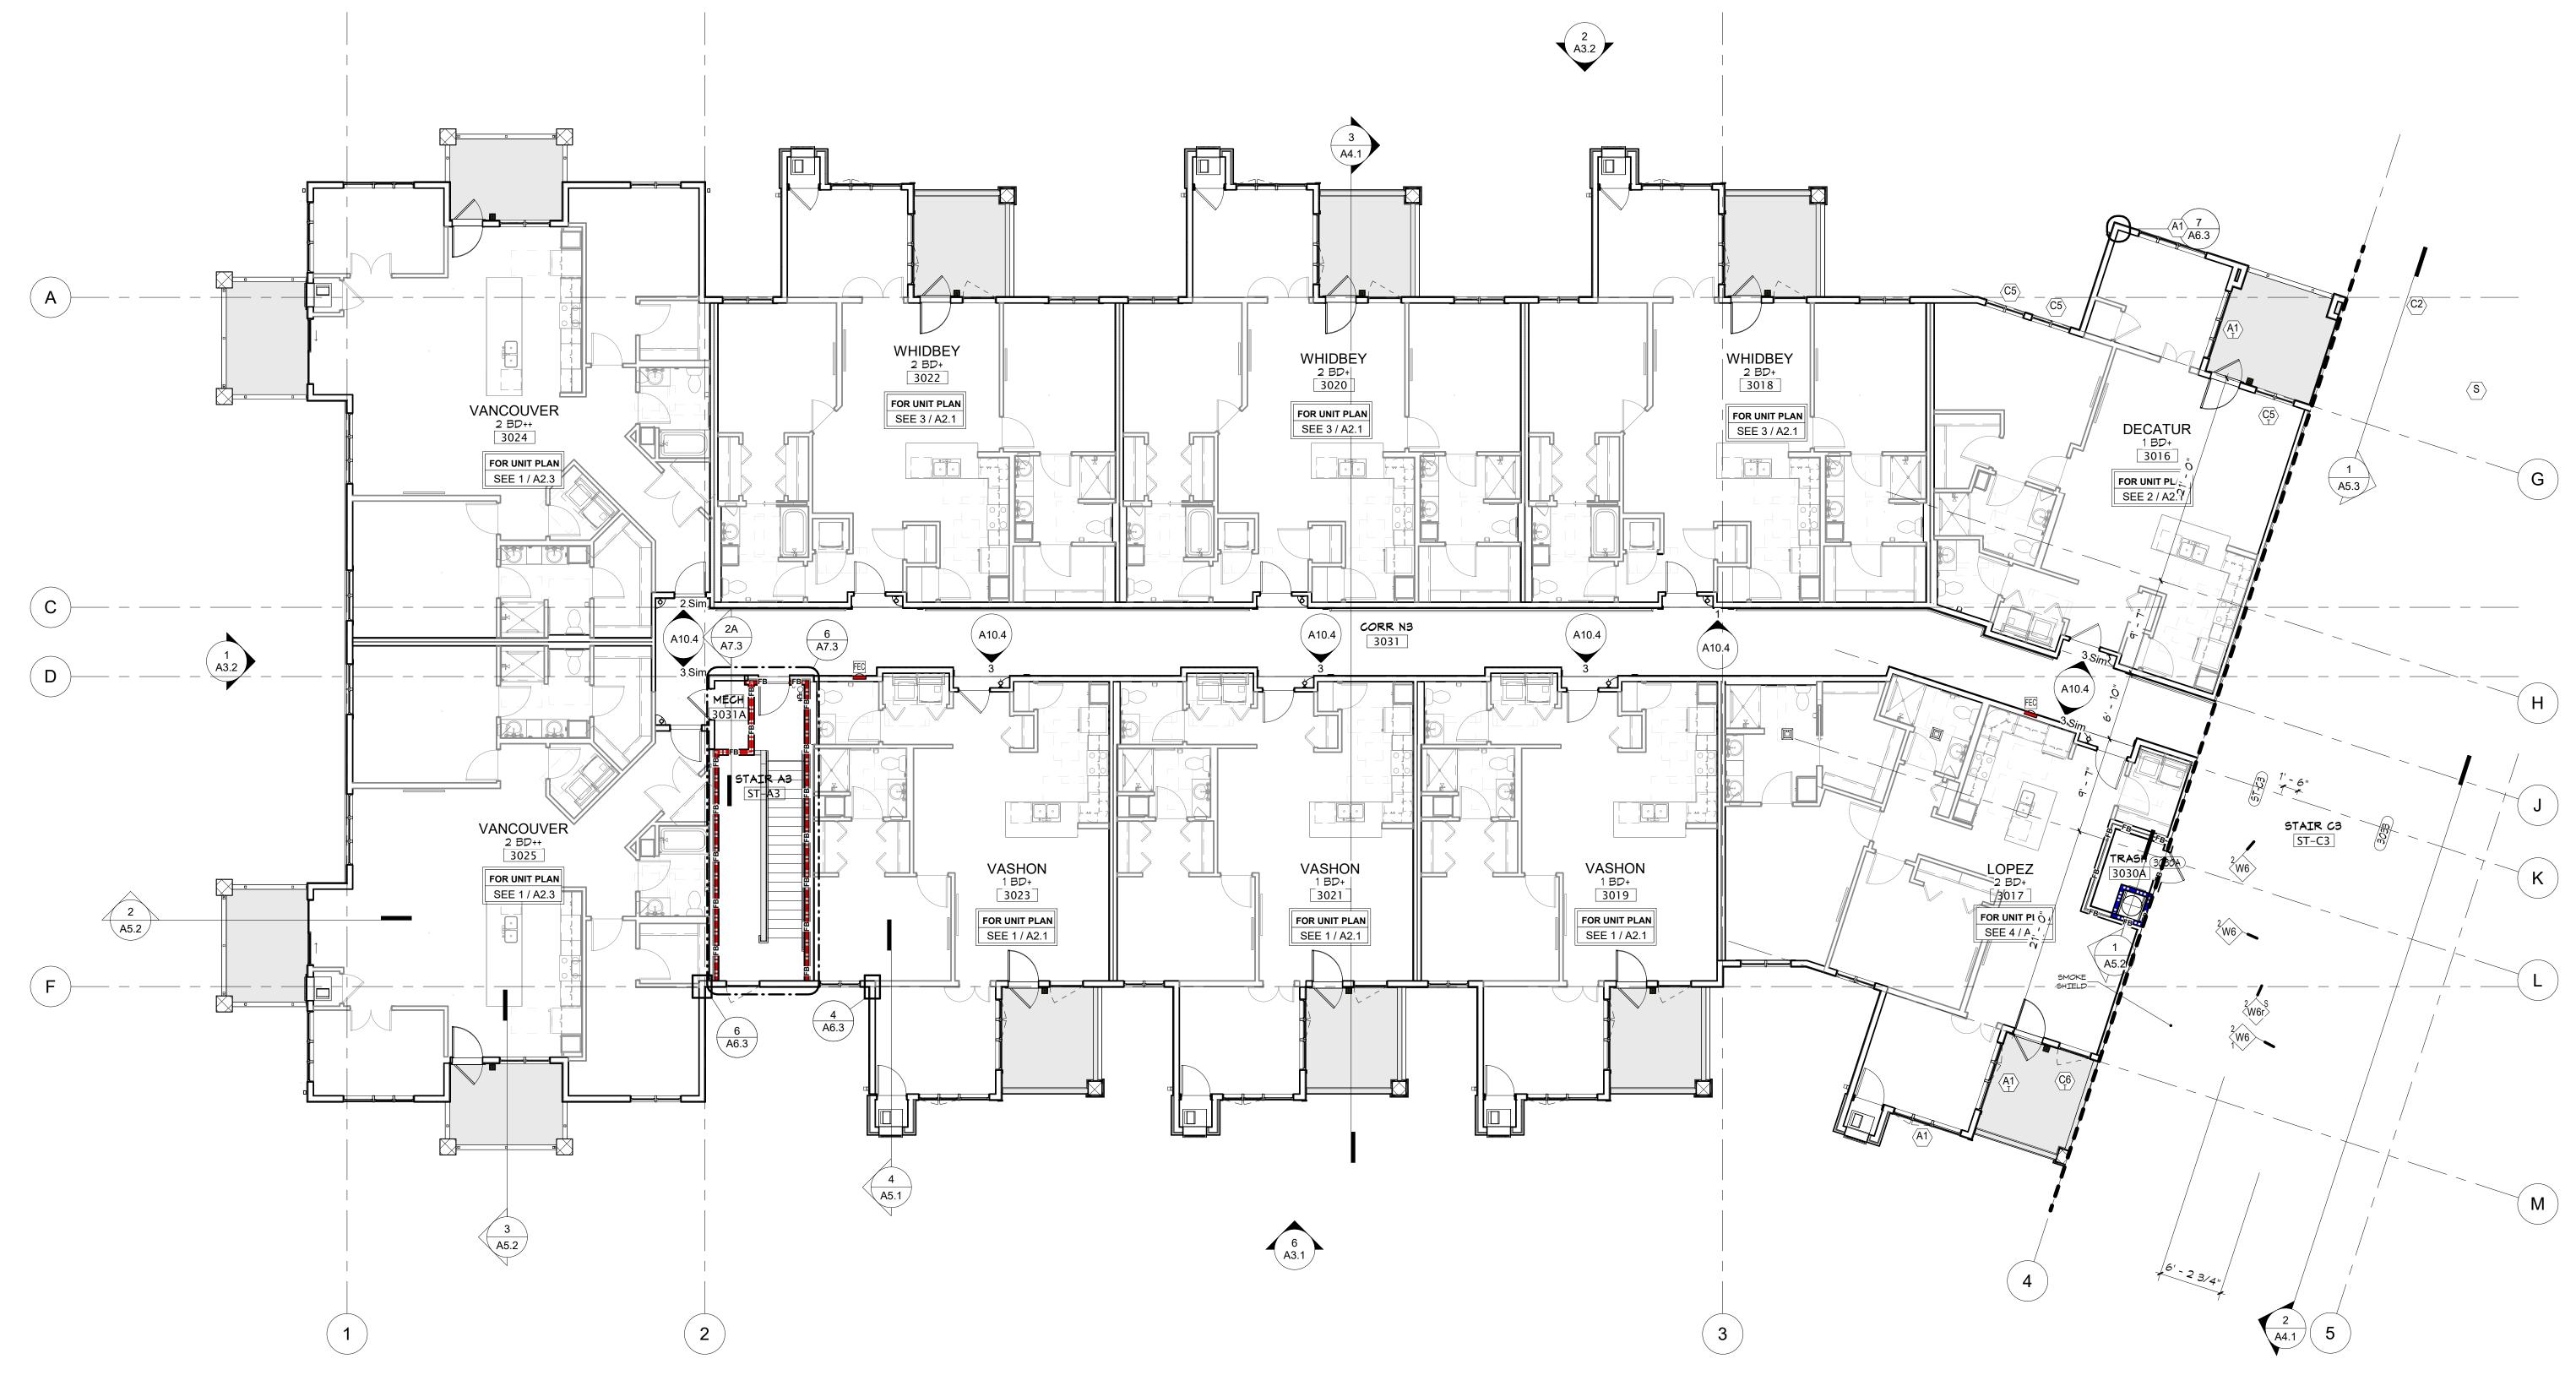


							3-[DOOR	SCHEE	DULE - T	HIRD F	LOOR								GENERAL PLAN NOTES	
	Deer				DO	OR				FRAME	=			GL	ASS	A	Card	Maa		1. TYPICAL INTERIOR DIMENSIONS FOR SINGLE STUD	
REV	Door Number	To Room Name	Width	HT			E MATL	- FIN	Туре			HDWR	Label			1	Card Rdr	•	Comments	FOR MULTIPLE STUD WALLS DIMENSIONS ARE TO F FURRING DIMENSIONS ARE TO FACE OF STUD, AND ARE TO FACE OF WALL.	
LEVEL 3 - E	EAST																				
3	3030A	TRASH	3' - 0"	6' - 8"	1 3/4"	AP	MCWV	/ ST	F1	DW	PREFIN	030A01	90							2. EXTERIOR DIMENSIONS ARE TO OUTSIDE FACE OF AND TO CENTERLINE OF WINDOWS.	CMU FOUNDATION & S
3	3031A	MECH	3' - 0"	6' - 8"	1 3/4"	AP	MCWV	′ ST	F1	DW	PREFIN	034A01	20								
		RESIDENT STORAGE	3' - 0"	6' - 8"	1 3/4"	AP	MCWV	′ ST	F1		PREFIN									3. PROVIDE ACCESS PANELS WHEREVER REQUIRED	
		STORAGE/ELEC	3' - 0"		1 3/4"				F1		PREFIN									AND/OR ELECTRICAL ITEMS. VERIFY WITH MECHAN COORDINATE EXACT LOCATION WITH ARCHITECT I	
		MECH	3' - 0"	6' - 8"					F1	DW		034A01	20								
		RES STORAGE	3' - 0"	6' - 8"					F1	DW	PREFIN									4. PRIME AND PAINT ALL EXPOSED EXTERIOR METALS	
		RES STORAGE	3' - 0"	7' - 0"				AN	F1	AL	AN	254X82		IT						PREFINISHED, SUCH AS, BUT NOT LIMITED TO: STE	EL LINTELS, BOLLARD
ç	ST-A3	STAIR A3	3' - 0"	6' - 8"	1 3/4"	AP	MCWV	' ST	F1	DW	PREFIN	034E32	60				•		STAIR SIDE CARD RDR; ELECTRIC LOCK	5. ALL STRUCTURAL STEEL TO BE (1) HOUR FIRE RAT	ED SEE STRUCTURAL
	ST-B3	STAIR B3	3' - 0"	6' - 8"	1 3/4"	AP	MCWV	/ ST	DW	DW	PREFIN	034E32	60				•		STAIR SIDE CARD RDR;	LOCATIONS AND QUANTITY OF STEEL BEAMS AND	
	51 00		00		10,4	/ 1						004202					•		ELECTRIC LOCK		
5	ST-C3	STAIR C3	3' - 0"	6' - 8"	1 3/4"	AP	MCWV	′ ST	DW	DW	PREFIN	034E32	60							6. SEE SHEET A10.1 FOR WALL TYPES.	
																				7. SEE A10 SERIES SHEETS FOR TYPICAL INTERIOR D	ETAILS.
																				 PAINT ALL ITEMS PENETRATING THE SLOPED ROOF SUCH AS BUT NOT LIMITED TO VENT PIPES, FAN CO 	
													OOR AN	םאוש חו		TES				SUCH AS BUT NOT LIMITED TO VENT PIPES, FAN CO	JVERS, ETC.
																				9. PROVIDE AN AUTOMATIC DRY SPRINKLER SYSTEM	
												1.	FIRE RATI	NG LABELS	S ARE SHO	WN IN M		UNO.		ATTIC INSTEAD OF DRAFTSTOPPING SEE AC1.1 CO	DE REVIEW.
																				10. SEE SHEETS A2 SERIES SHEETS FOR ENLARGED U	INIT PLANS AND FLOOF
												2.	UNDERCU	JT AT ALL II	INTERIOR [DOORSL	JNO.				
												3	DOOR HAF	RDWARF T					DOORS	11. AT RESIDENTIAL FLOORS, PROVIDE HANDRAIL ON (
												J J .	DOORTIA							PROVIDE BLOCKING FOR FUTURE RAILING AT OPPO	OSITE SIDE.
												4.	SEE A11.1	FOR DOO	R TYPES					12. SEE INTERIOR DESIGNER'S FINISH SCHEDULE FOR	LOCATION OF PICTUR
												5							CATIONS REQUIRING	RAILS AND ALL INTERIOR FINISHES.	
													AFETY GLA					0005 LU	CATIONS REQUIRING		
																100.				13. FOR TYPICAL AIR BARRIER INSTALLATION SEE 1 / A	v6.2
												G	LAZING	TYPES						14. SEE SHEET A10.5 FOR TYPICAL FIRESTOPPING PEN	VETRATION DETAILS.
																-0				15. ALL QUARTZ OR SOLID SURFACE COUNTERS SHALL	L HAVE UNDERMOUNT
													1" INSUL/ 1" INSUL/			ΞD					
													1/4" PLAT								
												Ţ	1/4" TEMI		~~						
													1/4" FROS 1/4" WIRE								
												D	OOR AN	ID WIND	OW ABE	BREVIA	TIONS				
														ALUMINUM			NL		NARROW LITE		\sim
												AF									
												C/ CL		CHAIN LINK	T WINDOW		OH PLA		OVERHEAD SEGMENTAL PLASTIC LAMINATE		
												D\		DRYWALL			PRE		PRE-FINISHED		
												F		FLUSH			PT				$O(1\tau_{1}, -$
												FC FF		FULL GLAS	SS REINFO	RCED	RP SCH		RAISED PANEL SOLID CORE HARDBOARD		~'H
												I ''	P	PLASTIC			SCR	2	SCREEN		•
												FX					SCV	V	SOLID CORE WOOD		1
																	SH				
														HOLLOW C	CORE WOO /IETAL	U	SL ST		SLIDING/GLIDING WINDOW STAIN		
													MKD H	HOLLOW M	/ETAL KNC	CKED	STL		STEEL		
																4.00	TR		TRAFFIC DOOR (SOLID CORE)		
												I IF		NSULATED	D FIBERGL	455	CLW WD		CLAD WOOD WOOD	NORTH	
															CORE WD \	/ENEER					L

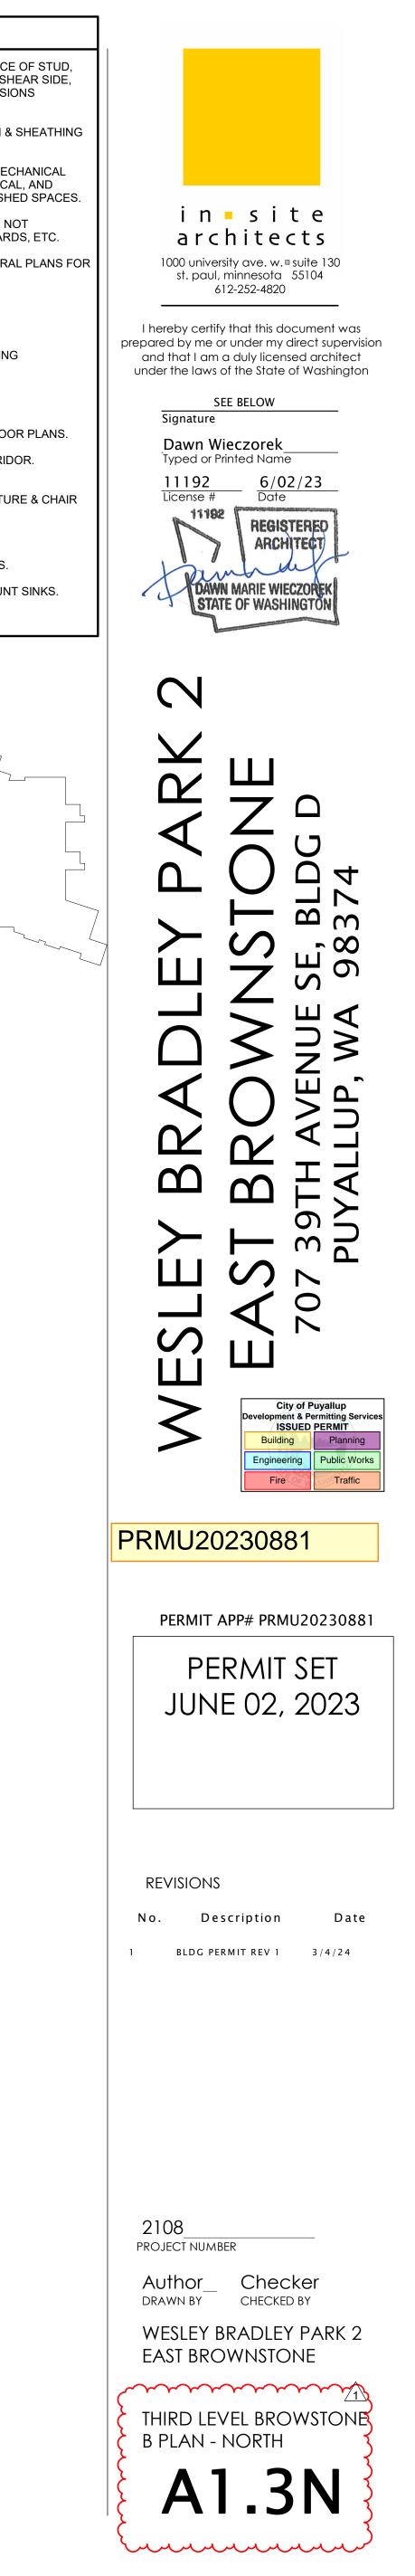



=880 LF SOFFIT REQ'D



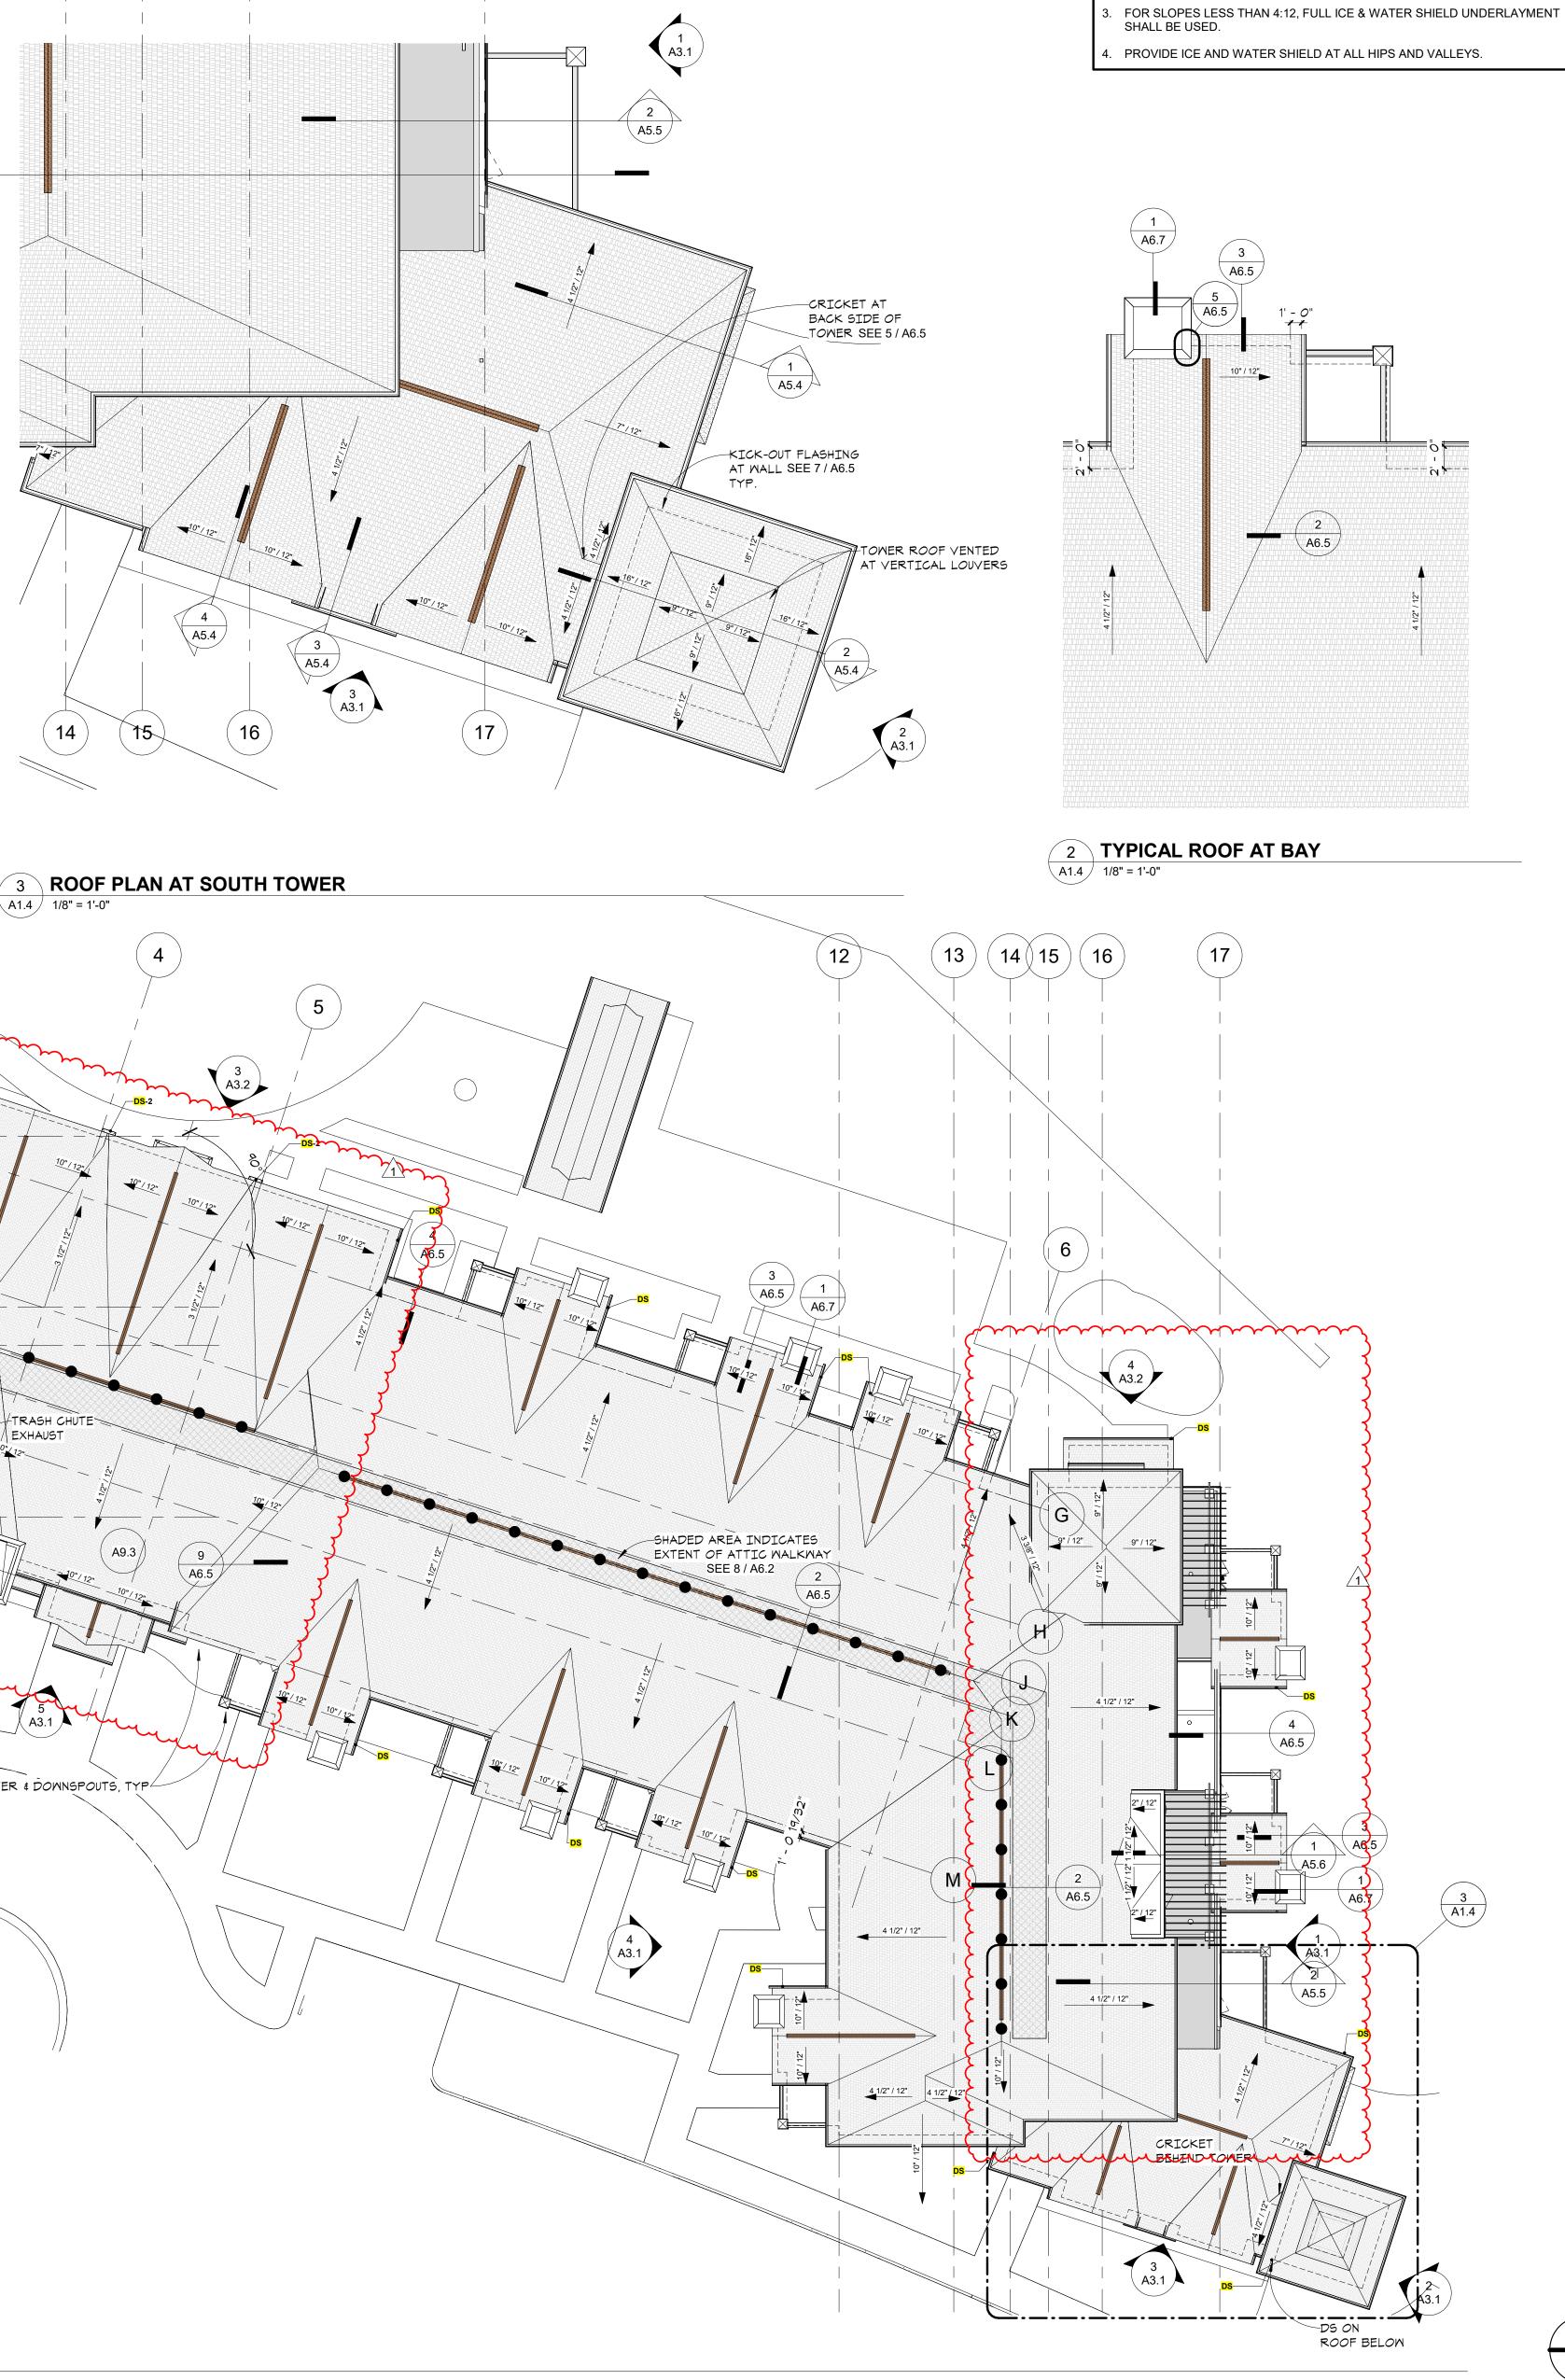






GENERAL ROOF NOTES

- WALKABLE MEMBRANE AT DECKS SHALL SLOPE A MINIMUM OF 3/16" PER FOOT.
- SOFFIT DEPTHS VARY SEE ROOF PLAN.


in • site architects 1000 university ave. w. 🛚 suite 130 st. paul, minnesota 55104 612-252-4820 I hereby certify that this document was prepared by me or under my direct supervision and that I am a duly licensed architect under the laws of the State of Washington SEE BELOW Signature Dawn Wieczorek Typed or Printed Name 11192 6/02/23 License # Date 11192 REGISTERED ARCHITECT DAWN MARIE WIECZOREN **STATE OF WASHINGT** N \Box 4 Δ m .<u></u> ∼ ∞ ШŐ $\blacksquare \triangleleft$ ₽Š $\mathbf{\Omega}$ Ω \mathbf{M} PU PU \mathbf{N} \bigcirc Б S City of Puyallup elopment & Permitting Service ISSUED PERMIT Building Engineering Public Works
Fire Traffic PRMU20230881 PERMIT APP# PRMU20230881 PERMIT SET JUNE 02, 2023 REVISIONS Date No. Description 1 BLDG PERMIT REV 1 3/4/24 2108_ PROJECT NUMBER Author___ Checker DRAWN BY CHECKED BY WESLEY BRADLEY PARK 2 EAST BROWNSTONE **ROOF PLANS & DETAILS**

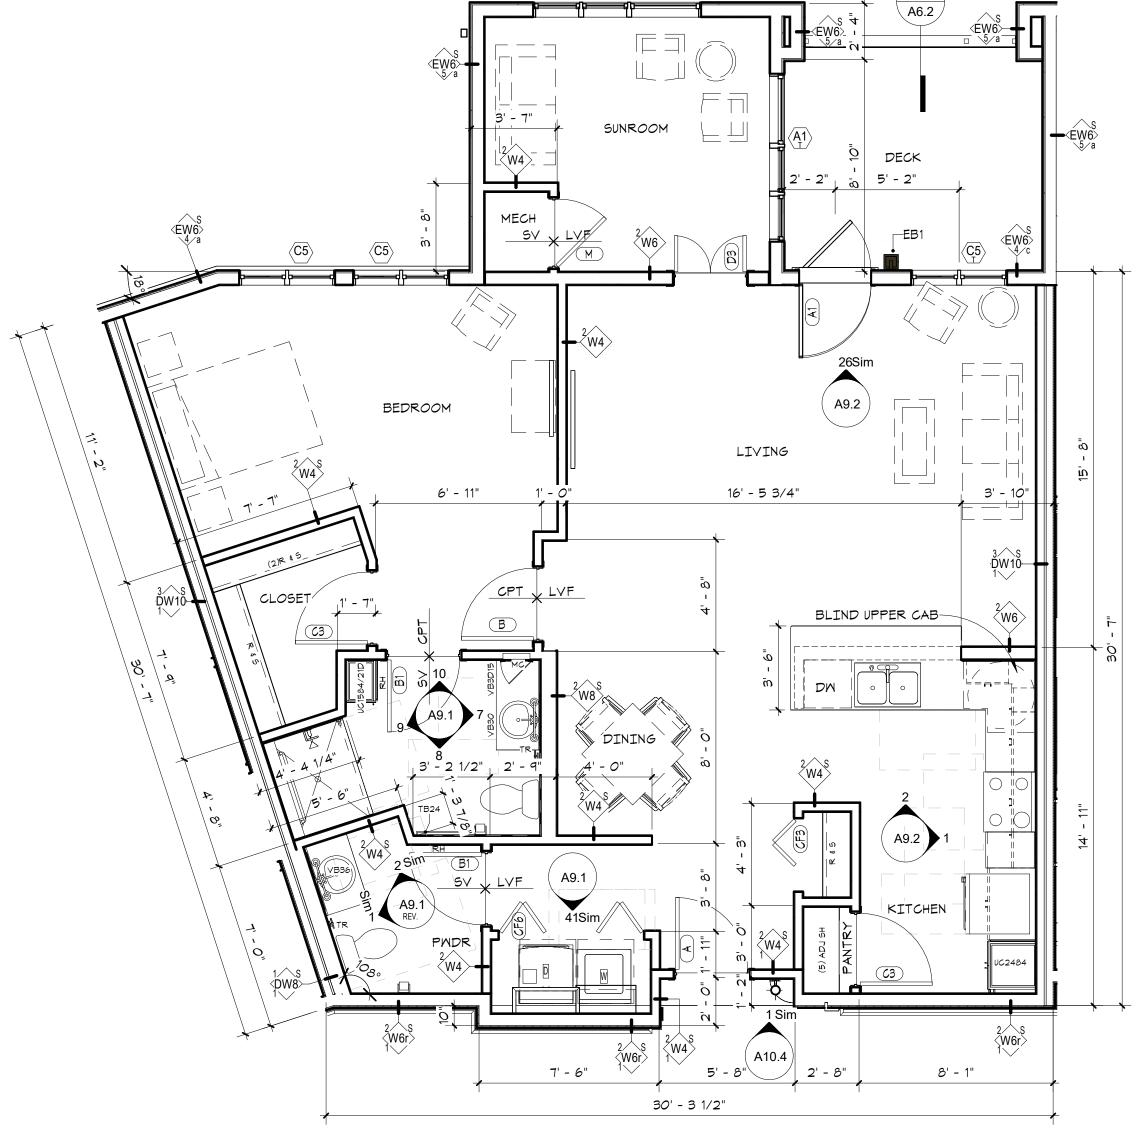

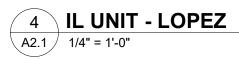

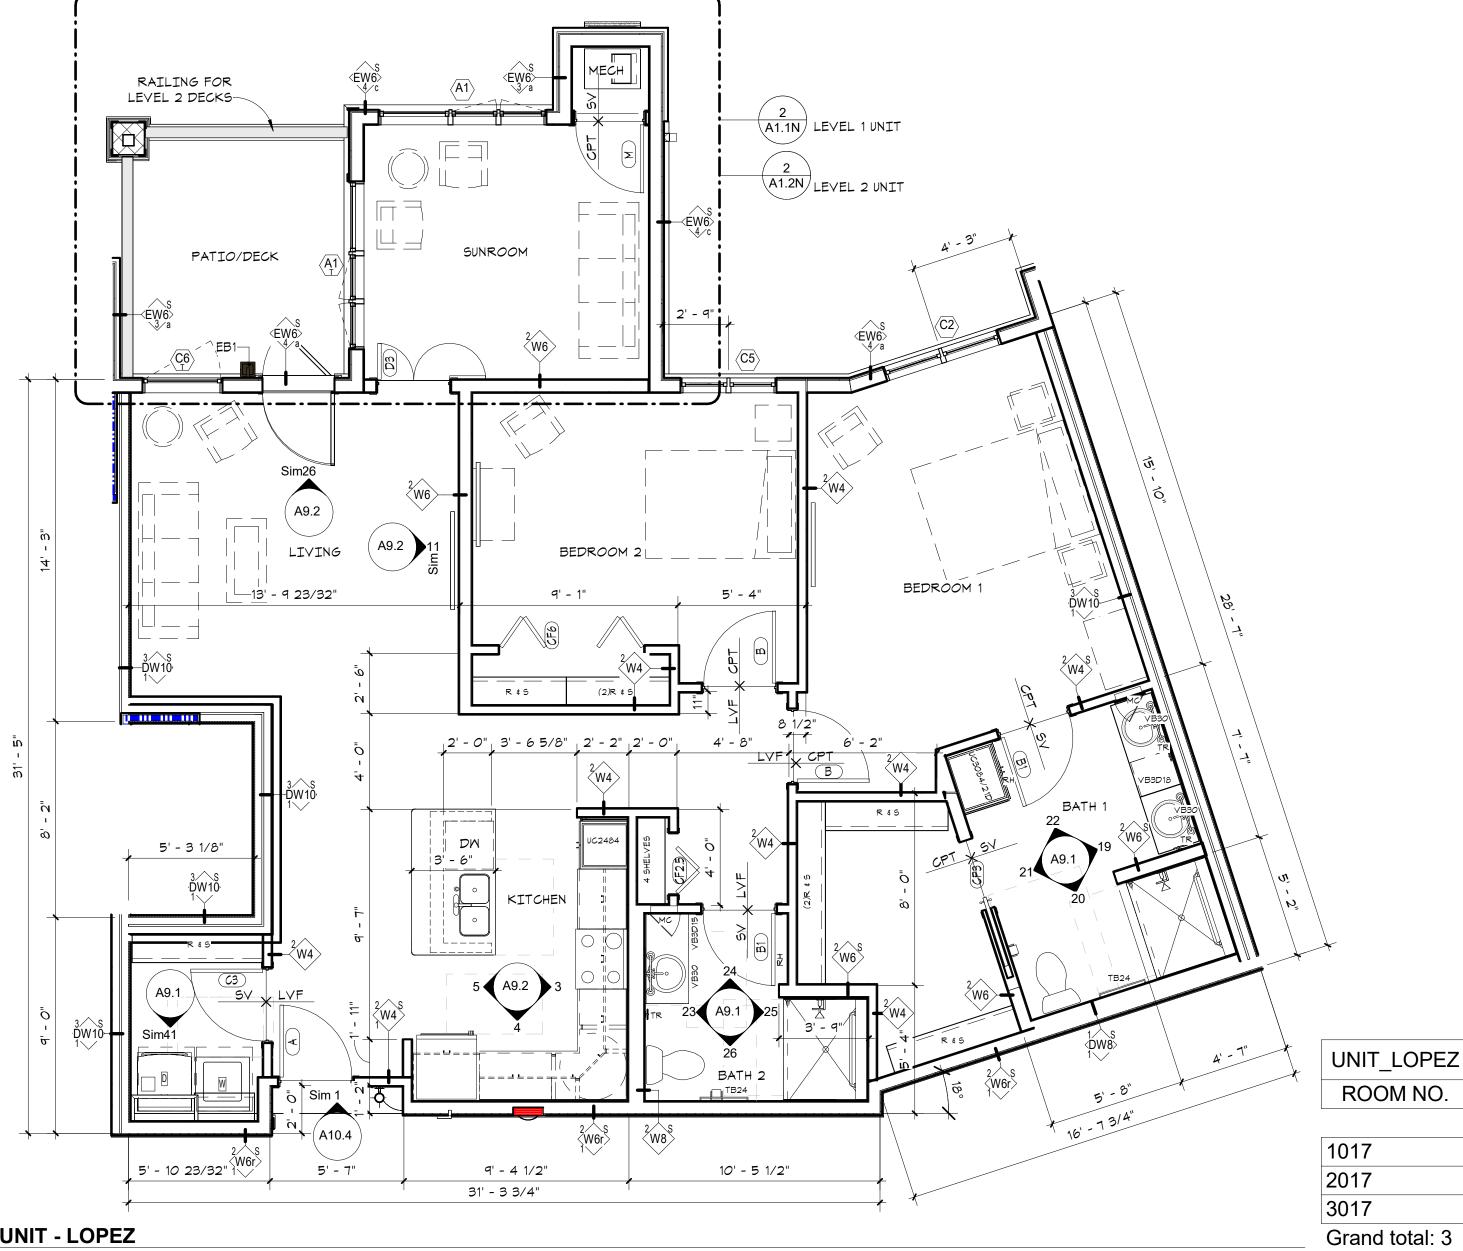

UNIT_LOPEZ	
ROOM NO.	
017	
2017	
8017	
Grand total: 3	

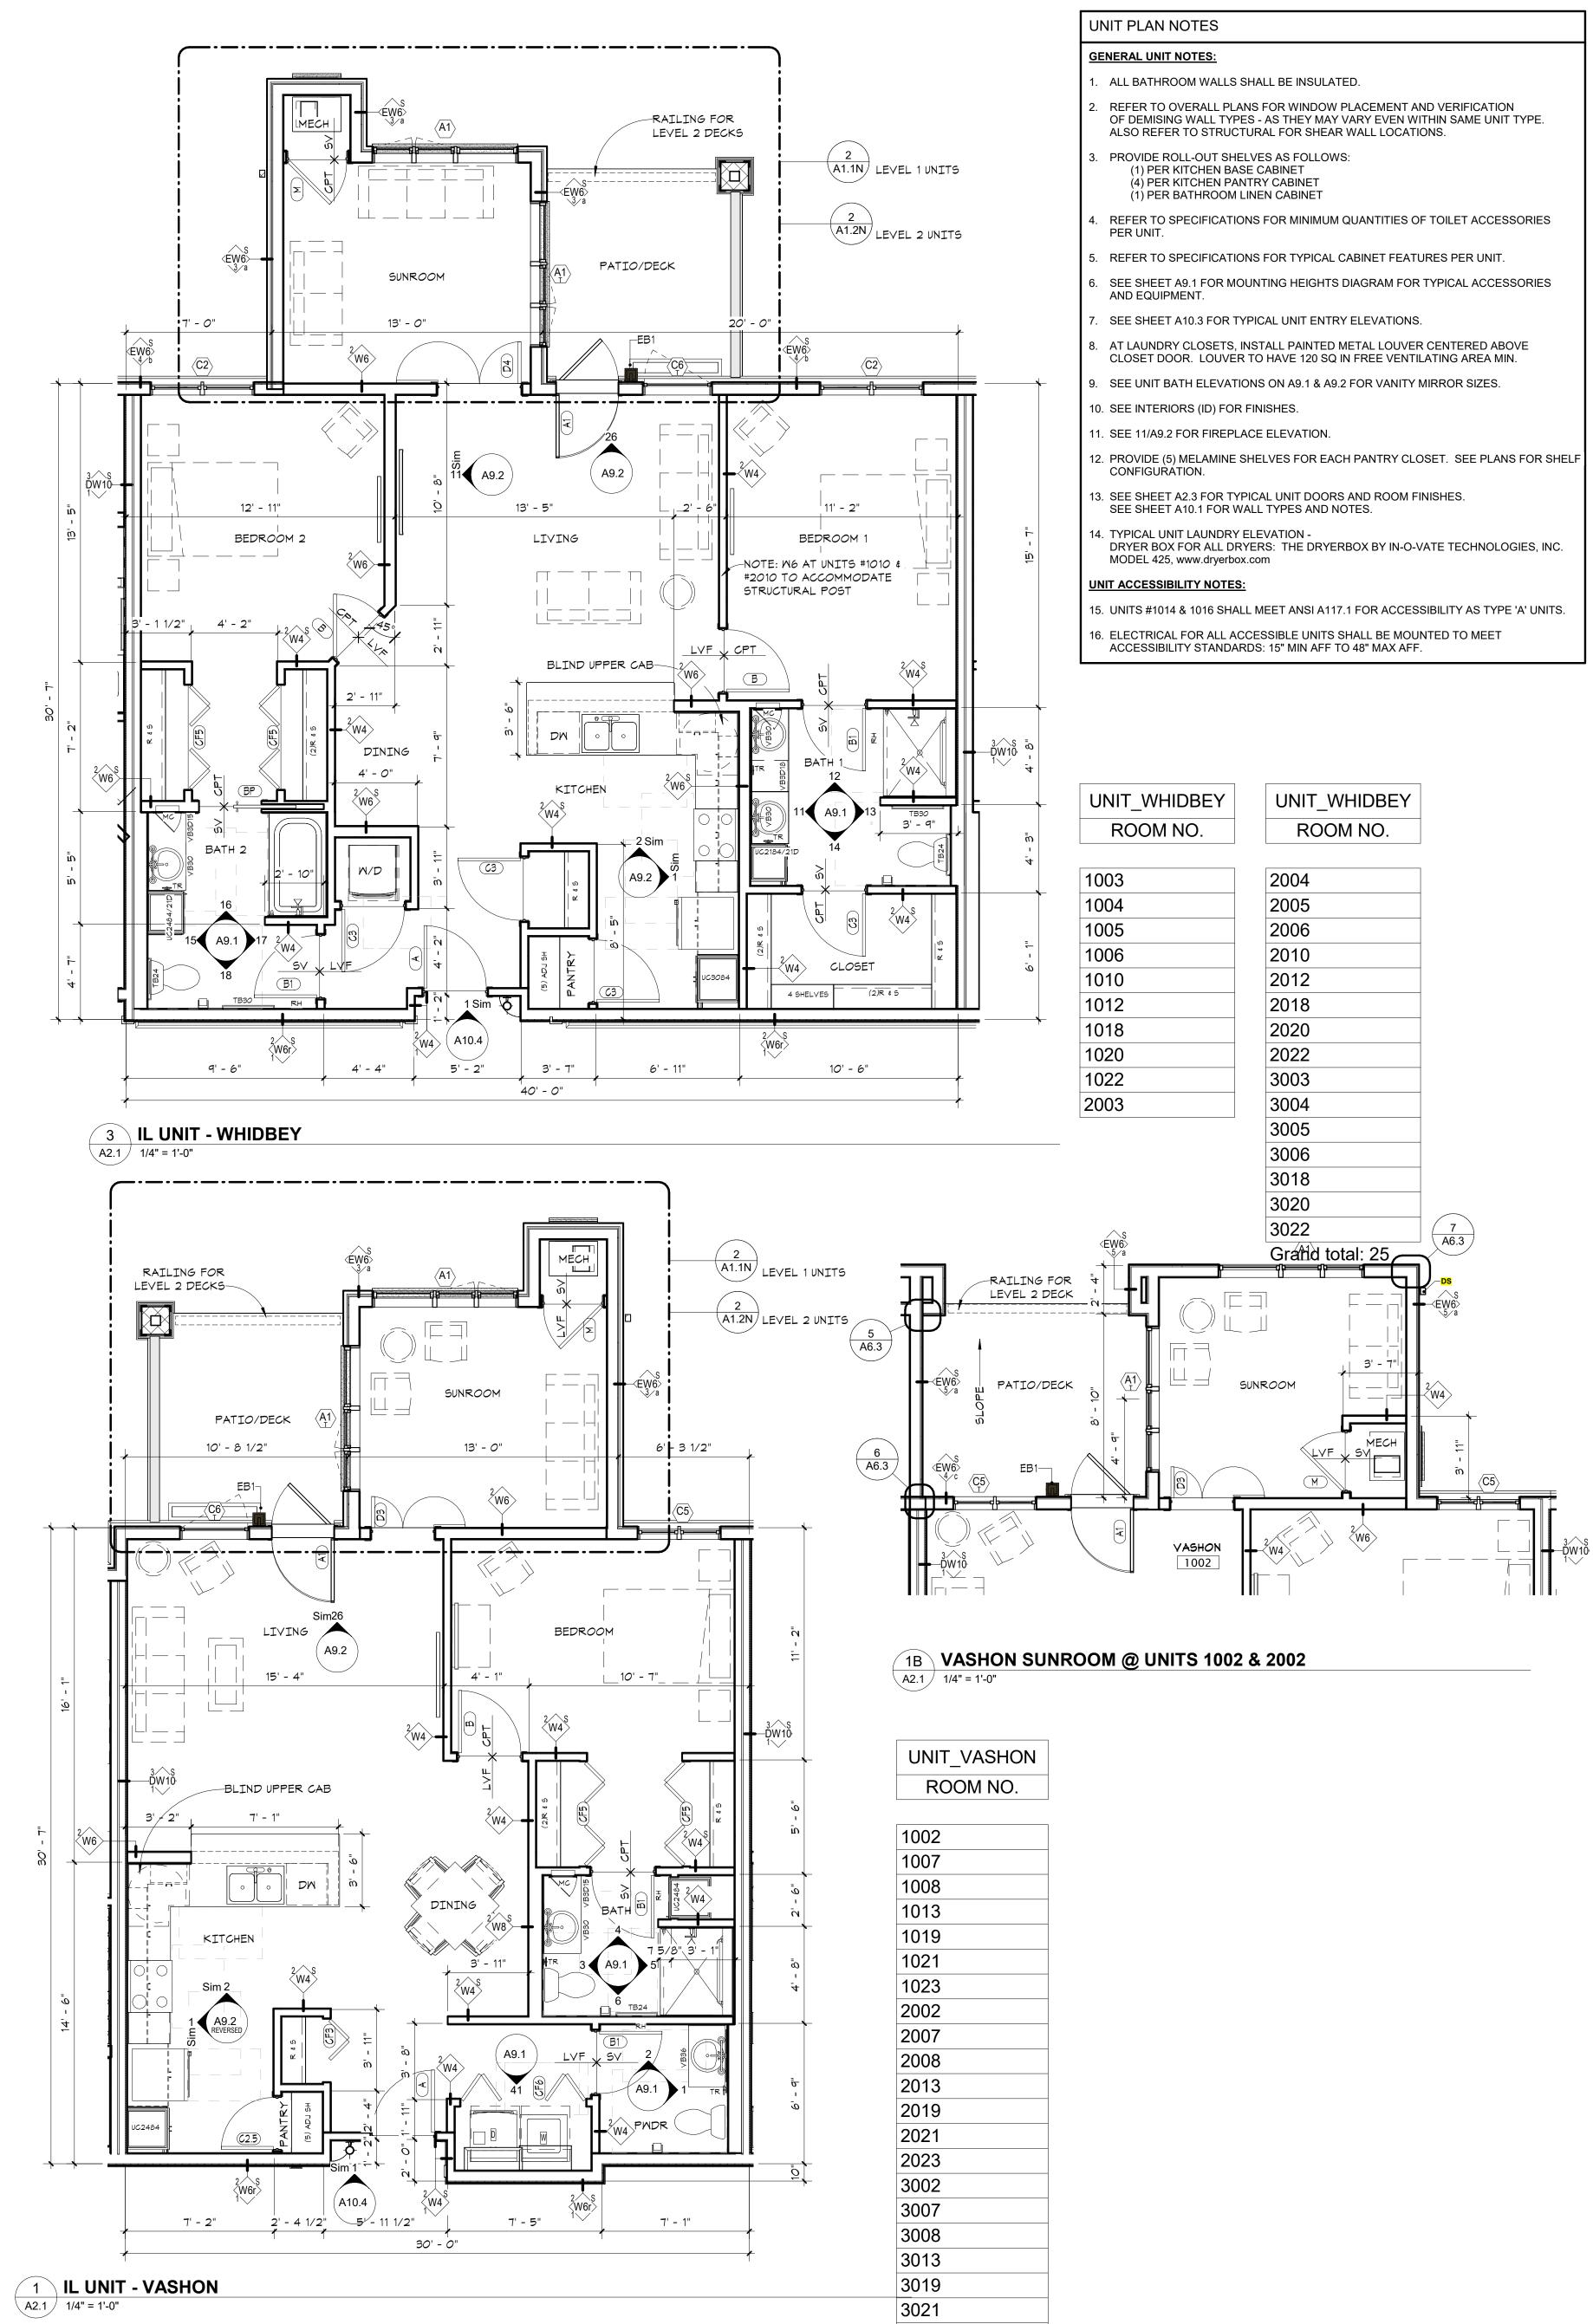



UNIT_DECATUR

ROOM NO.

2016


3016


Grand total: 2


1002
1007
1008
1013
1019
1021
1023
2002
2007
2008
2013
2019
2021
2023
3002
3007
3008
3013
3019
3021


3023 Grand total: 21


in site architects 1000 university ave. w. 🛛 suite 130 st. paul, minnesota 55104 612-252-4820 I hereby certify that this document was prepared by me or under my direct supervision and that I am a duly licensed architect under the laws of the State of Washington SEE BELOW Signature Dawn Wieczorek Typed or Printed Name 6/02/23 11192 License # Date 11192 REGISTERE ARCHITECT DAWN MARIE WIECZOR STATE OF WASHINGT \neg Ω m $r \infty$ ШO $\supset \geq$ 7 ш Δ 35 PU N 0 Ш S City of Puyallup elopment & Permitting Servic ISSUED PERMIT Building Engineering Public Works Fire Traffic PRMU20230881 PERMIT APP# PRMU20230881 PERMIT SET JUNE 02, 2023 REVISIONS Date No. Description 2108 PROJECT NUMBER Author_ Checker DRAWN BY CHECKED BY WESLEY BRADLEY PARK 2 EAST BROWNSTONE ENLARGED UNIT PLANS A2.

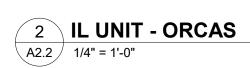


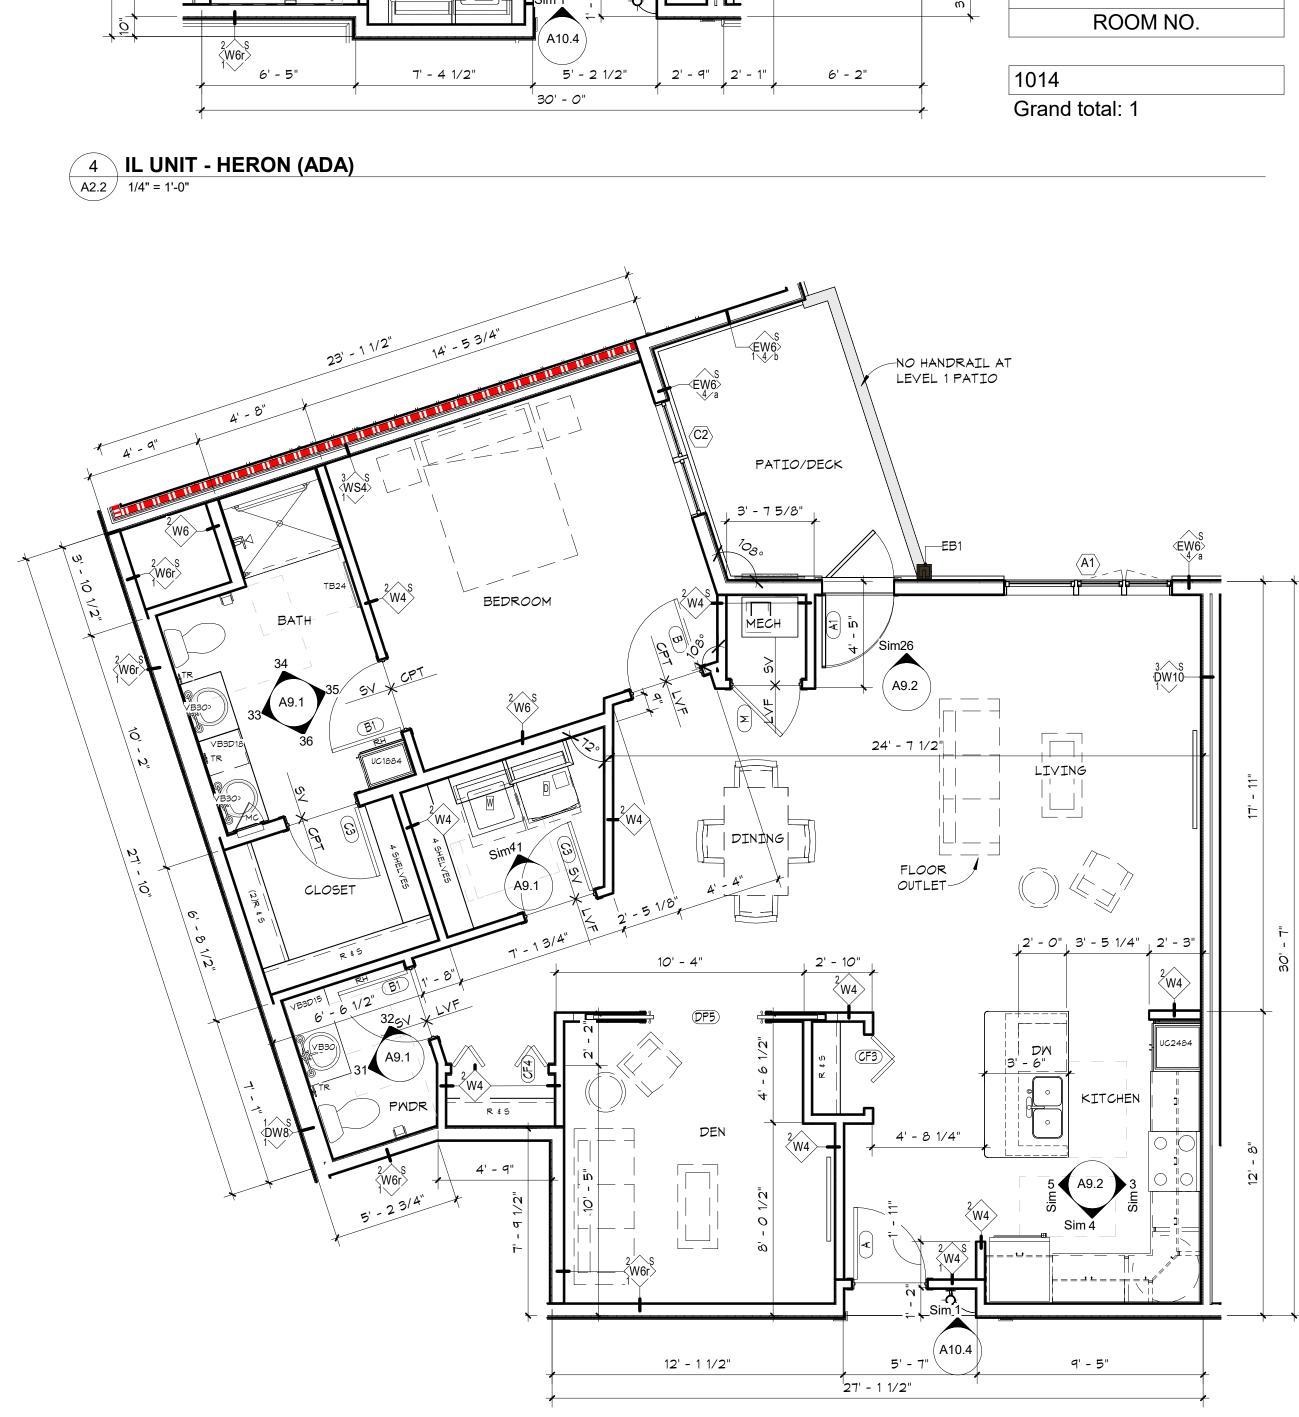


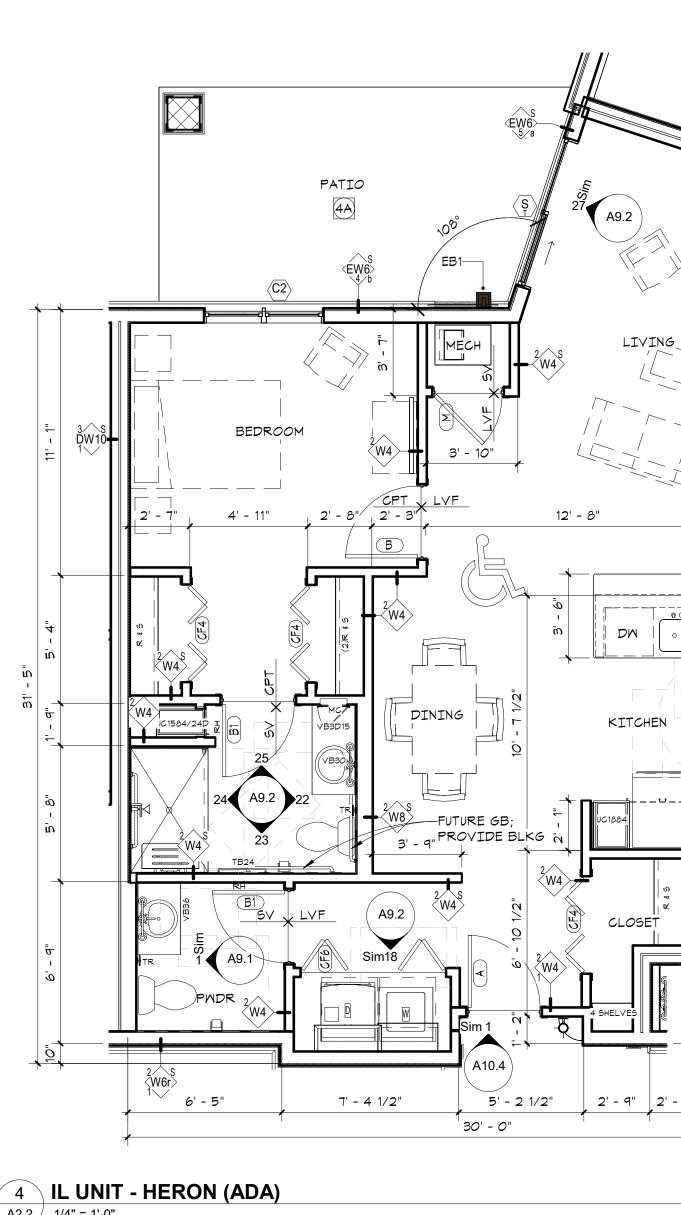

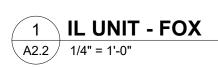


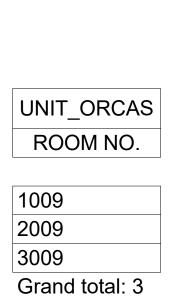

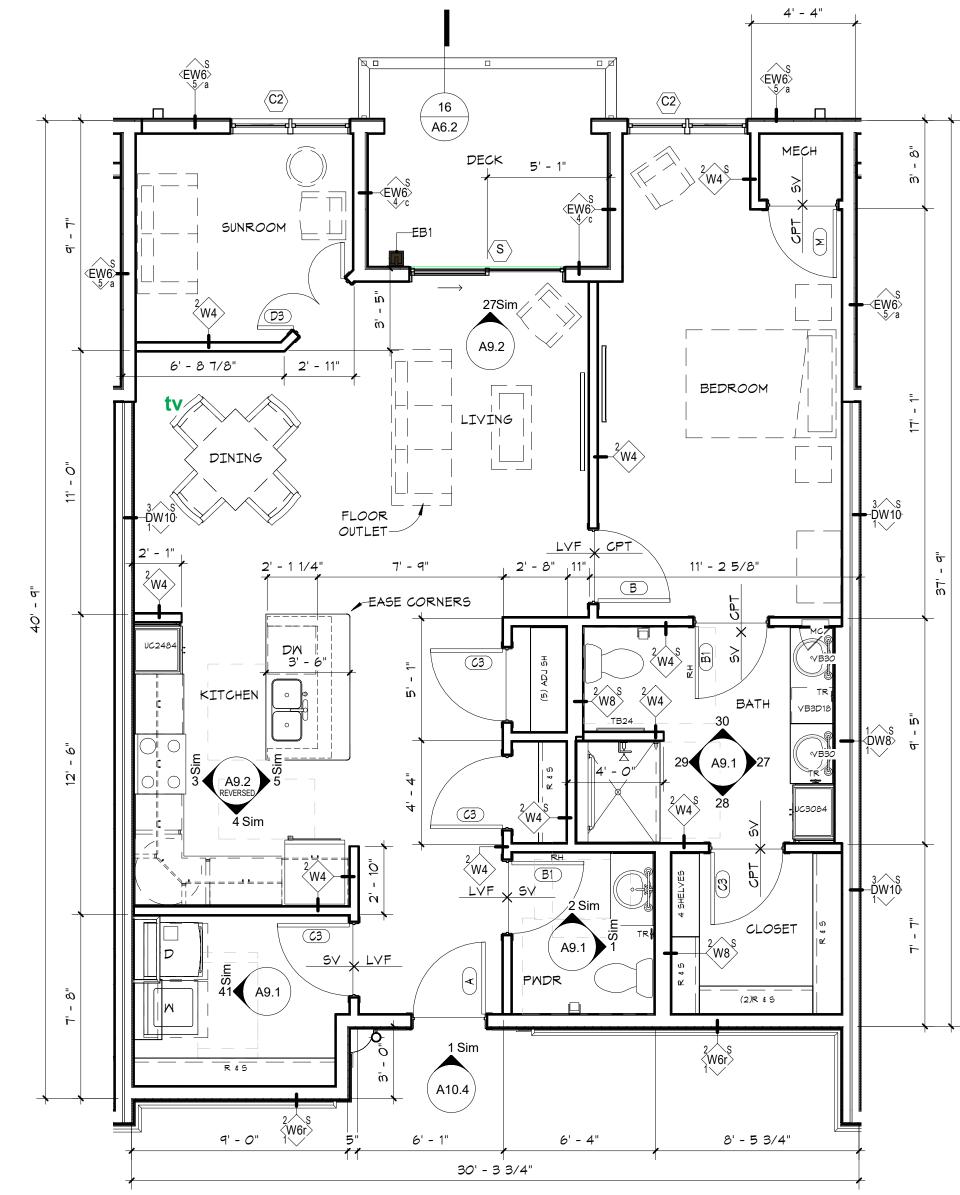

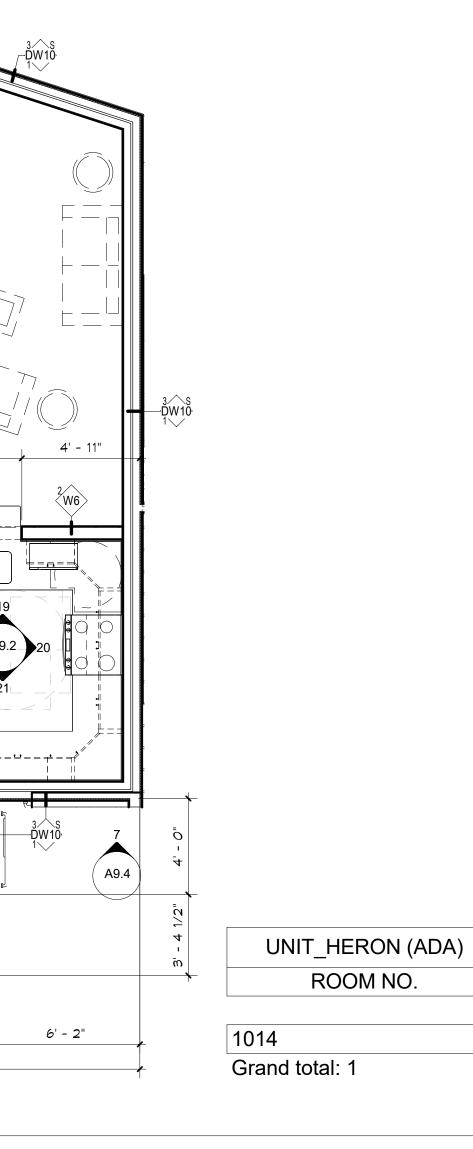

A9.2

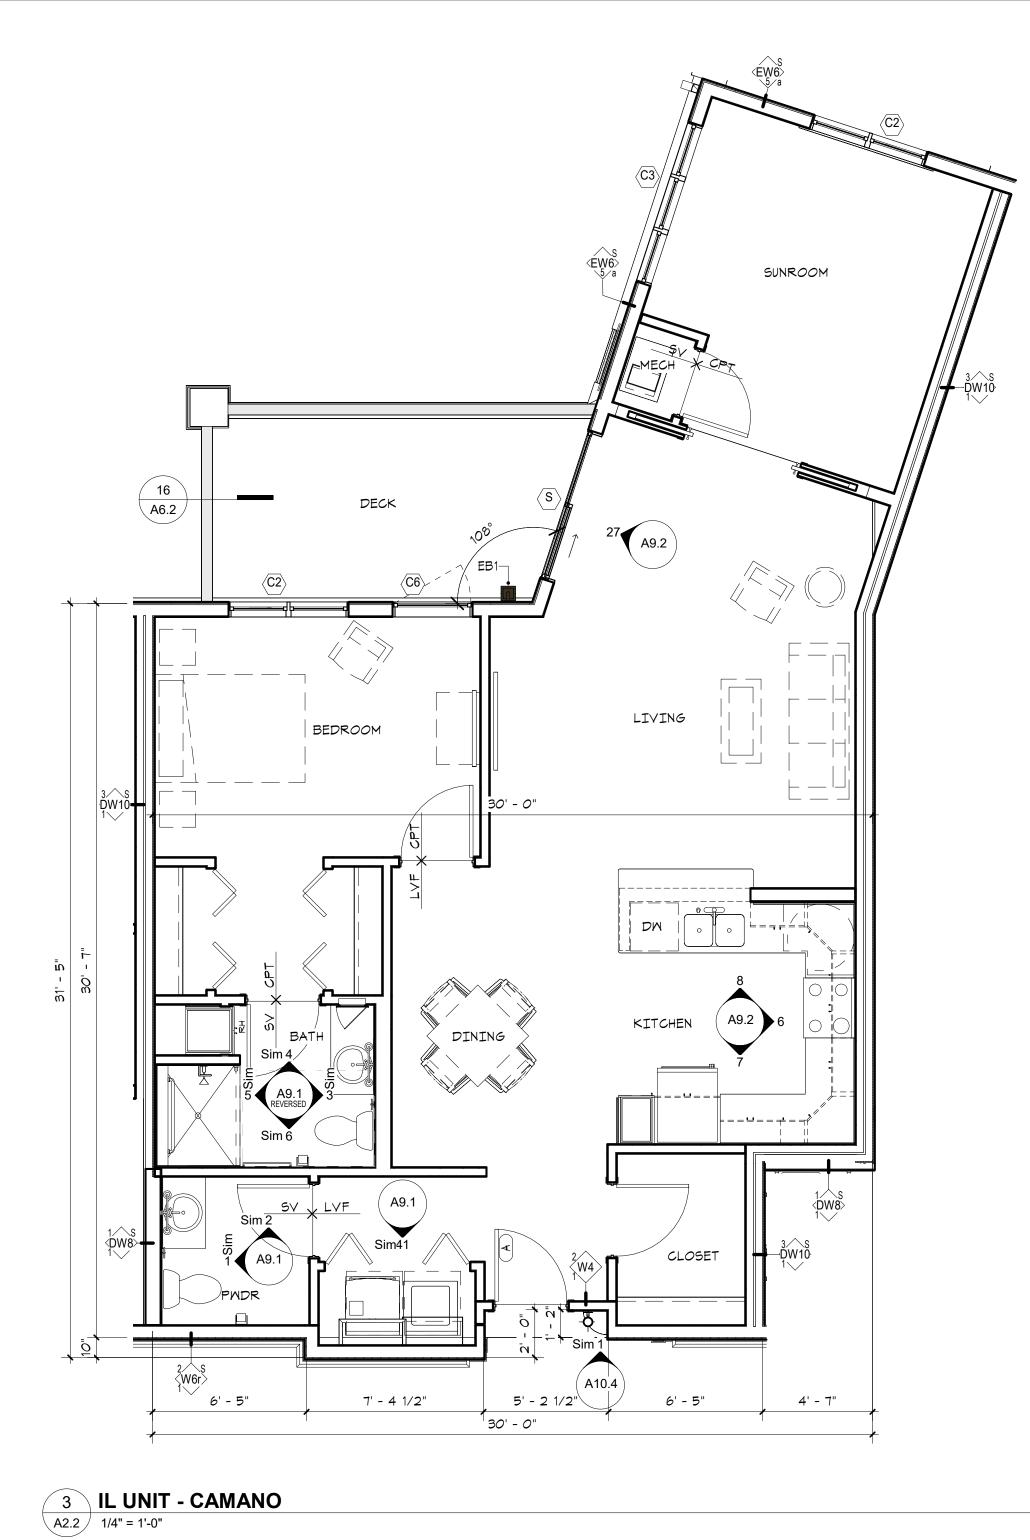






UNIT PLAN NOTES

- **GENERAL UNIT NOTES:**
- . ALL BATHROOM WALLS SHALL BE INSULATED.
- REFER TO OVERALL PLANS FOR WINDOW PLACEMENT AND VERIFICATION OF DEMISING WALL TYPES - AS THEY MAY VARY EVEN WITHIN SAME UNIT TYPE. ALSO REFER TO STRUCTURAL FOR SHEAR WALL LOCATIONS.
- PROVIDE ROLL-OUT SHELVES AS FOLLOWS: (1) PER KITCHEN BASE CABINET
- (4) PER KITCHEN PANTRY CABINET (1) PER BATHROOM LINEN CABINET
- REFER TO SPECIFICATIONS FOR MINIMUM QUANTITIES OF TOILET ACCESSORIES PER UNIT.
- REFER TO SPECIFICATIONS FOR TYPICAL CABINET FEATURES PER UNIT.
- SEE SHEET A9.1 FOR MOUNTING HEIGHTS DIAGRAM FOR TYPICAL ACCESSORIES AND EQUIPMENT.
- SEE SHEET A10.3 FOR TYPICAL UNIT ENTRY ELEVATIONS.
- 8. AT LAUNDRY CLOSETS, INSTALL PAINTED METAL LOUVER CENTERED ABOVE
- CLOSET DOOR. LOUVER TO HAVE 120 SQ IN FREE VENTILATING AREA MIN. 9. SEE UNIT BATH ELEVATIONS ON A9.1 & A9.2 FOR VANITY MIRROR SIZES.
- 10. SEE INTERIORS (ID) FOR FINISHES.
- 11. SEE 11/A9.2 FOR FIREPLACE ELEVATION.
- 12. PROVIDE (5) MELAMINE SHELVES FOR EACH PANTRY CLOSET. SEE PLANS FOR SHELF CONFIGURATION.
- 13. SEE SHEET A2.3 FOR TYPICAL UNIT DOORS AND ROOM FINISHES. SEE SHEET A10.1 FOR WALL TYPES AND NOTES.
- 14. TYPICAL UNIT LAUNDRY ELEVATION -DRYER BOX FOR ALL DRYERS: THE DRYERBOX BY IN-O-VATE TECHNOLOGIES, INC. MODEL 425, www.dryerbox.com

UNIT ACCESSIBILITY NOTES:


- 15. UNITS #1014 & 1016 SHALL MEET ANSI A117.1 FOR ACCESSIBILITY AS TYPE 'A' UNITS.
- 16. ELECTRICAL FOR ALL ACCESSIBLE UNITS SHALL BE MOUNTED TO MEET ACCESSIBILITY STANDARDS: 15" MIN AFF TO 48" MAX AFF.

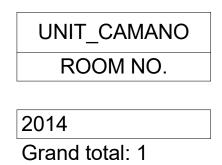


UNIT_FOX
ROOM NO.

2000	
3000	
Gran	d total: 2

in site architects 1000 university ave. w. 🛚 suite 130 st. paul, minnesota 55104 612-252-4820 I hereby certify that this document was prepared by me or under my direct supervision and that I am a duly licensed architect under the laws of the State of Washington SEE BELOW Signature Dawn Wieczorek Typed or Printed Name 11192 6/02/23 License # Date 11192 EGISTERE ARCHITECT N Ω m $\supset \geq$ 7 ш $\mathbf{\Omega}$ Ω PU S ш \mathbf{N} \bigcirc Ш S City of Puyallup elopment & Permitting Servic ISSUED PERMIT Building Planning Engineering Public Works
Fire Traffic PRMU20230881 PERMIT APP# PRMU20230881 PERMIT SET JUNE 02, 2023 REVISIONS No. Description Date 2108_ PROJECT NUMBER Author_ Checker DRAWN BY CHECKED BY WESLEY BRADLEY PARK 2 EAST BROWNSTONE ENLARGED UNIT PLANS A2.2

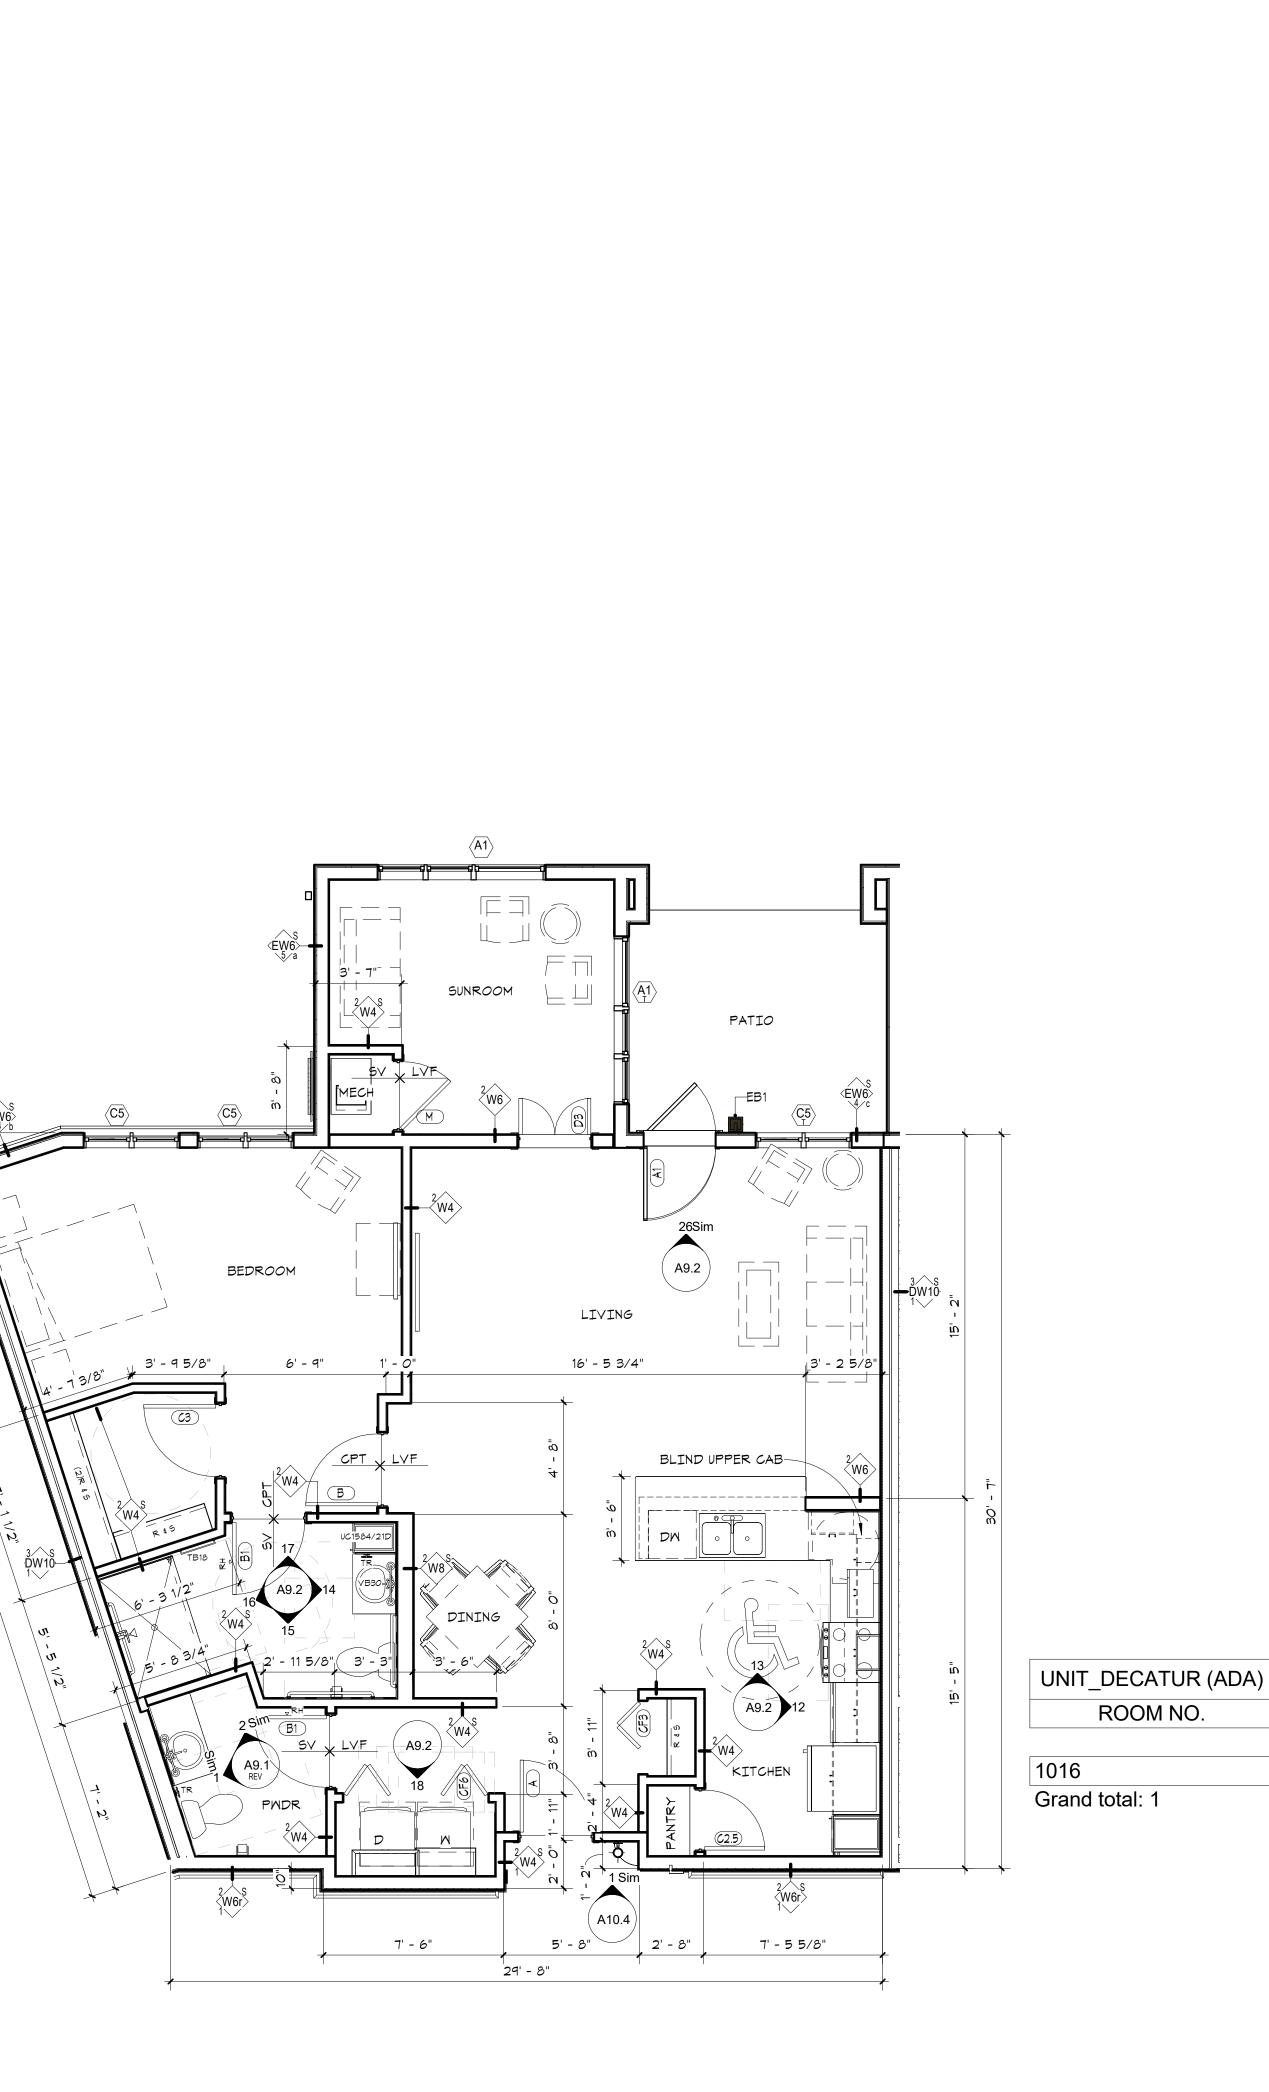

					TYPI	CAL U	NIT DOOF	R SCH	EDULE				DO
DOOR				DOOR			F	RAME			FIRE		1. FI
NO.	NAME	WIDTH	HT TI	IK TYPE	MAT	FIN	TYPE	MAT	FIN	HDWR	RATING	COMMENTS	2. U
٨	ENTRY	3' - 0"	6' - 8" 1 3	8/4" AP	SCHB	PT	F1	DW	PT	039U99	20 MIN-S	CONCEALED DROP BOTTOM	3. D
	ENTRY	3' - 0"		8/4" RP-1	IF	PT PT	F1 F5	WD	PREFIN				_
	BED/BATH	3 - 0"	6' - 8" 1				PREHUNG	WD	PREFIN	039U97 011U	-	EXTERIOR/WD TRIM INTERIOR/FG STORM DR	4. S
	BATH	3' - 0"		8/4" RP			PREHUNG	WD	PREFIN	011U			5. F
	BED/BATH POCKET	3' - 0"		8/4" RP			PREHUNG	WD	PREFIN	006C		POCKET W/PULL BOTH SIDES	SAF
C2.5	CLOSET	2' - 6"	6' - 8" 13	3/4" RP		-	PREHUNG	WD	PREFIN	010U			
C3	CLOSET	3' - 0"	6' - 8" 1 3	3/4" RP	SCHB	PREFIN	PREHUNG	WD	PREFIN	010U			GL
CF2.5	CLOSET	2' - 6"	6' - 8" 13	3/4" RP	HCHB	PREFIN	PREHUNG	WD	PREFIN	005		BIFOLD - FULL JAMB	
CF3	CLOSET	3' - 0"	6' - 8" 13	3/4" RP	HCHB	PREFIN	PREHUNG	WD	PREFIN	005		SINGLE BIFOLD - FULL JAMB	IN
CF4	CLOSET	4' - 0"	6' - 8" 13	3/4" RP	HCHB	PREFIN	PREHUNG	WD	PREFIN	005A		BIFOLD PAIR - FULL JAMB	IT
CF5	CLOSET	5' - 0"	6' - 8" 13	3/4" RP	HCHB	PREFIN	PREHUNG	WD	PREFIN	005A		BIFOLD PAIR - FULL JAMB	P
CF6	CLOSET	6' - 0"	6' - 8" 13	3/4" RP	HCHB	PREFIN	PREHUNG	WD	PREFIN	005A		BIFOLD PAIR - FULL JAMB	
CP3	POCKET/CLOSET	3' - 0"	6' - 8" 1 3	3/4" RP	HCHB	PREFIN	PREHUNG	WD	PREFIN	006B		POCKET W/PULL BOTH SIDES	F W
D3	SUNROOM	3' - 0"	6' - 8" 1 3	3/4" FG-MUNTINS	SCWD	PREFIN	PREHUNG	WD	PREFIN	025U		PAIR	
D4	SUNROOM	4' - 0"	6' - 8" 13	3/4" FG-MUNTINS	SCWD	PREFIN	PREHUNG	WD	PREFIN	025U		PAIR	DC
D5	CLOSET	5' - 0"	6' - 8" 1 3	8/4" RP	HCHB	PREFIN	PREHUNG	WD	PREFIN	010U			
DP5	DEN	5' - 0"	6' - 8" 13	3/4" FG-MUNTINS	SCWD	PREFIN	PREHUNG	WD	PREFIN	006A		PAIR/MUNTINS/POCKET/PULL BOTH SIDES	ALU AP
Μ	MECHANICAL	2' - 10"	6' - 8" 13	3/4" RP	SCHB	PREFIN	PREHUNG	WD	PREFIN	015U		SMOKE SEAL & SILL	CA
0	OPENING	5' - 0"	7' - 0"					WD	ST			CASED OPENING	CL

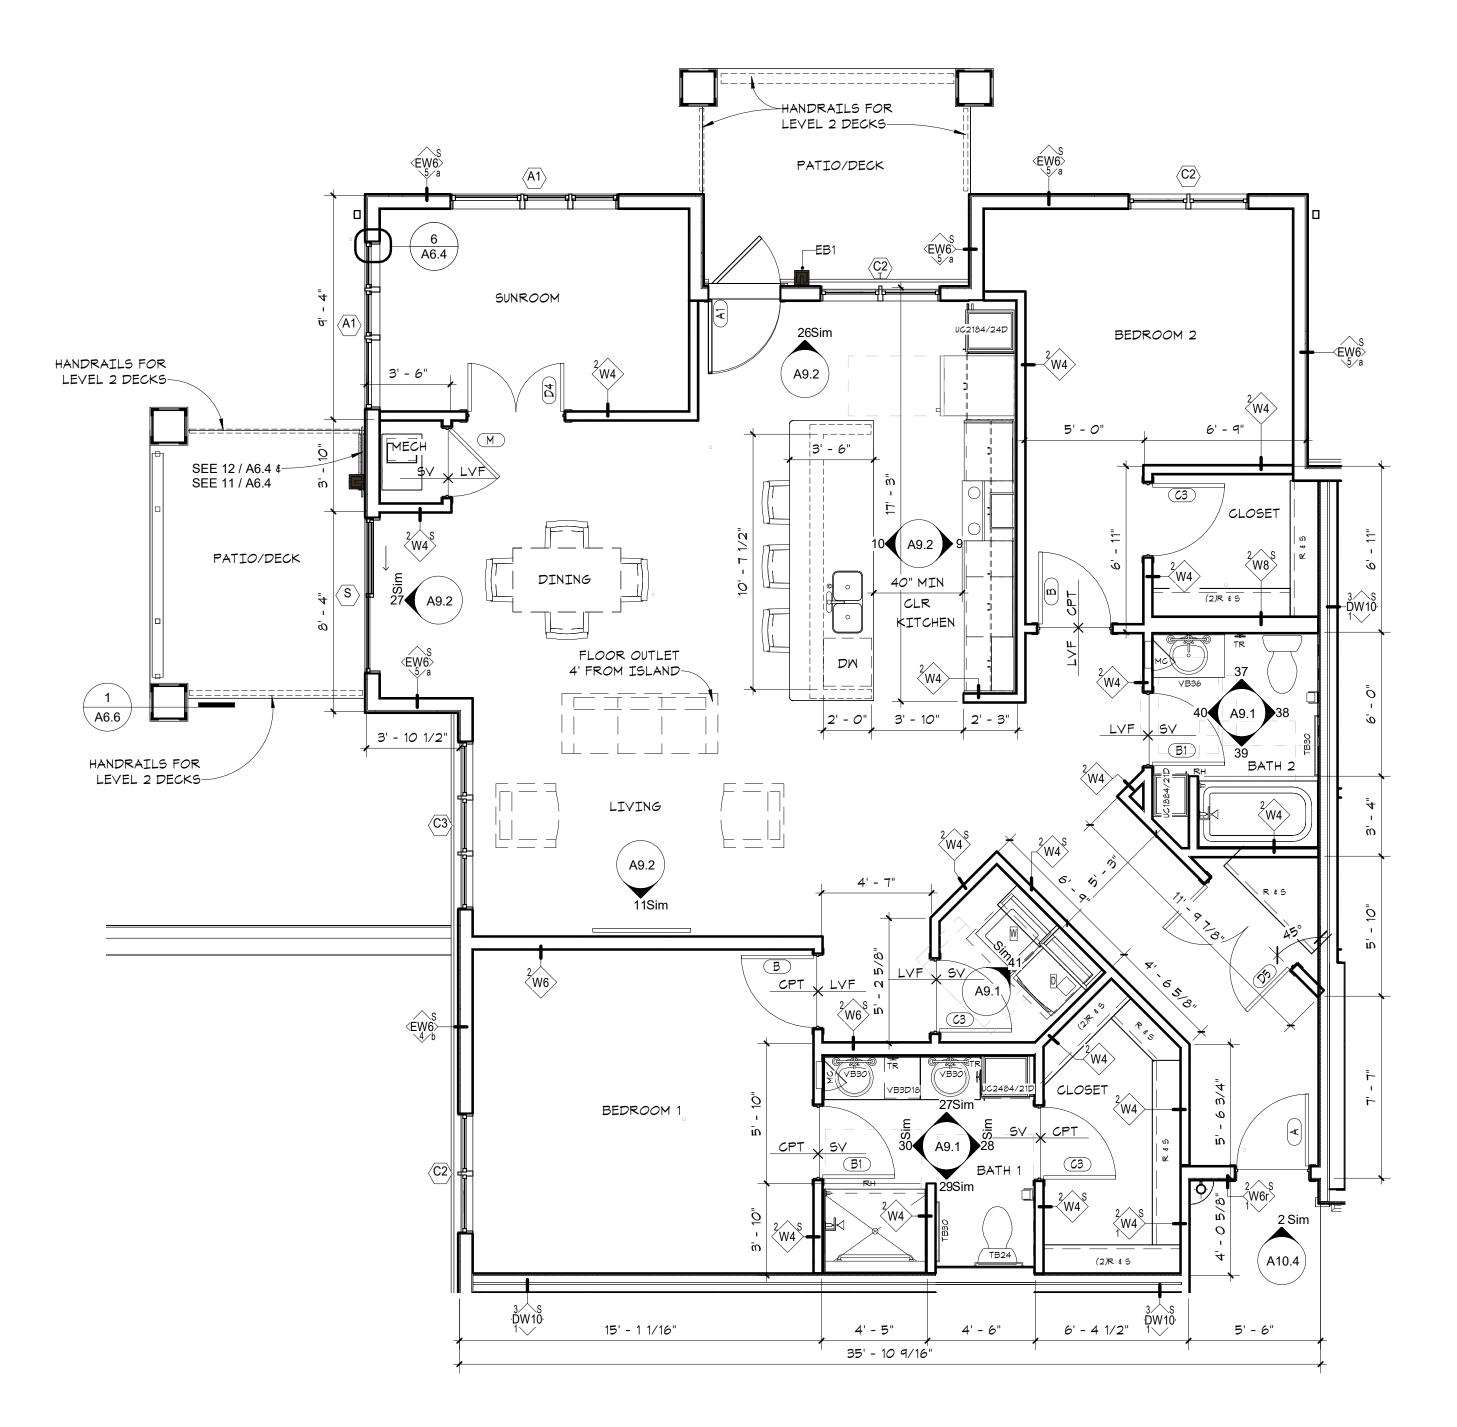



DOOR A	ND WINDOW NOTES		
. FIRE RA	TING LABELS ARE SHOWN IN MINU	ITES UNO.	
2. UNDERC	UT AT ALL INTERIOR DOORS UNO		
B. DOOR H	ARDWARE TO BE CENTERED ON F	RAIL OF PAN	IEL DOORS.
SEE A11	.1 FOR DOOR TYPES		
	TO ELEVATIONS AND PLANS FOR V AZING TO MEET IBC 2406.	WINDOWS L	OCATIONS REQUIRING
GLAZINO	G TYPES		
T 1" INSU P 1/4" PL/ T 1/4" TE T 1/4" FR	JLATED NON-TEMPERED JLATED TEMPERED ATE GLASS MPERED OSTED GLASS RED GLASS		
DOOR A	ND WINDOW ABBREVIATIO	ONS	
ALUM AP CA CL DW G G RP TCHB ICHB	ALUMINUM FLUSH W/ APPLIED MLDG CASEMENT WINDOW CHAIN LINK DRYWALL FLUSH FULL GLASS FIBERGLASS REINFORCED PLASTIC FIXED WINDOW HOLLOW CORE HARDBOARD HOLLOW CORE WOOD	NL OC OH PLAM PREFIN PT RP SCHB SCR SCW SH SL	NARROW LITE OVERHEAD COILING OVERHEAD SEGMENTAL PLASTIC LAMINATE PRE-FINISHED PAINT RAISED PANEL SOLID CORE HARDBOARD SCREEN SOLID CORE WOOD SINGLE HUNG WINDOW SLIDING/GLIDING WINDOW
IM IMKD F M	HOLLOW METAL HOLLOW METAL KNOCKED DOWN INSULATED FIBERGLASS INSULATED METAL	SL STL TR CLWD WD	SLIDING/GLIDING WINDOW STAIN STEEL TRAFFIC DOOR (SOLID CORE) CLAD WOOD WOOD
M //CWV	INSULATED METAL MINERAL CORE WD VENEER	WD	WOOD

FG

FRP

HCHB

HCW

HM

IM

HMKD

_MCWV____

FΧ

UNIT PLAN NOTES

AND EQUIPMENT.

- **GENERAL UNIT NOTES:** 1. ALL BATHROOM WALLS SHALL BE INSULATED.
- REFER TO OVERALL PLANS FOR WINDOW PLACEMENT AND VERIFICATION OF DEMISING WALL TYPES - AS THEY MAY VARY EVEN WITHIN SAME UNIT TYPE. ALSO REFER TO STRUCTURAL FOR SHEAR WALL LOCATIONS.
- . PROVIDE ROLL-OUT SHELVES AS FOLLOWS: (1) PER KITCHEN BASE CABINET (4) PER KITCHEN PANTRY CABINET (1) PER BATHROOM LINEN CABINET
- REFER TO SPECIFICATIONS FOR MINIMUM QUANTITIES OF TOILET ACCESSORIES
- PER UNIT. 5. REFER TO SPECIFICATIONS FOR TYPICAL CABINET FEATURES PER UNIT.
- 6. SEE SHEET A9.1 FOR MOUNTING HEIGHTS DIAGRAM FOR TYPICAL ACCESSORIES
- 7. SEE SHEET A10.3 FOR TYPICAL UNIT ENTRY ELEVATIONS.
- 8. AT LAUNDRY CLOSETS, INSTALL PAINTED METAL LOUVER CENTERED ABOVE
- CLOSET DOOR. LOUVER TO HAVE 120 SQ IN FREE VENTILATING AREA MIN.
- 9. SEE UNIT BATH ELEVATIONS ON A9.1 & A9.2 FOR VANITY MIRROR SIZES.
- 10. SEE INTERIORS (ID) FOR FINISHES. 11. SEE 11/A9.2 FOR FIREPLACE ELEVATION.
- 12. PROVIDE (5) MELAMINE SHELVES FOR EACH PANTRY CLOSET. SEE PLANS FOR SHELF CONFIGURÁTION.
- 13. SEE SHEET A2.3 FOR TYPICAL UNIT DOORS AND ROOM FINISHES. SEE SHEET A10.1 FOR WALL TYPES AND NOTES.
- 14. TYPICAL UNIT LAUNDRY ELEVATION -DRYER BOX FOR ALL DRYERS: THE DRYERBOX BY IN-O-VATE TECHNOLOGIES, INC. MODEL 425, www.dryerbox.com

UNIT ACCESSIBILITY NOTES:

- 15. UNITS #1014 & 1016 SHALL MEET ANSI A117.1 FOR ACCESSIBILITY AS TYPE 'A' UNITS.
- 16. ELECTRICAL FOR ALL ACCESSIBLE UNITS SHALL BE MOUNTED TO MEET ACCESSIBILITY STANDARDS: 15" MIN AFF TO 48" MAX AFF.


UNIT_VANCOUVER ROOM NO.

1024
1025
2024
2025
3024
3025
Original totals C

Grand total: 6

in site architects 1000 university ave. w. ■ suite 130 st. paul, minnesota 55104 612-252-4820 I hereby certify that this document was prepared by me or under my direct supervision and that I am a duly licensed architect under the laws of the State of Washington SEE BELOW Signature Dawn Wieczorek Typed or Printed Name 11192 6/02/23 License # Date 11192 REGISTEREC ARCHITECT N \Box 4 α m <u>, г</u> ОО ШŐ $\square \triangleleft$ $\supset \geq$ **7** > \square D D C \mathcal{O} City of Puyallup velopment & Permitting Servic ISSUED PERMIT Building Engineering Public Works Fire Traffic PRMU20230881 PERMIT APP# PRMU20230881 PERMIT SET JUNE 02, 2023 REVISIONS Date No. Description 2108_ PROJECT NUMBER Author_ Checker DRAWN BY CHECKED BY WESLEY BRADLEY PARK 2 EAST BROWNSTONE ENLARGED UNIT PLANS A2.3

DOOR NO.	
A	ENT
A1	ENT
В	BED
B1	BAT
BP	BED
C2.5	CLC
C3	CLC
CF2.5	CLC
CF3	CLC
CF4	CLC
CF5	CLC
CF6	CLC
CP3	POC
D3	SUN
D4	SUN
D5	CLC
DP5	DEN
М	ME
0	OPE

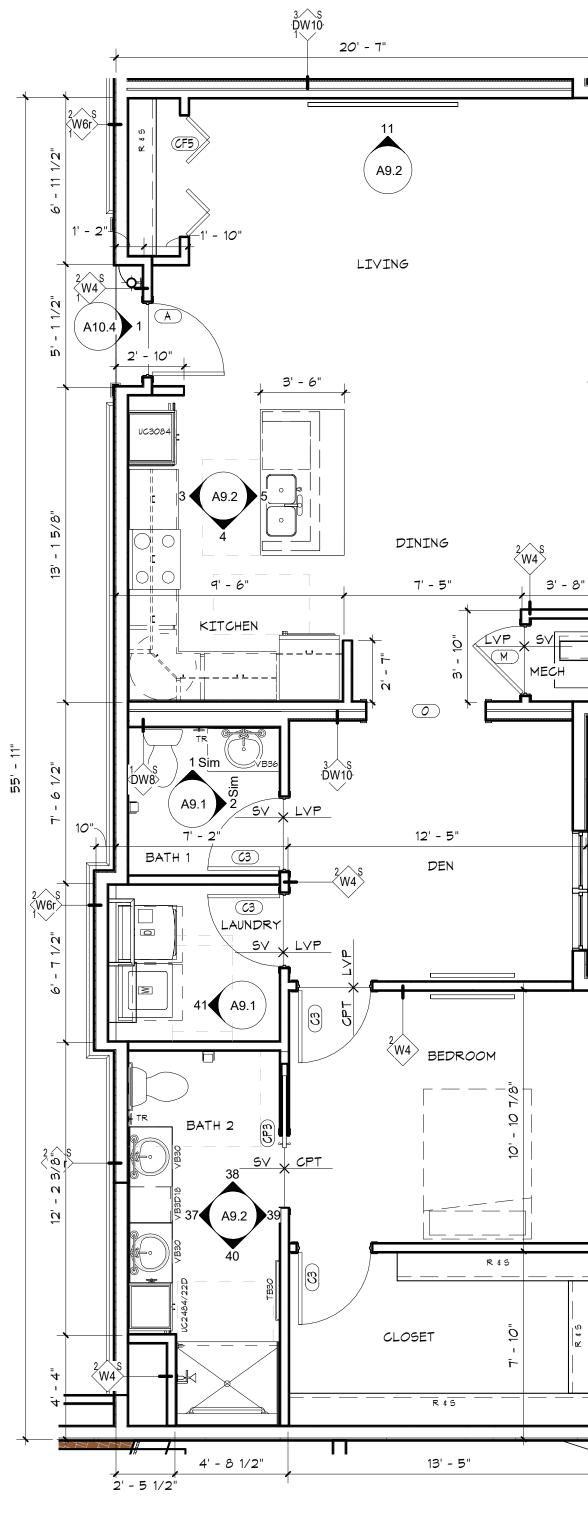

2 IL UNIT - LUMMI A2.4 1/4" = 1'-0"

					TYPI	CAL UI	NIT DOOF	R SCHI	EDULE				
			[DOOR			F	RAME			FIRE		
NAME	WIDTH	HT	THK	TYPE	MAT	FIN	TYPE	MAT	FIN	HDWR	RATING	COMMENTS	
ITRY	3' - 0"	6' - 8"	1 2/4"	AP	SCHB	PT	F1	DW	PT	039U99	20 MIN-S	CONCEALED DROP BOTTOM	
ITRY	3' - 0"	6' - 8"		RP-1	IF	PT	F1	WD	PREFIN	039U99	20 101111-3	EXTERIOR/WD TRIM INTERIOR/FG STORM DR	
D/BATH	3 - 0"			RP-1		PREFIN	PREHUNG	WD	PREFIN	039097	-	EXTERIOR/WD TRIM INTERIOR/FG STORM DR	
	3 - 0	6' - 8"		RP			PREHUNG	WD	PREFIN	0110			
D/BATH POCKET	3' - 0"	6' - 8"		RP			PREHUNG	WD	PREFIN	006C		POCKET W/PULL BOTH SIDES	
OSET	2' - 6"	6' - 8"		RP			PREHUNG	WD	PREFIN	010U			
OSET	3' - 0"		1 3/4"	RP			PREHUNG	WD	PREFIN	0100			
.OSET	2' - 6"	6' - 8"		RP			PREHUNG	WD	PREFIN	005		BIFOLD - FULL JAMB	
OSET	3' - 0"	6' - 8"		RP			PREHUNG	WD	PREFIN	005		SINGLE BIFOLD - FULL JAMB	
.OSET	4' - 0"	6' - 8"		RP			PREHUNG	WD	PREFIN	005A		BIFOLD PAIR - FULL JAMB	
OSET	5' - 0"		1 3/4"	RP			PREHUNG	WD	PREFIN	005A		BIFOLD PAIR - FULL JAMB	
OSET	6' - 0"			RP			PREHUNG	WD	PREFIN	005A		BIFOLD PAIR - FULL JAMB	
CKET/CLOSET	3' - 0"	6' - 8"	1 3/4"	RP			PREHUNG	WD	PREFIN	006B		POCKET W/PULL BOTH SIDES	
JNROOM	3' - 0"	-		FG-MUNTINS	SCWD	PREFIN	PREHUNG	WD	PREFIN	025U		PAIR	
JNROOM	4' - 0"		1 3/4"	FG-MUNTINS	SCWD	PREFIN	PREHUNG	WD	PREFIN	025U		PAIR	
OSET	5' - 0"	6' - 8"	1 3/4"	RP	HCHB	PREFIN	PREHUNG	WD	PREFIN	010U			
EN	5' - 0"	6' - 8"	1 3/4"	FG-MUNTINS	SCWD	PREFIN	PREHUNG	WD	PREFIN	006A		PAIR/MUNTINS/POCKET/PULL BOTH SIDES	
ECHANICAL	2' - 10"	6' - 8"	1 3/4"	RP	SCHB	PREFIN	PREHUNG	WD	PREFIN	015U		SMOKE SEAL & SILL	
PENING	5' - 0"	7' - 0"						WD	ST			CASED OPENING	

I 1" INSUL 1" INSU 1/4" PLA 1/4" TEN 1/4" FRC V_1/4" WIF DOOR A ALUM FG FRP FΧ HCHB

HCW

HM

HMKD

_MCWV

1 IL UNIT - FIDALGO (ADA) A2.4 1/4" = 1'-0"

2 S W6r


DOOR AND WINDOW NOTES				
. FIRE RATING LABELS ARE SHOWN IN MINUTES UNO.				
2. UNDERCUT AT ALL INTERIOR DOORS UNO.				
B. DOOR HARDWARE TO BE CENTERED ON RAIL OF PANEL DOORS.				
I. SEE A11.1 FOR DOOR TYPES				
5. REFER TO ELEVATIONS AND PLANS FOR WINDOWS LOCATIONS REQUIRING SAFETY GLAZING TO MEET IBC 2406.				
GLAZING TYPES				
N 1" INSULATED NON-TEMPERED T 1" INSULATED TEMPERED P 1/4" PLATE GLASS T 1/4" TEMPERED T 1/4" FROSTED GLASS N 1/4" WIRED GLASS				
DOOR AND WINDOW ABBREVIATIONS				
ALUM ALUMINUM AP FLUSH W/ APPLIED MLDG CA CASEMENT WINDOW CL CHAIN LINK DW DRYWALL FLUSH G FULL GLASS FRP FIBERGLASS REINFORCED PLASTIC FX FIXED WINDOW HCHB HOLLOW CORE HARDBOARD HCW HOLLOW CORE HARDBOARD HCW HOLLOW CORE WOOD HM HOLLOW METAL HMKD HOLLOW METAL	NL OC OH PLAM PREFIN PT RP SCHB SCR SCW SH SCR SL STL STL TR CLWD WD	NARROW LITE OVERHEAD COILING OVERHEAD SEGMENTAL PLASTIC LAMINATE PRE-FINISHED PAINT RAISED PANEL SOLID CORE HARDBOARD SCREEN SOLID CORE WOOD SINGLE HUNG WINDOW SLIDING/GLIDING WINDOW STAIN STEEL TRAFFIC DOOR (SOLID CORE) CLAD WOOD		


UNIT PLAN NOTES

- **GENERAL UNIT NOTES:** 1. ALL BATHROOM WALLS SHALL BE INSULATED.
- . REFER TO OVERALL PLANS FOR WINDOW PLACEMENT AND VERIFICATION OF DEMISING WALL TYPES - AS THEY MAY VARY EVEN WITHIN SAME UNIT TYPE.
- ALSO REFER TO STRUCTURAL FOR SHEAR WALL LOCATIONS. B. PROVIDE ROLL-OUT SHELVES AS FOLLOWS: (1) PER KITCHEN BASE CABINET (4) PER KITCHEN PANTRY CABINET (1) PER BATHROOM LINEN CABINET
- REFER TO SPECIFICATIONS FOR MINIMUM QUANTITIES OF TOILET ACCESSORIES
- PER UNIT.
- 5. REFER TO SPECIFICATIONS FOR TYPICAL CABINET FEATURES PER UNIT. 6. SEE SHEET A9.1 FOR MOUNTING HEIGHTS DIAGRAM FOR TYPICAL ACCESSORIES
- AND EQUIPMENT. 7. SEE SHEET A10.3 FOR TYPICAL UNIT ENTRY ELEVATIONS.
- 8. AT LAUNDRY CLOSETS, INSTALL PAINTED METAL LOUVER CENTERED ABOVE CLOSET DOOR. LOUVER TO HAVE 120 SQ IN FREE VENTILATING AREA MIN.
- 9. SEE UNIT BATH ELEVATIONS ON A9.1 & A9.2 FOR VANITY MIRROR SIZES.
- 10. SEE INTERIORS (ID) FOR FINISHES. 11. SEE 11/A9.2 FOR FIREPLACE ELEVATION.
- 12. PROVIDE (5) MELAMINE SHELVES FOR EACH PANTRY CLOSET. SEE PLANS FOR SHELF CONFIGURÁTION.
- 13. SEE SHEET A2.3 FOR TYPICAL UNIT DOORS AND ROOM FINISHES.
- SEE SHEET A10.1 FOR WALL TYPES AND NOTES. 14. TYPICAL UNIT LAUNDRY ELEVATION -
- DRYER BOX FOR ALL DRYERS: THE DRYERBOX BY IN-O-VATE TECHNOLOGIES, INC. MODEL 425, www.dryerbox.com


UNIT ACCESSIBILITY NOTES:

- 15. UNITS #1014 & 1016 SHALL MEET ANSI A117.1 FOR ACCESSIBILITY AS TYPE 'A' UNITS.
- 16. ELECTRICAL FOR ALL ACCESSIBLE UNITS SHALL BE MOUNTED TO MEET ACCESSIBILITY STANDARDS: 15" MIN AFF TO 48" MAX AFF.

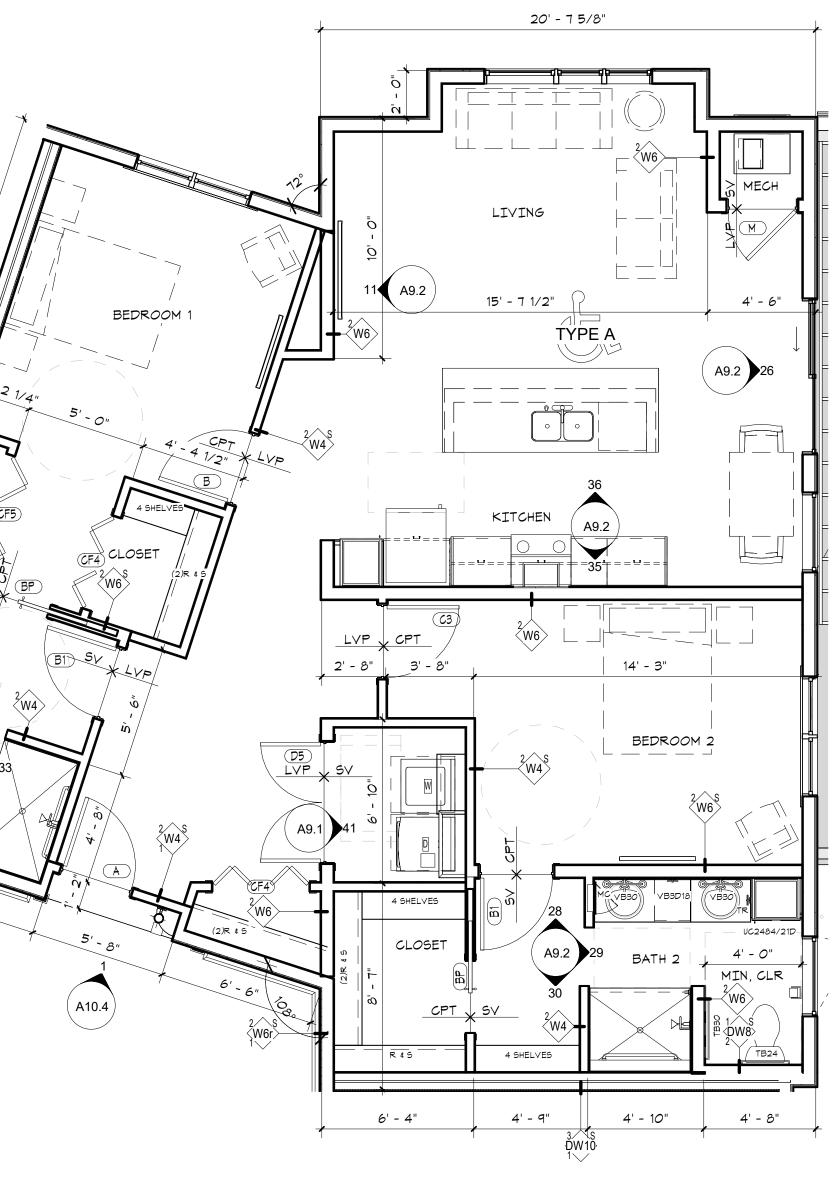

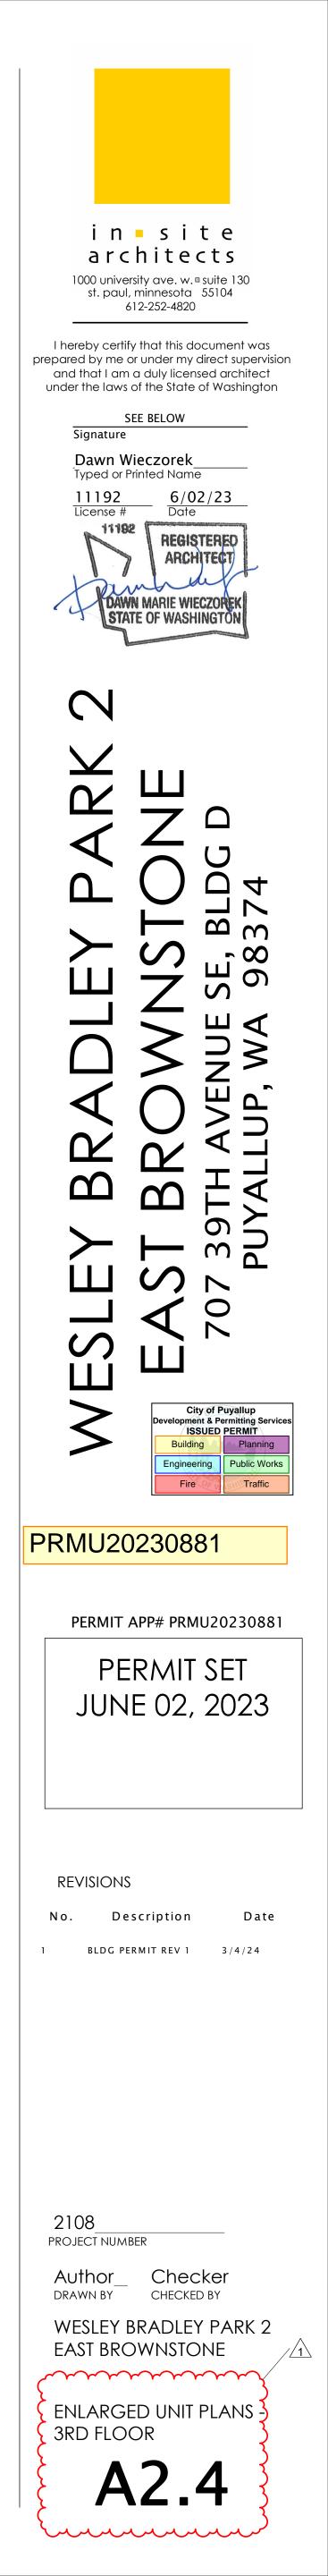




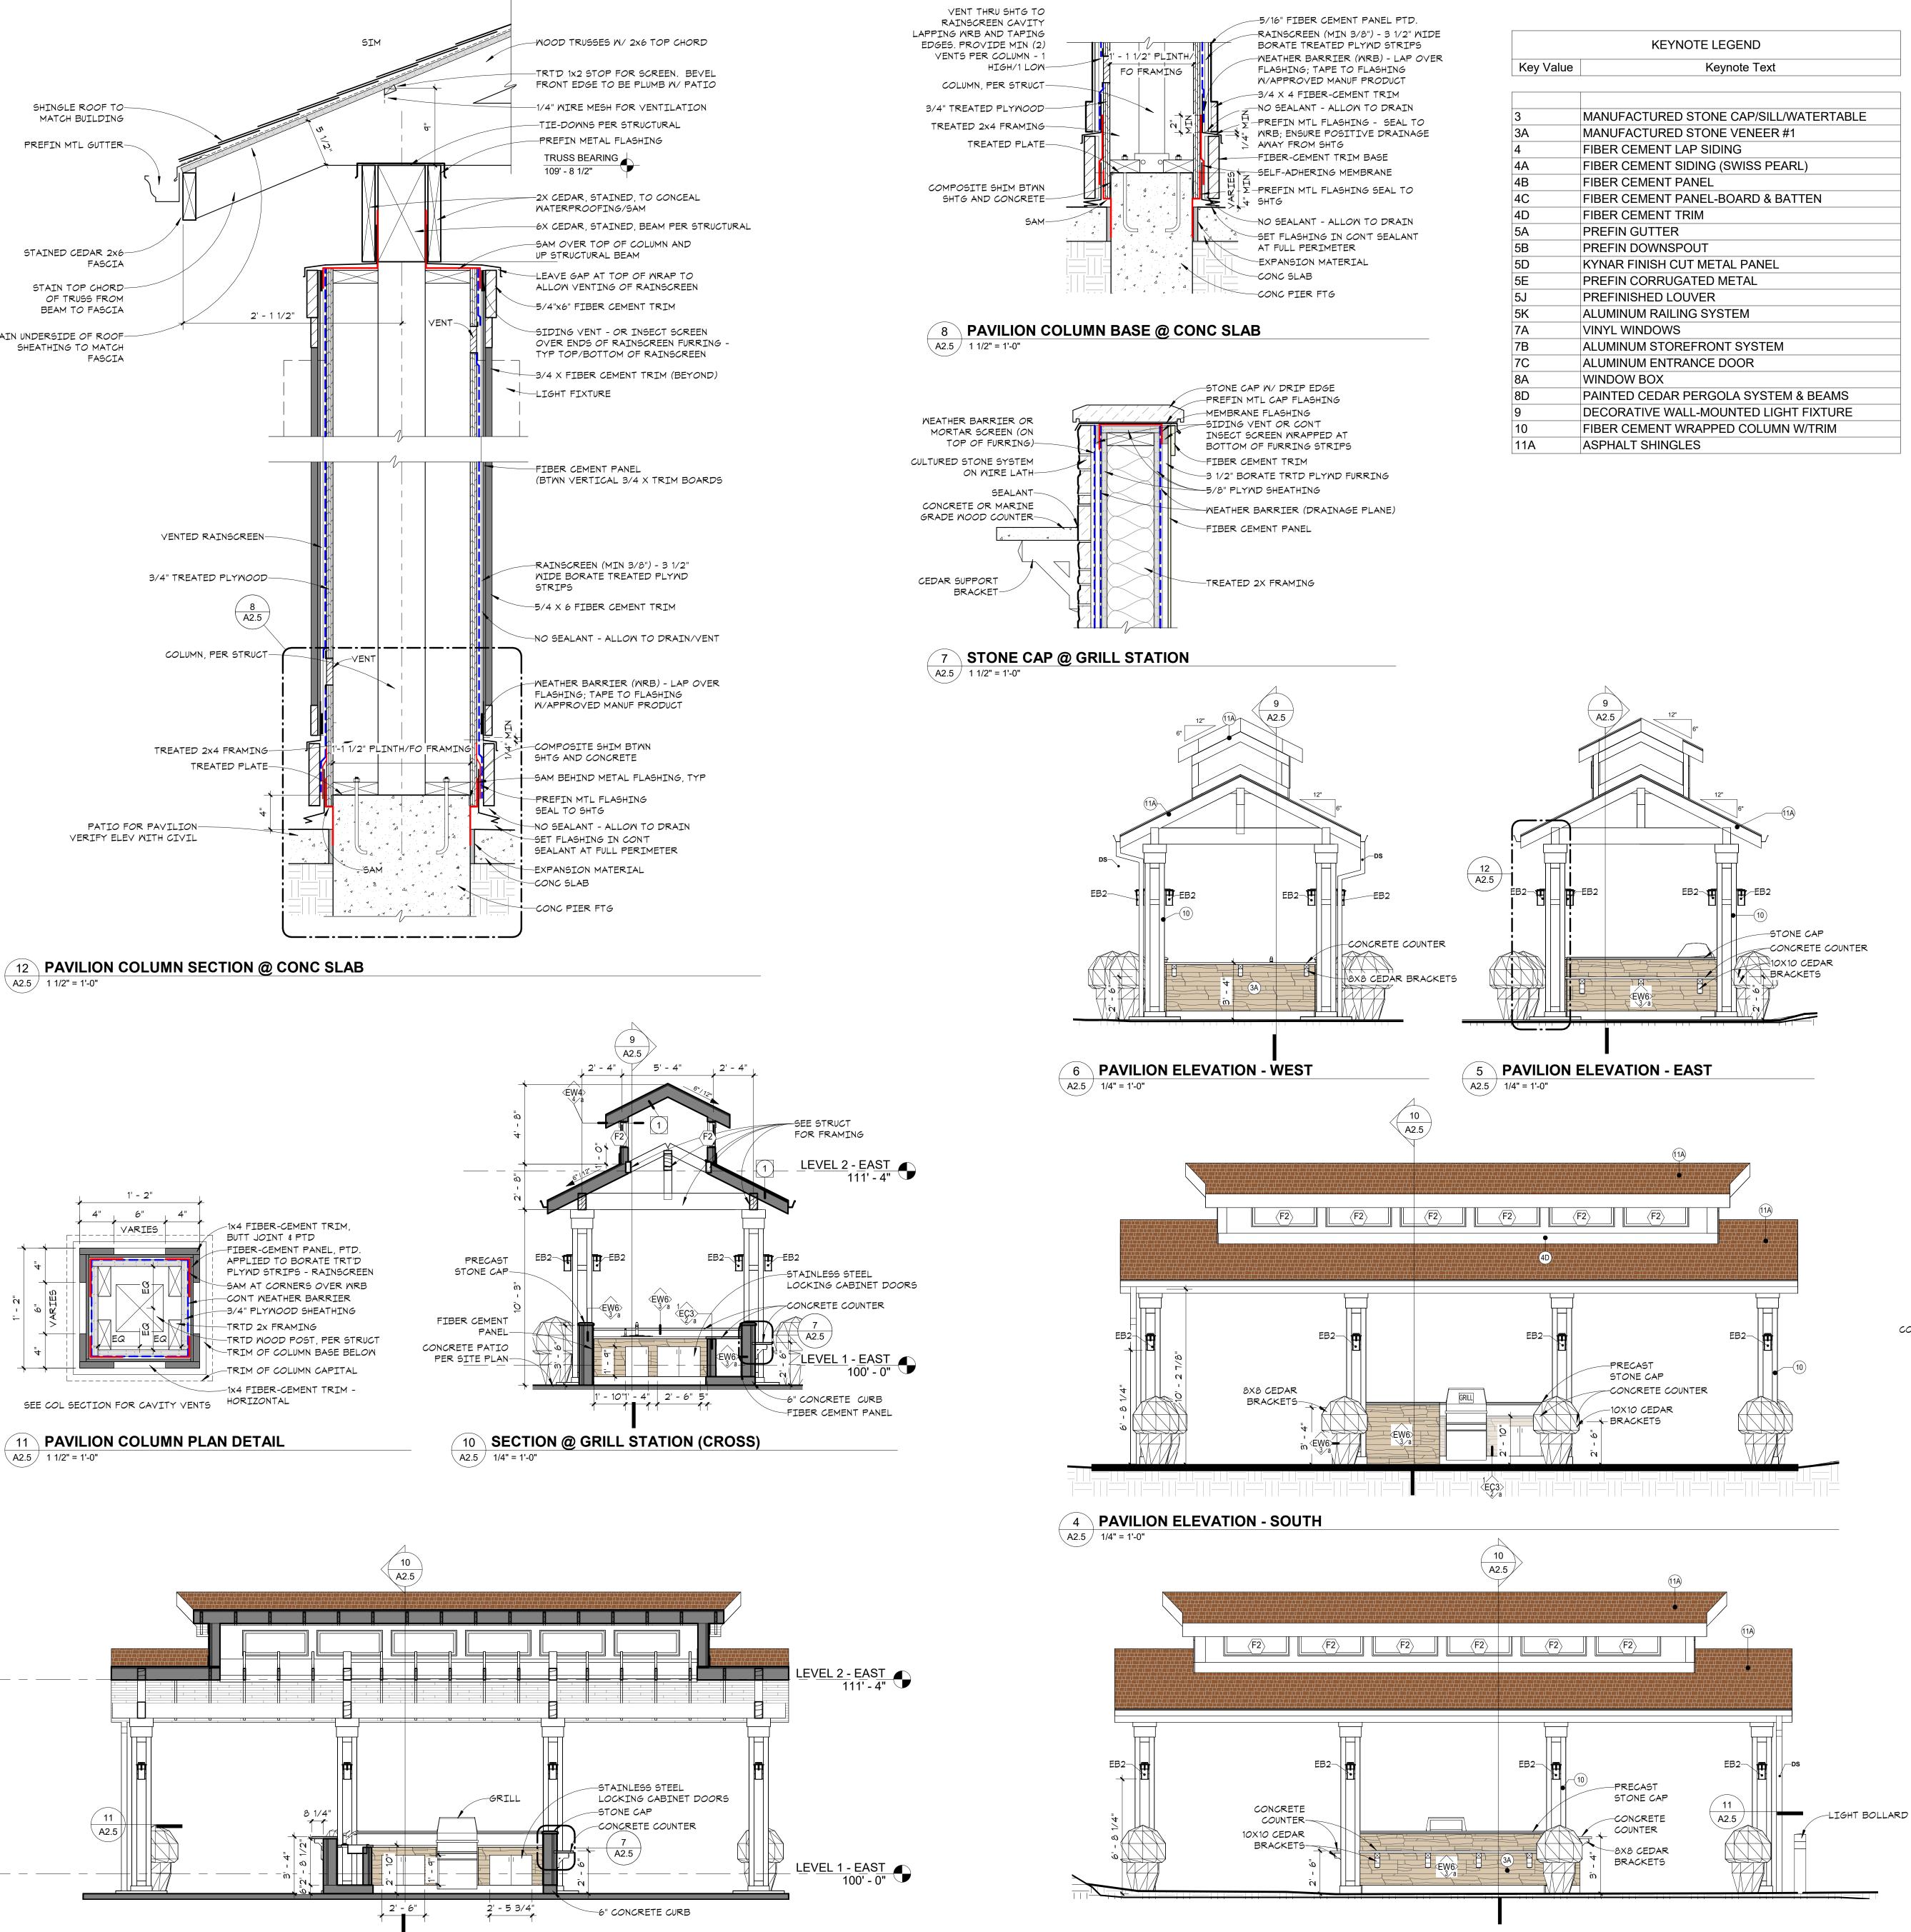









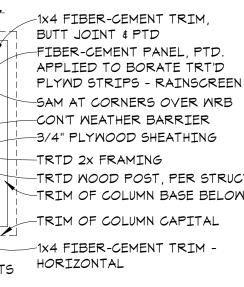


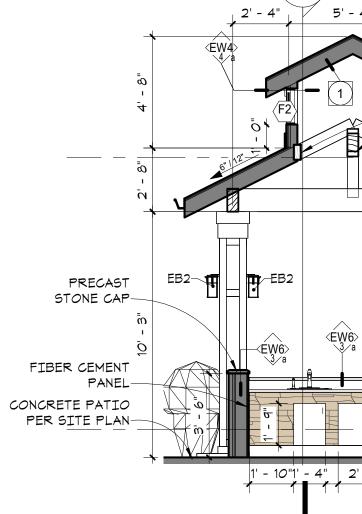

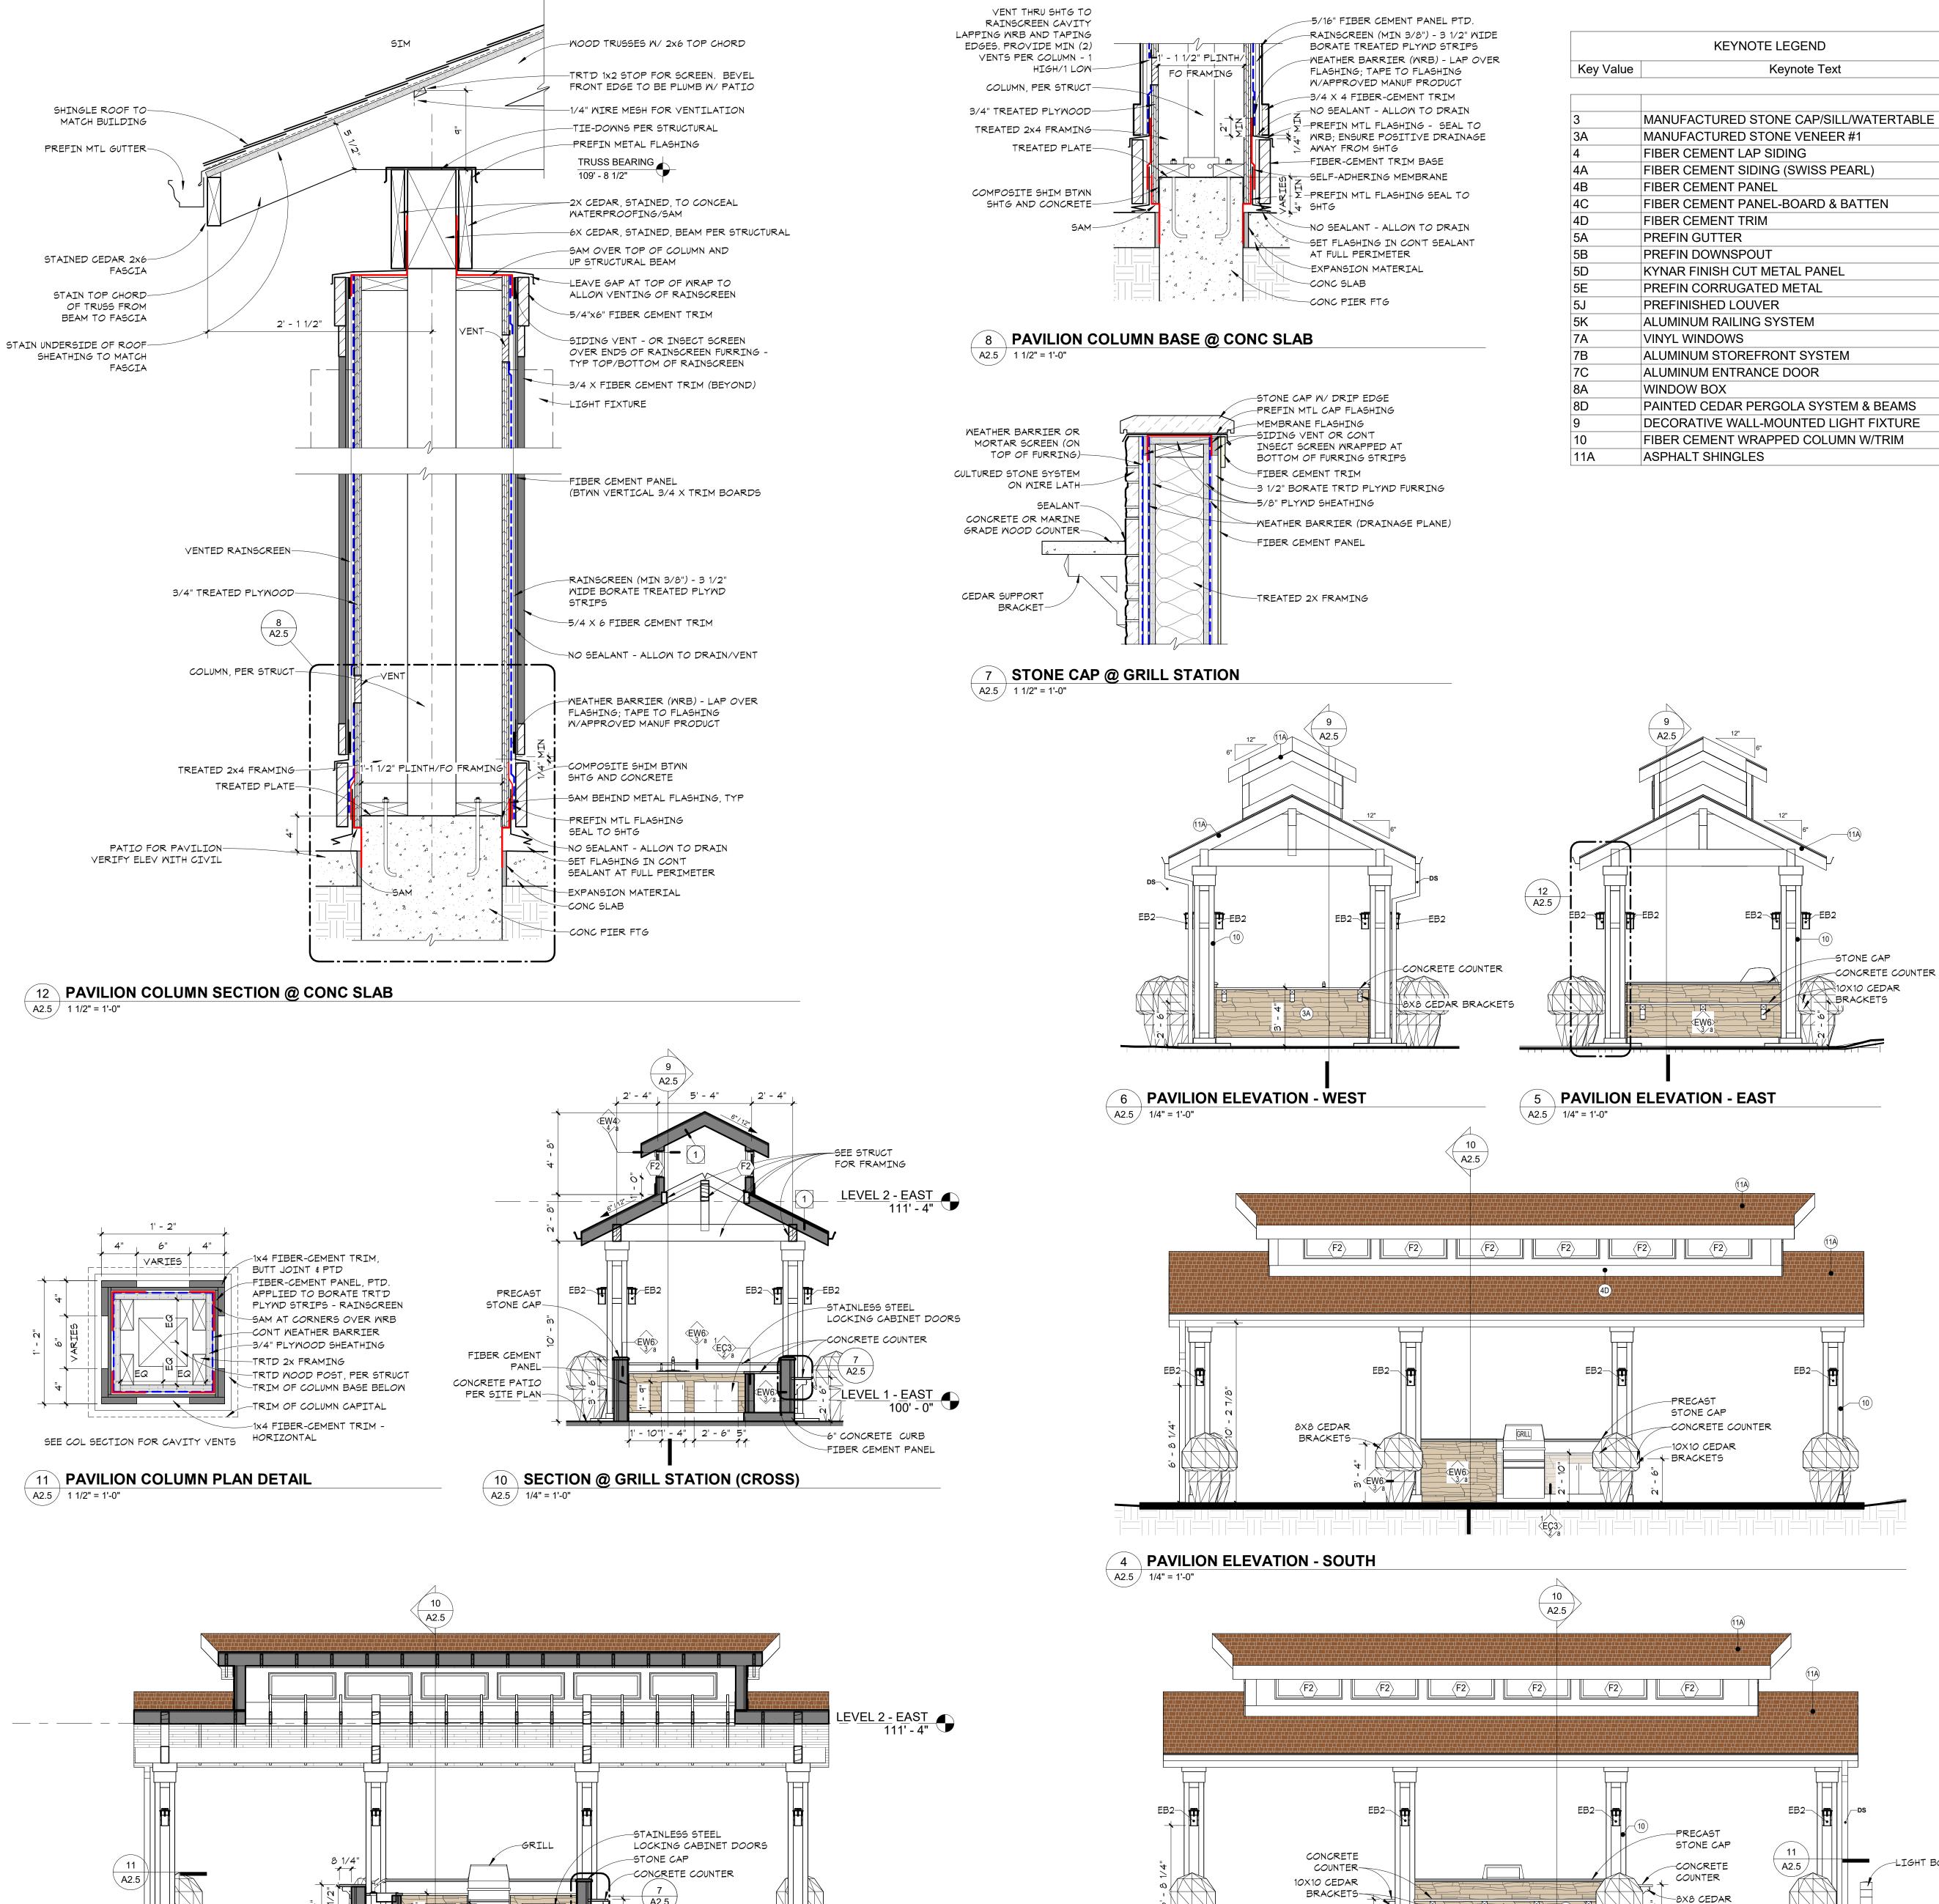

3 PAVILION ELEVATION - NORTH A2.5 1/4" = 1'-0"

alue	Keynote Text
	r
	MANUFACTURED STONE CAP/SILL/WATERTABLE
	MANUFACTURED STONE VENEER #1
	FIBER CEMENT LAP SIDING
	FIBER CEMENT SIDING (SWISS PEARL)
	FIBER CEMENT PANEL
	FIBER CEMENT PANEL-BOARD & BATTEN
	FIBER CEMENT TRIM
	PREFIN GUTTER
	PREFIN DOWNSPOUT
	KYNAR FINISH CUT METAL PANEL
	PREFIN CORRUGATED METAL
	PREFINISHED LOUVER
	ALUMINUM RAILING SYSTEM
	VINYL WINDOWS
	ALUMINUM STOREFRONT SYSTEM
	ALUMINUM ENTRANCE DOOR
	WINDOW BOX
	PAINTED CEDAR PERGOLA SYSTEM & BEAMS
	DECORATIVE WALL-MOUNTED LIGHT FIXTURE
	FIBER CEMENT WRAPPED COLUMN W/TRIM
	ASPHALT SHINGLES

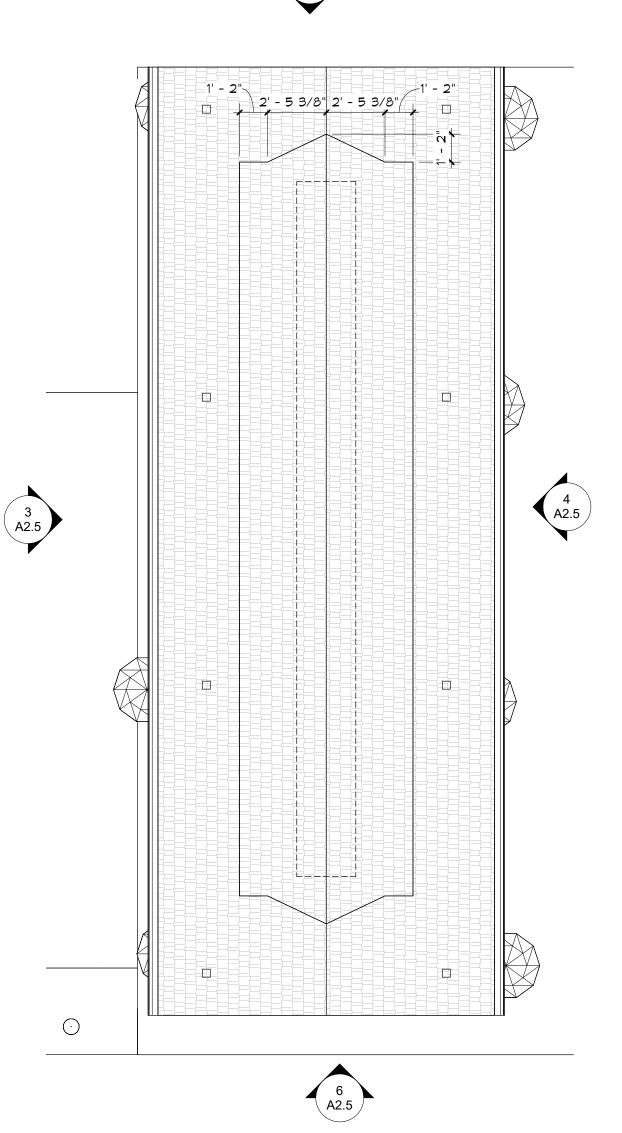


2 PAVILION ROOF PLAN

A2.5 1/4" = 1'-0"

5

🕄 A2.5 🌶

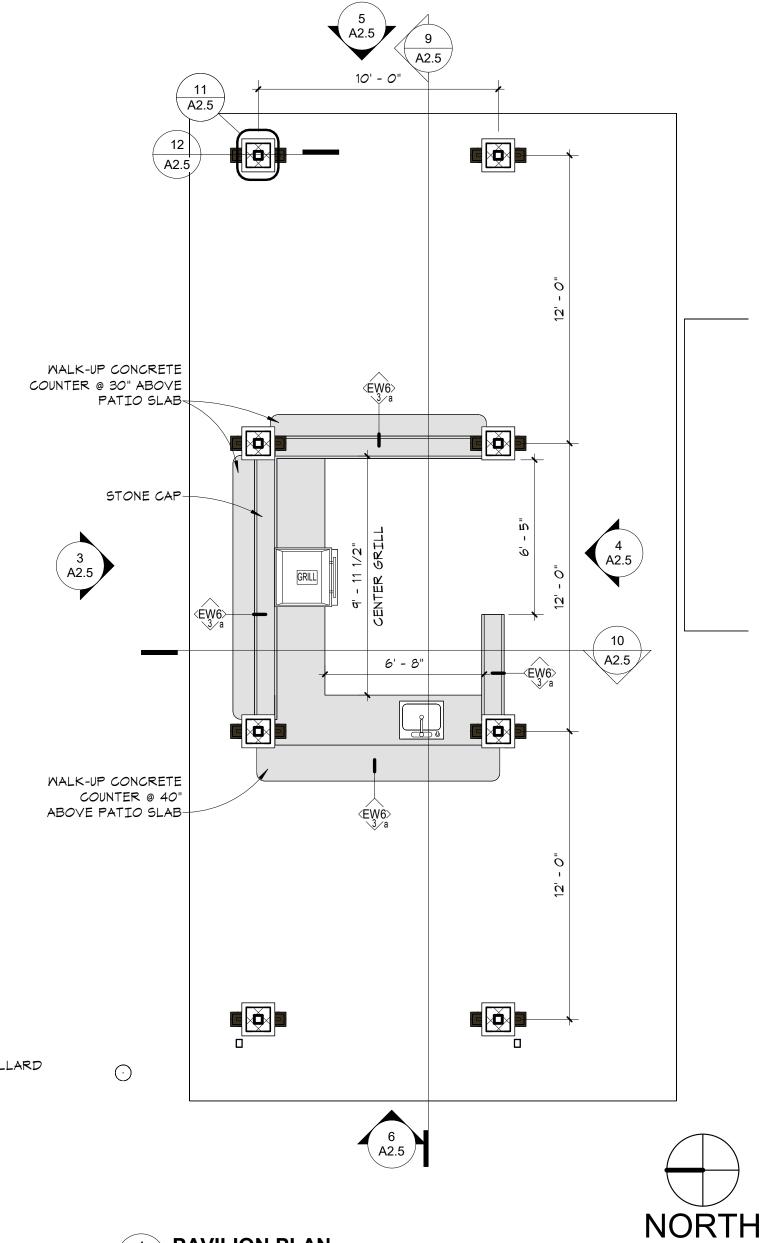


in site architects 1000 university ave. w. = suite 130 st. paul, minnesota 55104 612-252-4820 I hereby certify that this document was prepared by me or under my direct supervision and that I am a duly licensed architect under the laws of the State of Washington SEE BELOW Signature Dawn Wieczorek Typed or Printed Name 11192 6/02/23 License # Date 11192 REGISTERE ARCHITECT **TOAWN** MARIE WIECZORE STATE OF WASHINGT α m $r \infty$ ШО Ш < $\supset \geq$ 7 Щ Ч $\mathbf{\mathcal{L}}$ \square $\mathbf{\Omega}$ **6** m T \mathcal{O} 0 $\boldsymbol{\mathcal{O}}$ Ш City of Puyallup evelopment & Permitting Service: ISSUED PERMIT Building Planning Engineering Public Works
Fire Traffic PRMU20230881 PERMIT APP# PRMU20230881 PERMIT SET JUNE 02, 2023 REVISIONS Date No. Description 1 BLDG PERMIT REV 1 3/4/24 2108 PROJECT NUMBER Author_ Checker CHECKED BY DRAWN BY WESLEY BRADLEY PARK 2 EAST BROWNSTONE PAVILION PLANS, ELEVATIONS & DETAILS Λ7

2 EXTERIOR ELEVATION - TOWER SOUTH A3.1 1/8" = 1'-0"








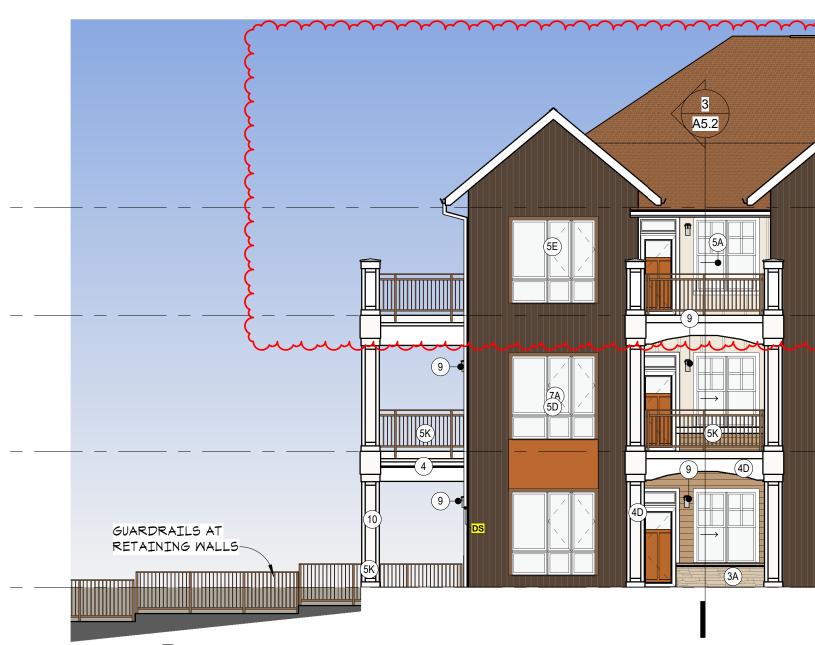



ONLY ACCESS-

EXTERIOR ELEVATION - SOUTH END_OVERALL A3.1 1/8" = 1'-0"

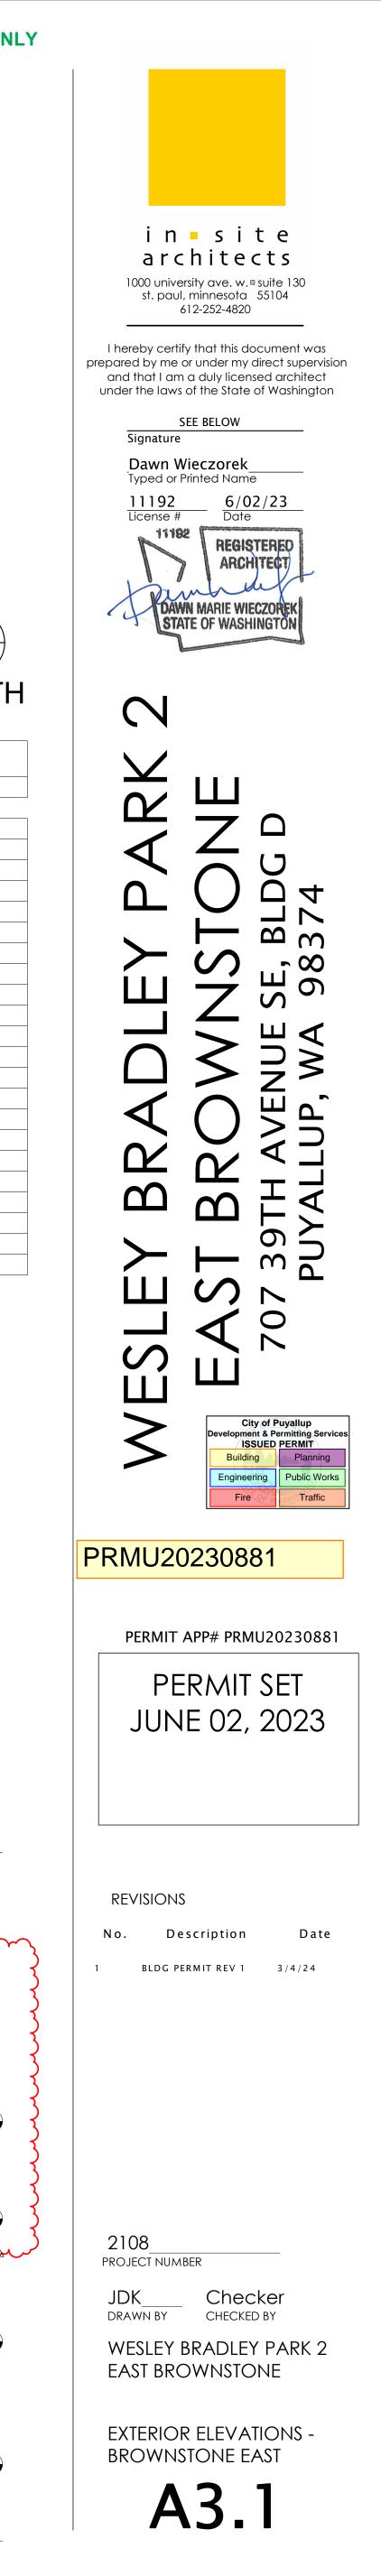

	ALLS	MAT'L TAKEOFF_W
Area TOTAL M	Material: Area	Material: Name
	136	Copper-Look Metal Panel
METAL: 19%	8,279	Metal - Corrugated
	7,328	Siding - Board + Batten (Hardie)
FC (HARDIE):	6,751	Siding - Lap Siding (Hardie)
FC (SWISS PE	5,584	Siding - thru body fiber cement (Swiss Pearl)
MANUFACTURE	17,308	Stone - Ashlar Dry Stack-Natural Color-Warm(1)

MAJOR VISIBLE EXPOSURE FROM THE STREET) NOTE: ALL WINDOWS MEET THE 2' SILL AND 8' HEAD REQUIREMENT, THEREFORE CALCULATIONS ARE DONE AS LF IN LIEU OF SF.


> WHIDBEY UNIT 1010: 27'-4" WHIDBEY UNIT 1012: 27'-4" HERON UNIT 1014: 11'-6"










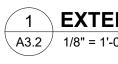

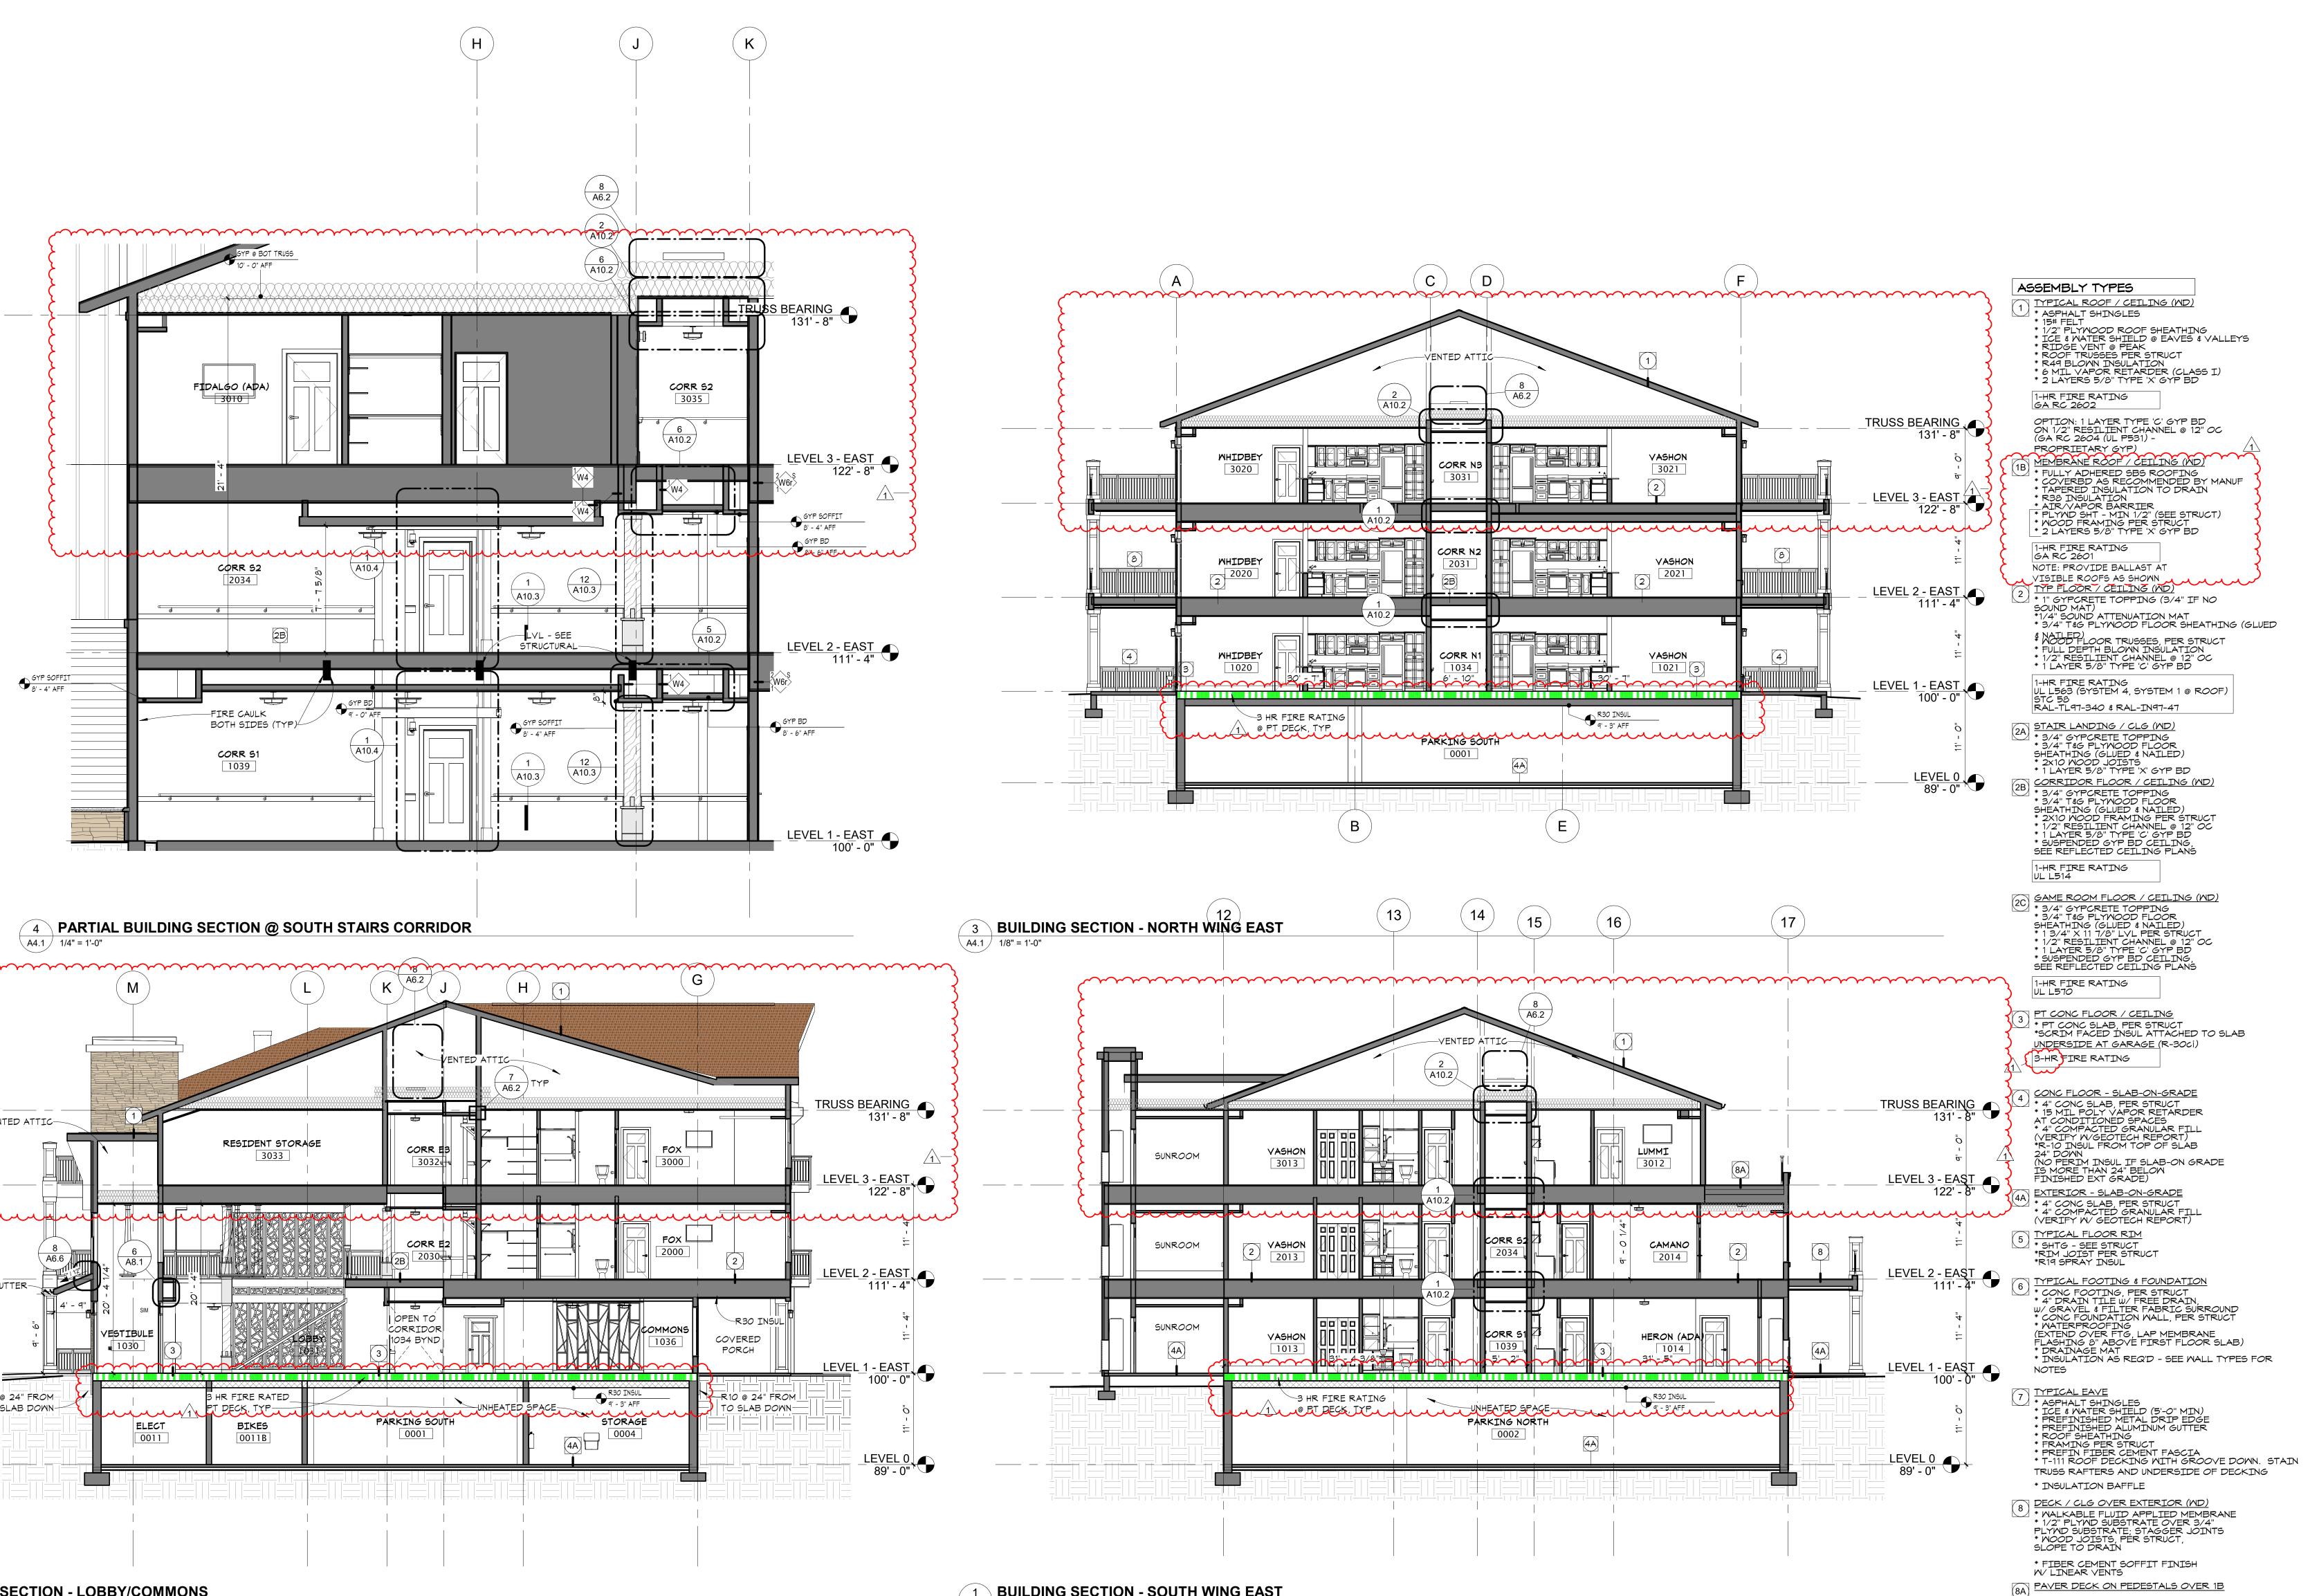






2 BUILDING SECTION - LOBBY/COMMONS A4.1 / 1/8" = 1'-0"

BUILDING SECTION - SOUTH WING EAST A4.1 1/8" = 1'-0"

in site architects 1000 university ave. w. 🛚 suite 130 st. paul, minnesota 55104 612-252-4820 I hereby certify that this document was prepared by me or under my direct supervision and that I am a duly licensed architect under the laws of the State of Washington SEE BELOW Signature Dawn Wieczorek Typed or Printed Name 6/02/23 11192 License # Date 11192 REGISTERE ARCHITECT STATE OF WASHING \sim \neg Δ m $r \infty$ ШŐ ╙┫ $\supset \geq$ 7 Щ こく < ⊒ \mathbf{P} \mathbf{m} $\mathbf{\Omega}$ 5 m T U) 0 5 Ш City of Puyallup velopment & Permitting Services ISSUED PERMIT Building Planning Engineering Public Works Fire Traffic PRMU20230881 PERMIT APP# PRMU20230881 PERMIT SET JUNE 02, 2023 REVISIONS Date Description No. 1 BLDG PERMIT REV 1 3/4/24 2108 PROJECT NUMBER Author Checker DRAWN BY CHECKED BY WESLEY BRADLEY PARK 2 EAST BROWNSTONE BUILDING SECTIONS A4.

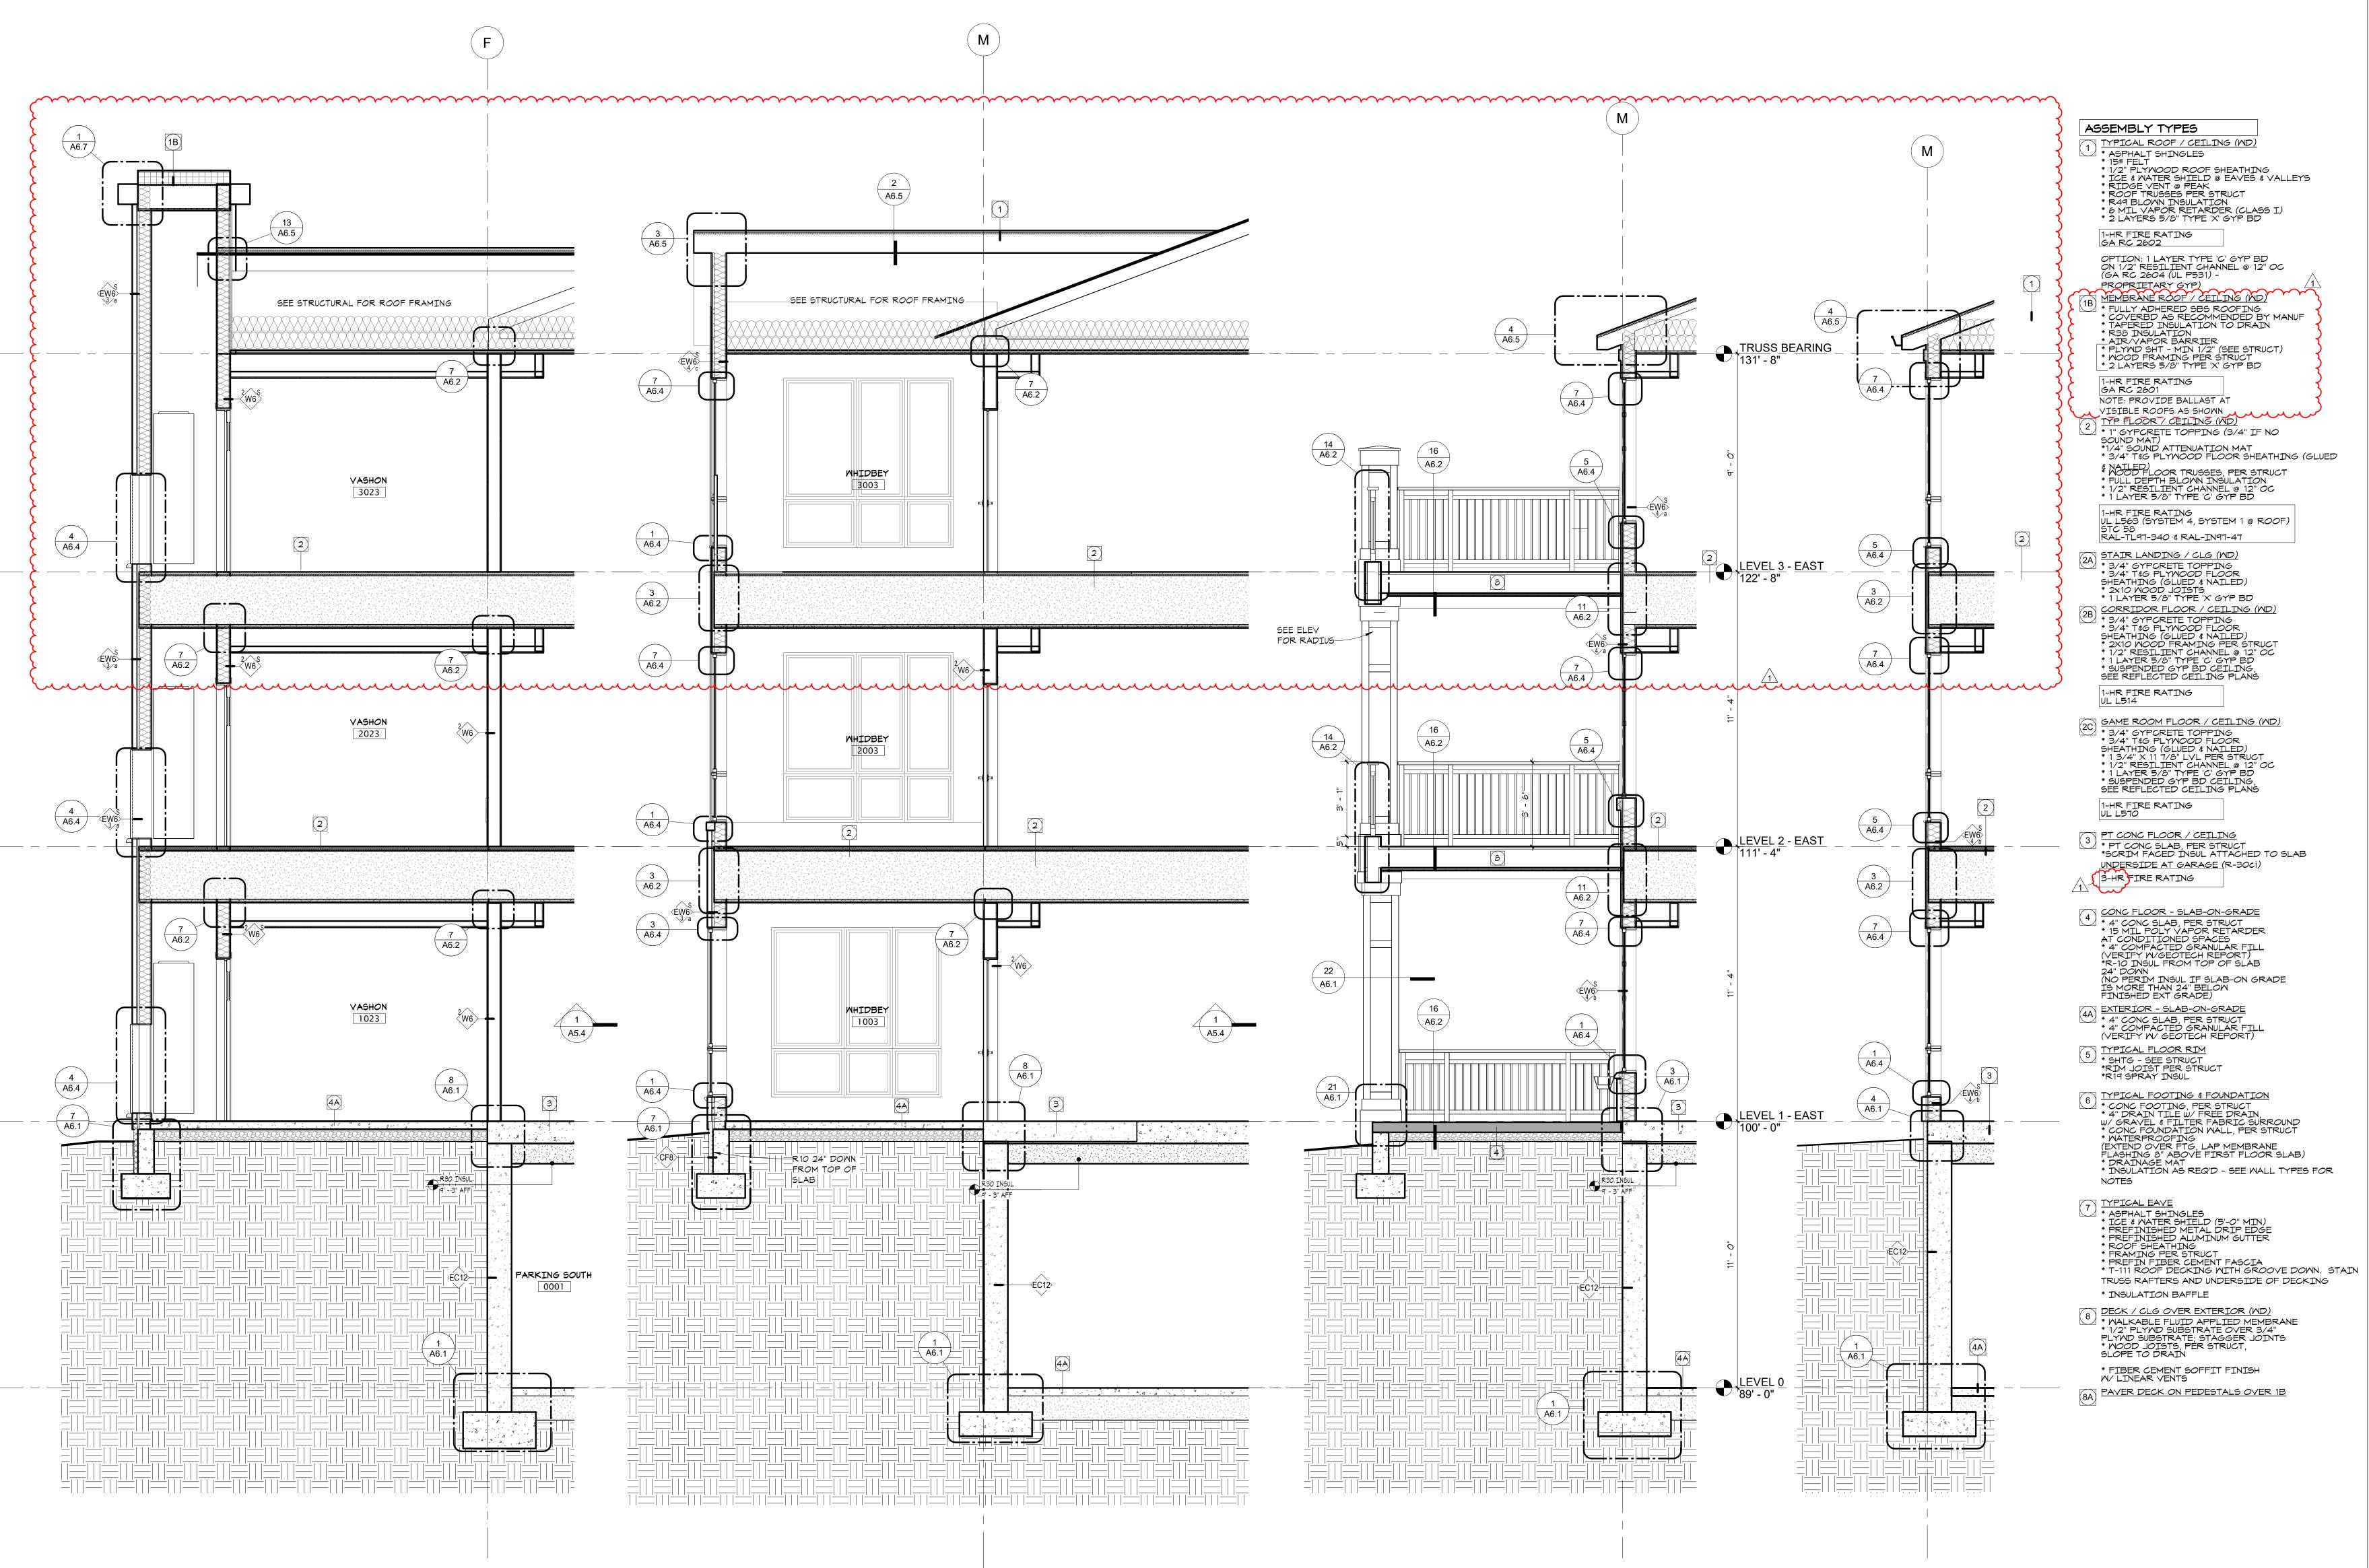


3 **SECTIC** A5.1 3/8" = 1'-0"

2 SECTION @ TYP DECK A5.1 3/8" = 1'-0"

1 SECTION @ TYPICAL WALL

A5.1 3/8" = 1'-0"


in site architects 1000 university ave. w. 🛚 suite 130 st. paul, minnesota 55104 612-252-4820 I hereby certify that this document was prepared by me or under my direct supervision and that I am a duly licensed architect under the laws of the State of Washington SEE BELOW Signature Dawn Wieczorek Typed or Printed Name 11192 6/02/23 License # Date 11192 REGISTERE ARCHITECT DAWN MARIE WIECZORE STATE OF WASHINGT \sim \neg Ω m $r \infty$ ШŐ ш ⊲ $\supset \geq$ 7 Ш \mathbf{P} \square \mathbf{M} 5 - m F U) 0 \mathcal{O} City of Puyallup velopment & Permitting Service ISSUED PERMIT Building Planning Engineering Public Works Fire Traffic PRMU20230881 PERMIT APP# PRMU20230881 PERMIT SET JUNE 02, 2023 REVISIONS Date No. Description 1 BLDG PERMIT REV 1 3/4/24 2108 PROJECT NUMBER Author_ Checker DRAWN BY CHECKED BY WESLEY BRADLEY PARK 2 EAST BROWNSTONE WALL SECTIONS **A5**

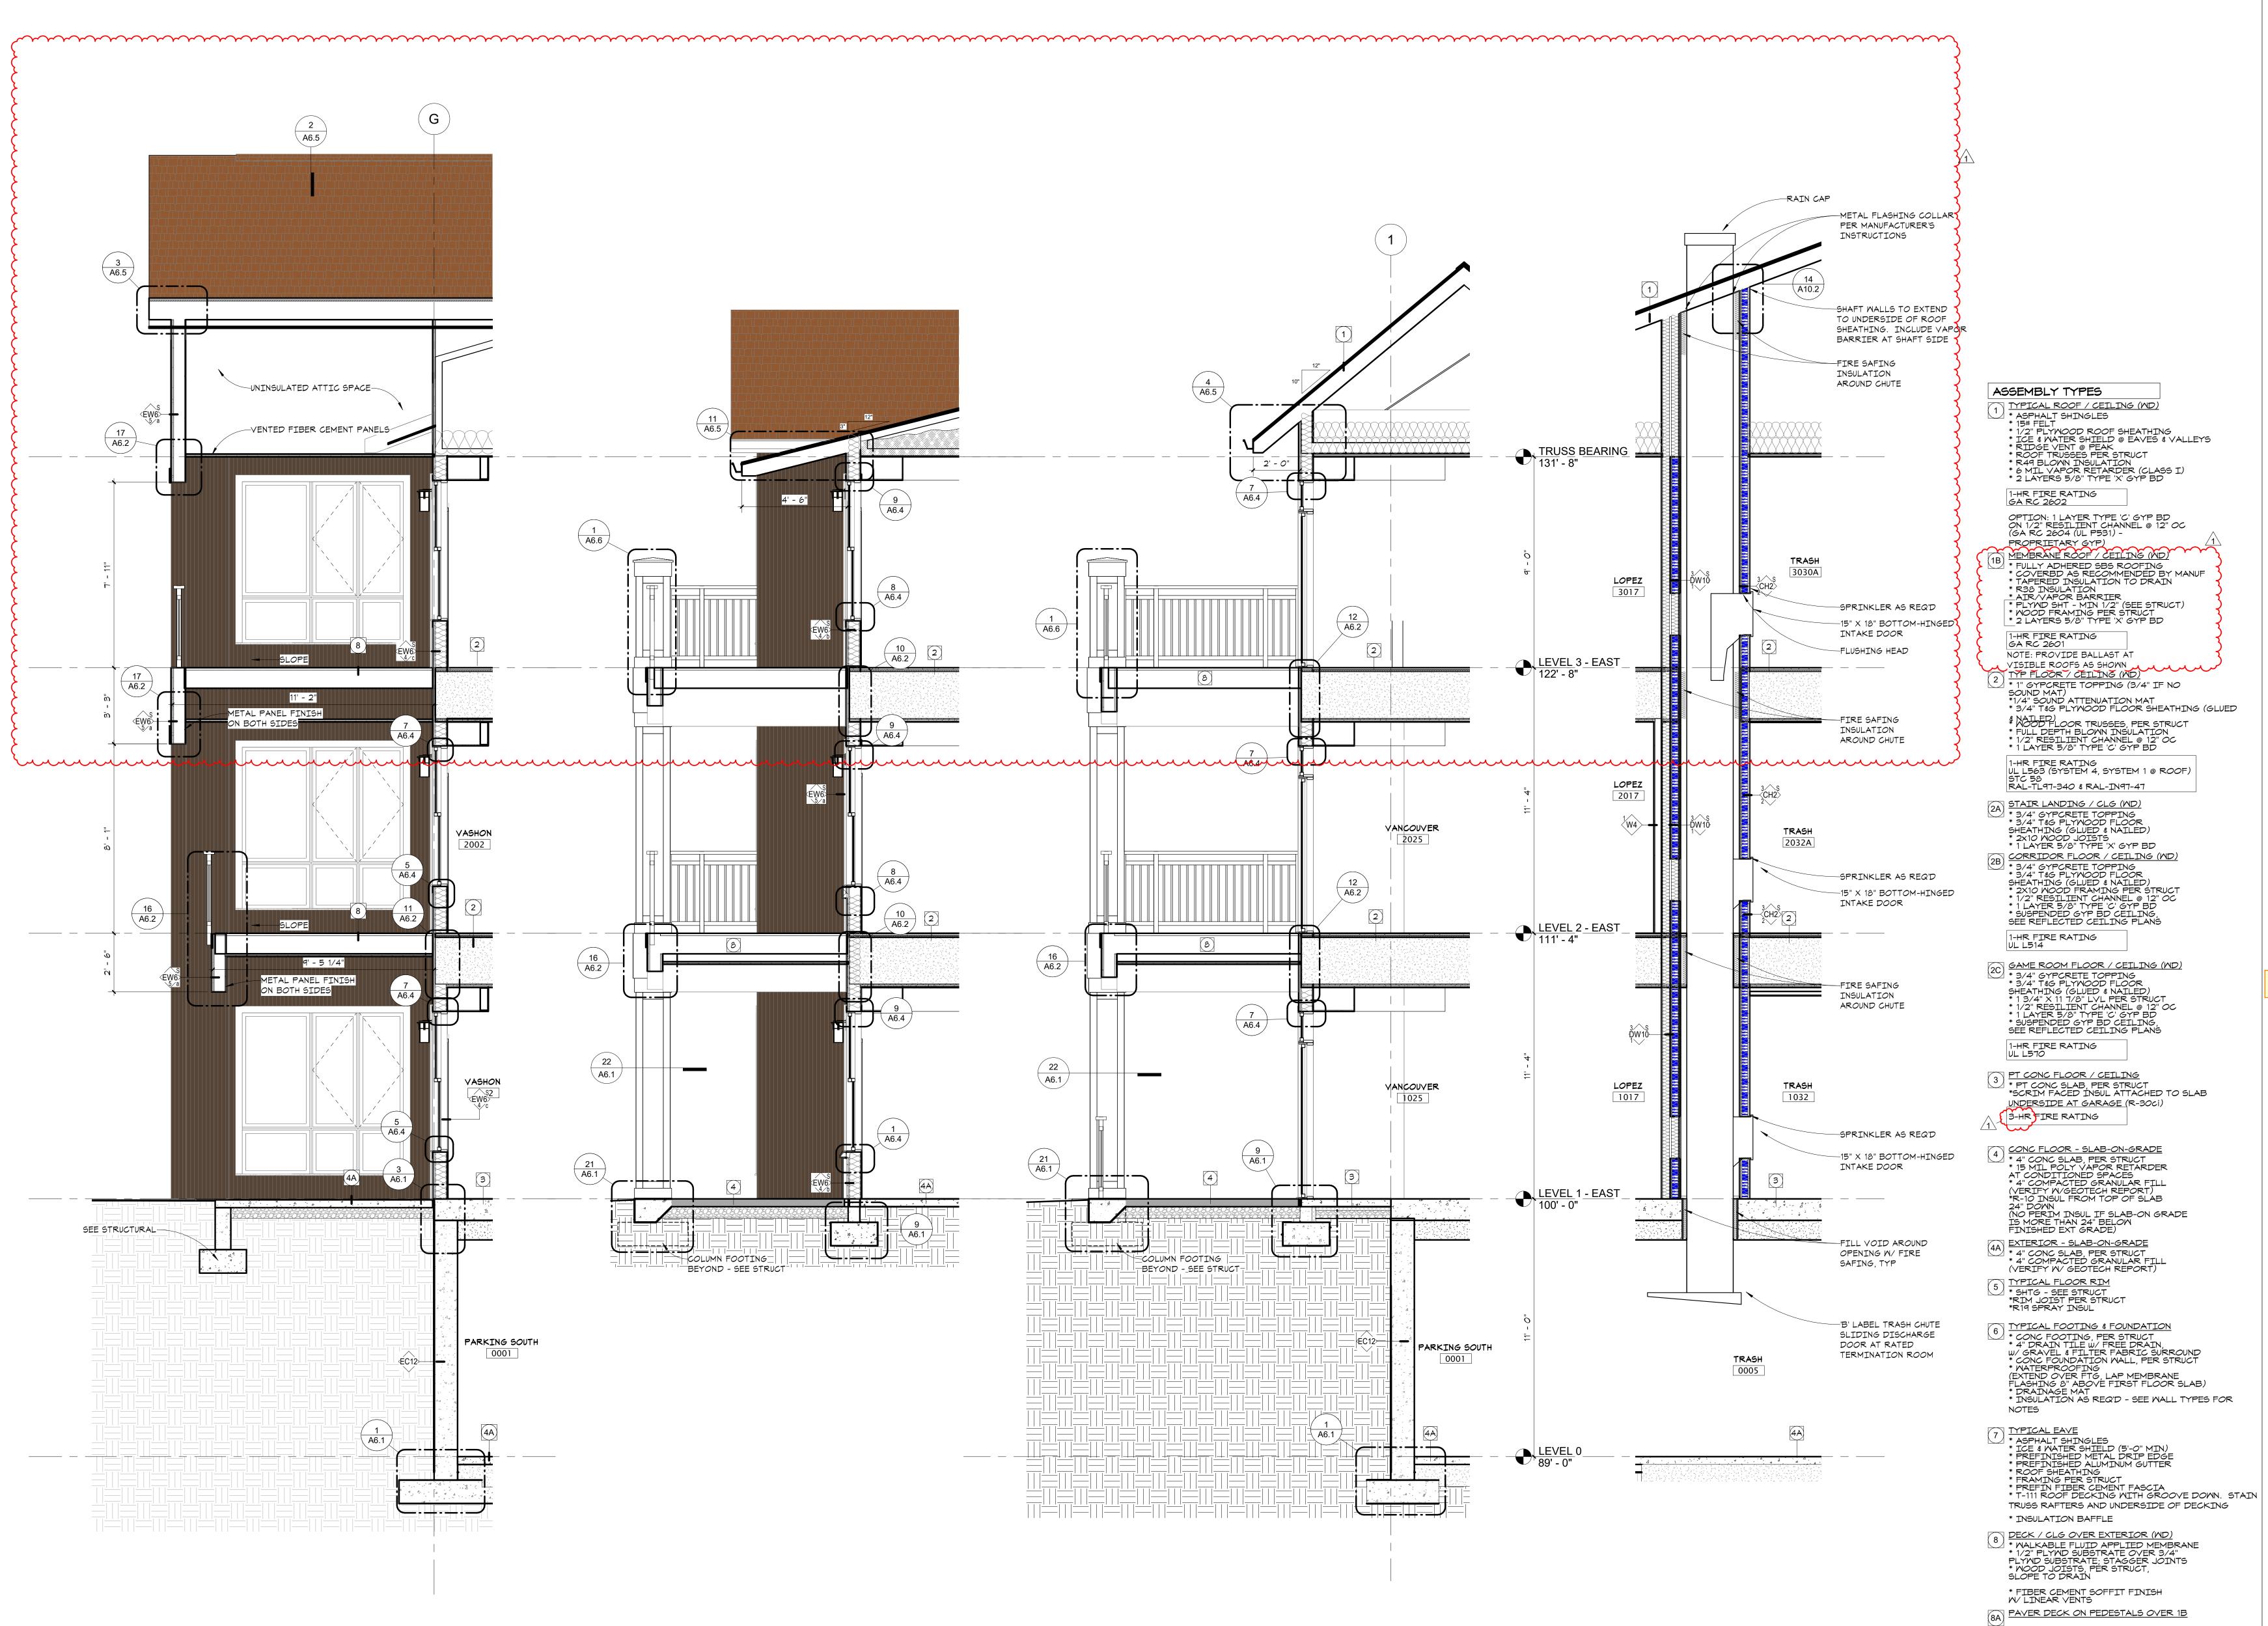

3 **SECTIC** A5.2 3/8" = 1'-0"

in site architects 1000 university ave. w. 🛚 suite 130 st. paul, minnesota 55104 612-252-4820 I hereby certify that this document was prepared by me or under my direct supervision and that I am a duly licensed architect under the laws of the State of Washington SEE BELOW Signature Dawn Wieczorek Typed or Printed Name 6/02/23 11192 License # Date 11192 REGISTERE ARCHITECT DAWN MARIE WIECZOR STATE OF WASHING N Δ m $r \infty$ ШÔ ╙┛┫ $\supset \geq$ 7 Щ Ч こく R \triangleleft $\mathbf{\Omega}$ $\mathbf{\Omega}$ **σ** E w $\mathbf{\mathcal{O}}$ 0 ら City of Puyallup velopment & Permitting Services ISSUED PERMIT Building Planning Engineering Public Works Fire PRMU20230881 PERMIT APP# PRMU20230881 PERMIT SET JUNE 02, 2023 REVISIONS Date No. Description 1 BLDG PERMIT REV 1 3/4/24 2108 PROJECT NUMBER Author_ Checker DRAWN BY CHECKED BY WESLEY BRADLEY PARK 2 EAST BROWNSTONE WALL SECTIONS A5




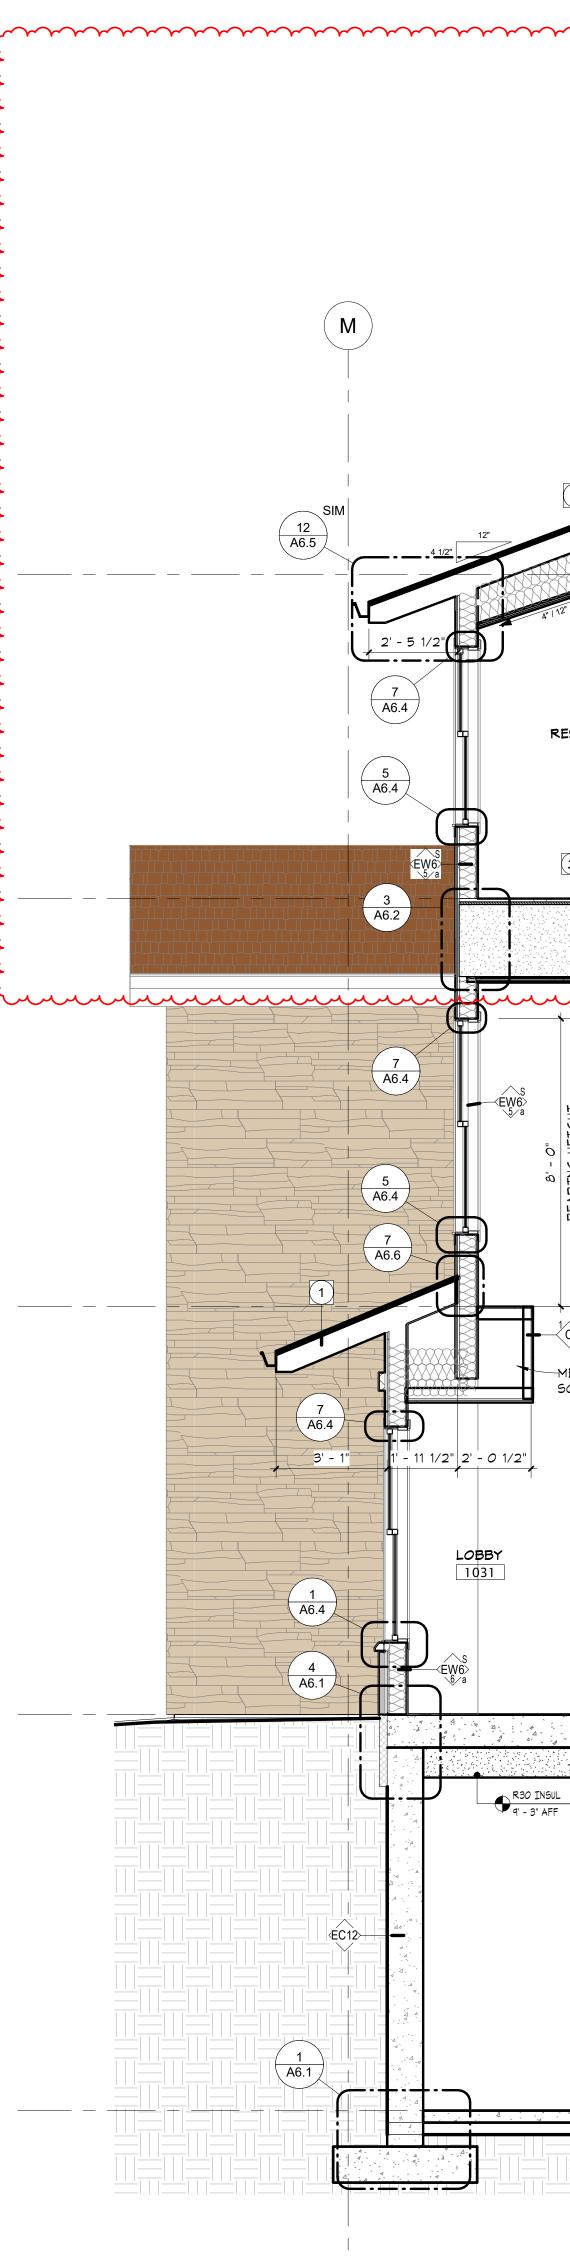






1 A5.4

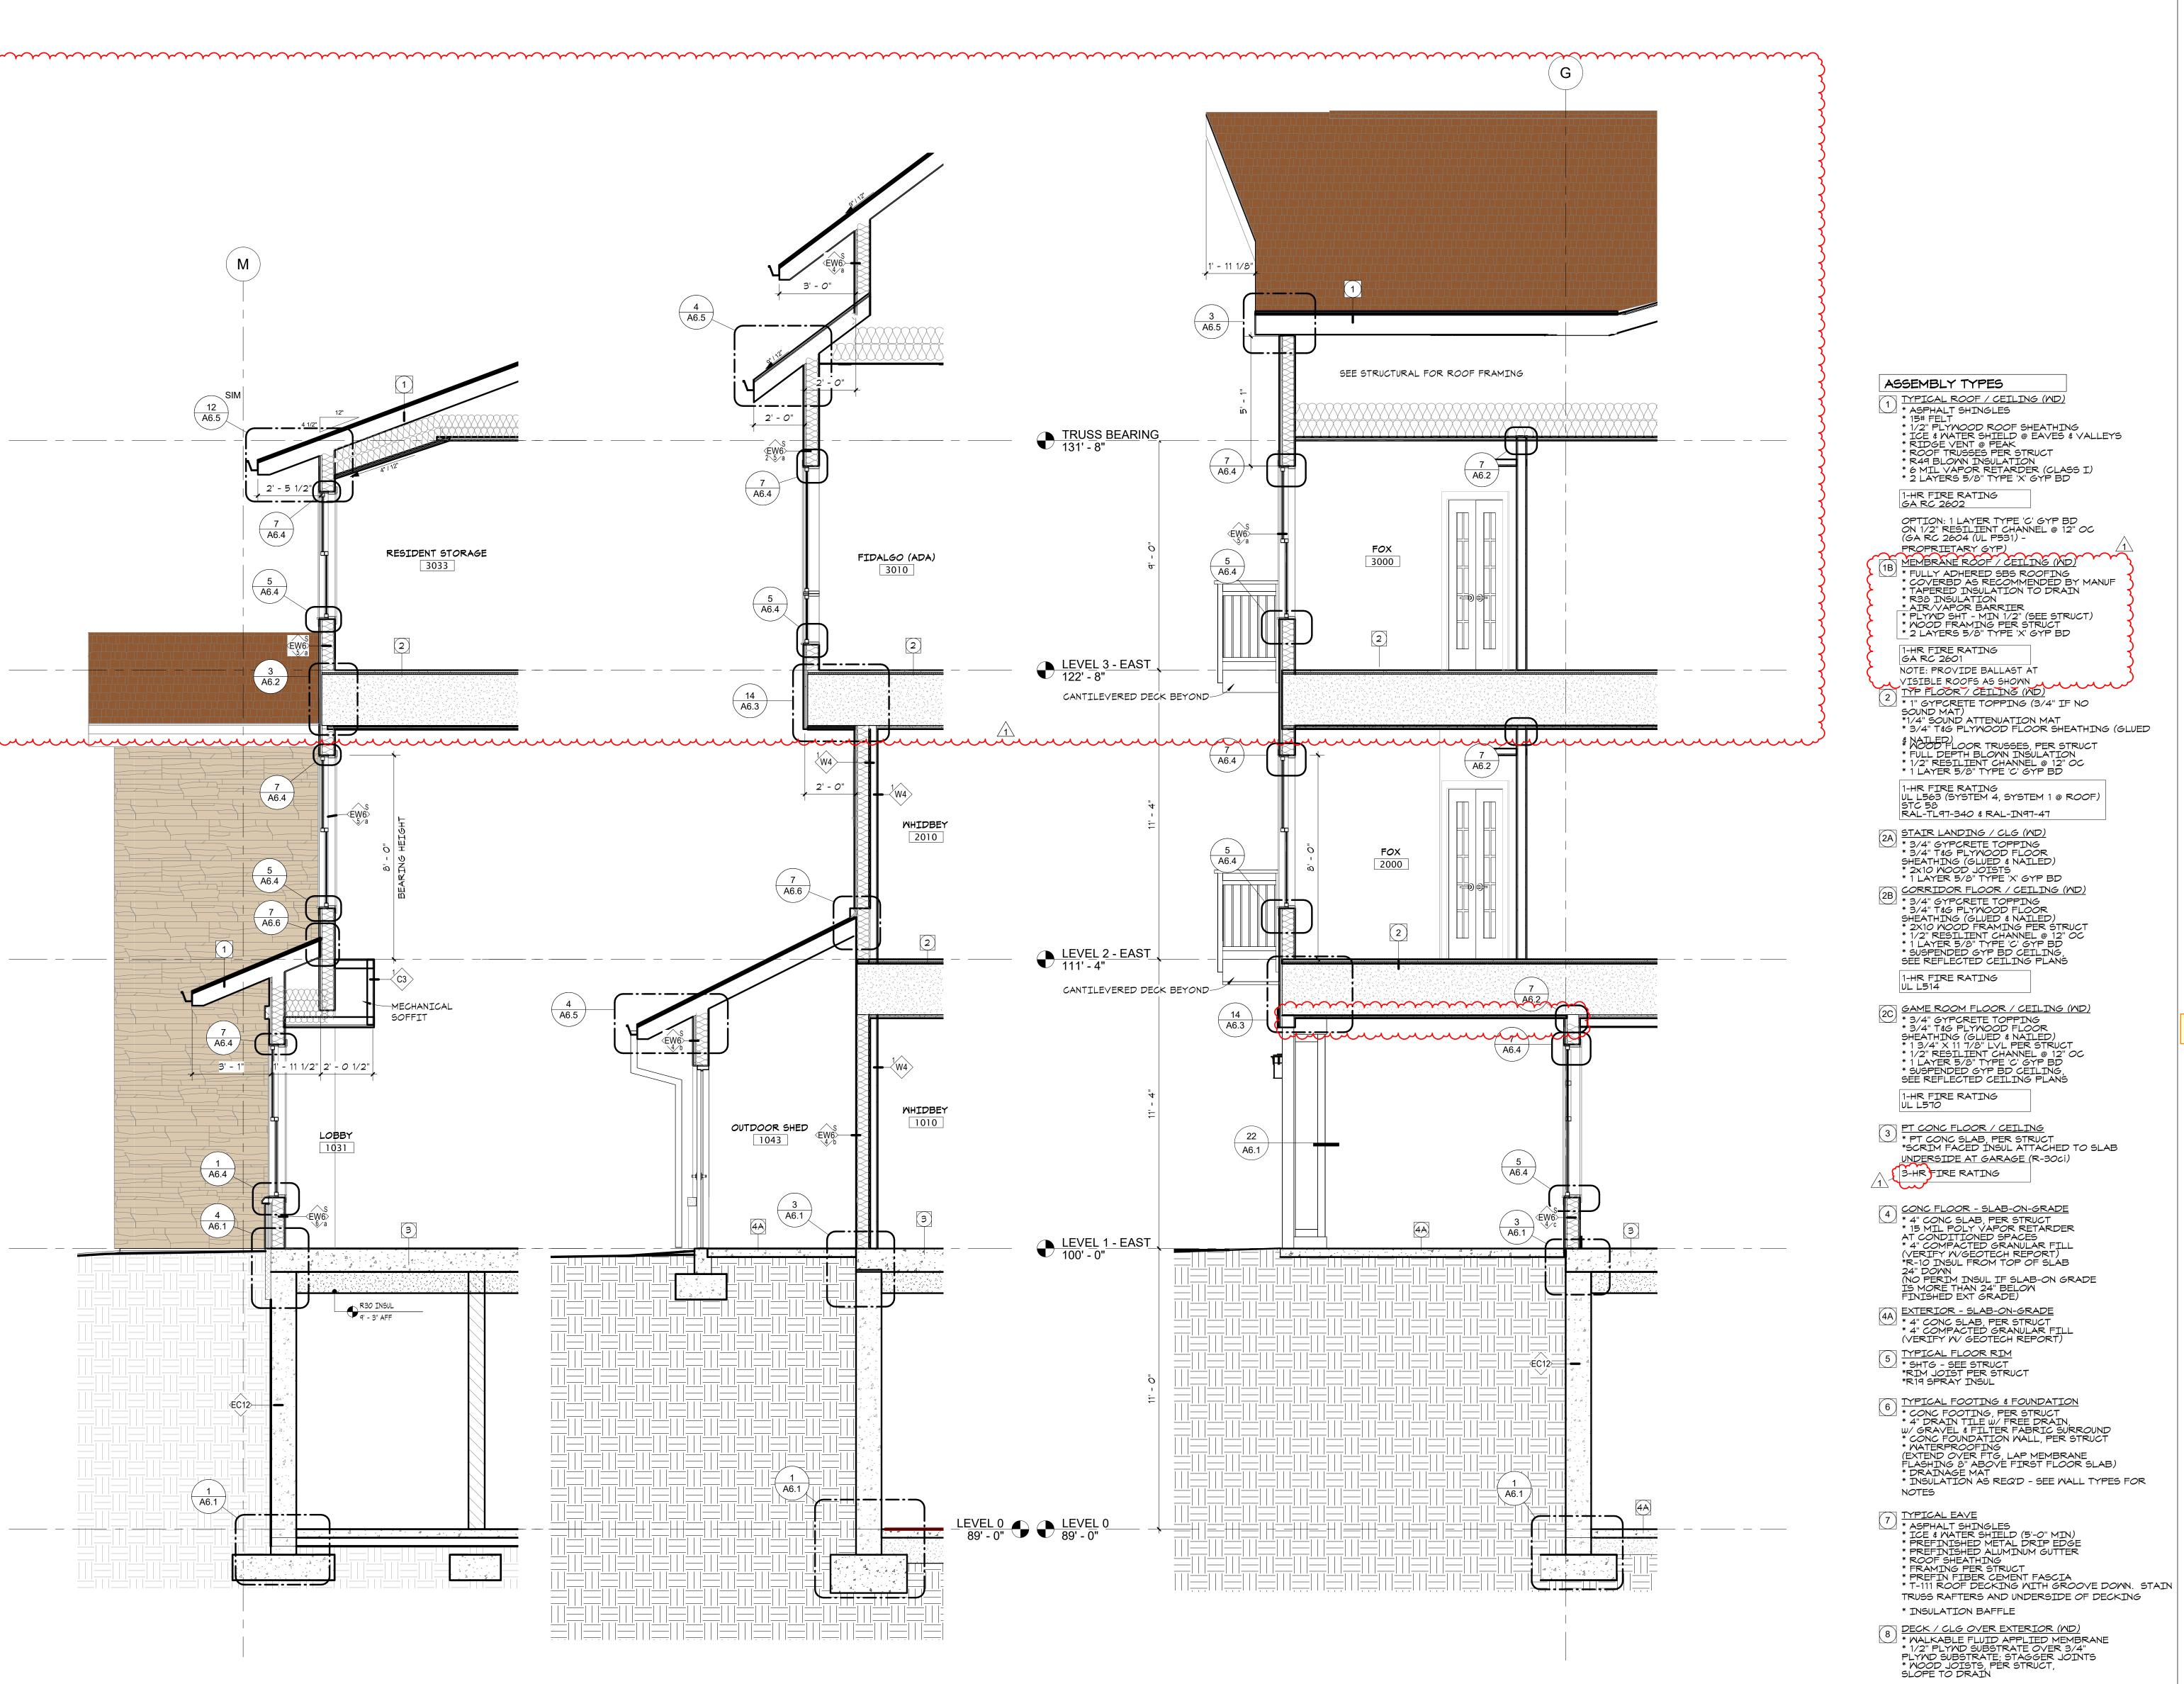




* FIBER CEMENT SOFFIT FINISH W/ LINEAR VENTS (8A) PAVER DECK ON PEDESTALS OVER 1B


in site architects 1000 university ave. w. = suite 130 st. paul, minnesota 55104 612-252-4820 I hereby certify that this document was prepared by me or under my direct supervision and that I am a duly licensed architect under the laws of the State of Washington SEE BELOW Signature Dawn Wieczorek Typed or Printed Name 6/02/23 11192 License # Date 11192 REGISTERE ARCHITECT \sim Δ m $r \infty$ ШŐ ╙┛┫ $\supset \geq$ 7 Щ Ч ' – \mathbf{r} $\mathbf{\Omega}$ Ω **σ** т Б $\mathbf{\mathcal{O}}$ 0 \mathcal{O} Ш City of Puyallup velopment & Permitting Services ISSUED PERMIT Building Planning Engineering Public Works Fire Traffic PRMU20230881 PERMIT APP# PRMU20230881 PERMIT SET JUNE 02, 2023 REVISIONS Date No. Description 1 BLDG PERMIT REV 1 3/4/24 2108 PROJECT NUMBER Author_ Checker DRAWN BY CHECKED BY WESLEY BRADLEY PARK 2 EAST BROWNSTONE WALL SECTIONS **A5**

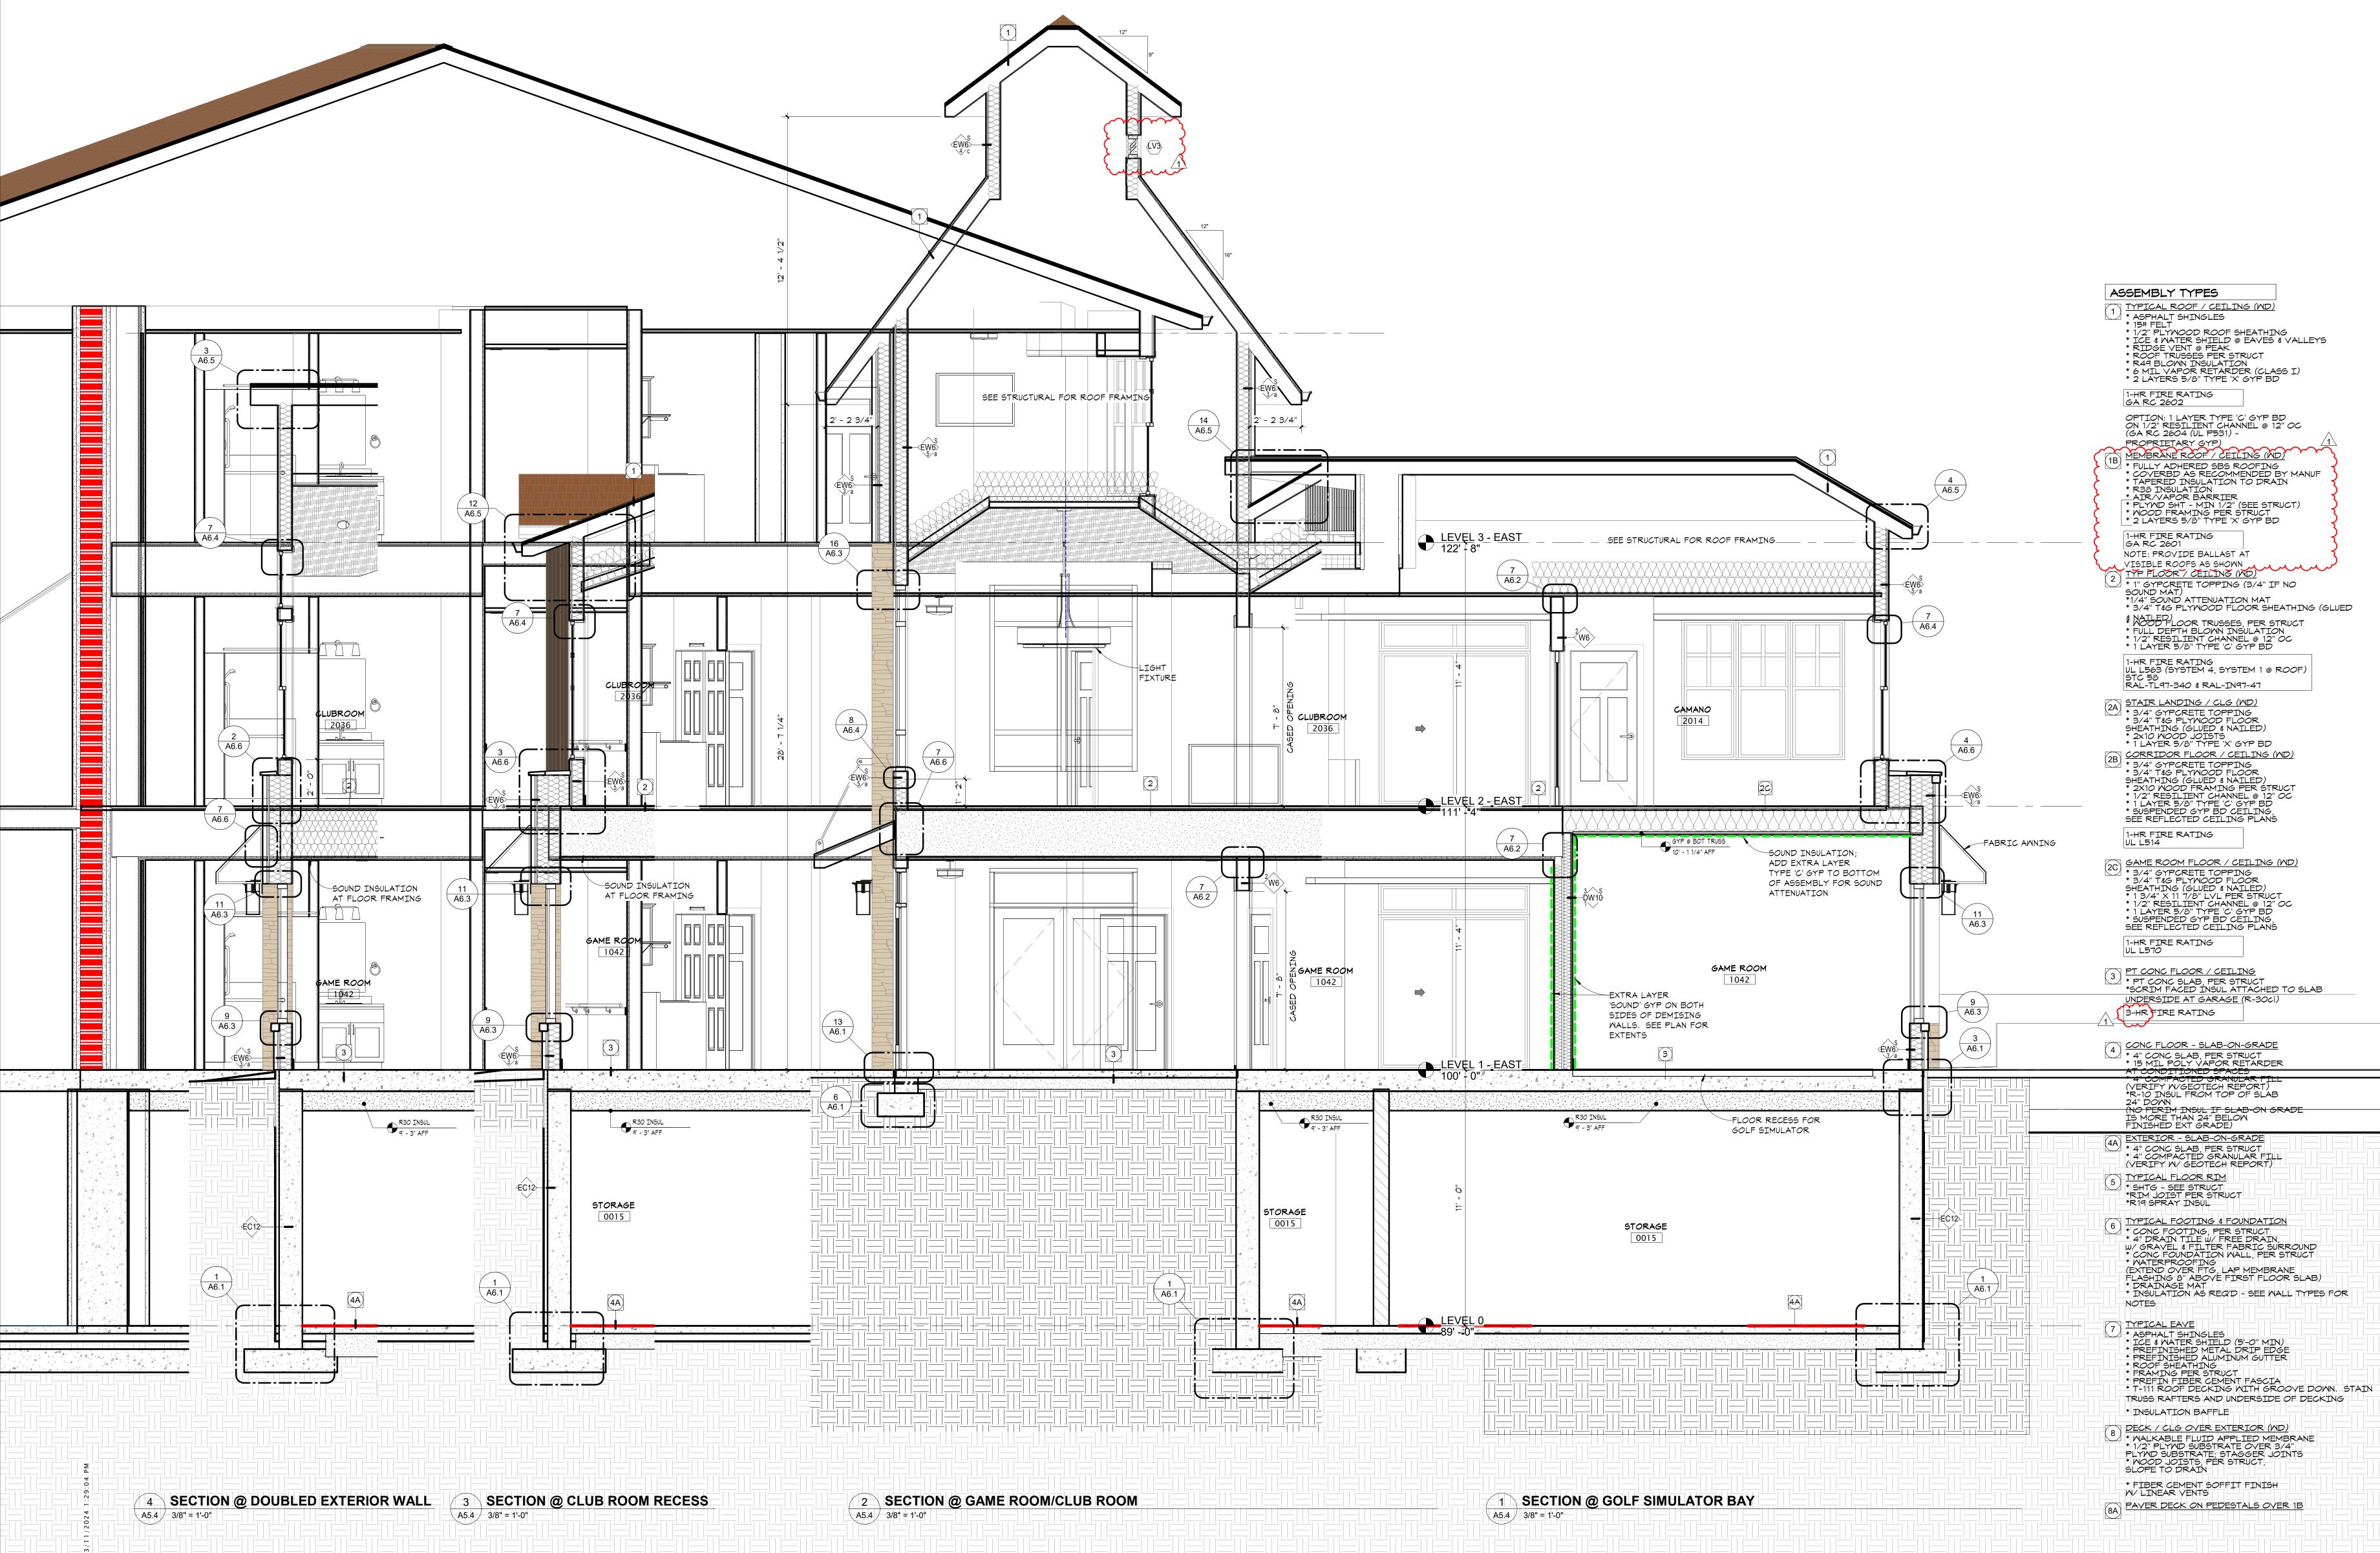

in site architects 1000 university ave. w. = suite 130 st. paul, minnesota 55104 612-252-4820 I hereby certify that this document was prepared by me or under my direct supervision and that I am a duly licensed architect under the laws of the State of Washington SEE BELOW Signature Dawn Wieczorek Typed or Printed Name 11192 6/02/23 License # Date 11192 REGISTERE ARCHITECT STATE OF WASHING \neg Δ m $r \infty$ ЩО $\supset \geq$ 7 ЩЧ ~ つ R \triangleleft V Μ $\mathbf{\Omega}$ **σ** m T $\boldsymbol{\mathcal{O}}$ 0 ら Ш City of Puyallup velopment & Permitting Services ISSUED PERMIT Building Planning Engineering Public Works Fire Traffic PRMU20230881 PERMIT APP# PRMU20230881 PERMIT SET JUNE 02, 2023 REVISIONS No. Description Date BLDG PERMIT REV 1 3/4/24 2108 PROJECT NUMBER JDK Checker DRAWN BY CHECKED BY WESLEY BRADLEY PARK 2 EAST BROWNSTONE WALL SECTIONS A5.4

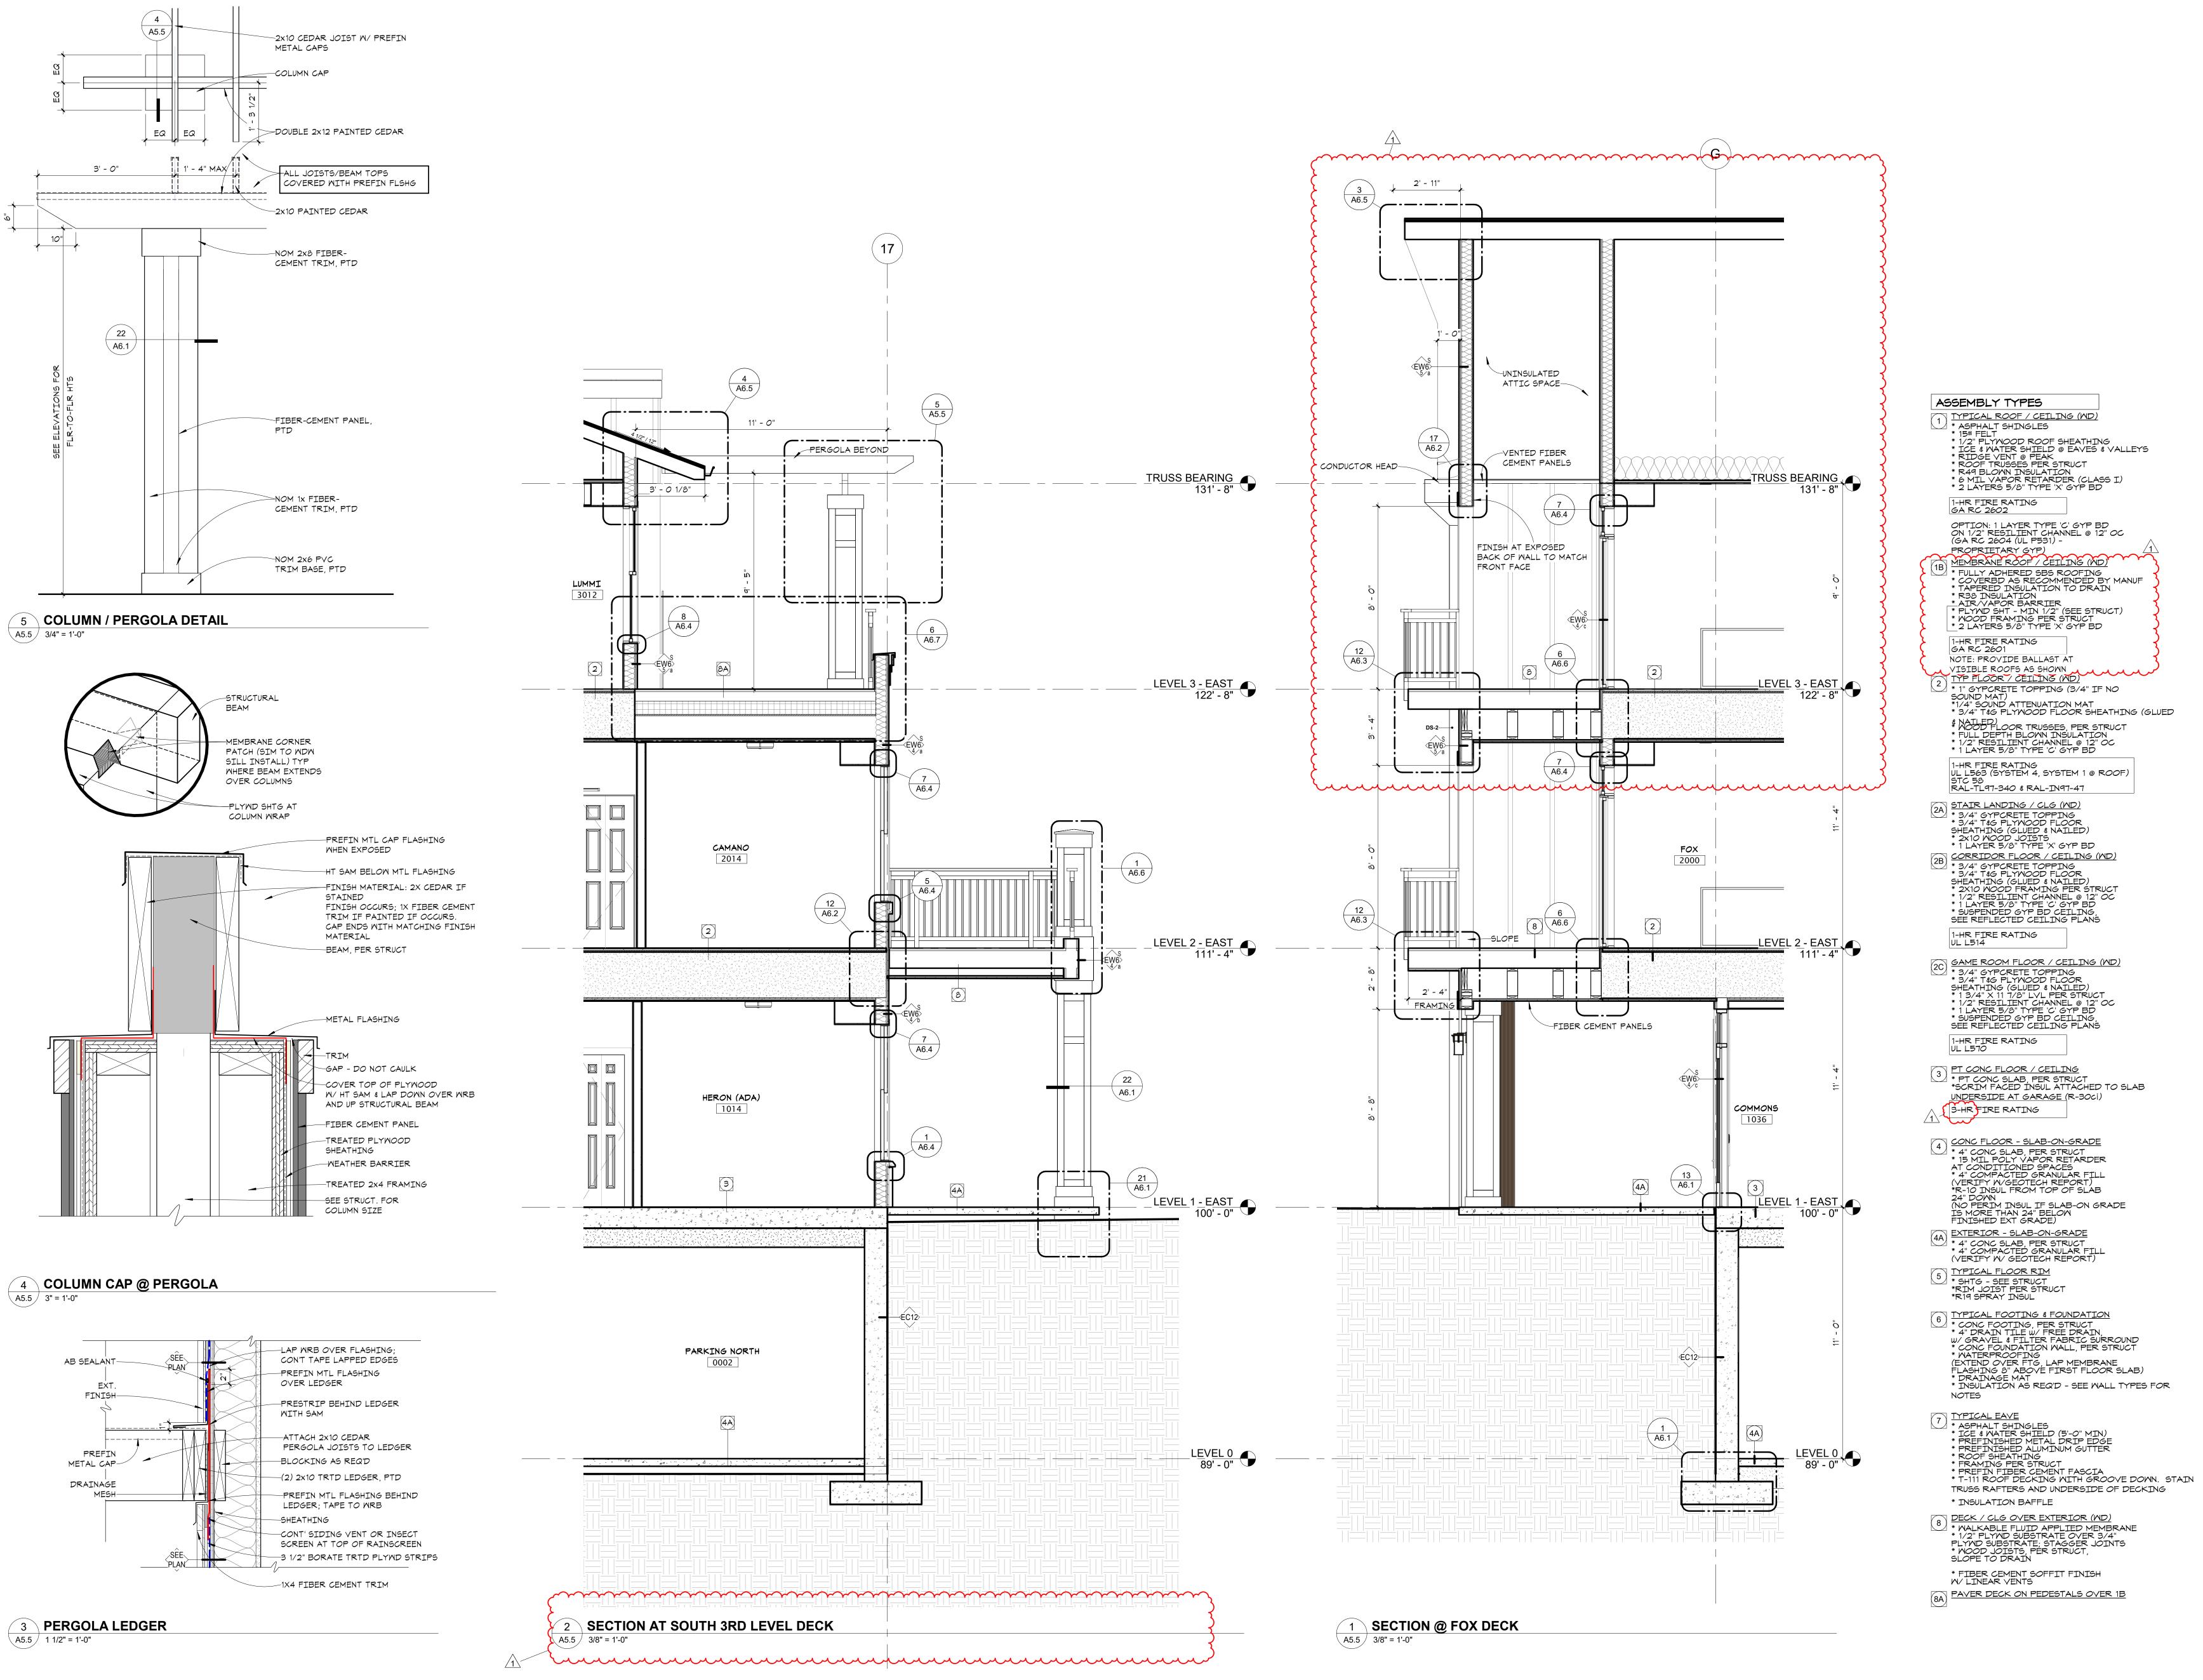

in site architects 1000 university ave. w. = suite 130 st. paul, minnesota 55104 612-252-4820 I hereby certify that this document was prepared by me or under my direct supervision and that I am a duly licensed architect under the laws of the State of Washington SEE BELOW Signature Dawn Wieczorek Typed or Printed Name 11192 6/02/23 License # Date 11192 REGISTERE ARCHITECT TOAWN MARIE WIECZORF STATE OF WASHINGT N \neg Δ m $r \infty$ ШŐ ╙┫ $\supset \geq$ 7 Щ. こく _ ۷ $\mathbf{\Omega}$ $\mathbf{\Omega}$ **σ** m T ら 0 ら Ш City of Puyallup velopment & Permitting Services ISSUED PERMIT Building Planning Engineering Public Works Fire PRMU20230881 PERMIT APP# PRMU20230881 PERMIT SET JUNE 02, 2023 REVISIONS Date No. Description 1 BLDG PERMIT REV 1 3/4/24 2108 PROJECT NUMBER JDK Checker DRAWN BY CHECKED BY WESLEY BRADLEY PARK 2 EAST BROWNSTONE WALL SECTIONS A5

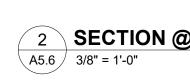




RES STORAGE 0012

З


2

2


(3) (A5.5) _____ ___ ___

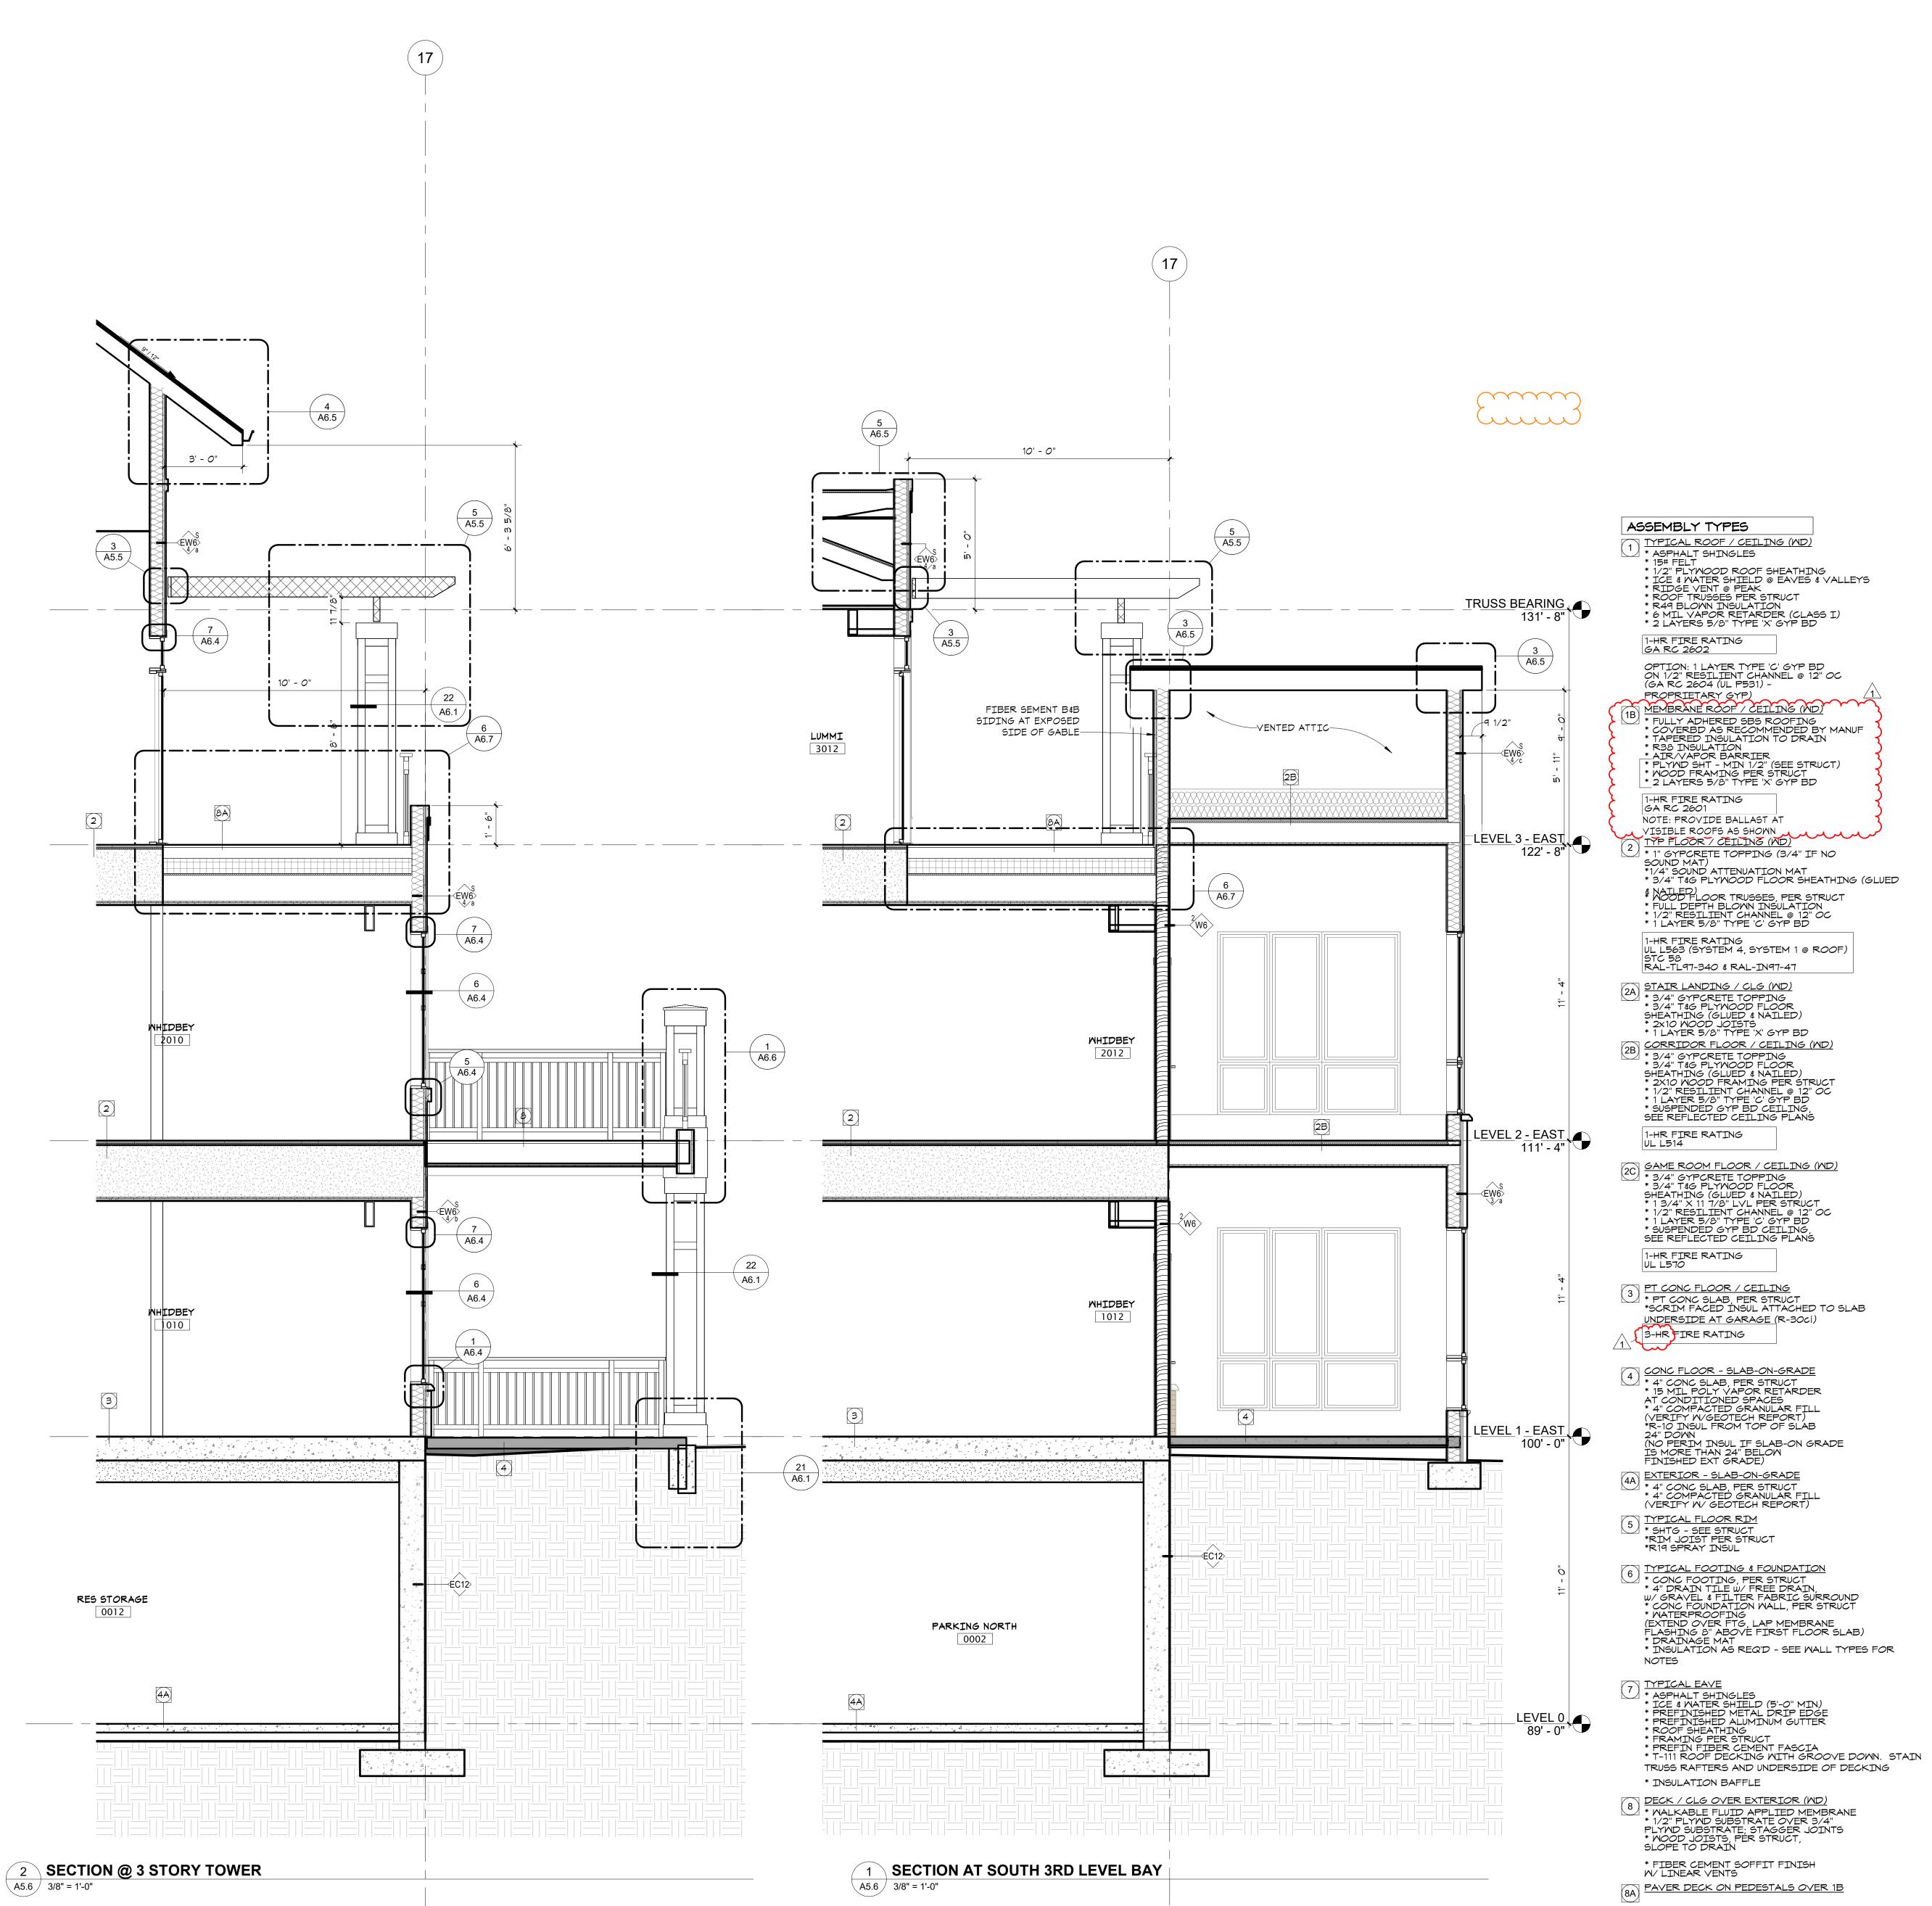

in site architects 1000 university ave. w. = suite 130 st. paul, minnesota 55104 612-252-4820 I hereby certify that this document was prepared by me or under my direct supervision and that I am a duly licensed architect under the laws of the State of Washington SEE BELOW Signature Dawn Wieczorek Typed or Printed Name 11192 6/02/23 License # Date 11192 REGISTERE ARCHITECT DAWN MARIE WIECZOR STATE OF WASHING N \neg Δ m $r \infty$ ШŐ \exists Щ Ч ~ 5 2 \triangleleft N Μ $\mathbf{\Omega}$ 5 т М $\boldsymbol{\mathcal{O}}$ 0 \mathbf{N} 5 ШÌ City of Puyallup evelopment & Permitting Services ISSUED PERMIT Building Planning Engineering Public Works Fire Traffic PRMU20230881 PERMIT APP# PRMU20230881 PERMIT SET JUNE 02, 2023 REVISIONS Date No. Description 1 BLDG PERMIT REV 1 3/4/24 2108 PROJECT NUMBER JDK_ Checker DRAWN BY CHECKED BY WESLEY BRADLEY PARK 2 EAST BROWNSTONE WALL SECTIONS **\5** Λ 0 ········

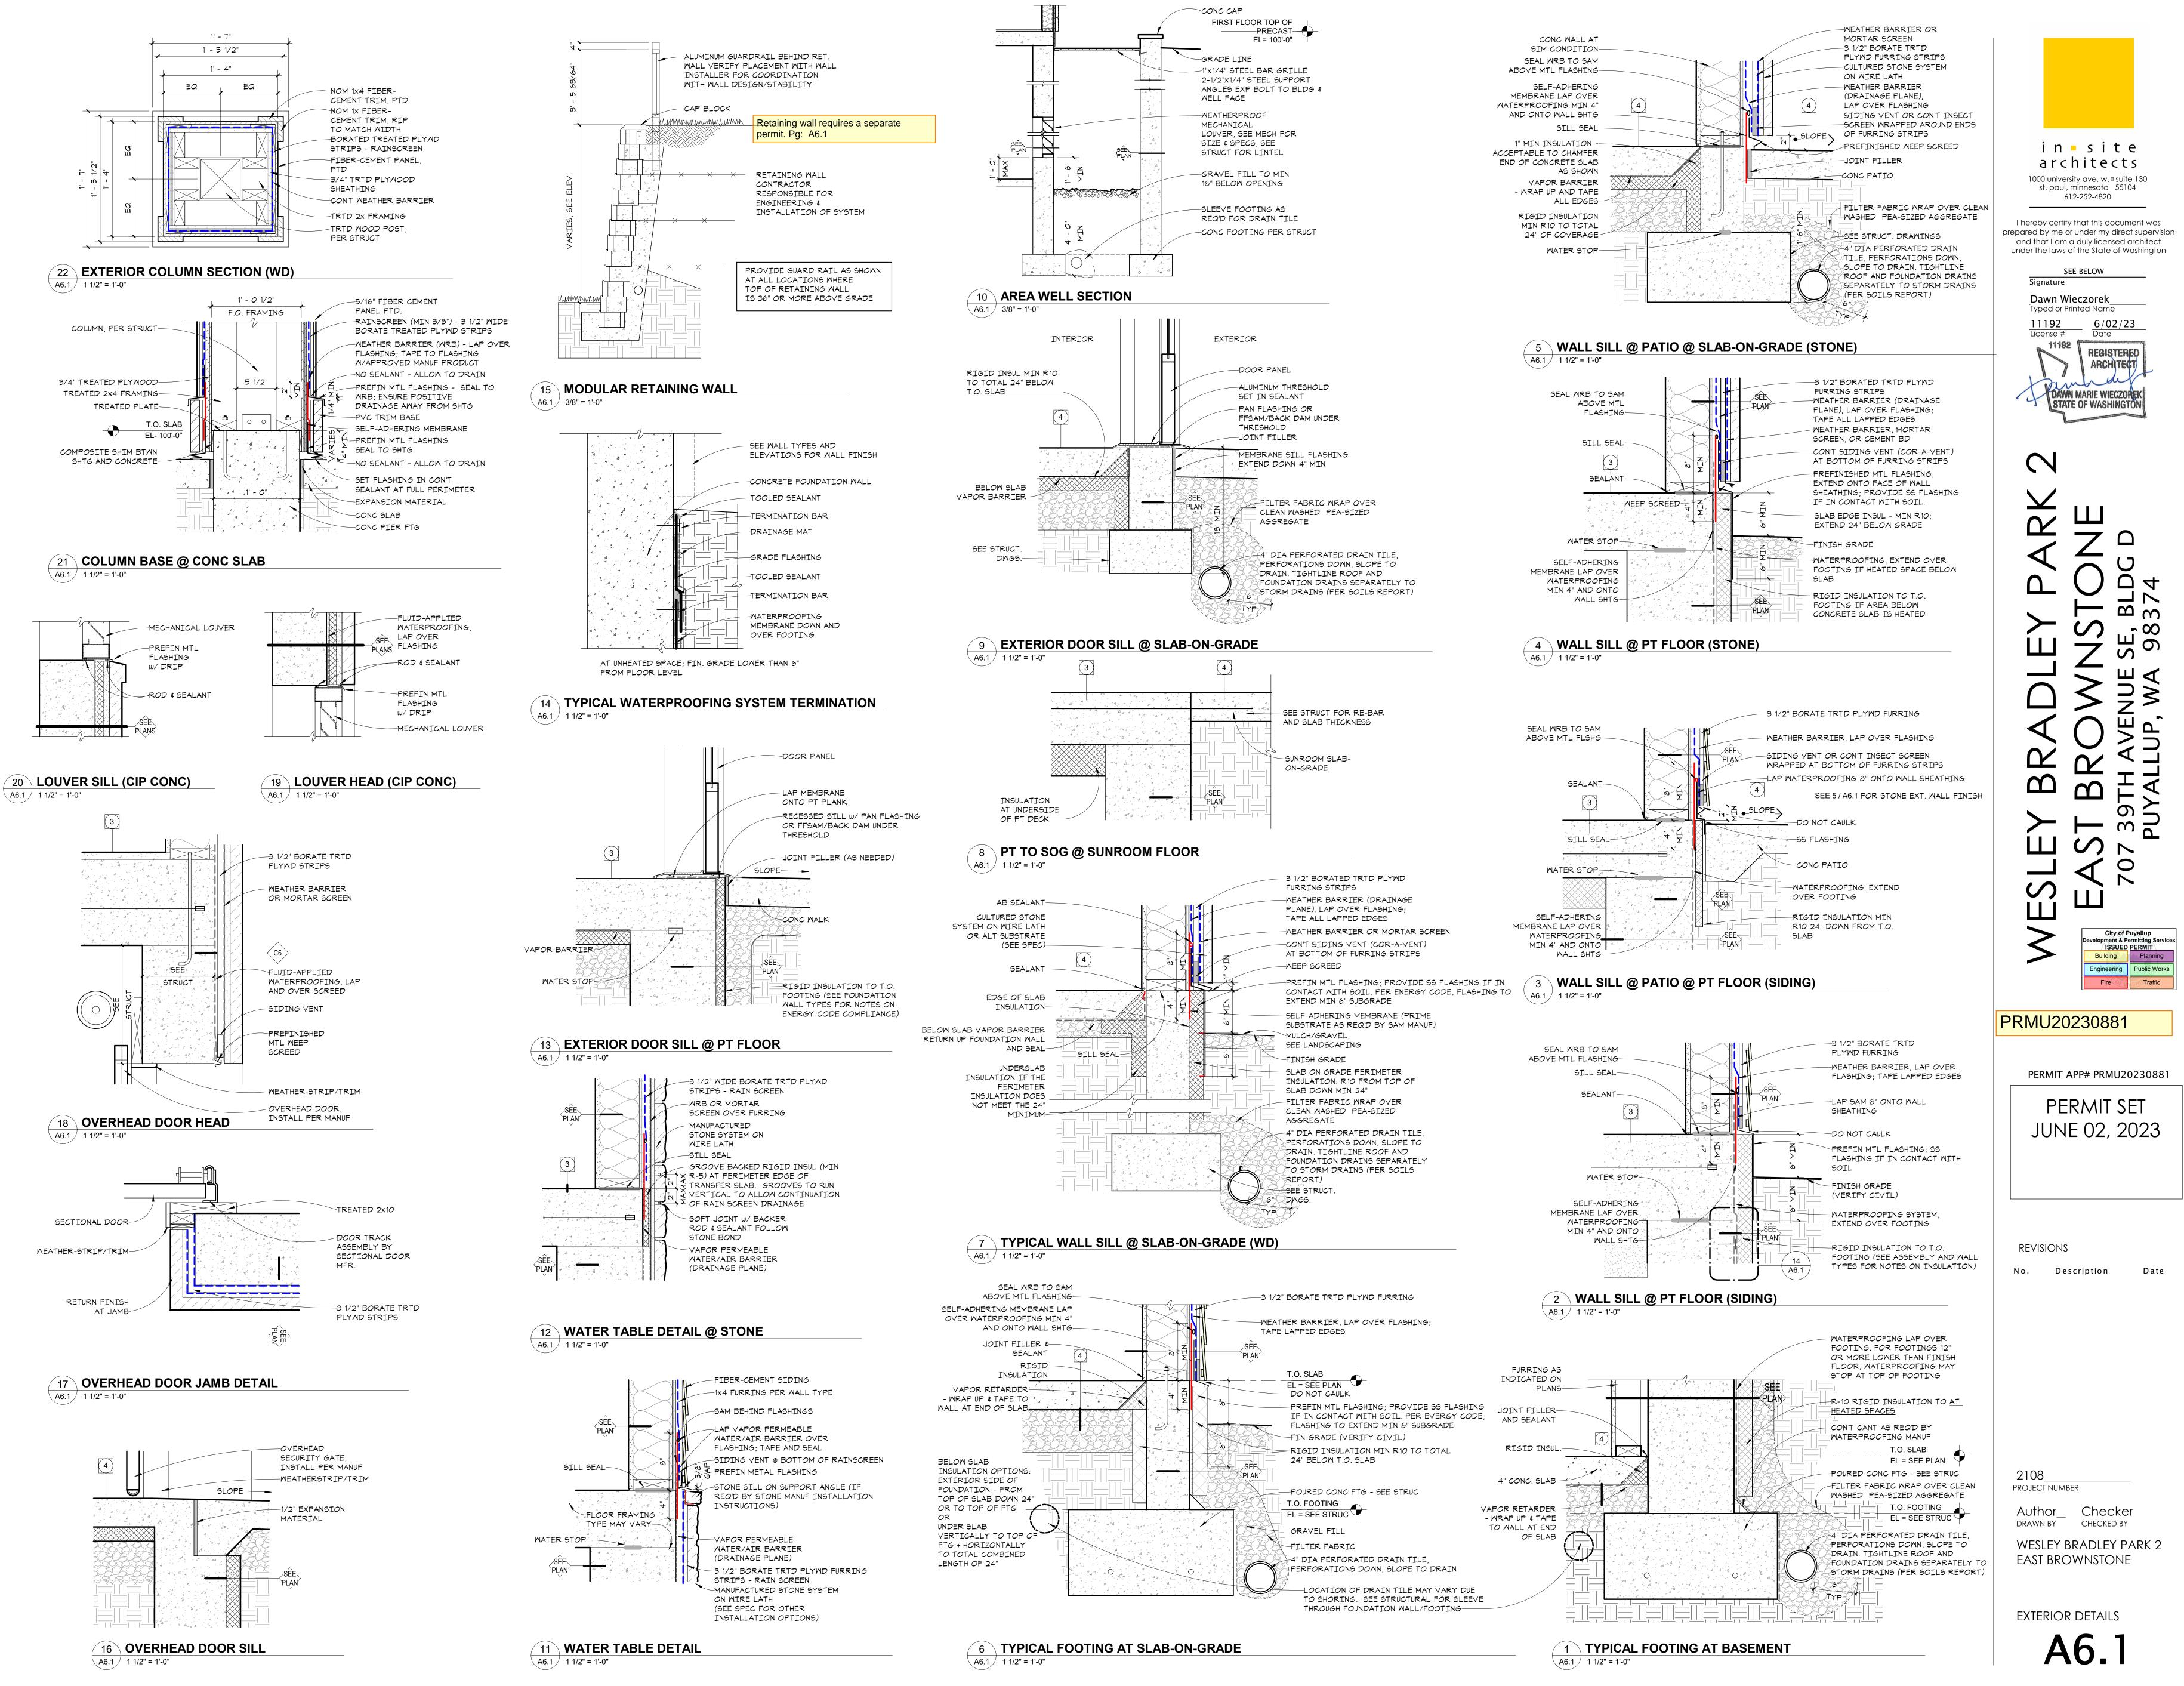




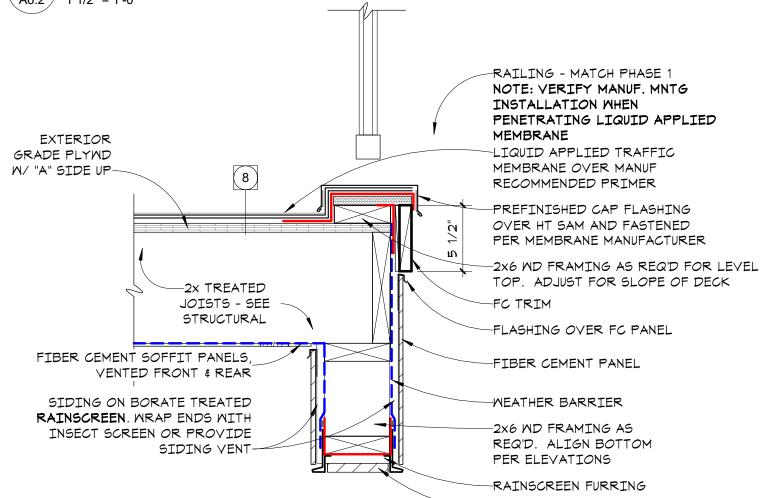


—1/2" FC TRIM



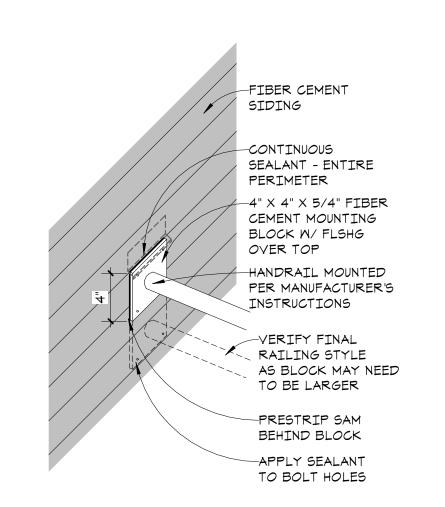

16 TYPICAL WALKABLE DECK EDGE AT SIDE A6.2 1 1/2" = 1'-0"

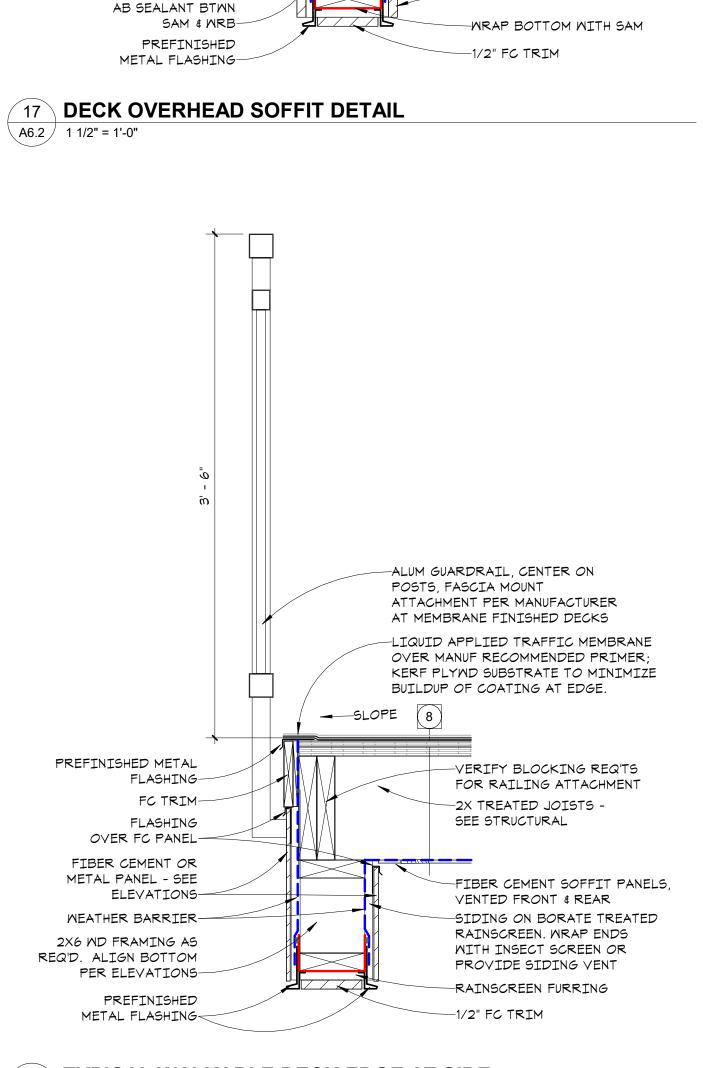

-UNINSULATED

OVER DECK-

ATTIC SPACE

-BLOCKING

PANELS

-VENTED FIBER CEMENT SOFFIT

TREATED RAINSCREEN. WRAP

ENDS WITH INSECT SCREEN

OR PROVIDE SIDING VENT

-RAINSCREEN FURRING

-SEAL WRB TO SAM

-1X6 FC TRIM

-PREFIN METAL FLASHING

-METAL PANEL ON BORATE

GABLE END TRUSS -

SEE STRUCTURAL


WEATHER BARRIER

PREFIN METAL FLASHING

2X6 WD FRAMING

AS REQ'D.

1X10 FC TRIM-

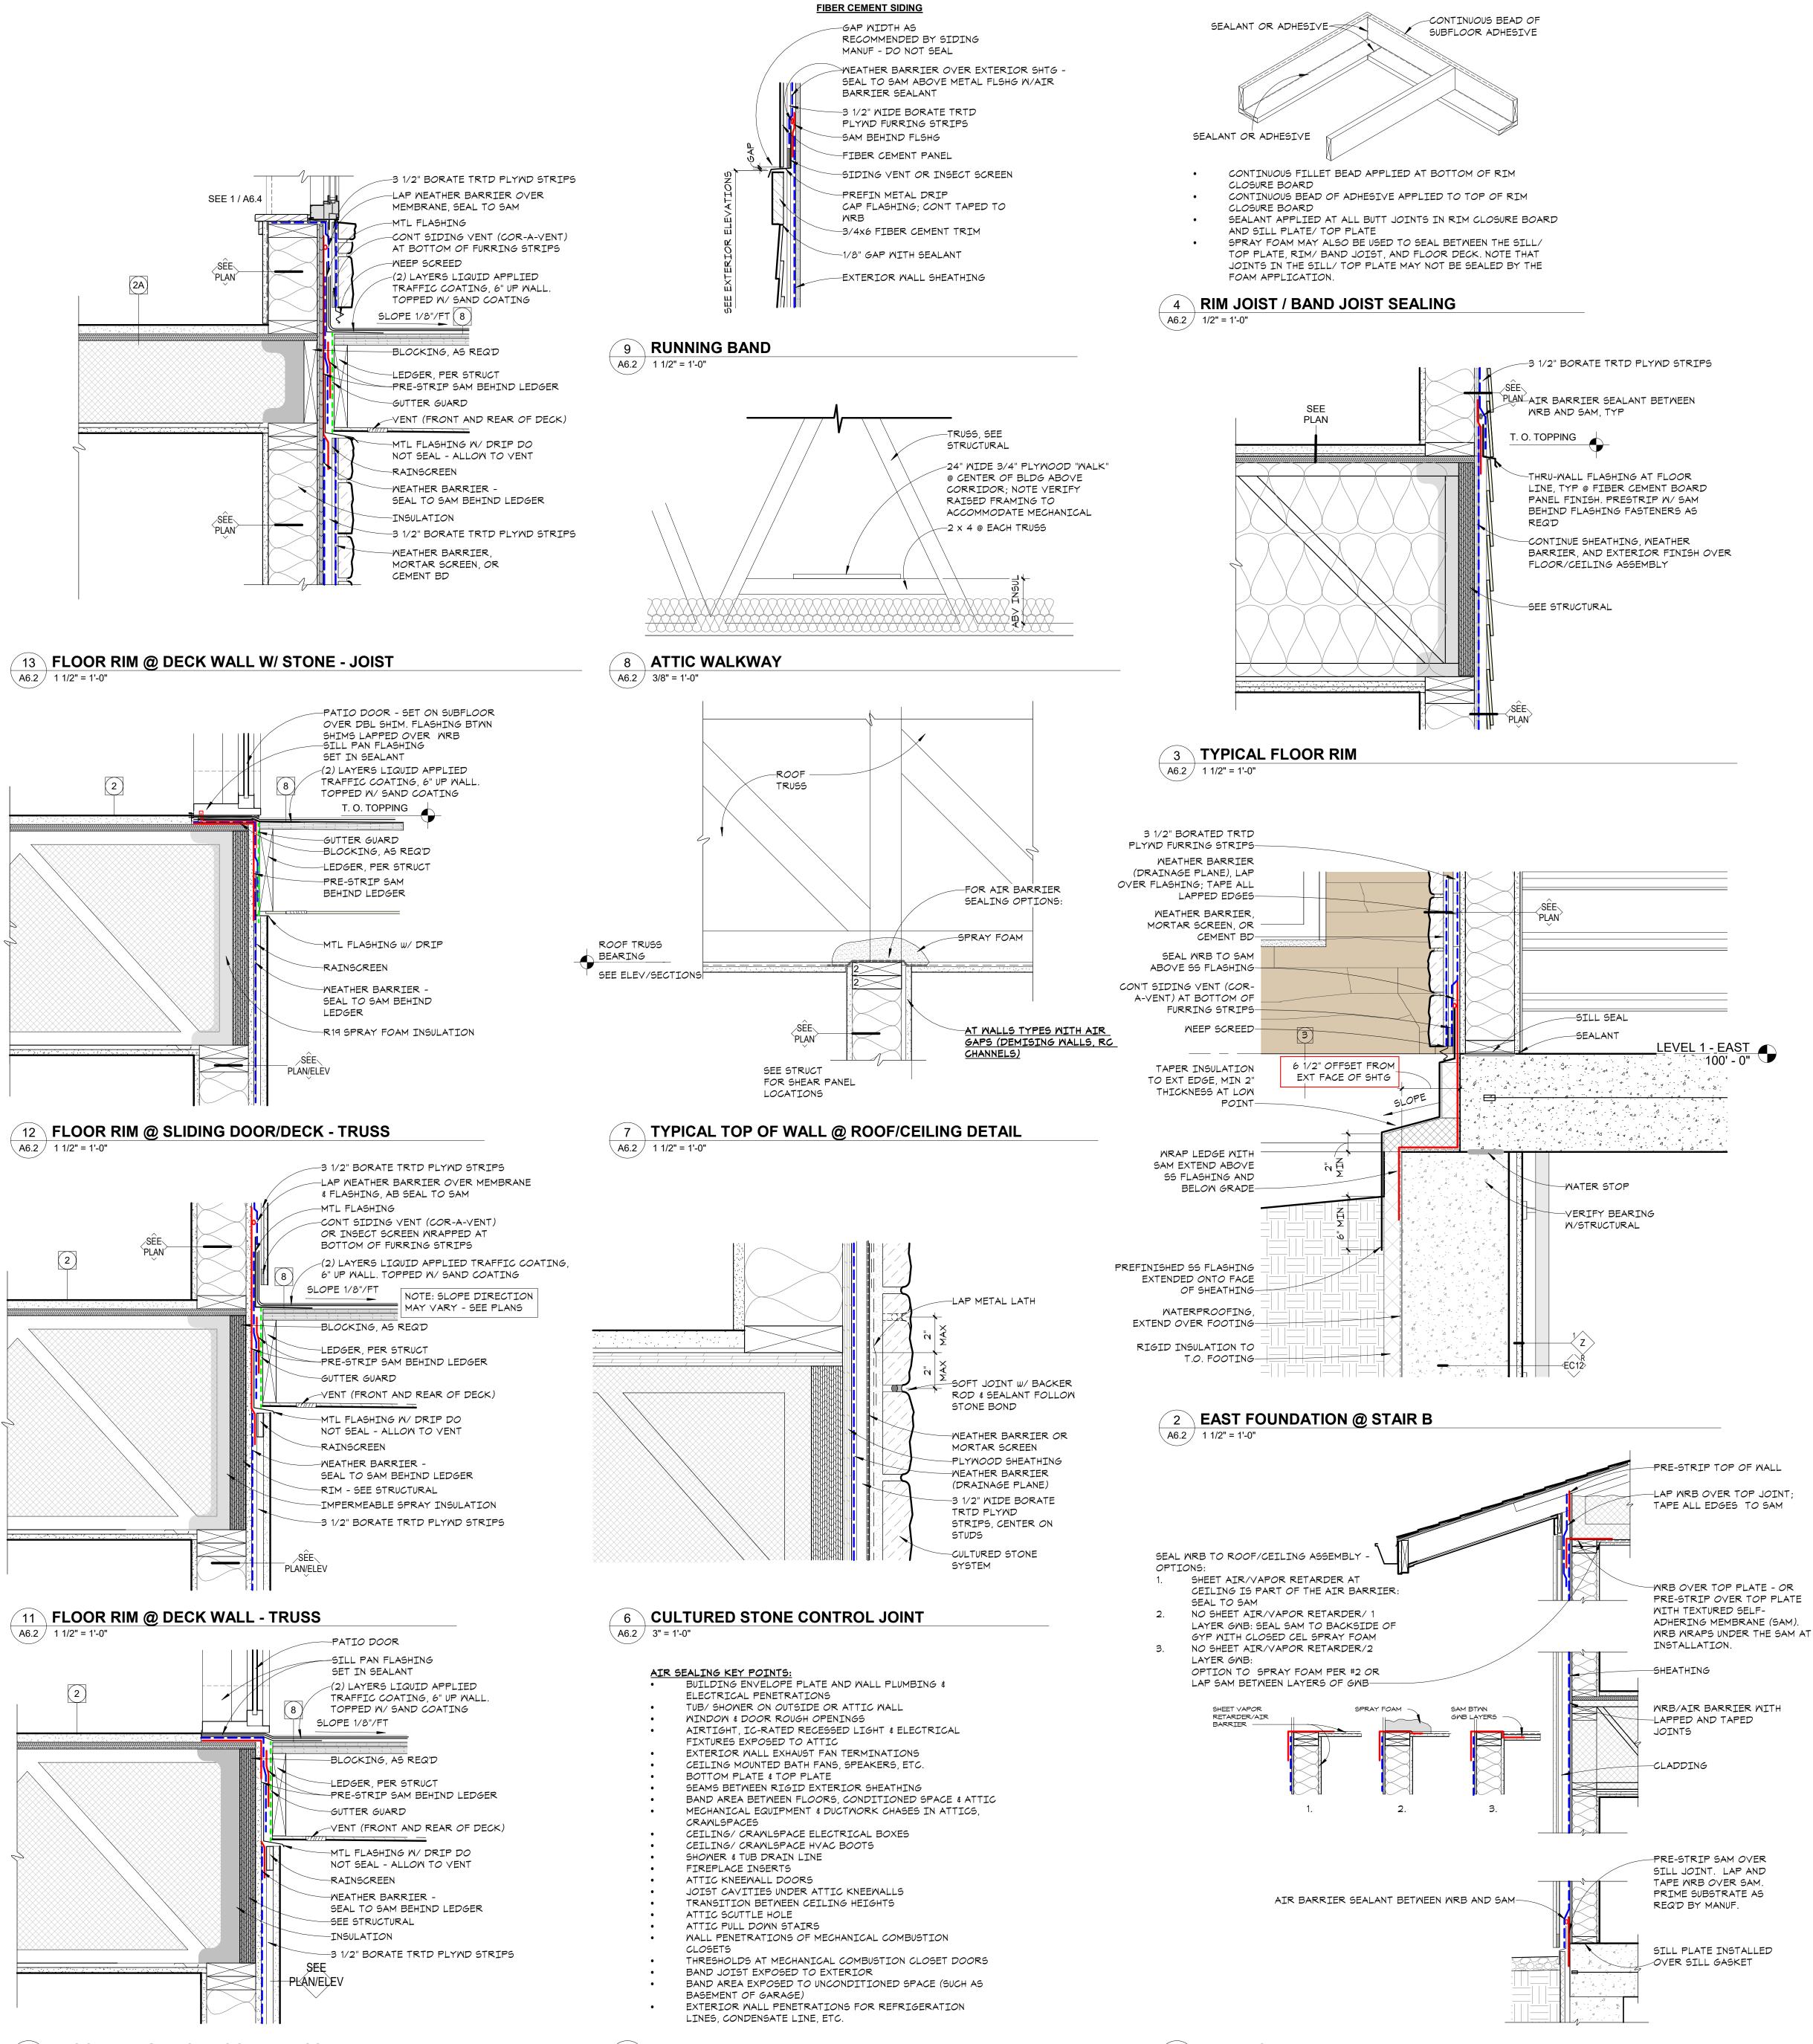



10 FLOOR RIM @ DECK DOOR - TRUSS A6.2 / 1 1/2" = 1'-0"


 \checkmark 5 \setminus AIR SEALING KEY POINTS \A6.2 / 3" = 1'-0"

1 EXTERIOR WEATHER AND AIR BARRIER A6.2 3/4" = 1'-0"


in site architects 1000 university ave. w. 🛚 suite 130 st. paul, minnesota 55104 612-252-4820 I hereby certify that this document was prepared by me or under my direct supervision and that I am a duly licensed architect under the laws of the State of Washington SEE BELOW Signature Dawn Wieczorek Typed or Printed Name 11192 6/02/23 License # Date 11192 REGISTERE ARCHITECT DAWN MARIE WIECZORE STATE OF WASHINGT Δ m ШО \supset 7 $\mathbf{\Omega}$ \mathbf{m} $\mathbf{\Omega}$ 0 МЪ U) 0 City of Puyallup velopment & Permitting Service ISSUED PERMIT Building Planning Engineering Public Works Fire PRMU20230881 PERMIT APP# PRMU20230881 PERMIT SET JUNE 02, 2023 REVISIONS Date No. Description 2108 PROJECT NUMBER Author Checker DRAWN BY CHECKED BY WESLEY BRADLEY PARK 2 EAST BROWNSTONE EXTERIOR DETAILS

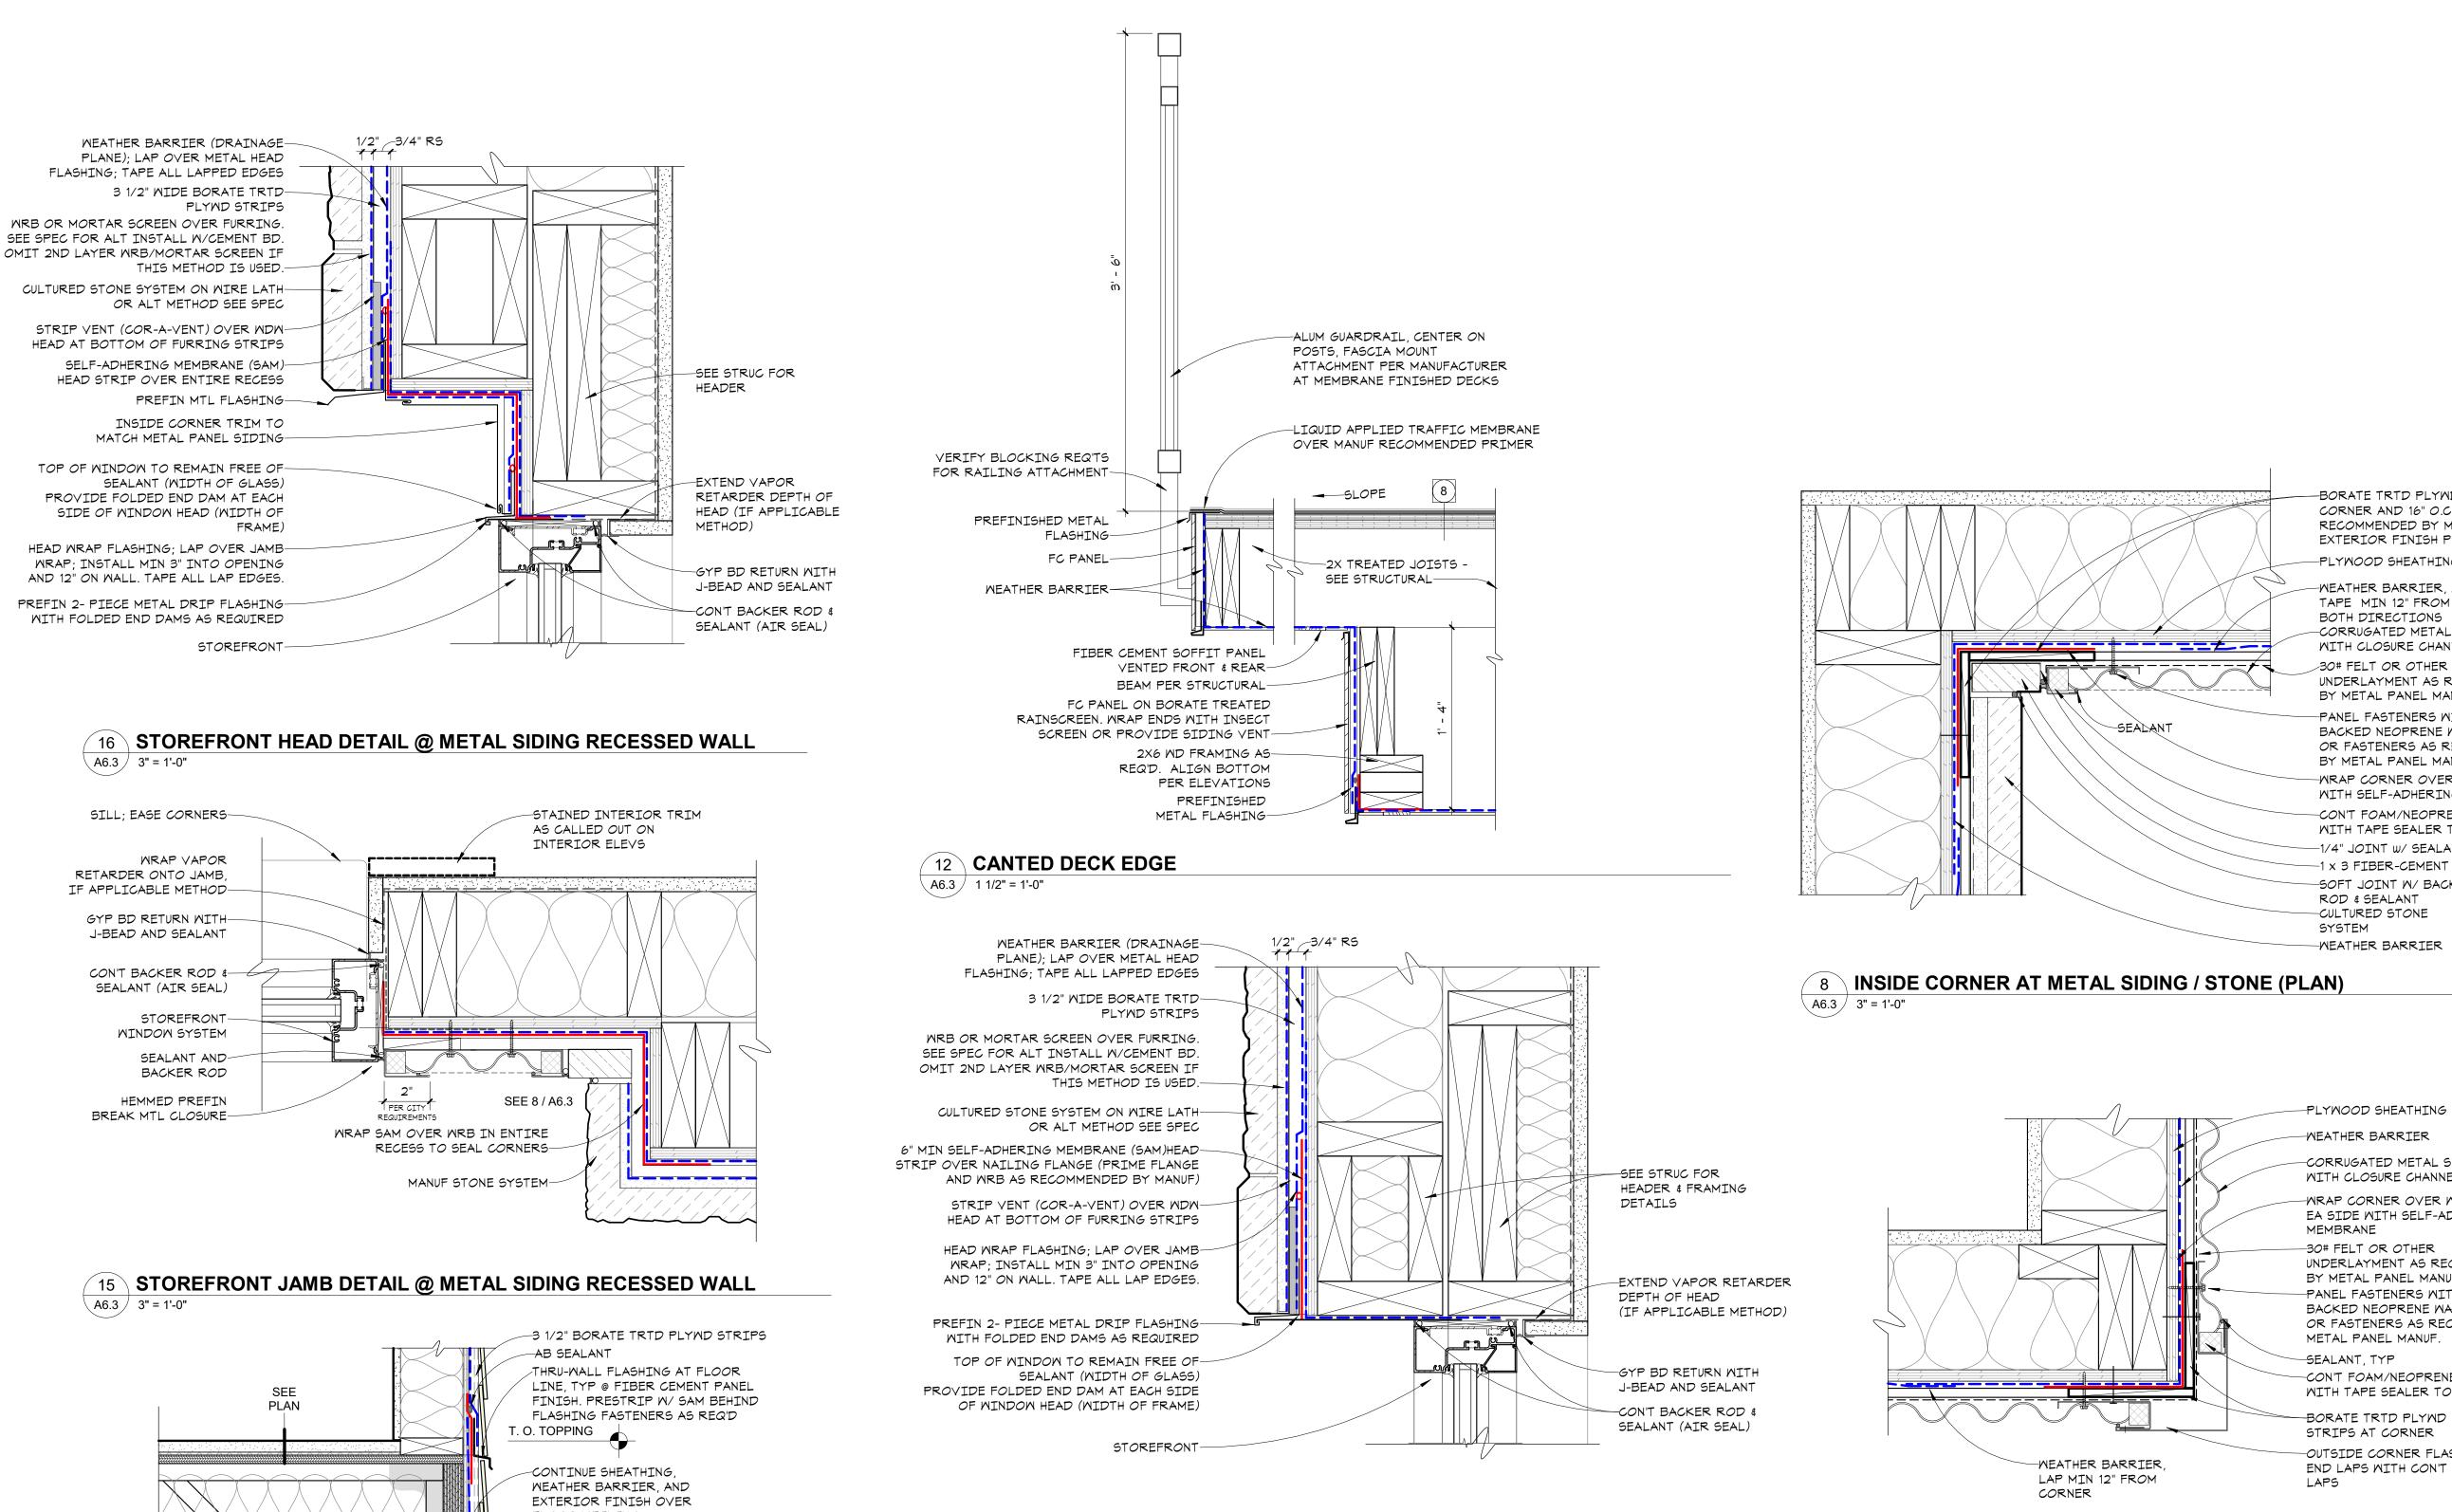

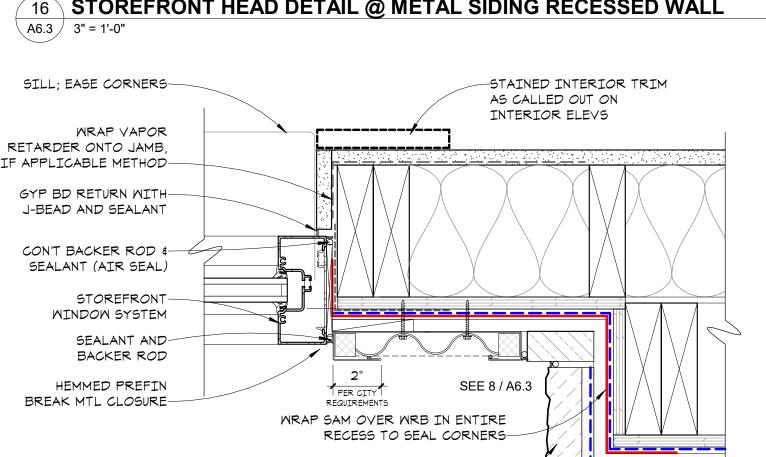


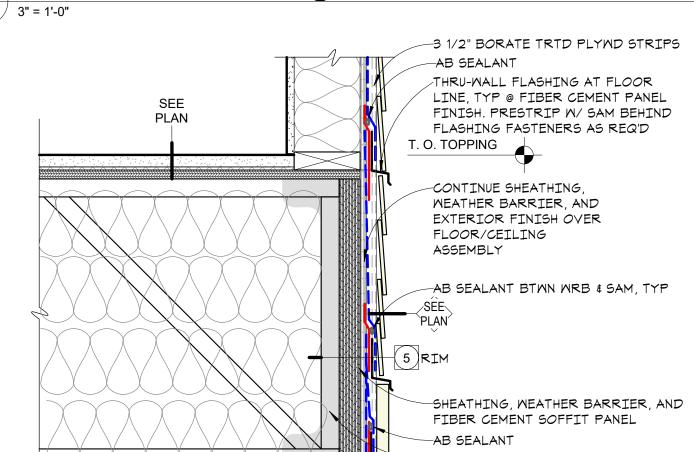

-SPRAY FOAM INSUL AT RIM

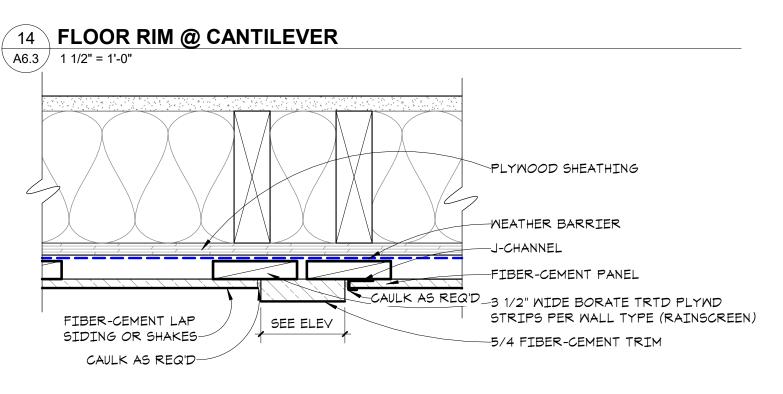




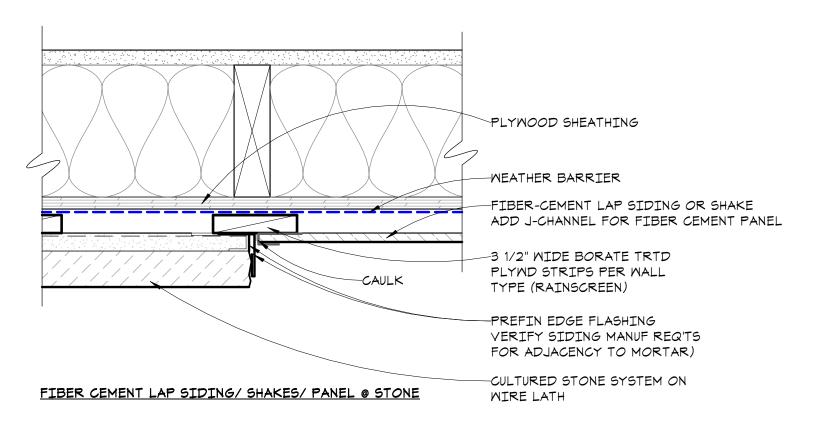



∖ A6.3 / 3" = 1'-0"



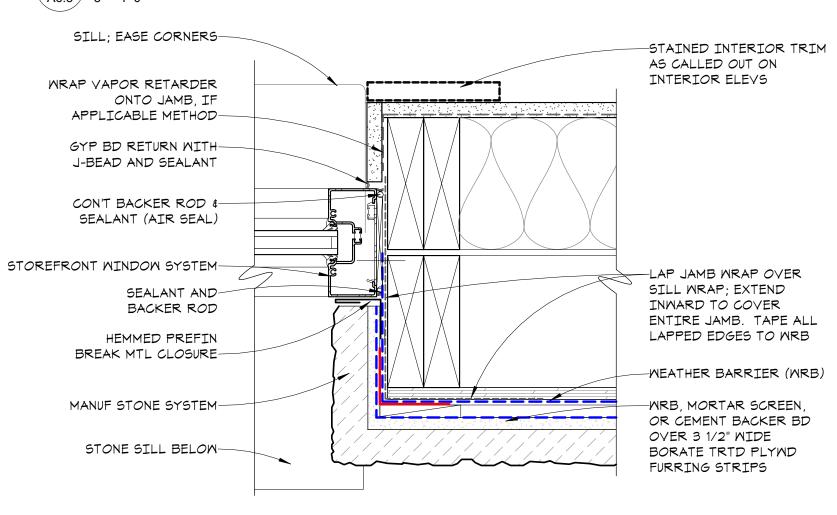




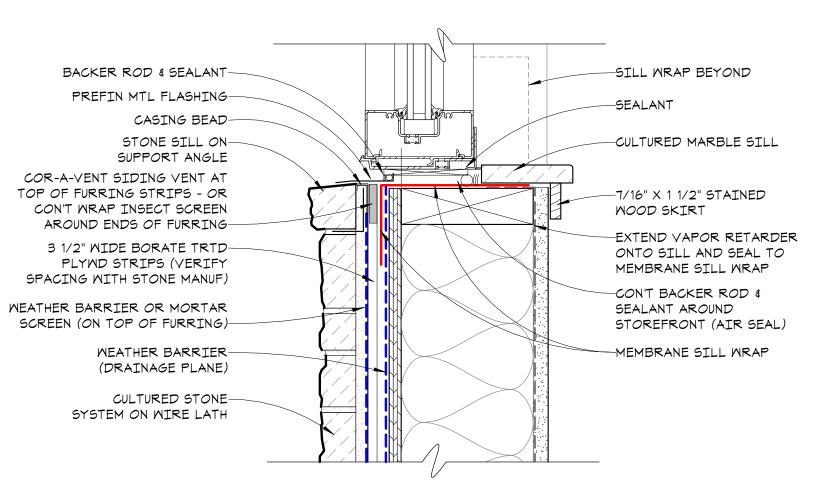

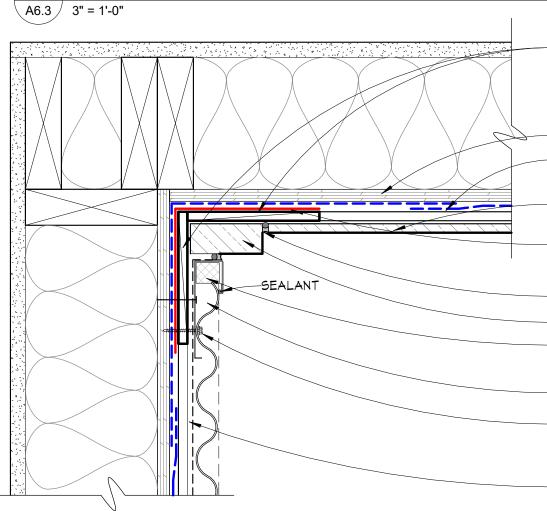



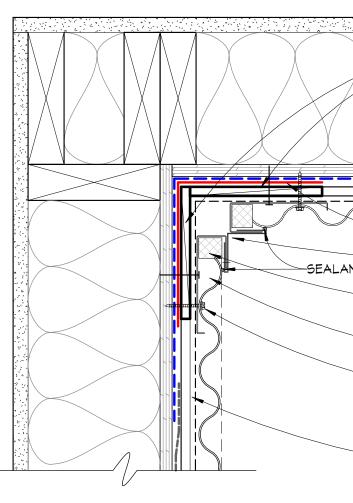




CORNER AND 16" O.C. OR AS RECOMMENDED BY MANUF OF EXTERIOR FINISH PRODUCTS -PLYWOOD SHEATHING - SEE STRUCT -WEATHER BARRIER, LAP AND TAPE MIN 12" FROM CORNER BOTH DIRECTIONS -CORRUGATED METAL SIDING WITH CLOSURE CHANNEL -30# FELT OR OTHER UNDERLAYMENT AS REQ'D BY METAL PANEL MANUF. -PANEL FASTENERS WITH METAL BACKED NEOPRENE WASHERS 16" O.C. OR FASTENERS AS RECOMMENDED BY METAL PANEL MANUF. -WRAP CORNER OVER WRB 6" EA SIDE WITH SELF-ADHERING MEMBRANE -CON'T FOAM/NEOPRENE CLOSURE WITH TAPE SEALER TOP AND BOTTOM -1/4" JOINT W/ SEALANT, TYP -1 x 3 FIBER-CEMENT TRIM -SOFT JOINT W/ BACKER

A6.3 3" = 1'-0"

3

-BORATE TRTD PLYWD STRIPS AT

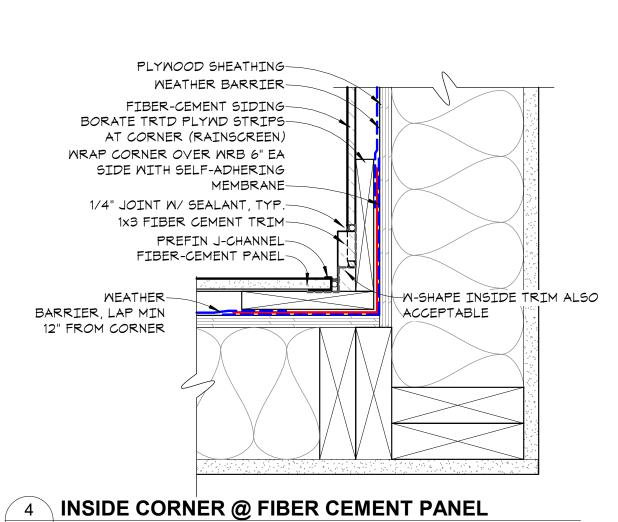

ROD & SEALANT -CULTURED STONE

-WEATHER BARRIER


SYSTEM

WEATHER BARRIER -CORRUGATED METAL SIDING WITH CLOSURE CHANNEL -WRAP CORNER OVER WRB 6" EA SIDE WITH SELF-ADHERING MEMBRANE -30# FELT OR OTHER UNDERLAYMENT AS REQ'D BY METAL PANEL MANUF. -PANEL FASTENERS WITH METAL BACKED NEOPRENE WASHERS 16" O.C. OR FASTENERS AS RECOMMENDED BY METAL PANEL MANUF. -SEALANT, TYP -CON'T FOAM/NEOPRENE CLOSURE


WITH TAPE SEALER TOP AND BOTTOM -BORATE TRTD PLYND STRIPS AT CORNER

-OUTSIDE CORNER FLASHING: 4" END LAPS WITH CON'T CAULK AT LAPS

INSIDE CORNER AT STONE / SIDING (PLAN) A6.3 / 3" = 1'-0"

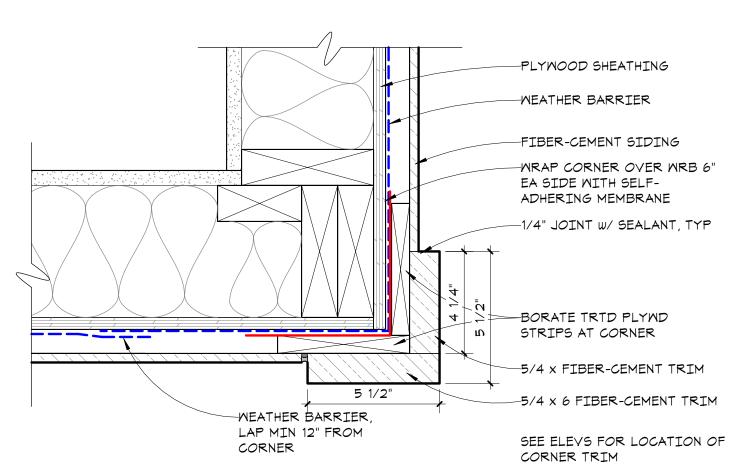

OUTSIDE CORNER AT SIDING (PLAN) A6.3 3" = 1'-0"

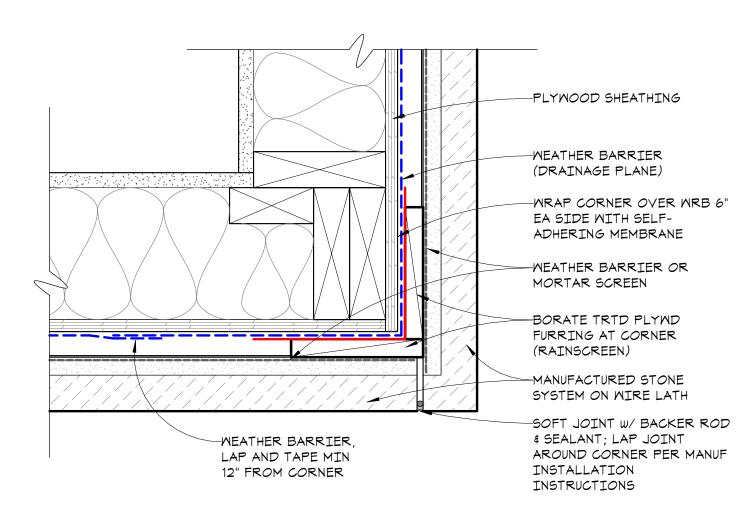

OUTSIDE CORNER AT STONE (PLAN) A6.3 3" = 1'-0"

OUTSIDE CORNER AT METAL SIDING (PLAN)

BORATE TRTD PLYND STRIPS AT CORNER AND 16" O.C. OR AS RECOMMENDED BY MANUF OF EXTERIOR FINISH PRODUCTS -PLYWOOD SHEATHING - SEE STRUCT WEATHER BARRIER, LAP AND TAPE MIN 12" FROM CORNER BOTH DIRECTIONS -FIBER-CEMENT LAP SIDING

-WRAP CORNER OVER WRB 6" EA SIDE WITH SELF-ADHERING MEMBRANE -1/4" JOINT W/ SEALANT, TYP

1 x 3 FIBER-CEMENT TRIM -CON'T FOAM/NEOPRENE CLOSURE WITH TAPE SEALER TOP AND BOTTOM CORRUGATED METAL SIDING

WITH CLOSURE CHANNEL -PANEL FASTENERS WITH METAL BACKED NEOPRENE WASHERS 16" O.C. OR FASTENERS AS RECOMMENDED BY METAL PANEL MANUF. -30# FELT OR OTHER UNDERLAYMENT AS REQ'D BY METAL PANEL MANUF.

	BORATE TRTD PLYWD STRIPS AT CORNER AND 16" O.C. OR AS RECOMMENDED BY MANUF OF EXTERIOR FINISH PRODUCTS
	PLYWOOD SHEATHING - SEE STRUCT WEATHER BARRIER, LAP AND
	TAPE MIN 12" FROM CORNER - BOTH DIRECTIONS
	CORRUGATED METAL SIDING
	WRAP CORNER OVER WRB 6" EA SIDE WITH SELF-ADHERING MEMBRANE
NT	
	CON'T FOAM/NEOPRENE CLOSURE WITH TAPE SEALER TOP AND BOTTOM
	CORRUGATED METAL SIDING WITH CLOSURE CHANNEL
	PANEL FASTENERS WITH METAL BACKED NEOPRENE WASHERS 16" O.C. OR FASTENERS AS RECOMMENDED BY METAL PANEL MANUF.

in site architects 1000 university ave. w. 🛚 suite 130 st. paul, minnesota 55104 612-252-4820 I hereby certify that this document was prepared by me or under my direct supervision and that I am a duly licensed architect under the laws of the State of Washington SEE BELOW Signature Dawn Wieczorek Typed or Printed Name 11192 6/02/23 License # Date 11192 REGISTERE ARCHITECT DAWN MARIE WIECZORE STATE OF WASHINGT Ω m $r \infty$ \supset -BORATE TRTD PLYND 7 ш -PLYWOOD SHEATHING **M** \mathbf{m} -WEATHER BARRIER, LAP AND TAPE MIN 12" FROM CORNER σ -FIBER-CEMENT SIDING ' **∩** -WRAP CORNER OVER WRB 6" EA SIDE WITH SELF-ADHERING MEMBRANE -1/4" JOINT W/ SEALANT, TYP 0 -1 x 3 FIBER-CEMENT TRIM \sim -SOFT JOINT W/ BACKER -CULTURED STONE SYSTEM City of Puyallup elopment & Permitting Servic ISSUED PERMIT Building Planning Engineering Public Works Fire Traffic PRMU20230881 PERMIT APP# PRMU20230881 PERMIT SET JUNE 02, 2023 REVISIONS Date No. Description 2108 PROJECT NUMBER Checker Author DRAWN BY CHECKED BY WESLEY BRADLEY PARK 2 EAST BROWNSTONE EXTERIOR DETAILS **A**6.


STRIPS AT CORNER


ROD & SEALANT

-WEATHER BARRIER


A6.4 3" = 1'-0"



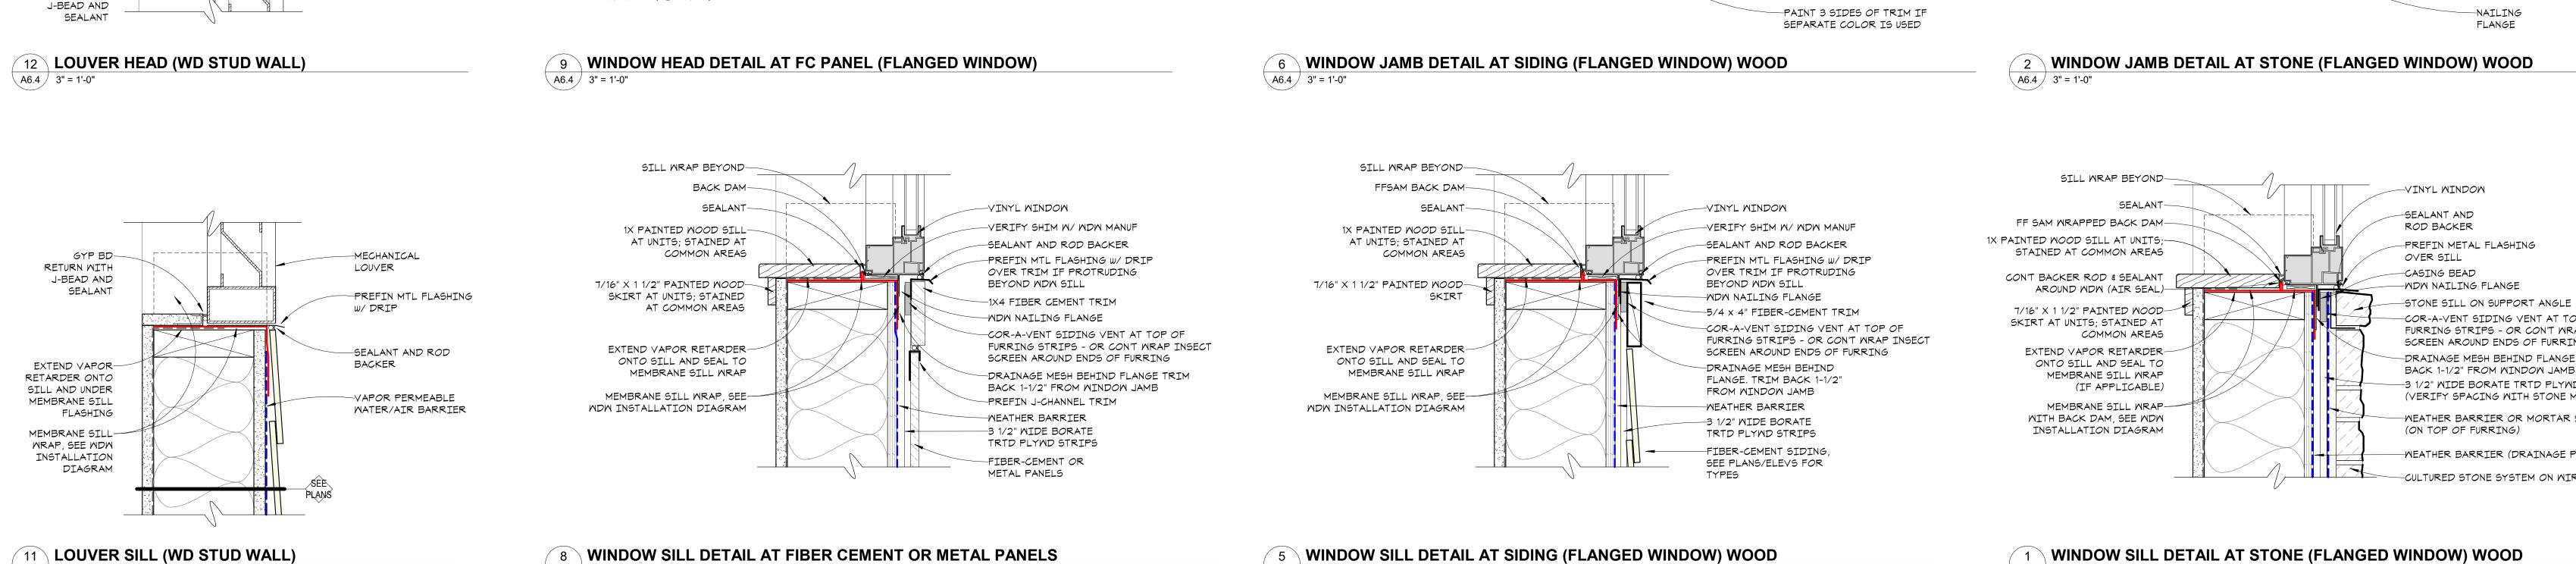

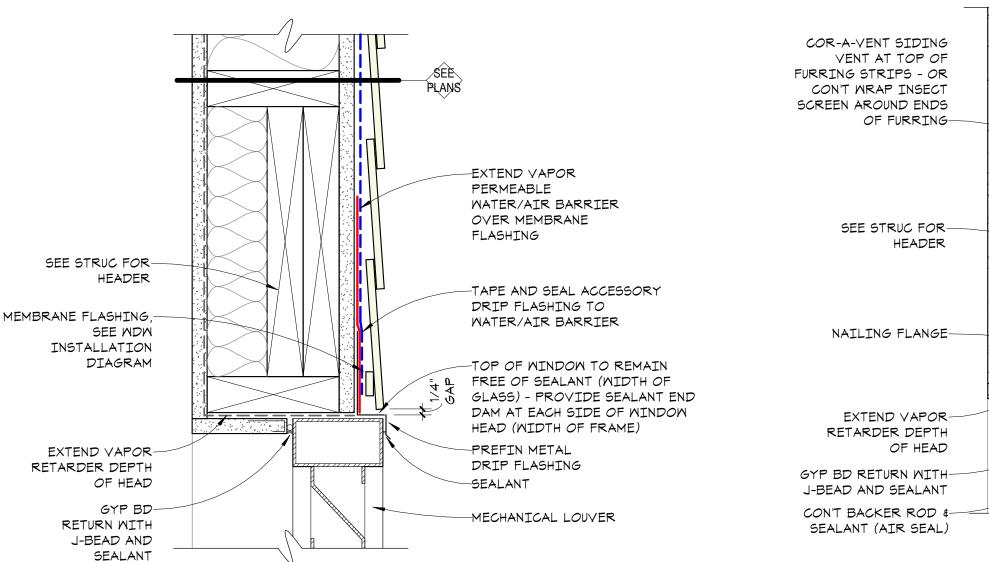

\ A6.4 / 3" = 1'-0"

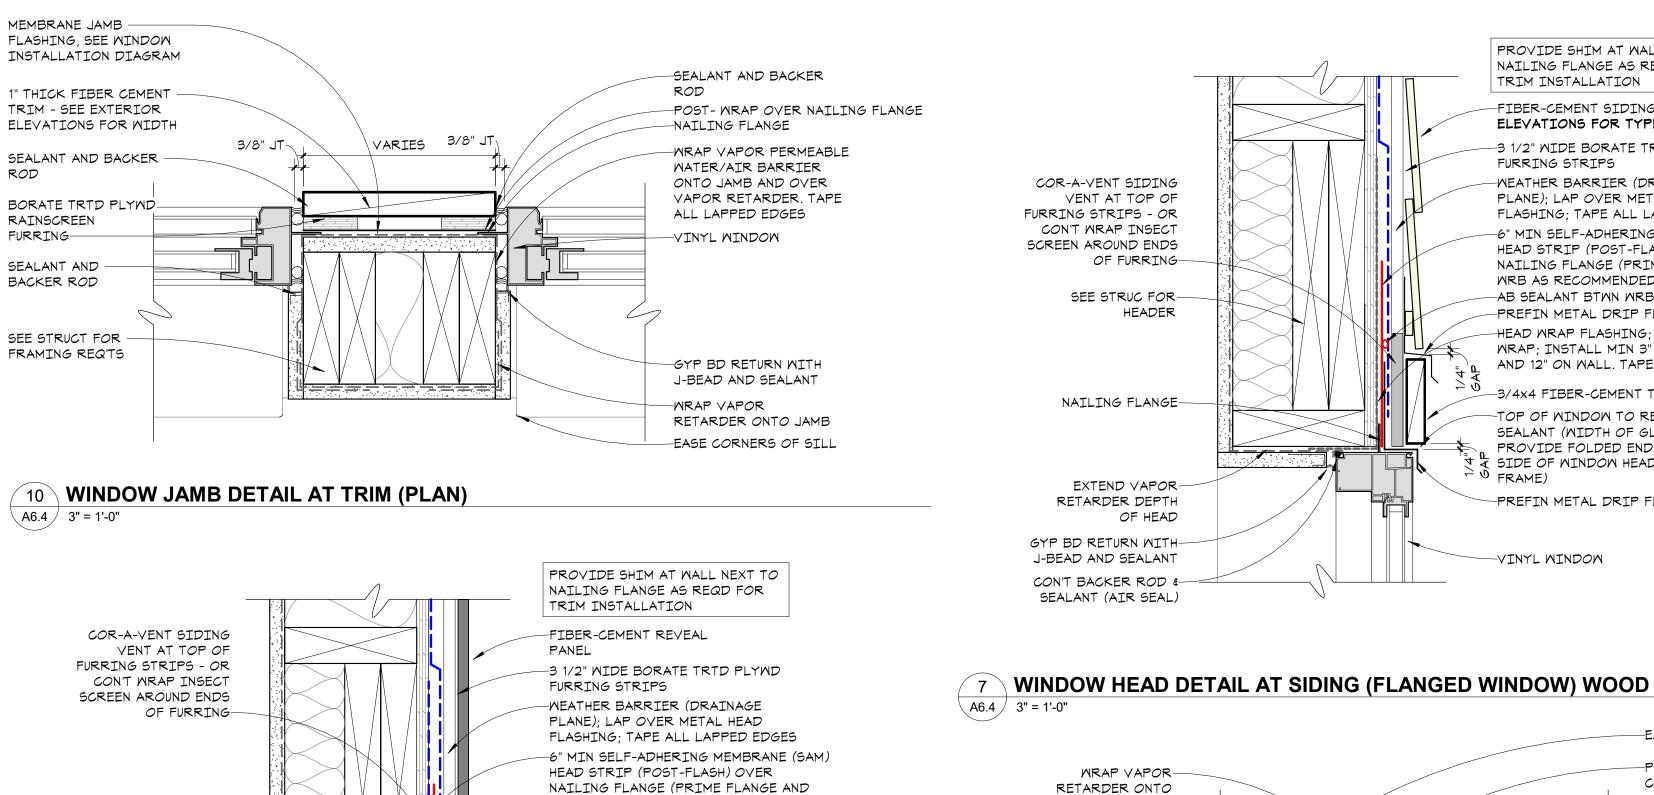

WRB AS RECOMMENDED BY MANUF)

HEAD WRAP FLASHING; LAP OVER JAMB

AND 12" ON WALL. TAPE ALL LAP EDGES.

TOP OF WINDOW TO REMAIN FREE OF

PROVIDE FOLDED END DAM AT EACH

SIDE OF WINDOW HEAD (WIDTH OF

WRAP; INSTALL MIN 3" INTO OPENING

-PREFIN METAL DRIP FLASHING

-3/4x4 FIBER-CEMENT TRIM


SEALANT (WIDTH OF GLASS)

-PREFIN METAL DRIP FLASHING

FRAME)

-VINYL WINDOW


13 WINDOW INSTALLATION DIAGRAM \ A6.4 / 1/4" = 1'-0"

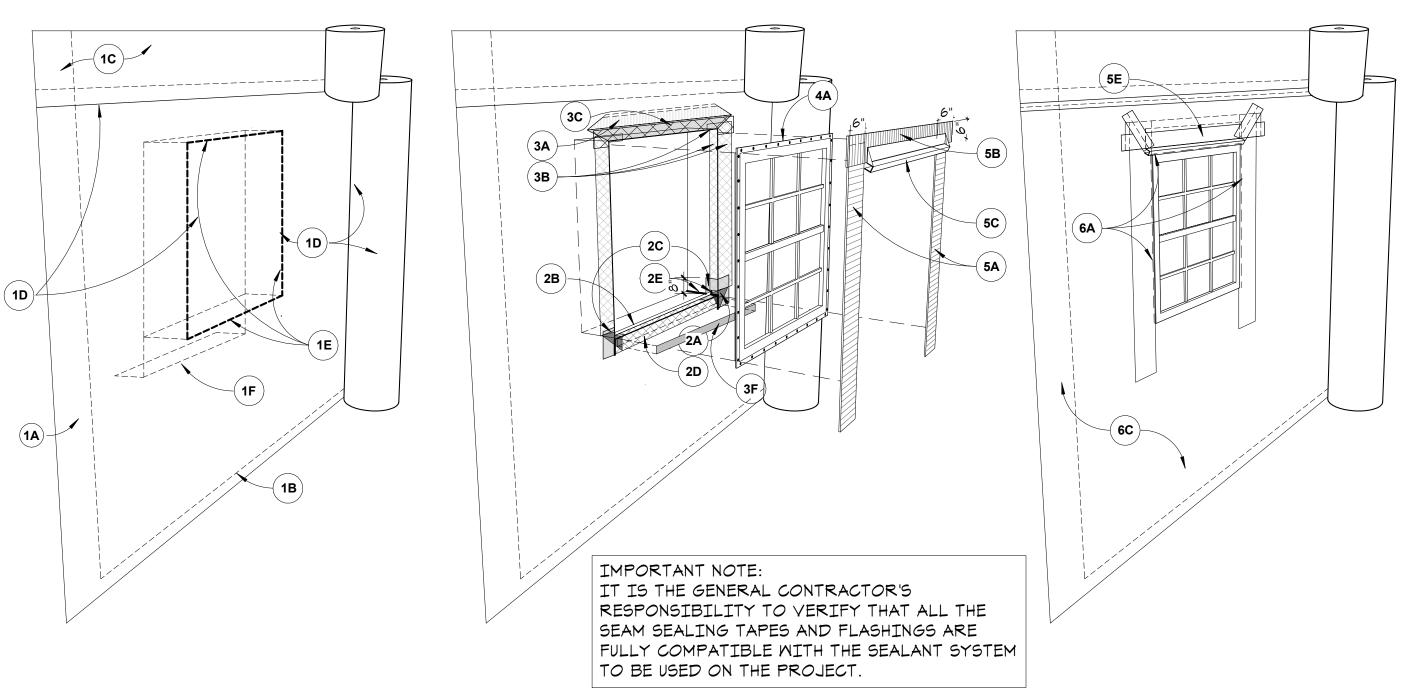


THESE DETAILS ARE TO BE USED FOR REFERENCE ONLY AND ARE NOT TO BE CONSTRUED AS INSTRUCTION FOR INSTALLATION. FOR RECOMMENDED INSTALLATION INSTRUCTIONS, REFER TO EACH MANUFACTURER'S PRODUCT MANUAL 1A UNWRAP AIR BARRIER ROLL AT BUILDING 3A CUT WRB AT 45 DEGREE ANGLE TO CREATE CORNER LEAVING 6"-12" FOR OVERLAP. (12" FLAP - TRIM LOWEST 1-1/2" OFF WRB & MIN. @ VERTICAL JOINTS)

- 1B ROLL SHOULD BE PLUMB. BOTTOM ROLL EDGE SHOULD EXTEND OVER SILL PLATE INTERFACE AT LEAST 2" TO 3"
- 1C SECURE AIR BARRIER PER MANUFACTURER RECOMMENDATIONS.
- 1D UNROLL DIRECTLY OVER WINDOWS AND DOORS. AT AIR BARRIER APPLICATIONS, LAP UPPER ROLL OVER BOTTOM ROLL BY 6" HORIZONTALLY.
- 1E TRIM THE AIR BARRIER CLEANLY AROUND THE ENTIRE WINDOW OPENING.
- 1F WHEN WRB REMOVED WELL BEFORE WINDOWS INSTALLED, WRB MAY BE LEFT DRAPING OVER ROUGH SILL & FASTENED TEMPORARILY
- 2A INSTALL MEMBRANE CORNER PATCH 2B INSTALL METAL ANGLE BACK DAM - ORIENT HORIZONTAL LEG TO FACE INTERIOR
- 2C INSTALL FOIL FACE SAM (FFSAM) BOOT MEMBRANE CORNER FLANGE. VERTICAL LEG MIN 8"
- 2D INSTALL FFSAM SILL MEMBRANE WRAP
- 2E APPLY SEALANT TO SEAMS & EDGES

- 5C INSTALL METAL HEAD FLASHING, LAPPING REMOVE - FOLD FLAP UP & FASTEN TEMPORARILY 3B INSTALL SELF-ADHERED WRB JAMB WRAP FLASHING AT EACH JAMB - EXTEND 3" MIN. 5D NOT USED INWARD AT RO. OVERLAP FFSAM CORNER BOOT MIN 6". APPLY SEALANT AT SEAMS. 5F FOLD WRB FLAP DOWN, LAPPING OVER HEAD 3C INSTALL SELF-ADHERED WRB HEAD WRAP
- FLASHING (15" WIDE STRIP) AT HEAD, LAPPING OVER JAMB WRAP FLASHINGS. EXTEND INWARD TO COVER MIN 3" OF HEAD RETURN.
- 3D APPLY SHIMS TO SILL PAN VERIFY SPACING OF SHIMS WITH WINDOW MANUFACTURER'S RECOMMENDATIONS
- 3E AT SILL PAN FLASHING, SEALANT SHOULD BE APPLIED TO UPPER PORTION OF SILL PAN BACK LEG SUCH THAT SEALANT IS ELEVATED ABOVE BOTTOM OF SILL PAN.
- 3F APPLY GUTTERGUARD DRAINAGE MESH AT SILL PAN DOWNTURN LEG TO ALLOW WATER TO DRAIN FROM SILL PAN - TRIM GUTTERGUARD BACK 1-1/2" FROM ROUGH OPENING
- 4A INSTALL WINDOW UNIT PER MANUFACTURER'S INSTRUCTIONS - SHIM & ADJUST AS REQUIRED 5A POST-FLASH: INSTALL SAM JAMB STRIP
- FLASHING AT EACH JAMB (NOTE: LIQUID APPLIED IS ALSO ACCEPTABLE) 5B POST-FLASH: INSTALL SAM HEAD STRIP
- FLASHING AT HEAD (NOTE: LIQUID APPLIED IS ALSO ACCEPTABLE)

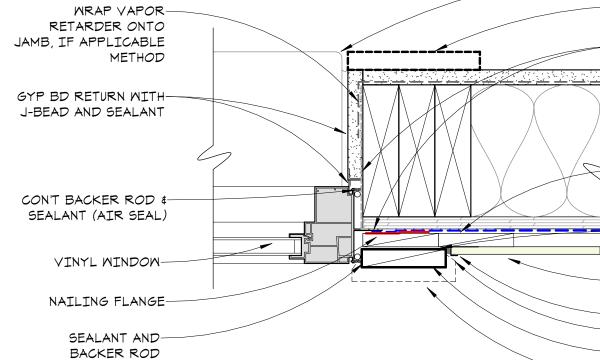



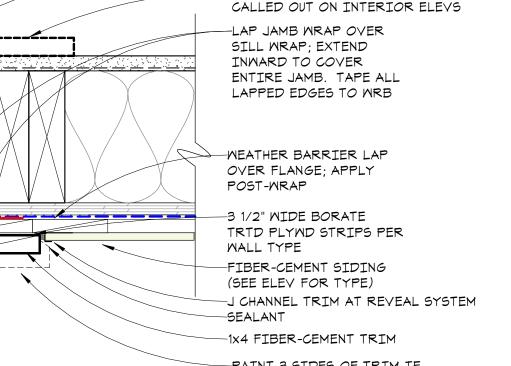

-EASE CORNER OF SILL

-PAINTED INTERIOR TRIM AS

PLANE); LAP OVER METAL HEAD FLASHING; TAPE ALL LAPPED EDGES -6" MIN SELF-ADHERING MEMBRANE (SAM) HEAD STRIP (POST-FLASH) OVER NAILING FLANGE (PRIME FLANGE AND WRB AS RECOMMENDED BY MANUF) -AB SEALANT BTWN WRB & SAM, TYP -PREFIN METAL DRIP FLASHING -HEAD WRAP FLASHING; LAP OVER JAMB WRAP; INSTALL MIN 3" INTO OPENING AND 12" ON WALL. TAPE ALL LAP EDGES. 3/4x4 FIBER-CEMENT TRIM

PROVIDE SHIM AT WALL NEXT TO NAILING FLANGE AS REQD FOR TRIM INSTALLATION -FIBER-CEMENT SIDING - SEE ELEVATIONS FOR TYPE -3 1/2" WIDE BORATE TRTD PLYWD FURRING STRIPS -WEATHER BARRIER (DRAINAGE

OVER WINDOW FRAME. TERMINATE HEAD

(SEALANT NOT NEEDED DUE TO SAM POST

FLASH @ HEAD & JAMBS.)

6B NOT USED.

FLASHING WITH 1/4" HIGH FOLDED END DAMS.

FLASHING. SEAL WRB TO SAM (AIR BARRIER

SEALANT AT GAPS BETWEEN WINDOW FRAME \$

WRAP FLASHING AT INTERIOR JAMBS & HEAD.

PENETRATIONS WITH SELF-ADHERED SEALING

NOTE: VERIFY ANY DRAINAGE HOLES IN

WINDOW TRACKS ARE CLEAR OF DIRT

AND/OR CONSTRUCTION DEBRIS

SEALANT). TAPE ALL EDGES AT WRB.

6A INSTALL A SOFT-ROD BACKER ROD & WET


6C REPAIR ACCIDENTAL TEARS, DAMAGE AND

TOP OF WINDOW TO REMAIN FREE OF SEALANT (WIDTH OF GLASS) PROVIDE FOLDED END DAM AT EACH


SIDE OF WINDOW HEAD (WIDTH OF


[™] FRAME) -PREFIN METAL DRIP FLASHING


VINYL WINDOW

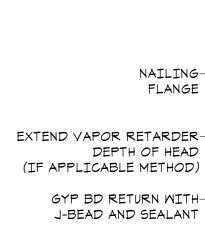


3/4" RS_ 1/2' PLYND STRIPS THIS METHOD IS USED. -VINYL WINDOW

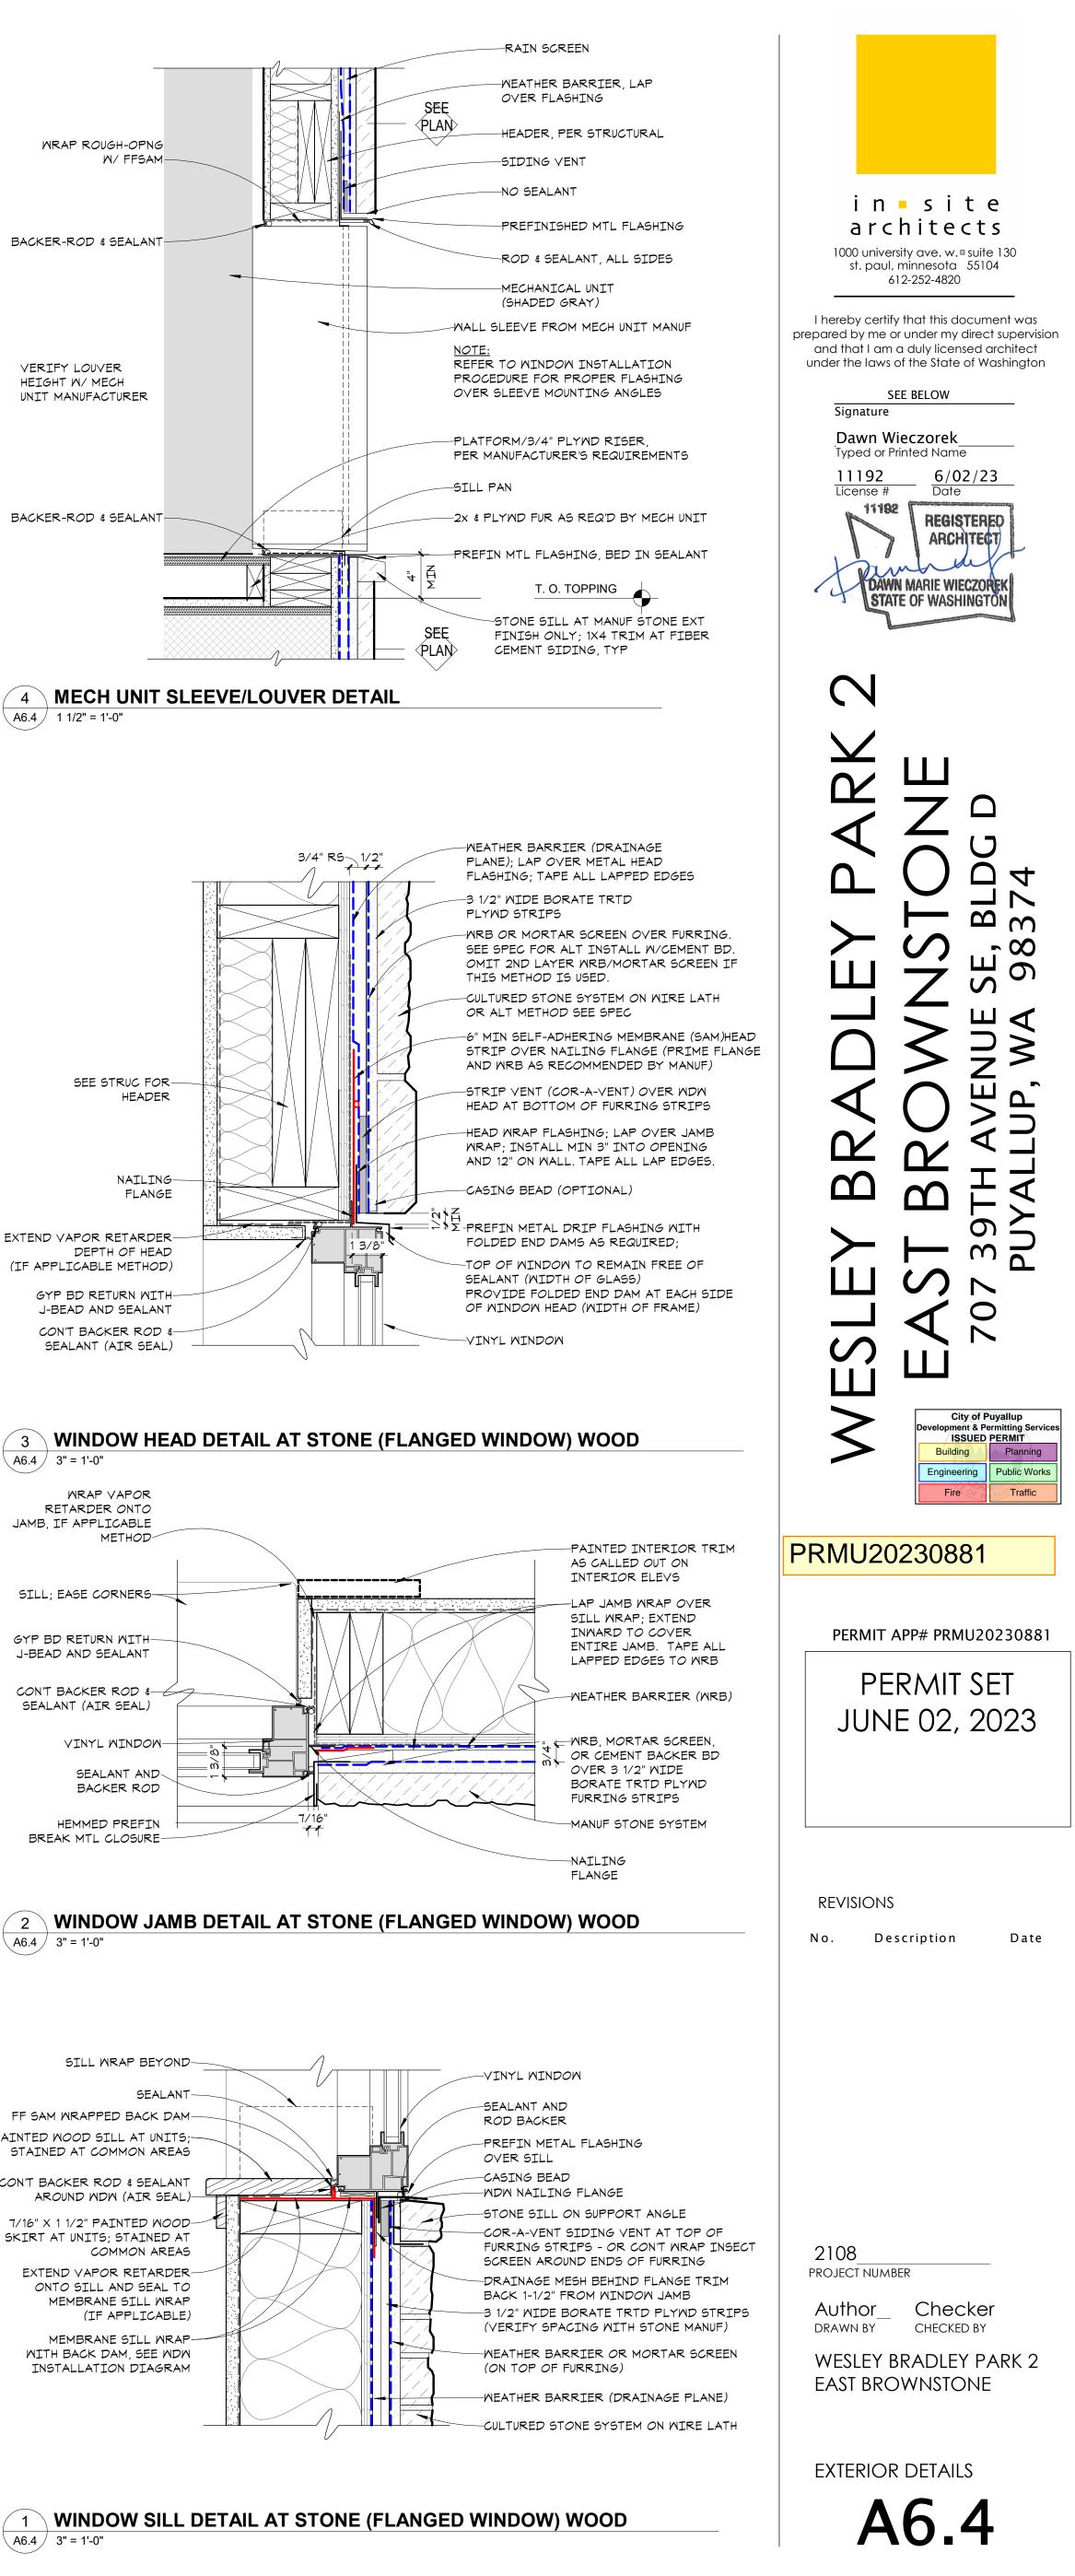

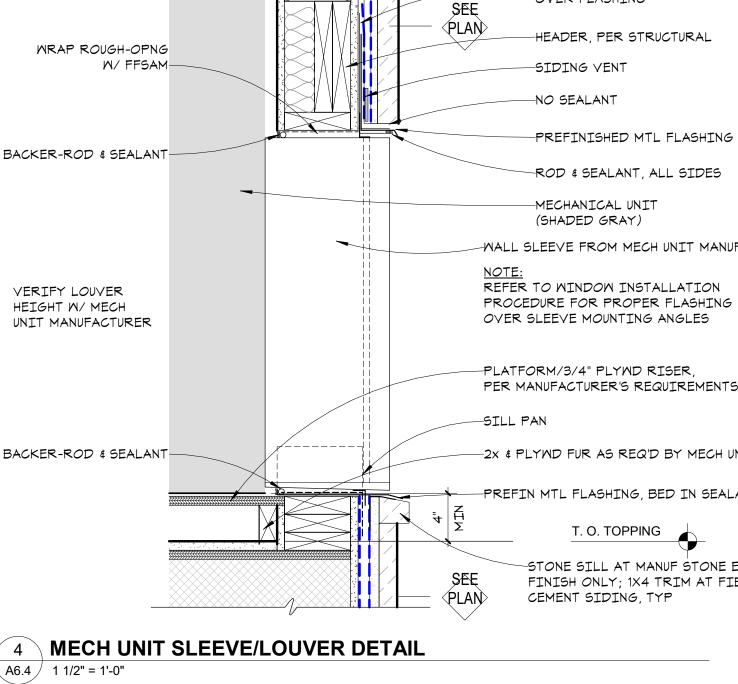


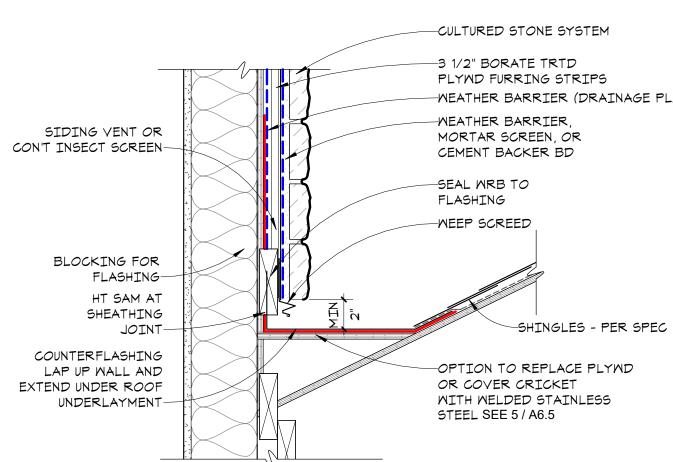





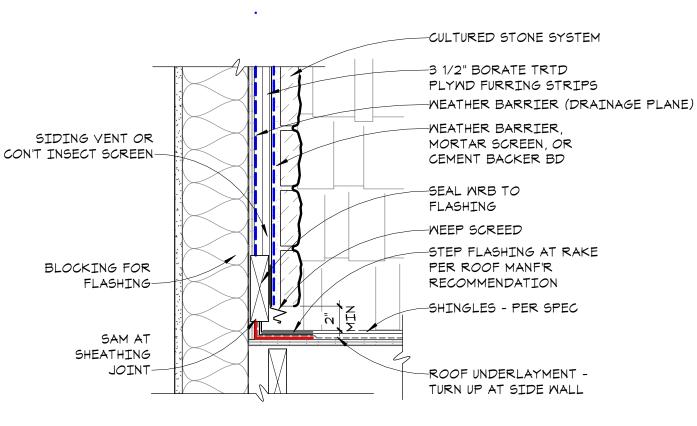




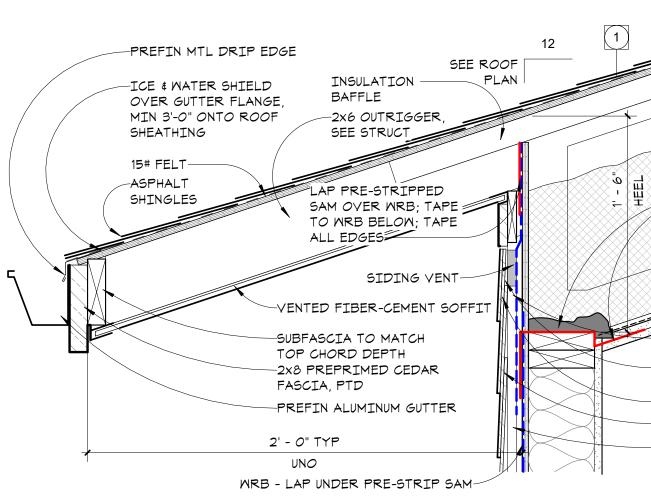


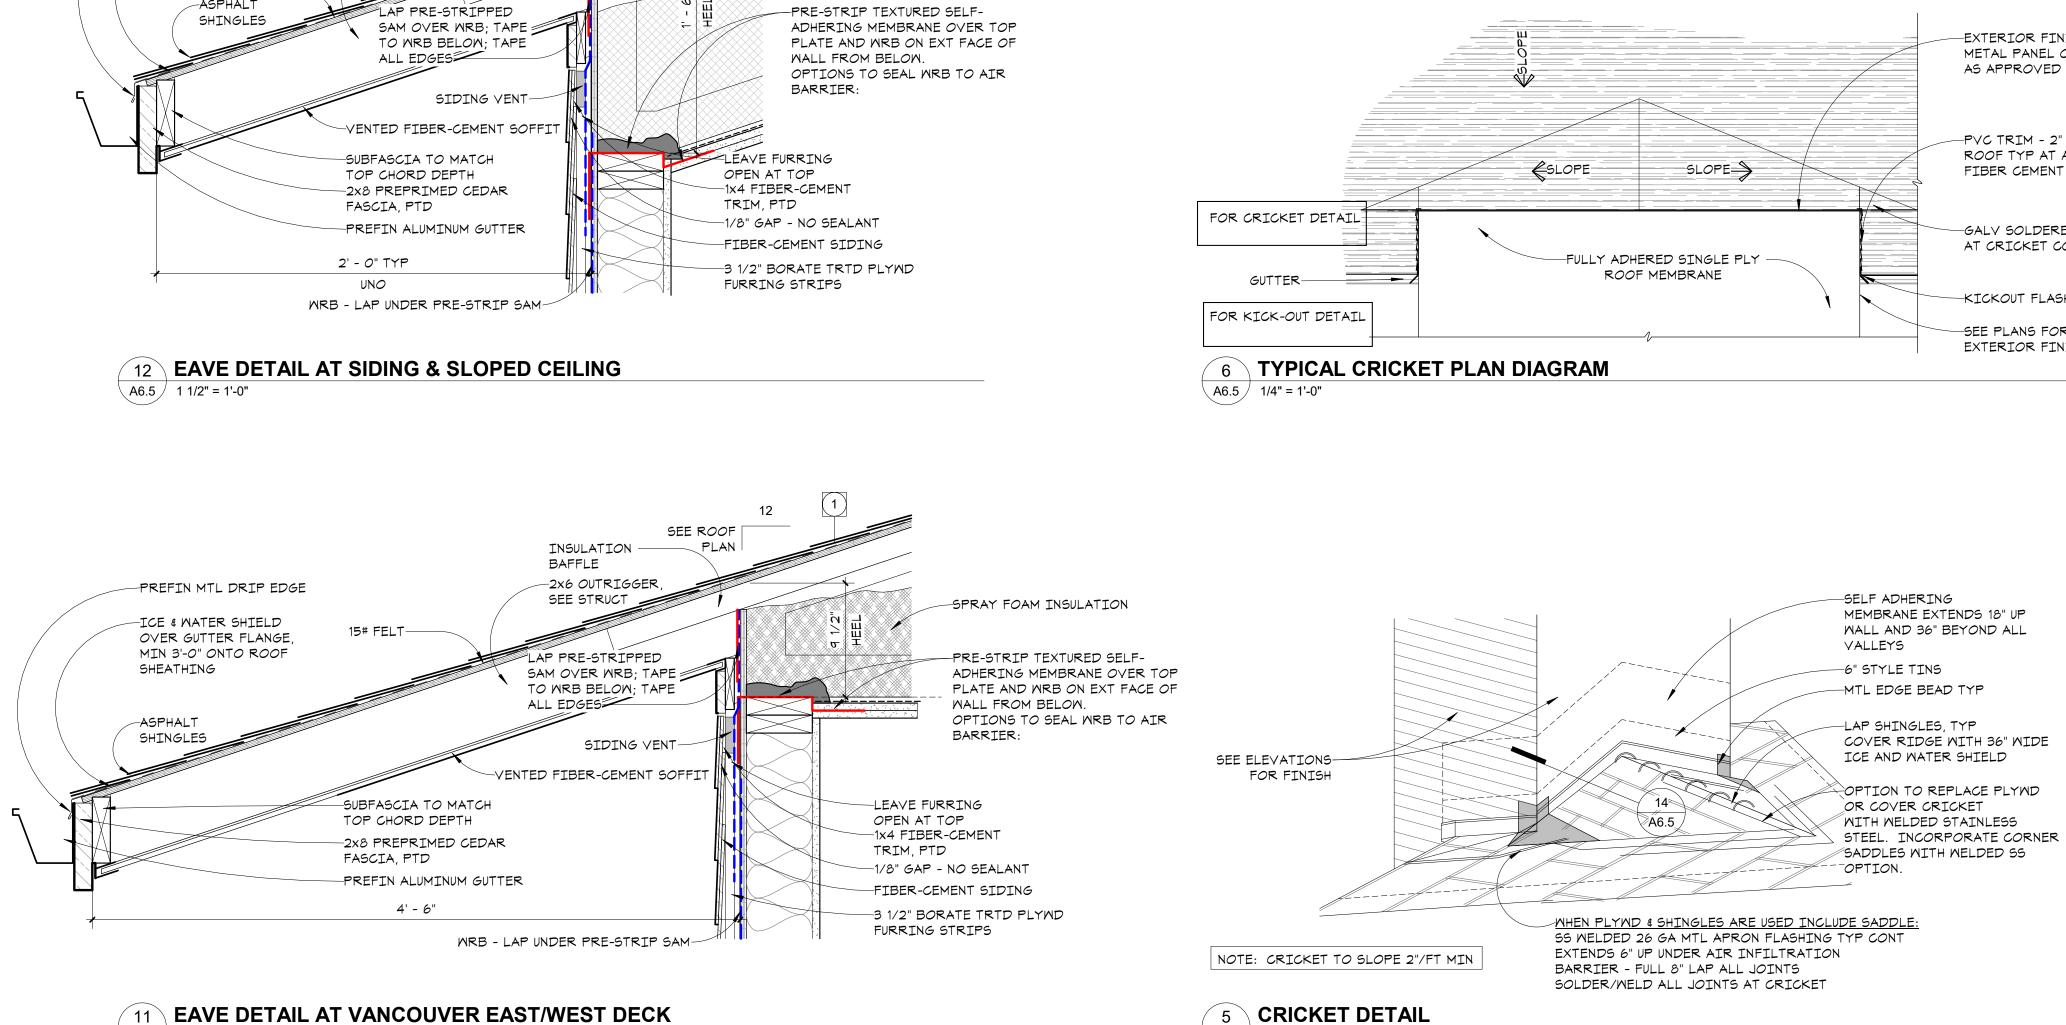


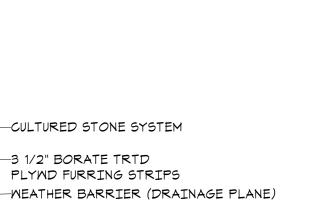

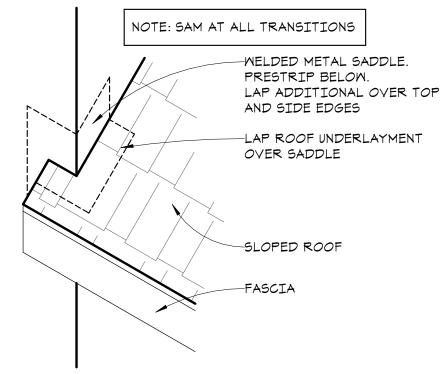


10 SADDLE @ ROOF/ CORNER A6.5 1 1/2" = 1'-0"

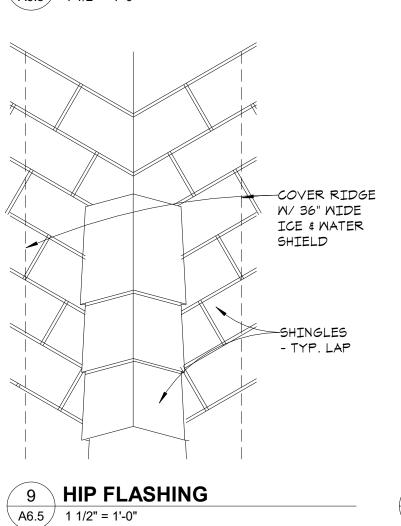

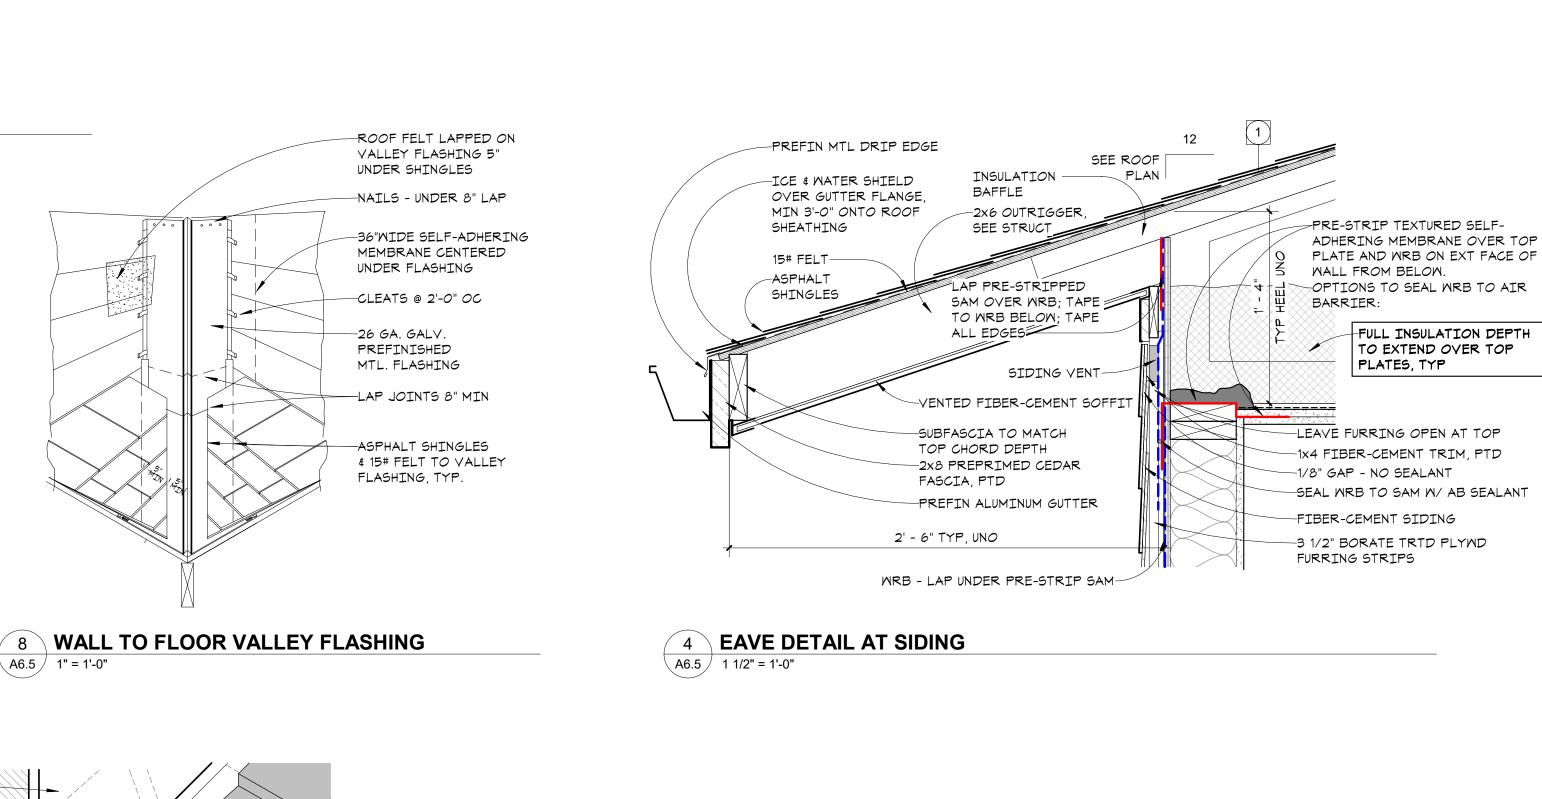

8

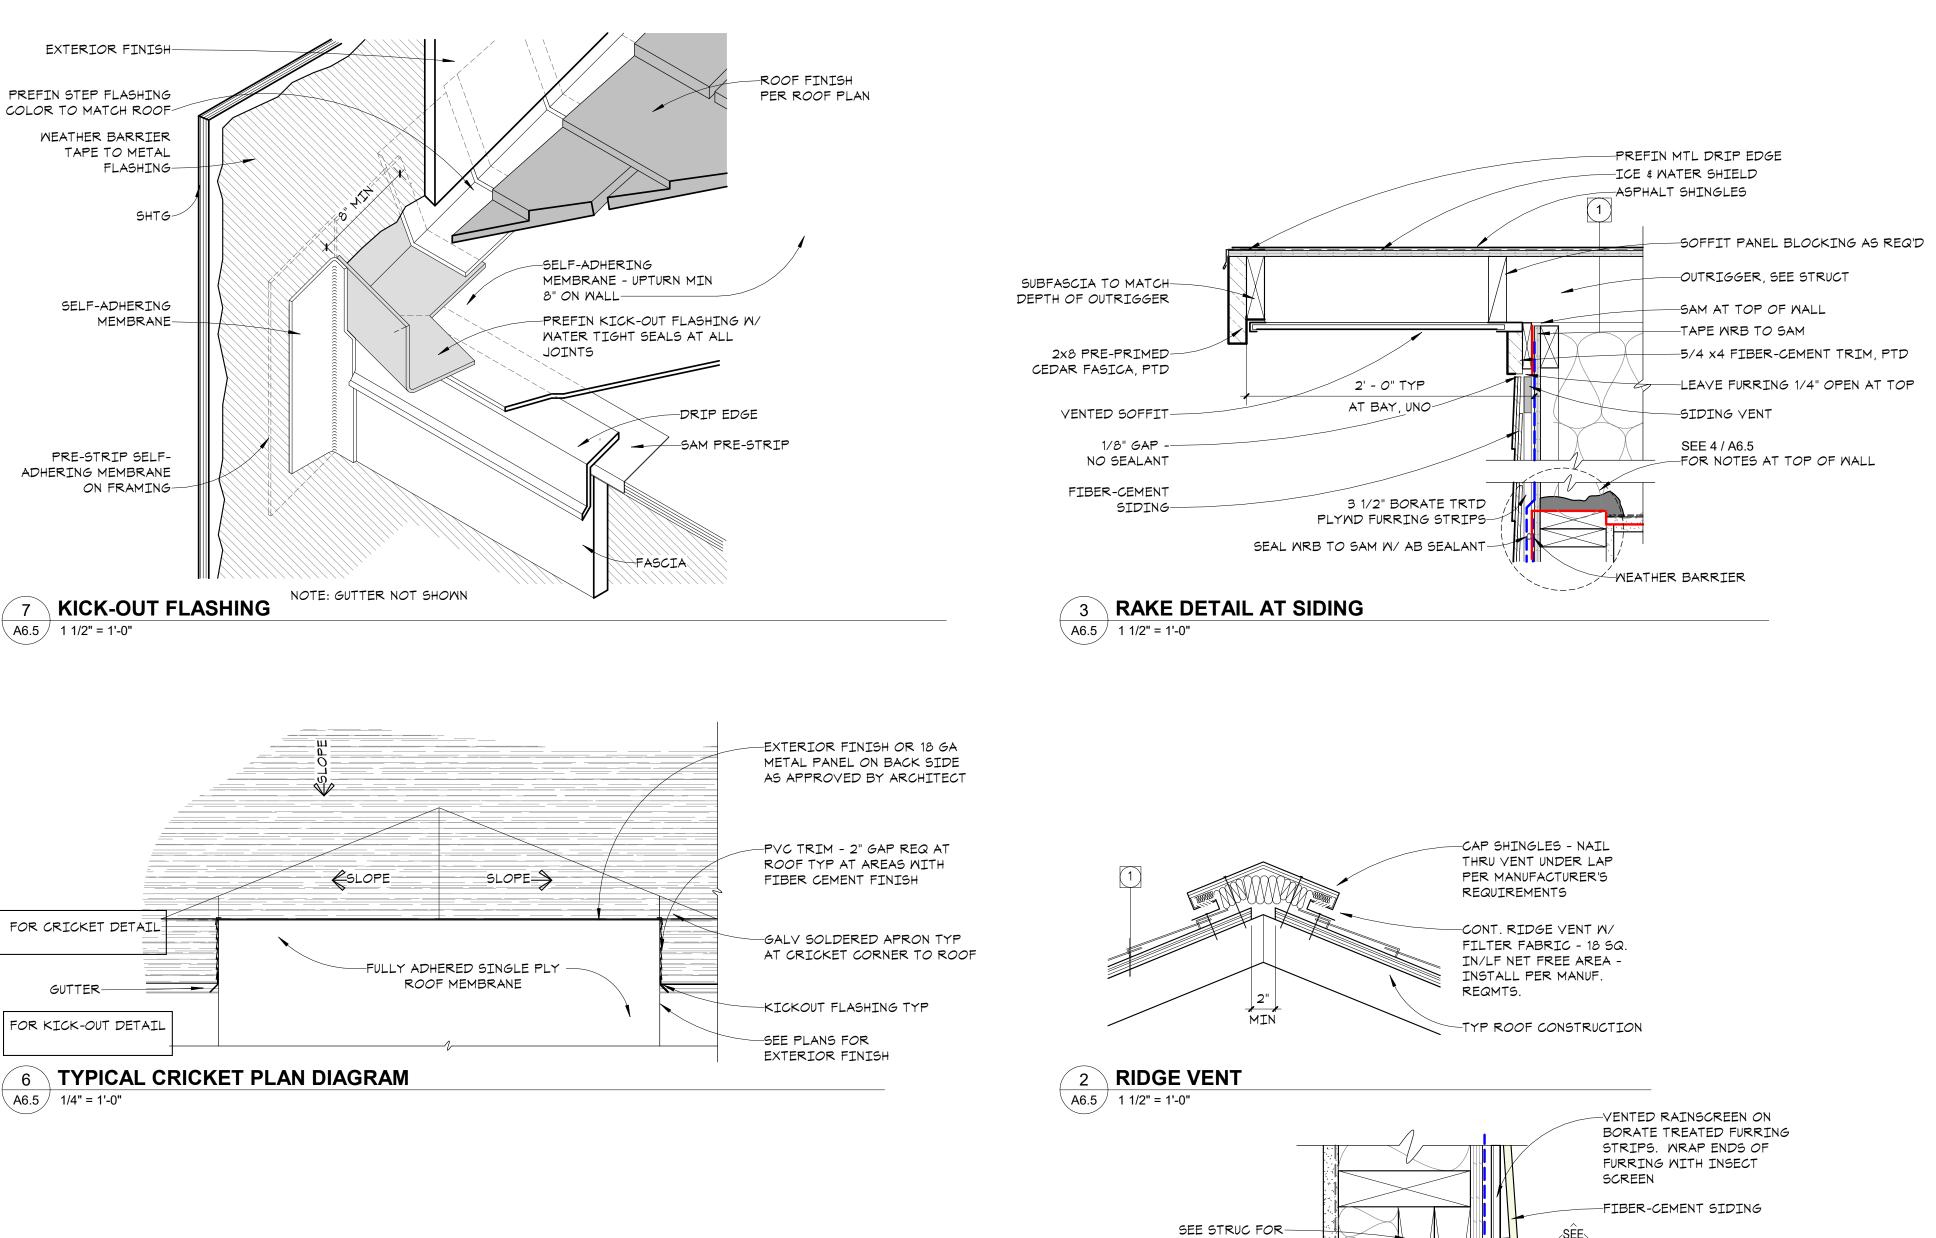

7 KICK-OUT FLASHING

A6.5 1/2" = 1'-0"

EXTERIOR HM DOOR HEAD **1** \ A6.5 / 3" = 1'-0"

HEADER

SEAL WRB TO SAM

W/ AB SEALANT-

SAM POST-

WRAP VAPOR-

OPENING

EXTEND VAPOR-

RETARDER DEPTH OF

HEAD (IF OCCURS)

PERMEABLE WATER/AIR

BARRIER INTO ROUGH

TO WRB

WRAP FLANGE

>SEE

PLAN/ELEV

ᡟᡔᠴᠴᠴ

-SIDING VENT

FLASHING

-PREFIN METAL

HM DOOR FRAME

DRIP FLASHING

-SPRAY FOAM INSULATION

-WEATHER BARRIER

ALL LAPPED EDGES

-PREFIN METAL DRIP

(DRAINAGE PLANE); LAP OVER

METAL HEAD FLASHING; TAPE


-5/4x4 FIBER-CEMENT TRIM

-TOP OF FLASHING TO REMAIN FREE


END DAM AT EACH SIDE OF OPENING

OF SEALANT - PROVIDE SEALANT


in site architects 1000 university ave. w. = suite 130 st. paul, minnesota 55104 612-252-4820 I hereby certify that this document was prepared by me or under my direct supervision and that I am a duly licensed architect under the laws of the State of Washington SEE BELOW Signature Dawn Wieczorek Typed or Printed Name 11192 6/02/23 License # Date 11192 REGISTEREC ARCHITECT TOAWN MARIE WIECZOREN STATE OF WASHINGT Ω m $r \infty$ шo Ш∢ $\supset \geq$ 7 Ρ $\mathbf{\Omega}$ \mathbf{m} $\mathbf{\Omega}$ **6** т М \mathcal{O} 0 \mathcal{O} Ш City of Puyallup velopment & Permitting Services Building Planning Engineering Public Works Fire Traffic PRMU20230881 PERMIT APP# PRMU20230881 PERMIT SET JUNE 02, 2023 REVISIONS Date No. Description 2108 PROJECT NUMBER Author Checker DRAWN BY CHECKED BY WESLEY BRADLEY PARK 2 EAST BROWNSTONE EXTERIOR DETAILS

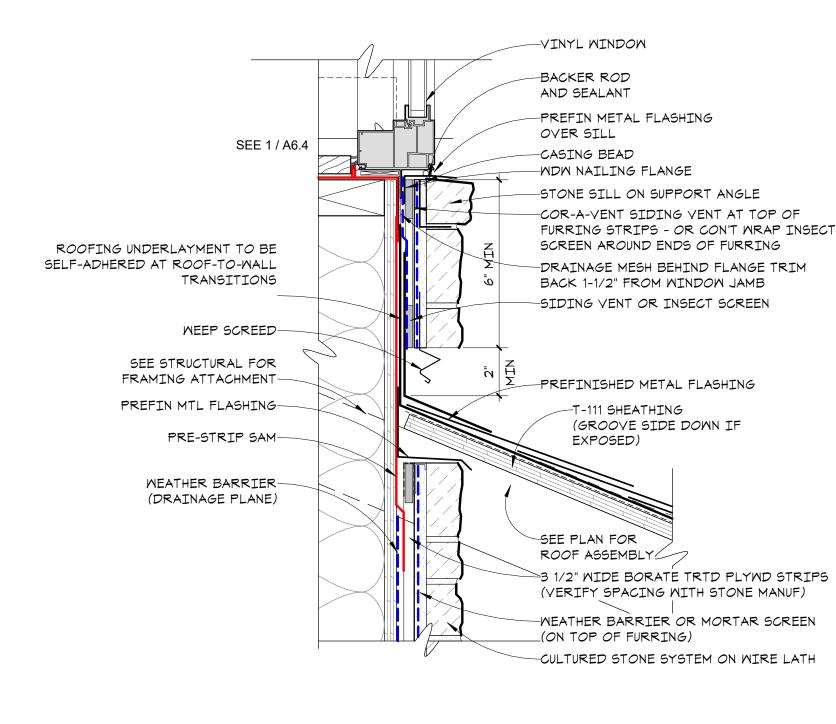




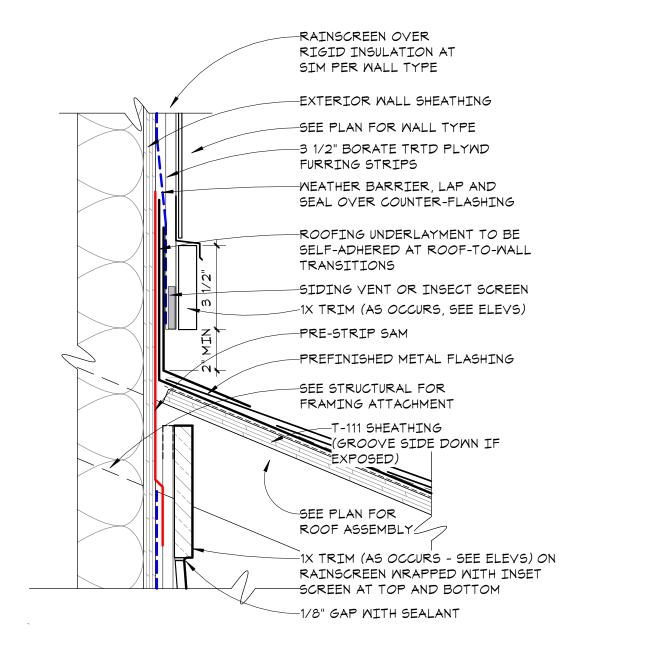


3 RECESS DETAIL @ GAME/CLUB ROOMS A6.6 1 1/2" = 1'-0"

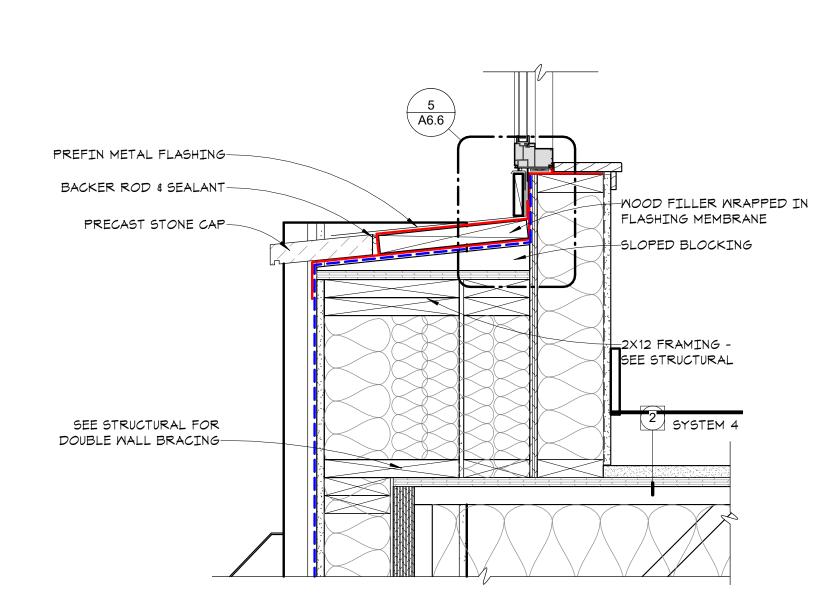



4 RECESS DETAIL @ CAMANO SUNROOM A6.6 1 1/2" = 1'-0"

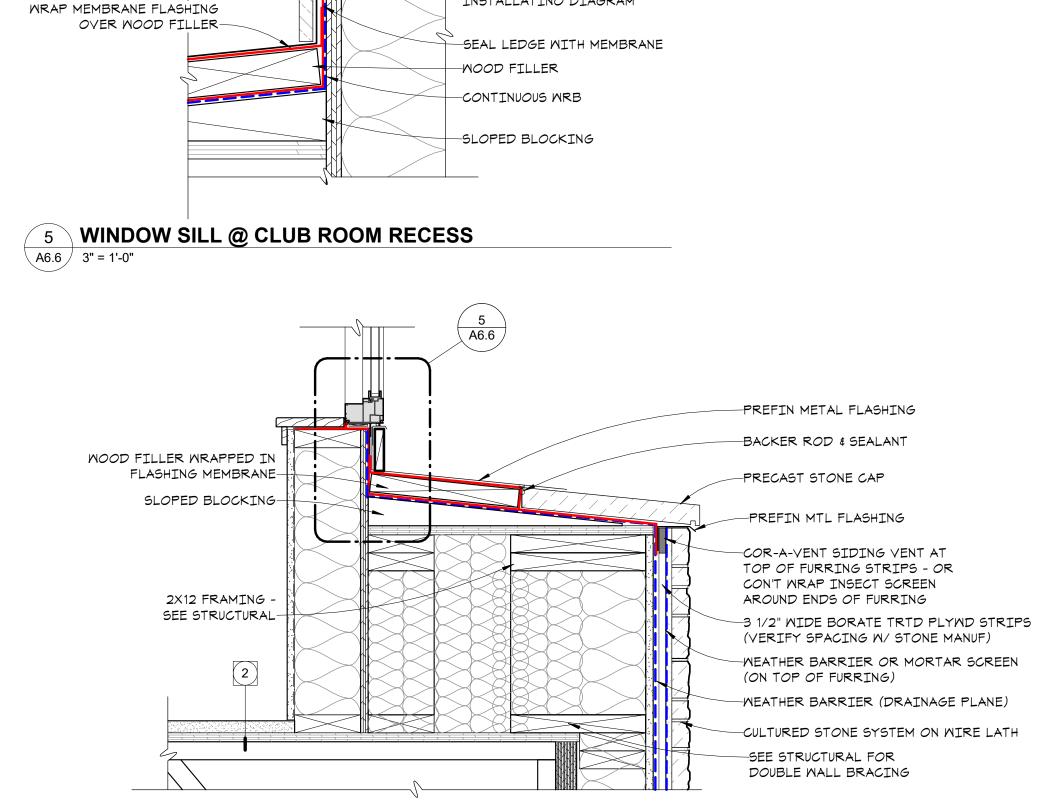


-SEALANT BACKER ROD & SEALANT--FF SAM WRAPPED BACK DAM PREFIN METAL FLASHING--1X STAINED WOOD SILL FIBER CEMENT TRIM-PREFIN METAL FLASHING TUCKED BEHIND TRIM -MEMBRANE SILL WRAP WITH FLASHING AND EXTENDED BACK DAM, SEE NDN OUT TO STONE CAP-INSTALLATINO DIAGRAM WRAP MEMBRANE FLASHING

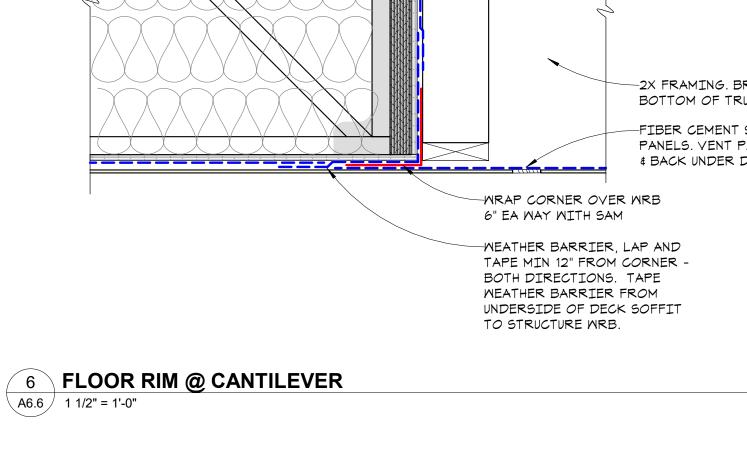

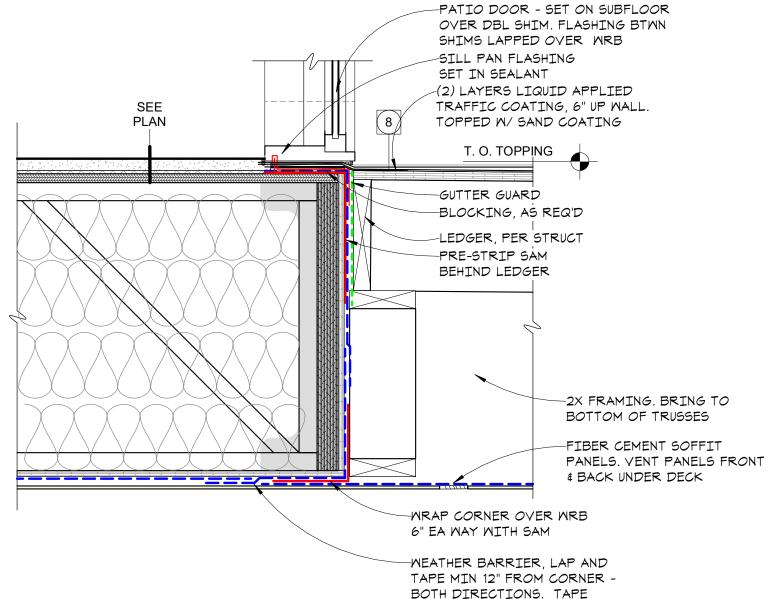


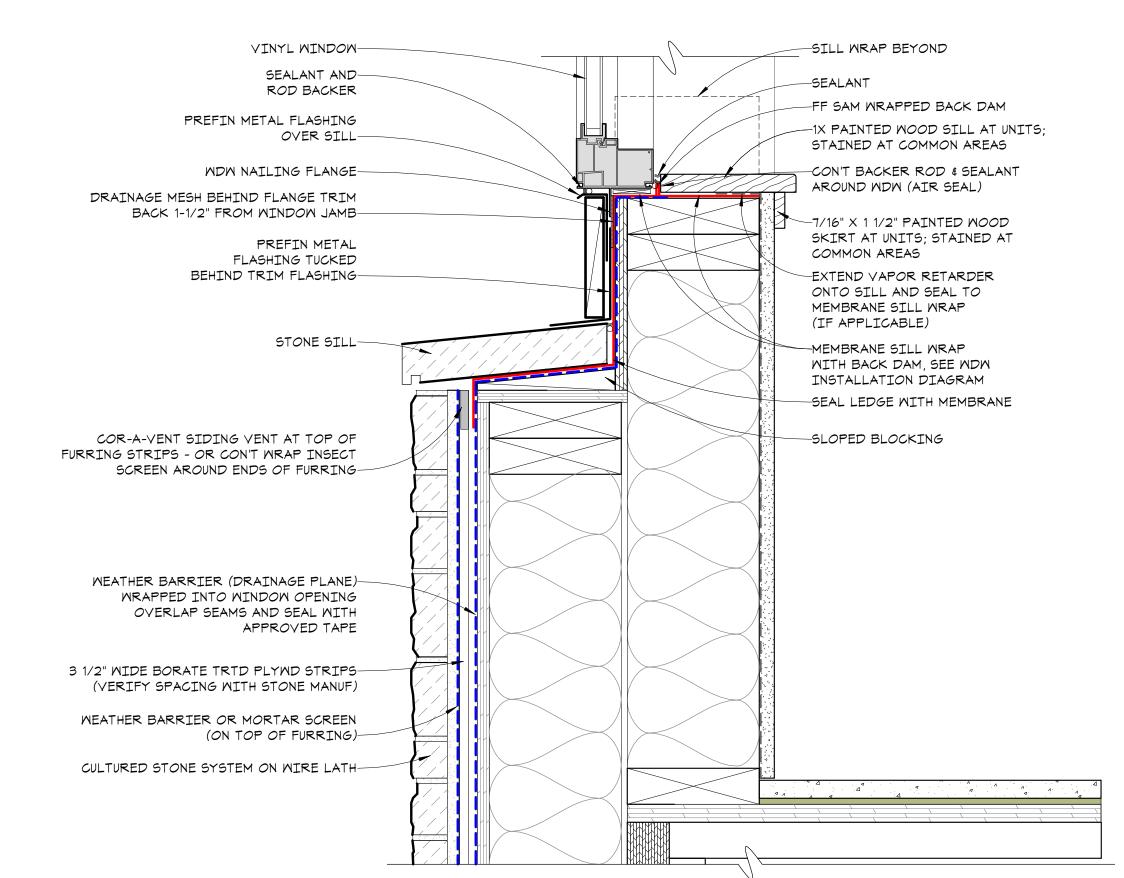





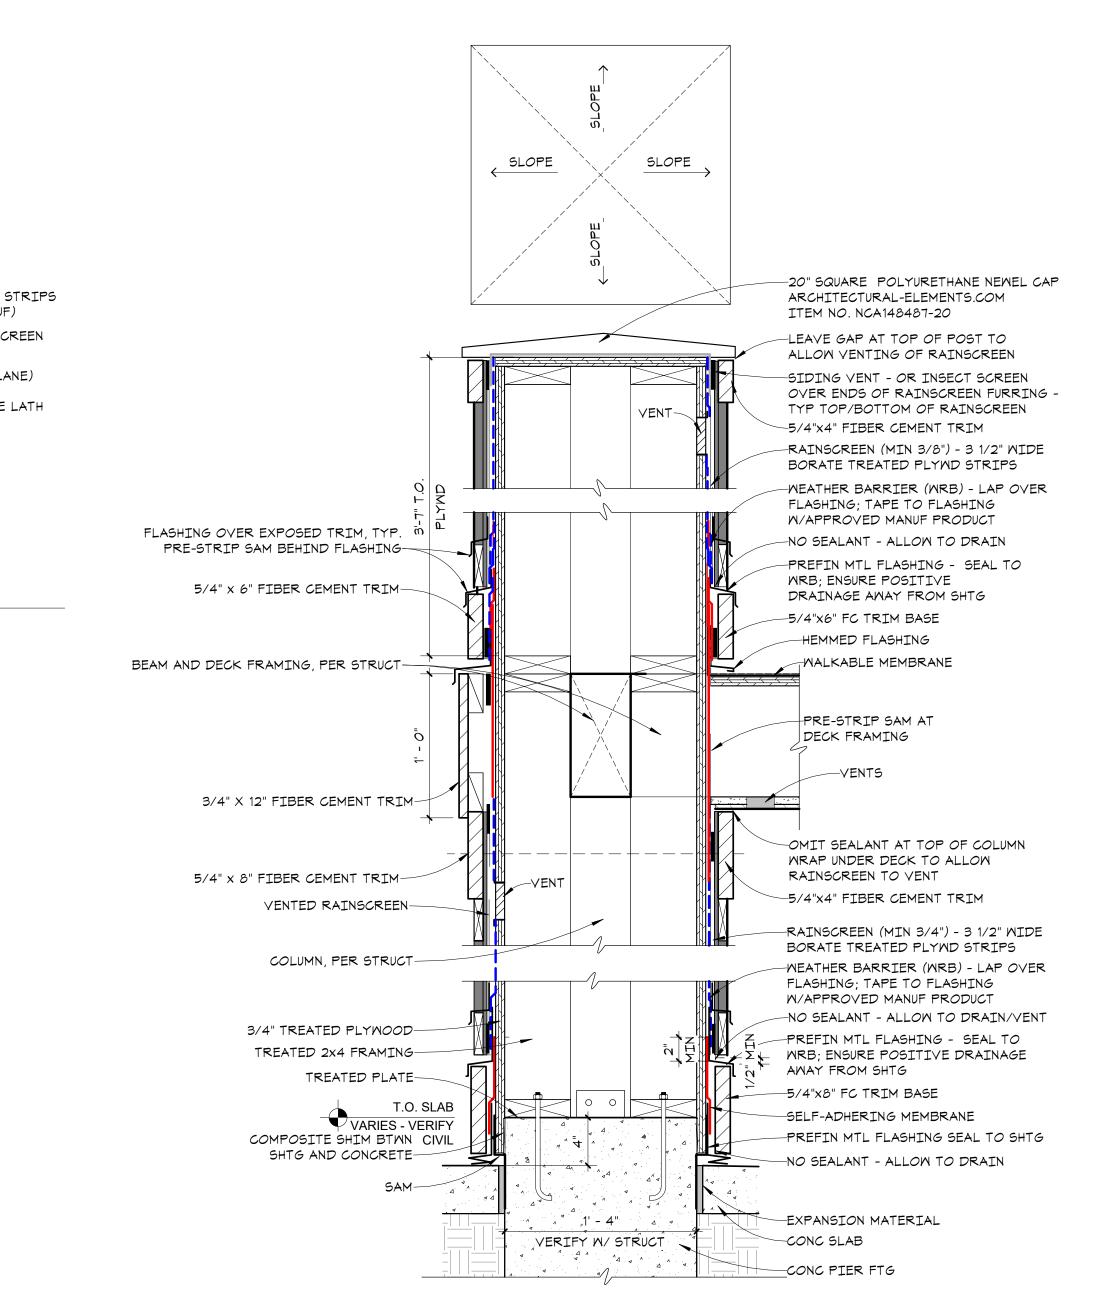

in site architects 1000 university ave. w. = suite 130 st. paul, minnesota 55104 612-252-4820 I hereby certify that this document was prepared by me or under my direct supervision and that I am a duly licensed architect under the laws of the State of Washington SEE BELOW Signature Dawn Wieczorek Typed or Printed Name 6/02/23 11192 License # Date 11192 REGISTERE ARCHITECT DAWN MARIE WIECZORE STATE OF WASHINGT \sim \neg Δ m $r \infty$ ШO $\supset \geq$ 7 \bigcap \mathbf{m} \mathbf{m} σ 0 \sim \mathbf{S} City of Puyallup velopment & Permitting Service ISSUED PERMIT Building Planning Engineering Public Works Fire PRMU20230881 PERMIT APP# PRMU20230881 PERMIT SET JUNE 02, 2023 REVISIONS No. Description Date 2108 PROJECT NUMBER Author_ Checker DRAWN BY CHECKED BY WESLEY BRADLEY PARK 2 EAST BROWNSTONE EXTERIOR DETAILS A6.

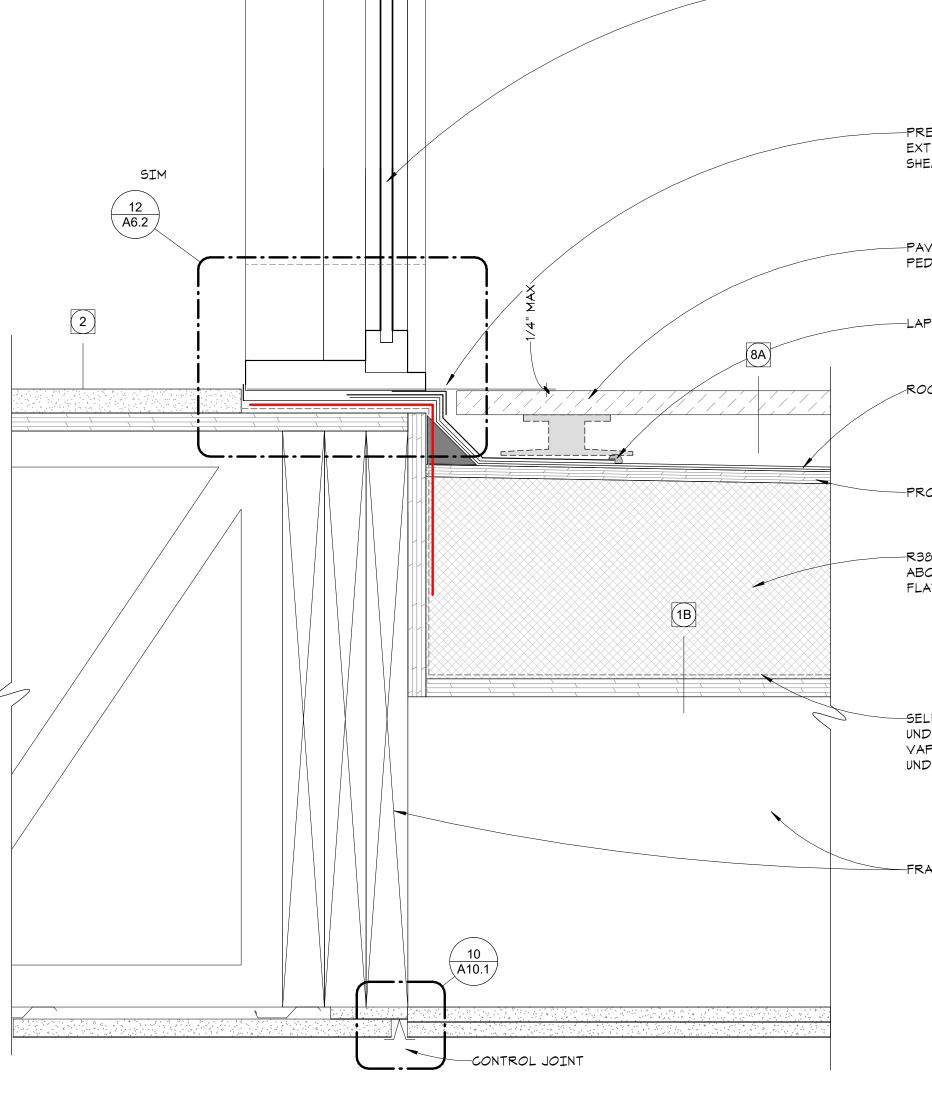

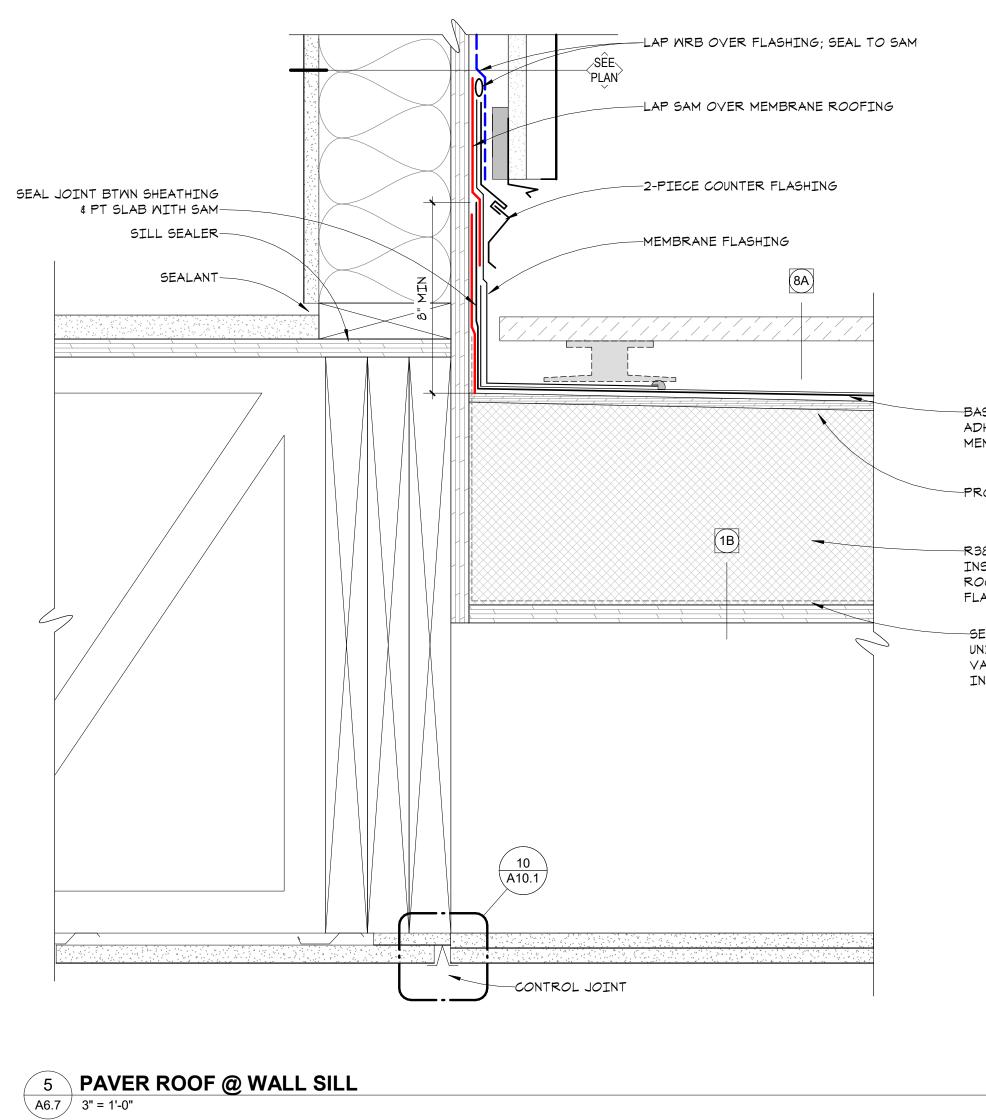

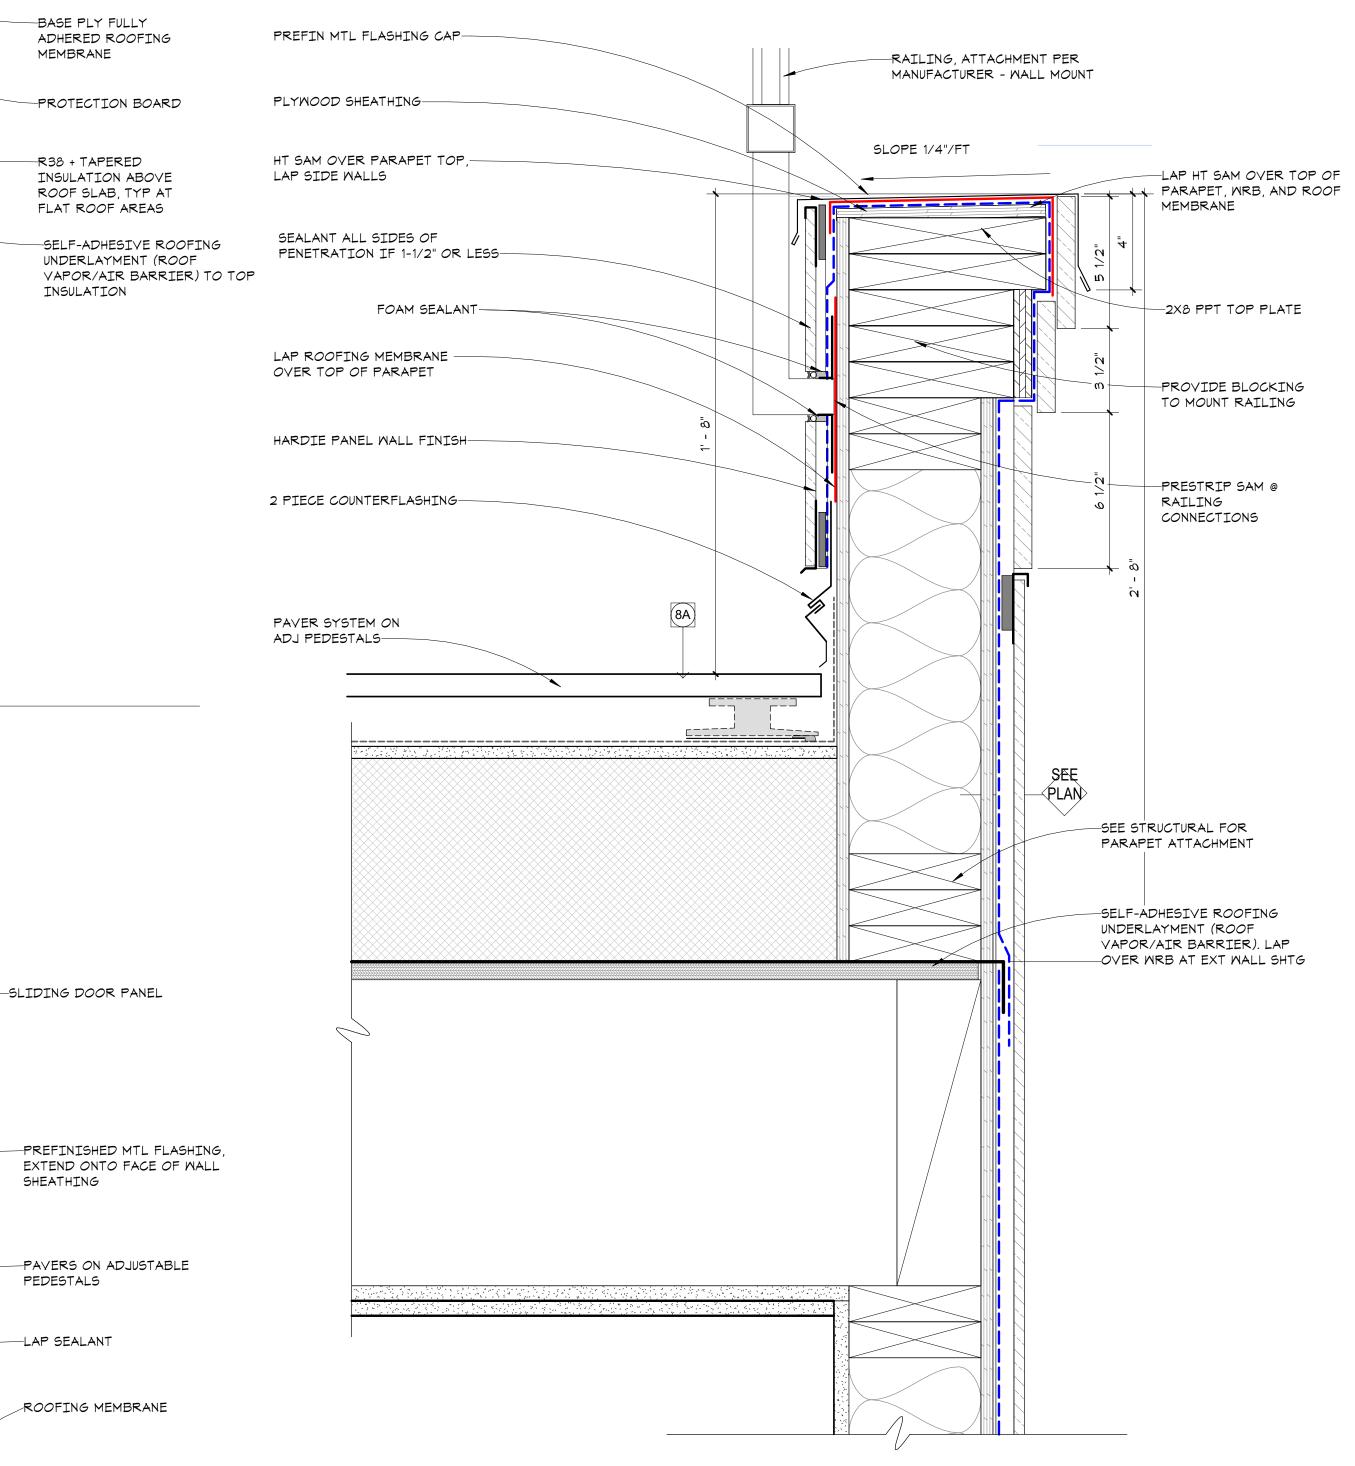

-PROTECTION BOARD

A6.7 3" = 1'-0" -R38 + TAPERED INSULTAION ABOVE ROOF SLAB, TYP AT FLAT ROOF AREAS

4 PAVER-PARAPET DETAIL


-SELF-ADHESIVE ROOFING UNDERLAYMENT (ROOF VAPOR/AIR BARRIER) LAP UNDER DOOR THRESHOLD

FRAMING - SEE STRUCTURAL

LAP ROOFING MEMBRANE OVER CORNER CANTS AND UP PARAPET WALLS. LAP HT SAM OVER MEMBRANE AND WRB AT EXTERIOR WALL. CAP WITH PREFIN MTL FLASHING R19 RIGID INSUL CLOSED CEL FOAM SPRAY INSUL-2X10 JOISTS, PER STRUCT-

SLOPE 1/4"/ FT 8 1/2"


CHIMNEY ROOF EDGE DETAIL A6.7 1 1/2" = 1'-0"

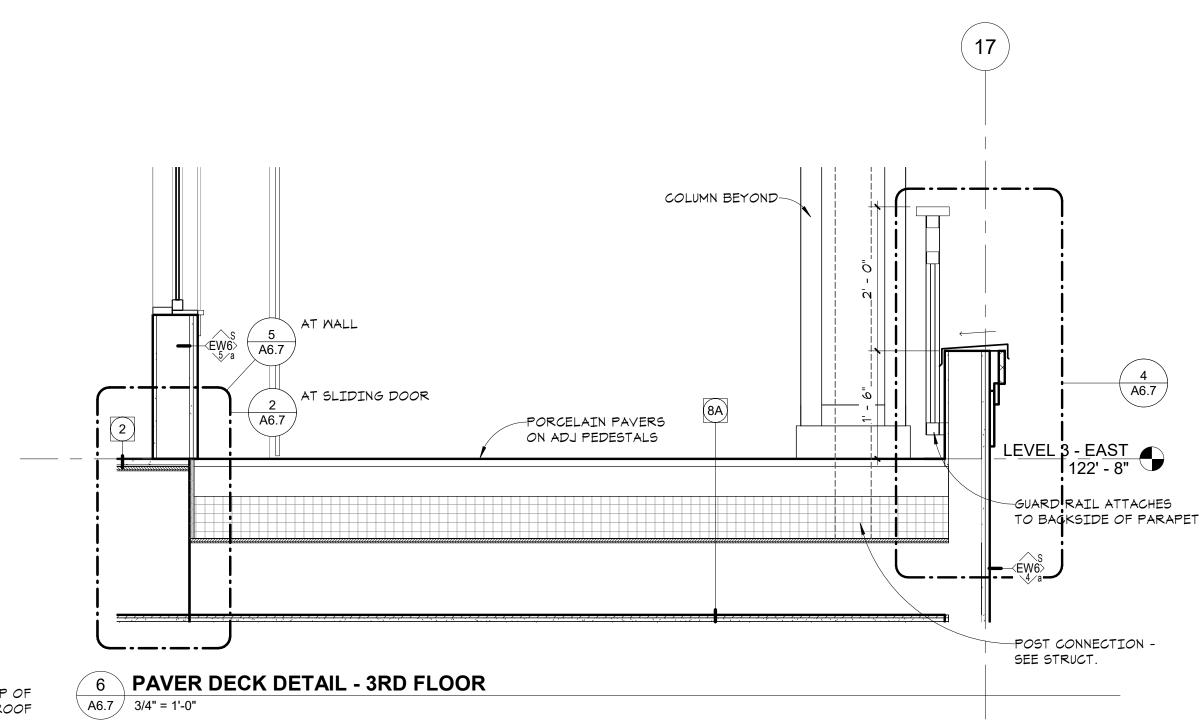

METAL EDGING AS REQ'D-


LSLOPE TO DRAIN SLOPË TO DRAIN BASE PLY FULLY ADHERED ROOFING MEMBRANE-PROTECTION BOARD-R-38 + TAPERED INSULATION ABOVE ROOF SLAB, TYP AT FLAT ROOF AREAS SELF-ADHESIVE ROOFING UNDERLAYMENT (ROOF VAPOR/AIR BARRIER) TO TOP OF ROOF INSULATION ROOF/CEILING ASSEMBLY



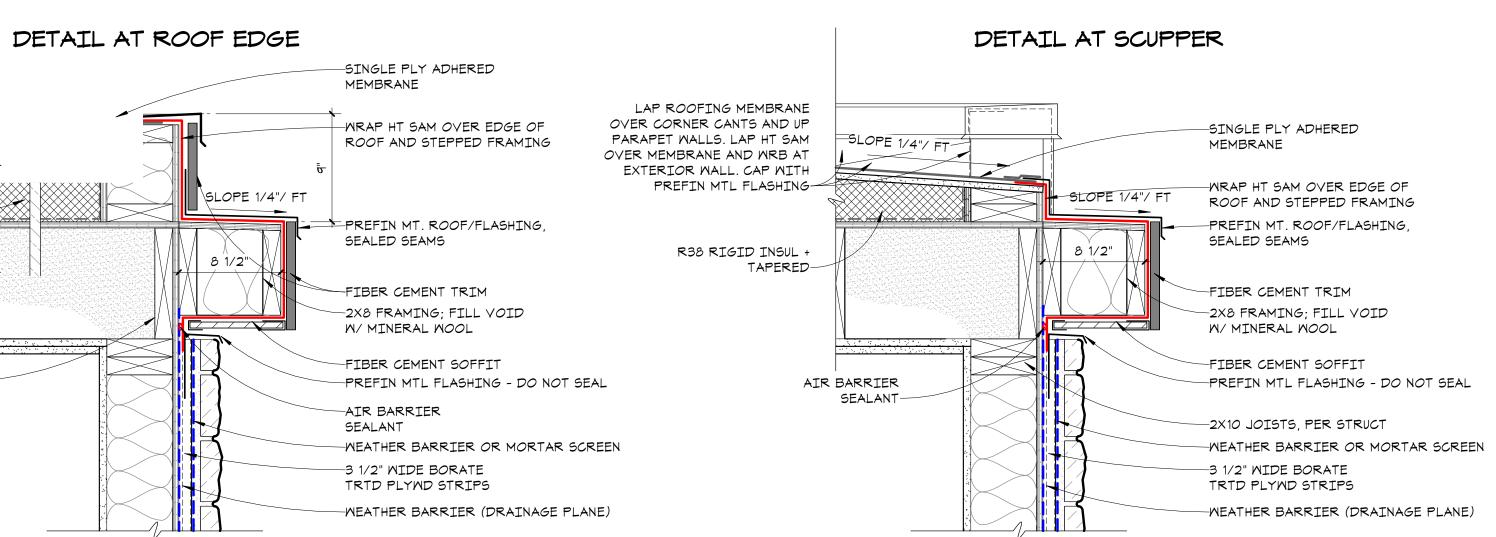

in site architects 1000 university ave. w. 🛛 suite 130 st. paul, minnesota 55104 612-252-4820 I hereby certify that this document was prepared by me or under my direct supervision and that I am a duly licensed architect (4) (A6.7) under the laws of the State of Washington SEE BELOW Signature Dawn Wieczorek Typed or Printed Name 11192 6/02/23 License # Date 11192 REGISTERED ARCHITECT DAWN MARIE WIECZORE STATE OF WASHINGT N \Box Δ m .<u></u> ∼ ∞ ШŐ Ш∢ \exists /EN $\mathbf{\Omega}$ ADJUSTABLE PEDESTALS \mathbf{m} \mathbf{m} $o \leq$ ~ ຟ 0 \sim S Ш́ City of Puyallup evelopment & Permitting Services ISSUED PERMIT Building Planning EngineeringPublic WorksFireTraffic PRMU20230881 PERMIT APP# PRMU20230881 PERMIT SET JUNE 02, 2023 REVISIONS Date No. Description 1 BLDG PERMIT REV 1 3/4/24 2108 PROJECT NUMBER Author_ Checker DRAWN BY CHECKED BY WESLEY BRADLEY PARK 2 EAST BROWNSTONE $\begin{tabular}{c} \hline \end{tabular} \end{t$ EXTERIOR DETAILS A6. mmm

-PATIO PAVERS ON

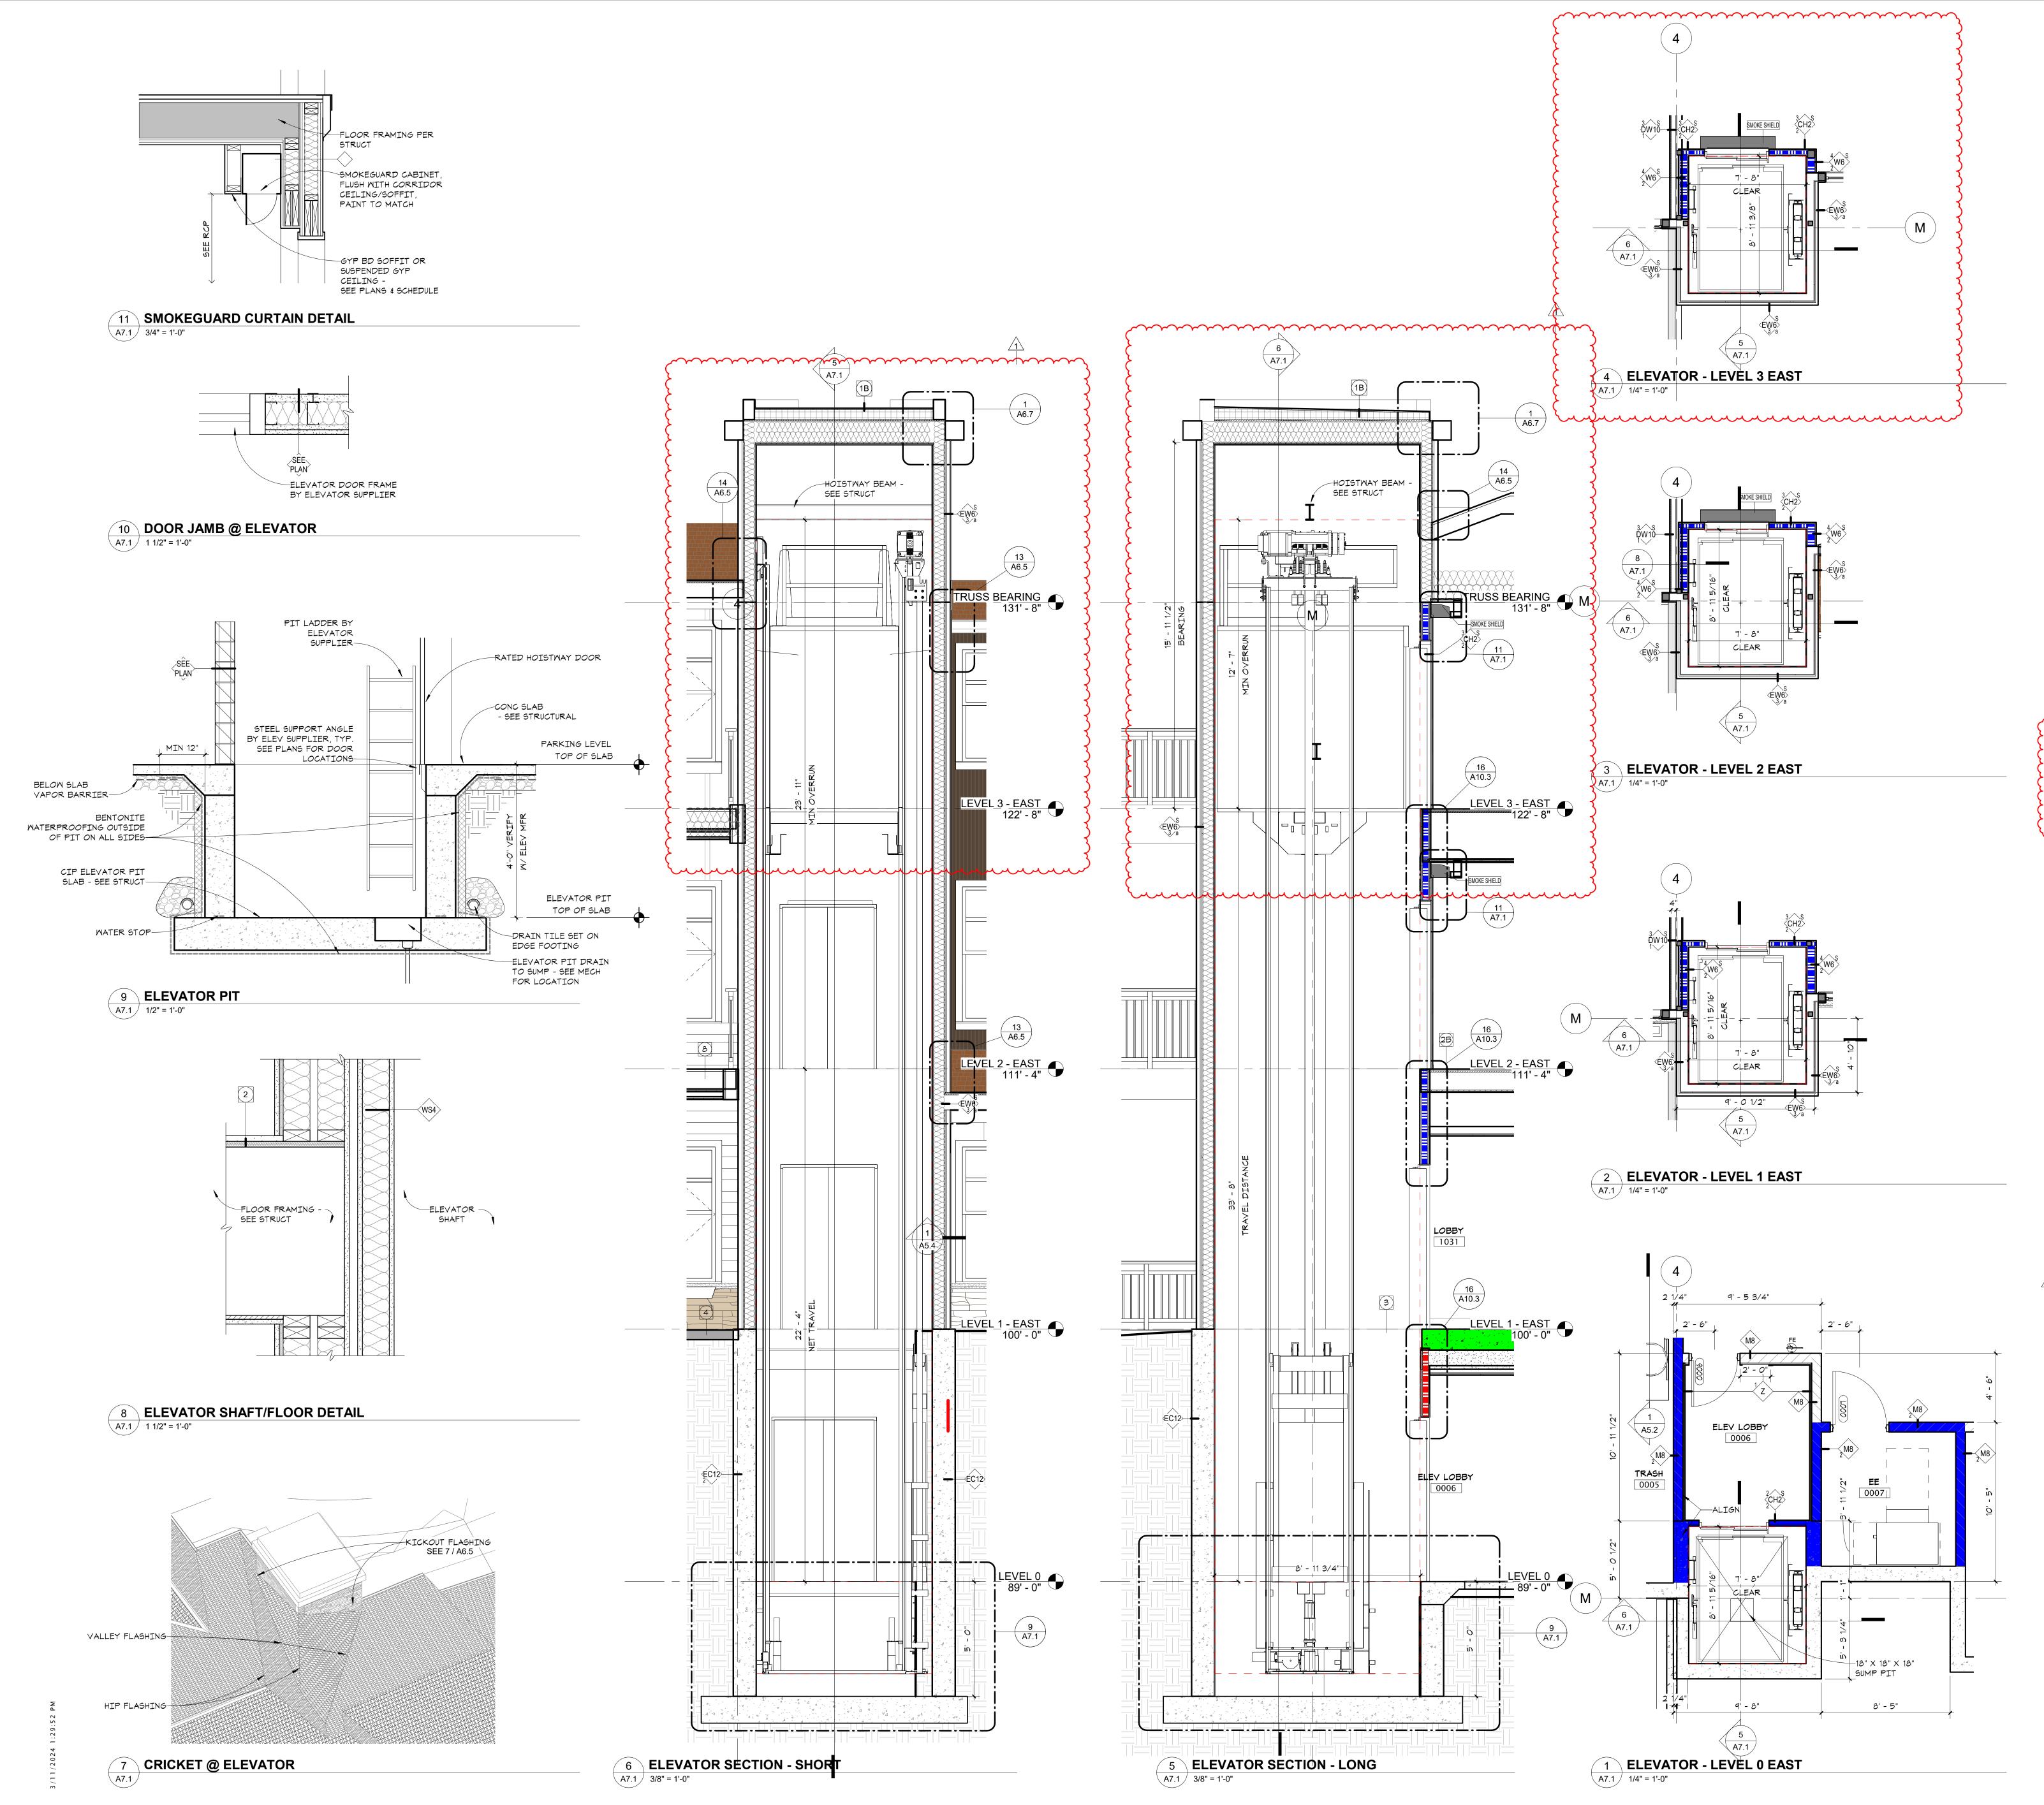

* 15# FELT * 1/2" PLYWOOD ROOF SHEATHING * ICE & WATER SHIELD @ EAVES & VALLEYS * RIDGE VENT @ PEAK * ROOF TRUSSES PER STRUCT * R49 BLOWN INSULATION * 6 MIL VAPOR RETARDER (CLASS I) * 2 LAYERS 5/8" TYPE 'X' GYP BD 1-HR FIRE RATING GA RC 2602 OPTION: 1 LAYER TYPE 'C' GYP BD ON 1/2" RESILIENT CHANNEL @ 12" OC (GA RC 2604 (UL P531) -PROPRIETARY GYP) MEMBRANE ROOF / CEILING (ND) B) MEMORANE ROOF / CEILING (ND) * FULLY ADHERED SBS ROOFING * COVERBD AS RECOMMENDED BY MANUF * TAPERED INSULATION TO DRAIN * R38 INSULATION * AIR/VAPOR BARRIER * PLYMD SHT - MIN 1/2" (SEE STRUCT) * WOOD FRAMING PER STRUCT * 2 LAYERS 5/8" TYPE 'X' GYP BD 1-HR FIRE RATING GA RC 2601 NOTE: PROVIDE BALLAST AT VISIBLE ROOFS AS SHOWN 2 * 1" GYPCRETE TOPPING (3/4" IF NO SOUND MAT) *1/4" SOUND ATTENUATION MAT * 3/4" T&G PLYWOOD FLOOR SHEATHING (GLUED * NATLED) * MOOD FLOOR TRUSSES, PER STRUCT * FULL DEPTH BLOWN INSULATION * 1/2" RESILIENT CHANNEL @ 12" OC * 1 LAYER 5/8" TYPE 'C' GYP BD 1-HR FIRE RATING UL L563 (SYSTEM 4, SYSTEM 1 @ ROOF) STC 58 RAL-TL97-340 & RAL-IN97-47 2A * 3/4" GYPCRETE TOPPING * 3/4" T&G PLYWOOD FLOOR SHEATHING (GLUED & NAILED) * 2X10 WOOD JOISTS * 1 LAYER 5/8" TYPE 'X' GYP BD * 1 LAYER 5/8" TYPE 'X' GYP BD <u>CORRIDOR FLOOR / CEILING (WD)</u> * 3/4" GYPCRETE TOPPING * 3/4" T&G PLYWOOD FLOOR SHEATHING (GLUED & NAILED) * 2X10 WOOD FRAMING PER STRUCT * 1/2" RESILIENT CHANNEL @ 12" OC * 1 LAYER 5/8" TYPE 'C' GYP BD * SUSPENDED GYP BD CEILING, SEE REFLECTED CEILING PLANS 1-HR FIRE RATING UL L514 2C GAME ROOM FLOOR / CEILING (WD) C) GAME KOOM FLOOK / CEILING (MD) * 3/4" GYPCRETE TOPPING * 3/4" T&G PLYWOOD FLOOR SHEATHING (GLUED & NAILED) * 1 3/4" X 11 7/8" LVL PER STRUCT * 1/2" RESILIENT CHANNEL @ 12" OC * 1 LAYER 5/8" TYPE 'C' GYP BD * SUSPENDED GYP BD CEILING, SEE REFLECTED CEILING PLANS 1-HR FIRE RATING UL L570 3 <u>PT CONC FLOOR / CEILING</u> * PT CONC SLAB, PER STRUCT *SCRIM FACED INSUL ATTACHED TO SLAB UNDERSIDE AT GARAGE (R-30ci) 3-HR FIRE RATING 4 CONC FLOOR - SLAB-ON-GRADE * 4" CONC SLAB, PER STRUCT * 15 MIL POLY VAPOR RETARDER AT CONDITIONED SPACES * 4" COMPACTED GRANULAR FILL (VERIFY W/GEOTECH REPORT) *R-10 INSUL FROM TOP OF SLAB 24" DOWN (NO PERIM INSUL IF SLAB-ON GRADE IS MORE THAN 24" BELOW FINISHED EXT GRADE) 4A EXTERIOR - SLAB-ON-GRADE * 4" CONC SLAB, PER STRUCT * 4" COMPACTED GRANULAR FILL (VERIFY W/ GEOTECH REPORT) 5 <u>* SHTG - SEE STRUCT</u> *RIM JOIST PER STRUCT *R19 SPRAY INSUL 6 TYPICAL FOOTING & FOUNDATION * CONC FOOTING, PER STRUCT * 4" DRAIN TILE W/ FREE DRAIN, W/ GRAVEL & FILTER FABRIC SURROUND * CONC FOUNDATION WALL, PER STRUCT * WATERPROOFING (EXTEND OVER FTG, LAP MEMBRANE FLASHING &" ABOVE FIRST FLOOR SLAB) * DRAINAGE MAT * INSULATION AS REQ'D - SEE WALL TYPES FOR NOTES

ASSEMBLY TYPES

* ASPHALT SHINGLES * 15# FELT

TYPICAL ROOF / CEILING (WD)


NOTES TYPICAL EAVE * ASPHALT SHINGLES * ICE & WATER SHIELD (5'-O" MIN) * PREFINISHED METAL DRIP EDGE * PREFINISHED ALUMINUM GUTTER * ROOF SHEATHING * FRAMING PER STRUCT * PREFIN FIBER CEMENT FASCIA * T-111 ROOF DECKING WITH GROOVE DOWN. STAIN TRUSS RAFTERS AND UNDERSIDE OF DECKING * INSULATION BAFFLE


8 <u>DECK / CLG OVER EXTERIOR (WD)</u> * WALKABLE FLUID APPLIED MEMBRANE * 1/2" PLYWD SUBSTRATE OVER 3/4" PLYWD SUBSTRATE; STAGGER JOINTS * WOOD JOISTS, PER STRUCT, SLOPE TO DRAIN


* FIBER CEMENT SOFFIT FINISH W/ LINEAR VENTS 8A PAVER DECK ON PEDESTALS OVER 1B


in site architects 1000 university ave. w. suite 130 st. paul, minnesota 55104 612-252-4820 I hereby certify that this document was prepared by me or under my direct supervision and that I am a duly licensed architect under the laws of the State of Washington SEE BELOW Signature Dawn Wieczorek Typed or Printed Name 11192 6/02/23 License # Date 11192 REGISTERE ARCHITECT **DAWN MARIE WIECZORE** STATE OF WASHINGT N \neg Δ m $r \infty$ ШŐ ╙┛┫ $\supset \geq$ 7 Щ Ч こく \triangleleft $\mathbf{\Omega}$ Ω $\mathbf{\Omega}$ **σ** m T ら 0 ら Ш City of Puyallup velopment & Permitting Services ISSUED PERMIT Building Planning Engineering Public Works Fire Traffic PRMU20230881 PERMIT APP# PRMU20230881 PERMIT SET JUNE 02, 2023 REVISIONS Date No. Description 1 BLDG PERMIT REV 1 3/4/24 2108 PROJECT NUMBER Author_ Checker DRAWN BY CHECKED BY WESLEY BRADLEY PARK 2 EAST BROWNSTONE ELEVATOR PLANS & SECTIONS & DETAILS & **PAVILION STAIRS** A7.




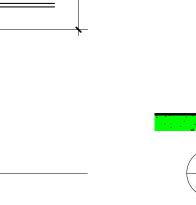

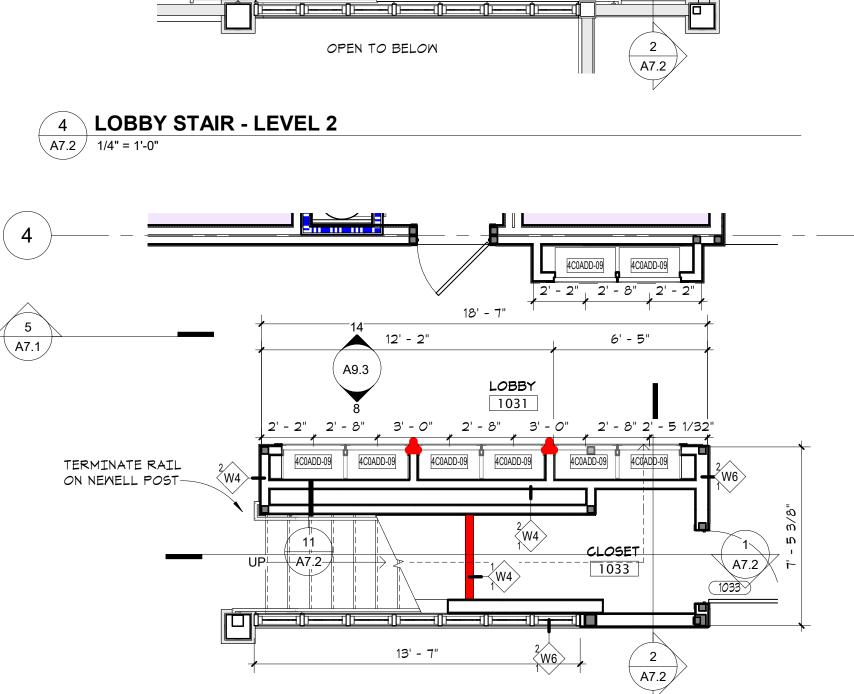

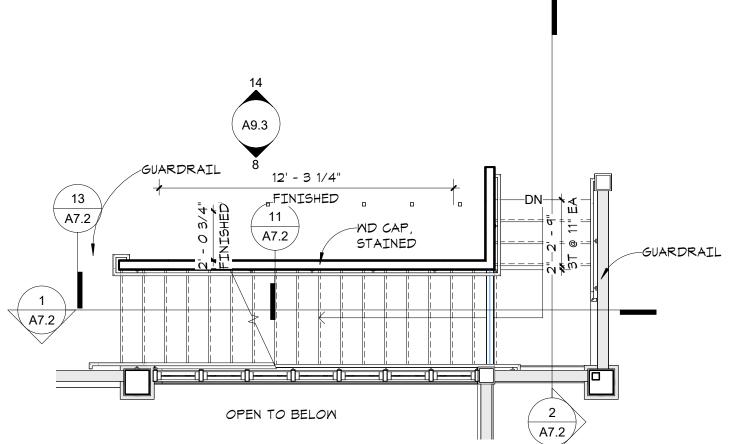

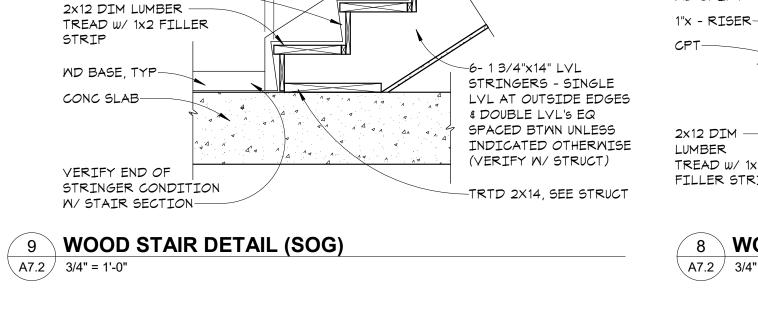


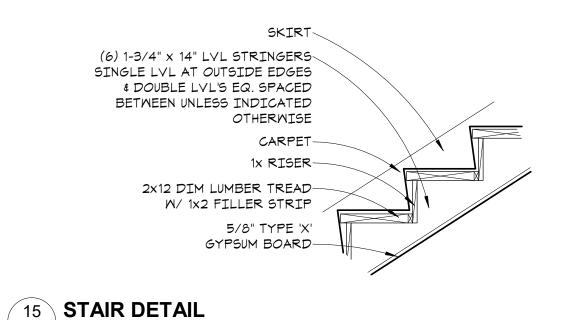


A7.2 3/4" = 1'-0"


WD SKIRT


1"x - RISER-

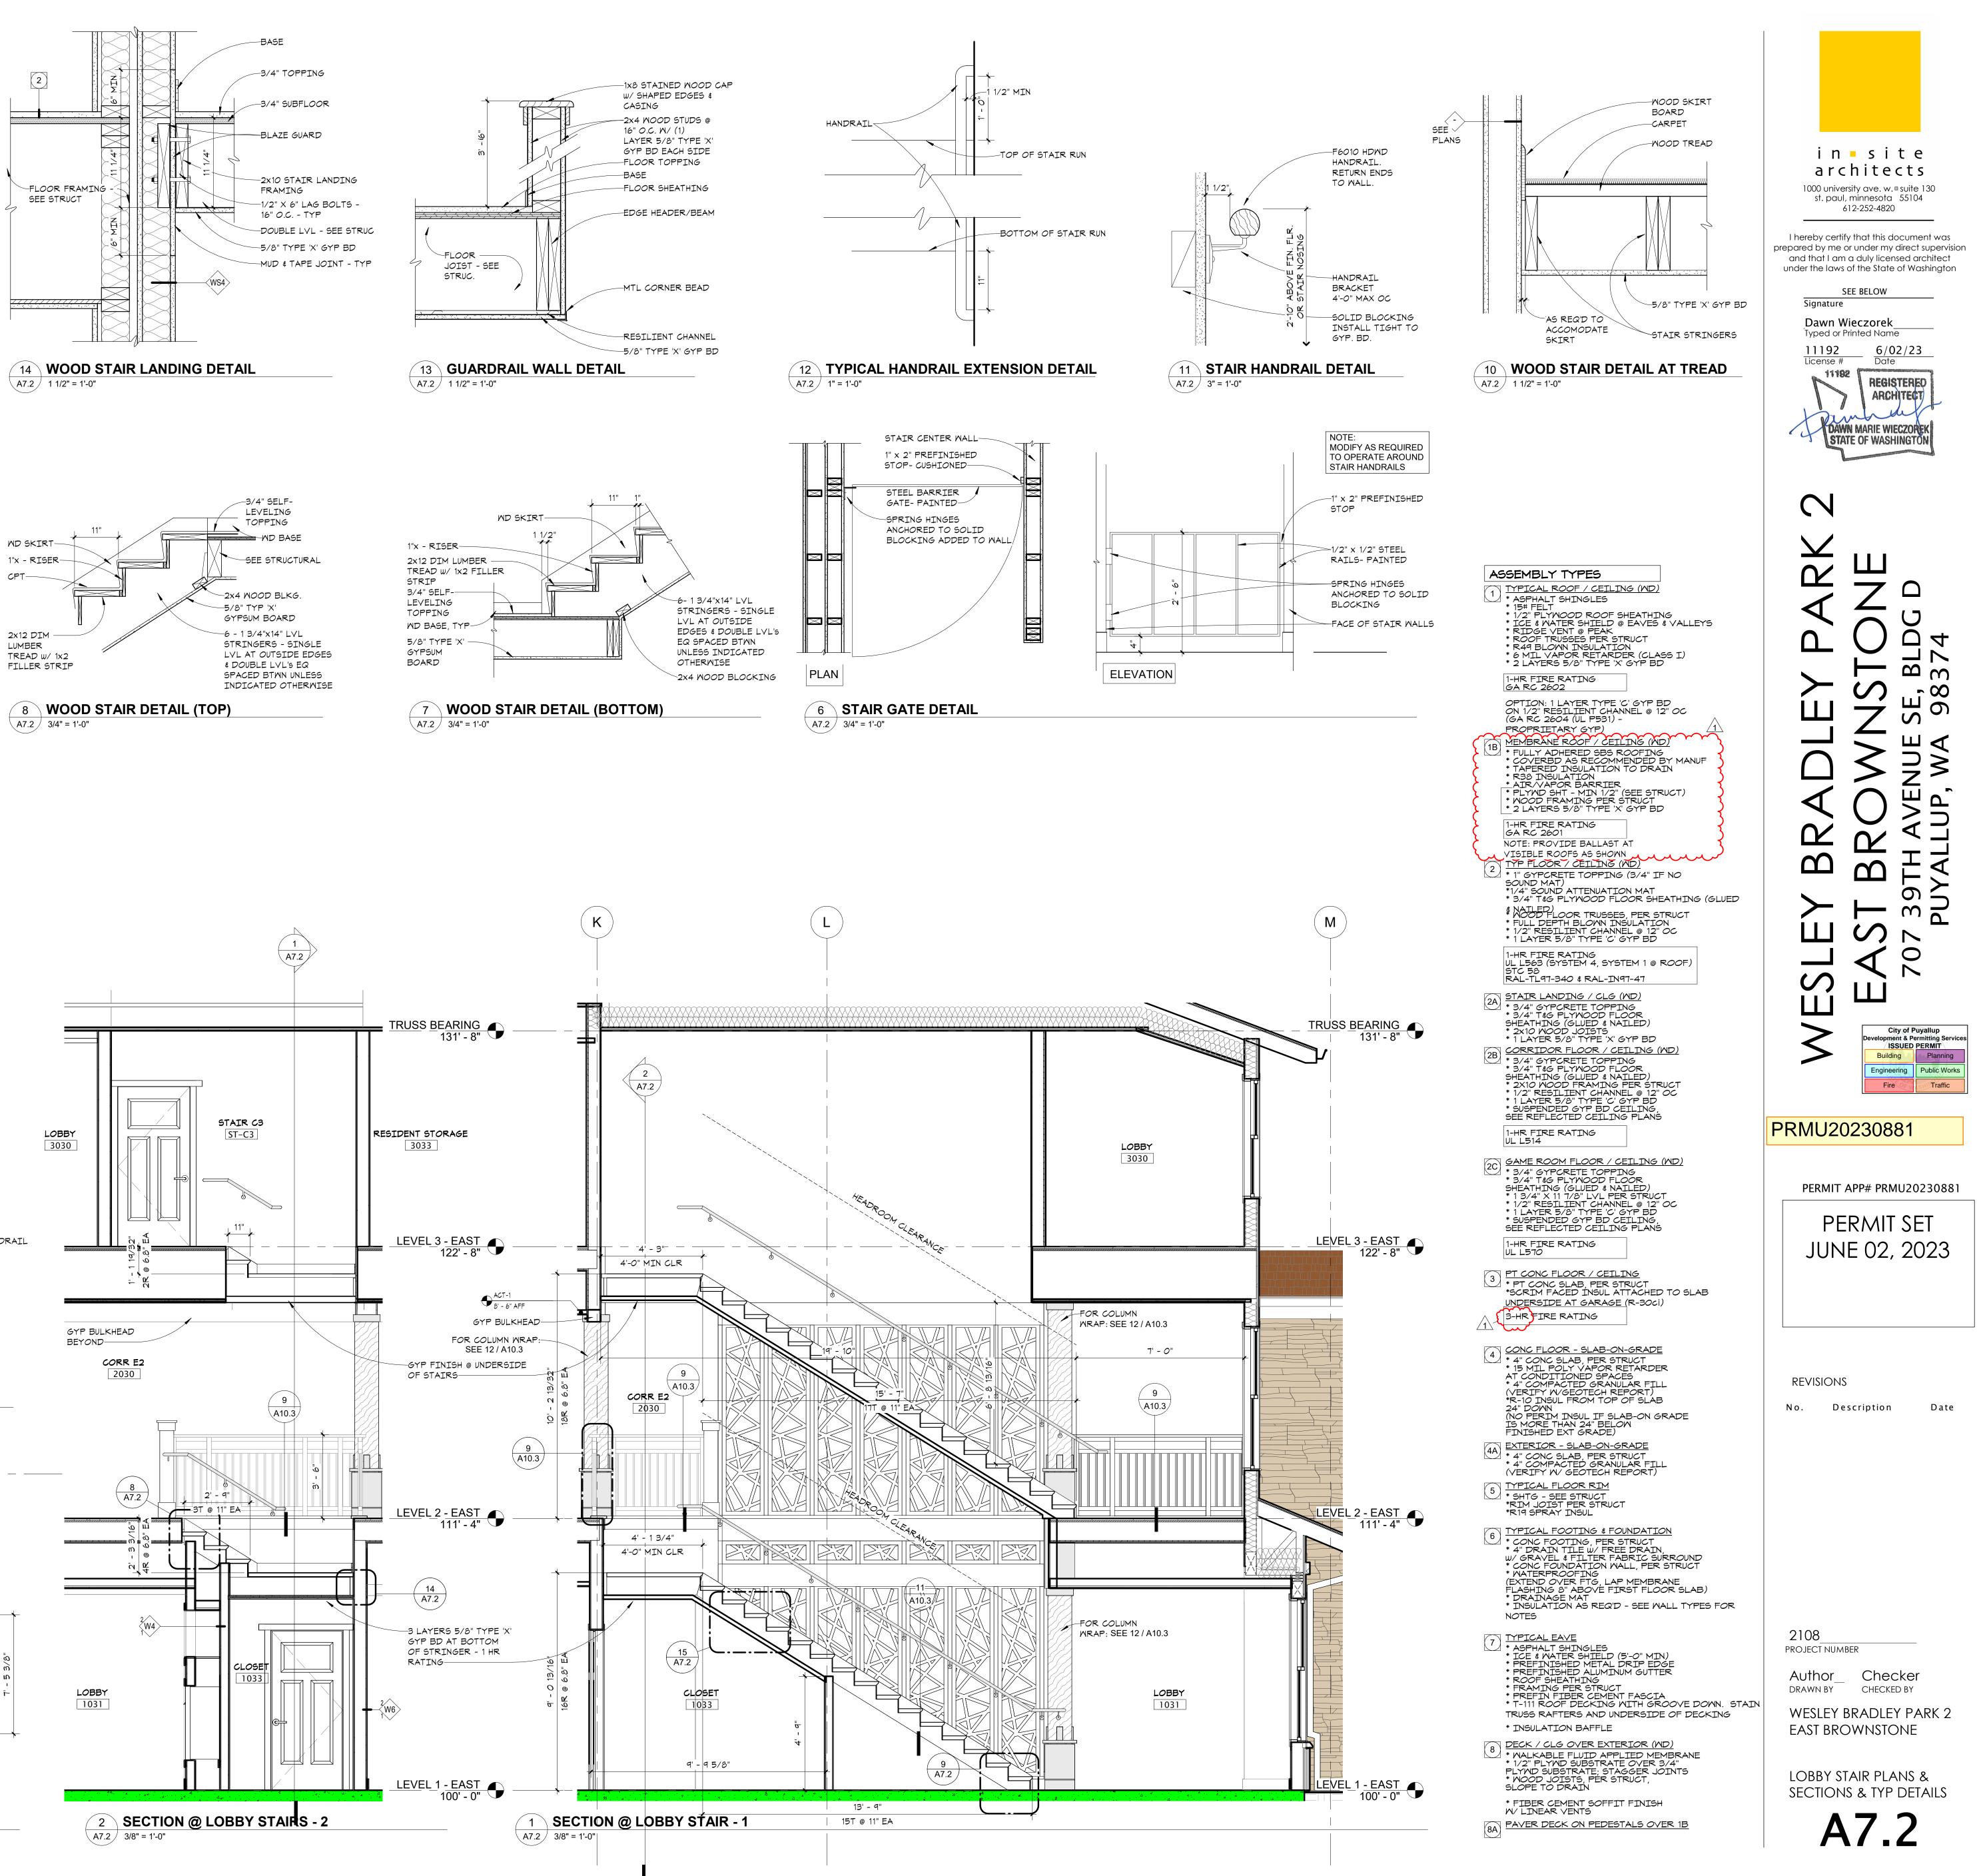



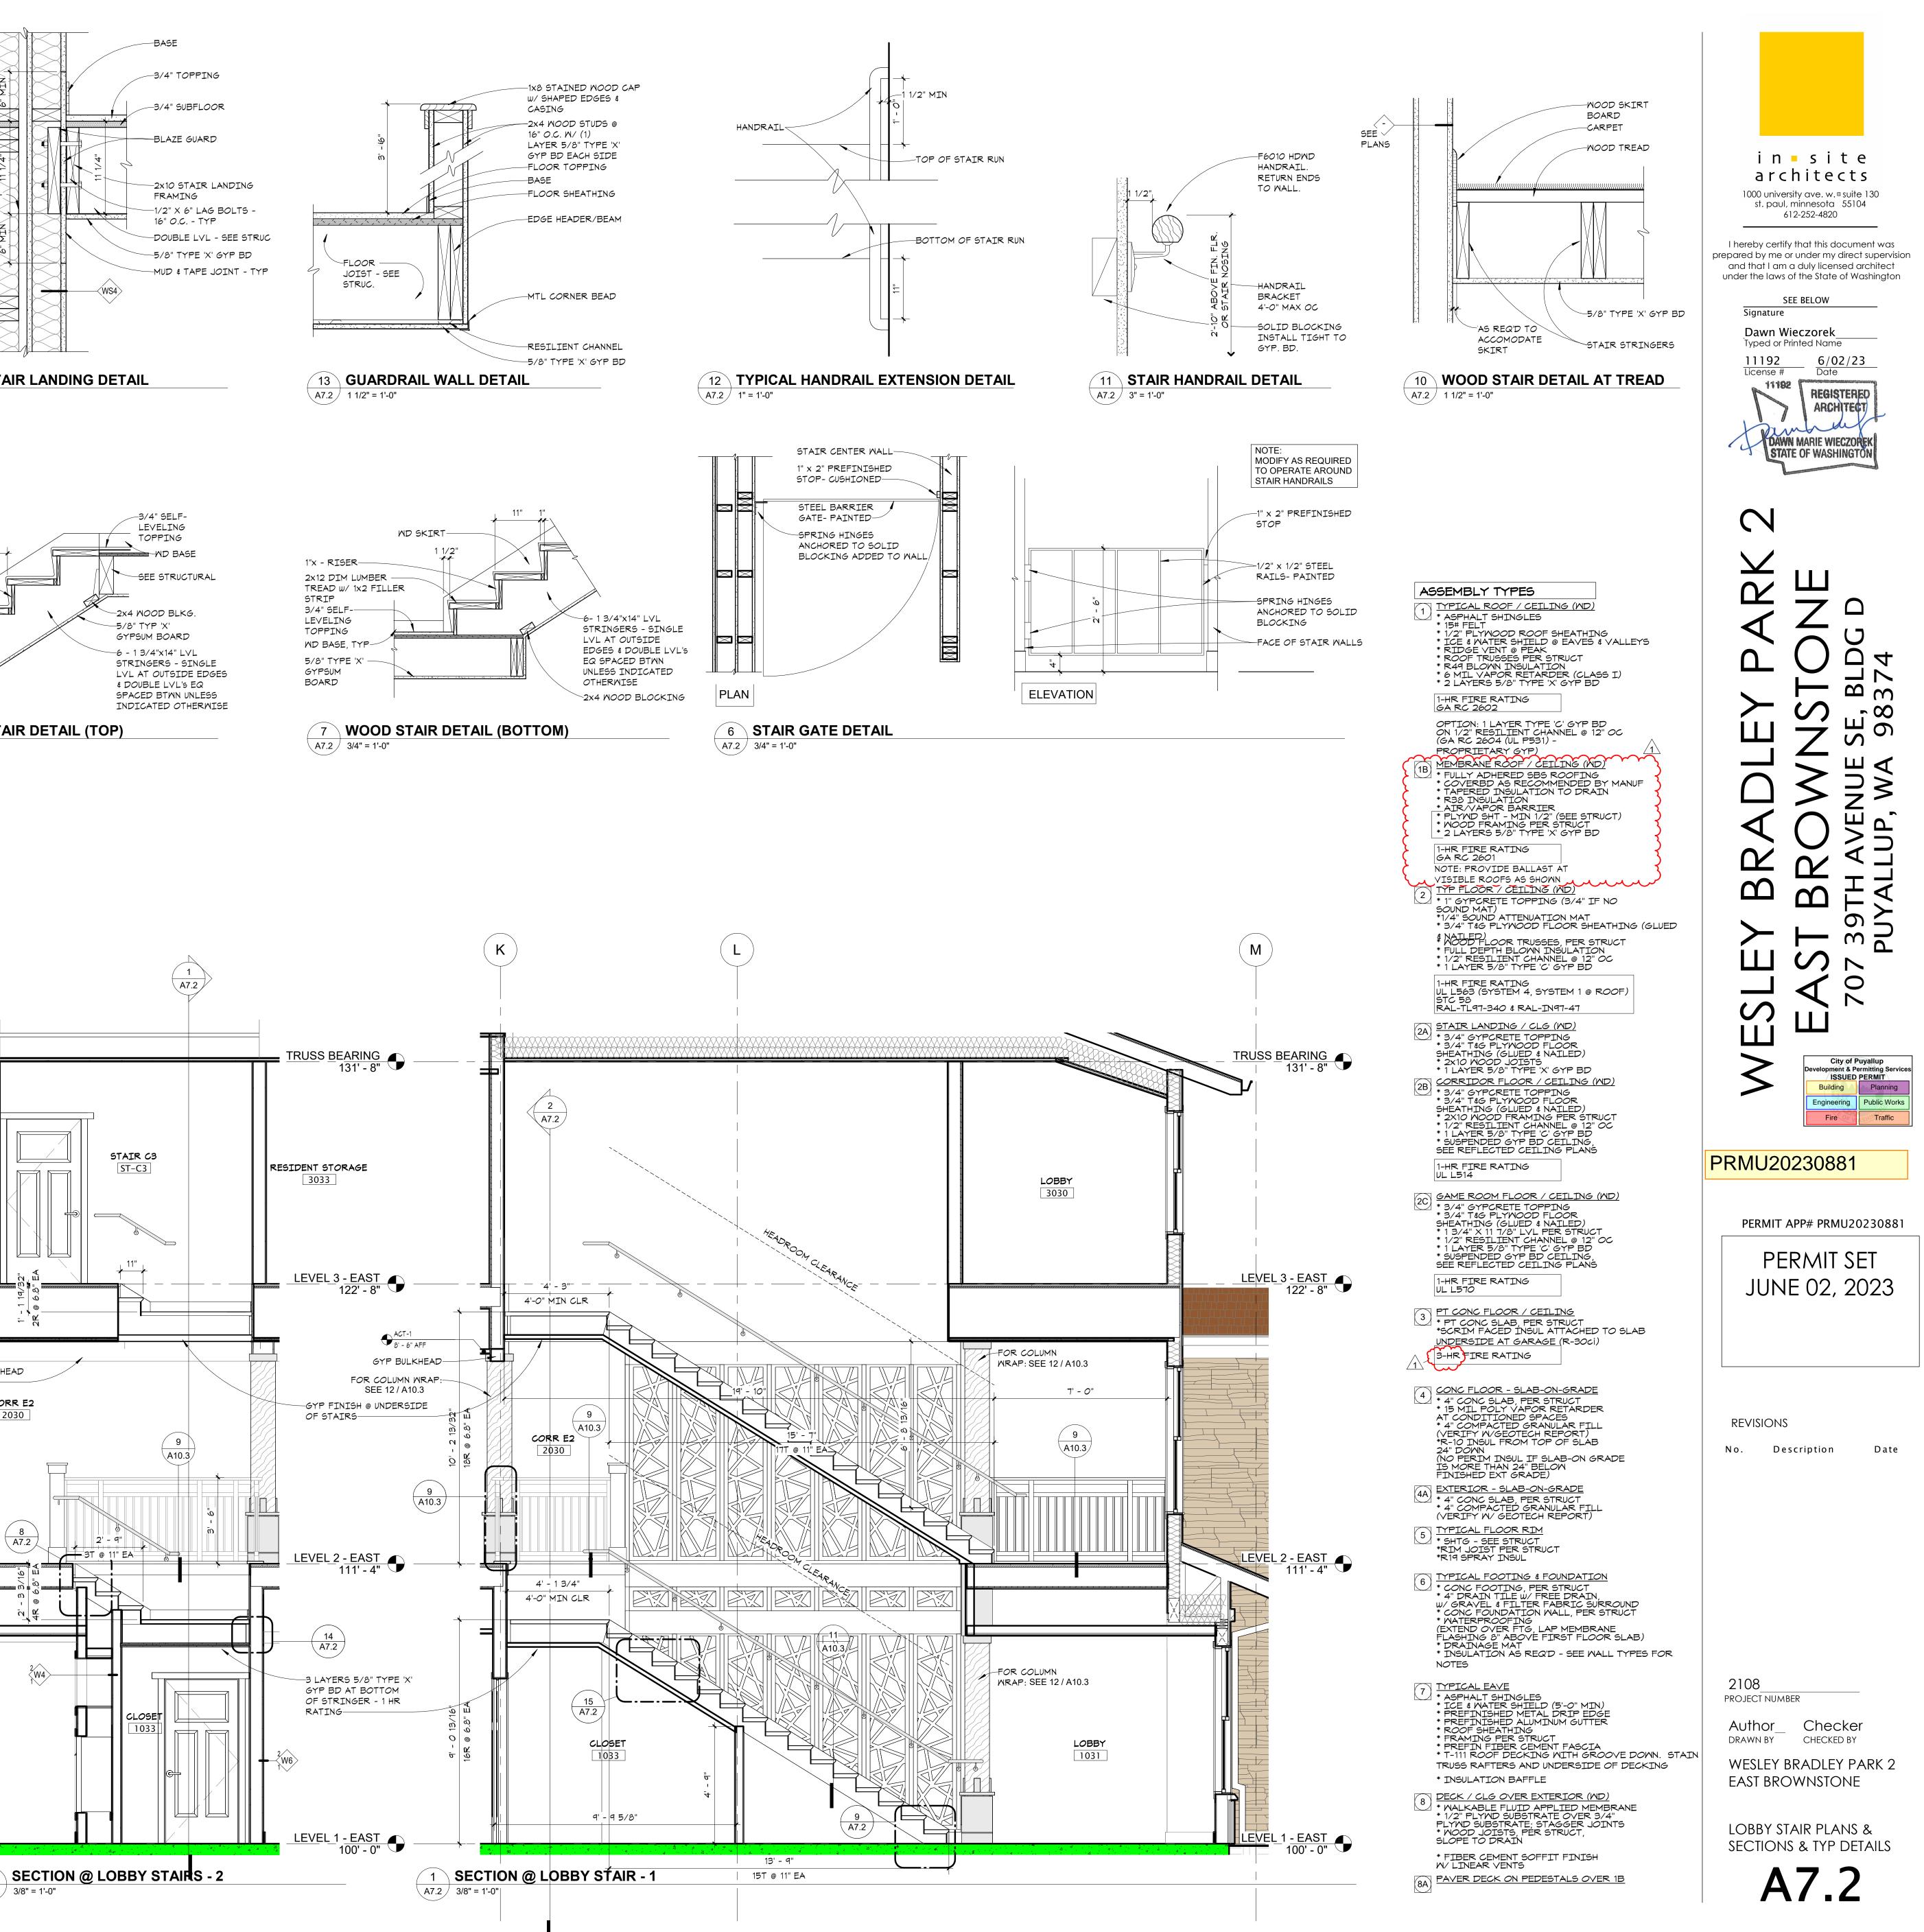

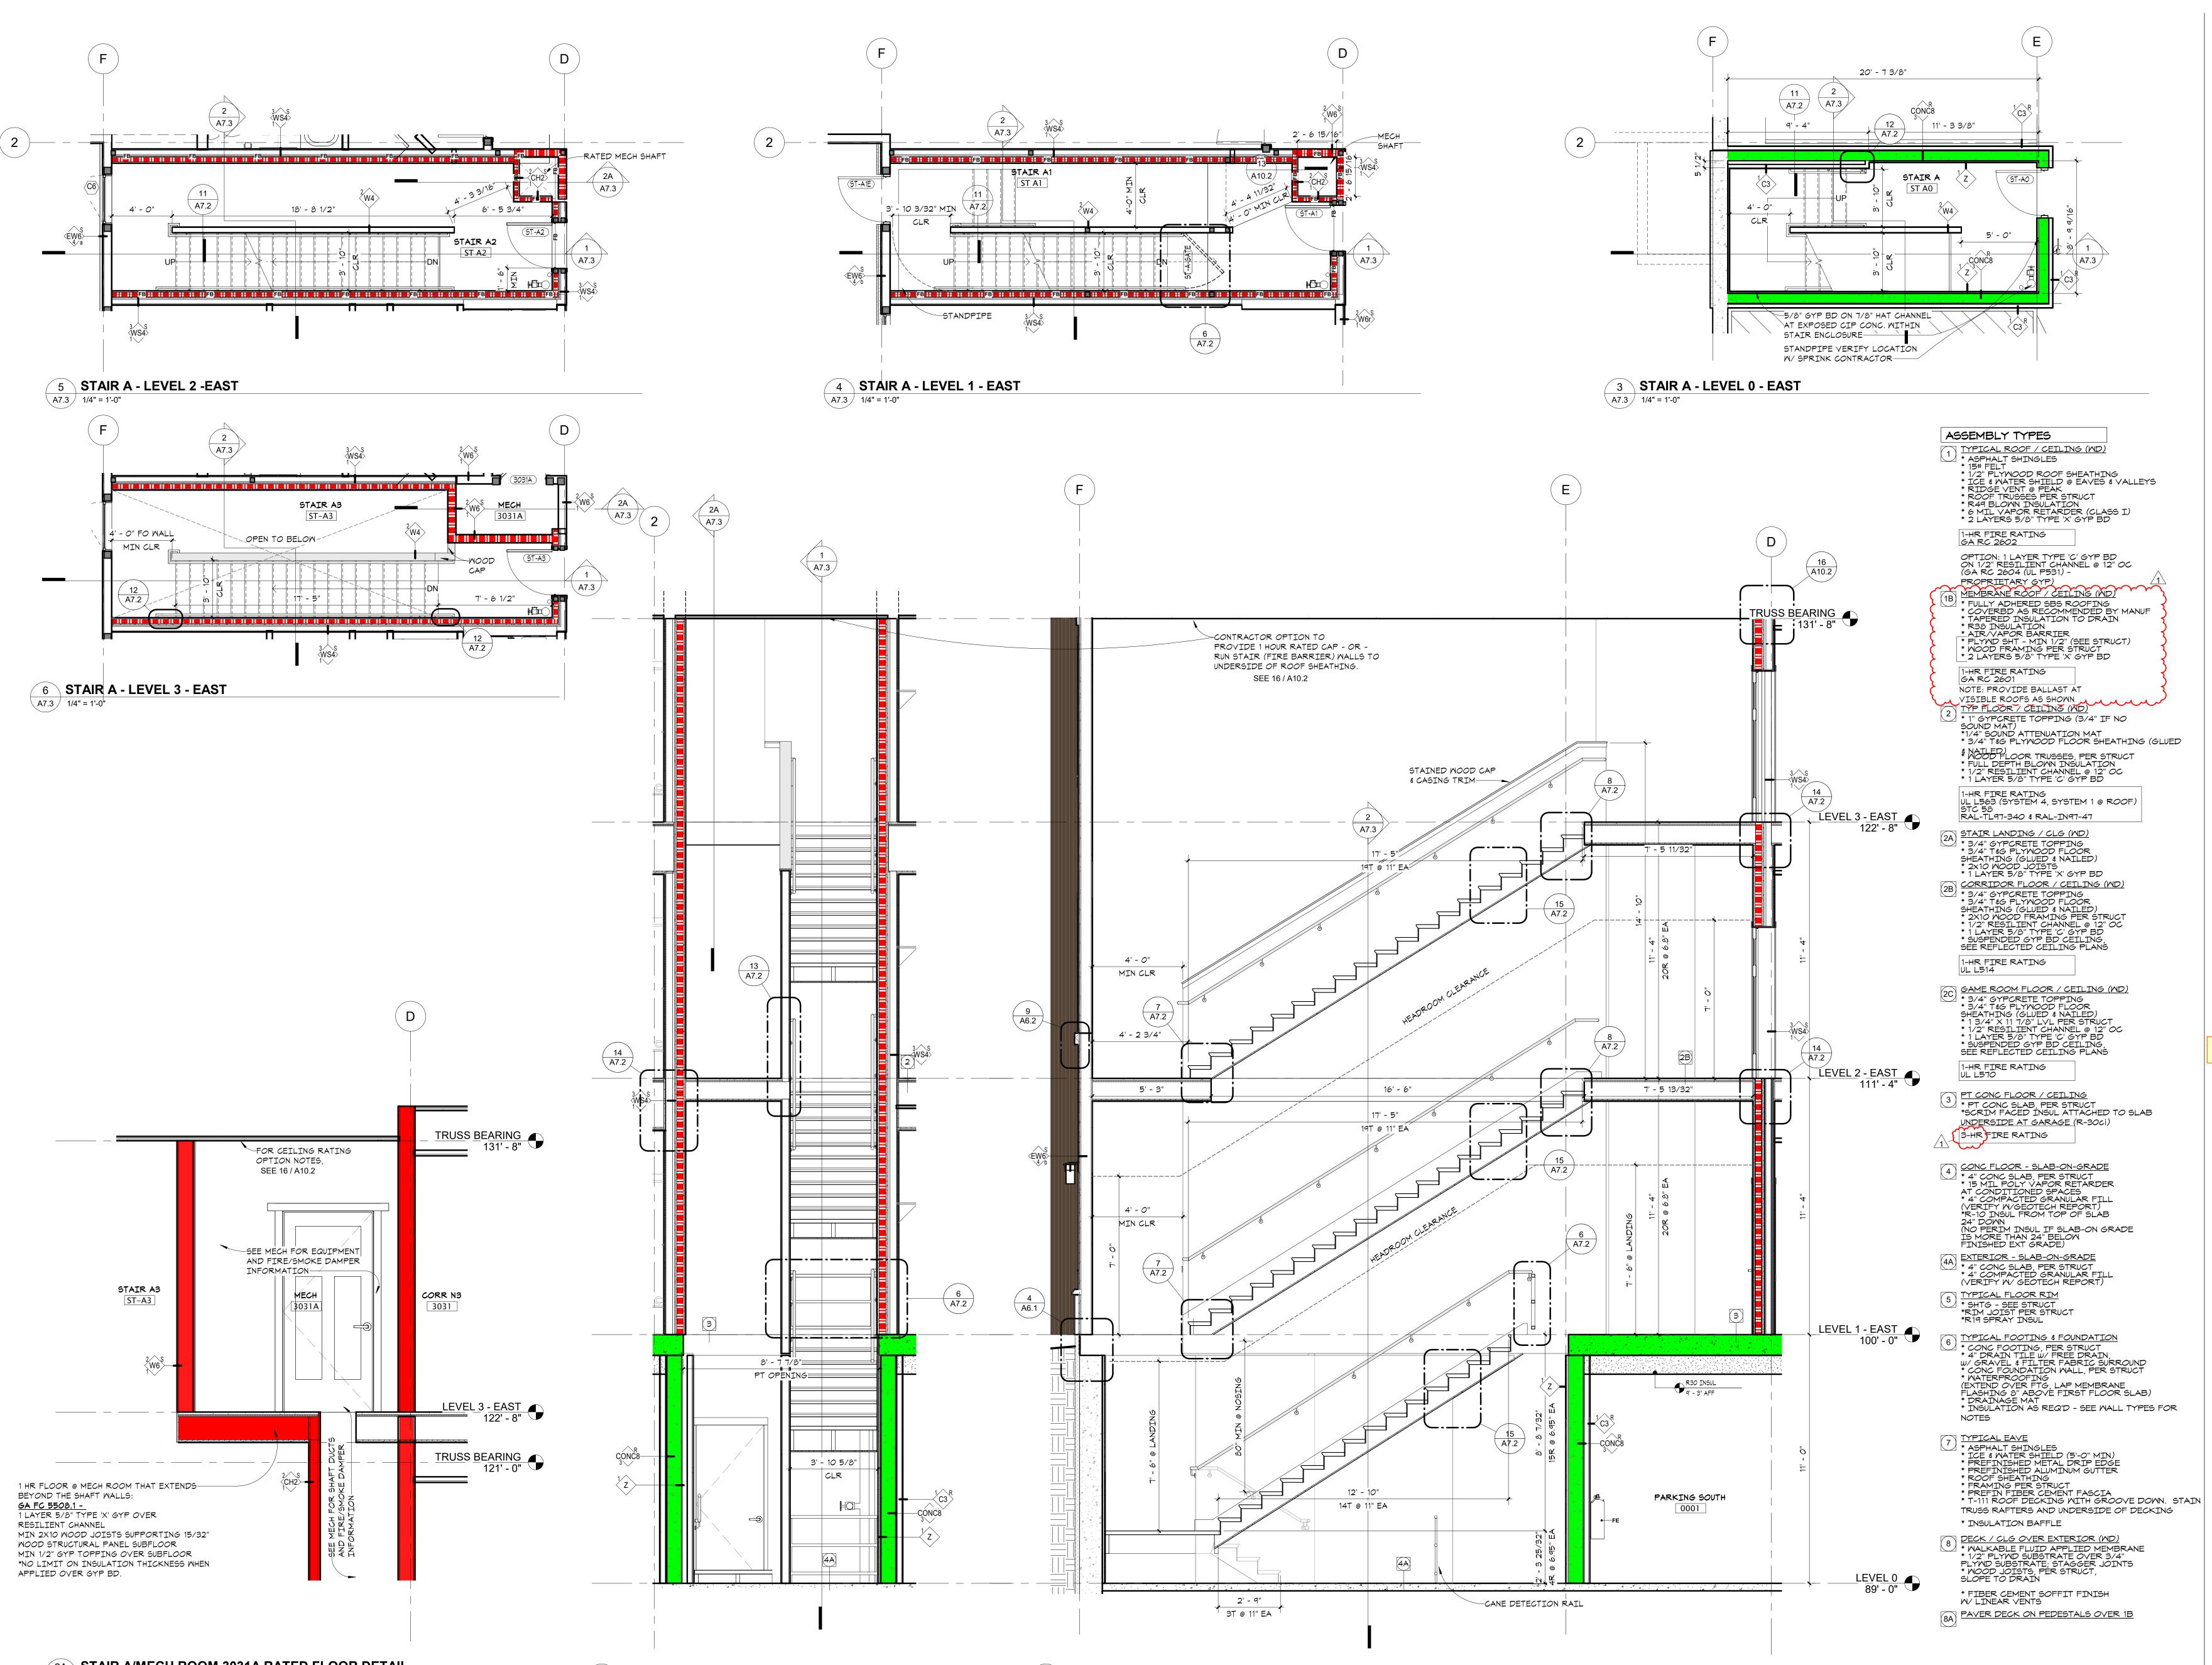

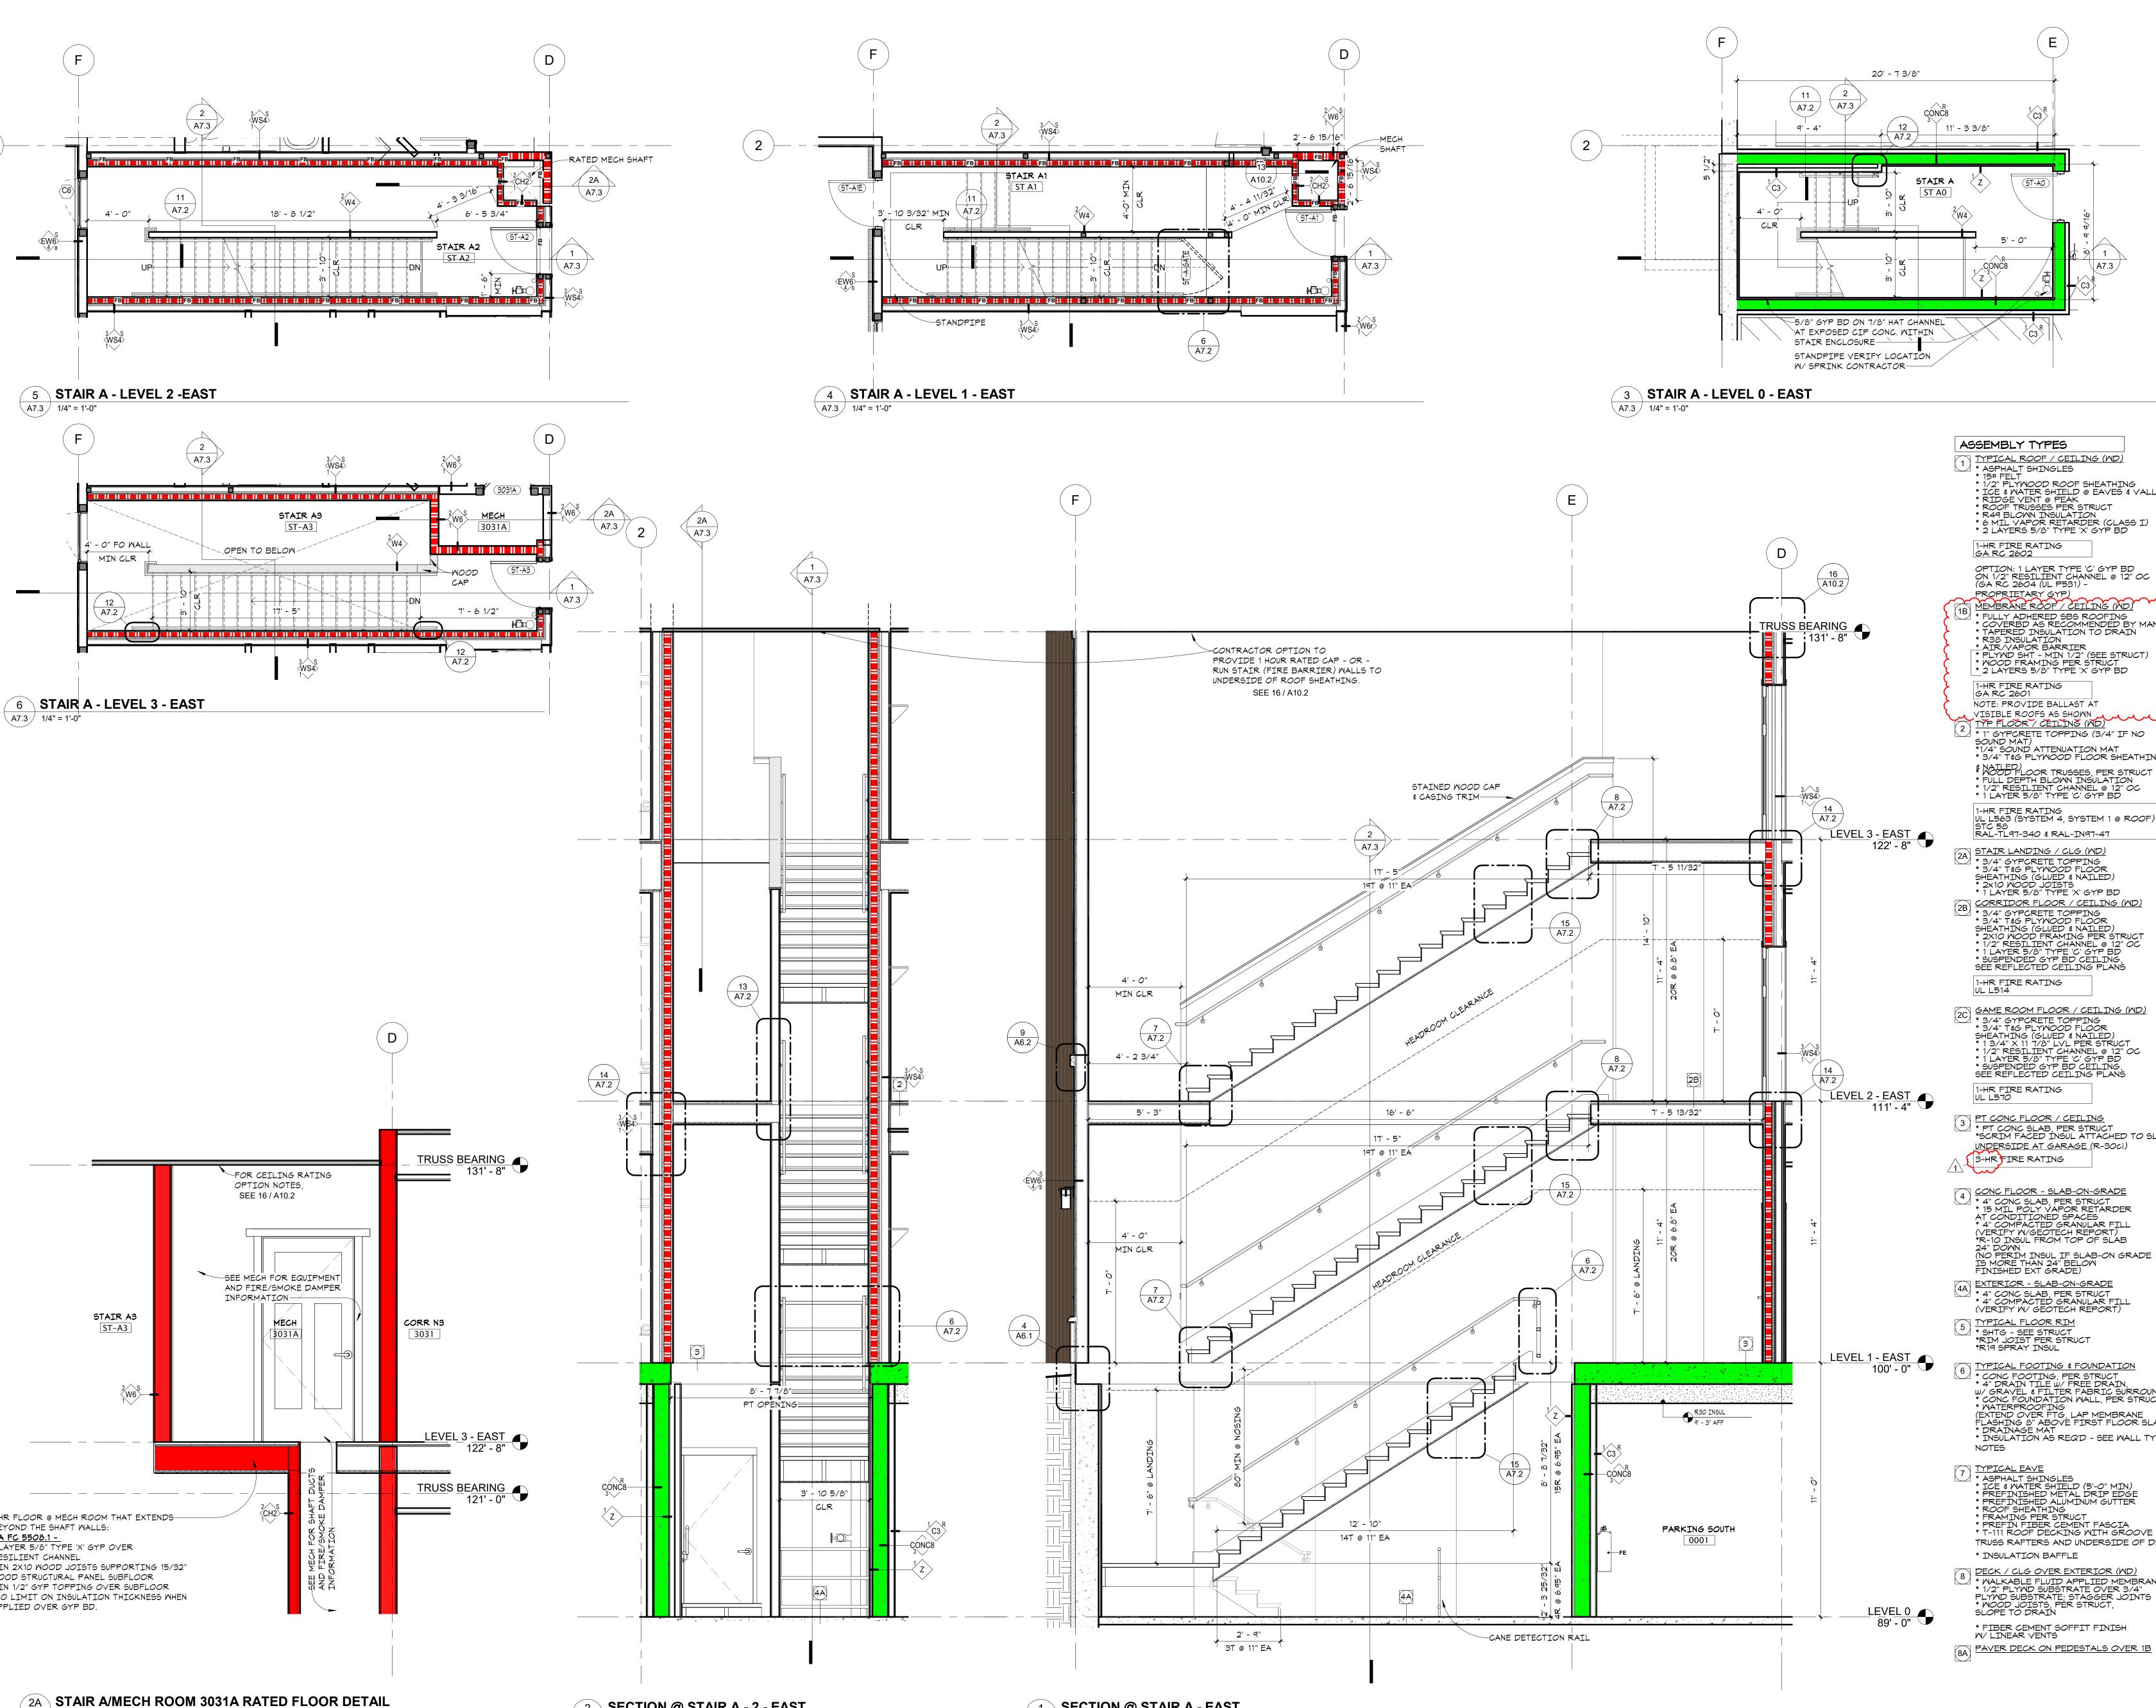


A7.3 1/2" = 1'-0"


A7.3 3/8" = 1'-0"

SECTION @ STAIR A - 2 - EAST


SECTION @ STAIR A - EAST A7.3 3/8" = 1'-0"


in site architects 1000 university ave. w. 🛚 suite 130 st. paul, minnesota 55104 612-252-4820 I hereby certify that this document was prepared by me or under my direct supervision and that I am a duly licensed architect under the laws of the State of Washington SEE BELOW Signature Dawn Wieczorek Typed or Printed Name 11192 6/02/23 License # Date 11192 REGISTERE ARCHITECT DAWN MARIE WIECZORE STATE OF WASHINGT \frown Δ m $r \infty$ ШŐ ш ⊲ ₽Ň 7 Щ Ч こく \mathbf{N} Μ $\mathbf{\Omega}$ **σ** m T ら 0 ら City of Puyallup velopment & Permitting Services ISSUED PERMIT Building Planning Engineering Public Works Fire Traffic PRMU20230881 PERMIT APP# PRMU20230881 PERMIT SET JUNE 02, 2023 REVISIONS Date Description No. 2108 PROJECT NUMBER Author Checker DRAWN BY CHECKED BY WESLEY BRADLEY PARK 2 EAST BROWNSTONE STAIR A PLANS & SECTIONS **A**/

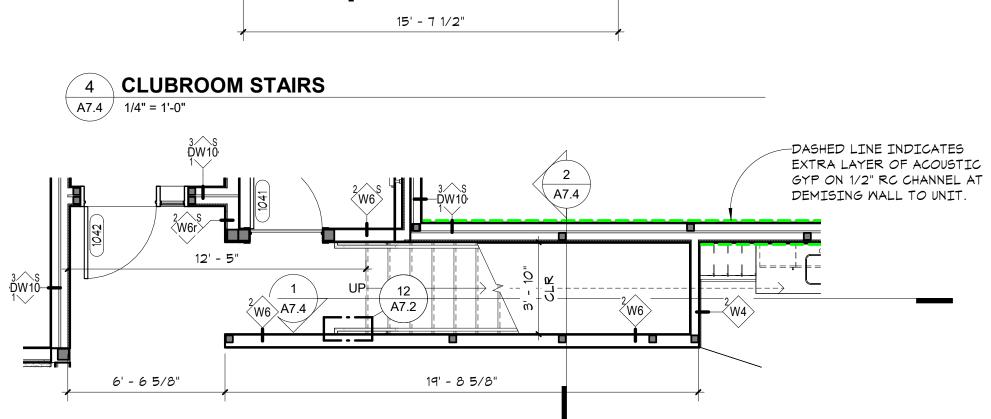


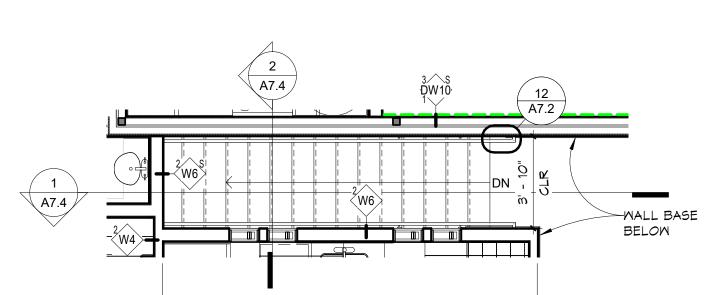





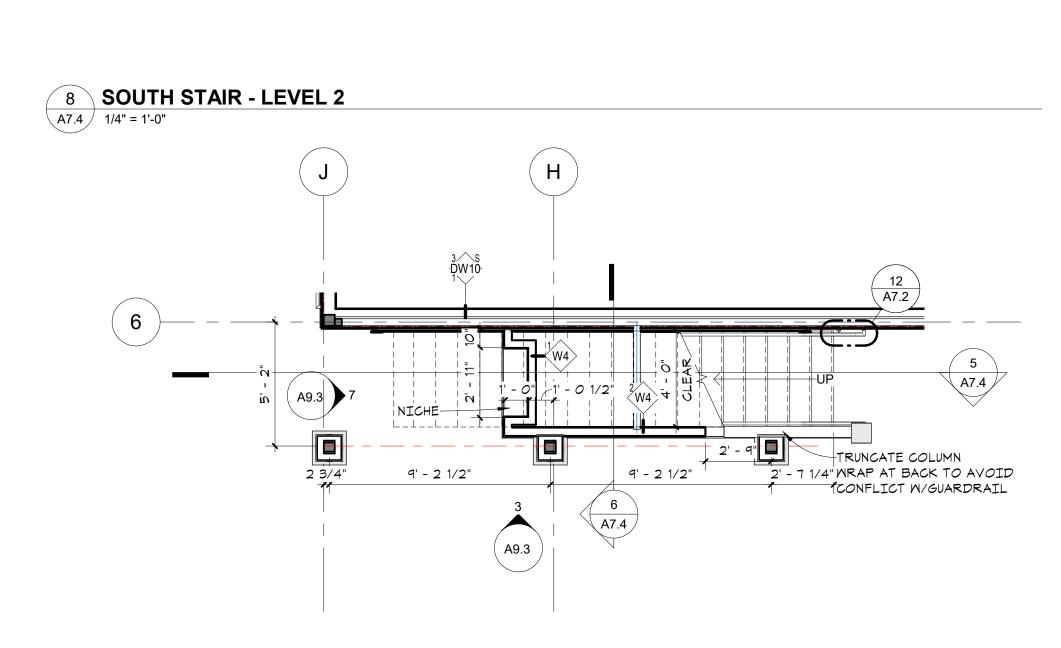

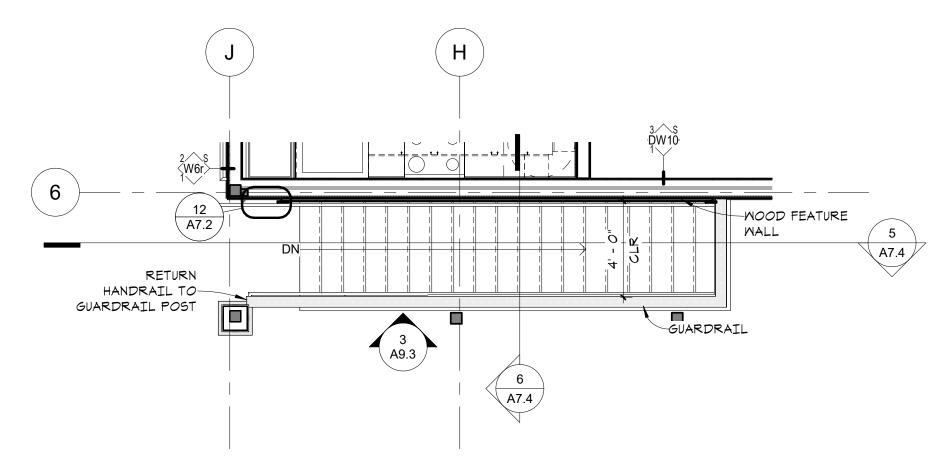

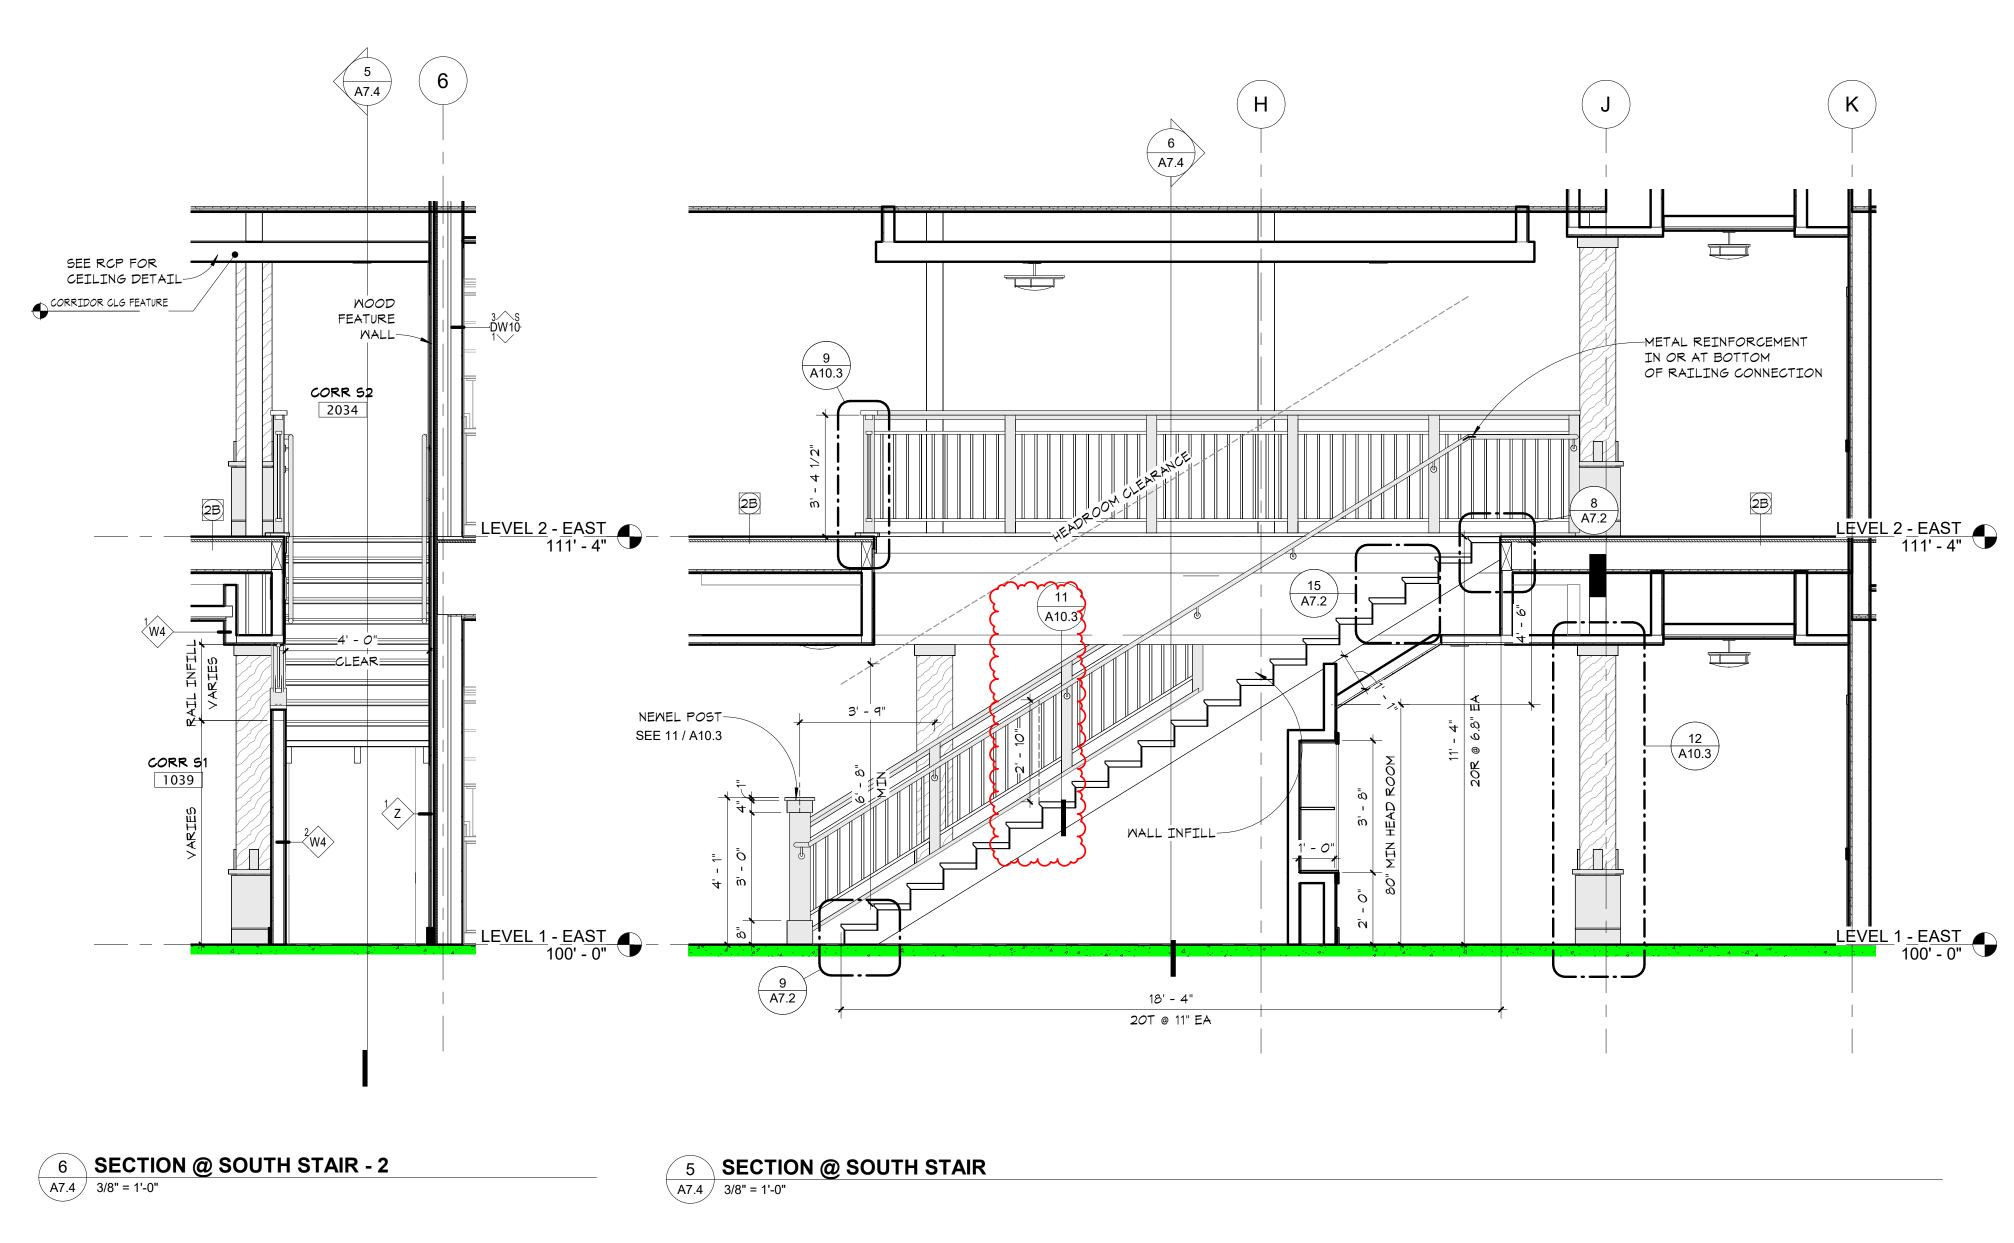

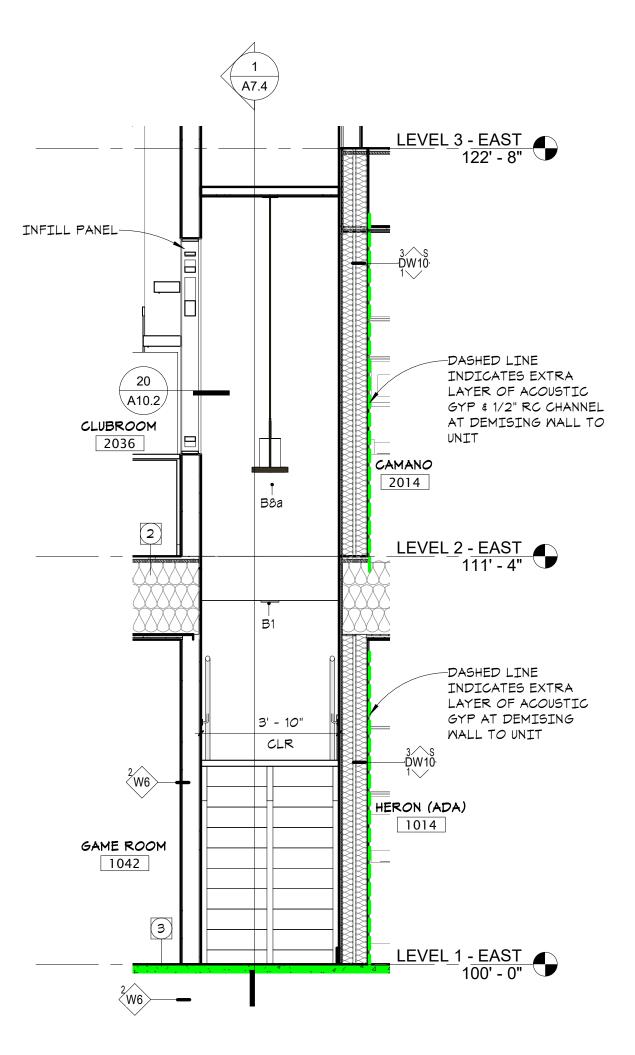

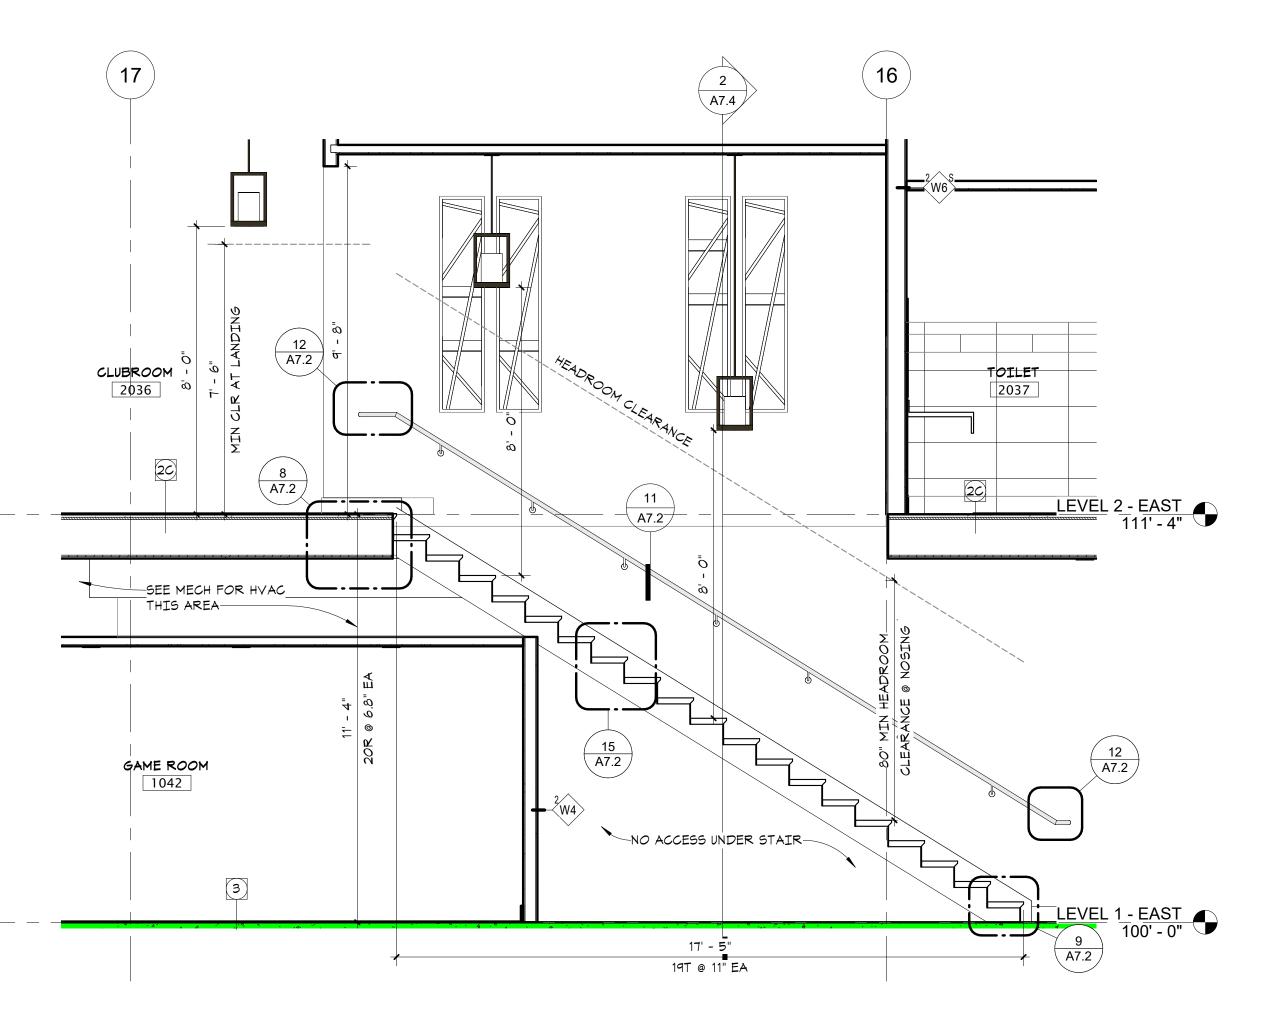


2 SECTION @ GAME ROOM/CLUB ROOM STAIRS - 2 A7.4 3/8" = 1'-0"


1 SECTION @ GAME ROOM / CLUB ROOM STAIRS A7.4 3/8" = 1'-0"

ASSEMBLY TYPES TYPICAL ROOF / CEILING (WD) 1) * ASPHALT SHINGLES * 15# FELT * 1/2" PLYWOOD ROOF SHEATHING * ICE & WATER SHIELD @ EAVES & VALLEYS * RIDGE VENT @ PEAK * ROOF TRUSSES PER STRUCT * R49 BLOWN INSULATION * 6 MIL VAPOR RETARDER (CLASS I) * 2 LAYERS 5/8" TYPE 'X' GYP BD 1-HR FIRE RATING GA RC 2602 OPTION: 1 LAYER TYPE 'C' GYP BD ON 1/2" RESILIENT CHANNEL @ 12" OC (GA RC 2604 (UL P531) -PROPRIETARY GYP) MEMBRANE ROOF / CEILING (ND) MEMBRANE ROOF / CEILING (ND) * FULLY ADHERED SBS ROOFING * COVERBD AS RECOMMENDED BY MANUF * TAPERED INSULATION TO DRAIN * R38 INSULATION * AIR/VAPOR BARRIER * PLYWD SHT - MIN 1/2" (SEE STRUCT) * WOOD FRAMING PER STRUCT * 2 LAYERS 5/8" TYPE 'X' GYP BD 1-HR FIRE RATING GA RC 2601 NOTE: PROVIDE BALLAST AT VISIBLE ROOFS AS SHOWN 📈 TYP FLOOR / CEILING (WD) * 1" GYPCRETE TOPPING (3/4" IF NO SOUND MAT) *1/4" SOUND ATTENUATION MAT * 3/4" T&G PLYWOOD FLOOR SHEATHING (GLUED * NATLED) * WOOD FLOOR TRUSSES, PER STRUCT * FULL DEPTH BLOWN INSULATION * 1/2" RESILIENT CHANNEL @ 12" OC * 1 LAYER 5/8" TYPE 'C' GYP BD 1-HR FIRE RATING UL L563 (SYSTEM 4, SYSTEM 1 @ ROOF) STC 58 RAL-TL97-340 & RAL-IN97-47 2A STAIR LANDING / CLG (WD) * 3/4" GYPCRETE TOPPING * 3/4" T&G PLYWOOD FLOOR SHEATHING (GLUED & NAILED) * 2X10 WOOD JOISTS * 1 LAYER 5/8" TYPE 'X' GYP BD CORRIDOR FLOOR / CEILING (WD) * 3/4" GYPCRETE TOPPING * 3/4" T&G PLYWOOD FLOOR SHEATHING (GLUED & NAILED) * 2X10 WOOD FRAMING PER STRUCT * 1/2" RESILIENT CHANNEL @ 12" OC * 1 LAYER 5/8" TYPE 'C' GYP BD * SUSPENDED GYP BD CEILING, SEE REFLECTED CEILING PLANS 1-HR FIRE RATING UL L514 20 GAME ROOM FLOOR / CEILING (WD) * 3/4" GYPCRETE TOPPING * 3/4" T&G PLYWOOD FLOOR SHEATHING (GLUED & NAILED) * 1 3/4" X 11 7/8" LVL PER STRUCT * 1/2" RESILIENT CHANNEL @ 12" OC * 1 LAYER 5/8" TYPE 'C' GYP BD * SUSPENDED GYP BD CEILING, SEE REFLECTED CEILING PLANS 1-HR FIRE RATING UL L570 PT CONC FLOOR / CEILING * PT CONC SLAB, PER STRUCT *SCRIM FACED INSUL ATTACHED TO SLAB

UNDERSIDE AT GARAGE (R-30ci) 3-HR FIRE RATING

- 4 CONC FLOOR SLAB-ON-GRADE * 4" CONC SLAB, PER STRUCT * 15 MIL POLY VAPOR RETARDER AT CONDITIONED SPACES * 4" COMPACTED GRANULAR FILL (VERIFY W/GEOTECH REPORT) *R-10 INSUL FROM TOP OF SLAB 24" DOWN (NO PERIM INSUL IF SLAB-ON GRADE IS MORE THAN 24" BELOW FINISHED EXT GRADE) EXTERTOR SLAP ON COMP
- 4A) * 4" CONC SLAB, PER STRUCT * 4" COMPACTED GRANULAR FILL (VERIFY W/ GEOTECH REPORT) 5 <u>TYPICAL FLOOR RIM</u> * SHTG - SEE STRUCT *RIM JOIST PER STRUCT *R19 SPRAY INSUL
- 6 <u>TYPICAL FOOTING & FOUNDATION</u> * CONC FOOTING, PER STRUCT * 4" DRAIN TILE W/ FREE DRAIN, W/ GRAVEL & FILTER FABRIC SURROUND * CONC FOUNDATION WALL, PER STRUCT * WATERPROOFING (EXTEND OVER FTG, LAP MEMBRANE FLASHING & ABOVE FIRST FLOOR SLAB) * DRAINAGE MAT * INSULATION AS REQ'D SEE WALL TYPES FOR NOTES NOTES
- TYPICAL EAVE * ASPHALT SHINGLES * ICE & WATER SHIELD (5'-O" MIN) * PREFINISHED METAL DRIP EDGE * PREFINISHED ALUMINUM GUTTER * ROOF SHEATHING * FRAMING PER STRUCT * PREFIN FIBER CEMENT FASCIA * T-111 ROOF DECKING WITH GROOVE DOWN. STAIN TRUSS RAFTERS AND UNDERSIDE OF DECKING
- TRUSS RAFTERS AND UNDERSIDE OF DECKING * INSULATION BAFFLE
- 8 <u>DECK / CLG OVER EXTERIOR (MD)</u> * WALKABLE FLUID APPLIED MEMBRANE * 1/2" PLYMD SUBSTRATE OVER 3/4" PLYMD SUBSTRATE; STAGGER JOINTS * WOOD JOISTS, PER STRUCT, SLOPE TO DRAIN
- * FIBER CEMENT SOFFIT FINISH W/ LINEAR VENTS
- (8A) PAVER DECK ON PEDESTALS OVER 1B

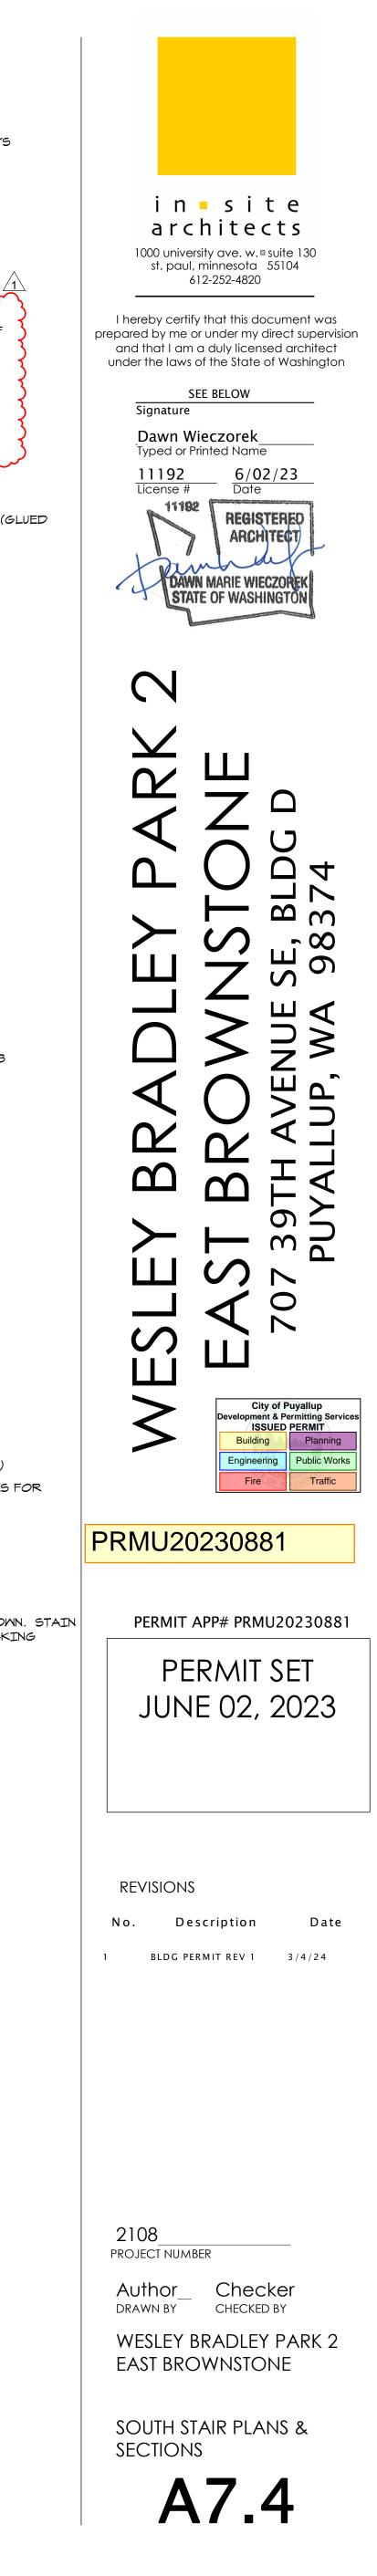


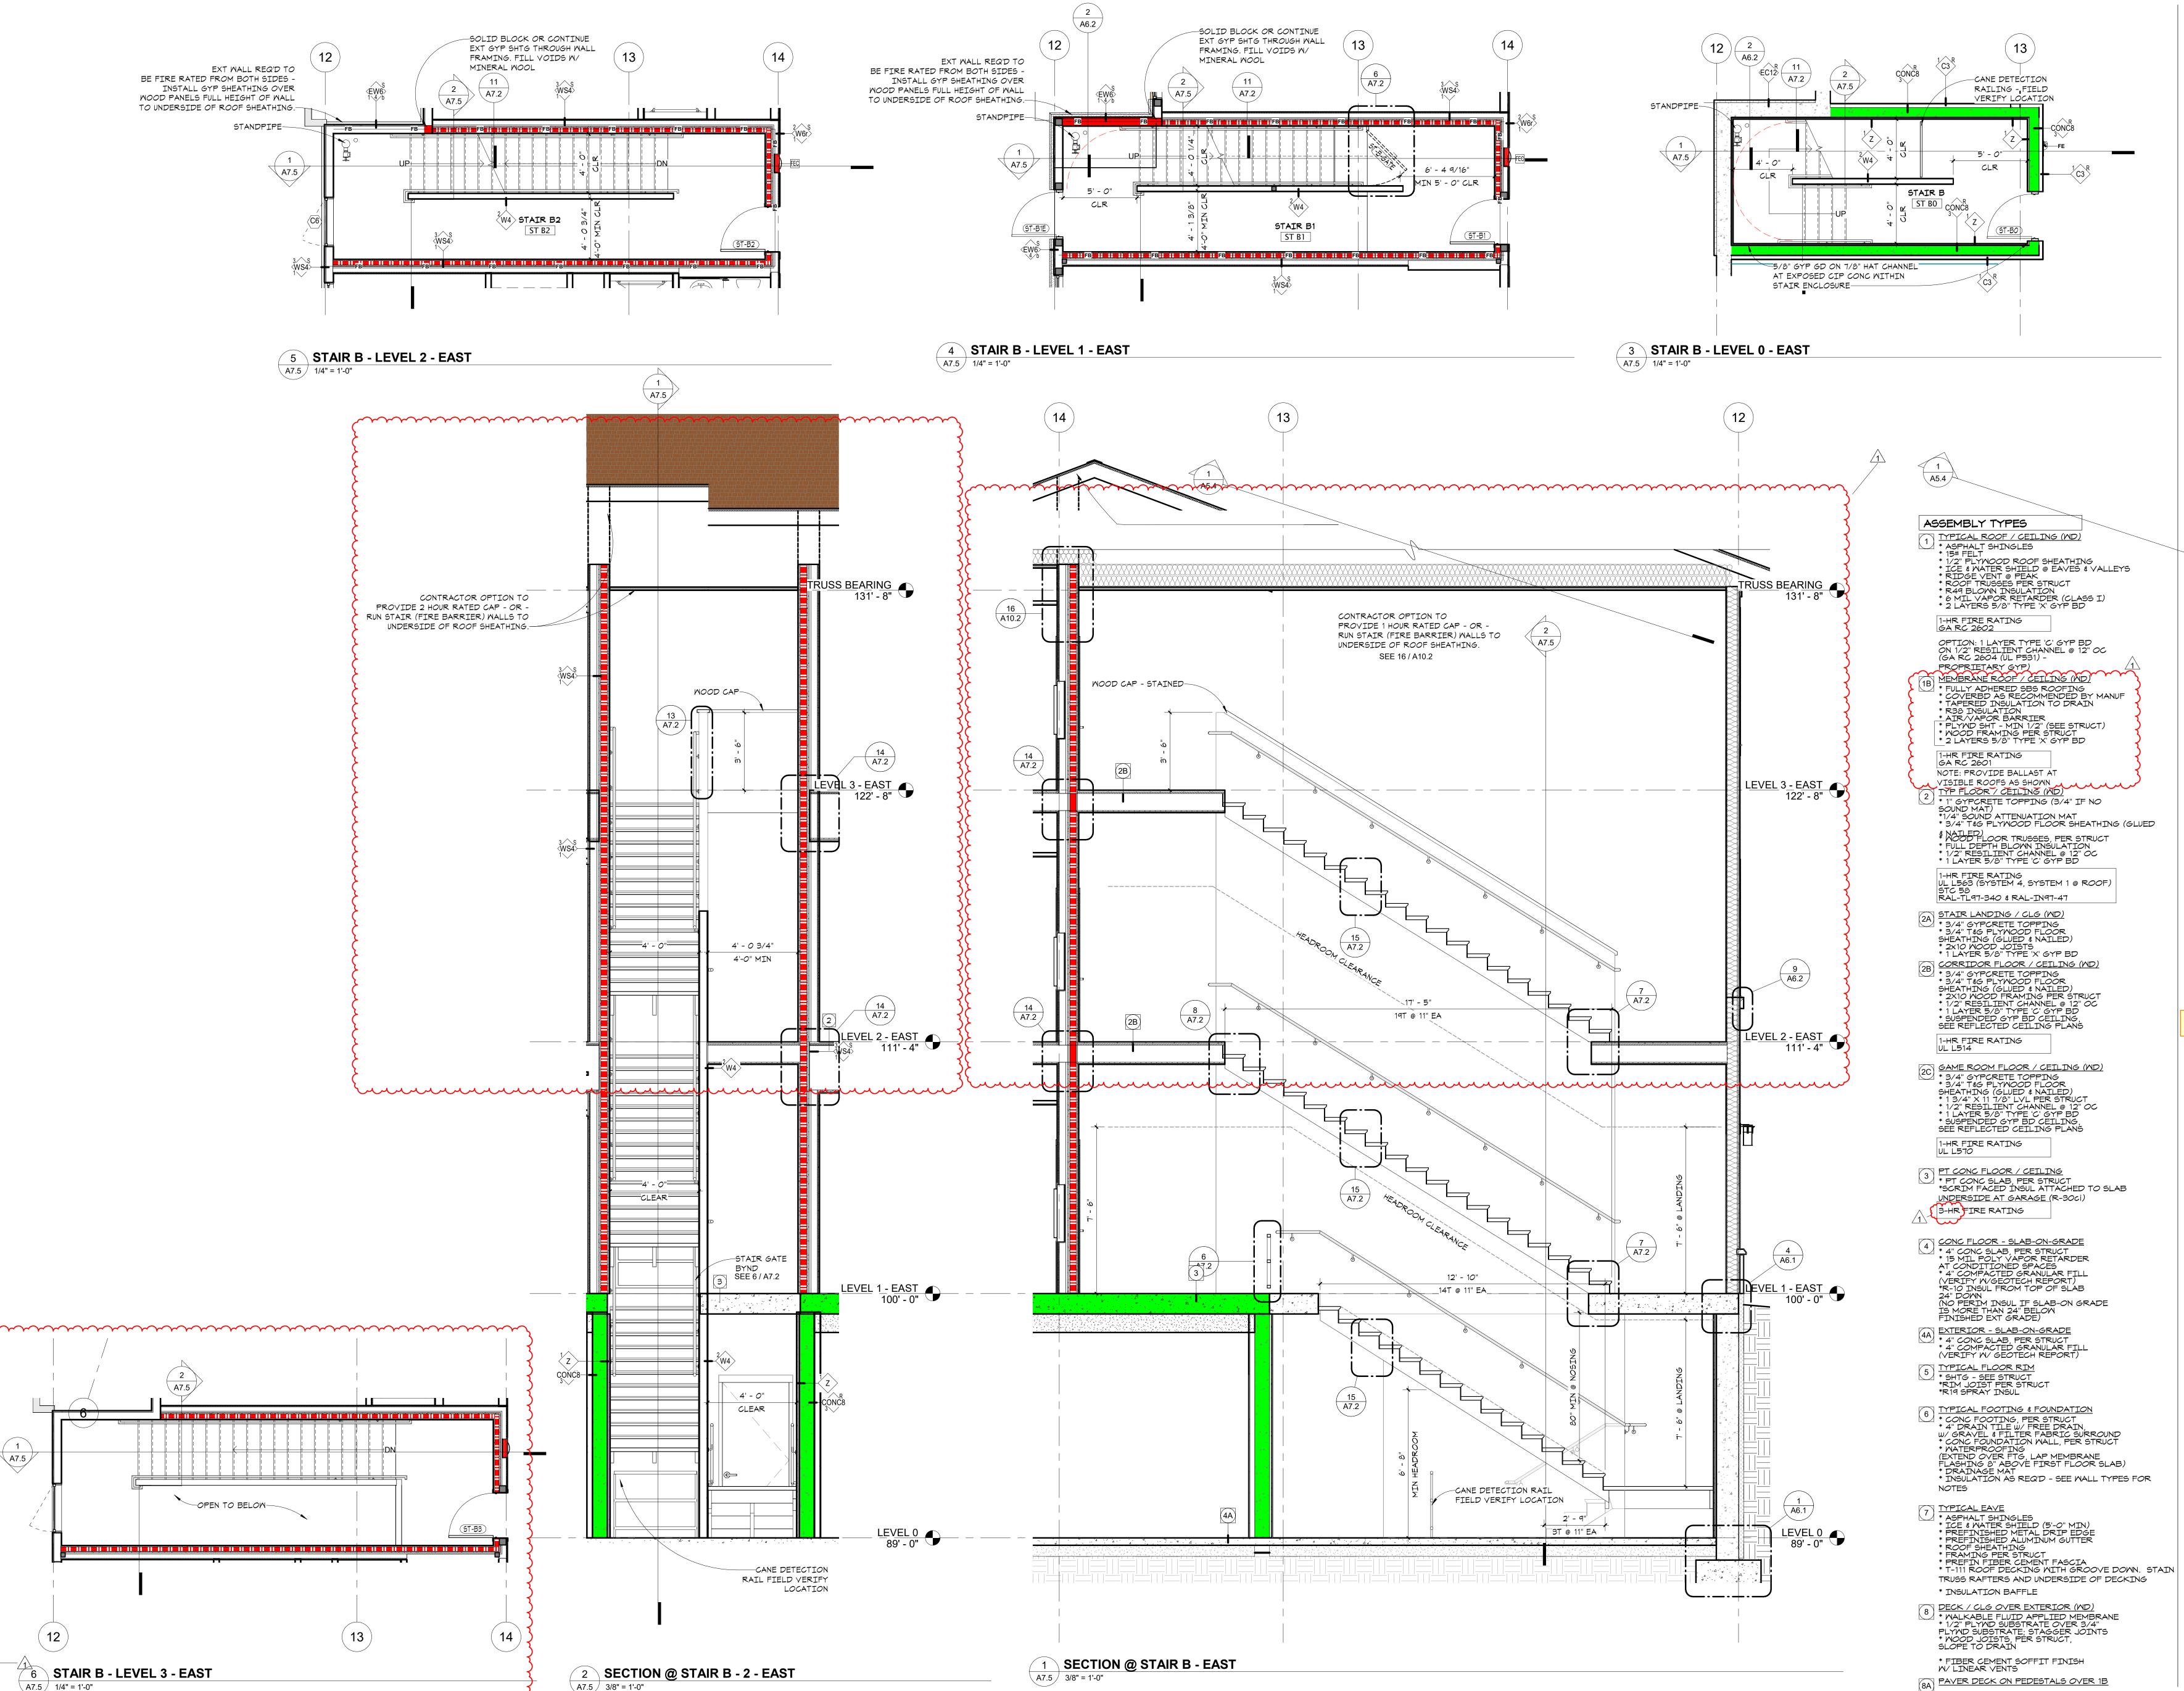

A7.5


〔12〕


\ A7.5 / 1/4" = 1'-0"

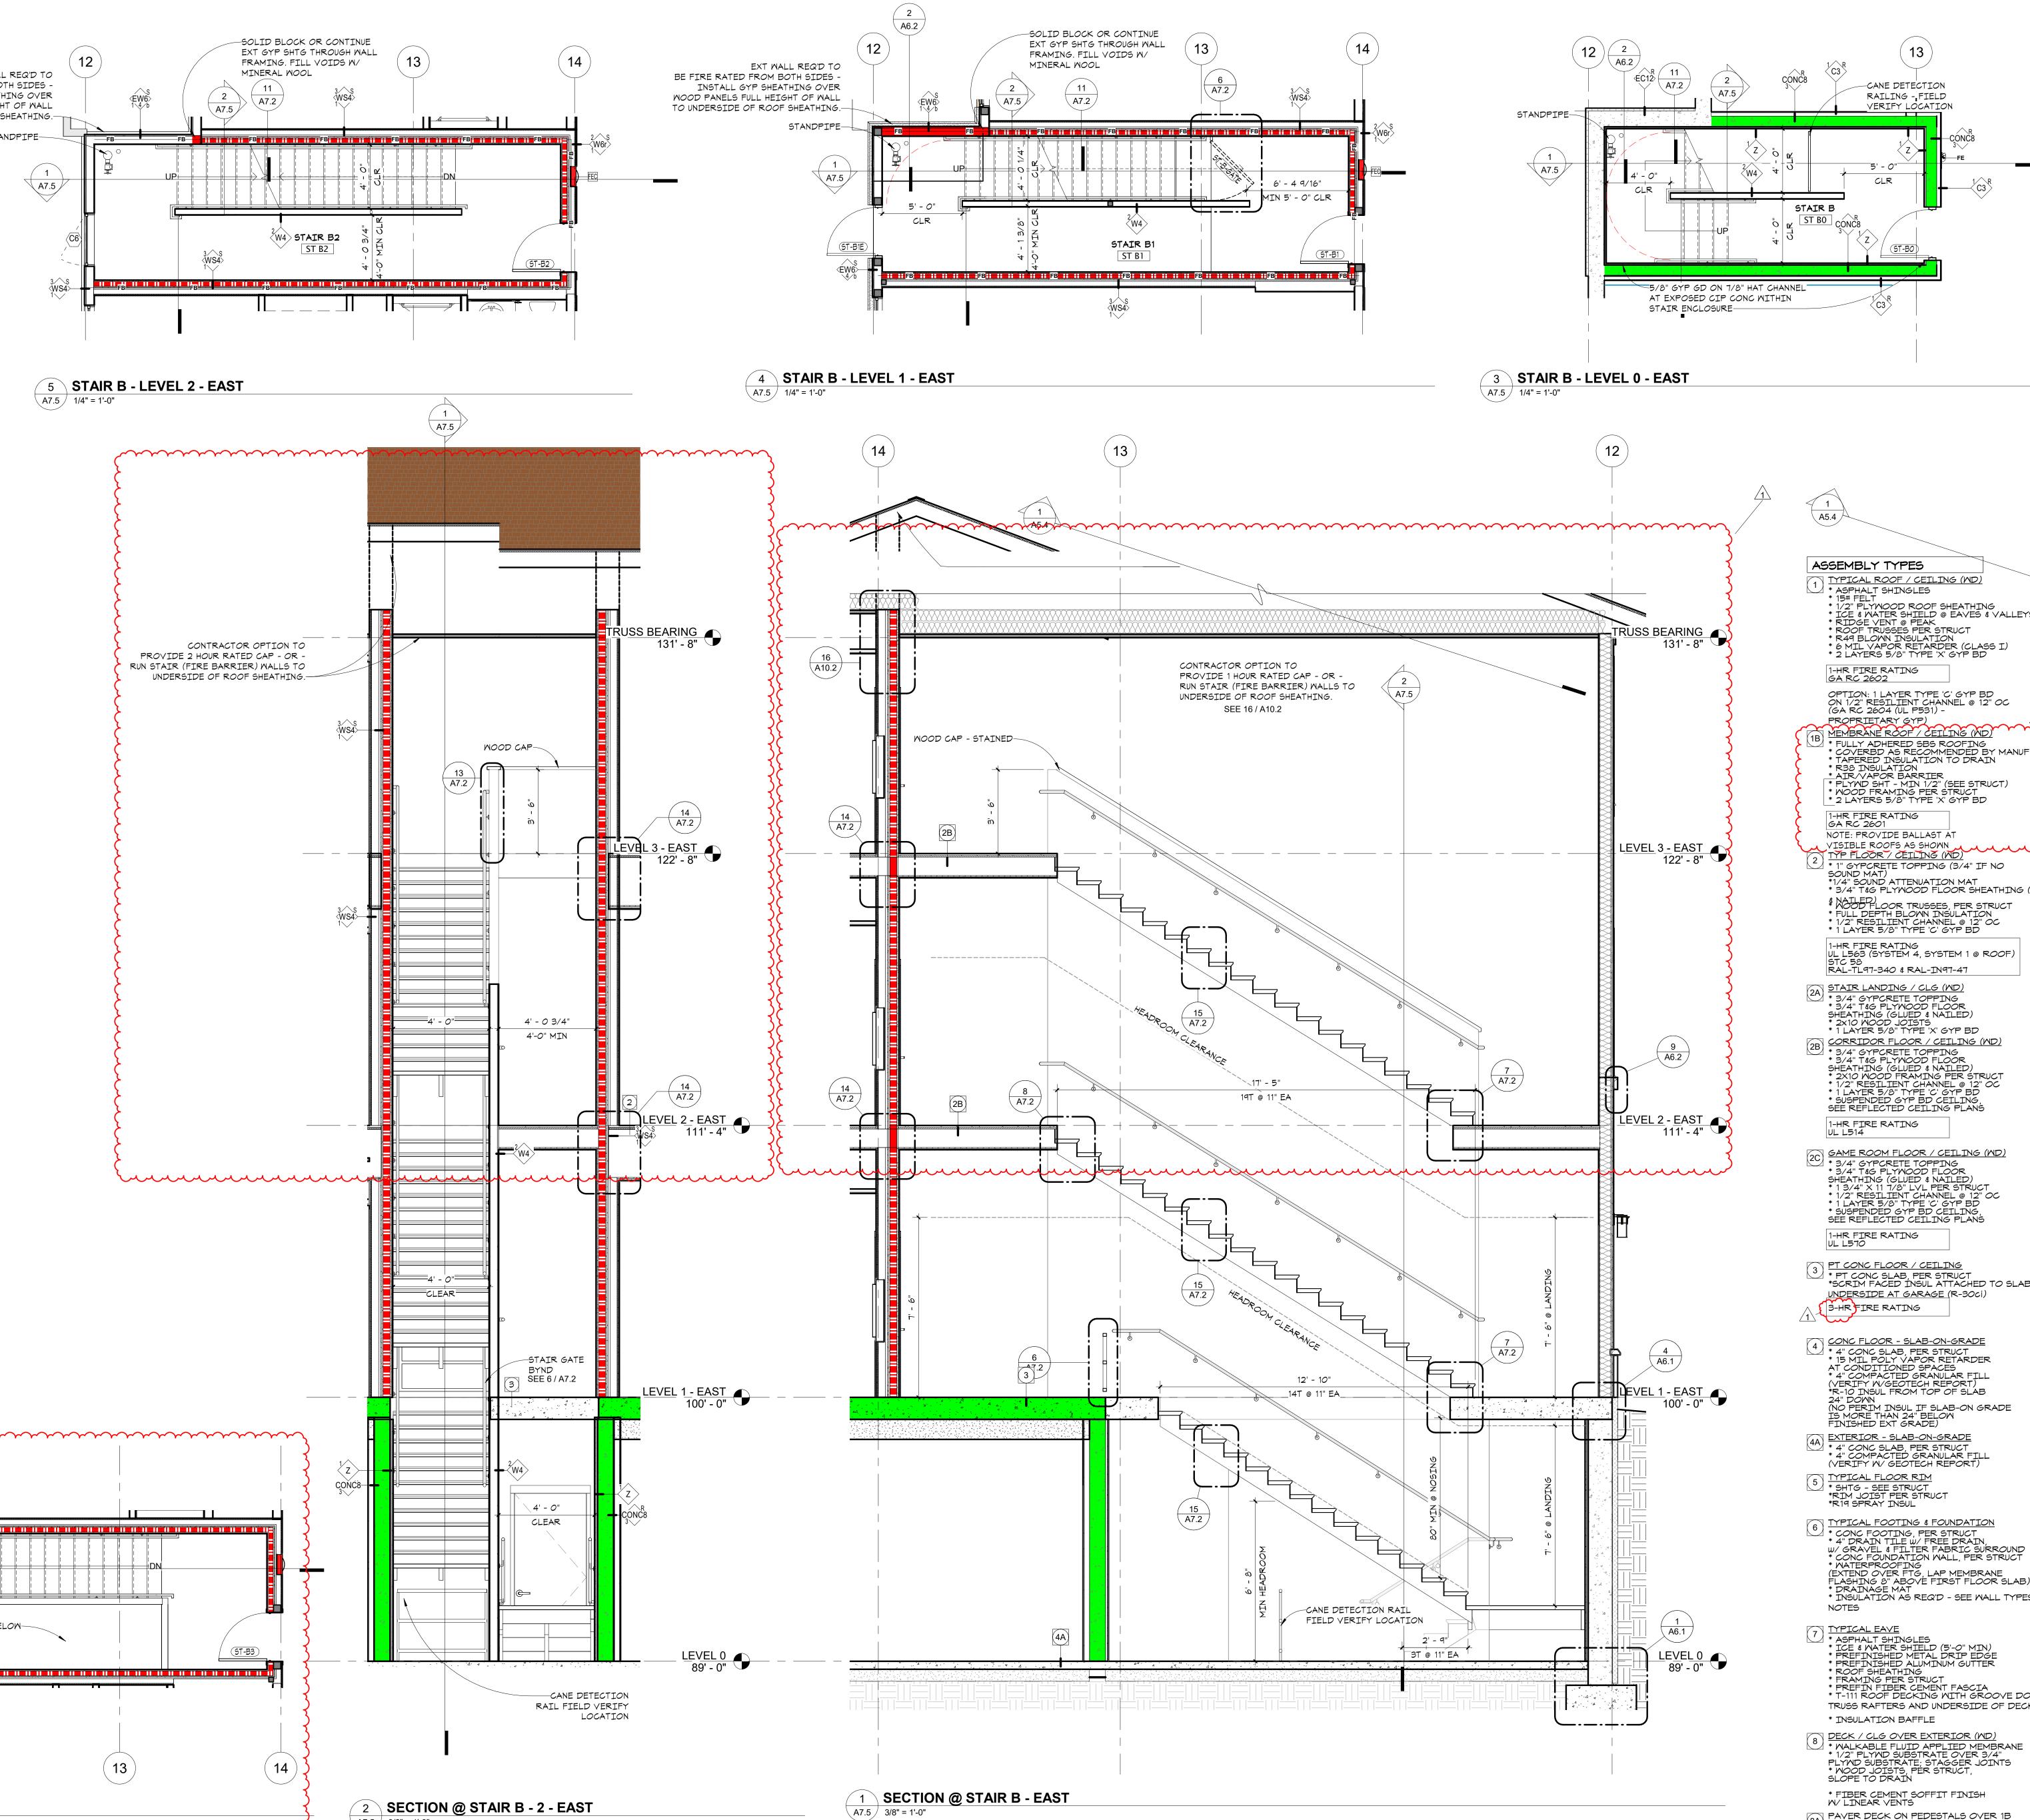




in site architects 1000 university ave. w. 🛚 suite 130 st. paul, minnesota 55104 612-252-4820 I hereby certify that this document was prepared by me or under my direct supervision and that I am a duly licensed architect under the laws of the State of Washington SEE BELOW Signature Dawn Wieczorek Typed or Printed Name 11192 6/02/23 License # Date 11192 REGISTERE ARCHITECT DAWN MARIE WIECZORE STATE OF WASHINGT \sim m m $r \infty$ ШŐ $\supset \geq$ 7 ` ش م ~ ¬ P Μ \mathbf{M} **6** m T 5 0 ら City of Puyallup velopment & Permitting Services ISSUED PERMIT Building Planning Engineering Public Works Fire PRMU20230881 PERMIT APP# PRMU20230881 PERMIT SET JUNE 02, 2023 REVISIONS Date No. Description 1 BLDG PERMIT REV 1 3/4/24 2108 PROJECT NUMBER Author_ Checker DRAWN BY CHECKED BY WESLEY BRADLEY PARK 2 EAST BROWNSTONE STAIR B PLANS & SECTIONS **A7**

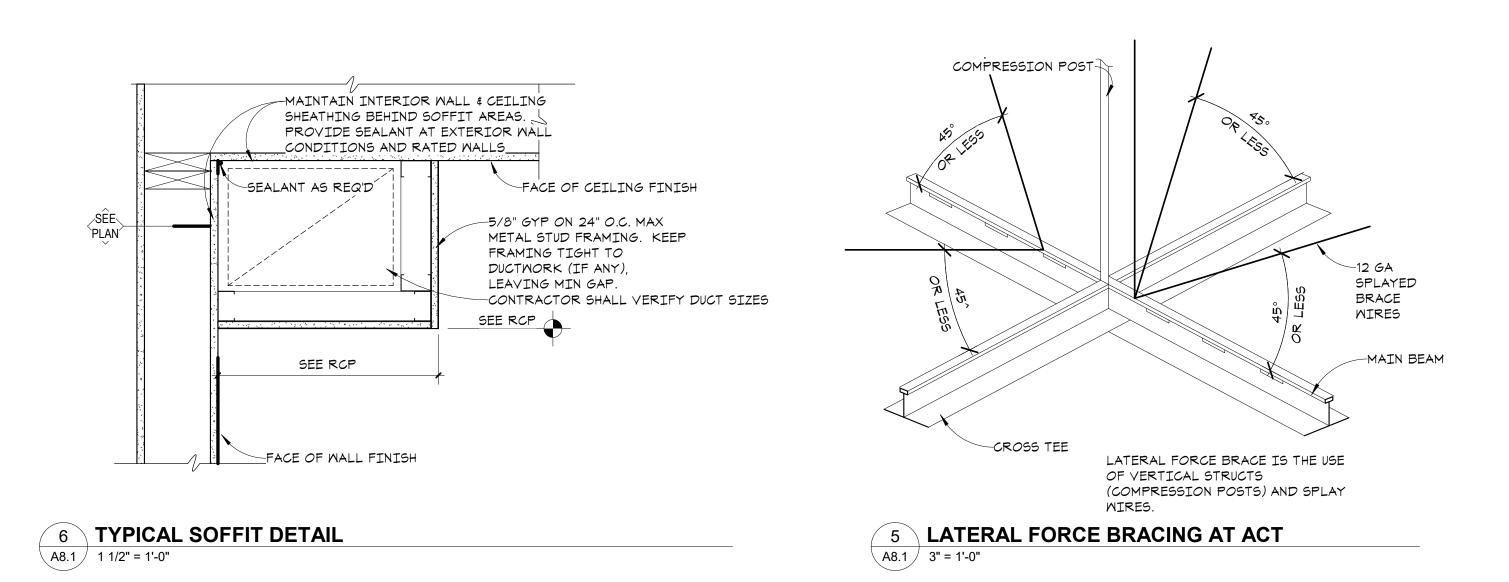


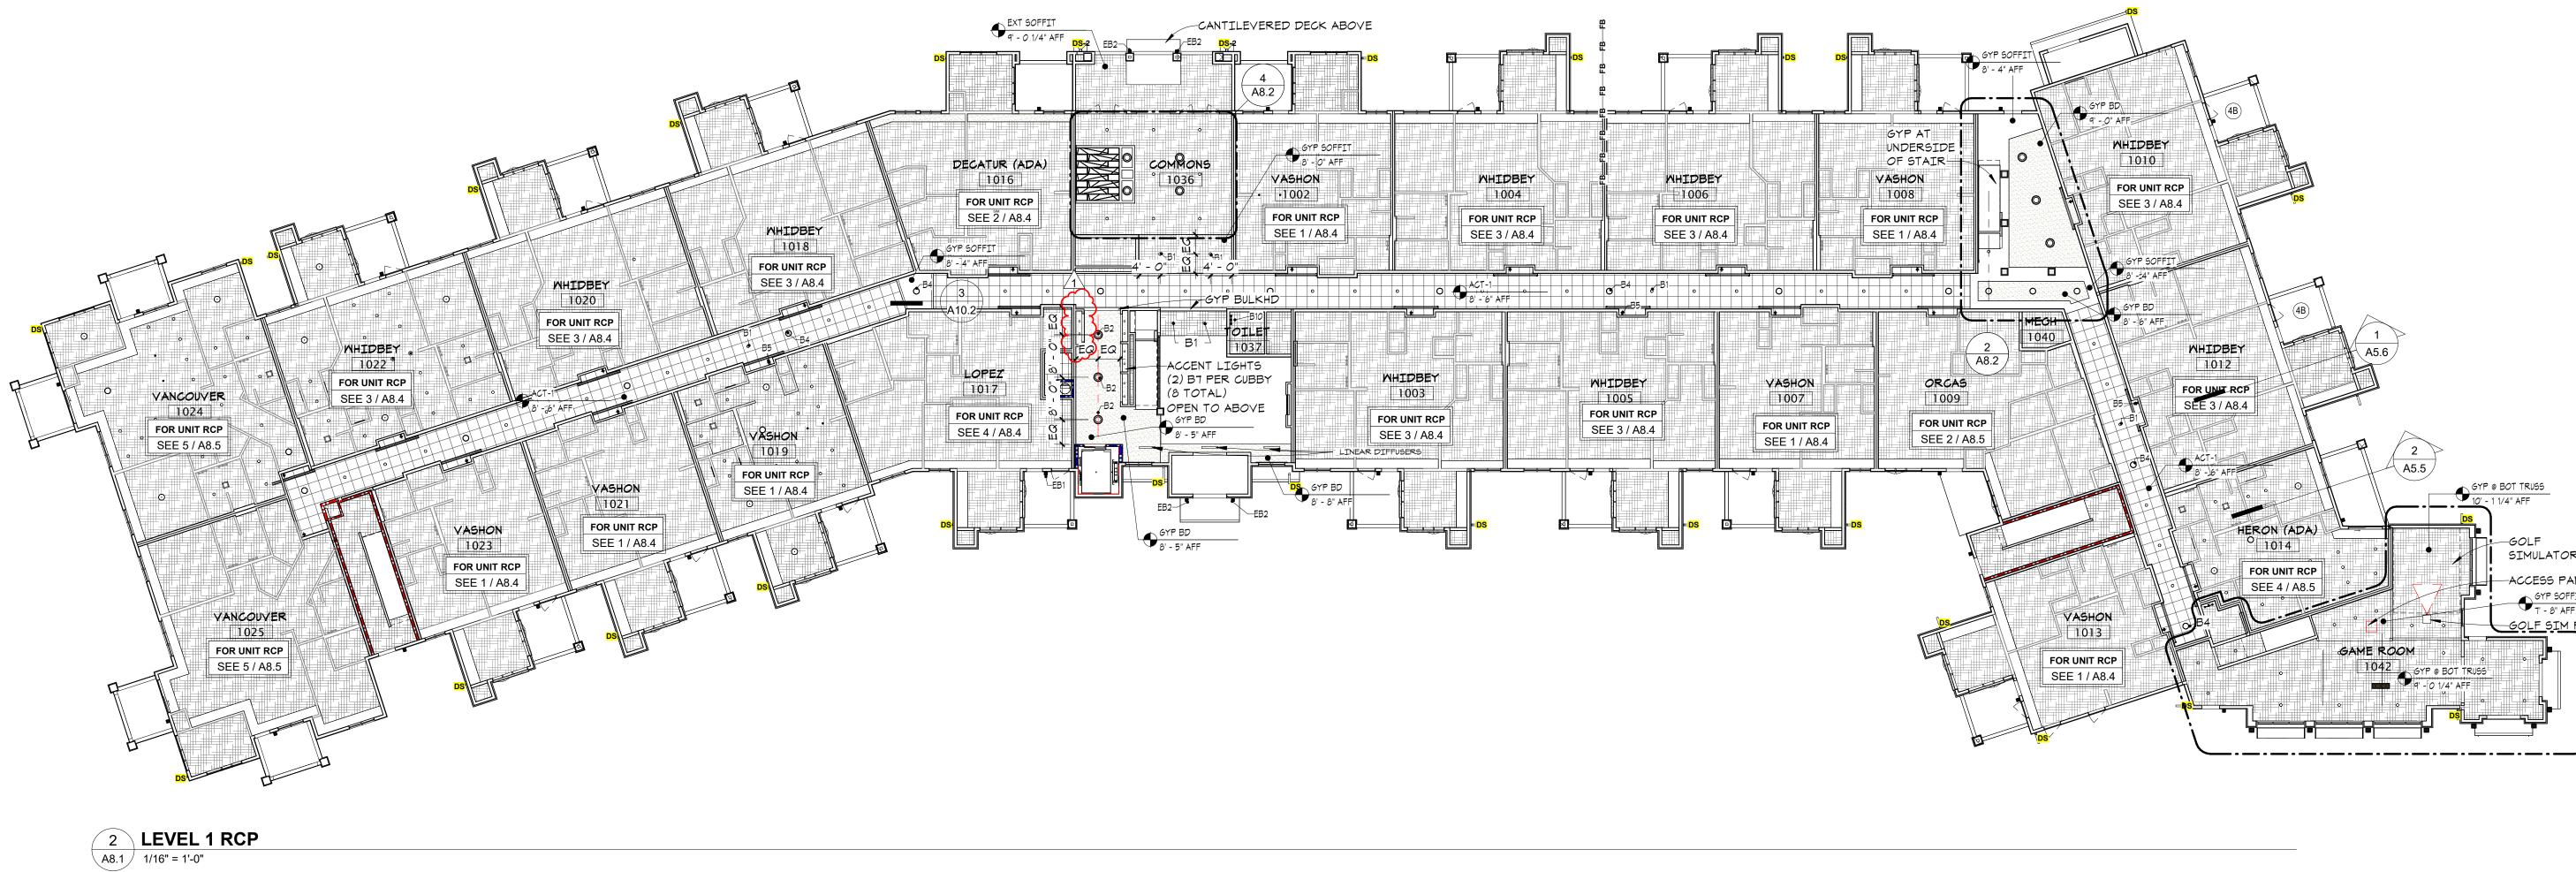

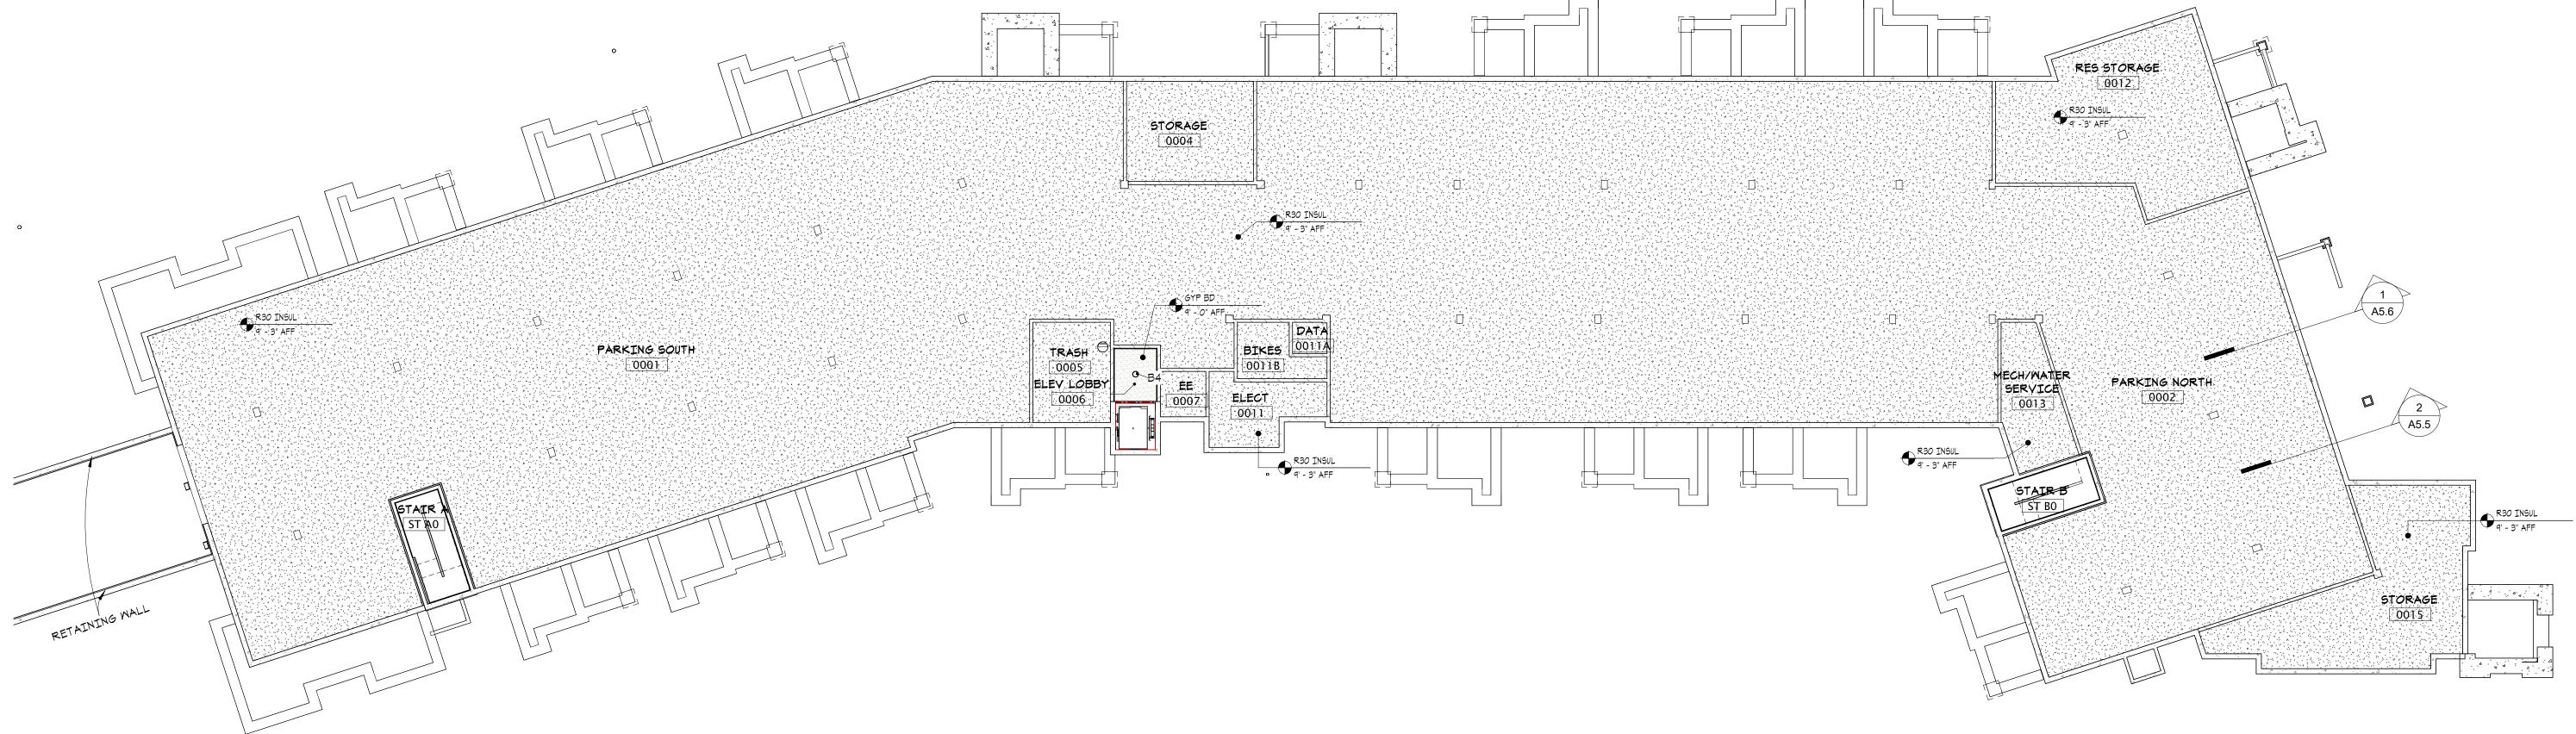


1 **LEVEL 0 RCP** A8.1 1/16" = 1'-0"

8/11/2024 1·30·49 PM

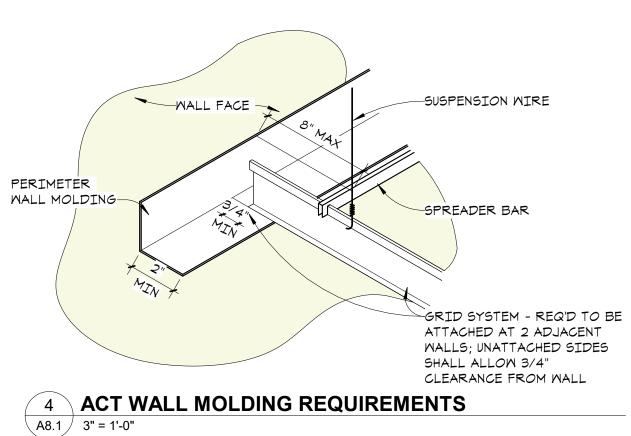

REFLECTED CEILING PLAN NOTES

- . ALL FRAMING FOR SOFFITS TO BE USED AS PLENUMS TO BE CONSTRUCTED WITH NON-COMBUSTIBLE FRAMING.
- 2. SOFFIT DIMENSIONS ARE MAX DIMENSIONS TYPICALLY. SOFFITS TO BE FRAMED AS TIGHT TO MECH DUCTWORK AS FIELD CONDITIONS ALLOW, UNO
- 3. VERIFY LOCATION OF ACCESS PANELS WITH HVAC AND PLUMBING CONTRACTOR.
- 4. ALL SUSPENDED CEILING GRID SYSTEMS SHALL BE CENTERED IN SPACES AS SHOWN, UNLESS INDICATED OTHERWISE BY DIMENSION.
- 5. LIGHT FIXTURES SHOWN ARE FOR LOCATION ONLY.
- 6. PROVIDE BLOCKING AS REQUIRED FOR LIGHT FIXTURE SUPPORT. FINAL LIGHTING PLAN TBD.
- 7. SEE MECHANICAL PLANS FOR TYPES, SIZES, AND LOCATIONS OF MECHANICAL GRILLS AND REGISTERS. PAINT TO MATCH ADJACENT WALL COLOR.
- 8. COORDINATE ALL SPRINKLER HEAD LOCATIONS WITH STRUCTURAL, MECHANICAL, PLUMBING, AND ELECTRICAL ITEMS PRIOR TO SUBMISSION OF DESIGN DRAWINGS TO THE ARCHITECT. NO STRUCTURAL SUPPORT MEMBERS SHALL BE PENETRATED WITHOUT THE PRIOR WRITTEN PERMISSION OF THE STRUCTURAL ENGINEER. ALL SPRINKLER PIPES SHALL BE CONCEALED. USE RECESSED SPRINKLER HEADS AT THE CENTER OF SUSPENDED CEILING GRID PANELS, WHERE OCCURS.

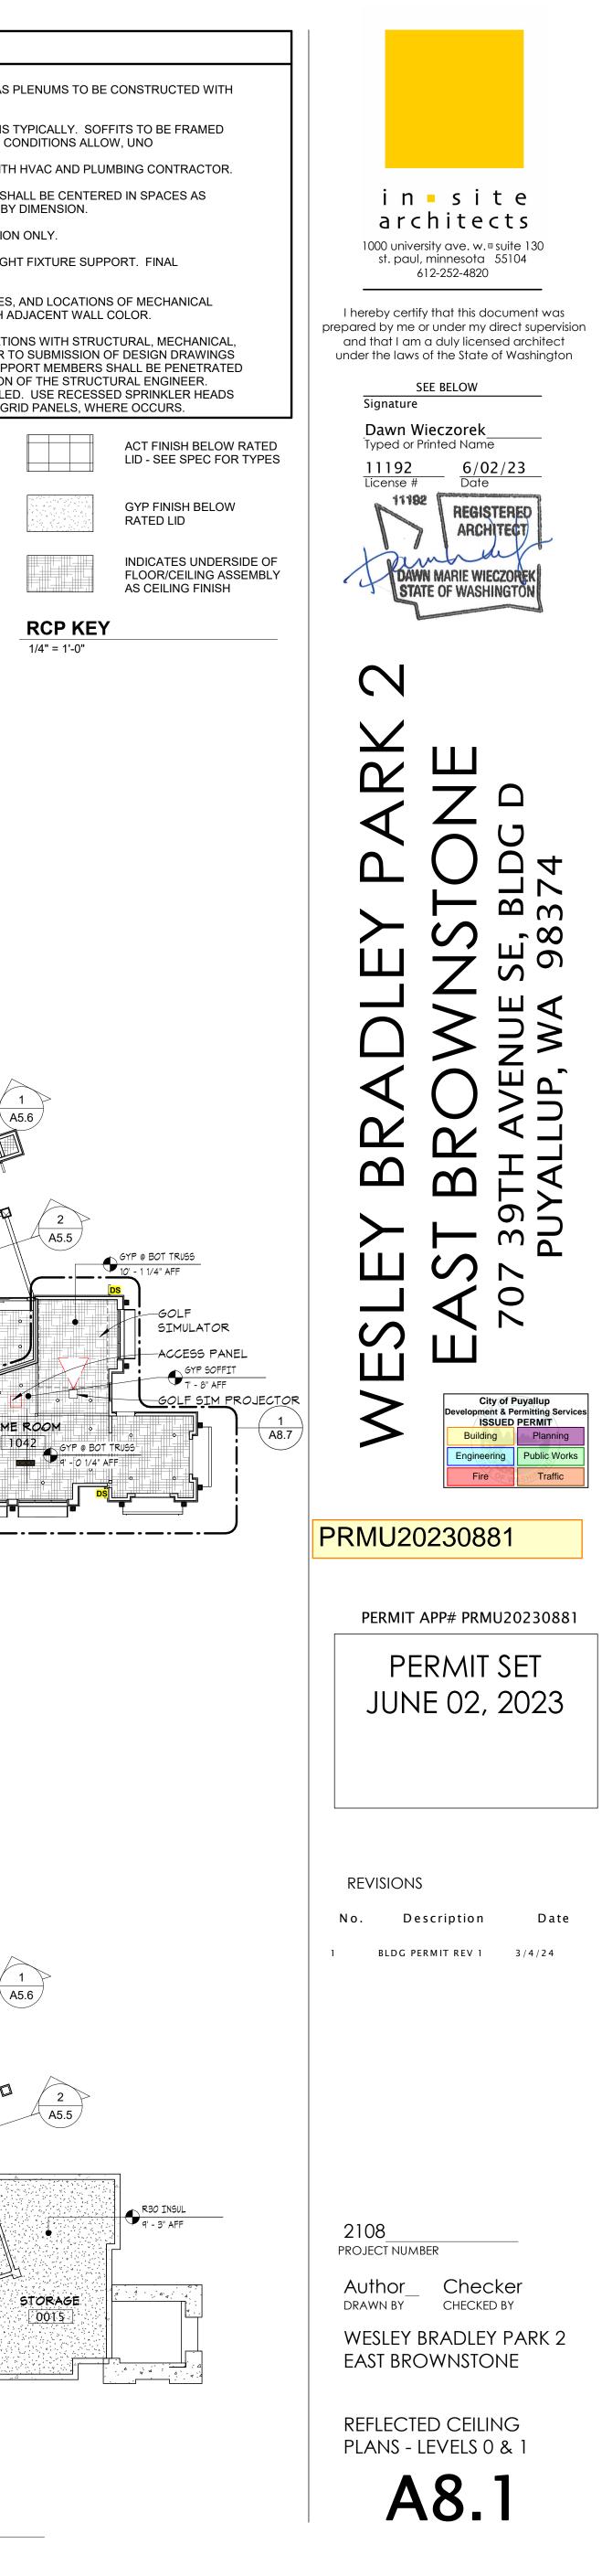

MHIDBEY

FOR UNIT RCP

SEE 3 / A8.4

VANCOUVER 2025

FOR UNIT RCP


SEE 5 / A8.5


VANCOUVER


2024

FOR UNIT RCP

SEE 5 / A8.5

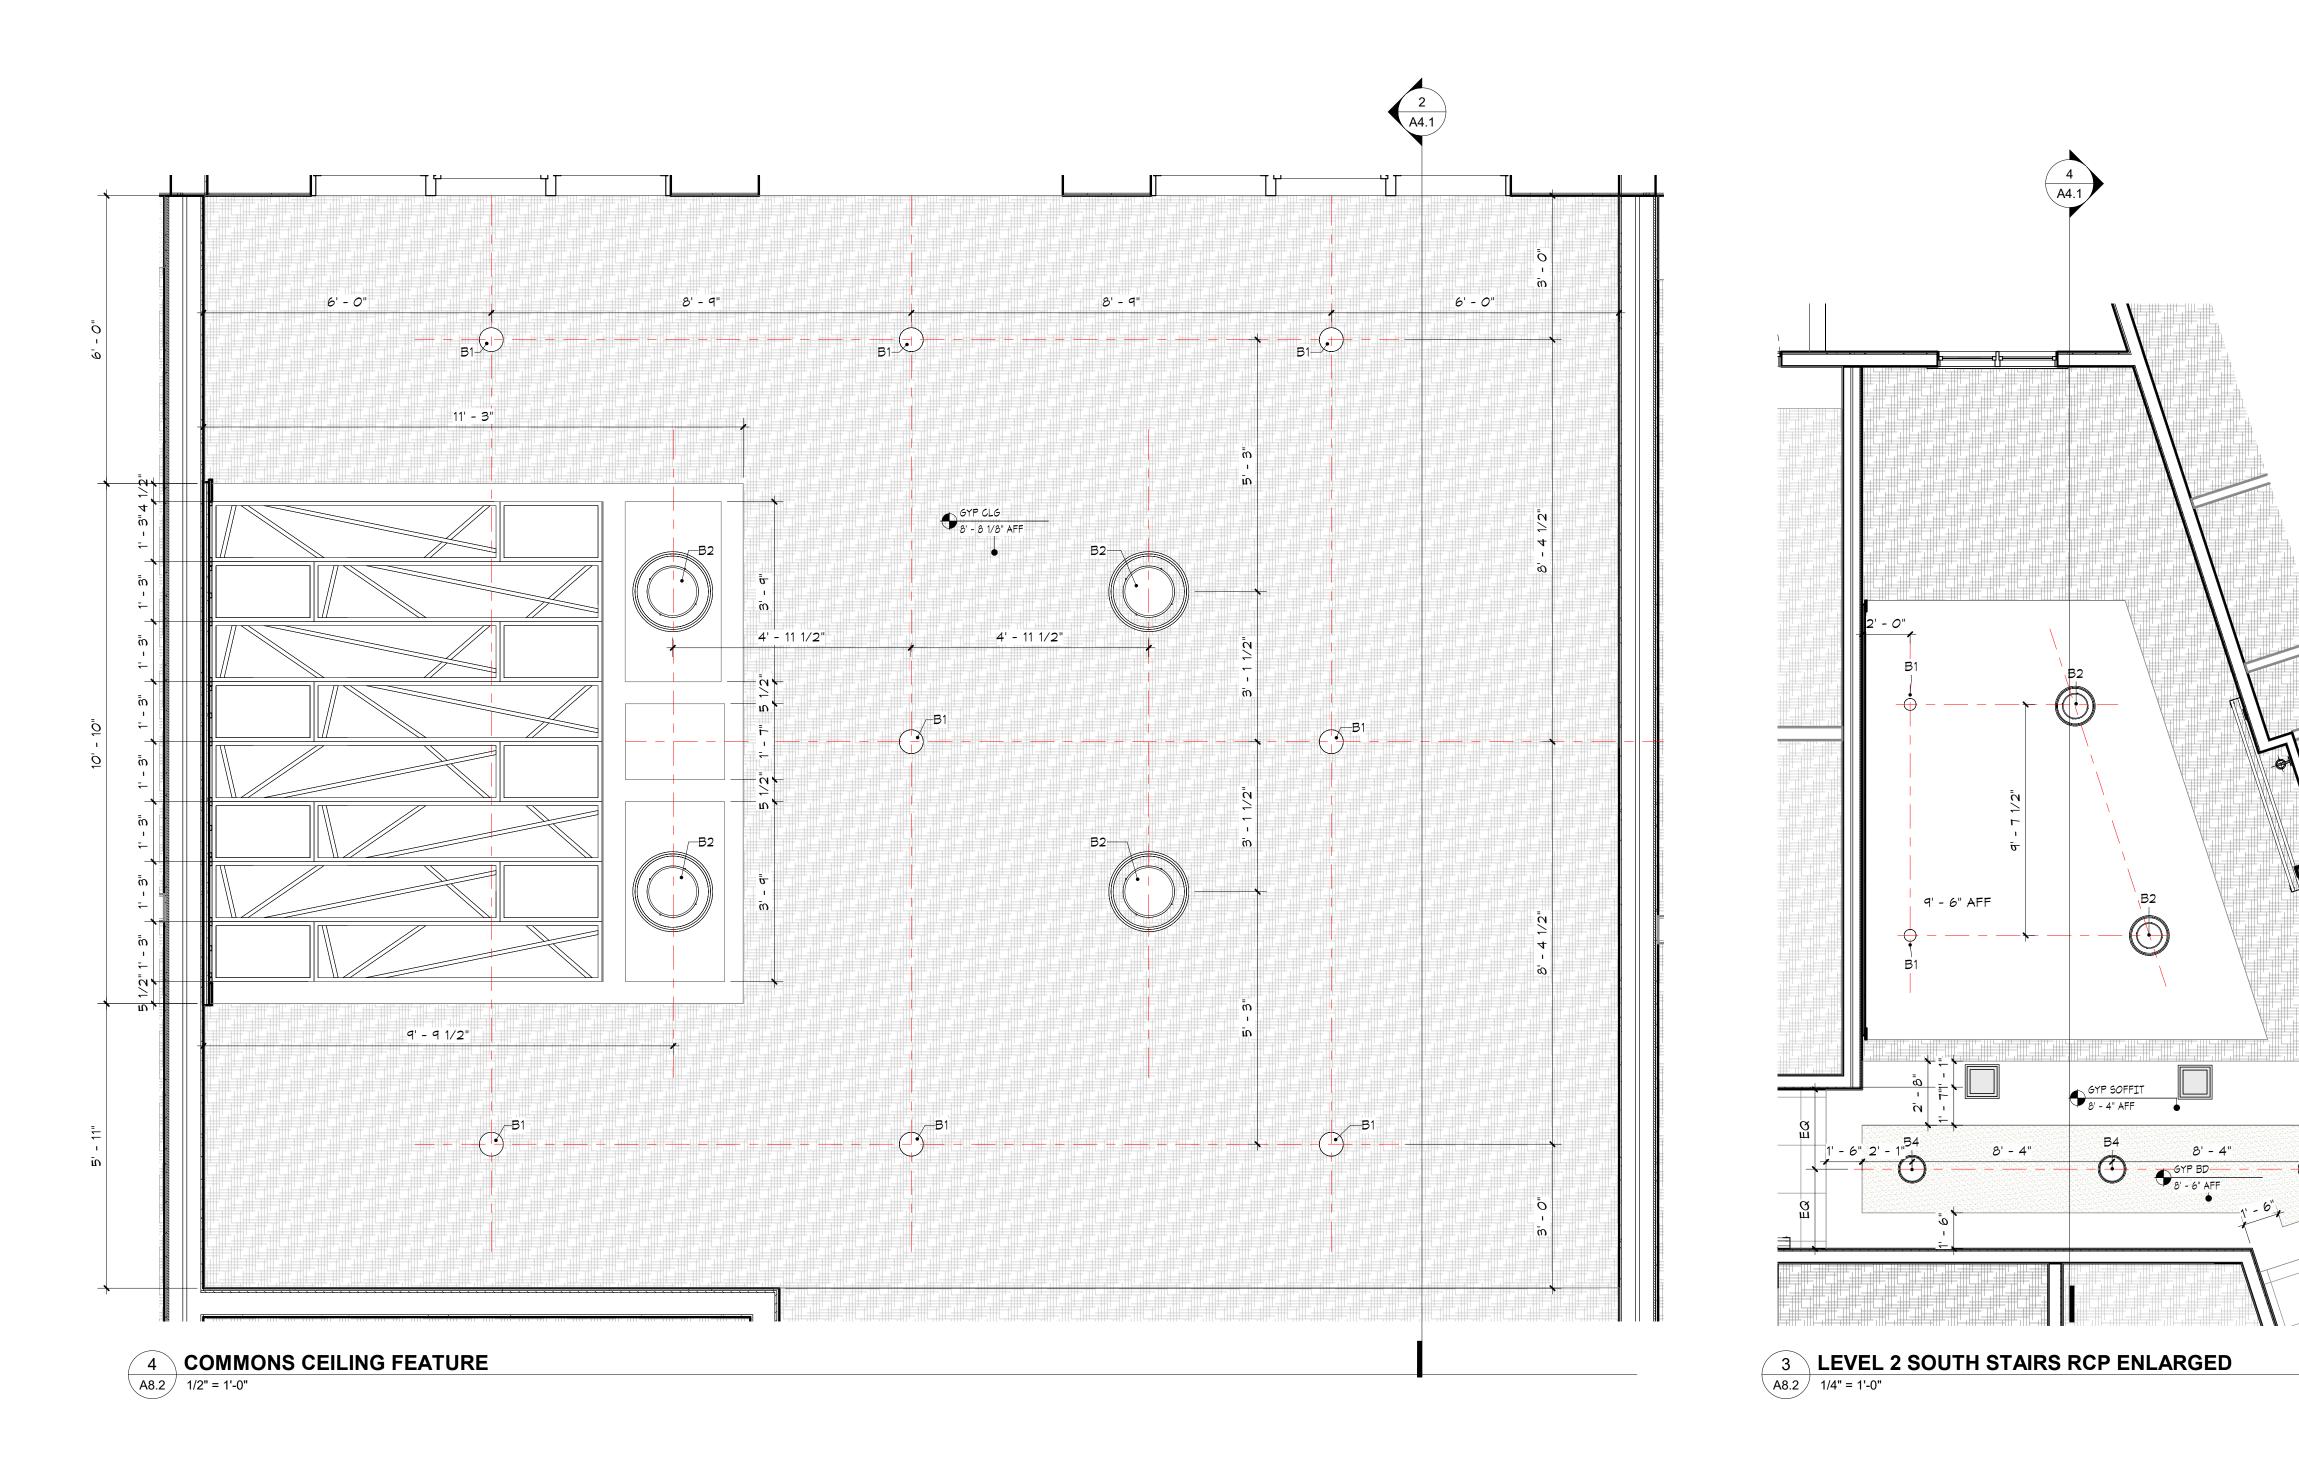


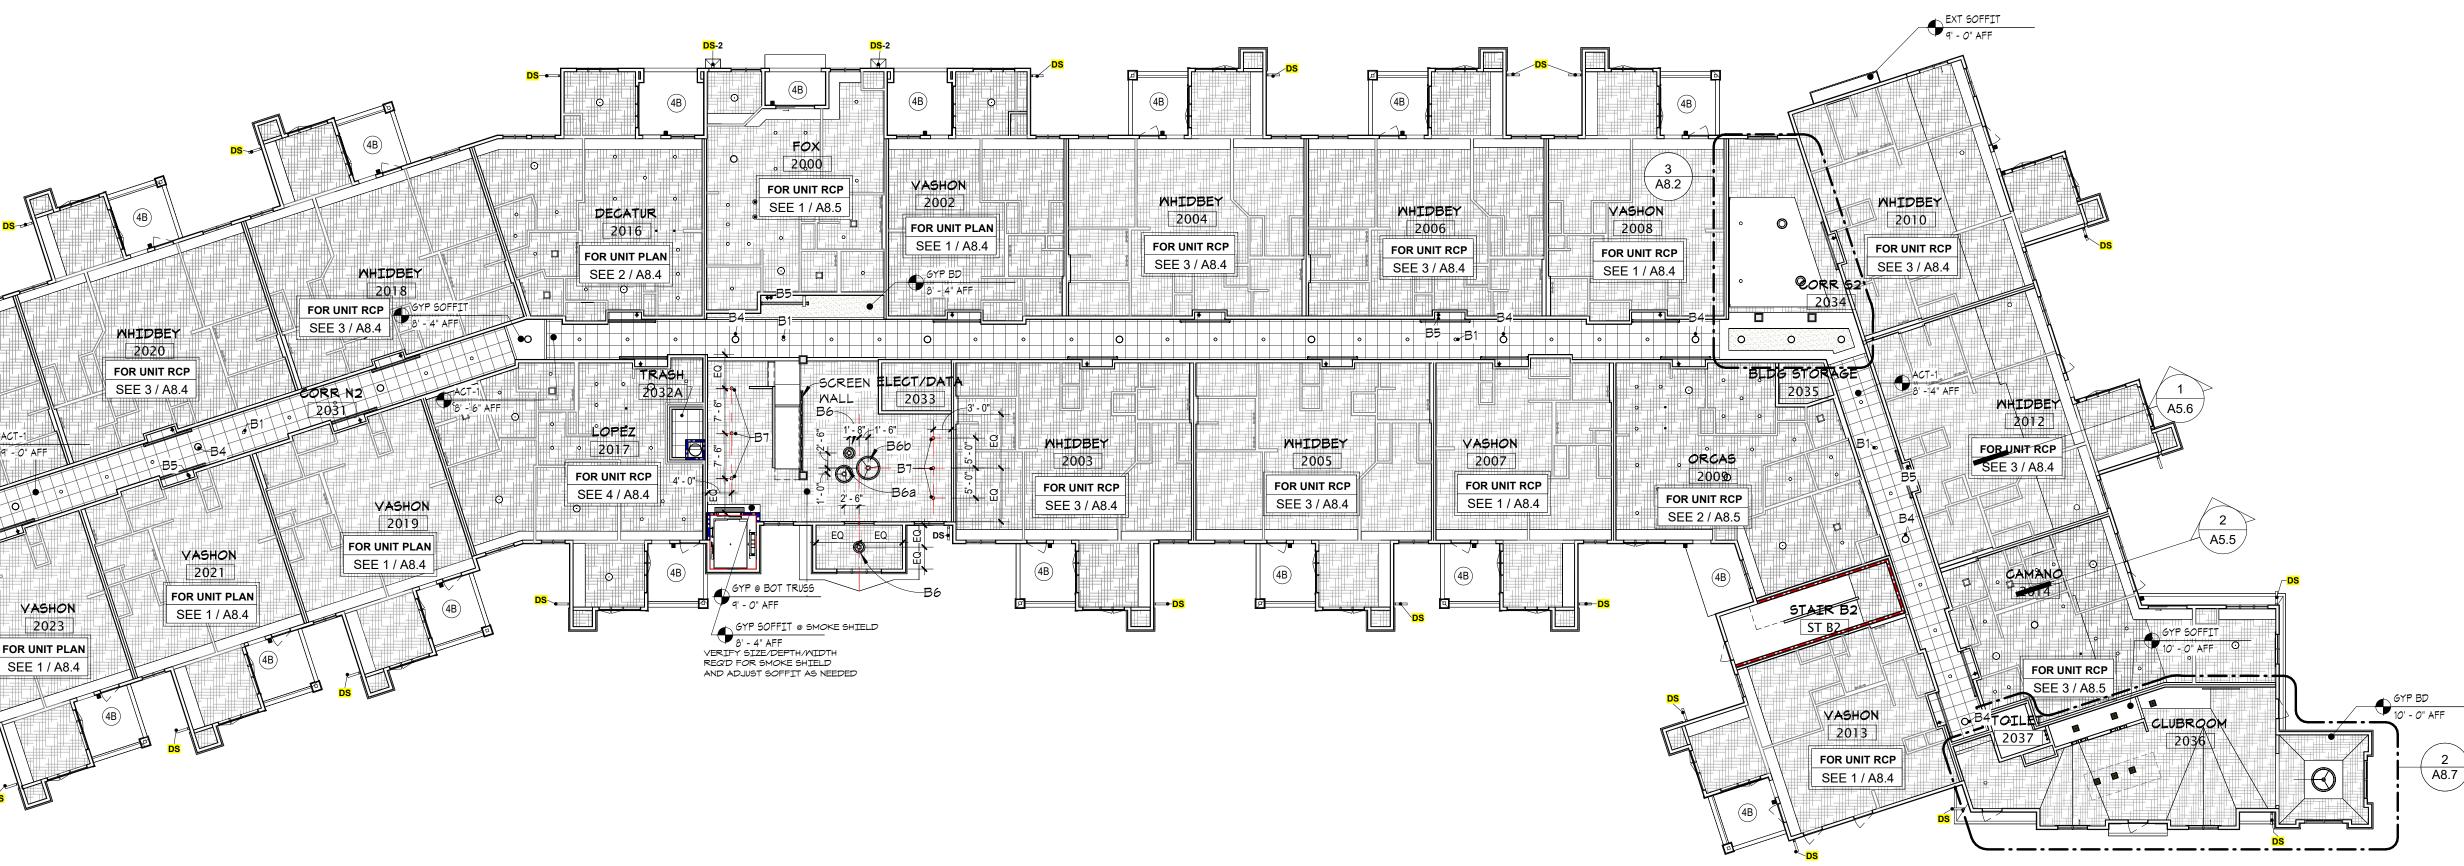


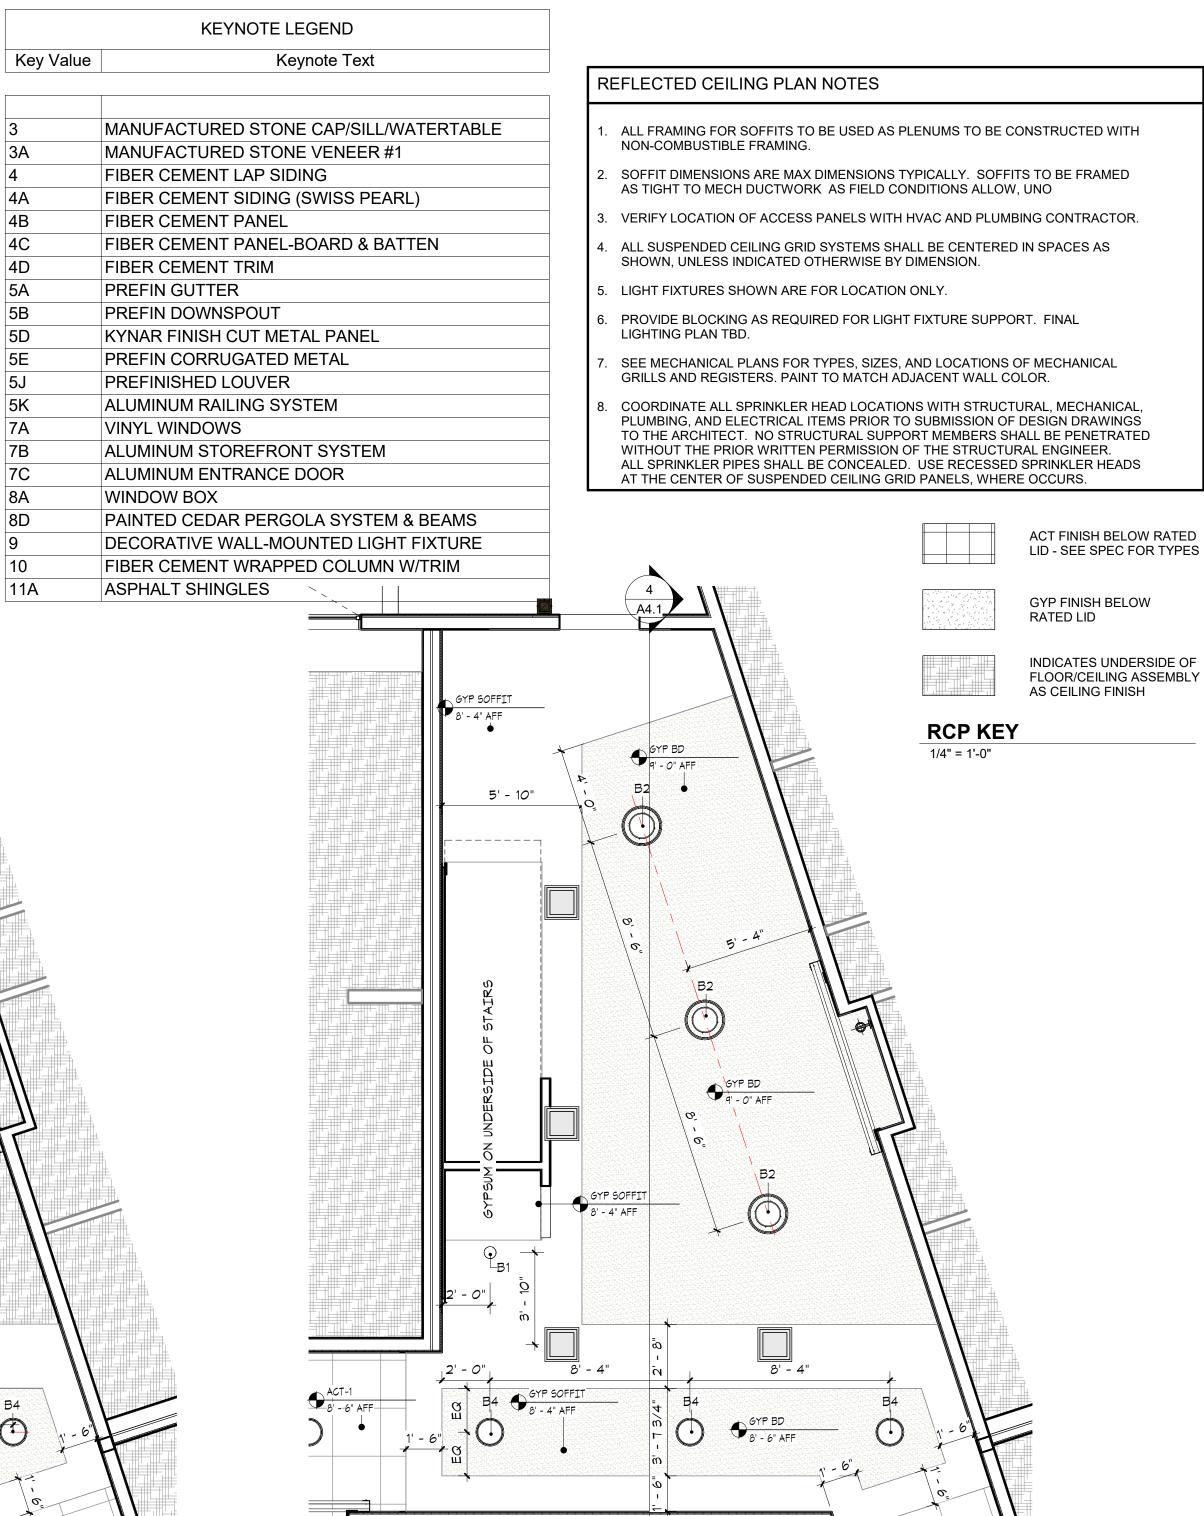



ACT-1 8' - 6" AFF

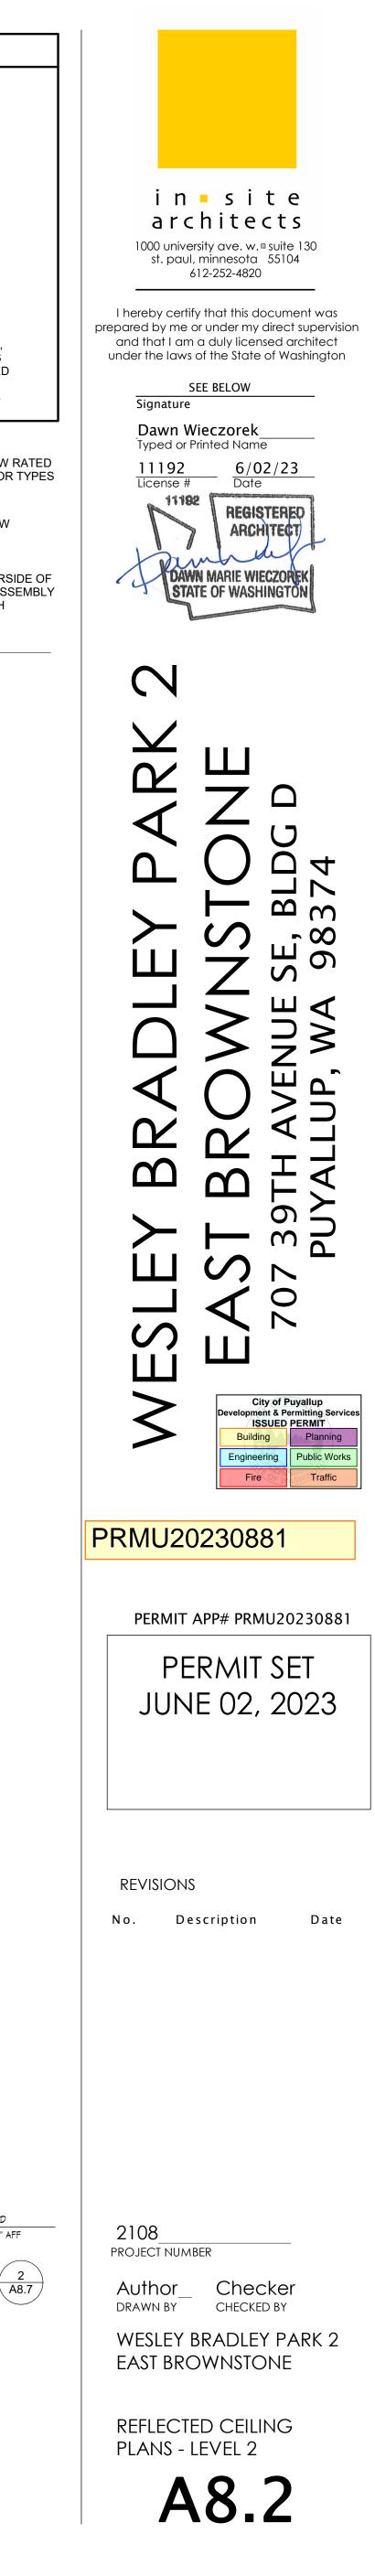

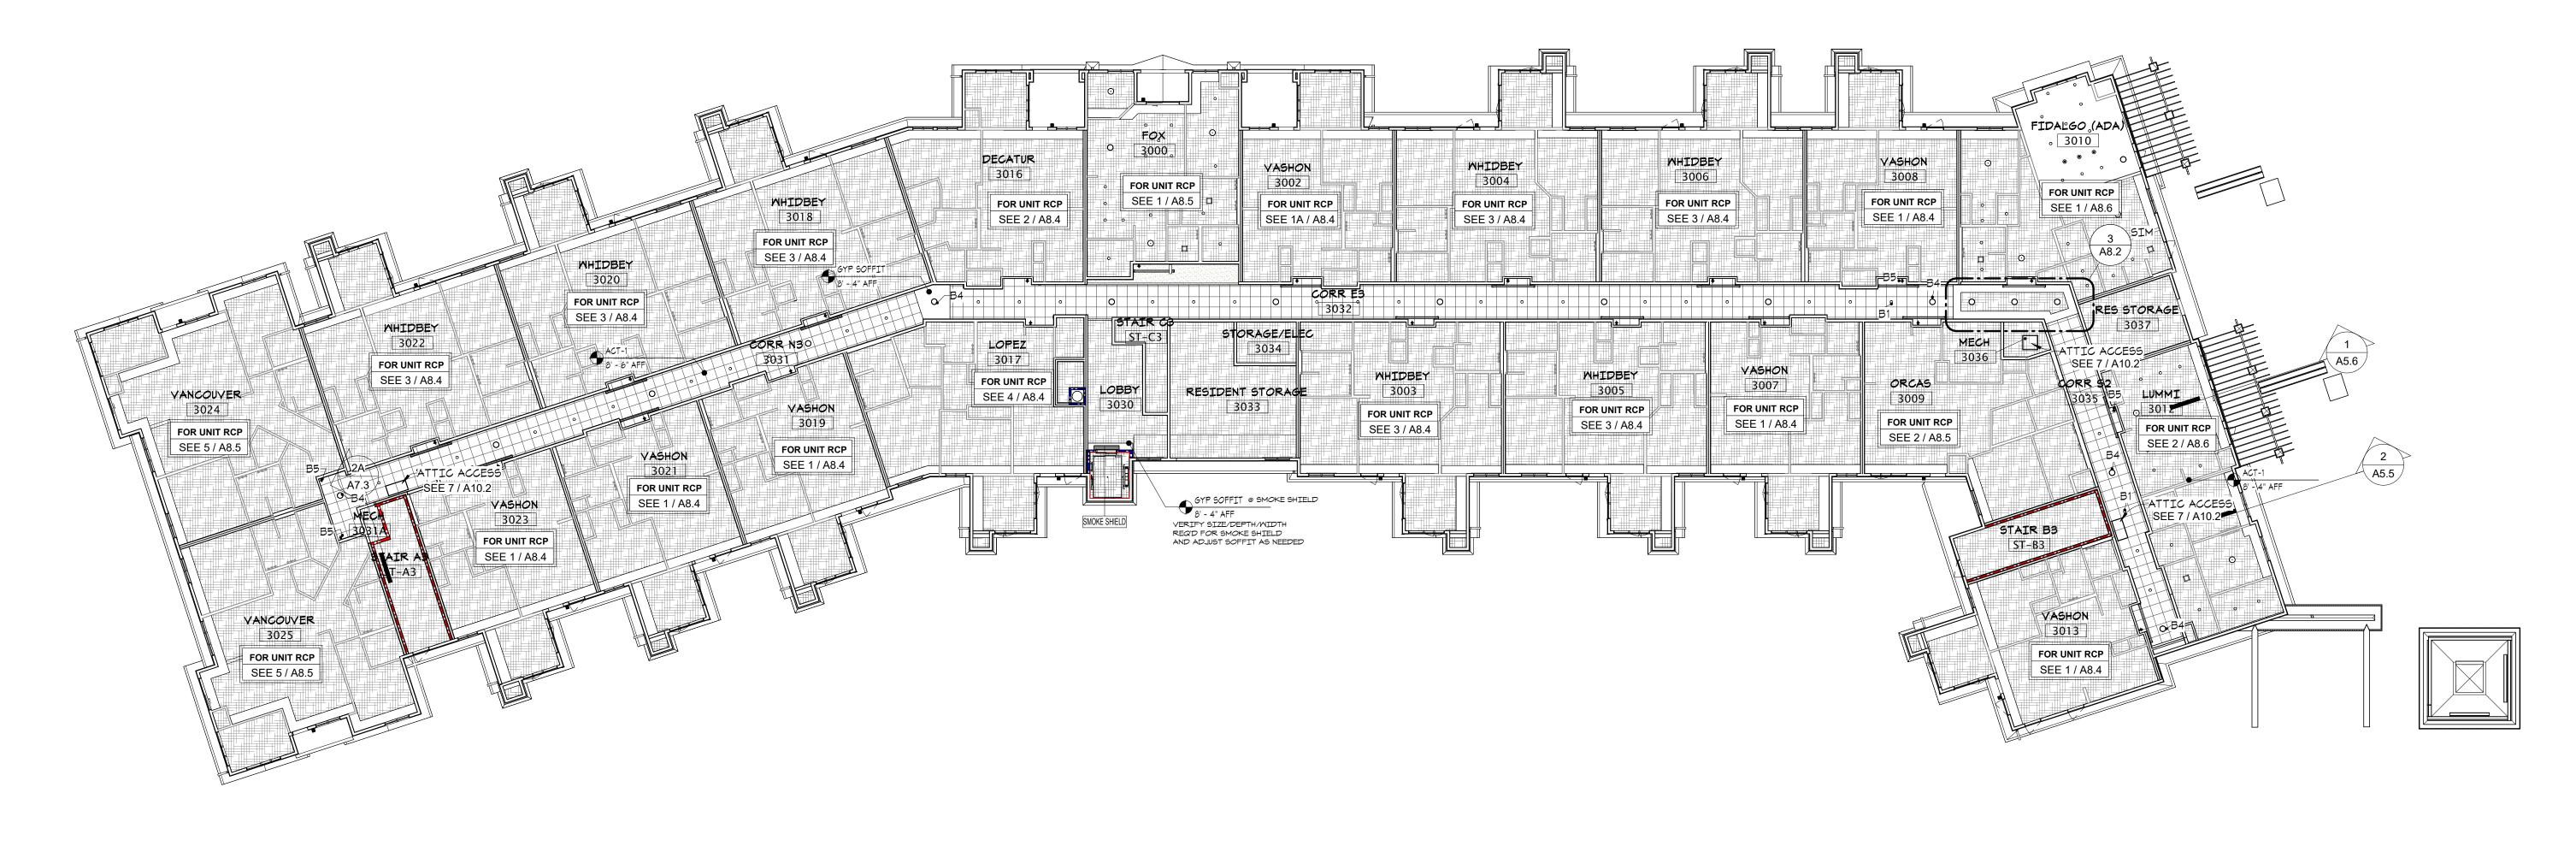


	KEYNOTE LEGEND
Key Value	Keynote Text
3	MANUFACTURED STONE CAP/SILL/WATERTABLE
3A	MANUFACTURED STONE VENEER #1
4	FIBER CEMENT LAP SIDING
4A	FIBER CEMENT SIDING (SWISS PEARL)
4B	FIBER CEMENT PANEL
4C	FIBER CEMENT PANEL-BOARD & BATTEN
4D	FIBER CEMENT TRIM
5A	PREFIN GUTTER
5B	PREFIN DOWNSPOUT
5D	KYNAR FINISH CUT METAL PANEL
5E	PREFIN CORRUGATED METAL
5J	PREFINISHED LOUVER
5K	ALUMINUM RAILING SYSTEM
7A	VINYL WINDOWS
7B	ALUMINUM STOREFRONT SYSTEM
7C	ALUMINUM ENTRANCE DOOR
8A	WINDOW BOX
8D	PAINTED CEDAR PERGOLA SYSTEM & BEAMS
9	DECORATIVE WALL-MOUNTED LIGHT FIXTURE
10	FIBER CEMENT WRAPPED COLUMN W/TRIM
11A	ASPHALT SHINGLES


REFLECTED CEILING PLAN NOTES

- ALL FRAMING FOR SOFFITS TO BE USED AS PLENUMS TO BE CONSTRUCTED WITH NON-COMBUSTIBLE FRAMING.
- SOFFIT DIMENSIONS ARE MAX DIMENSIONS TYPICALLY. SOFFITS TO BE FRAMED AS TIGHT TO MECH DUCTWORK AS FIELD CONDITIONS ALLOW, UNO
- 8. VERIFY LOCATION OF ACCESS PANELS WITH HVAC AND PLUMBING CONTRACTOR.
- ALL SUSPENDED CEILING GRID SYSTEMS SHALL BE CENTERED IN SPACES AS SHOWN, UNLESS INDICATED OTHERWISE BY DIMENSION.
- 5. LIGHT FIXTURES SHOWN ARE FOR LOCATION ONLY.
- PROVIDE BLOCKING AS REQUIRED FOR LIGHT FIXTURE SUPPORT. FINAL LIGHTING PLAN TBD.
- SEE MECHANICAL PLANS FOR TYPES, SIZES, AND LOCATIONS OF MECHANICAL GRILLS AND REGISTERS. PAINT TO MATCH ADJACENT WALL COLOR.
- COORDINATE ALL SPRINKLER HEAD LOCATIONS WITH STRUCTURAL, MECHANICAL, PLUMBING, AND ELECTRICAL ITEMS PRIOR TO SUBMISSION OF DESIGN DRAWINGS TO THE ARCHITECT. NO STRUCTURAL SUPPORT MEMBERS SHALL BE PENETRATED WITHOUT THE PRIOR WRITTEN PERMISSION OF THE STRUCTURAL ENGINEER. ALL SPRINKLER PIPES SHALL BE CONCEALED. USE RECESSED SPRINKLER HEADS AT THE CENTER OF SUSPENDED CEILING GRID PANELS, WHERE OCCURS.


ACT FINISH BELOW LID - SEE SPEC FO
GYP FINISH BELOW RATED LID

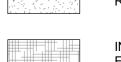

RCP KEY 1/4" = 1'-0"

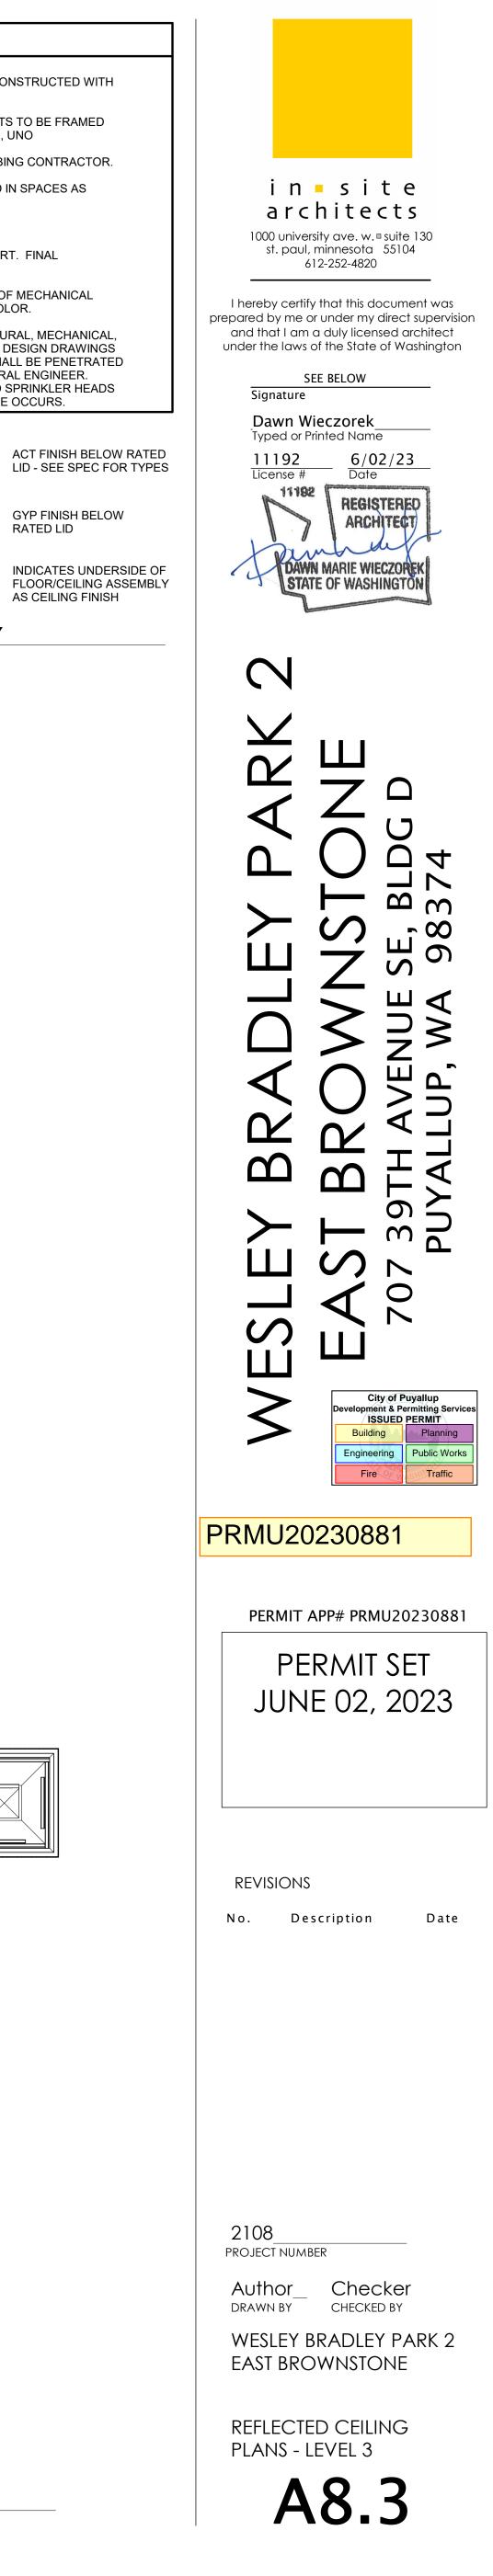



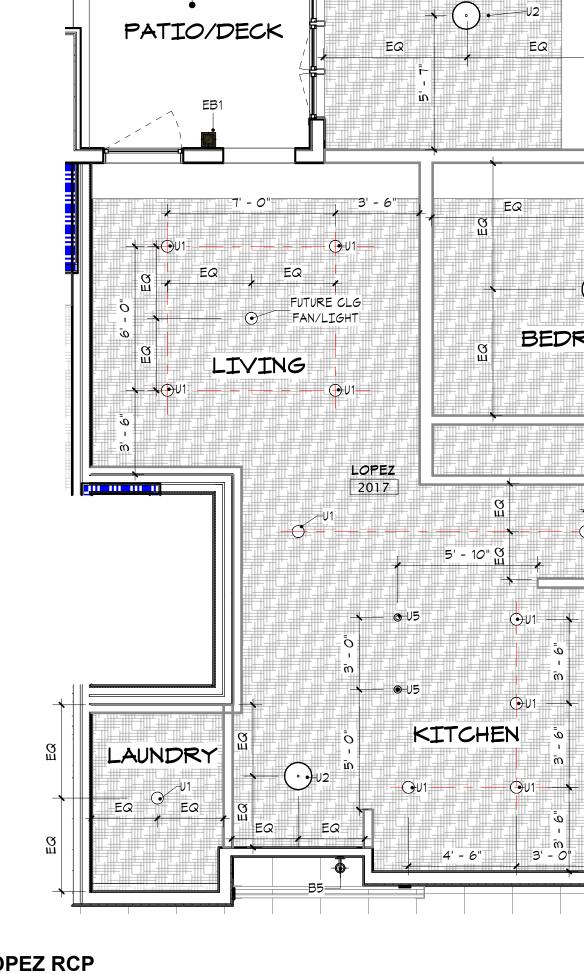



4 LOPEZ RCP A8.4 1/4" = 1'-0"

EXT SOFFIT B.O. DECK FRAMING OR ROOF TRUSSES

SUNROOM




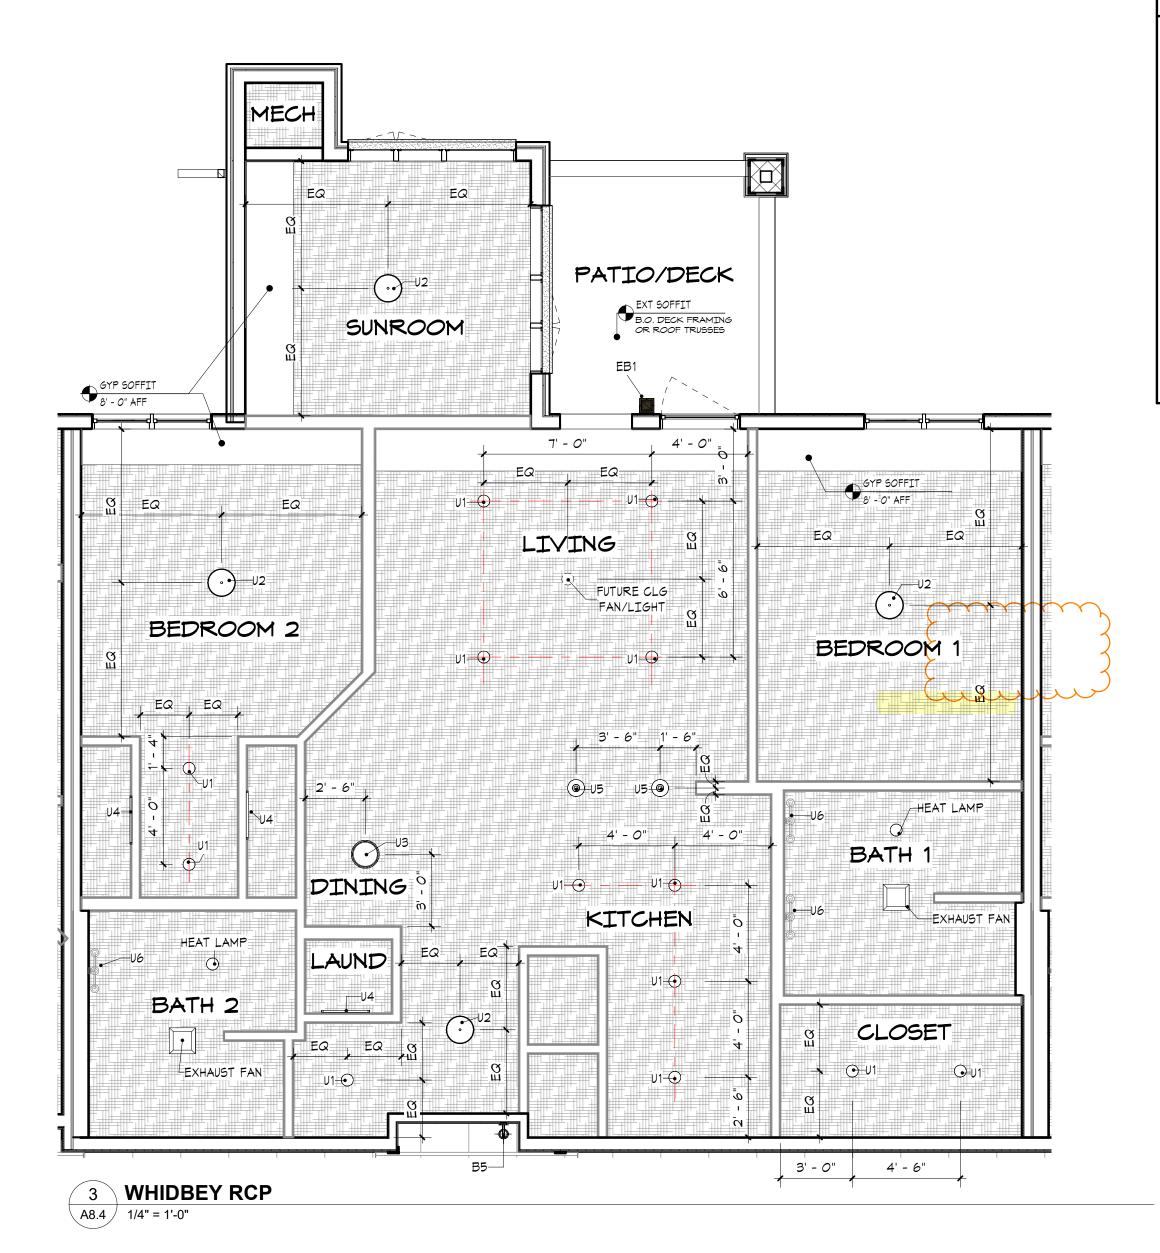

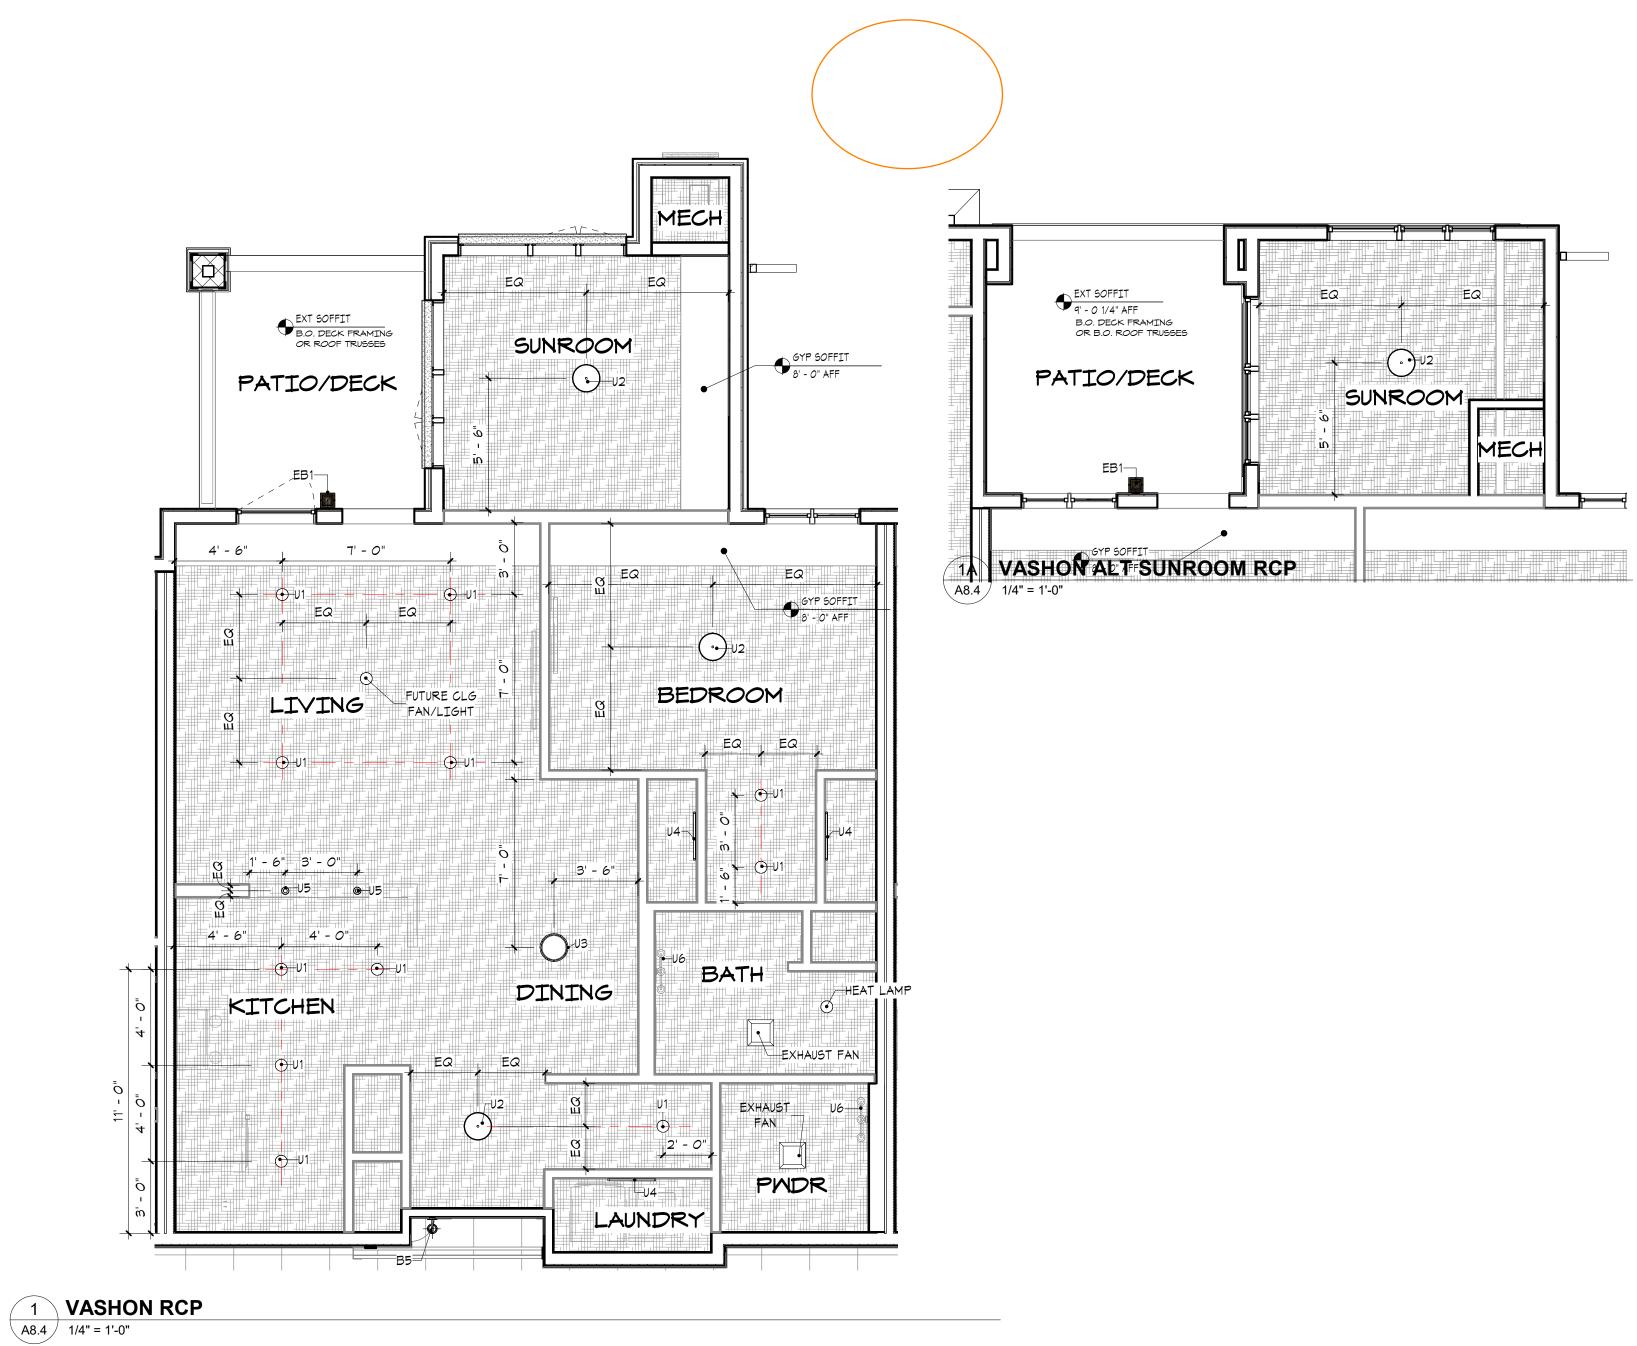

REFLECTED CEILING PLAN NOTES

- ALL FRAMING FOR SOFFITS TO BE USED AS PLENUMS TO BE CONSTRUCTED WITH NON-COMBUSTIBLE FRAMING.
- SOFFIT DIMENSIONS ARE MAX DIMENSIONS TYPICALLY. SOFFITS TO BE FRAMED AS TIGHT TO MECH DUCTWORK AS FIELD CONDITIONS ALLOW, UNO
- VERIFY LOCATION OF ACCESS PANELS WITH HVAC AND PLUMBING CONTRACTOR.
- ALL SUSPENDED CEILING GRID SYSTEMS SHALL BE CENTERED IN SPACES AS SHOWN, UNLESS INDICATED OTHERWISE BY DIMENSION.
- LIGHT FIXTURES SHOWN ARE FOR LOCATION ONLY.
- PROVIDE BLOCKING AS REQUIRED FOR LIGHT FIXTURE SUPPORT. FINAL LIGHTING PLAN TBD.
- SEE MECHANICAL PLANS FOR TYPES, SIZES, AND LOCATIONS OF MECHANICAL GRILLS AND REGISTERS. PAINT TO MATCH ADJACENT WALL COLOR.
- COORDINATE ALL SPRINKLER HEAD LOCATIONS WITH STRUCTURAL, MECHANICAL, PLUMBING, AND ELECTRICAL ITEMS PRIOR TO SUBMISSION OF DESIGN DRAWINGS TO THE ARCHITECT. NO STRUCTURAL SUPPORT MEMBERS SHALL BE PENETRATED WITHOUT THE PRIOR WRITTEN PERMISSION OF THE STRUCTURAL ENGINEER. ALL SPRINKLER PIPES SHALL BE CONCEALED. USE RECESSED SPRINKLER HEADS

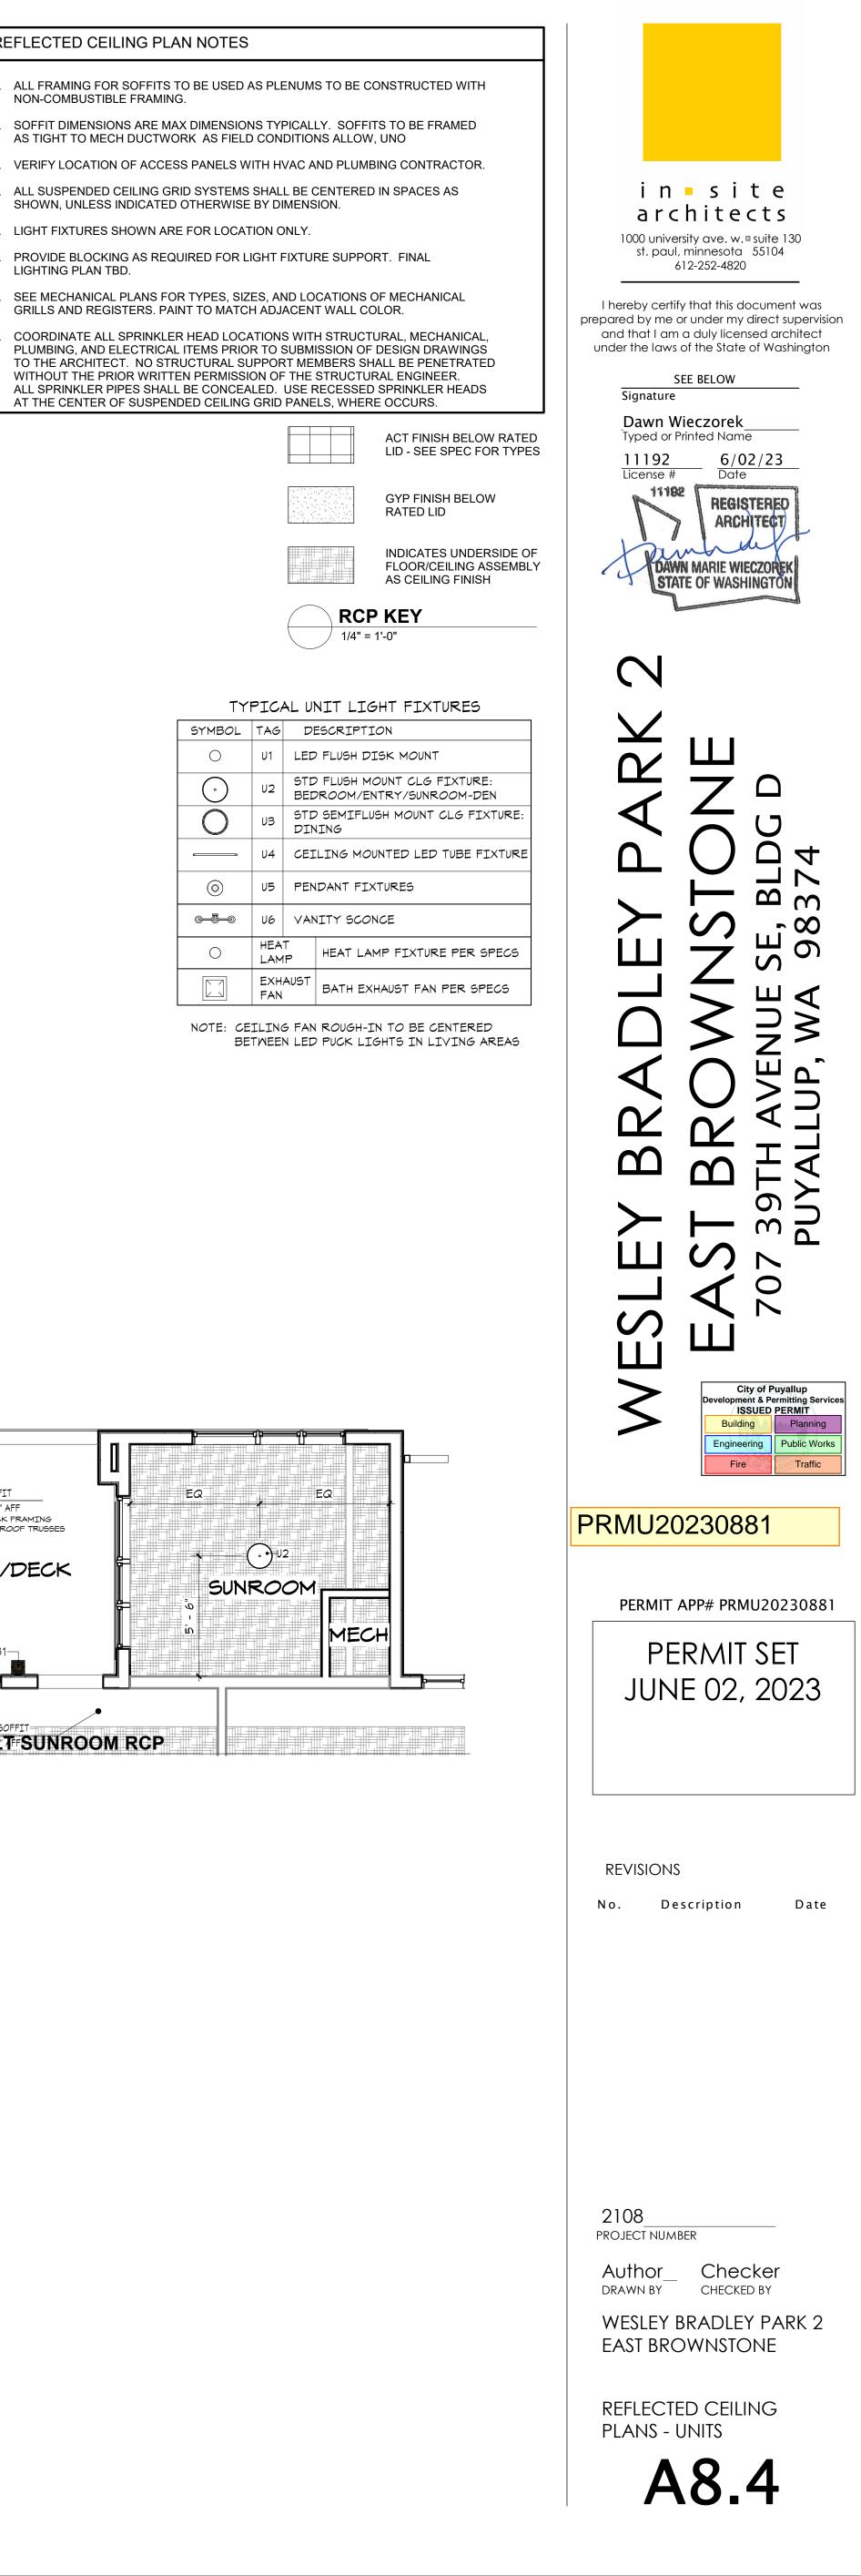



TYPICAL UNIT LIGHT FIXTURES


SYMBOL	TAG	D	ESCRIPTION
0	U1	LED	P FLUSH DISK MOUNT
$\overline{\mathbf{\cdot}}$	U2) FLUSH MOUNT CLG FIXTURE DROOM/ENTRY/SUNROOM-DE
0	UЗ) SEMIFLUSH MOUNT CLG FIX NING
	U4	CEI	LING MOUNTED LED TUBE FI
\bigcirc	U5	PEN	DANT FIXTURES
6-3- 0	U6	VAN	ITY SCONCE
0	HEA LAM		HEAT LAMP FIXTURE PER S
	EXH. FAN	AUST	BATH EXHAUST FAN PER SP

NOTE: CEILING FAN ROUGH-IN TO BE CENTERED BETWEEN LED PUCK LIGHTS IN LIVING AREAS

3 **CAMANO RCP** A8.5 1/4" = 1'-0"

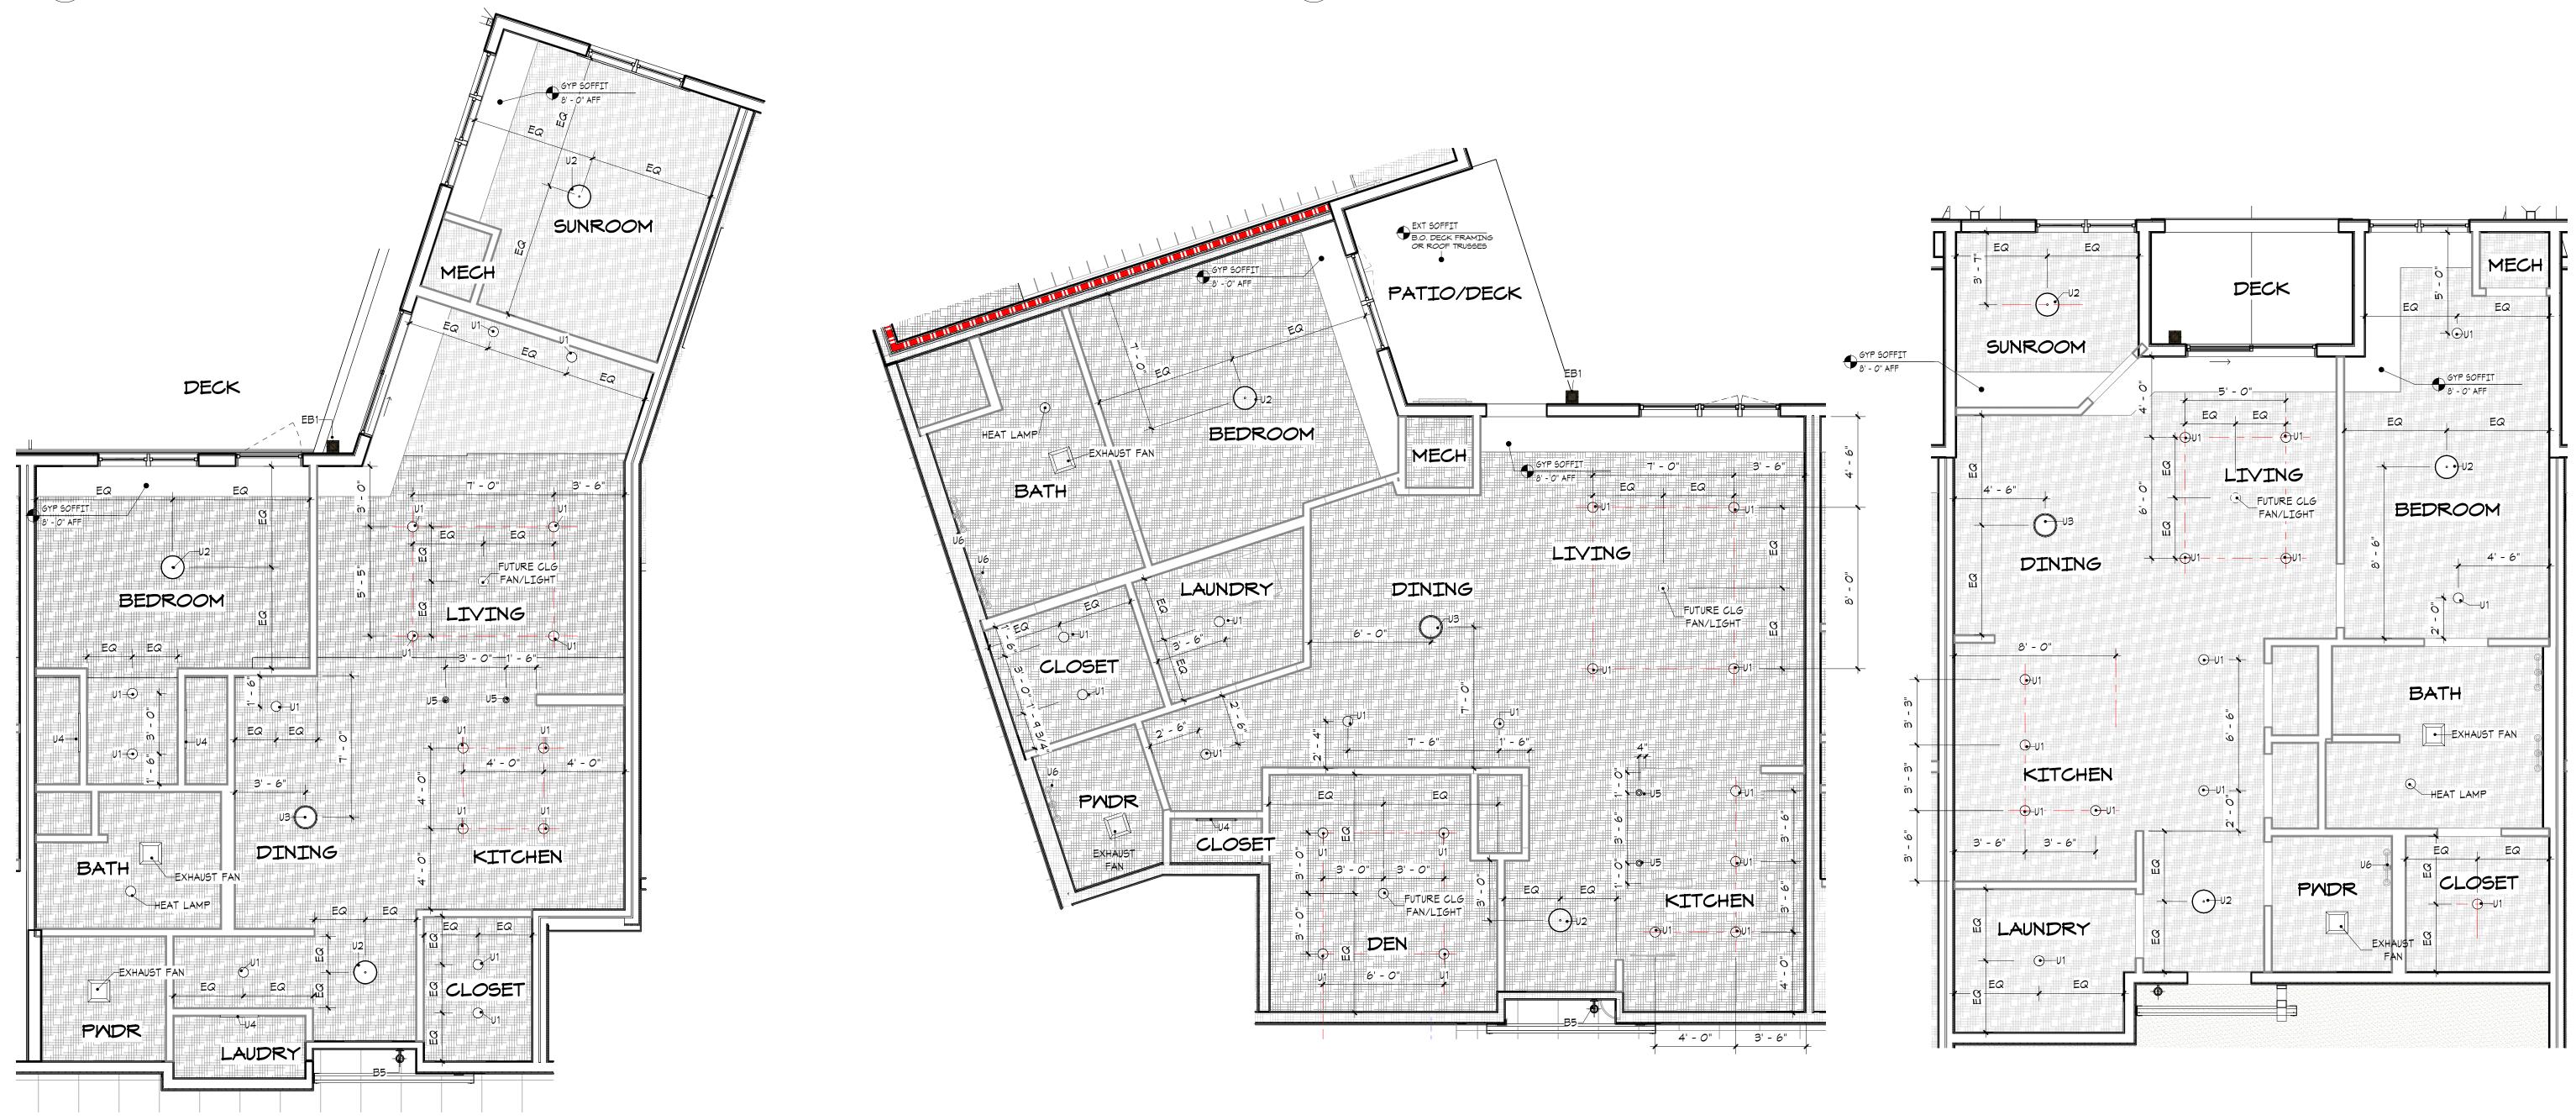


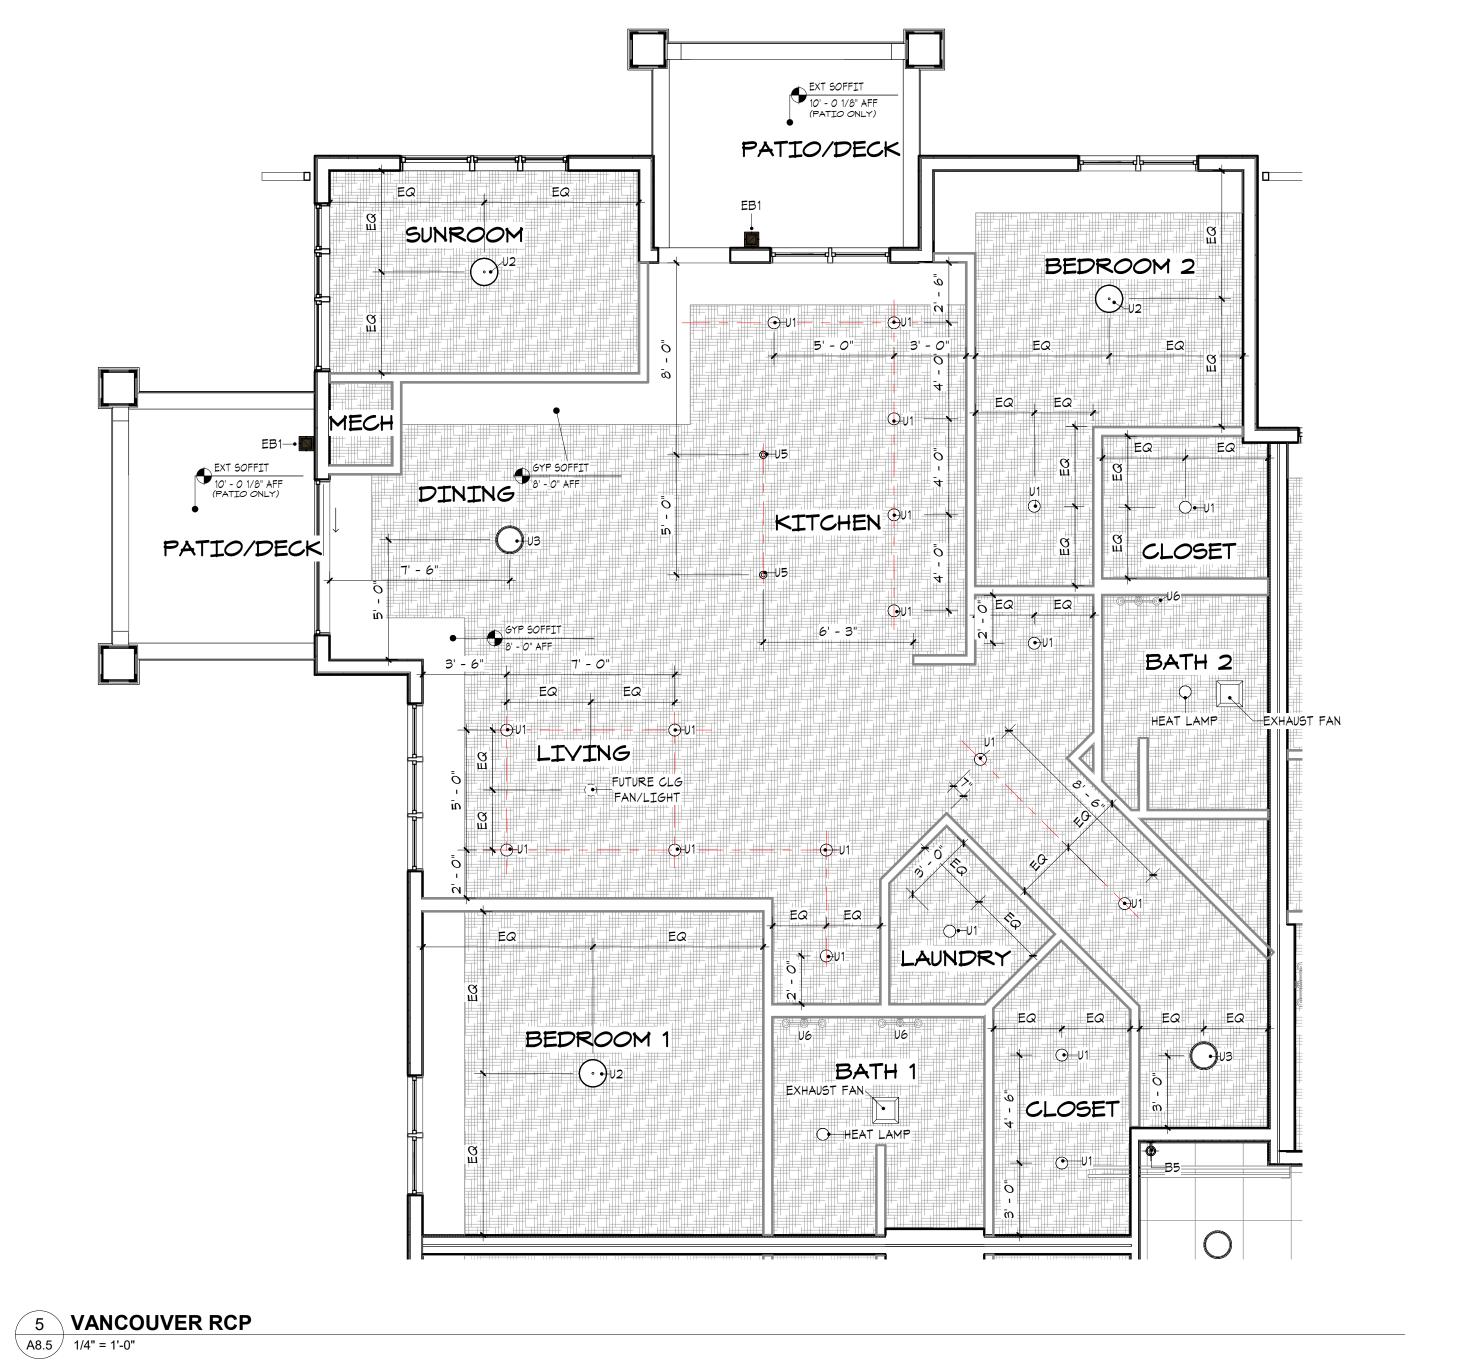

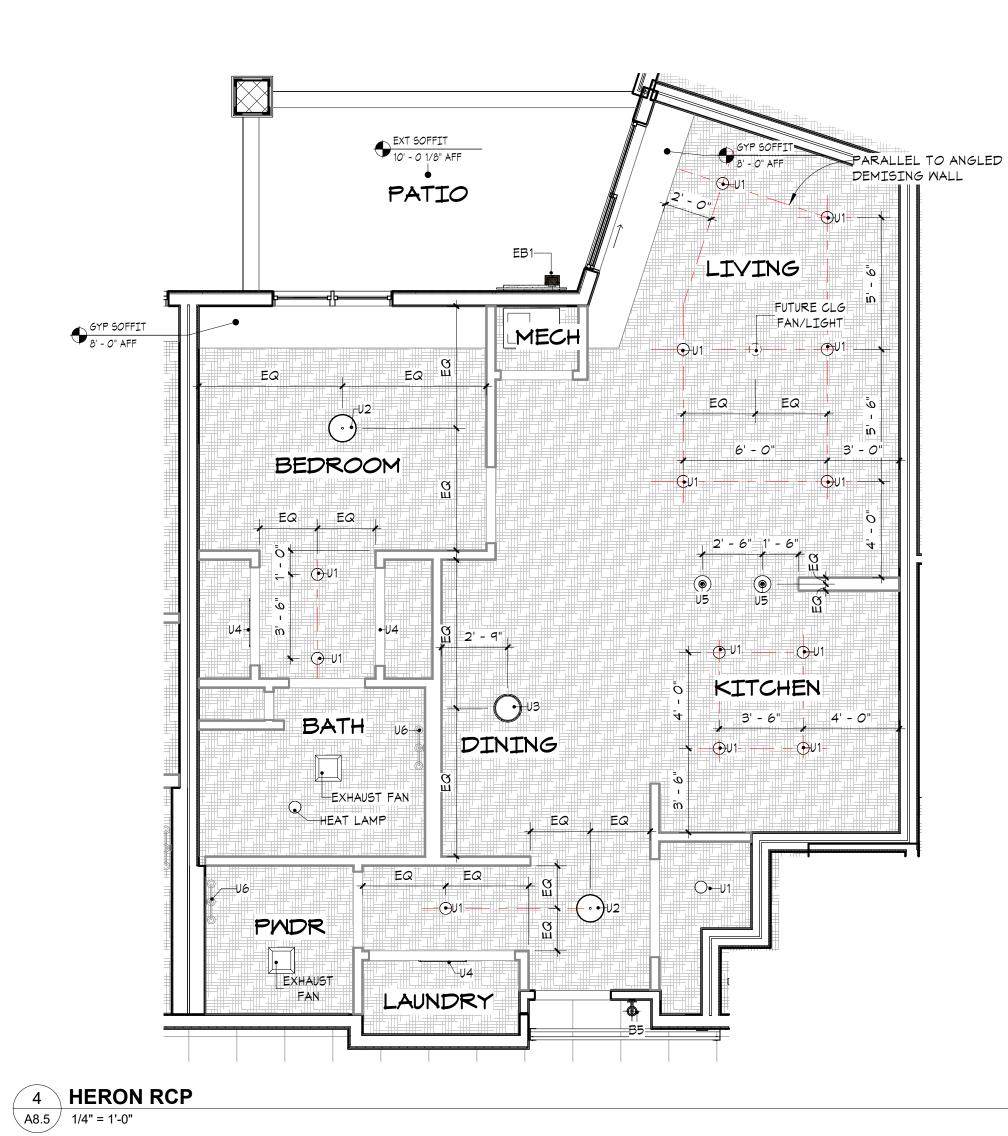

2 ORCAS RCP A8.5 1/4" = 1'-0"

1 FOX RCP A8.5 1/4" = 1'-0"

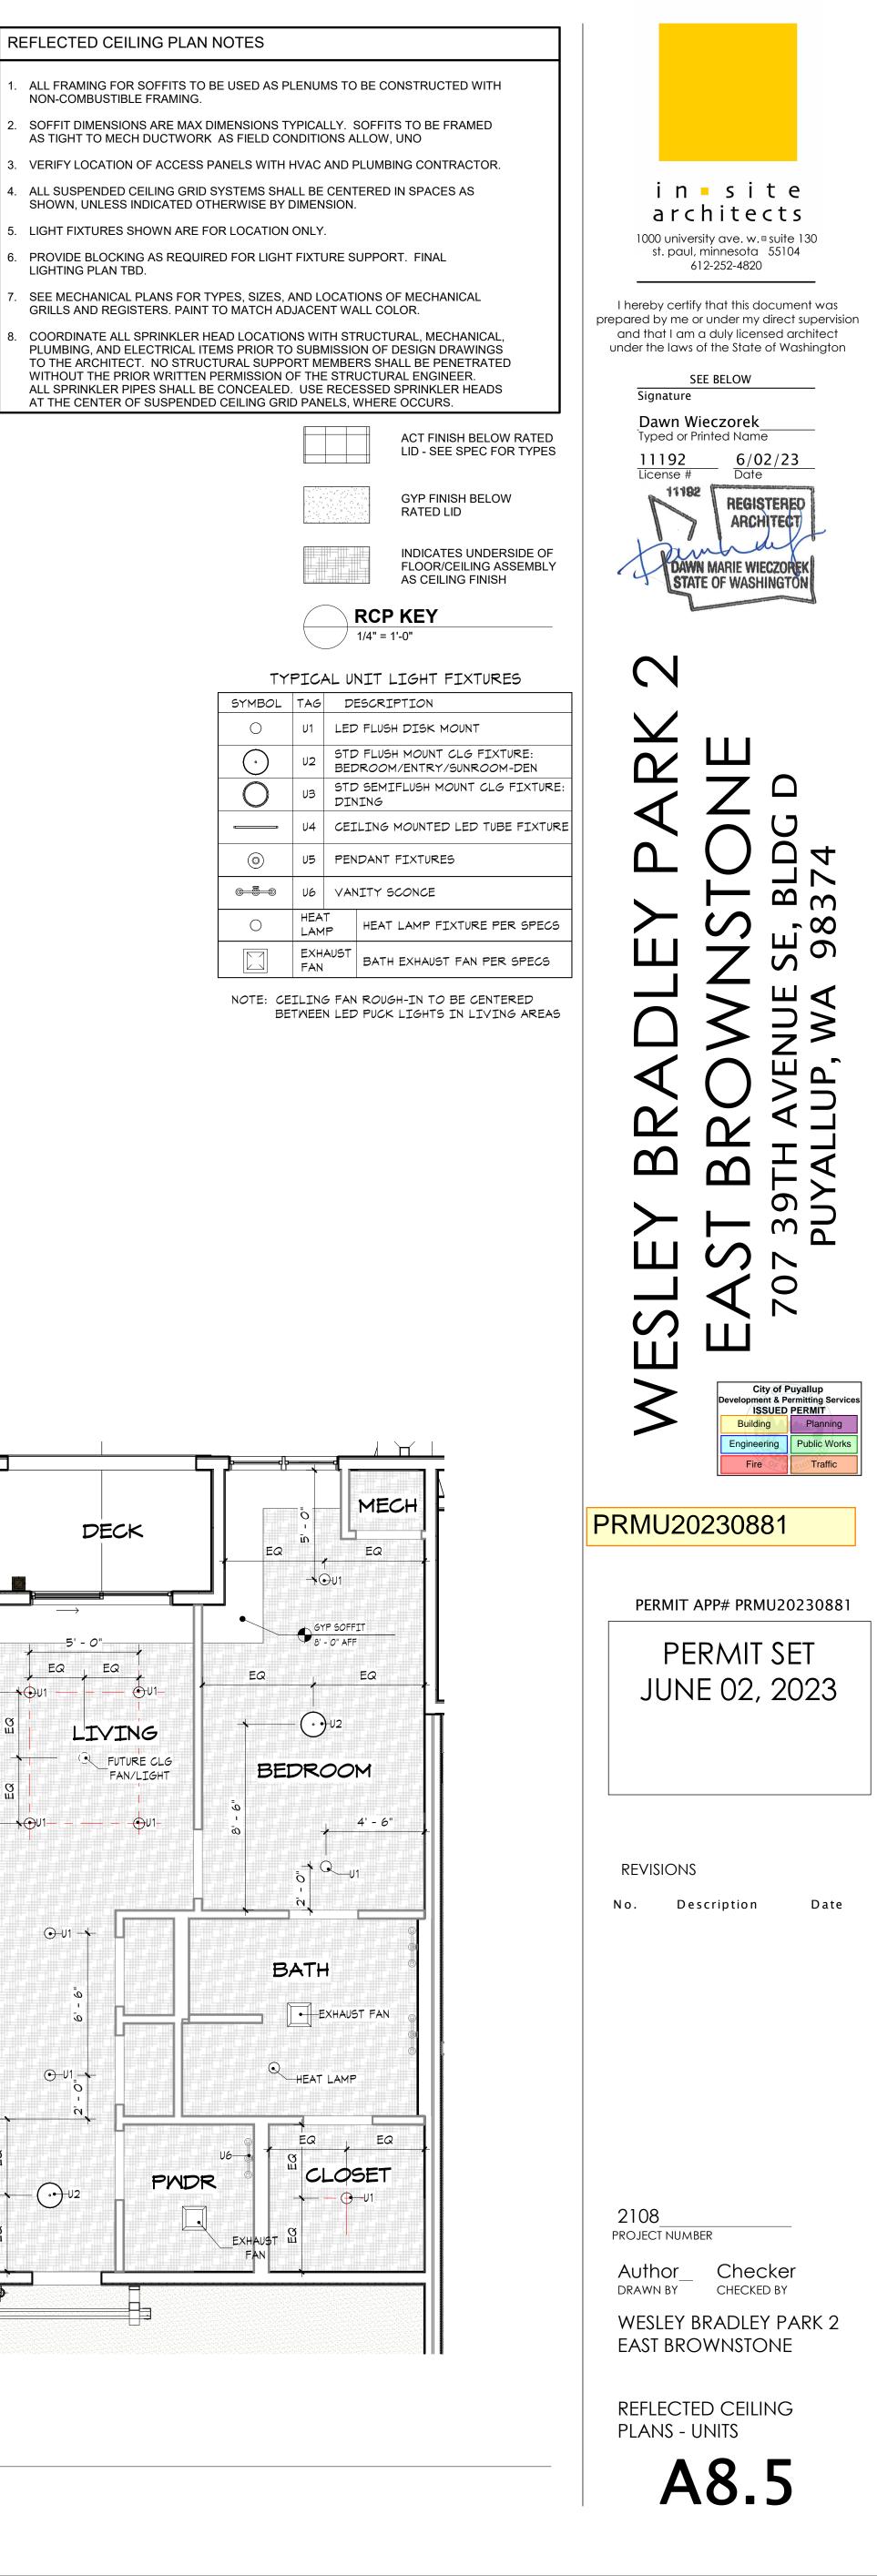

GRILLS AND REGISTERS. PAINT TO MATCH ADJACENT WALL COLOR. COORDINATE ALL SPRINKLER HEAD LOCATIONS WITH STRUCTURAL, MECHANICAL, PLUMBING, AND ELECTRICAL ITEMS PRIOR TO SUBMISSION OF DESIGN DRAWINGS TO THE ARCHITECT. NO STRUCTURAL SUPPORT MEMBERS SHALL BE PENETRATED WITHOUT THE PRIOR WRITTEN PERMISSION OF THE STRUCTURAL ENGINEER. ALL SPRINKLER PIPES SHALL BE CONCEALED. USE RECESSED SPRINKLER HEADS AT THE CENTER OF SUSPENDED CEILING GRID PANELS, WHERE OCCURS.


ALL FRAMING FOR SOFFITS TO BE USED AS PLENUMS TO BE CONSTRUCTED WITH NON-COMBUSTIBLE FRAMING.

- SOFFIT DIMENSIONS ARE MAX DIMENSIONS TYPICALLY. SOFFITS TO BE FRAMED AS TIGHT TO MECH DUCTWORK AS FIELD CONDITIONS ALLOW, UNO
- VERIFY LOCATION OF ACCESS PANELS WITH HVAC AND PLUMBING CONTRACTOR.
- ALL SUSPENDED CEILING GRID SYSTEMS SHALL BE CENTERED IN SPACES AS SHOWN, UNLESS INDICATED OTHERWISE BY DIMENSION.
- LIGHT FIXTURES SHOWN ARE FOR LOCATION ONLY.
- PROVIDE BLOCKING AS REQUIRED FOR LIGHT FIXTURE SUPPORT. FINAL LIGHTING PLAN TBD.

- SEE MECHANICAL PLANS FOR TYPES, SIZES, AND LOCATIONS OF MECHANICAL

2 LUMMI RCP A8.6 1/4" = 1'-0"

1 A4.1

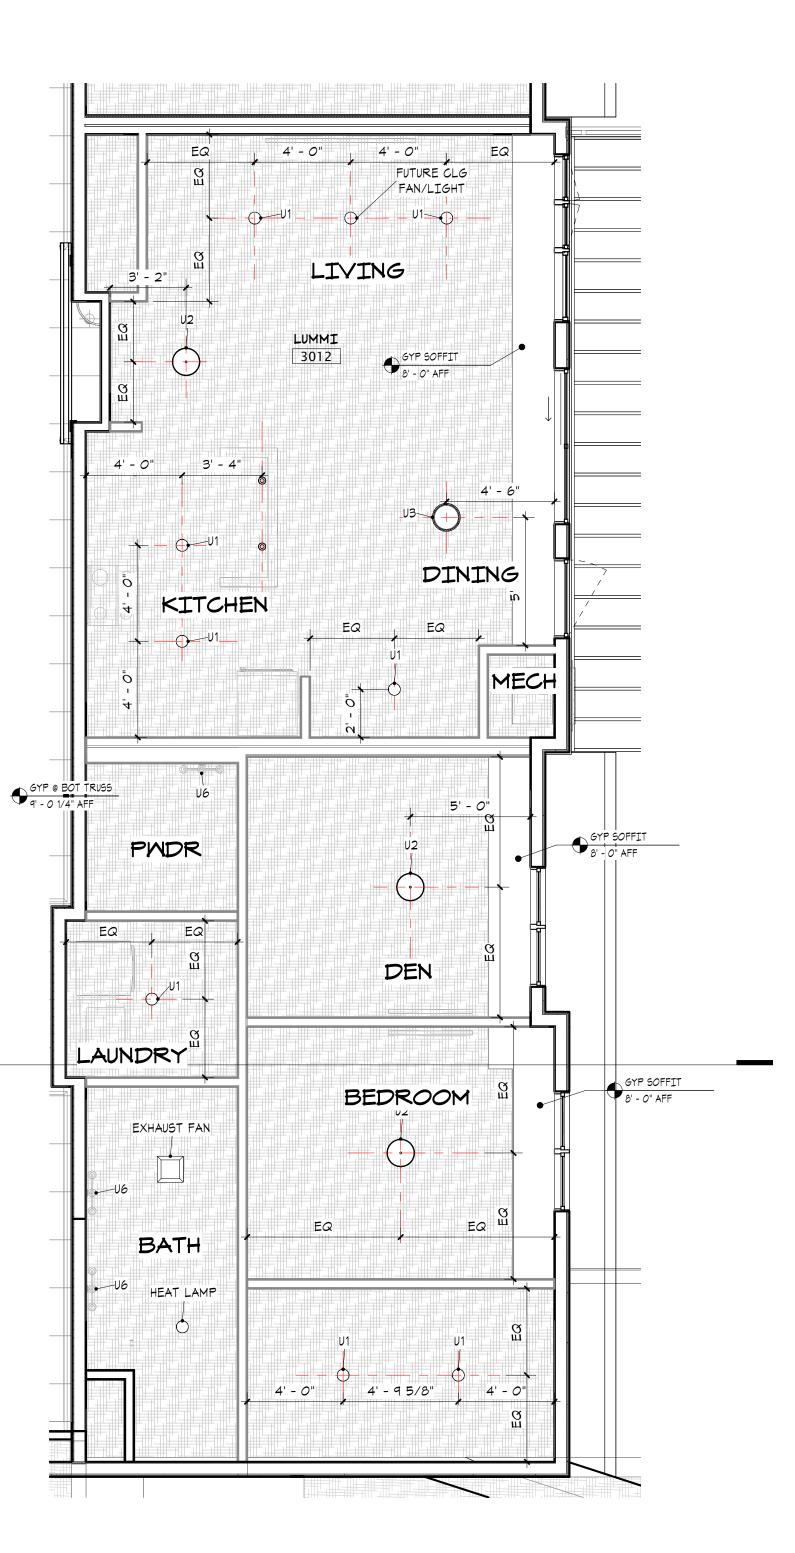





1 **FIDALGO RCP** A8.6 1/4" = 1'-0"


REFLECTED CEILING PLAN NOTES

- ALL FRAMING FOR SOFFITS TO BE USED AS PLENUMS TO BE CONSTRUCTED WITH NON-COMBUSTIBLE FRAMING.
- SOFFIT DIMENSIONS ARE MAX DIMENSIONS TYPICALLY. SOFFITS TO BE FRAMED AS TIGHT TO MECH DUCTWORK AS FIELD CONDITIONS ALLOW, UNO
- VERIFY LOCATION OF ACCESS PANELS WITH HVAC AND PLUMBING CONTRACTOR.
- ALL SUSPENDED CEILING GRID SYSTEMS SHALL BE CENTERED IN SPACES AS SHOWN, UNLESS INDICATED OTHERWISE BY DIMENSION.
- 5. LIGHT FIXTURES SHOWN ARE FOR LOCATION ONLY.
- PROVIDE BLOCKING AS REQUIRED FOR LIGHT FIXTURE SUPPORT. FINAL LIGHTING PLAN TBD.
- SEE MECHANICAL PLANS FOR TYPES, SIZES, AND LOCATIONS OF MECHANICAL
- GRILLS AND REGISTERS. PAINT TO MATCH ADJACENT WALL COLOR. COORDINATE ALL SPRINKLER HEAD LOCATIONS WITH STRUCTURAL, MECHANICAL, PLUMBING, AND ELECTRICAL ITEMS PRIOR TO SUBMISSION OF DESIGN DRAWINGS TO THE ARCHITECT. NO STRUCTURAL SUPPORT MEMBERS SHALL BE PENETRATED WITHOUT THE PRIOR WRITTEN PERMISSION OF THE STRUCTURAL ENGINEER.

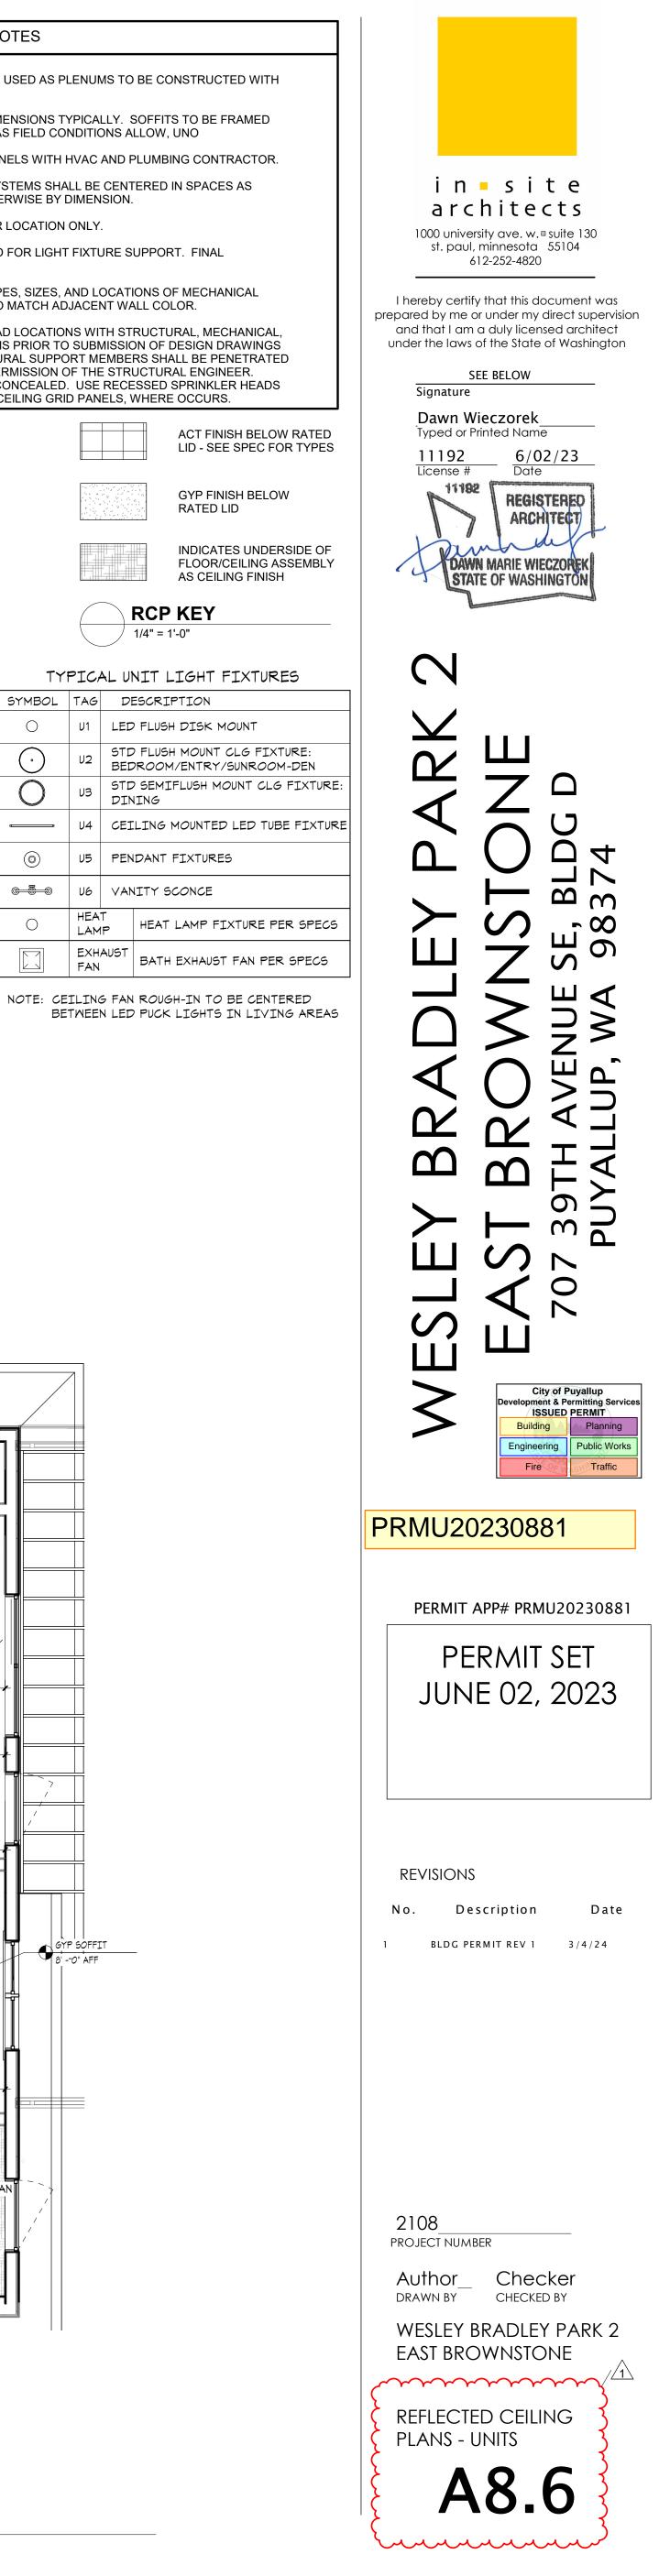


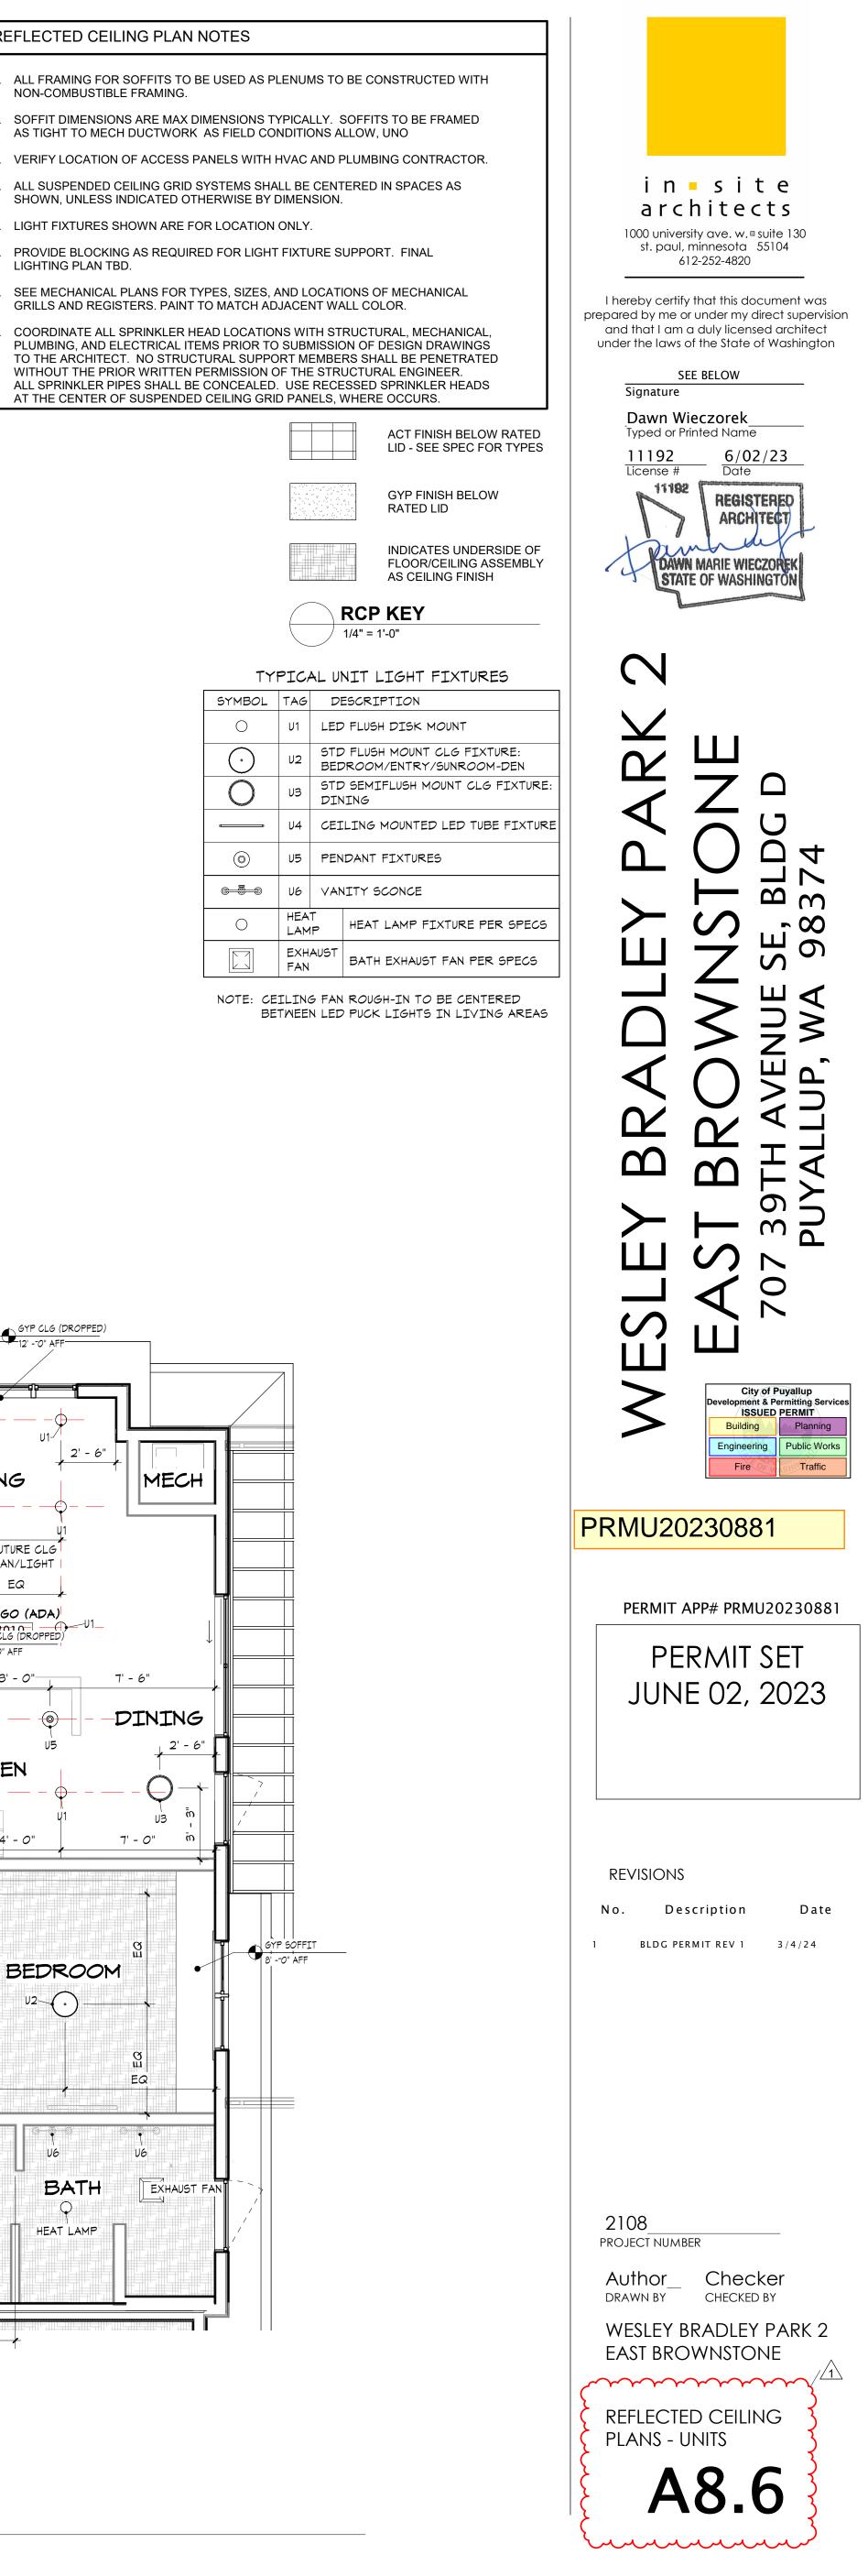

1 LEVEL 1 GAME ROOM RCP ENLARGED A8.7 1/4" = 1'-0"

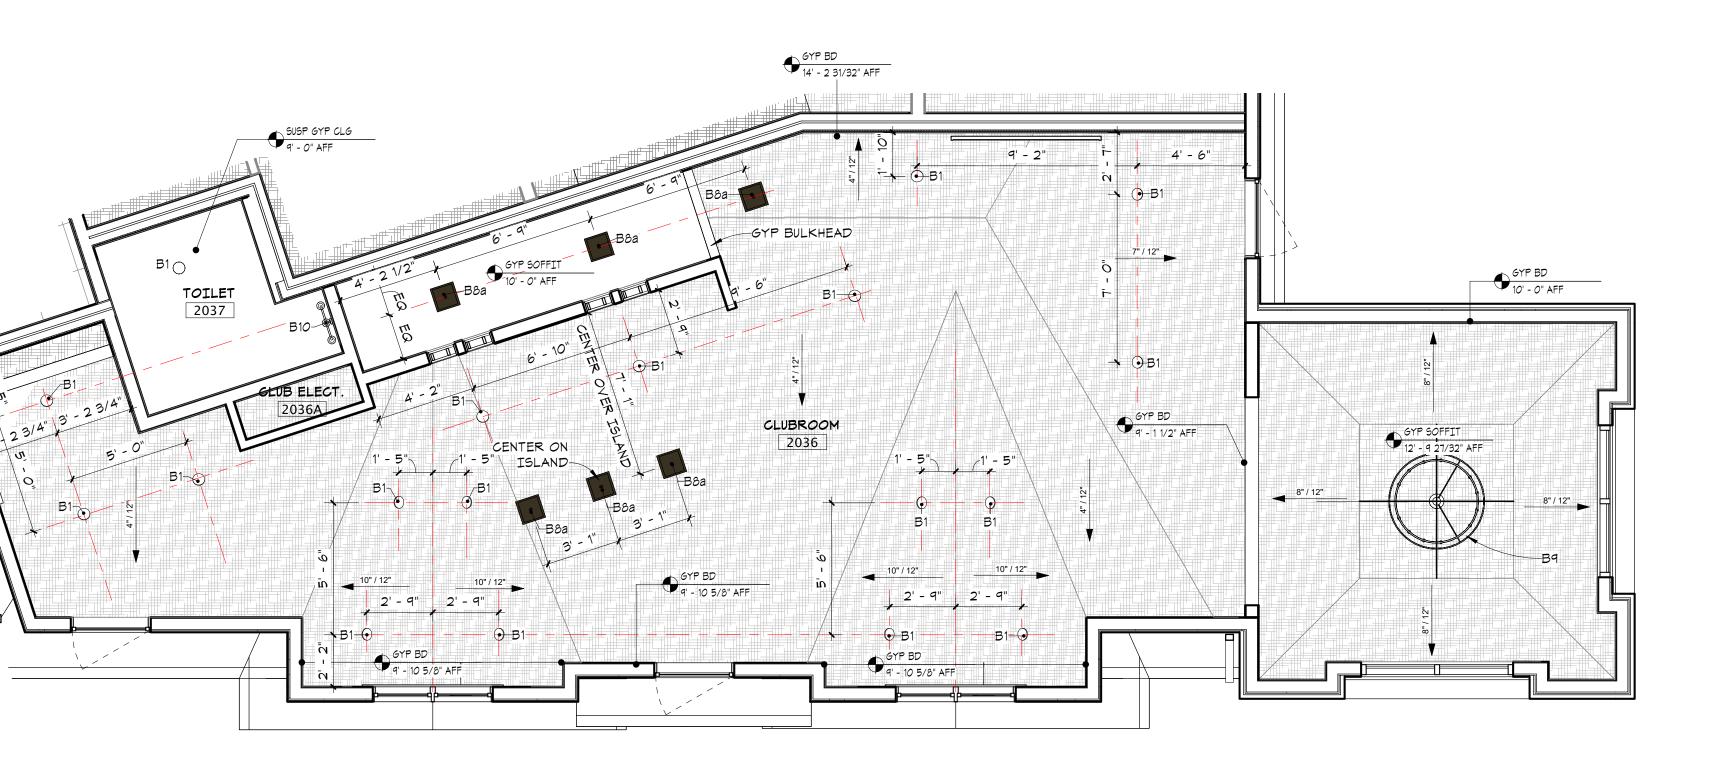



2 LEVEL 2 CLUB ROOM RCP ENLARGED A8.7 1/4" = 1'-0"

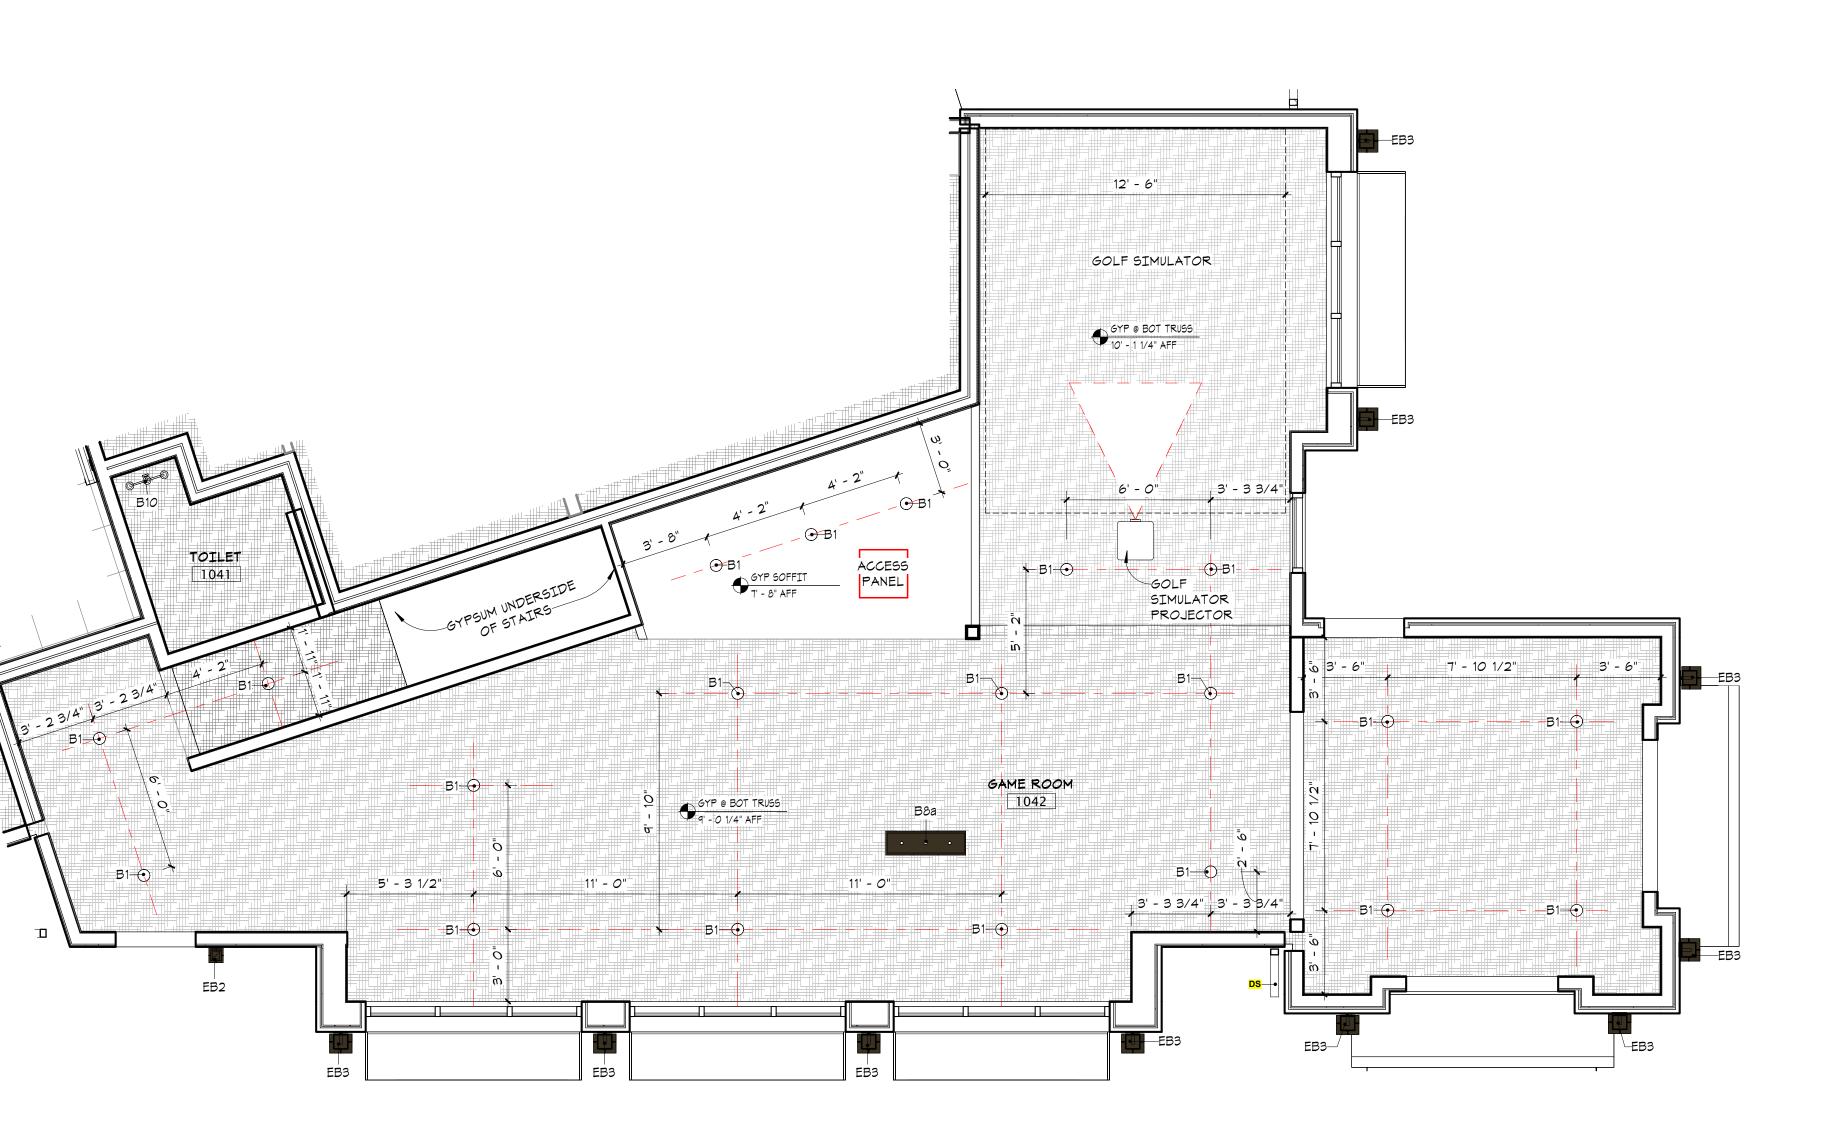

REFLECTED CEILING PLAN NOTES


- ALL FRAMING FOR SOFFITS TO BE USED AS PLENUMS TO BE CONSTRUCTED WITH NON-COMBUSTIBLE FRAMING.
- SOFFIT DIMENSIONS ARE MAX DIMENSIONS TYPICALLY. SOFFITS TO BE FRAMED AS TIGHT TO MECH DUCTWORK AS FIELD CONDITIONS ALLOW, UNO
- 8. VERIFY LOCATION OF ACCESS PANELS WITH HVAC AND PLUMBING CONTRACTOR.
- ALL SUSPENDED CEILING GRID SYSTEMS SHALL BE CENTERED IN SPACES AS SHOWN, UNLESS INDICATED OTHERWISE BY DIMENSION.
- LIGHT FIXTURES SHOWN ARE FOR LOCATION ONLY.
- PROVIDE BLOCKING AS REQUIRED FOR LIGHT FIXTURE SUPPORT. FINAL LIGHTING PLAN TBD.
- 7. SEE MECHANICAL PLANS FOR TYPES, SIZES, AND LOCATIONS OF MECHANICAL GRILLS AND REGISTERS. PAINT TO MATCH ADJACENT WALL COLOR.
- COORDINATE ALL SPRINKLER HEAD LOCATIONS WITH STRUCTURAL, MECHANICAL, PLUMBING, AND ELECTRICAL ITEMS PRIOR TO SUBMISSION OF DESIGN DRAWINGS TO THE ARCHITECT. NO STRUCTURAL SUPPORT MEMBERS SHALL BE PENETRATED WITHOUT THE PRIOR WRITTEN PERMISSION OF THE STRUCTURAL ENGINEER. ALL SPRINKLER PIPES SHALL BE CONCEALED. USE RECESSED SPRINKLER HEADS

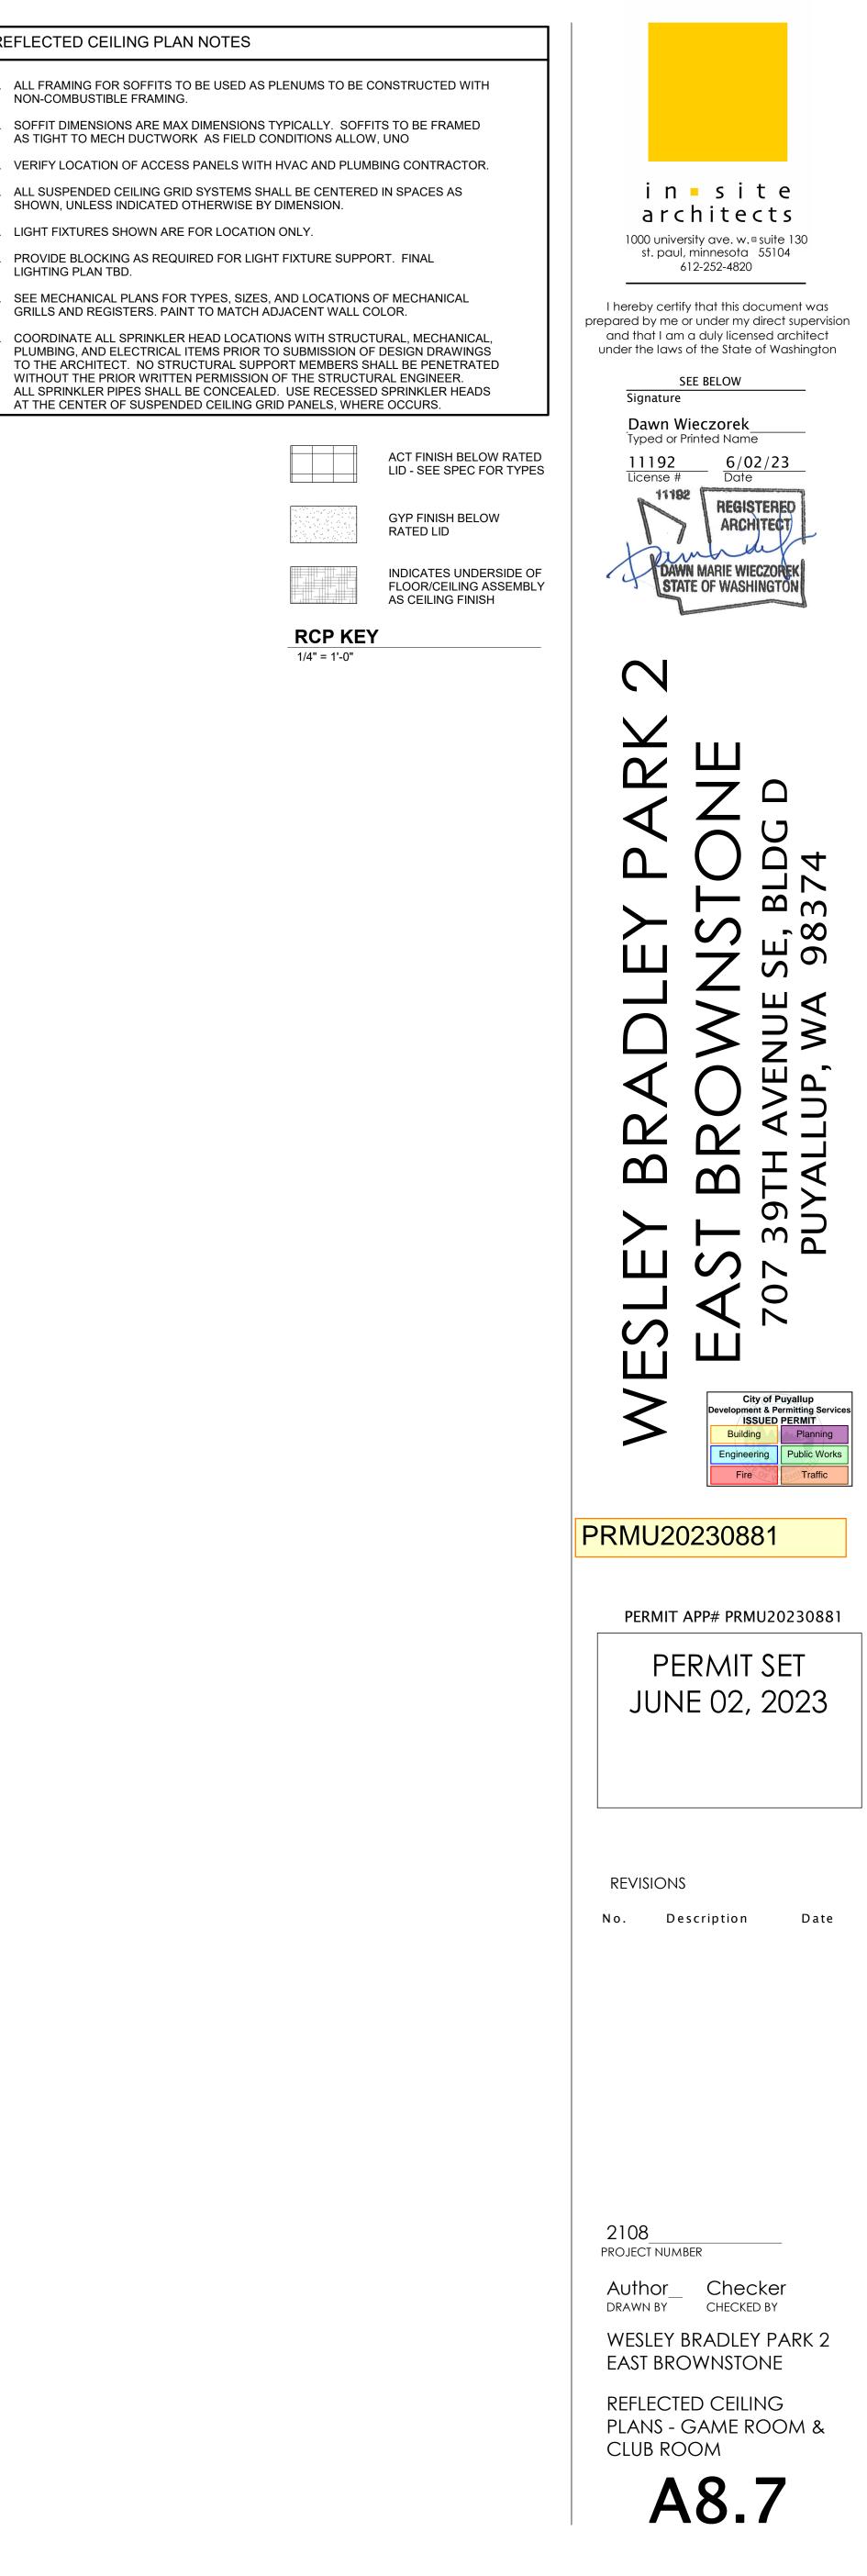

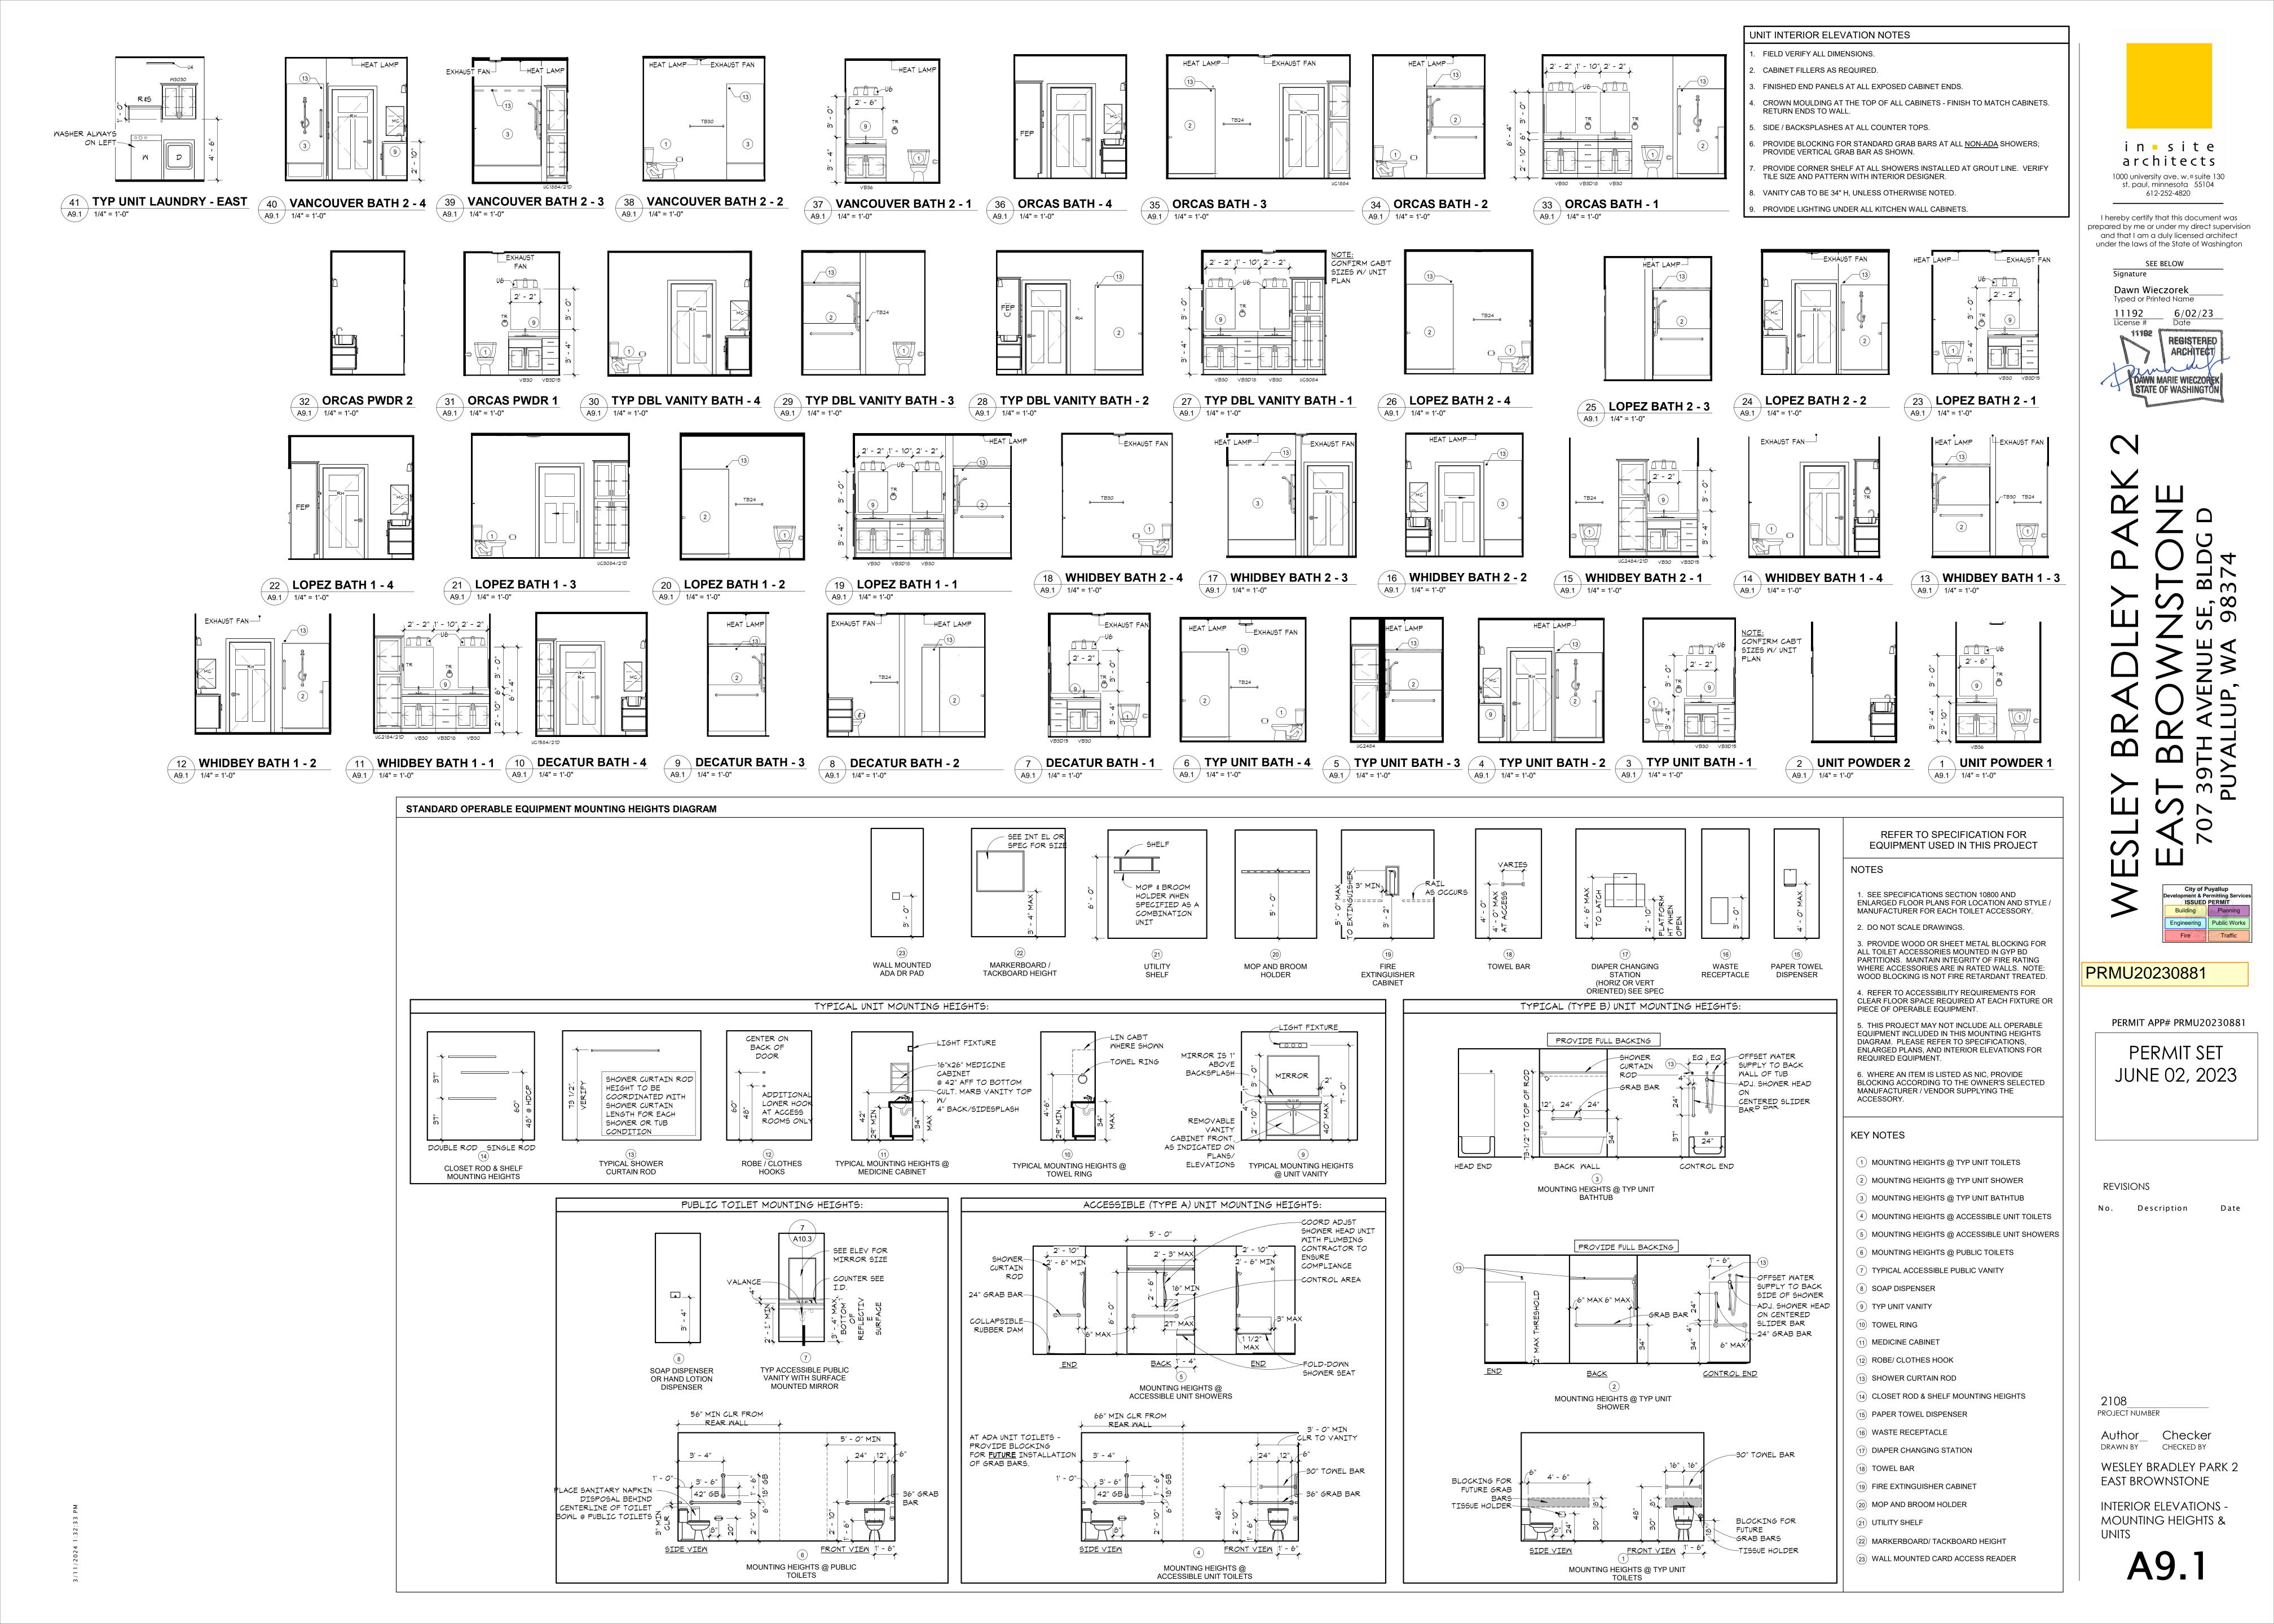




16 DECATUR ADA BATH - 3 A9.2 1/4" = 1'-0"

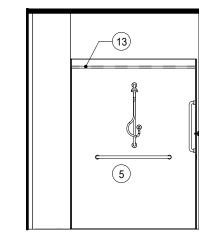

22 HERON (ADA) MASTER BATH - 1 A9.2 1/4" = 1'-0"

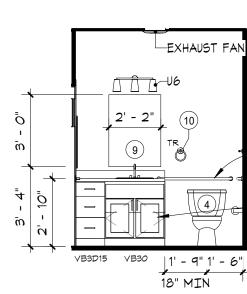


30 FIDALGO MASTER BATH - 3 A9.2 1/4" = 1'-0"

XHAUST FAN

TB24


23 HERON (ADA) MASTER BATH - 2 A9.2 1/4" = 1'-0"

HEAT LAMP

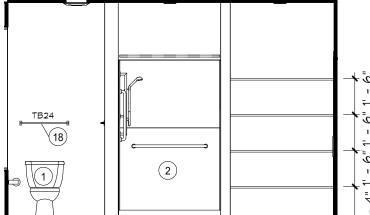


A9.2 1/4" = 1'-0"

A9.2 1/4" = 1'-0"

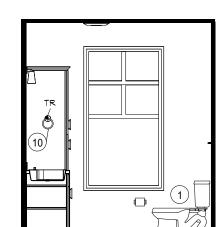



29 FIDALGO MASTER BATH - 2




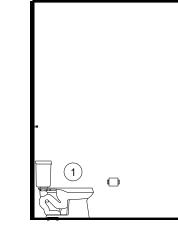



2' - 2" 💍 тв24 (9) UC2484/22D VB30 VB3D18 VB30 **3RD FLR UNIT BATH - 1** 37

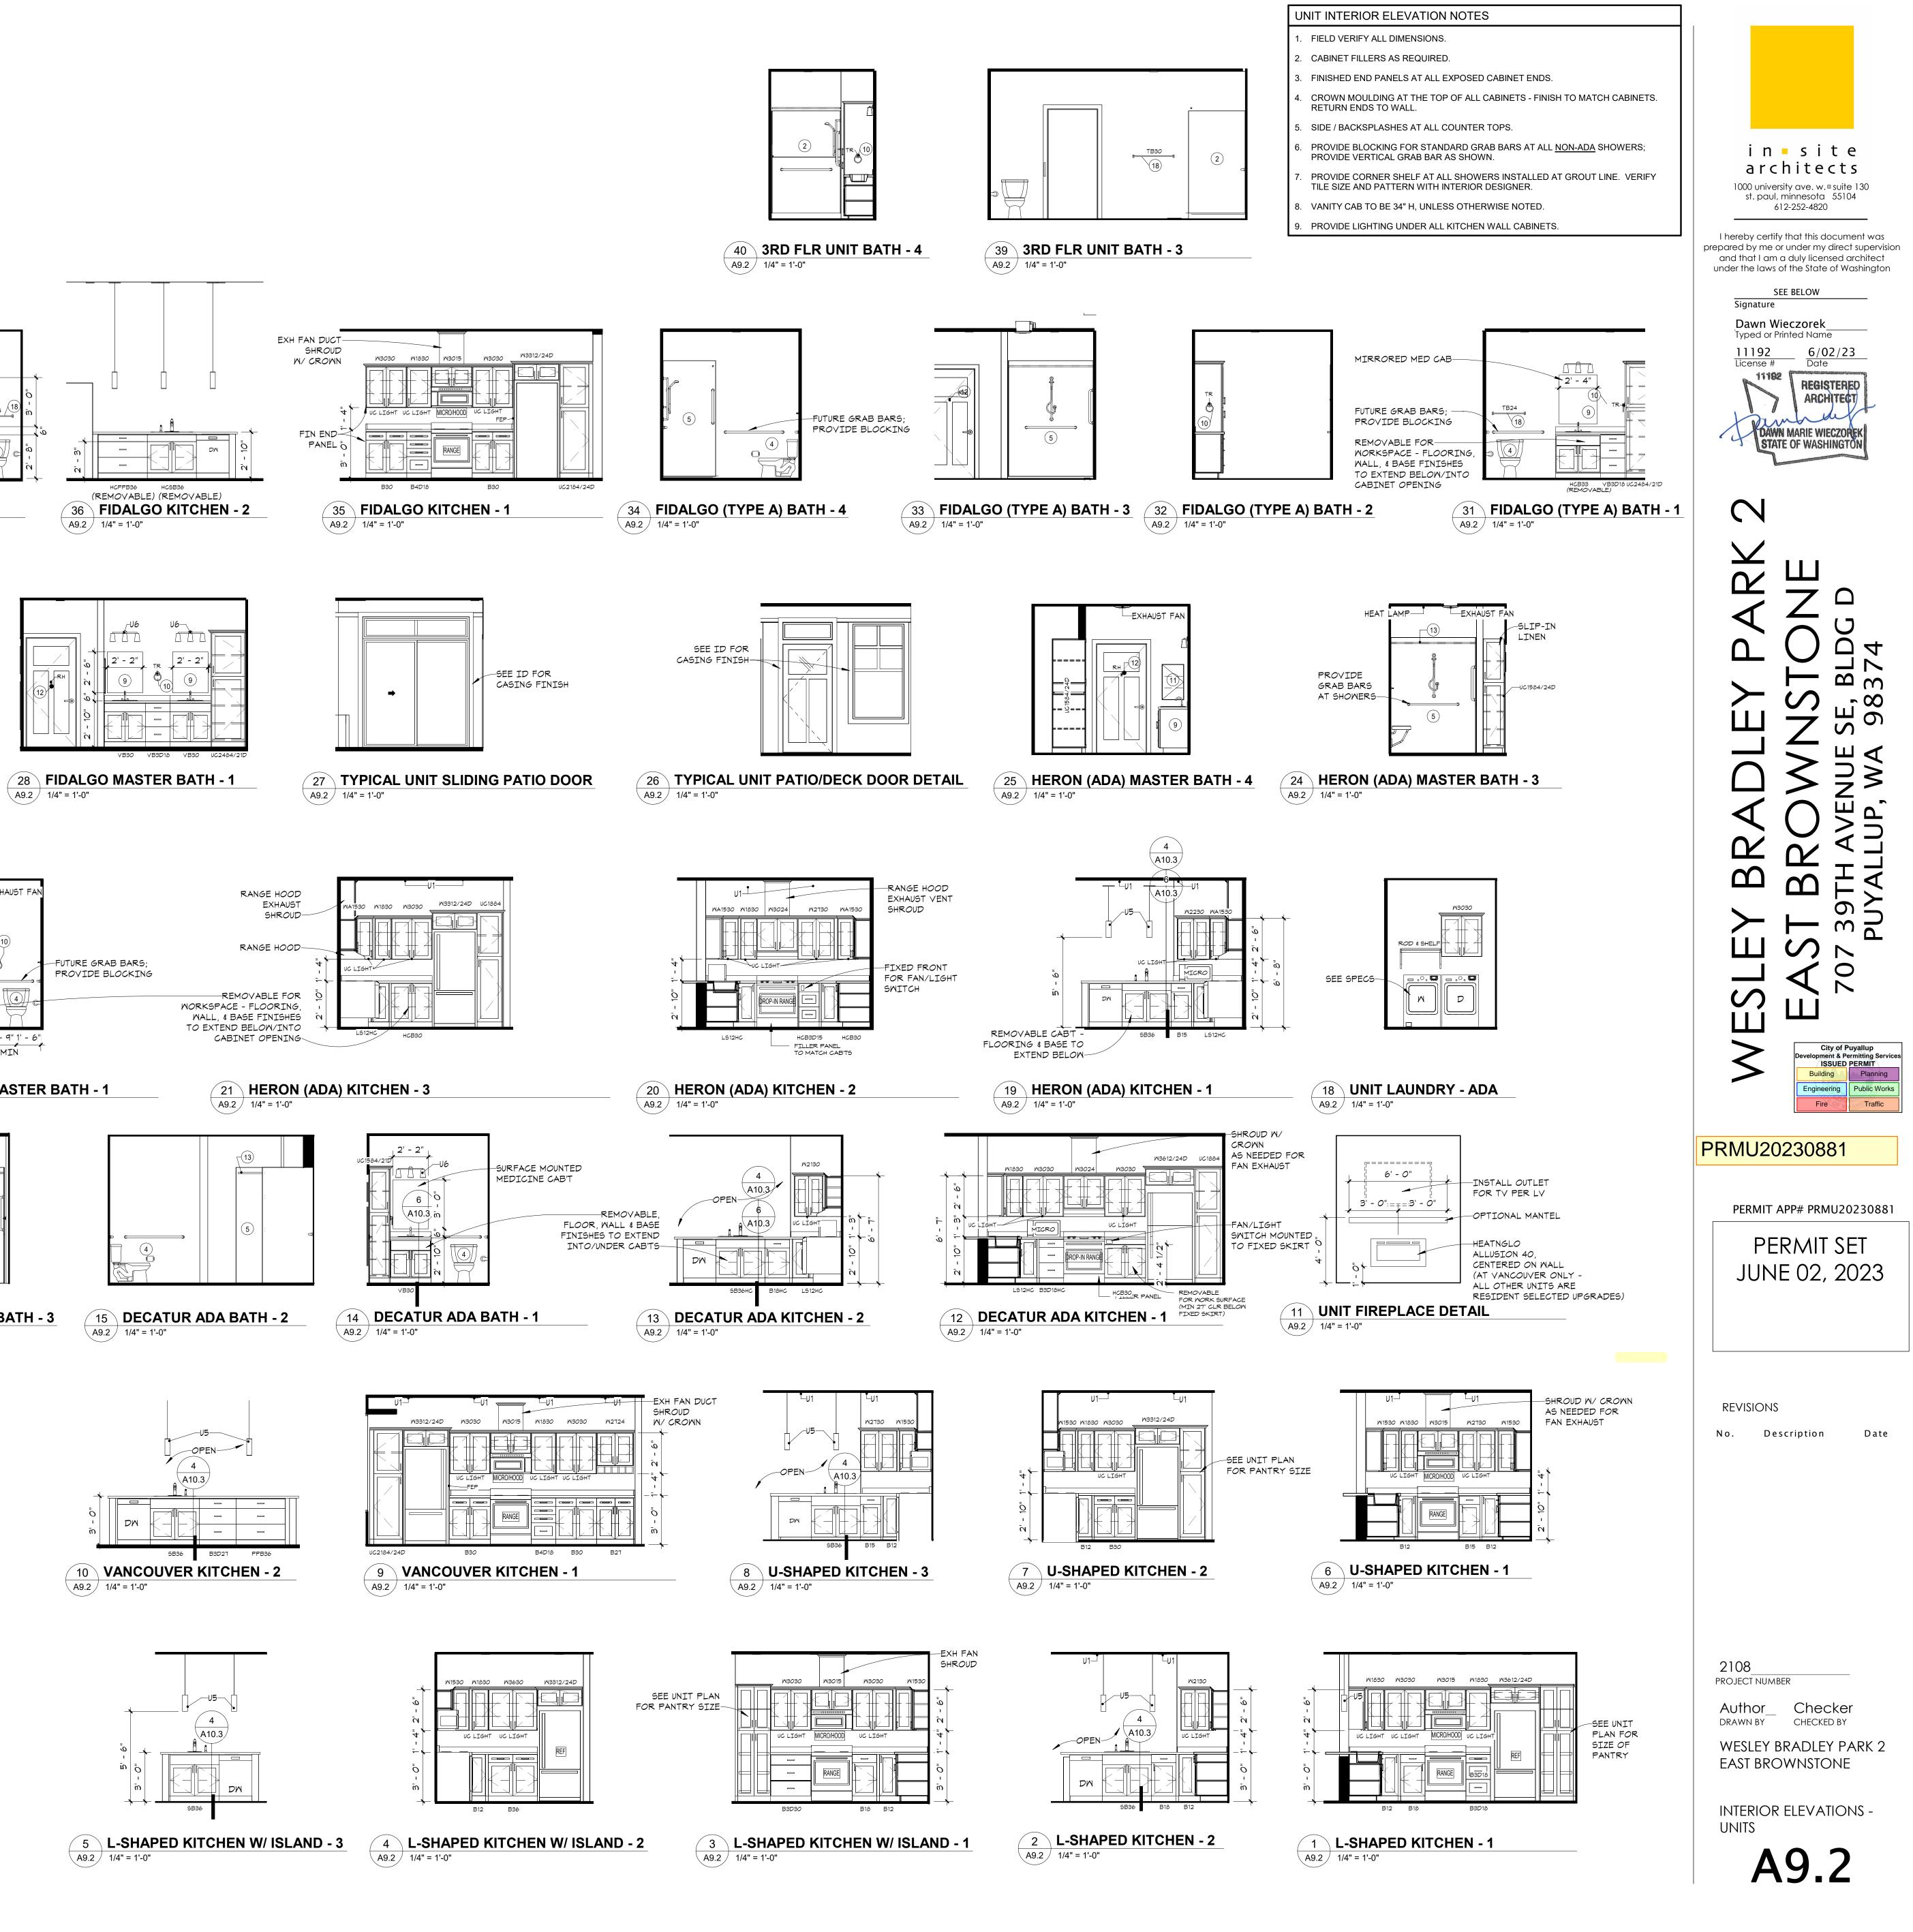


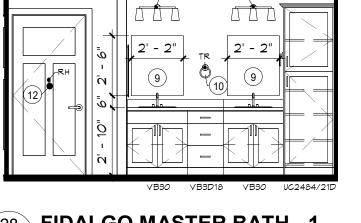


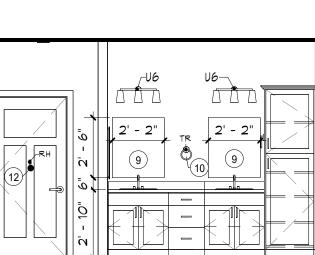


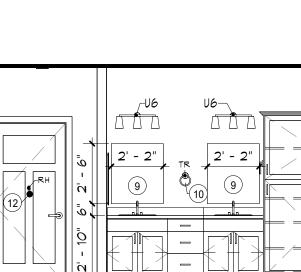


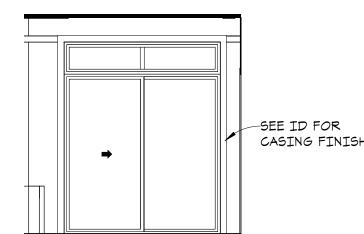


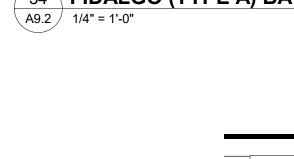


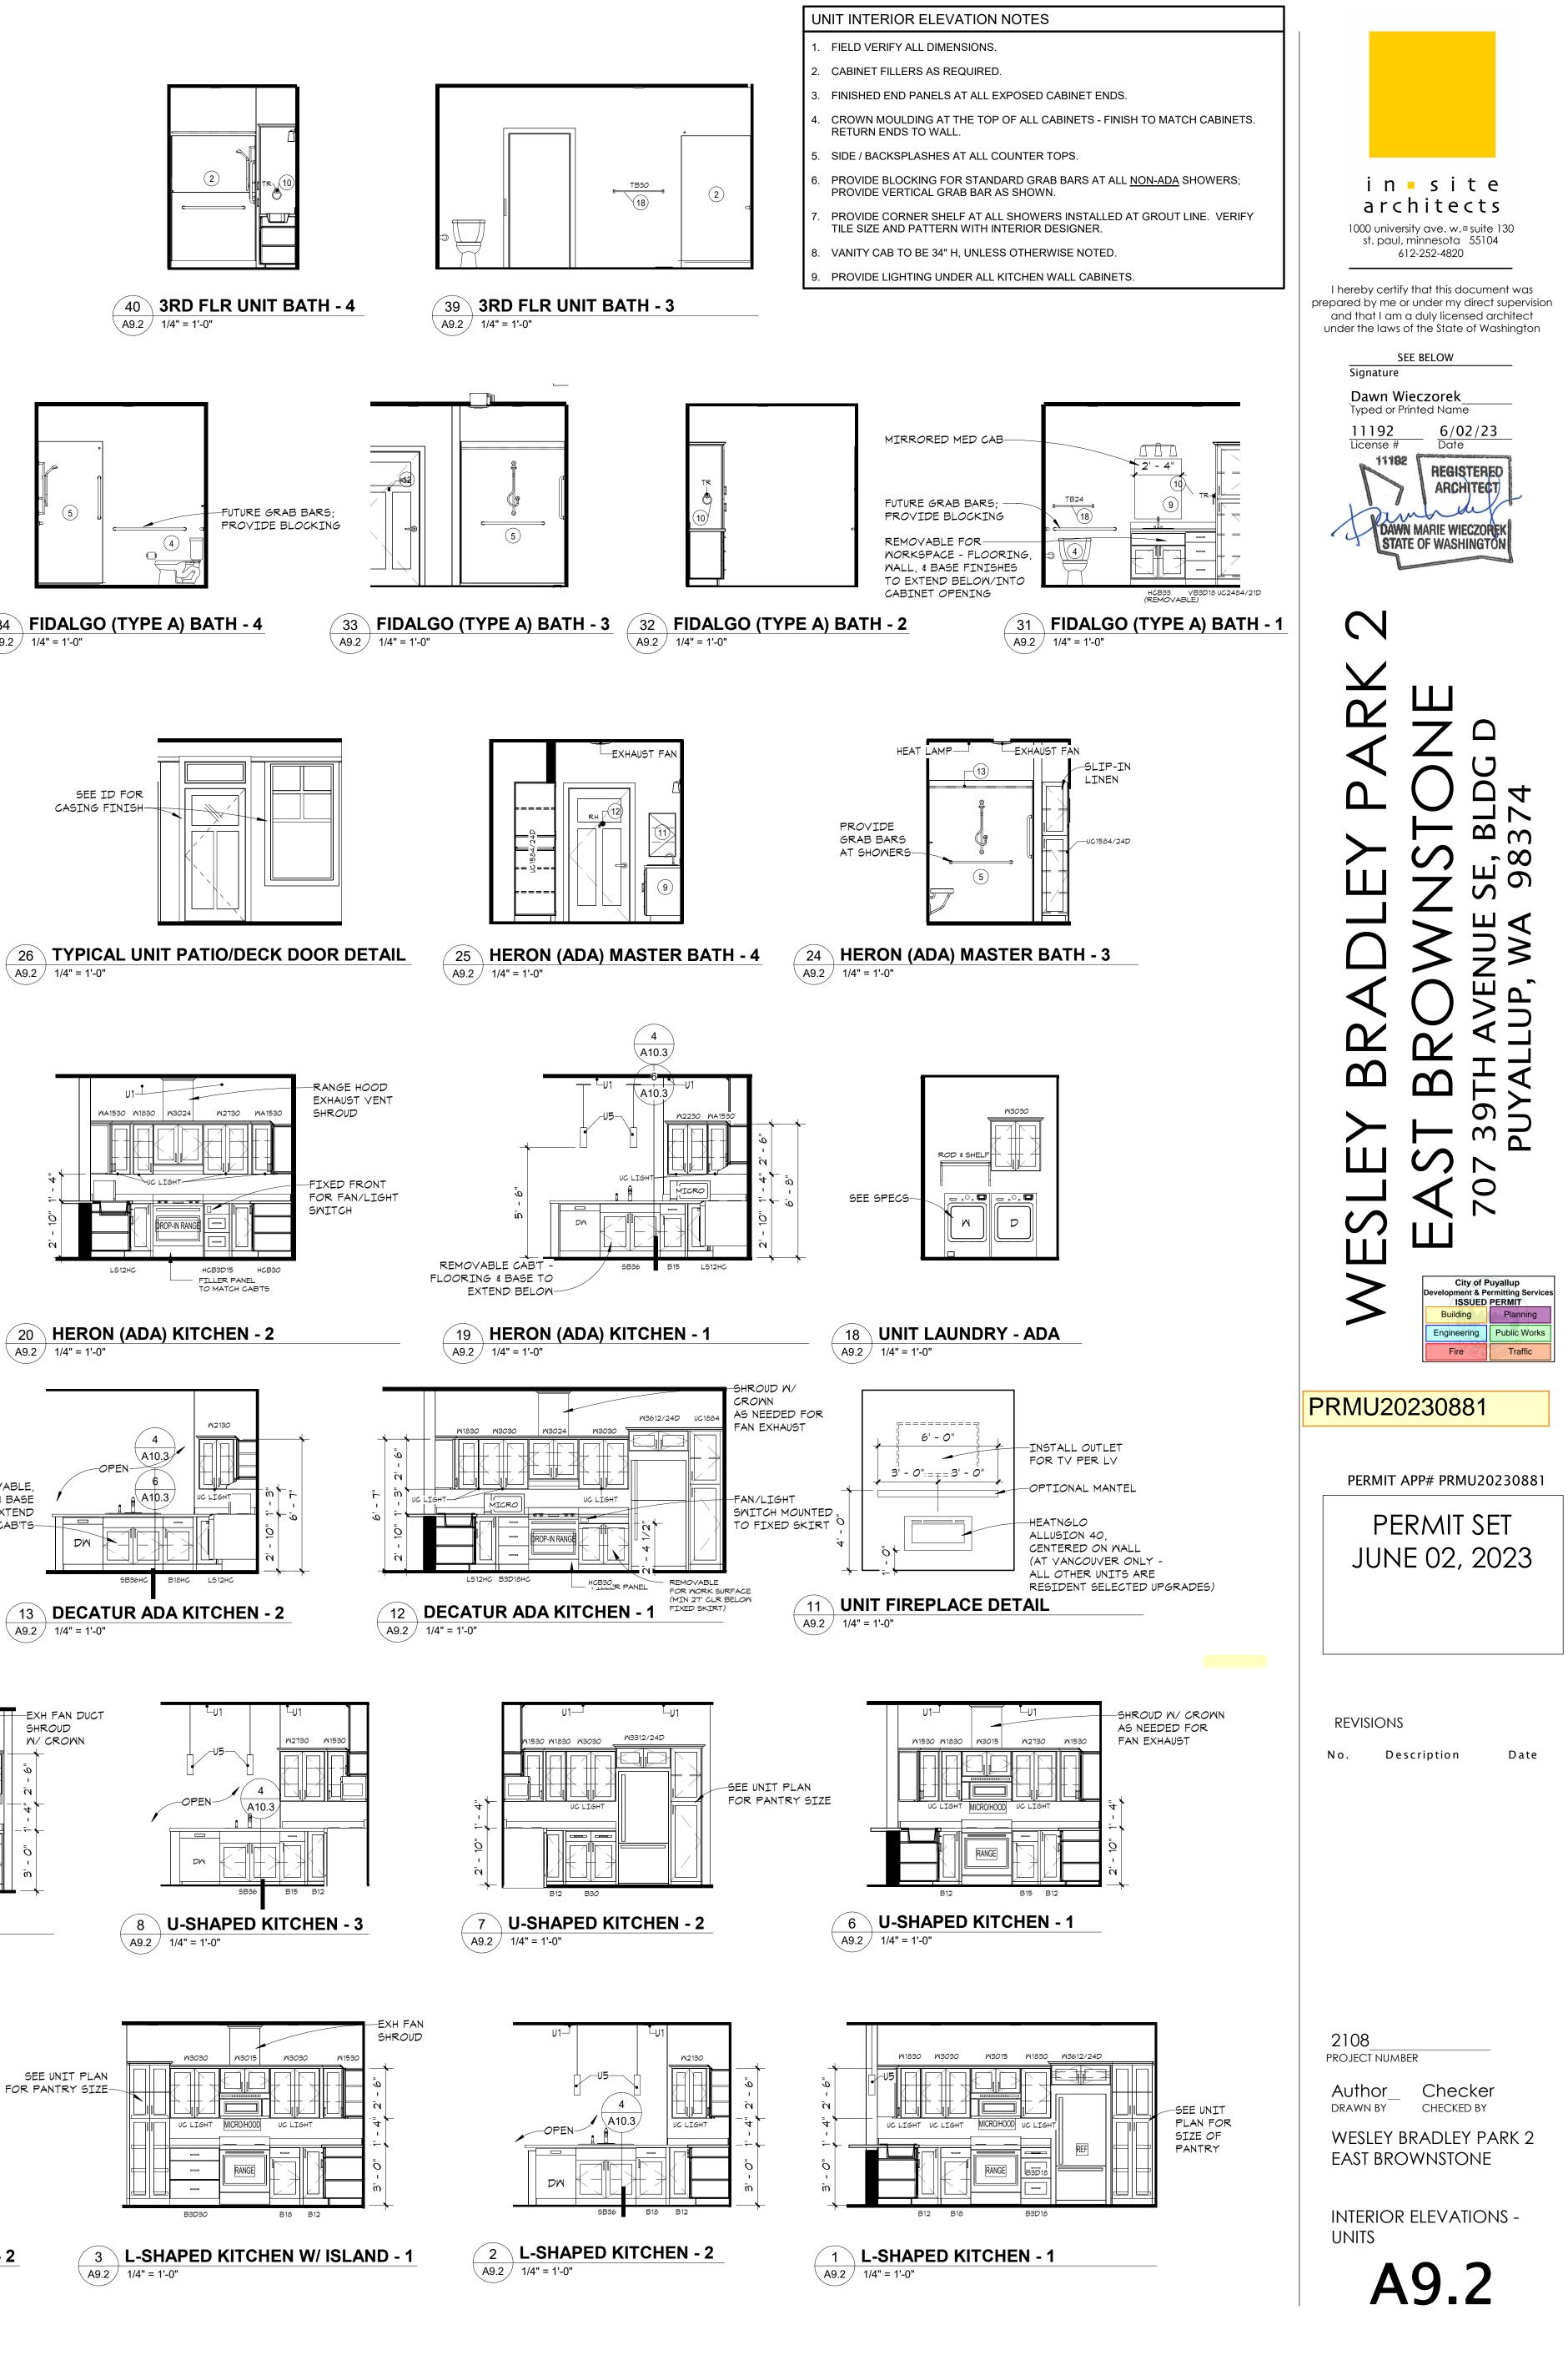


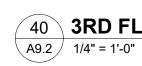


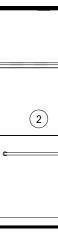

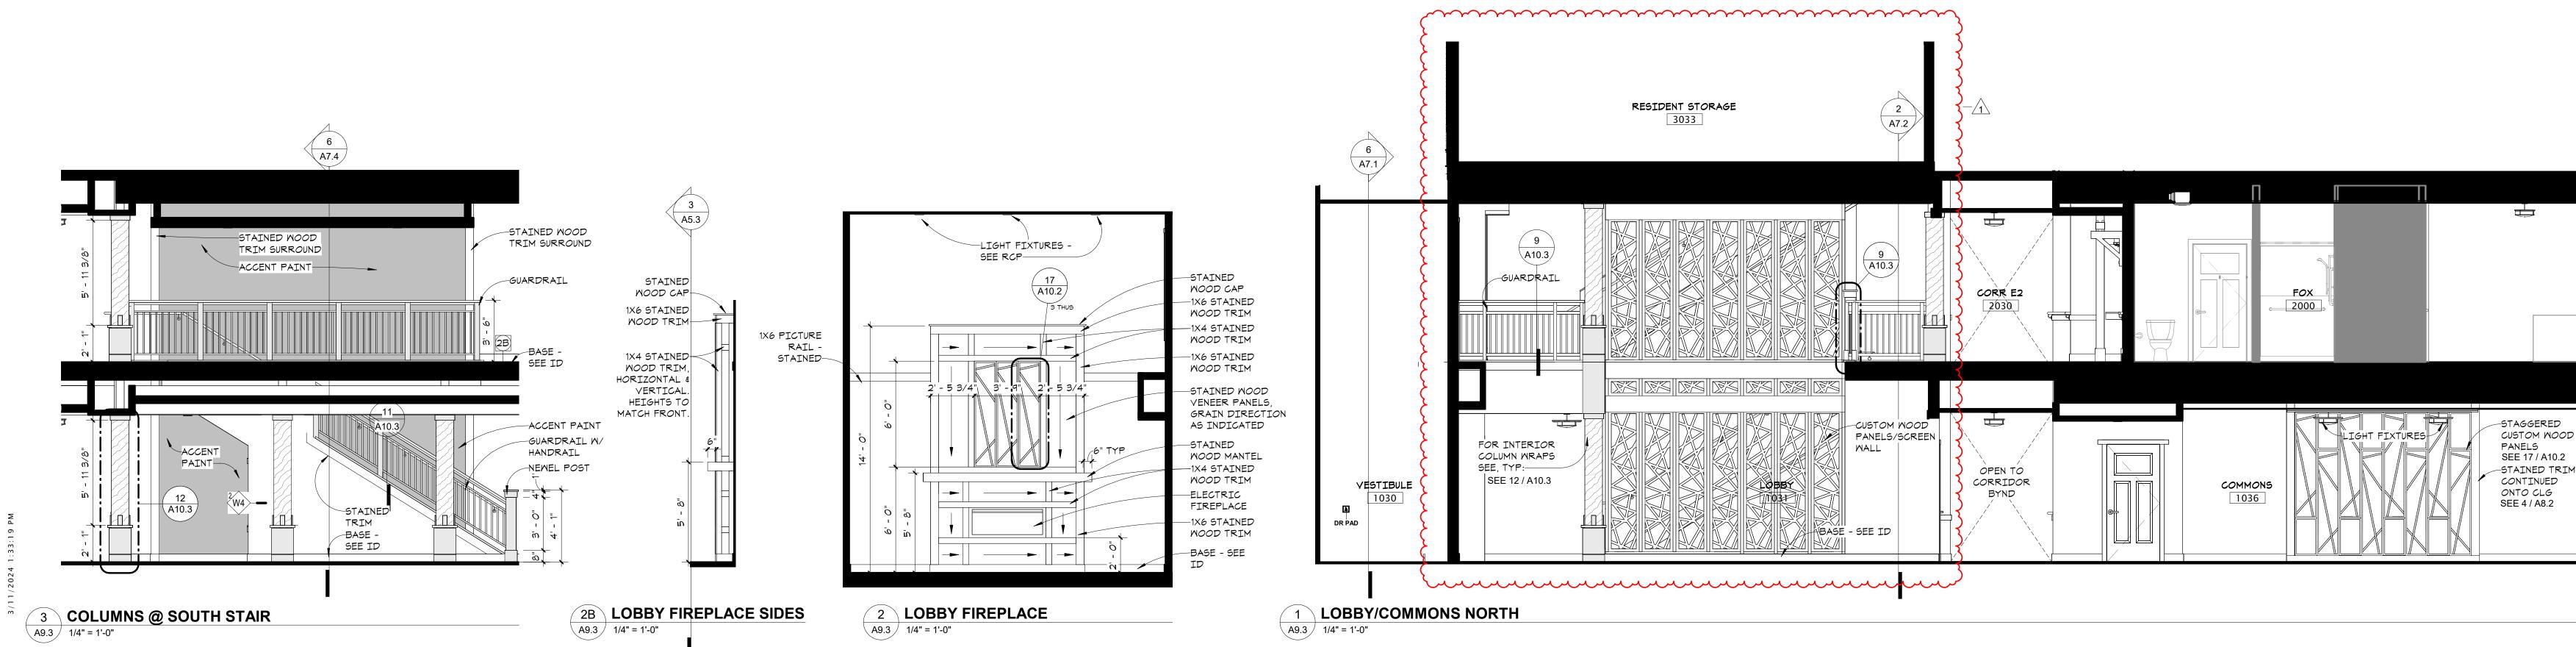


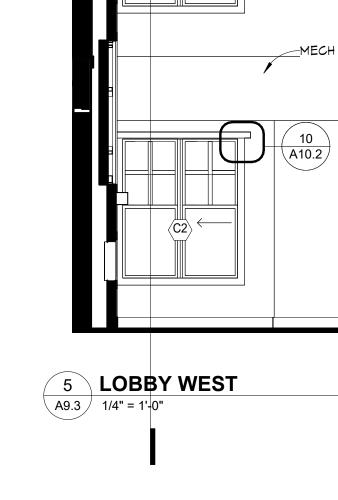


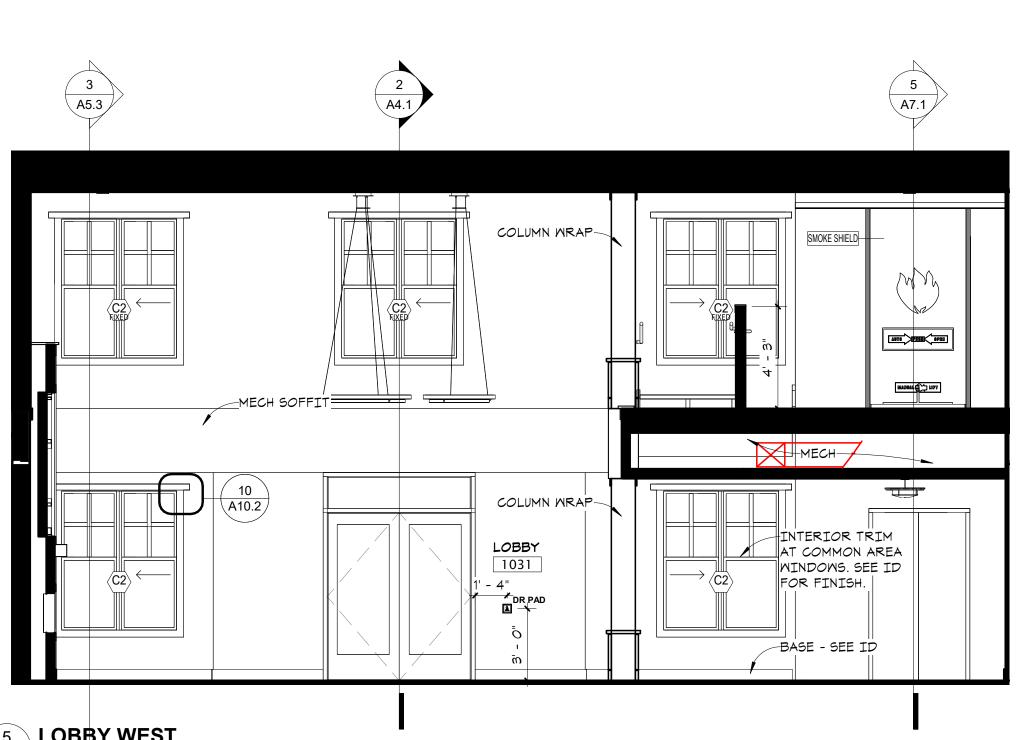


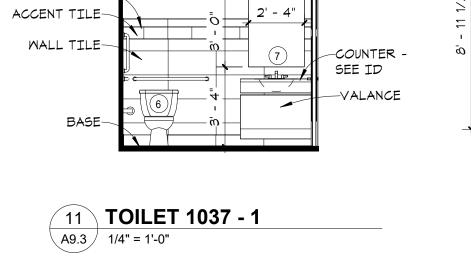


BULLNOSE TOP-

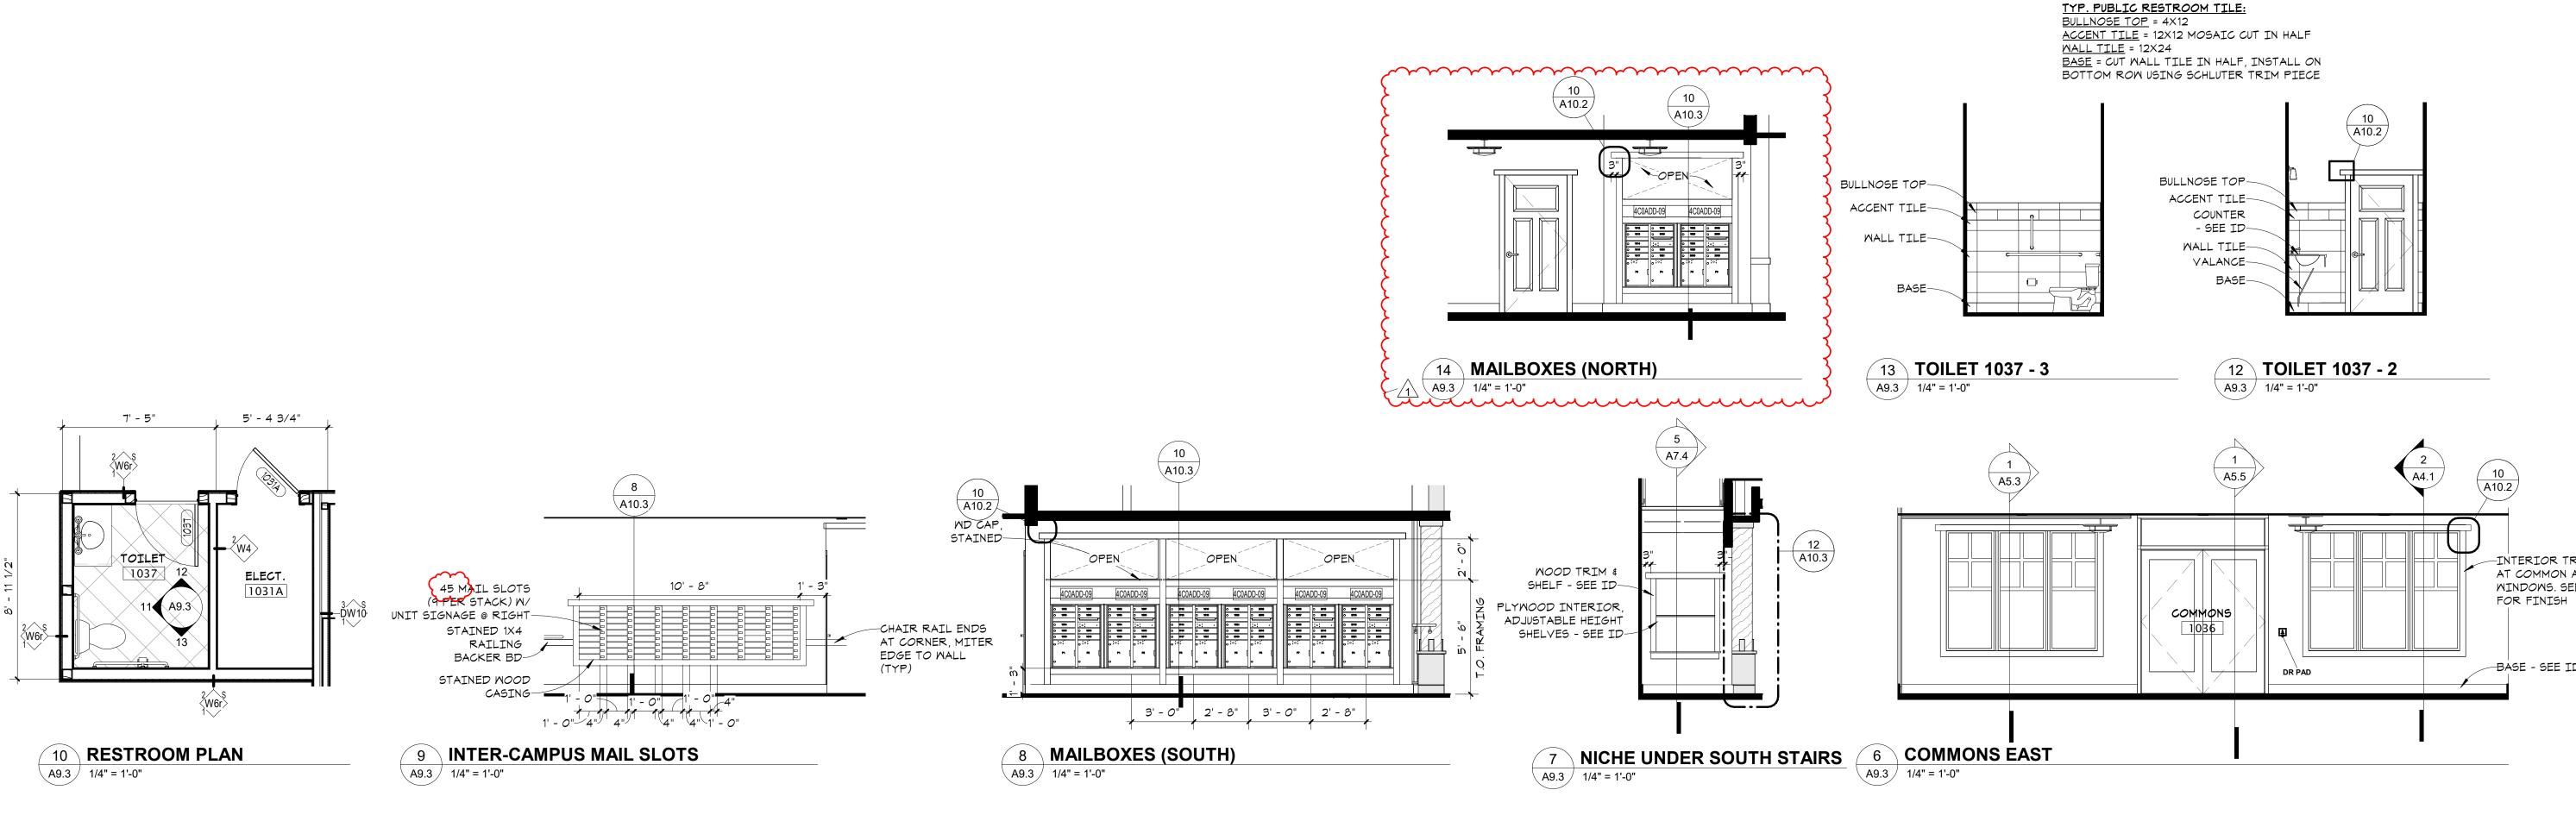


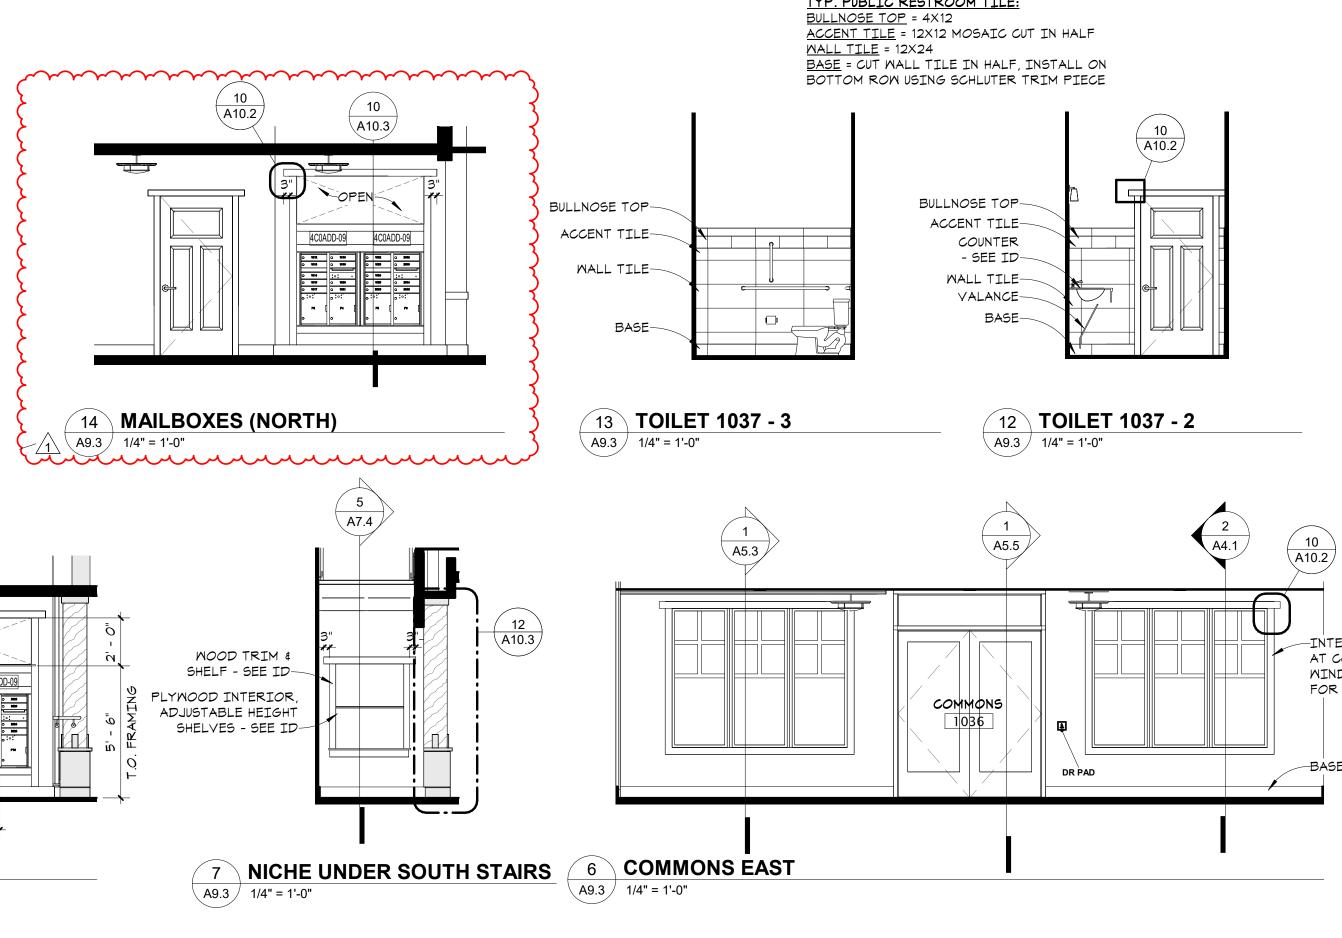


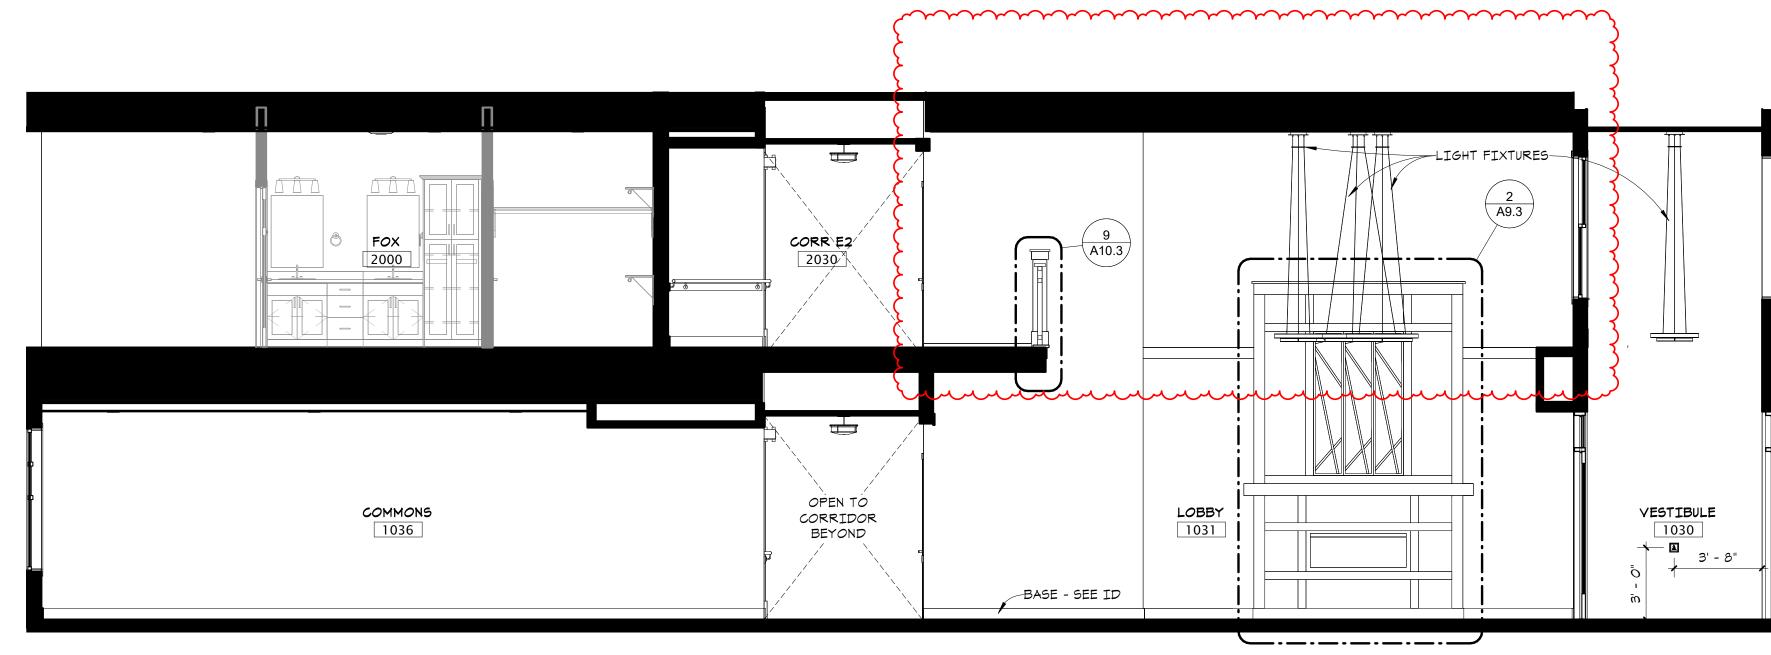




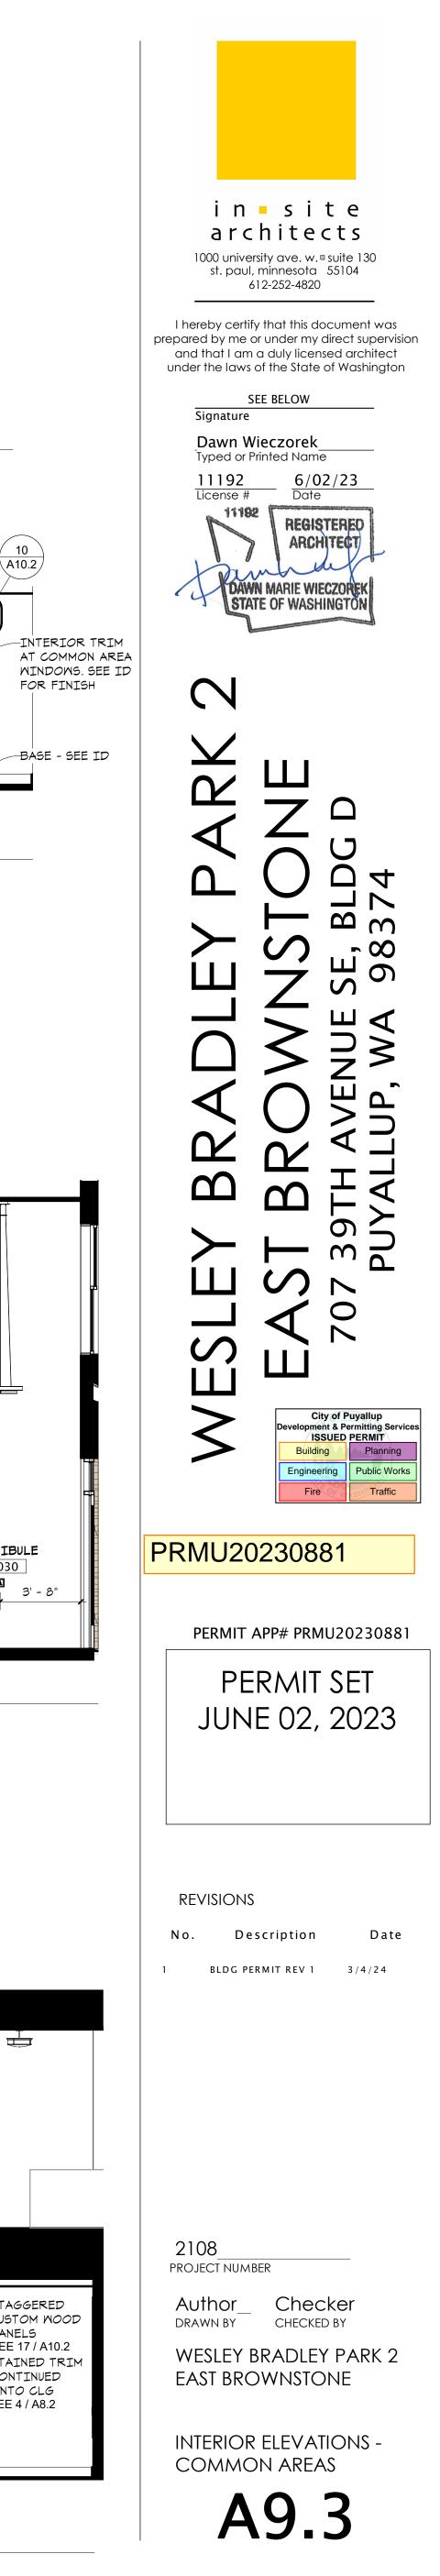


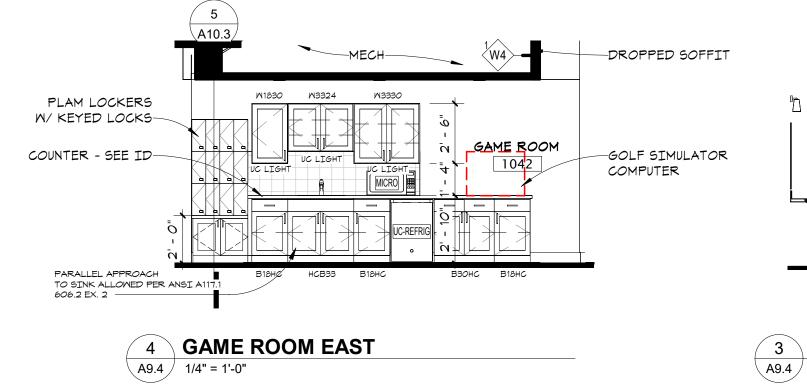

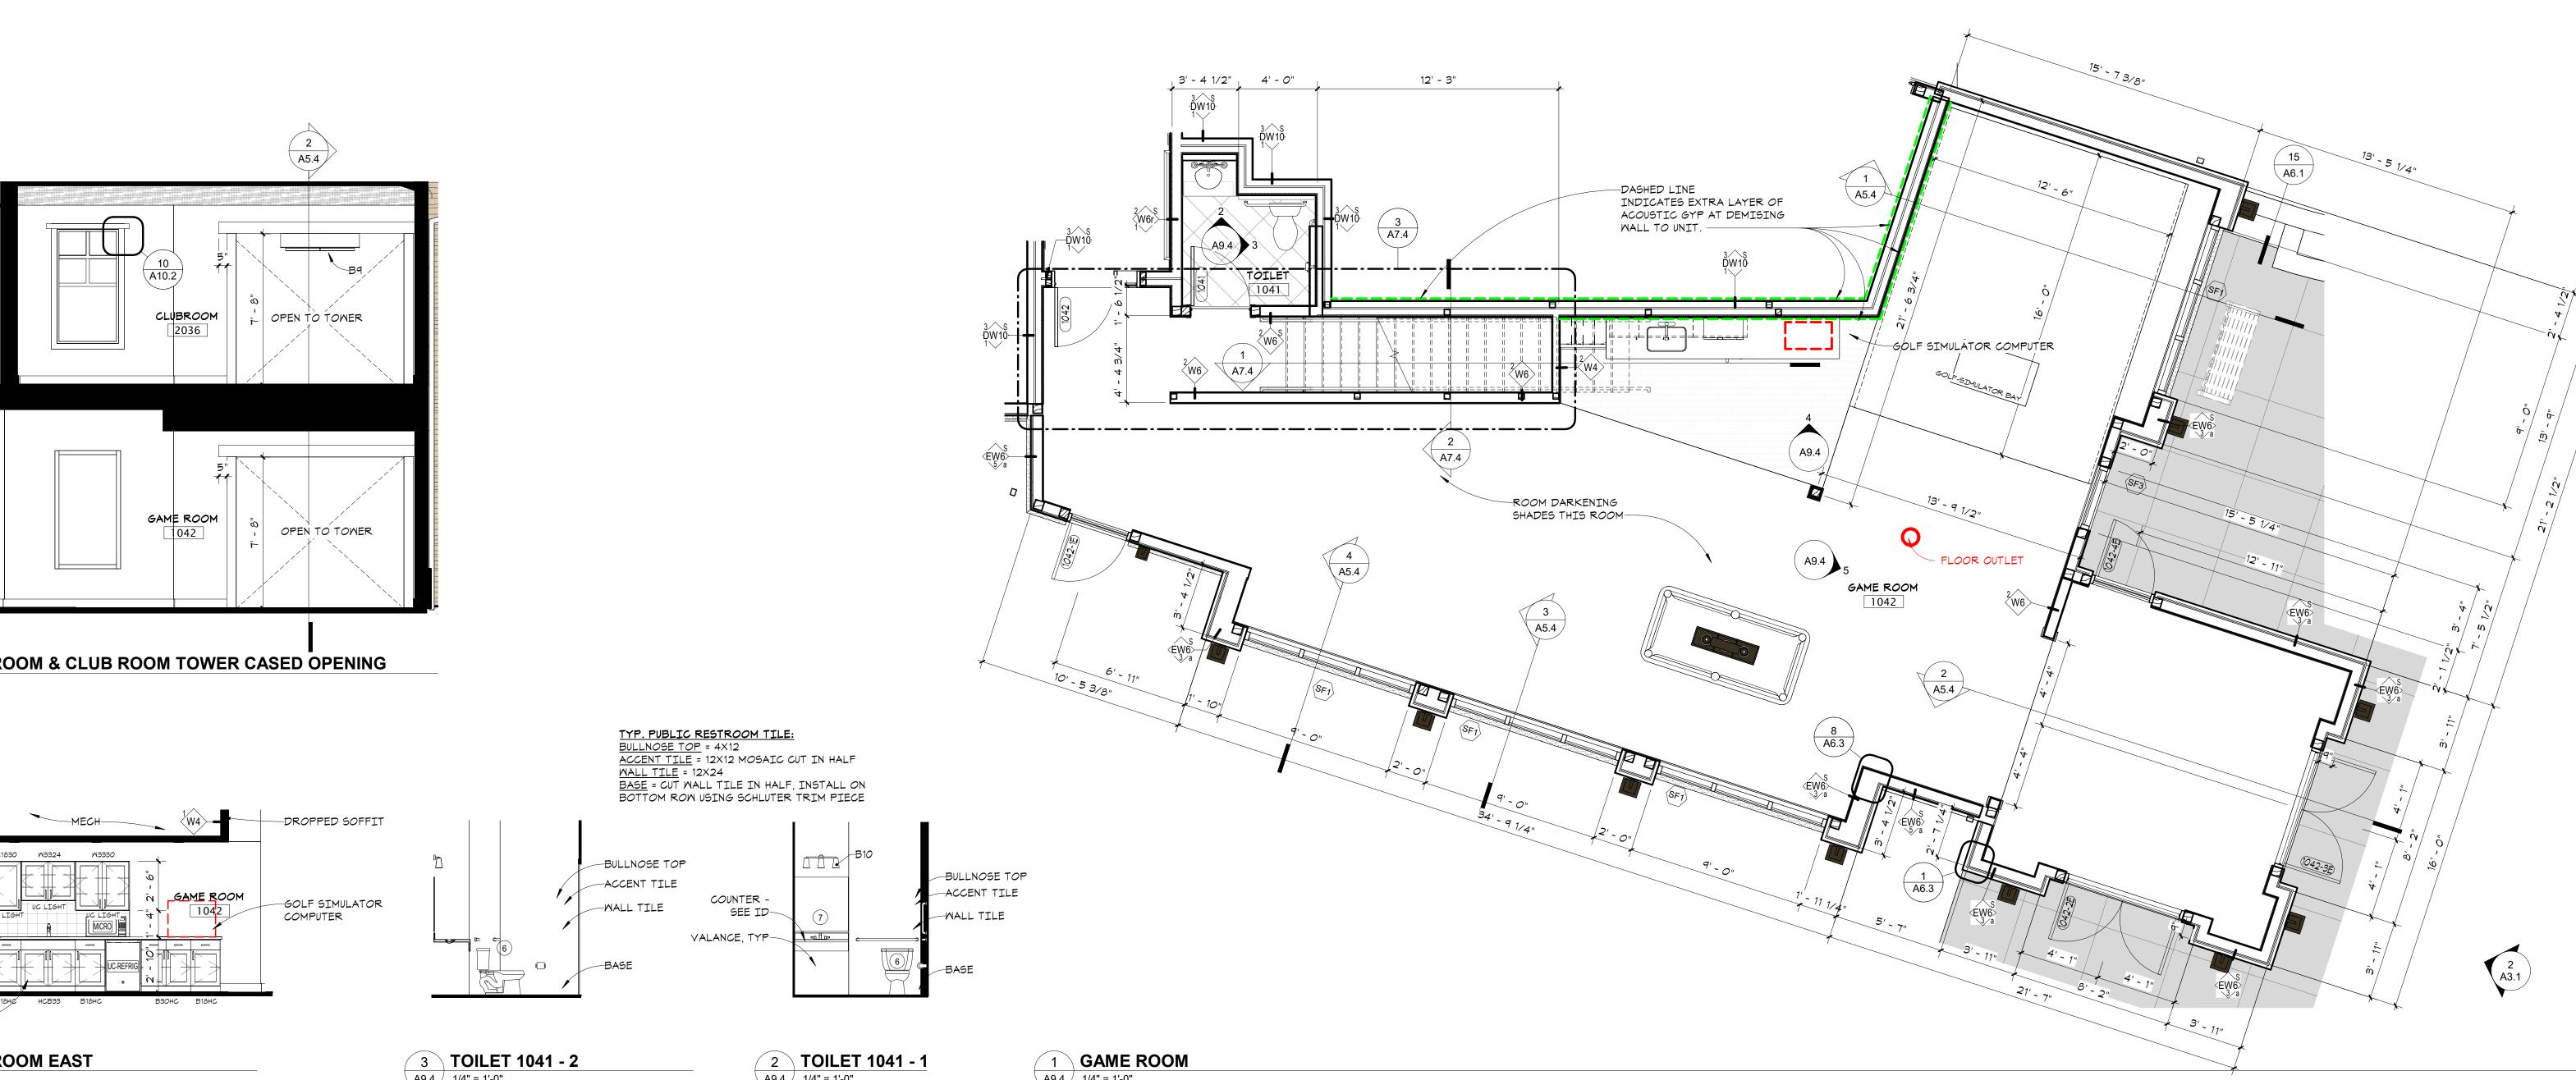



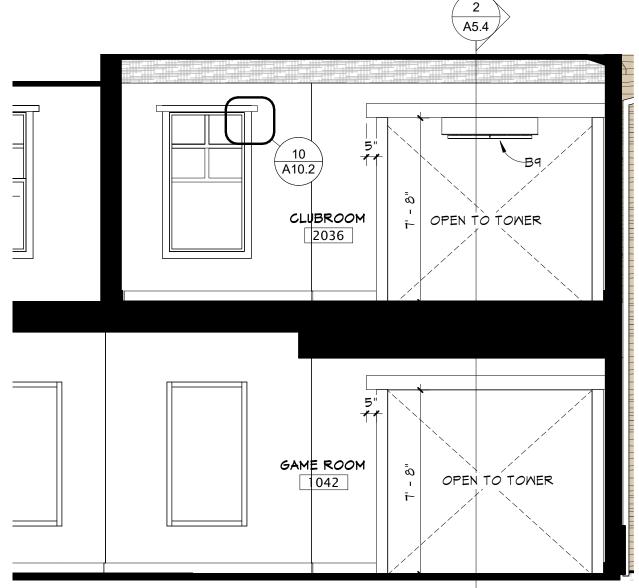


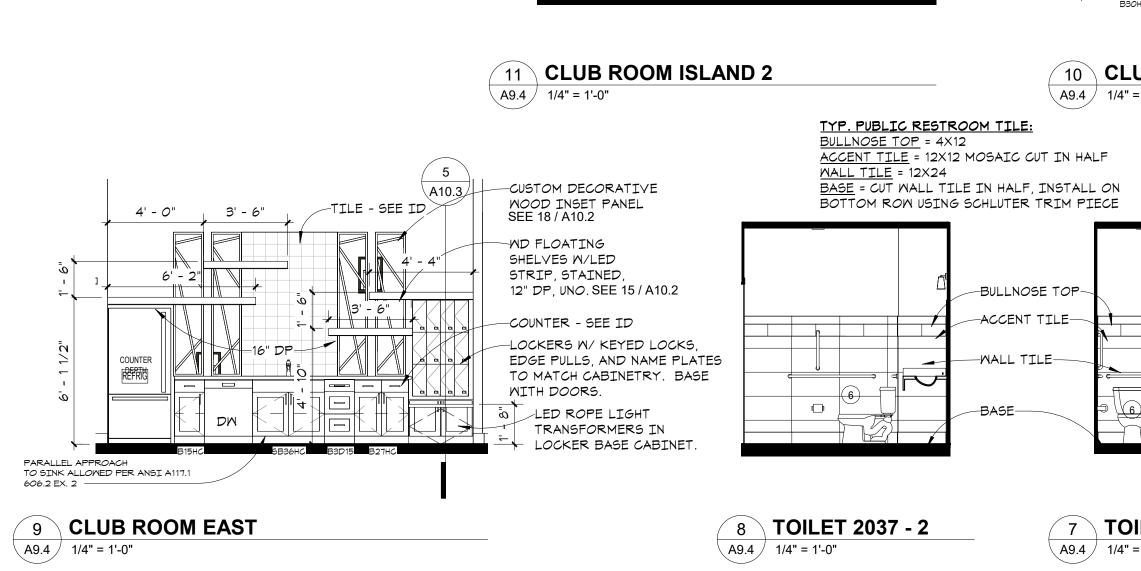

1' - 4" 3" 1' - 4"

3' - 11"

2' - 9"

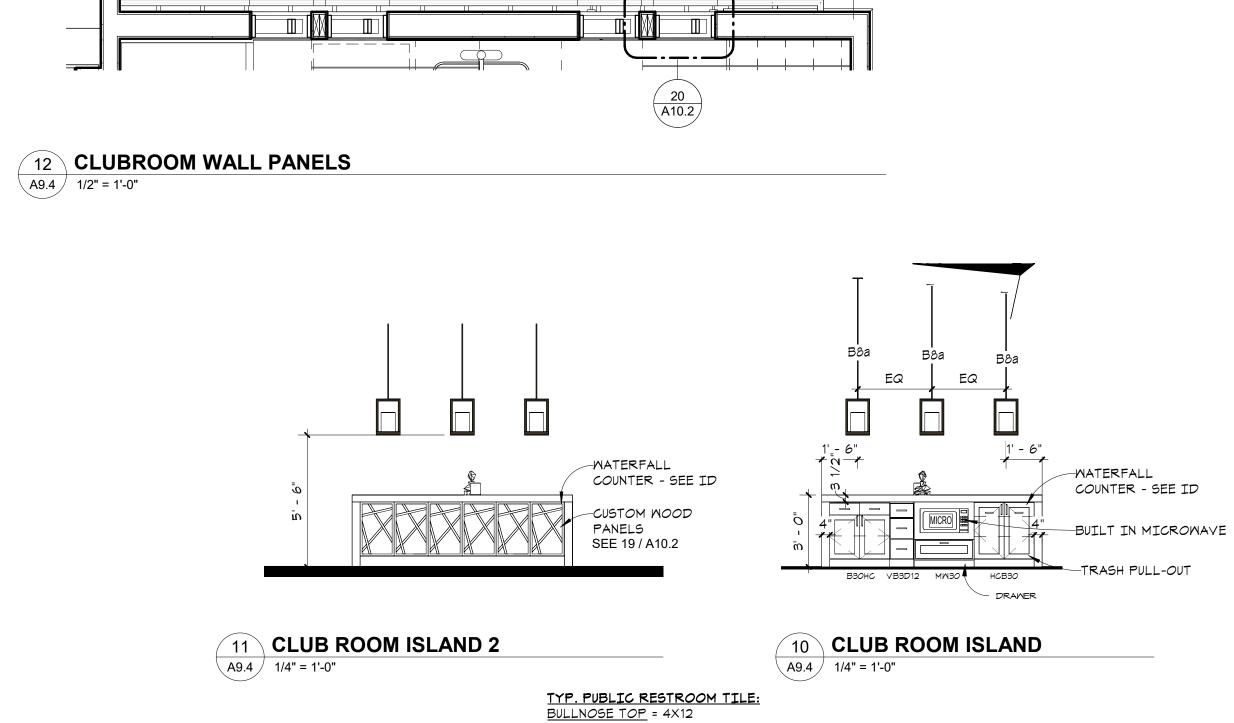



1'-4" 3" 1'-4" 2'-10"

A9.4 1/4" = 1'-0"



-BASE-

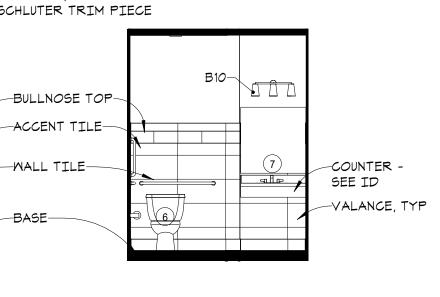

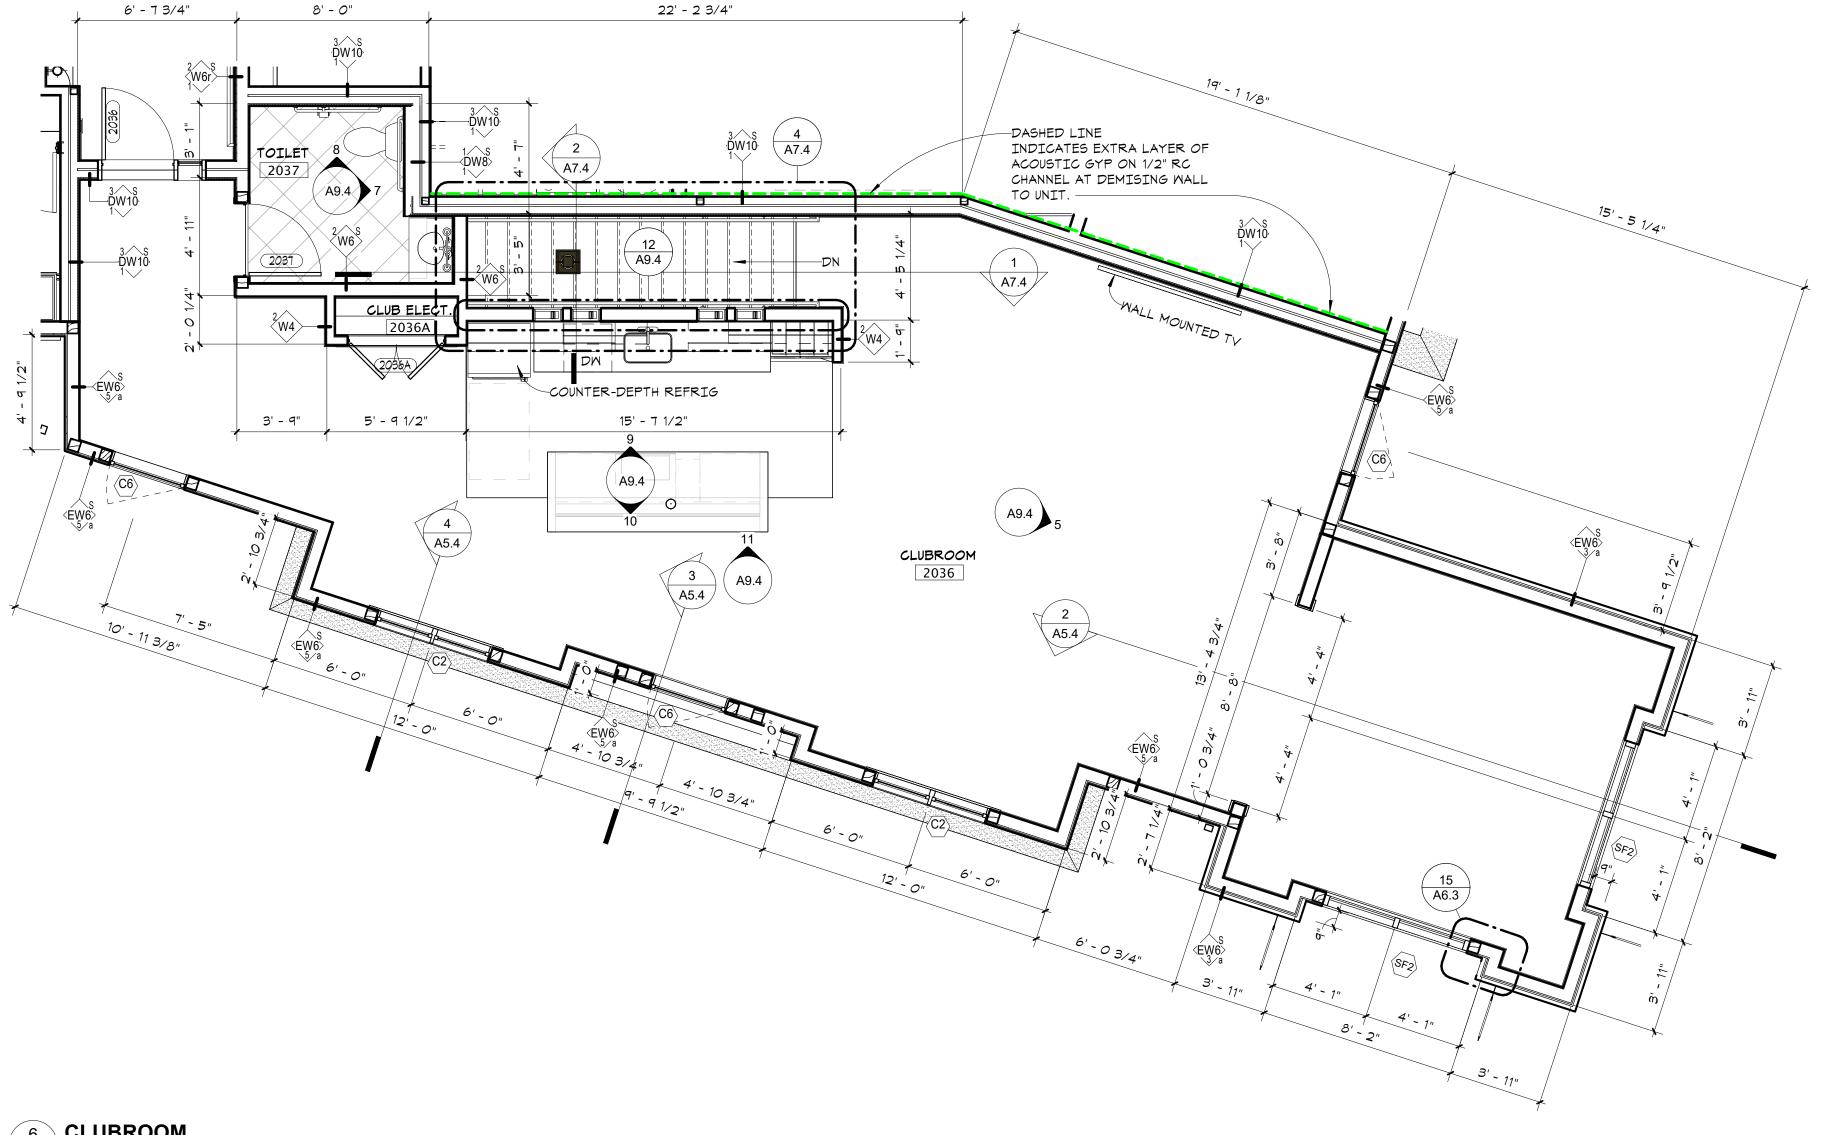






A9.4 1/4" = 1'-0"

in site architects 1000 university ave. w. 🛚 suite 130 st. paul, minnesota 55104 612-252-4820 I hereby certify that this document was prepared by me or under my direct supervision and that I am a duly licensed architect under the laws of the State of Washington SEE BELOW Signature Dawn Wieczorek Typed or Printed Name 11192 6/02/23 License # Date 11192 REGISTERE ARCHITECT DAWN MARIE WIECZOR STATE OF WASHING N \Box 4 **し へ** μ β .<u></u> ∼ ∞ ЩÕ $\square \triangleleft$ J> S≥ P /E $\mathbf{\mathcal{L}}$ Ω \mathbf{M} 39 PU 0 Ш С City of Puyallup evelopment & Permitting Service ISSUED PERMIT Building Planning
 Engineering
 Public Works

 Fire
 Traffic
 PRMU20230881 PERMIT APP# PRMU20230881 PERMIT SET JUNE 02, 2023 REVISIONS Date No. Description 2108 PROJECT NUMBER Author_ Checker DRAWN BY CHECKED BY WESLEY BRADLEY PARK 2 EAST BROWNSTONE INTERIOR ELEVATIONS -COMMON AREAS A9.4

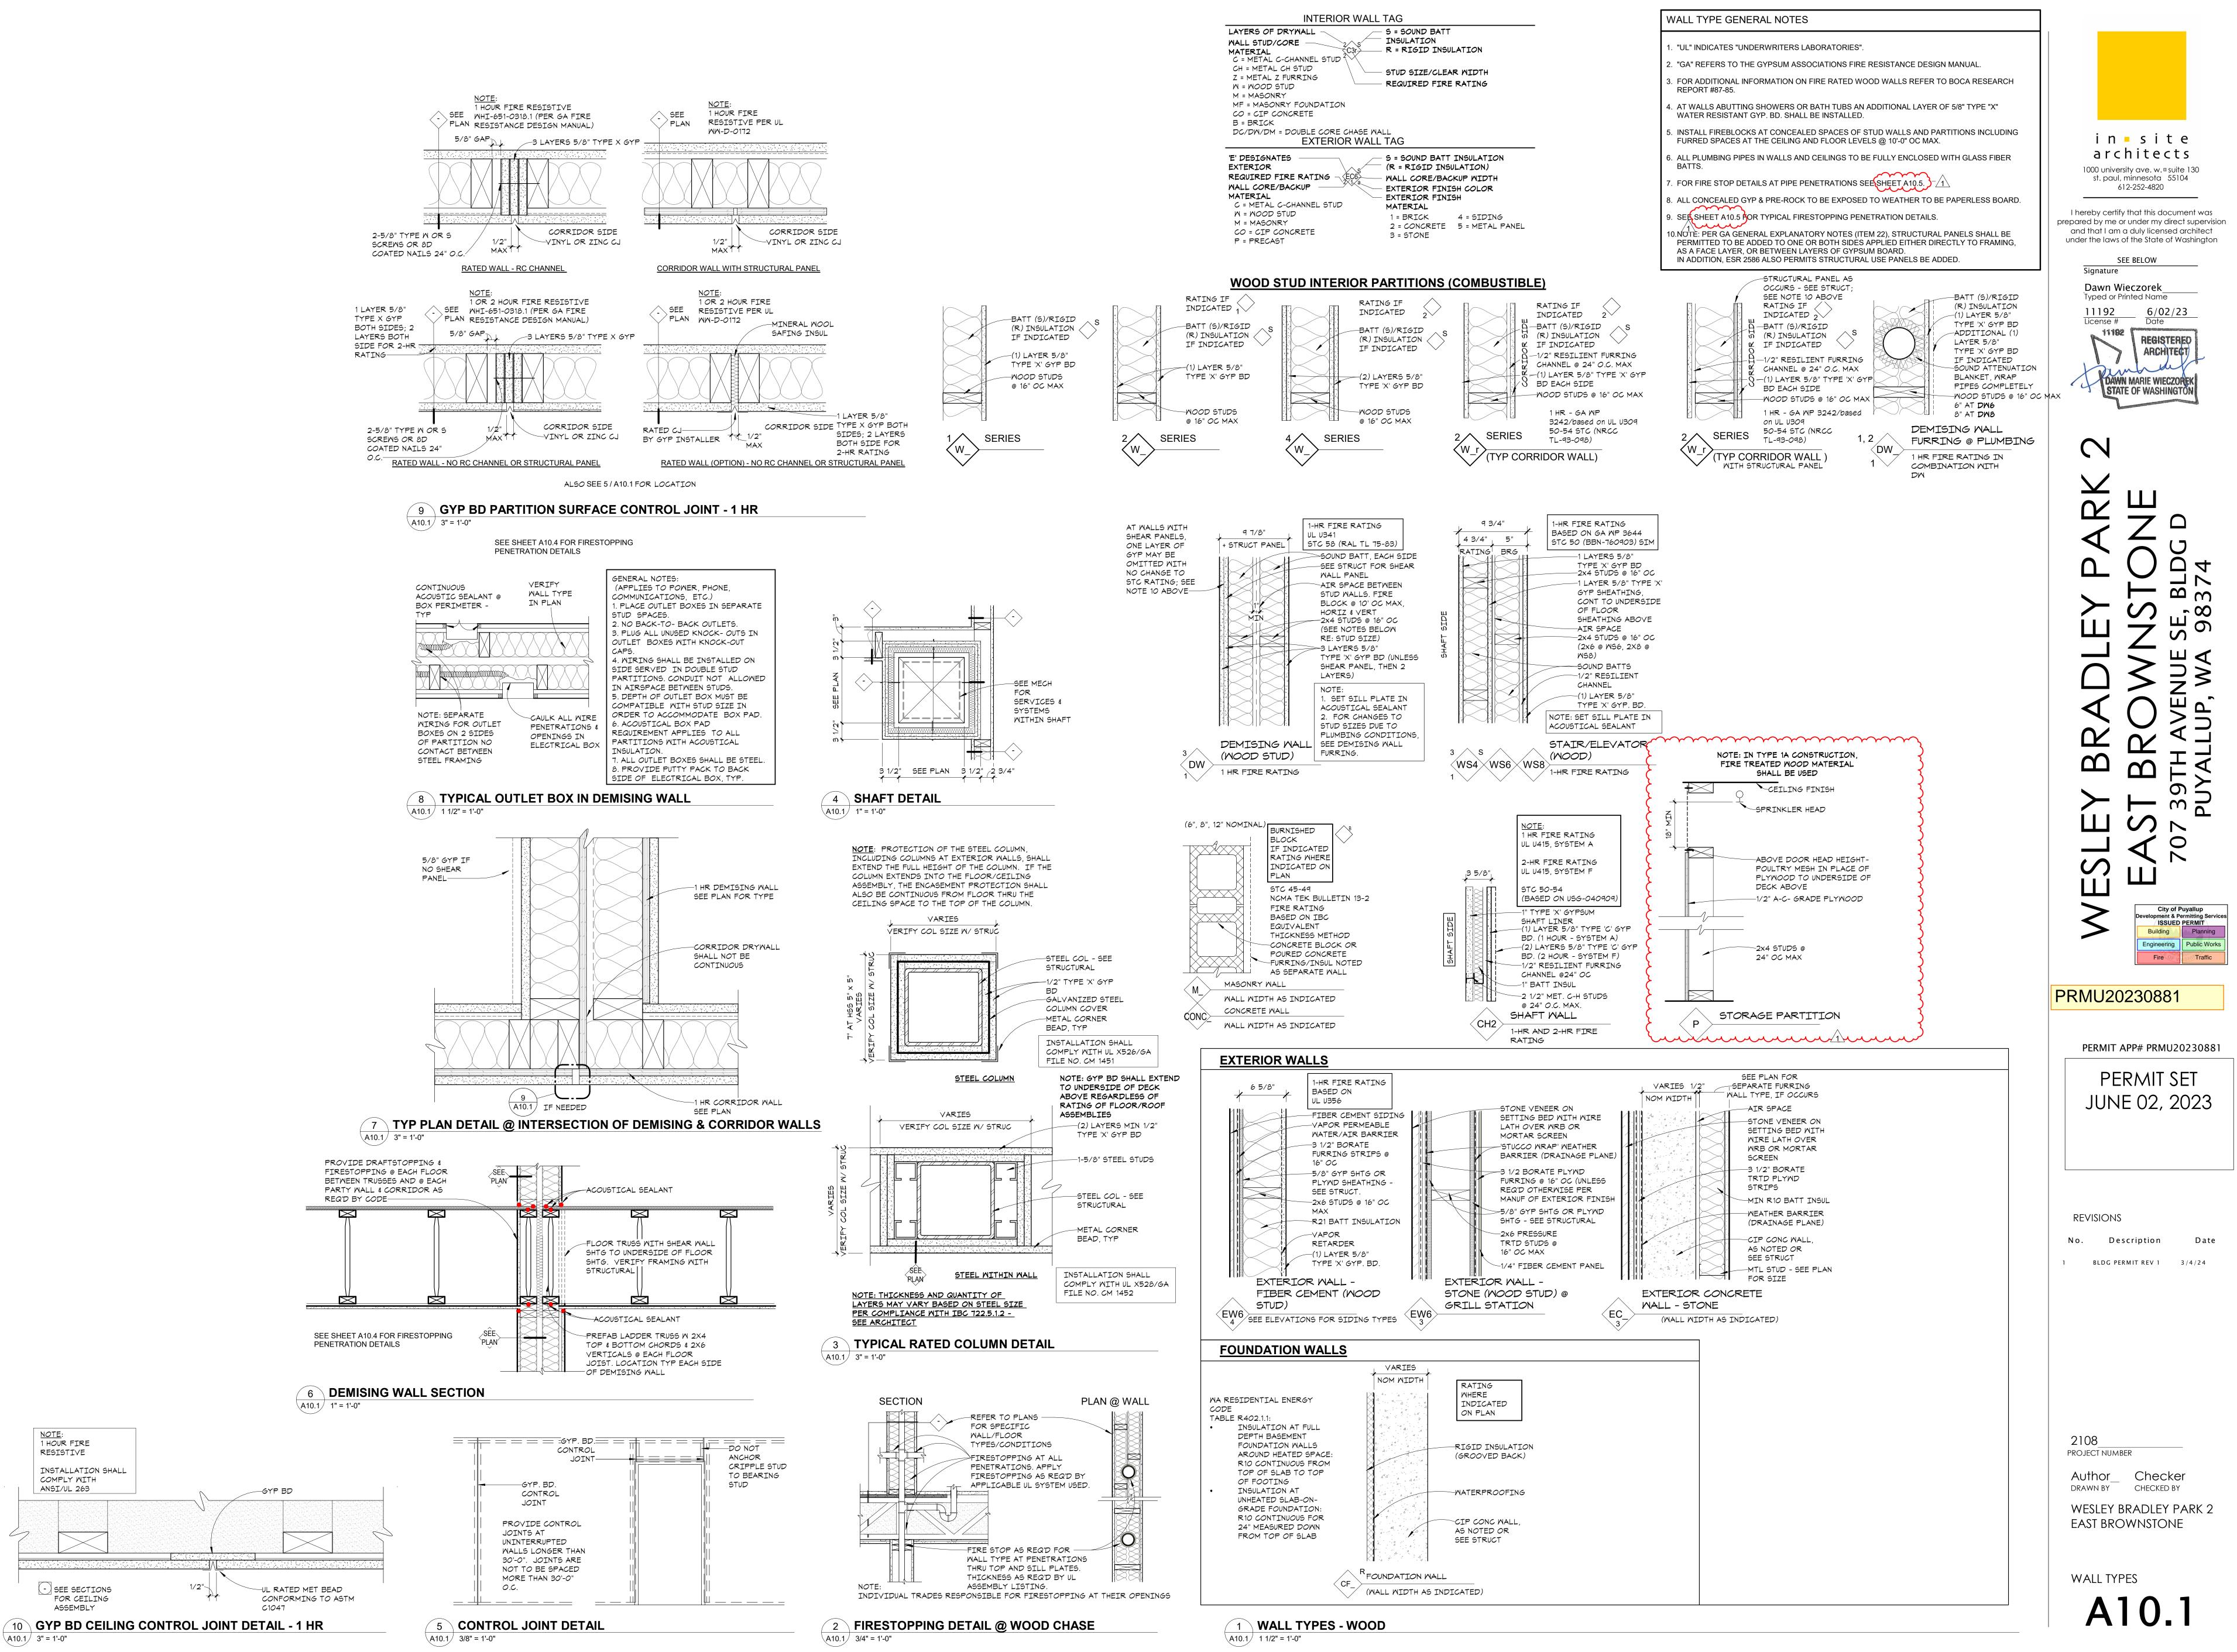

<u>NOTE</u>: 1 HOUR FIRE

RESISTIVE

COMPLY WITH

- SEE SECTIONS


ASSEMBLY


A10.1 3" = 1'-0"


FOR CEILING


ANSI/UL 263


INSTALLATION SHALL

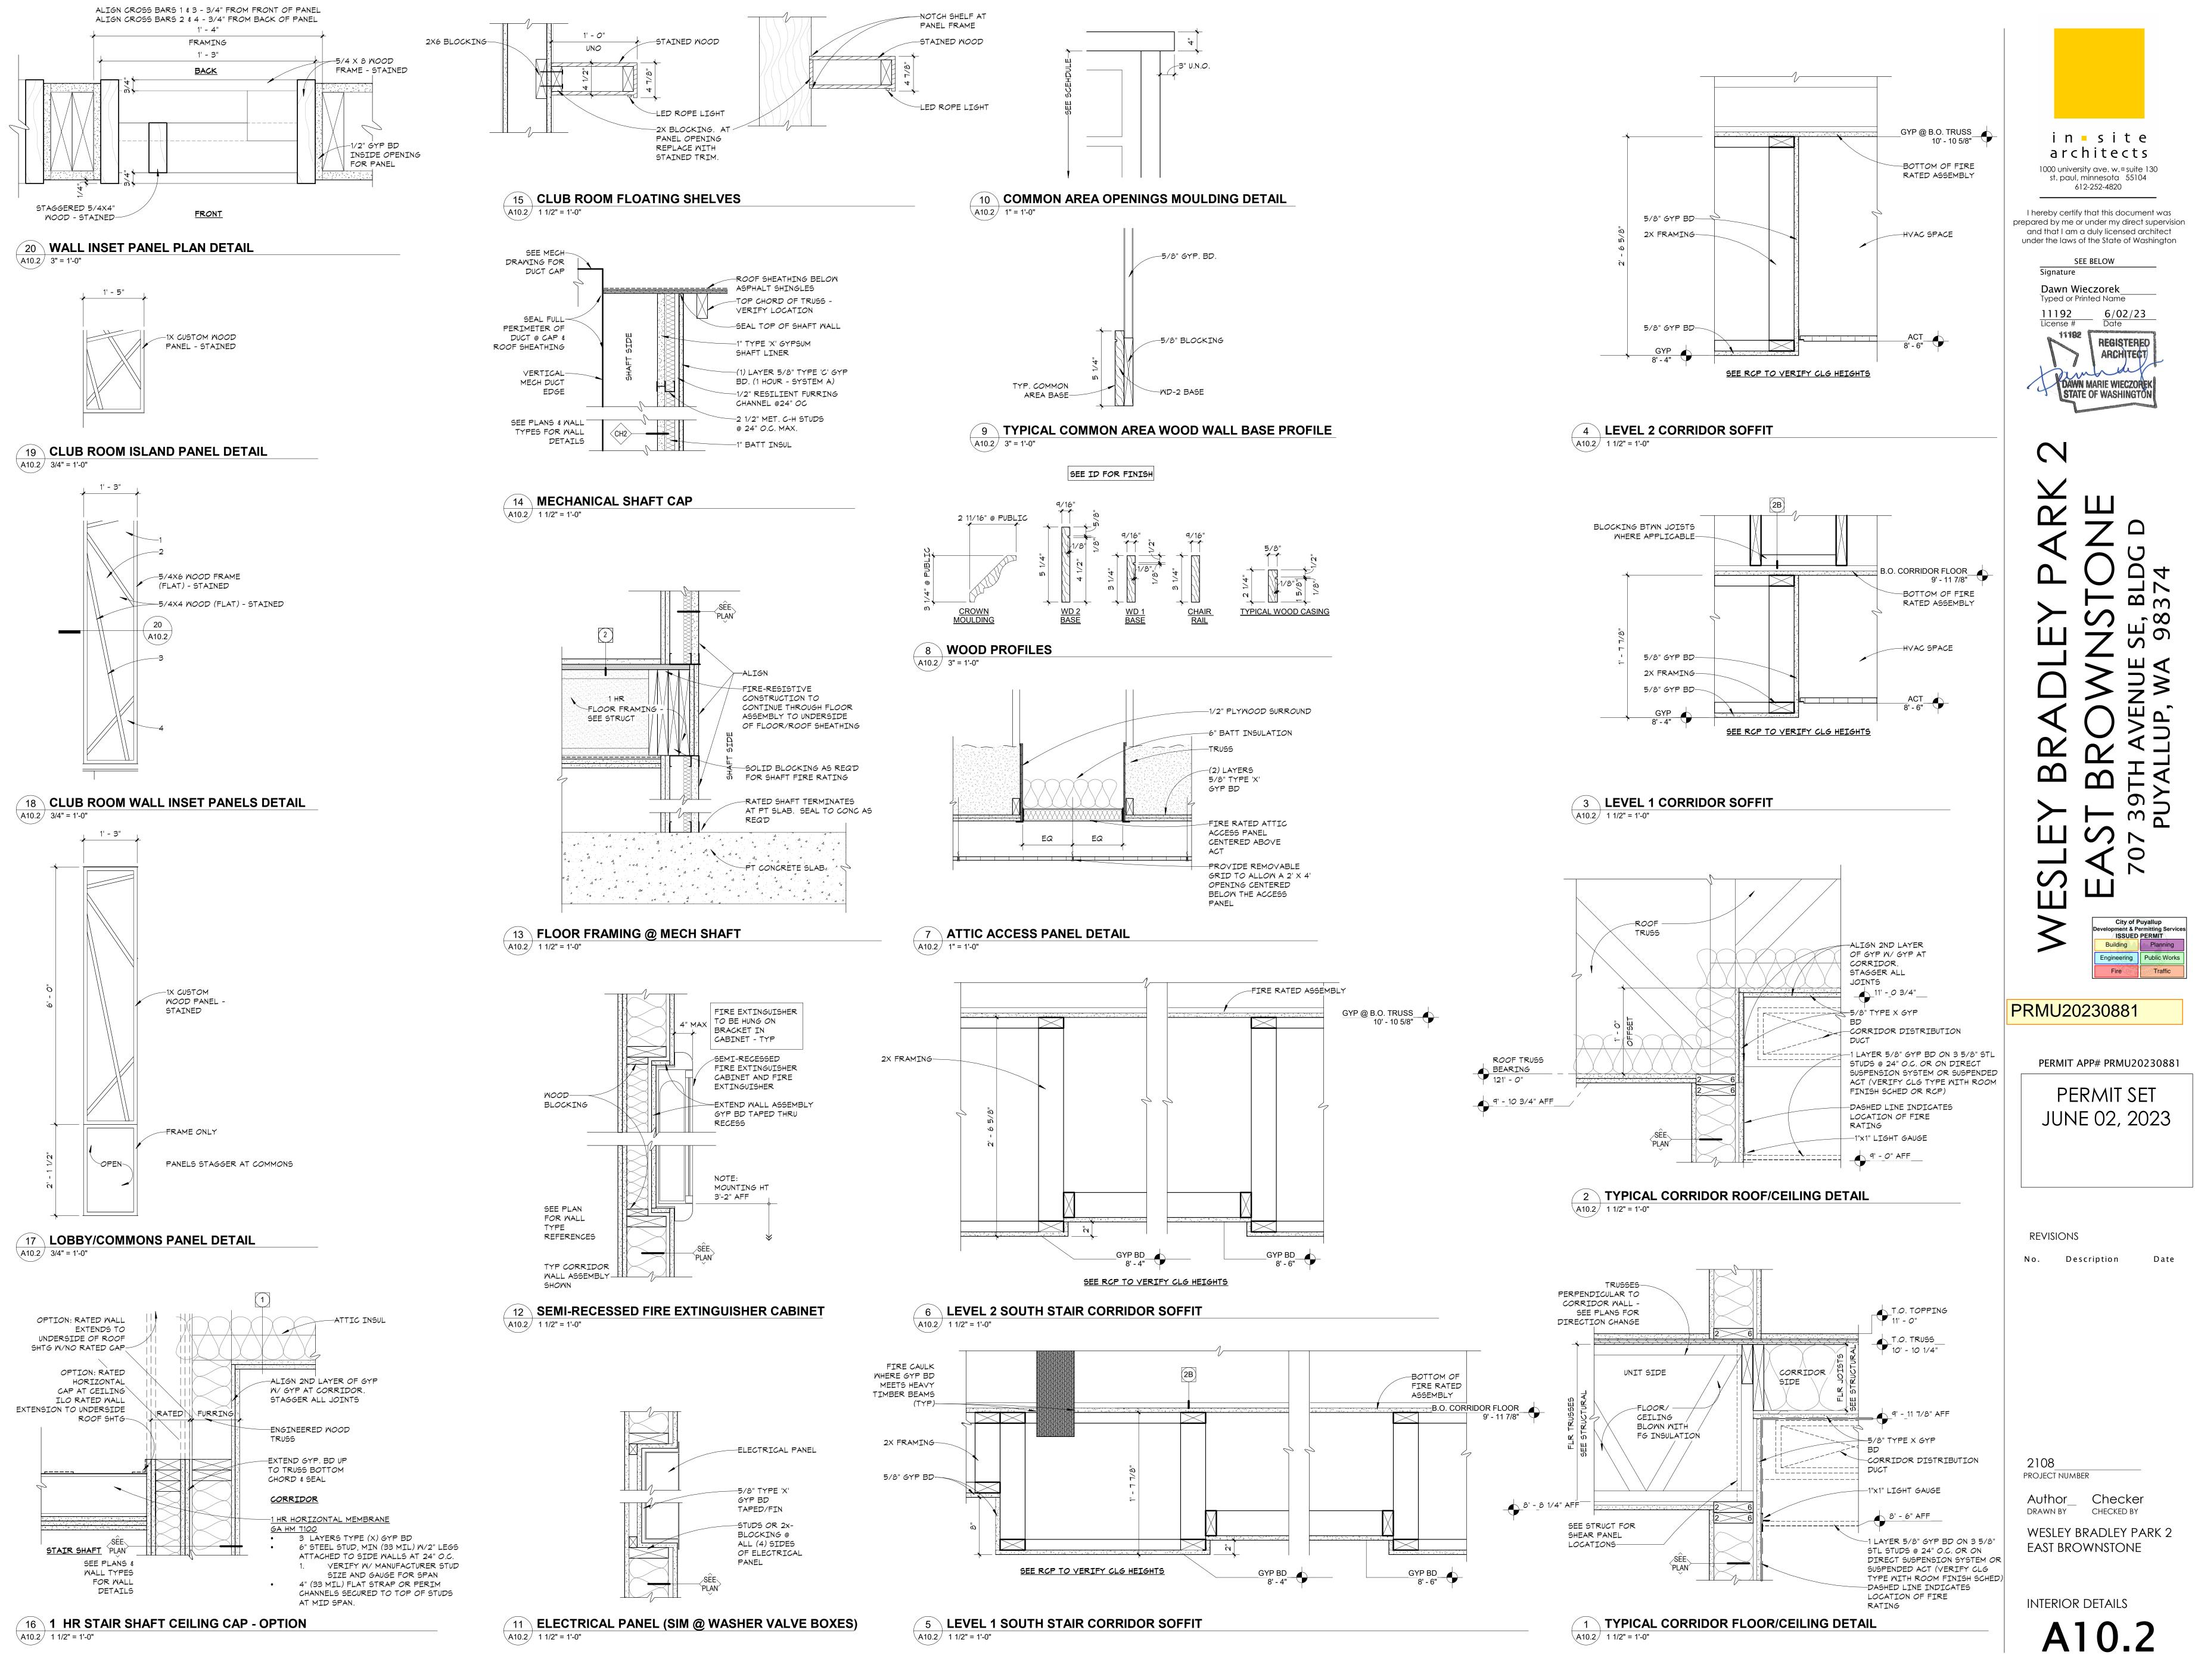


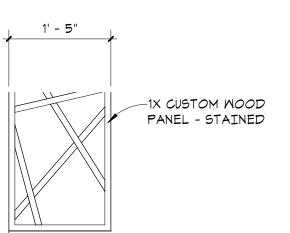


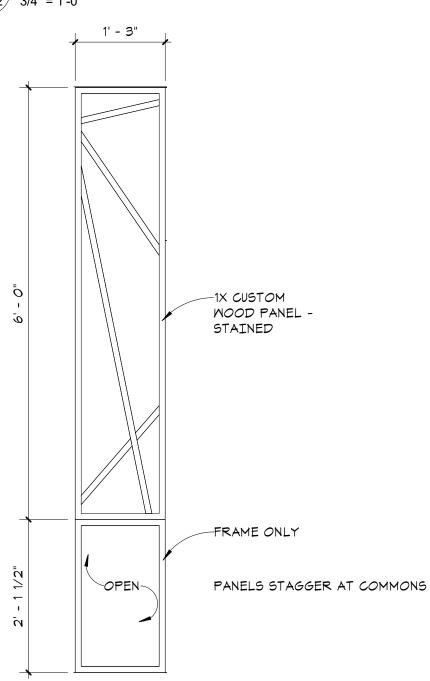


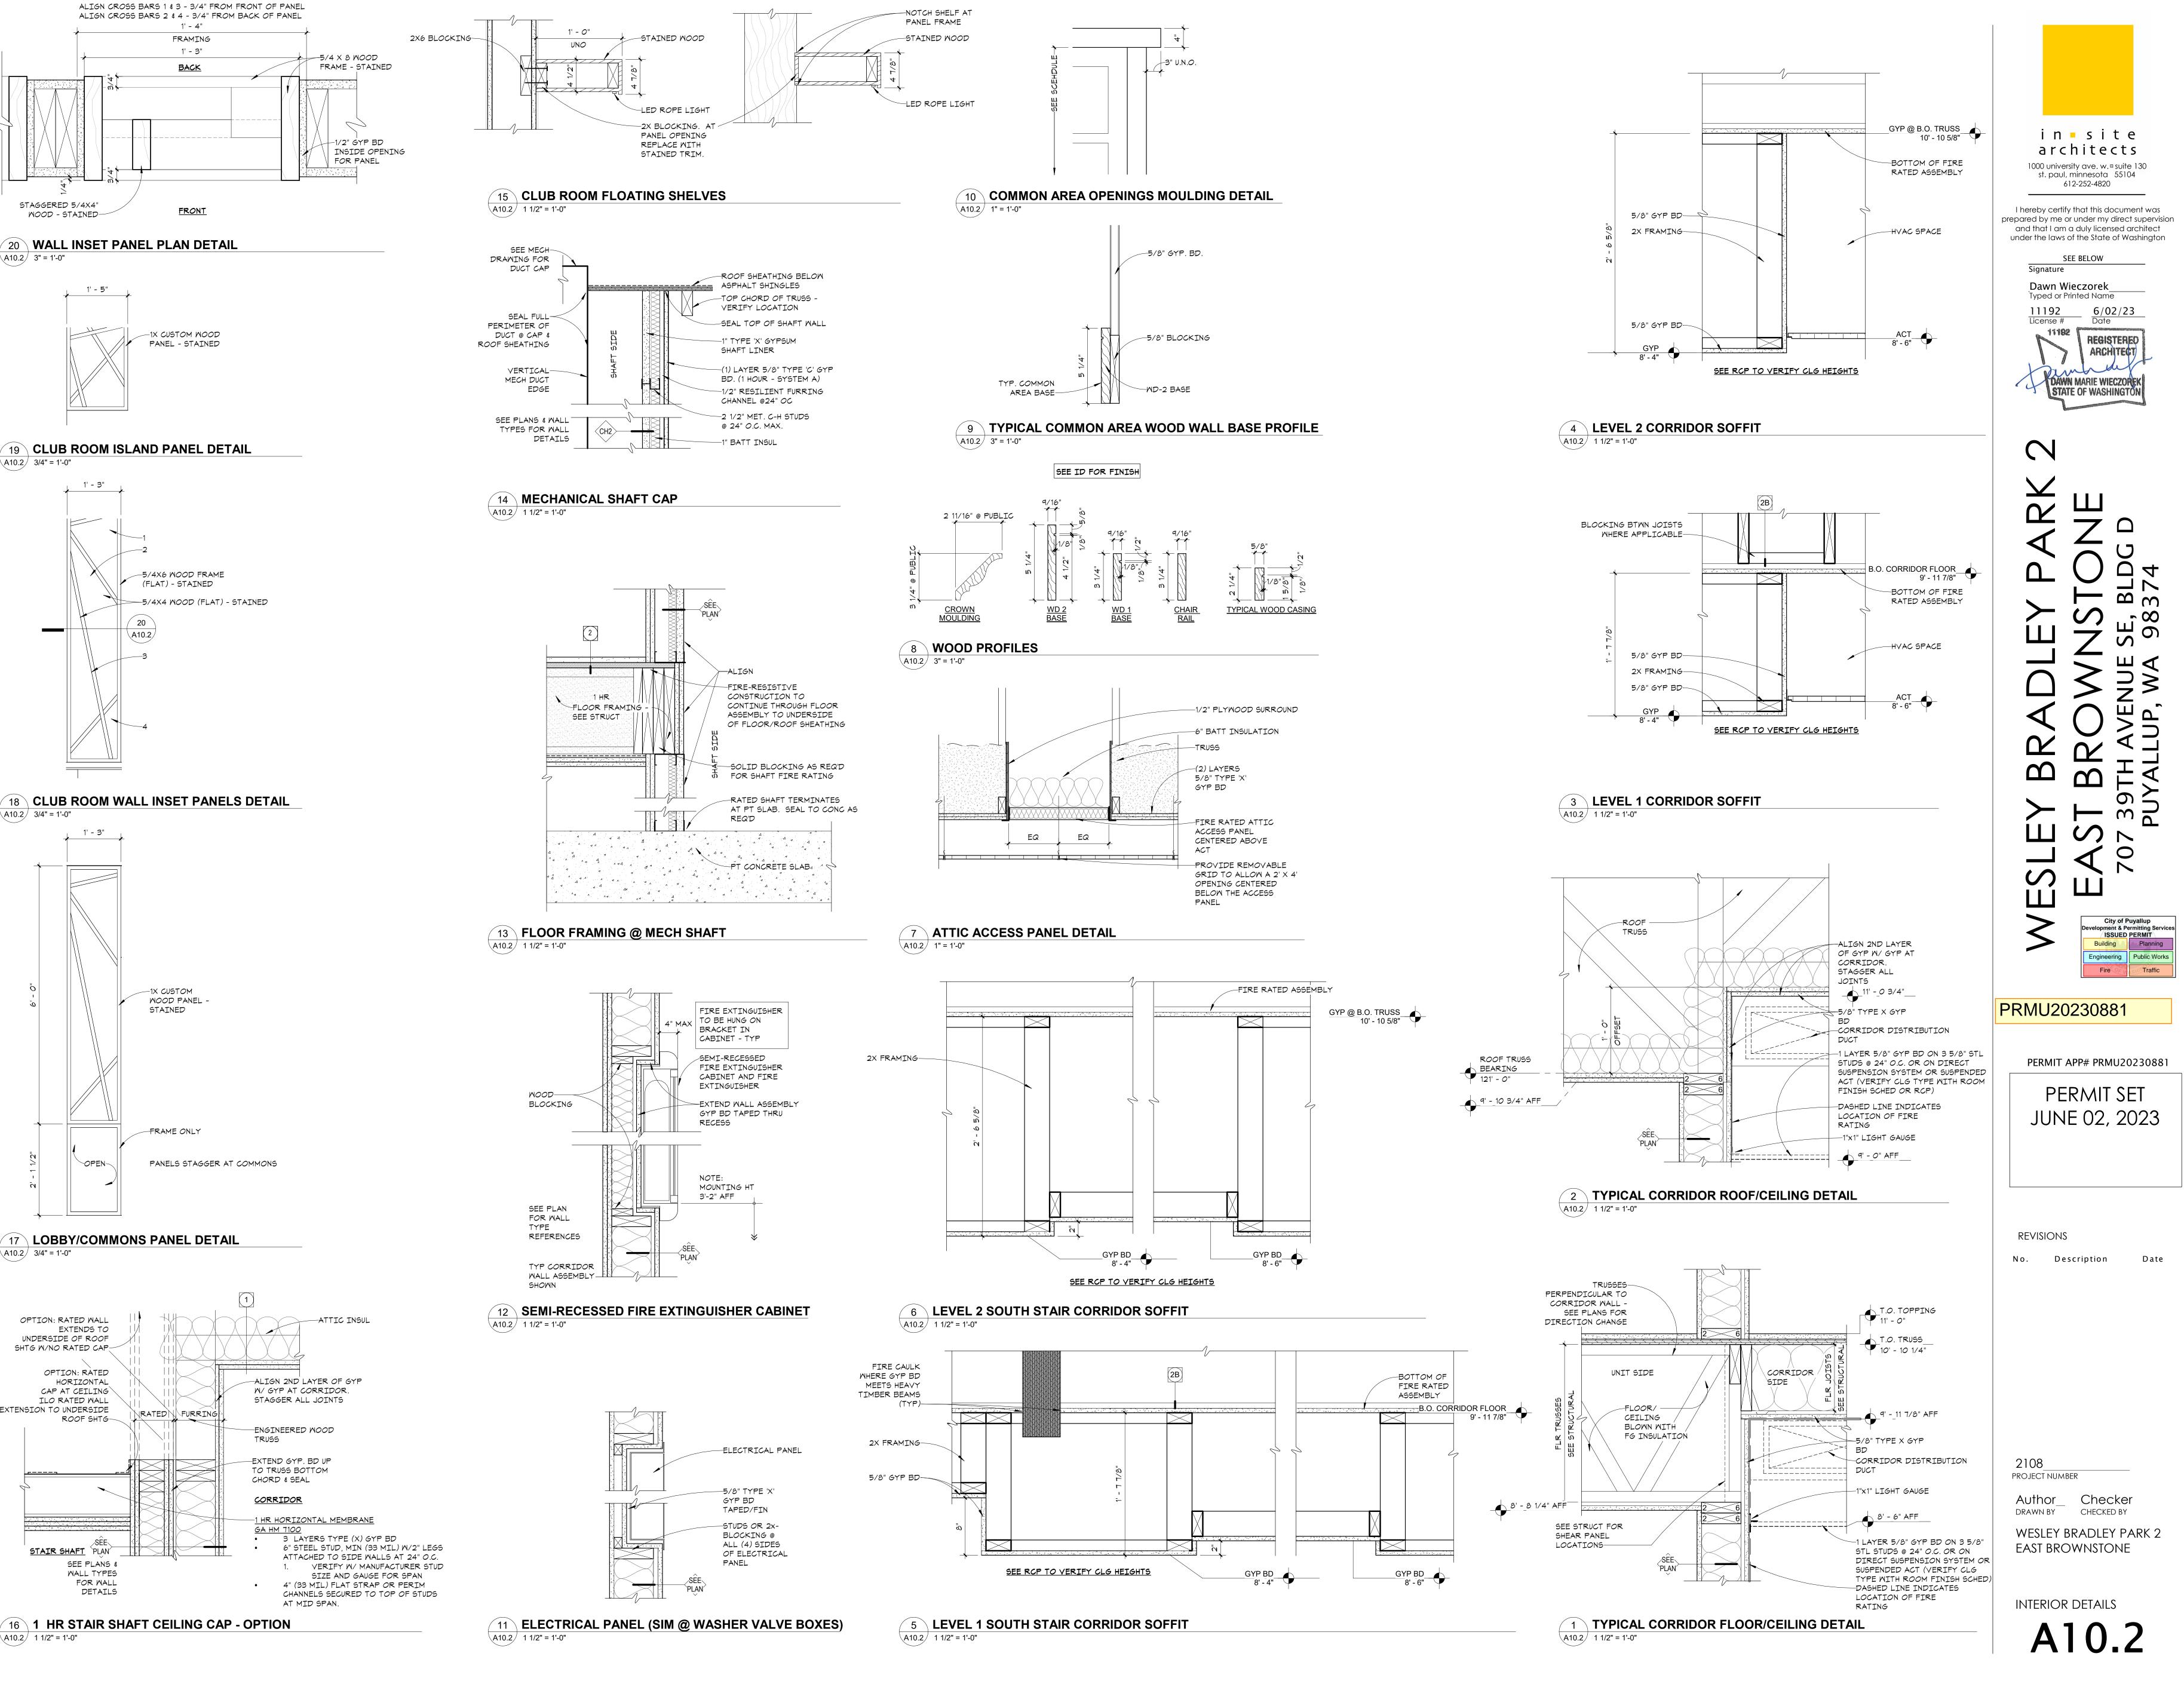

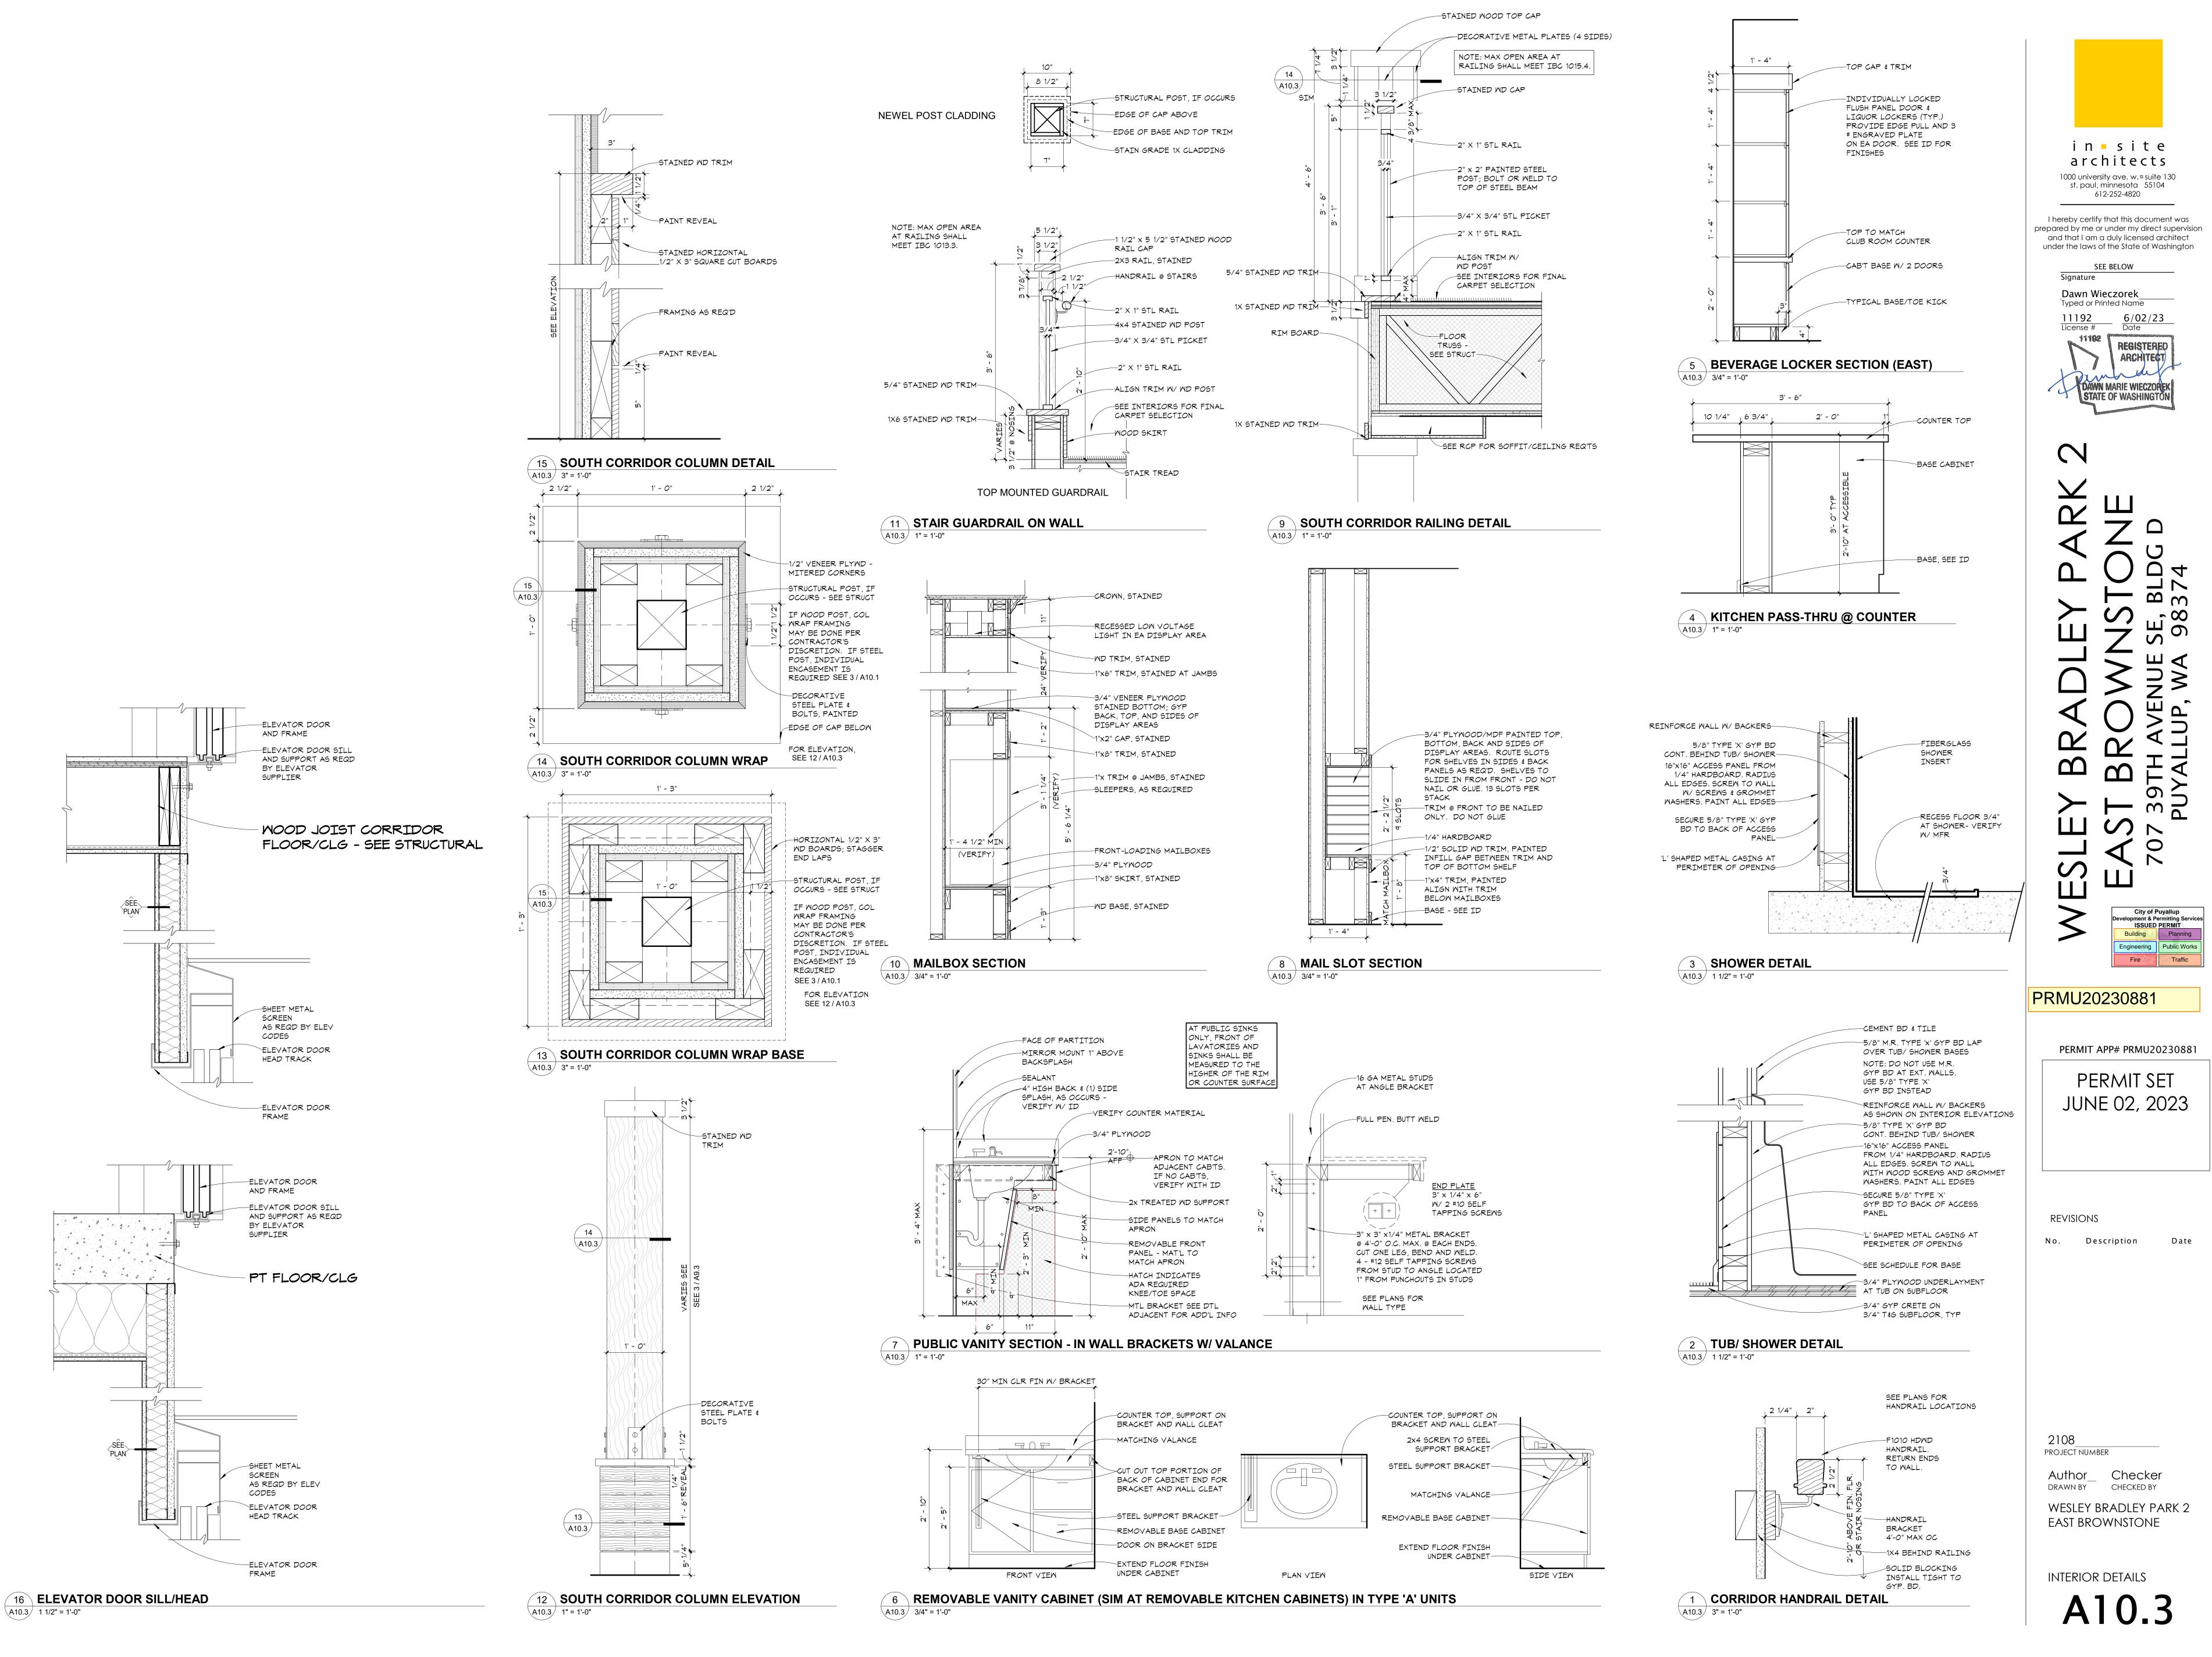

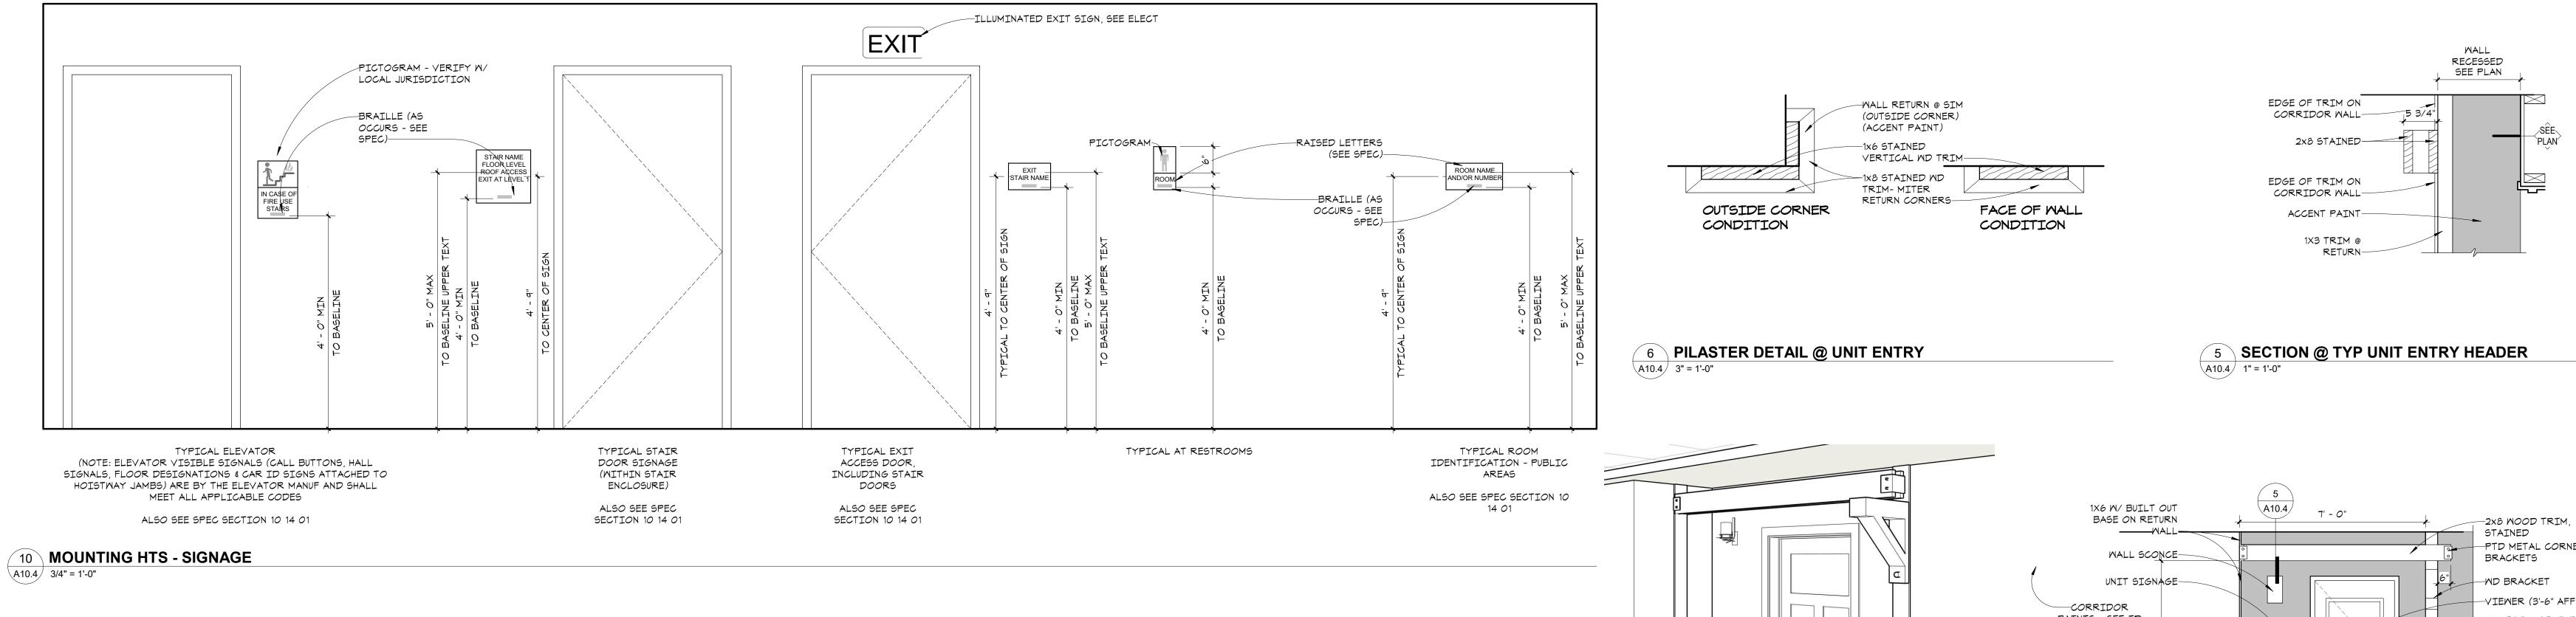

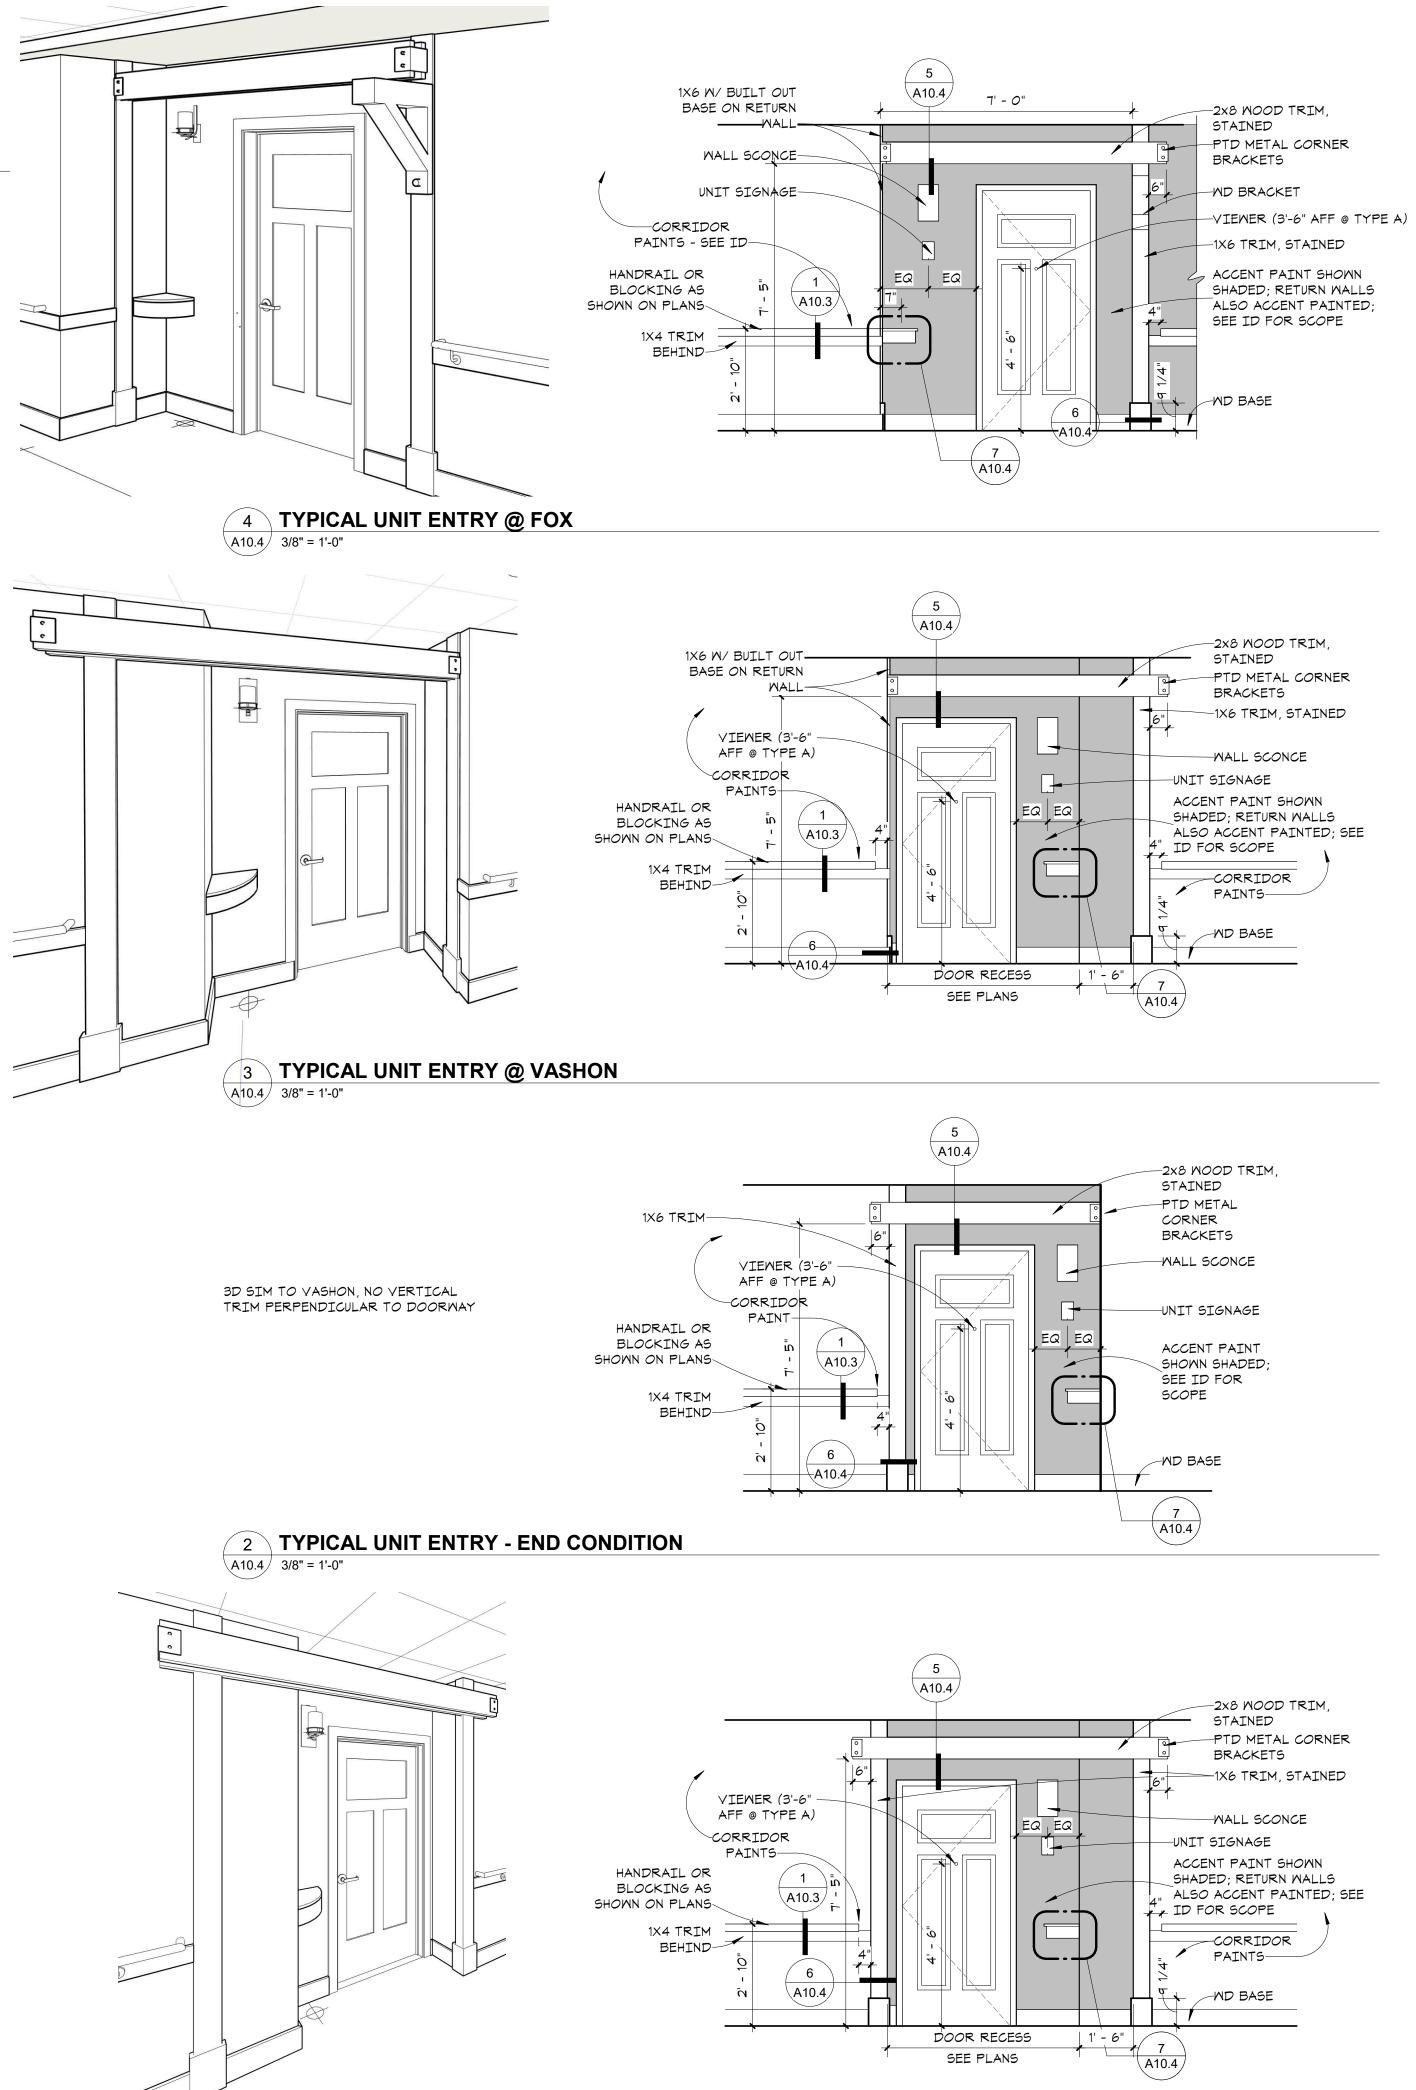


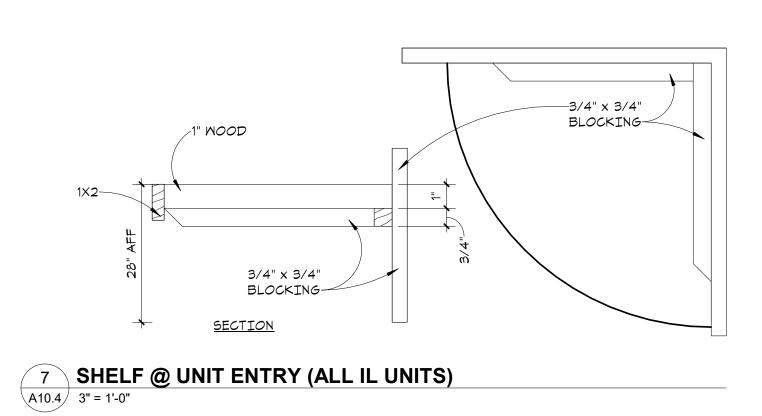


SEE PLANS


1 **TYPICAL UNIT ENTRY** A10.4 3/8" = 1'-0"

in site architects 1000 university ave. w. 🛚 suite 130 st. paul, minnesota 55104 612-252-4820 I hereby certify that this document was prepared by me or under my direct supervision and that I am a duly licensed architect under the laws of the State of Washington SEE BELOW Signature Dawn Wieczorek Typed or Printed Name 11192 6/02/23 License # Date 11192 REGISTERE ARCHITECT STATE OF WAS N \neg Δ m $r \infty$ ЩО \exists 7 ے ل Δ $\mathbf{\Omega}$ M $o \leq$ т М 0 \mathcal{O} Ш City of Puyallup evelopment & Permitting Services ISSUED PERMIT Building Planning EngineeringPublic WorksFireTraffic PRMU20230881 PERMIT APP# PRMU20230881 PERMIT SET JUNE 02, 2023 REVISIONS No. Description Date 2108_ PROJECT NUMBER Author_ Checker DRAWN BY CHECKED BY WESLEY BRADLEY PARK 2 EAST BROWNSTONE INTERIOR DETAILS A10.4

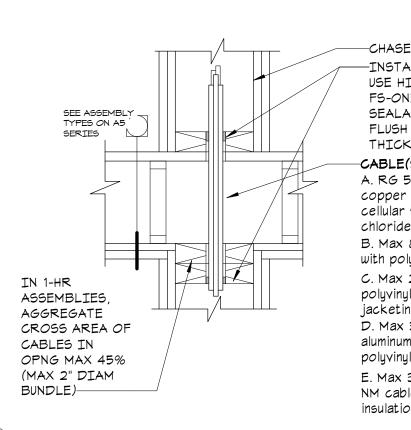

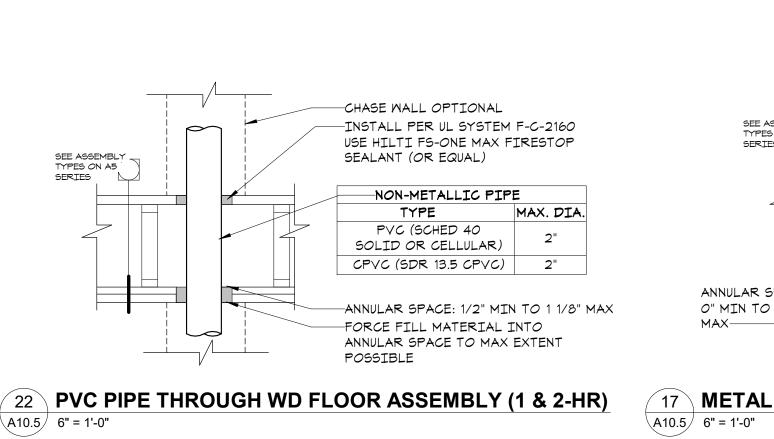



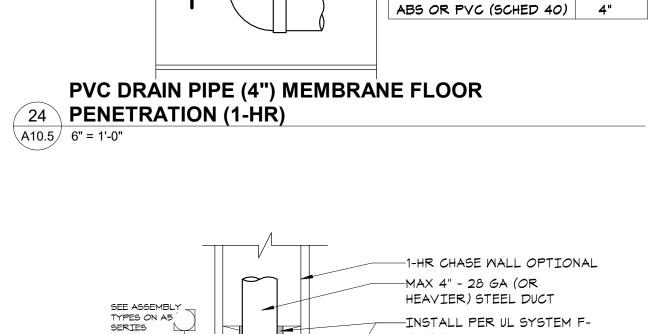

-CLOSET FLANGE - ABS OR PVC;

FLOOR OPNG 1/2" MAX LARGER

-NON-METALLIC PIPE

MAX. DIA.

THAN OUTSIDE DIAM OF

TYPE

CLOSET FLANGE

SEE ASSEMBLY TYPES ON A5 SERIES

INSTALL PER UL


FS-ONE MAX


SYSTEM F-C-2203 MIN


3/4" THICKNESS HILTI


FS-ONE SEALANT OR


INTUMESCENT SEALANT

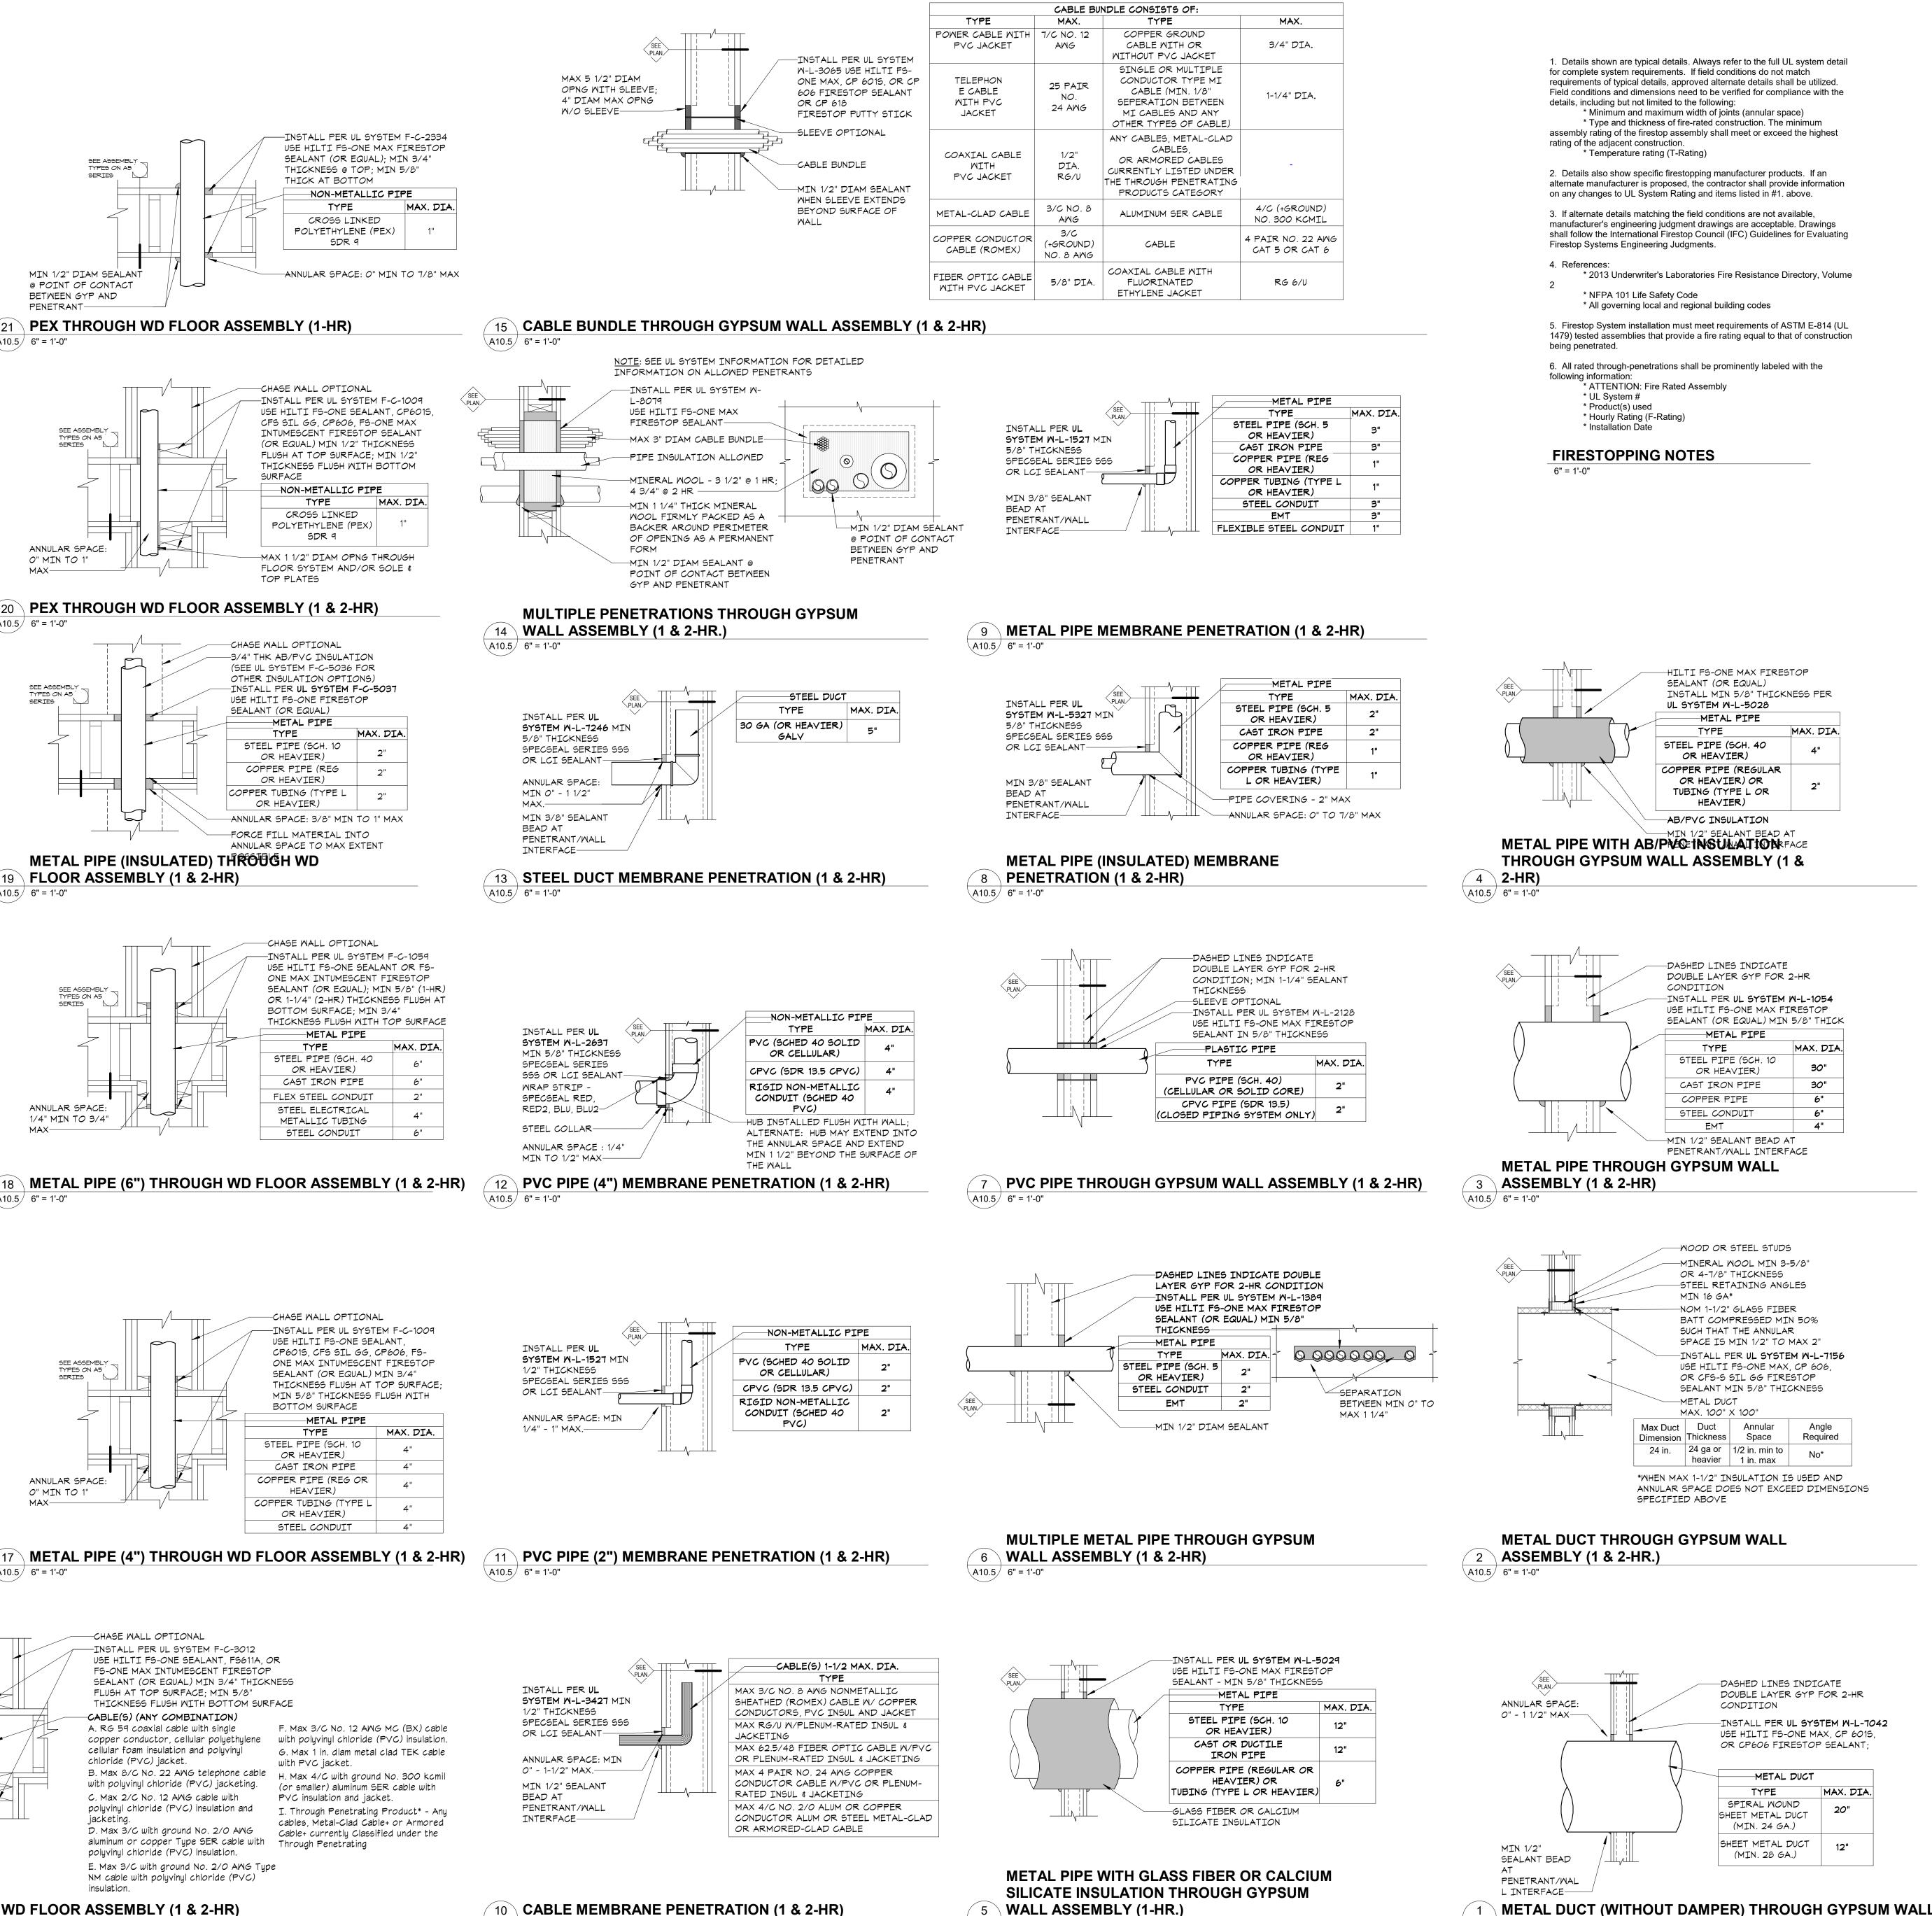

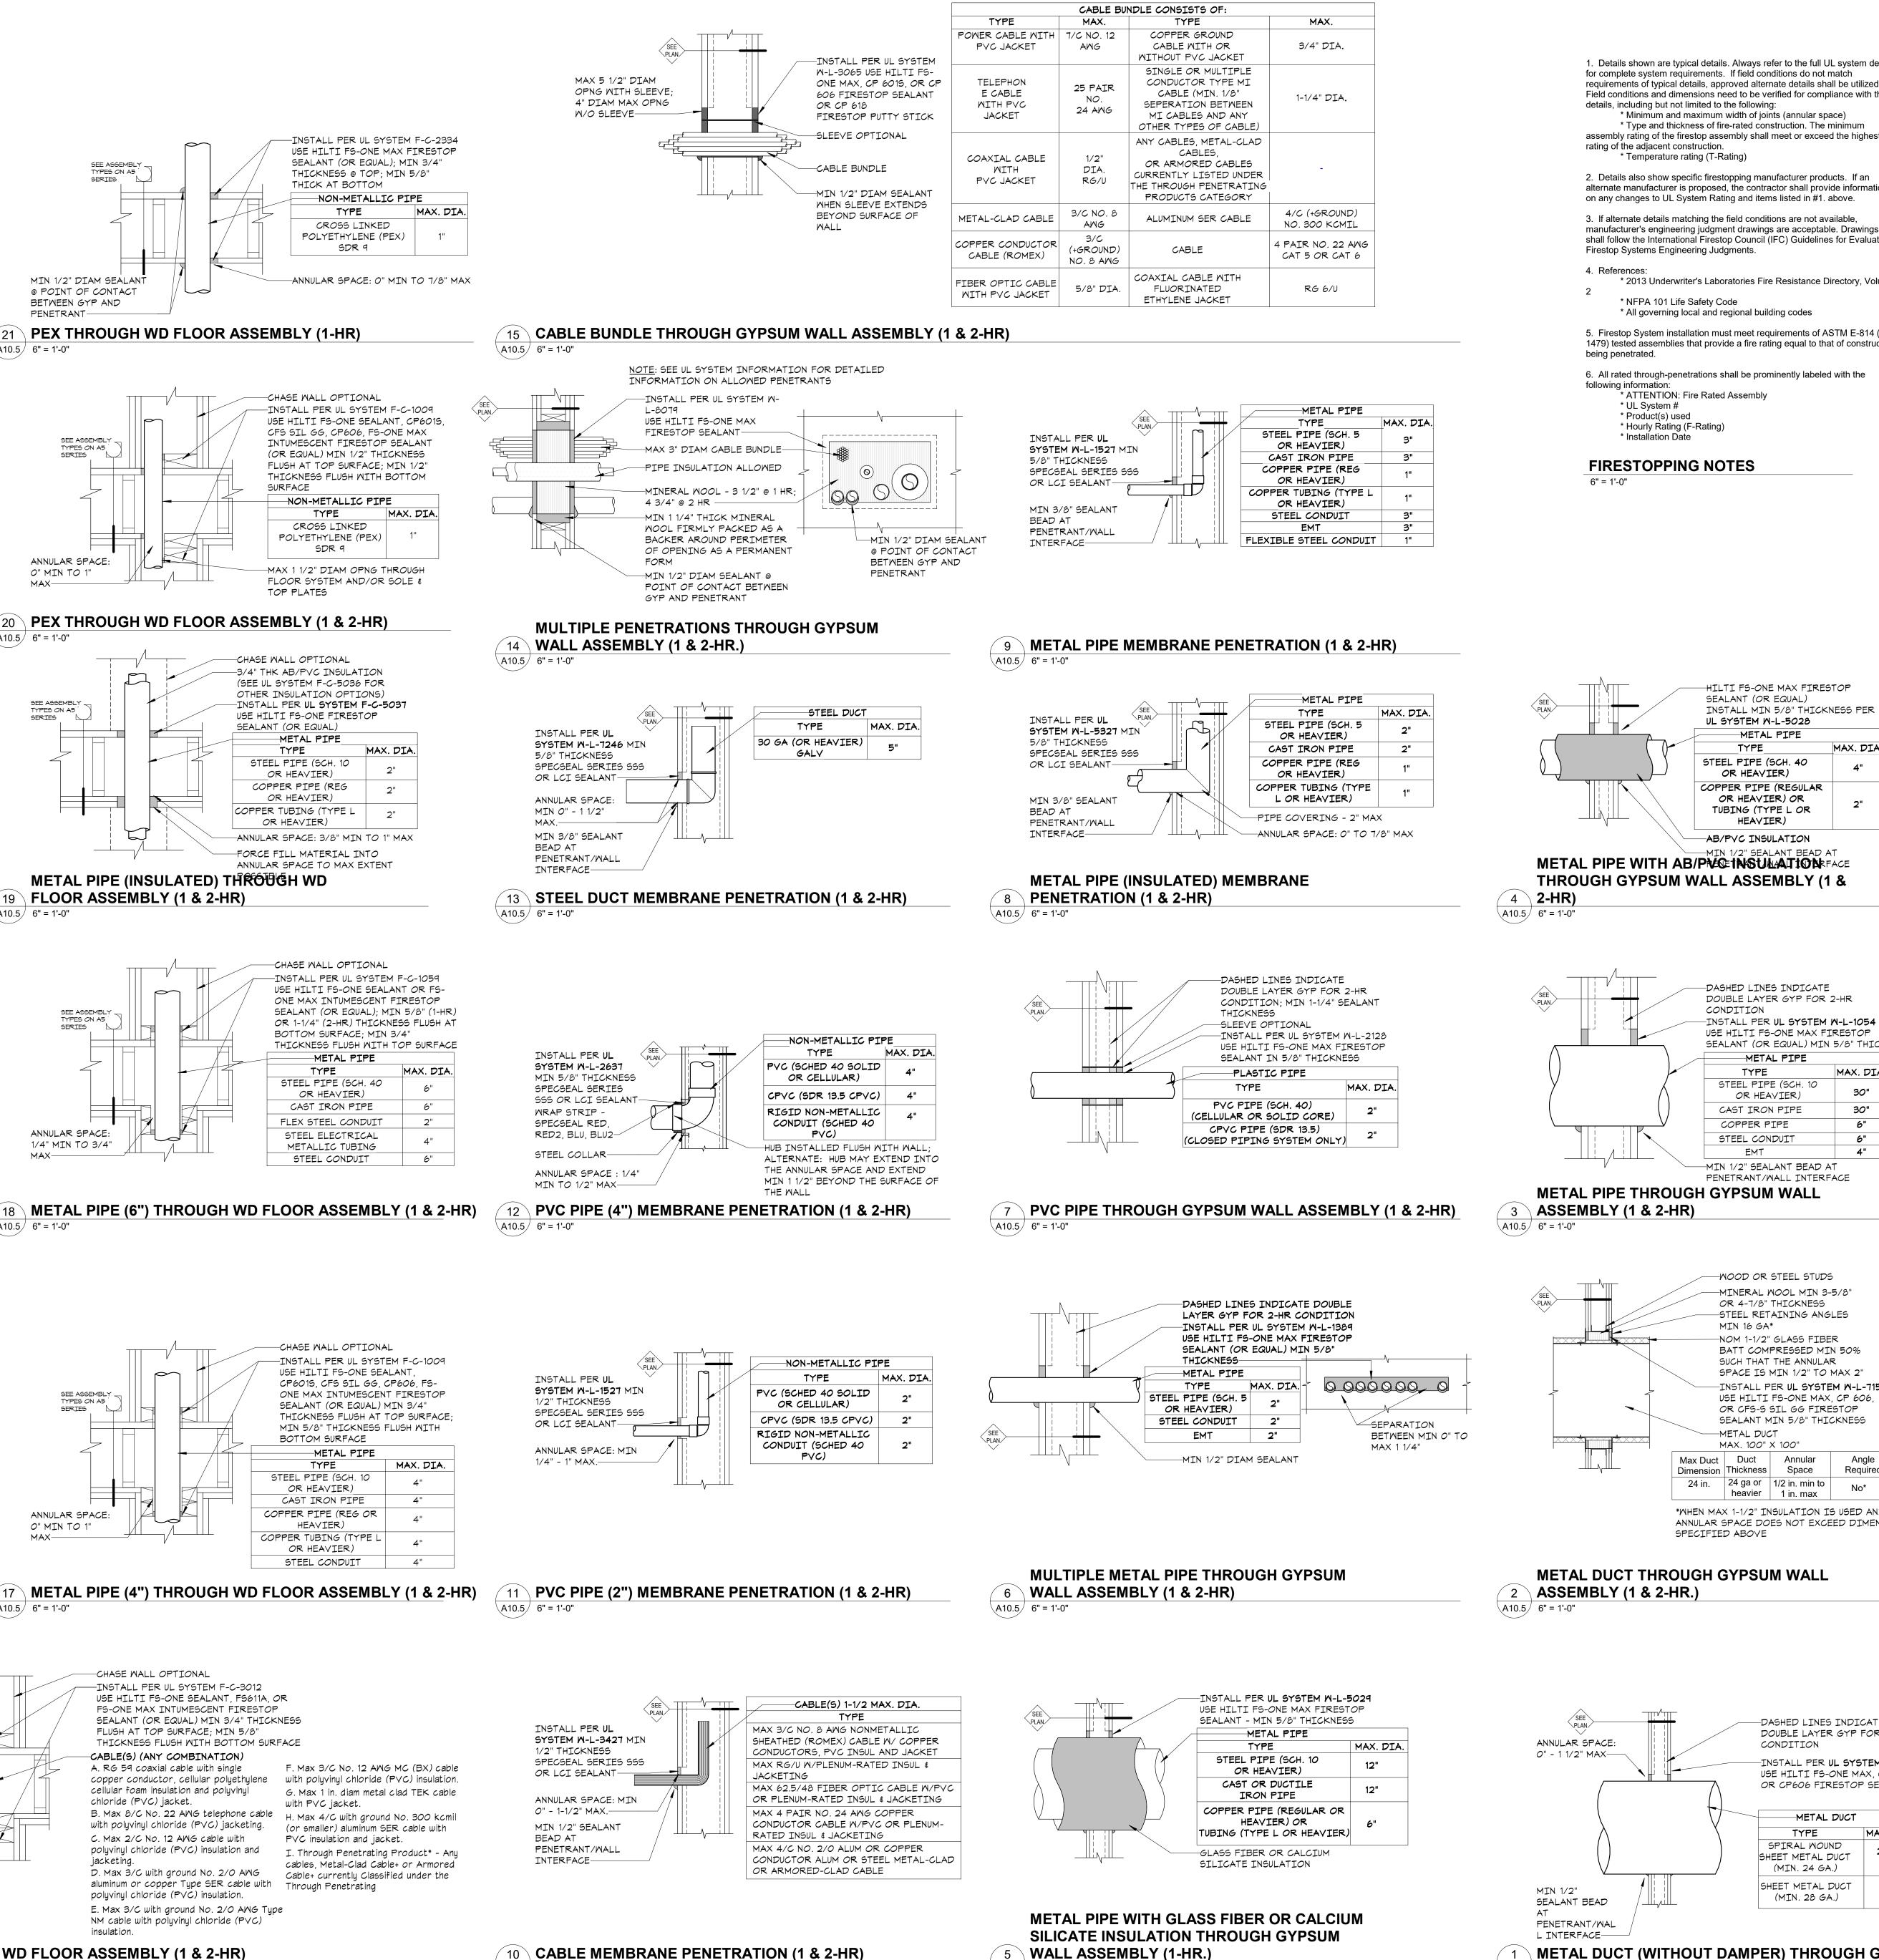


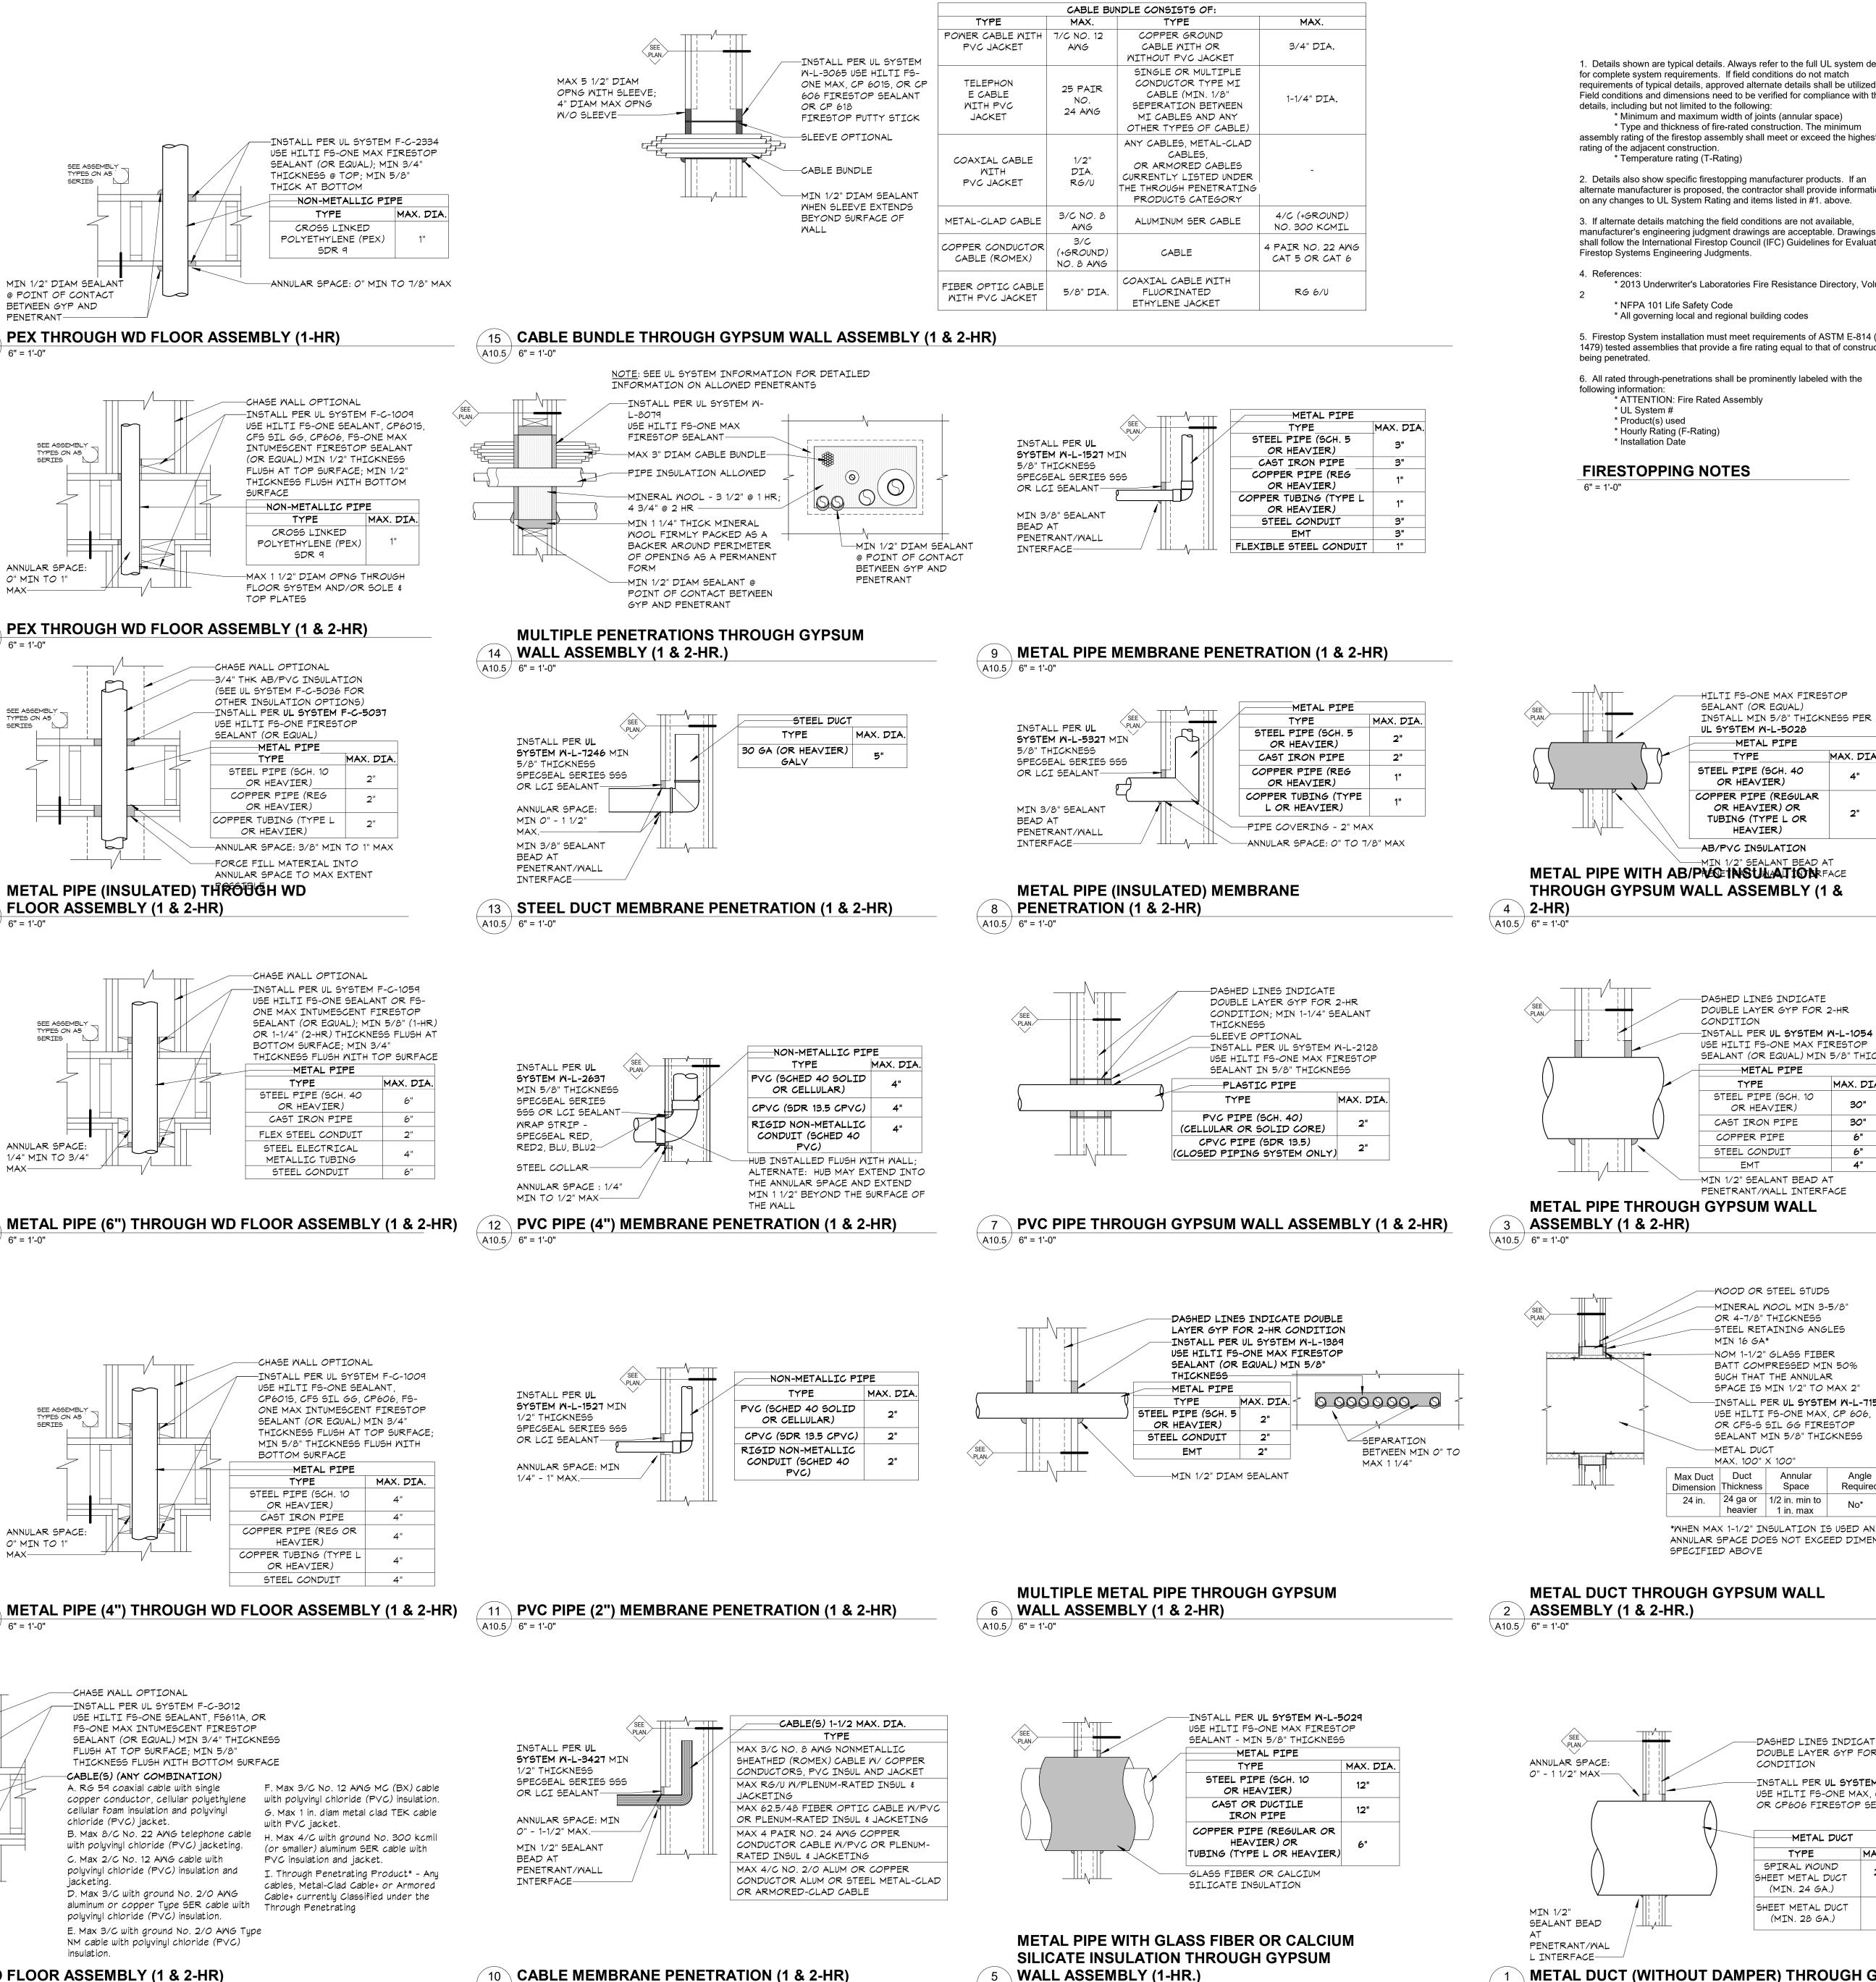

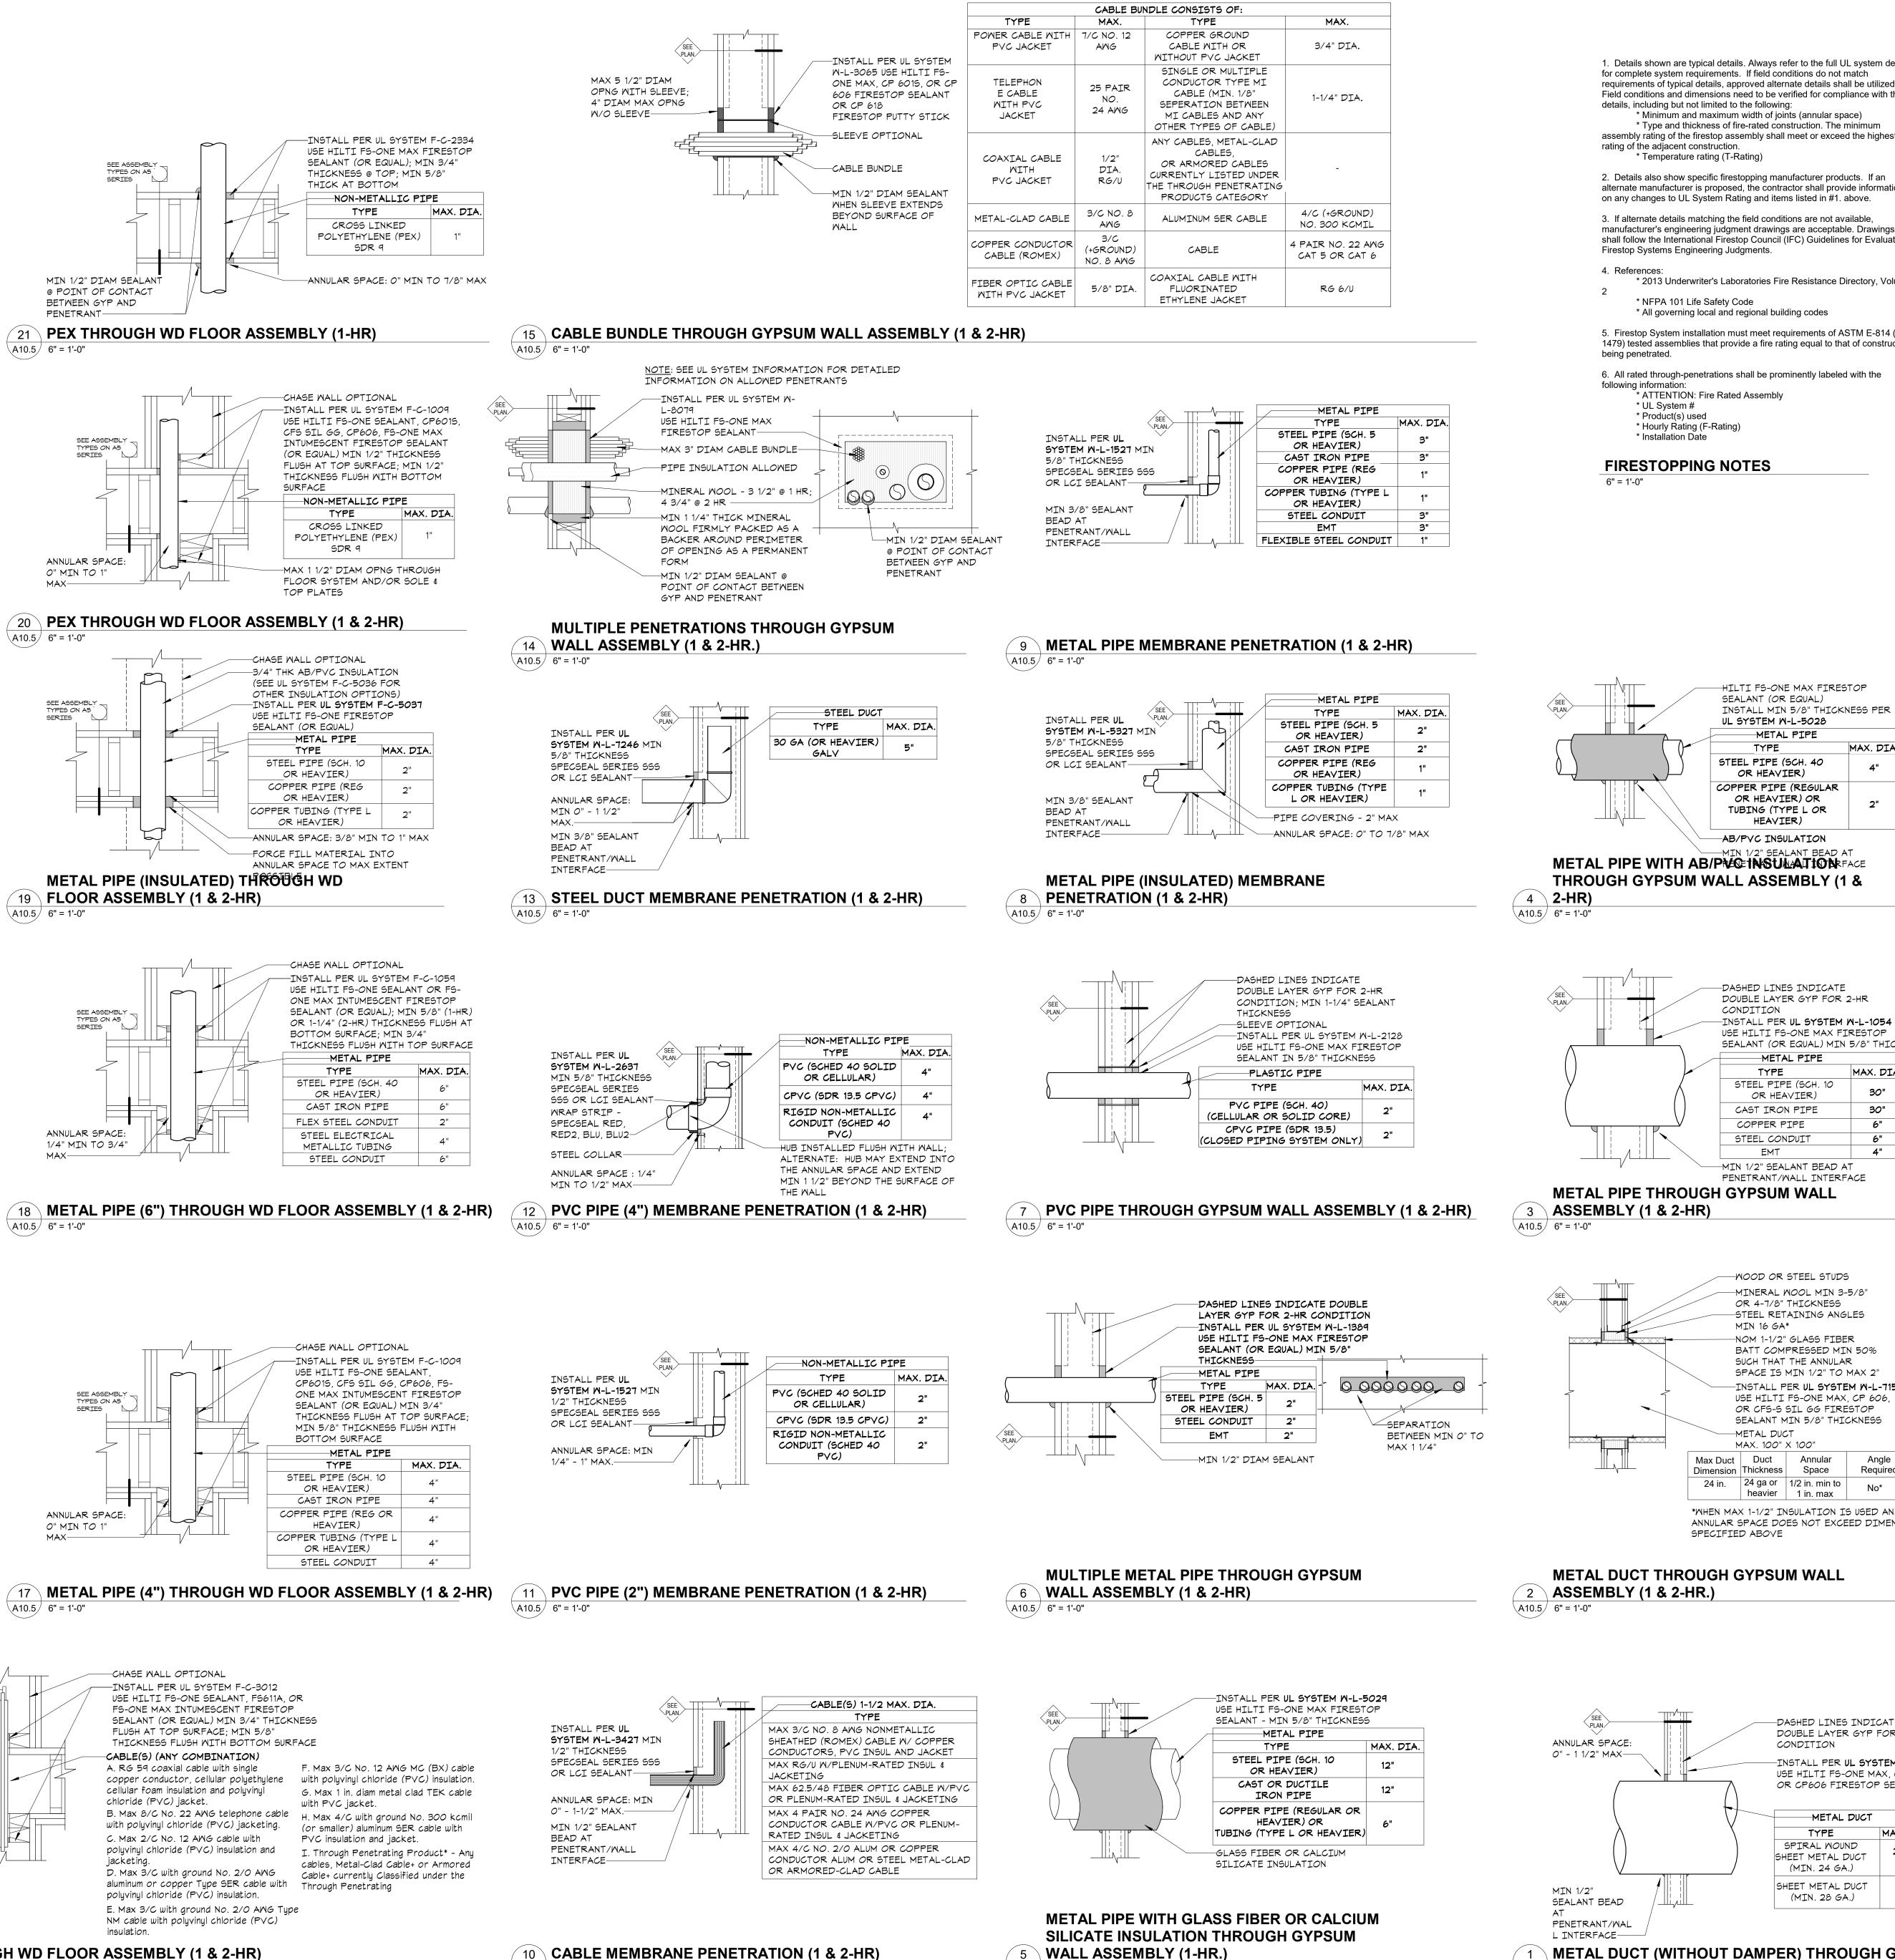

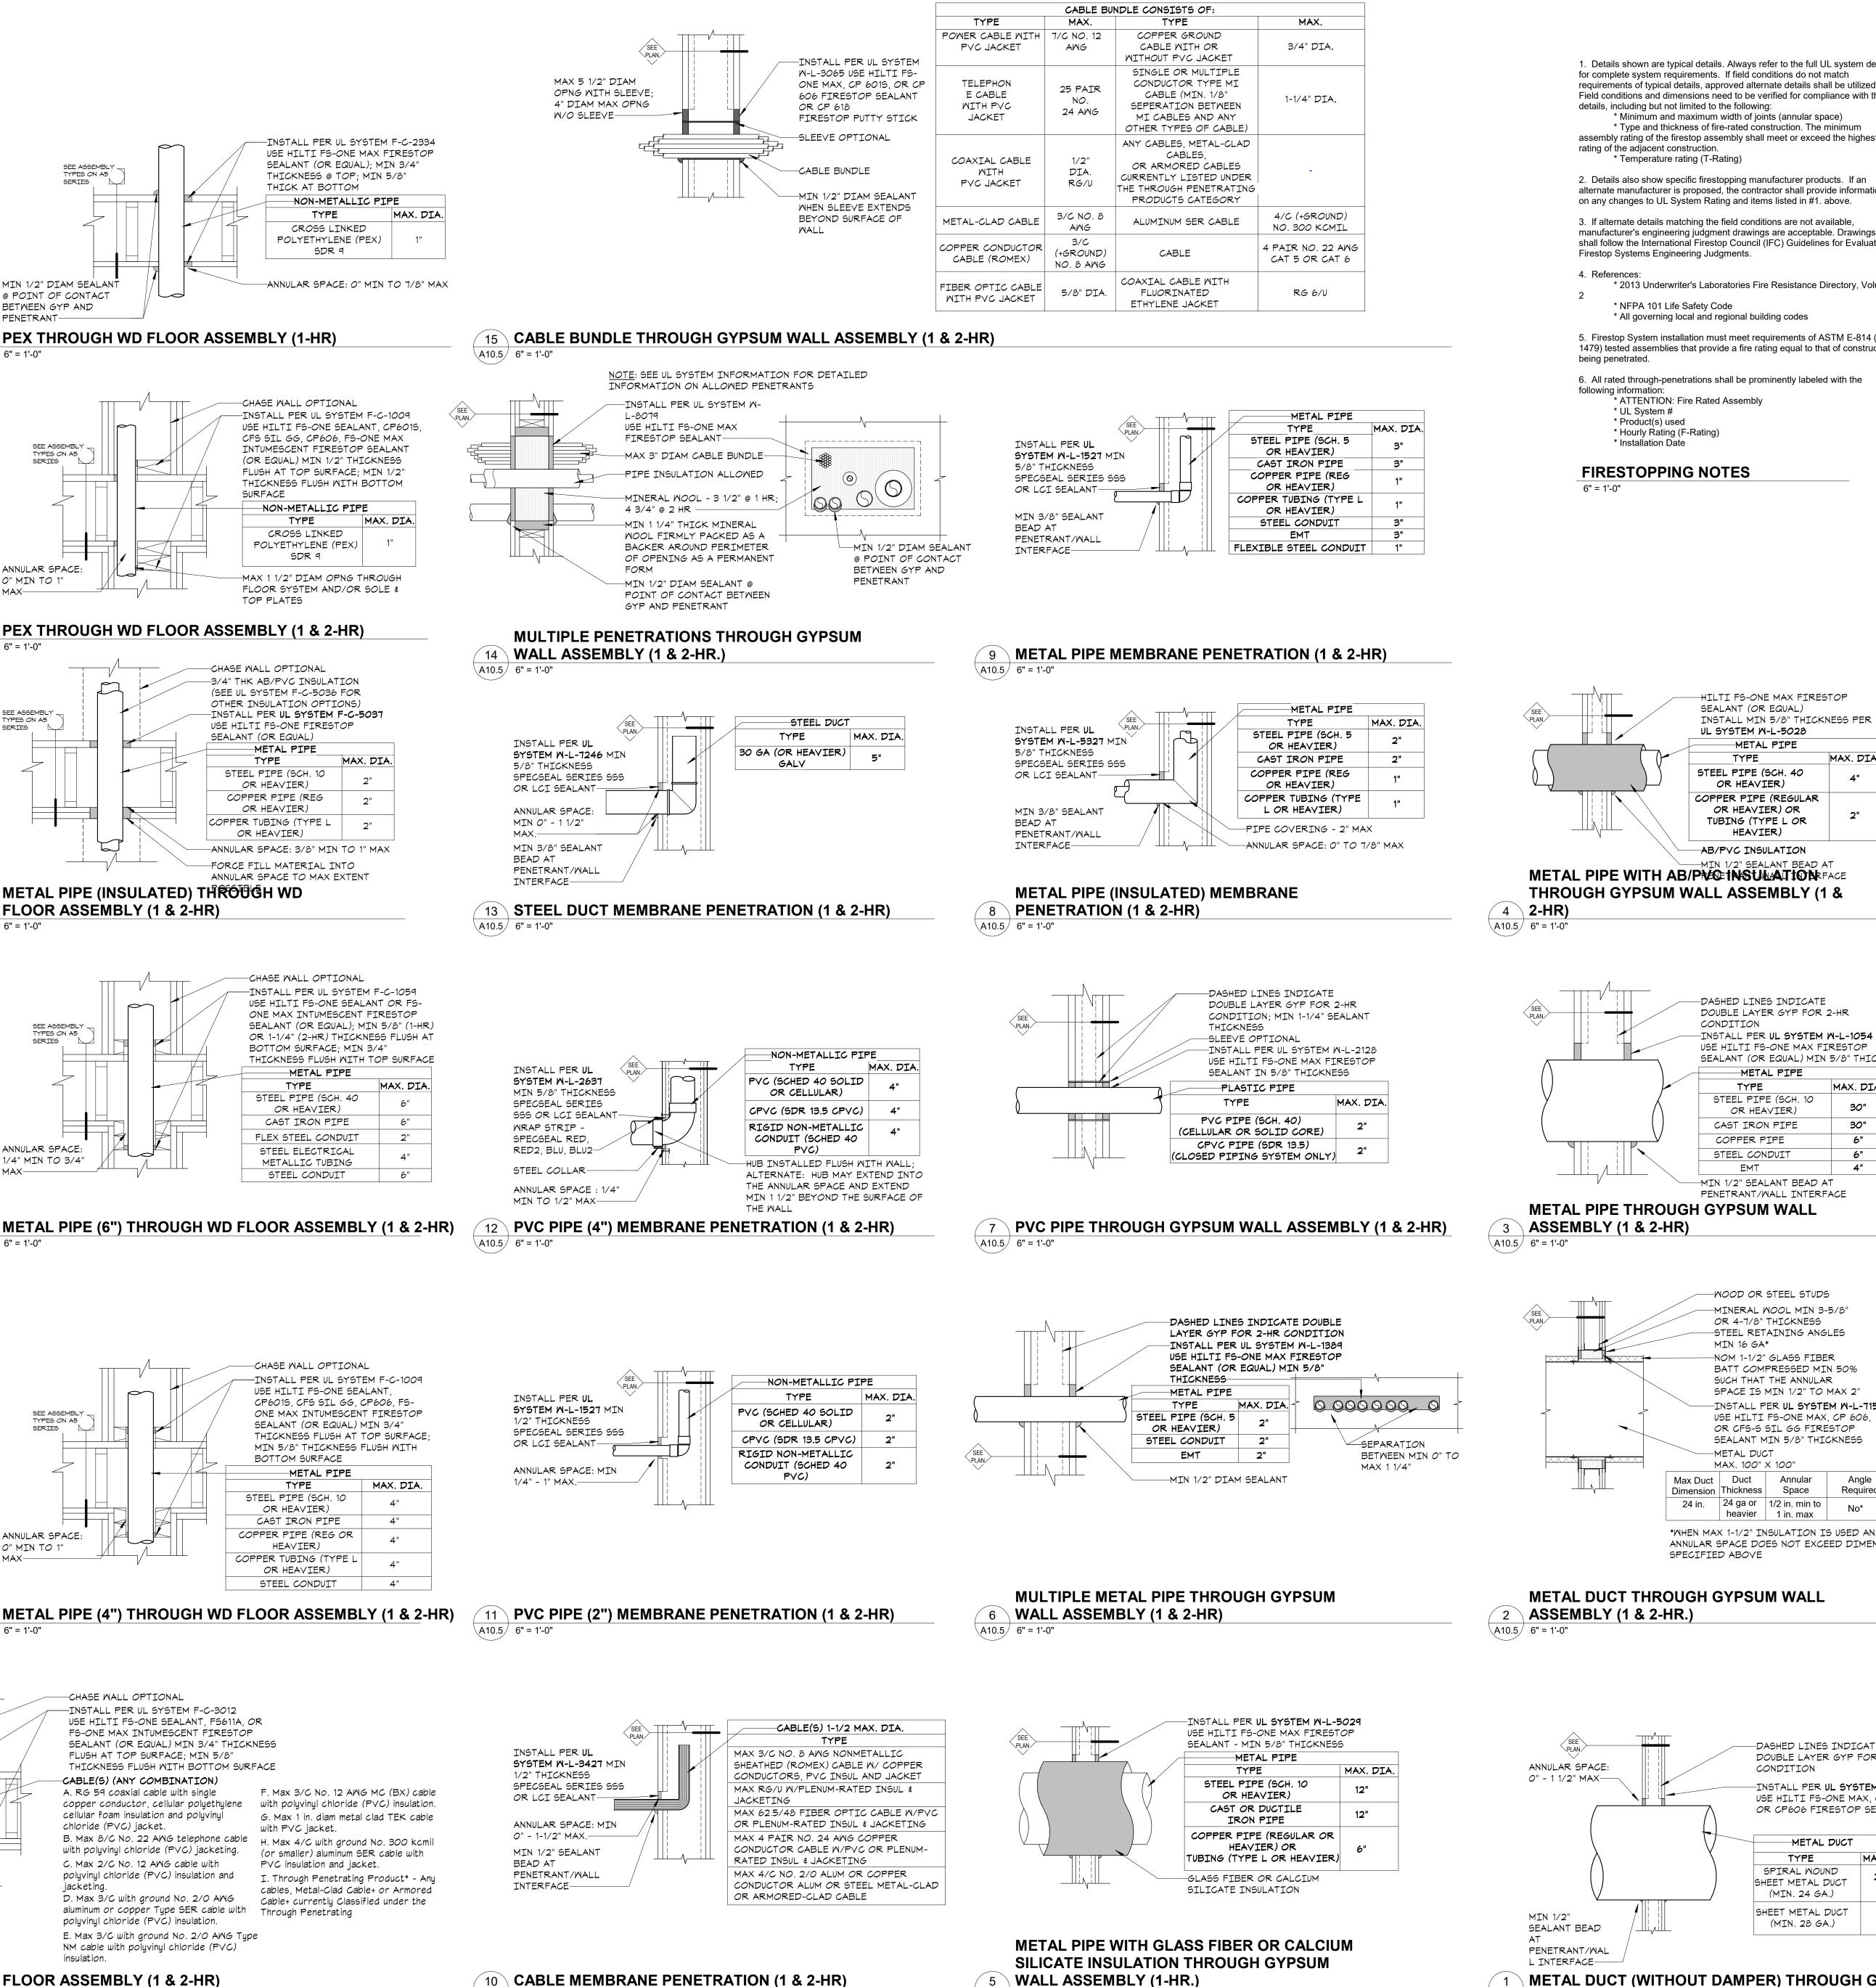


∖A10.5∕ 6" = 1'-0"

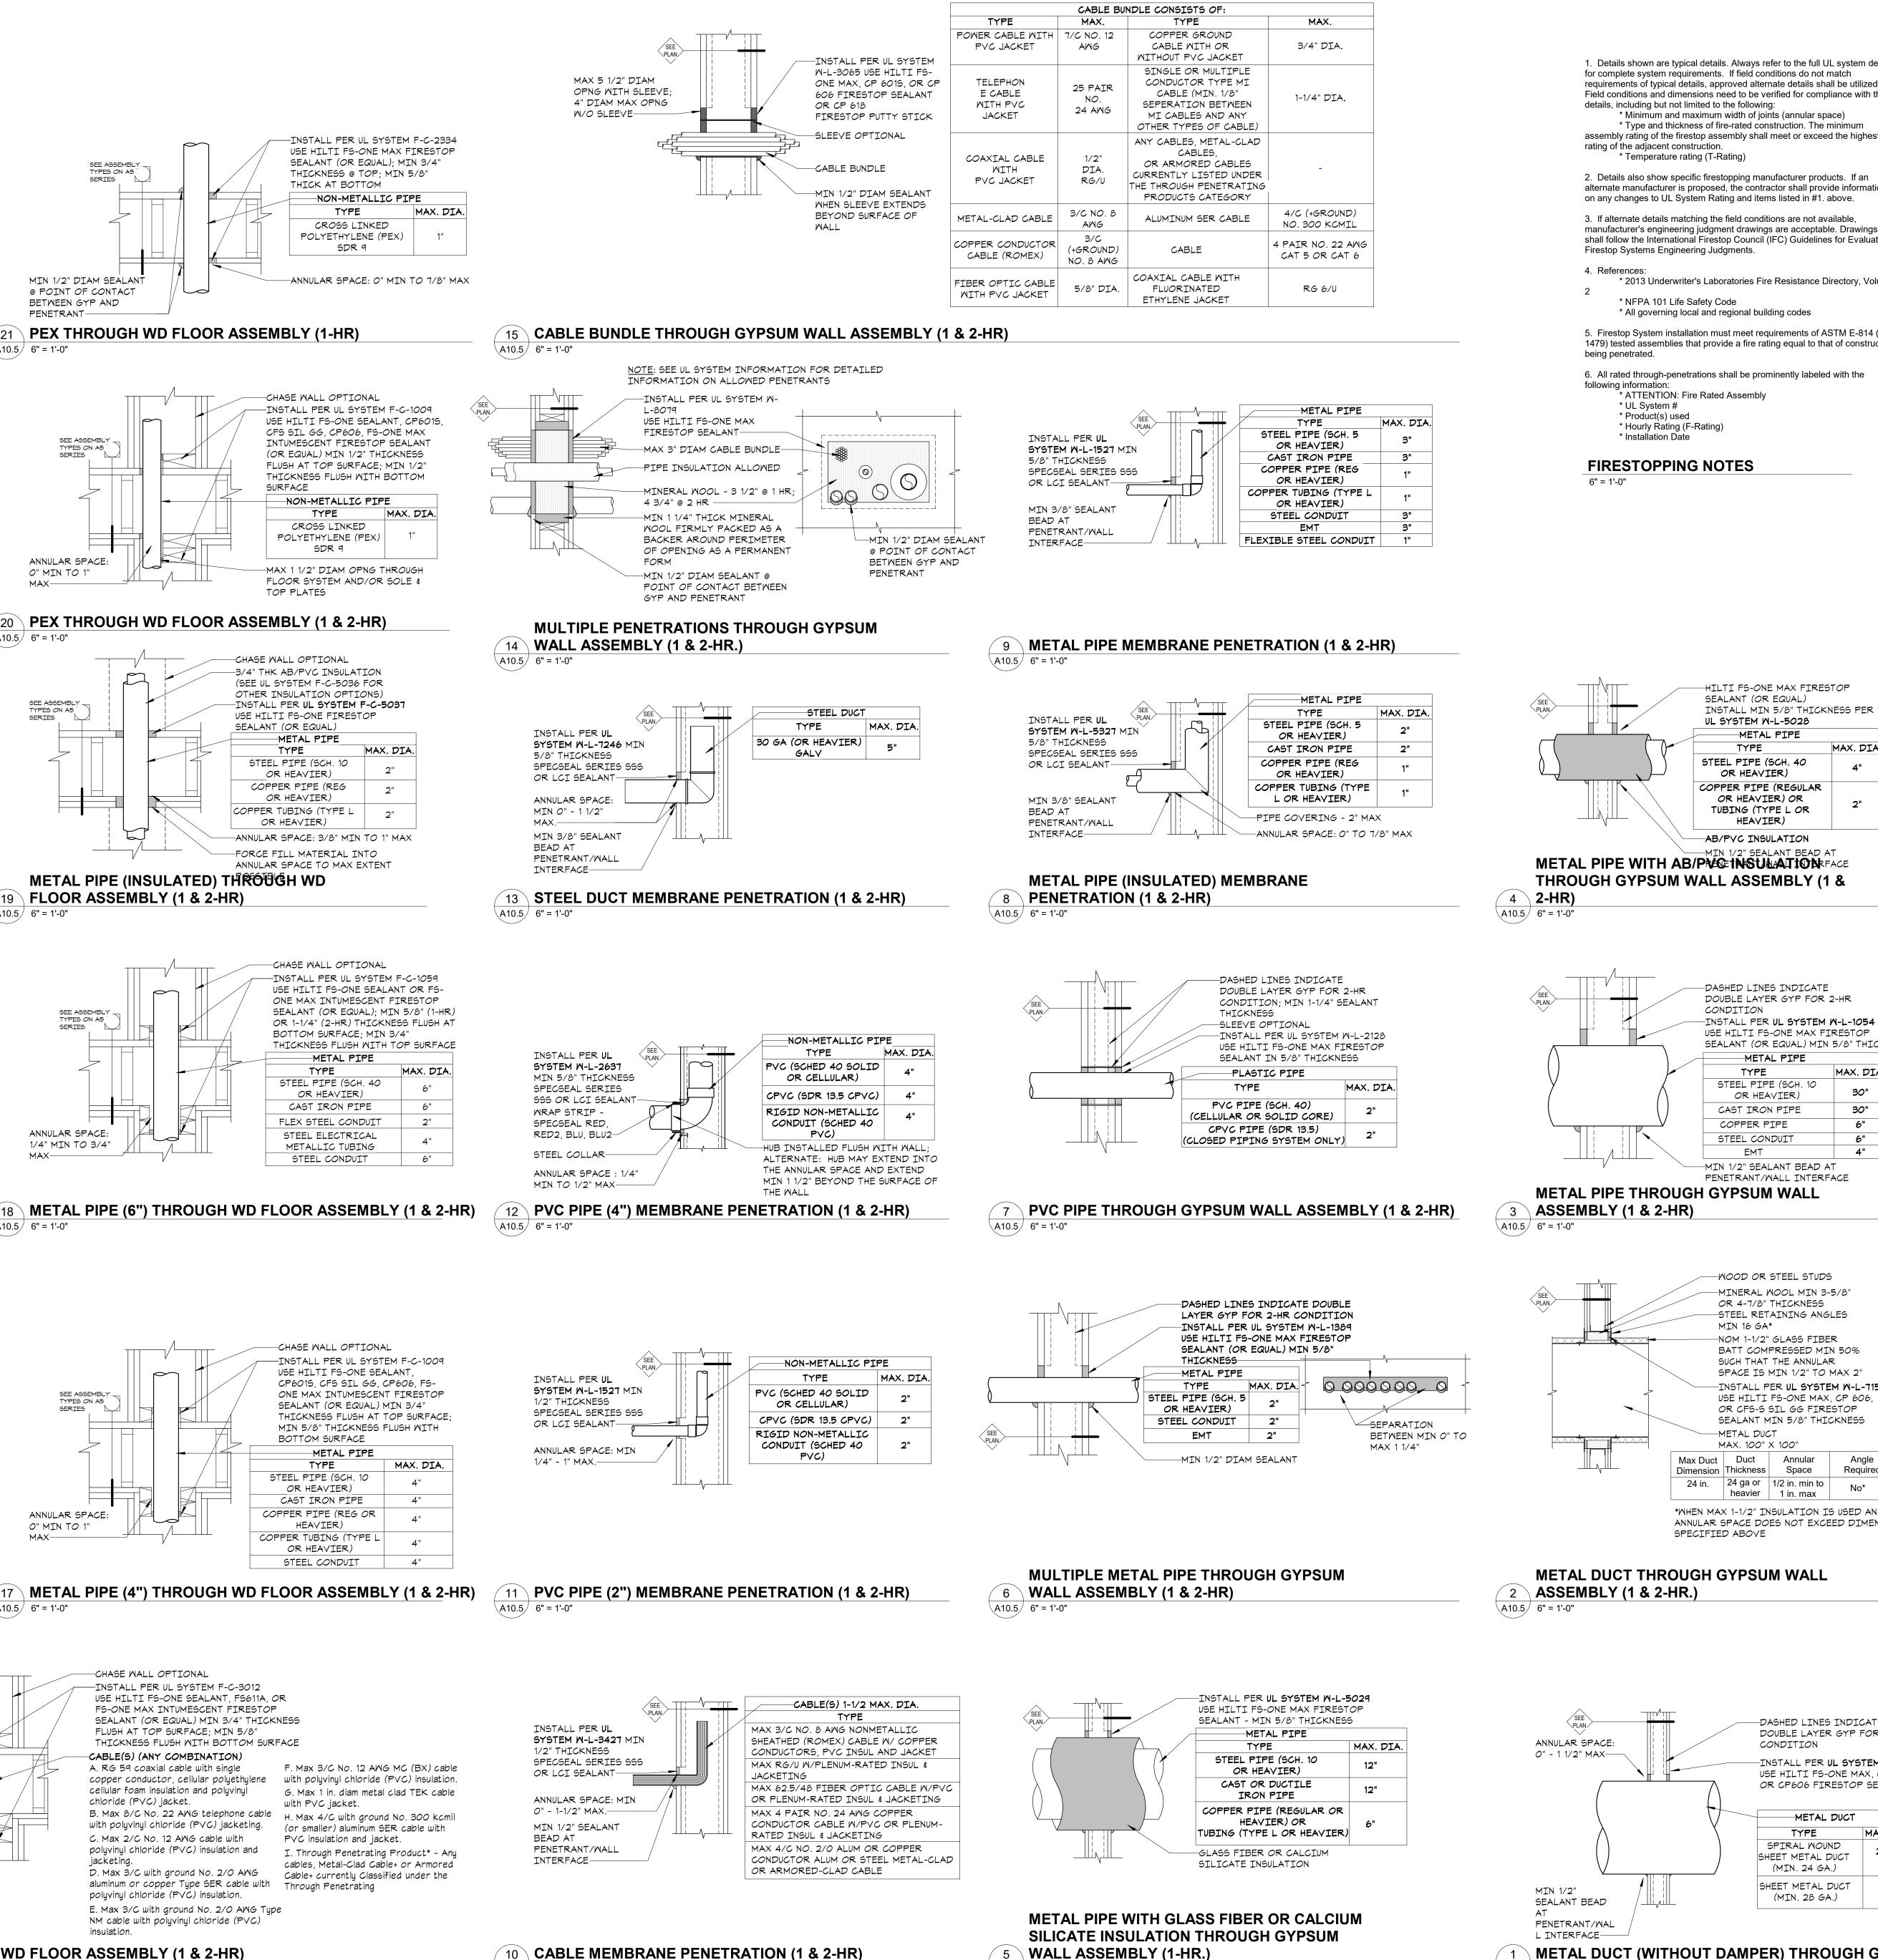

\A10.5/ 6" = 1'-0"

in site architects 1000 university ave. w. suite 130 st. paul, minnesota 55104 612-252-4820 I hereby certify that this document was prepared by me or under my direct supervision and that I am a duly licensed architect under the laws of the State of Washington SEE BELOW Signature Dawn Wieczorek Typed or Printed Name 1192 6/02/23 License # Date 11192 REGISTERE ARCHITECT TDAWN MARIE WIECZORE STATE OF WASHINGT $\omega \omega$ ШM $\supset >$ 7 ` ش م $\mathbf{\mathcal{N}}$ $\mathbf{\Omega}$ \mathbf{M} 5 ω μ 0 City of Puyallup velopment & Permitting Service ISSUED PERMIT Building Planning Engineering Public Works Fire PRMU20230881 PERMIT APP# PRMU20230881 PERMIT SET JUNE 02, 2023 REVISIONS Date No. Description 2108 PROJECT NUMBER Author Checker DRAWN BY CHECKED BY WESLEY BRADLEY PARK 2 EAST BROWNSTONE PENETRATION FIRESTOPPING DETAILS

						TYPI	CAL UI		R SCH	EDULE			
DOOR				[DOOR			F	RAME			FIRE	
NO.	NAME	WIDTH	HT	THK	TYPE	MAT	FIN	TYPE	MAT	FIN	HDWR	RATING	COMMENTS
А	ENTRY	3' - 0"	6' - 8"	1 3/4"	AP	SCHB	PT	F1	DW	PT	039U99	20 MIN-S	CONCEALED DROP BOTTOM
A1	ENTRY	3' - 0"	6' - 8"	1 3/4"	RP-1	IF	PT	F5	WD	PREFIN	039U97	-	EXTERIOR/WD TRIM INTERIOR/FG STORM DR
В	BED/BATH	3' - 0"	6' - 8"	1 3/4"	RP	SCHB	PREFIN	PREHUNG	WD	PREFIN	011U		
B1	BATH	3' - 0"	6' - 8"	1 3/4"	RP	SCHB	PREFIN	PREHUNG	WD	PREFIN	011U		
BP	BED/BATH POCKET	3' - 0"	6' - 8"	1 3/4"	RP	SCHB	PREFIN	PREHUNG	WD	PREFIN	006C		POCKET W/PULL BOTH SIDES
C2.5	CLOSET	2' - 6"	6' - 8"	1 3/4"	RP	SCHB	PREFIN	PREHUNG	WD	PREFIN	010U		
C3	CLOSET	3' - 0"	6' - 8"	1 3/4"	RP	SCHB	PREFIN	PREHUNG	WD	PREFIN	010U		
CF2.5	CLOSET	2' - 6"	6' - 8"	1 3/4"	RP	HCHB	PREFIN	PREHUNG	WD	PREFIN	005		BIFOLD - FULL JAMB
CF3	CLOSET	3' - 0"	6' - 8"	1 3/4"	RP	HCHB	PREFIN	PREHUNG	WD	PREFIN	005		SINGLE BIFOLD - FULL JAMB
CF4	CLOSET	4' - 0"	6' - 8"	1 3/4"	RP	HCHB	PREFIN	PREHUNG	WD	PREFIN	005A		BIFOLD PAIR - FULL JAMB
CF5	CLOSET	5' - 0"	6' - 8"	1 3/4"	RP	HCHB	PREFIN	PREHUNG	WD	PREFIN	005A		BIFOLD PAIR - FULL JAMB
CF6	CLOSET	6' - 0"	6' - 8"	1 3/4"	RP	HCHB	PREFIN	PREHUNG	WD	PREFIN	005A		BIFOLD PAIR - FULL JAMB
CP3	POCKET/CLOSET	3' - 0"	6' - 8"	1 3/4"	RP	HCHB	PREFIN	PREHUNG	WD	PREFIN	006B		POCKET W/PULL BOTH SIDES
D3	SUNROOM	3' - 0"	6' - 8"	1 3/4"	FG-MUNTINS	SCWD	PREFIN	PREHUNG	WD	PREFIN	025U		PAIR
D4	SUNROOM	4' - 0"	6' - 8"	1 3/4"	FG-MUNTINS	SCWD	PREFIN	PREHUNG	WD	PREFIN	025U		PAIR
D5	CLOSET	5' - 0"	6' - 8"	1 3/4"	RP	HCHB	PREFIN	PREHUNG	WD	PREFIN	010U		
DP5	DEN	5' - 0"	6' - 8"	1 3/4"	FG-MUNTINS	SCWD	PREFIN	PREHUNG	WD	PREFIN	006A		PAIR/MUNTINS/POCKET/PULL BOTH SIDES
М	MECHANICAL	2' - 10"	6' - 8"	1 3/4"	RP	SCHB	PREFIN	PREHUNG	WD	PREFIN	015U		SMOKE SEAL & SILL
0	OPENING	5' - 0"	7' - 0"						WD	ST			CASED OPENING

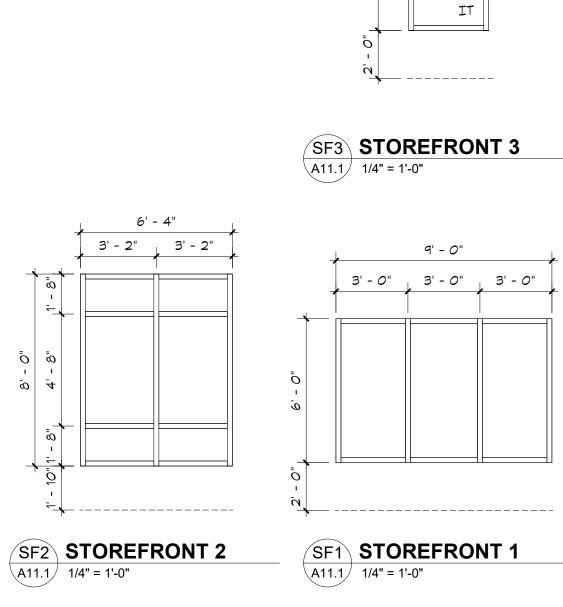

3' - 4"

- n_____




DOOR A	AND WINDOW NOTES		
1. FIRE RA	ATING LABELS ARE SHOWN IN MINU	JTES UNO.	
2. UNDER	CUT AT ALL INTERIOR DOORS UNC).	
3. DOOR H	HARDWARE TO BE CENTERED ON F	RAIL OF PAI	NEL DOORS.
4. SEE A1	1.1 FOR DOOR TYPES		
	TO ELEVATIONS AND PLANS FOR GLAZING TO MEET IBC 2406.	WINDOWS	LOCATIONS REQUIRING
GLAZIN	G TYPES		
IT 1" INS P 1/4" PI T 1/4" TI F 1/4" FI W 1/4" W	ULATED NON-TEMPERED ULATED TEMPERED LATE GLASS EMPERED ROSTED GLASS /IRED GLASS	ONS	
ALUM AP CA CL DW F FG FRP FX HCHB HCW HM HMKD IF IM MCWV	ALUMINUM FLUSH W/ APPLIED MLDG CASEMENT WINDOW CHAIN LINK DRYWALL FLUSH FULL GLASS FIBERGLASS REINFORCED PLASTIC FIXED WINDOW HOLLOW CORE HARDBOARD HOLLOW CORE WOOD HOLLOW METAL HOLLOW METAL HOLLOW METAL HOLLOW METAL SULATED FIBERGLASS INSULATED FIBERGLASS INSULATED METAL MINERAL CORE WD VENEER	NL OC OH PLAM PREFIN PT RP SCHB SCR SCW SH SCW SH SL ST STL TR CLWD WD	NARROW LITE OVERHEAD COILING OVERHEAD SEGMENTAL PLASTIC LAMINATE PRE-FINISHED PAINT RAISED PANEL SOLID CORE HARDBOARD SCREEN SOLID CORE WOOD SINGLE HUNG WINDOW SLIDING/GLIDING WINDOW STAIN STEEL TRAFFIC DOOR (SOLID CORE) CLAD WOOD

	Door	To Room Name			DOC)R				FRAME				GLASS		Auto-	Card	Mag	
REV	Number		Width	HT	THK	TYPE	MATL	FIN	Туре	MATL	FIN	R	Label	Door	Sidelite	OP	Rdr	Hold	Comments
EVEL 0																			
(0001	PARKING SOUTH	3' - 0"	7' - 0"	1 3/4"	F	HM	PT	F1A	HM	PT	634X					•		WEATHERSTRIPPING
(0001A	PARKING SOUTH	16' - 5"	0"	0"							\sim							COLLING GRATE STALE DOOI
(0004	STORAGE	3' - 0"	7' - 0"	1 3/4"	F	HM	PT	F1A	HM	PT	034X03	\sim				•	(WEATHERSTRIPPING
(0005	TRASH	6' - 0"	<u> </u>	1 3/4"	F	HM	PT	F1A	HM	PREFIN	044B05							
(0006	ELEV LOBBY	3' - 0"	Z'-Q",	1 3/4"	NL	HM	PT	F1A	HM	PT	634X02	S	IT		•	•		
(0007	EE	3' - 6"	7' - 0"	1 3/4"	F	HM	PT	F1A	HM	PT	034B	90						
(0011	ELECT	3' - 0"	7'-0"	1 3/4"	5	HM	PT	F1A	HM	PT	034	60						
(011A	DATA	3' - 0"	7'.0"	1 3/4"	(F)	HM	PT	F1A	HM	PT	034							
{	0011B	BIKES	3' - 0"	7' - 0"	1 3/4"	F	HM	PT	F1A	HM	PT	030D					•		
(0012	RES STORAGE	3' - 0"	7' - 0"	1 3/4"	F	HM	PT	F1A	HM	PT	030D							
(013	MECH/WATER SERVICE	6' - 0"	7' - 0"	1 3/4"	F	HM	PT	F1A	HM	PREFIN	044B05					\sim	\sim	$\overline{}$
(0015	STORAGE	3' - 6"	7' - 0"	1 3/4"	F	HM	PT	F1A	HM	PT					<u>د</u>			
	ST-A0	STAIR A	3' - 0"	7' - 0"	1 3/4"	F	HM	PT	F1A	HM	PT	030A01	180						WEATHERSTRIPPING
	ST-B0	STAIR B	3' - 0"	7' - 0"	1 3/4"	F	HM	PT	F1A	HM	PT	030A01	180						WEATHERSTRIPPING


											_								
	Door				DOC	OR				FRAME				G	ASS	Auto-	Card	Mag	
REV	Number	To Room Name	Width	HT	THK	TYPE	MATL	FIN	Туре	MATL	FIN	HDWR L	_abel	Door	Sidelite	OP	Rdr	Hold	Comments
LEVEL 1	- EAST																		
	1030	VESTIBULE	6' - 0"	7' - 0"	1 3/4"	FG	AL	AN	F2	AL	AN	264E44		IT		•	•		AUTO OP BOTH DOORS
	1030E	VESTIBULE	6' - 0"	7' - 0"	1 3/4"	FG	AL	AN	F2	AL	AN	182XL		IT		•			AUTO OP BOTH DOORS
	1031A	ELECT.	3' - 0"	6' - 8"	1 3/4"	AP	MCWV	ST	DW	DW	PREFIN	034A01 2	0						
	1032	TRASH	3' - 0"	6' - 8"	1 3/4"	AP	MCWV	ST	DW	DW	PREFIN		5						
	1033	CLOSET	3' - 0"	6' - 8"	1 3/4"	AP	MCWV	ST	DW	DW	PREFIN	034 6	0						
	1035	STORAGE	3' - 0"	6' - 8"	1 3/4"	AP	MCWV	ST	DW	DW	PREFIN	034A01 2	0						
	1036E	COMMONS	6' - 0"	7' - 0"	1 3/4"	FG	AL	AN	F2	AL	AN	264E44		IT		•	•		WEATHERSTRIPPING
	1037	TOILET	3' - 0"	6' - 8"	1 3/4"	AP	MCWV	ST	DW	DW	PREFIN	031101 2	0						
	1039E	CORR S1	3' - 0"	7' - 0"	1 3/4"	FG	AL	AN	F1	AL	AN	254X82		IT			•		
	1040	MECH	3' - 0"	6' - 8"	1 3/4"	AP	MCWV	ST	DW	DW	PREFIN	034A01 2	0						
	1041	TOILET	3' - 0"	6' - 8"	1 3/4"	AP	MCWV	ST	DW	DW	PREFIN	031110							
	1042	GAME ROOM	3' - 0"	6' - 8"	1 3/4"	AP	MCWV	ST	F4	DW	PREFIN	030D 2	0		Т				
	1042-1E	GAME ROOM	3' - 0"	6' - 8"	1 3/4"	FG	AL	AN	F1	AL	AN	254X82		Т			•		
	1042-2E	GAME ROOM	6' - 0"	7' - 0"	1 3/4"	FG	AL	AN	F2	AL	AN			IT					NOT AN EXIT; DOOR FIXED; NO HARDWARE EXCEPT PUL
	1042-3E	GAME ROOM	6' - 0"	7' - 0"	1 3/4"	FG	AL	AN	F2	AL	AN			IT					NOT AN EXIT; DOOR FIXED; NO HARDWARE EXCEPT PUL
	1042-4E	GAME ROOM	3' - 0"	6' - 8"	1 3/4"	FG	AL	AN	F1	AL	AN	254X82		Т			•		
	1043E	OUTDOOR SHED	6' - 0"	7' - 0"	1 3/4"	F	HM	PT	F1	HM	PREFIN								HASP & PADLOCK
	ST-A1	STAIR A1	3' - 0"	6' - 8"	1 3/4"	AP	MCWV	ST	DW	DW	PREFIN	034E32 6	0				•		STAIR SIDE CARD RDR; ELECTRIC LOCK
	ST-A1E	STAIR A1	3' - 0"	7' - 0"	1 3/4"	FG	AL	AN	F1	AL	AN	254X82		IT			•		
	ST-B1	STAIR B1	3' - 0"	6' - 8"	1 3/4"	AP	MCWV	ST	DW	DW	PREFIN	034E32 6	0				•		STAIR SIDE CARD RDR; ELECTRIC LOCK
	ST-B1E	STAIR B1	3' - 0"	7' - 0"	1 3/4"	FG	AL	AN	F1	AL	AN	254X82		IT			•		

	2-DOOR SCHEDULE - SECOND FLOOR																		
	Door				DOC	OR				FRAME				GL	ASS	Auto-	Card	Mag	
REV	Number	To Room Name	Width	HT	THK	TYPE	MATL	FIN	Туре	MATL	FIN	HDWR	Label	Door	Sidelite	OP	Rdr	Hold	Comments
EVEL 2	- EAST																		
	2032A	TRASH	3' - 0"	6' - 8"	1 3/4"	AP	MCWV	ST	F1	DW	PREFIN	030A01	45						
	2033	ELECT/DATA	3' - 0"	6' - 8"	1 3/4"	AP	MCWV	ST	F1	DW	PREFIN	034A01	20						
	2035	BLDG STORAGE	3' - 0"	6' - 8"	1 3/4"	AP	MCWV	ST	F1	DW	PREFIN	034A01	20						
	2036	CLUBROOM	3' - 0"	6' - 8"	1 3/4"	AP	MCWV	ST	F4	DW	PREFIN	030D	20		Т				
	2036A	CLUB ELECT.	4' - 0"	6' - 8"	1 3/4"	AP	MCWV	ST	F1	DW	PREFIN	034A01							
	2037	TOILET	3' - 0"	6' - 8"	1 3/4"	AP	MCWV	ST	DW	DW	PREFIN	031110							
	ST-A2	STAIR A2	3' - 0"	6' - 8"	1 3/4"	AP	MCWV	ST	F1	DW	PREFIN	034E32	60				•		STAIR SIDE CARD RDR; ELECTRIC LOCK
	ST-B2	STAIR B2	3' - 0"	6' - 8"	1 3/4"	AP	MCWV	ST	DW	DW	PREFIN	034E32	60				•		STAIR SIDE CARD RDR; ELECTRIC LOCK

							3-D	OOR S	SCHED	ULE - T	HIRD FI	OOR							
	Door				DO	OR				FRAME				GL	ASS	Auto-	Card	Mag	
REV	Number	To Room Name	Width	HT	THK	TYPE	MATL	FIN	Туре	MATL	FIN	HDWR	Label	Door	Sidelite	OP	Rdr	Hold	
EVEL 3	- EAST																		
	3030A	TRASH	3' - 0"	6' - 8"	1 3/4"	AP	MCWV	ST	F1	DW	PREFIN	030A01	90						
	3031A	MECH	3' - 0"	6' - 8"	1 3/4"	AP	MCWV	ST	F1	DW	PREFIN	034A01	20						
	3033	RESIDENT STORAGE	3' - 0"	6' - 8"	1 3/4"	AP	MCWV	ST	F1	DW	PREFIN	030D	20						
	3034	STORAGE/ELEC	3' - 0"	6' - 8"	1 3/4"	AP	MCWV	ST	F1	DW	PREFIN	030D	20						
	3036	MECH	3' - 0"	6' - 8"	1 3/4"	AP	MCWV	ST	F1	DW	PREFIN	034A01	20						
	3037	RES STORAGE	3' - 0"	6' - 8"	1 3/4"	AP	MCWV	ST	F1	DW	PREFIN	030D							
	3037-1	RES STORAGE	3' - 0"	7' - 0"	1 3/4"	FG	AL	AN	F1	AL	AN	254X82		IT					
	ST-A3	STAIR A3	3' - 0"	6' - 8"	1 3/4"	AP	MCWV	ST	F1	DW	PREFIN	034E32	60				•		STAIR SIDE CARD RDR; ELECTRIC LOCK
	ST-B3	STAIR B3	3' - 0"	6' - 8"	1 3/4"	AP	MCWV	ST	DW	DW	PREFIN	034E32	60				•		STAIR SIDE CARD RDR; ELECTRIC LOCK
	ST-C3	STAIR C3	3' - 0"	6' - 8"	1 3/4"	AP	MCWV	ST	DW	DW	PREFIN	034E32	60						

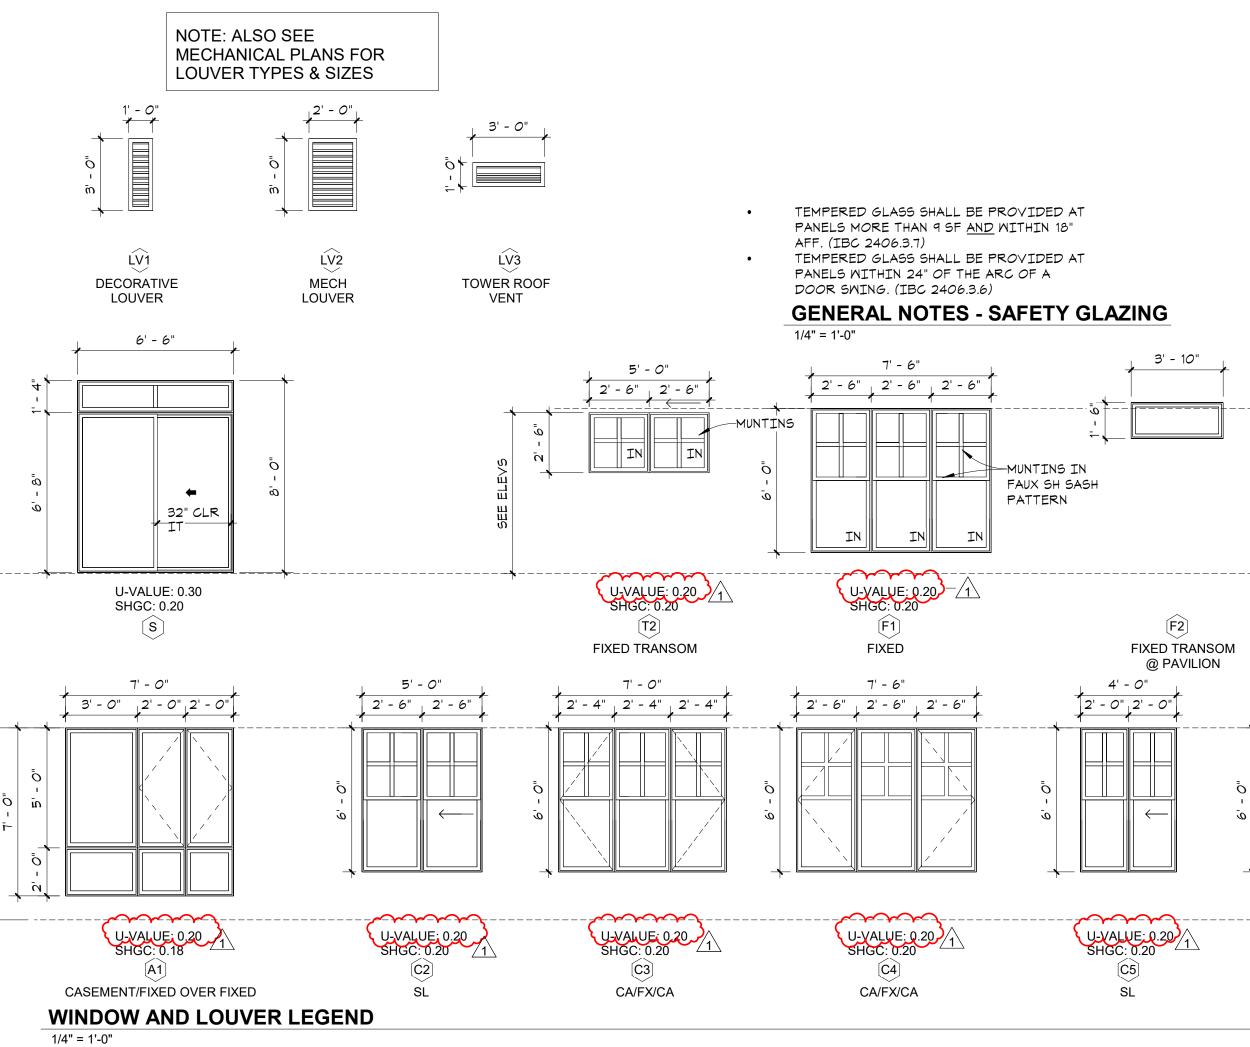

1-DOOR SCHEDULE - FIRST FLOOR

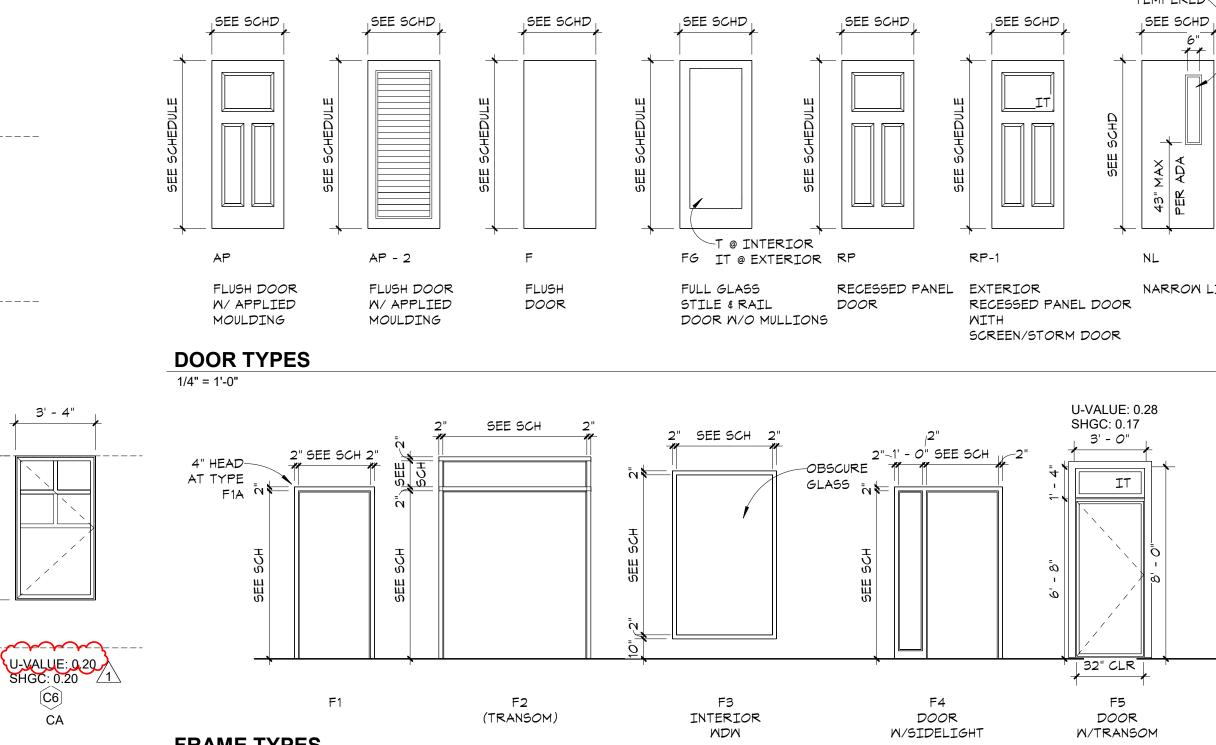

FRAME TYPES 1/4" = 1'-0"

3' - 4"

