


FOUNDATION PLAN

SCALE : 3/4" = 1'-0"

NOTE: ALL ROOF & FLOOR TRUSSES TO ALIGN W/ STUDS @ 24" O.C. TYP. ALL HEADERS SHALL HAVE CONTINUOUS WITH ALLOWED BEARING TO FOUNDATION WITH BUILT-UP STUDS OR POSTS PER PLAN.

FOOTING SCHEDULE	
18"Ø	18"Øx10' PLAIN CONC FTG
24"Ø	24"Øx12' PLAIN CONC FTG
24"	24"x24"x10' PLAIN CONC FTG
24"R	24"x24"x10' CONC FTG W/ (3) #4 E.V.
30"	30"x30"x12' CONC FTG W/ (4) #4 E.V.

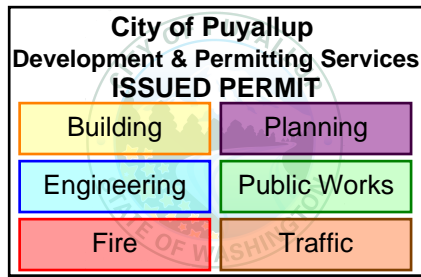

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**PHILLIPS**  
STRUCTURAL ENGINEERING  
PO Box 108, Milton, WA 98354  
Phone (253) 344-1666  
www.phillipsse.com

4/5/2023


ALL VARIATIONS FROM DIMENSIONS AND CONDITIONS SHOWN ON THE DRAWINGS SHALL BE REPORTED TO THE ENGINEER PRIOR TO ANY PROCEEDING WITH WORK. FAILURE TO DO SO SHALL BE THE SOLE RESPONSIBILITY FOR ANY COSTS NECESSARY FOR REMEDIAL WORK. REUSE OF DOCUMENTS UNAUTHORIZED ALTERATION OF ANY OF THE INFORMATION ON THIS DOCUMENT, ENGINEER'S SEAL AND SIGNATURE, THE DESIGN AND IDEAS OF PROFESSIONAL SERVICE, IS THE PROPERTY OF PHILLIPS STRUCTURAL ENGINEERING, LLC. AND SHALL BE THE PROPERTY OF ANY PARTY FOR ANY OTHER PROJECT WITHOUT WRITTEN PERMISSION FROM PHILLIPS STRUCTURAL ENGINEERING, LLC.

**43rd AVE DUPLEX**  
**PRRNSF20230919**

433 43RD AVE SW  
PUYALLUP, WA

WIND SPEED:	110 MPH
WIND EXPOSURE:	B
ROOF SNOW LOAD:	25 PSF

FOUNDATION PLAN	
DRAWN BY:	AMS
ORIGINAL DRAWING DATE:	APR. 5, 2023
SCALE:	N.T.S. (UNO)
PFE NUMBER:	PSE 21.047
DESIGNER:	RUPELLE
SHEET NO.:	S-1

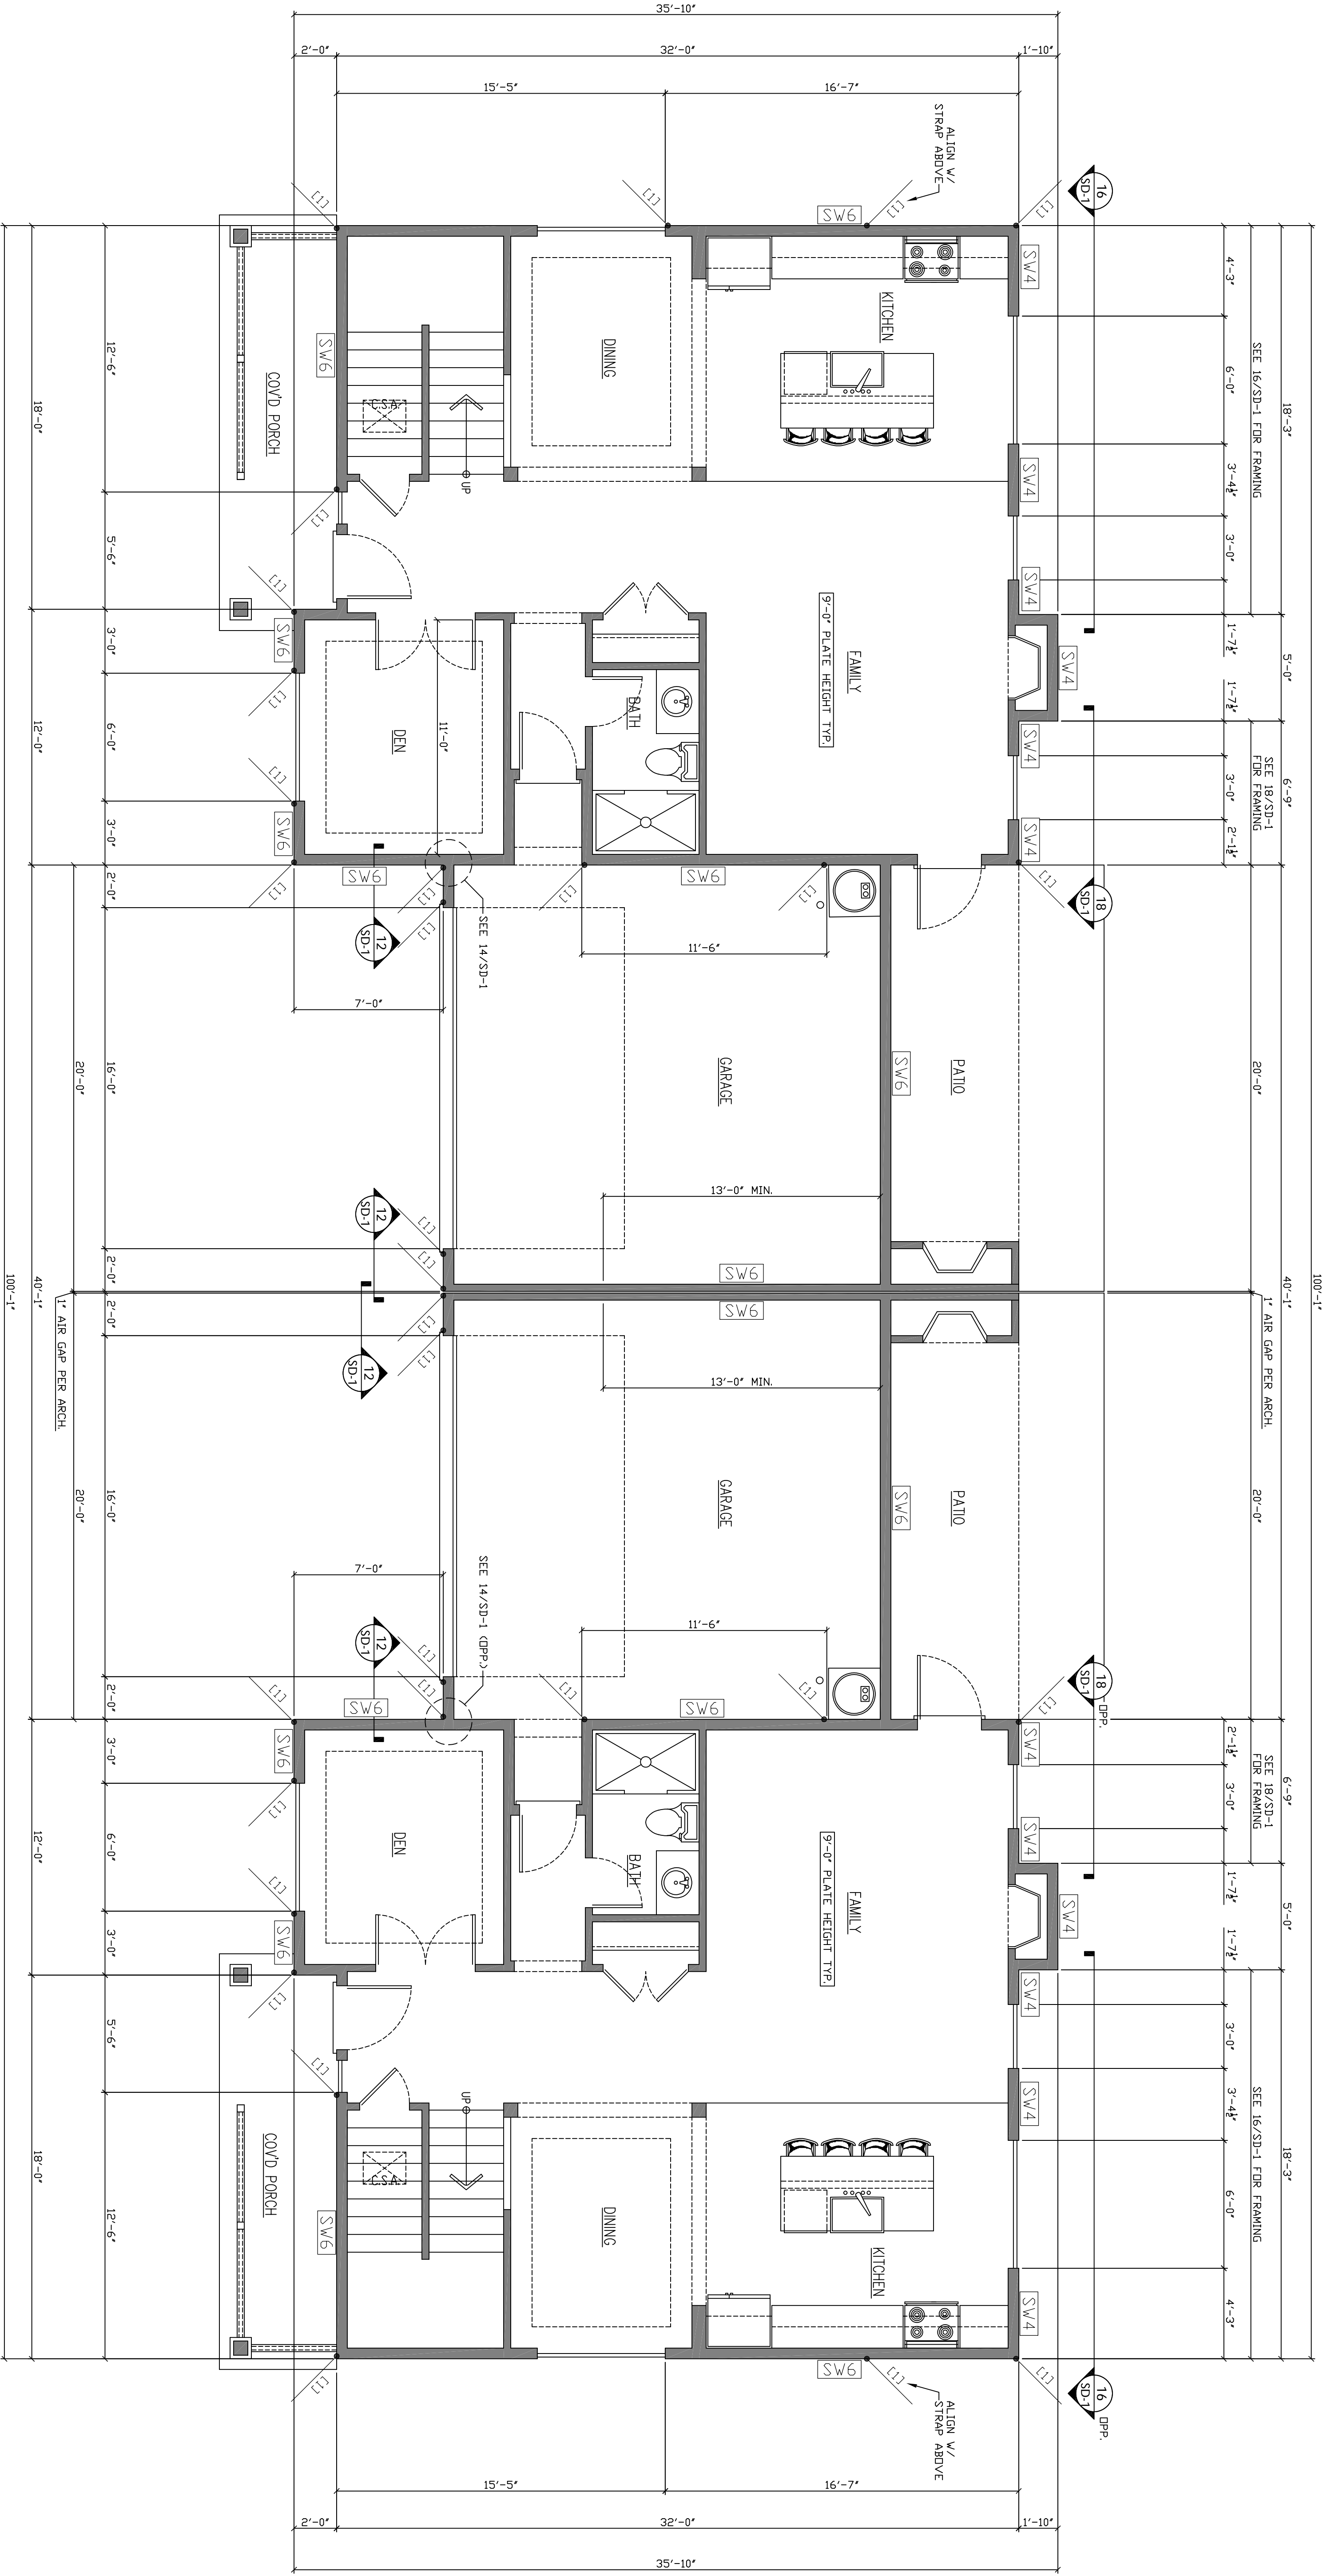


MAIN FLOOR SHEAR WALLS,  
HOLDOWNS, AND STRUCTURE

SCALE : 3/8" = 1'-0"

City of Puyallup  
Development & Permitting Services  
ISSUED PERMIT

Building	Planning
Engineering	Public Works
Fire	Traffic

REVISIONS		
REV	DATE	REVISION DESCRIPTION

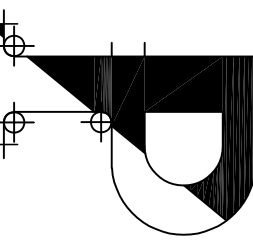  
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Phone: (253) 344-1666  
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4/5/2023


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**433rd AVE DUPLEX**  
**PRRNSF20230919**  
433 43RD AVE SW  
PUYALLUP, WA

WIND SPEED:	110 MPH
WIND EXPOSURE:	B
ROOF SNOW LOAD:	21 PSF

MAIN FLOOR SHEAR WALLS, HOLDOWNS, AND STRUCTURE	
DRAWN BY:	AMS
ORIGINAL DRAWING DATE:	APR. 5, 2023
SCALE:	N.T.S. (UNO)
P/E NUMBER:	PSE 21.047
DESIGNER:	RUDEPPEL
SHEET NO.:	<b>S-2</b>



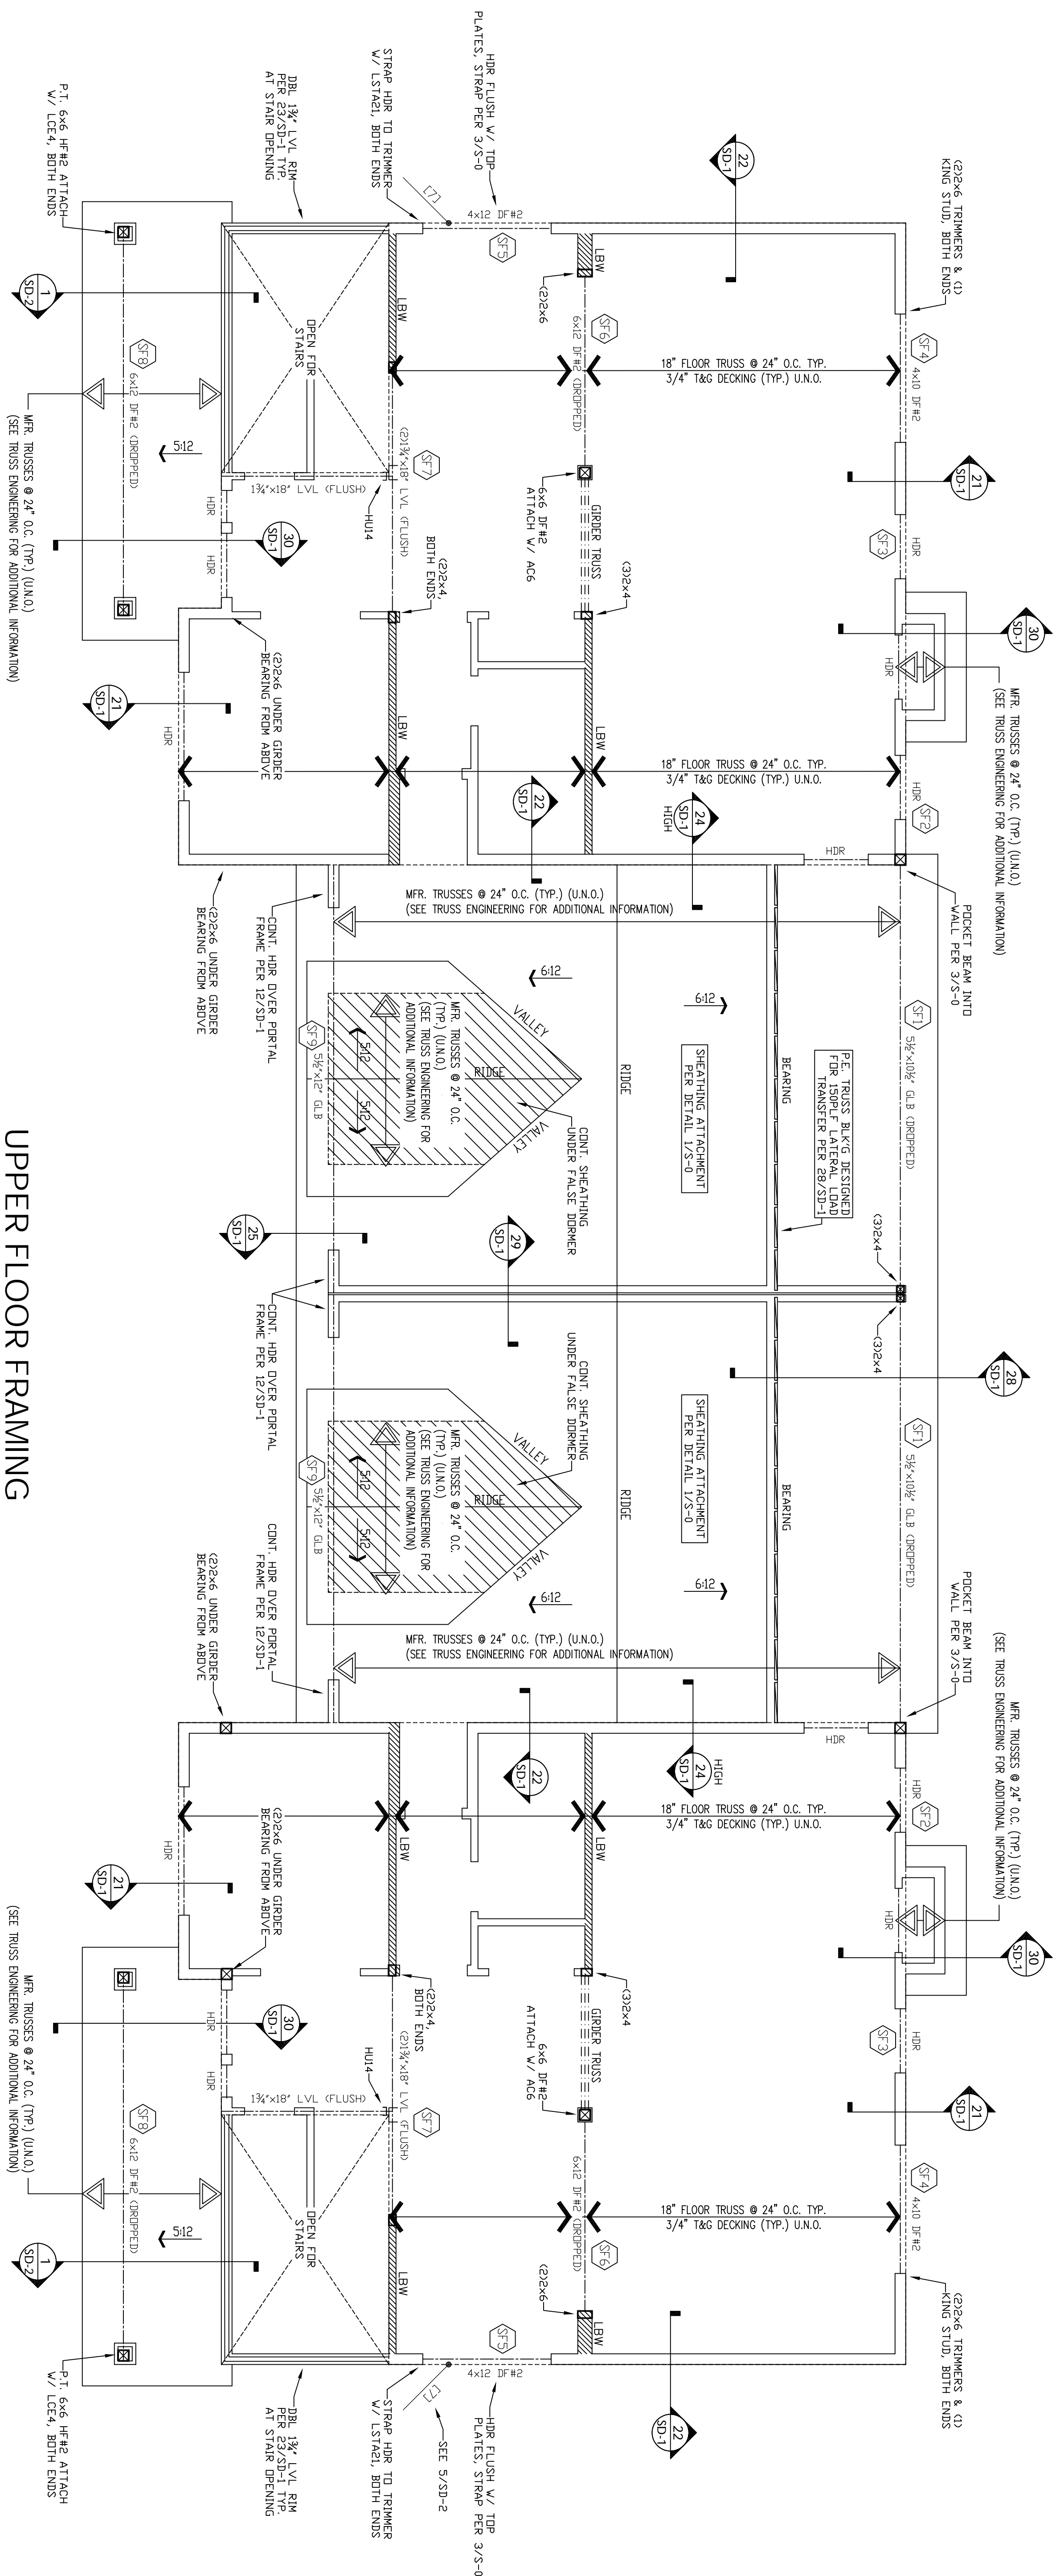


## UPPER FLOOR FRAMING


SCALE:  $\frac{1}{4}" = 1'-0"$

## FLOOR TRUSSES BY OTHERS

NOTE: ALL ROOF & FLOOR TRUSSES TO ALIGN W/ STUDS @ 24" O.C. TYP, ALL HEADERS SHALL HAVE CONTINUOUS ALIGNED BEARING TO FOUNDATION WITH BUILT-UP STUDS OR POSTS PER PLAN.

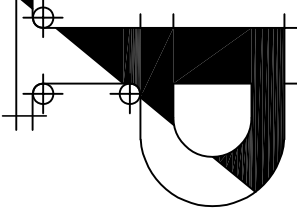[illegible]

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4/5/2023

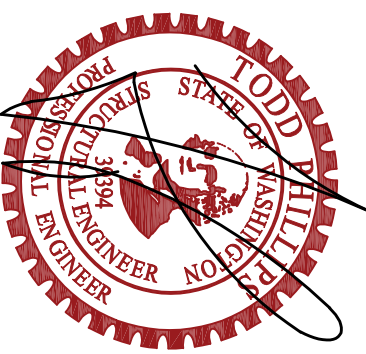ALL ALLOCATIONS FOR DIMENSIONS AND CONDITIONS SHOWN ON THE DRAWINGS SHALL BE REFERRED TO THE DESIGNER FOR RESOLUTION WITH THE DESIGNER PRIOR TO PROCEEDING TO THE NEXT STEP OF THE PROJECT. THE CONTRACTOR SHALL BE RESPONSIBLE FOR ANY COSTS NECESSARY FOR REMEDIAL WORK.

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PROJECT INFORMATION

PROJECT: UNAUTHORIZED FROM PHILLIPS STRUCTURAL ENGINEERING, PLLC.

## 43rd AVE DUPLEX

PRRNSF20230919

433 43RD AVE SW  
PUYALLUP, WA


WIND SPEED:	110 MPH
WIND EXPOSURE:	B
ROOF SNOW LOAD:	25 PSF

## UPPER FLOOR FRAMING

DRAWN BY:	AMS
ORIGINAL DRAWING DATE:	APR. 5, 2023
SCALE:	N.T.S. (UNO.)
PSE NUMBER:	PSE 21.047
DESIGNER:	RUEPPELL

**S-3**



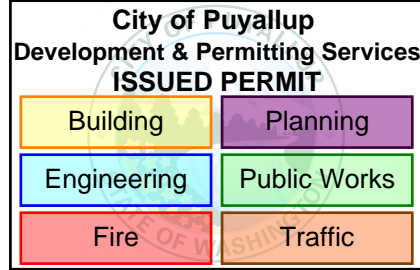

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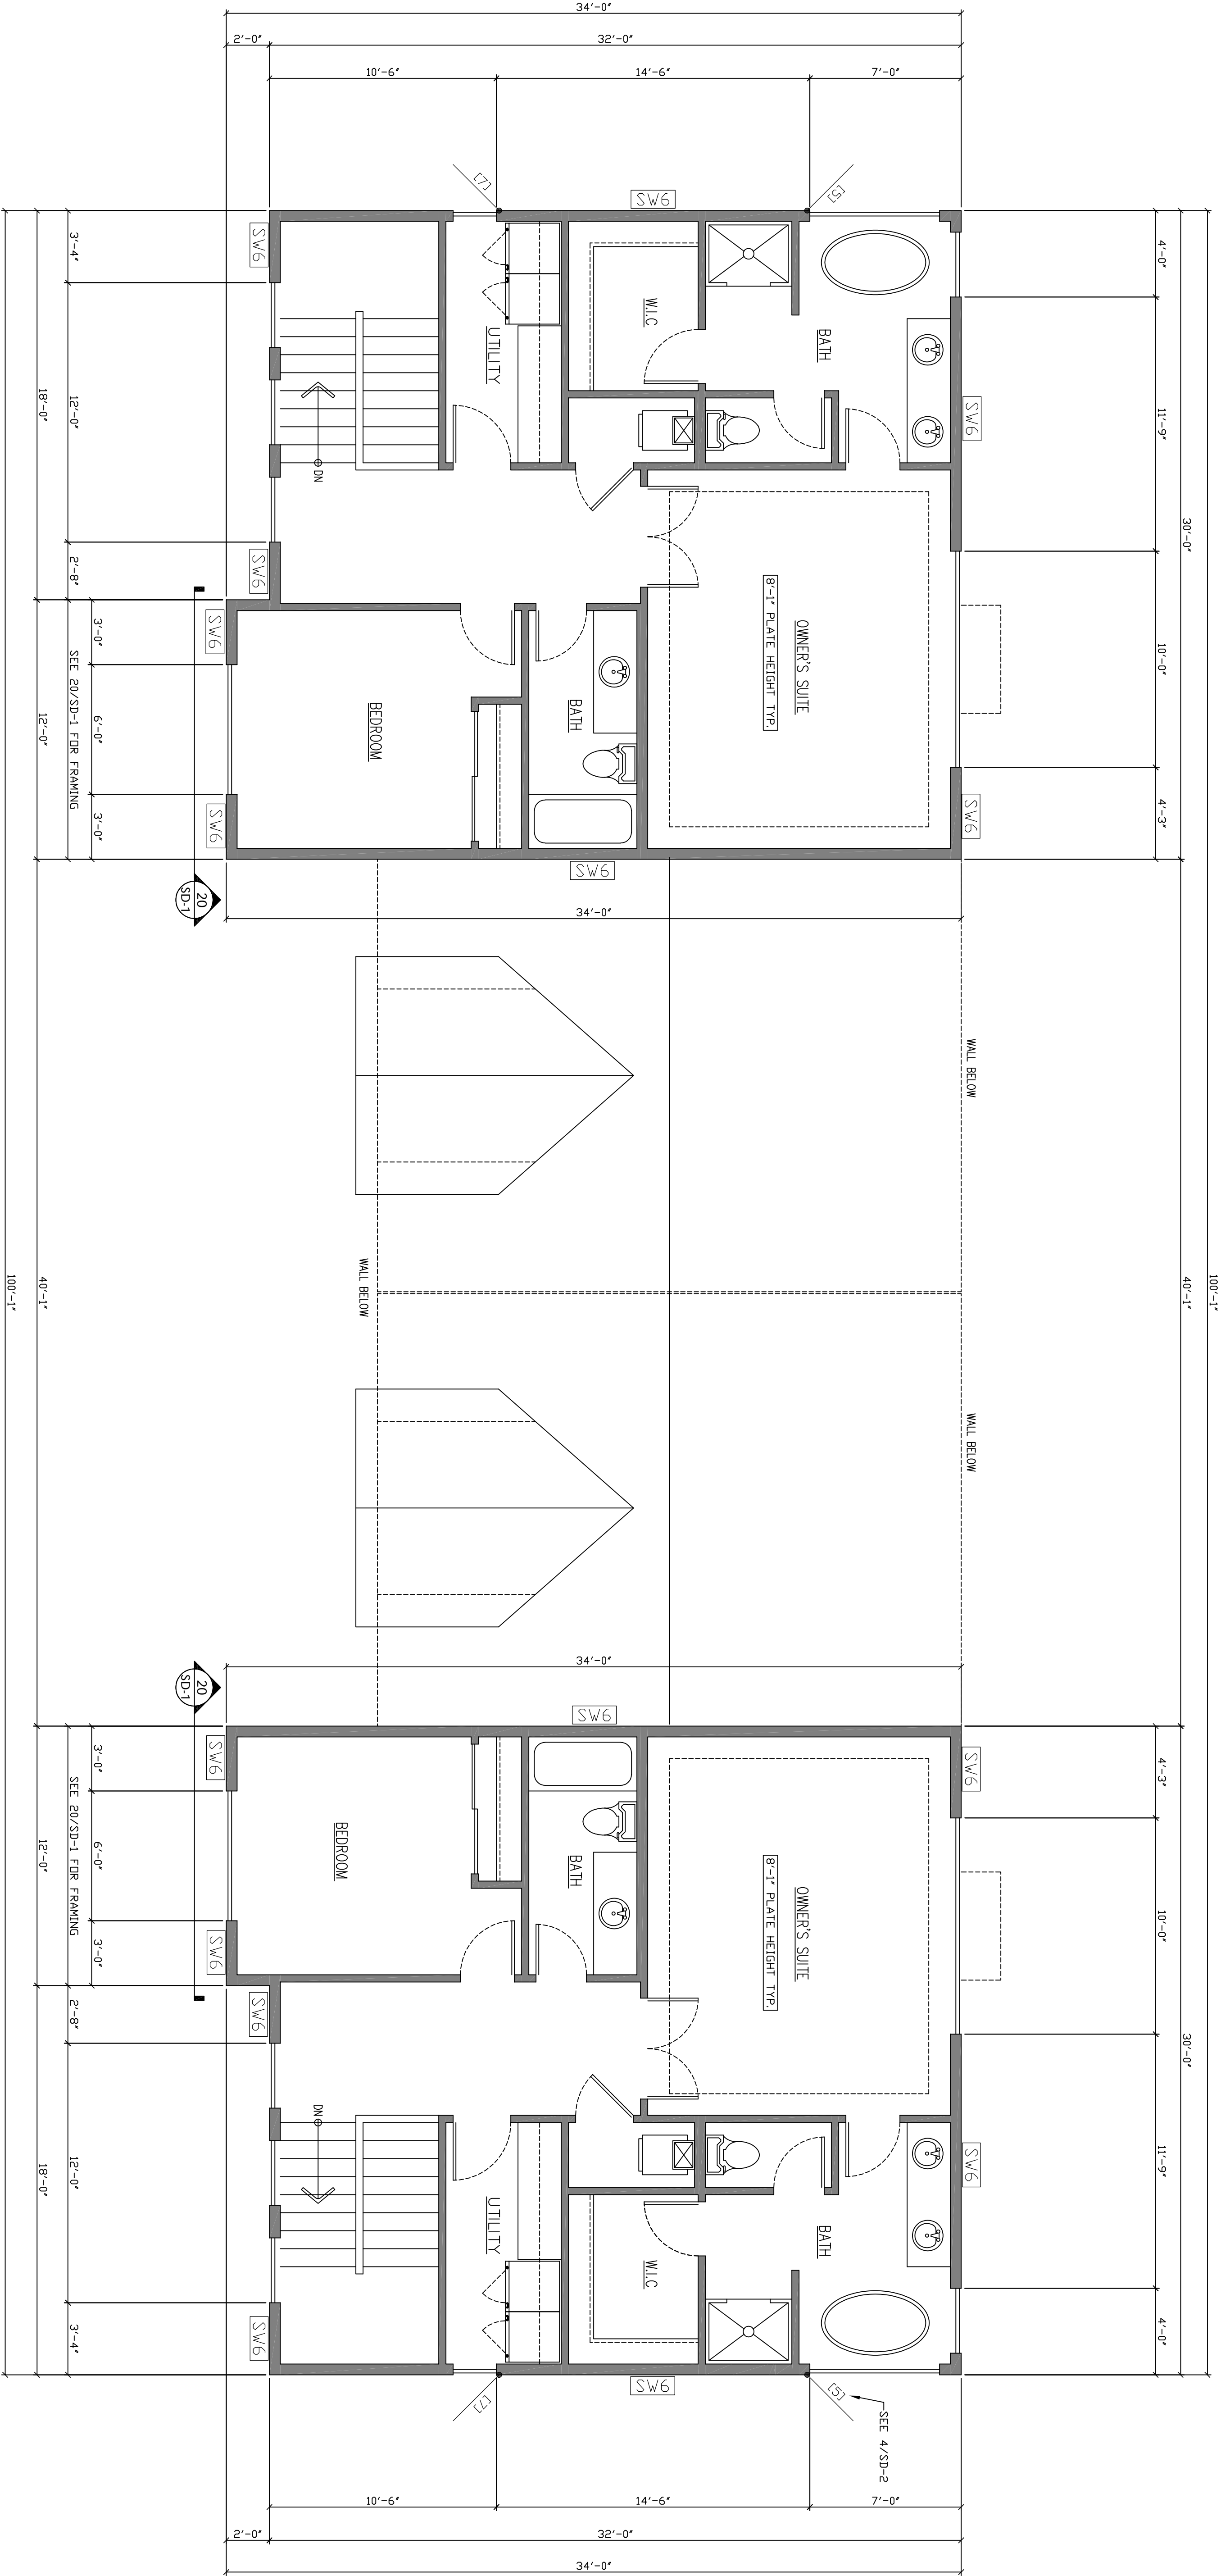
**433rd AVE DUPLEX**

**PRRNSF20230919**

433 43RD AVE SW  
PUYALLUP, WA

WIND SPEED:	110 MPH
WIND EXPOSURE:	B
ROOF SNOW LOAD:	25 PSF


UPPER FLOOR SHEAR WALLS, HOLDOWNS, AND STRUCTURE	
DRAWN BY:	AMS
ORIGINAL DRAWING DATE:	APR. 5, 2023
SCALE:	N.T.S. (UNO)
PFE NUMBER:	PSE 21.04F
DESIGNER:	RIEPELLE
SHEET NO.:	S-4




UPPER FLOOR SHEAR WALLS,  
HOLDOWNS, AND STRUCTURE

SCALE: 1/2" = 1'-0"



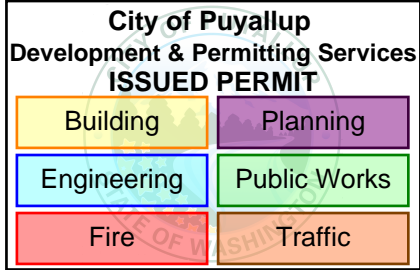

REVISIONS		
REV.	DATE	REVISION DESCRIPTION

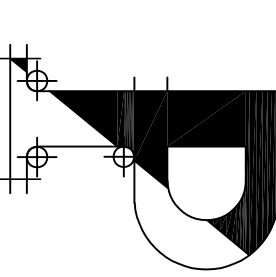

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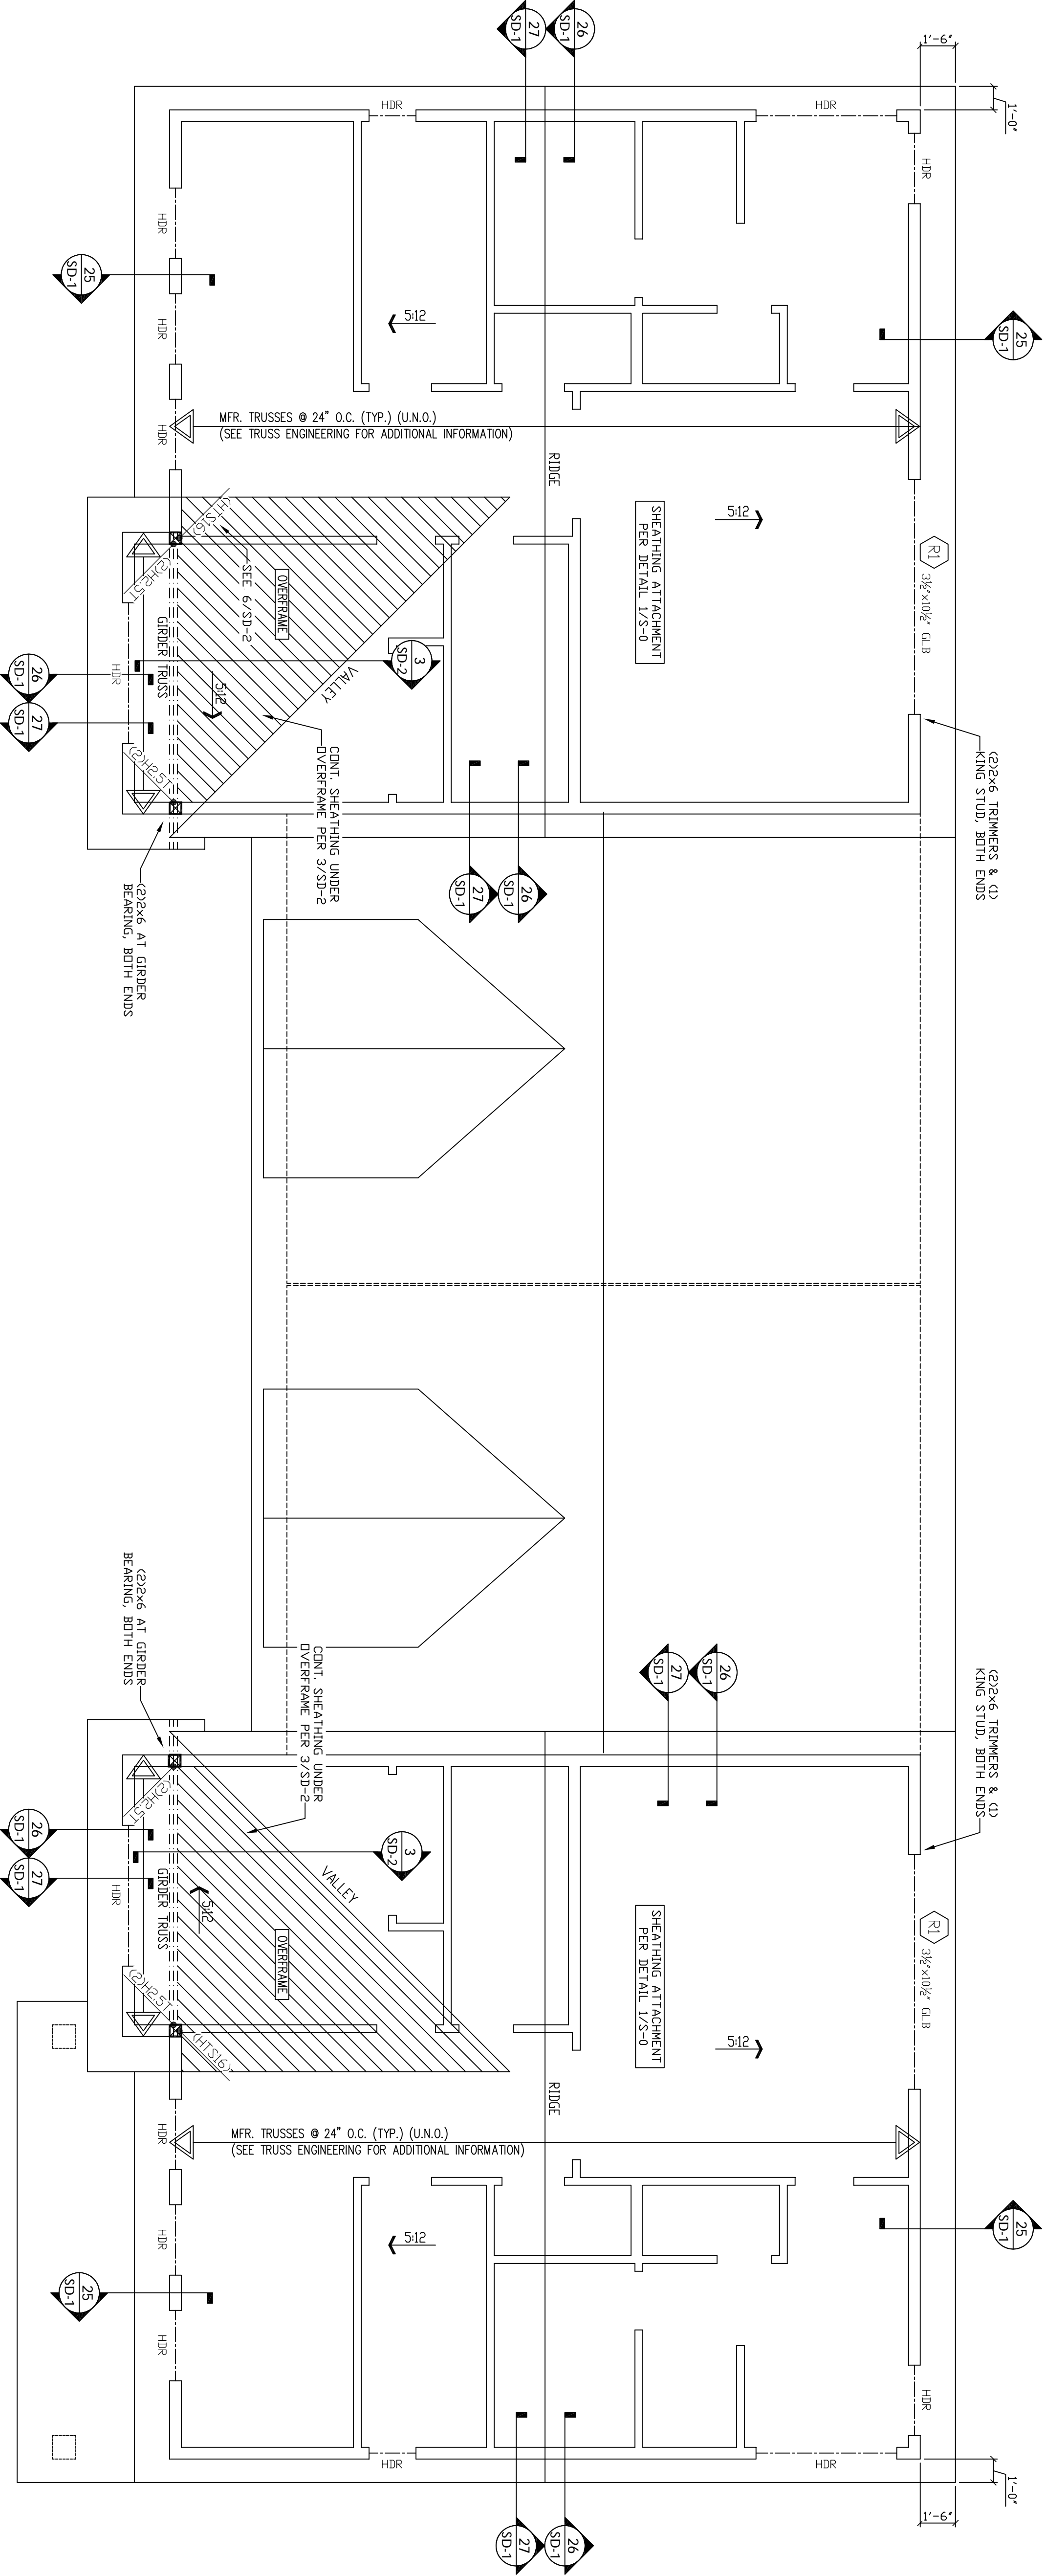
**433rd AVE DUPLEX**

**PRRNSF20230919**

433 43RD AVE SW  
PUYALLUP, WA

WIND SPEED:	110 MPH
WIND EXPOSURE:	B
ROOF SNOW LOAD:	21 PSF

ROOF FRAMING	
DRAWN BY:	AMS
ORIGINAL DRAWING DATE:	APR. 5, 2023
SCALE:	N.T.S. (U.N.O.)
P/E NUMBER:	PSE 21.047
DESIGNER:	RUDEPPEL
SHEET NO.:	<b>S-5</b>



ROOF FRAMING






SCALE :  $\frac{1}{4}'' = 1'-0''$

ROOF TRUSSES BY OTHERS

NOTE: ALL GIRDERS & FLOOR TRUSSES TO BE 2x6. ALL STUDS & 2x4 C. STUDS SHALL BE 2x4. ALL HEADERS SHALL HAVE CONTINUOUS BUILT-UP STUDS OR POSTS PER PLAN.




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1	3	4	5	6

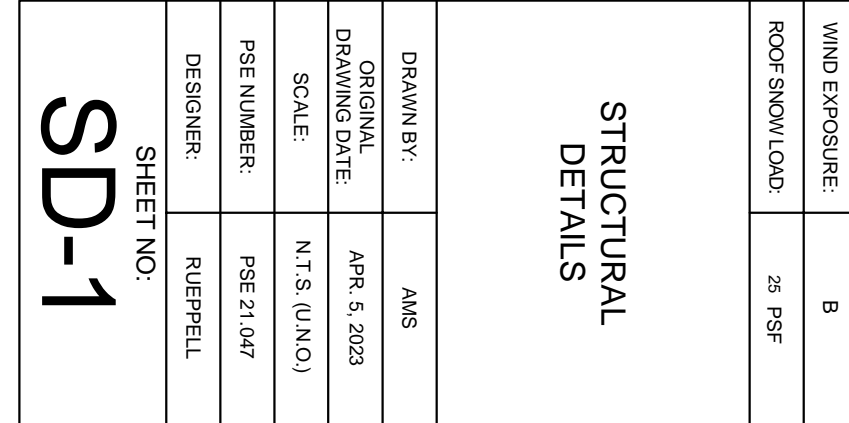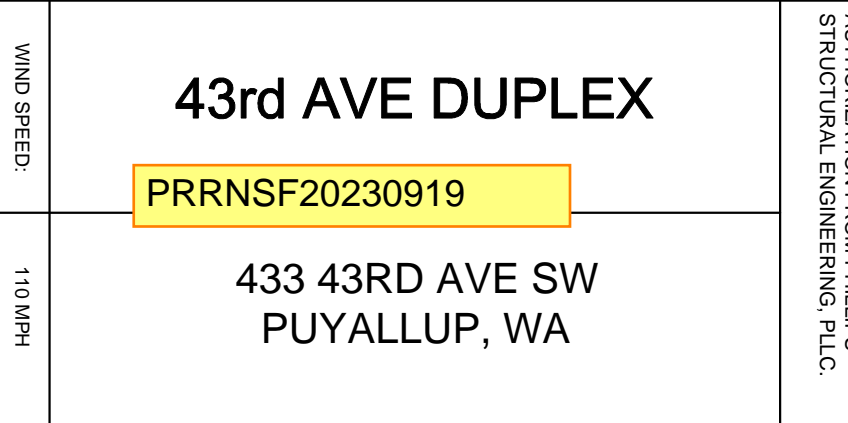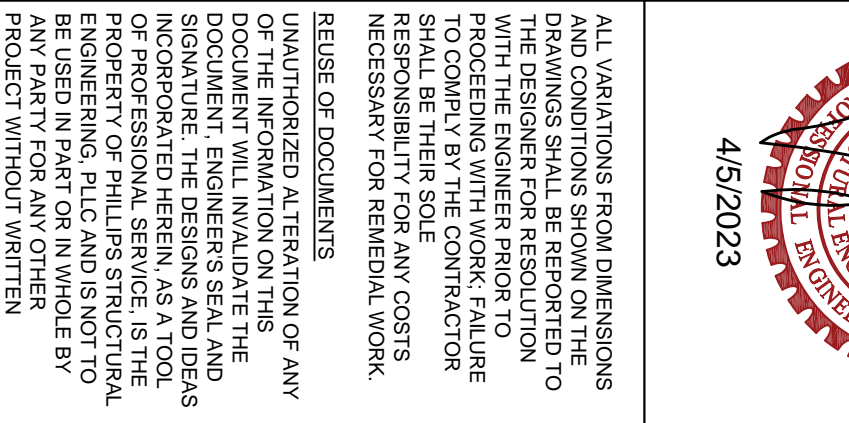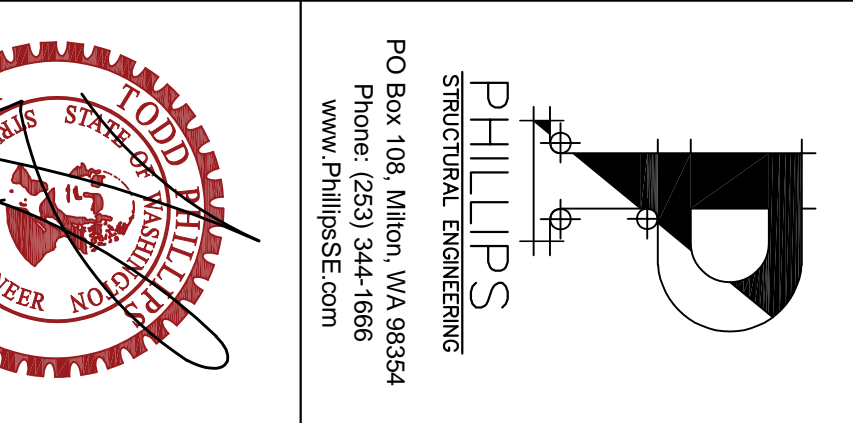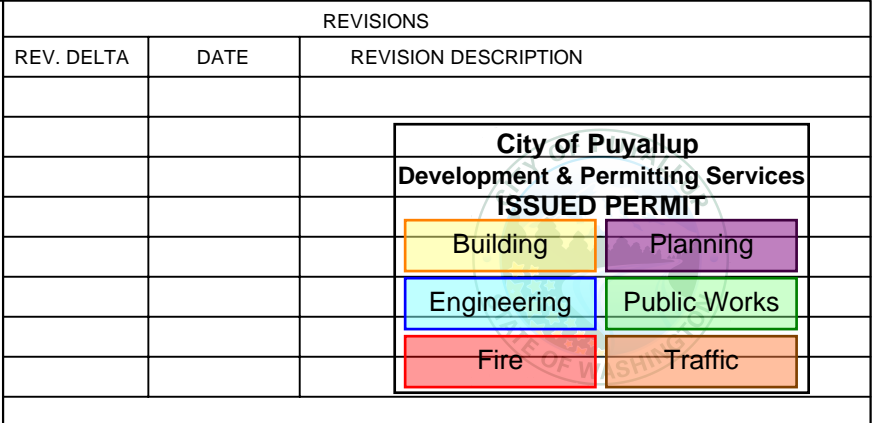

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**43rd AVE DUPLEX**  
**PRRNSF20230919**  
433 43RD AVE SW  
PUYALLUP, WA

WIND SPEED:	110 MPH
WIND EXPOSURE:	B
ROOF SNOW LOAD:	21 PSF

STRUCTURAL DETAILS	
DRAWN BY:	AMS
ORIGINAL DRAWING DATE:	APR. 5, 2023
SCALE:	N.T.S. (UNO.)
PFE NUMBER:	PFE 21.047
DESIGNER:	RUEPFEL
SHEET NO.:	<b>SD-2</b>

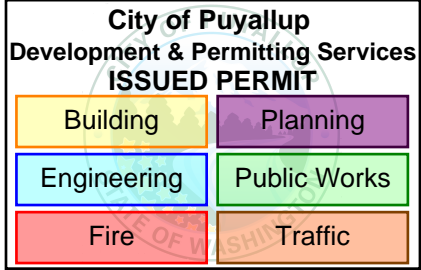PHILLIPS STRUCTURAL ENGINEERING