	1	2	3
	DRAWING S	YMBOLS	ABBREVIATIONS
Η		SECTION NUMBER DRAWING NUMBER SECTION CALLOUT SECTION CALLOUT ELEVATION NUMBER DRAWING NUMBER DRAWING NUMBER	A AMP AB ANCHOR BOLT AC ALTERNATING CURRENT ACC ACCESSIBLE ACP ACOUSTICAL CEILING PANEL ACT ACOUSTIC CEILING TILE AD AREA DRAIN ADA AMERICANS WITH DISABILITIES ACT ADD ADDENDUM ADDN ADDITION ADDL ADDITIONAL ADJ ADJUSTABLE AFF ABOVE FINISHED FLOOR AGGR AGGREGATE AHJ AUTHORITY HAVING JURISDICTION AHU AIR HANDLING UNIT AISC AMERICAN INSTITUTE OF STEEL CONSTRUCTION ALT ALTERNATE ALUM ALUMINUM ANCH ANCHOR ANOD ANODIZED AP ACCESS PANEL APPROX APPROXIMATE
G	XX NUMBER AXXX DRAWING NUMBER DETAIL CALLOUTS MATCH LINE	ELEVATION CALLOUT ELEVATION NUMBER AXXX DRAWING NUMBER INTERIOR ELEVATION CALLOUT	AR ACID RESISTANT ARCH ARCHITECT, ARCHITECTURAL ASST ASSISTANT ASTM AMERICAN SOCIETY FOR TESTING MATERIALS ASSY ASSEMBLY ATM ATMOSPHERIC ATS AUTOMATIC TRANSFER SWITCH AUTO AUTOMATIC AV AUDIO VISUAL AVE AVENUE AVG AVERAGE AWP ACOUSTICAL WALL PANEL
F	$\overrightarrow{AXXX} \overrightarrow{DRAWING NUMBERFOR CONTINUATION}$ $\overrightarrow{MATCH LINE}$ $\overrightarrow{1}$ $\overrightarrow{C}$ $\overrightarrow{A}$ $$	ROOM NAME XXXX ROOM NUMBER RECOUNT ACC	B         BA         BA         BA         BA         BA         BA         BA         BA         BARRIER         BARARIER         CA
D	PLAN SYMB         PLAN SYMB         PLAN SYMB         Image: Provide the symplectic sympl	OLS SUPPLY AIR DIFFUSER RETURN AIR GRILLE EXHAUST FAN PUBLIC ANNOUNCEMENT SPEAKER	CORR CORRIDOR CP CENTER POINT CPT CARPET CR CARD READER CRAC COMPUTER ROOM AIR CONDITIONING UNIT CRB CARD READER WITH BIOMETRIC SCAN CRAH COMPUTER ROOM AIR HANDLING UNIT CSK COUNTERSINK, COUNTERSUNK CT CERAMIC TILE CTR COUNTER CTWR COOLING TOWER CU CONDENSING UNIT CUB CUBIC CW COLD WATER CY CUBIC YARD D d PENNY (NAILS) D DEEP db DECIBLES DBL DOUBLE DC DIRECT CURRENT DEG DEGREE(S) DEMODEMOLISH, DEMOLITION DEPT DEPARTMENT DET DETAIL DF DRINKING FOUNTAIN
С	FXRECESSED TROFFER LIGHTING FIXTUREFXRECESSED CAN LIGHITNG FIXTUREFXRECESSED STRIP LIGHITNG FIXTUREFXSURFACE MOUNTED STRIP LIGHITNG FIXTUREFXVALL MOUNTED LIGHITNG FIXTURE	EPO EMERGENCY BOWER OFF SWITCH	DIA DIAMETER DIAG DIAGONAL DICA DRILLED IN CONCRETE ANCHOR DIFF DIFFUSER DIM DIMENSION(S) DIR DIRECTOR DISC DISCONNECT DISP DISPENSER DIV DIVISION DL DEAD LOAD DMPF DAMP PROOF, DAMP PROOFING DN DOWN DO DITTO DP DEEP DR DOOR/DRAIN DRC DOOR CONTACT DS DOWNSPOUT DW DISHWASHER DWG DRAWING DWL DOWEL DWR DRAWER DWTR DISTILLED WATER E E EAST EA EXHAUST AIR
В	SECURITY         SECURITY         CR         CRB         CRB         COMBINATION CARD         READER/BIOMETRIC         SCANNER         DC	RF RFID READER	EA EXHAUST AIR EB EXPANSION BOLT EF EXHAUST FAN EJ EXPANSION JOINT EL ELEVATION ELEC ELECTRICAL ELEV ELEVATION / ELEVATOR ELIM ELIMINATE EMER EMERGENCY EPWREMERGENCY POWER ENAM ENAMEL(ED) ENCL ENCLOSURE ENG ENGINEER ENT ENTRANCE EP EXPLOSION PROOF EPOXFL EPOXY FLOORING EPOXPT EPOXY FLOORING EPOXPT EPOXY PAINT EQ EQUAL EQUIPEQUIPMENT EPO EMERGENCY POWER OFF ES EMERGENCY SHOWER ESDF ELECTRO STATIC DISSAPATIVE FLOORING EST ESTIMATE(D) ETC ET CETERA ETR EXISTING TO REMAIN EVAC EVACUATE, EVACUATION EW EYE WASH
A	DBDURESS BUTTONICINTERCOMICCINTERCOM W/CAMERAPIRPASSIVE INFRARED DETECTORMDMOTION DETECTORPINPIN PAD		EXAM EXAMINATION EXC EXCAVATE, EXCAVATED, EXCAVATION EXH EXHAUST EXIST EXISTING EXP EXPOSED, EXPANSION EXT EXTERIOR EXTR EXTRUDED

#### 5

FAB FABRICATE, FABRICATOR / FABRIC FAC FACILITY FACP FIRE ALARM CONTROL PANEL FAS FIRE ALARM SYSTEM

FAS FIRE ALARM SYSTEM FB FLAT BAR FC FURRING CHANNEL FCU FAN COIL UNIT FD FLOOR DRAIN FDC FIRE DEPARTMENT CONNECTION FDN FOUNDATION FE-X FIRE EXTINGUISHER, "X" DENOTES TYPE FEC-X FIRE EXTINGUISHER CABINET, "X" DENOTES TYPE FGL FIBERGIAS FGL FIBERGLAS FH FIRE HYDRANT FHC FIRE HOSE CABINET

FARENHEIT

FIRE ALARM

FHC FIRE HOSE CABINET FIG FIGURE FIN FINISH, FINISHED FLASH FLASHING FLEX FLEXIBLE FLR FLOOR, FLOORING FLUOR FLUORESCENT FO FINISHED OPENING FOIB FURNISHED BY OTHERS, INSTALLED BY OTHERS FOIC FURNISHED BY OTHERS, INSTALLED BY CONTRACTOR FOW FACE OF WALL FP FIRE PROOFING, FIRE PROTECTION FPM FEET PER MINUTE FPS FEET PER SECOND FPS FEET PER SECOND FR FIRE RATED, FIRE RATING FREQFREQUENCY FRTW FIRE RETARDANT TREATED WOOD FRTW FIRE RETARDANT TR FS FLOOR SINK FSD FIRE/SMOKE DAMPER FT FOOT, FEET FTG FOOTING F TO F FACE TO FACE FURRFURRING FUT FUTURE FWC FABRIC WALL COVERING FXD FIXED

GA GAUGE / GYPSUM ASSOCIATION GAL GALLON GALV GALVANIZED GRAB BAR GC GENERAL CONTRACTOR GEN GENERAL / GENERATOR GFRCGLASS FIBER REINFORCED CONCRETE GFRG GLASS FIBER REINFORCED GYPSUM GALVANIZED IRON GLASS OR GLAZING

GLANGLUE LAMINATED GLP GYPSUM LATH AND PLASTER GSL GYPSUM SHAFT LINER GWB GYPSUM WALLBOARD GYP GYPSUM

H HIGH HB HOSE BIBB HC HOLLOW CORE HD HAND DRYER HDB HARD BOARD HDF HIGH DENSITY FIBERBOARD HDW HARDWARE HDWDHARDWOOD HM HOLLOW METAL HO HOLD OPEN HORIZHORIZONTAL HR HOUR HT HEIGHT

GB

HZ HERTZ (FREQUENCY) HT HEIGHT HVAC HEATING, VENTILATION AND AIR CONDITIONING

I IBC INTERNATIONAL BUILDING CODE IC INTERCOM ID INSIDE DIAMETER IEC INTERNATIONAL ENERGY CODE IFC INTERNATIONAL FIRE CODE IMC INTERNATIONAL MECHANICAL CODE INCL INCLUDE, INCLUDING INFO INFORMATION INSUL INSULATION

INSUL INSULATION INT INTERIOR IPC INTERNATIONAL PLUMBING CODE

JANITOR JANITOR'S SINK JOINT KITCHEN KILO-VOLT

JAN JS

KIT

KV KILO-VOLT KVA KILO-VOLT-AMPERE KW KILO-WATT LONG

LAM LAMINATE, LAMINATED LAWI LAWINATE, LAWINATED LAU LAUNDRY LAV LAVATORY LH LEFT HAND LHR LEFT HAND REVERSED LS LAG SCREW LT LIGHT LTG LIGHTING

MAS MASONRY MATL MATERIAL MAX MAXIMUM MDF MEDIUM DENSITY FIBERBOARD MDF(T) MAIN DISTRIBUTION FRAME-TELECOM MECH MECHANICAL MECHANICAL MED MEDIUM MEMB MEMBRANE MEZZ MEZZANINE MFR MANUFACTURE, MANUFACTURER MGMT MANAGEMENT MGMT MANAGEMEN MH MANHOLE MIN MINIMUM, MINUTE MTD MOUNTED MTD MOUNTED MTL METAL MTS MANUAL TRANSFER SWITCH MP METAL PANEL MPOE MINIMUM POINT OF ENTRY (TELECOM)

MS METAL STUD MVA MEGA-VOLT-AMPERE MVBL MOVABLE MW MEGA-WATT

NORTH NEC NATIONAL ELECTRIC CODE NEPA NATIONAL FIRE PROTECTION ASSOCIATION NOPA NATIONAL FIRE PROT NIC NOT IN CONTRACT NOM NUMBER NOM NOMINAL NS NO SCALE NTS NOT TO SCALE

ON CENTER OUTSIDE DIAMETER OVERHEAD O OVERFLOW DRAIN O OVERHEAD DOOR OH OVERHEAD OFD OVERFLOV OHD OVERHEAD OPNG OPENING OPP OPPOSITE OFRD OVERFLOW ROOF DRAIN OTS OPEN TO STRUCTURE ABOVE

PA PUBLIC ANNOUNCEMENT SYSTEM PB PUSH BUTTON PBD PARTICLE BOARD PBD PARTICLE BOARD PC PRECAST PDU PLANTER DRAIN PDU POWER DISTRIBUTION UNIT PERP PERPINDICULAR PIR PASSIVE INFRARED DETECTOR PL PROPERTY LINE PL PROPERTY LINE PLAM PLASTIC LAMINATE PLAS PLASTER PLYWD PLYWOOD

PNL PANEL PR PAIR PRK PARK, PARKING PROP PROPERTY PROPERTY POC POINT OF CONNECTION PT PAINT, PAINTED, POINT, PRESSURE TREATED PTD PAPER TOWEL DISPENSER PTN PARTITION PVMT PAVEMENT



R RISER RA RETURN AIR RAD RADIUS RAF RAISED ACCESS FLOOR SYSTEM RD ROOF DRAIN, ROAD REF REFERENCE REFERENCE REF REFERENCE REFR REFRIGERATOR REINF REINFORCE, REINFORCING REQD REQUIRED REV REVISION RF RELIEF FAN RFG ROOFING RH RIGHT HAND RHR RIGHT HAND REVERSED RL RAIN LEADER RM ROOM RO ROUGH OPENING RPM REVOLUTIONS PER MINUTE RPP REMOTE POWER PANEL RR RELAY RACK RTU RIGHT RTU ROOF TOP AIR CONDITIONING UNIT

SOUTH SUPPLY AIR SOLID CORE SCHED SCHEDULE SD SMOKE DETECTOR, STORM DRAIN SD SMOKE DETECTOR, STORM DRAIN SECT SECTION SGL SINGLE SHT SHEET SHTGSHEATHING SIM SIMILAR SJ SIESMIC JOINT SMACNA SHEET METAL AND AIRCONDITIONING CONTRACTORS NATIONAL ASSOCIATION SMD SMOKE DAMPER SMR SHEET METAL ROOFING SMP SHEET METAL PANEL SPD SOAP DISPENSER SPEC SPECIFICATION SPKLR SPRINKLER SPKLR SPRINKLER SPKR SPEAKER SPKR SPEAKER SPR SINGLE PLY ROOFING SQ SQUARE SR SERVER RACK SS SERVICE SINK SSM SOLID SURFACING MATERIAL SSTL STAINLESS STEEL STC SOUND TRANSMISSION OF ASS SOUND TRANSMISSION CLASS

STE STEEL STORSTORAGE STRUCT STRUCTURE, STRUCTURAL SVF SHEET VINYL FLOORING SW SIDEWALK SWBD SWITCHBOARD SWG SWITCHGEAR T TREAD TBB TELEPHONE BACKBOARD TBD TILE BACKER BOARD TD TRENCH DRAIN TEL TELEPHONE TEMPTEMPERATURE, TEMPORARY

TERZ TERRAZZO T&G TONGUE AND GROOVE THK THICK, THICKNESS TO TOP OF TO TOP OF TPD TOILET PAPER DISPENSER TS TUBE STEEL TSTAT THERMOSTAT TV TELEVISION TVD TYPICAL TYP TYPICAL


U URINAL UF UNDER FLOOR UL UNDERWRITERS LABORATORIES UNFIN UNFINISHED UNGRD UNDERGROUND UON UNLESS OTHERWISE NOTED UPS UNITERRUPTIBLE POWER SUPPLY

V VOLT VB VAPOR BARRIER VC VIDEO CAMERA VCT VINYL COMPOSITION TILE VERT VERTICAL VEST VESTIBULE VIF VERIFY IN FIELD VNR VENEER VTF VINYL TILE FLOORING VWC VINYL WALL COVERING

WATT WEST, WIDE WITH WATER CLOSET WD WOOD WF WIDE FLANGE WH WALL HYDRANT WM WATER METER WMP WIRE MESH PARTITION W/O WITHOUT WP WEATHER PROOF, WATER PROOF WWF WELDED WIRE FABRIC

XRAY XRAY PROCESS OR MACHINE XFMR TRANSFORMER YD YARD ZN ZINC

VICINITY MAP

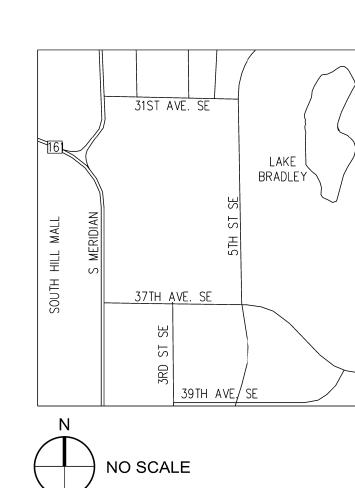

## **PROJECT INFO**

PROJECT ADDRESS 1023 39TH AVENUE SE PUYALLUP, WA 98374-2121

PARCEL NUMBER 0419034037

LEGAL DESCRIPTION SECTION 03 TOWNSHIP 19 RANGE 04 QUART ROS 2007-04-30-5001 (AFF OF MIN OR CORR S 2007102600450) COM AT S  $\frac{1}{4}$  COR OF SEC TH N SEC W 2621.06 FT FROM SE COR TH N OO DEG 676.33 FT TO POB TH CONT N 00 DEG 00 MIN 2 TO A PT S 00 DEG 00 MIN 24 SEC W 30.21 FT TH 17 SEC E 1258.61 FT TH S 00 DEG 13 MIN 45 SE S 42 DEG 55 MIN 23 W 659.07 FT TH S 07 DEG 4 686.42 FT TH N 87 DEG 01 MIN 38 SEC W 169.4 MIN 42 SEC E 672.42 FT TH N 89 DEG 59 MIN 3 TO POB APPROVED SUBD BY CY OF PUYALLU 04/03/07 OUT OF 4-028 SEG 2008-0246 10/23/0

# CODE INFORMA

#### APPLICABLE CODES

WASHINGTON BUILDING CODE, 2021 EDITION WASHINGTON FIRE CODE, 2021 EDITION WASHINGTON MECHANICAL CODE, 2021 EDITION WASHINGTON MECHANICAL CODE, 2021 EDITION WASHINGTON PLUMBING CODE, 2021 EDITION NATIONAL ELECTRIC CODE, 2023 EDITION WASHINGTON STATE ENERGY CODE, 2021 EDI

#### LAND USE CODES

PUYALLUP MUNICIPAL CODE EXISTING ZONING DESIGNATION: MP - BUSIN PROPOSED ZONING DESIGNATION: MP - BUSI CHANGE OF USE REQUIRED: NO

**BUILDING CODE INFORMATION** BUILDING OCCUPANCY GROUP: TYPE B, DAT

TYPE OF CONSTRUCTION: TYPE IIA, FULLY S NO CHANGE TO BUILDING HEIGHT OR AREA

LAND USE CODE INFORMATION

### EXISTING SITE AREA: 15.77ACRES


## **GENERAL NOTE**


- DO NOT SCALE THE DRAWINGS.
- THE DRAWINGS AND SPECIFICATIONS AND WHAT IS SHOWN ON ONE SHALL BE CON **REQUIRED BY BOTH.**
- THE CONTRACTOR SHALL VERIFY ALL F - 3. PRIOR TO COMMENCING ANY WORK. NOTIFY THE ARCHITECT IMMEDIATELY IMPACT THE IMPLEMENTATION OF THE ALL EXISTING ELEMENTS SHOWN ON T ARE INCLUDED WITHOUT ANY GUARAN
- ALL DIMENSIONS ARE SHOWN TO THE S OR FINISHED SURFACES, UNLESS NOTE 4
- DETAILS ARE SHOWN ON THE DRAWING OCCURANCE OF THE CONDITION AND AF OTHER SIMILAR CONDITIONS.
- PROVIDE A MINIMUM OF 6" FROM AN AD. SURFACE TO THE EDGE OF ANY FINISHE 6


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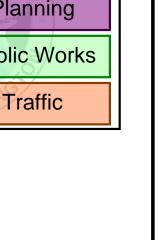
8	9	10	11	12
		PROJECT DIRECTORY		SHEET INDEX
PROJECT SITE		OWNER BENAROYA CAPITAL, LLC 9675 SE 36TH STREET, SUITE 115 MERCER ISLAND, WA 98040 MAIN PHONE: 253-200-4120 CONTACT: DAVID VRANIZAN 206-774-1011 DAVEV@BENAROYA.COM		ARCHITECTURAL A-000-12 GENERAL INFORMATION A-101-12 OVERALL SITE PLAN A-102-12 ENLARGED SITE PLAN: NORTH UTILITY YARD GENERATOR PLAN STRUCTURAL
		CASCADE MISSION CRITICAL, LLC 6210 36TH AVENUE N.E. SEATTLE, WA 98115 MAIN PHONE: 206-294-1288 CONTACT: LEONARD A. RUFF, AIA PHONE: 206-294-1288 EMAIL: LEONARD.RUFF@CASCADE MISSIONCRITICAL.COM		S1.0GENERAL STRUCTURAL NOTESS1.1GENERAL STRUCTURAL NOTESS2.1CNORTH YARD GENERATOR PLAN (EAST)S3.2BDETAILS
39TH AVE. SE		STRUCTURAL ENGINEER QUANTUM CONSULTING ENGINEERS 1511 THIRD AVENUE, SUITE 323 SEATTLE, WA 98101 MAIN PHONE: 206-957-3900 CONTACT: SCOTT TINKER, PE 206-957-3917 SCOTTTINKER@QUANTUMCE.COM		City of PuyallupDevelopment & Permitting ServicesISSUED PERMITBuildingPlanningEngineeringFireTraffic
RMATION		SCOPE OF WORK		
		WORK UNDER THIS PERMIT INSTALL 7 (SEVEN) 2,500 KW DIESEL STANDBY GENERATORS EACH WITH 8,400 GALLON INTEGRAL FUEL STORAGE BELLY TANKS. WORK UNDER SEPARATE PERMITS ELECTRICAL WORK		
ER 43 PARCEL "1" OF SURVEY N 86 DEG 31 MIN 42 G OO MIN 24 SEC E 24 SEC E 1923.18 FT H S 87 DEG 44 MIN EC W 1391.90 FT TH 42 MIN 49 SEC E 5 FT TH N 00 DEG 52 6 SEC W 736.66 FT JP PLANNING DEPT 7CL DC11/19/07CL		Separate approval by L & I is required for factory built eFRAME™ Enclosures. Contact L & I Factory Assembled Structures and provide verification for inspections.		
ATION				
I TON N DITION				
IESS PARK SINESS PARK				
A CENTER SPRINKLERED				
ES				City of Puyallup Building REVIEWED FOR COMPLIANCE RayC
ARE COMPLEMENTARY. NSTRUED TO BE				05/31/2024 5:15:23 PM
FIELD CONDITIONS IF ANY CONDITIONS DESIGN INTENT. HE DRAWINGS		City of Puy		See Slab Construction permits for Building, Planning and Engineering review
TEE OF ACCURACY. STRUCTURAL GRID ED OTHERWISE. GS FOR THE FIRST		Fire REVIEW FOR COMPLIA	'ED	THE APPROVED CONSTRUCTION PLANS AND ALL ENGINEERING MUST BE POSTED ON THE JOB AT ALL INSPECTIONS IN A VISIBLE AND
ARE TYPICAL FOR ALL DJACENT FINISHED ED OPENING.		DDrake 05/30/202 1:53:46 P	e 14 M	READILY ACCESSIBLE LOCATION. Approval of submitted plans is not an approval of omissions or oversight by this office or noncompliance with any applicable regulations of local government. The contractor is responsible for making sure that the building complies with all applicable building codes and regulations of the local government.





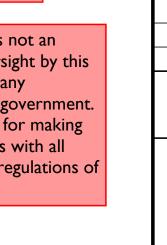

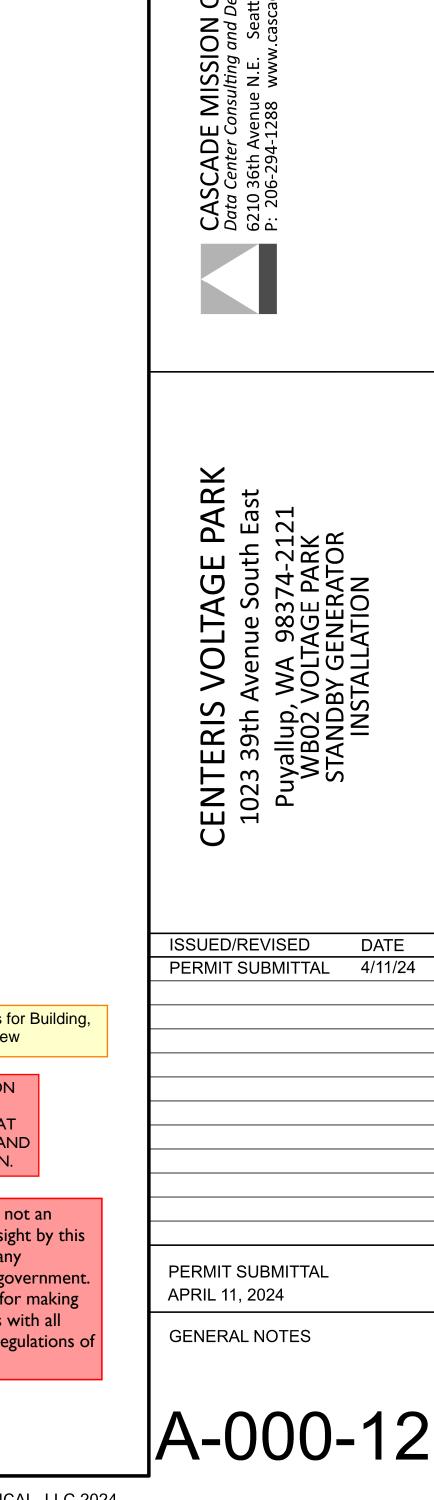

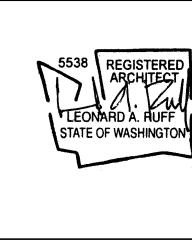

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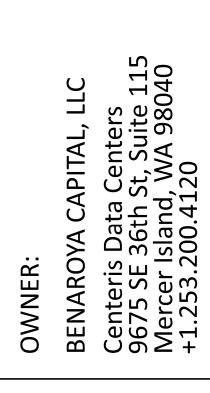
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**CRITI** Design



### SITE INFORMATION

PARCEL NO. 0419034037 ADDRESS: 1023 39TH AVENUE S.E. PARCEL AREA: 15.77 ACRES

LEGAL DESCRIPTION

Section 03 Township 19 Range 04 Quarter 42 LOT 2 OF BLR 2022-03-22-5003 A POR OF BLR 2019-05-22-5002 LY IN CY OF PUYALLUP MORE PARTICULARLY DESC AS FOLL COM AT STONE MON MARKING S 1/4 COR OF SEC 3 SD STONE MON LIES N 86 DEG 31 MIN 42 SEC E 2621.06 FT FROM SE COR OF SD SEC 3 TH N 00 DEG 00 MIN 24 SEC E 2599.51 FT TH S 87 DEG 44 MIN 17 SEC E 496.53 FT TO POB TH S 00 DEG 04 MIN W 132.96 FT TH S 16 DEG 29 MIN 57 SEC E 15.96 FT TH S 00 DEG 00 MIN 36 SEC E 335.82 FT TH S 52 DEG 49 MIN 01 SEC E 132.81 FT TH S 89 DEG 15 MIN 41 SEC E 28.82 FT TH S 82 DEG 14 MIN 13 SEC E 58.63 FT TH S 53 DEG 48 MIN 38 SEC E 78.9 FT TH S 89 DEG 41 MIN 48 SEC E 655.79 FT TH S 83 DEG 08 MIN 36 SEC E 199.54 FT TH N 00 DEG 13 MIN 45 SEC E 602.4 FT TH N 87 DEG 44 MIN 17 SEC W 1118.01 FT TO POB EASE OF REC OUT OF 04-19-03-4-031 & 4-034 SEG 2019-0472 05/30/19 JP 20190652DC 03/31/22 JP

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#### OVERALL SCOPE OF WORK

#### DATA CENTER BUILDING (PARCEL 0419034037) TENANT IMPROVEMENTS

INSTALL 7 (SEVEN) 2,500 KW STANDBY DIESEL GENERATORS, EACH EQUIPPED WITH 8,400 GALLON ABOVE GROUND FUEL STORAGE BELLY TANKS.

#### STANDBY DIESEL GENERATOR INFORMATION MODEL: KOHLER MODEL KD2500 RATED AT 2500 KW/3125 KVA


FUEL STORAGE: UL 142 LISTED ABOVE GROUND DIESEL FUEL STORAGE BELLY TANK FOR EACH GENERATOR, 8,300 GALLON USABLE CAPACITY. EPA RATING: TIER 2 FOR STATIONARY EMERGENCY APPLICATIONS ENCLOSURES: PRE-FABRICATED METAL SOUND ENCLOSURES, RATED AT 85 dba


#### **FUEL STORAGE INFORMATION - NEW GENERATORS**


FUEL TYPE: NO. 2 DIESEL FUEL STORAGE PER GENERATOR: 8,400 GALLONS

TOTAL FUEL QUANTITY PROPOSED THIS PERMIT: 8,400 GALLONS X 7 = 58,100 GALLONS FUEL STORAGE METHOD: ABOVE GROUND BELLY TANK WITHIN GENERATOR ENCLOSURE, UL 142 LISTED

EACH GENERATOR EQUIPPED WITH A 7 1/2 GALLON FILL/SPILL BUCK WITH PADLOCKED LID AND OVERFILL PREVENTION VALVE INSTALLED IN FILL/SPILL BUCKET SET AT 90%

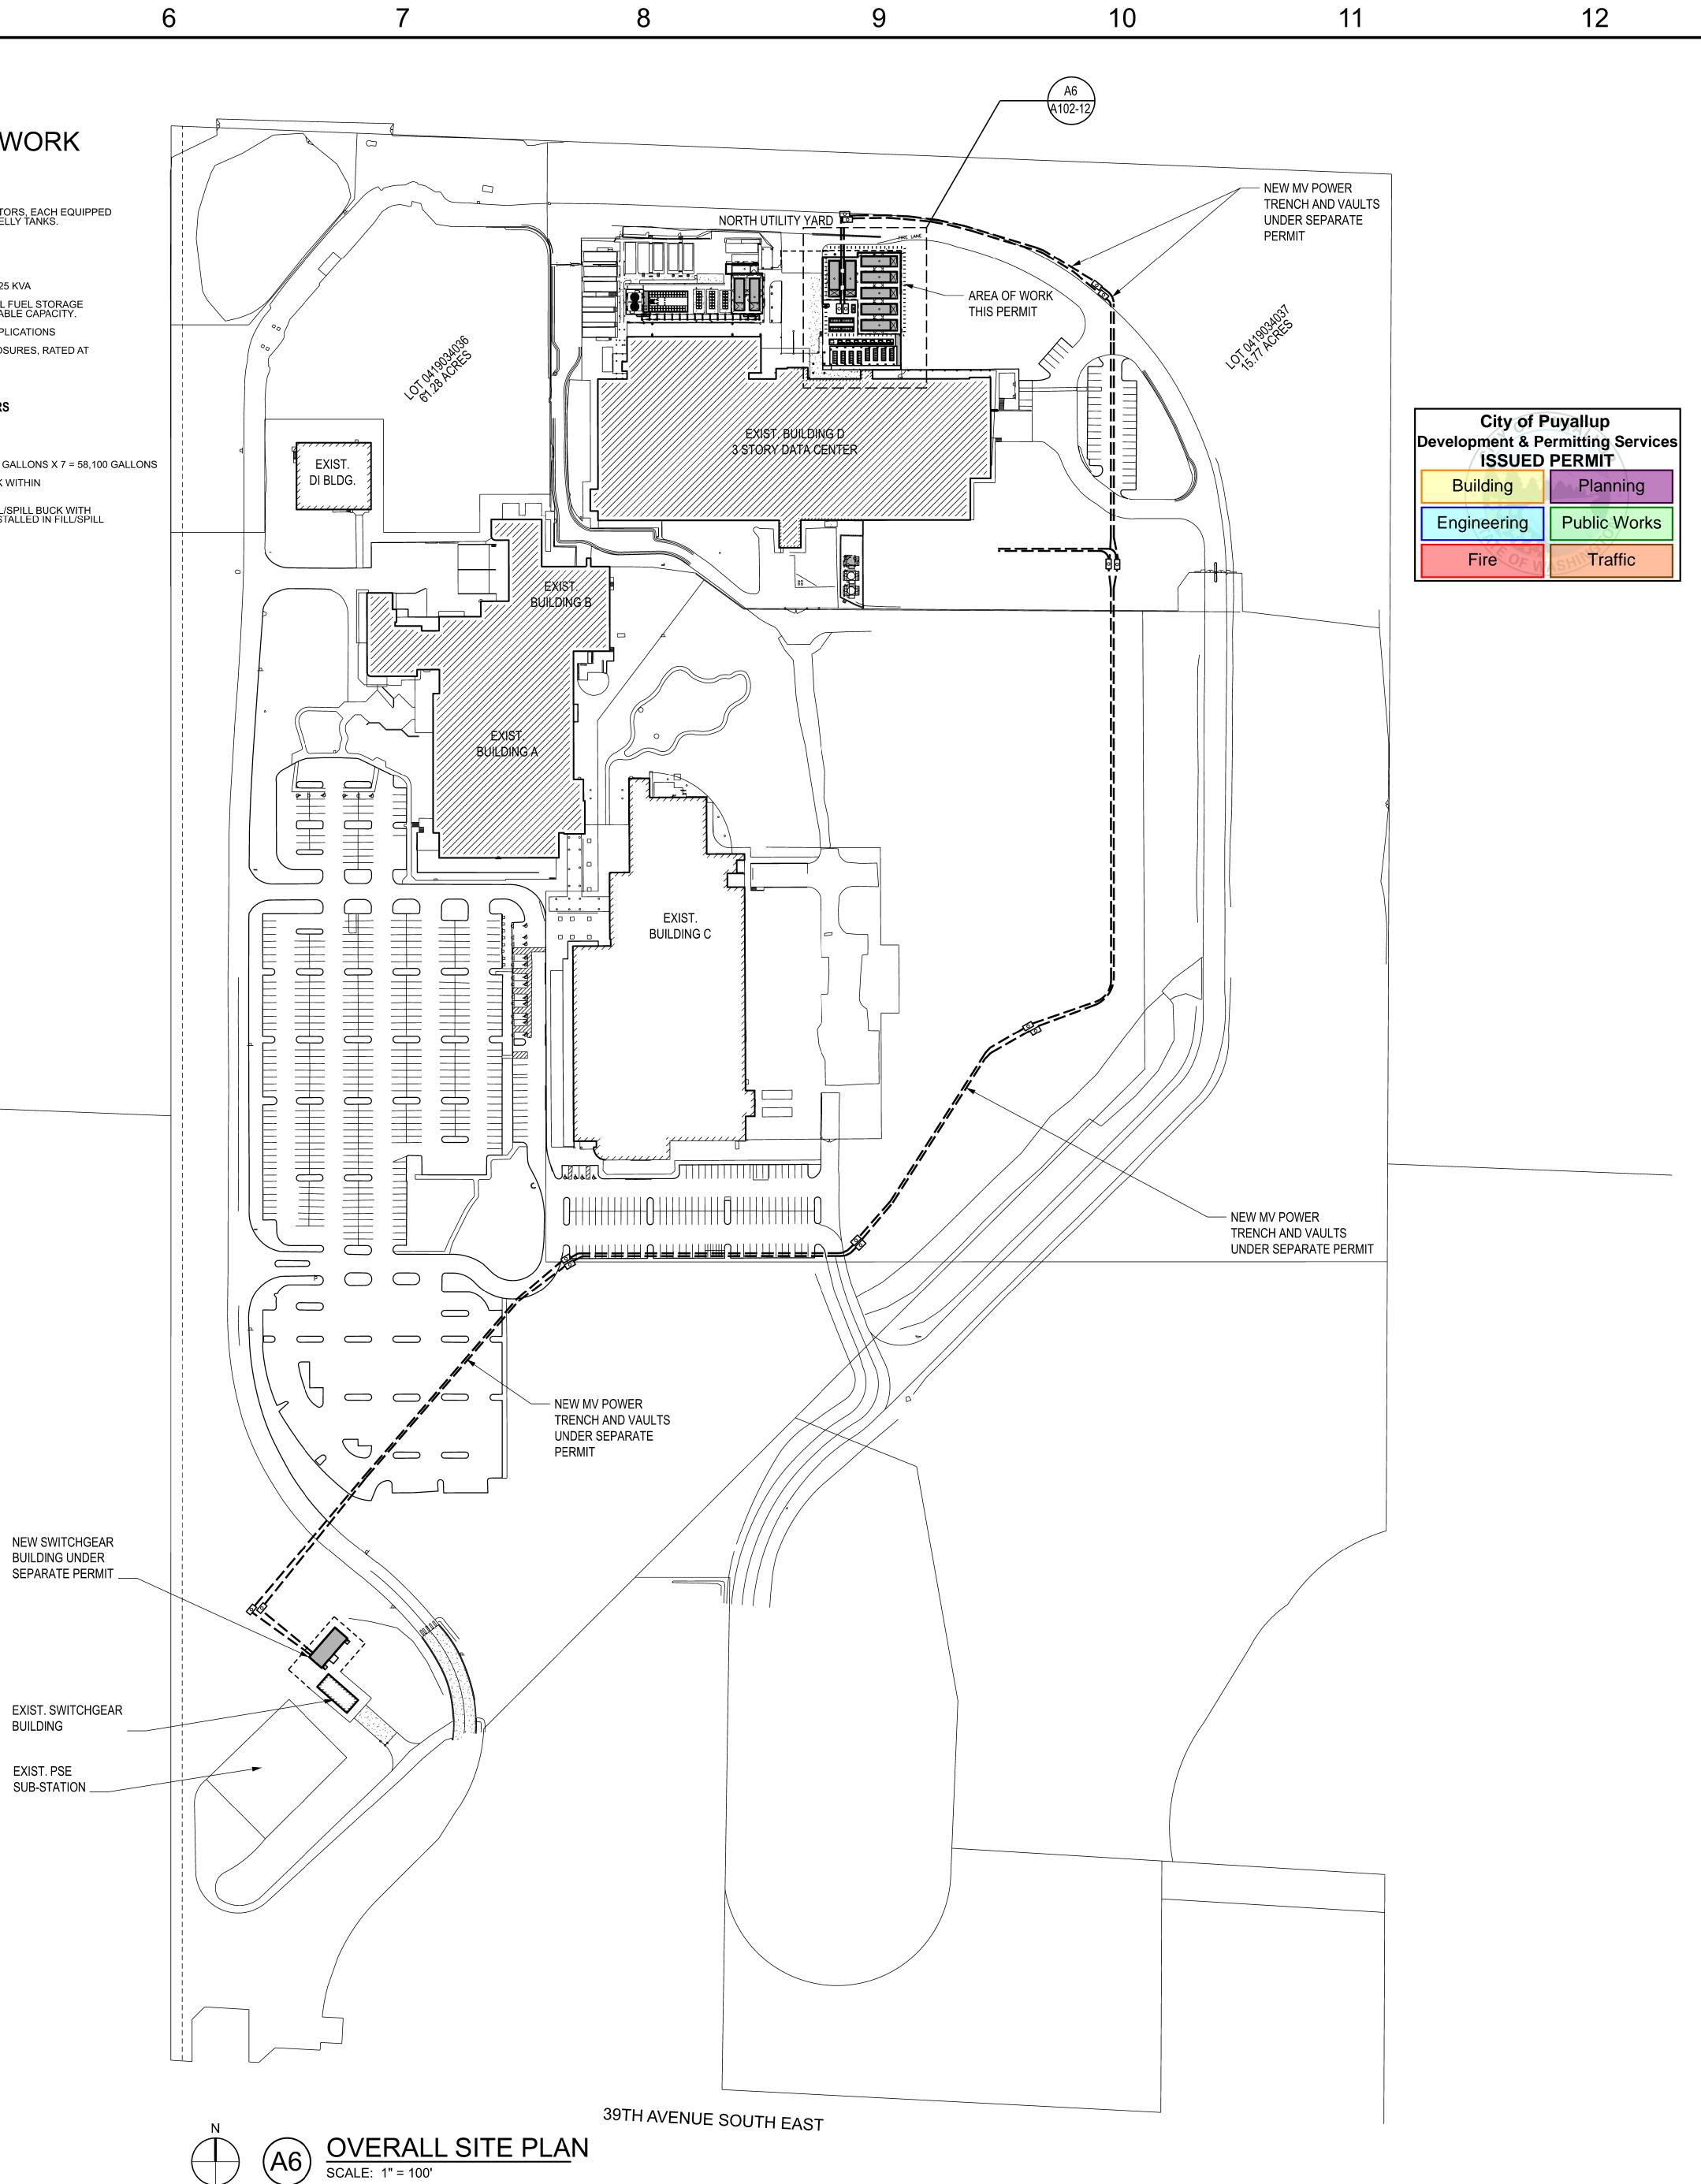

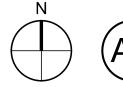

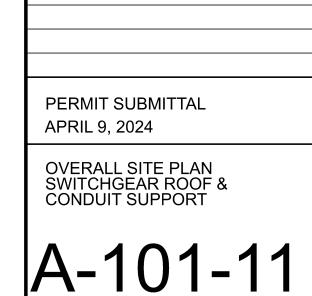

ISSUED/REVISED

PERMIT SUBMITTAL 4/9/24



DATE






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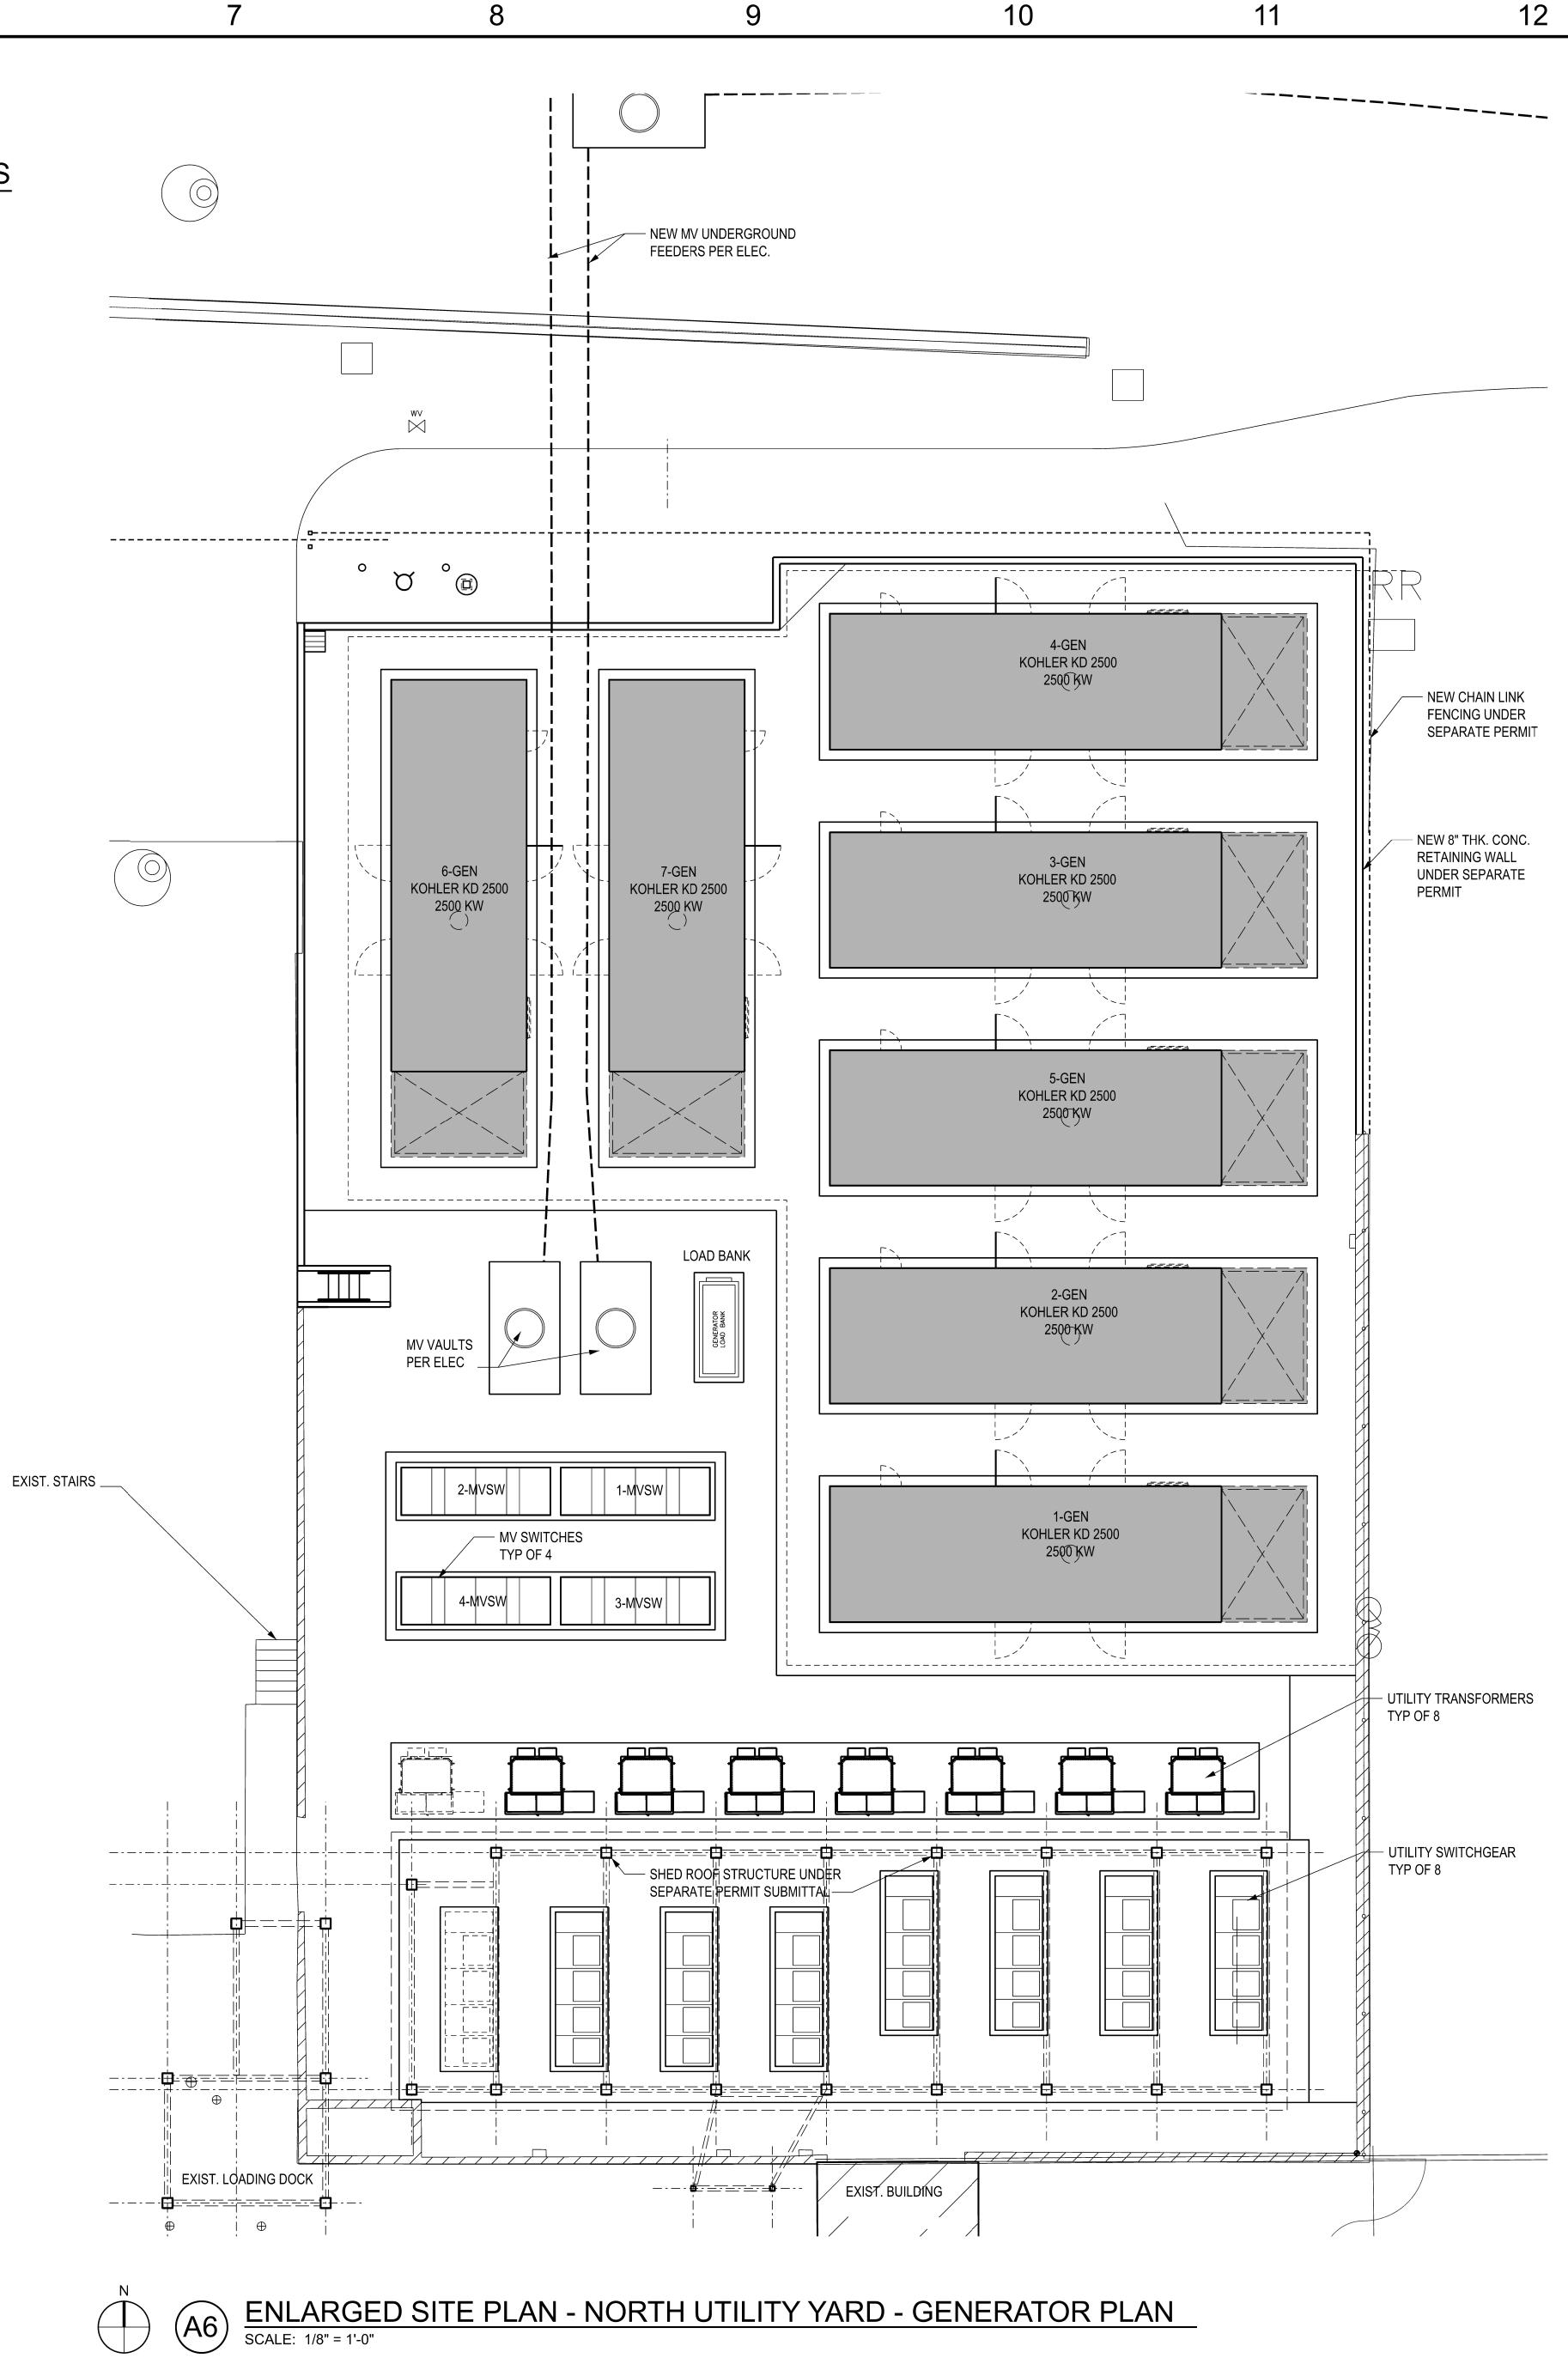
## WORK UNDER SEPARATE PERMITS

INSTALLATION OF MEDIUM VOLTAGE FEEDERS, VAULTS AND SWITCHES.

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- INSTALLATION OF UTILITY TRANSFORMERS. INSTALLATION OF ELECTRICAL SWITCHGEAR.
- INSTALLATION OF ELECTRICAL LOAD BANK.
- CONSTRUCTION OF NEW SHED ROOF OVER ELECTRICAL SWITCHGEAR. NEW CHAINLINK FENCING AND ROLLING SECURITY GATE.
- CONSTRUCTION OF GENERATOR FOUNDATIONS & EQUIPMENT PADS.
- INSTALLATION OF GENERATOR ACCESS PLATFORMS AND STAIRS.

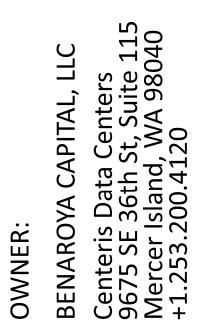City of Puyallup Development & Permitting Services ISSUED PERMIT						
Building	Planning					
Engineering	Public Works					
Fire	Traffic					



6



ENLARGED SITE PLAN

PERMIT SUBMITTAL

ISSUED/REVISED

PERMIT SUBMITTAL 4/11/24

DATE

APRIL 11, 2024

PARK CENTERIS VOLTAGE 1023 39th Avenue South Puyallup, WA 98374-2 WB02 VOLTAGE PAR STANDBY GENERATO INSTALLATION VOLTAGE







CONSULTANT:

11;040 LLC lite 98( OWNER: BENAROV Centeris I 9675 SE 3 Mercer Is +1.253.20