SUPPORT CAMPUS EXPANSION IMPROVEMENTS - PHASE 1

CIVIL CONSTRUCTION PERMIT

APPLICANT

PUYALLUP SCHOLL DISTRICT 1501 39TH AVE SW PUYALLUP, WA 98373 (253) 841-8641

CONTACT: LES GERSTMANN, ASST. DIRECTOR OF CONSTRUCTION MANAGMENT

CIVIL ENGINEER

JMJ TEAM 905 MAIN ST SUITE. 200 SUMNER. WA 98390 (206) 596 - 2020CONTACT: JUSTIN JONES, PE

ARCHITECT

TCF ARCHITECTURE 902 NORTH SECOND ST TACOMA, WA 98403 (206) 572-3993CONTACT: MONA REZVANI-OLSON, ASSOCIATE AIA

SURVEYOR

SITTS & HILL 4815 CANTER STREET TACOMA, WA 98409 (253) 474-9449CONTACT: DESI SCHILLING, P.L.S.

1501 39th Ave SW, Puyallup, WA 98371

PROJECT AREA

SHFFT LIST

OTILL I LIOT					
PUY SH Construction Documents - Phase 1					
Page #	Sheet #	Sheet Name			
1	C1-101	Cover Sheet			
2	C2-101	Composite Existing Site Plan			
3	C2-102	Existing Site Plan - South			
4	C3-101	Alignment Control Plan			
5	C4-101	TESC Plan			
6	C4-102	TESC Details			
7	C4-103	TESC Details			
8	C5-101	Demolition Plan			
9	C6-101	Proposed Site Plan			
10	C6-201	Storm Plan & Profile			
11	C6-301	Notes & Details			
12	C6-302	Notes & Details			
13	C7-101	Landscape Plan			

Vicinity Map

SITE INFORMATION:

SITE ADDRESS: 1501 39TH AVE SW PUYALLUP, WA

TAX PARCEL NUMBER(S): 0419043122 ZONING: PF & CB TOTAL PROJECT AREA: 5.0 ACRES

CONTROL INFORMATION:

HORIZONTAL DATUM: WASHINGTON STATE PLANE COORDINATE SYSTEM, SOUTH ZONE,

NAD 83/2011

BASED ON GPS OBSERVATION UTILIZING THE WASHINGTON STATE

REFERENCE NETWORK (WSRN)

MEASURED PUYALLUP PUBLISHED BENCHMARK

VERTICAL DATUM:

WSRN WITH NGS

BASED ON GPS OBSERVATION UTILIZING THE

GEOID18 LOADED

TO CONVERT TO NGVD DATUM. SUBTRACT 3.51 FROM ALL

ELEVATION VALUES

"SW 31-09" NGVD 29 ELEVATION 350.52

SURVEY DATE: APRIL, 2022

SERVICE PROVIDERS:

WATER: FRUITLAND MUTUAL WATER

LEGAL DESCRIPTION:

THE WEST HALF OF THE WEST HALF OF THE EAST HALF OF THE SOUTHWEST QUARTER OF SECTION 4, TOWNSHIP NORTH, RANGE 4 EAST, WILLAMETTE MERIDIAN, IN PIERCE COUNTY, WASHINGTON

PROJECT SITE

TOGETHER WITH THE WEST HALF OF SOUTHWEST QUARTER OF THE SOUTHWEST QUARTER OF SECTION 4, TOWNSHIP 19 NORTH, RANGE 4 EAST, WILLAMETTE MERIDIAN, IN PIERCE COUNTY, WASHINGTON;

EXCEPT THE WEST 30 FEET THEREOF RESERVED FOR ROAD; AND

EXCEPT RIGHT OF WAY FOR 112TH STREET EAST (LAKEVIEW PUYALLUP ROAD); AND

AND

EXCEPT THOSE PORTIONS CONVEYED TO THE STATE OF WASHINGTON BY DEED RECORDED UNDER RECORDING NUMBERS 2227326, 2227327, 2239840, 2227151, AND 9407070774;

EXCEPT THAT PORTION THEREOF CONVEYED TO THE CITY OF PUYALLUP BY DEED RECORDED UNDER RECORDING NUMBERS 200907210799 AND 200907210800;

EXCEPT THAT PORTION OF THE SOUTHWEST QUARTER OF THE SOUTHWEST QUARTER OF SECTION 4, TOWNSHIP 19 NORTH, RANGE 4 EAST, WILLAMETTE MERIDIAN, IN PIERCE COUNTY, WASHINGTON, DESCRIBED AS FOLLOWS: BEGINNING 30 FEET NORTH AND 15 FEET EAST OF THE SOUTHWEST CORNER OF SAID SECTION 4; THENCE NORTH553.14 FEET;

THENCE EAST 315 FEET; THENCE SOUTH 553.14 FEET;

THENCE WEST 315 FEET TO THE POINT OF THE BEGINNING;

EXCEPT THAT PORTION OF THE SOUTHWEST QUARTER OF THE SOUTHWEST QUARTER OF SECTION 4, TOWNSHIP 19 NORTH, RANGE 4 EAST, WILLAMETTE MERIDIAN, IN PIERCE COUNTY, WASHINGTON, DESCRIBED AS FOLLOWS COMMENCING AT THE SOUTHWEST CORNER OF SAID SECTION 4;

THENCE NORTH 00°04'25" EAST ALONG THE WEST LINE OF SAID SECTION, A DISTANCE OF 1,148.90 FEET TO

THE TRUE POINT OF BEGINNING;

THENCE NORTH 89°07'39" EAST, A DISTANCE OF 162.0 FEET:

THENCE NORTH 00°04'25" EAST. A DISTANCE OF 148.0 FEET: THENCE SOUTH 89°07'39" WEST, A DISTANCE OF 162.0 FEET TO THE WEST LINE OF SAID SECTION; THENCE SOUTH 00°04'25" WEST, 148.0 FEET ALONG THE WEST LINE OF SAID SECTION TO THE TRUE POINT OF

TOGETHER WILL ALL THAT PORTION OF PARCEL 2 AS DESCRIBED AND DELINEATED ON COSTCO WHOLESALE LOT COMBINATION RECORDED JUNE 7, 2000UNDER AUDITOR FILE NUMBER 2000006075005, IN PIERCE COUNTY, WASHINGTON LYING NORTH OF THE FOLLOWING DESCRIBED LINE AND ITS EASTERLY AND WESTERLY EXTENSIONS:

COMMENCING AT THE NORTHWEST CORNER OF SAID PARCEL 2; THENCE SOUTH 01°23'27" WEST ALONG THE WEST LINE OF SAID PARCEL 2, 499.48 FEET TO INTERSECT THE WESTERLY EXTENSION OF THE SOUTH LINE OF LOT 7 OF CRESTLINE ESTATES, PER PLAT THEREOF AS RECORDED IN VOLUME 45 OF PLATS AT PAGES 9 AND 10, RECORDS OF PIERCE COUNTY, WASHINGTON, BEING

THE POINT OF BEGINNING OF THIS LINE DESCRIPTION; THENCE SOUTH 88°16'11" EAST, ALONG SAID WESTERLY EXTENSION, 172.00 FEET TO THE SOUTHWEST CORNER OF SAID LOT 7 AND THE TERMINUS OF THIS LINE DESCRIPTION;

AND EXCEPT ANY PORTION OF SAID PARCEL 2 OF COSTCO WHOLESALE LOT COMBINATION RECORDED JUNE 7, 2000 UNDER RECORDING NO. 2000006075005, IN PIERCE COUNTY, WASHINGTON DESCRIBED AS THE CLAIM BOUNDARY WITHIN AGREED ORDER TO QUIET TITLE, PIERCE COUNTY SUPERIOR COURT CAUSE NUMBER 22-2-09290-0.

City of Puyallup **Development & Permitting Services ISSUED PERMIT** Building Planning Engineering **Public Works** Traffic

APPROVED ander Jule CITY OF PUYALLUP **ENGINEERING SERVICES** 07/10/2024 **NOTE**: THIS APPROVAL IS VOID AFTER 180 DAYS FROM APPROVAL DATE. THE CITY WILL NOT BE RESPONSIBLE FOR ERRORS AND/OR OMISSIONS ON THESE

CALL TWO BUSINESS DAYS BEFORE YOU DIG 1-800-424-5555 UTILITIES UNDERGROUND LOCATION CENTER

1562-008 June 10th, 2024 DRAWN BY: DESIGN BY:

SHEET NUMBER,

Cover Sheet

wner/Developer

Puyallup School District 1501 39th Ave SW Puyallup, WA 98371

902 North Second Street Tacoma, WA 98403 253-572-3993

905 Main Street, Suite #200

Support Campus Expansion

ONE INCH AT FULL SCALE.

IF NOT, SCALE ACCORDINGLY

Civil Construction Permit

41829 FORESSIONAL ENGIN

DESCRIPTION

1 06/10/24 Revised Per City Comments

REV DATE

Improvements - Phase 1

Sumner, WA 98390 (206) 596-2020

1501 39th Ave SW Puyallup, WA 98373


TCF Architecture


253-841-8641


FIELD CONDITIONS MAY DICTATE CHANGES TO THESE PLANS AS DETERMINED BY THE CITY ENGINEER


C1-101


1 OF 13

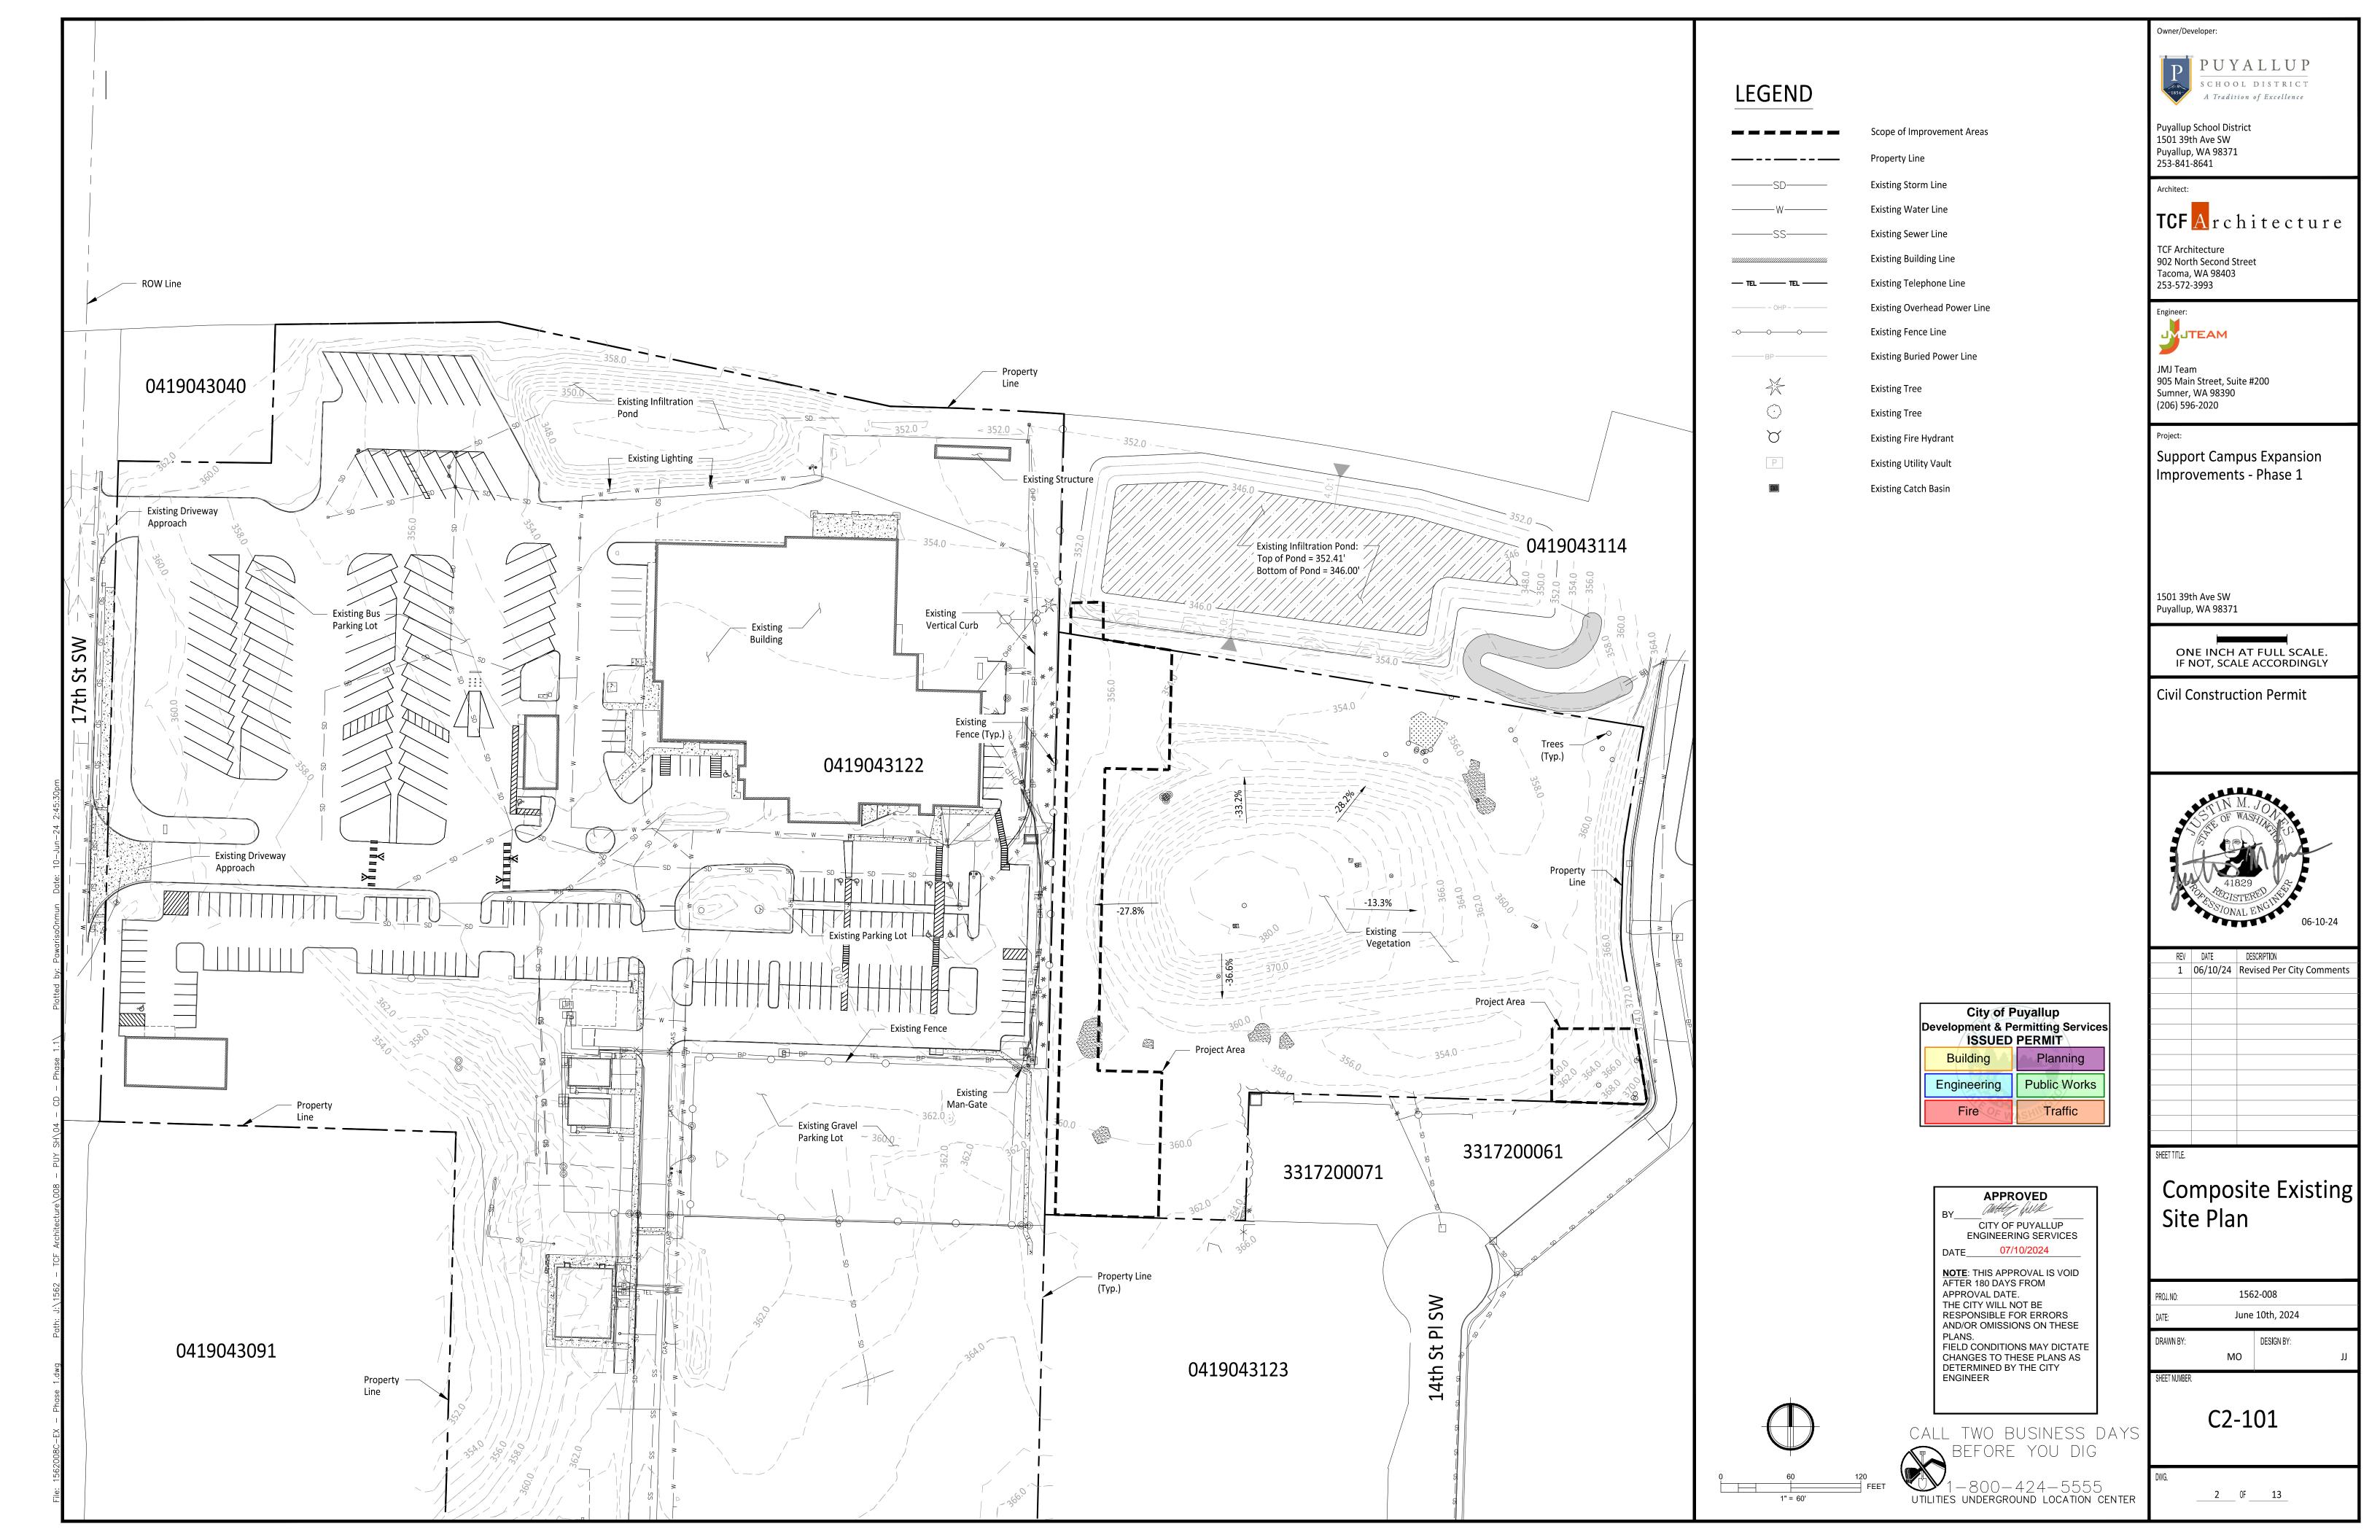


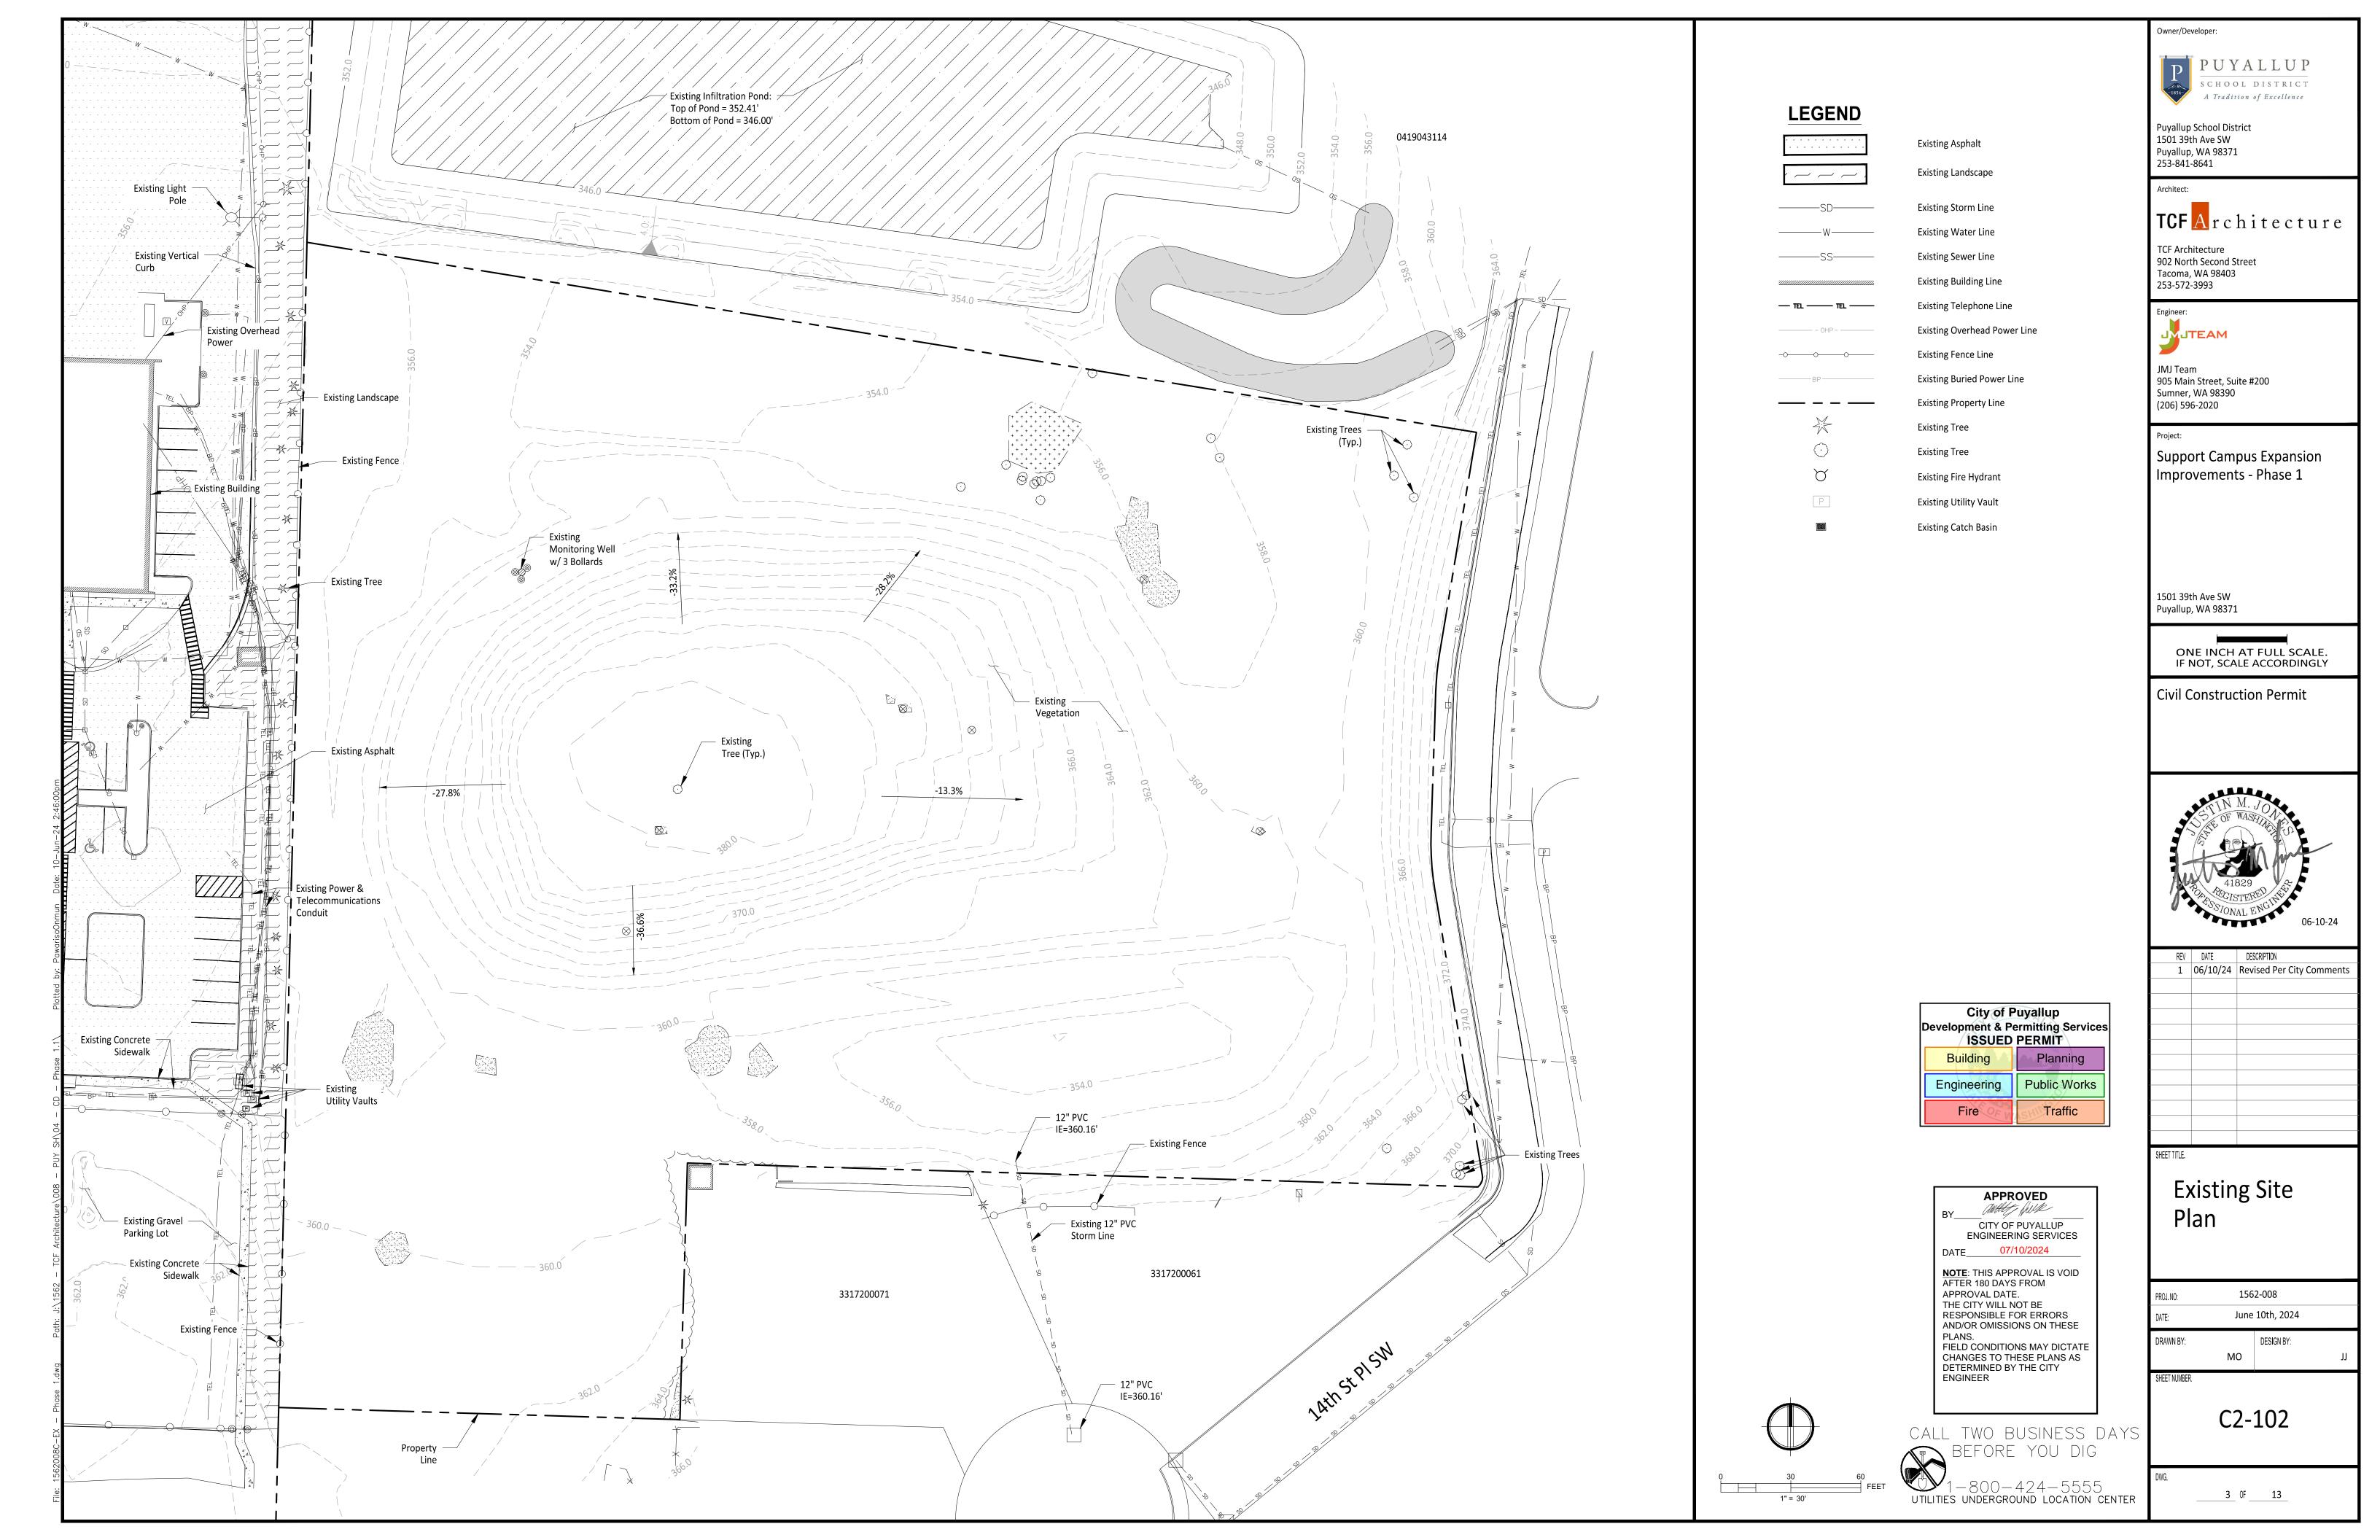


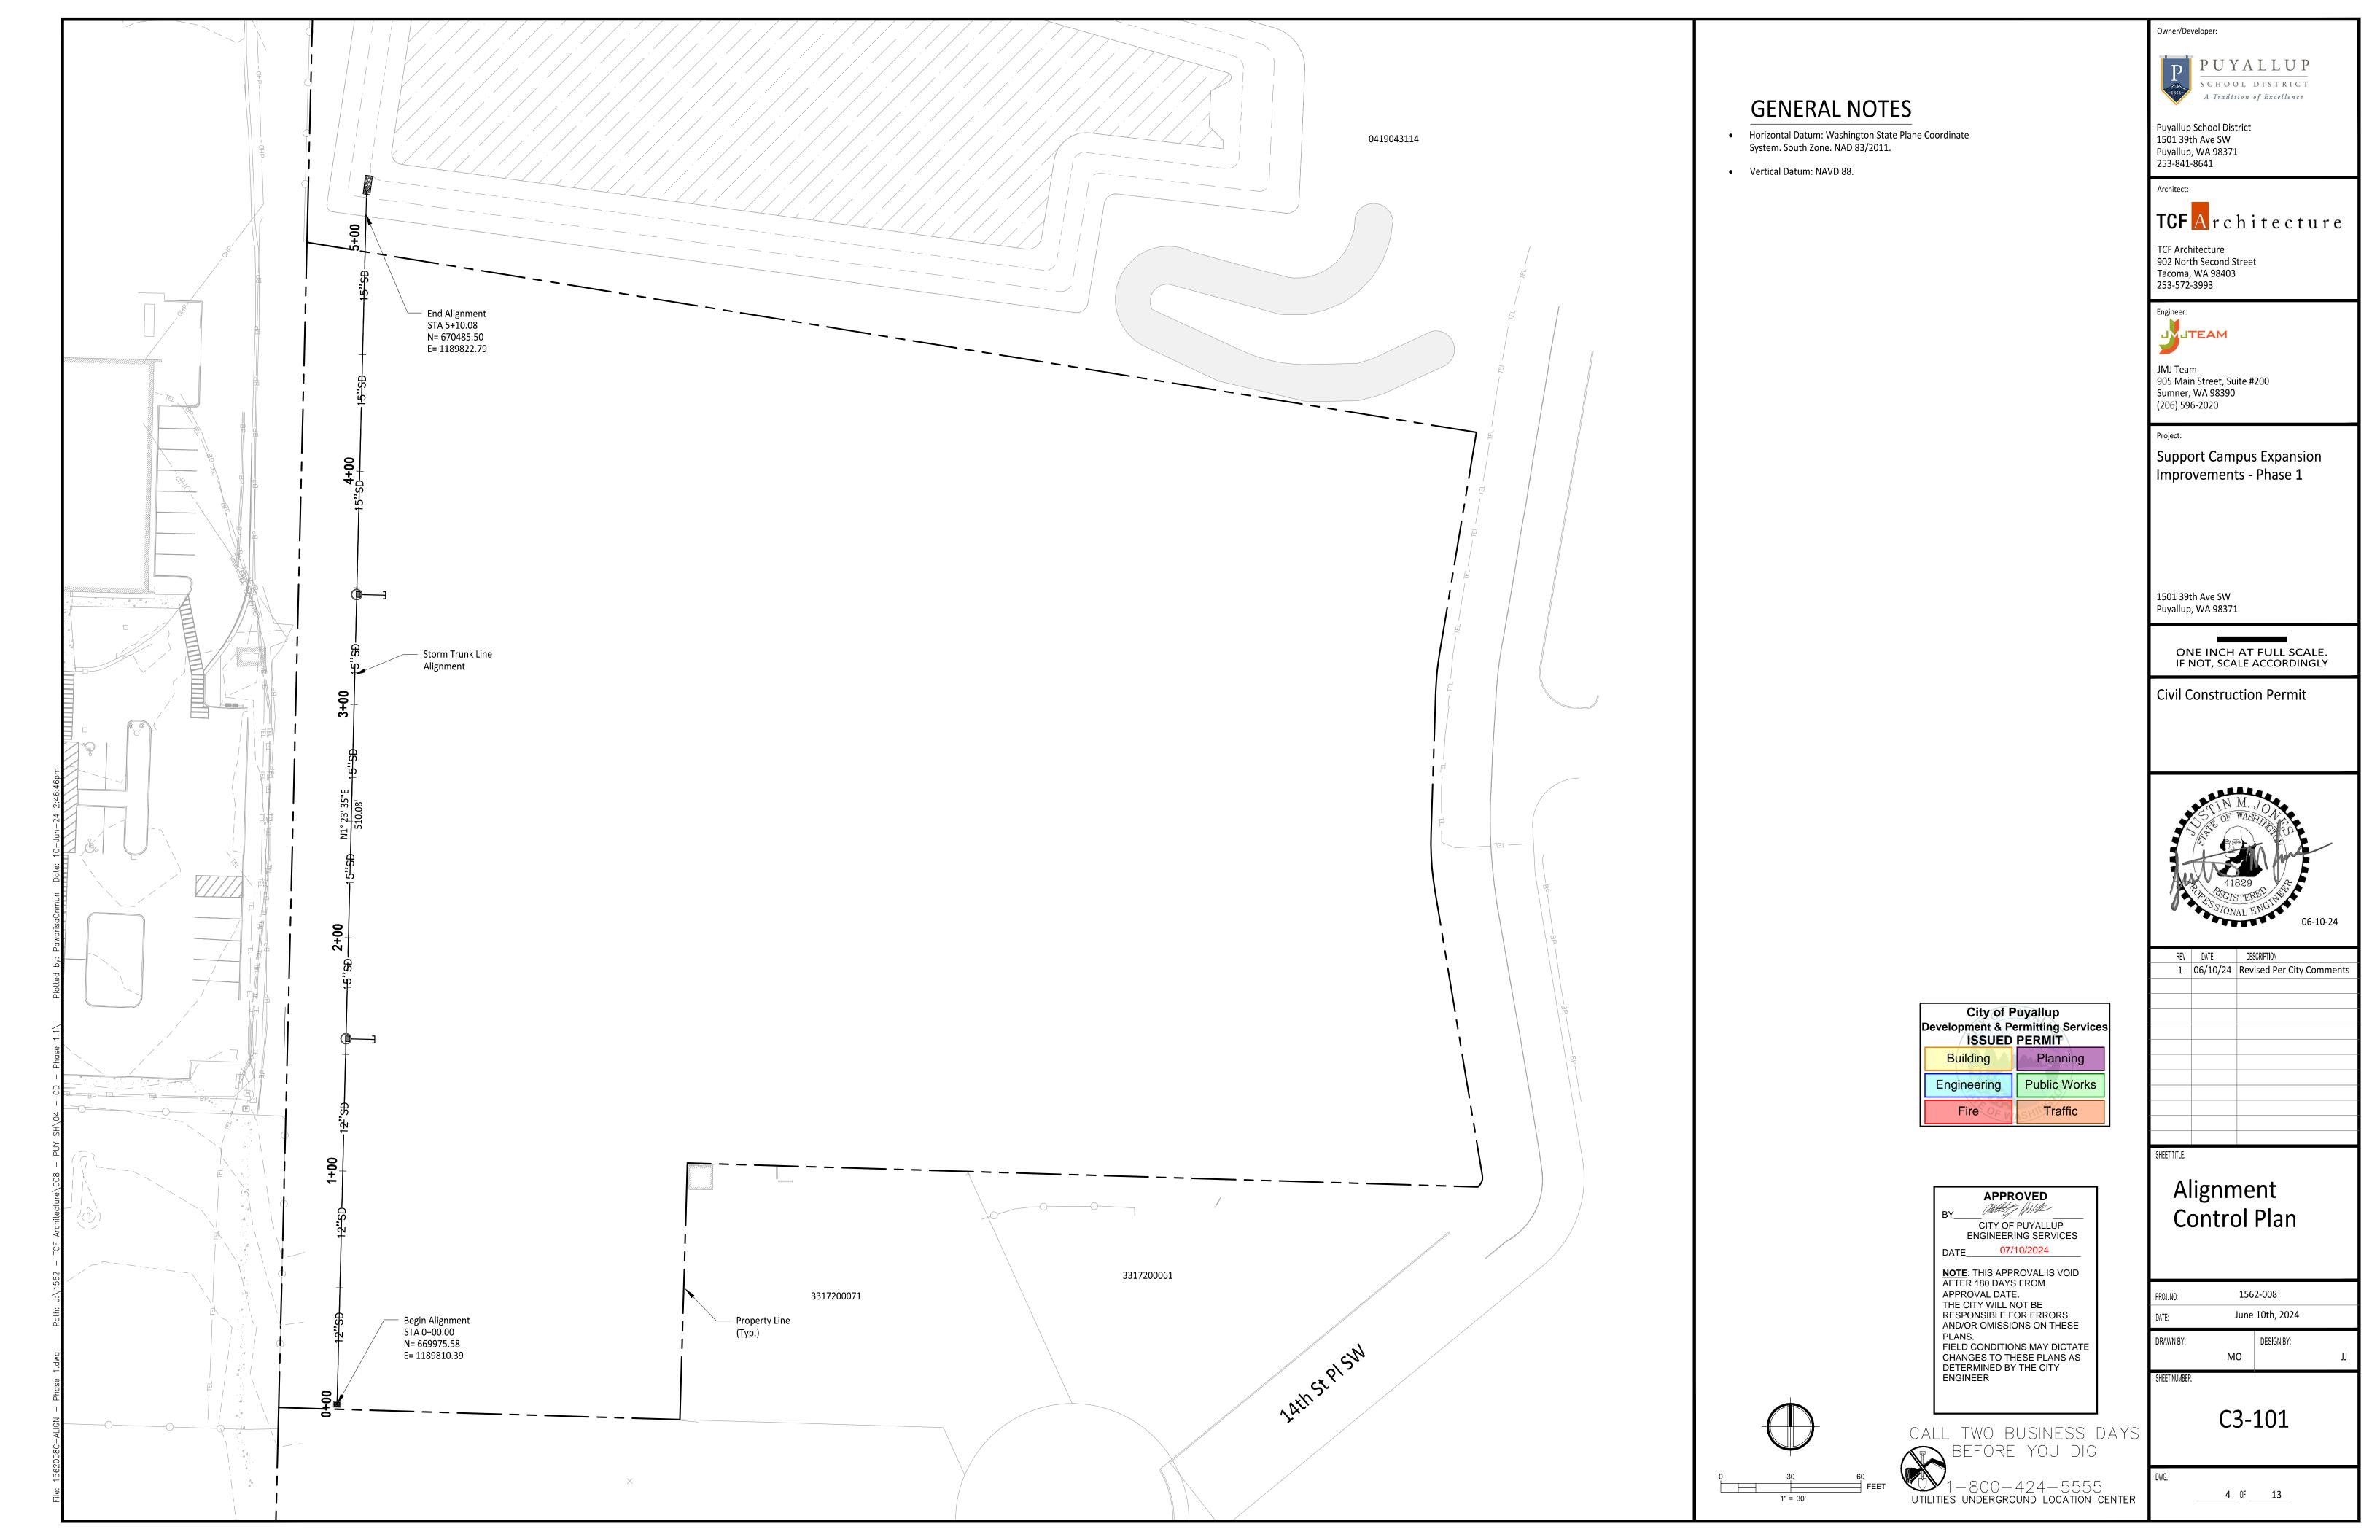

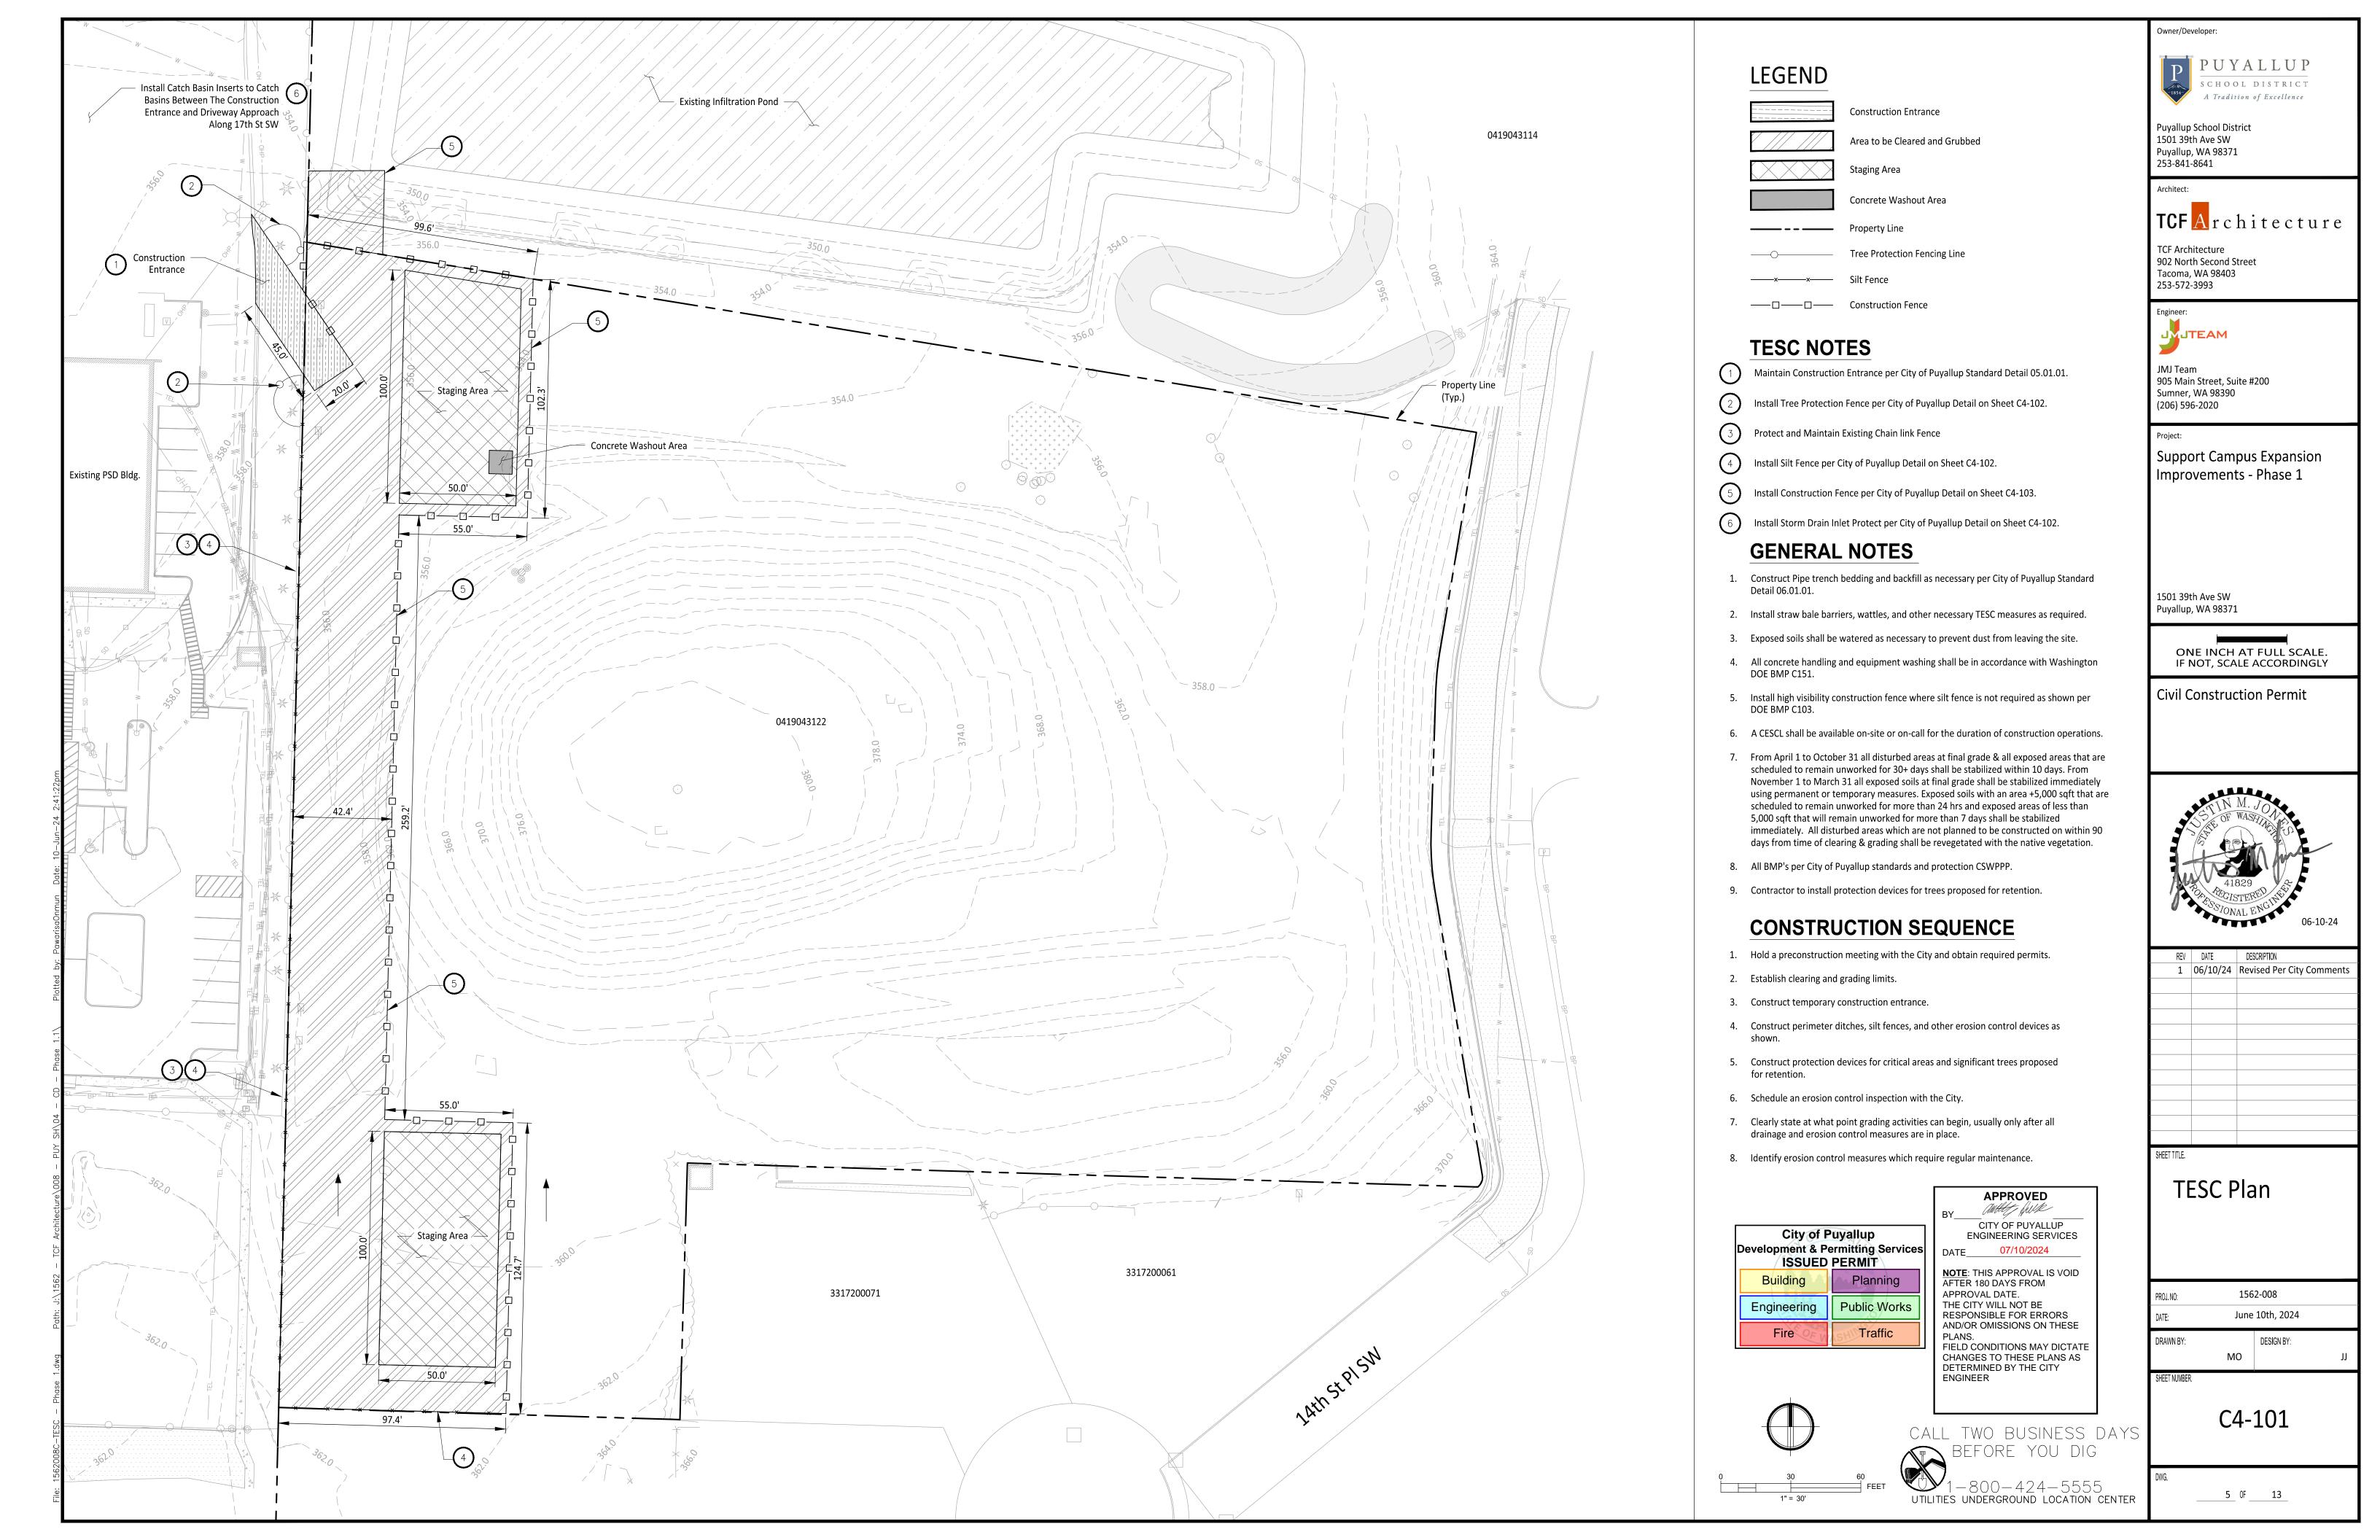

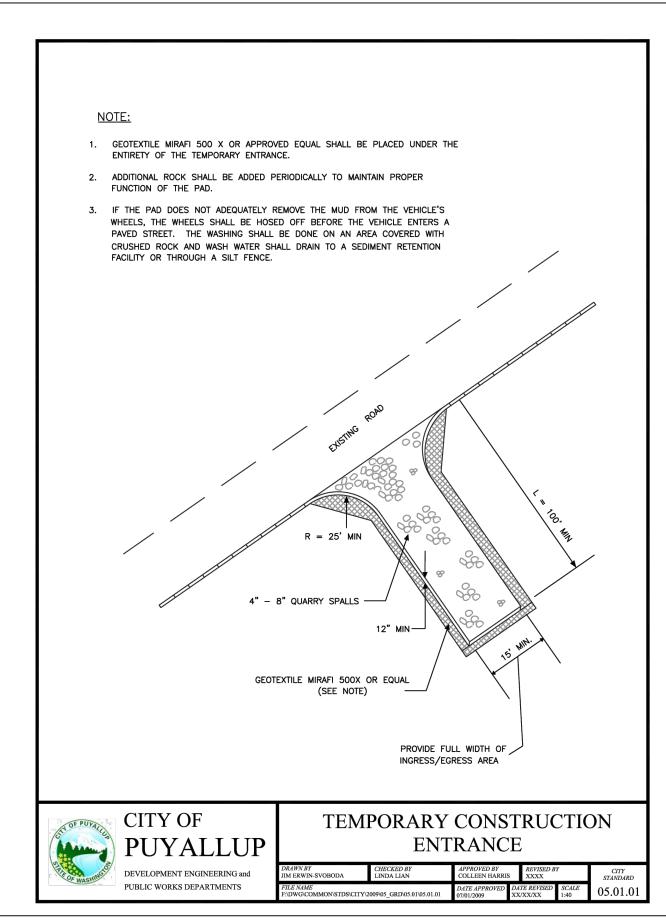

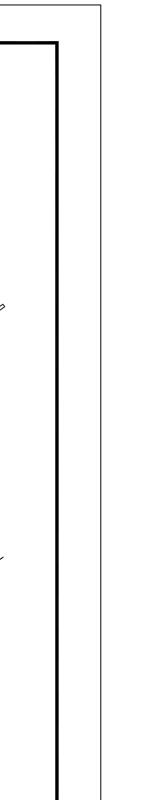

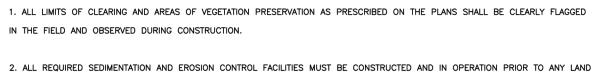

CLEARING AND/OR OTHER CONSTRUCTION TO ENSURE THAT SEDIMENT LADEN WATER DOES NOT ENTER THE NATURAL DRAINAGE SYSTEM. THE CONTRACTOR SHALL SCHEDULE AN INSPECTION OF THE EROSION CONTROL FACILITIES PRIOR TO ANY LAND CLEARING AND/OR CONSTRUCTION. ALL EROSION AND SEDIMENT FACILITIES SHALL BE MAINTAINED IN A SATISFACTORY CONDITION AS DETERMINED BY THE CITY, UNTIL SUCH TIME THAT CLEARING AND/OR CONSTRUCTION IS COMPLETED AND THE POTENTIAL FOR ON-SITE EROSION HAS PASSED. THE IMPLEMENTATION, MAINTENANCE, REPLACEMENT, AND ADDITIONS TO THE EROSION AND SEDIMENTATION CONTROL SYSTEMS SHALL BE THE RESPONSIBILITY OF THE PERMITEE.

3. THE EROSION AND SEDIMENTATION CONTROL SYSTEM FACILITIES DEPICTED ON THESE PLANS ARE INTENDED TO BE MINIMUM REQUIREMENTS TO MEET ANTICIPATED SITE CONDITIONS. AS CONSTRUCTION PROGRESSES AND UNEXPECTED OR SEASONAL CONDITIONS DICTATE, FACILITIES WILL BE NECESSARY TO ENSURE COMPLETE SILTATION CONTROL ON THE SITE. DURING THE COURSE OF CONSTRUCTION, IT SHALL BE THE OBLIGATION AND RESPONSIBILITY OF THE PERMITEE TO ADDRESS ANY NEW CONDITIONS THAT MAY BE CREATED BY HIS ACTIVITIES AND TO PROVIDE ADDITIONAL FACILITIES, OVER AND ABOVE THE MINIMUM REQUIREMENTS, AS MAY BE NEEDED TO PROTECT ADJACENT PROPERTIES, SENSITIVE AREAS, NATURAL WATER COURSES, AND/OR STORM DRAINAGE SYSTEMS.

4. APPROVAL OF THESE PLANS IS FOR GRADING, TEMPORARY DRAINAGE, EROSION AND SEDIMENTATION CONTROL ONLY. IT DOES NOT CONSTITUTE AN APPROVAL OF PERMANENT STORM DRAINAGE DESIGN, SIZE OR LOCATION OF PIPES, RESTRICTORS, CHANNELS, OR RETENTION FACILITIES.

5. ANY DISTURBED AREA WHICH HAS BEEN STRIPPED OF VEGETATION AND WHERE NO FURTHER WORK IS ANTICIPATED FOR A PERIOD OF 30 DAYS OR MORE, MUST BE IMMEDIATELY STABILIZED WITH MULCHING, GRASS PLANTING, OR OTHER APPROVED EROSION CONTROL TREATMENT APPLICABLE TO THE TIME OF YEAR IN QUESTION. GRASS SEEDING ALONE WILL BE ACCEPTABLE ONLY DURING THE MONTHS OF APRIL THROUGH SEPTEMBER INCLUSVE. SEEDING MAY PROCEED OUTSIDE THE SPECIFIED TIME PERIOD WHENEVER IT IS IN THE INTEREST OF THE PERMITEE BUT MUST BE AUGMENTED WITH MULCHING, NETTING, OR OTHER TREATMENT APPROVED BY THE

6. IN CASE EROSION OR SEDIMENTATION OCCURS TO ADJACENT PROPERTIES, ALL CONSTRUCTION WORK WITHIN THE DEVELOPMENT THAT WILL FURTHER AGGRAVATE THE SITUATION MUST CEASE, AND THE OWNER/CONTRACTOR WILL IMMEDIATELY COMMENCE RESTORATION METHODS. RESTORATION ACTIVITY WILL CONTINUE UNTIL SUCH TIME AS THE AFFECTED PROPERTY OWNER IS SATISFIED.

7. NO TEMPORARY OR PERMANENT STOCKPILING OF MATERIALS OR EQUIPMENT SHALL OCCUR WITHIN CRITICAL AREAS OR ASSOCIATED BUFFERS, OR THE CRITICAL ROOT ZONE FOR VEGETATION PROPOSED FOR RETENTION.




GRADING, EROSION, AND SEDIMENTATION CONTROL NOTES

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AWN BY ERWIN-SVOBODA	CHECKED BY LINDA LIAN			REVISED BY LINDA LIAN		CITY STANDARD
E NAME DWG\COMMON\STDS\CITY\2009\05_GRD\05.01\05.02.01		DATE APPROVED 07/01/2009			SCALE 1:1	05.02.01


TREE PROTECTION ZONE (TPZ)


NO ENTRY, NO GRADE CHANGES, STORAGE/STOCKPILING OF MATERIALS OR EQUIPMENT, PLACEMENT OF FILL OR TOP SOIL, TRENCH-ING OR VEHICULAR/FOOT TRAFFIC PERMITTED WITHIN THE TPZ. THIS TREE BARRIER SHALL NOT BE REMOVED WITHOUT AUTHORIZA-TION FROM PUYALLUP PLANNING DEPARMENT—<u>SUBJECT TO FINES AND ENFORCEMENT ACTION BY THE CITY</u>—TO REPORT VIOLATIONS OR FOR MORE INFORMATION—CALL (253) 864:4165

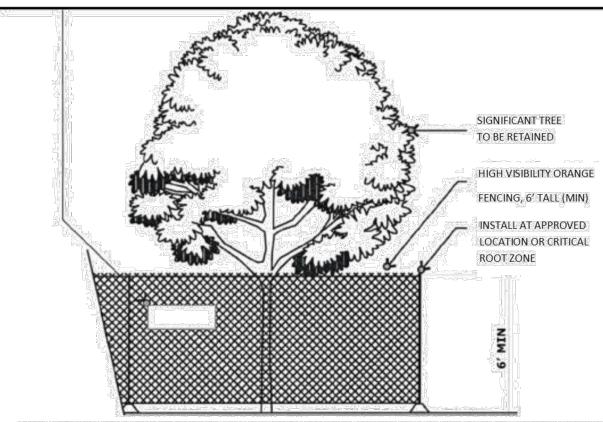

- MINIMUM SIX (6) FOOR HIGH TEMPORARY HIGH VISIBILITY ORANGE CONSTRUCTION FENCING SHALL BE PLACED AT THE CRITICAL ROOT ZONE OR DESIGNATED LIMIT OF DISTURBANCE ON APPROVED FINAL LANDSCAPE PLAN SET, FENCING SHALL BE INSTALLED USING POSTS ORIVEN INTO GROUND-PIER BLOCKS SHALL NOT BE USED. AVOID POSTS ORIVEN INTO ROOTS LARGER THAN I' DIAMETER. FENCING SHALL BE INSTALLED PRIOR TO WORK COMMENCING ON SITE AND REMAIN IN PLACE THROUGHOUT ALL PHASES ON CONSTRUCTION—CALL THE CITY'S PLANNING. IDIVISION WITH REQUESTS TO MODIFY THE LOCATION OF THE TREE PROTECTION FENCING—(253) 864-4165
- TREATMENT OF ROOTS EXPOSED DURING CONSTRUCTION. FOR ROOTS OVER ONE (I) INCH-DIAMETER DAMAGED DURING CONSTRUCTION, MAKE A CLEAN STRAIGHT CUT TO REMOVE DAMAGED. PORTION OF ROOT. ALL EXPOSED ROOTS SHALL BE TEMPORARILY COVERED WITH DAMP BURLAP TO PREVENT DRYING AND COVERED WITH SOIL AS SOON AS POSSIBLE OTHER PRE-TREATMENT. MEASURES MAY BE REQUIRED TO PROTECT ROOT SYSTEM—SEE APPROVED TREE PROTECTION OR FINALLANDSCAPE PLAN FOR FURTHER DETAILS.
- NO STOCKPILING OF MATERIALS, VEHICULAR TRAFFIC, PLACEMENT OF TOP SOIL OR FILL MATERIAL, STORAGE OF EQUIPMENT OR MACHINERY SHALL BE ALLOWED WITHIN THE LIMITS OF THE ESTABLISHED FENCING, FENCING SHALL NOT BE MOVED OR REMOVED UNLESS APPROVED BY THE CITY PLANNING DIVISION, WORK WHTIN PROTECTION FENCE, SHALL BE DONE MANUALLY UNDER THE SUPERVISION OF THE ON-SITE. ARBORIST WITH PRIOR WRITTEN APPROVAL BY THE CITY PLANNING DIVISION.
- THE ABOVE REFERENCED TPZ SIGNS, SHALL BE PLACED EVERY IS FEET ALONG THE FENCING AND SHALL REMAIN. IN PLACE THROUGHOUT ALL PHASES OF CONSTRUCTION



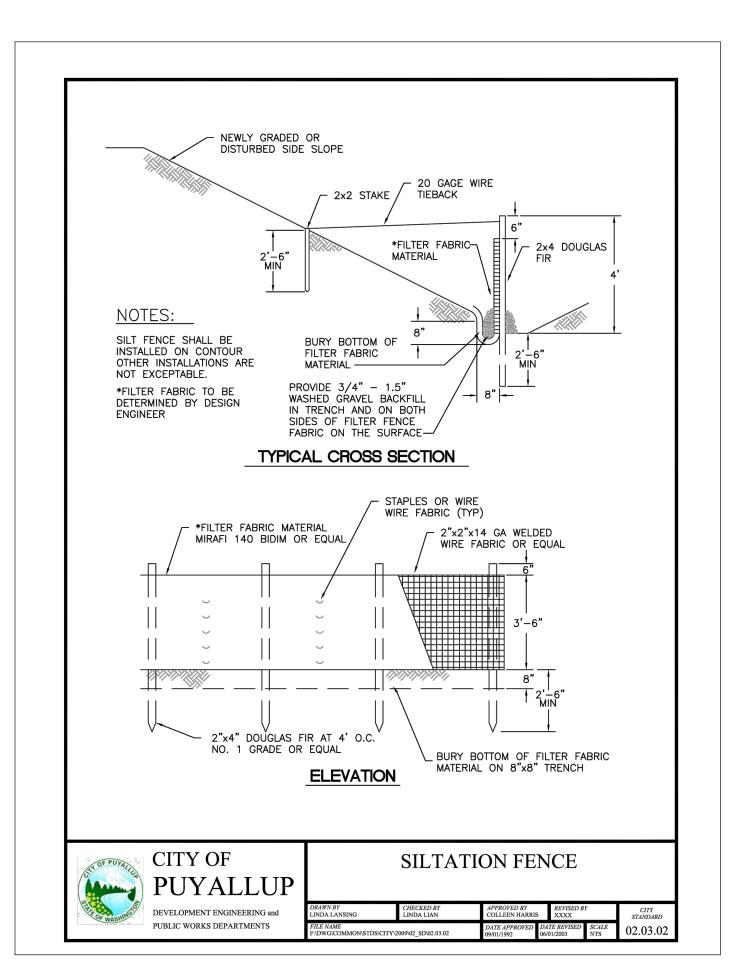

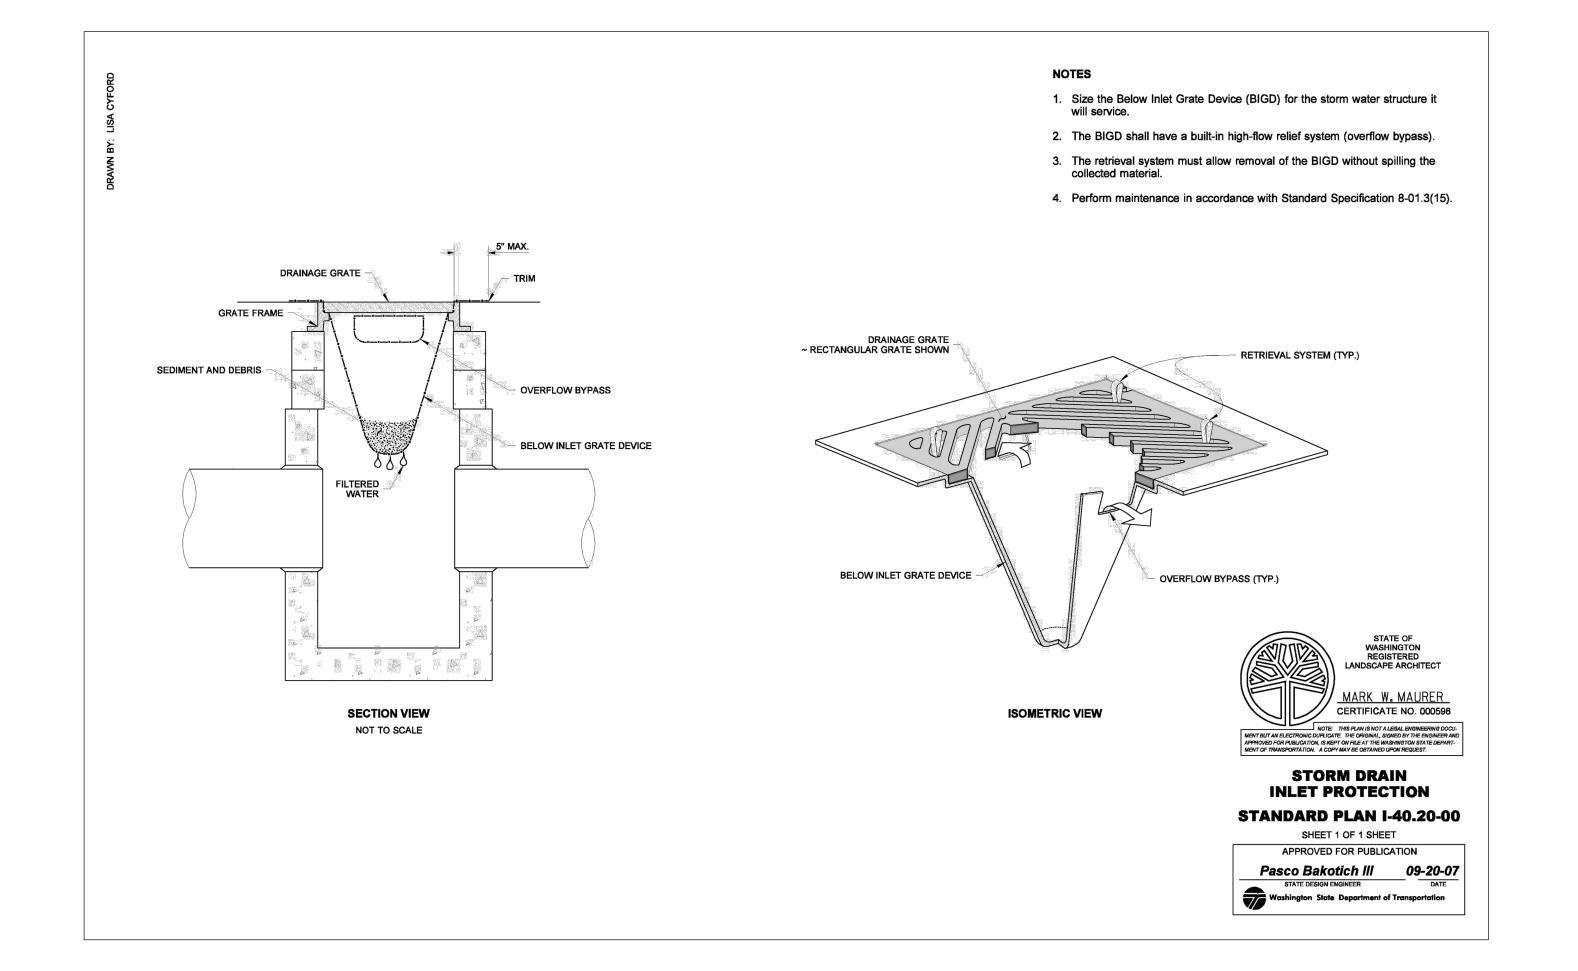



Puyallup School District 1501 39th Ave SW Puyallup, WA 98371 253-841-8641

Owner/Developer:

Architect:

TCF Architecture

TCF Architecture 902 North Second Street Tacoma, WA 98403 253-572-3993




JMJ Team 905 Main Street, Suite #200 Sumner, WA 98390 (206) 596-2020

Support Campus Expansion Improvements - Phase 1

1501 39th Ave SW Puyallup, WA 98371

> ONE INCH AT FULL SCALE. IF NOT, SCALE ACCORDINGLY

Civil Construction Permit

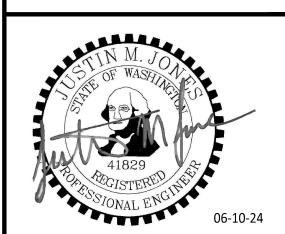

DESCRIPTION 1 06/10/24 Revised Per City Comments

City of F	
	ermitting Services PERMIT
Building	Planning
Engineering	Public Works
Fire OF V	Traffic

REV DATE

1562-008 June 10th, 2024 DRAWN BY: DESIGN BY:

SHEET NUMBER.

C4-102

6 OF 13

-800-424-5555 UTILITIES UNDERGROUND LOCATION CENTER

DATE

PLANS.

ENGINEER

APPROVED andly full CITY OF PUYALLUP **ENGINEERING SERVICES**

07/10/2024

NOTE: THIS APPROVAL IS VOID

AFTER 180 DAYS FROM

THE CITY WILL NOT BE

RESPONSIBLE FOR ERRORS

AND/OR OMISSIONS ON THESE

FIELD CONDITIONS MAY DICTATE


CHANGES TO THESE PLANS AS

CALL TWO BUSINESS DAYS


BEFORE YOU DIG

DETERMINED BY THE CITY

APPROVAL DATE.

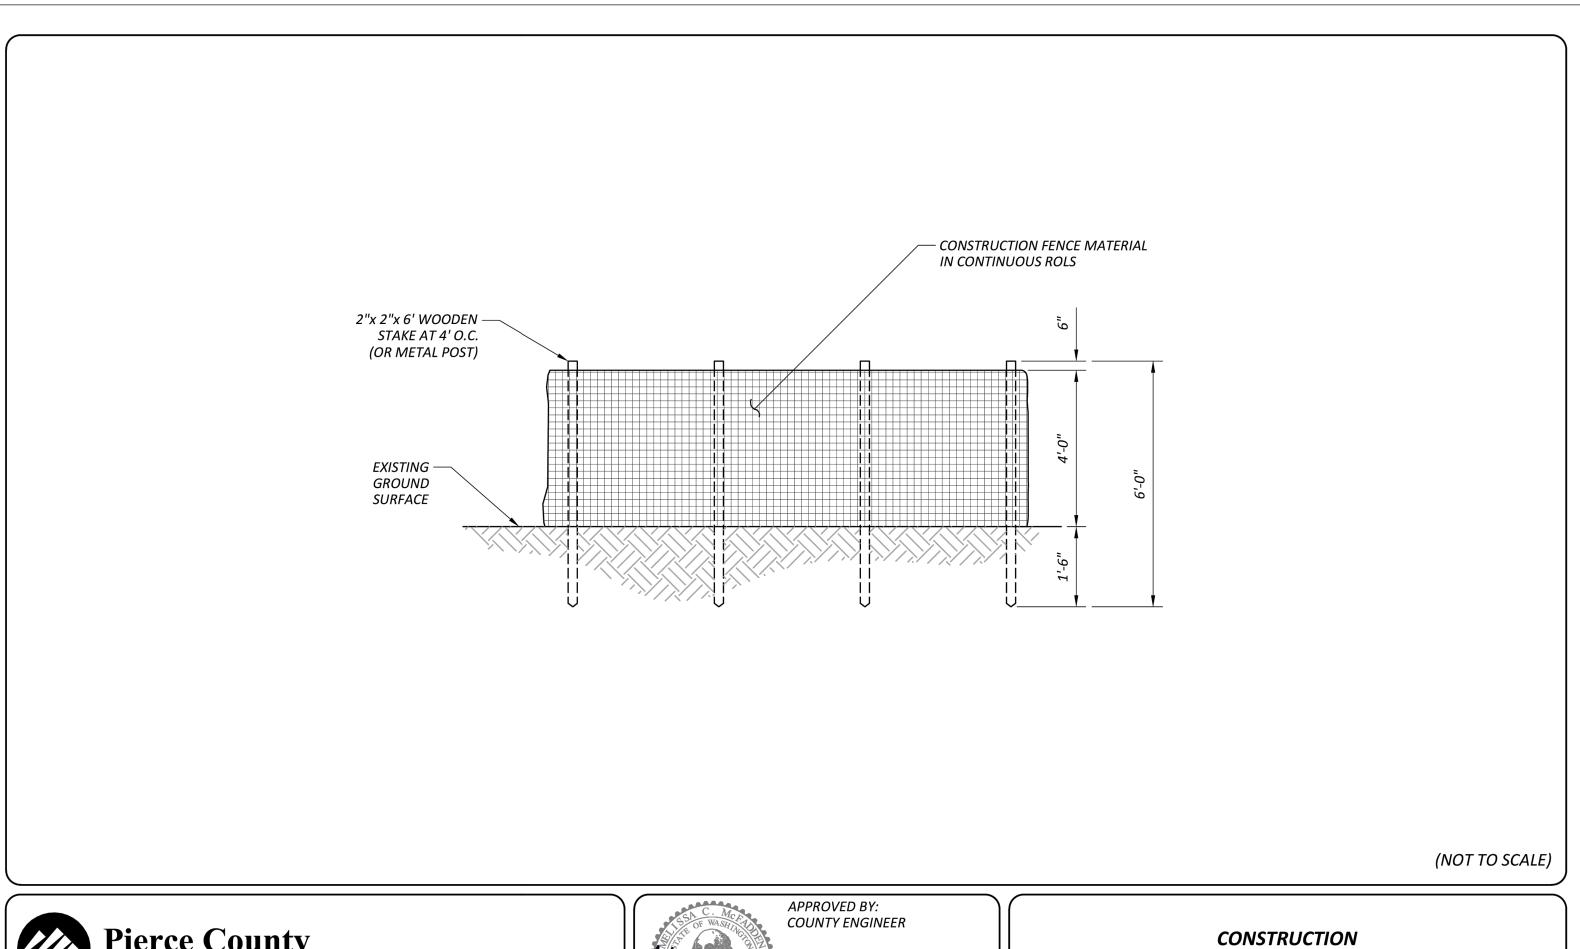



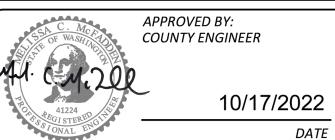

FENCE

STANDARD DRAWING PC.L1

Owner/Developer:



Puyallup School District 1501 39th Ave SW Puyallup, WA 98371 253-841-8641

Architect:

TCF Architecture

TCF Architecture 902 North Second Street Tacoma, WA 98403 253-572-3993




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REV	DATE	DESCRIPTION
1	06/10/24	Revised Per City Commen
ALIEET TITLE		

1562-008

C4-103

June 10th, 2024

SHEET TITLE.

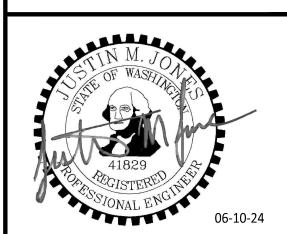TESC Details APPROVED CITY OF PUYALLUP ENGINEERING SERVICES DATE 07/10/2024

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City of Puyallup
Development & Permitting Services

ISSUED PERMIT

Building

Engineering

Planning

Public Works

Traffic

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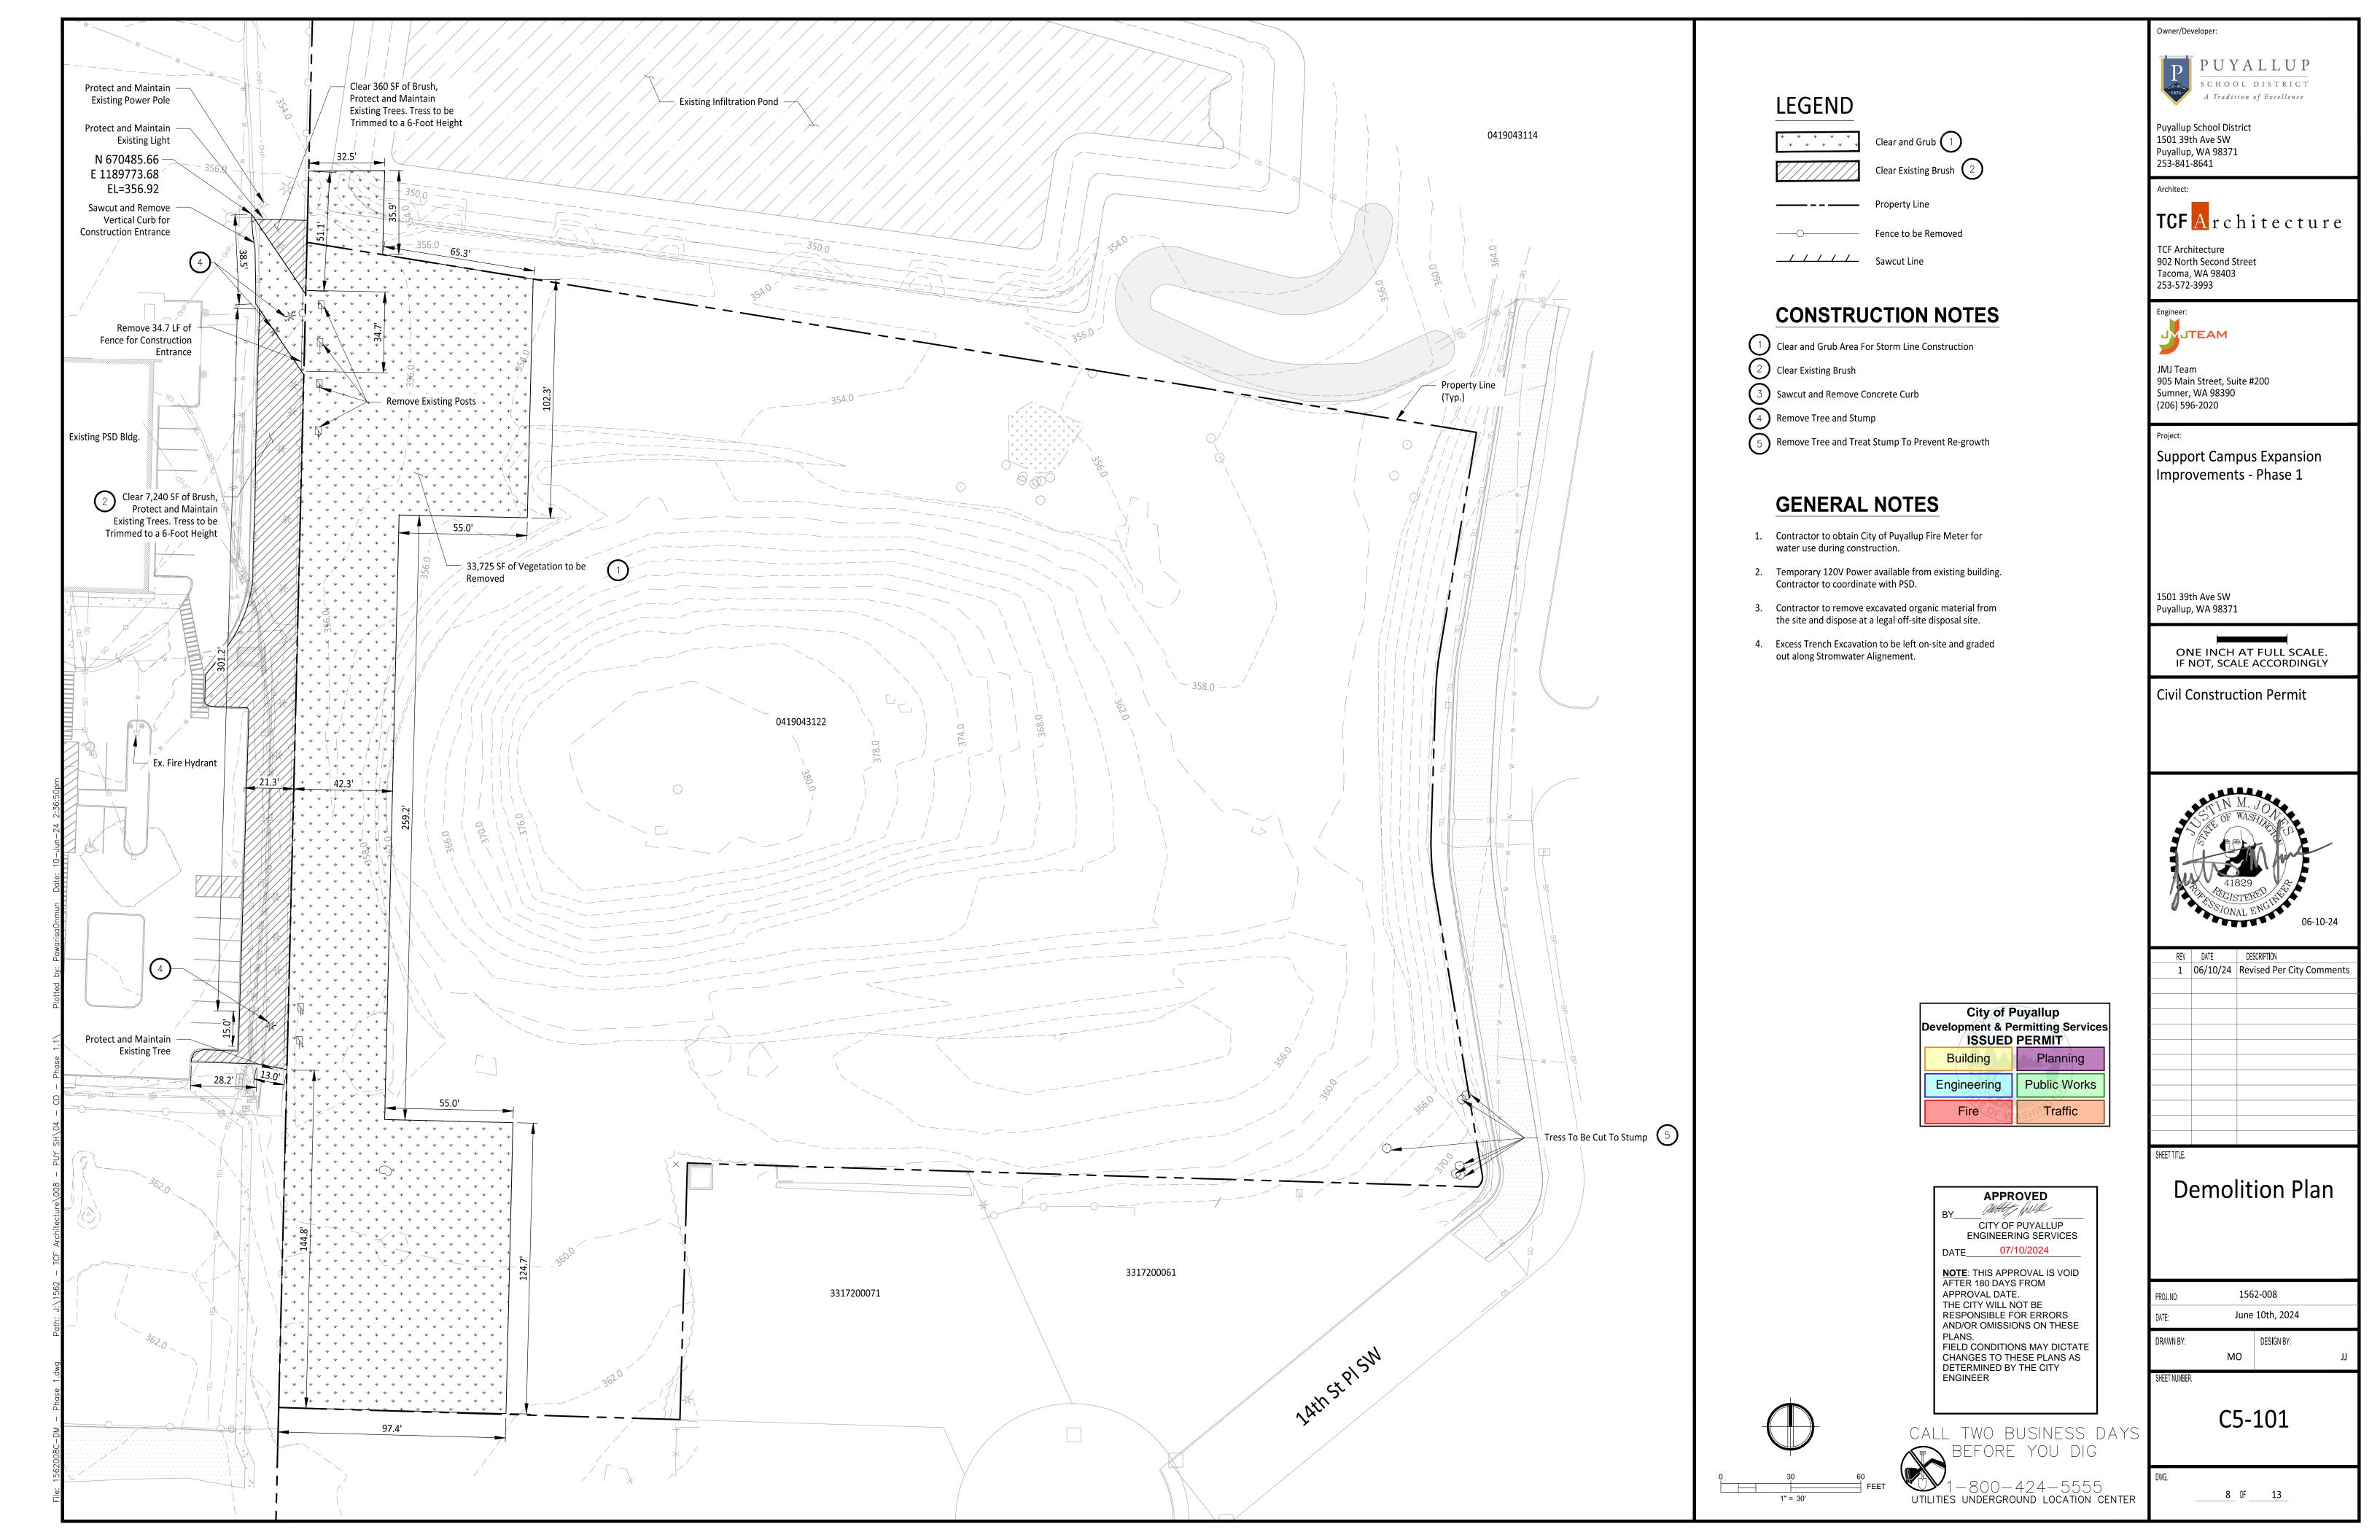
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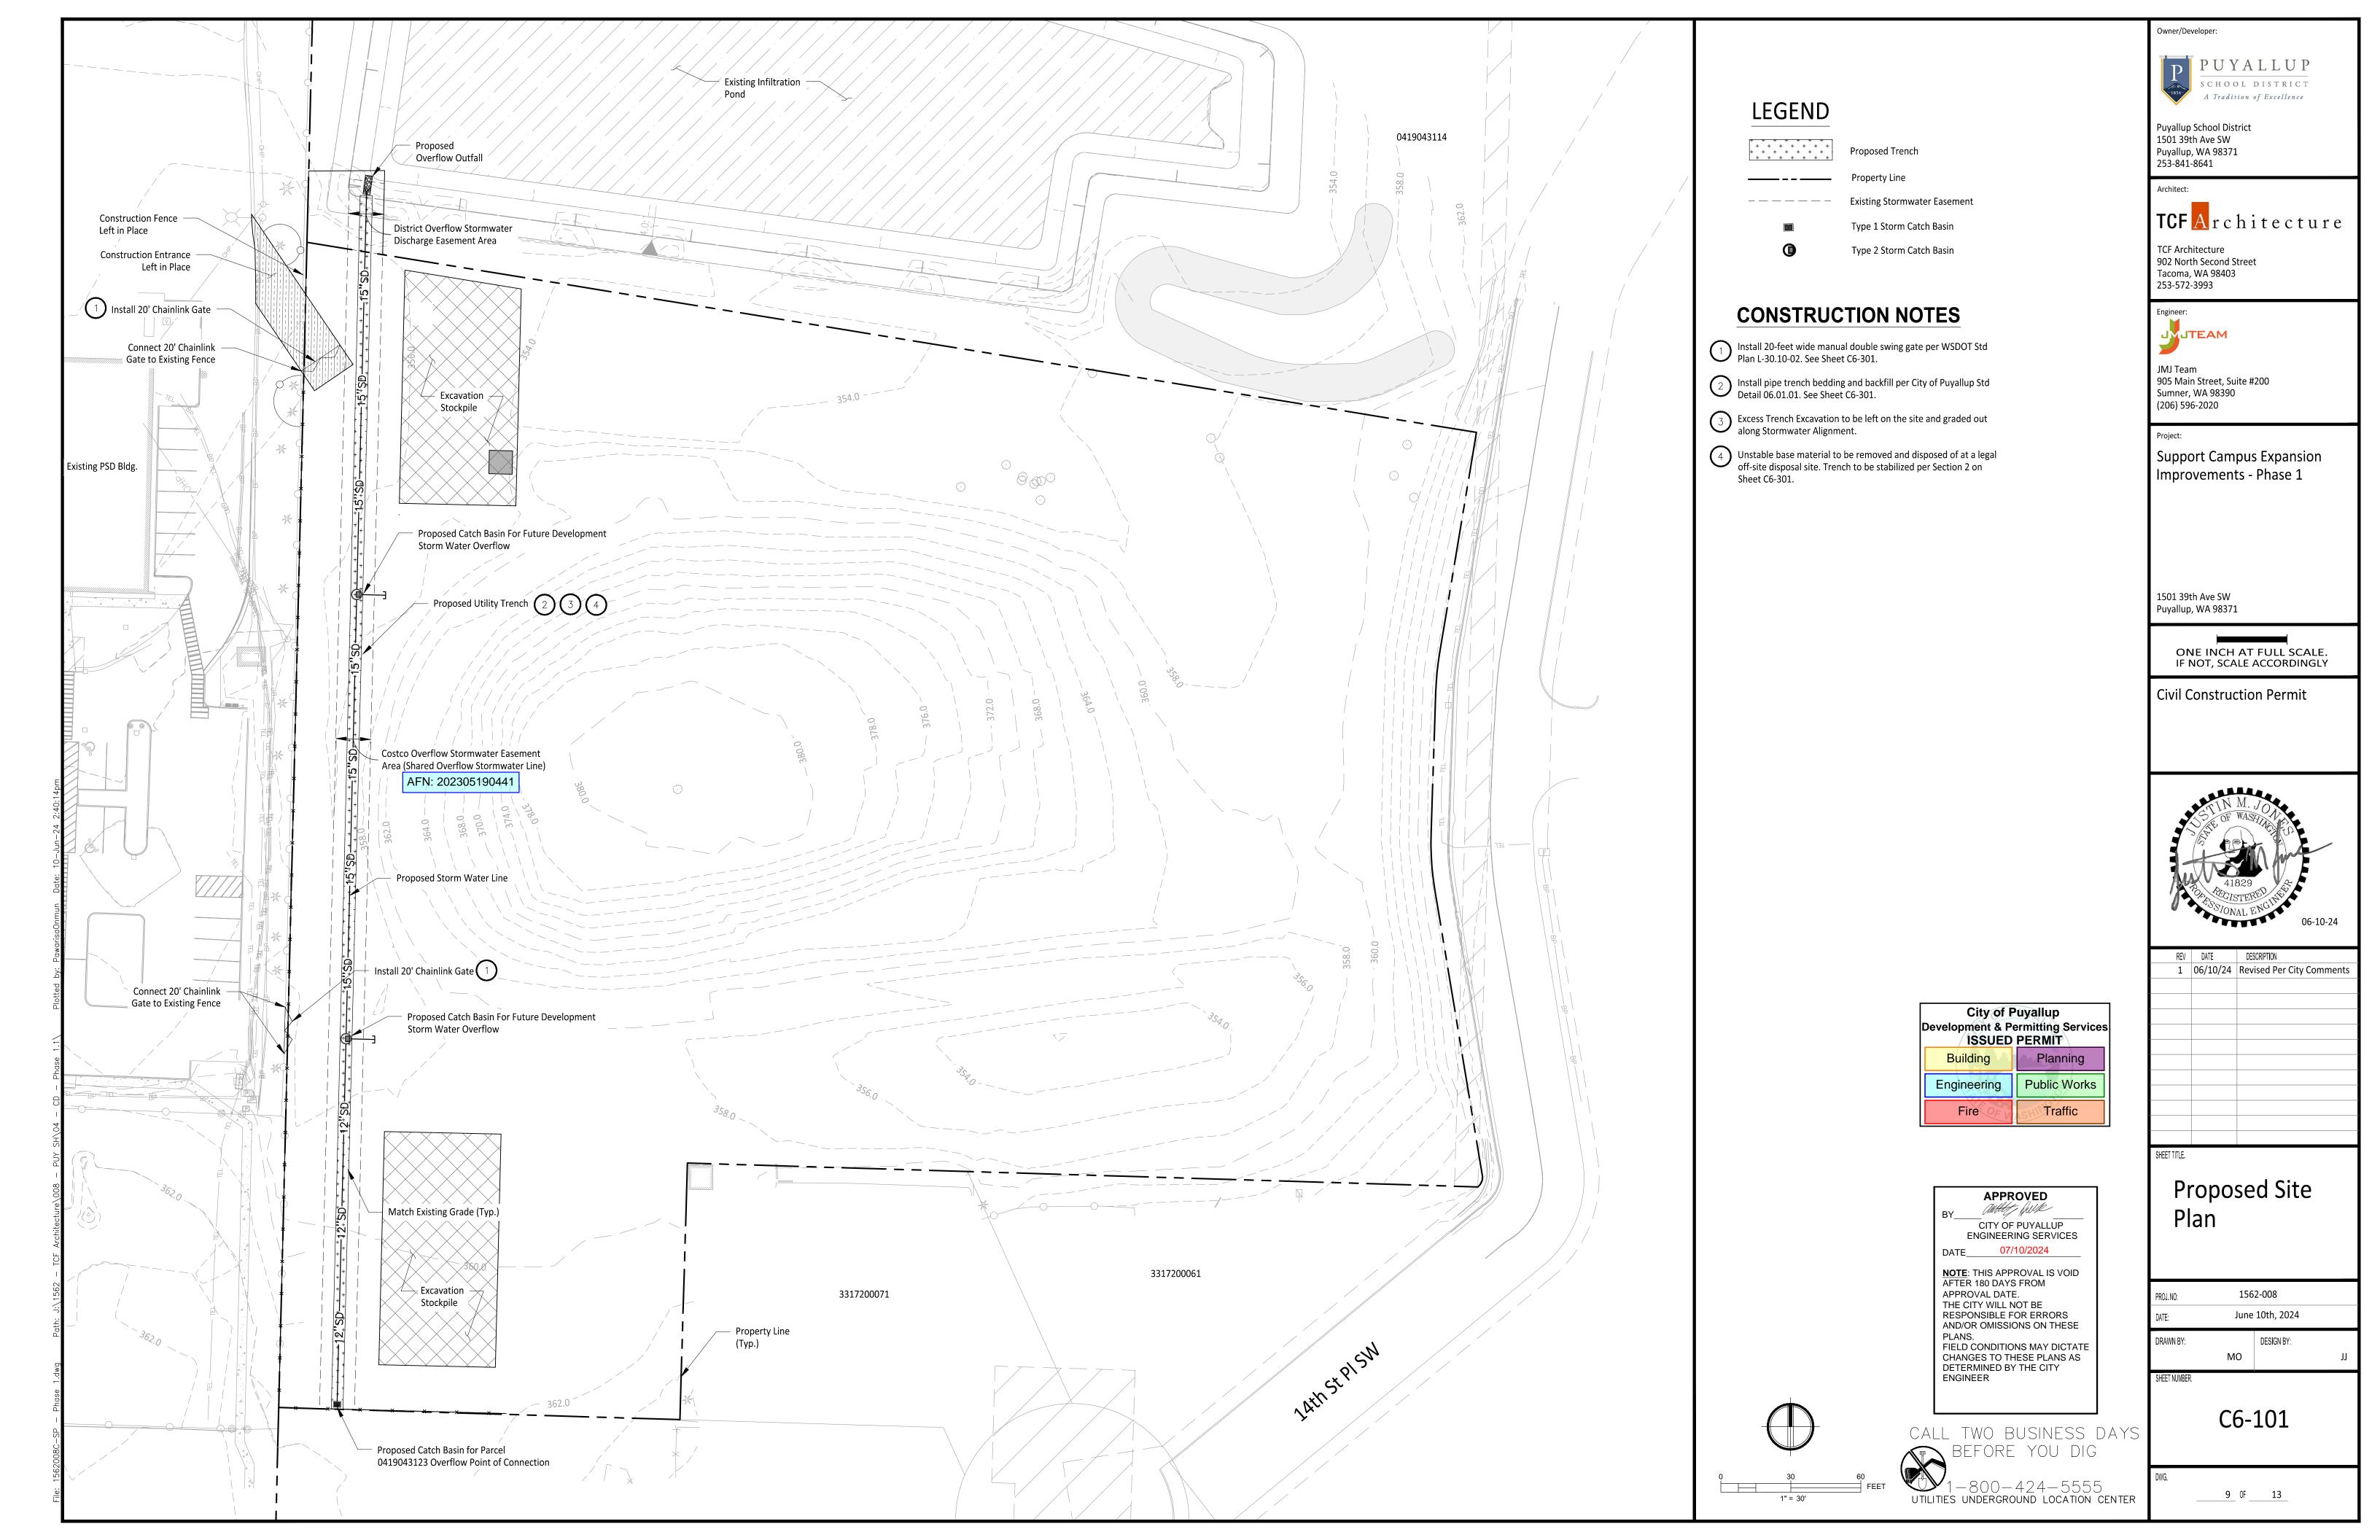
7 OF <u>13</u>


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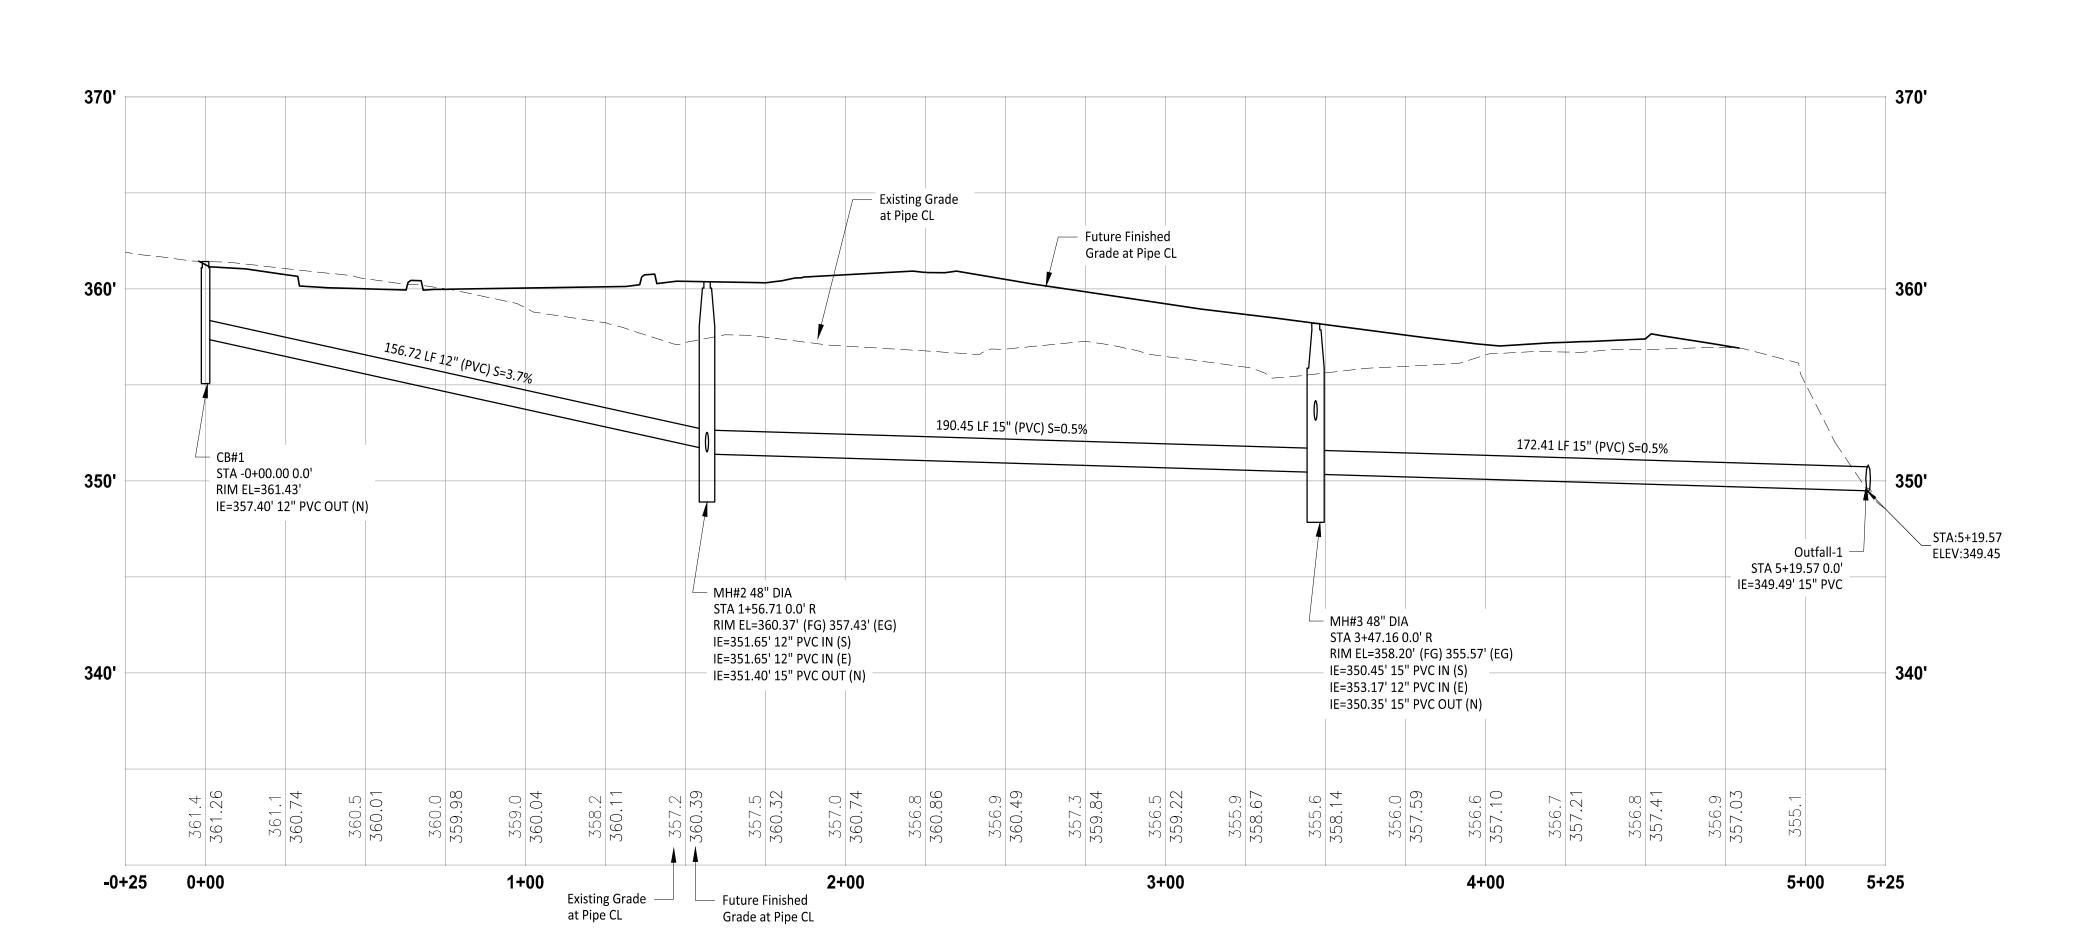
SHEET NUMBER.

BEFORE YOU DIG 1-800-424-5555 1-800-424-5555 UTILITIES UNDERGROUND LOCATION CENTER







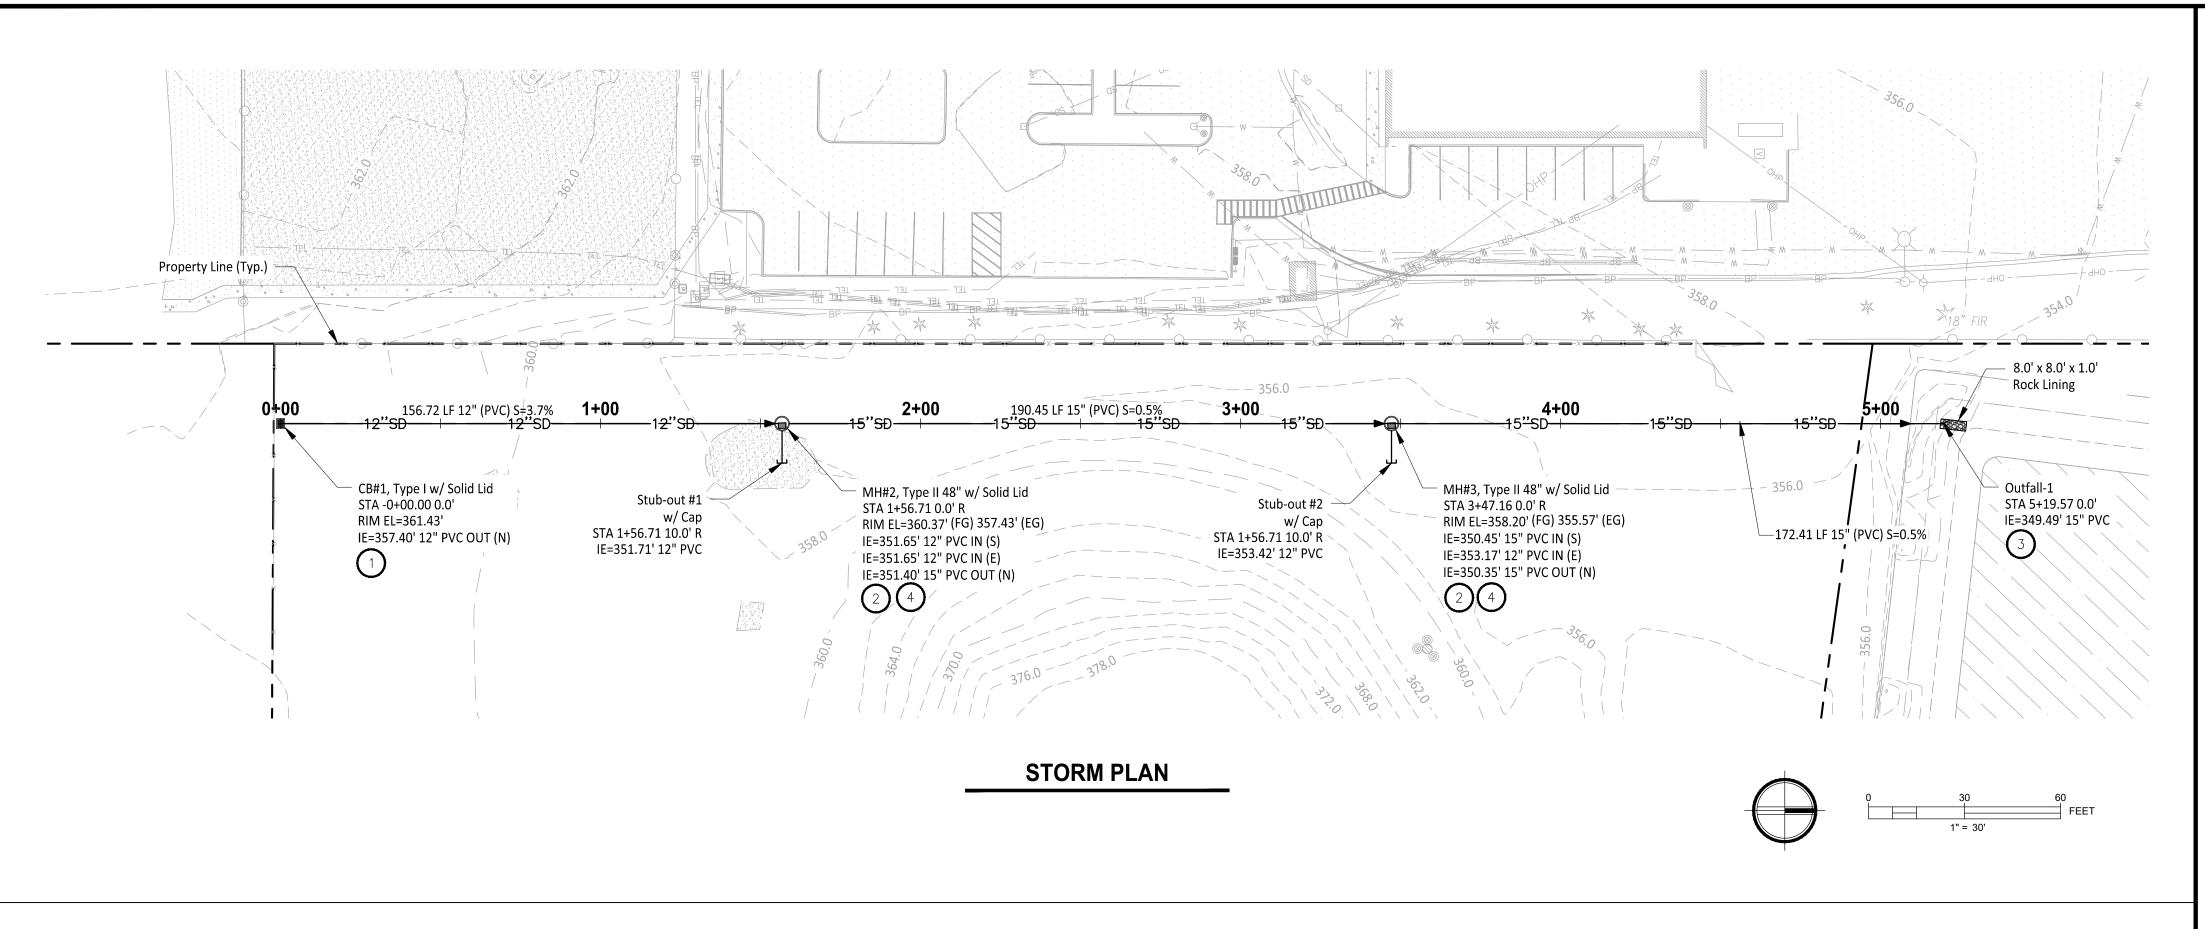

STORM PROFILE

HORIZ: 1''=30'

VERT: 1"=5'

LEGEND

Type 1 Storm Catch Basin


Type 2 Storm Catch Basin

CONSTRUCTION NOTES

- Install Type 1 CB per City of Puyallup Std. Detail 02.01.02. See Sheet C6-301.
- Install Type II Manhole per City of Puyallup Std. Detail 02.01.04. See Sheet C6-301.
- See Sheet C6-301 for Outfall Section
- Install Manhole per City of Puyallup Std. Details on Sheet C6-302.

CITY OF PUYALLUP GENERAL NOTES

- All work in City right-of-way requires a permit from the City of Puyallup. Prior to any work commencing, the general contractor shall arrange for a preconstruction meeting at the Development Services Center to be attended by all contractors that will perform work shown on the approved engineering plans, representatives from all applicable utility companies, the project owner and appropriate city staff. Contact Engineering Services at (253-841-5568) to schedule the meeting. The contractor is responsible to have their own set of approved plans at the meeting.
- After completion of all items shown on these plans and before acceptance of the project the contractor shall obtain a "punch list" prepared by the City's inspector detailing remaining items of work to be completed. All items of work shown on these plans shall be completed to the satisfaction of the City prior to acceptance of the water system and provision of sanitary sewer
- All materials and workmanship shall conform to the Standard Specifications for Road, Bridge, and Municipal Construction (hereinafter referred to as the "Standard Specifications"), Washington State Department of Transportation and American Public Works Association, Washington State Chapter, latest edition, unless superseded or amended by the City of Puyallup City Standards for Public Works Engineering and Construction (here in after referred to as the "City Standards").
- A copy of these approved plans and applicable city developer specifications and details shall be on site during construction.
- Any revisions made to these plans must be reviewed and approved by the developer's engineer and the City prior to any implementation in the field. The City shall not be responsible for any errors and/or omissions on these plans.
- 6. The contractor shall have all utilities verified on the ground prior to any construction. Call (811) at least two working days in advance. The owner and his/her engineer shall be contacted immediately if a conflict exists.
- Any structure and/or obstruction that requires removal or relocation relating to this project shall be done so at the developer's expense.
- 8. Locations of existing utilities are approximate. It shall be the contractor's responsibility to determine the true elevations and locations of hidden utilities. All visible items shall be the engineer's
- 9. The contractor shall install, replace, or relocate all signs, as shown on the plans or as affected by construction, per City Standards.
- 10. Power, street light, cable, and telephone lines shall be in a trench located within a 10-foot utility easement adjacent to public right-of-way. Right-of-way crossings shall have a minimum horizontal separation from other utilities (sewer, water, and storm) of 5 feet.
- 11. All construction surveying for extensions of public facilities shall be done under the direction of a Washington State licensed land surveyor or a Washington State licensed professional civil engineer.
- 12. During construction, all public streets adjacent to this project shall be kept clean of all material deposits resulting from on-site construction, and existing structures shall be protected as directed by the City.
- 13. Certified record drawings are required prior to project acceptance.
- 14. A NPDES Stormwater General Permit may be required by the Department of Ecology for this project. For information contact the Department of Ecology, Southwest Region Office at (360)407-6300.
- 15. Any disturbance or damage to Critical Areas and associated buffers, or significant trees designated for preservation and protection shall be mitigated in accordance with a Mitigation Plan reviewed and approved by the City's Planning Division. Preparation and implementation of the Mitigation Plan shall be at the developer's expense.

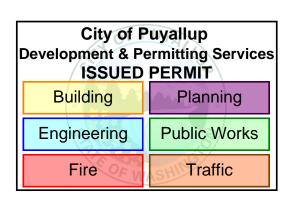



AND/OR OMISSIONS ON THESE PLANS. FIELD CONDITIONS MAY DICTATE CHANGES TO THESE PLANS AS DETERMINED BY THE CITY **ENGINEER**

BEFORE YOU DIG

CALL TWO BUSINESS DAYS

-800 - 424 - 5555UTILITIES UNDERGROUND LOCATION CENTER

Owner/Developer:



Puyallup School District 1501 39th Ave SW Puyallup, WA 98371 253-841-8641

Architect:

TCF Architecture TCF Architecture 902 North Second Street

Engineer: JTEAM

Tacoma, WA 98403

253-572-3993


JMJ Team 905 Main Street, Suite #200 Sumner, WA 98390 (206) 596-2020

Support Campus Expansion Improvements - Phase 1

1501 39th Ave SW Puyallup, WA 98371

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Civil Construction Permit

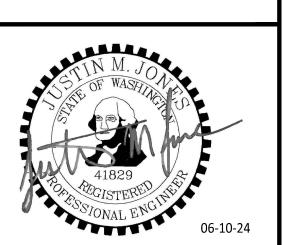

1	06/10/24	Revised Per City Comments
SHEET TITLE.		

DESCRIPTION

REV DATE


Storm Plan & Profile


1562-008 June 10th, 2024 DRAWN BY: DESIGN BY:


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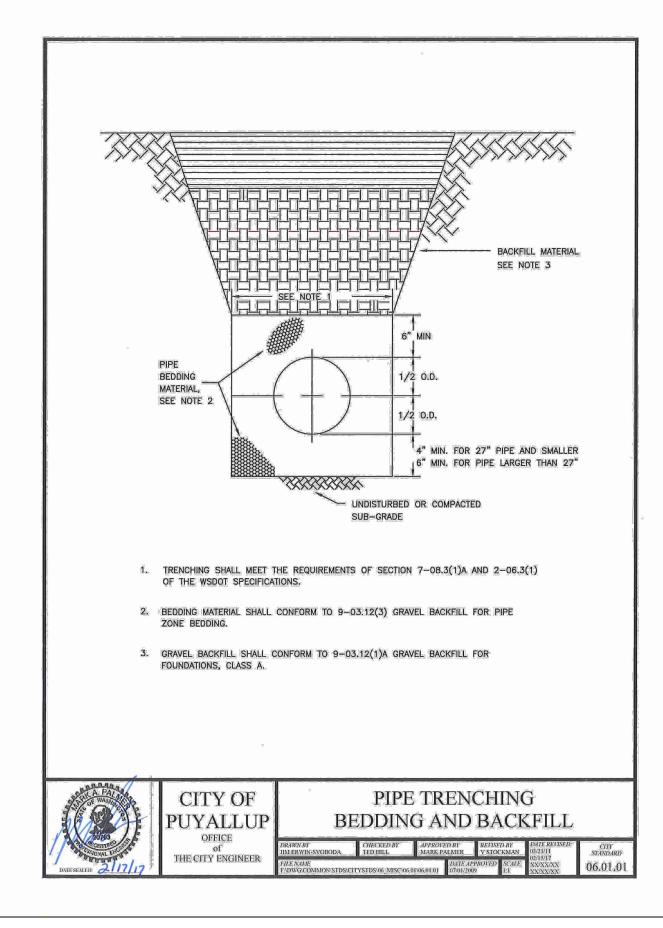
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10 OF 13





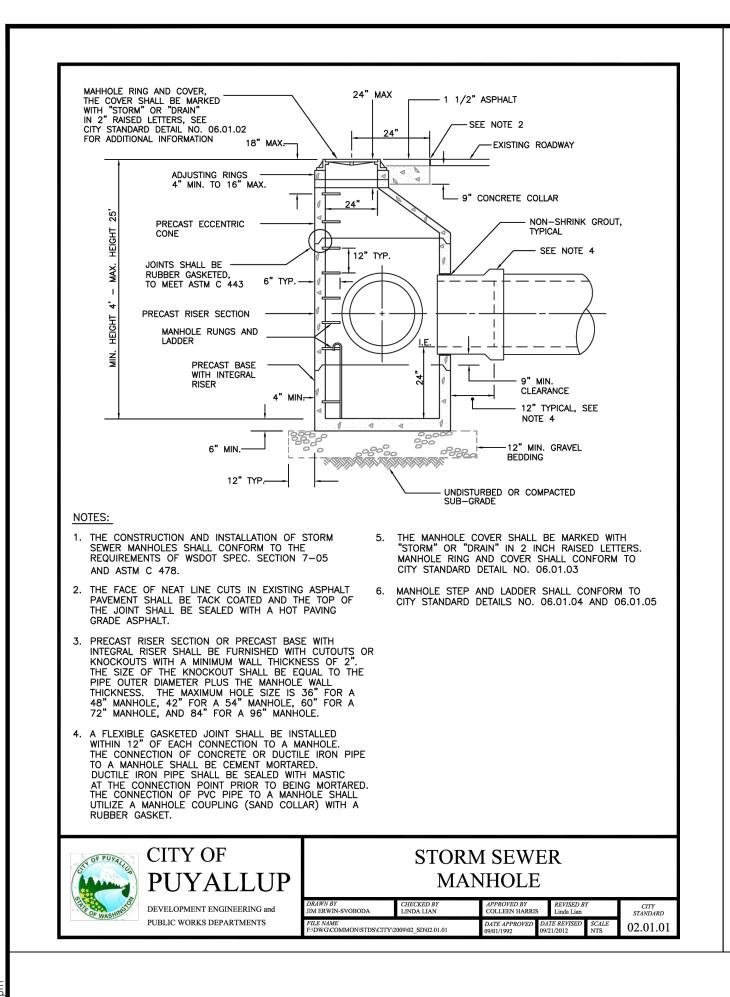

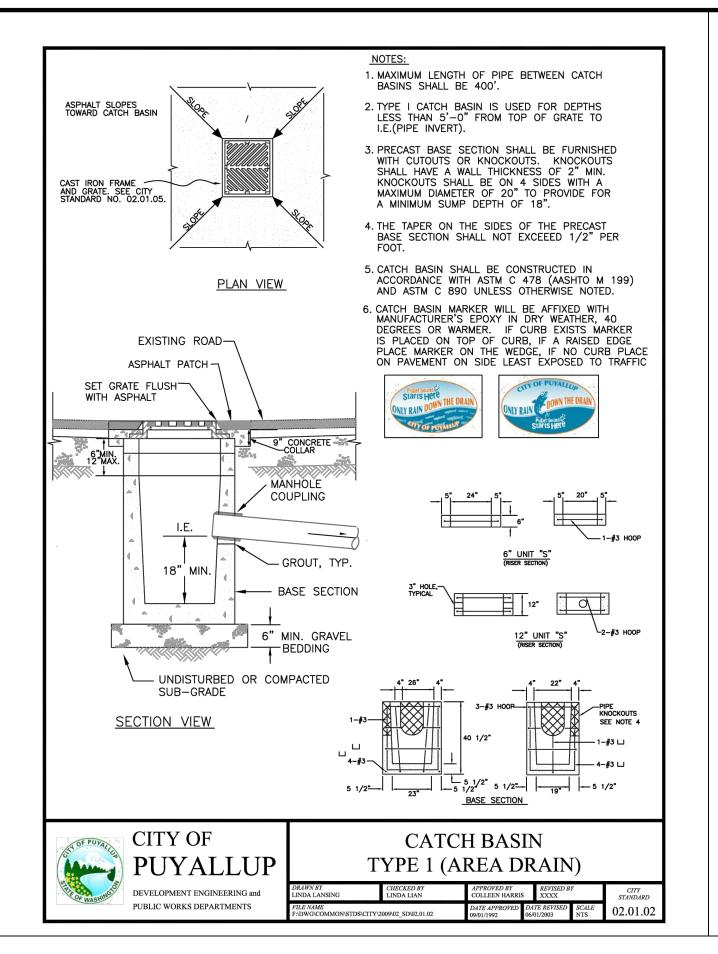

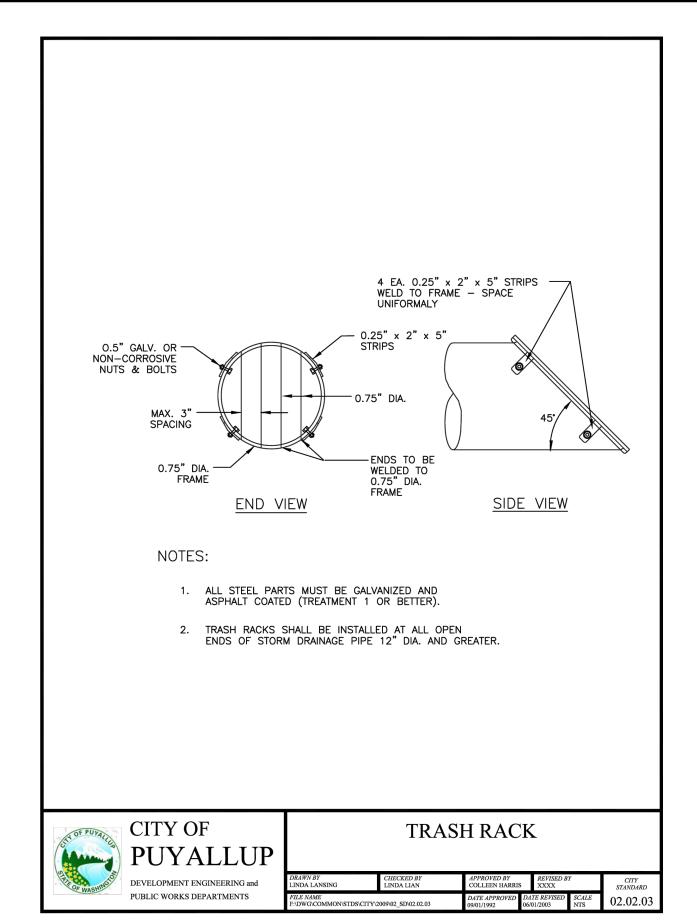

JMJ Team 905 Main Street, Suite #200 Sumner, WA 98390 (206) 596-2020


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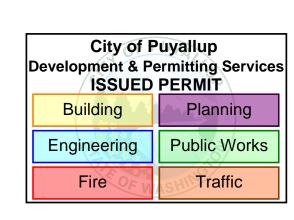
1501 39th Ave SW


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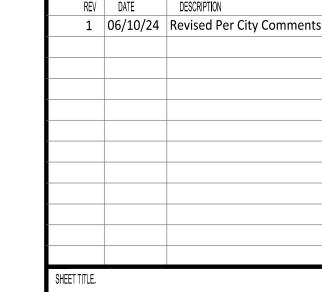




AND/OR OMISSIONS ON THESE

FIELD CONDITIONS MAY DICTATE CHANGES TO THESE PLANS AS DETERMINED BY THE CITY **ENGINEER**

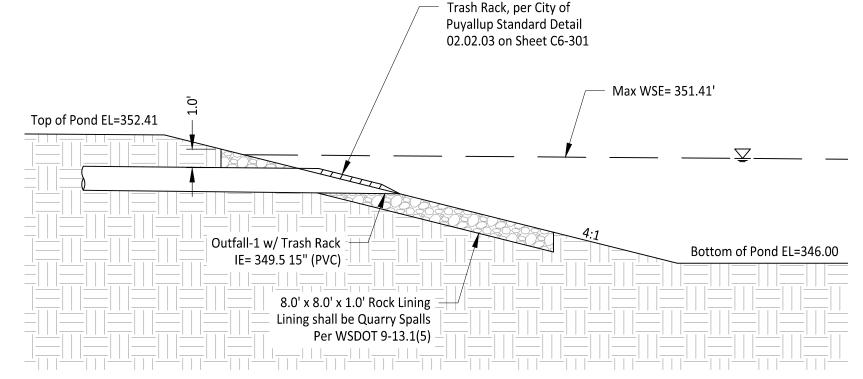CALL TWO BUSINESS DAYS BEFORE YOU DIG -800-424-5555 UTILITIES UNDERGROUND LOCATION CENTER

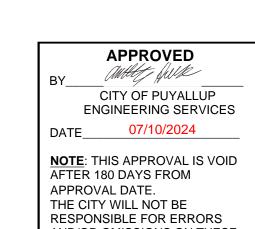

PORTESSIONAL EX


Notes & Details


PROJ. NO:	156	2-008		
DATE:	June 10th, 2024			
DRAWN BY:	MO	DESIGN BY:		


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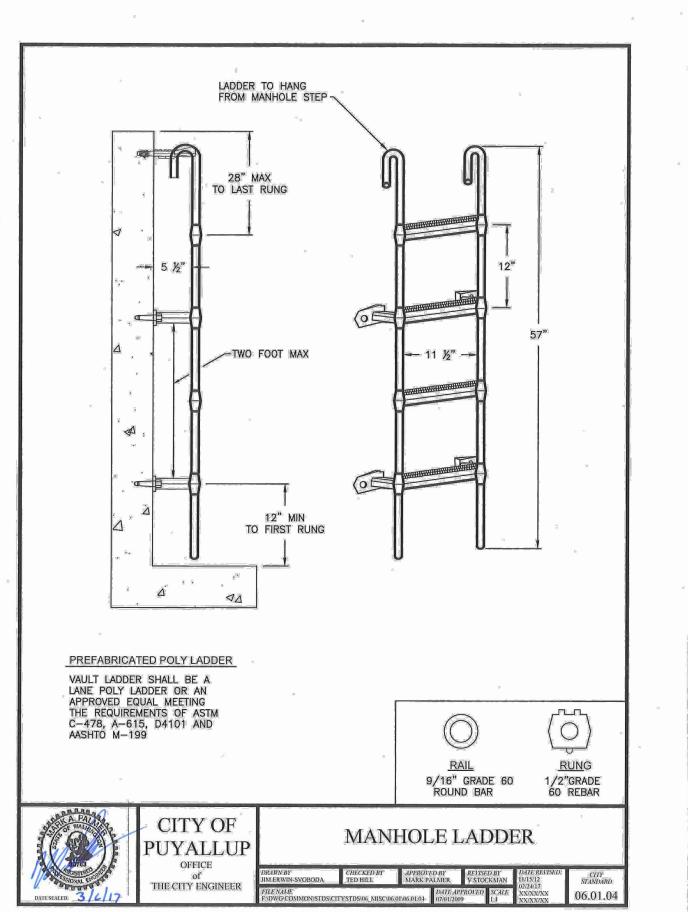
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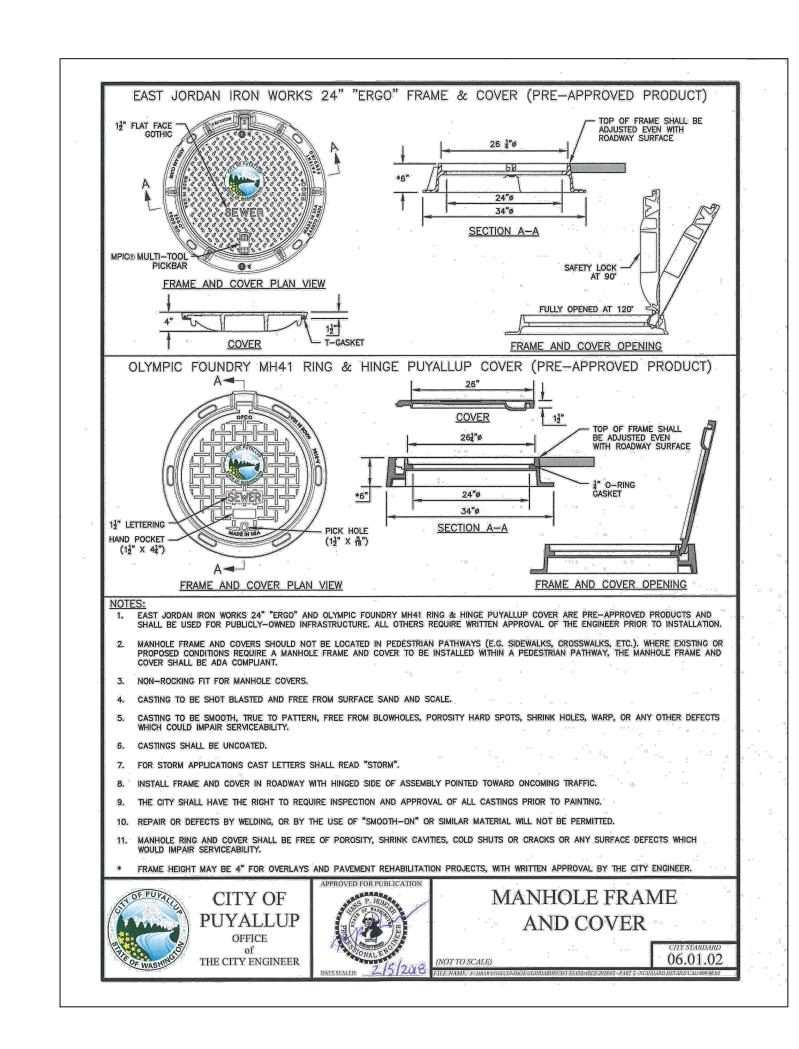
11 OF 13






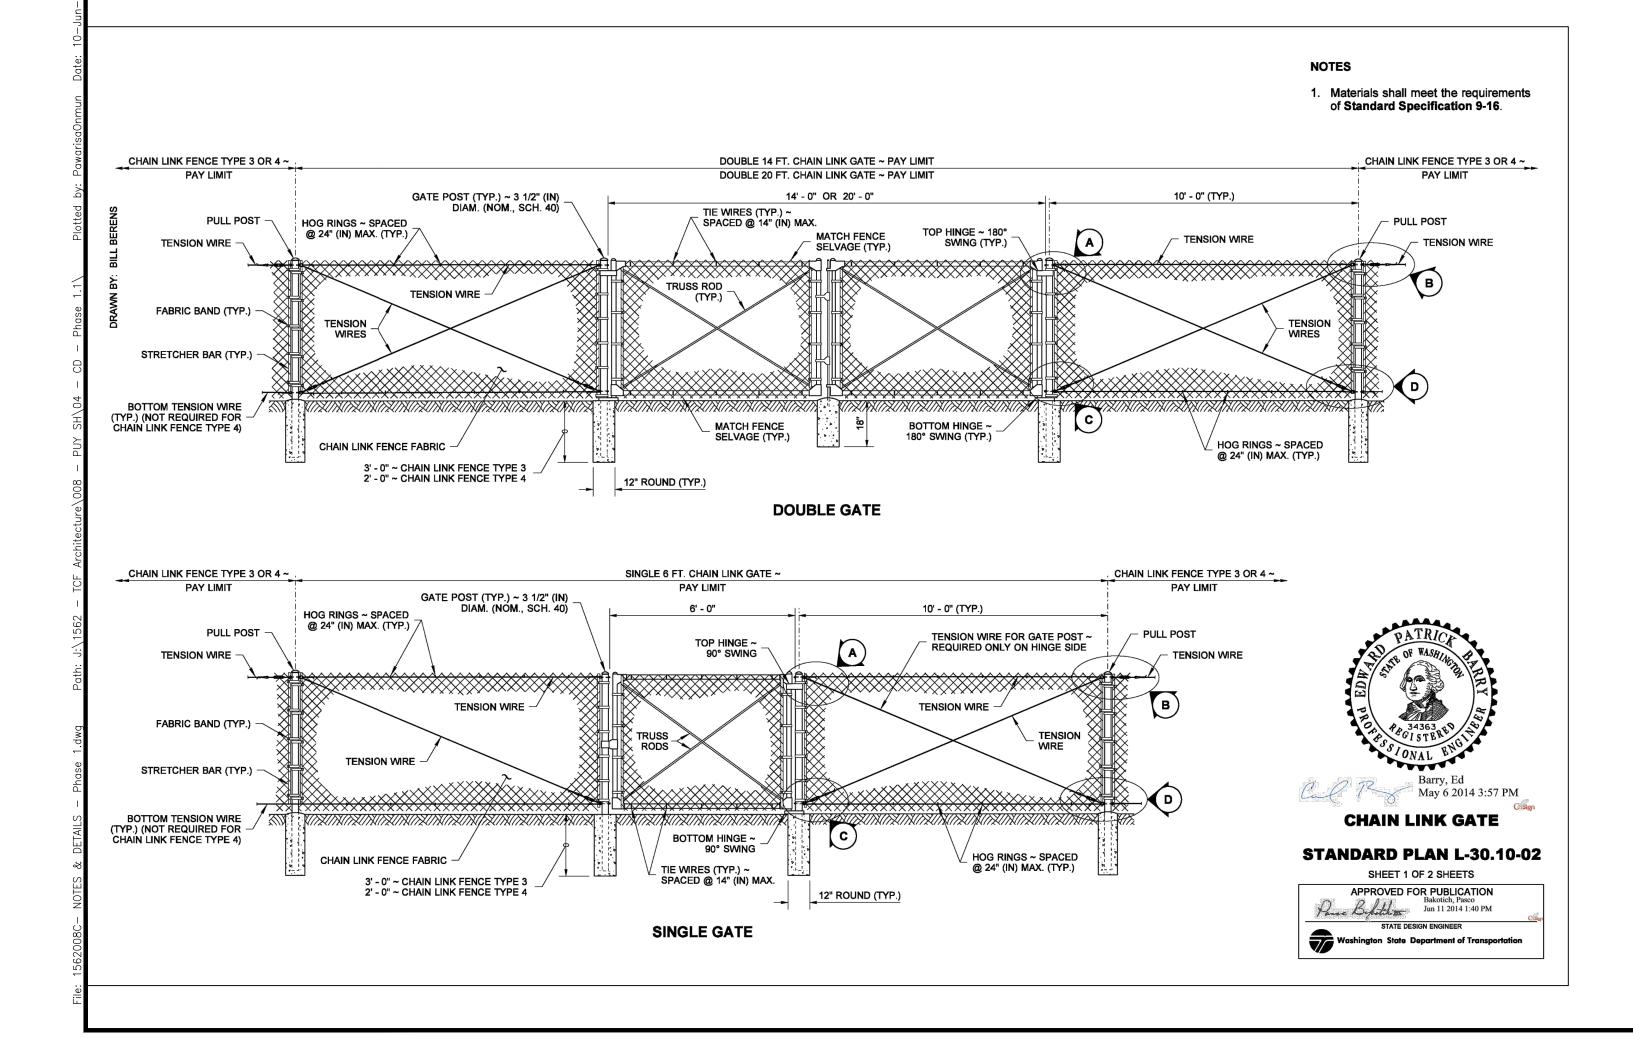

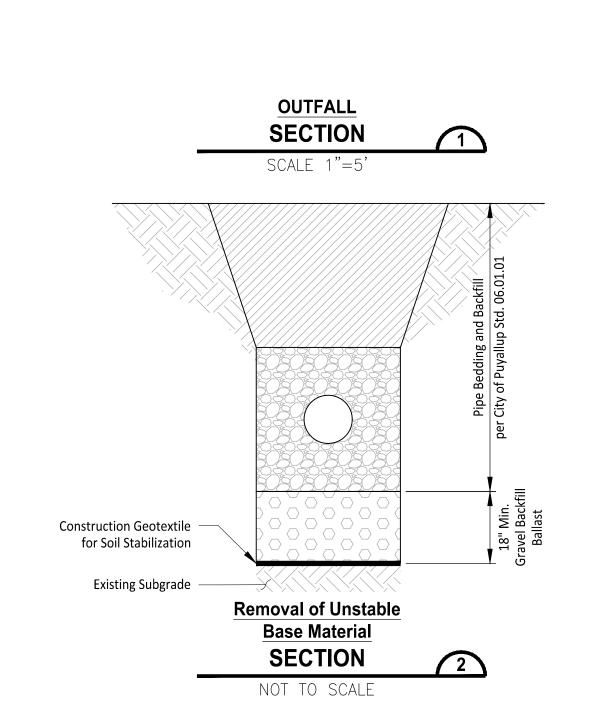

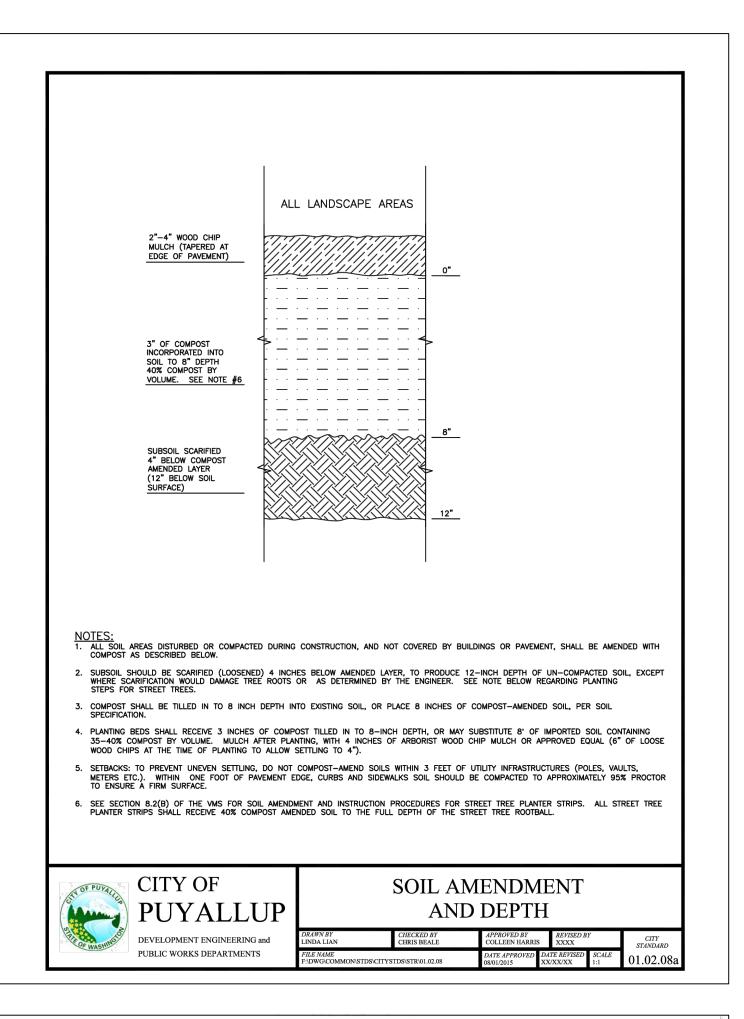


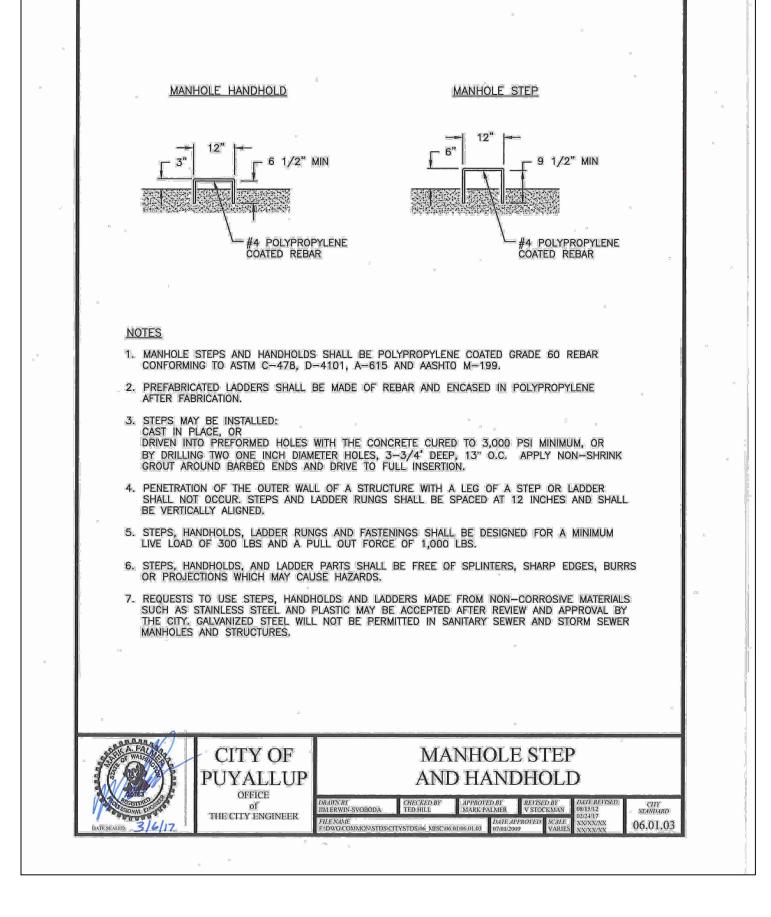

STORMWATER NOTES

- 1. All work in City right-of-way requires a permit from the City of Puyallup. Prior to any work commencing, the general contractor shall arrange for a preconstruction meeting at the Development Services Center to be attended by all contractors that will perform work shown on the engineering plans, representatives from all applicable Utility Companies, the project owner and appropriate City staff. Contact Engineering Services to schedule the meeting (253) 841-5568. The contractor is responsible to have their own approved set of plans at the meeting.
- 2. After completion of all items shown on these plans and before acceptance of the project, the contractor shall obtain a "punch list" prepared by the City's inspector detailing remaining items of work to be completed. All items of work shown on these plans shall be completed to the satisfaction of the City prior to acceptance of the water system and provision of sanitary sewer service.
- 3. All materials and workmanship shall conform to the Standard Specifications for Road, Bridge, and Municipal Construction (hereinafter referred to as the "Standard Specifications"), Washington State Department of Transportation and American Public Works Association, Washington State Chapter, latest edition, unless superseded or amended by the City of Puyallup City Standards for Public Works Engineering and Construction (hereinafter referred to as the "City Standards").
- 4. A copy of these approved plans and applicable city developer specifications and details shall be on site during construction.
- 5. Any revisions made to these plans must be reviewed and approved by the developer's engineer and the Engineering Services Staff prior to any implementation in the field. The City shall not be responsible for any errors and/or omissions on these plans.
- 6. The contractor shall have all utilities verified on the ground prior to any construction. Call (811) at least two working days in advance. The owner and his/her engineer shall be contacted immediately if a conflict exists.
- 7. Any structure and/or obstruction which require removal or relocation relating to this project, shall be done so at the developer's expense.
- 8. During construction, all existing and newly installed drainage structures shall be protected from sediments.
- 9. All storm manholes shall conform to City Standard Detail No. 02.01.01. Flow control manhole/oil water separator shall conform to City Standard Detail No. 02.01.06 and 02.01.07.
- 10. Manhole ring and cover shall conform to City Standard Detail 06.01.02.
- 11. Catch basins Type I shall conform to City Standard Detail No.02.01.02 and 02.01.03 and shall be used only for depths less than 5 feet from top of the grate to the invert of the storm pipe.

- 12. Catch basins Type II shall conform to City Standard Detail No.02.01.04 and shall be used for depths greater than 5 feet from top of the grate to the invert of the storm pipe. City of Puyallup City Standards Storm Revised 04/2024200-22
- 13. Cast iron or ductile iron frame and grate shall conform to City Standard Detail No.02.01.05. Grate shall be marked with "drains to stream". Solid catch basin lids (square unless noted as round) shall conform to WSDOT Standard Plan B-30.20-04 (Olympic Foundry No. SM60 or equal). Vaned grates shall conform to WSDOT Standard Plan B-30.30-03 (Olympic Foundry No. SM60V or equal).
- 14. Stormwater pipe shall be only PVC, concrete, ductile iron, or dual walled Polypropylene pipe.
 - a. The use of any other type shall be reviewed and approved by the Engineering Services Staff prior to installation.
 - b. PVC pipe shall be per ASTM D3034, SDR 35 for pipe size 15-inch and smaller and F679 for pipe sizes 18 to 27 inch. Minimum cover on PVC pipe shall be 3.0 feet.
 - c. Concrete pipe shall conform to the WSDOT Standard Specifications for concrete underdrain pipe. Minimum cover on concrete pipe shall not less than 3.0 feet.
 - d. Ductile iron pipe shall be Class 50, conforming to AWWA C151. Minimum cover on ductile iron pipe shall be 1.0 foot.
 - e. Polypropylene Pipe (PP) shall be dual walled, have a smooth interior and exterior corrugations and meet WSDOT 9-05.24(1). 12-inch through 30-inch pipe shall meet or exceed ASTM F2736 and AASHTO M330, Type S, or Type D. 36-inch through 60-inch pipe shall meet or exceed ASTM F2881 and AASHTO M330, Type S, or Type D. Testing shall be per ASTM F1417. Minimum cover over Polypropylene pipe shall be 3-feet.
- 15. Trenching, bedding, and backfill for pipe shall conform to City Standard Detail No. 06.01.01.
- 16. Storm pipe shall be a minimum of 10 feet away from building foundations and/or roof lines.
- 17. All storm pipe shall be tested and inspected for acceptance as outlined in Section 209 of the City of Puyallup Stormwater Management Standards.
- 18. All temporary sedimentation and erosion control measures, and protective measures for critical areas and significant trees shall be installed prior to initiating any construction activities.
- 19. Registration is required for all Class V UIC wells within public drainage tracts or public rightof-way and must be submitted sixty (60) days prior to well construction. A copy of the online registration shall be submitted to the City prior to construction.

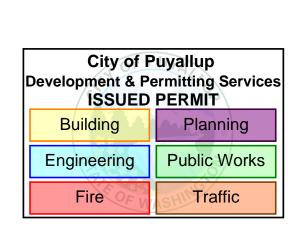

APPROVED

BY______CITY OF PUYALLUP
ENGINEERING SERVICES

DATE_____07/10/2024

NOTE: THIS APPROVAL IS VOID
AFTER 180 DAYS FROM
APPROVAL DATE.
THE CITY WILL NOT BE
RESPONSIBLE FOR ERRORS
AND/OR OMISSIONS ON THESE

PLANS.
FIELD CONDITIONS MAY DICTATE
CHANGES TO THESE PLANS AS
DETERMINED BY THE CITY
ENGINEER

CALL TWO BUSINESS DAYS
BEFORE YOU DIG

UTILITIES UNDERGROUND LOCATION CENTER

41829
41829

AUGISTERED

SONAL ENGIN

Owner/Developer:

Puyallup School District 1501 39th Ave SW Puyallup, WA 98371 253-841-8641

Architect:

Engineer:

JMJ Team

905 Main Street, Suite #200

Support Campus Expansion

ONE INCH AT FULL SCALE. IF NOT, SCALE ACCORDINGLY

Civil Construction Permit

Improvements - Phase 1

Sumner, WA 98390

(206) 596-2020

1501 39th Ave SW

Puyallup, WA 98371

TCF Architecture 902 North Second Street Tacoma, WA 98403 253-572-3993

SCHOOL DISTRICT

A Tradition of Excellence

TCF Architecture

REV DATE DESCRIPTION

1 06/10/24 Revised Per City Comments

SHEET TITLE.

Notes & Details

PROJ. NO: 1562-008

DATE: June 10th, 2024

DRAWN BY: DESIGN BY:

SHEET NUMBER.

C6-302

____12_ OF ____13_

