

REPLACEMENT OF HVAC UNITS TRACTOR SUPPLY NO. 1886 621 RIVER RD, PUYALLUP, WA 98371

oversights by this office or non compliance with any applicable regulations of local government. The contractor is responsible for making sure that the building complies with all applicable codes and regulations of the local government.

engineering must be posted on the job at all inspections in a visible and readily accessible location.

Full sized legible color plans are required to be provided by


City of Puyallup


ISSUED PERMIT

the permitee on site for inspection.

Building

Engineering

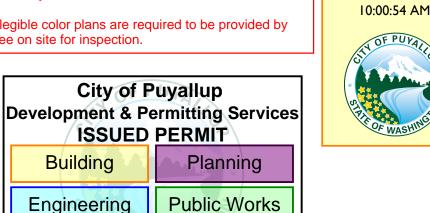

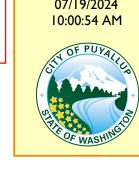

SHEET INDEX

SHEET NO. SHEET NAME INDEX SHEET MECHANICAL NOTES MECHANICAL SCHEDULE MECHANICAL DETAILS HOLD DOWN DETAILS ROOF FRAMING PLAN

PROJECT SCOPE

- REMOVE (E) RTUs 1-3 & CU-7
- 2. INSTALL (N) RTUs 1-3 & CU-7
- 3. INSTALL (N) UNITS AT THE SAME LOCATION AS (E) UNIT
- 4. UTILIZE (E) ELECTRICAL DISCONNECT FOR (N) UNIT
- NO DUCT WORK AND NO ROOF WORK
- 6. UTILIZE (E) CONDENSATE DRAIN SYSTEM FOR (N) UNIT

PROJECT DATA

OCCUPANCY GROUP M / RETAIL STORE

STORIES

FIRE SPRINKLER REQ'D

REPLACEMENT AREA COMMERCIAL (SHOPPING CENTER - COMMUNITY)

BUSINESS

TRACTOR SUPPLY NO. 1886

621 RIVER RD, PUYALLUP, WA 98371

TEL: +1 253 845 0397

APPLICABLE BUILDING CODES

2021 WASHINGTON BUILDING CODE


2021 WASHINGTON STATE FIRE CODE


2021 WASHINGTON STATE MECHANICAL CODE


2021 WASHINGTON STATE PLUMBING CODE

2021 WASHINGTON STATE ENERGY CODE


2021 WASHINGTON STATE EXISTING BUILDING CODE

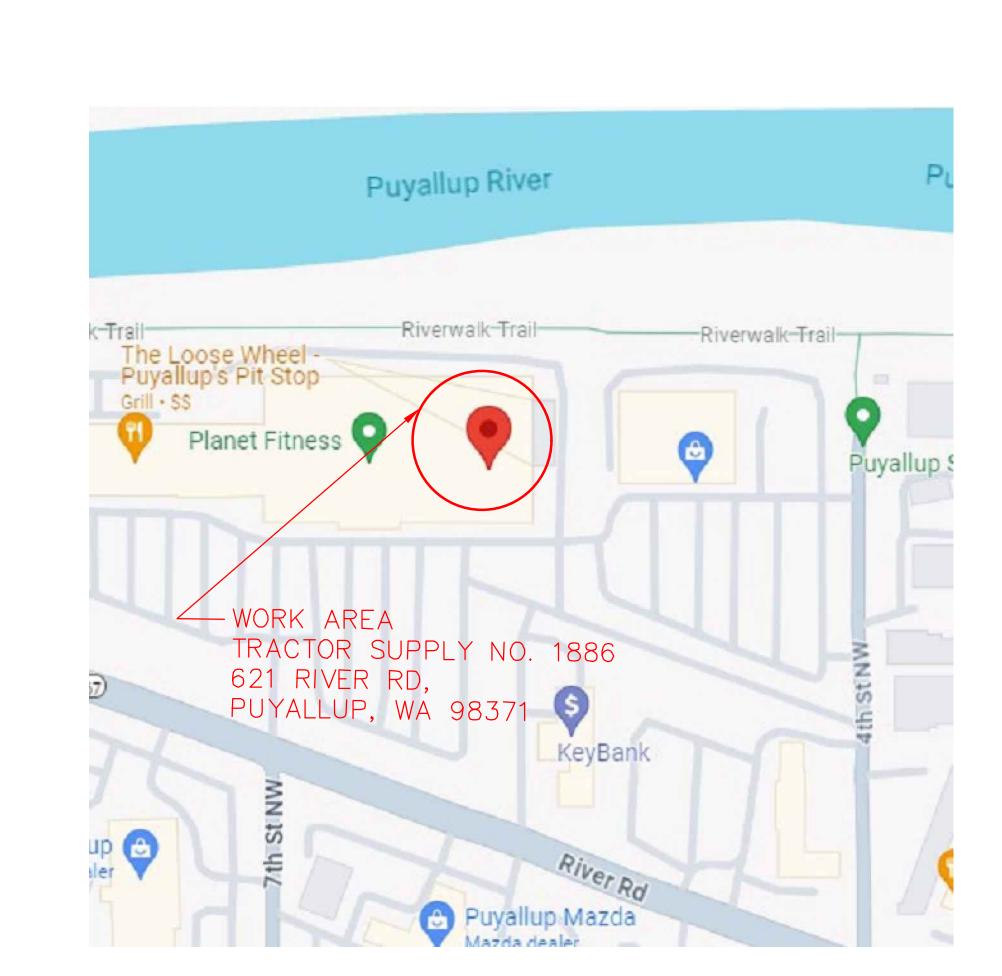

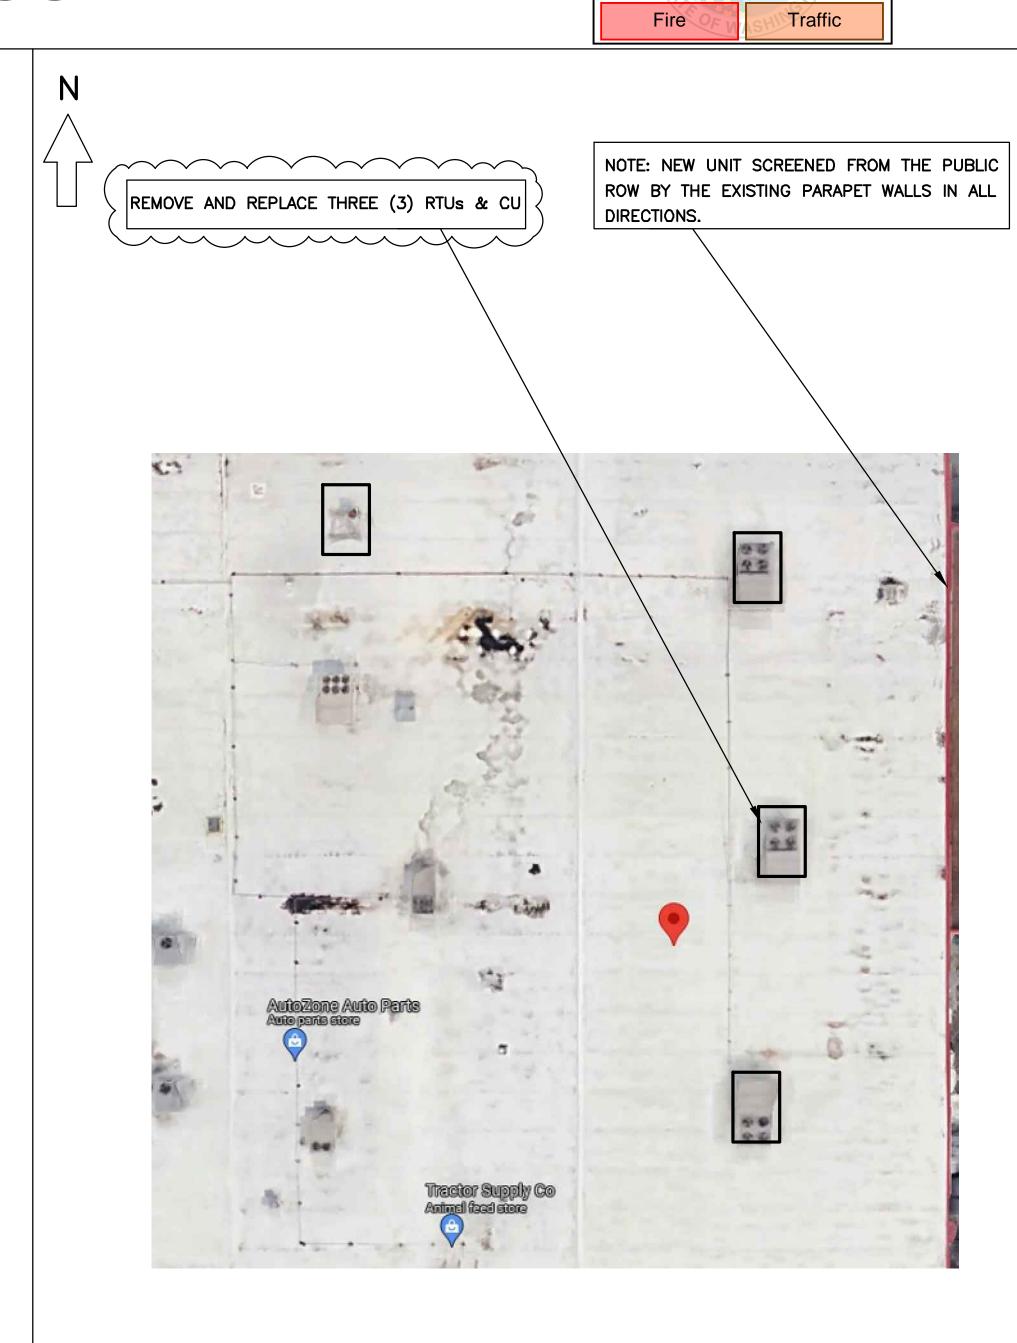

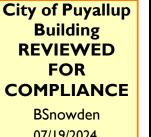

07/19/2024

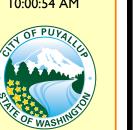

TRACTOR SUPPLY NO. 1886 621 RIVER RD, PUYALLUP, WA 98371

TRACTOR SUPPLY Cº

General Notes

PRMH20241062




1390 W. 6TH STREET, SUITE 108 CORONA, CA 92882 PHONE (951) 283-7085

Stamp



ACEMENT

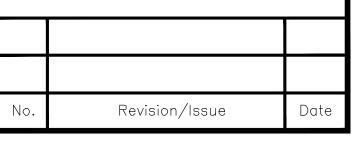



TRACTOR SUPPLY NO. 1886 621 RIVER RD, PUYALLUP, WA 98371

> 148824-0651 06/18/2024

> > AS NOTED

PROJECT VICINITY MAP SCALE N.T.S.

PROJECT AERIAL VIEW SCALE N.T.S.

HVAC ABBREVIATIONS

AHU AIR HANDLING UNIT

COOLING TOWER

CU CONDENSER UNIT

EH ELECTRIC HEATER

ODC OPEN DRIVE COMPRESSOR

RTU ROOFTOP UNIT

SHP | SPLIT SYSTEM HEAT PUMP

MECHA	NICAL SYMBOL LIST:
SYMBOL	DESCRIPTION
[X]	SUPPLY AIR DOWN
	SUPPLY AIR UP AND THRU
	RETURN AIR DOWN
	RETURN AIR UP AND THRU
\nearrow	EXHAUST AIR DOWN
	EXHAUST AIR UP AND THRU
	MANUAL DAMPER
- Contraction of the contraction	MITERED ELBOW WITH TURNING VANES
	RADIUSED ELBOW
	CONNECT/REMOVE TO EXISTING
T	THERMOSTAT
$oxed{\mathbb{H}}$	HUMIDISTAT
M	MOTORIZED DAMPER ACTUATOR
XXX-X	EQUIPMENT / PLUMBING FIXTURE TAG
<u></u>	REVISION TAG
← ₩	DIRECTION OF AIRFLOW
(BD)	BACKDRAFT DAMPER
(CD	CONTROL DAMPER
	FIRE/SMOKE DAMPER
	FIRE DAMPER
	SMOKE DAMPER

GENERAL NOTES

PART I: MECHANICAL SCOPE OF WORK

1. CONTRACTOR SHALL FURNISH ALL LABOR AND MATERIALS, EQUIPMENT AND ACCESSORIES FOR COMPLETE AND FULLY OPERATING SYSTEM(S) INCLUDING (BUT NOT LIMITED TO): CONTROLS, ACCESSORIES AND ALL REQUIRED FEES.

WORK SPECIFIED ELSEWHERE AND BY OTHERS TO INCLUDE ELECTRICAL CONDUIT, LINE VOLTAGE WIRING, CARPENTRY AND PLATFORMS, CUTTING, CORING AND DRILLING BY OTHERS.

- A. OBTAINING ALL PERMITS AND APPROVAL FROM AUTHORITIES HAVING JURISDICTION, AND PAYING ALL FEES REQUIRED
- B. CUTTING AND PATCHING
- C. SHOP DRAWINGS
- D. START-UP, TEST AND ADJUSTMENTS
- E. CLEAN-UP
- 2. JOB CONDITIONS: VERIFY ELECTRICAL POWER REQUIREMENTS ON JOB SITE. MAINTAIN CONTINUITY OF SERVICE TO ANY EXISTING SYSTEMS. VISIT SITE PRIOR TO BIDDING TO UNDERSTAND CONDITIONS AFFECTING INSTALLATION OF THE PROPOSED SYSTEMS, COORDINATE WORK WITH ALL TRADES, ALL WORK SHALL COMPLY WITH ALL CODES, REGULATIONS AND JURISDICTIONS HAVING AUTHORITY.

PART 2: GENERAL HVAC NOTES

- 3. ALL DIMENSIONS TO BE FIELD VERIFIED PRIOR TO COMMENCEMENT OF WORK.
- 4. ALL DEBRIS TO BE REMOVED AT THE END OF EACH DAY.
- 5. ALL SPACE CONDITIONING SYSTEMS ARE TO BE INDIVIDUALLY CONTROLLED BY THERMOSTATS OR SENSORS LOCATED WITHIN THAT UNIT ZONE. THERMOSTATS TO BE PROGRAMMABLE.
- 6. SMOKE DETECTOR BY MECHANICAL CONTRACTOR.
- 7. LOW VOLTAGE WIRING, CONDUITS AND LINE VOLTAGE WIRING BY ELECTRICAL CONTRACTOR,
- 8. CONTRACTOR TO PROVIDE AND INSTALL ALL REQUIRED DISCONNECTS, TRANSFORMERS, RELAYS, INTERLOCKS, SWITCHES, TIME CLOCKS AND GLOBAL SHUT DOWN IF REQUIRED.
- 9. AT THE TIME OF ROUGH INSTALLATION, DURING STORAGE ON THE CONSTRUCTION SITE AND UNTIL FINAL STARTUP OF THE HEATING, COOLING, AND VENTILATION EQUIPMENT, ALL DUCT AND OTHER RELATED AIR DISTRIBUTION COMPONENT OPENING BE COVERED WITH TAPE, PLASTIC, SHEET METAL OR OTHER METHODS ACCEPTABLE TO THE ENFORCING AGENCY TO REDUCE THE AMOUNT OF WATER, DUST AND DEBRIS, WHICH MAY ENTER THE SYSTEM [CGBSC 4.504.1]

CONSTRUCTION NOTES:

- 1. THIS BUILDING IS IN FULL OPERATION. IT IS THE RESPONSIBILITY OF THE CONTRACTOR TO COORDINATE WITH TENANTS FOR WORK PERFORMED IN SPECIFIC SPACE.
- 2. CONTRACTOR MUST PROTECT ALL OCCUPANTS OF THE BUILDING AGAINST HARM DUE TO OR ASSOCIATED WITH THIS WORK.
- 3. THIS PROJECT WILL BE EXECUTED WHILE THE BUILDING IS IN FULL OPERATION.
- 4. AFTER COMPLETION OF TESTING, ADJUSTING, AND BALANCING, A FINAL REPORT SHALL BE PROVIDED AND SIGNED BY THE INDIVIDUAL RESPONSIBLE FOR PERFORMING THESE SERVICES.
- 5. PROVIDE BUILDING OWNER WITH DETAILED OPERATION AND MAINTENANCE INSTRUCTIONS AND COPIES OF GUARANTEES/WARRANTIES FOR EACH SYSTEM PRIOR TO FINAL INSPECTION.
- CONTRACTOR SHALL ENSURE ALL ACCESS LOCKS, SCREWS, AND BOLTS SHALL BE OF CORROSION RESISTANT MATERIAL. IMC 304.10
- 7. CONTRACTOR SHALL PROVIDE CLEANOUTS FOR THE CONDENSATE LINES. IMC 307.2.5
- CONDENSATE WASTE PIPES FROM AIR—COOLING COILS ARE SIZED IN ACCORDANCE WITH THE EQUIPMENT CAPACITY AS SPECIFIED IN SECTION 310.3 CMC (IMC SECTION 307.2.2). CONDENSATE WASTE AND DRAIN LINE SHALL NOT BE LESS THAN 3/4 INCH INTERNAL DIAMETER AND SHALL NOT DECREASE IN SIZE FROM DRAIN PAN CONNECTION TO THE PLACE OF CONDENSATE DISPOSAL.
- 9. CONDENSATE FROM ALL COOLING COILS AND EVAPORATORS SHALL BE CONVEYED FROM THE DRAIN PAN OUTLET TO AN APPROVED PLACE OF DISPOSAL. PIPING SHALL MAINTAIN MINIMUM HORIZONTAL SLOPE IN THE DIRECTION OF DISCHARGE OF NO LESS THAN 1%. CONDENSATE SHALL NOT DISCHARGE INTO A STREET, ALLEY, OR OTHER AREAS THAT COULD CAUSE A NUISANCE.



General Notes



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Engineer



Proscap Engineering & Energy Group

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6/24/2024

NOTES

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PLACEMENT OF RIUS & CONTROL SUPPLY NO. 1886
621 RIVER RD,
PUYALLUP, WA 98371

No. Revision/Issue Date



Project Name and Address

TRACTOR SUPPLY NO. 1886
621 RIVER RD,
PUYALLUP, WA 98371

Project

148824-0651

Date

06/18/2024

Scale

AS NOTED

City of Puyallup
Development & Permitting Services
ISSUED PERMIT
Building Planning
Engineering Public Works
Fire Traffic

	TABLE 1 - ROOFTOP UNIT SCHEDULE (NEW)																			
MANUFACTURER					COOLING DATA								HEATING DATA ELECT.							
ID	AREAS	HVAC UNIT	27/		MODEL	NOMINAL		0555			OUTSIDE AIR	CAPACIT	Y(Btu/hr)	ENTERING WB	ENTERING DB	CAPACITY INPUT		460-		
MARK	SERVED	TYPE	QTY	MFR	MODEL	TONS	EER	SEER	IEER	(CFM)	(CFM)	TOTAL SENSIBLE (DEG.F)	(DEG.F)	INPUT (Btu/hr)	OUTPUT (Btu/hr)	MCA	моср	WEIGHT (lbs)		
RTU - 1	SALES AREA	PACKAGE UNIT	1	LENNOX	LGT180H4M	15.0	12.0		15.0	6,000	1,046	184,400	140,100	67.0	80.0	260,000	211,000	31.0	35	2,351
RTU - 2	SALES AREA	PACKAGE UNIT	1	LENNOX	LGT180H4M	15.0	12.0		15.0	6,000	1,046	184,400	140,100	67.0	80.0	260,000	211,000	31.0	35	2,351
RTU - 3	SALES AREA	PACKAGE UNIT	1	LENNOX	LGT180H4M	15.0	12.0		15.0	6,000	1,046	184,400	140,100	67.0	80.0	260,000	211,000	31.0	35	2,351


	TABLE I - SPLIT AIR CONDITIONING UNITS (NEW)											
				CONE	DENSING	UNIT						
			GENERAL	COOLIN	NG DATA		OTHERS			SYS	TEM	DATA
ID MARK	MFR	QTY	MODEL NO.	CAPACIT	Y(Btu/hr)	ELECTR	ELECTRICAL SYSTEM			TON	EER	IEER
MARK	IVII I (WODEL ING.	TOTAL	SENSIBLE	VOLTS	MCA	MOCP	(LBS)			
CU 7	LENNOX	1	EL090XCSST1G	90,000	72,000	460-3-60	17.00	25.00	345	7.5	11.2	14.8

	Table 2 - Rooftop Unit Schedule (Existing)																		
MANUFACTURER					COOLING DATA EI								EL	ECT.					
ID MARK	AREAS SERVED	HVAC UNIT TYPE	QTY	MFR	MODEL	NOMINAL TONS	EER :	SEER IEER		OUTSIDE AIR (CFM)	CAPACIT	Y(Btu/hr) SENSIBLE	ENTERING WE (DEG.F)	B ENTERING DB (DEG.F)	CAPACITY INPUT (Btu/hr)	CAPACITY OUTPUT (Btu/hr)	460- MCA	3-60 MOCP	WEIGHT
RTU - 1	SALES AREA	PACKAGE UNIT	1	YORK	DJ180N24S4VFH2E	15.0	12.0	14.2	6,000	1,046	178,000	142,400	67	80	300,000	240,000	41.1	50	1,765
RTU - 2	SALES AREA	PACKAGE UNIT	1	YORK	DJ180N24S4VFH2E	15.0	12.0	14.2	6,000	1,046	178,000	142,400	67	80	300,000	240,000	41.1	50	1,765
RTU - 3	SALES AREA	PACKAGE UNIT	1	YORK	DJ180N24S4VFH2E	15.0	12.0	14.2	6,000	1,046	178,000	142,400	67	80	300,000	240,000	41.1	50	1,765

	TABLE 2 - SPLIT AIR CONDITIONING UNITS (EXISTING)											
				CONE	DENSING	UNIT						
			GENERAL	COOLIN	NG DATA		OTHERS			SYS	TEM [ATAC
<u>ID</u>	ID MFR QTY MODEL NO.		CAPACIT	Y(Btu/hr)	ELECTR	UNIT WEIGHT	TON	EER	IEER			
MARK	1011 1		WODEL NO.	TOTAL	SENSIBLE	VOLTS	MCA	MOCP	(LBS)			
CU 7	TRANE	1	TTA090A400DA	98,000	78,400	460-3-60	35.8	45	311	7.5	11.5	13.1

	IABLE	= 3 - ZON	E VENTILATI	ON SUMMAI	₹Y
SECTIONS	AREA (Sq Ft)	ZONE OCCUPANCY	ZONE POPULATION	AREA OUTDOOR AIRFLOW RATE (CFM/SQ FT)	OUTDOOR AIFLOV RATE(Voz)
SALES AREA	4,500	RETAIL	68	0.12	1,046
SALES AREA	4,500	RETAIL	68	0.12	1,046
SALES AREA	4,500	RETAIL	68	0.12	1,046
SALES AREA	2,250	RETAIL	31	0.12	523

Т	TABLE 4 - CURB ADAPTER SCHEDULE										
ID MARK	MODEL	ADAPTER MODEL	WEIGHT (lbs)	MANUFACTURER							
RTU - 1	LGT180H4M	AC / YK05 / LN03	450	AES INDUSTRIES							
RTU - 2	LGT180H4M	AC / YK05 / LN03	450	AES INDUSTRIES							
RTU - 3	LGT180H4M	AC / YK05 / LN03	450	AES INDUSTRIES							

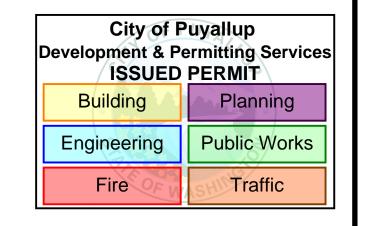

General Notes

PRMH20241062

TRACTOR SUPPLY Cº

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Engineer



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6/24/2024

MECHANICAL


REPLACEMENT OF RTUS & CU
TRACTOR SUPPLY NO. 1886
621 RIVER RD,
PUYALLUP, WA 98371




Revision/Issue


Project Name and Address

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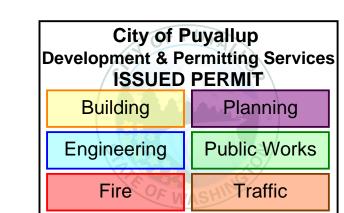


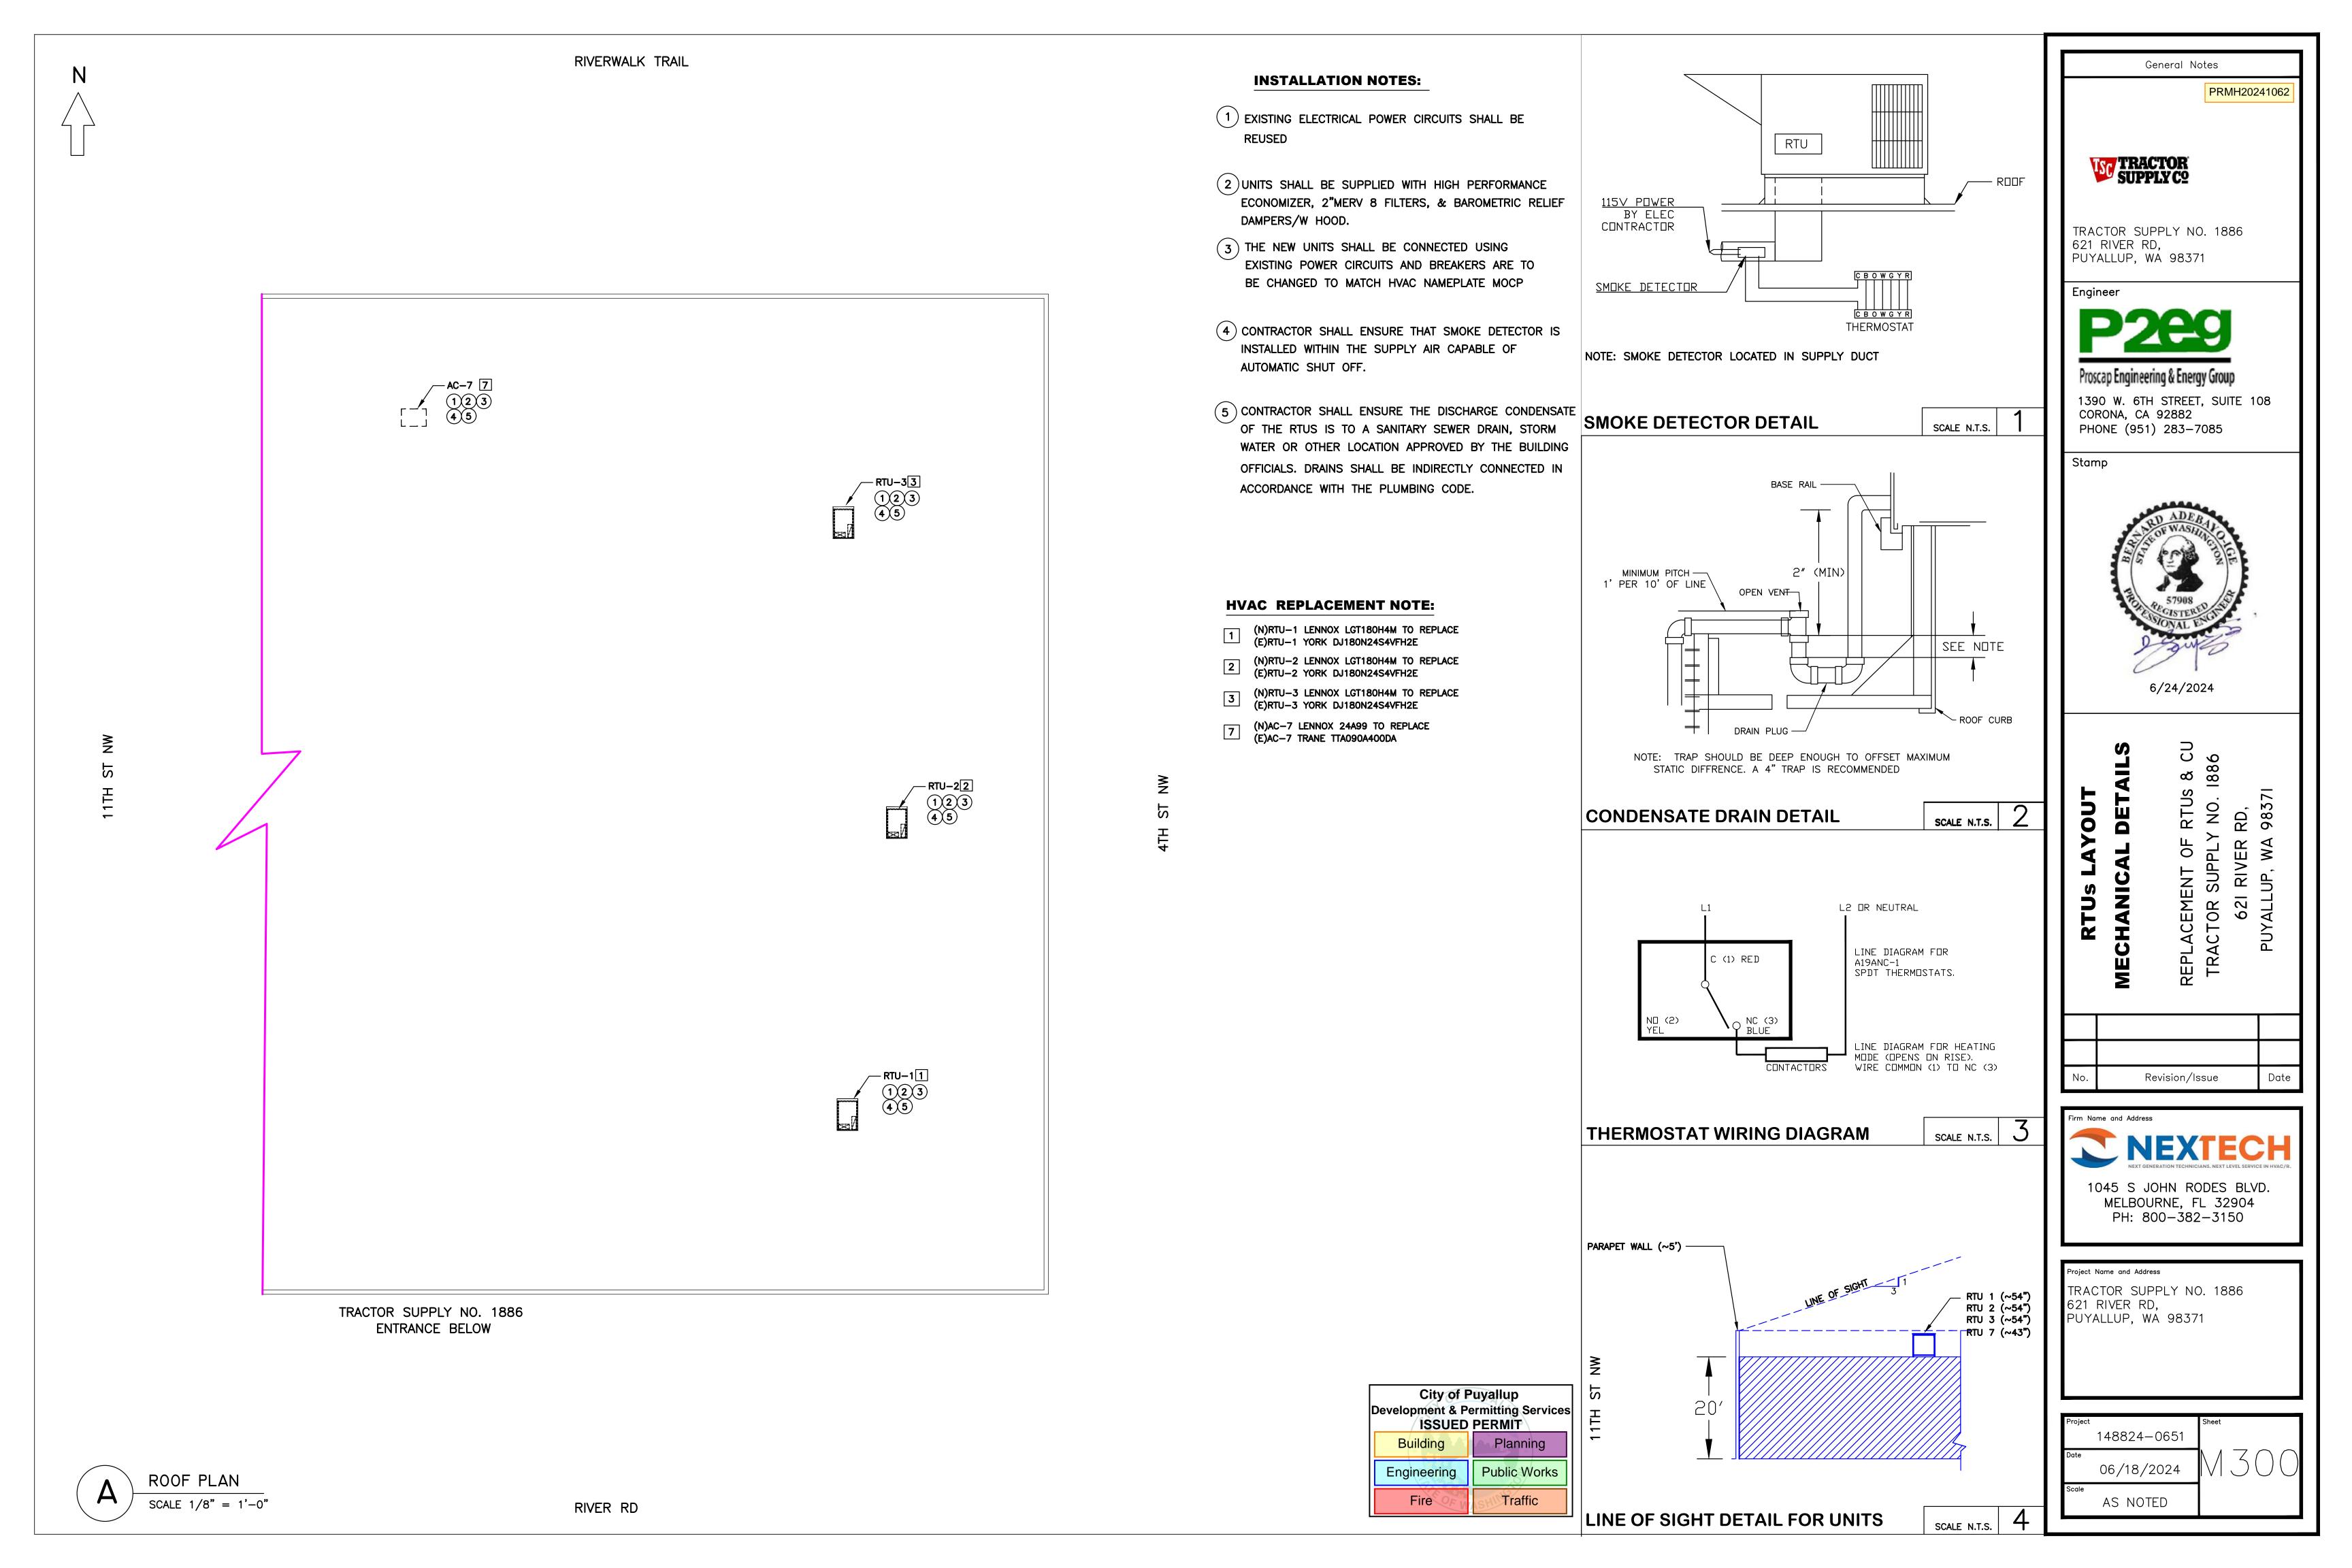

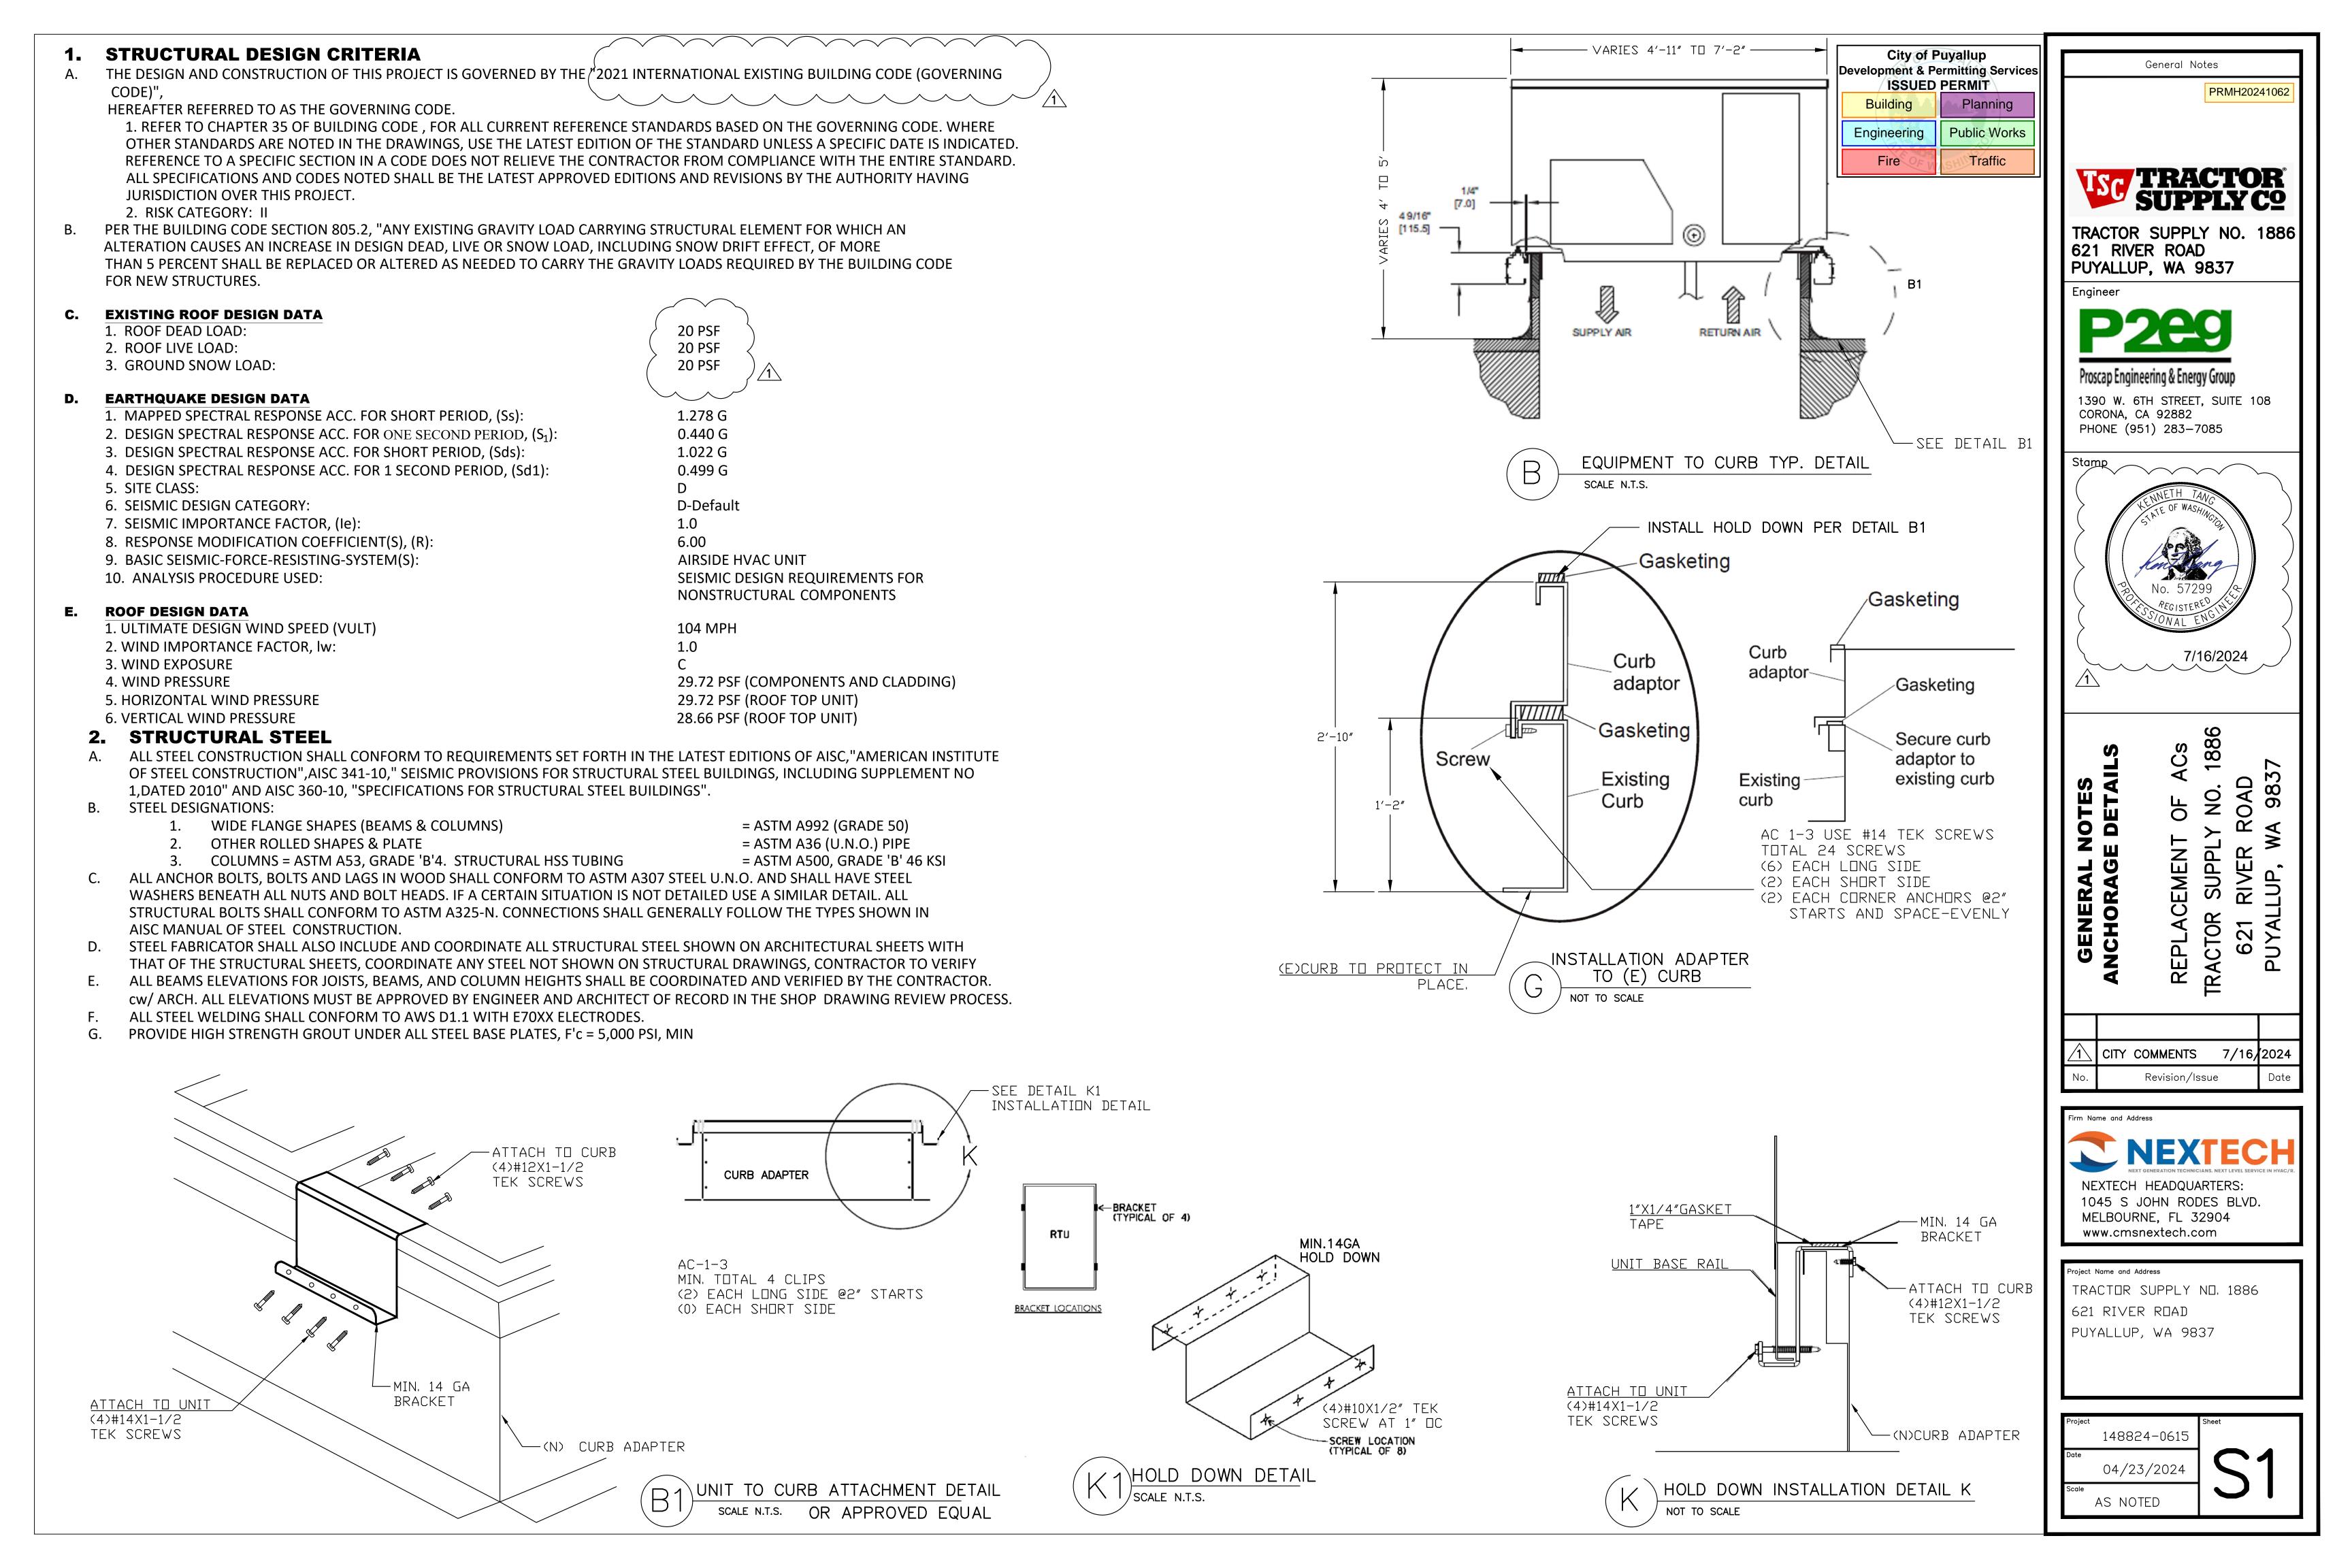

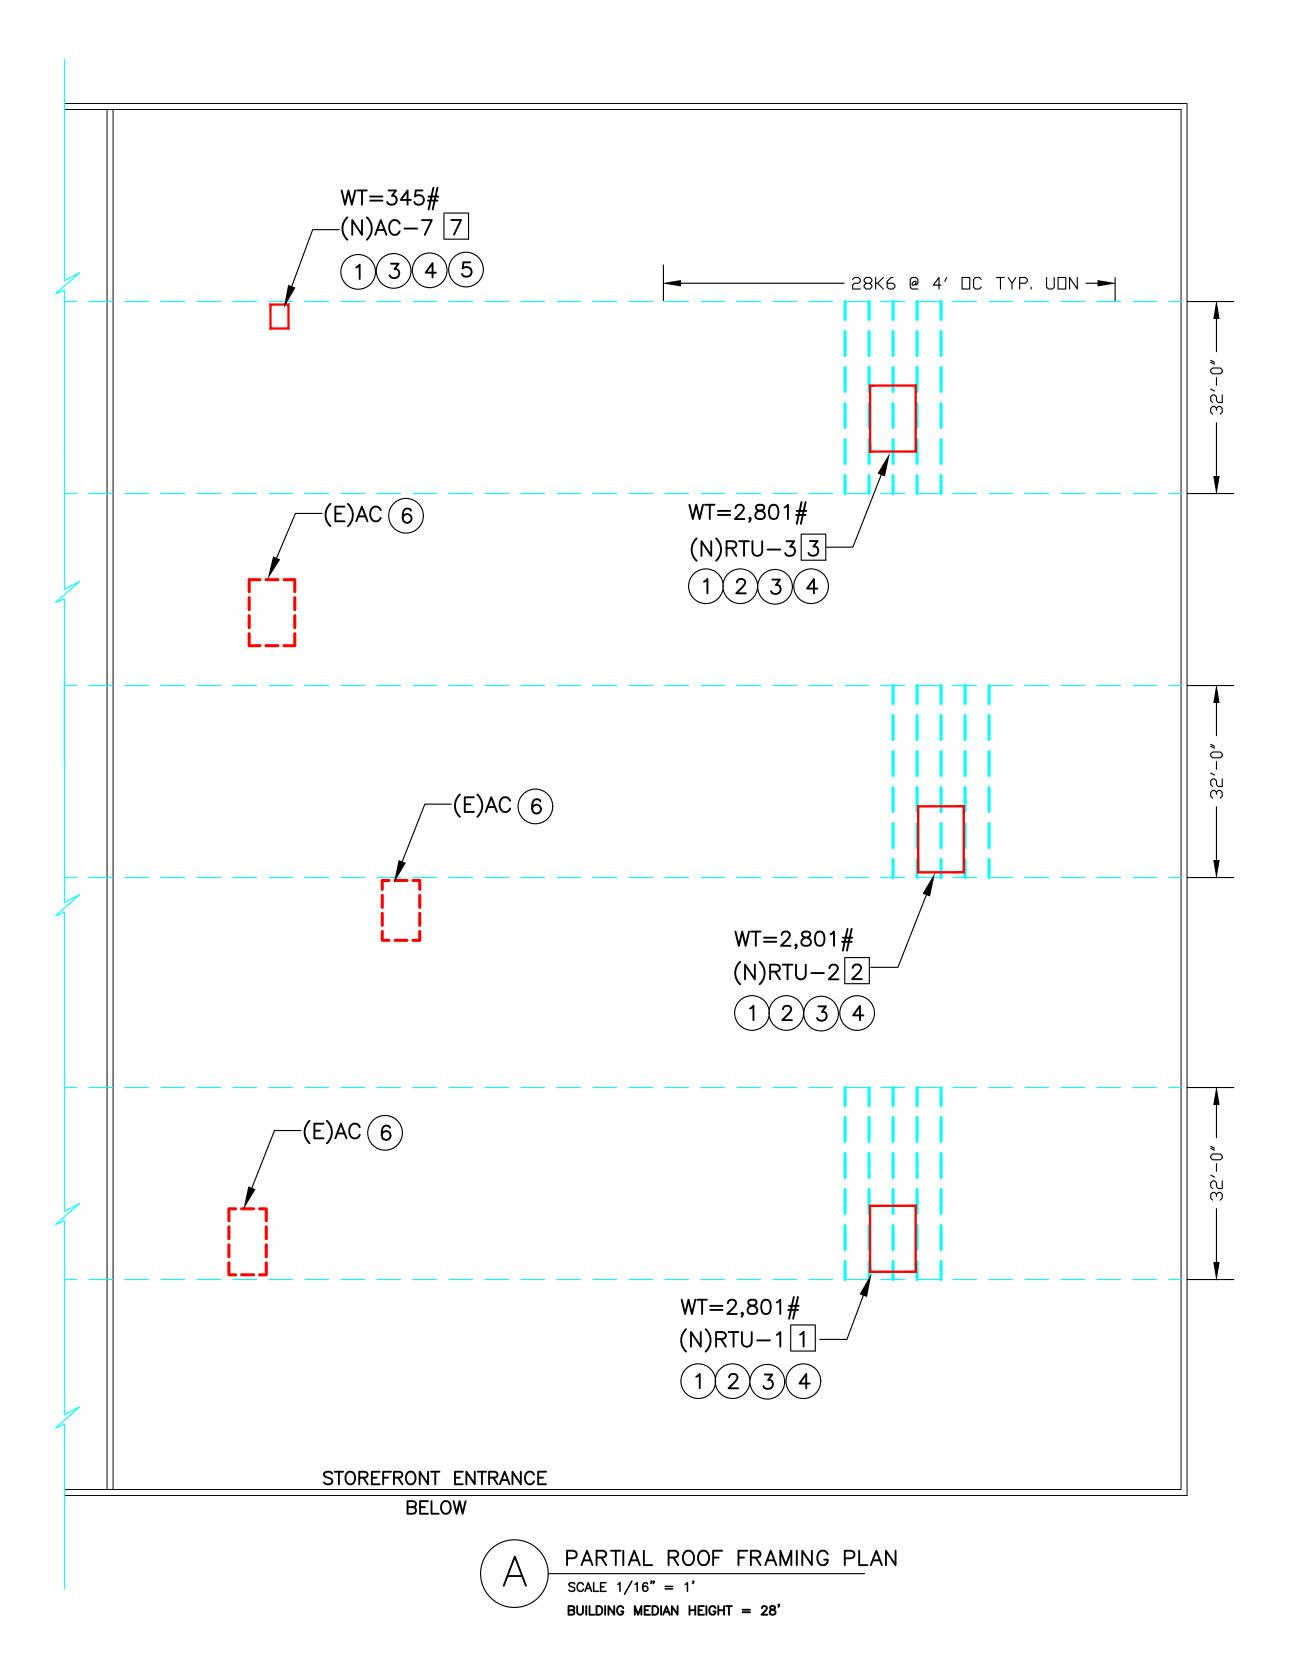

CURB	ADAPTER SCHE	EDULE	
ID MARK	ADAPTER MODEL	WEIGHT (Ibs)	MANUFACTURER
AC# 1-3	AC / YK05 / LN03	450	AES INDUSTRIES



PROJECT SCOPE

- REMOVE (E) ACs 1-3, AND 7
- 2. INSTALL (N) ACs 1-3, AND 7
- INSTALL (N) UNITS AT THE SAME LOCATION AS (E) UNIT
- UTILIZE (E) ELECTRICAL DISCONNECT FOR (N) UNIT
- NO DUCT WORK AND NO ROOF WORK
- UTILIZE (E) CONDENSATE DRAIN SYSTEM FOR (N) UNIT

NOTES:

- 1. FOR (N) RTUs ATTACHMENT, SEE DETAIL B/S1.
- 2. FOR (FOR ANY INSTALLATION OF ANY (N) DUCT WORK WHERE IT CONFLICTS W/ (E) JOIST BRIDGING OR BRACING, CONTRACTOR SHALL RELOCATE AS REQUIRED (TYP).
- 3. FOR ADDITIONAL INFO, SEE MECH./REFRIG. CONTRACTOR.
- 4. REMOVE (E) RTUS FROM ROOF PRIOR TO PLACING (N) RTUS ON ROOF. AT NO TIME SHALL THE (N) RTUS BE PLACED ON THE ROOF WHILE THE EXISTING RTUS BEING REPLACED REMAINS ON THE ROOF.
- 5. THIS BUIDING IS IN FULL OPERATION IT IS THE RESPONSIBILITY OF THE CONTRACTOR TO COORDINATE WITH TENANTS FOR WORK PERFORMED IN SPECIFIC SPACE. CONTRACTOR MUST PROTECT ALL OCCUPANTS OF THIS BUILDING AGAINST ANY POSSIBLE HARM THAT IS DUE TO OR ASSOCIATED WITH THIS WORK. THIS PROJECT WILL BE EXECUTED WHILE BUILDING IS IN FULL OPERATION.
- 6. CONTRACTOR SHALL CONFIRM ALL FIELD CONDITIONS AND REPORT TO THE ARCHITECT/ENGINEER ANY DISCREPANCY AND INACCURACY.

CONSTRUCTION NOTES:


- (1) REMOVE (E)RTUS OFF THE ROOF. (E) ROOF CURB TO REMAIN.
- (2) INSTALL CURB ADAPTER PER UNIT SCHEDULE BELOW AND INSTALL HOLD DOWN BRACKETS PER DETAILS B1/S1.
- (3) CONFIRM THE (E) RTU NUMBER TO BE REPLACED AS SHOWN ON THE UNIT SCHEDULE HEREON.
- (4) REPLACE (E)RTU w/(N)RTU, SEE DETAILS B AND G/S1 FOR ATTACHMENT OF (N)RTU TO (N)CURB ADAPTER AND (E)CURB.
- (5) REPLACE (E)RTU w/(N)RTU, SEE DETAILS L/S1 FOR ATTACHMENT OF (N)RTU TO (E)CURB.
- (6) PROTECT IN PLACE.

ROOF MECHANICAL EQUIPMENTS

- (N)AC-1 LENNOX MODEL LGT180H4M-G 15T CONF E=12.0 (2,351#) (E)AC-1 YORK MODEL DJ180N24S4VFH2E (15T)
- (N)AC-2 LENNOX MODEL LGT180H4M-G 15T CONF E=12.0 (2,351#) (E)AC-2 YORK MODEL DJ180N24S4VFH2E (15T)
- (N)AC-3 LENNOX MODEL LGT180H4M-G 15T CONF E=12.0 (2,351#) (E)AC-3 YORK MODEL DJ180N24S4VFH2E (15T)
- (N)AC-7 LENNOX MODEL EL090XCSST1G AC/7.5TON/460-3 (345#) (E)AC-7 TRANE MODEL TTA090A400DA (7.5T)

NOTES:

- PLACE (N) RTU ON THE ROOF EQUIPMENT CURB.
- INSTALL STAINLESS STEEL HOLD DOWN BRACKET (MIN. 7GA) SEE DETAIL AA.
- INSTALL TEK SCREWS AT THE BASE BRACKETS UNTIL THE UNIT IS SECURELY FASTENED AT THE (N) ROOF CURB.
- INSTALL TEK SCREWS AT THE BASE BRACKETS TO THE CURB.

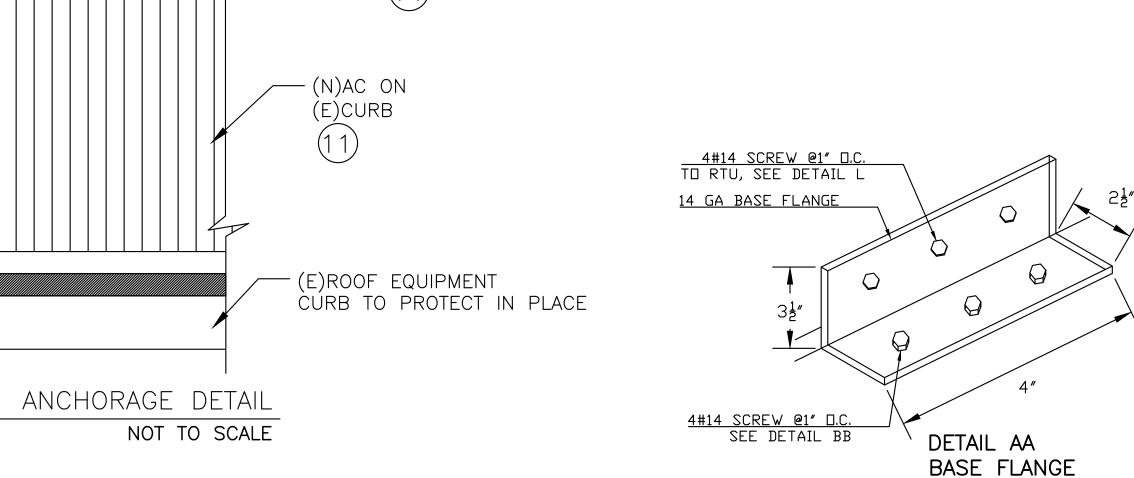

General Notes

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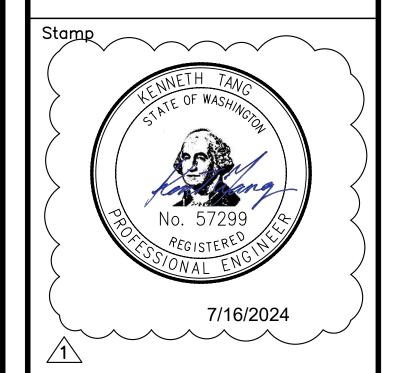
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Engineer



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NO.

TRACTOR

RIVE!

621 PUYAL

1886

CITY COMMENTS 7/16/2024 Revision/Issue



1045 S JOHN RODES BLVD. MELBOURNE, FL 32904 www.cmsnextech.com

Project Name and Address TRACTOR SUPPLY NO. 1886 621 RIVER ROAD PUYALLUP, WA 9837

> 148824-0615 04/23/2024 AS NOTED