
A PORTION OF THE NW 1/4 OF THE NW 1/4 OF SEC. 27, TWN. 20 N., RGE. 04 E. W.M. CITY OF PUYALLUP, PIERCE COUNTY, WASHINGTON.

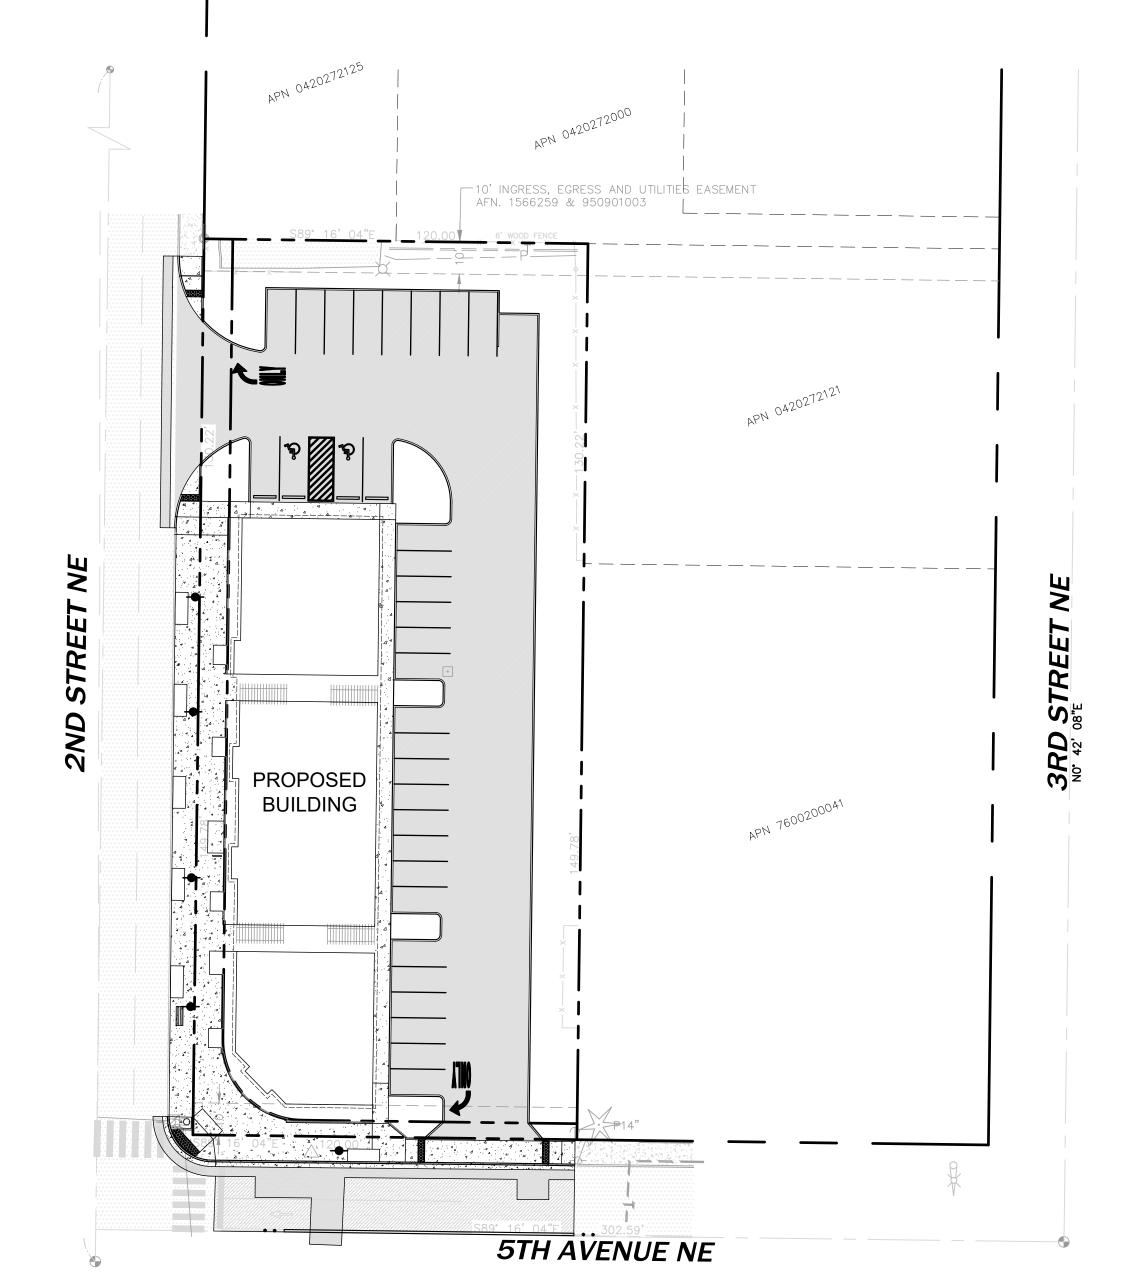

OWNER

DOCE LLC P.O.BOX 64160 TACOMA, WA 98464 CONTACT: DON HUBER

CIVIL ENGINEER

2215 NORTH 30TH STREET, SUITE 300 TACOMA, WA 98403 PH. (253) 383-2422 CONTACT: BART BRYNESTAD, PE

SURVEYOR

2215 NORTH 30TH STREET. SUITE 300 TACOMA, WA 98403 PH. (253) 383-2422 CONTACT: DAVE FOLLANSBEE, PLS

ARCHITECT

JAMES GUERRERO ARCHITECTS 7520 BRIDGEPORT WAY W LAKEWOOD, WA 98499 PH. (253) 851-6000 CONTACT: JAMES GUERRERO, AIA

TOPOGRAPHIC NOTE

THE EXISTING CULTURAL AND TOPOGRAPHIC DATA SHOWN ON THESE DRAWINGS HAS BEEN PREPARED, IN PART, BASED UPON INFORMATION FURNISHED BY OTHERS. WHILE THIS INFORMATION IS BELIEVED TO BE RELIABLE, AHBL CANNOT ENSURE ACCURACY AND THUS IS NOT RESPONSIBLE FOR THE ACCURACY OF THAT INFORMATION OR FOR ANY ERRORS OR OMISSIONS WHICH MAY HAVE BEEN INCORPORATED INTO THESE DRAWINGS AS

FILL SPECIFICATION

FILL MATERIAL SHALL NOT CONTAIN PETROLEUM PRODUCTS. OR SUBSTANCES WHICH ARE HAZARDOUS, DANGEROUS, TOXIC, OR WHICH OTHERWISE VIOLATE ANY STATE, FEDERAL, OR LOCAL LAW, ORDINANCE, CODE, REGULATION, RULE, ORDER, OR STANDARD.

TRENCH NOTE

IF WORKERS ENTER ANY TRENCH OR OTHER EXCAVATION FOUR OR MORE FEET IN DEPTH THAT DOES NOT MEET THE OPEN PIT REQUIREMENTS OF WSDOT SECTION 2-09.3(3)B, IT SHALL BE SHORED AND CRIBBED. THE CONTRACTOR ALONE SHALL BE RESPONSIBLE FOR WORKER SAFETY AND AHBL ASSUMES NO RESPONSIBILITY. ALL TRENCH SAFETY SYSTEMS SHALL MEET THE REQUIREMENTS OF THE WASHINGTON INDUSTRIAL SAFETY AND HEALTH ACT. CHAPTER 49.17 RCW.

UTILITY NOTE

THE LOCATIONS OF EXISTING UNDERGROUND UTILITIES ARE APPROXIMATE ONLY AND HAVE NOT BEEN INDEPENDENTLY VERIFIED BY THE OWNER OR ITS REPRESENTATIVE. THE CONTRACTOR SHALL DETERMINE THE EXACT LOCATION OF ALL EXISTING UTILITIES BEFORE COMMENCING WORK AND AGREES TO BE FULLY RESPONSIBLE FOR ANY AND ALL DAMAGES THAT HAPPEN DUE TO THE CONTRACTOR'S FAILURE TO LOCATE EXACTLY AND PRESERVE ANY AND ALL UNDERGROUND UTILITIES. AHBL ASSUMES NO LIABILITY FOR THE LOCATION OF UNDERGROUND UTILITIES.

UTILITIES

WATER - CITY OF PUYALLUP SANITARY SEWER - CITY OF PUYALLUP ELECTRICITY - PUGET SOUND ENERGY NATURAL GAS - PUGET SOUND ENERGY TELEPHONE - CENTURYLINK

SITE

ZONING-

SITE ADDRESS - XXX 2ND STREET NE PUYALLUP WA 98371

CBD

PARCEL -7600200051 SITE AREA -33,600 SF (0.77 ACRES)

VERTICAL DATUM NAVD 1988 VERTICAL DATUM ON

ORTHOMETRICALLY CORRECTED GPS OBSERVATION USING WSRN AND GEOID 2012A.

BASIS OF BEARING

NAD 1983

WASHINGTON STATE PLANE SOUTH PROJECTION, BASED ON GPS OBSERVATIONS USING WSRN AND GEOID 2012A. UNITS OF MEASUREMENT ARE US SURVEY FEET.

AMR NOTE

REFER TO APPROVED AMR E21-570 AND APPROVED AMR E21-0571 FOR APPROVED MODIFICATIONS TO PUYALLUP ROAD STANDARDS.

C4.0 C4.2 C4.3 C4.4

C4.6

C5.0

Sheet Number | Sheet Title

SURFACING NOTES AND DETAILS CHANNELIZATION PLAN CHANNELIZATION NOTES AND DETAILS CHANNELIZATION NOTES AND DETAILS GRADING AND DRAINAGE PLAN DRAINAGE NOTES AND DETAILS UTILITY PLAN WATER AND SEWER NOTES AND DETAILS C4.5 WATER AND SEWER NOTES AND DETAILS

> WATER AND SEWER NOTES AND DETAILS WATER AND SEWER NOTES AND DETAILS

FUTURE CONCEPTUAL INTERSECTION DESIGN

APPROVED

CITY OF PUYALLUP DEVELOPMENT ENGINEERING

NOTE: THIS APPROVAL IS VOID AFTER 180 DAYS FROM APPROVAL

THE CITY WILL NOT BE

DETERMINED BY THE

PLANS.

MANAGER.

RESPONSIBLE FOR ERRORS

AND/OR OMISSIONS ON THESE

CHANGES TO THESE PLANS AS

DEVELOPMENT ENGINEERING

FIELD CONDITIONS MAY DICTATE

2215 North 30th Street, Suite 300, Tacoma, WA 98403

253.383.2422 TEL 253.383.2572 FAX www.ahbl.com WEB

PUYALLUP 2ND STREET

APARTMENTS

SPP MANUFACTURING

P.O.BOX 64160 **TACOMA, WA 98464**

DON HUBER

2190606.10

SITE DEVELOPMENT

PERMIT SET

NUTICE
ALTERATION OF THIS DOCUMENT SHALL INVALIDATE THE PROFESSIONAL SEAL AND SIGNATURE. PUBLICATION OF THIS DOCUMENT DOES NOT DEROGATE FROM RESERVED OWNERSHIP RICHTS IN 1T. THIS DOCUMENT IS FOR USE ONLY FOR THE PROJECT IDENTIFIED IN THE TITLE BLOCK AND IS NOT TO BE USED FOR REPAIR, REMODEL OR ADDITION TO THAT PROJECT OR FOR ANY OTHER PROJECT

Project Title:

Project No.

Issue Set & Date:

Sheet No.

<u>Designed by:</u>

<u>Revisions:</u>

Sheet Title:

1 of 26 Sheets

COVER SHEET

<u>Drawn by:</u> <u>Checked by:</u>

LEGAL DESCRIPTION

(PER OLD REPUBLIC TITLE, LTD., ORDER NUMBER 5217024093-CB. EFFECTIVE DATE MAY 23, 2018, AT 8:00 A.M.):

PARCEL A:

THAT PORTION OF THE NORTHWEST QUARTER OF THE NORTHWEST QUARTER OF SECTION 27, TOWNSHIP 20 NORTH, RANGE 4 EAST, W.M., DESCRIBED AS FOLLOWS:

BEGINNING ON THE EAST BOUNDARY OF 2ND STREET N.E. IN THE CITY OF PUYALLUP, 149.78 FEET NORTH OF THE SOUTHWEST CORNER OF BLOCK 4, SHUMAN'S ADDITION TO PUYALLUP, PIERCE COUNTY, WASHINGTON, ACCORDING TO THE PLAT THEREOF, RECORDED IN VOLUME 5 OF PLATS, PAGE 99, RECORDS OF PIERCE COUNTY, WASHINGTON;

THENCE CONTINUE NORTH ON SAID BOUNDARY, 130.22 FEET; THENCE EAST PARALLEL WITH THE SOUTH LINE OF SAID BLOCK 4,

THENCE SOUTH PARALLEL WITH SAID EAST BOUNDARY OF 2ND STREET N.E., 130.22 FEET TO THE NORTH LINE OF SAID BLOCK 4; THENCE WEST 120 FEET TO THE POINT OF BEGINNING.

PARCEL B:

LOTS 1, 2 AND 3, BLOCK 4, SHUMAN'S SECOND ADDITION TO PUYALLUP, PIERCE COUNTY, WASHINGTON, ACCORDING TO THE PLAT THEREOF, RECORDED IN VOLUME 5 OF PLATS, PAGE 99, RECORDS OF PIERCE COUNTY, WASHINGTON.

BOTH SITUATE IN THE COUNTY OF PIERCE, STATE OF WASHINGTON.

U=UNKNOWN - o o COMMUNICATION LINE OHP — OVERHEAD UTILITIES FENCE **ASPHALT** CONCRETE GRAVEL

FOUND MONUMENT AS NOTED

FOUND PROPERTY CORNER

SANITARY SEWER MANHOLE

TRAFFIC SIGNAL POLE W/ LIGHT

HUB AND TACK

SIGN AS NOTED

BOLLARD

SET NAIL AND WASHER

STORM CATCH BASIN

UTILITY POWER POLE

STORM MANHOLE

GUY ANCHOR

JUNCTION BOX

FIRE HYDRANT WATER METER WATER VALVE

P=PINE

LEGEND

TESC NOTES AND DETAILS HORIZONTAL CONTROL AND SURFACING PLAN SURFACING NOTES AND DETAILS C2.3 C2.5 C3.0 C3.1 C3.2 C3.3 C3.4 C3.5

SHEET INDEX

EXISTING CONDITIONS MAP

TESC AND DEMOLITION PLAN

TESC NOTES AND DETAILS

COVER SHEET

SITE VALLEY AVE NE N LEVEE RD

GENERAL NOTES

(now what's below.

Call before you dig.

1. ALL WORK IN CITY RIGHT-OF-WAY REQUIRES A PERMIT FROM THE CITY OF PUYALLUP. PRIOR TO ANY WORK COMMENCING, THE GENERAL CONTRACTOR SHALL ARRANGE FOR A PRECONSTRUCTION MEETING AT THE DEVELOPMENT CENTER TO BE ATTENDED BY ALL MAJOR CONTRACTORS, REPRESENTATIVES OF INVOLVED UTILITIES, AND THE CITY OF PUYALLUP. CONTACT ENGINEERING SERVICES AT (253-841-5568) TO SCHEDULE THE MEETING. THE CONTRACTOR IS RESPONSIBLE TO HAVE THEIR OWN SET OF PLANS AT THE MEETING.

2. AFTER COMPLETION OF ALL ITEMS SHOWN ON THESE PLANS AND BEFORE ACCEPTANCE OF THE PROJECT THE CONTRACTOR SHALL OBTAIN A "PUNCH LIST" PREPARED BY THE CITY'S INSPECTOR DETAILING REMAINING ITEMS OF WORK TO BE COMPLETED:- ALL ITEMS OF WORK SHOWN ON THESE PLANS SHALL BE COMPLETED TO THE SATISFACTION OF THE CITY PRIOR TO ACCEPTANCE OF THE WATER SYSTEM AND PROVISION OF SANITARY SEWER SERVICE.

3. ALL MATERIALS AND WORKMANSHIP SHALL CONFORM TO THE STANDARD SPECIFICATIONS FOR ROAD, BRIDGE, AND MUNICIPAL CONSTRUCTION (HEREINAFTER REFERRED TO AS THE "STANDARD SPECIFICATIONS"), WASHINGTON STATE DEPARTMENT OF TRANSPORTATION AND AMERICAN PUBLIC WORKS ASSOCIATION WASHINGTON STATE CHAPTER, LATEST EDITION, UNLESS SUPERSEDED OR AMENDED BY THE CITY OF PUYALLUP CITY STANDARDS FOR PUBLIC WORKS ENGINEERING AND CONSTRUCTION (HEREINAFTER REFERRED TO AS THE "CITY STANDARDS").

4. A COPY OF THESE APPROVED PLANS AND APPLICABLE CITY DEVELOPER SPECIFICATIONS AND DETAILS SHALL BE ON SITE DURING CONSTRUCTION.

5. ANY REVISIONS MADE TO THESE PLANS MUST BE REVIEWED AND APPROVED BY THE DEVELOPER'S ENGINEER AND THE CITY PRIOR TO ANY IMPLEMENTATION IN THE FIELD. THE CITY SHALL NOT BE RESPONSIBLE FOR ANY ERRORS AND/OR OMISSIONS ON THESE PLANS.

6. THE CONTRACTOR SHALL HAVE ALL UTILITIES VERIFIED ON THE GROUND PRIOR TO ANY CONSTRUCTION. CALL (811) AT LEAST 48 HOURS IN ADVANCE. THE OWNER AND HIS/HER ENGINEER SHALL BE CONTACTED IMMEDIATELY IF A CONFLICT EXISTS.

7. ANY STRUCTURE AND/OR OBSTRUCTION WHICH REQUIRE REMOVAL OR RELOCATION RELATING TO THIS PROJECT SHALL BE DONE SO AT THE DEVELOPER'S EXPENSE.

8. LOCATIONS OF EXISTING UTILITIES ARE APPROXIMATE. IT SHALL BE THE CONTRACTOR'S RESPONSIBILITY TO DETERMINE THE TRUE ELEVATIONS AND LOCATIONS OF HIDDEN UTILITIES. ALL VISIBLE ITEMS SHALL BE THE ENGINEER'S RESPONSIBILITY.

9. THE CONTRACTOR SHALL INSTALL, REPLACE, OR RELOCATE ALL SIGNS, AS SHOWN ON THE PLANS OR AS AFFECTED BY CONSTRUCTION, PER CITY STANDARDS. 10.POWER, STREET LIGHT, CABLE, AND TELEPHONE LINES SHALL BE IN A TRENCH LOCATED WITHIN A

10-FOOT UTILITY EASEMENT ADJACENT TO PUBLIC RIGHT-OF-WAY. RIGHT-OF-WAY CROSSINGS SHALL HAVE

A MINIMUM HORIZONTAL SEPARATION FROM OTHER UTILITIES (SEWER, WATER, STORM) OF 5 FEET. 11. ALL CONSTRUCTION SURVEYING FOR EXTENSIONS OF PUBLIC FACILITIES SHALL BE DONE UNDER THE DIRECTION OF A WASHINGTON STATE LICENSED LAND SURVEYOR OR A WASHINGTON STATE LICENSED

PROFESSIONAL CIVIL ENGINEER. 12. DURING CONSTRUCTION, ALL PUBLIC STREETS ADJACENT TO THIS PROJECT SHALL BE KEPT CLEAN OF ALL MATERIAL DEPOSITS RESULTING FROM ON-SITE CONSTRUCTION, AND EXISTING STRUCTURES SHALL BE


PROTECTED AS DIRECTED BY THE CITY.

13. CERTIFIED RECORD DRAWINGS ARE REQUIRED PRIOR TO PROJECT ACCEPTANCE.

14. A NPDES STORMWATER GENERAL PERMIT MAY BE REQUIRED BY THE DEPARTMENT OF ECOLOGY FOR THIS PROJECT. FOR INFORMATION CONTACT THE DEPARTMENT OF ECOLOGY AT (360)407-6300.

15. ANY DISTURBANCE OR DAMAGE TO CRITICAL AREAS AND ASSOCIATED BUFFERS, OR SIGNIFICANT TREES DESIGNATED FOR PRESERVATION AND PROTECTION SHALL BE MITIGATED IN ACCORDANCE WITH A MITIGATION PLAN REVIEWED AND APPROVED BY THE CITY'S PLANNING DIVISION. PREPARATION AND IMPLEMENTATION OF THE MITIGATION PLAN SHALL BE AT THE DEVELOPER'S EXPENSE.

DATE: February 6, 2024 FILENAME: Q:\2019\2190606\10 CIV\CAD\ Final Design\2190606-SH-COVR.dwg

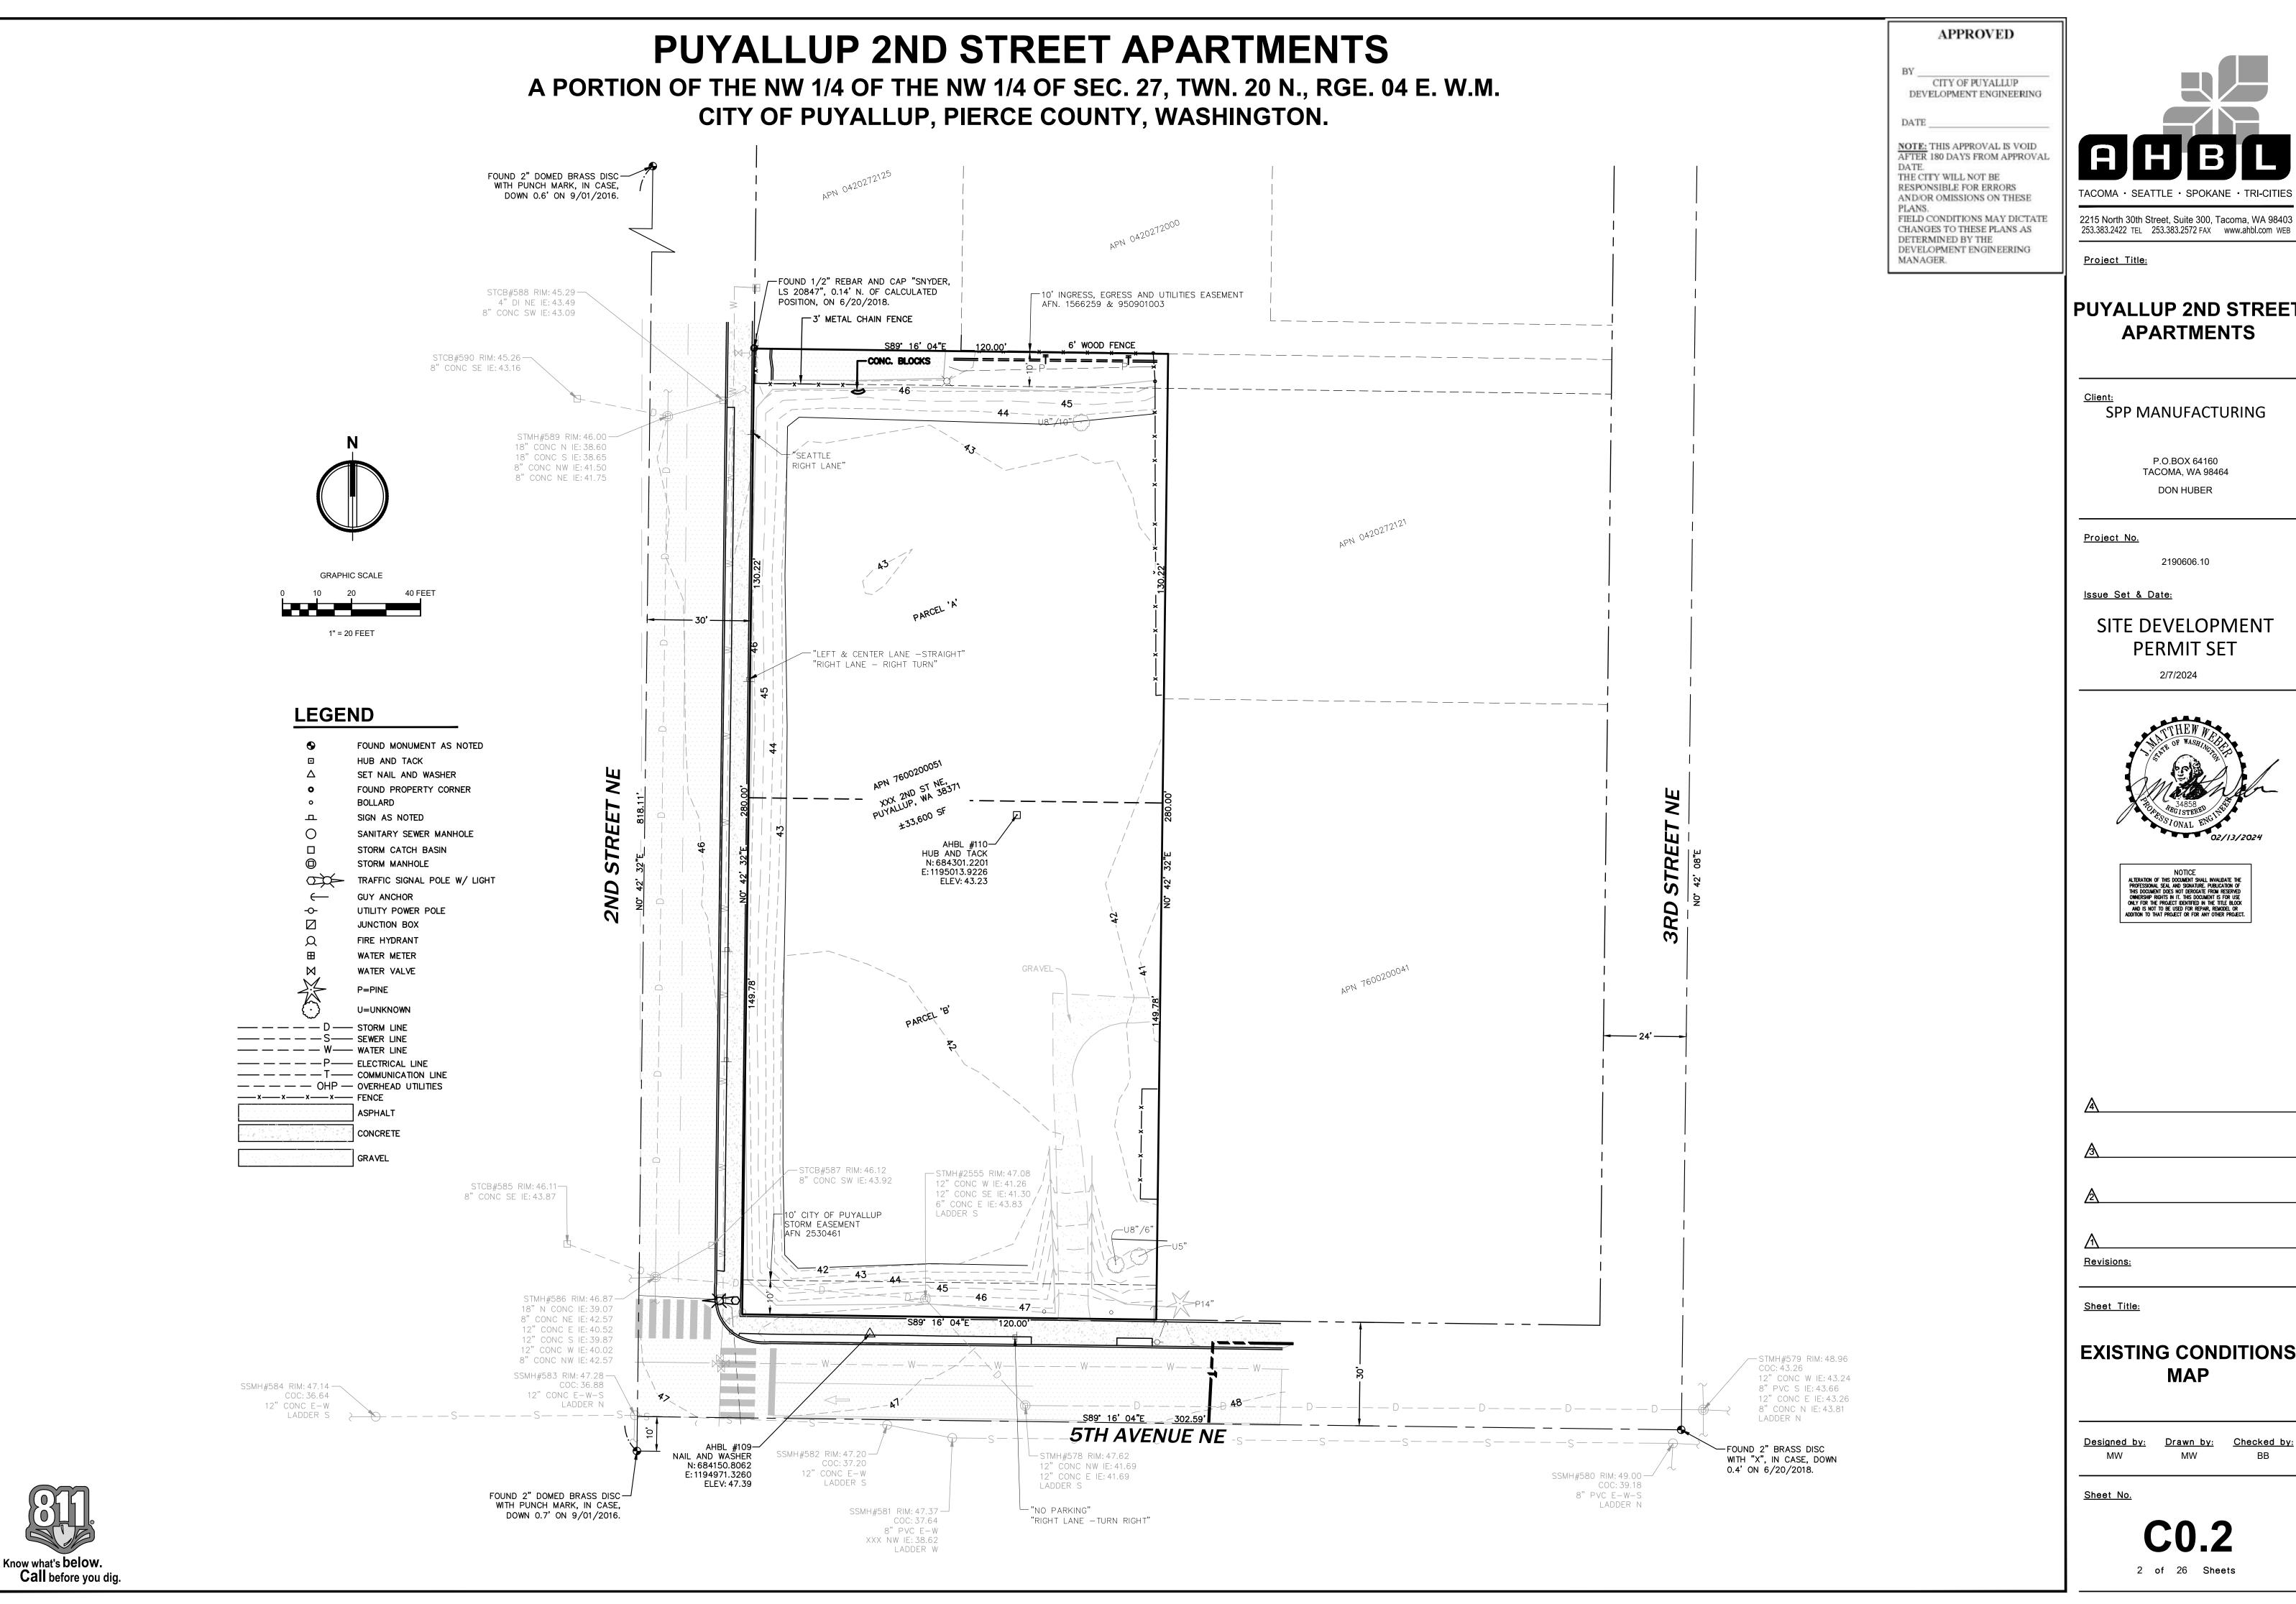



SPP MANUFACTURING

P.O.BOX 64160 TACOMA, WA 98464 DON HUBER


<u>Project No.</u>

2190606.10

Issue Set & Date:

SITE DEVELOPMENT **PERMIT SET**



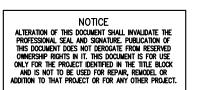

<u> </u>		

Sheet Title:

EXISTING CONDITIONS MAP

Designed by: Drawn by: Checked by:

Sheet No.

A PORTION OF THE NW 1/4 OF THE NW 1/4 OF SEC. 27, TWN. 20 N., RGE. 04 E. W.M. CITY OF PUYALLUP, PIERCE COUNTY, WASHINGTON.

- PROVIDE TEMPORARY SEDIMENT TRAP

PROTECT FUTURE INFILTRATION AREA FROM EQUIPMENT/VEHICLE COMPACTION AND SEDIMENT

REMOVE CURB AND SIDEWALK

TO NEAREST JOINT (TYP)

S89° 16' 04"E

-STMH#578 RIM: 47.62

12" CONC NW IE: 41.69

12" CONC E IE: 41.69

"RIGHT LANE -TURN RIGHT"

RETAIN FOR REUSE

REMOVE ROAD SIGN AND

LADDER S

"NO PARKING"

PRIOR TO GRADING OPERATIONS.

GRADING DAYLIGHT LINE

LADEN RUNOFF. LIMITS OF FUTURE FACILITY SHALL

BE CLEARLY MARKED FOR PROTECTION. CONFIRM PROTECTED AREA WITH ENGINEER-OF-RECORD

MIN. SURFACE AREA 404 SF

- RIPRAP 6"-8" QUARRY SPALLS

TOP BERM: 45.5 **BOTTOM ELEV: 42.5**

BOTTOM DIM. : 15' x 5'

10' INGRESS, EGRESS AND UTILITIES EASEMENT

AFN. 1566259 & 950901003

GRAVEL ~

- STMH#2555 RIM: 47.0000 12" CONC W IE: 41.26 12" CONC SE IE: 41.50 6" CONC E IE: 43.83 LADDER S

R25.0'

-3' METAL CHAIN FENCE

RIGHT^NLANE" REMOVE ROAD SIGN AND

"LEFT & CENTER LANE -STRAIGHT,

"RIGHT LANE - RIGHT TURN"

REMOVE ROAD SIGN AND

RETAIN FOR REUSE

-STCB#587 RIM: 46.12

10' CITY OF PUYALLUP

STORM EASEMENT

AFN 2530461

PROTECT EXISTING

AHBL #109-

STORM

SSMH#582 RIM: 47.20-

12" CONC E-W

LADDER S

SSMH#581 RIM: 47.37 —


XXX NW IE: 38.62

COC: 37.64 8" PVC F-W

LADDER W

8" CONC SW IE: 43.92

RETAIN FOR REUSE

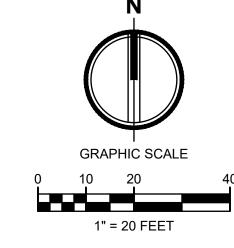

CITY OF PUYALLUP DEVELOPMENT ENGINEERING DATE

APPROVED

NOTE: THIS APPROVAL IS VOID AFTER 180 DAYS FROM APPROVA THE CITY WILL NOT BE RESPONSIBLE FOR ERRORS AND/OR OMISSIONS ON THESE

2215 North 30th Street, Suite 300, Tacoma, WA 98403 253.383.2422 TEL 253.383.2572 FAX www.ahbl.com WEB DEVELOPMENT ENGINEERING MANAGER. Project Title:

PLANS. FIELD CONDITIONS MAY DICTATE CHANGES TO THESE PLANS AS DETERMINED BY THE

CONSTRUCTION SEQUENCE

1. HOLD A PRECONSTRUCTION MEETING WITH THE CITY AND OBTAIN

- 2. STAKE OR PAINT CLEARING AND GRADING LIMITS.
- 3. PROVIDE INLET PROTECTION AS SHOWN
- 4. CONSTRUCT TEMPORARY CONSTRUCTION ENTRANCE.
- INSTALL SILT FENCE AND INFILTRATION AREA PROTECTION
- 6. INSTALL TEMPORARY SEDIMENT TRAP
- 7. SCHEDULE AN EROSION CONTROL INSPECTION WITH THE CITY.
- 8. CONSTRUCT PERMANENT STORMWATER SYSTEM AND INFILTRATION
- 9. PROVIDE COVER MEASURES (ARMORING, MULCHING, AND HYDROSEEDING) AS REQUIRED TO STABILIZE DENUDED AREAS AND PREVENT THE TRANSPORT OF SEDIMENT-LADEN STORMWATER OFF-SITE.
- 10. THE CONTRACTOR SHALL INSPECT THE EROSION CONTROL MEASURES A MINIMUM OF ONCE WEEKLY AND AFTER EVERY STORM EVENT THAT PRODUCES RUNOFF FROM THE SITE. THE CONTRACTOR SHALL REPAIR OR ADD EROSION CONTROL MEASURES AS REQUIRED
- 11. COVER ALL AREAS THAT WILL BE UNWORKED FOR MORE THAN SEVEN DAYS DURING THE DRY SEASON OR TWO DAYS DURING THE WET SEASON WITH STRAW, WOOD FIBER MULCH, COMPOST, PLASTIC SHEETING OR EQUIVALENT
- 12. AFTER SITE HAS BEEN PERMANENTLY STABILIZED, REMOVE SEDIMENT FROM STORM PIPES AND CATCH BASIN SUMPS.
- 13. COORDINATE WITH THE CITY OF PUYALLUP AND ENGINEER FOR FINAL
- 14. REMOVE REMAINING TEMPORARY EROSION CONTROL DEVICES
- WHEN AREA HAS BEEN PERMANENTLY STABILIZED WITH VEGETATION OR SURFACING, AND REMOVAL IS APPROVED BY THE ENGINEER AND THE CITY OF PUYALLUP.

LEGEND

(CE) CONSTRUCTION ENTRANCE ASPHALT TO BE REMOVED CONCRETE TO BE REMOVED (CL) CLEARING/PROJECT LIMITS

(SL) SAWCUT LINE (ID) INTERCEPTOR DITCH

INLET SEDIMENT PROTECTION ROCK CHECK DAM

SILTATION FENCE

TREE TO BE REMOVED TREE TO REMAIN

EXISTING MAJOR CONTOUR EXISTING MINOR CONTOUR

EXISTING CATCH BASIN

RESPONSIBILITY OF THE PERMITTEE.

COURSES, AND/OR STORM DRAINAGE SYSTEMS.

PROPOSED MAJOR CONTOUR PROPOSED MINOR CONTOUR **EXISTING STORM MANHOLE**

Issue Set & Date: — —×××— —

Project No.

SITE DEVELOPMENT **PERMIT SET**

2/7/2024

PUYALLUP 2ND STREET

APARTMENTS

SPP MANUFACTURING


P.O.BOX 64160

TACOMA, WA 98464

DON HUBER

2190606.10



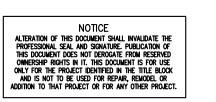

GRADING, EROSION & SEDIMENTATION CONTROL NOTES: 1. ALL WORK IN CITY RIGHT-OF-WAY REQUIRES A PERMIT FROM THE CITY OF PUYALLUP. PRIOR TO ANY WORK COMMENCING. THE GENERAL CONTRACTOR SHALL ARRANGE FOR A PRECONSTRUCTION MEETING AT CITY HALL TO BE ATTENDED BY ALL MAJOR CONTRACTORS, REPRESENTATIVES OF INVOLVED UTILITIES AND THE CITY OF PUYALLUP. CONTACT THE ENGINEERING DIVISION AT THE CITY OF PUYALLUP TO SCHEDULE THE MEETING (253-864-4165). THE CONTRACTOR IS RESPONSIBLE TO HAVE HIS SET OF PLANS AT THE MEETING.

2. AFTER COMPLETION OF ALL ITEMS SHOWN ON THESE PLANS AND BEFORE ACCEPTANCE OF THE PROJECT, THE CONTRACTOR SHALL OBTAIN A "PUNCH LIST" PREPARED BY THE CITY'S INSPECTOR DETAILING REMAINING ITEMS OF WORK TO BE COMPLETED. ALL ITEMS OF WORK SHOWN ON THESE PLANS SHALL BE COMPLETED TO THE SATISFACTION OF THE CITY PRIOR TO ACCEPTANCE OF THE WATER SYSTEM AND PROVISION OF SANITARY SEWER SERVICE.

3. ALL MATERIALS AND WORKMANSHIP SHALL CONFORM TO THE STANDARD SPECIFICATIONS FOR ROAD, BRIDGE, AND MUNICIPAL CONSTRUCTION (HEREINAFTER REFERRED TO AS THE "STANDARD SPECIFICATIONS"), WASHINGTON STATE DEPARTMENT OF TRANSPORTATION AND AMERICAN PUBLIC WORKS ASSOCIATION, WASHINGTON STATE CHAPTER, LATEST EDITION, UNLESS SUPERSEDED OR AMENDED BY THE CITY OF PUYALLUP CITY STANDARDS FOR PUBLIC WORKS ENGINEERING AND CONSTRUCTION (HEREINAFTER REFERRED TO AS THE "CITY STANDARDS").

4. A COPY OF THESE APPROVED PLANS AND APPLICABLE CITY DEVELOPER SPECIFICATIONS AND DETAILS SHALL BE ON SITE DURING CONSTRUCTION.

5. ANY REVISIONS MADE TO THESE PLANS MUST BE REVIEWED AND APPROVED BY THE DEVELOPER'S ENGINEER AND THE CITY ENGINEER PRIOR TO ANY IMPLEMENTATION IN THE FIELD. THE CITY SHALL NOT BE RESPONSIBLE FOR ANY ERRORS AND/OR OMISSIONS ON THESE PLANS.

6. THE CONTRACTOR SHALL HAVE ALL UTILITIES VERIFIED ON THE GROUND PRIOR TO ANY CONSTRUCTION. CALL (1-800-424-5555) AT LEAST 48 HOURS IN ADVANCE. THE OWNER AND HIS ENGINEER SHALL BE CONTACTED IMMEDIATELY IF A CONFLICT EXISTS.

7. ALL LIMITS OF CLEARING AND AREAS OF VEGETATION PRESERVATION AS PRESCRIBED ON THE PLANS SHALL BE CLEARLY FLAGGED IN THE FIELD AND OBSERVED DURING CONSTRUCTION.

EROSION AND SEDIMENTATION CONTROL ONLY. IT DOES NOT CONSTITUTE AN APPROVAL OF PERMANENT STORM DRAINAGE DESIGN, SIZE OR LOCATION OF PIPES, RESTRICTORS, CHANNELS, OR RETENTION FACILITIES. 11. ANY DISTURBED AREA WHICH HAS BEEN STRIPPED OF VEGETATION AND WHERE NO FURTHER WORK IS ANTICIPATED FOR A PERIOD OF 30 DAYS OR MORE, MUST BE IMMEDIATELY STABILIZED WITH MULCHING, GRASS PLANTING, OR OTHER APPROVED EROSION CONTROL TREATMENT APPLICABLE TO THE TIME OF YEAR IN QUESTION. GRASS SEEDING ALONE WILL BE ACCEPTABLE ONLY DURING THE MONTHS OF APRIL THROUGH SEPTEMBER INCLUSIVE. SEEDING MAY PROCEED OUTSIDE THE SPECIFIED TIME PERIOD WHENEVER IT IS IN THE INTEREST OF THE PERMITTEE BUT MUST BE AUGMENTED WITH MULCHING, NETTING, OR OTHER TREATMENT APPROVED BY THE CITY.

8. ALL REQUIRED SEDIMENTATION AND EROSION CONTROL FACILITIES MUST BE

OTHER CONSTRUCTION TO ENSURE THAT SEDIMENT LADEN WATER DOES NOT

ENTER THE NATURAL DRAINAGE SYSTEM. THE CONTRACTOR SHALL SCHEDULE

CONSTRUCTION IS COMPLETED AND THE POTENTIAL FOR ON-SITE EROSION HAS

PASSED. THE IMPLEMENTATION. MAINTENANCE, REPLACEMENT, AND ADDITIONS

9. THE EROSION AND SEDIMENTATION CONTROL SYSTEM FACILITIES DEPICTED

NECESSARY TO ENSURE COMPLETE SILTATION CONTROL ON THE SITE. DURING

RESPONSIBILITY OF THE PERMITTEE TO ADDRESS ANY NEW CONDITIONS THAT

MAY BE CREATED BY HIS ACTIVITIES AND TO PROVIDE ADDITIONAL FACILITIES.

OVER AND ABOVE THE MINIMUM REQUIREMENTS, AS MAY BE NEEDED TO

10. APPROVAL OF THESE PLANS IS FOR GRADING, TEMPORARY DRAINAGE,

PROTECT ADJACENT PROPERTIES, SENSITIVE AREAS, NATURAL WATER

ON THESE PLANS ARE INTENDED TO BE MINIMUM REQUIREMENTS TO MEET

ANTICIPATED SITE CONDITIONS. AS CONSTRUCTION PROGRESSES AND

UNEXPECTED OR SEASONAL CONDITIONS DICTATE, FACILITIES WILL BE

THE COURSE OF CONSTRUCTION, IT SHALL BE THE OBLIGATION AND

CONSTRUCTED AND IN OPERATION PRIOR TO ANY LAND CLEARING AND/OR

AN INSPECTION OF THE EROSION CONTROL FACILITIES PRIOR TO ANY LAND

CLEARING AND/OR OTHER CONSTRUCTION. ALL EROSION AND SEDIMENT

TO THE EROSION AND SEDIMENTATION CONTROL SYSTEMS SHALL BE THE

FACILITIES SHALL BE MAINTAINED IN A SATISFACTORY CONDITION AS DETERMINED BY THE CITY, UNTIL SUCH TIME THAT CLEARING AND/OR


12. IN CASE EROSION OR SEDIMENTATION OCCURS TO ADJACENT PROPERTIES, ALL CONSTRUCTION WORK WITHIN THE DEVELOPMENT THAT WILL FURTHER AGGRAVATE THE SITUATION MUST CEASE, AND THE OWNER/CONTRACTOR WILL IMMEDIATELY COMMENCE RESTORATION METHODS. RESTORATION ACTIVITY WILL CONTINUE UNTIL SUCH TIME AS THE AFFECTED PROPERTY OWNER IS SATISFIED.

13. NO TEMPORARY OR PERMANENT STOCKPILING OF MATERIALS OR EQUIPMENT SHALL OCCUR WITHIN CRITICAL AREAS OR ASSOCIATED BUFFERS OR THE CRITICAL ROOT ZONE FOR VEGETATION PROPOSED FOR RETENTION.

14. AT ANY TIME DURING CONSTRUCTION IT IS DETERMINED BY THE CITY THAT MUD AND DEBRIS ARE BEING TRACKED ONTO PUBLIC STREETS WITH INSUFFICIENT CLEANUP, ALL WORK SHALL CEASE ON THE PROJECT UNTIL THIS CONDITION IS CORRECTED. THE CONTRACTOR AND/OR THE OWNER SHALL IMMEDIATELY TAKE ALL STEPS NECESSARY TO PREVENT FUTURE TRACKING OF MUD AND DEBRIS INTO THE PUBLIC ROW, WHICH MAY INCLUDE THE INSTALLATION OF A WHEEL WASH FACILITY ON-SITE.

15. CONTRACTOR SHALL DESINGATE A WASHINGTON DEPARTMENT OF ECOLOGY CERTIFIED EROSION AND SEDIMENT CONTROL LEAD PERSON, AND SHALL COMPLY WITH THE STORMWATER POLLUTION PREVENTION PLAN (SWPPP) PREPARED FOR THEIR PROJECT

16. SEDIMENT-LADEN RUNOFF SHALL NOT BE ALLOWED TO DISCHARGE BEYOND THE CONSTRUCTION LIMITS IN ACCORDANCE WITH THE PROJECT'S NPDES GENERAL STORMWATER PERMIT.

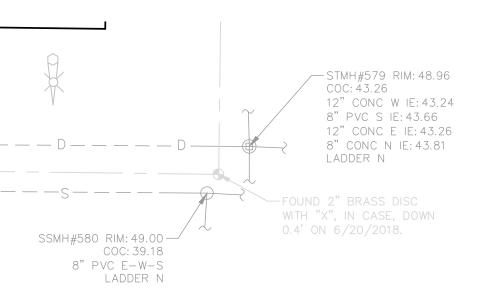

<u>Revisions:</u>

Sheet Title:

TESC AND DEMOLITION

MW

Sheet No.

3 of 26 Sheets

DATE: February 7, 2024 FILENAME: Q:\2019\2190606\10 CIV\CAD\ Final Design\2190606-SH-TESC.dwg

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emoved, should be

onstruction C 1.0 SH

Callouts added to display the

signs throughout construction

splayed during

SMH#584 RIM: 47.14 —

12" CONC E-W

(now what's below.

Call before you dig.

COC: 36.64

LADDER S

REMOVE CURB AND SIDEWALK

STMH#589 RIM: 46.00

8" CONC NW IE: 41.50

8" CONC NE IE: 41.75

REMOVE BUS STOP

SIGN AND RETAIN/FOR

REMOVE ROAD SIGN .

STCB#585 RIM: 46.11-

8" CONC SE IE: 43.87

AND RE/TAIN FOR

STMH#586 RIM: 46.87 -

18" N CONC IE: 39.07

8" CONC NE IE: 42.57

12" CONC E IE: 40.52

12" CONC S IE: 39.87

12" CONC W IE: 40.02

8" CONC NW IE: 42.57

SSMH#583 RIM: 47.28 —

12" CONC E-W-S

COC: 36.88

LADDER N

REUSE

SAWCUT

BACK OF

CURB

18" CONC N IE: 38.60 18" CONC S IE: 38.65

STCB#588 RIM: 45.29 -

8" CONC SW IE: 43.09

STCB#590 RIM: 45.26 —


8" CONC SE IE: 43.16

4" DI NE IE: 43.49

TO NEAREST JOINT

<u>Drawn by:</u> <u>Checked by:</u> MW

A PORTION OF THE NW 1/4 OF THE NW 1/4 OF SEC. 27, TWN. 20 N., RGE. 04 E. W.M. CITY OF PUYALLUP, PIERCE COUNTY, WASHINGTON.

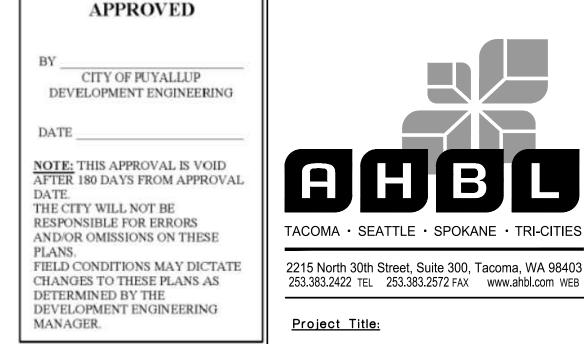

PUYALLUP 2ND STREET

APARTMENTS

SPP MANUFACTURING

P.O.BOX 64160

TACOMA, WA 98464

DON HUBER

2190606.10


SITE DEVELOPMENT

PERMIT SET

2/7/2024

Project No.

Issue Set & Date:

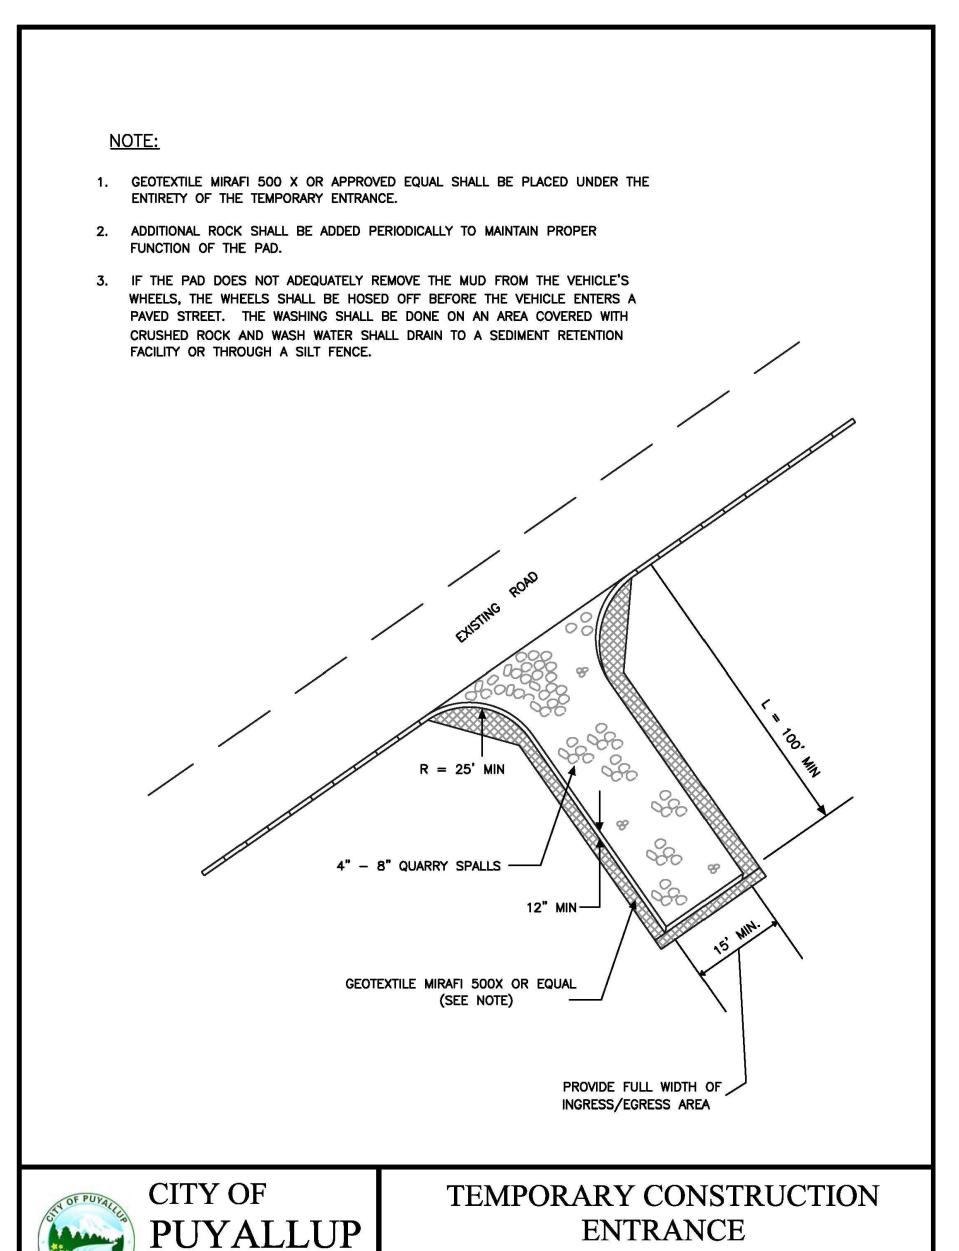

DRAWN BY JIM ERWIN-SVOBODA

TEMPORARY CONSTRUCTION ENTRANCE

CHECKED BY LINDA LIAN

TLE NAME

!\DWG\COMMON\STDS\CITY\2009\05_GRD\05.01\05.01.01

1. ALL LIMITS OF CLEARING AND AREAS OF VEGETATION PRESERVATION AS PRESCRIBED ON THE PLANS SHALL BE CLEARLY FLAGGED IN THE FIELD AND OBSERVED DURING CONSTRUCTION. 2. ALL REQUIRED SEDIMENTATION AND EROSION CONTROL FACILITIES MUST BE CONSTRUCTED AND IN OPERATION PRIOR TO ANY LAND CLEARING AND/OR OTHER CONSTRUCTION TO ENSURE THAT SEDIMENT LADEN WATER DOES NOT ENTER THE NATURAL DRAINAGE SYSTEM. THE CONTRACTOR SHALL SCHEDULE AN INSPECTION OF THE EROSION CONTROL FACILITIES PRIOR TO ANY LAND CLEARING AND/OR CONSTRUCTION. ALL EROSION AND SEDIMENT FACILITIES SHALL BE MAINTAINED IN A SATISFACTORY CONDITION AS DETERMINED

BY THE CITY, UNTIL SUCH TIME THAT CLEARING AND/OR CONSTRUCTION IS COMPLETED AND THE POTENTIAL FOR ON-SITE EROSION

HAS PASSED. THE IMPLEMENTATION, MAINTENANCE, REPLACEMENT, AND ADDITIONS TO THE EROSION AND SEDIMENTATION CONTROL

3. THE EROSION AND SEDIMENTATION CONTROL SYSTEM FACILITIES DEPICTED ON THESE PLANS ARE INTENDED TO BE MINIMUM REQUIREMENTS TO MEET ANTICIPATED SITE CONDITIONS. AS CONSTRUCTION PROGRESSES AND UNEXPECTED OR SEASONAL CONDITIONS DICTATE, FACILITIES WILL BE NECESSARY TO ENSURE COMPLETE SILTATION CONTROL ON THE SITE. DURING THE COURSE OF CONSTRUCTION, IT SHALL BE THE OBLIGATION AND RESPONSIBILITY OF THE PERMITEE TO ADDRESS ANY NEW CONDITIONS THAT MAY BE CREATED BY HIS ACTIVITIES AND TO PROVIDE ADDITIONAL FACILITIES, OVER AND ABOVE THE MINIMUM REQUIREMENTS, AS MAY BE


4. APPROVAL OF THESE PLANS IS FOR GRADING, TEMPORARY DRAINAGE, EROSION AND SEDIMENTATION CONTROL ONLY. IT DOES NOT CONSTITUTE AN APPROVAL OF PERMANENT STORM DRAINAGE DESIGN, SIZE OR LOCATION OF PIPES, RESTRICTORS, CHANNELS, OR RETENTION FACILITIES.

NEEDED TO PROTECT ADJACENT PROPERTIES, SENSITIVE AREAS, NATURAL WATER COURSES, AND/OR STORM DRAINAGE SYSTEMS.

5. ANY DISTURBED AREA WHICH HAS BEEN STRIPPED OF VEGETATION AND WHERE NO FURTHER WORK IS ANTICIPATED FOR A PERIOD OF 30 DAYS OR MORE, MUST BE IMMEDIATELY STABILIZED WITH MULCHING, GRASS PLANTING, OR OTHER APPROVED EROSION CONTROL TREATMENT APPLICABLE TO THE TIME OF YEAR IN QUESTION. GRASS SEEDING ALONE WILL BE ACCEPTABLE ONLY DURING IS IN THE INTEREST OF THE PERMITEE BUT MUST BE AUGMENTED WITH MULCHING, NETTING, OR OTHER TREATMENT APPROVED BY THE

6. IN CASE EROSION OR SEDIMENTATION OCCURS TO ADJACENT PROPERTIES, ALL CONSTRUCTION WORK WITHIN THE DEVELOPMENT THAT WILL FURTHER AGGRAVATE THE SITUATION MUST CEASE, AND THE OWNER/CONTRACTOR WILL IMMEDIATELY COMMENCE RESTORATION METHODS. RESTORATION ACTIVITY WILL CONTINUE UNTIL SUCH TIME AS THE AFFECTED PROPERTY OWNER IS SATISFIED.

7. NO TEMPORARY OR PERMANENT STOCKPILING OF MATERIALS OR EQUIPMENT SHALL OCCUR WITHIN CRITICAL AREAS OR ASSOCIATED BUFFERS, OR THE CRITICAL ROOT ZONE FOR VEGETATION PROPOSED FOR RETENTION.

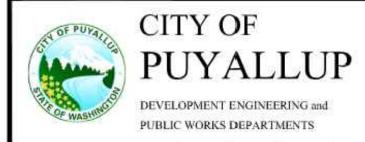

CITY STANDARD


SCALE 1:40 05.01.01

SYSTEMS SHALL BE THE RESPONSIBILITY OF THE PERMITEE.

GRADING, EROSION, AND SEDIMENTATION CONTROL NOTES

GRADING AND T.E.S.C. NOTES

05.02.01

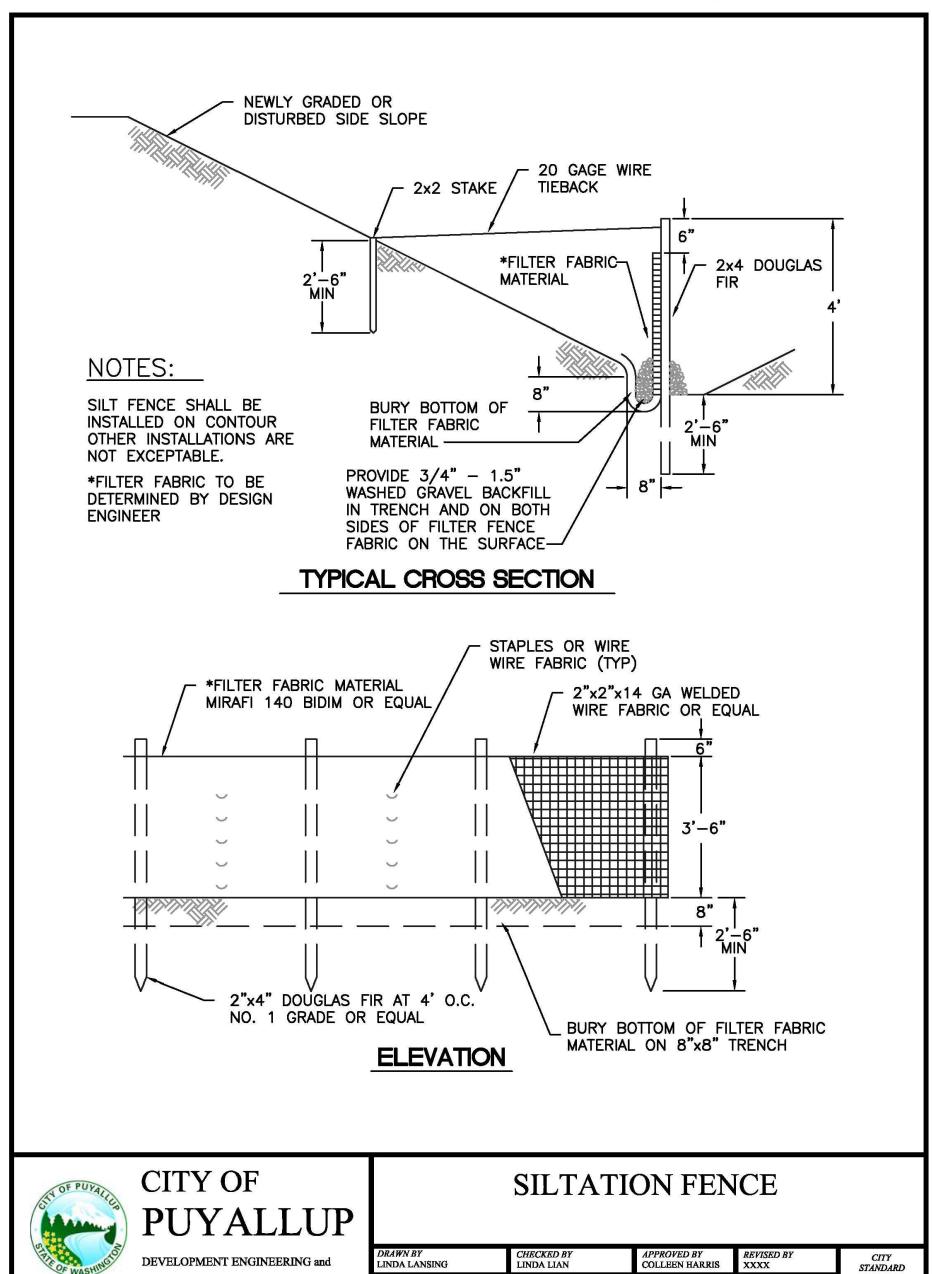

FILE NAME
F:\DWG\COMMON\STDS\CITY\2009\02 SD\02.03.02

SILTATION FENCE

DEVELOPMENT ENGINEERING and

PUBLIC WORKS DEPARTMENTS



TESC NOTES AND DETAILS

Designed by: Drawn by: Checked by:

Revisions:

Sheet Title:

02.03.02

Sheet No.

4 of 26 Sheets

DEVELOPMENT ENGINEERING and

PUBLIC WORKS DEPARTMENTS

A PORTION OF THE NW 1/4 OF THE NW 1/4 OF SEC. 27, TWN. 20 N., RGE. 04 E. W.M. CITY OF PUYALLUP, PIERCE COUNTY, WASHINGTON.

CITY OF PUYALLUP
DEVELOPMENT ENGINEERING

DATE

NOTE: THIS APPROVAL IS VOID
AFTER 180 DAYS FROM APPROVAL
DATE
THE CITY WILL NOT BE
RESPONSIBLE FOR ERRORS
AND/OR OMISSIONS ON THESE
PLANS.
FIELD CONDITIONS MAY DICTATE
CHANGES TO THESE PLANS AS
DETERMINED BY THE
DEVELOPMENT ENGINEERING

MANAGER.

APPROVED



PUYALLUP 2ND STREET APARTMENTS

SPP MANUFACTURING

Project Title:

P.O.BOX 64160 TACOMA, WA 98464 DON HUBER

<u>Project No.</u>


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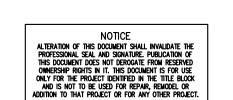
Issue Set & Date:

SITE DEVELOPMENT

PERMIT SET

2/7/2024



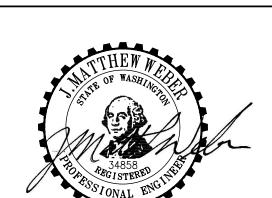

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Revisions:

Sheet Title:

TESC NOTES AND DETAILS

Designed by:Drawn by:Checked by:MWMWBB

Sheet No.

C1.2

ADAPTER SKIRT
(FOR A PERFECT FIT)

RETRIEVAL STRAP


36"

OVERFLOW
(TO BYPASS PEAK STORM VOLUMES)

24"

EXISTING CATCH BASIN

PROVIDE CATCH BASIN SEDIMENT PROTECTION WITH STREAMGUARD BASIN INSERT #3003, FROM BOW HEAD ENVIRONMENTAL OR EQUIVALENT. P.O. BOX 375 PRESTON, WA 98050 PHONE: 1-800-909-3677

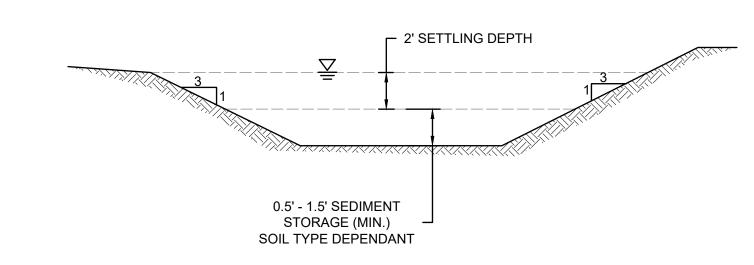

SEDIMENT TRAP

1 INLET PROTECTION
NOT TO SCALE

CHECK DAM SPACING

SPACING (FT

100

50

25 20

15


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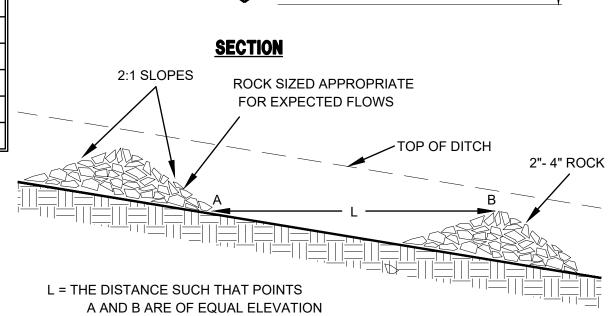
DITCH SLOPE CHECK DAM

10

20





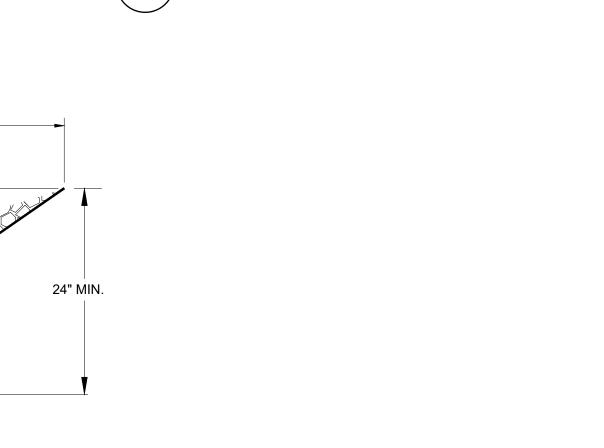

CHECK DAM NOTES:


THE MAXIMUM SPACING BETWEEN THE DAMS SHALL BE SUCH THAT THE TOE OF THE UPSTREAM DAM IS AT THE SAME ELEVATION AS THE TOP OF THE DOWNSTREAM DAM.

ROCK MUST COMPLETELY COVER THE BOTTOM AND SIDES OF THE DITCH

- 2. ROCK CHECK DAMS SHALL BE CONSTRUCTED OF 2- TO 4- INCH DIAMETER QUARRY SPALLS. THE QUARRY SPALLS MUST BE PLACED BY HAND OR MECHANICAL PLACEMENT (NO DUMPING OF SPALLS TO FORM DAM) TO ACHIEVE COMPLETE COVERAGE OF THE DITCH OR SWALE AND TO INSURE THAT THE CENTER OF THE DAM IS LOWER THAN THE EDGES.
- 3. LOG CHECK DAMS SHALL BE CONSTRUCTED OF 4- TO 6- INCH DIAMETER LOGS. THE LOGS SHALL BE EMBEDDED INTO THE SOIL AT LEAST 18 INCHES.
- 4. IN THE CASE OF GRASS-LINED DITCHES AND SWALES, CHECK DAMS SHALL BE REMOVED WHEN THE GRASS HAS MATURED SUFFICIENTLY TO PROTECT THE DITCH OR SWALE. THE AREA BENEATH THE CHECK DAMS SHALL BE SEEDED AND MULCHED IMMEDIATELY AFTER DAM REMOVAL.
- 5. CHECK DAMS SHALL BE CHECKED FOR SEDIMENT ACCUMULATION AFTER EACH SIGNIFICANT RAINFALL. SEDIMENT SHALL BE REMOVED WHEN IT REACHES ONE HALF OF THE ORIGINAL DAM HEIGHT OR BEFORE.





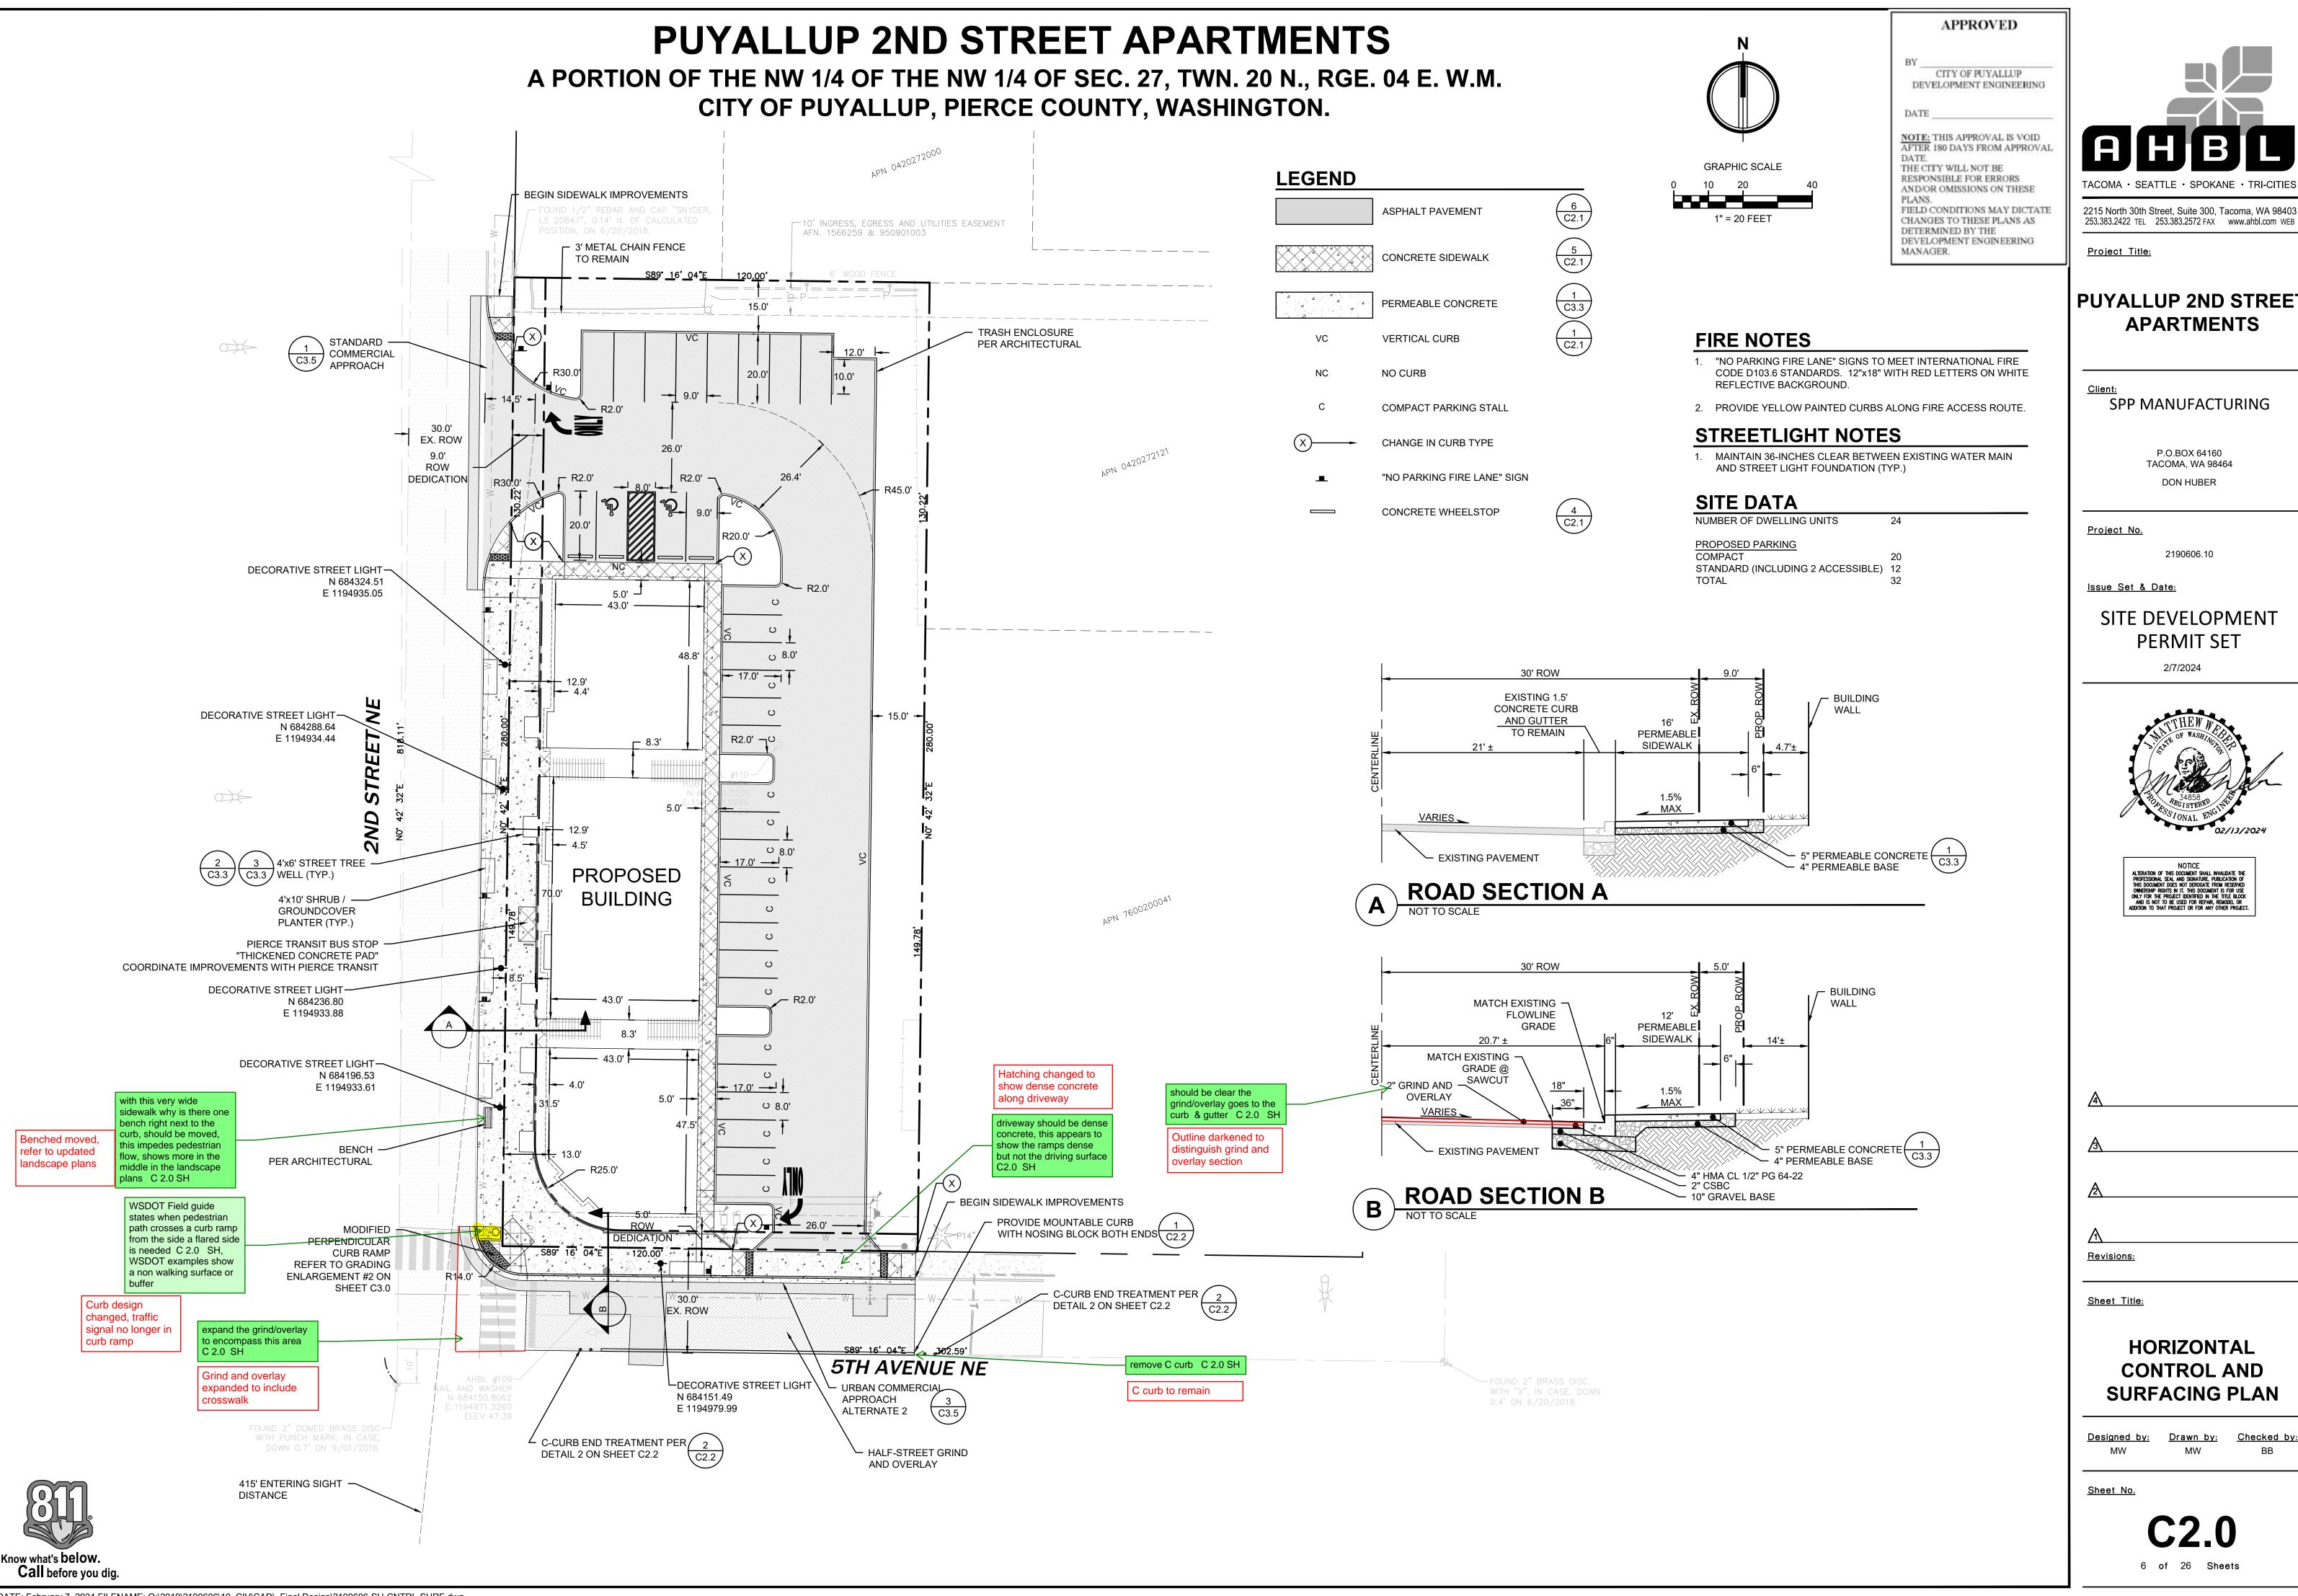



Project Title:

SPP MANUFACTURING

P.O.BOX 64160 **TACOMA**, WA 98464 DON HUBER

<u>Project No.</u>


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Issue Set & Date:

SITE DEVELOPMENT **PERMIT SET**

2/7/2024



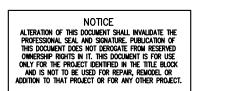

Revisions:


Sheet Title:

HORIZONTAL CONTROL AND SURFACING PLAN

Designed by: Drawn by: Checked by: MW

Sheet No.

A PORTION OF THE NW 1/4 OF THE NW 1/4 OF SEC. 27, TWN. 20 N., RGE. 04 E. W.M. CITY OF PUYALLUP, PIERCE COUNTY, WASHINGTON.

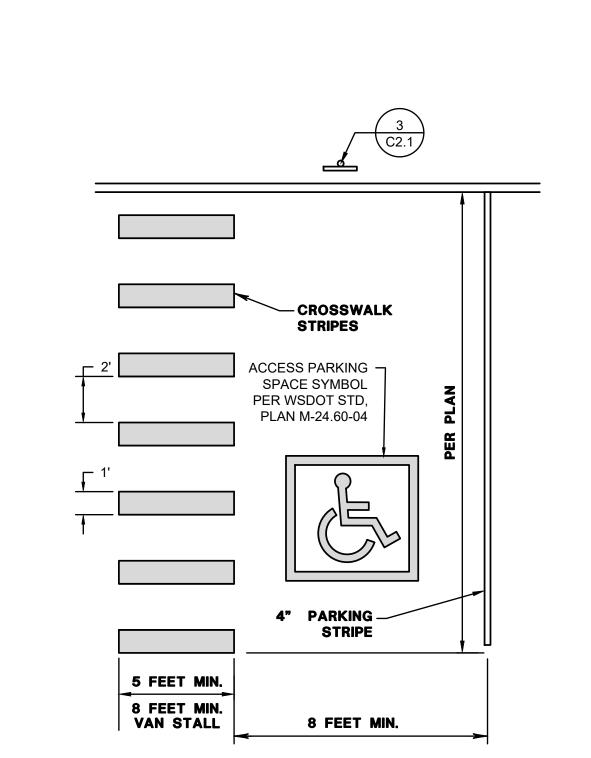

ACCESSIBLE PARKING
NOT TO SCALE





1. PROVIDE VAN ACCESSIBLE STALL SIGN ON STALLS IDENTIFIED AS

2. PLACE NO PARKING SIGN 12 INCHES BEHIND CURB AT OUTSIDE

3. PROVIDE NO PARKING SIGN ON STALL POST IF AISLE LEADS TO

ACCESSIBLE SIGNAGE

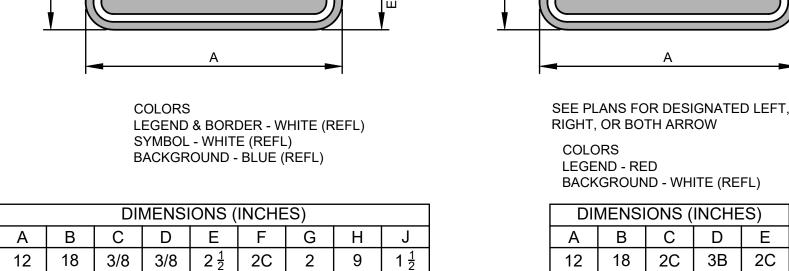


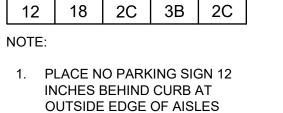


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11/97

TIME:



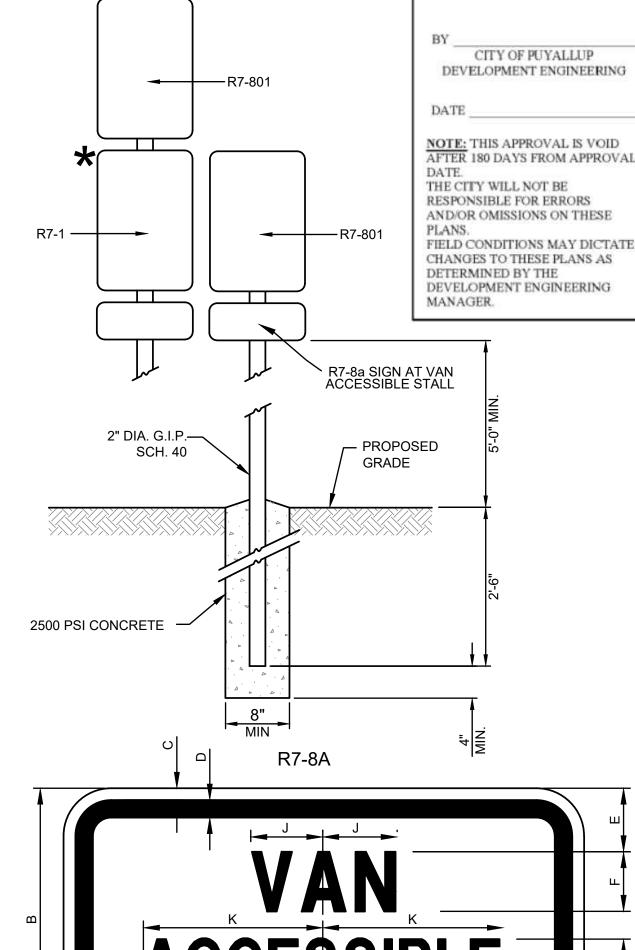
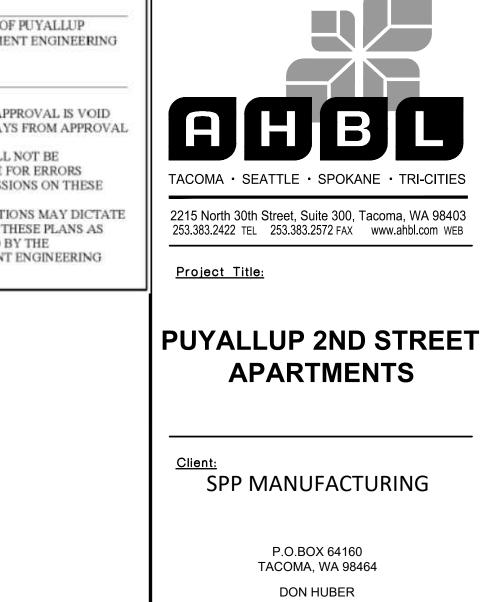
<u>Project No.</u>


APPROVED


Issue Set & Date: SITE DEVELOPMENT **PERMIT SET**

2190606.10

2/7/2024



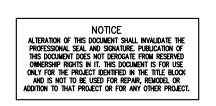


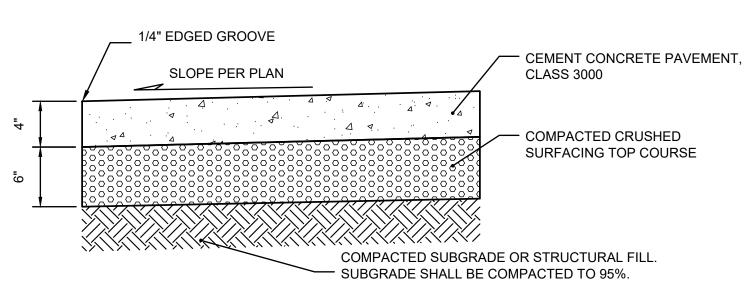

EXPANSION JOINT NOTES:

- 1. EXPANSION JOINTS CONSISTING OF 3/16" BY 2" PREMOLDED JOINT MATERIAL SHALL BE PLACED AT 15 FOOT INTERVALS.
- 2. CONTRACTION JOINTS SHALL INSTALLED EVERY 5'. EXPANSION JOINTS SHALL BE PLACED AT EVERY THIRD JOINT. ALL JOINTS SHALL BE CLEAN AND EDGED WITH AN EDGE HAVING 1/4" RADIUS. JOINTS SHALL BE FLUSH WITH THE FINISHED SURFACE.
- 3. PREMOLDED JOINT FILLER SHALL BE PER THE SPECIFICATIONS AT 21 FOOT MAX SPACING
- 4. FORMS SHALL BE EITHER WOOD OR STEEL
- 5. CONCRETE SIDEWALK SHALL HAVE A MINIMUM COMPRESSIVE STRENGTH OF 3,000 PSI @ 28 DAYS.
- 6. A BROOMED FINISH SHALL BE PROVIDED IN TRANSVERSE DIRECTION UNLESS OTHERWISE INDICATED.




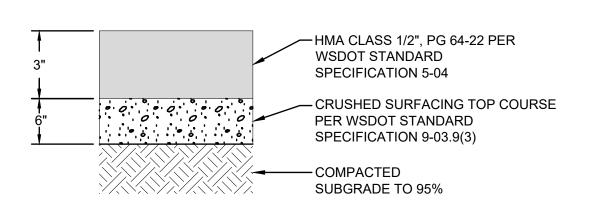

NOTE:

1. ALL DEPTHS SHOWN ARE COMPACTED DEPTHS. 2. RECOMPACT EXISTING STRUCTURAL FILL.

6 PAVEMENT SECTION
NOT TO SCALE

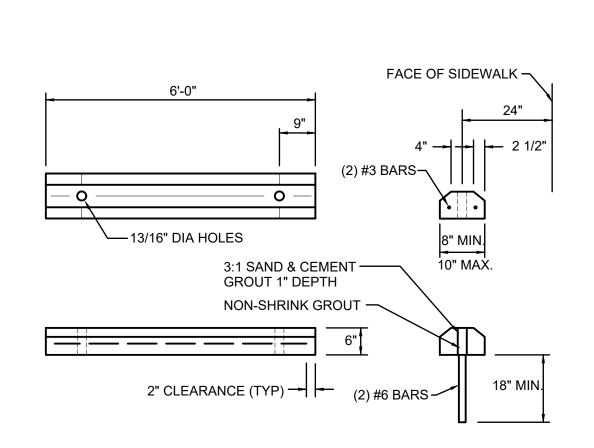

FACE OF CURB

CEMENT CONCRETE,

3000 PSI

8 1/4"

VERTICAL CURB

NOT TO SCALE



Know what's below. Call before you dig.

Sheet No. 7 of 26 Sheets


SURFACING NOTES

AND DETAILS


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Revisions:


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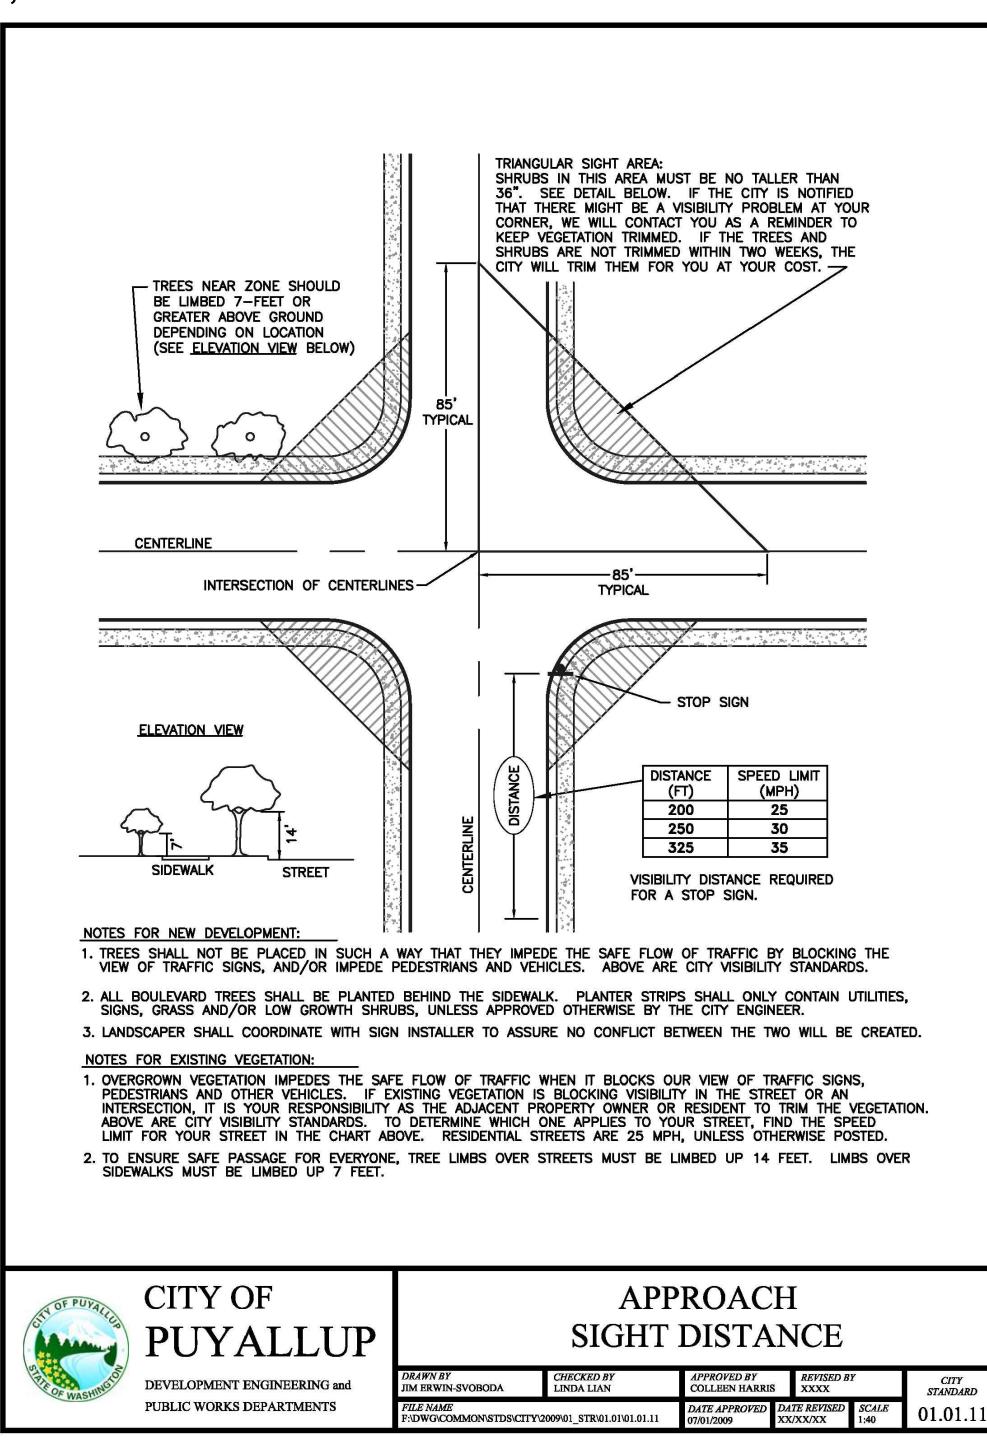


A PORTION OF THE NW 1/4 OF THE NW 1/4 OF SEC. 27, TWN. 20 N., RGE. 04 E. W.M. CITY OF PUYALLUP, PIERCE COUNTY, WASHINGTON.

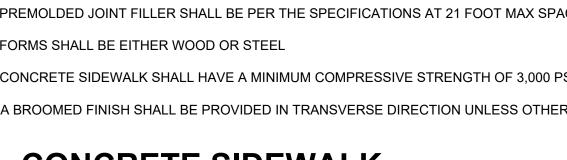

WSDOT MOUNTABLE CURB

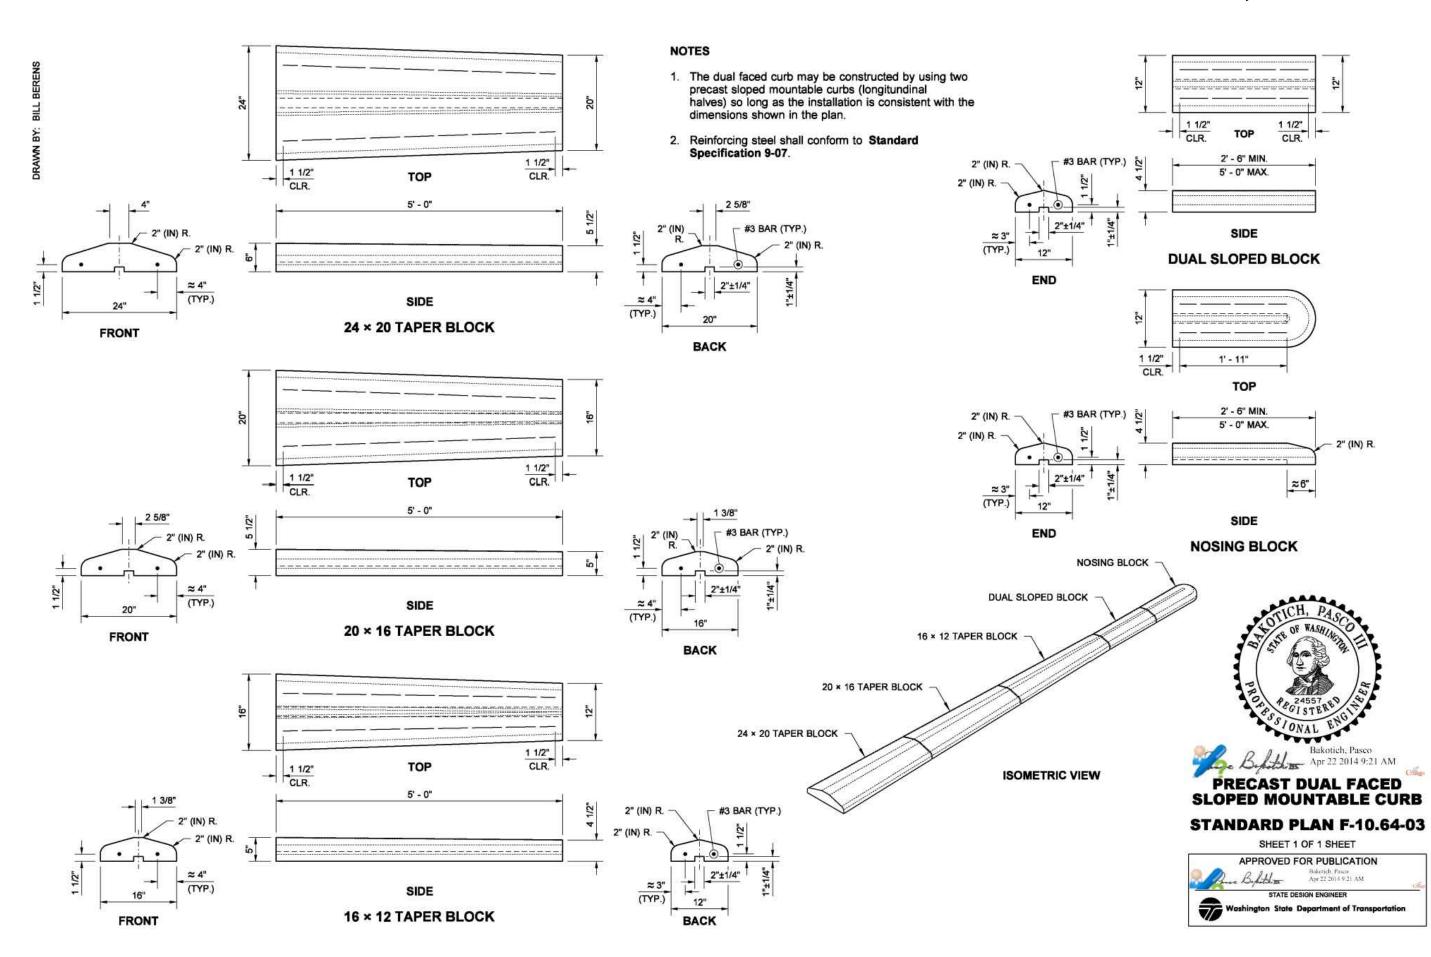

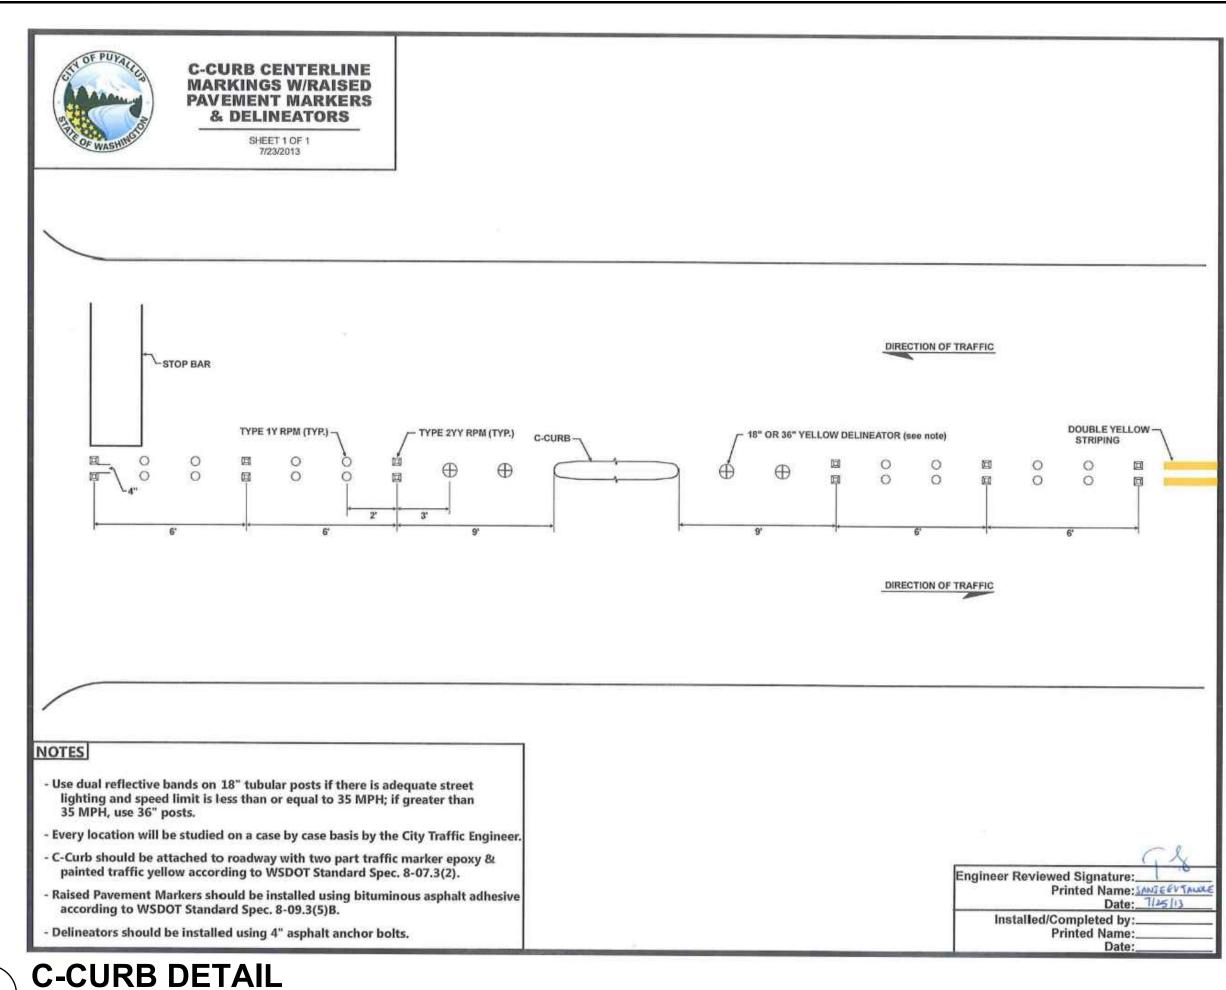

APPROACH SIGHT DISTANCE

DATE

NOTE: THIS APPROVAL IS VOID
AFTER 180 DAYS FROM APPROVAL
DATE.
THE CITY WILL NOT BE
RESPONSIBLE FOR ERRORS
AND OF COMPASSIONS ON THIS SE

THE CITY WILL NOT BE
RESPONSIBLE FOR ERRORS
AND/OR OMISSIONS ON THESE
PLANS.
FIELD CONDITIONS MAY DICTATE
CHANGES TO THESE PLANS AS
DETERMINED BY THE
DEVELOPMENT ENGINEERING
MANAGER.

TACOMA · SEATTLE · SPOKANE · TRI-CITIES

2215 North 30th Street, Suite 300, Tacoma, WA 98403
253.383.2422 TEL 253.383.2572 FAX www.ahbl.com WEB

APPROVED

PUYALLUP 2ND STREET APARTMENTS

lient:
SPP MANUFACTURING

P.O.BOX 64160 TACOMA, WA 98464 DON HUBER


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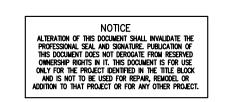
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Issue Set & Date:

SITE DEVELOPMENT PERMIT SET

2/7/2024



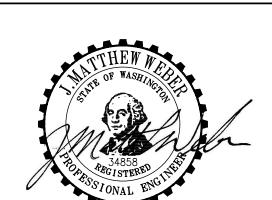

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Revisions:

Sheet Title:

SURFACING NOTES AND DETAILS

Sheet No.

C2.2


8 of 26 Sheets

NOT TO SCALE

Know what's below.

Call before you dig.

A PORTION OF THE NW 1/4 OF THE NW 1/4 OF SEC. 27, TWN. 20 N., RGE. 04 E. W.M.

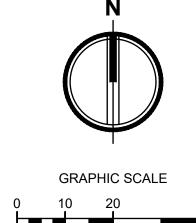

CITY OF PUYALLUP DEVELOPMENT ENGINEERING

DATE NOTE: THIS APPROVAL IS VOID AFTER 180 DAYS FROM APPROVAL THE CITY WILL NOT BE

RESPONSIBLE FOR ERRORS AND/OR OMISSIONS ON THESE

APPROVED

PLANS. FIELD CONDITIONS MAY DICTATE CHANGES TO THESE PLANS AS DETERMINED BY THE DEVELOPMENT ENGINEERING MANAGER.

2215 North 30th Street, Suite 300, Tacoma, WA 98403

FIRE NOTES

- 1. "NO PARKING FIRE LANE" SIGNS TO MEET INTERNATIONAL FIRE CODE D103.6 STANDARDS. 12"x18" WITH RED LETTERS ON WHITE REFLECTIVE BACKGROUND.
- 2. PROVIDE YELLOW PAINTED CURBS ALONG FIRE ACCESS ROUTE.

PUYALLUP 2ND STREET **APARTMENTS**

253.383.2422 TEL 253.383.2572 FAX www.ahbl.com WEB

Project Title:

SPP MANUFACTURING

P.O.BOX 64160 **TACOMA, WA 98464** DON HUBER

Project No.


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Issue Set & Date:

SITE DEVELOPMENT **PERMIT SET**

2/7/2024



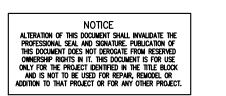

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<u>Revisions:</u>


Sheet Title:

CHANNELIZATION PLAN

Designed by: Drawn by: Checked by:


Sheet No.

9 of 26 Sheets

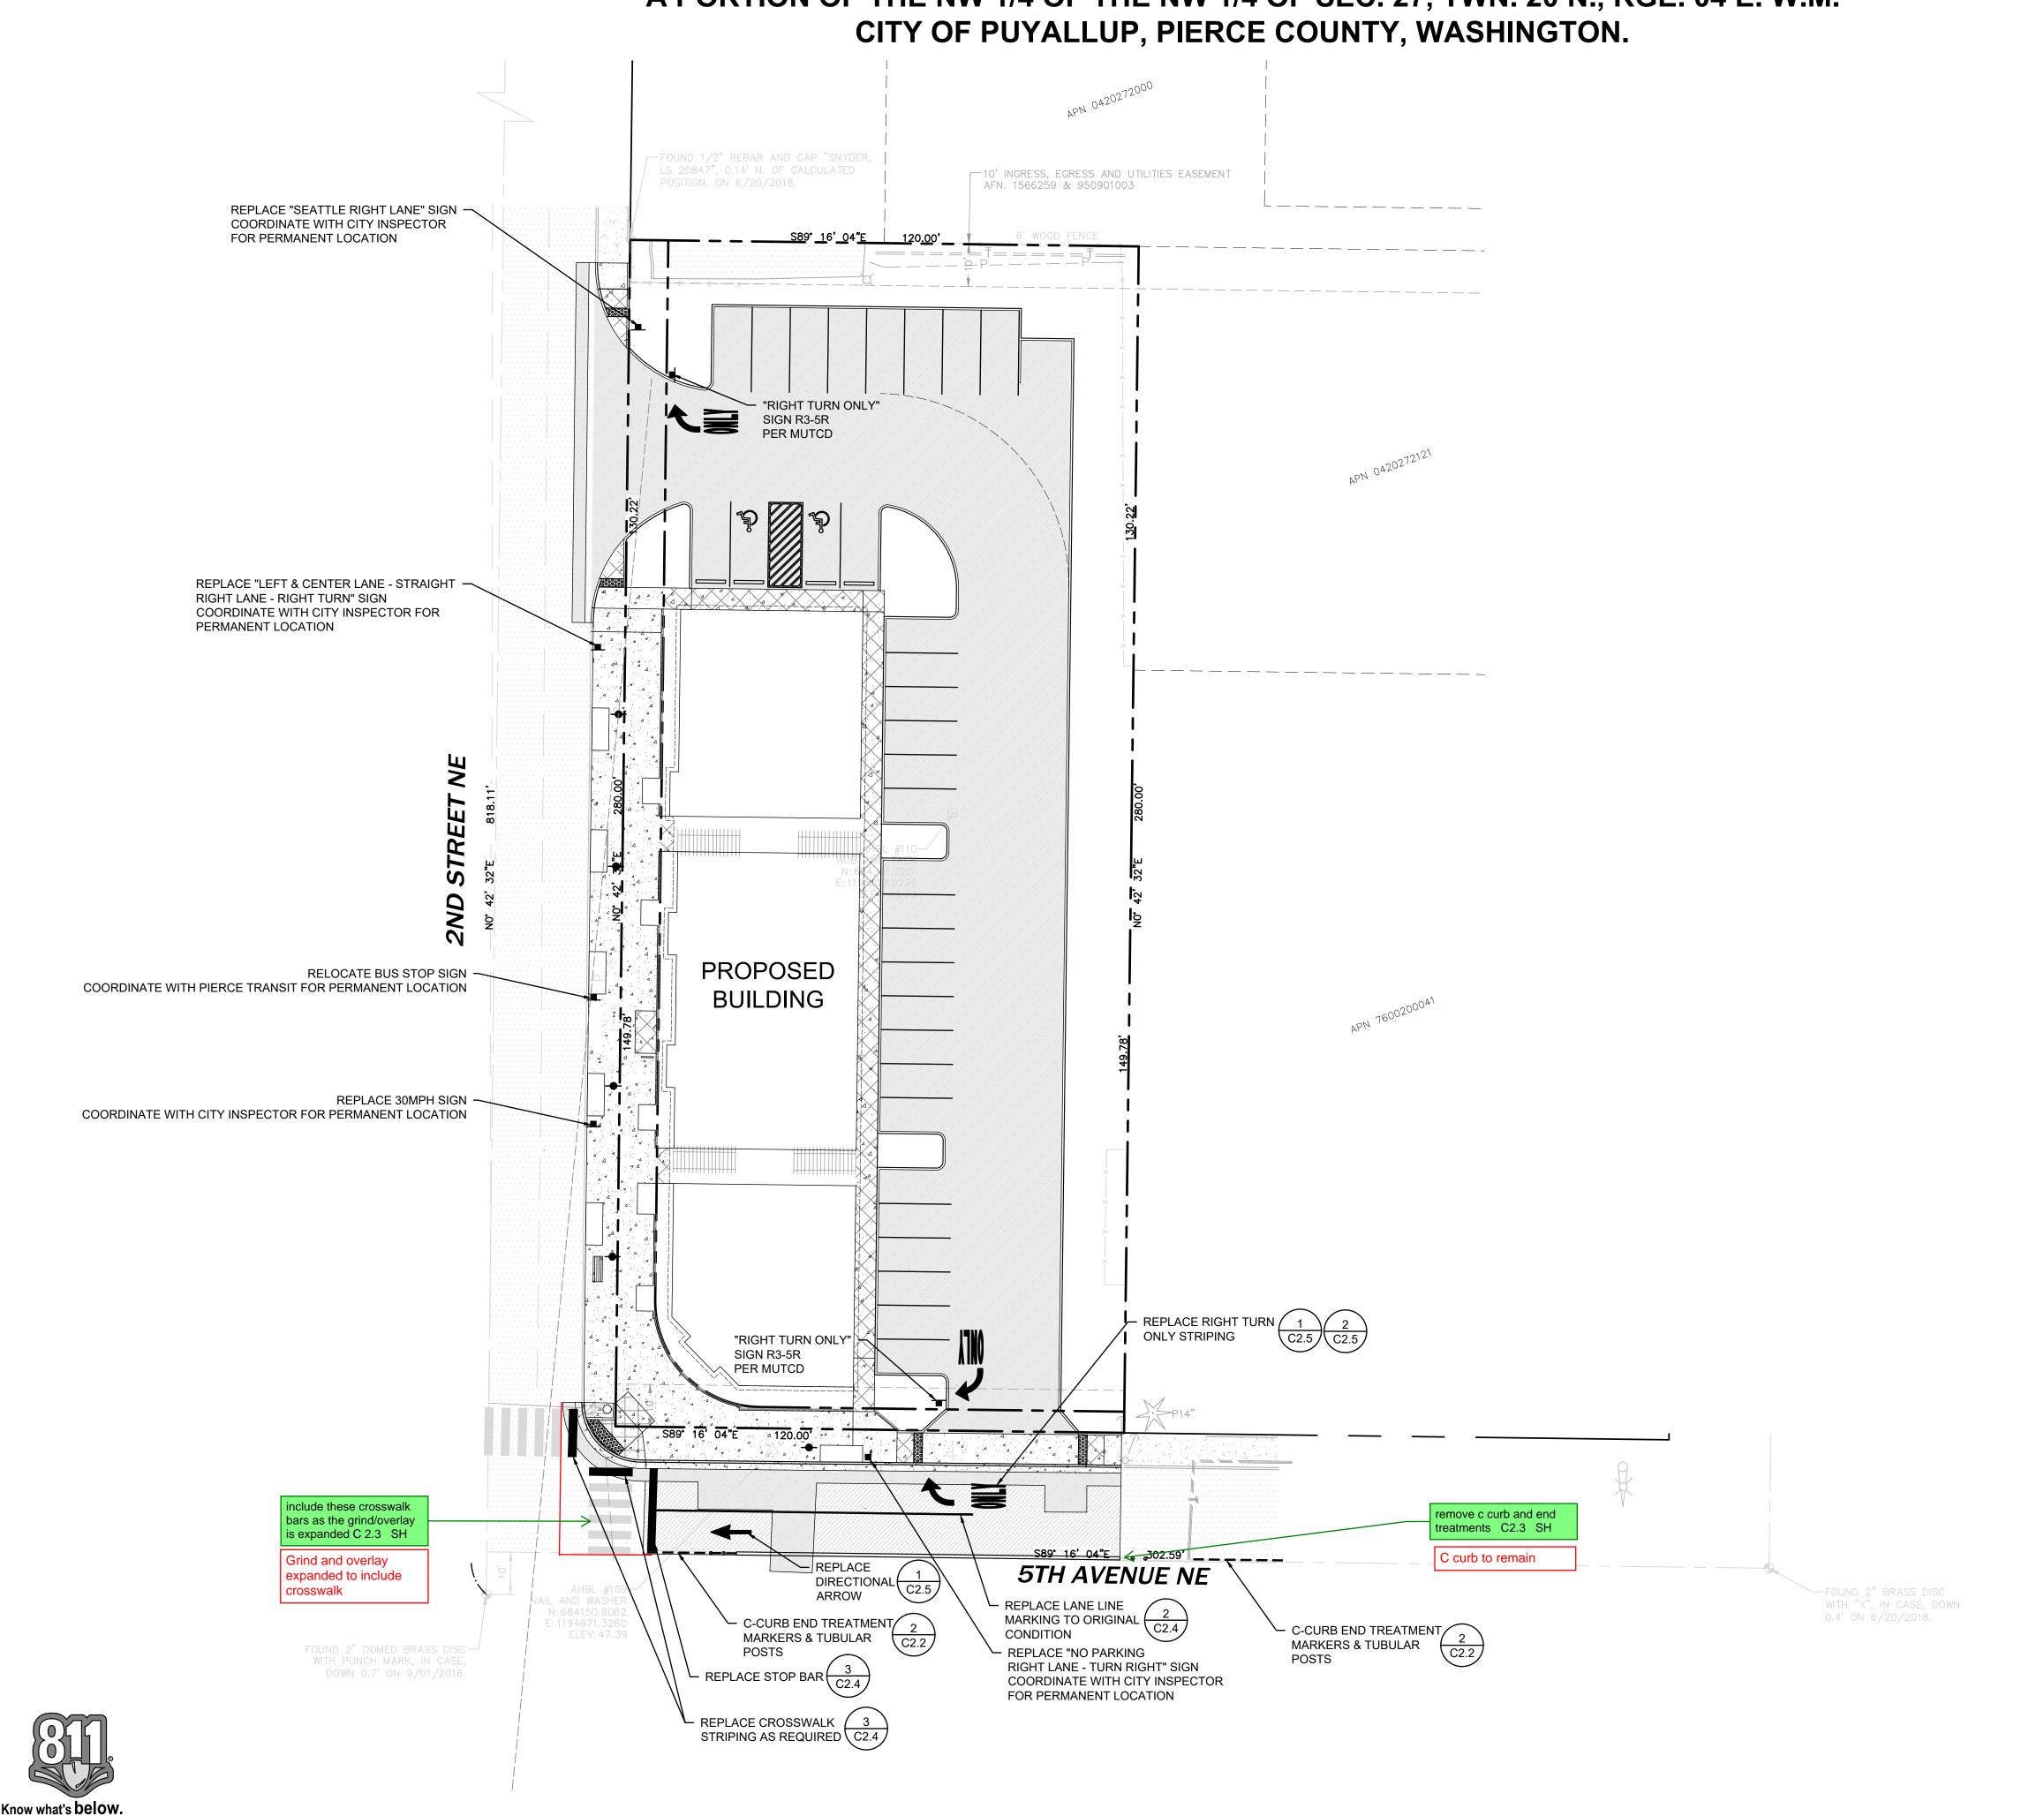


Call before you dig.

A PORTION OF THE NW 1/4 OF THE NW 1/4 OF SEC. 27, TWN. 20 N., RGE. 04 E. W.M. CITY OF PUYALLUP, PIERCE COUNTY, WASHINGTON.

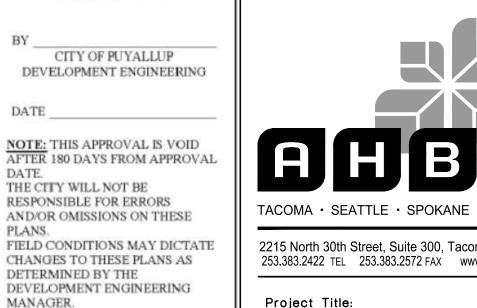

APPROVED

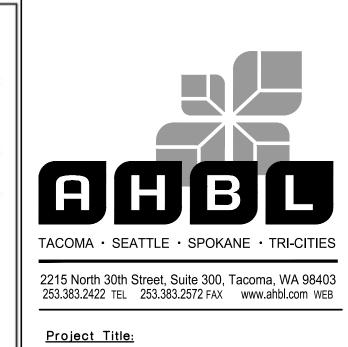

PUYALLUP 2ND STREET **APARTMENTS**

SPP MANUFACTURING

P.O.BOX 64160 **TACOMA, WA 98464** DON HUBER


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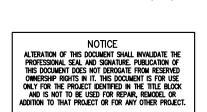
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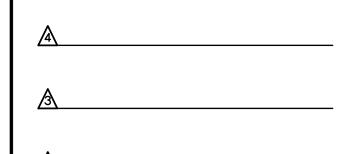
Issue Set & Date:

SITE DEVELOPMENT **PERMIT SET**

2/7/2024





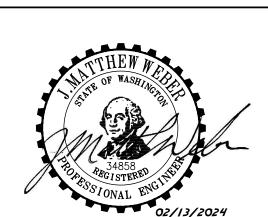

Revisions:


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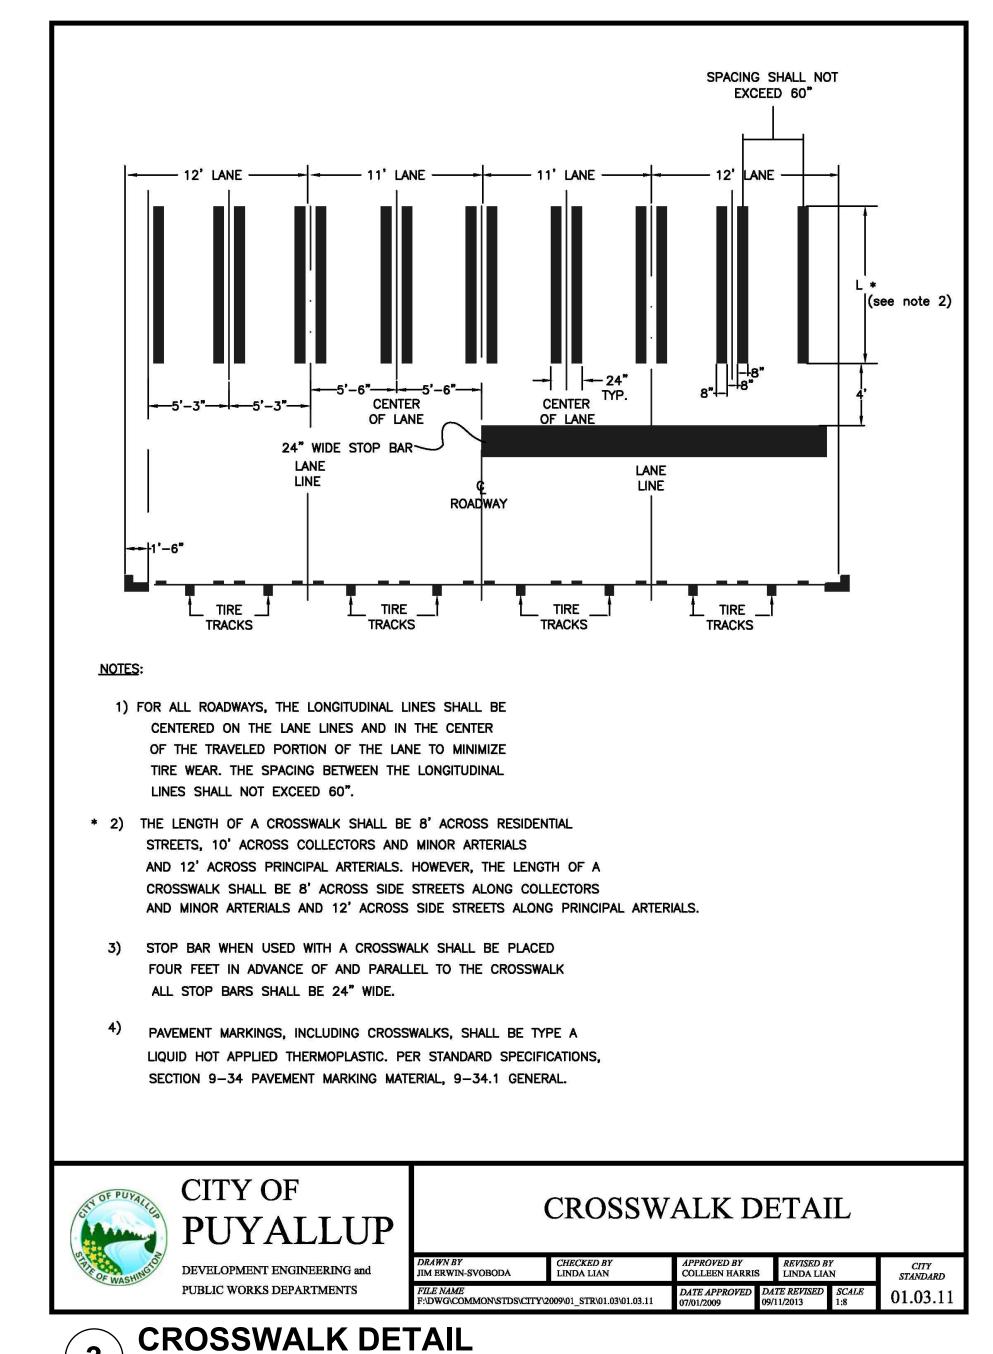
CHANNELIZATION NOTES AND DETAILS

Designed by: Drawn by: Checked by:

Sheet No.

10 of 26 Sheets



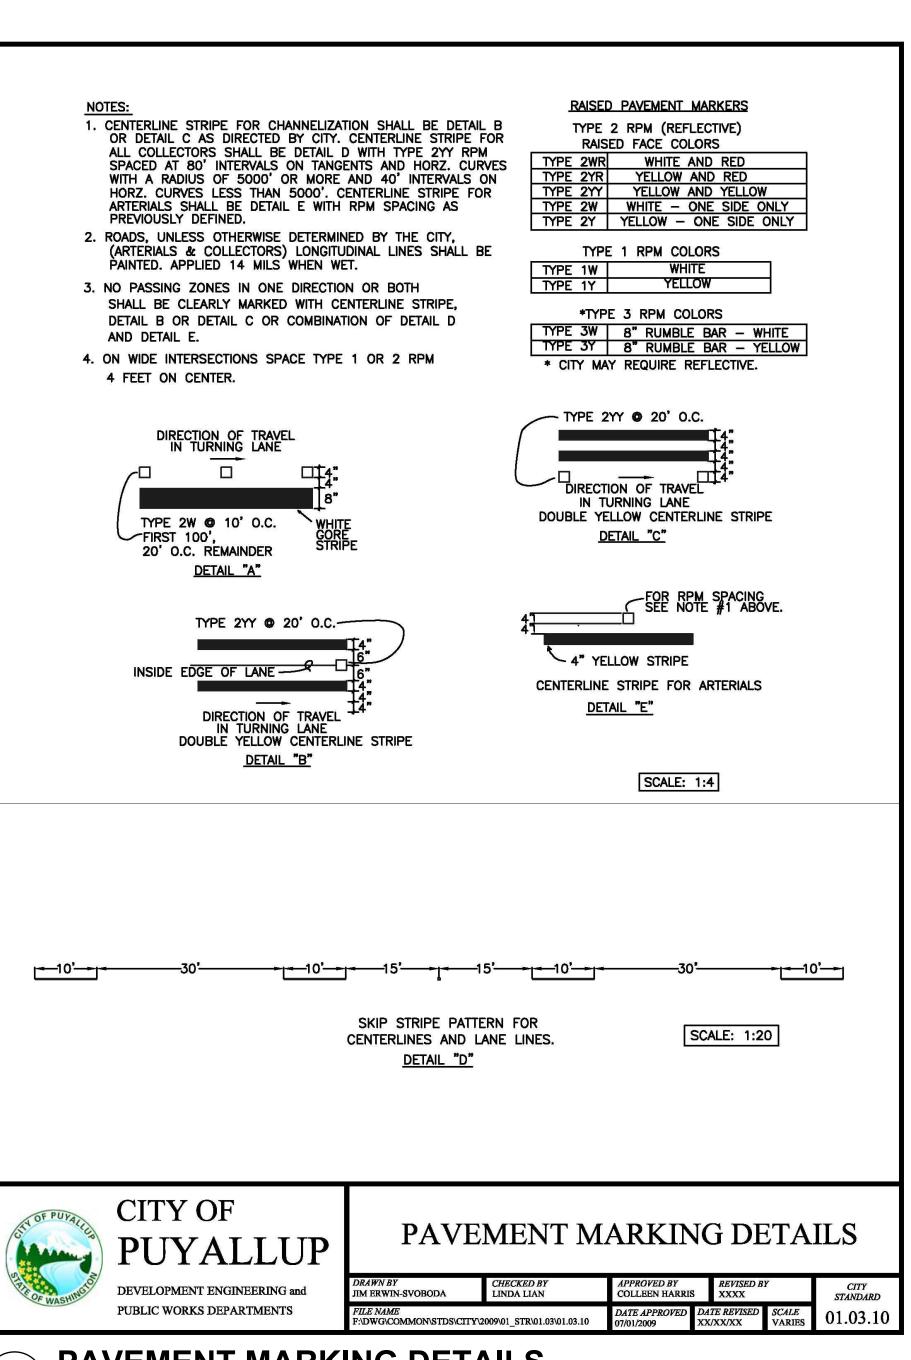



PUYALLUP

DEVELOPMENT ENGINEERING and

PUBLIC WORKS DEPARTMENTS

CASE 1

WHEN LEFT TURN POCKET

IS 100' OR LESS

* THE PLACEMENT AND NUMBER

OF ARROW/ONLY MARKINGS

FOR LANES EXCEEDING 275'

WILL BE APPROVED ON AN

INDIVIDUAL BASES BY THE

** DISTANCES SHALL BE EQUAL

WHEN LESS THAN 100'

CITY OF PUYALLUP

NOTES:

24" WIDE STOP BAR TYP. SEE NOTE 3

CASE 2

WHEN LEFT TURN POCKET

IS 101' - 200'

24" WIDE STOP BAR_

DOUBLE

YELLOW W/TYPE 2YY

20' O.C.

SEE CITY

1. PAINT FOR LANES STRIPES SHALL COMPLY WITH SPECIFICATIONS

SHALL MEET CONSTRUCTION REQUIREMENTS 8-22.3 OF 2002

MUNICIPAL CONSTRUCTION. SEE PAVEMENT MARKING DETAILS

2. PAVEMENT MARKINGS SHALL BE TYPE A - LIQUID HOT APPLIED

THERMOPLASTIC. PER STANDARD SPECIFICATIONS, SECTION 9-34

FOR NO HEAT, INSTANT DRY PAVEMENT MARKING. GLASS

BEADS SHALL COMPLY WITH SPECIFICATIONS FOR TYPE II

WATERPROOF OVERLAY GLASS SPHERES. INSTALLATION

STANDARD SPECIFICATIONS FOR ROAD, BRIDGE AND

FOR EXCEPTIONS WHEN PAINT CAN NOT BE USED.

PAVEMENT MARKING MATERIAL, 9-34.1 GENERAL.

STUDY DETERMINES THEY ARE WARRENTED.

CITY OF

3. STOP BAR IS TO BE INSTALLED ONLY WHERE A TRAFFIC

STANDARD DETAIL

NO. 01.03.10

TYP.
SEE NOTE 3

CASE 3

WHEN LEFT TURN POCKET:

IS 201' - 275'

TYP. SEE NOTE 3

GORE

STRIPE W/

TYPE 2W

RPM's @

10' O.C.

SEE CITY

-8" WHITE

STRIPE W/

TYPE 2W

RPM's @

20' O.C.

SEE CITY

STANDARD DETAIL

LEFT/RIGHT TURN POCKET

ARROW AND ONLY LAYOUT

FILE NAME
F:\DWG\COMMON\STDS\CITY\2009\01_STR\01.03\01.03.0

APPROVED BY COLLEEN HARRIS

 DATE APPROVED
 DATE REVISED
 SCALE

 07/01/2009
 09/11/2013
 1;40

01.03.06


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STANDARD DETAIL


NO. 01.03.10





A PORTION OF THE NW 1/4 OF THE NW 1/4 OF SEC. 27, TWN. 20 N., RGE. 04 E. W.M. CITY OF PUYALLUP, PIERCE COUNTY, WASHINGTON.

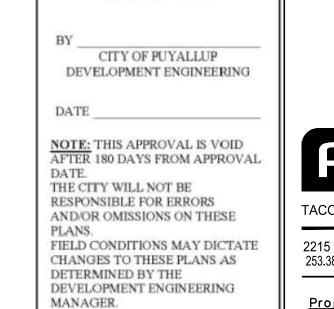


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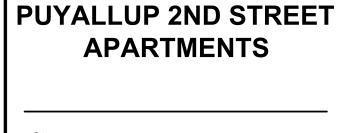


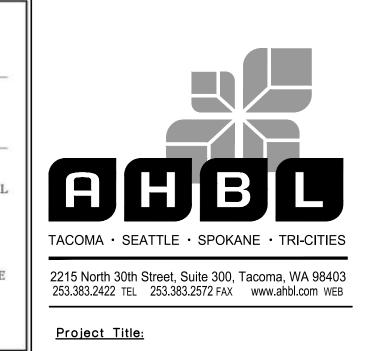

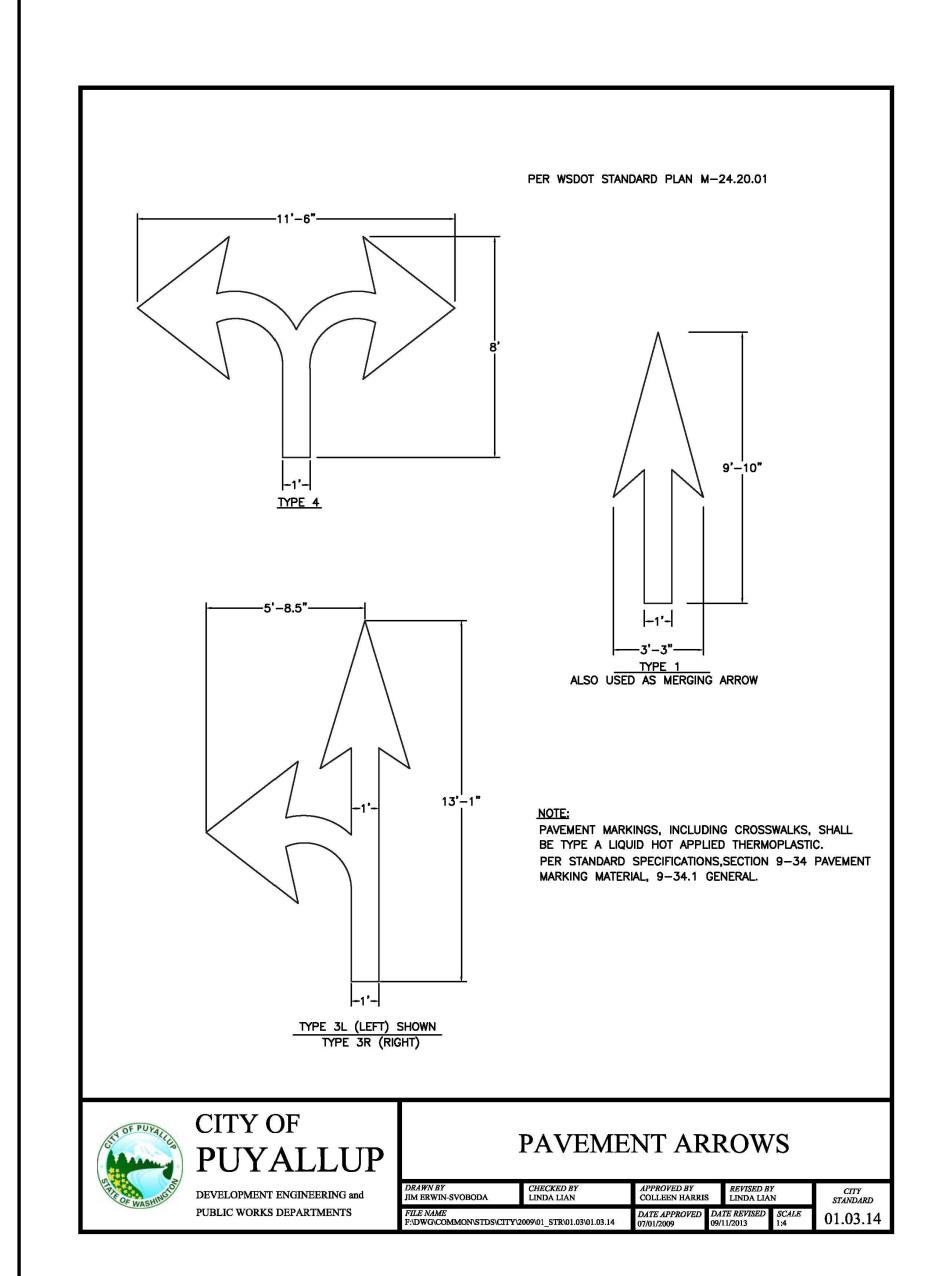

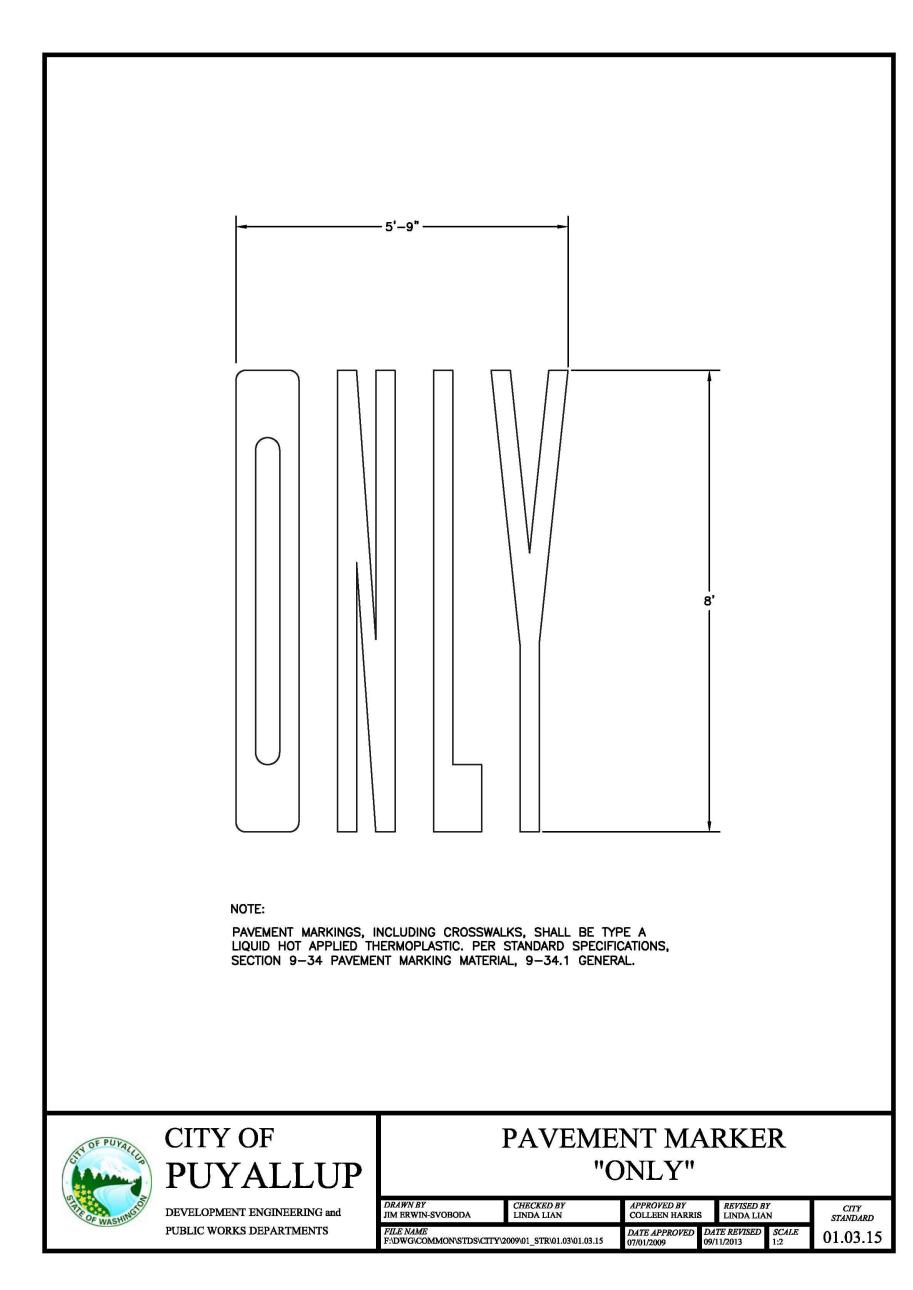

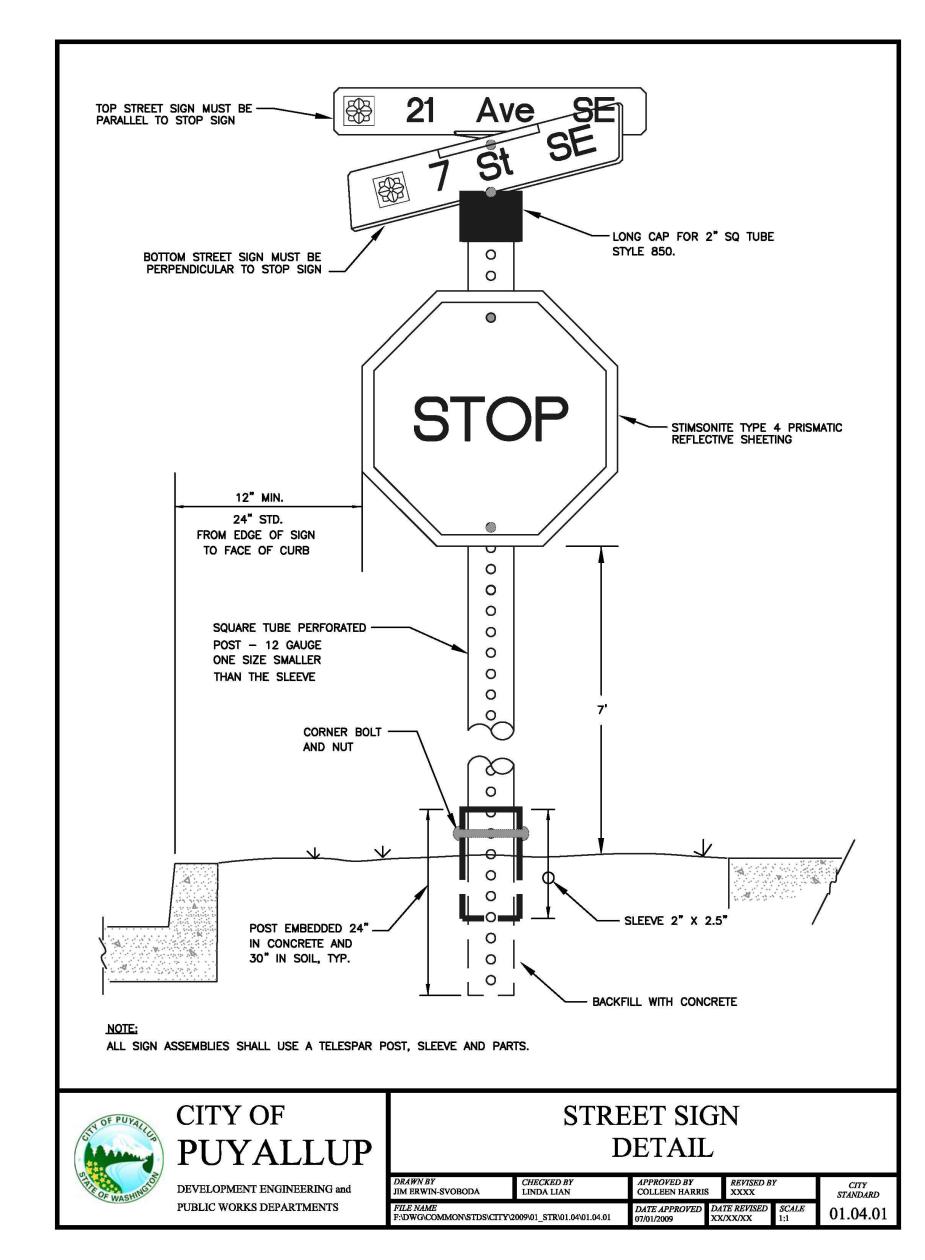



SPP MANUFACTURING

P.O.BOX 64160 TACOMA, WA 98464 DON HUBER

<u>Project No.</u>


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Issue Set & Date:

SITE DEVELOPMENT **PERMIT SET**

2/7/2024



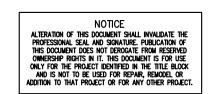

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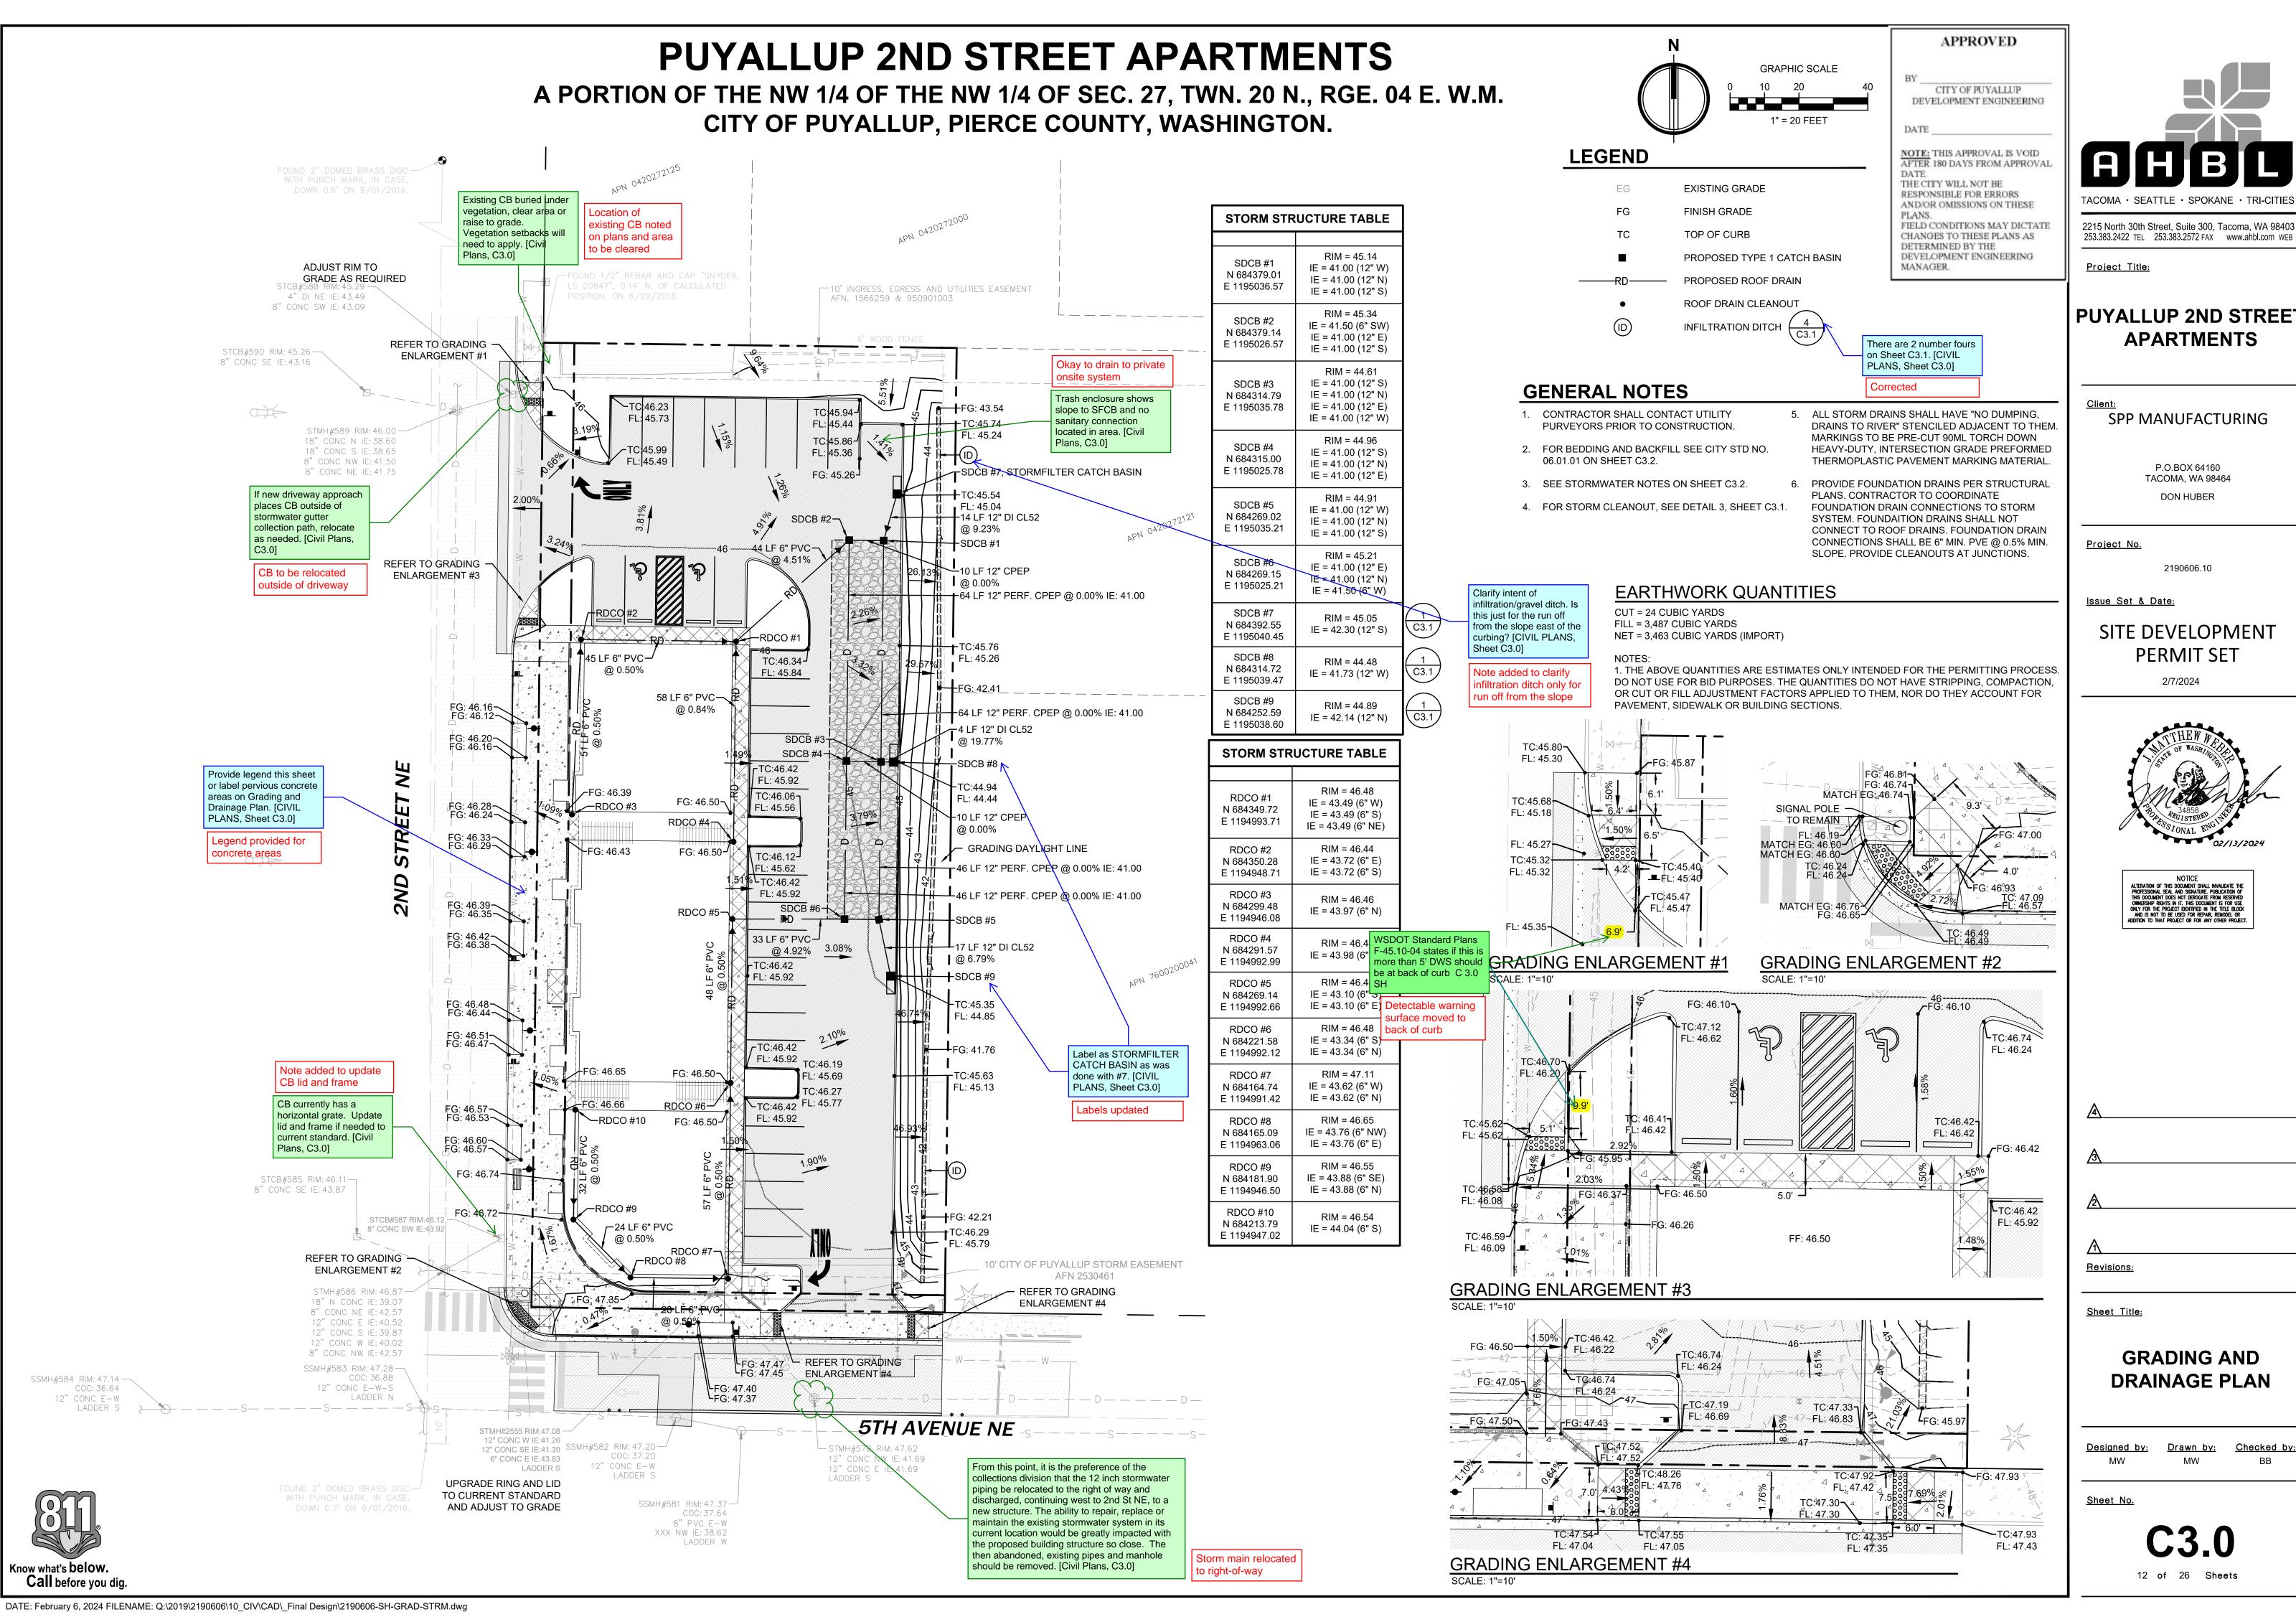
Revisions:

Sheet Title:

CHANNELIZATION NOTES AND DETAILS

Designed by: Drawn by: Checked by:

Sheet No.





Project Title:

| PUYALLUP 2ND STREET **APARTMENTS**

SPP MANUFACTURING

P.O.BOX 64160 **TACOMA, WA 98464** DON HUBER

<u>Project No.</u>


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Issue Set & Date:

SITE DEVELOPMENT **PERMIT SET**

2/7/2024



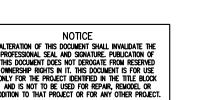

Revisions:


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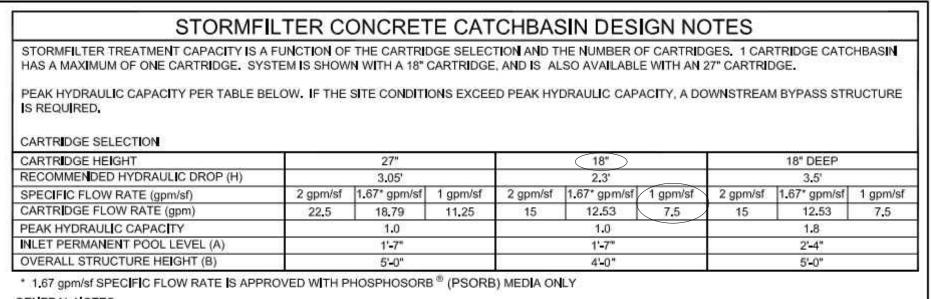
GRADING AND DRAINAGE PLAN


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A PORTION OF THE NW 1/4 OF THE NW 1/4 OF SEC. 27, TWN. 20 N., RGE. 04 E. W.M. CITY OF PUYALLUP, PIERCE COUNTY, WASHINGTON.






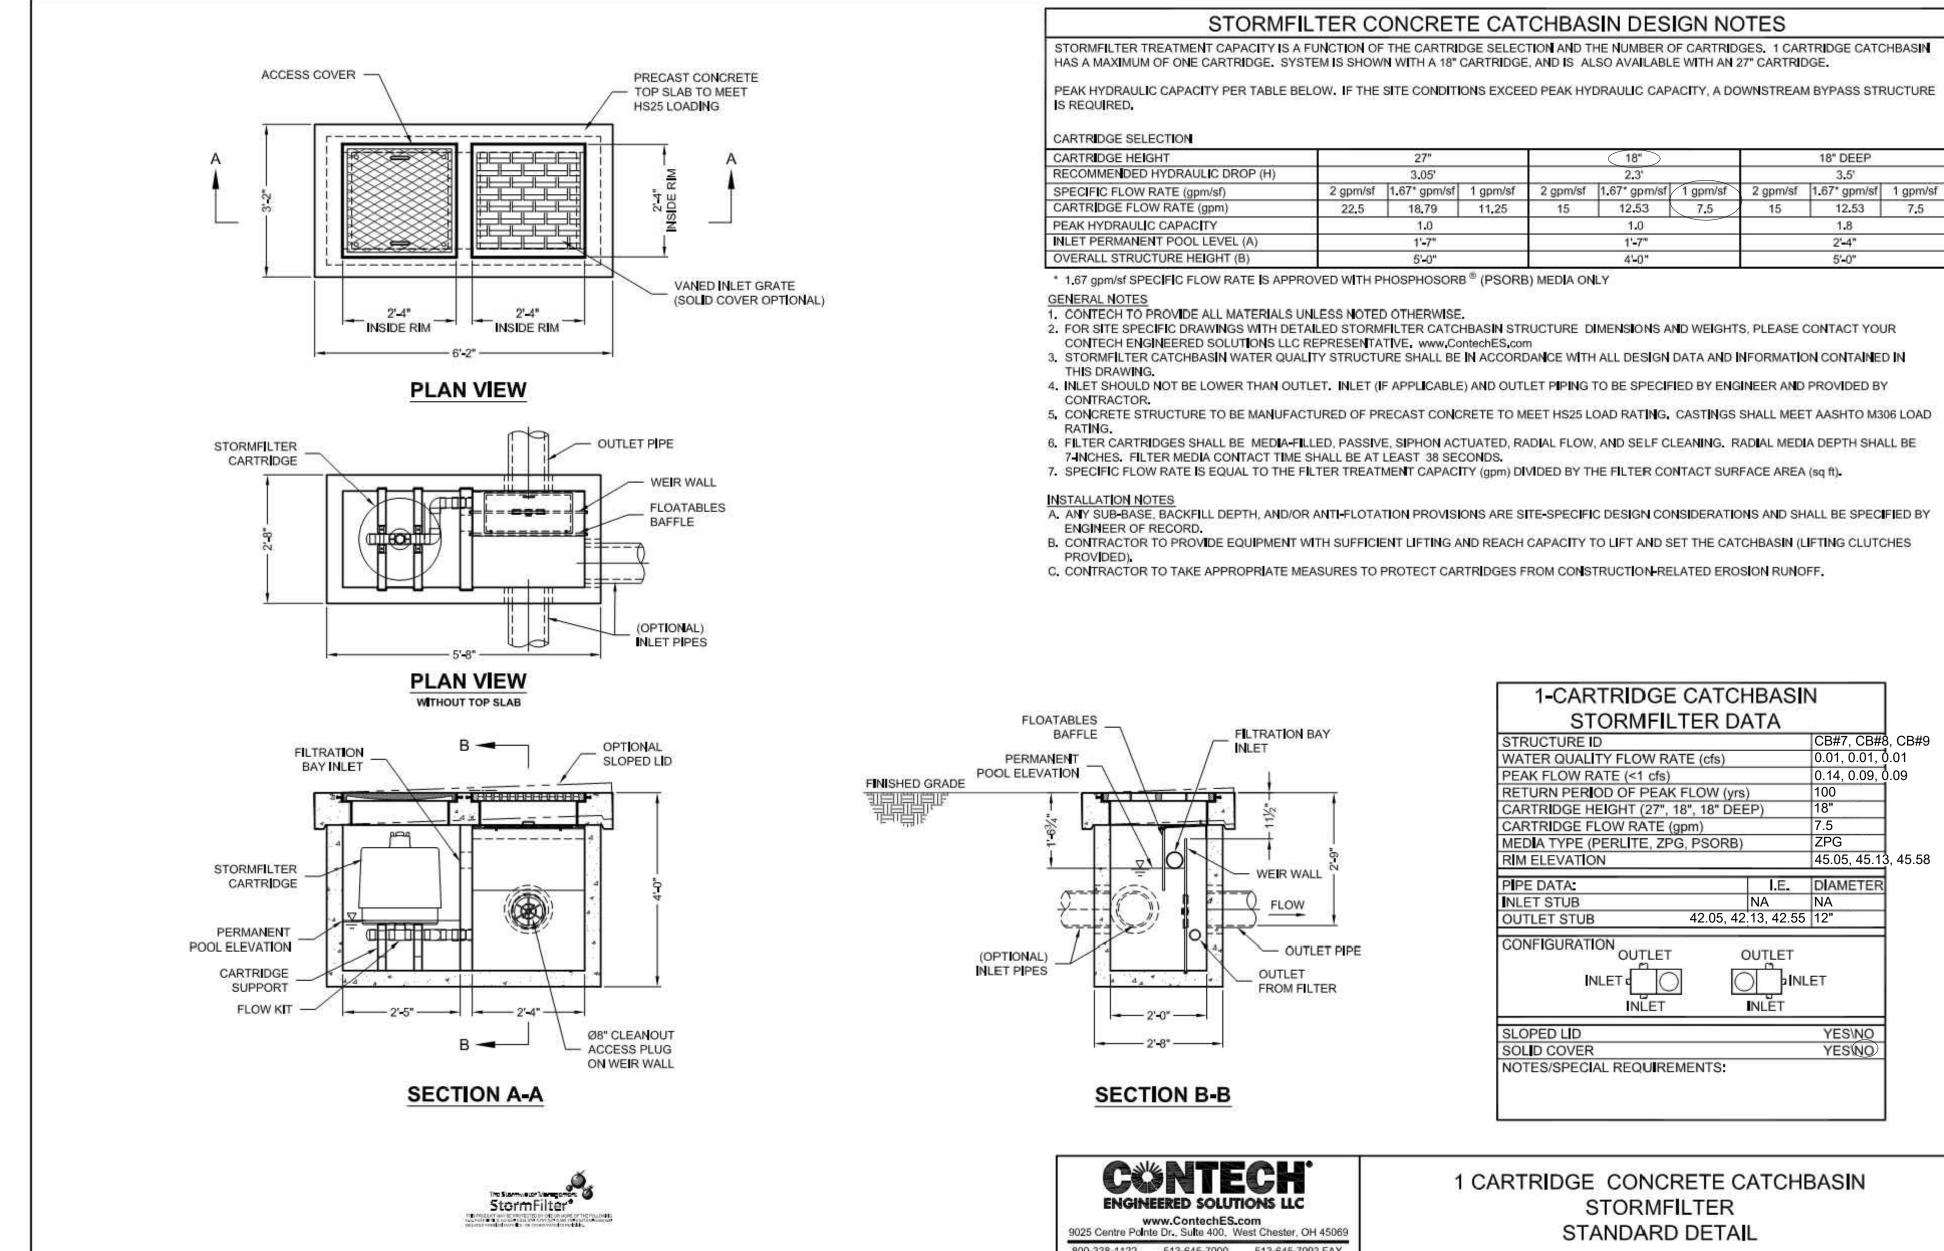


EXCAVATE INFILTRATION TRENCHES TO FINAL GRADE ONLY AFTER ALL DISTURBED AREAS IN THE UPGRADIENT PROJECT DRAINAGE AREA HAVE BEEN PERMANENTLY STABILIZED. THE SIDEWALLS AND BOTTOM OF THE INFILTRATION FACILITY EXCAVATION SHALL BE RAKED OR SCARIFIED TO A MINIMUM DEPTH OF 3 INCHES AFTER FINAL EXCAVATION TO RESTORE INFILTRATION RATES

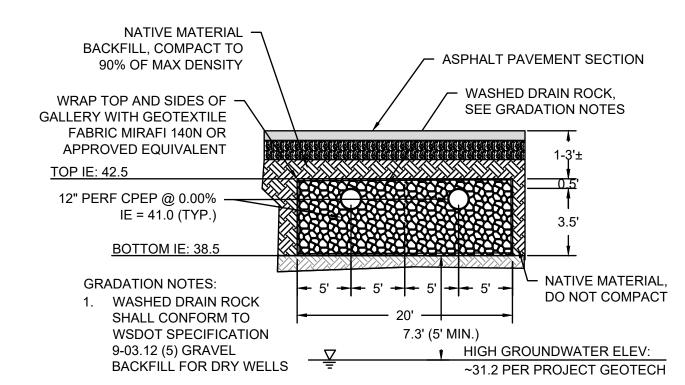PRIOR TO BACKFILL OF INFILTRATION TRENCH WITH GRAVEL, CONTRACTOR SHALL COORDINATE INFILTRATION VERIFICATION TESTING WITH GEOTECHNICAL ENGINEER. INFILTRATION VERIFICATION REPORT SHALL BE PROVIDED TO ENGINEER AND CITY OF PUYALLUP. VERIFICATION TESTING FOR INFILTRATION TRENCH SHALL CONSIST OF A MINIMUM OF 1 MODIFIED FALLING-HEAD PERCOLATION TEST. TESTING SHALL BE IN ACCORDANCE WITH ECOLOGY STORMWATER MANAGEMENT MANUAL FOR WESTERN

INFILTRATION TRENCH DETAIL

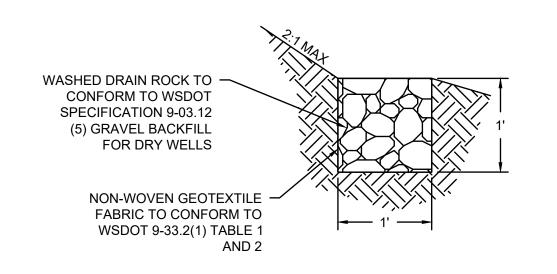

INFILTRATION DITCH

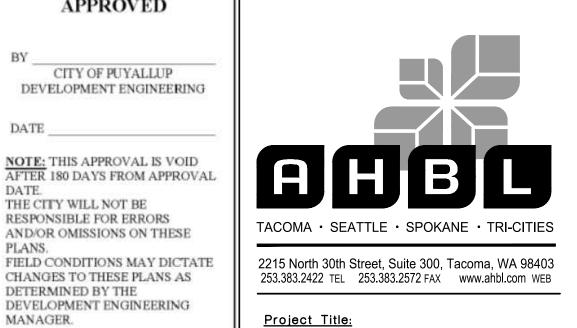

APPROVED

CITY OF PUYALLUP

THE CITY WILL NOT BE

DETERMINED BY THE

RESPONSIBLE FOR ERRORS

DATE

PLANS.

MANAGER.

| PUYALLUP 2ND STREET **APARTMENTS**

SPP MANUFACTURING

P.O.BOX 64160 **TACOMA, WA 98464** DON HUBER

<u>Project No.</u>


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Issue Set & Date:

SITE DEVELOPMENT **PERMIT SET**

2/7/2024



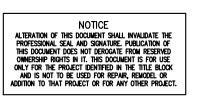

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Sheet Title:

Revisions:

DRAINAGE NOTES AND DETAILS

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Sheet No.

13 of 26 Sheets

Call before you dig.

Know what's below.

STORMFILTER

DOWNSPOUT CONNECTION

10

MIN.

6" PVC----

SDR 35 TYP.

STUD WALL

SEE STRUCTURAL DETAILS

BUILDING FOUNDATION

SEE STRUCTURAL DETAILS

ROOF DOWNSPOUT ——

CUT HOLE TO ALLOW

FINISH -

GRADE

6" PVC CAP

DOWNSPOUT TO

PENETRATE WITH

1/8" CLEARANCE.

PROVIDE FITTINGS -

AS REQUIRED.

SEE ARCHITECTURAL DETAILS.

- RAISE - 1/2" WIDE BORDER

3000 PSI CLASS C-

(LANDSCAPE AREAS

└-2-7/8"

CONCRETE (TYP.)

ONLY)

8-3/4" ——

1/2", -2"

7-3/4"—

CAST IRON RING AND COVER

PROVIDE COUPLINGS &

REDUCERS AS NECESSARY

STORM CLEANOUT

1. PIPE MATERIAL AS SPECIFIED

CAP AT END

2. PIPE DIAMETER AS SHOWN


BY THE ENGINEER.

PER PLAN.


FIBRE JOINT -PACKING


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A PORTION OF THE NW 1/4 OF THE NW 1/4 OF SEC. 27, TWN. 20 N., RGE. 04 E. W.M. CITY OF PUYALLUP, PIERCE COUNTY, WASHINGTON.

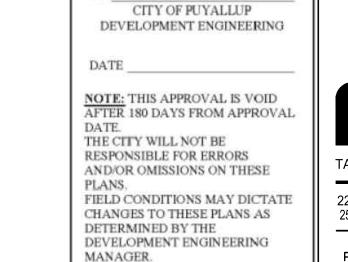

APPROVED



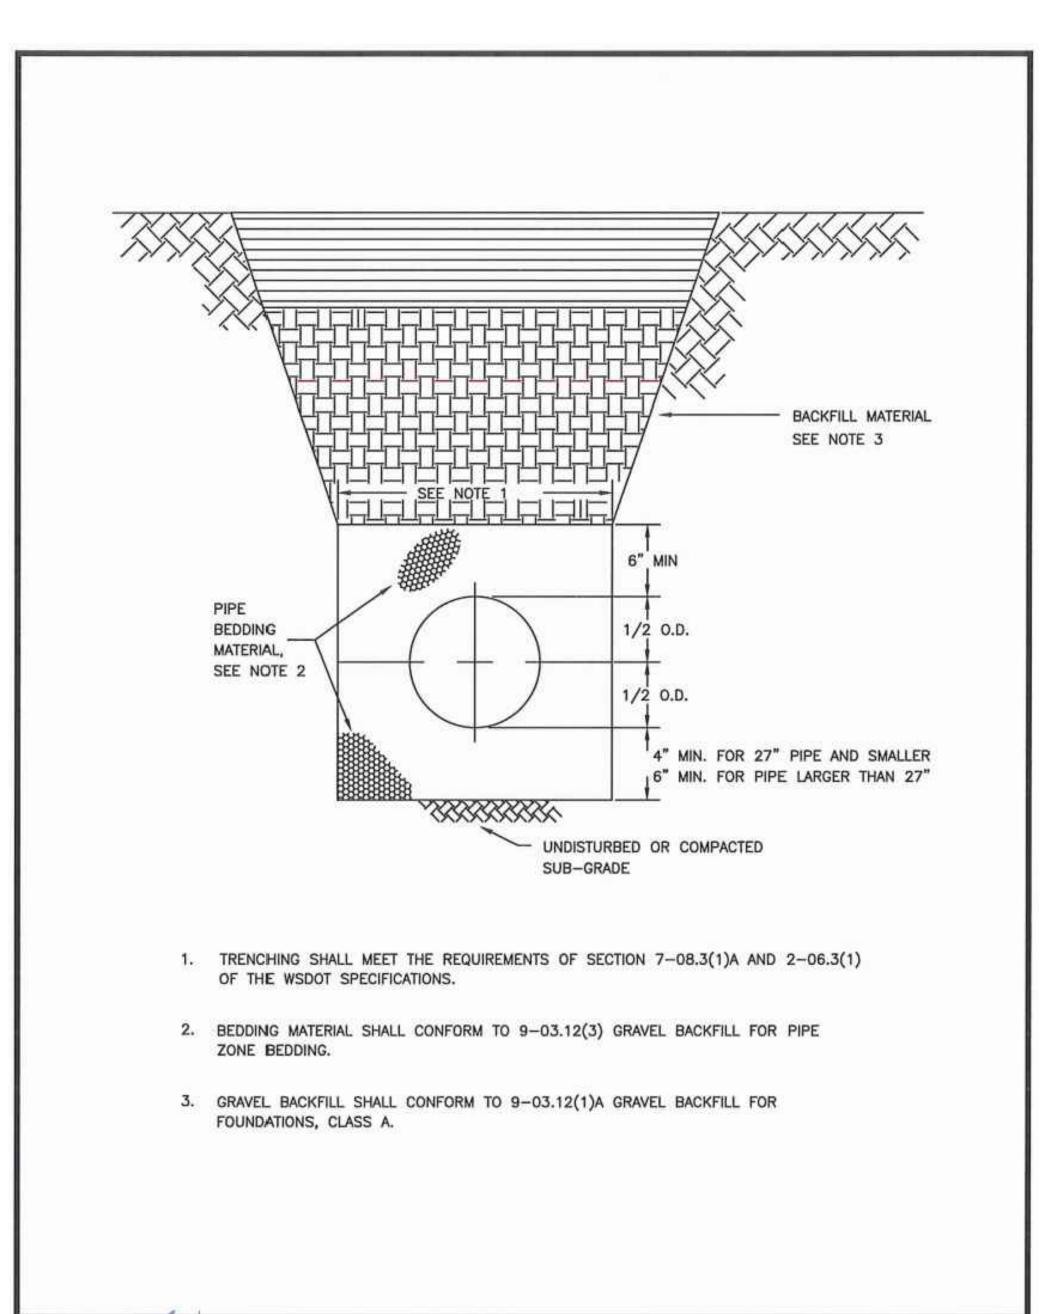

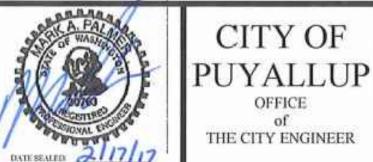PIPE TRENCHING BEDDING AND BACKFILL

DRAWN BY
JIM ERWIN-SVOBODA

CHECKED BY
APPROVED BY
MARK PALMER
V STOCKMAN
03/21/11
02/15/17
STANDARD

FILE NAME
FADWGCOMMON/STDS/CITYSTDS/06_MISC/06.01/06.01.01

DATE APPROVED
SCALE
XX/XX/XX
XX/XX/XX
XX/XX/XX

07/01/2009

PIPE TRENCHING BEDDING AND BACKFILL

STORMWATER NOTES:

1. ALL WORK IN CITY RIGHT-OF-WAY REQUIRES A PERMIT FROM THE CITY OF PUYALLUP. PRIOR TO ANY WORK COMMENCING, THE GENERAL CONTRACTOR SHALL ARRANGE FOR A PRECONSTRUCTION MEETING AT THE DEVELOPMENT SERVICES CENTER TO BE ATTENDED BY ALL CONTRACTORS THAT WILL PERFORM WORK SHOWN ON THE ENGINEERING PLANS, REPRESENTATIVES FROM ALL APPLICABLE UTILITY COMPANIES, THE PROJECT OWNER AND APPROPRIATE CITY STAFF. CONTACT ENGINEERING SERVICES TO SCHEDULE THE MEETING (253) 841-5568. THE CONTRACTOR IS RESPONSIBLE TO HAVE THEIR OWN APPROVED SET OF PLANS AT THE MEETING.

- 2. AFTER COMPLETION OF ALL ITEMS SHOWN ON THESE PLANS AND BEFORE ACCEPTANCE OF THE PROJECT, THE CONTRACTOR SHALL OBTAIN A "PUNCH LIST" PREPARED BY THE CITY'S INSPECTOR DETAILING REMAINING ITEMS OF WORK TO BE COMPLETED. ALL ITEMS OF WORK SHOWN ON THESE PLANS SHALL BE COMPLETED TO THE SATISFACTION OF THE CITY PRIOR TO ACCEPTANCE OF THE WATER SYSTEM AND PROVISION OF SANITARY SEWER SERVICE.
- 3. ALL MATERIALS AND WORKMANSHIP SHALL CONFORM TO THE STANDARD SPECIFICATIONS FOR ROAD, BRIDGE, AND MUNICIPAL CONSTRUCTION (HEREINAFTER REFERRED TO AS THE "STANDARD SPECIFICATIONS"), WASHINGTON STATE DEPARTMENT OF TRANSPORTATION AND AMERICAN PUBLIC WORKS ASSOCIATION, WASHINGTON STATE CHAPTER, LATEST EDITION, UNLESS SUPERSEDED OR AMENDED BY THE CITY OF PUYALLUP CITY STANDARDS FOR PUBLIC WORKS ENGINEERING AND CONSTRUCTION (HEREINAFTER REFERRED TO AS THE "CITY STANDARDS").
- 4. A COPY OF THESE APPROVED PLANS AND APPLICABLE CITY DEVELOPER SPECIFICATIONS AND DETAILS SHALL BE ON SITE DURING CONSTRUCTION.
- 5. ANY REVISIONS MADE TO THESE PLANS MUST BE REVIEWED AND APPROVED BY THE DEVELOPER'S ENGINEER AND THE ENGINEERING SERVICES STAFF PRIOR TO ANY IMPLEMENTATION IN THE FIELD. THE CITY SHALL NOT BE RESPONSIBLE FOR ANY ERRORS AND/OR OMISSIONS ON THESE PLANS.
- 6. THE CONTRACTOR SHALL HAVE ALL UTILITIES VERIFIED ON THE GROUND PRIOR TO ANY CONSTRUCTION. CALL (811) AT LEAST TWO WORKING DAYS IN ADVANCE. THE OWNER AND HIS/HER ENGINEER SHALL BE CONTACTED IMMEDIATELY IF A CONFLICT EXISTS.
- 7. ANY STRUCTURE AND/OR OBSTRUCTION WHICH REQUIRE REMOVAL OR RELOCATION RELATING TO THIS PROJECT, SHALL BE DONE SO AT THE DEVELOPER'S EXPENSE.
- 8. DURING CONSTRUCTION, ALL EXISTING AND NEWLY INSTALLED DRAINAGE STRUCTURES SHALL BE PROTECTED FROM SEDIMENTS.
- 9. ALL STORM MANHOLES SHALL CONFORM TO CITY STANDARD DETAIL NO. 02.01.01. FLOW CONTROL MANHOLE/OIL WATER SEPARATOR SHALL CONFORM TO CITY STANDARD DETAIL NO. 02.01.06 AND 02.01.07.
- 10. MANHOLE RING AND COVER SHALL CONFORM TO CITY STANDARD DETAIL 06.01.02.
- 11. CATCH BASINS TYPE I SHALL CONFORM TO CITY STANDARD DETAIL NO.02.01.02 AND 02.01.03 AND SHALL BE USED ONLY FOR DEPTHS LESS THAN 5 FEET FROM TOP OF THE GRATE TO THE INVERT OF THE STORM PIPE.
- 12. CATCH BASINS TYPE II SHALL CONFORM TO CITY STANDARD DETAIL NO.02.01.04 AND SHALL BE USED FOR DEPTHS GREATER THAN 5 FEET FROM TOP OF THE GRATE TO THE INVERT OF THE STORM PIPE. CITY OF PUYALLUP CITY STANDARDS STORM REVISED 10/2019
- 13. CAST IRON OR DUCTILE IRON FRAME AND GRATE SHALL CONFORM TO CITY STANDARD DETAIL NO.02.01.05. GRATE SHALL BE MARKED WITH "DRAINS TO STREAM". SOLID CATCH BASIN LIDS (SQUARE UNLESS NOTED AS round) SHALL CONFORM TO WSDOT STANDARD PLAN B-30.20-04 (OLYMPIC FOUNDRY NO. SM60 OR EQUAL). VANED GRATES SHALL CONFORM TO WSDOT STANDARD PLAN B-30.30-03 (OLYMPIC FOUNDRY NO. SM60V OR EQUAL).
- 14. STORMWATER PIPE SHALL BE ONLY PVC, CONCRETE, DUCTILE IRON, OR DUAL WALLED POLYPROPYLENE PIPE.
- a. THE USE OF ANY OTHER TYPE SHALL BE REVIEWED AND APPROVED BY THE ENGINEERING SERVICES STAFF PRIOR TO INSTALLATION.
- b. PVC PIPE SHALL BE PER ASTM D3034, SDR 35 FOR PIPE SIZE 15-INCH AND SMALLER AND F679 FOR PIPE SIZES 18 TO 27 INCH. MINIMUM COVER ON PVC PIPE SHALL BE 3.0 FEET.
- c. CONCRETE PIPE SHALL CONFORM TO THE WSDOT STANDARD SPECIFICATIONS FOR CONCRETE UNDERDRAIN PIPE. MINIMUM COVER ON CONCRETE PIPE SHALL NOT LESS THAN 3.0 FEET.
- d. DUCTILE IRON PIPE SHALL BE CLASS 50, CONFORMING TO AWWA C151. MINIMUM COVER ON DUCTILE IRON PIPE SHALL BE 1.0 FOOT.
- e. POLYPROPYLENE PIPE (PP) SHALL BE DUAL WALLED, HAVE A SMOOTH INTERIOR AND EXTERIOR CORRUGATIONS AND MEET WSDOT 9-05.24(1). 12-INCH THROUGH 30-INCH PIPE SHALL MEET OR EXCEED ASTM F2736 AND AASHTO M330, TYPE S, OR TYPE D. 36-INCH THROUGH 60-INCH PIPE SHALL MEET OR EXCEED ASTM F2881 AND AASHTO M330, TYPE S, OR TYPE D. TESTING SHALL BE PER ASTM F1417. MINIMUM COVER OVER POLYPROPYLENE PIPE SHALL BE 3-FEET.
- 15. TRENCHING, BEDDING, AND BACKFILL FOR PIPE SHALL CONFORM TO CITY STANDARD DETAIL NO. 06.01.01.
- 16. STORM PIPE SHALL BE A MINIMUM OF 10 FEET AWAY FROM BUILDING FOUNDATIONS AND/OR ROOF LINES.
- 17. ALL STORM DRAIN MAINS SHALL BE TESTED AND INSPECTED FOR ACCEPTANCE AS OUTLINED IN SECTION 406 OF THE CITY OF PUYALLUP SANITARY SEWER SYSTEM STANDARDS.
- 18. ALL TEMPORARY SEDIMENTATION AND EROSION CONTROL MEASURES, AND PROTECTIVE MEASURES FOR CRITICAL AREAS AND SIGNIFICANT TREES SHALL BE INSTALLED PRIOR TO INITIATING ANY CONSTRUCTION ACTIVITIES.

ILLUMINATION NOTES:

1. ALL WORK SHALL BE IN ACCORDANCE WITH CITY OF PUYALLUP PUBLIC WORKS STANDARDS AND WSDOT STANDARDS AND SPECIFICATIONS.

- 2. THE LOCATIONS OF FEATURES SHOWN ARE APPROXIMATE AND SHALL BE VERIFIED BY THE CONTRACTOR PRIOR TO CONSTRUCTION START.
- 3. UTILITY LOCATIONS ARE APPROXIMATE AND SHALL BE VERIFIED IN THE FIELD BY THE CONTRACTOR PRIOR TO ANY ILLUMINATION WORK.
- 4. ALL WORK SHALL BE CONSISTENT WITH UTILITY AGENCY REQUIREMENTS. THE CONTRACTOR SHALL COORDINATE WITH AFFECTED UTILITY AGENCIES THROUGHOUT THE PROJECT. THE CONTRACTOR SHALL BE RESPONSIBLE FOR ANY DAMAGE TO UTILITIES.
- 5. CONDUIT LOCATIONS ARE SHOWN FOR ILLUSTRATIVE PURPOSES. ACTUAL LOCATIONS SHALL BE DETERMINED BY THE CONTRACTOR IN THE FIELD.
- 6. CONTRACTOR SHALL COORDINATE WITH THE CITY SIGNAL/ILLUMINATION TECHNICIAN AT 253.405.4390 PRIOR TO CONSTRUCTION.
- 7. THE LOCATION OF ALL CONDUITS, JUNCTION BOXES, POLES, AND CABINETS SHOWN ON THIS PLAN MAY BE ADJUSTED IN THE FIELD TO AVOID CONFLICTS AND MEET ADA REQUIREMENTS. ALL FINAL LOCATIONS SHALL BE APPROVED BY THE CITY TRAFFIC ENGINEER PRIOR TO CONSTRUCTION.
- 8. JUNCTION BOX LOCATIONS SHOWN ARE FOR ILLUSTRATIVE PURPOSES ONLY. JUNCTION BOXES SHALL BE FIELD LOCATED BY THE CONTRACTOR WITH DIRECTION FROM THE CITY.
- 9. CONTRACTOR SHALL ADJUST JUNCTION BOX LIDS TO BE FLUSH WITH TOP OF SIDEWALK.
- 10. ANY NEW JUNCTION BOX WHICH WILL BE LOCATED WITHIN OR PARTIALLY WITHIN SIDEWALK SHALL HAVE LIDS AND FRAMES WITH A NON-SLIP COATING ON THE TOP SURFACE EQUAL TO MEBAC1 OR SLIPNOT#3.

ROADWAY NOTES:

1. ALL WORK IN CITY RIGHT-OF-WAY REQUIRES A PERMIT FROM THE CITY OF PUYALLUP. PRIOR TO ANY WORK COMMENCING, THE GENERAL CONTRACTOR SHALL ARRANGE FOR A PRECONSTRUCTION MEETING AT THE DEVELOPMENT SERVICES CENTER TO BE ATTENDED BY ALL CONTRACTORS THAT WILL PERFORM WORK SHOWN ON THE ENGINEERING PLANS, REPRESENTATIVES FROM ALL APPLICABLE UTILITY COMPANIES, THE PROJECT OWNER AND APPROPRIATE CITY STAFF. CONTACT ENGINEERING SERVICES TO SCHEDULE THE MEETING (253) 841-5568. THE CONTRACTOR IS RESPONSIBLE TO HAVE THEIR OWN APPROVED SET OF PLANS AT THE MEETING.

- 2. AFTER COMPLETION OF ALL ITEMS SHOWN ON THESE PLANS AND BEFORE ACCEPTANCE OF THE PROJECT, THE CONTRACTOR SHALL OBTAIN A "PUNCH LIST" PREPARED BY THE CITY'S INSPECTOR DETAILING REMAINING ITEMS OF WORK TO BE COMPLETED. ALL ITEMS OF WORK SHOWN ON THESE PLANS SHALL BE COMPLETED TO THE SATISFACTION OF THE CITY PRIOR TO ACCEPTANCE OF THE WATER SYSTEM AND PROVISION OF SANITARY SEWER SERVICE.
- 3. ALL MATERIALS AND WORKMANSHIP SHALL CONFORM TO THE STANDARD SPECIFICATIONS FOR ROAD, BRIDGE, AND MUNICIPAL CONSTRUCTION (HEREINAFTER REFERRED TO AS THE "STANDARD SPECIFICATIONS"), WASHINGTON STATE DEPARTMENT OF TRANSPORTATION AND AMERICAN PUBLIC WORKS ASSOCIATION, WASHINGTON STATE CHAPTER, LATEST EDITION, UNLESS SUPERSEDED OR AMENDED BY THE CITY OF PUYALLUP CITY STANDARDS FOR PUBLIC WORKS ENGINEERING AND CONSTRUCTION (HEREINAFTER REFERRED TO AS THE "CITY STANDARDS").
- 4. A COPY OF THESE APPROVED PLANS AND APPLICABLE CITY DEVELOPER SPECIFICATIONS AND DETAILS SHALL BE ON SITE DURING CONSTRUCTION.
- 5. ANY REVISIONS MADE TO THESE PLANS MUST BE REVIEWED AND APPROVED BY THE DEVELOPER'S ENGINEER AND THE ENGINEERING SERVICES STAFF PRIOR TO ANY IMPLEMENTATION IN THE FIELD. THE CITY SHALL NOT BE RESPONSIBLE FOR ANY ERRORS AND/OR OMISSIONS ON THESE PLANS.
- 6. THE CONTRACTOR SHALL HAVE ALL UTILITIES VERIFIED ON THE GROUND PRIOR TO ANY CONSTRUCTION. CALL (811) AT LEAST TWO WORKING DAYS IN ADVANCE. THE OWNER AND HIS/HER ENGINEER SHALL BE CONTACTED IMMEDIATELY IF A CONFLICT EXISTS.
- 7. ANY STRUCTURE AND/OR OBSTRUCTION WHICH REQUIRES REMOVAL OR RELOCATION RELATING TO THIS PROJECT, SHALL BE DONE SO AT THE DEVELOPER'S EXPENSE.
- 8. MONUMENTS SHALL BE INSTALLED AT ALL STREET INTERSECTIONS, AT ANGLE POINTS, AND POINTS OF CURVATURE IN EACH STREET. ALL BOUNDARY MONUMENTS MUST BE INSTALLED ACCORDING TO THE WASHINGTON STATE SUBDIVISION LAWS.
- 9. CURB AND GUTTER INSTALLATION SHALL CONFORM TO CITY STANDARD DETAIL 01.02.09.
- 10. SIDEWALKS AND DRIVEWAYS SHALL BE INSTALLED AS LOTS ARE BUILT ON. SIDEWALKS AND DRIVEWAYS SHALL CONFORM TO CITY STANDARD DETAIL 01.02.01, 01.02.02 AND 01.02.12. IF ASPHALT IS DAMAGED DURING REPLACEMENT OF CURB AND GUTTER, THE REPAIR SHALL CONFORM TO CITY STANDARD DETAIL 01.02.10.
- 11. THE SURROUNDING GROUND (5 FEET BEYOND THE BASE) FOR ALL POWER TRANSFORMERS, TELEPHONE/TV PEDESTALS, AND STREET LIGHT MAIN DISCONNECTS SHALL BE GRADED TO A POSITIVE 2 PERCENT SLOPE FROM TOP OF CURB.
- 12. SIGNAGE AND TRAFFIC CONTROL DEVICES ARE SAFETY ITEMS AND SHALL BE INSTALLED PRIOR TO ISSUANCE OF ANY CERTIFICATE OF OCCUPANCY OR PLAT APPROVAL. HOWEVER, IN LARGER DEVELOPMENTS, EXACT LOCATIONS OF STOP AND YIELD SIGNS MAY NEED TO BE DETERMINED AFTER FULL BUILDOUT WHEN TRAFFIC PATTERNS HAVE BEEN ESTABLISHED. IN THIS CASE, CONTRACTOR SHALL PROVIDE INDICATED "CITY-PLACED" SIGNS, SIGNPOSTS, AND BRACKETS TO THE CITY SIGN SPECIALIST (253) 841-5471 FOR LATER INSTALLATION BY THE CITY. ALL SIGNAGE SHALL BE IN ACCORDANCE WITH THE MANUAL ON UNIFORM TRAFFIC CONTROL DEVICES (MUTCD).
- 13. PRIOR TO ANY SIGN OR STRIPING INSTALLATION OR REMOVAL THE CONTRACTOR SHALL CONTACT THE CITY SIGN SPECIALIST (253) 841-5471 TO ARRANGE FOR AN ON-SITE MEETING TO DISCUSS PLACEMENT AND UNIFORMITY.
- 14. NEW OR REVISED STOP SIGNS OR YIELD SIGNS SHALL BE ADVANCE WARNED USING THE PROCEDURE OUTLINED IN THE MUTCD. ADVANCE WARNING SIGNS AND FLAGS SHALL BE MAINTAINED BY INSTALLER FOR 30 DAYS AND THEN REMOVED.



PUYALLUP 2ND STREET APARTMENTS

ent: SPP MANUFACTURING

> P.O.BOX 64160 TACOMA, WA 98464

> > DON HUBER

<u>Project No.</u>


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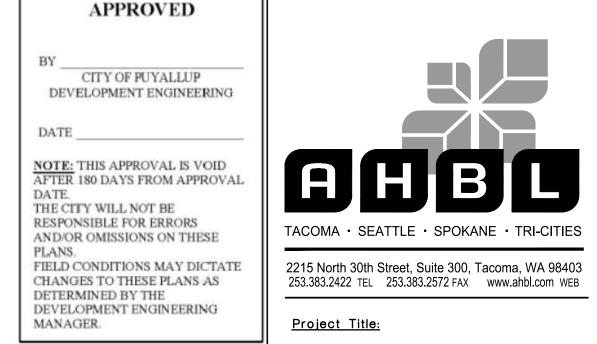
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14 of 36 Shoots

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PUYALLUP 2ND STREET

APARTMENTS

SPP MANUFACTURING

P.O.BOX 64160 TACOMA, WA 98464 DON HUBER

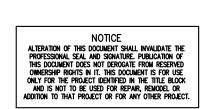2190606.10

SITE DEVELOPMENT

PERMIT SET


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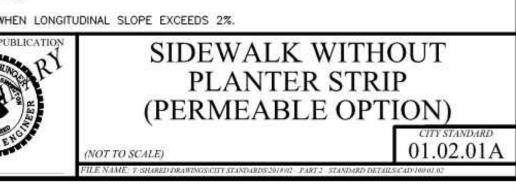
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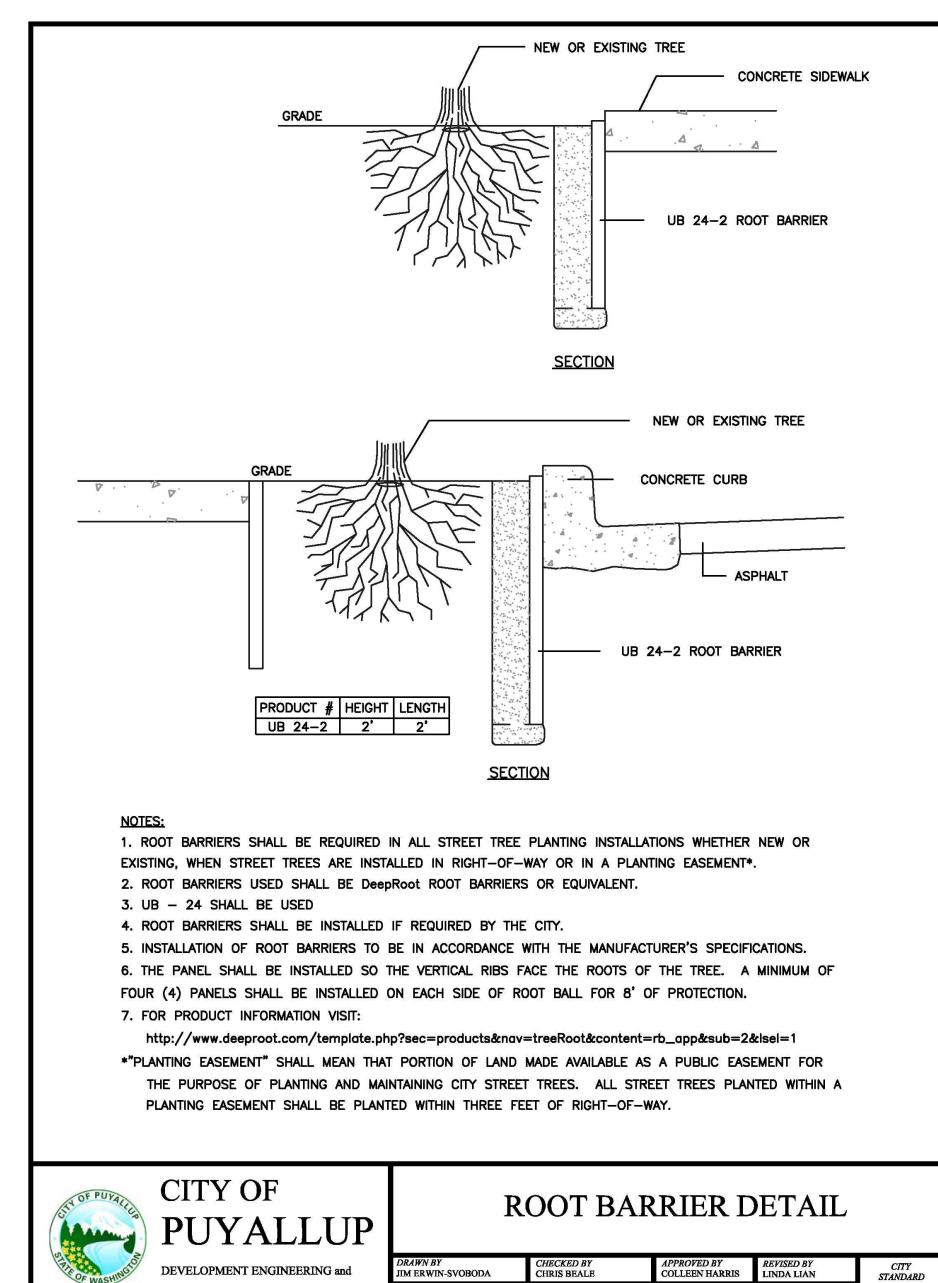
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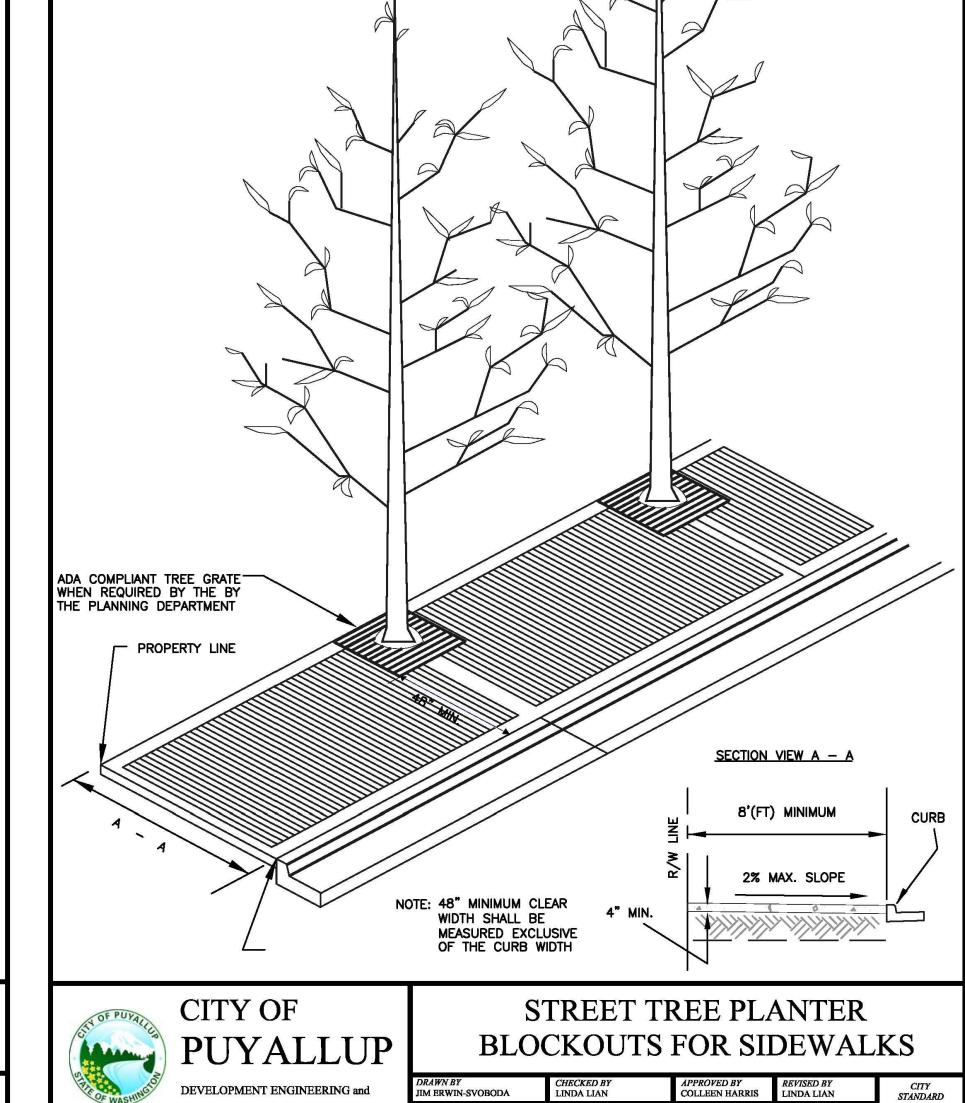
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O1.02.03

PUBLIC WORKS DEPARTMENTS

STREET TREE P

3 STREET TREE PLANTER BLOCKOUTS FOR SIDEWALKS

FILE NAME
F:\DWG\COMMON\STDS\CITY\2009\01 STR\01.02\01.02.04

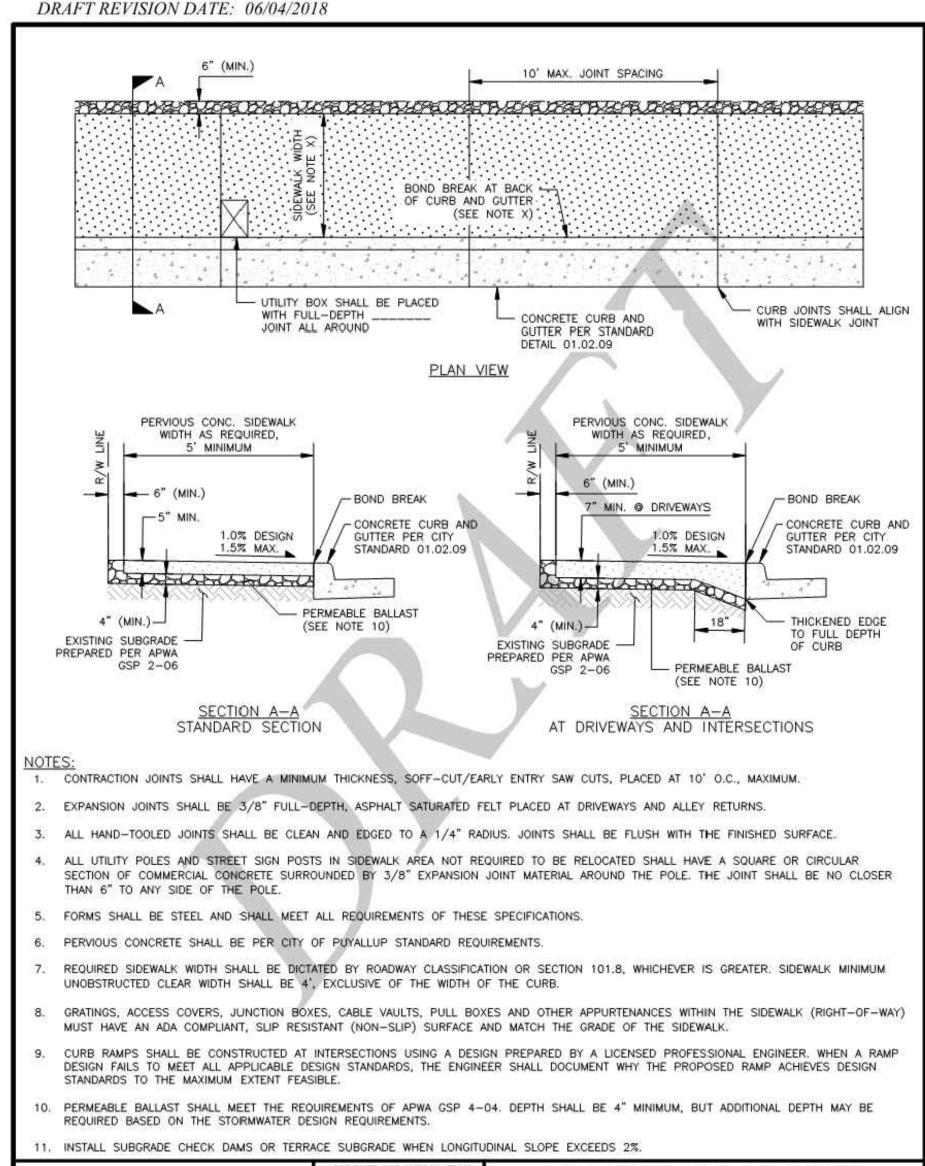SIDEWALK WITHOUT PLANTING STRIP

CITY OF

OFFICE

THE CITY ENGINEER

PUYALLU

2 ROOT BARRIER DETAIL

PUBLIC WORKS DEPARTMENTS

DRAINAGE NOTES
AND DETAILS

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Sheet No.


<u>Revisions:</u>

Sheet Title:

01.02.04

C3.315 of 26 Sheets

A PORTION OF THE NW 1/4 OF THE NW 1/4 OF SEC. 27, TWN. 20 N., RGE. 04 E. W.M. CITY OF PUYALLUP, PIERCE COUNTY, WASHINGTON.

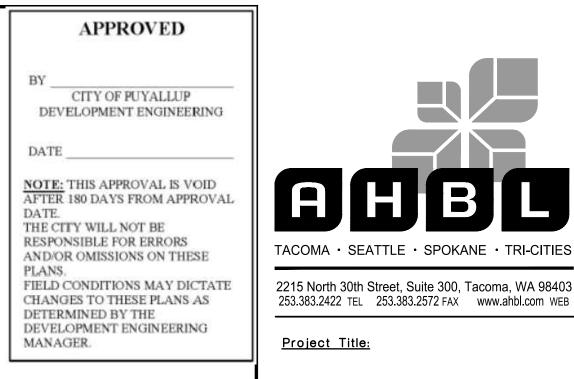

PUYALLUP 2ND STREET

APARTMENTS

SPP MANUFACTURING

P.O.BOX 64160

TACOMA, WA 98464

DON HUBER

2190606.10

SITE DEVELOPMENT

PERMIT SET


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Project No.


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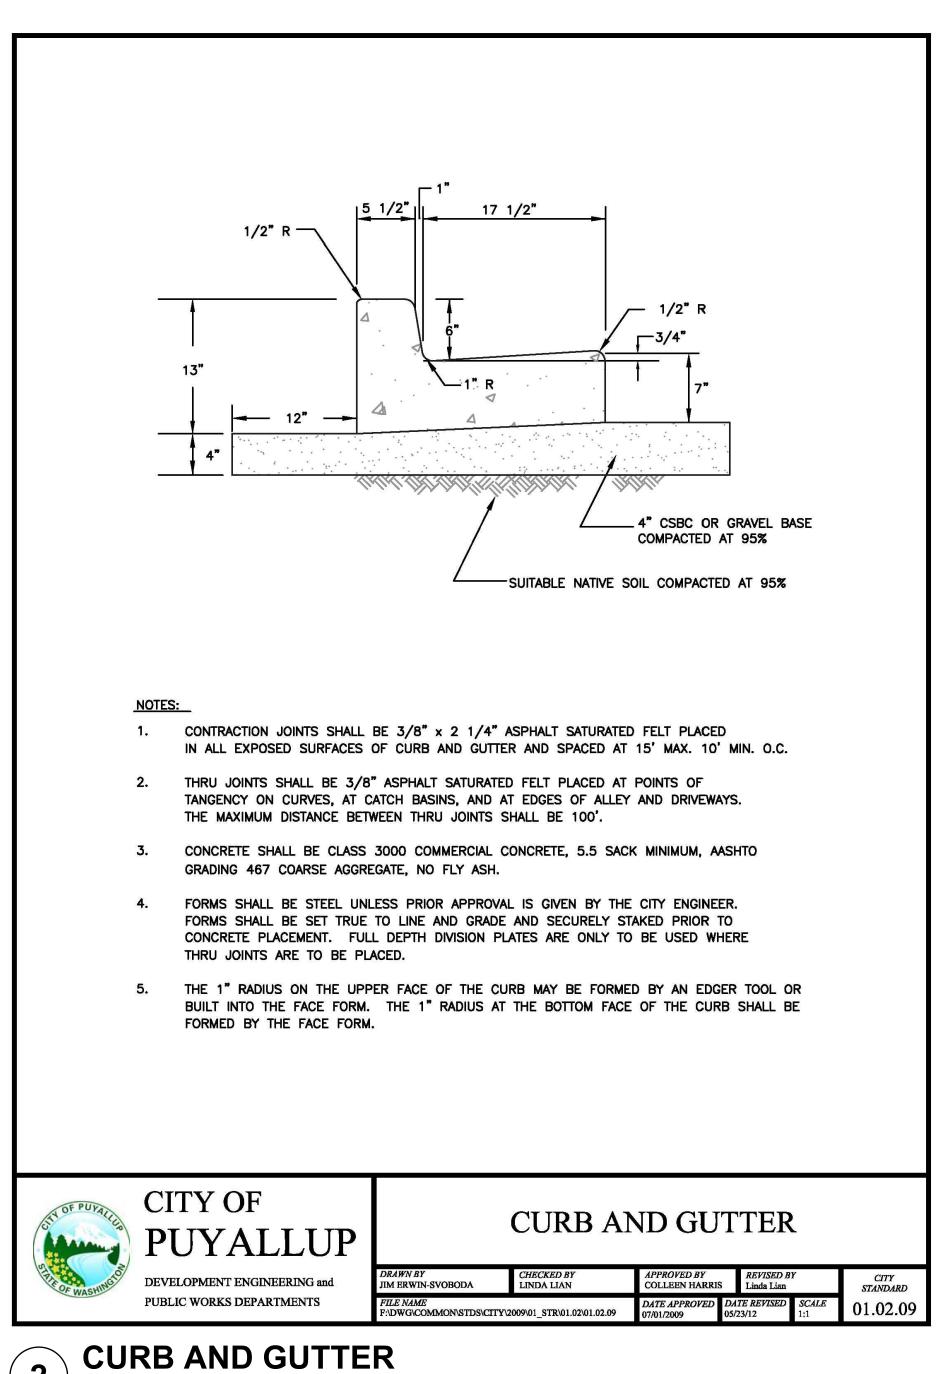
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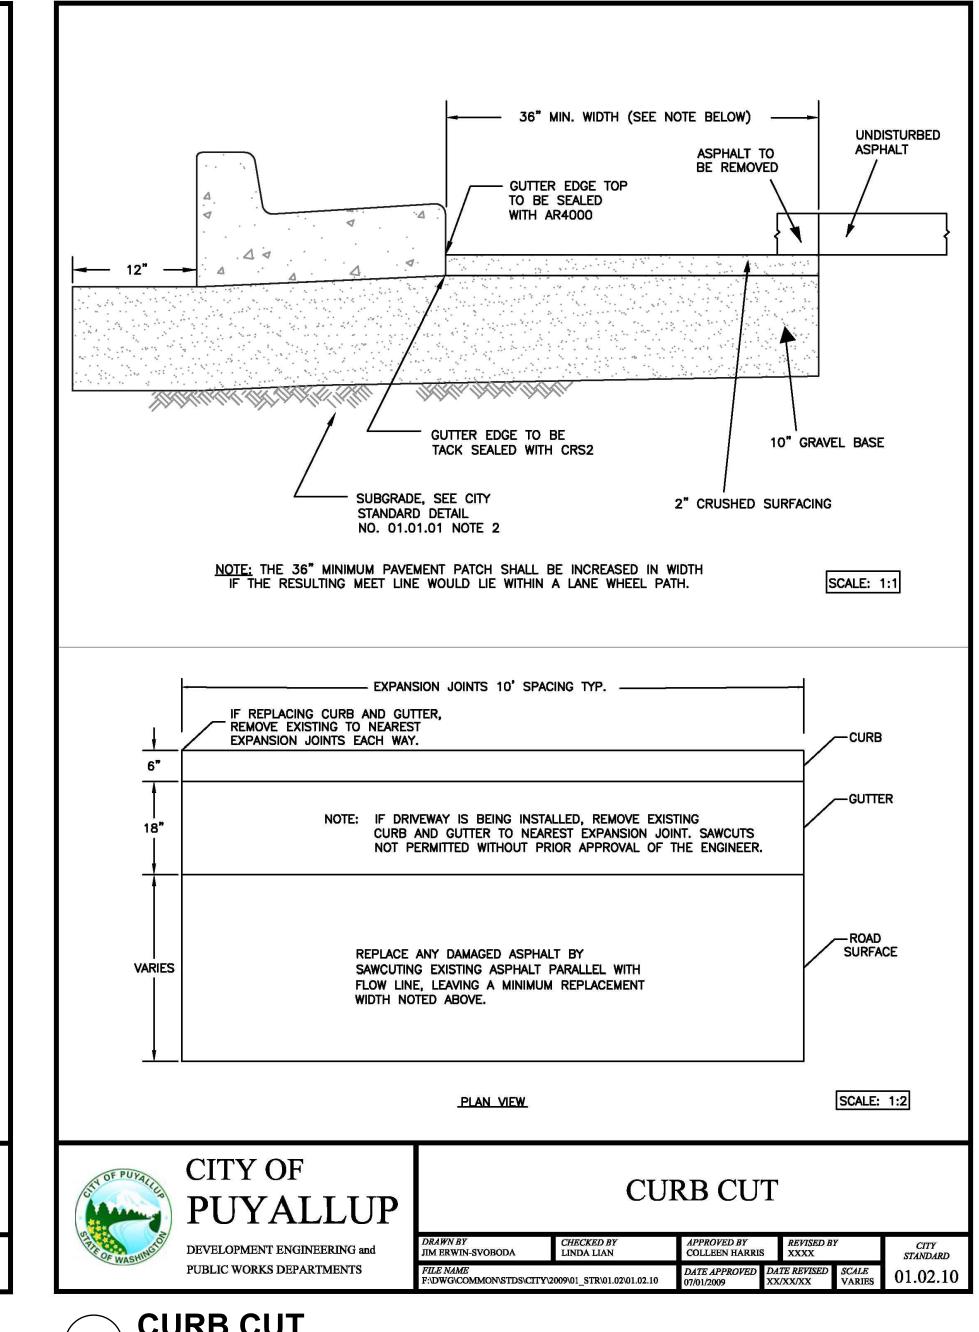
1. ALL SOIL AREAS DISTURBED OR COMPACTED DURING CONSTRUCTION, AND NOT COVERED BY BUILDINGS OR PAVEMENT, SHALL BE AMENDED WITH

- 2. SUBSOIL SHOULD BE SCARIFIED (LOOSENED) 4 INCHES BELOW AMENDED LAYER, TO PRODUCE 12—INCH DEPTH OF UN—COMPACTED SOIL, EXCEPT WHERE SCARIFICATION WOULD DAMAGE TREE ROOTS OR AS DETERMINED BY THE ENGINEER. SEE NOTE BELOW REGARDING PLANTING STEPS FOR STREET TREES.
- 3. COMPOST SHALL BE TILLED IN TO 8 INCH DEPTH INTO EXISTING SOIL, OR PLACE 8 INCHES OF COMPOST-AMENDED SOIL, PER SOIL
- SPECIFICATION. 4. PLANTING BEDS SHALL RECEIVE 3 INCHES OF COMPOST TILLED IN TO 8-INCH DEPTH, OR MAY SUBSTITUTE 8" OF IMPORTED SOIL CONTAINING 35-40% COMPOST BY VOLUME. MULCH AFTER PLANTING, WITH 4 INCHES OF ARBORIST WOOD CHIP MULCH OR APPROVED EQUAL (6" OF LOOSE WOOD CHIPS AT THE TIME OF PLANTING TO ALLOW SETTLING TO 4").
- 5. SETBACKS: TO PREVENT UNEVEN SETTLING, DO NOT COMPOST-AMEND SOILS WITHIN 3 FEET OF UTILITY INFRASTRUCTURES (POLES, VAULTS, METERS ETC.). WITHIN ONE FOOT OF PAVEMENT EDGE, CURBS AND SIDEWALKS SOIL SHOULD BE COMPACTED TO APPROXIMATELY 95% PROCTOR TO ENSURE A FIRM SURFACE.
- 6. SEE SECTION 8.2(B) OF THE VMS FOR SOIL AMENDMENT AND INSTRUCTION PROCEDURES FOR STREET TREE PLANTER STRIPS. ALL STREET TREE PLANTER STRIPS SHALL RECEIVE 40% COMPOST AMENDED SOIL TO THE FULL DEPTH OF THE STREET TREE ROOTBALL.





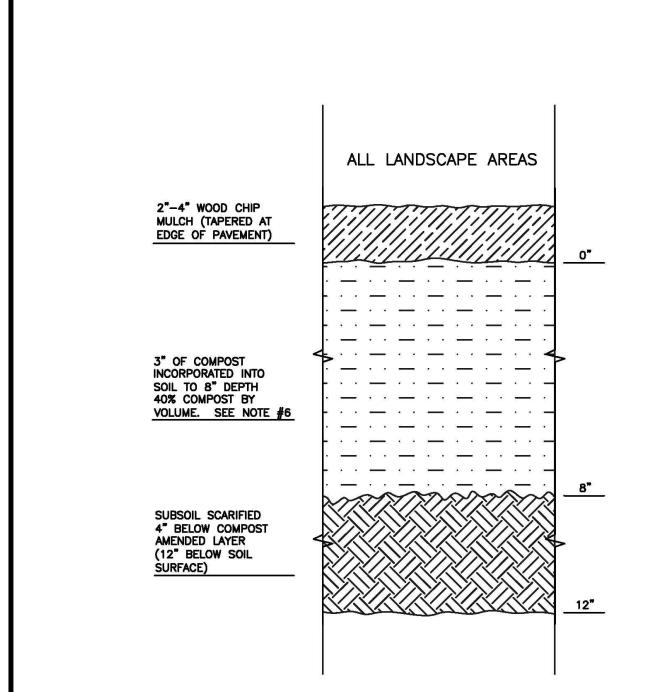

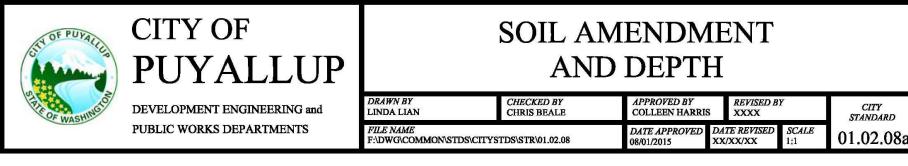



Know what's below. Call before you dig. **DRAINAGE NOTES AND DETAILS**


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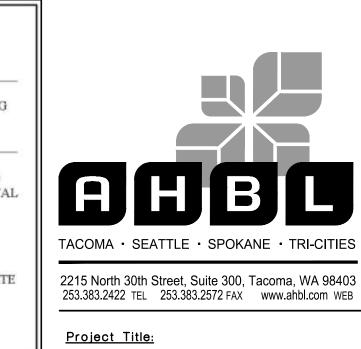
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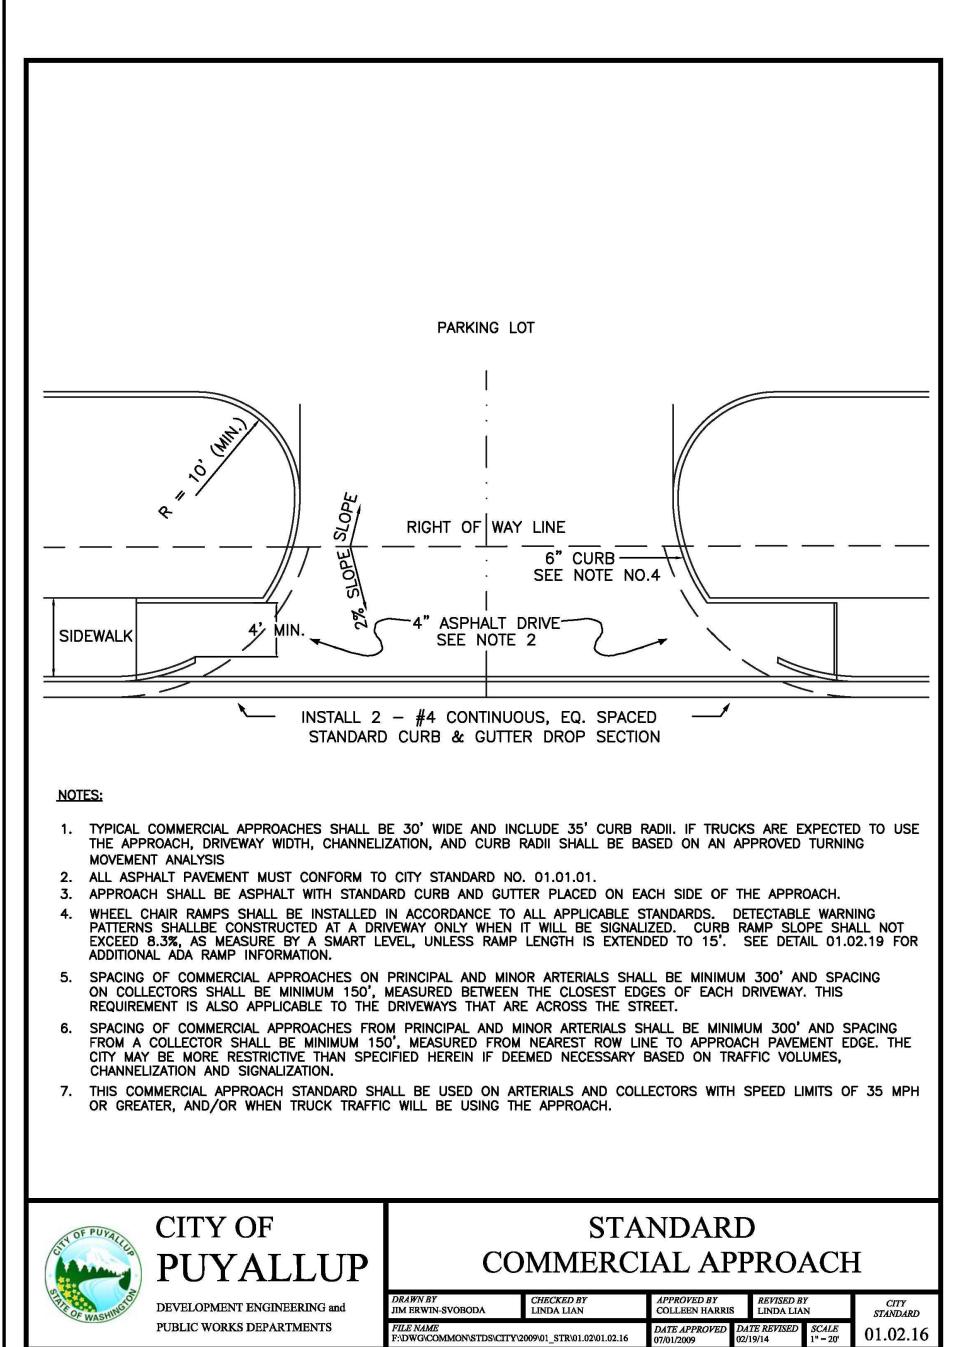
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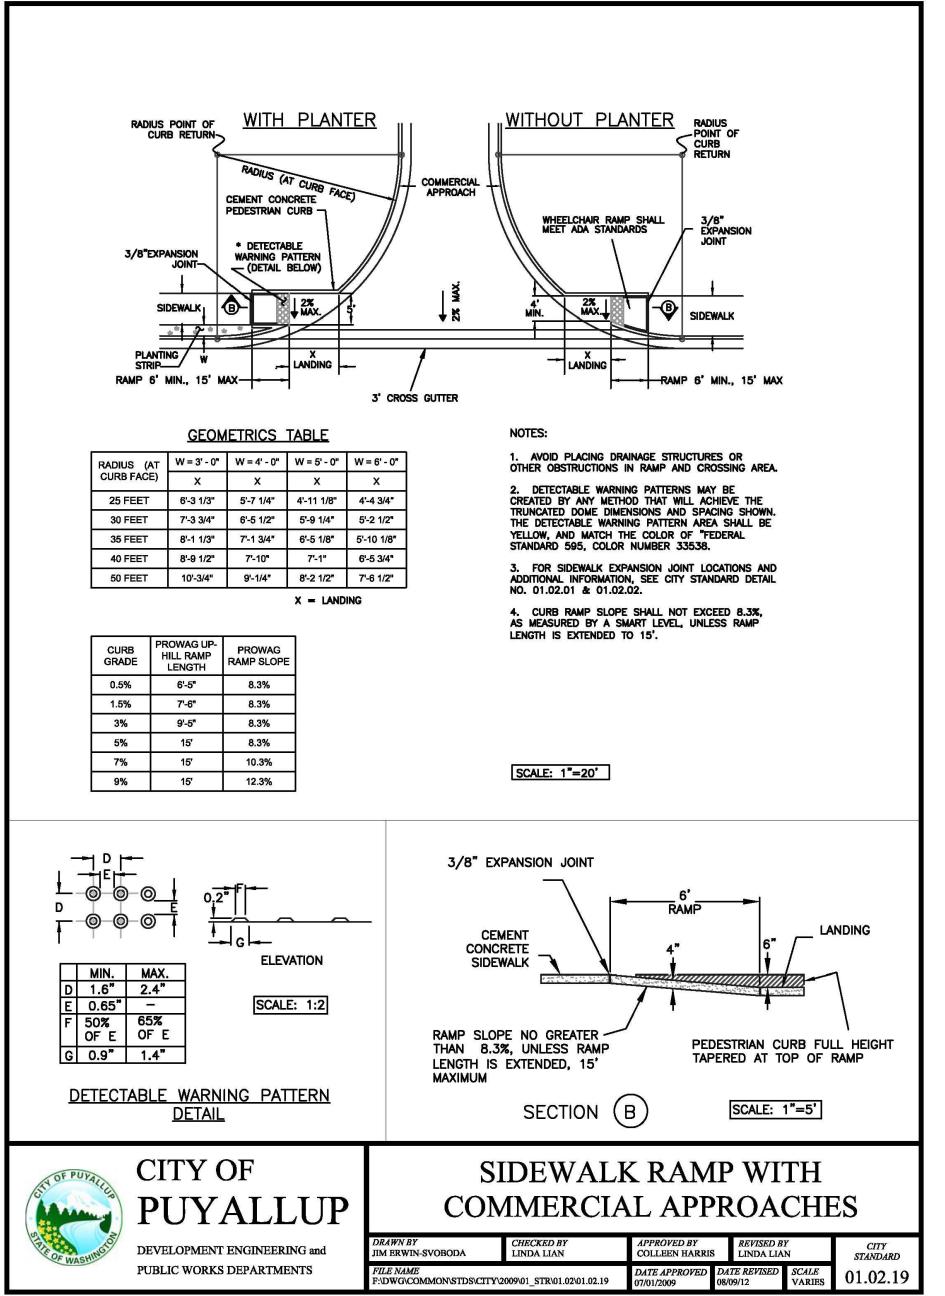
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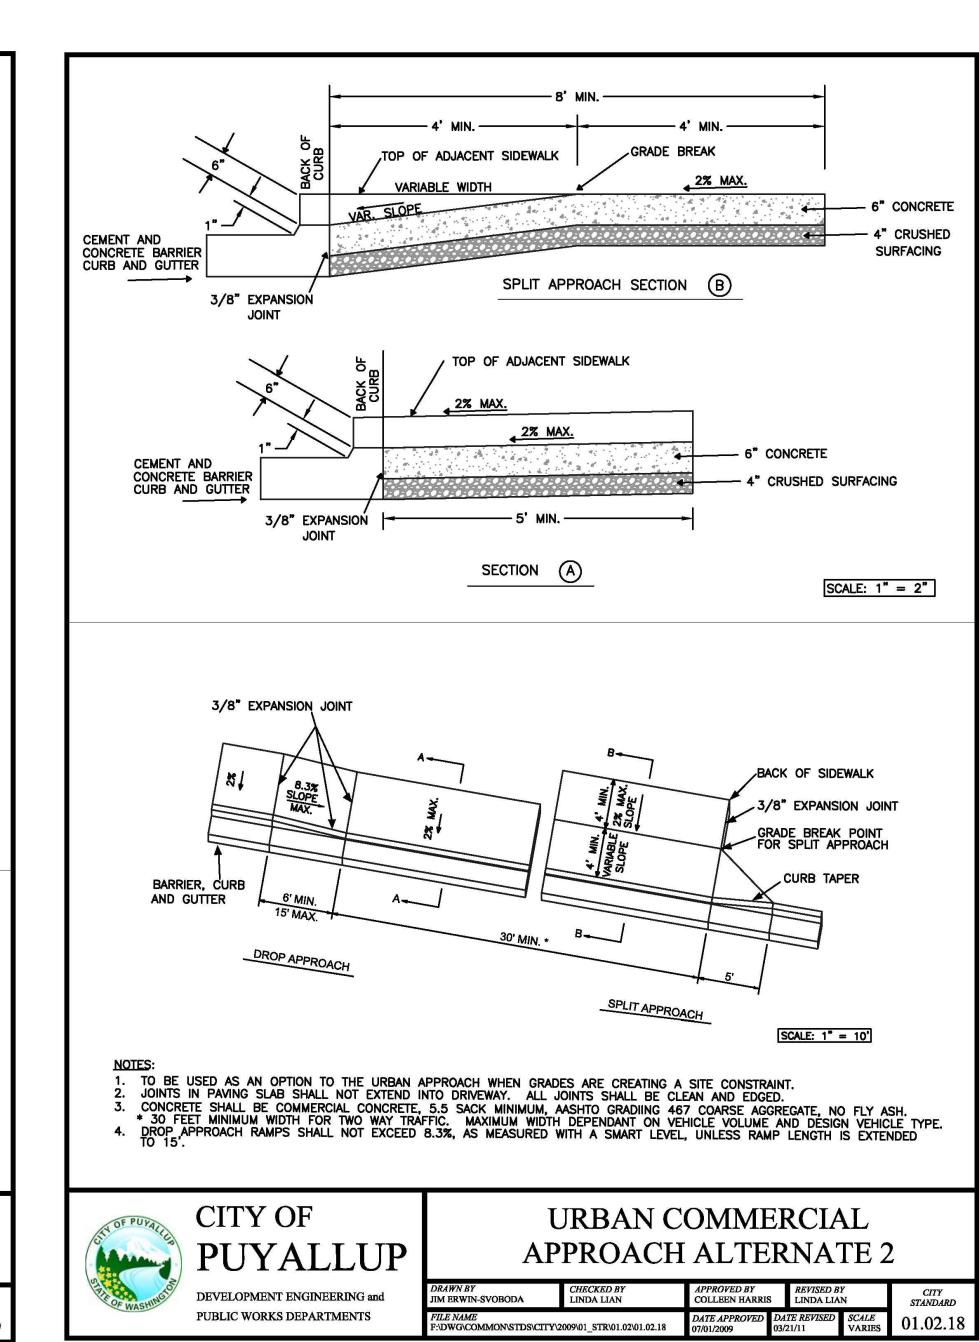








SIDEWALK RAMP WITH COMMERCIAL APPROACH

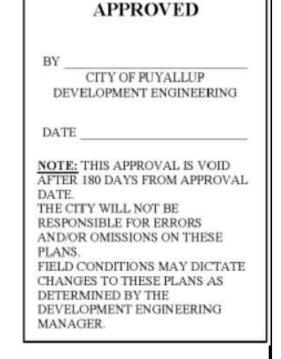





SPP MANUFACTURING

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<u>Project No.</u>


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SITE DEVELOPMENT **PERMIT SET**

2/7/2024





Revisions:
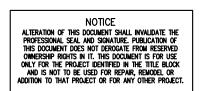
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DRAINAGE NOTES AND DETAILS

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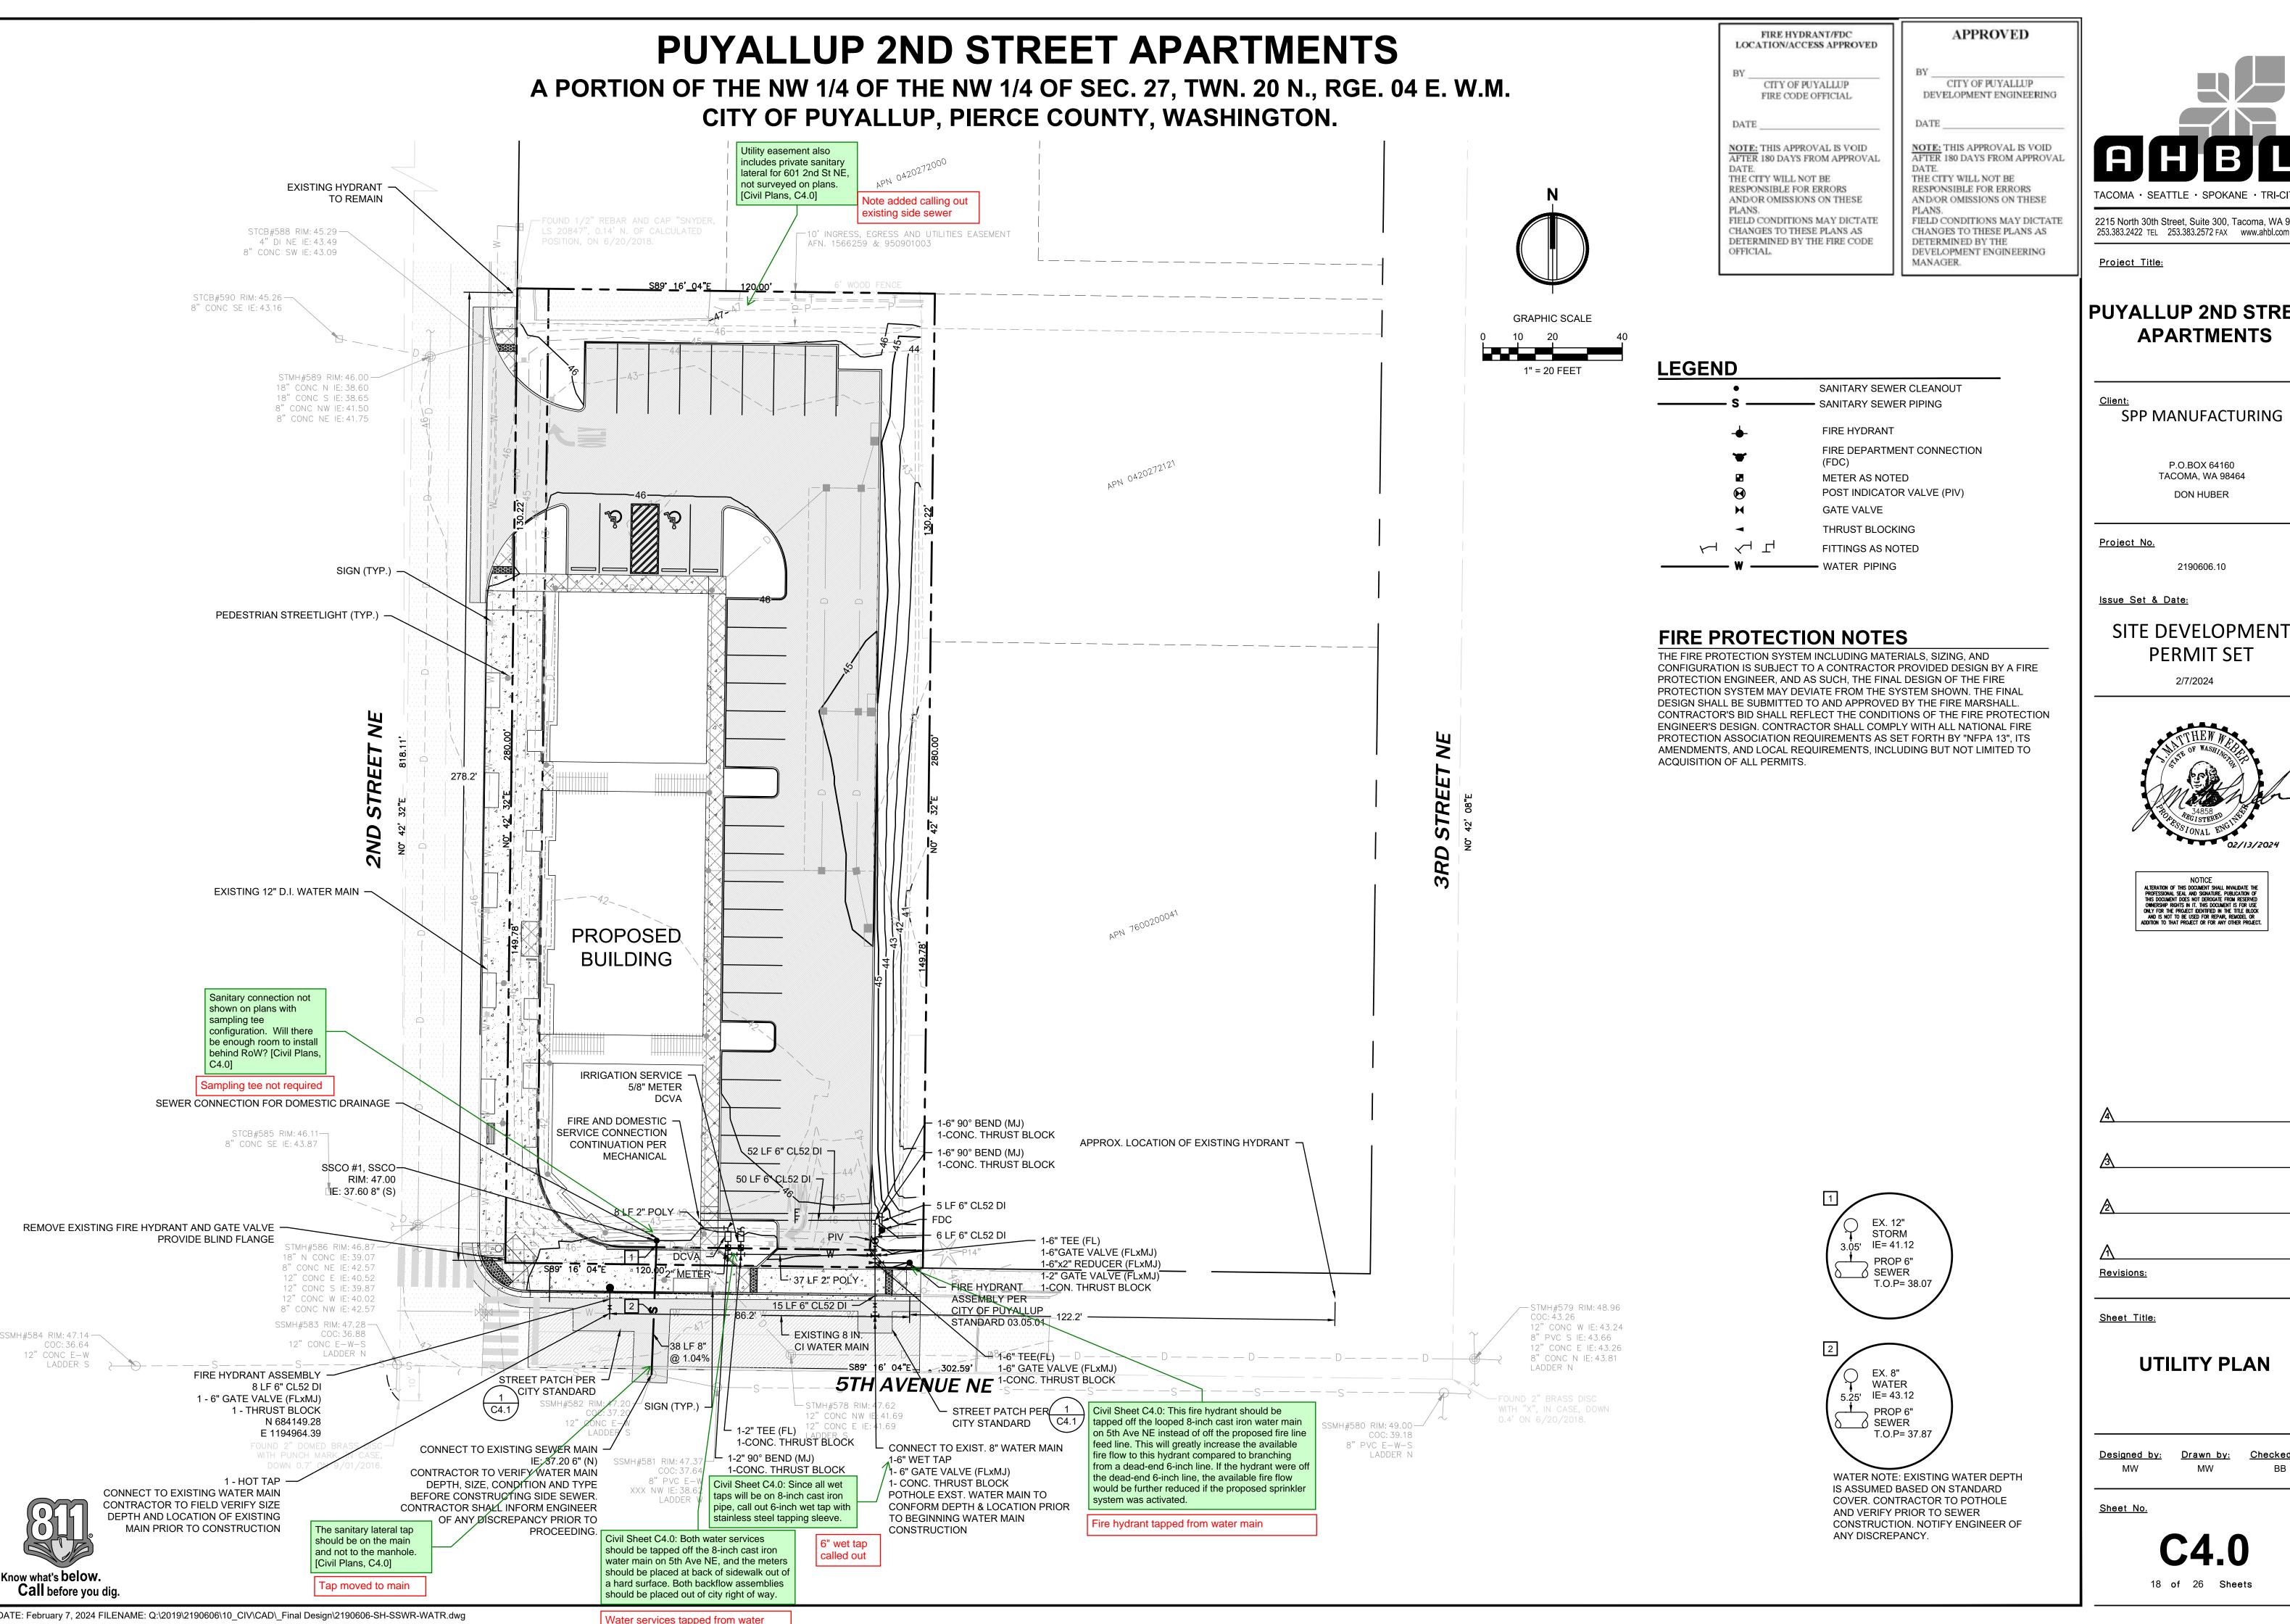
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17 of 26 Sheets

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STANDARD COMMERCIAL APPROACH




2215 North 30th Street, Suite 300, Tacoma, WA 98403 253.383.2422 TEL 253.383.2572 FAX www.ahbl.com WEB


PUYALLUP 2ND STREET **APARTMENTS**

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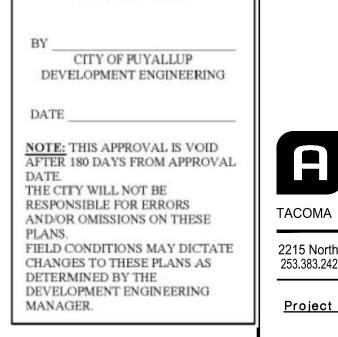
UTILITY PLAN

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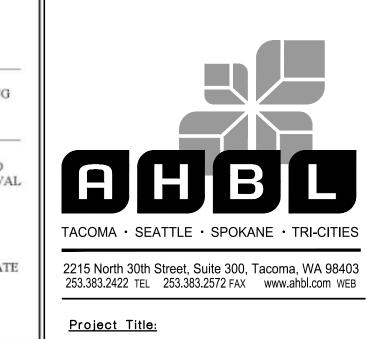
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Water services tapped from water

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APPROVED

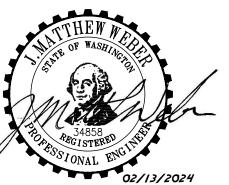

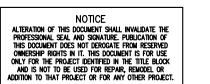APARTMENTS

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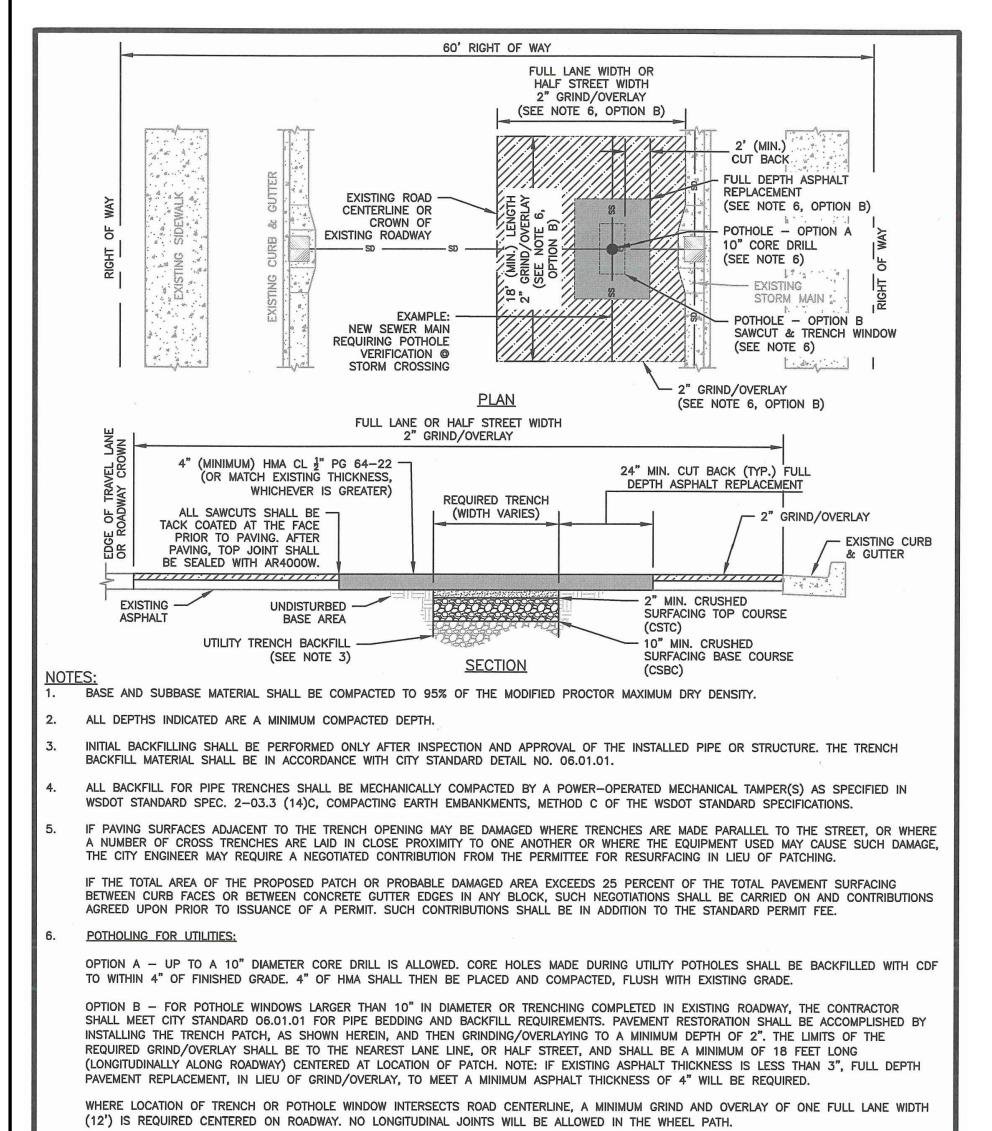
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ALL MANHOLE FRAMES, VALVE FRAMES AND MONUMENT COVERS SHALL BE INSTALLED AFTER PLACEMENT OF ASPHALT. IF MORE THAN ONE LIFT

STREET PATCH


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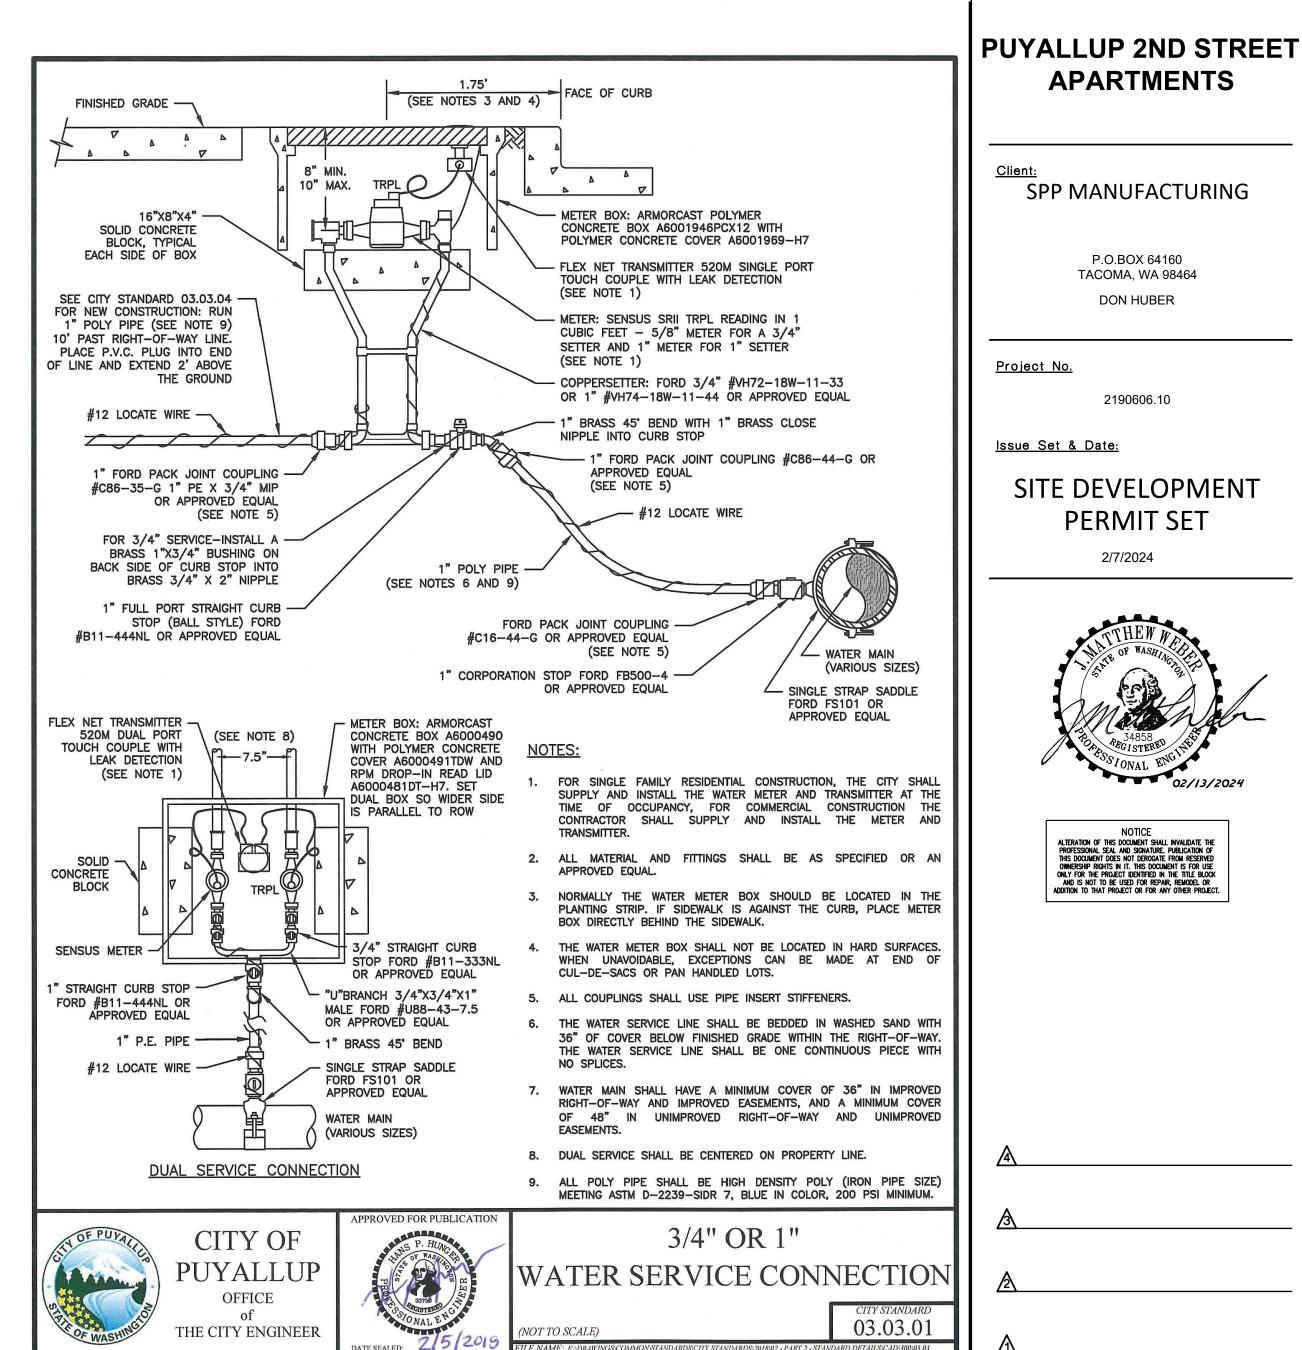
IS NECESSARY, FRAMES AND LIDS WILL BE ADJUSTED TO FINISH GRADE AT FIRST LIFT AS DIRECTED BY THE CITY.

OFFICE

THE CITY ENGINEER

STREET PATCH



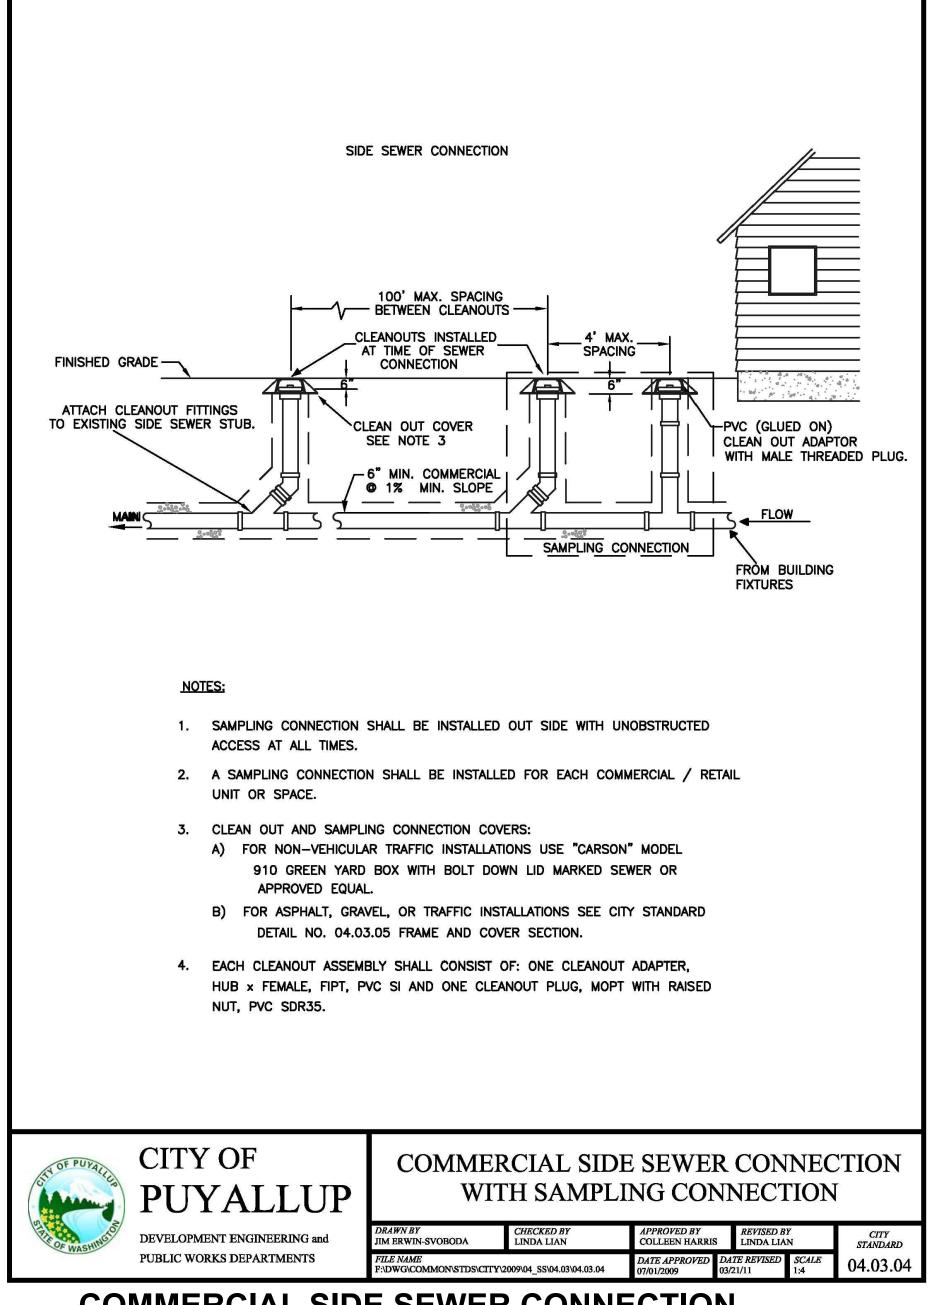







WATER AND SEWER NOTES AND DETAILS Designed by: Drawn by: Checked by:


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TACOMA · SEATTLE · SPOKANE · TRI-CITIES 2215 North 30th Street, Suite 300, Tacoma, WA 98403 253.383.2422 TEL 253.383.2572 FAX www.ahbl.com WEB Project Title:

PUYALLUP 2ND STREET **APARTMENTS**

APPROVED

CITY OF PUYALLUP DEVELOPMENT ENGINEERING

NOTE: THIS APPROVAL IS VOID AFTER 180 DAYS FROM APPROVAL

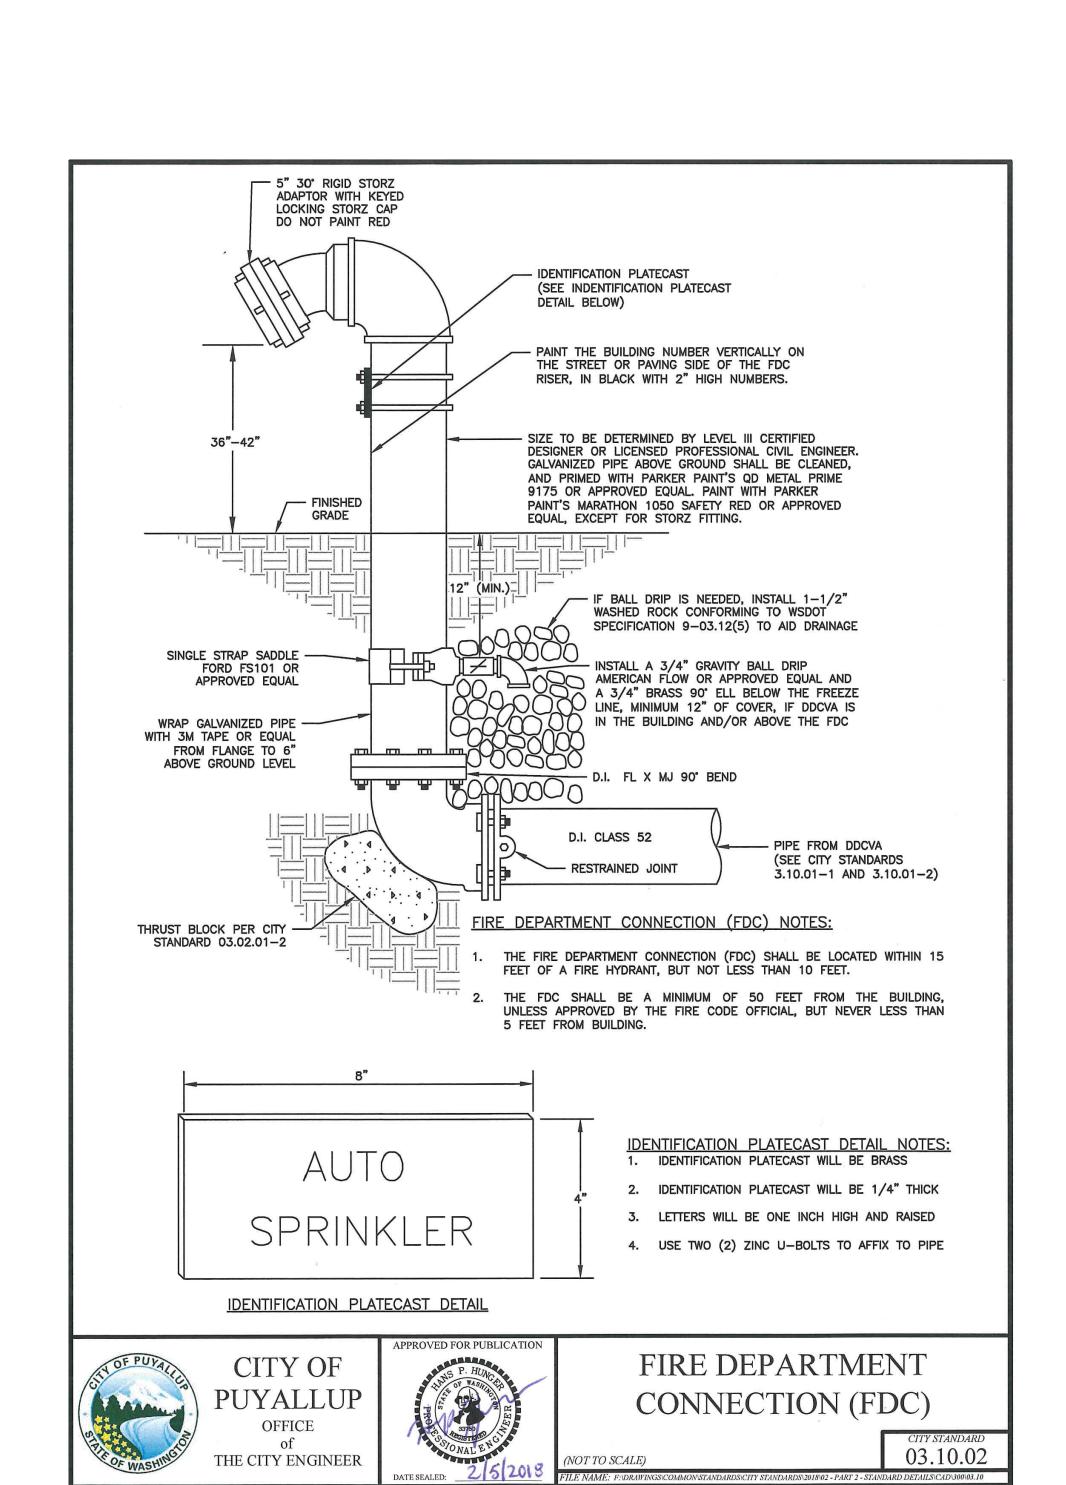AND/OR OMISSIONS ON THESE

FIELD CONDITIONS MAY DICTATE

CHANGES TO THESE PLANS AS

DEVELOPMENT ENGINEERING

THE CITY WILL NOT BE RESPONSIBLE FOR ERRORS

DETERMINED BY THE

DATE

PLANS.

MANAGER.

SPP MANUFACTURING

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<u>Project No.</u>


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Issue Set & Date:

SITE DEVELOPMENT **PERMIT SET**

2/7/2024



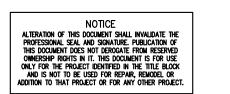

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<u>Revisions:</u>

Sheet Title:

WATER AND SEWER NOTES AND DETAILS

Designed by: Drawn by: Checked by: MW

Sheet No.

20 of 26 Sheets

CONCRETE GUARD POSTS, 9"

DIA. X 6' LONG WITH 5-1/2" DIA. X 5'-8" LONG, REBAR

PAINT SAME AS FIRE HYDRANT

NOTE: CONCRETE GUARD POSTS SHALL

BE INSTALLED WHEN REQUIRED

DO NOT INSTALL GUARD POSTS

(SEE NOTES 3, 4, AND 5)

- STORZ COUPLING

2' MIN. TO 20' MAX.

(SEE NOTES 7 & 8)

12X12X4 SOLID CONCRETE

BEARING BLOCK ON

THE FIRE HYDRANT AND CONCRETE GUARD POSTS SHALL BE PAINTED, RUST-OLEUM SAFETY YELLOW #7543 (TWO COATS) OR AN APPROVED EQUAL. THE STORZ FITTING SHALL NOT BE PAINTED.

(#8 TACOMA STEAMER PORT THREAD) WITH A 5" 'STORZ' COUPLING AND BLIND CAP INSTALLED ON THE STEAMER PORT, (STEAMER PORT SHALL

DRAINS AND 5-1/4" MAIN VALVE OPENING. HYDRANTS SHALL BE DESIGNED IN A MANNER THAT WILL PREVENT BARREL BREAKAGE WHEN STRUCK

GATE VALVES SHALL CONFORM TO THE LATEST AWWA SPECIFICATIONS FOR COLD WATER, RESILIENT SEATED WEDGE GATE VALVES, 200 PSI WORKING PRESSURE. THEY SHALL BE IRON—BODIED BRONZE—MOUNTED, NON—RISING STEM, COUNTER—CLOCKWISE OPENING, MECHANICAL JOINT BY FLANGED. VALVE STEMS SHALL BE PROVIDED WITH O—RING SEALS AND SHALL BE AS MANUFACTURED BY THE MUELLER COMPANY OR APPROVED

THE HOLDING SPOOL SHALL BE A MECHANICAL-JOINT (M.J.) HOLDING SPOOL, WITH THE USE OF MEGA-LUG CONNECTORS OR APPROVED EQUAL

3. IF DISTANCE BETWEEN WATER MAIN AND FIRE HYDRANT IS GREATER THAN 17 FEET, RESTRAINED JOINTS ARE REQUIRED ON ANY ADDITIONAL JOINTS. THE MAXIMUM 6-INCH HYDRANT RUN ALLOWED IS 20 FEET. ANY PROPOSED HYDRANT RUN EXCEEDING 20' IN LENGTH SHALL BE SIZED USING AN ENGINEERED HYDRAULIC FIRE FLOW MODEL. ANY HYDRANT RUN EXCEEDING 50 FEET IN LENGTH SHALL BE NO LESS THAN 8-INCHES IN DIAMETER.

12. A MINIMUM THREE FOOT (3') RADIUS UNOBSTRUCTED CLEAR ZONE (WORK AREA) SHALL BE PROVIDED AROUND ALL FIRE HYDRANTS. ADDITIONALLY,

NO WOODY LANDSCAPE SHALL BE PLANTED WITHIN TEN FEET (10') OF ANY FIRE HYDRANT. OVERREACHING BRANCHES OF TREES ADJACENT TO

NOT TO SCALE)

BY A VEHICLE. HYDRANTS SHALL CONFORM TO THE LATEST REVISION OF AWWA SPECIFICATIONS NO. C 502-73 FOR FIRE HYDRANTS FOR ORDINARY WATER SERVICE. FIRE HYDRANTS SHALL INCLUDE THE ENTIRE ASSEMBLY COMPLETE, INCLUDING HYDRANT, GATE VALVE AND BOX, CONNECTING

FACE THE STREET), 1-1/4" PENTAGONAL OPERATING NUT (COUNTER-CLOCKWISE OPENING), O-RING TYPE STUFFING BOX, AUTOMATIC BARREL

. FIRE HYDRANTS SHALL HAVE TWO 2-1/2" HOSE PORTS (NATIONAL STANDARD THREAD) WITH CAPS AND CHAINS AND ONE 4" PUMPER PORT

UNDISTURBED SOIL

(SEE NOTES 3 AND 4)

- EXISTING

ASPHALT

BY THE CITY ENGINEER.

IN CITY RIGHT-OF-WAY.

3' (MIN.) CLEAR ZONE

EQUALLY SPACED.

(SEE NOTE 3)

CLEAR ZONE

(GROUND LEVEL

LANDSCAPING ONLY)

10' MINIMUM CLEARANCE

TO WOODY LANDSCAPE

2-1/2" TO NO GREATER THAN 6"-

(SEE NOTE 10)

UNIMPROVED RIGHT-OF-WAY AND UNIMPROVED EASEMENTS.

THE CITY ENGINEER

FIRE HYDRANT ASSEMBLY

7 C.F. OF 1-1/2" WASHED ROCK — CONFORMING TO WSDOT

WRAPPED WITH GEOTEXTILE FABRIC

PIPING, FITTINGS, AND ACCESSORIES.

WITH CLASS 52 DUCTILE IRON PIPE.

BREAKWAY FLANGE OR -BREAKWAY LUGS

. ALL MATERIALS AND FITTINGS SHALL BE AS SPECIFIED OR APPROVED EQUAL.

5. FIRE HYDRANTS SHALL BE AVK, CLOW MEDALLION, M & H 129S, MUELLER CENTURION, OR WATEROUS.

9. FIRE HYDRANTS SHALL BE LOCATED A MINIMUM OF 50 FEET FROM A BUILDING OR STRUCTURE.

10. THE CONTRACTOR SHALL PLACE A 6 OZ. GEOTEXTILE FABRIC AROUND THE WASHED ROCK AREA, ENDS TO OVERLAP.

11. A FLUORESCENT ORANGE BAG MUST COVER AND BE SECURED TO THE FIRE HYDRANT UNTIL APPROVED FOR USE BY CITY ENGINEER.

HYDRANTS SHALL HAVE A MAINTAINED VERTICAL CLEARANCE OF SEVEN (7') FEET ABOVE FINISHED GRADE OF THE FIRE HYDRANT.

3' (MIN.)

- GUARD POST

GUARD POST DETAIL

NOTE: TOP OF POST SHALL BE NOT

FOOTING SHALL BE NOT LESS THAN

OF CRUSHED COMPACTED ROCK

CONFORMING TO NOTE 2, CITY

STANDARD 06.01.01, FILLED TO

WITHIN 4" OF GROUND LEVEL

15" IN DIAMETER AND SHALL CONSIST

VALVE BOX SHALL BE INSTALLED AS SPECIFIED IN

CITY STANDARD 03.01.01 -

WATER VALVES AND MAIN

(FLG X MJ TEE)

(SEE NOTE 2)

FIRE HYDRANT ASSEMBLY

03.05.01


6" GATE VALVE


(FLG X MJ)


(SEE NOTE 6)

LESS THAN 3 FEET ABOVE

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2 INCH AND SMALLER DCVA

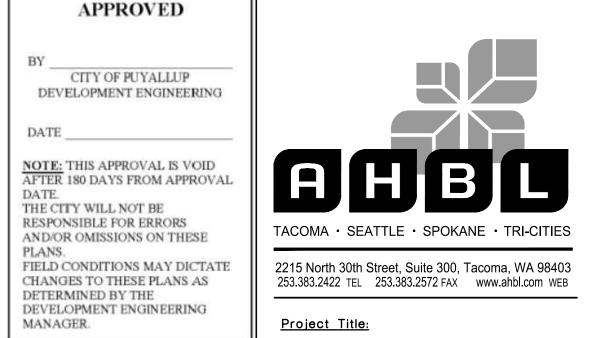SANITARY SEWER NOTES:

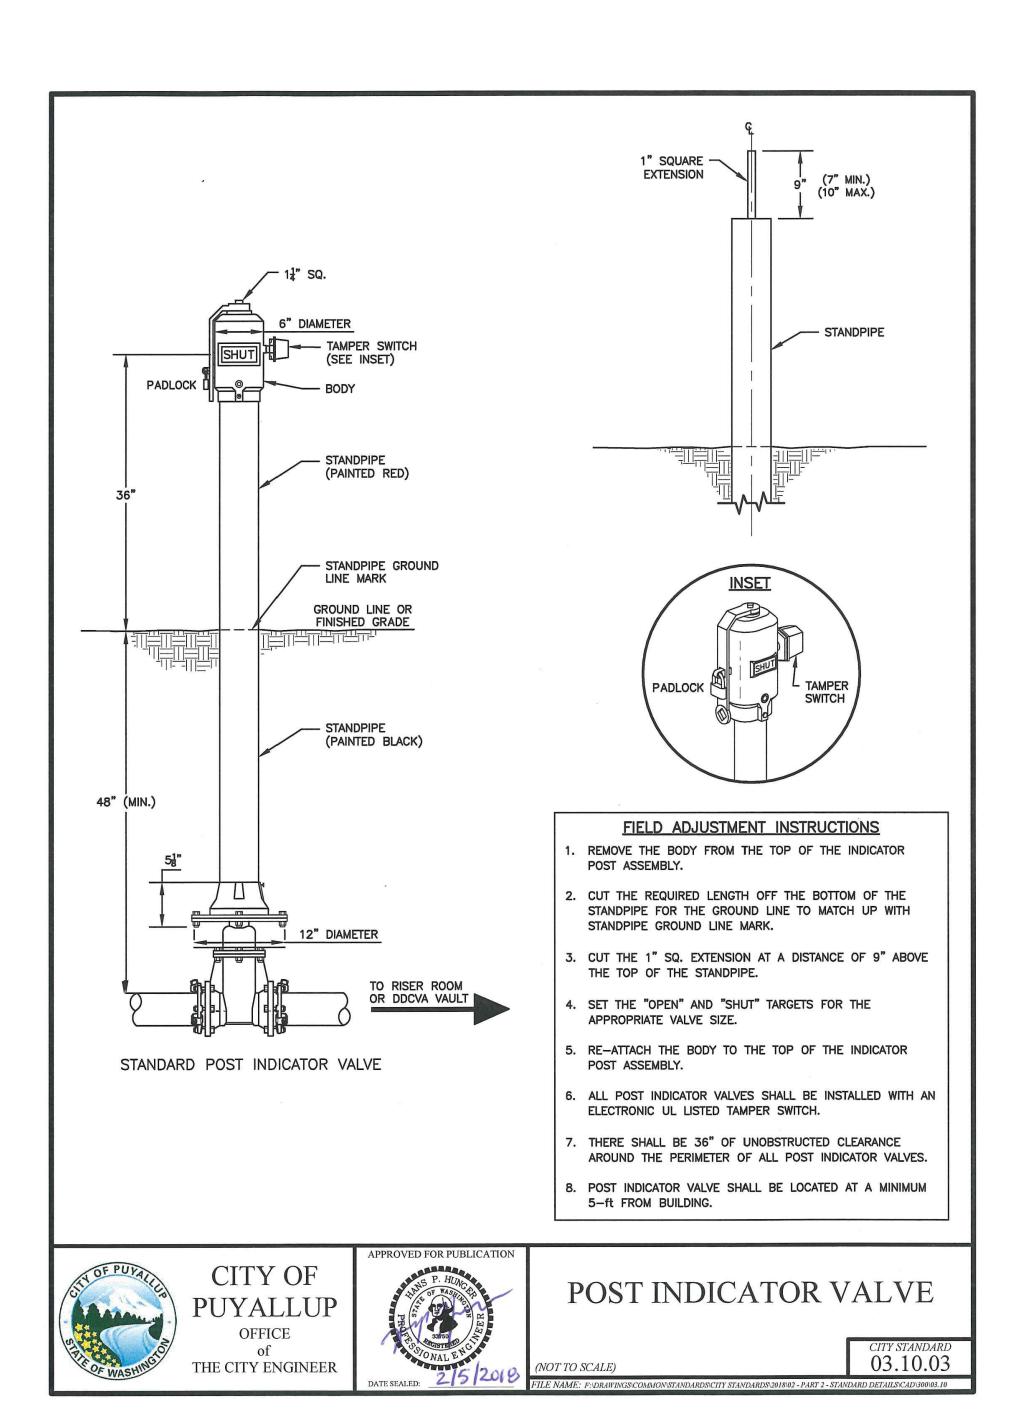- ALL WORK IN CITY RIGHT-OF-WAY REQUIRES A PERMIT FROM THE CITY OF PUYALLUP. PRIOR TO ANY WORK COMMENCING, THE GENERAL CONTRACTOR SHALL ARRANGE FOR A PRECONSTRUCTION MEETING AT THE DEVELOPMENT SERVICES CENTER TO BE ATTENDED BY ALL CONTRACTORS THAT WILL PERFORM WORK SHOWN ON THE ENGINEERING PLANS, REPRESENTATIVES FROM ALL APPLICABLE UTILITY COMPANIES, THE PROJECT OWNER AND APPROPRIATE CITY STAFF. CONTACT ENGINEERING SERVICES TO SCHEDULE THE MEETING (253) 841-5568. THE CONTRACTOR IS RESPONSIBLE TO HAVE THEIR OWN APPROVED SET OF PLANS
- 2. AFTER COMPLETION OF ALL ITEMS SHOWN ON THESE PLANS AND BEFORE ACCEPTANCE OF THE PROJECT, THE CONTRACTORS SHALL OBTAIN A "PUNCH LIST" PREPARED BY THE CITY'S INSPECTOR DETAILING REMAINING ITEMS OF WORK TO BE COMPLETED. ALL ITEMS OF WORK SHOWN ON THESE PLANS SHALL BE COMPLETED TO THE SATISFACTION OF THE CITY PRIOR TO ACCEPTANCE OF THE SEWER SYSTEM AND PROVISION OF SANITARY SEWER SERVICE.
- ALL MATERIALS AND WORKMANSHIP SHALL CONFORM TO THE STANDARD SPECIFICATIONS FOR ROAD, BRIDGE. AND MUNICIPAL CONSTRUCTION (HEREINAFTER REFERRED TO AS THE "STANDARD SPECIFICATIONS"). WASHINGTON STATE DEPARTMENT OF TRANSPORTATION AND AMERICAN PUBLIC WORKS ASSOCIATION, WASHINGTON STATE CHAPTER, LATEST EDITION, UNLESS SUPERSEDED OR AMENDED BY THE CITY OF PUYALLUP CITY STANDARDS FOR PUBLIC WORKS ENGINEERING AND CONSTRUCTION (HEREINAFTER REFERRED TO AS THE "CITY STANDARDS")
- 4. A COPY OF THESE APPROVED PLANS AND APPLICABLE CITY DEVELOPER SPECIFICATIONS AND DETAILS SHALL BE ON SITE DURING CONSTRUCTION.
- ANY REVISIONS MADE TO THESE PLANS MUST BE REVIEWED AND APPROVED BY THE DEVELOPER'S ENGINEER AND THE ENGINEERING SERVICES STAFF PRIOR TO ANY IMPLEMENTATION IN THE FIELD. THE CITY SHALL NOT BE RESPONSIBLE FOR ANY ERRORS AND/OR OMISSIONS ON THESE PLANS.
- THE CONTRACTOR SHALL HAVE UTILITIES VERIFIED ON THE GROUND PRIOR TO ANY CONSTRUCTION. CALL (811) AT LEAST TWO WORKING DAYS IN ADVANCE. THE OWNER AND HIS/HER ENGINEER SHALL BE CONTACTED IMMEDIATELY IF A CONFLICT EXISTS.
- ANY STRUCTURE AND/OR OBSTRUCTION WHICH REQUIRE REMOVAL OR RELOCATION RELATING TO THIS PROJECT SHALL BE DONE SO AT THE DEVELOPER'S EXPENSE.
- MINIMUM GRADE ON ALL 4 INCH RESIDENTIAL SIDE SEWERS SHALL BE 2 PERCENT AND 6 INCH COMMERCIAL SIDE SEWERS SHALL BE 1 PERCENT: MAXIMUM SHALL BE 8 PERCENT. ALL SIDE SEWERS SHALL BE 6 INCHES WITHIN CITY RIGHT-OF-WAY.
- 9. SIDE SEWERS SHALL BE INSTALLED IN ACCORDANCE WITH CITY STANDARD NOS. 04.03.01, 04.03.02, 04.03.03 AND 04.03.04. SIDE SEWER INSTALLATION WORK SHALL BE DONE IN ACCORDANCE WITH THE WASHINGTON INDUSTRIAL SAFETY AND HEALTH ACT (WISHA).
- 10. ALL SEWER PIPE SHALL BE PVC, POLYPROPYLENE, OR DUCTILE IRON. PVC SEWER PIPE SHALL CONFORM TO ASTM D-3034, SDR35 FOR PIPE SIZES 15-INCH AND SMALLER AND ASTM F679 FOR PIPE SIZES 18- TO 27-INCH, DUCTILE IRON PIPE SHALL BE CLASS 51 OR GREATER, LINED WITH PROTECTO 401TM EPOXY LINING OR EQUIVALENT, UNLESS OTHERWISE NOTED. 12-INCH THROUGH 30-INCH POLYPROPYLENE PIPE (PP) SHALL BE DUAL WALLED, HAVE A SMOOTH INTERIOR AND EXTERIOR CORRUGATIONS AND MEET WSDOT 9-05.24(2). IT SHALL MEET OR EXCEED ASTM F2764. PP SHALL HAVE A MINIMUM PIPE STIFFNESS OF 46 PII WHEN TESTED IN ACCORDANCE WITH ASTM D2412. TESTING SHALL BE PER ASTM F1417. TRENCHING, BEDDING, AND BACKFILL SHALL BE IN ACCORDANCE WITH CITY STANDARD NO. 06.01.01. MINIMUM COVER ON PVC AND PP PIPE SHALL BE 3.0 FEET. MINIMUM COVER ON DUCTILE IRON PIPE SHALL BE 1.0 FOOT.
- 11. SANITARY SEWER MANHOLE FRAMES AND COVERS SHALL CONFORM TO CITY STANDARD NO. 06.01.02.
- 12. SANITARY SEWER MANHOLES SHALL CONFORM TO CITY STANDARD NOS. 04.01.01, 04.01.02, 04.01.03 AND 04.01.04. ALL MANHOLES SHALL BE CHANNELED FOR FUTURE LINES AS SPECIFIED ON THESE PLANS. MANHOLE STEPS AND LADDER SHALL CONFORM TO STANDARD NO. 06.01.03.
- 13. SANITARY SEWER PIPE AND SIDE SEWERS SHALL BE 10 FEET AWAY FROM BUILDING FOUNDATIONS AND/OR ROOF LINES WITH THE EXCEPTION OF SIDE SEWERS THAT PROVIDE SERVICE TO A SINGLE-FAMILY RESIDENCE. AT THE DISCRETION OF THE REVIEW ENGINEER, A LICENSED PROFESSIONAL ENGINEER WILL BE REQUIRED TO STAMP THE DESIGN TO ACCOUNT FOR DEPTH OR PROXIMITY TO FOUNDATION, STEEP SLOPES, OR OTHER
- 14. NO SIDE SEWERS SHALL BE CONNECTED TO ANY HOUSE OR BUILDING UNTIL ALL MANHOLES ARE ADJUSTED TO THE FINISHED GRADE OF THE COMPLETED ASPHALT ROADWAY AND THE ASPHALT PATCH AND SEAL AROUND THE RING ARE ACCEPTED.
- 15. FOR COMMERCIAL DEVELOPMENTS IN WHICH SOURCES OF GREASE AND/OR OILS MAY BE INTRODUCED TO THE CITY SANITARY SEWER SYSTEM, A CITY APPROVED GREASE INTERCEPTOR SHALL BE INSTALLED DOWNSTREAM FROM THE SOURCE.
- 16. ONCE SEWER AND ALL OTHER UTILITY CONSTRUCTION IS COMPLETED, ALL SANITARY SEWER MAINS AND SIDE SEWERS SHALL BE TESTED PER SECTION 406 OF THE CITY STANDARDS

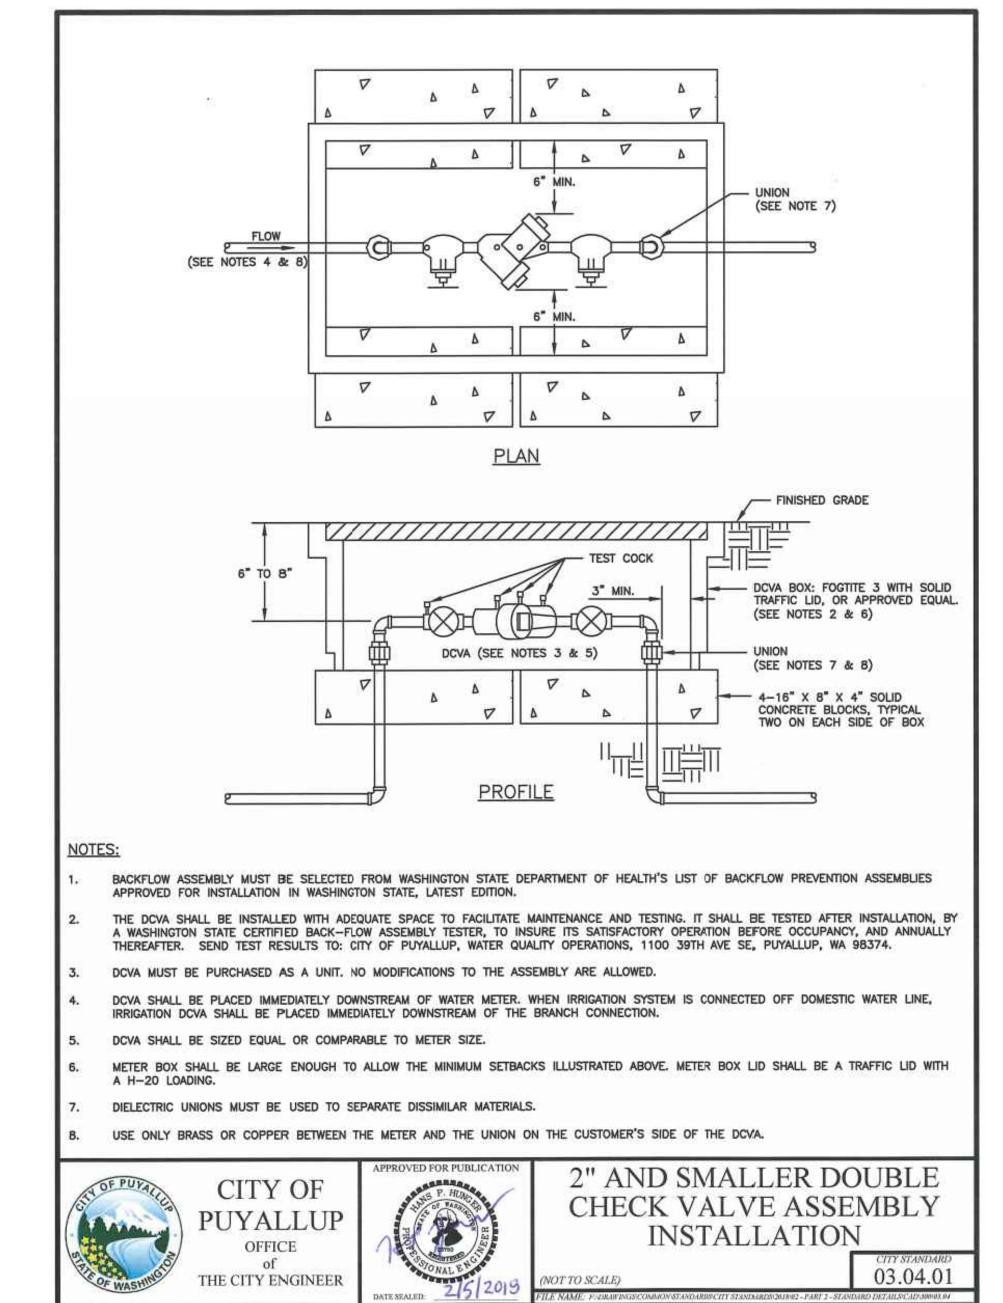PUYALLUP 2ND STREET APARTMENTS

SPP MANUFACTURING

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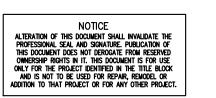
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Issue Set & Date:

SITE DEVELOPMENT **PERMIT SET**





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WATER AND SEWER NOTES AND DETAILS

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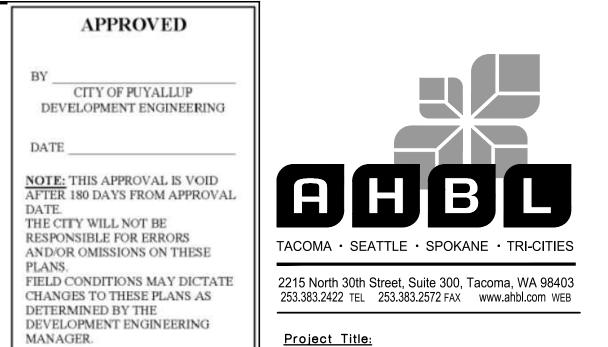
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(now what's below. Call before you dig.

POST INDICATOR VALVE (PIV)

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PUYALLUP 2ND STREET

APARTMENTS

SPP MANUFACTURING

P.O.BOX 64160

TACOMA, WA 98464

DON HUBER

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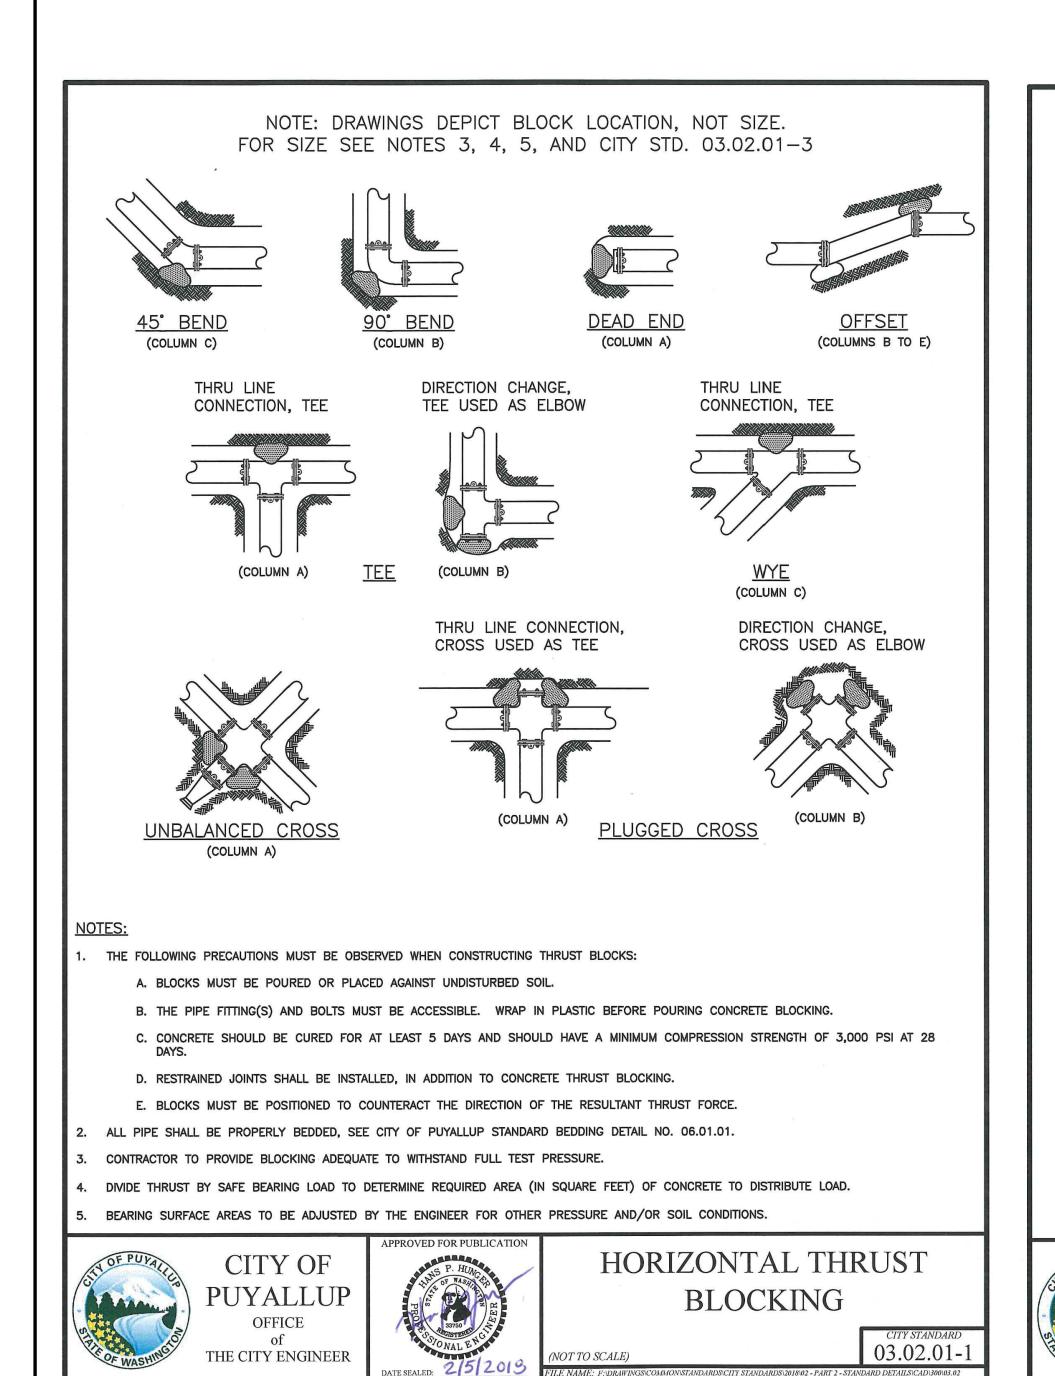
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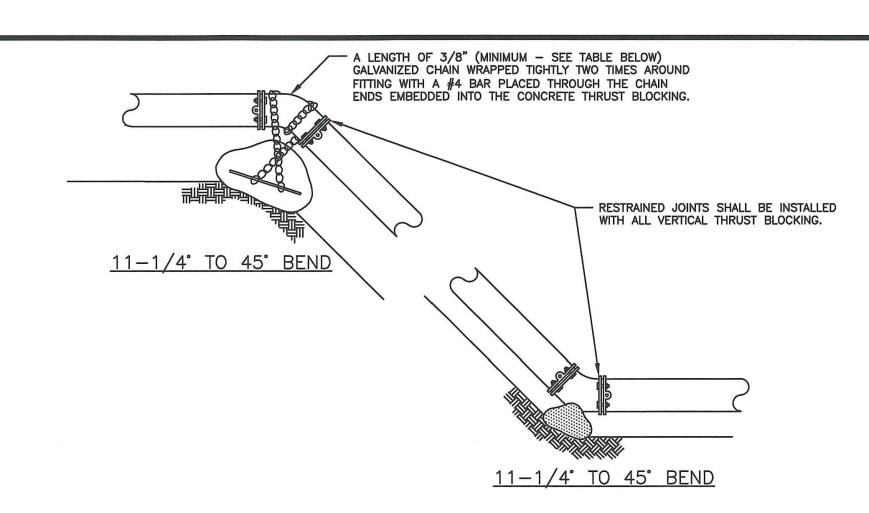
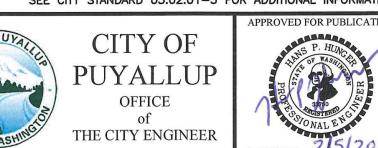


TABLE 1: CONCRETE BLOCKING FOR VERTICAL BENDS

PIPE DIAMETER (INCHES)	TEST PRESSURE (PSI)	BEND ANGLE (DEG)	CONCRETE VOLUME (FT ³)	CUBE SIZE (FEET)	CHAIN SIZE (INCHES)	CHAIN EMBEDMENT (INCHES)
ned control		11.25°	6	1.8		
4"	200	22.5°	12	2.3	3/8"	17"
		45°	22	2.8		
		11.25°	14	2.4		
6"	200	22.5°	27	3.0	3/8"	17"
		45°	50	3.7		
		11.25°	25	2.9	3/8"	
8"	200	22.5°	48	3.6		17"
		45°	89	4.5		
		11.25°	38	3.4	3/8"	
10"	200	22.5°	75	4.2		17"
		45°	139	5.2		
		11.25°	55	3.8	3/8"	17"
12"	200	22.5°	108	4.8	3/8	17
		45°	200	5.8	1/2"	24"
		11.25°	75	4.2	3/8"	17"
14"	200	22.5°	147	5.3	1/2"	20"
		45°	272	6.5	1/2"	27"
		11.25*	98	4.6	3/8"	17"
16"	200	22.5°	192	5.8	1/2"	24"
		45°	355	7.1	3/4"	30"

ALL NOTES ON CITY STANDARD 03.02.01-1 SHALL APPLY TO THIS DETAIL. SEE CITY STANDARD 03.02.01-3 FOR ADDITIONAL INFORMATION





VERTICAL THRUST BLOCKING

03.02.01-2

TABLE 2: THRUST AT FITTINGS AT 200 PSI THRUST FITTINGS AT 200 PSI С **PRESSURE** 90° BEND | 45° BEND | 22.5° BEND | 11.25° BEND (PSI) DEAD ENDS SIZE 1,225 4" 200 3,140 4,440 2,405 615 9,995 5,410 2,760 1,385 7,070 200 12,565 17,770 9,620 4,905 2,465 200 19,635 10" 200 5,545 12" 28,275 39,985 21,640 11,030 200 7,545 15,015 14" 200 38,485 54,425 29,455 200 38,470

TABLE 3: BEARING VALUE OF SOIL

SOIL TYPE	SAFE BEARING LOAD LBS/SF
MUCK, PEAT, ETC.	0
SOFT CLAY/ALLUVIAL SOIL	1,000
SAND	2,000
SAND AND GRAVEL	3,000
SAND AND GRAVEL CEMENTED WITH CLAY	4,000
HARD SHALE	10,000

SEE CITY STANDARDS 03.02.01-1 AND 03.02.01-2 FOR ADDITIONAL INFORMATION.

1 TO DETERMINE THRUST AT PRESSURES OTHER THAN PSI SHOWN, MULTIPLY THE THRUST OBTAINED IN TABLE 2 BY THE RATIO OF THE PRESSURE

THE THRUST ON A 12 INCH, 90° BEND AT 300 PSI.

 $39,985 \times \frac{300 \text{ PS}}{200 \text{ PS}} = 59,978 \text{ LBS}$

2 TO DETERMINE THE BEARING AREA OF THE THRUST BLOCK IN SQUARE FEET (SF):

SEE TABLE 3, BEARING VALUE OF SOIL

FOR SAND AND GRAVEL BEARING VALUE FROM TABLE 3 IS 3,000 LBS/SF

59,978 LBS ÷ 3000 LB/SF = 20 SF OF AREA

THRUST BLOCKING TABLE

⑤ NO WATER MAIN SHALL DEAD END AGAINST A MAIN LINE VALVE. DEAD END WATER MAINS SHALL BE BLOCKED AGAINST A RESTRAINED MECHANICAL

THE CITY ENGINEER



THRUST BLOCKING TABLE

CITY STANDARD 03.02.01-3

Sheet Title:

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WATER AND SEWER NOTES AND DETAILS

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VERTICAL THRUST BLOCKING

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HORIZONTAL THRUST BLOCKING

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METER BOX: ARMORCAST POLYMER CONCRETE BOX

A6001947TDW AND RPM DROP-IN LID A6000481DT-H7.

- 1-1/2" OR 2" METER: SENSUS OMNI R2

 FLEX NET TRANSMITTER 520M SINGLE PORT TOUCH COUPLE

JSE 316 GRADE STAINLESS

- 4-16"X8"X4" SOLID

(SEE NOTE 8)

STEEL BOLTS AND TEFLON NUTS

ON METER FLANGE CONNECTIONS

CONCRETE BLOCKS, TYPICAL

COPPERSETTER: FORD 1-1/2"

VH76-18B-11-66 OR 2" VH77-18B-11-77 OR

APPROVED EQUAL

NORMALLY THE WATER METER BOX SHOULD BE LOCATED IN THE PLANTING STRIP. IF SIDEWALK IS AGAINST THE CURB, PLACE METER BOX

WATER MAINS SHALL HAVE A MINIMUM COVER OF 36" IN IMPROVED RIGHT-OF-WAY AND IMPROVED EASEMENTS, AND A MINIMUM OF 48" IN

THE WATER SERVICE LINE SHALL BE BEDDED IN WASHED SAND WITH 36" OF COVER BELOW FINISHED GRADE WITHIN THE RIGHT-OF-WAY. THE

FOR A 1-1/2" WATER SERVICE, ALL MATERIAL SHALL BE 2" FROM THE WATER MAIN TO THE COPPERSETTER. REDUCE FROM 2" TO 1-1/2"

THE STAINLESS STEEL METER FLANGE BOLTS SHALL BE 5/8" DIAMETER FOR THE 1-1/2" METER, AND 3/4" DIAMETER FOR THE 2" METER.

PROVIDE A 6" CIRCULAR VALVE BOX WITH COVER (APPLIED ENGINEERING PRODUCT MODEL 708 WITH GREEN LID OR AN APPROVED EQUAL) OVER

ALL POLY PIPE SHALL BE HIGH DENSITY POLY (IRON PIPE SIZE) MEETING ASTM D-2239-SIDR 7, BLUE IN COLOR, 200 PSI MINIMUM.

DIRECTLY BEHIND THE SIDEWALK. THE WATER METER BOX SHALL NOT BE LOCATED IN HARD SURFACES. WHEN UNAVOIDABLE, EXCEPTIONS CAN

TWO ON EACH SIDE OF BOX

#12 LOCATE WIRE

FORD PACK JOINT COUPLING -

(SEE NOTE 4)

CONCRETE

C16-77 OR APPROVED EQUAL

A6001640TX12 WITH POLYMER CONCRETE COVER

READING IN 1 CUBIC FEET

2"X4" BRASS

(SEE NOTE 7)

2" POLY PIPE WATER SERVICE LINE

(SEE NOTE 4)

(SEE NOTES 5 AND 6)

ALL MATERIALS AND FITTINGS SHALL BE AS SPECIFIED OR AN APPROVED EQUAL.

BE MADE AT END OF CUL-DE-SACS OR PAN HANDLED LOTS.

ALL POLY PIPE COUPLINGS SHALL USE PIPE INSERT STIFFENERS.

WATER SERVICE LINE SHALL BE ONE CONTINUOUS PIECE WITH NO SPLICES.

UNIMPROVED RIGHT-OF-WAY AND UNIMPROVED EASEMENTS.

FORD PACK JOINT COUPLING -

C86-77 OR APPROVED EQUAL

FOR 1-1/2" SERVICE INSTALL -

2"X1-1/2" BRASS BUSHING ON BACK SIDE OF BRASS 45° BEND

FINISHED GRADE

10" MIN.

VALVE BOX AND COVER

OVER BY-PASS VALVE


#12 LOCATE WIRE

PLACE TWO 18"


LONG GALV. PIPES IN EYE BRACE

(SEE NOTE 9)

12" MAX.

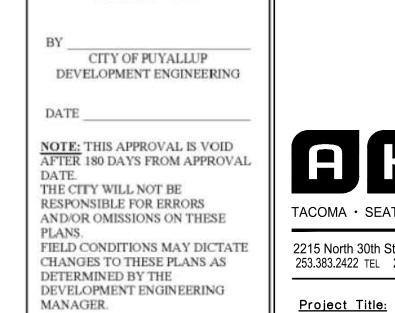

APPROVED

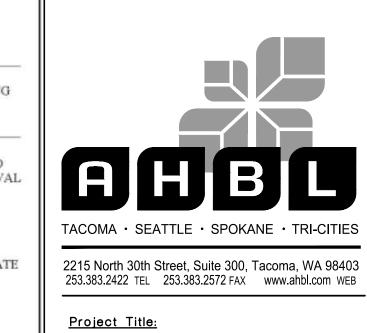

PUYALLUP 2ND STREET

APARTMENTS

SPP MANUFACTURING

P.O.BOX 64160

TACOMA, WA 98464

DON HUBER

2190606.10

SITE DEVELOPMENT


PERMIT SET

2/7/2024

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Project No.

Issue Set & Date:

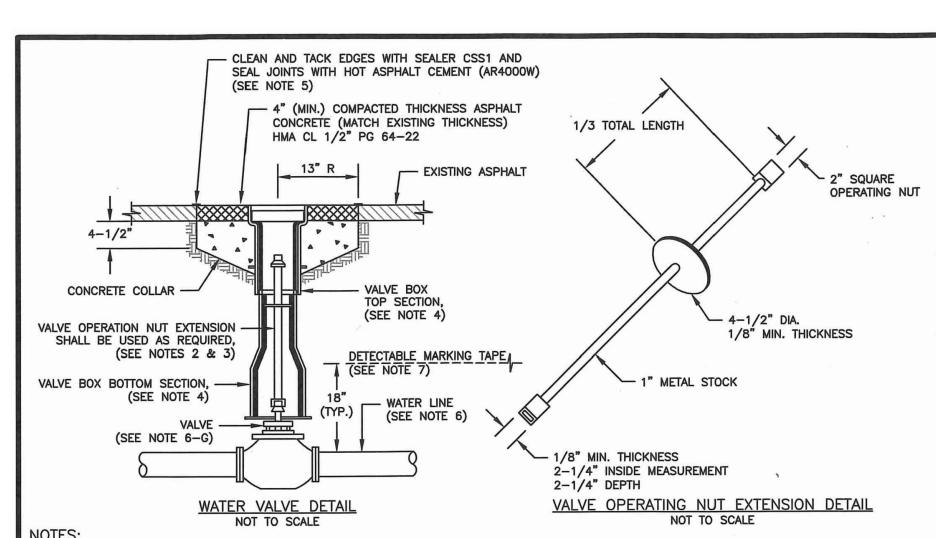


WATER MAINS SHALL HAVE A MINIMUM COVER OF 36" FROM PAVED FINAL GRADE IN IMPROVED RIGHT-OF-WAY AND IMPROVED EASEMENTS, AND A MINIMUM OF

- VALVE OPERATING NUT EXTENSIONS ARE REQUIRED WHEN THE VALVE NUT IS MORE THAN FIVE (5) FEET BELOW FINISHED GRADE. EXTENSIONS ARE TO BE A MINIMUM OF TWO (2) FEET LONG. ONLY ONE EXTENSION TO BE USED PER VALVE. TOP OF EXTENSION SHALL BE 2 FEET 6 INCHES TO 3 FEET BELOW
- ALL VALVE OPERATING NUT EXTENSIONS ARE TO BE MADE OF STEEL, SIZED AS NOTED, AND PAINTED WITH TWO COATS OF METAL PAINT.
- VALVE BOXES SHALL BE TWO-PIECE, ADJUSTABLE, CAST IRON WITH EXTENSION PIECES (IF NECESSARY), AS MANUFACTURED BY THE VANRICH #940 SEATTLE OR APPROVED EQUAL. THE WORD "WATER" SHALL BE CAST IN RELIEF ON THE VALVE BOX COVER. VALVE BOX TOPS INSTALLED IN ARTERIAL ROADWAYS SHALL BE MANUFACTURED BY EAST JORDAN (EJ) IRONWORKS MODEL 8555 WITH LOCKING VALVE BOX COVER MODEL 6800 (PART# 06800025U) OR APPROVED EQUAL.
- NEAT LINE CUTS SHALL BE SEALED WITH A HOT PAVING GRADE ASPHALT AND FACE OF CUT TACKED.
- WATER MAINS SHALL BE CONSTRUCTED AND TESTED IN ACCORDANCE WITH DIVISION 7 OF THE WSDOT STANDARD SPECIFICATIONS SUPPLEMENTED WITH THE
- A. DUCTILE IRON PIPE SHALL CONFORM TO AWWA C 151, THICKNESS CLASS 52, AND THE EXTERIOR SHALL BE COATED WITH COAL TAR VARNISH. PIPE AND FITTINGS SHALL BE MORTOR LINED AND SHALL CONFORM TO AWWA C 104. THE THICKNESS OF THE LINING SHALL BE NOT LESS THAN 1/16" THICK FOR 3" TO 12" PIPE, 3/32" THICK FOR 14" TO 24" PIPE, AND 1/8" THICK FOR 30" TO 54" PIPE. THE CEMENT LINING SHALL CONFORM TO THE
- B. JOINTS SHALL BE TYTON PUSH-ON JOINTS, OR APPROVED EQUAL, OR MECHANICAL JOINT TYPE PER AWWA C 111 EXCEPT WHERE FLANGED JOINTS ARE REQUIRED TO CONNECT TO VALVES OR OTHER EQUIPMENT.
- C. BOLTS AND NUTS FOR BURIED FLANGES LOCATED OUTDOORS, ABOVE GROUND, OR IN OPEN VAULTS IN STRUCTURES SHALL BE TYPE 316 STAINLESS STEEL COMFORMING TO ASTM A 193, GRADE B8M FOR BOLTS, AND ASTM A 194, GRADE 8M FOR NUTS. BOLTS AND NUTS LARGER THAN ONE AND ONE-QUARTER (1-1/4) INCHES SHALL BE STEEL, ASTM A 307, GRADE B, WITH CADMIUM PLATING, ASTM A 165, TYPE NS.
- D. BOLTS USED IN FLANGE INSTALLATION SETS SHALL CONFORM TO ASTM B 193, GRADE B7. NUTS SHALL COMPLY WITH ASTM A 194, GRADE 2H.
- PROVIDE A WASHER FOR EACH NUT, WHERE NEEDED. WASHERS SHALL BE OF THE SAME MATERIAL AS THE NUTS.
- F. ALL FITTINGS SHALL CONFORM TO THE REQUIREMENTS OF AWWA C 110 AND AWWA C 111.
- RESILIENT SEATED WEDGE GATE VALVES SHALL BE USED FOR TEN (10) INCH MAINS AND SMALLER. BUTTERFLY VALVES SHALL BE USED FOR MAINS GREATER THAN TEN (10) INCHES.
- 1) RESILIENT SEATED WEDGE GATE VALVE: GATE VALVES SHALL CONFORM TO THE LATEST AWWA SPECIFICATIONS FOR COLD WATER, DOUBLE-DISK GATE VALVES, 200 PSI WORKING PRESSURE, THEY SHALL BE IRON-BODIED, BRONZE MOUNTED, NON-RISING STEM, WITH TWO (2) INCH SQUARE NUT. COUNTER-CLOCKWISE OPENING, MECHANICAL JOINT AND / OR FLANGED ENDS (6" VALVES ON FIRE HYDRANT LINES WHICH SHALL BE MECHANICAL JOINTS BY FLANGED). VALVE STEMS SHALL BE PROVIDED WITH O-RING SEALS AND SHALL BE AS MANUFACTURED BY THE MUELLER COMPANY OR

NOT TO SCALE

- 2) BUTTERFLY VALVES: BUTTERFLY VALVES CONFORMING WITH AWWA C 504, CLASS 150 AND SHALL HAVE STANDARD AWWA TWO (2) INCH SQUARE NUT.
- DETECTABLE MARKING TAPE SHALL BE INSTALLED 18" ABOVE PIPE, BE BLUE IN COLOR, AND READ "CAUTION WATER LINE BELOW" MEETING WSDOT SPEC. 9-15.18.

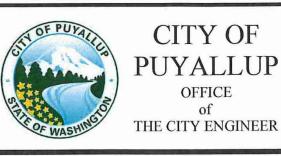

WATER VALVES AND MAINS

03.01.01

THE CITY ENGINEER

IMMEDIATELY BEFORE COPPERSETTER.

BY-PASS VALVE.

1-1/2" AND 2" WATER SERVICE CONNECTION

03.03.02

- EXISTING

VALVE BOX SHALL BE

2" RESILIENT SEATED

DOUBLE STRAP SADDLE,

FORD FSD202 OR

APPROVED EQUAL

2"X4" BRASS

INSTALLED AS SPECIFIED I

CITY STANDARD 03.01.01

WATER VALVES AND MAIN

WEDGE GATE VALVE WITH

2" SQUARE OPERATING NU

WATER MAIN


(VARIOUS SIZES)


ASPHALT

SEWER MAIN TAP

NOTES FOR CONNECTING TAPS ON EXISTING SEWER MAINS

- 1. THE TEE FITTING SHALL BE A ROMAC INDUSTRIES STYLE "CB" SEWER SADDLE (OR APPROVED EQUAL). ONLY NEW SADDLE AND PARTS SHALL BE INSTALLED. DUE TO PIPE SIZE MATERIALS OR PIPE CONDITION, THE CITY ENGINEER MAY REQUIRE AN ALTERNATE METHOD/MATERIAL BE USED.
- 2. THE SEWER MAIN TAP SHALL BE CUT WITH A SEWER PIPE TAPPING MACHINE (HOLE SAW) CAPABLE OF RETAINING THE COUPON.
- 3. THE ROUND HOLE CUT INTO THE SEWER MAIN SHALL BE NO LARGER THAN THE INSIDE DIAMETER OF THE SADDLE GASKET. THE HOLE SAW CUT EDGES SHALL BE SMOOTH.
- 4. THE COUPON SHALL BE RETAINED AND SURRENDERED TO THE INSPECTOR. THE PERMIT HOLDER WILL PAY ALL COSTS ASSOCIATED WITH THE LOCATION AND RETRIEVAL OF A LOST COUPON. ADDITIONALLY THE PERMIT HOLDER WILL BE HELD LIABLE FOR ANY SUBSEQUENT DAMAGES CAUSED BY A LOST COUPON.
- 5. BOLTS SHALL BE TORQUED TO MANUFACTURE SPECIFICATIONS, THEN RETORQUED AFTER 10 MINUTES.
- 6. NO TAPS SHALL BE ALLOWED ON EXISTING SEWER MAINS OVER 18" IN DIAMETER. CONNECTIONS INTO SEWER MAINS OVER 18" IN DIAMETER SHALL INTERSECT THE SEWER MAIN IN A MANHOLE. IN SOME CASES THE CITY ENGINEER MAY ALLOW A VARIANCE TO THIS REQUIREMENT.
- 7. ALL TRENCHING, BEDDING, AND BACKFILL SHALL BE IN ACCORDANCE WITH CITY STANDARD DETAIL NO. 06.01.01. ALL ASPHALT REPAIR SHALL BE IN ACCORDANCE WITH CITY STANDARD NO. 01.01.20. ALL ADDITIONAL UTILITY AND RIGHT OF WAY REPAIRS SHALL BE INACCORDANCE WITH THE "CITY STANDARDS" MANUAL.
- 8. THE CITY OF PUYALLUP WILL CONDUCT A "SEWER MAIN VIDEO INSPECTION" OF THE SEWER TAP. THE PERMIT HOLDER WILL BE REQUIRED TO REPAIR ANY SEWER TAP CONSTRUCTION DEFECTS FOUND BY THE CITY INSPECTORS. THE COST OF ALL REPAIRS AND SUBSEQUENT "SEWER MAIN VIDEO INSPECTIONS" WILL BE THE RESPONSIBILITY OF THE PERMIT HOLDER. THE DAMAGE DEPOSIT POSTED BY THE BUILDER WILL BE HELD UNTIL PROBLEMS ARE CORRECTED. DUE TO PUBLIC HEALTH AND SAFETY, BUILDING OCCUPANCY WILL NOT BE ALLOWED UNTIL REPAIRS ARE COMPLETED AND ACCEPTED BY THE CITY ENGINEER.

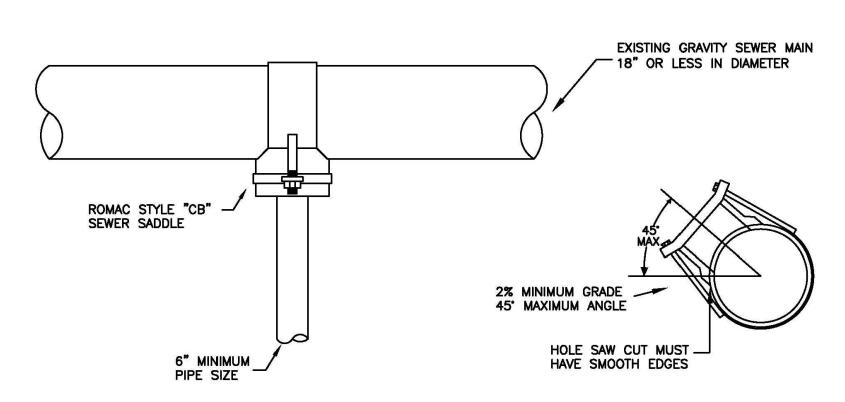

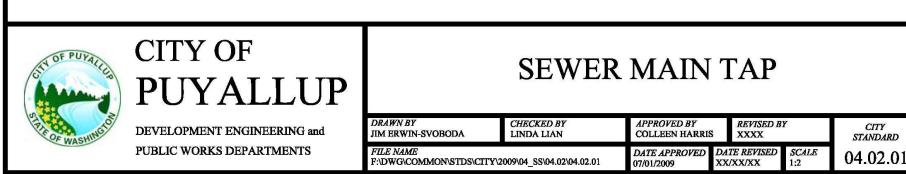

WATER VALVES AND MAINS

1.5 INCH AND 2 INCH WATER SERVICE CONNECTION

Know what's below.

Call before you dig.

MW Sheet No.

Revisions:

Sheet Title:


23 of 26 Sheets

WATER AND SEWER

NOTES AND DETAILS


Designed by: Drawn by: Checked by:

A PORTION OF THE NW 1/4 OF THE NW 1/4 OF SEC. 27, TWN. 20 N., RGE. 04 E. W.M. CITY OF PUYALLUP, PIERCE COUNTY, WASHINGTON.

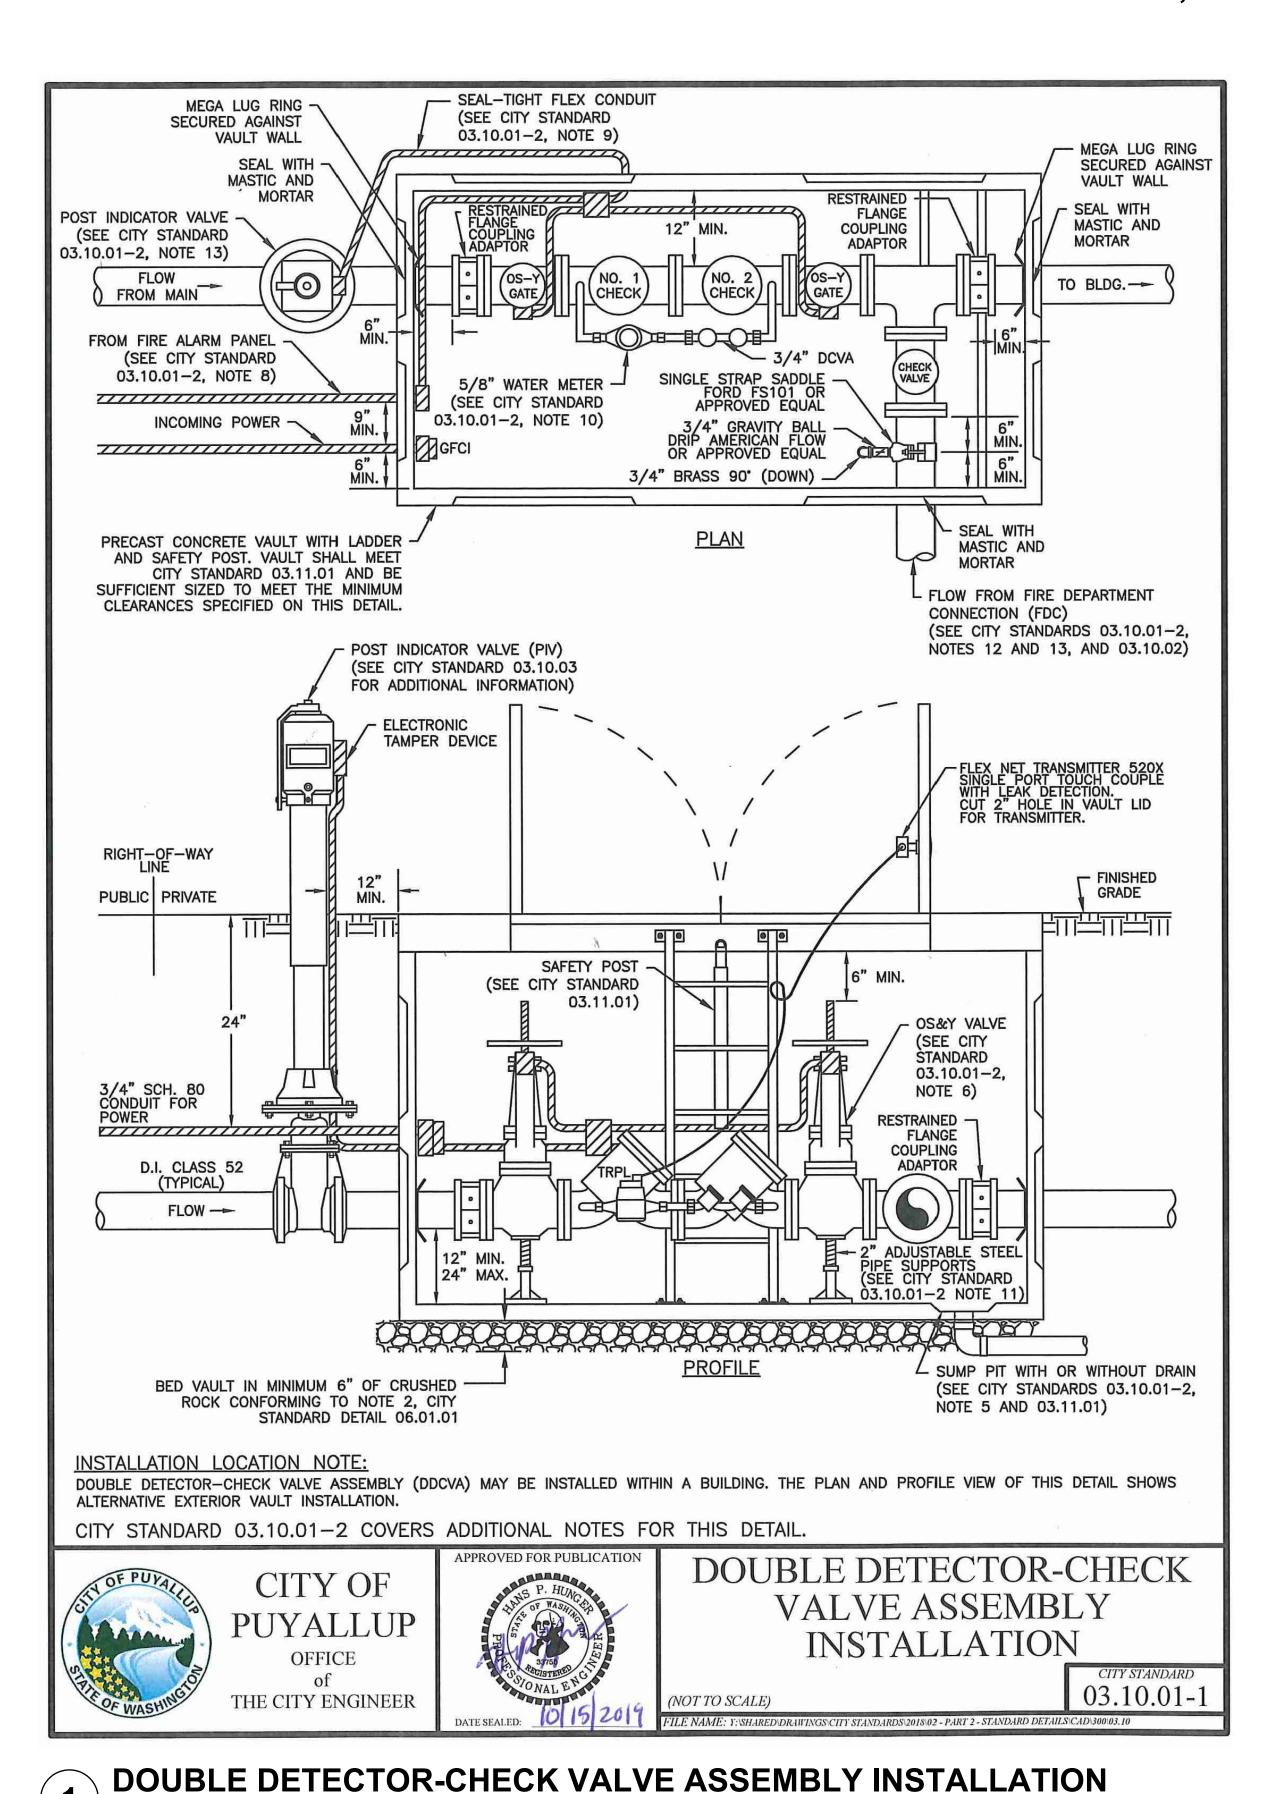

NOTES FOR: DOUBLE DETECTOR CHECK VALVE ASSEMBLY (DDCVA) INSTALLATION CITY STANDARD 03.10.01-1

- BACKFLOW ASSEMBLY MUST BE SELECTED FROM WASHINGTON STATE DEPARTMENT OF HEALTH'S LIST OF BACKFLOW PREVENTION ASSEMBLIES APPROVED FOR INSTALLATION IN WASHINGTON STATE, LATEST EDITION.
- THE DDCVA SHALL BE INSTALLED WITH ADEQUATE SPACE TO FACILITATE MAINTENANCE AND TESTING. IT SHALL BE TESTED AFTER INSTALLATION, BY A WASHINGTON STATE CERTIFIED BACK-FLOW ASSEMBLY TESTER, TO INSURE ITS SATISFACTORY OPERATION BEFORE OCCUPANCY, AND ANNUALLY THEREAFTER. SEND TEST RESULTS TO: CITY OF PUYALLUP, WATER QUALITY OPERATIONS, 1100 39TH AVE SE, PUYALLUP, WA 98374.
- 3. DDCVA MUST BE PURCHASED AS A UNIT. NO MODIFICATIONS TO THE ASSEMBLY ARE ALLOWED.
- DDCVA IS ALLOWED TO BE LOCATED WITHIN A BUILDING AS APPROVED BY THE FIRE CODE OFFICIAL. WHEN THE DDCVA IS LOCATED WITHIN A BUILDING, THE FIRE DEPARTMENT CONNECTION (FDC) BALL DRIP SHALL DRAIN TO THE NEAREST APPROVED ON-SITE STORM DRAINAGE STRUCTURE.
- IN A VAULT INSTALLATION, IF VAULT CANNOT BE DRAINED TO DAYLIGHT, A 1/4 HP SUMP PUMP SHALL BE INSTALLED IN THE SUMP PIT OF THE VAULT. IT SHALL BE WIRED PER WASHINGTON STATE ELECTRICAL CODE, AND INSPECTED BY A STATE ELECTRICAL INSPECTOR. THE DISCHARGE PIPE SHALL BE CONNECTED TO THE NEAREST APPROVED ON-SITE STORM DRAINAGE STRUCTURE.
- 6. DDCVA OUTSIDE STEM AND YOKE (OS&Y) GATE VALVES, AND THE POST INDICATOR VALVE (PIV), SHALL HAVE SUPERVISED TAMPER SWITCHES.
- 7. ALL ELECTRICAL SHALL BE INSPECTED BY A WASHINGTON STATE ELECTRICAL INSPECTOR.
- 8. IN A VAULT INSTALLATION, RUN TWO 3/4" SCHEDULE 80 P.V.C. CONDUITS TO THE VAULT. ONE WILL BE USED FOR A GFCI PROTECTED OUTLET AND ONE WILL BE FOR LOW VOLTAGE COMING FROM THE FIRE ALARM PANEL, INSTALL AN APPLETON FSCA OR FDCA CAST DEVICE BOX OR APPROVED EQUAL ON THE VAULT WALL AT THE CONDUIT PENETRATION.
- 9. IN A VAULT INSTALLATION, RUN LOW VOLTAGE WIRE INSIDE VAULT AND TO PIV THROUGH SEAL-TIGHT FLEX CONDUIT. CONDUIT SHALL BE SECURELY FASTENED PERPENDICULAR OR HORIZONTALLY TO THE WALLS OF THE VAULT.
- 10. WATER METER SHALL BE A SENSUS SRII TRPL READING IN 1 CUBIC FEET.
- 11. PIPE SUPPORTS SHALL BE RUST-PROTECTED WITH ALUMINUM PAINT.
- 12. THE FDC SHALL BE LOCATED WITHIN 15 FEET OF A FIRE HYDRANT, BUT NOT LESS THAN 10 FEET.
- 13. THE FDC AND PIV SHALL BE A MINIMUM OF 50 FEET FROM A BUILDING, UNLESS APPROVED BY THE CITY OF PUYALLUP FIRE CODE OFFICIAL, BUT NEVER LESS THAN 5 FEET FROM BUILDING.
- 14. A DDCVA INSTALLED MORE THAN 5 FEET ABOVE THE FLOOR LEVEL MUST HAVE A PLATFORM UNDER IT FOR THE TESTER OR MAINTENANCE PERSON TO STAND ON. THE PLATFORM MUST BE OSHA APPROVED AND MEET ALL APPLICABLE SAFETY STANDARDS AND CODES.

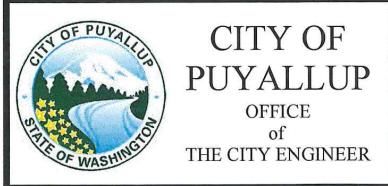



DOUBLE DETECTOR-CHECK VALVE ASSEMBLY INSTALLATION (NOTES)

03.10.01-2



DOUBLE DETECTOR-CHECK VALVE ASSEMBLY INSTALLATION (NOTES)

APPROVED

CITY OF PUYALLUP DEVELOPMENT ENGINEERING

DATE NOTE: THIS APPROVAL IS VOID AFTER 180 DAYS FROM APPROVAL

THE CITY WILL NOT BE RESPONSIBLE FOR ERRORS AND/OR OMISSIONS ON THESE PLANS. FIELD CONDITIONS MAY DICTATE CHANGES TO THESE PLANS AS DETERMINED BY THE DEVELOPMENT ENGINEERING MANAGER.



PUYALLUP 2ND STREET **APARTMENTS**

Project Title:

SPP MANUFACTURING

P.O.BOX 64160 **TACOMA, WA 98464** DON HUBER


Project No.


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Issue Set & Date:

SITE DEVELOPMENT **PERMIT SET**

2/7/2024



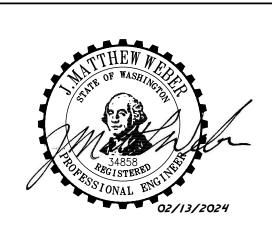
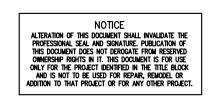
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Revisions:

Sheet Title:

WATER AND SEWER

<u>Drawn by:</u> <u>Checked by:</u>

NOTES AND DETAILS

Sheet No.

A PORTION OF THE NW 1/4 OF THE NW 1/4 OF SEC. 27, TWN. 20 N., RGE. 04 E. W.M. CITY OF PUYALLUP, PIERCE COUNTY, WASHINGTON.

304 Water System Plan Notes

The following notes shall also be shown on the plans.

WATER SYSTEM NOTES:

- All work in City right-of-way requires a permit from the City of Puyallup. Prior to any work commencing, the general contractor shall arrange for a preconstruction meeting at the Development Services Center to be attended by all contractors that will perform work shown on the engineering plans, representatives from all applicable Utility Companies, the project owner and appropriate City staff. Contact Engineering Services to schedule the meeting (253) 841-5568. The contractor is responsible to have their own approved set of plans at the meeting.
- After completion of all items shown on these plans and before acceptance of the project, the
 contractor shall obtain a "punch list" prepared by the City's inspector detailing remaining
 items of work to be completed. All items of work shown on these plans shall be completed to
 the satisfaction of the City prior to acceptance of the water system and provision of sanitary
 sewer service.
- 3. All materials and workmanship shall conform to the Standard Specifications for Road, Bridge, and Municipal Construction (hereinafter referred to as the "Standard Specifications"), Washington State Department of Transportation and American Public Works Association, Washington State Chapter, latest edition, unless superseded or amended by the City of Puyallup City Standards for Public Works Engineering and Construction (hereinafter referred to as the "City Standards"), or as directed by Fruitland Mutual Water Company (FMWC), Valley Water (VW), or Tacoma City Water (TCW) is the purveyor.
- 4. A copy of these approved plans and applicable city developer specifications and details shall be on site during construction.
- 5. Any revisions made to these plans must be reviewed and approved by the developer's engineer, the Engineering Services Staff, and the FMWC, VW or TCW when served by that purveyor, prior to any implementation in the field. The City shall not be responsible for any errors and/or omissions on these plans.
- The contractor shall have all utilities verified on the ground prior to any construction. Call (811) at least two working days in advance. The owner and his/her engineer shall be contacted immediately if a conflict exists.
- 7. Any structure and/or obstruction which requires removal or relocation relating to this project shall be done so at the developer's expense.
- 8. Bacteriological (Coliform and Iron Bacteria) test samples will be taken by the City (or FMWC, VW or TCW when served by that purveyor) and paid for by the contractor, except for Capital Improvement Projects (CIP) which shall be paid for by the City.
- Water mains shall have a minimum cover of 36 inches from paved final grade in improved right-of-way and improved easements, and a minimum of 48 inches in unimproved right-ofway and unimproved easements.
- Pipe for water mains shall be ductile iron conforming to Section 7-09 of the Standard Specifications, Class 52 with tyton or approved equal joints. Pipe shall be cement lined in accordance with A.S.A. Specification A 21.4-1964.
- 11. Connections to existing water mains typically shall be wet taps through a tapping tee and tapping valve and shall be made by a city approved contractor. The tapping sleeve shall be Romac SST all stainless steel tapping sleeve or approved equal. A two-piece epoxy coated or ductile iron tapping sleeve may be used on ductile iron pipe, when the tap is smaller than the water main size i.e. 6-inch tap on 8-inch pipe. The City (or FMWC, VW or TCW when served by that purveyor) shall approve the time and location for these connections.
- 12. All water mains and appurtenances shall be hydrostatically tested at 200 psi in accordance with Standard Specification 7-09.3(23). Pressure testing shall not be performed until satisfactory purity samples have been received, except when new water mains are installed independently from the water system piping.
- 13. Fire hydrants shall be installed in accordance with City Standard Detail 03.05.01 and as directed by the City of Puyallup Fire Code Official.
- 14. Valve marker posts shall be installed where valve boxes are hidden from view or in unpaved areas. The installation shall be in accordance with City Standard Detail 03.01.02.
- 15. Resilient seated wedge gate valves shall be used for 10-inch mains and smaller. Butterfly valves shall be used for mains greater than 10 inches.
- Pipe fitting for water mains shall be ductile iron and shall be mechanical joint conforming to AWWA Specification C111-72.
- 17. Water main pipe and service connections shall be a minimum of 10 feet away from building foundations and/or roof lines.
- 18. Where a water main crosses the Northwest Gas pipeline, the water line shall be cased with PVC pipe a minimum of 10 feet beyond each side of the gas line easement. Contact Williams Northwest Pipeline before the crossing is made.
- Trenching, bedding, and backfill for water mains shall be installed in accordance with City Standard Detail 06.01.01.
- 20. All commercial and industrial developments, irrigation systems, and multi-family water service connections shall be protected by a double check valve assembly or a reduced pressure backflow assembly as directed by the City (or FMWC, VW or TCW when served by that purveyor) conforming to City Standard Details 03.04.01, 03.04.02, and 03.04.03.
- 21. Any lead joint fitting disturbed during construction shall be replaced with a mechanical joint fitting at the contractor's expense.
- 22. When hydraulic fire flow modeling is required for a project, the City will issue a permit. The hydraulic modeling criteria is based on the projected 2030 water demand, while maintaining a minimum system pressure of 20 pounds per square inch and a maximum velocity of 10 feet per second.

- 23. When using a fire hydrant for non-firefighting purposes, a city hydrant meter must be used. Coordinate the acquisition of the hydrant meter with the City's Utility Billing Division at Puyallup City Hall. A city approved backflow protection assembly shall be installed by the person requesting use of a fire hydrant. The assembly shall be accompanied by a current backflow assembly test report. The test report shall be available at the site for the duration of the hydrant use.
- 24. Should a break occur on any City water main, the Contractor shall follow the City's adopted "Water Main Break Procedure" issued to them at the Pre-Construction Meeting and notify those connected to the system in the impacted area as outlined in the Procedure.
- Water Main Repairs (References: AWWA C651-14 and WSDOT Standard Specification Section 7-09)

(Note: A planned water main repair shall be approved by the City Inspector and/or Water Division Supervisor prior to commencing work.)

- a. Repair without depressurization Small leaks shall be repaired using repair bands while maintaining positive pressure in the water main. Valves surrounding the leak will be partially shut by the City Water Department to reduce the flow and pressure to the area. Blowoffs and hydrants in the reduced pressure area may be opened as needed to further reduce the pressure. The water main trench shall be over-excavated to allow water in the trench to be pumped out and maintained below the level of the water main. The repair shall be completed with the water main pressure remaining positive. After the repair is made, the system shall be fully pressurized and a visual leak inspection will be completed. The water main in the affected area shall be flushed to achieve three pipe volumes pulled from the pipe (distance measured from valve opened for flushing to the exit hydrant or blowoff).
- b. Repair/cut-in with depressurization Trench shall be over excavated and dewatered below the water main. Flush water from pipe from each direction until it runs clear. Immediately prior to installation of a new pipe section for repair or cut in tee, all new fittings and pipe spools shall be swabbed with a five percent (5%) chlorine solution (minimum). The interior of the existing pipe shall be swabbed with a five percent (5%) chlorine solution at least 6 feet in each direction from exposed cut ends. The water main in the affected area shall be flushed to achieve three pipe volumes pulled from the pipe (distance measured from the valve opened for flushing to the exit hydrant or blowoff). Customers shall be notified after the water main is flushed and repairs have been completed, as outlined in the "Water Main Break Procedure."

26. New Water Main Installation:

a. Each new water main section shall be delivered, stacked and stored onsite with ends plugged. The plugs shall remain in the pipe until each particular section is installed. National Sanitation Foundation (NSF) approved sixty-five percent (65%) calcium hypochlorite shall be added to the upstream end of each pipe section, and at each hydrant tee in the amount given in the table below (or per approved manufacturer specifications). The minimum amount of calcium hypochlorite added should be sufficient to achieve a 50 mg/L concentration within the impacted area.

65% Calcium Hypochlorite Addition per Pipe Section

	Pipe Volume	5-gram	Hypochlorite Granules		Maximum	
Pipe Diameter (Inches)	per 18 feet (gal)	tablets per pipe section	Ounces per 500 feet	Teaspoons per 18 feet	Fill Rate (gpm)	
4	35	1	1.7	0.2	40	
6	53	1	3.8	0.4	90	
8	70	2	6.7	0.7	150	
12	106	4	15.1	1.4	350	
16	141	6	27	2.5	600	

- b. New water mains shall be filled using an approved backflow prevention assembly. The water main shall be filled from the lower elevation end so that as the water main is filled, the chorine is contacted, dissolved and spread relatively uniform through the length of the new water main. The fill rate shall be minimized so that the velocity of the water is less than 1 ft/sec (see table above). Successful pressure test and bacteriological tests shall be completed and provided to the City prior to any new mater main connection to the existing water system.
- c. The chlorinated water will be allowed to remain in contact with the new water main system for 24 to 72 hours. After 24 hours, water may be added to the water main for the purposes of pressure testing. The water in the main used for pressure testing must remain in the water main until pressure test is completed. If necessary, liquid chlorine shall be injected into the water main with fill water to maintain a concentration in the water main above 50 mg/L. Under no circumstance shall "super" chlorinated water be allowed to sit within a new water main for more than 5 days.
- d. Pressure testing includes testing against new valves and hydrants. Each valve shall be tested by closing each in turn and reducing the pressure beyond the valve. The pressure on the back side of the valve should not be eliminated. Care must be taken that, during this process, positive pressure remains throughout the system being tested at all times. All hydrant foot valves shall be open during pressure testing so that the pressure test is against the hydrant valve. Pressure testing will not be allowed against any existing valves.
- e. After successful pressure testing, the water main shall be thoroughly flushed to remove all "super" chlorinated water from the new water main. Flushing of new or extended water mains shall be conducted per WSDOT Specification 7-09.3(24)A with a minimum velocity developed within the pipe while flushing of 2.5 feet per second (fps). All flushed water shall be dechlorinated prior to disposal. The Contractor shall be responsible for disposal of all chlorinated water flushed from mains. The City shall approve the disposal method prior to implementation in the field. The Contractor shall utilize onsite disposal methods, if available. Disposal of flush water to the sanitary sewer system shall not be allowed without written permission from the Water Pollution Control Plant (WPCP) Supervisor. Any planned discharge to a stormwater system shall be dechlorinated to a concentration of 0.1 ppm or less, pH adjusted (if necessary) to be between 6.5 and 8.5, and volumetrically and velocity controlled to prevent any resuspension of sediments. The City will require independent testing throughout the water discharge process to ensure compliance of these standards are met.

- Samples for bacteriological analysis shall be collected after flushing and again 24 hours after the first set of samples.
- g. All closure/final connection fittings shall be sprayed clean and then swabbed with a five percent (5%) chlorine solution immediately prior to installation per AWWA Standard C651. Additional samples for bacteriological analysis shall be collected from the immediate vicinity of the new or replaced water main and analyzed after the final connections are made. If necessary, additional flushing shall be conducted and additional samples shall be collected until satisfactory results are obtained.

APPROVED

CITY OF PUYALLUP DEVELOPMENT ENGINEERING

DATE

NOTE: THIS APPROVAL IS VOID
AFTER 180 DAYS FROM APPROVAL
DATE.
THE CITY WILL NOT BE
RESPONSIBLE FOR ERRORS
AND/OR OMISSIONS ON THESE
PLANS.
FIELD CONDITIONS MAY DICTATE

CHANGES TO THESE PLANS AS DETERMINED BY THE DEVELOPMENT ENGINEERING MANAGER.



PUYALLUP 2ND STREET
APARTMENTS

<u>Client:</u>

Project Title:

SPP MANUFACTURING

P.O.BOX 64160 TACOMA, WA 98464 DON HUBER

Project No.


2190606.10

Issue Set & Date:

SITE DEVELOPMENT PERMIT SET

2/7/2024



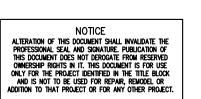

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Revisions:

Sheet Title:

WATER AND SEWER NOTES AND DETAILS

Designed by:

<u>Drawn by:</u> Checked by:

Sheet No.

C4.7





A PORTION OF THE NW 1/4 OF THE NW 1/4 OF SEC. 27, TWN. 20 N., RGE. 04 E. W.M. CITY OF PUYALLUP, PIERCE COUNTY, WASHINGTON.

PERPENDICULAR CURB RAMP -



CITY OF PUYALLUP
DEVELOPMENT ENGINEERING

DATE

APPROVED

NOTE: THIS APPROVAL IS VOID AFTER 180 DAYS FROM APPROVAL DATE. THE CITY WILL NOT BE RESPONSIBLE FOR ERRORS AND/OR OMISSIONS ON THESE

PLANS. FIELD CONDITIONS MAY DICTATE CHANGES TO THESE PLANS AS DETERMINED BY THE DEVELOPMENT ENGINEERING MANAGER.

GRAPHIC SCALE 1" = 10 FEET

— STMH#578 RIM: 47.62

12" CONC NW IE: 41.69

12" CONC E IE: 41.69

LADDER S

PROPOSED BUILDING PROPOSED SIGNAL POLE FOUNDATION -STCB#585 RIM: 46.11— 8" CONC SE IE: 43.87 PERPENDICULAR CURB RAMP STMH#586 RIM: 46.87 — 18" N CONC IE: 39.07 8" CONC NE IE: 42.57 12" CONC E IE: 40.52 12" CONC S IE: 39.87 12" CONC W IE: 40.02 8" CONC NW IE: 42.57 EXISTING SIGNAL POLE TO BE REMOVED -AND J-BOX RELOCATED BEHIND FUTURE CURB SSMH#583 RIM: 47.28 — COC: 36.88 12" CONC E-W-S LADDER N **5TH AVENUE NE**

SSMH#582 RIM: 47.20 —

COC: 37.20

12" CONC E-W LADDER S

NOTE:

IMPROVEMENTS.

THIS CONCEPTUAL INTERSECTION DESIGN SHALL NOT

BE USED FOR CONSTRUCTION. THE PURPOSE OF THIS

IMPROVEMENT ARE COMPATIBLE WITH THE FUTURE

SHEET IS TO ILLUSTRATE THAT THE CURRENT



2215 North 30th Street, Suite 300, Tacoma, WA 98403 253.383.2422 TEL 253.383.2572 FAX www.ahbl.com WEB

Project Title:

PUYALLUP 2ND STREET **APARTMENTS**

SPP MANUFACTURING

P.O.BOX 64160 TACOMA, WA 98464 DON HUBER

Project No.


2190606.10

Issue Set & Date:

SITE DEVELOPMENT **PERMIT SET**

2/7/2024



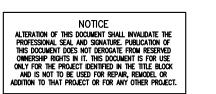

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73	
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Revisions:

Sheet Title:

FUTURE CONCEPTUAL INTERSECTION DESIGN

Designed by: Drawn by: Checked by:

Sheet No.

26 of 26 Sheets



SSMH#584 RIM: 47.14 — COC: 36.64

12" CONC E-W LADDER S