CBRE - MICHAEL'S ROOFTOP UNIT REPLACEMENT PUYALLUP, WASHINGTON



SOCOTEC CONSULTING, INC 401 2nd Ave South, Suite 301 P: +1 (206) 467-0054

WWW SOCOTEC US

CBRE - MICHAELS 4621 MERIDIAN AVENUE EAST PUYALLUP, WA 98373


HVAC RTU REPLACEMENT

PRMH20241300

Project Number	P243900T	
Revision Date		
No	Description	
-	-	
		1 -

Develo	City of Puyallup	ices



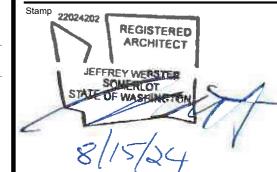

O ORM

PERMIT

AUGUST 12, 2024 **AS SHOWN** SJH

CONSTRUCTION SUBSTITUTION PROTOCOL SYMBOLS: PRODUCT OR SYSTEM SUBSTITUTIONS MAY BE APPROPRIATE DURING THE CONSTRUCTION BASED ON A NUMBER OF FACTORS, SOME OF WHICH ARE NOTED BELOW:

ELEVATION

REFERENCE SHEET

SCOPE OF

ABBREVIATIONS:

ANCHOR BOLT

ADDITIONAL

ADJUSTABLE

ALUMINUM

ALTERNATE

ASSEMBLY

ATTACH(ED)

BUILDING LINE

BACKER PLATE

BREATHER MEMBRANE

BRITISH THERMAL UNIT

BOTTOM OF WALL

BUILT UP ROOF MEMBRANE

CUBIC FEET PER MINUTE

CONCRETE MASONRY UNIT

BUILDING

BLOCKING

BEAM

BRICK

BRACKET

BATTEN

BETWEEN

CAPACITY

COPING CAP

CUBIC FEET

CONTROL JOINT

CENTER LINE

CLADDING

CLEAN OUT

CONCRETE

CONTINUOUS

COVER PLATE

CERAMIC TILE

CUBIC YARD

PENNY (NAILS

DEPARTMENT

DEGREES

DEMOLISH

DETAIL

DIAMETER

DIMENSIONS

DOWNSPOU⁻

DEAD LOAD

DRAIN SUMP/DOWN SPOUT

DOWN

DOOR

DOWEL

EXISTING

EXPANSION BOLT EAVE FLASHING

EXPANSION JOINT

EACH

COATING

COUNTER FLASHING

CONDUIT

COLUMN

CEILING

BASEMENT

AUXILIARY

AVENUE

ARCHITECTURAL

ABOVE FINISHED FLOOR

ADDL

ALUM

ATCH

BLKG

BRK

BRKT

BSMT

BTN

BTW

BTYL

BUR

C/CP

CMU CO

CONC

COND

CONT

CFLG

DEMO

DEPT DET

DWG DWL

SHEET NUMBER

DATUM OR BENCH

DETAIL REFERENCE

NO. SHEET NUMBER

POUNDS

LEAD FLASHING

LONG LEG VERTICAL

LINEAR FEET

LIVE LOAD

LAP PLATE

LIGHTING

MAXIMUM

MISC

NOM

OTS

PLYD

RENF

MECHANICAL

MANUFACTURER

METAL PANEL

NEW

NORTH

NUMBER

NOMINAL

OVERALL

ON CENTER

OVERHEAD

PLAZA DRAIN

PERIMETER

PLYWOOD

POWER

QUARRY TILE

QUANTITY

RISER

RADIUS

ROOF DRAIN

REFERENCE

REQUIRED

ROOFING NAIL

REGLET

ROOM

REINFORCED / REINFORCING

ROOFING FASTENER

POLYURETHANE

POLYVINYL CHLORIDE

PRESSURE-TREATED

PLATE

POLYETHYLENE

OPPOSITE

OUNCE

OUTSIDE FACE

OUTSIDE DIAMETER

OVERFLOW DRAIN

OPEN TO STRUCTURE

PRECAST CONCRETE

POUNDS PER SQARE FOOT

POUNDS PER SQUARE INCH

MISCELLANEOUS

NOT IN CONTRACT

NOISE REDUCTION

COEFFICIENT

NOT TO SCALE

ELEVATION (GRADE)

EXPOSED, EXPANSION

ELECTRICAL

EMERGENCY

ENCLOSED

ENTRANCE

ESTIMATED

EXTERIOR

FABRICATED

FASTEN(ED)

FIELD VERIFY

FLOOR DRAIN

FOUNDATION

FACTORY FINISH

FLASHING

FINISHED

FLANGE

FLOORING

FM GLOBAL

FOOT, FEET

GALVANIZED

GLASS

GROUND

GYPSUM

GRAVEL STOP

HEIGHT, HIGH

HAT CHANNEL

HARDBOARD

HORIZONTAL

COOLING

INCH

JOIST

JOINT

1000 LBS.

KILOWATTS

INDUSTRIAL

INTERIOR

INSULATION

INTERNATIONAL

RESIDENTIAL CODE

KIPS PER SQUARE INCH

HOLLOW METAL

INSIDE DIAMETER

HOSE BIB

GALVANIZED STEEL

GYPSUM WALL BOARD

HI DENSITY POLYETHYLENE

HEATING, VENTILATION &

INTERNATIONAL BLDG CODE

FOOTING

FURRING

FIRE RETARDANT TREATED

GENERAL CONTRACTOR

FLOOR LINE

RIDGE FLASHING

EQUAL

ENTR

FLR

FTG

FURR

GALV

GND

GYP

HDPE

HVAC

JST JNT

KIP

KSI

GRVST

- THE SPECIFIED PRODUCT OR SYSTEMS IS NOT COMPATIBLE WITH AN ADJOINING COMPONENT, PRODUCT OR SYSTEM;
- 2. THE SPECIFIED ITEM NO LONGER COMPLIES WITH THE CURRENT BUILDING CODE REQUIREMENTS;
- 3. THE SPECIFIED PRODUCT OR SYSTEM DOES NOT HAVE A QUALIFIED INSTALLER OR AN INSTALLER CAPABLE OF INSTALLING WITHIN THE PROJECT SCHEDULE:
- 4. THE MANUFACTURER OF THE SPECIFIED PRODUCT DECLINES TO WARRANT THE
- 5. THE OWNER DECIDED TO SUBSTITUTE A LESS COSTLY COMPONENT WITHIN THE DESIGN.

ROUGH OPENING

SANITARY DRAIN

SPLASH BLOCK ROOF SCUTTLE

SECTION

SQUARE FEET

SHEATHING

SILICONE

SEALANT

SIMILAR

COMPOSITION SHINGLE

SINGLE PLY MEMBRANE

STAINLESS STEEL

STRESS PLATE

TOP OF CURB

TOP OF STEEL

TOP OF SLAB

UNDERLAYMENT

VARIABLE

VERTICAL

VINYL TILE

WITHOUT

WOOD

WINFLG WINDOW FLANGE

WWM WELDED WIRE MESH

WATER CLOSET

WIDE FLANGE

WOOD SCREWS

WATERPROOFING

WELDED WIRE FABRIC

WEATHER RESISTIVE BARRIER

WOOD BLOCKING

WOOD FIBER BOARD

VFRIFY

VENTILATION

VENTILATION PIPE

VAPOR RETARDER

VERIFY IN FIELD

TYPICAL

TREAD

THROUGH

TEMPERED GLASS

TONGUE & GROOVE

TOP OF CONCRETE

UNDERWRITERS LABORATORY

VAPOR PERMEABLE FLASHING

STORAGE

SYSTEM

REVEAL

C/E RVT CLOSED END RIVET

RIVET

2-RGT 2 PC REGLET

RVT

SHGL

SHTG SILC SIM SLNT

SPM

STP

SYS

T&G

TOC TOS TRD TS

TYP

VAR

VENT

VER

VERT

VIF

WD

WFBD

WWF

STOR

REVOLUTIONS PER MINUTE

SELF-ADHERED MEMBRANE

VICINITY MAP:



PROJECT INFORMATION:

4621 MERIDIAN AVENUE EAST PUYALLUP, WASHINGTON 98373 SHEET INDEX:

M2.10

M3.00

government.

PROJECT INFORMATION / SHEET INDEX

ROOF PLAN / SIGHT LINE SECTION RTU 1-4 ASSEMBLY PLANS / SECTIONS

RTU 5 ASSEMBLY PLANS / SECTIONS

RTU 6 ASSEMBLY PLANS / SECTIONS

MECHANICAL LEGEND AND ABBREVIATIONS

MECHANICAL BASIS OF DESIGN, AND NOTES

STRUCTURAL ROOF PLAN

MECHANICAL SCHEDULES MECHANICAL DEMO PLAN

MECHANICAL ROOF PLAN

MECHANICAL DETAILS

Approval of submitted plans is not an

regulations of local government. The

codes and regulations of the local

The approved construction plans,

approval of omissions or oversights by this office or non compliance with any applicable

contractor is responsible for making sure

documents, and all engineering must be

posted on the job at all inspections in a

visible and readily accessible location.

be provided by the permitee on site for

Full sized legible color plans are required to

Separate Electrical Permit is required with

the Washington State Department of Labor

electrical-permits-fees-and-inspections

or call for Licensing Information:

1-800-647-0982

PROJECT MANAGER:

CONTACT:

BUILDING

PRINCIPAL:

ARCHITECT:

PROJECT MANAGER:

ENVELOPE DESIGN:

PROJECT TEAM:

https://lni.wa.gov/licensing-permits/electrical/

MICHAEL'S

SUITE A905

(253) 864-7600

JASON FOLSOM

Phone: (956) 207-7777

4621 S. MERIDIAN ST

PUYALLUP, WA 98373

HARLINGEN, TEXAS 78552

Email: Jason.Folsom@cbre.com

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SEATTLE, WASHINGTON 98104

Email: Darbi.Krumpos@socotec.us

Email: Name.Name@socotec.us

Email: Emile.Wang@socotec.us

401 2nd AVE S., SUITE 301

Phone: (206) 467-0544

DARBI KRUMPOS

EMILE WANG

CBRE | ON DEMAND PROJECT MANAGEMENT

that the building complies with all applicable

GENERAL DESCRIPTION:

- REMOVE AND DISPOSE OF EXISTING ROOFTOP HVAC UNITS. INSTALL AND FLASH NEW CURB EXTENSIONS TO EXISTING ROOF CURBS AND
- INSTALL AND HOOK UP NEW ROOFTOP HVAC UNITS.

SITE STATISTICS ARE TAKEN FROM AVAILABLE PUBLIC INFORMATION AND HAVE NOT BEEN CONFIRMED BY ACTUAL SURVEY.

GENERAL NOTES:

- ENSURE ALL INTERIOR FINISHES ARE PROTECTED FROM DAMAGE DUE TO THE ENVIRONMENT OR CONSTRUCTION. PHASE ALL WORK TO ALLOW STRUCTURE TO BE WEATHER TIGHT BY CLOSE OF WORK EACH DAY.
- DISENGAGE ALL ELECTRICAL. MECHANICAL AND PLUMBING SYSTEMS TO BI FFFECTED WITH ONGOING WORK. NOTIFY OWNER OF SCHEDULE FOR THIS.
- REMOVE AND PROPERLY CAP ALL ELECTRICAL FIXTURES; STORE ALL TO BE REUSED; NOTIFY OWNER OF ANY IN NEED OF REPAIR/REPLACEMENT.
- REMOVE AND STORE ALL OPERABLE MOTORS AND ASSOCIATED CHAINS AND HARDWARE; NOTIFY OWNER OF ANY IN NEED OF REPAIR/REPLACEMENT.

SITE MAP:




RESIDENTIAL SHEET METAL COMMERCIAL SHEET METAL SEALANTS AND SEALANT APPLICATION LOW SLOPE ROOFING

SDI STEEL DECK INSTITUTE, SDI ROOF DECK DESIGN MANUAL, RDDM2 (2020) AISI COLD FORMED STEEL DESIGN MANUAL, 2017 EDITION

AMERICAN SOCIETY OF CIVIL ENGINEERS (ASCE) 7-16 ARCHITECTURAL PAINTING SPECIFICATIONS MANUAL, MASTER PAINTERS INSTITUTE (2019) ASHRAE 90.1-2019; ENERGY STANDARD FOR BUILDINGS **EXCEPT** LOW RISE RESIDENTIAL BUILDINGS

STEEL ROOF DECK LIGHT GAUGE STEEL FRAMING ROOF DRAINAGE WIND LOADING EXTERIOR PAINTING ENERGY DESIGN

City of Puyallup Building REVIEWED FOR COMPLIANCE

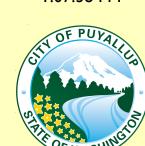


SKinnear 08/23/2024 1:07:38 PM


REFERENCED DESIGN MANUALS FOR INDUSTRY STANDARDS* REDWOOD DECKS, MATERIALS, CONSTRUCTION & FINISHING, CALIF REDWOOD ASSOC. (2007) WOOD DECK CONSTRUCTION SMACNA RESIDENTIAL SHEET METAL GUIDELINES, 1ST EDITION (2001)


SMACNA ARCHITECTURAL SHEET METAL MANUAL 7TH EDITION (2012) SWR INSTITUTE; SEALANTS: THE PROFESSIONAL'S GUIDE (2013); ASTM C 1193-16R23 STANDARD GUIDE FOR USE OF JOINT SEALANTS; HANDBOOK OF ADHESIVES AND SEALANTS, 3RD EDITION (2020) NRCA ROOFING MANUAL-MEMBRANE ROOF SYSTEMS (2023)

ROOF DRAINAGE - SECOND EDITION; ROOF CONSULTANTS INSTITUTE (2021)

*REFERENCE THE CURRENT VERSION OF THE ABOVE NOTED MANUALS FOR INDUSTRY STANDARDS

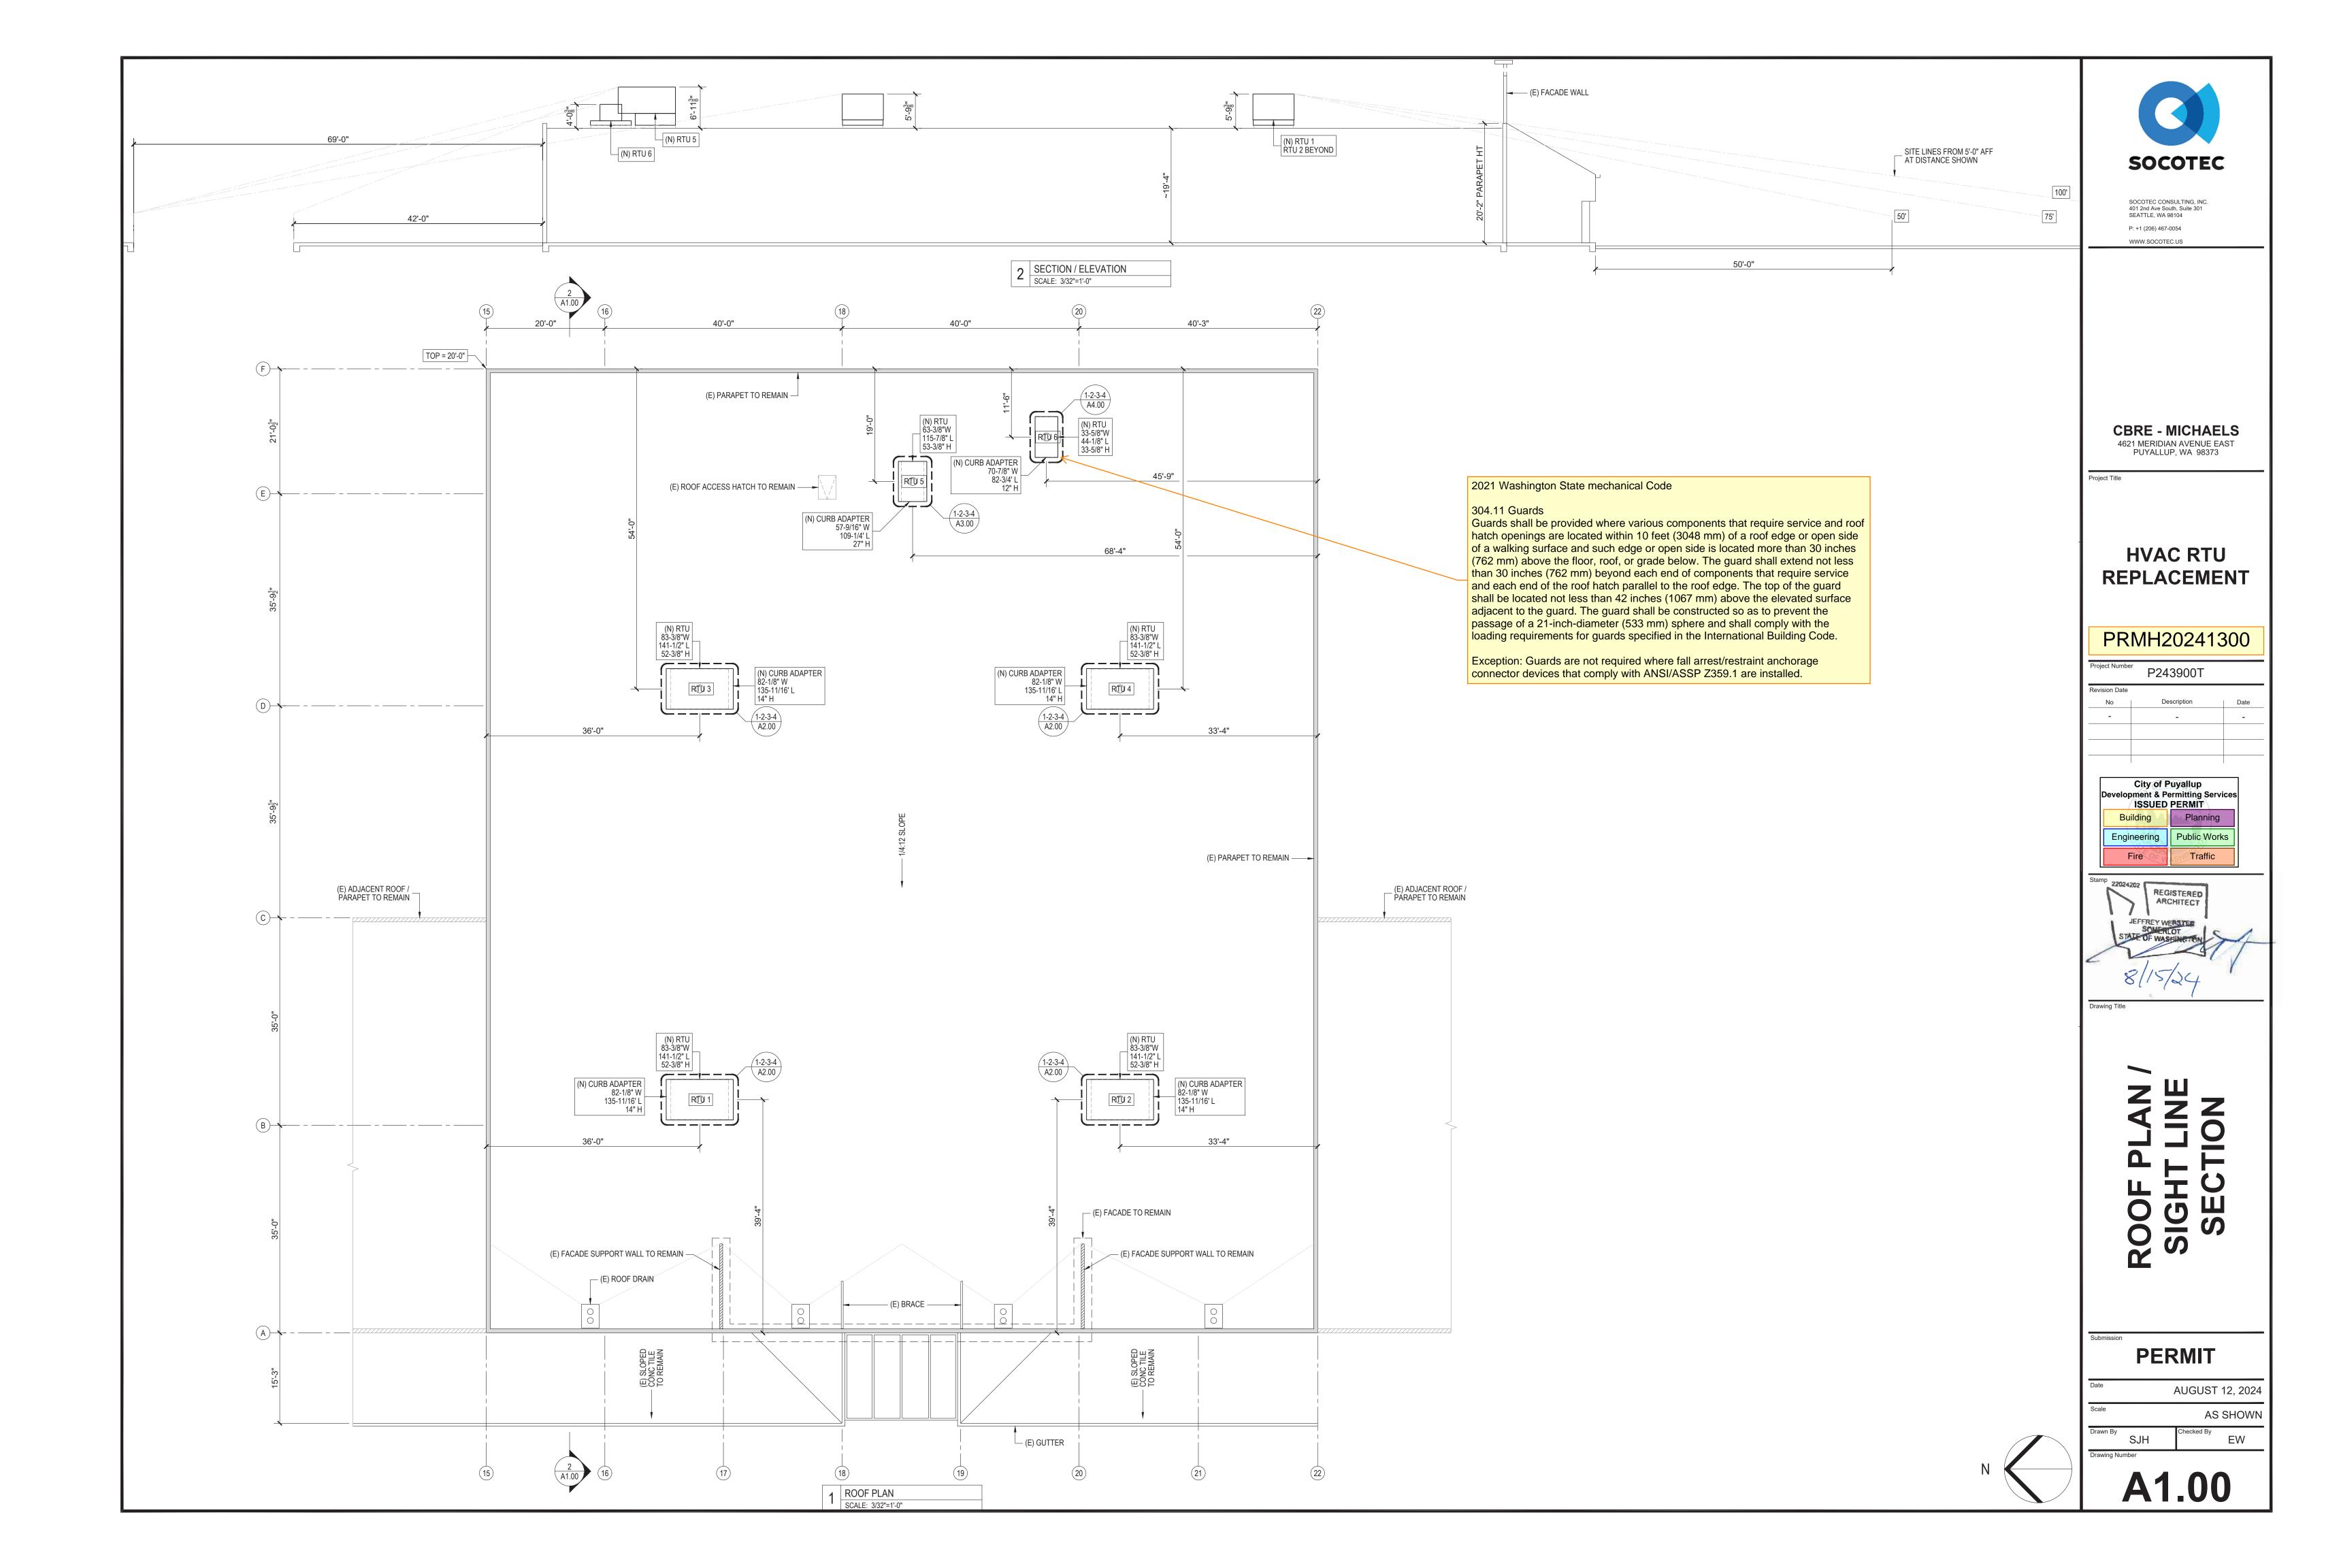

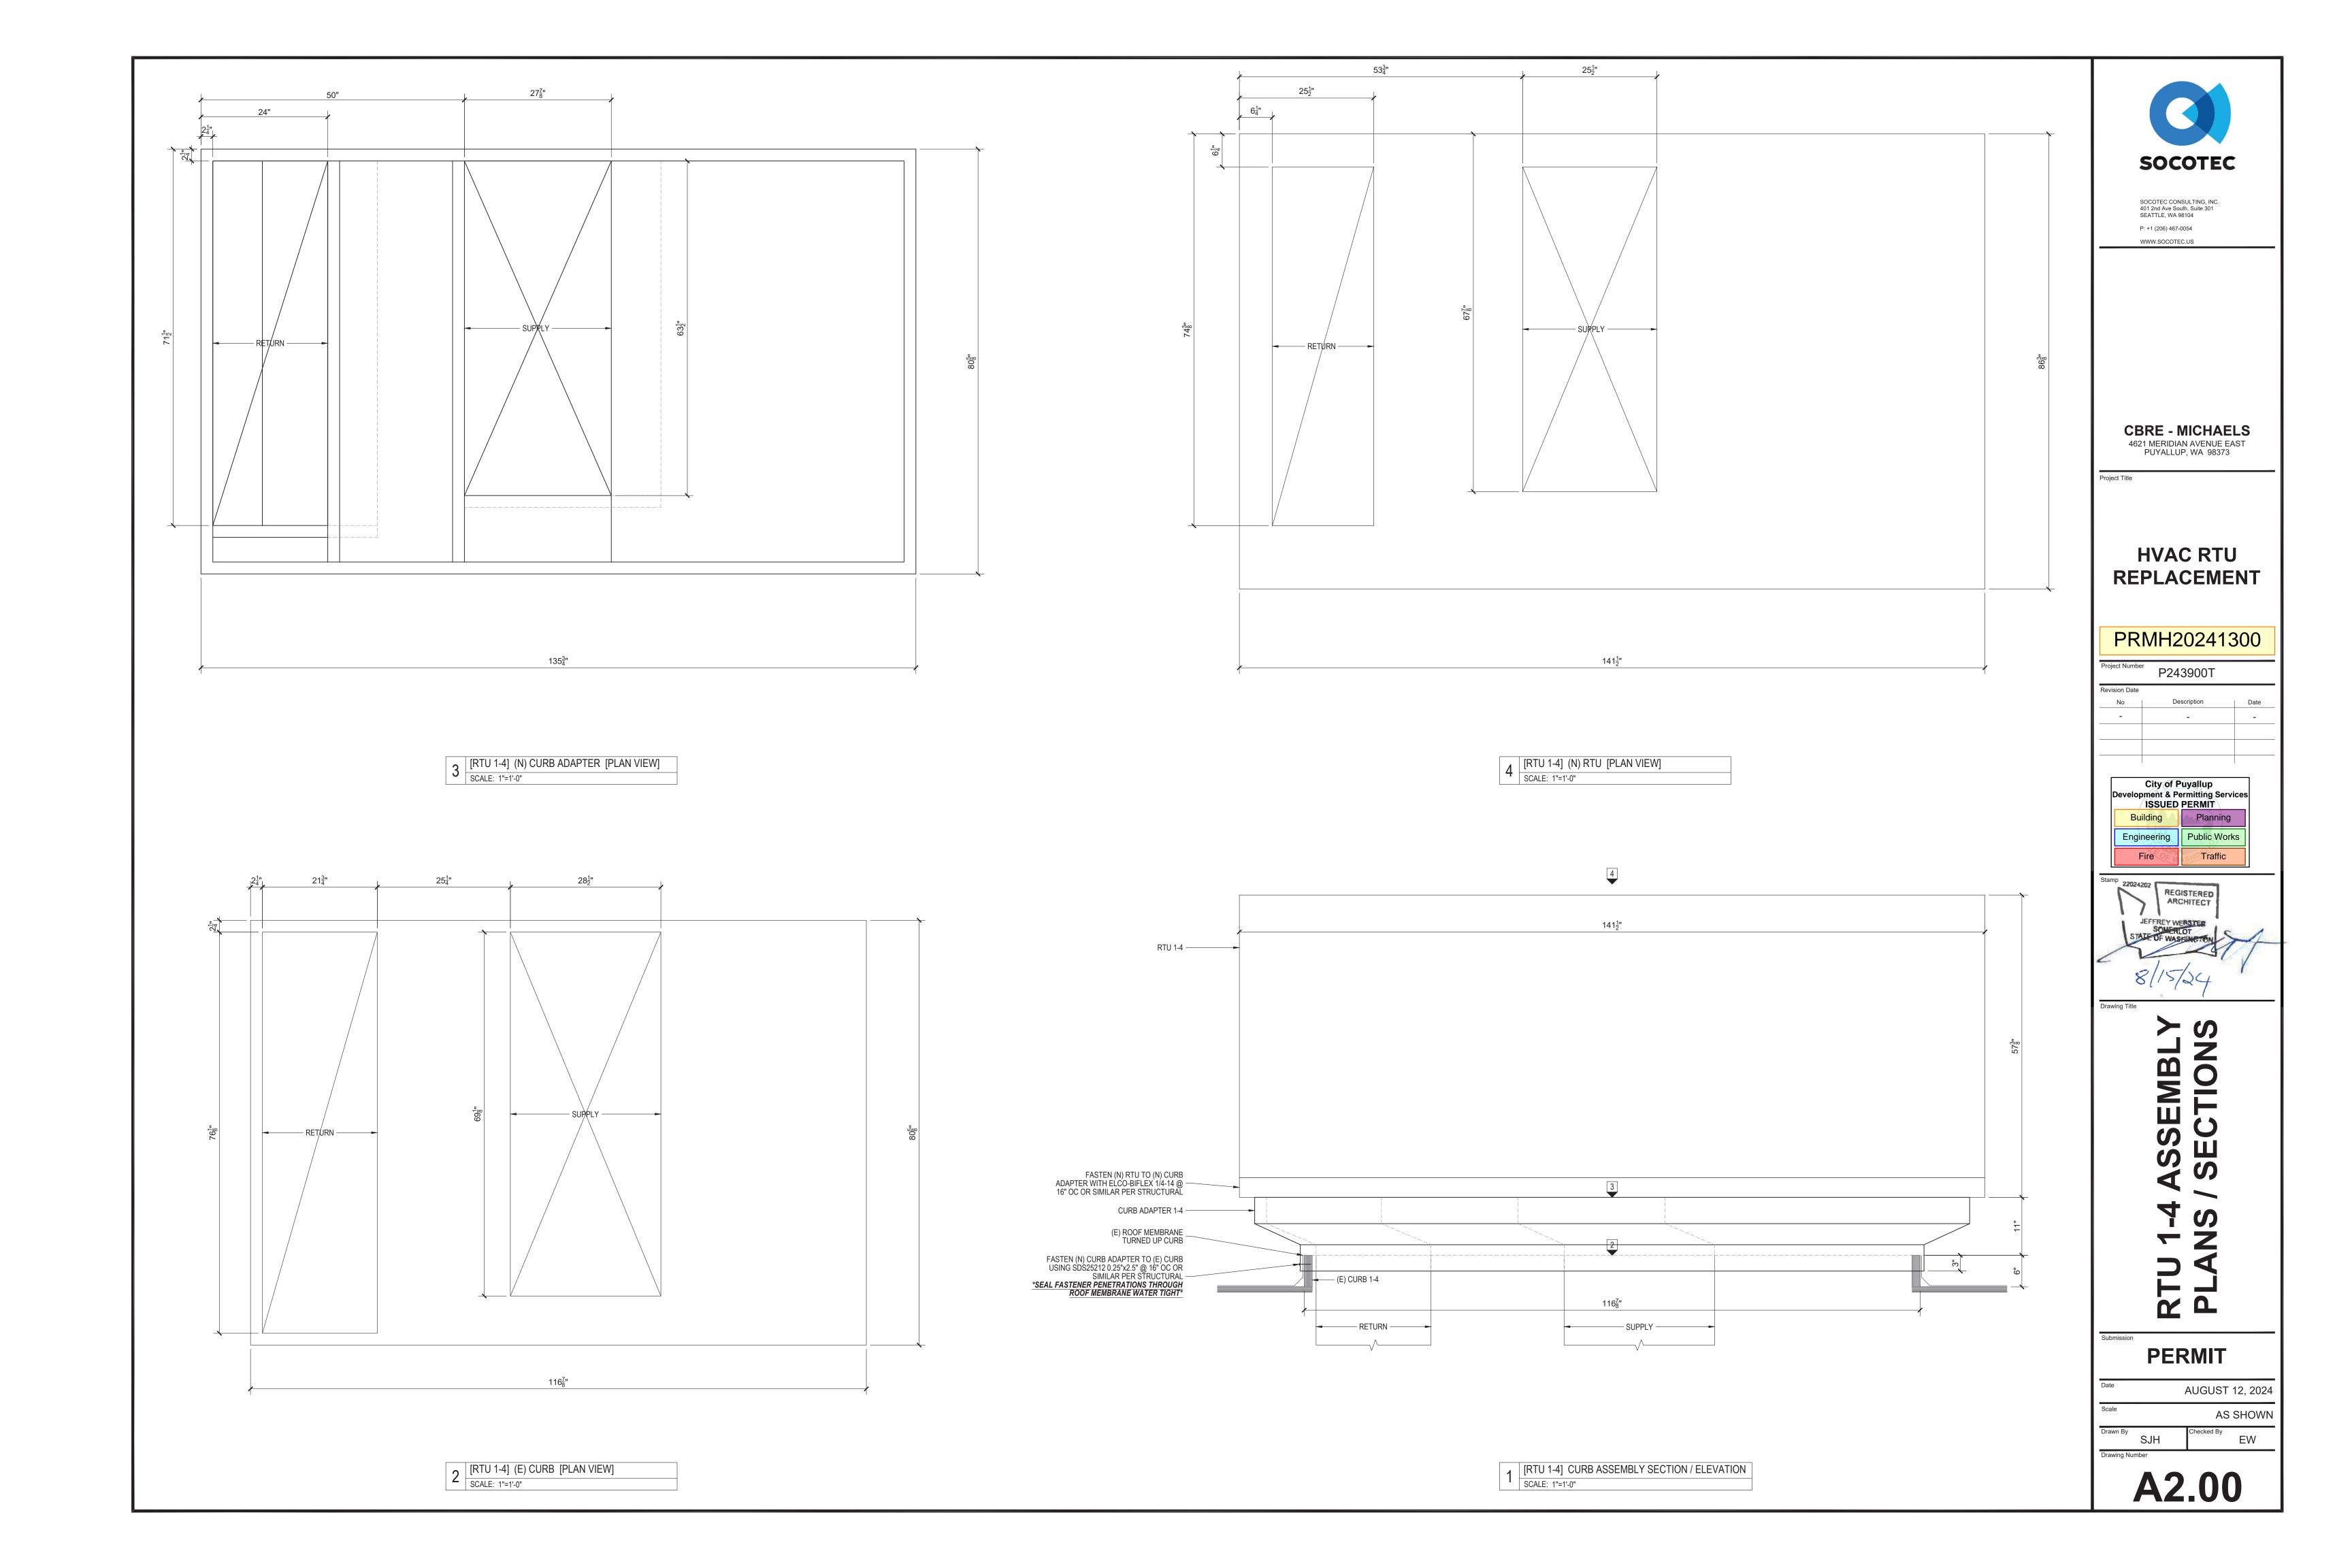

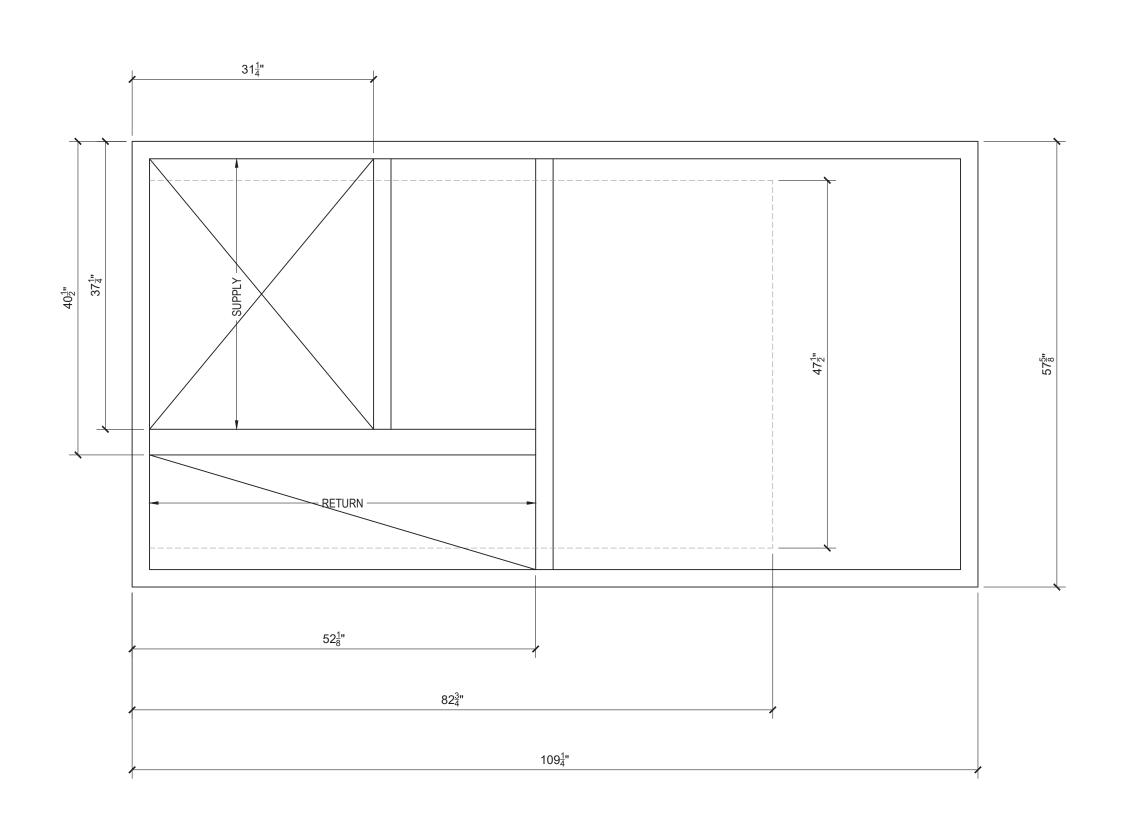



3 [RTU 5] (N) CURB ADAPTER [PLAN VIEW]
SCALE: 1"=1'-0"

2 [RTU 5] (E) CURB [PLAN VIEW]
SCALE: 1"=1'-0"

Sign Andrew Area and Area and

IDTU SI (AN DEL

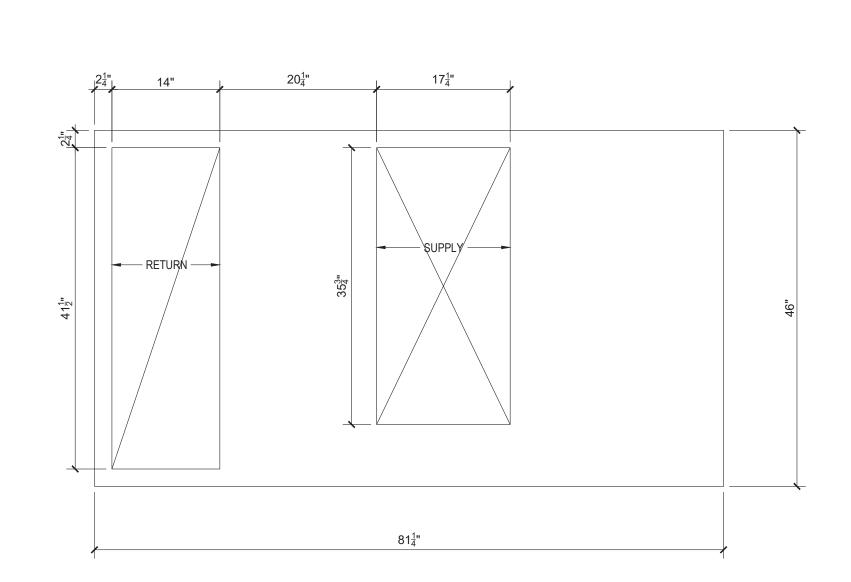

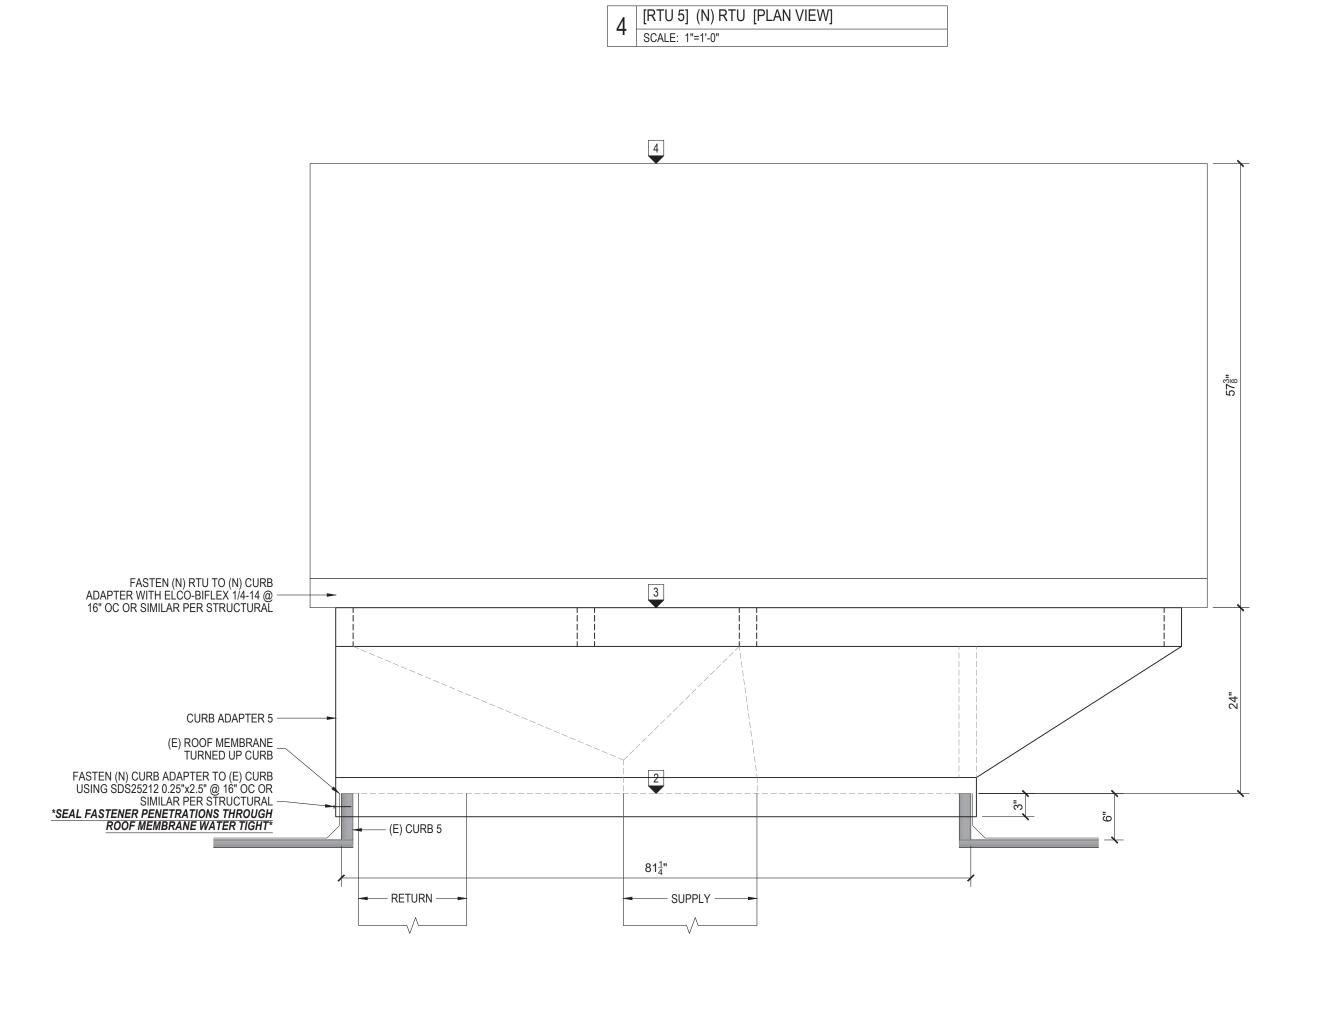

1 [RTU 5] CURB ASSEMBLY SECTION / ELEVATION
SCALE: 1"=1'-0"

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PUYALLUP, WA 98373


Project Title

HVAC RTU REPLACEMENT

PRMH20241300

Project Numbe	Project Number P243900T					
Revision Date						
No	Description	Date				
-	-	-				

Development &	City of Puyallup Development & Permitting Services ISSUED PERMIT								
Building	Planning								
Engineering	Public Works								
Fire	Traffic								

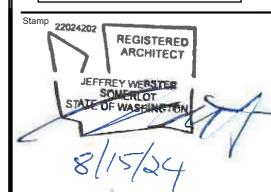

Drawing Title


RECTIONS / SECTIONS


PERMIT

SJH


Date AUGUST 12, 2024
Scale AS SHOWN


A3.00

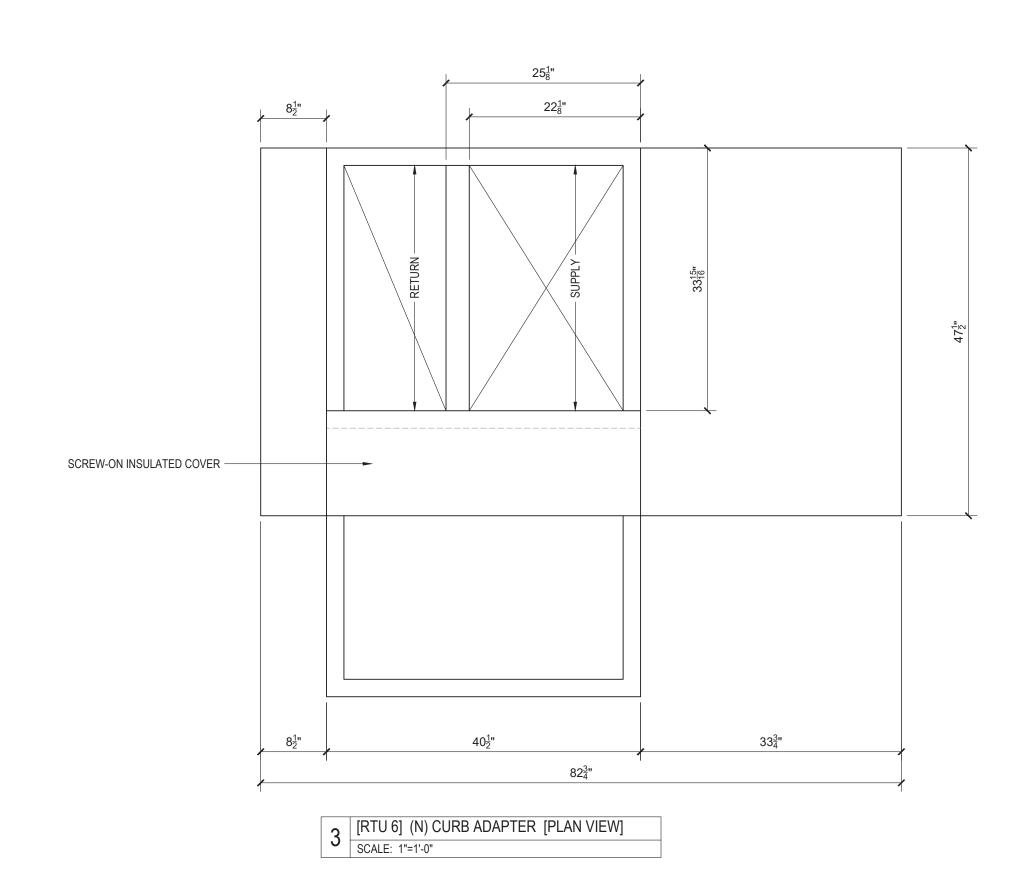

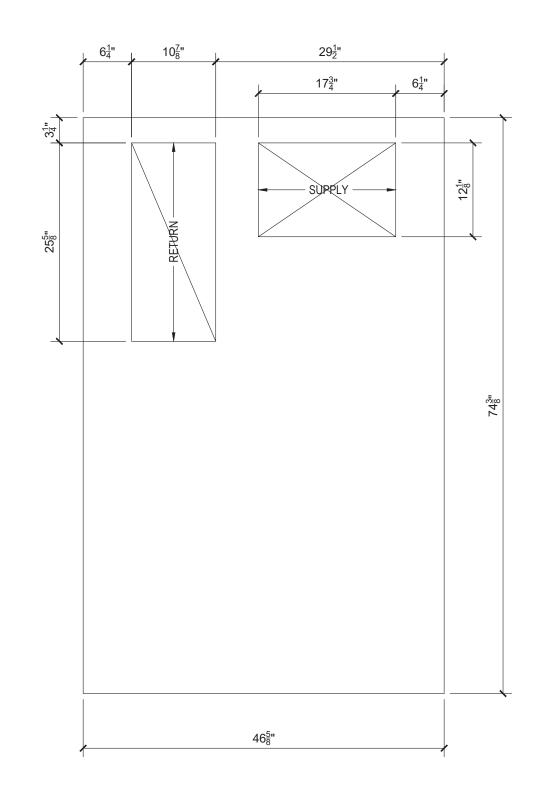

4 | [RTU 6] (N) RTU [PLAN VIEW]
| SCALE: 1"=1'-0"

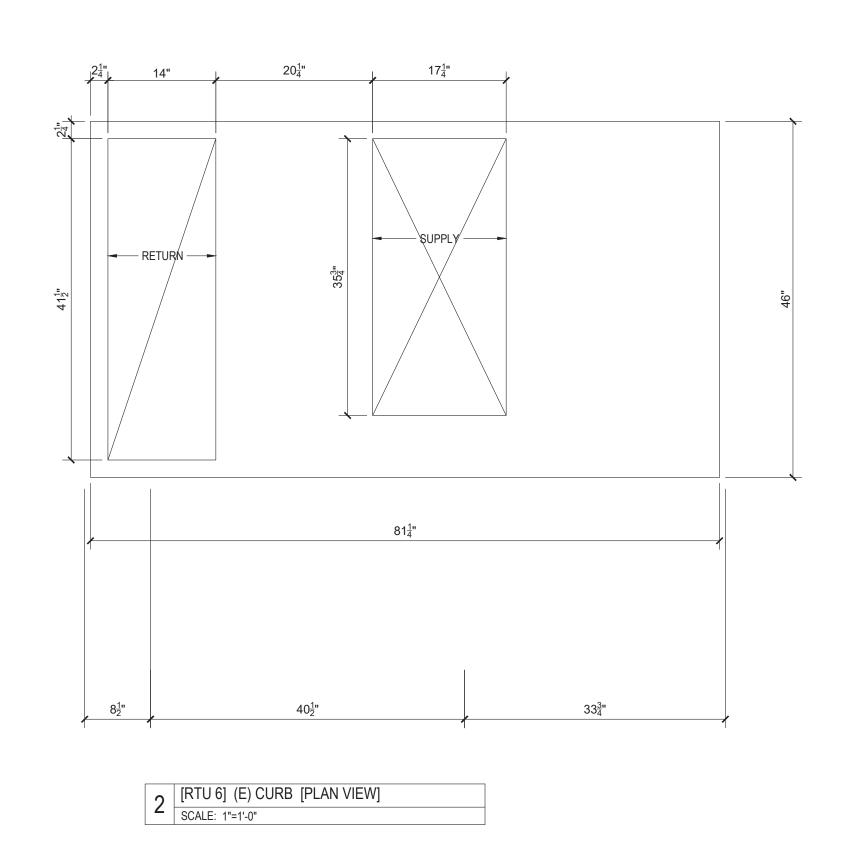

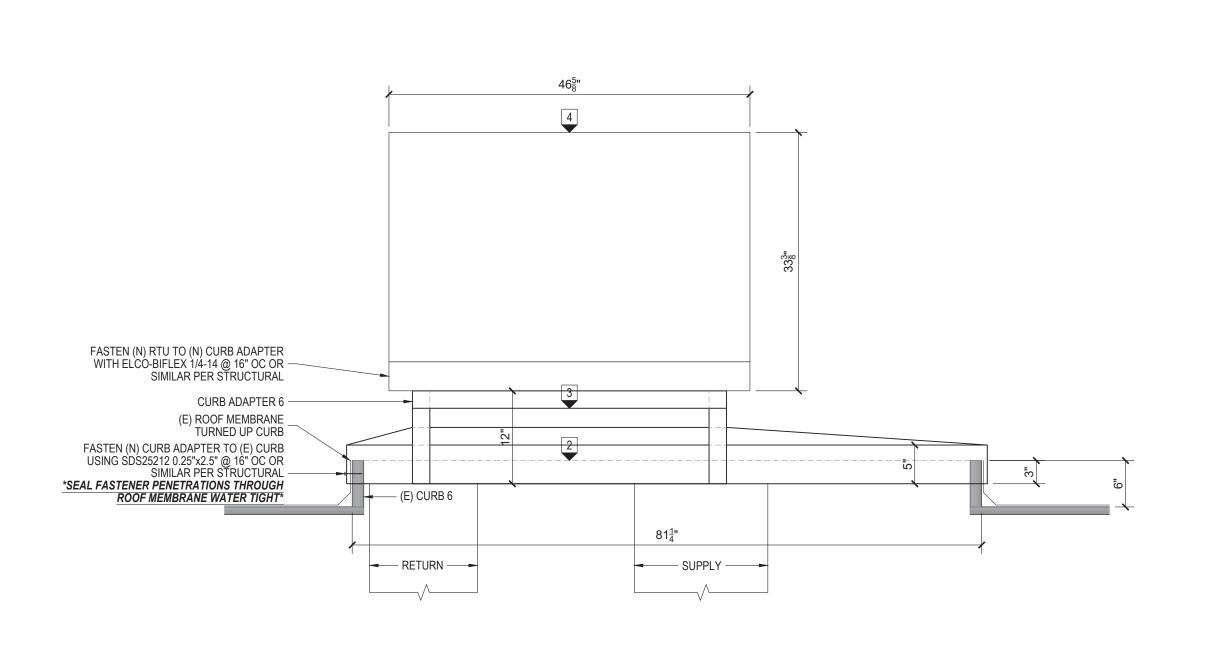

1 [RTU 6] CURB ASSEMBLY SECTION / ELEVATION
SCALE: 1"=1'-0"



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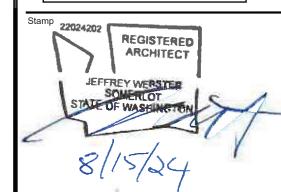
Draiget Title

HVAC RTU REPLACEMENT

PRMH20241300

Project Numbe	P243900T	
Revision Date		
No	Description	Date
-	-	-

	Puyallup ermitting Services PERMIT
Building	Planning
Engineering	Public Works
Fire	Traffic



Drawing Title

RTU 6 ASSEMBLY PLANS / SECTIONS

PERMIT

AUGUST 12, 2024

Drawn By SJH Checked By EW

Drawing Number

A4.00

NOTES 1. ALL DIMENSIONS MUST BE VERIFIED IN FIELD. LOCATIONS OF UNITS ARE APPROXIMATED. DIMENSIONS OF THE EXISTING ROOF STRUCTURAL ELEMENTS ARE BASED UPON THE ORIGINAL DRAWINGS. ACTUAL CONDITIONS MAY VARY.



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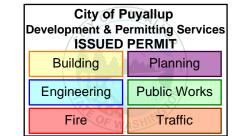
4621 MERIDIAN AVENUE EAST
PUYALLUP, WA 98373


HVAC RTU REPLACEMENT

PRMH20241300

P243900T

No Description Date



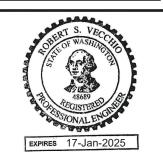

Prawing Title

STRUCTURAL ROOF PLAN


PERMIT

Date AUGUST 12, 2024
Scale AS SHOWN

SJH


Drawing Number

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PROJECT ADDRESS
4621 MERIDAN, PUYALLUP, WA 98373

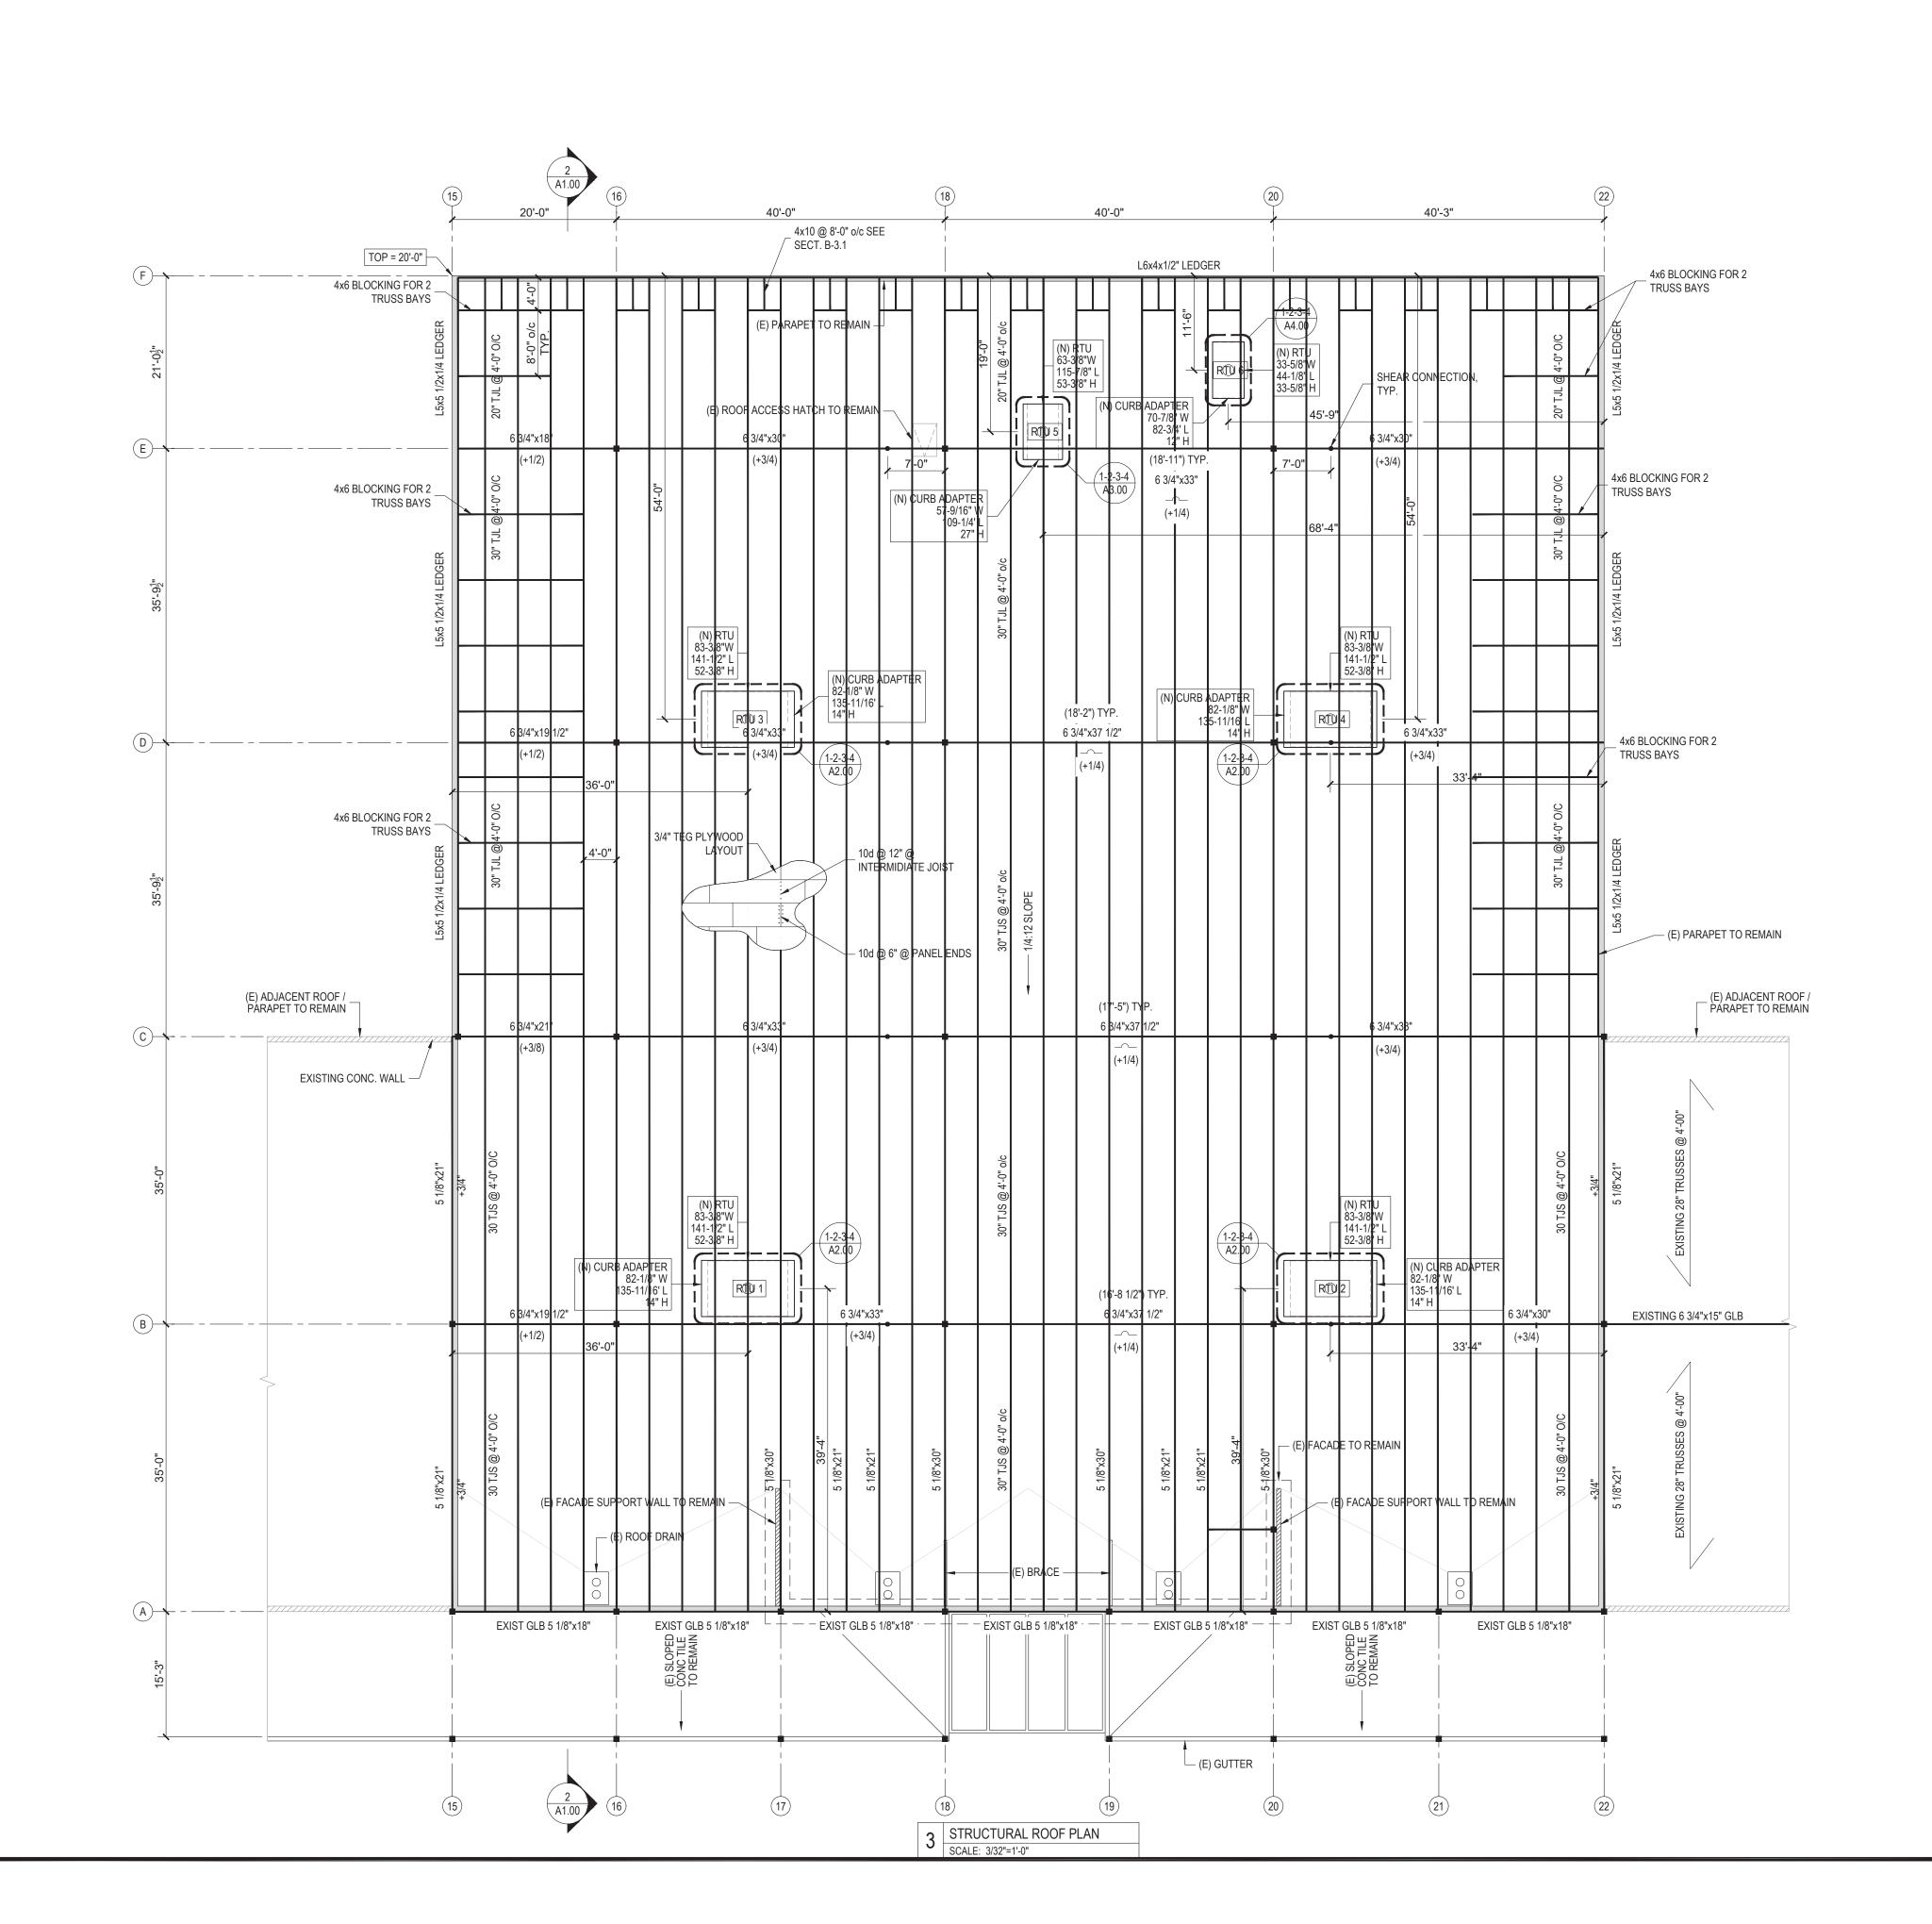

MECHANICAL DRAWING INDEX

SHEET NUMBER	SHEET TITLE	SHEET SCALE
M0.00	MECHANICAL LEGEND AND ABBREVIATIONS	NTS
M1.00	MECHANICAL BASIS OF DESIGN, AND NOTES	NTS
M1.10	MECHANICAL SCHEDULES	NTS
M2.00	MECHANICAL DEMO PLAN	3/32" = 1'-0"
M2.10	MECHANICAL ROOF PLAN	3/32" = 1'-0"
M3.00	MECHANICAL DETAILS	NTS

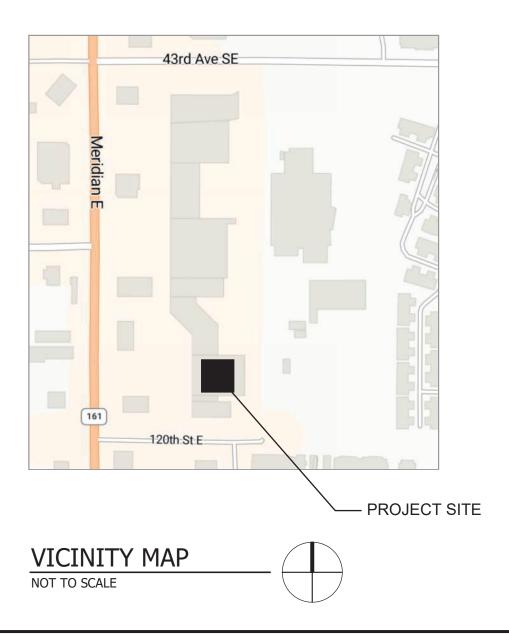

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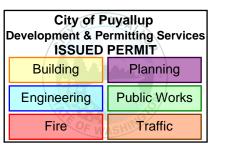
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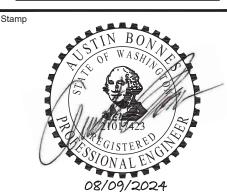
Project Number #

Revision Date

No Description Date

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Drawing Title

MECHANICAL LEGEND AND ABBREVIATIONS

PERMIT

AUGUST 12, 2024

Scale AS SHOWN

Drawn By Checked By

M0.00

HVAC DUCT MATERIALS SPECIFICATION MATRIX

DUCT SYSTEM OR SECTION SMACNA PRESSURE CLASS		MATERIALS FITTINGS		INSULATION	REMARKS	
ROOFTOP PACKAGE UNITS						
SUPPLY & RETURN	SMACNA +1" PRESSURE SEAL ALL TRANSVERSE JOINTS, LONGITUDINAL SEAMS, BRANCH CONNECTIONS OVAL AND SPIRAL LOCK SEAMS DO NOT REQUIRE SEALING	INDOORS: 1" LINED GALVANIZED DUCT OUTDOORS: 2" LINED GALVANIZED DUCT OUTDOORS FLEX: 12' MAX LENGTH, THERMAFLEX S-TL CLASS I AIR DUCT	CENTERLINE RADIUS OF 1.0 DIAMETER OR MITERED 90S WITH VANES, SPIN-IN BRANCHES OK.	2" LINED	WHERE OUTDOORS, COAT ALL SIDES WITH RCD CORP. #15 WEATHER BARRIER COATING	

REMARKS

1: ALL DUCT WORK TO BE CONSTRUCTED TO SMACNA SEAL CLASS A STANDARDS: ALL TRANSVERSE JOINTS, LONGITUDINAL SEAMS AND DUCT WALL PENETRATIONS TO BE SEALED.

2: ALL DIMENSIONS SHOWN ON PLANS ARE INSIDE CLEAR DIMENSIONS.

MECHANICAL BASIS	OF DESIGN		MICHAEL'S PUYALLUF
BOD CRITERIA	BOD INPUT	SOURCE	ADDITIONAL SOURCE INFO (DATE, MEETING, E-MAIL, ETC)
RUSHING PROJECT CONTACTS			
MECHANICAL EOR	AUSTIN BONNES		
MECHANICAL LEAD ENGINEER	LINDA COPPA		
BUILDING & MECHANICAL CODE NOTES			
DEFERRED PERMIT SUBMITTALS			
	SEISMIC TIEDOWN CALCULATIONS, BY MC		
HVAC SYSTEM SELECTION OWNER CRITE	RIA NOTES		
	EXISTING BUILDING WITH EXISTING COOLING AND GAS HEAT		
	REPLACEMENT OF EXISTING ROOFTOP HEAT/COOLING UNIT WITH SAME CAPACITY AS		
	PREVIOUS UNITS		
HVAC LOAD DESIGN CRITERIA			
PROJECT LOCATION	: PUYALUP, WASHINGTON		
INDOOR RELATIVE HUMIDITY CONTROL	NOT CONTROLLED	PROJECT CRITERIA	
HVAC LOAD SELECTION BASIS		2021 WSEC	SECTION C403.2.1

PLUMBING BASIS OF DESIGN			MICHAEL'S PUYALLUI
BOD CRITERIA	BOD INPUT	SOURCE	ADDITIONAL SOURCE INFO (DATE, MEETING, E-MAIL, ETC)
RUSHING PROJECT CONTACTS			
PLUMBING LEAD ENGINEER/DESIGNER	STEVEN HUFF		
BUILDING & PLUMBING CODE NOTES			
	2021 WASHINGTON STATE FUEL GAS CODE		
	2021 UNIFORM PLUMBING CODE		
PLUMBING SYSTEM OWNER CRITERIA			
GAS PIPE			SEE PIPING MATERIALS MATRIX ON DRAWINGS FOR FULL DETAILS
CONDENSATE PIPING MATERIAL			SEE PIPING MATERIALS MATRIX ON DRAWINGS FOR FULL DETAILS

PLUMBING MATERIALS SPECIFICATION MATRIX

SERVICE ID	SERVICE DESCRIPTION	DESIGN PRESSURE (PSIG)	SIZE	MATERIAL	JOINTS	LOCATION FOR USE	INSULATION (R- VALUES PER 2021 WSEC)	REMARKS
CONDENSATE								
GAS-FIRED EQUIP CO	CONDENSATE - COMBUSTION EQUIPMENT	5	ALL	CPVC PER ASTM D1784 & FITTINGS PER ASTM D 2846	SOLVENT WELD	CAN BE INSTALLED IN PLENUMS IF RATED FOR DRY USE IN PLENUMS	NOT REQUIRED	
NATURAL GAS P.	TPING							
N(-	LOW PRESSURE NATURAL GAS (<14" W.C.)	14" WC	1" AND SMALLER	CORRUGATED STAINLESS STEEL TUBING (CSST) ASTM A240 STEEL W/ POLYETHYLENE JACKET	THREADED	UNIT CONNECTION	NONE	
	(<14 W.C.)	14" WC	4" AND SMALLER	CARBON STEEL PIPE SCH 40 A53B ERW	THREADED OR BUTTWELD	ALL		OUTDOORS - PAINTED C GALVANIZED

REMARKS

1) SOLVENT CEMENT JOINTS TO BE IN ACCORDANCE WITH SECTION 705.5.2 OF THE 2021 UNIFORM PLUMBING CODE AND ASTM F656 FOR PRIMER AND ASTM D2564 FOR SOLVENT CEMENTS.

2) CARBON STEEL PIPING INSTALLED OUTDOORS SHALL BE PAINTED WITH A PROTECTIVE PAINT OR COATING TO PROTECT FROM WEATHER INDUCED CORROSION. ANY PIPE OR FITTINGS WITH OBSERVABLE CORROSION SHALL

BE CLEANED AND PREPARED OR REPLACED PRIOR TO PAINTING

3) COMBUSTION CONDENSATE SHALL BE PROVIDED WITH A CONDENSATE NEUTRALIZER (JJM BOILER WORKS JM SERIES OR EQUAL). CONDENSATE SHALL TERMINATE IN A LOCATION ACCEPTABLE TO LOCAL AHJ.

ISOLATION & TIEDOWN SCHEDULE - EQUIPMENT, PIPING, & DUCTWORK

TAG#	EQUIPMENT TYPE	GENERIC EQUIPMENT TYPE DESCRIPTION	MOUNTING LOCATION (REMARK 1)	EXTERNAL ISOLATION TYPE (REMARK 2 & 5)	ISOLATOR TYPE (REMARK 5)	FLEX CONNECTION	PIPING FLEX CONNECTION BY	SUPPORT STANCHION (REMARK 6)
ROOFTOP AIR HAND	LING UNIT							
RTU-1 - RTU-6	PACKAGED ROOFTOP UNIT	ROOFTOP AIR HANDLING UNIT	ROOF	CURB WITH ADAPTOR	REMARK 5	NEOPRENE DUCT FLEXIBLE CONNECTOR: DURO- DYNE TYPE MFN OR MF6N	MC	NA
PIPING								
PIPING	ALL	ALL SIZES	ROOF	NEOPRENE ISOLATION TO ISOLATE FROM SUPPORT	NA	NA	NA	REMARK 6
PIPING	PIPING	THROUGH PENETRATIONS		RESILENT GAP SEALANT	NA	NA	NA	NA

REMARKS (APPLY TO ALL EQUIPMENT UNO):

1: SEE MECHANICAL PLANVIEW DRAWINGS FOR EQUIPMENT LOCATIONS.

2: GC TO PROVIDE WASHINGTON STATE STAMPED SEISMIC TIEDOWN CALCULATIONS PER 2021 INTERNATIONAL BUILDING AND MECHANICAL CODES WITH SEATTLE AMENDMENTS AS A DEFERRED SUBMITTAL.

REFER TO THE STRUCTURAL DRAWINGS FOR SEISMIC DESIGN CATEGORY, SITE CLASS, AND OCCUPANCY CATEGORY. ALL EQUIPMENT TO BE ATTACHED PERECTED PER ASCE 7 AS REFERENCED BY IBC.

3: IMPORTANCE (Ip) FACTOR FOR SEISMIC CALCULATIONS. Ip = 1.0.

4: GC TO VERIFY WITH FIELD DETAILER AND/OR INSTALLER INSTALLATION DETAIL (TO VERIFY UNIT ATTACHMENT TYPE TO STRUCTURE) PRIOR TO ISOLATION VENDOR PERFORMING SEISMIC TIEDOWN CALCULATIONS AND PRIOR

TO SEISMIC TIEDOWN PACKAGE BEING SUBMITTED FOR TEAM REVIEW. ALL TIEDOWN LOCATIONS AND DETAILS TO BE SUBMITTED TO AND APPROVED BY THE PROJECT STRUCTURAL ENGINEER. MC SHALL CONTRACT WITH

THE STRUCTURAL ENGINEER FOR THIS SUPPORT WORK.

5: ROOFTOP UNITS TO SIT ON EXISTING ROOF CURB WITH ADAPTOR INSTALLED BY MC. MC SHALL STRUCTURALLY AND SEISMICALLY ATTACH ADAPTOR TO EXISTING CURB TO LEVELING

CURB AND UNIT TO SPRING CURB.

6: PIPING TO SIT ON STEEL STANCHIONS PROVIDED AND INSTALLED BY MC. MC TO COORDINATE STANCHION LOCATIONS IN FIELD SHOP DRAWINGS.

7: STAMPED SEISMIC EXPANSION AND ANCHORING PACKAGE TO BE PROVIDED BY MC

8: MAKE ALL ISOLATOR MOUNT STRUCTURAL CONNECTIONS USING NEOPRENE ISOLATION WASHER GROMMETS.

9: GAS PIPING SHALL UTILIZE A FLEXIBLE CONNECTOR.



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4621 MERIDIAN
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Project Title

HVAC RTU REPLACEMENT


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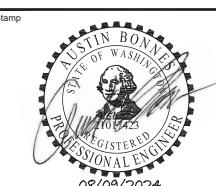
Project Number #

Revision Date

No Description Date

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Drawing 1

MECHANICAL BASIS OF DESIGN AND NOTES

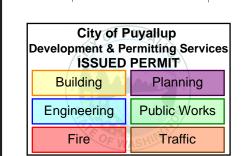PERMIT

AUGUST 12, 2024

AS SHOWN

awing Number

M1.00

ROOFTOP PACKAGE UNIT SCHEDULE

TAG #	RTU 1-4	RTU-5	RTU-6
ROVIDED BY	M.C.	M.C.	M.C.
BASIS OF DESIGN			
IANUFACTURER	CARRIER	CARRIER	CARRIER
IODEL	48LCE017A3M5-4R4C0	48LCE008A3M5-4R4C0	48GCEJ06A3M5-3W4Q
DCATION	ROOF	ROOF	ROOF
ERVICE	BUILDING	BUILDING	BUILDING
UPPLY FAN INFORMATION			
N TYPE	CENTRIFUGAL	CENTRIFUGAL	CENTRIFUGAL
N CFM	6000 CFM	3000 CFM	2000 CFM
N E.S.P.	.5" W.G.	.5" W.G.	.5" W.G.
OTOR BRAKE HORSEPOWER	2.34 BHP	0.91 BHP	0.88 BHP
PPLY VFD	YES	YES	YES
OOLING INFORMATION	123	123	123
	DV AID COOLED	DV - ATD-COOLED	DV - AID-COOLED
OOLING TYPE	DX - AIR-COOLED	DX - AIR-COOLED	DX - AIR-COOLED
APORATOR EAT (DB°F/WB°F)	80 / 67°F	80 / 67°F	80 / 67°F
IIT LAT (DB°F/WB°F)	58.0 / 57.2°F	58.3 / 57.2°F	58.3 / 57.3°F
OOLING MBH TOTAL (GROSS)	186 MBH	93 MBH	62 MBH
IBIENT CONDENSER TEMPERATURE °F (COOLING)	95°F	95°F	95°F
OOLING LOCKOUT TEMPERATURE	55°F	55°F	55°F
DDE MIN SEER/EER	10.8 EER	11.0 EER	11.0 EER
CTUAL SEER/EER	12.8 EER	12.8 EER	17.4 SEER
EATING INFORMATION - PRIMARY			
ATING TYPE	GAS	GAS	GAS
ATING COIL EAT/LAT	70°F / 109°F	70°F / 115°F	70°F / 110°F
EATING MBH TOTAL	251 MBH	146 MBH	88 MBH
ATING LOCKOUT TEMPERATURE (AMB / COIL EAT)	47°F / 55°F	47°F / 55°F	47°F / 55°F
LECTRICAL INFORMATION			
MERGENCY POWER (NEC 700)	NA	NA	NA
GALLY REQUIRED STANDBY POWER (NEC 701)	NA	NA	NA
ANDBY POWER (NEC 702)	NA	NA NA	NA
SCONNECT	BY E.C.	BY E.C.	BY E.C.
CCR	SEE ELECTRICAL, REMARK 6	SEE ELECTRICAL, REMARK 6	SEE ELECTRICAL, REMARK 6
LTAGE/PHASE	208/3	208/3	208/3
IIT MCA	86.9	47	30
IIT FLA	92	50	29
NIT MOCP	100	60	45
TURN SMOKE DETECTOR (REMARK 1)	NO (REMARK 1)	NO (REMARK 1)	NO (REMARK 1)
NIT MISC INFORMATION			
STED IN AHRI CERTIFICATION PROGRAM	YES	YES	YES
CTORY CURB	YES	YES	YES
DAPTOR CURB HT	14"	27"	12"
NIT HEIGHT	59''	59''	41"
/ERALL HEIGHT (INCLUDING CURB ADAPTOR)	73''	86"	53"
/ERALL WIDTH	86"	63"	47"
/ERALL LENGTH	142"	116"	74"
NIT WEIGHT	2622 LBS	1852 LBS	686 LBS
IRB ADAPTOR WEIGHT	392 LBS	309 LBS	144 LBS
ERATING WEIGHT WITH CURB ADAPTOR	3014 LBS	2161 LBS	830 LBS
PE OF REFRIGERANT	R-410A	R-410A	R-410A
W AMBIENT OPERATION	NO	NO	NO
ONOMIZER WITH BAROMETRIC RELIEF	YES	YES	YES
MPRESSOR QUANTITY	1	1	1
NTROLLED BY (REMARK 4)	STANDALONE PROG CONTROLLER	STANDALONE PROG CONTROLLER	STANDALONE PROG CONTROLLER
ONDENSATE OVERFLOW SHUTDOWN SWITCH IN	YES, BY CC	YES, BY CC	YES, BY CC
RIMARY DRAIN PAN	•	•	
SCHARGE (HORIZONTAL / DOWNFLOW) MARKS:	DOWNFLOW 1.2.3.4.5.6.7	DOWNFLOW 1.2.3.4.5.6.7	DOWNFLOW 1.2.3.4.5.6.7
DODERS:	1 / 3 / 5 6 /	1 / 4 / 5 6 /	1 1 2 / 1 6 6 7

1: WHERE INDICATED IS BY FIRE ALARM CONTRACTOR REFERENCE INDICATED AS TO WHERE SMOKE DETECTORS MAY BE REQUIRED IS PER IMC SECTION 606. DESIGN OF SMOKE DETECTION SYSTEM IS BY FIRE ALARM CONTRACTOR. ALL SMOKE DETECTORS ARE PROVIDED BY FIRE ALARM CONTRACTOR. INSTALLATION OF DUCT DETECTORS IS BY FIRE ALARM CONTRACTOR UNDER THE SUPERVISION OF M.C. ALL WIRING AND FIRE LIFE SAFETY INTERLOCKS ARE BY FIRE ALARM CONTRACTOR

- 2: PROVIDE MANUFACTURER'S TOUCHSCREEN INTERFACE CONTROLLER OR ALTERNATE CAPABLE OF EXECUTING CONTROL FUNCTIONS.
- 3: PROVIDE WITH UNIT CONTROLLER WITH INPUT CAPABILITY FROM EXISTING THERMOSTATS.
- 4: PROVIDE UNIT WITH SCCR TO MEET FULL CIRCUIT RATING REQUIREMENT.
- 5: UNIT OR UNIT COMPONENTS TO HAVE A MINIMUM AIC OF 5,000.
- 6: THE WASHINGTON STATE DEPARTMENT OF ENERGY AND THE ENVIRONMENTAL PROTECTION AGENCY REQUIRE EQUIPMENT TO UTILIZE REFRIGERANTS WITH < 700 GWP BASED ON EQUIPMENT TYPE
- AND INSTALLATION/REFRIGERATION CHARGE DATE. REFRIGERANT TYPE SELECTED WILL COMPLY WITH DOE AND EPA REQUIREMENTS.
- 7: PROVIDE WITH INTERNAL VFD.

RTU ROOF CURB			
TAG #	RTU-1-CURB - RTU-4-CURB	RTU-5-CURB	RTU-6-CURB
MANUFACTURER	CDI CURBS	CDI CURBS	CDI CURBS
MODEL NUMBER	48LCE017	48LC08	48GCEJ06
RTU - BASIS OF DESIGN			
RTU MANUFACTURER	CARRIER	CARRIER	CARRIER
RTU MODEL	48LCE017A3M5-4R4C0	48LCE008A3M5-4R4C0	48GCEJ06A3M5-3W4Q
DESIGN PARAMETERS			
FAN BASE OD (LENGTH & WIDTH DIMENSION IN INCHES)	SEE RTU SCHEDULE	SEE RTU SCHEDULE	SEE RTU SCHEDULE
OUTSIDE OF CURB (LENGTH & WIDTH DIMENSION IN INCHES)	FIELD VERIFY	FIELD VERIFY	FIELD VERIFY
ROOF OPENING (LENGTH & WIDTH DIMENSION IN INCHES)	FIELD VERIFY	FIELD VERIFY	FIELD VERIFY
DUCT OD MAX SIZE (LENGTH & WIDTH DIMENSION IN INCHES)	FIELD VERIFY	FIELD VERIFY	FIELD VERIFY
ACTUAL DUCT SIZE (LENGTH & WIDTH DIMENSION IN INCHES)	FIELD VERIFY	FIELD VERIFY	FIELD VERIFY
FAN CFM	6000 CFM	3000 CFM	2000 CFM
CURB WEIGHT	400 LBS	310 LBS	145 LBS
REMARKS:			
1. MATERIAL: 16 GA GALVANIZED STEEL WITH INSULATED PANEL	S PER WSEC.		



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HVAC RTU REPLACEMENT

PRMH20241300

Project Number	#	
Revision Date		
No	Description	Date
-		

City of Puyallup Development & Permitting Services ISSUED PERMIT		
Building	Planning	
Engineering	Public Works	
Fire OF V	Traffic	



Drawing Title

MECHANICAL SCHEDULES

PERMIT

AUGUST 12, 2024

Scale AS SHOWN

LJC

N/1 10

GENERAL SHEET NOTES A. DEMOLISH EXISTING AIR HANDLERS ON ROOF. EXISTING CURB TO BE RE-USED. B. TEMPORARILY CAP GAS CONNECTIONS FOR CONNECTION TO NEW UNITS ON FLOOR BELOW. C. DEMOLISH EXISTING ROOFTOP GAS PIPE AND PIPE THROUGH ROOF. D. DEMOLISH EXISTING CONDENSATE PIPE CONNECTION. RTU-5 RTU-6 EXISTING ROOF ACCESS HATCH RTU-4 1 MECHANICAL DEMO PLAN SCALE: 3/32"=1'-0"



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-		

Development & P	City of Puyallup Development & Permitting Services ISSUED PERMIT		
Building	Planning		
Engineering	Public Works		
Fire	Traffic		




MECH/ DEMO

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AUGUST 12, 2024

AS SHOWN

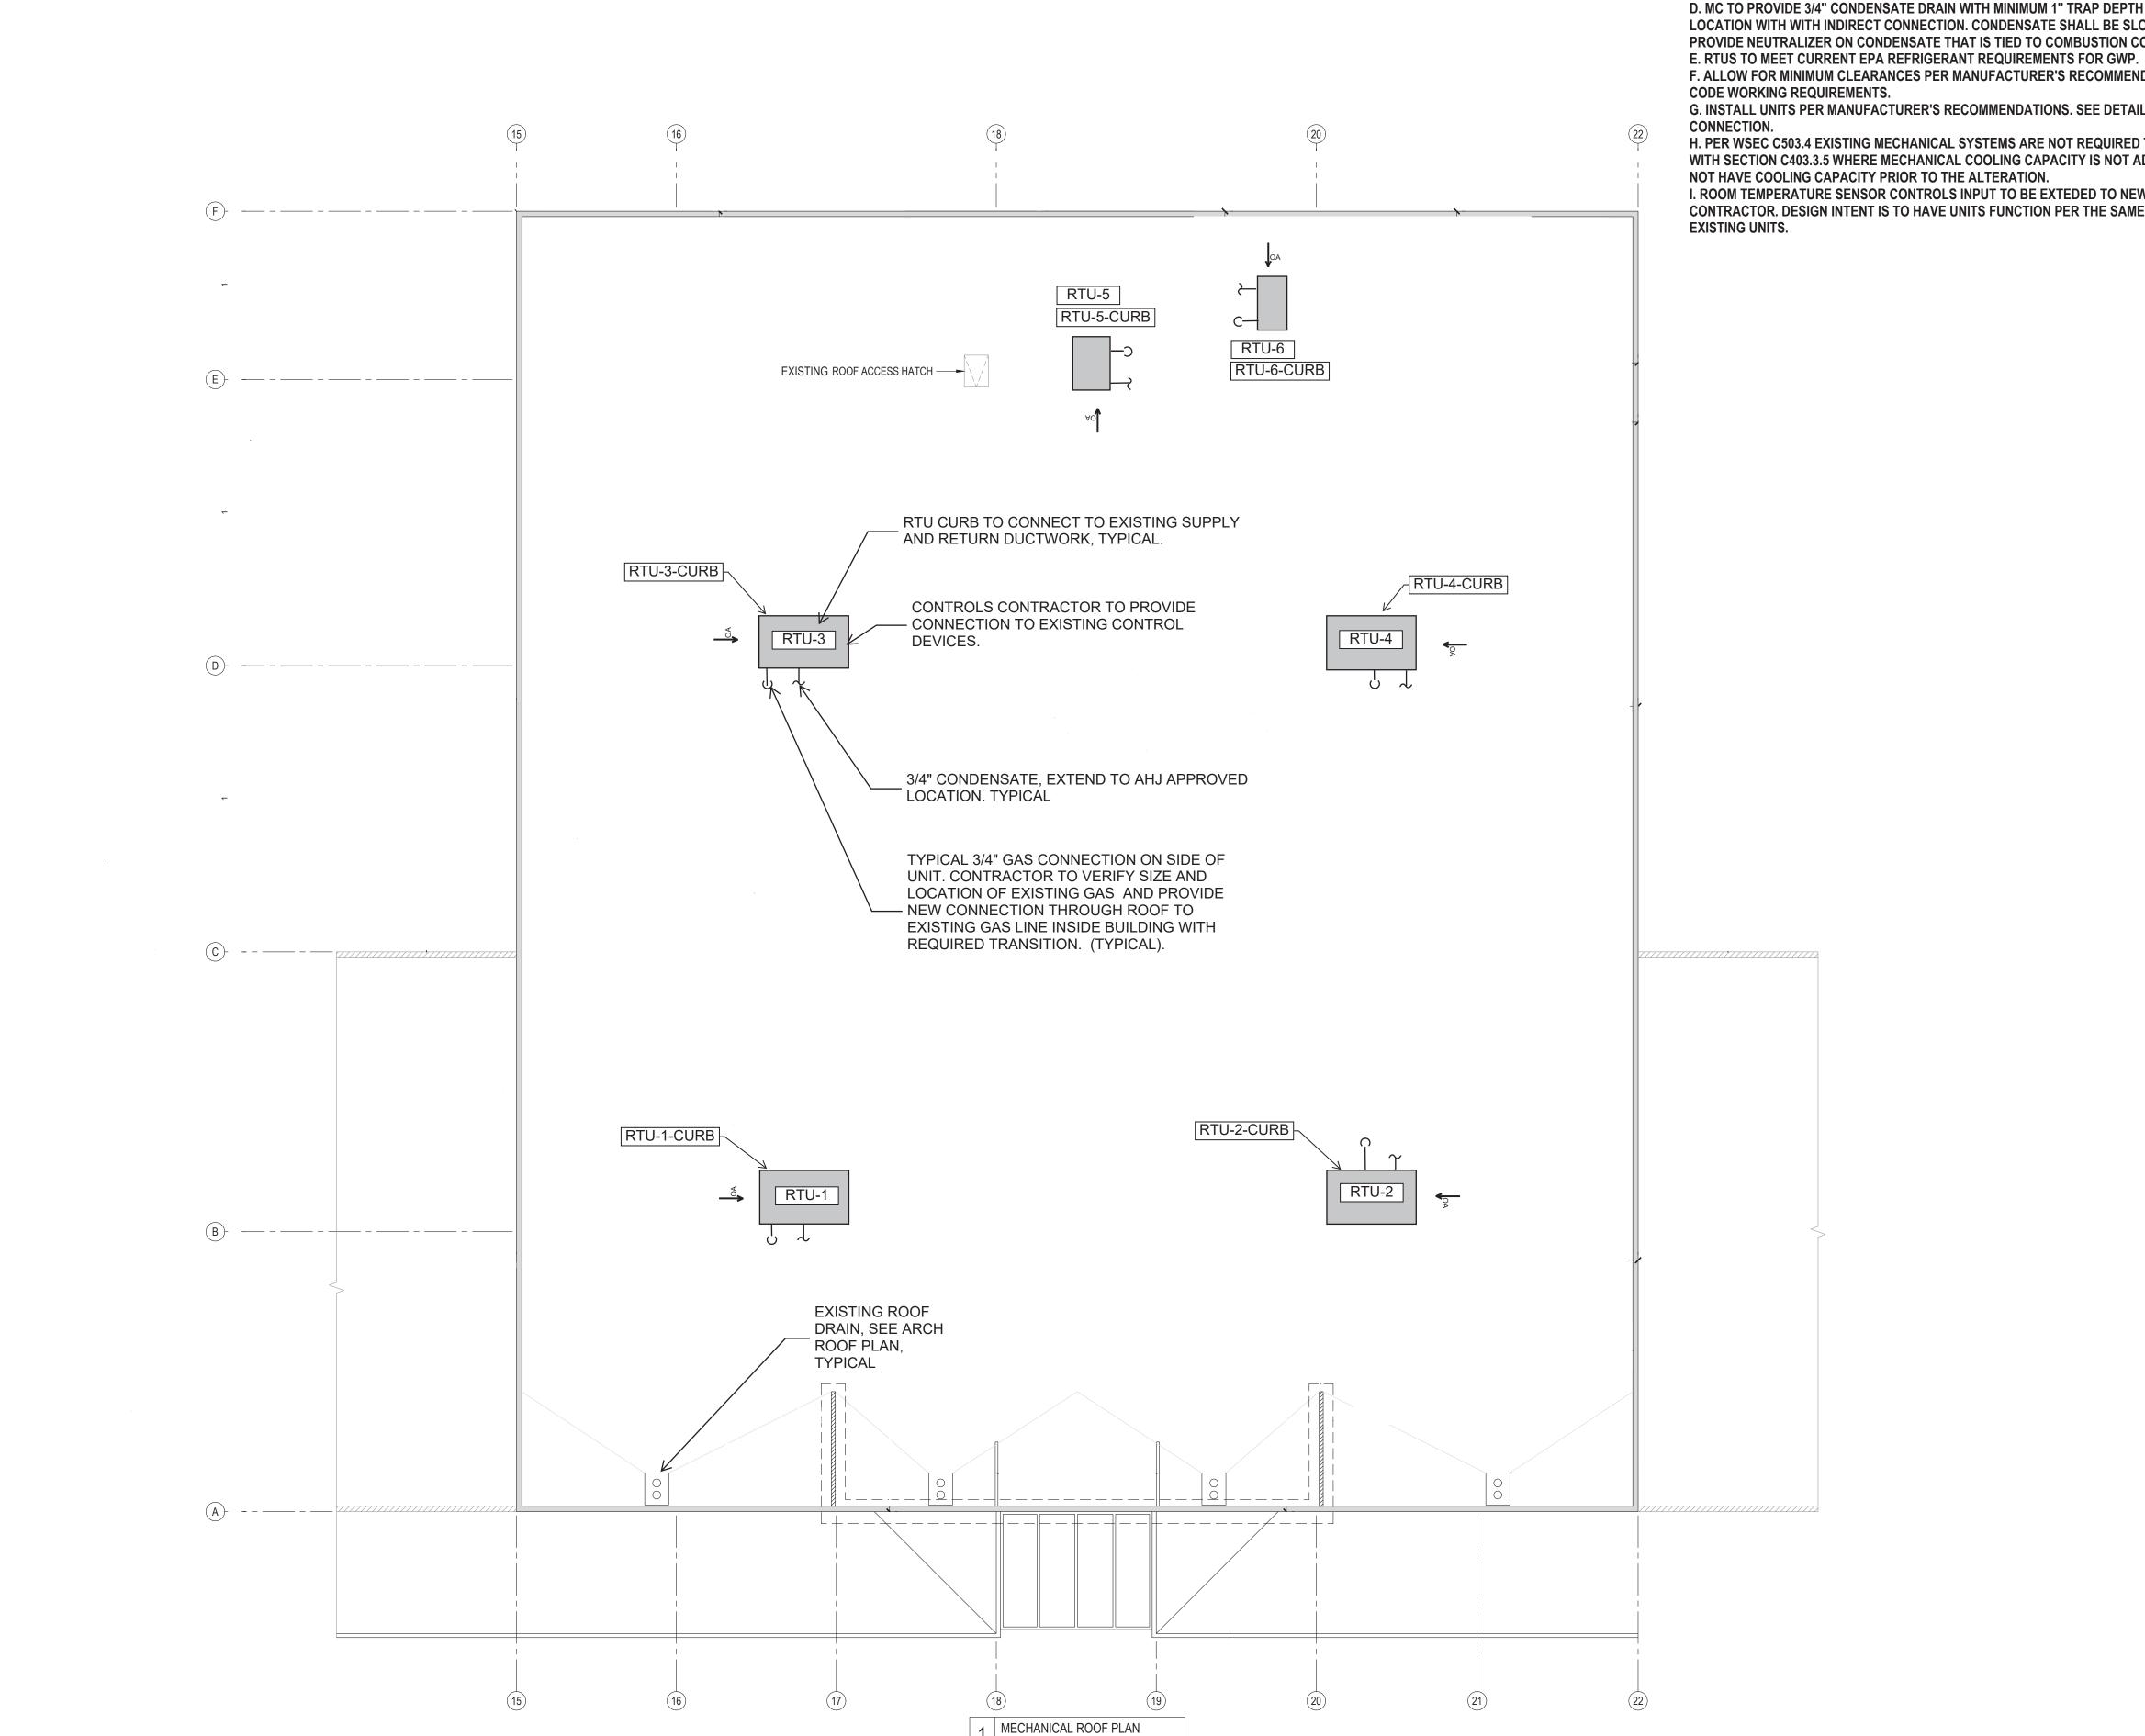

SCALE: 3/32"=1'-0"

GENERAL SHEET NOTES

A. SEE TIEDOWN SCHEDULE FOR ROOF SUPPORT.

B. SEE PIPING MATERIALS SCHEDULE ON SCHEDULE SHEW. ALL OUTDOOR GAS PIPING TO BE PAINTED FOR WEATHER PROTECTION.

C. EXTEND EXISTING GAS TO NEW UNITS. VERIFY SIZE AND LOCATION. PROVIDE SHUT-OFF VALVE AND FLEX CONNECTION FOR EACH CONNECTION. SUPPORT PIPING AND PROVIDE FLEX CONNECTION PER TIE-DOWN SCHEDULE. CONNECT TO EXISTING GAS PIPE INSIDE BUILDING.

D. MC TO PROVIDE 3/4" CONDENSATE DRAIN WITH MINIMUM 1" TRAP DEPTH TO AHJ APPROVED LOCATION WITH WITH INDIRECT CONNECTION. CONDENSATE SHALL BE SLOPED AT 1/4" PER FOOT. PROVIDE NEUTRALIZER ON CONDENSATE THAT IS TIED TO COMBUSTION CODENSATE.

F. ALLOW FOR MINIMUM CLEARANCES PER MANUFACTURER'S RECOMMENDATIONS AND ELECTRICAL

G. INSTALL UNITS PER MANUFACTURER'S RECOMMENDATIONS. SEE DETAIL ON DETAIL SHEETS FOR GAS

H. PER WSEC C503.4 EXISTING MECHANICAL SYSTEMS ARE NOT REQUIRED TO BE MODIFIED TO COMPLY WITH SECTION C403.3.5 WHERE MECHANICAL COOLING CAPACITY IS NOT ADDED TO A SYSTEM THAT DID NOT HAVE COOLING CAPACITY PRIOR TO THE ALTERATION.

I. ROOM TEMPERATURE SENSOR CONTROLS INPUT TO BE EXTEDED TO NEW UNITS BY CONTROL CONTRACTOR. DESIGN INTENT IS TO HAVE UNITS FUNCTION PER THE SAME OPERATIONAL MODES AS SOCOTEC

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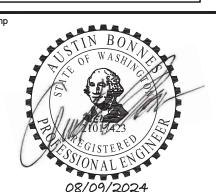
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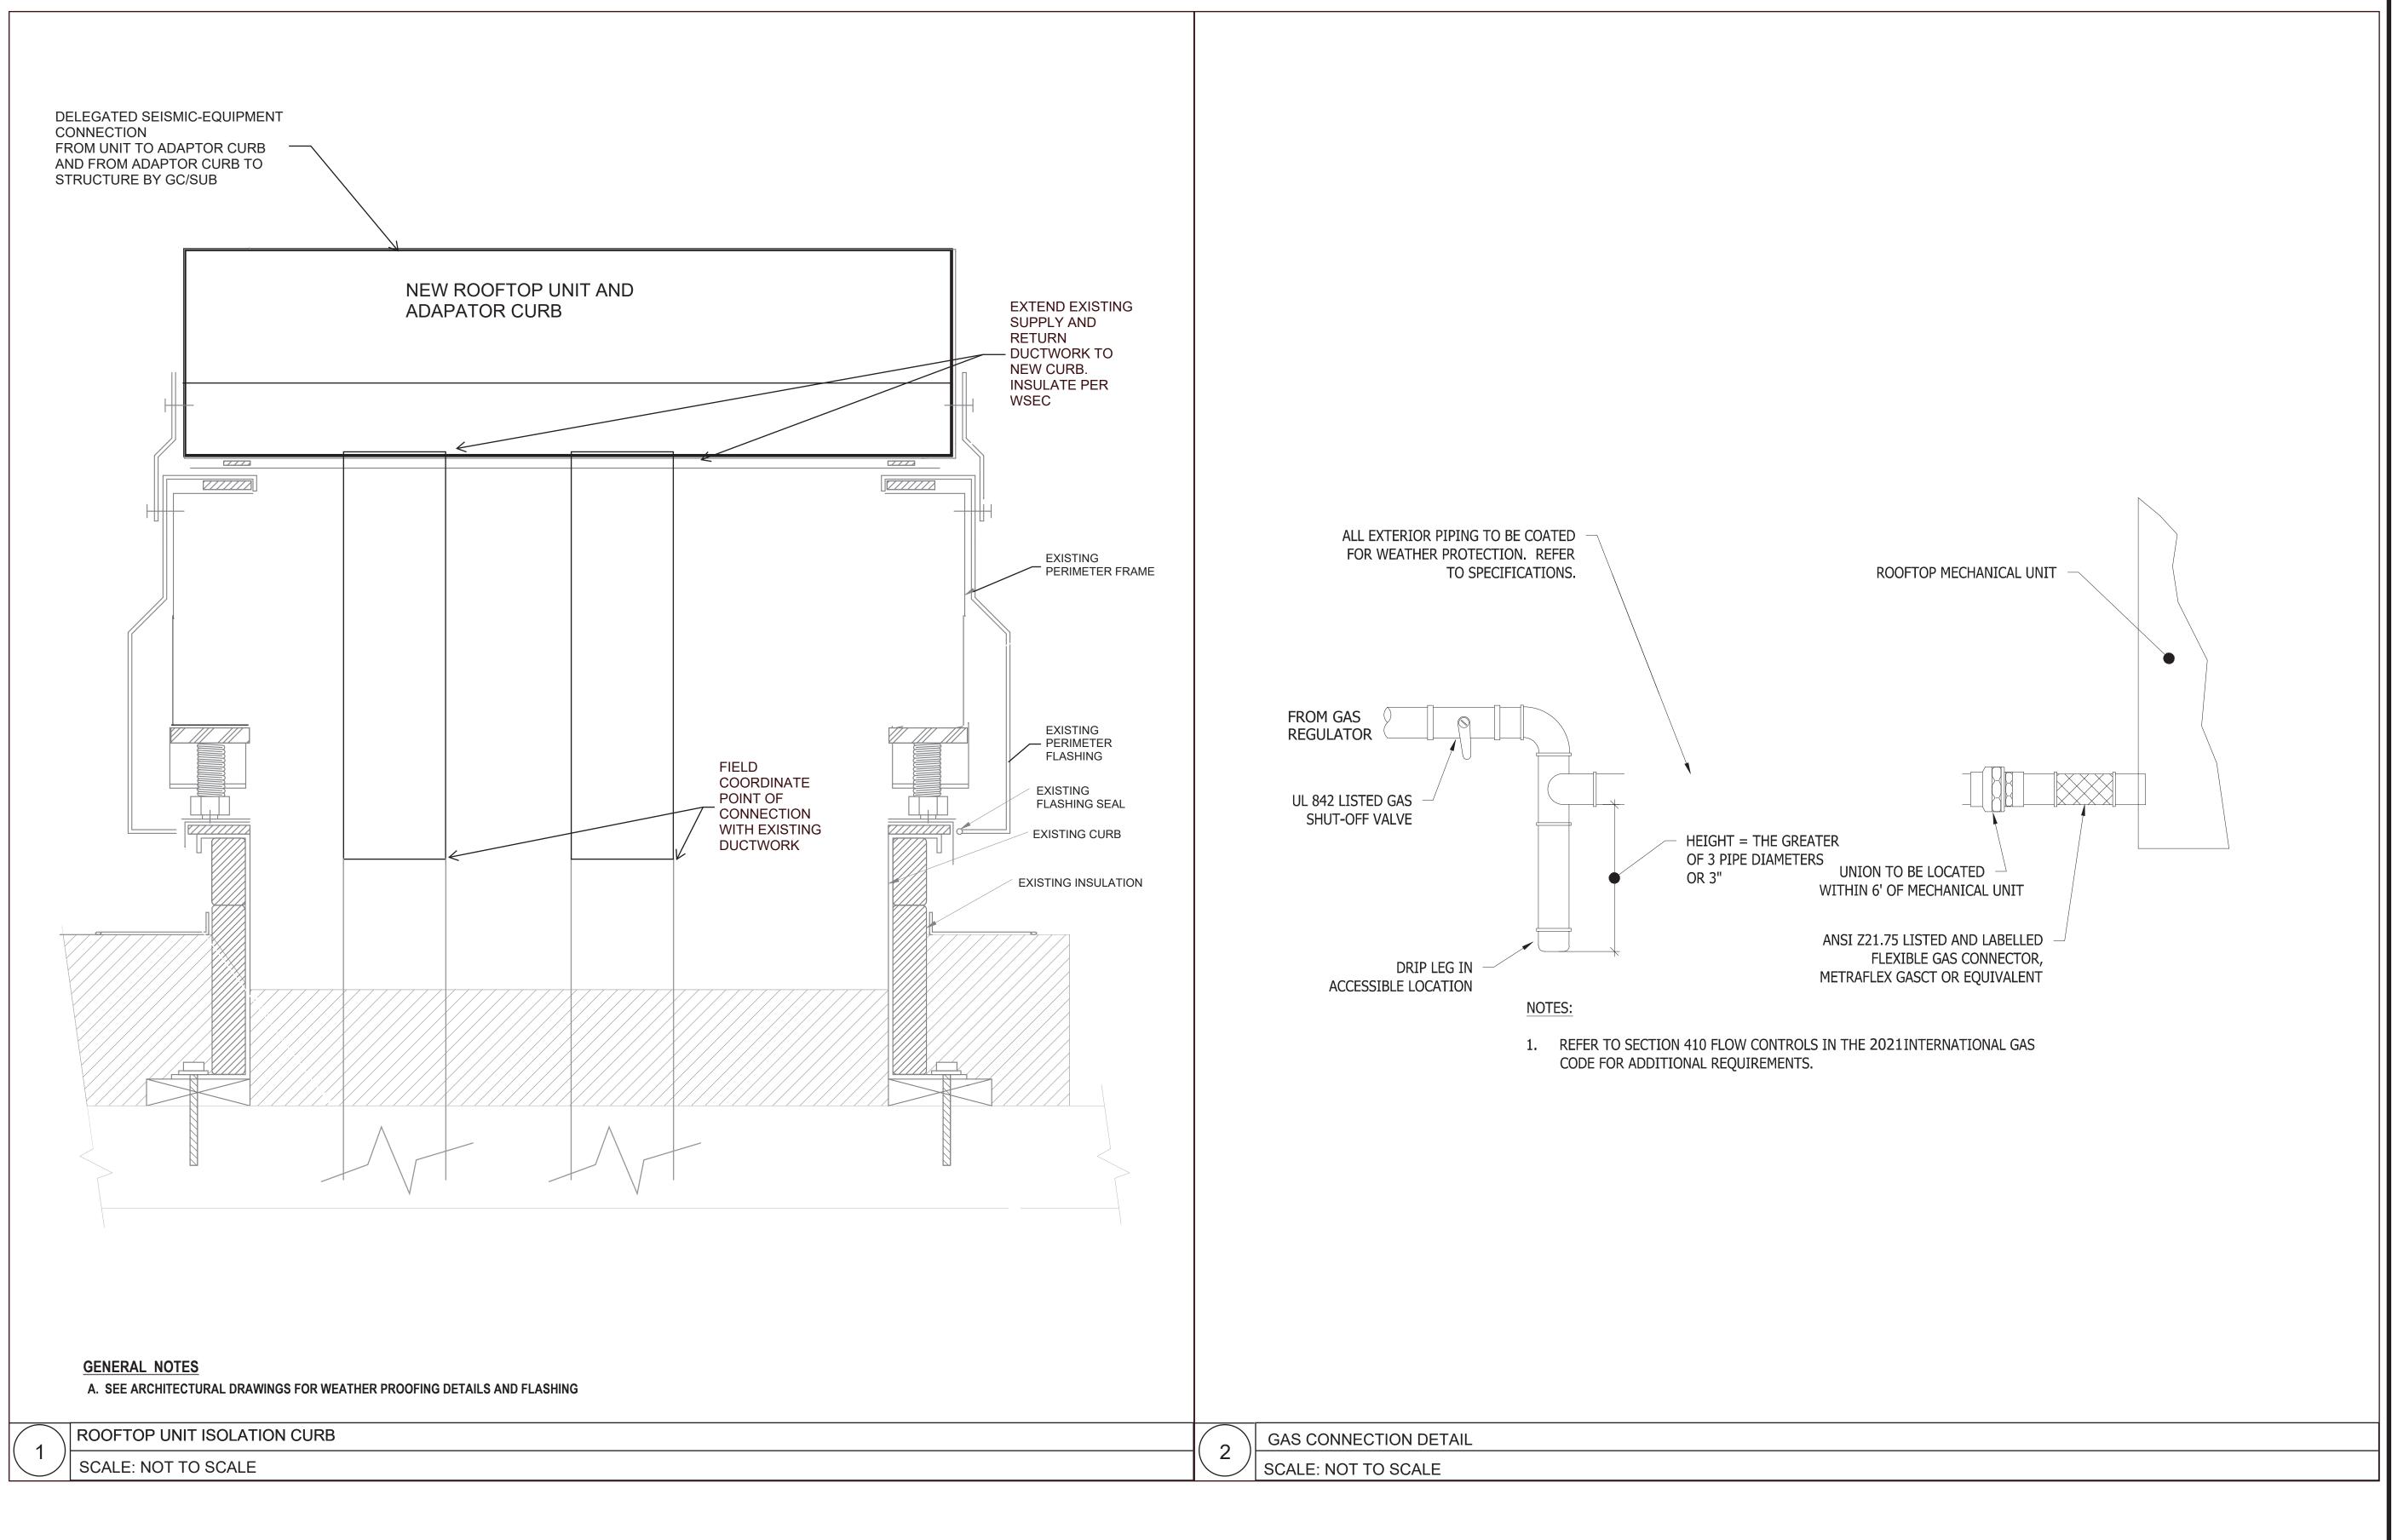


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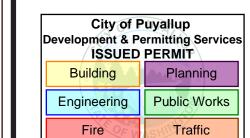
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Drawing T

MECHANICAL DETAILS

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AUGUST 12, 2024

AUGUST 12, 2022

Scale AS SHOWN

LJC

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