
	ELECTRICAL LEGE
SYMBOL	DESCRIPTION
	ELECTRICAL SERVICE
	POLE MOUNTED TRANSFORME
\boxtimes	STREET LIGHTING METER C
	HANDHOLE PER WSDOT STA
#	WIRE (LOAD) RUN
X	FIXTURE SYMBOL
O	NEW DECORATIVE STREET LIG
⊶×	EXISTING STREET LIGHT
	OVERHEAD ELECTRIC UTILITY
OHP	OVERHEAD POWER
	WIRING CONCEALED BELOW
OHP	OVERHEAD POWER

		STREET LIGHT	SCH	EDULE	-
ST. LT. NO.	CRCT	TYPE	FIXTURE HT.	NORTHING	EAS
A	(E)	KING LUMINAIRE K107, RAL6005 GREEN, 120V – 277V	14FT	684324.51	11949
В	(E)	KING LUMINAIRE K107, RAL6005 GREEN, 120V – 277V	14FT	684288.64	11949
С	(E)	KING LUMINAIRE K107, RAL6005 GREEN, 120V – 277V	14FT	684236.8	11949
D	(E)	KING LUMINAIRE K107, RAL6005 GREEN, 120V – 277V	14FT	684196.53	11949
E	(E)	KING LUMINAIRE K107, RAL6005 GREEN, 120V – 277V	14FT	684151.49	11949

NOTE:

1. PROVIDE CONCRETE BASE TO COMPLY PER CITY STANDARDS DETAIL 01.05.06 SHEET E1.3.

CONDUIT AND WIRE SCHEDULE					
RUN	CONDU	IT SIZE	CONDUCT	FOR SIZE	REMARKS
NO. (*)	ILLUM	SPARE	ILLUM.	GRN GND	
1	2"	2"	2#6	1#6	SCH. 40 PVC.
2	2"		2#6	1#6	SCH. 40 PVC.
3		(2) 2"			SCH. 80 PVC.
4					

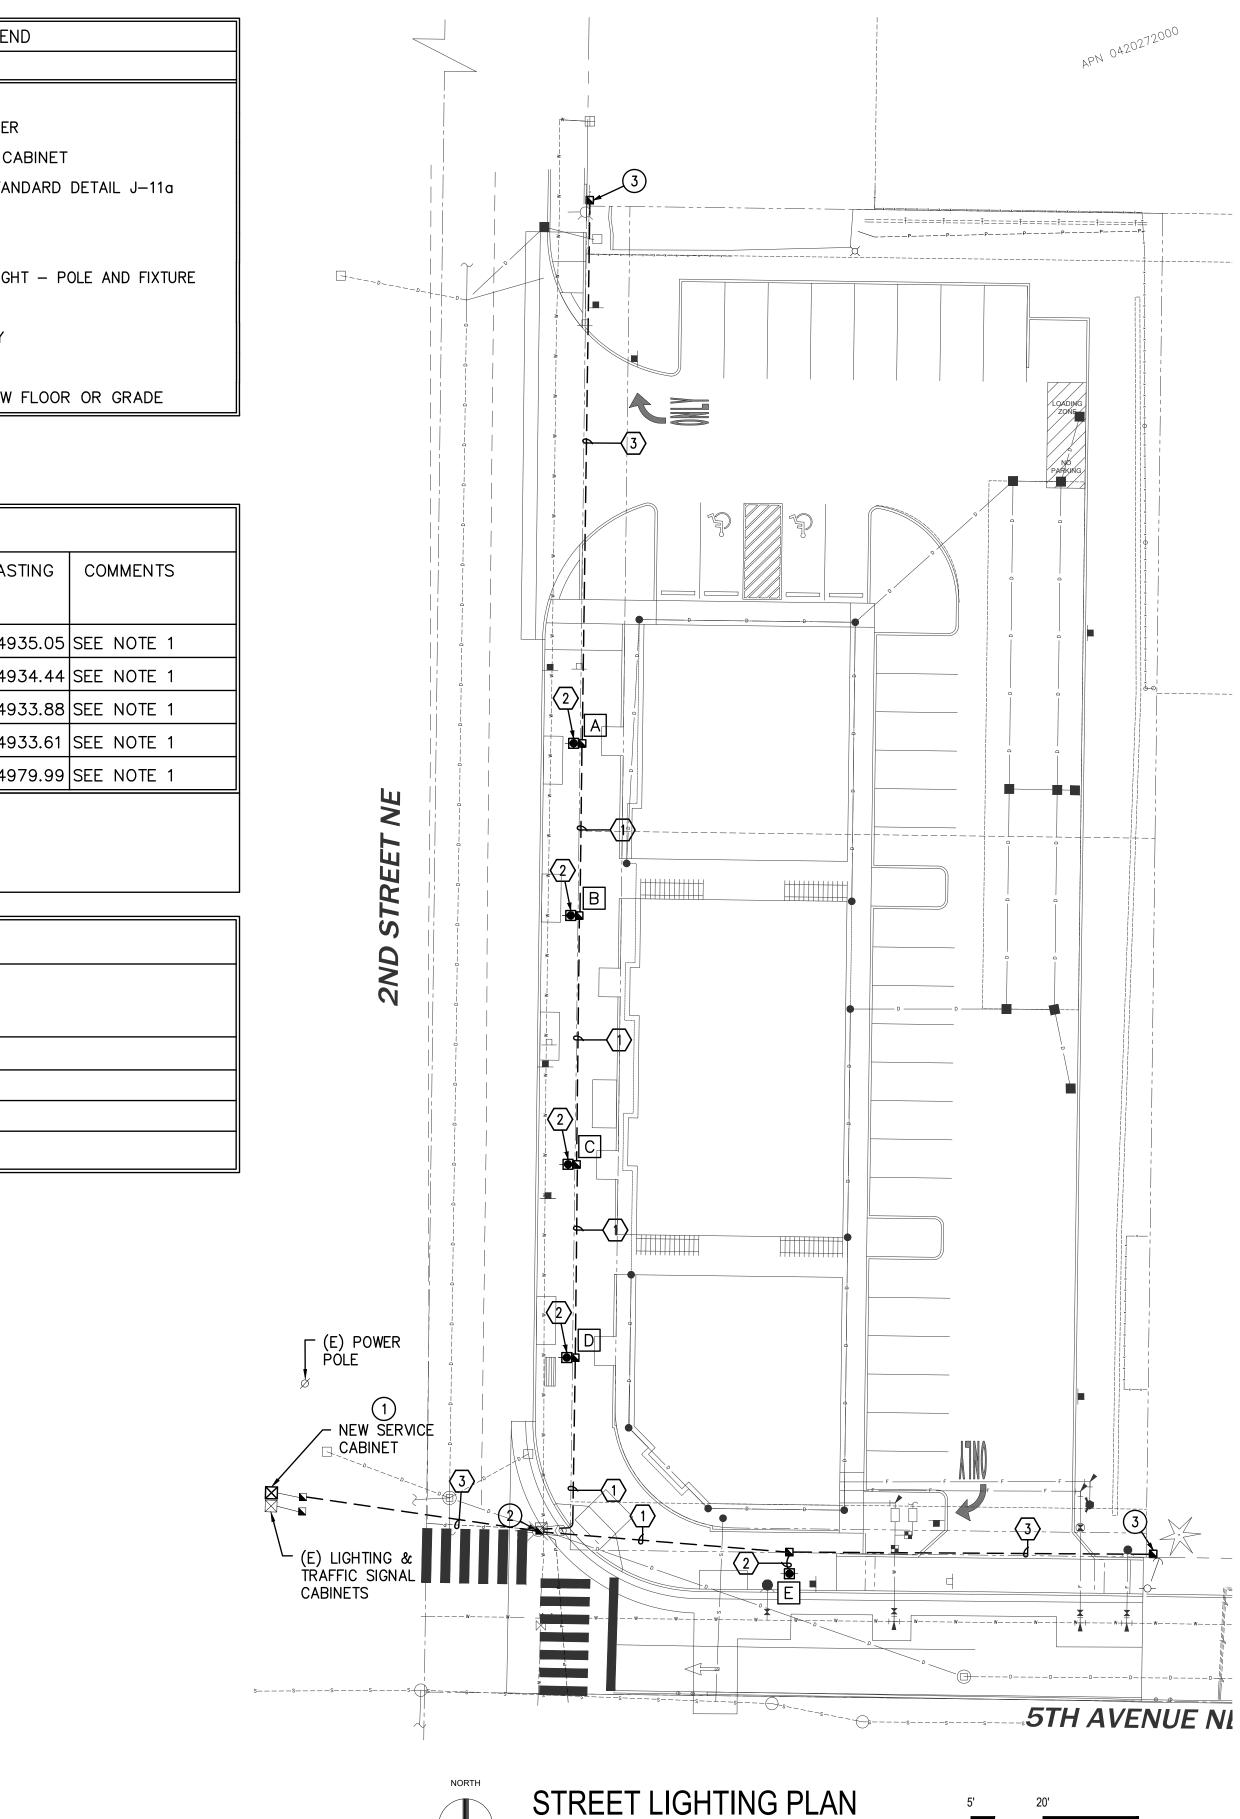

SIREEI LIG SCALE: 1" = 20'-0"

0'

0' 10'

PLAN KEY NOTES

- 1 PROVIDE NEW LIGHTING SERVICE CABINET LOCATED ON NORTH SIDE OF THE EXISTING SIGNAL CABINET, ON NW CORNER OF 2ND ST NE & 5TH AVE NE. TAP INTO POWER FEEDING EXISTING CABINET AND EXTEND TO NEW. SEE DETAIL ON E1.3.
- 2 REMOVE CONDUCTORS FEEDING EXISTING JUNCTION BOX AND REFEED FROM NEW CABINET. JUNCTION BOX TO SERVE AS UTILITY POINT OF CONSTRUCTION FOR NEW LIGHTING. PROVIDE CONDUIT AND CONDUCTOR PER CITY REQUIREMENTS.
- 3 TERMINATE CONDUIT RUN WITH JUNCTION BOX.

<u>NOTE:</u>

- COORDINATE ALL WORK WITH CITY STREET LIGHT TECHNICIAN CARY BERTRAM AT (253) 341–8439 PRIOR TO MATERIALS ORDERING AND CONSTRUCTION.
- 2. ALL JUNCTION BOXES SHALL BE PLACED BEHIND THE SIDEWALK UNLESS OTHERWISE NOTED..
- 3. MAINTAIN 5-FT SEPARATION FROM FIRE HYDRANTS TO ALL ELECTRICAL EQUIPMENT. VERIFY HYDRANT LOCATION(S) PRIOR TO TRENCHING.
- 4. CONTRACTOR SHALL OBTAIN WRITTEN AUTHORIZATION FROM PUGET SOUND ENERGY (PSE) FOR THE ELECTRICAL SERVICE LOCATION. IF IT IS DETERMINED AN ALTERNATE SERVICE CONNECTION, THE ALTERNATE SERVICE LOCATION SHALL BE APPROVED BY THE CITY AND ALL CHANGES IN THE DESIGN SHALL BE RECORDED ON AS-BUILT PLANS.
- 5. A COPY OF THE LOAD CALCULATION SHALL BE PROVIDED TO THE CITY'S SIGNAL TECHNICIAN PRIOR TO INSTALLATION.
- 6. CONTRACTOR SHALL CONTACT THE CITY'S SIGNAL TECHNICIAN WHEN THE LIGHTS ARE READY TO BE ENERGIZED.
- 7. ALL CONDUIT SHALL BE INSTALLED WITH 24 INCHES MINIMUM COVER.
- 8. ALL CONDUIT SHALL BE SCHEDULE 40 PVC UNLESS OTHERWISE INDICATED, ALL CONDUCTORS SHALL BE COPPER WITH TYPE USE XLP INSULATION.
- 9. PROVIDE 36 INCH CLEARANCE BETWEEN EXISTING WATER MAIN AND LIGHT FIXTURE FOOTING.
- 10. PEDESTRIAN STREETLIGHT OFFSET MUST MAINTAIN 8-FOOT CLEAR WALKABLE PATH.
- 11. PRIOR TO CUT-OVER FOR THE NEW SERVICE CABINET, THE CONTRACTOR MUST PROVIDE A DETAILED IMPLEMENTATION PLAN WITH THE CITY TO MINIMIZE DOWNTIME FOR THE TRAFFIC SIGNAL. CITY MAY REQUIRE A UPO TO BE AVAILABLE TO ASSIST CONTROL TRAFFIC WHILE THE DARK SIGNAL IS BEING CONNECTED TO THE NEW POWER SOURCE. MUST COORDINATE WITH STREET LIGHT TECHNICIAN (CARY BERTRAM) 2 WEEKS PRIOR TO ENSURE AVAILABILITY TO ASSIST WITH SIGNAL POWER DOWN/ POWER UP PROCEDURE.

APPROVED

BY _____CITY OF PUYALLUP

DEVELOPMENT ENGINEERING

NOTE: THIS APPROVAL IS VOID AFTER 180 DAYS FROM APPROVAL DATE.

THE CITY WILL NOT BE RESPONSIBLE FOR ERRORS AND/OR OMISSIONS ON THESE PLANS. FIELD CONDITIONS MAY DICTATE CHANGES TO THESE PLANS AS DETERMINED BY THE DEVELOPMENT ENGINEERING MANAGER.

BHU		Tacoma, WA 98402	Fax: (253) 383-3283	Job Number: 21-146.2
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1111 Fawcett Ave Suite 100 Tac Phone: (253) 383-3257 Fax general@hultzbhu.com Job

> 2ND STREET & 5TH AVENUE NE PUYALLUP, WA

	HOMAS URQUIN STREE PAGE ISTERED PAGE ISTE			
Rev.	Description			
Phase: REVIEW SET				
Draw	n: AD			
Appr	oved: PC			

Date: 04-01-2022 SHEET TITLE SITE PLAN -ELECTRICAL

SHEET

E1.1

ISSUED FOR#



SHEET SIZE IS TRUE SCALE WHEN ABOVE LINE MEASURES AS NOTED

		STREET LIG	HTING SPECIFICATIONS			
1.	30-	-FOOT STEEL STREETLIGHT STANDAR	D			
	а.	DIMENSIONS				
			ROVIDE A FIXTURE MOUNTING HEIGHT C AL 12 FOOT MAST ARM WITH A THREE	DF 30'0"		
		BASE PLATE SHALL HAVE SLOTTED HOLES TO ACCOMMODATE 1-INCH ANCHOR BOLTS, AND 11 1/2" BOLT CIRCLE WITH MINIMUM CLEARANCE OF 1" BETWEEN BOLT AND POLE.				
			ATED APPROXIMATELY 12 INCHES FROM ES FROM MAST ARM SO AS THE HAND ONCOMING TRAFFIC.			
	b.	STRENGTH				
		ISOTACH WHEN USED WITH A LUMIN	REQUIREMENTS OF AASHTO FOR 90 M NAIRE WEIGHING 48 POUNDS WITH A ATTACHING BOLTS AND SCREWS THAT A ESS STEEL.			
	c.	FINISH				
		THE POLES AND ALL HARDWARE SA MINIMUM 3 MIL THICKNESS.	AHALL BE HOT DIPPED GALVANIZED,			
	d.	MAST ARM ATTACHMENT SHALL BE SECURED BY 3 BOLTS.				
	e.	EACH POLE SHALL HAVE HANDHOLE (WITH COVER), GROUND LUG AND REMOVABLE POLE CAP.				
	f.	EACH CITY POLE SHALL HAVE A BLACK 4" TO 6" LETTER C STENCILED ON ROADWAY SIDE OF POLE 16" ABOVE GRADE.				
2.	ANG	CHORAGE				
	a.	DIPPED GALVANIZING AFTER THREAD EXTEND FROM THREADED END FOR	4 BOLTS, 1"X36"X4" #8UNC WITH HO DS ARE CUT. GALVANIZED AREA SHALL A MINIMUM OF 12 INCHES. BOLTS SH NUTS AND FLAT WASHERS FOR LEVELI	HALL		
	b.		BE INSTALLED WITH ONE 1/2" DRAIN H IEER HAS APPROVED THE POLE INSTAL			
3.	CO	NDUIT				
	CF CC	ROSSINGS SHALL BE RIGID METALLIC	NIMUM OF 24 INCHES DEEP. ALL ROAD OR SCHEDULE 80 PVC. CONDUIT SHA DT STANDARD SPECIFICATIONS. SCHEDU HAN ROADWAY CROSSINGS.	LL		
PUYA		CITY OF	STRE	ET LIGHT		
PUYA	ILIN .	PUYALLUP		ICATIONS		
WASHIN	STOP	DEVELOPMENT ENGINEERING and PUBLIC WORKS DEPARTMENTS	DRAWN BY JIM ERWIN-SVOBODA FILE NAME	APPROVED BY COLLEEN HARRIS LINDA DATE APPROVED DATE REVIS		
			F:\DWG\COMMON\STDS\CITY\2009\01_STR\01.05\01.05.01	07/01/2009 02/25/2015		

(STR LIGHT SPECS CONTINUED)

4. JUNCTION BOXES (WHEN REQUIRED)

JUNCTION BOXES SHALL BE INSTALLED AT LOCATIONS AS SHOWN ON THE PLANS. THEY WILL CONFORM TO WSDOT STANDARD PLAN J-40.10-02, TYPE 1. THEY SHALL BE LEVEL WITH THE SIDEWALK GRADE AND FIRMLY BEDDED TO PREVENT FUTURE SETTLING. JUNCTION BOXES ARE PREFERRED NOT TO BE INSTALLED IN THE SIDEWALK. THE COVER SHALL BE GALVANIZED AND GROUNDED. THE LETTERS "LT" SHALL BE ETCHED ON THE COVER. (SEE CITY STANDARD DETAIL NO. 01.06.01). IF THE JUNCTION BOX IS NOT IN THE SIDEWALK THEN IT SHALL HAVE A CONCRETE COLLAR. IF THE JUNCTION BOX IS IN THE SIDEWALK THEN IT SHALL HAVE A NON-SLIP SURFACE TREATMENT. SEE CITY STANDARD DETAIL NO. 01.06.01.

5. CONDUCTORS, WIRES, ETC. WIRE CONDUCTORS FOR UNDERGROUND FEEDER RUNS AND FOR CIRCUITRY FROM THE IN-LINE FUSE IN THE POLES TO THE JUNCTION BOX SHALL BE 600 VOLT, SINGLE CONDUCTOR STRANDED COPPER AND INSULATED WITH USE GRADE POLYVINYL CHLORIDE COMPOUND (XLP) OR APPROVED EQUAL IN ACCORDANCE WITH THE INSULATED POWER CABLE ENGINEER'S ASSOCIATION SPECIFICATIONS. AN AWG NO. 8 GREEN INSULATED STRANDED COPPER WIRE WILL BE RUN TO THE SERVICE GROUND LUG ON EACH POLE. FEEDERS SHALL BE SIZED IN ACCORDANCE WITH THE NATIONAL ELECTRICAL CODE. WIRES INSIDE THE POLE BETWEEN BALLAST AND IN-LINE FUSES SHALL BE ROME 2C AWG 10 STRANDED POLE AND BRACKET WIRE OR APPROVED EQUAL. SPLICES WILL BE ALLOWED IN JUNCTION BOXES AND POLE BASES ONLY. NO MORE THAN 2 CONDUITS WILL BE ALLOWED INSIDE THE STREET POLE.

6. FUSES LUMINARE FUSING AND ELECTRICAL CONNECTIONS AT LIGHT STANDARD BASES SHALL CONFORM TO SECTION 9-29.7 OF THE STATE OF WASHINGTON STANDARD SPECIFICATIONS AND AS SHOWN ON THE UNIFORM LUMINARE WIRING DETAIL IN THE APPENDIX. IN-LINE FUSE HOLDERS SHALL BE SEC MODEL 1791-SF WITH FNM-5 FUSES OR APPROVED EQUAL. (REFER TO CITY STANDARD DETAIL NO. 01.06.01)

7. LUMINAIRES AND LAMPS

RESIDENTIAL STREETS AND NEIGHBORHOOD COLLECTORS: LEOTEK LED GC1-40E-MV-NW-2-530 (67 WATT LED)

ARTERIALS AND COMMERCIAL COLLECTORS: GE EVOLVE LED ERS2-E-0-HX-EX-5-40 (130 WATT LED)

THE CITY WILL ENERGIZE THE STREET LIGHTS WHEN A HOME IS OCCUPIED ADJACENT TO A STREET LIGHT OR IMMEDIATELY ACROSS THE STREET. AT THE DEVELOPER'S REQUEST, STREET LIGHTS MAY BE ENERGIZED PRIOR TO OCCUPANCY OF HOMES. HOWEVER, THE DEVELOPER OR BUILDER SHALL ASSUME FULL RESPONSIBILITY FOR ELECTRICAL POWER COSTS AND REPAIR COSTS DUE TO VANDALISM, THEFT, OR CONSTRUCTION.

8. SAFE WIRING LABELS

THE CONTRACTOR IS ADVISED THAT SAFE WIRING LABELS REQUIRED BY LABOR AND INDUSTRIES SHALL APPLY ON THIS PROJECT. (ELECTRICAL INSPECTION STICKER)

GUARANTEE

THE CONTRACTOR SHALL SURRENDER TO THE CITY OF PUYALLUP ANY GUARANTEE OR WARRANTY ACQUIRED BY HIM AS A NORMAL TRADE PRACTICE IN CONNECTION WITH THE PURCHASE OF ANY MATERIALS OR ITEMS USED IN THE CONSTRUCTION OF THE ILLUMINATION.


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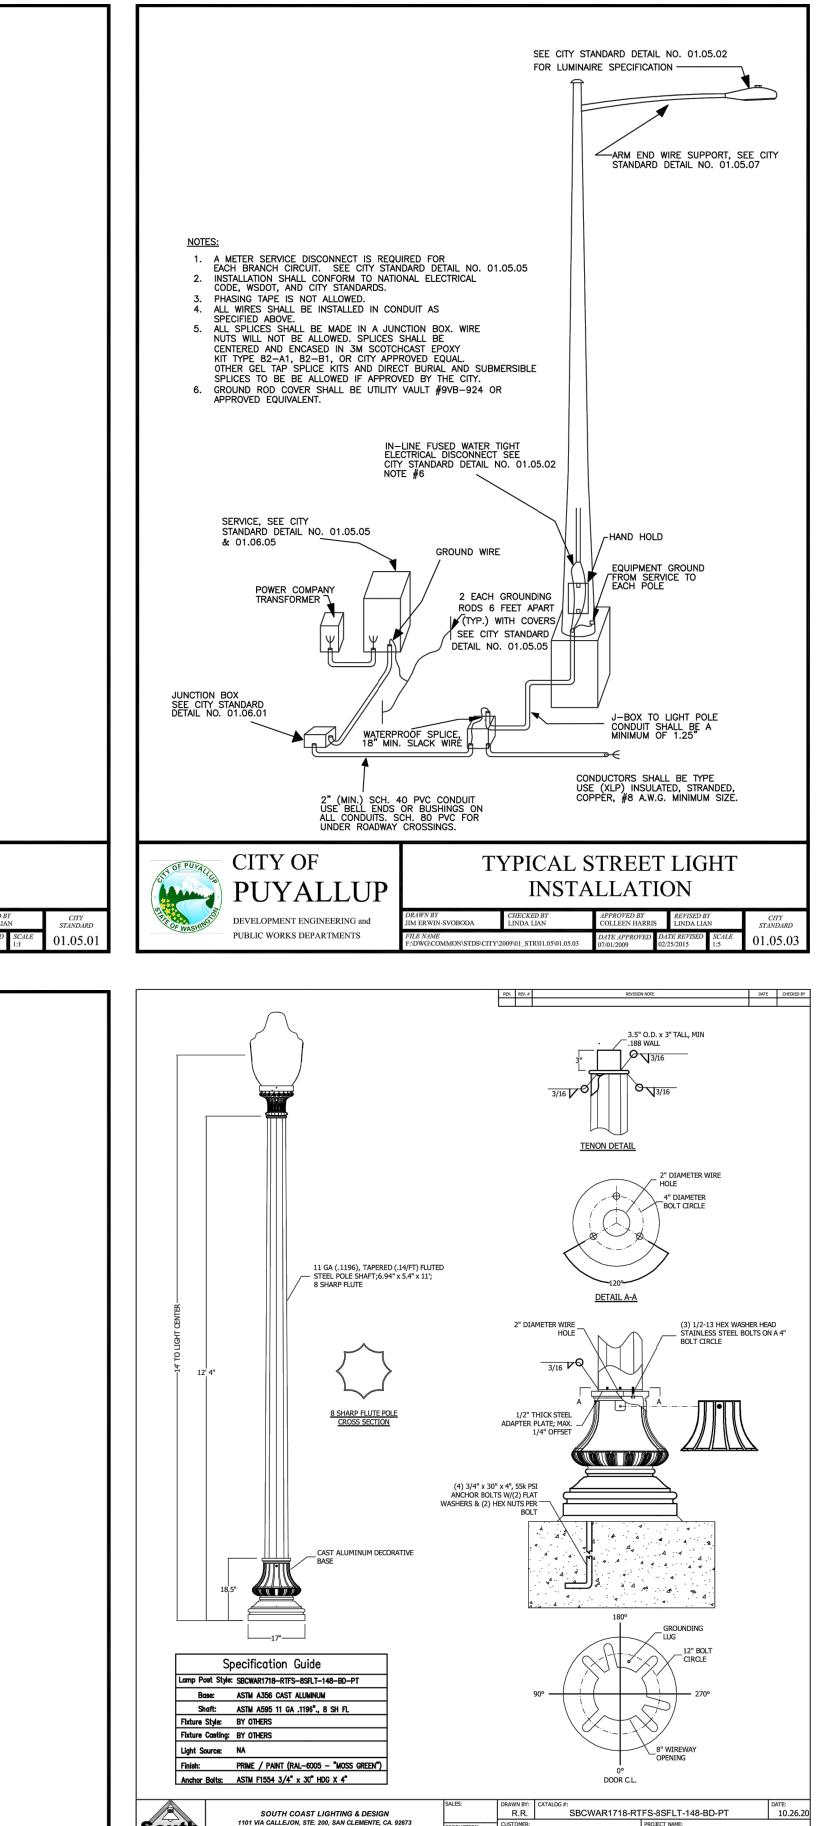
Lighting & Desi

01 05 02

VOICE - 949.276.8850 / FAX - 949.276.8855 DUTHCOASTLIGHTING.COM / WWW.SOUTHCOASTLIGHTING.COM

10. LOCATION SEE CITY STANDARD SECTION 01.01 ROADWAY DESIGN.




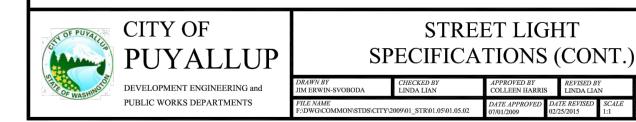

ILLUMINATION NOTES: WSDOT STANDARDS AND SPECIFICATIONS.

- CONTRACTOR PRIOR TO CONSTRUCTION START.
- PRIOR TO ANY ILLUMINATION WORK.
- SHALL BE RESPONSIBLE FOR ANY DAMAGE TO UTILITIES.
- DETERMINED BY THE CONTRACTOR IN THE FIELD.
- AT (253) 341-8439 PRIOR TO CONSTRUCTION.

- SLIPNOT#3.

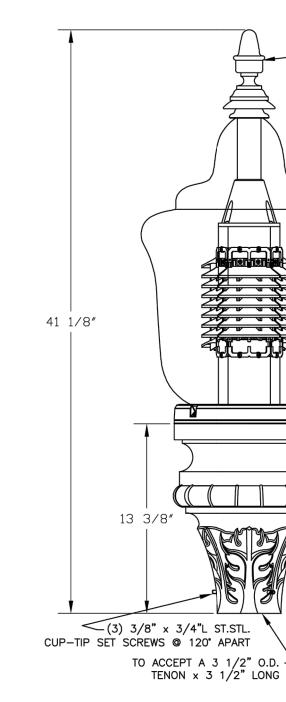

CITY STANDARDS

1 OF 1

R-102620-1A

IG NUMBER

C.O. PUYALLUP, WA.

1. ALL WORK SHALL BE IN ACCORDANCE WITH CITY OF PUYALLUP PUBLIC WORKS STANDARDS AND

2. THE LOCATIONS OF FEATURES SHOWN ARE APPROXIMATE AND SHALL BE VERIFIED BY THE

3. UTILITY LOCATIONS ARE APPROXIMATE AND SHALL BE VERIFIED IN THE FIELD BY THE CONTRACTOR

4. ALL WORK SHALL BE CONSISTENT WITH UTILITY AGENCY REQUIREMENTS. THE CONTRACTOR SHALL COORDINATE WITH AFFECTED UTILITY AGENCIES THROUGHOUT THE PROJECT. THE CONTRACTOR

5. CONDUIT LOCATIONS ARE SHOWN FOR ILLUSTRATIVE PURPOSES. ACTUAL LOCATIONS SHALL BE

6. CONTRACTOR SHALL COORDINATE WITH THE CITY SIGNAL/ILLUMINATION TECHNICIAN CARY BERTRAM

7. THE LOCATION OF ALL CONDUITS, JUNCTION BOXES, POLES, AND CABINETS SHOWN ON THIS PLAN MAY BE ADJUSTED IN THE FIELD TO AVOID CONFLICTS AND MEET ADA REQUIREMENTS. ALL FINAL LOCATIONS SHALL BE APPROVED BY THE CITY TRAFFIC ENGINEER PRIOR TO CONSTRUCTION.

8. JUNCTION BOX LOCATIONS SHOWN ARE FOR ILLUSTRATIVE PURPOSES ONLY. JUNCTION BOXES SHALL BE FIELD LOCATED BY THE CONTRACTOR WITH DIRECTION FROM THE CITY.

9. CONTRACTOR SHALL ADJUST JUNCTION BOX LIDS TO BE FLUSH WITH TOP OF SIDEWALK.

10. ANY NEW JUNCTION BOX WHICH WILL BE LOCATED WITHIN OR PARTIALLY WITHIN SIDEWALK SHALL HAVE LIDS AND FRAMES WITH A NON-SLIP COATING ON THE TOP SURFACE EQUAL TO MEBAC1 OR

BY CITY OF PUYALLUP DEVELOPMENT ENGINEERING DATE

NOTE: THIS APPROVAL IS VOID AFTER 180 DAYS FROM APPROVAL DATE. THE CITY WILL NOT BE RESPONSIBLE FOR ERRORS AND/OR OMISSIONS ON THESE

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STREET & 5TH PUYALLUP,

2ND

	EOR CONTRACTOR
Rev.	Description
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DATE BY

Phase: REVIEW SET AD Drawn: Approved: PC 04-01-2022 Date: SHEET TITLE ELECTRICAL NOTES AND DETAILS SHEET



ISSUED FOR# //// V///// V/// SHEET SIZE IS TRUE SCALE WHEN ABOVE LINE MEASURES AS NOTED


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		KING U.S. ORDER No: -	DRAWING TYP	'E:	DRAWING	DRAWING NUM PUYA	BER: ALLUP-1	—

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ALTERATION

PLOTTED: Monday, January 23, 2023 5:07:43 PM PLOTTED BY: ANATOLYD Dwc Path: 1:\2021 JOBS\21-146\Acad\elec\st ltg\21-146 E13 ST LTG.DWG



APPROVED

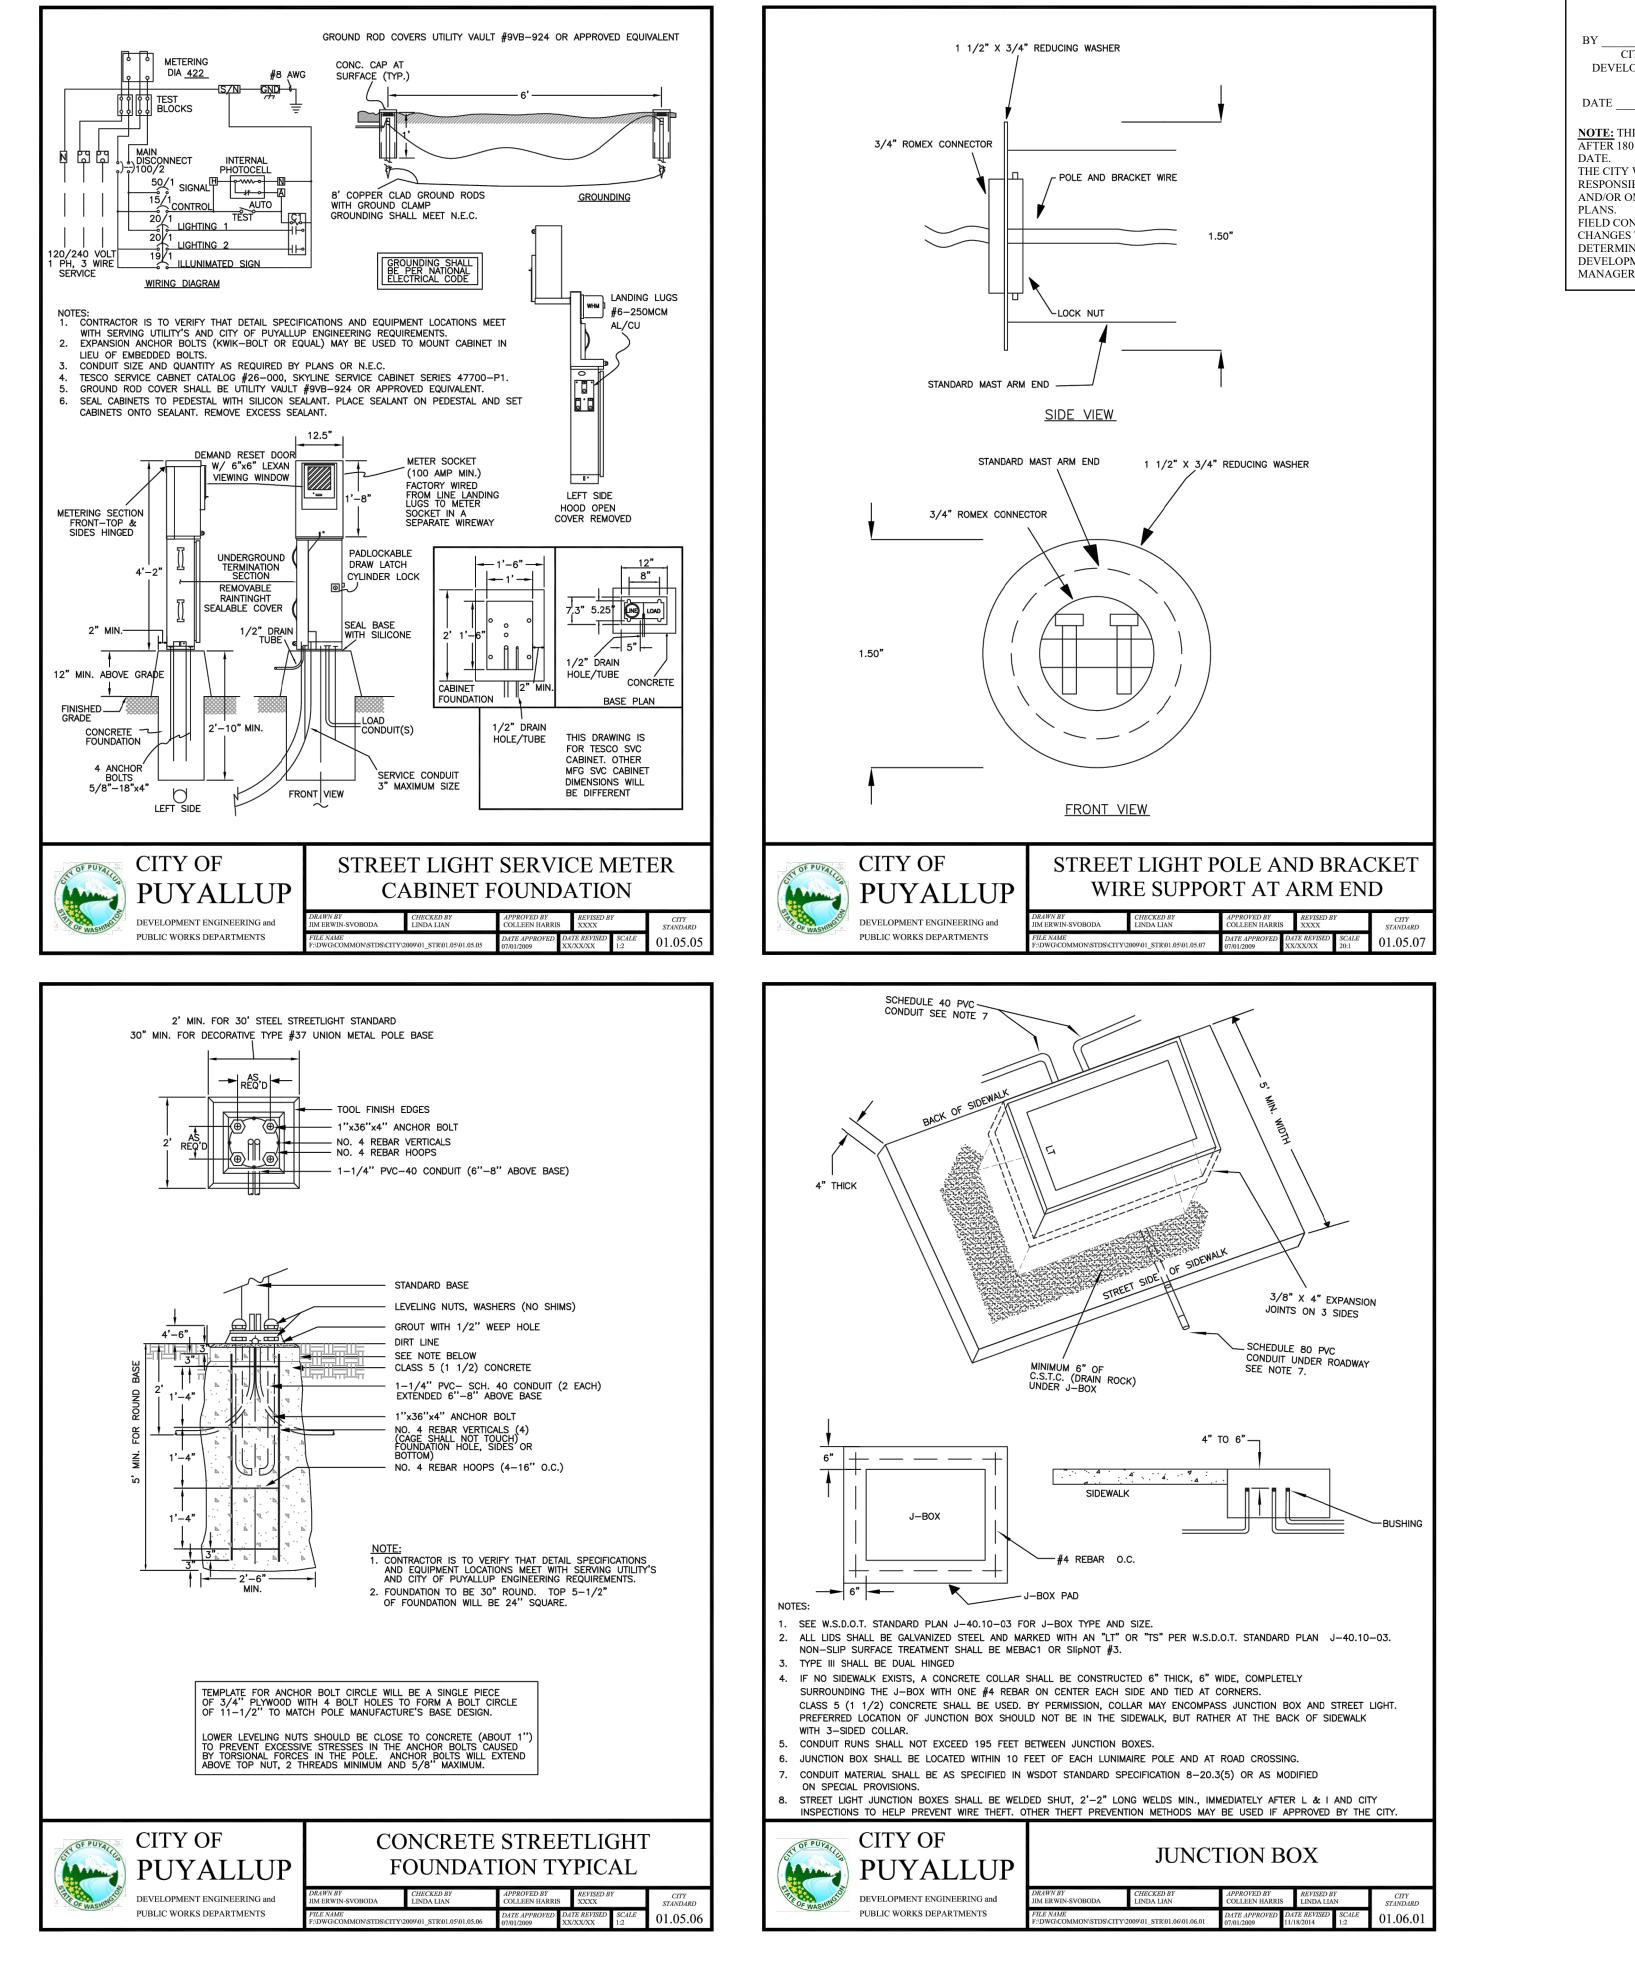BY ______ CITY OF PUYALLUP DEVELOPMENT ENGINEERING

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 1111 Fawcett Ave Suite 100
 Tacoma, WA 98402

 Phone: (253) 383-3257
 Fax: (253) 383-3283

 general@hultzbhu.com
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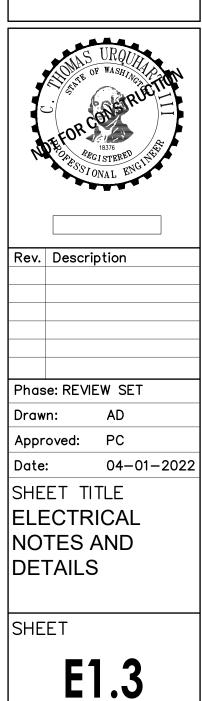
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