

LEGEND

EXISTING	PROPOSED	PROPERTY LINE
---	---	R.O.W. CENTERLINE
---	---	EASEMENT
---	---	SAWCUT LINE
---	---	WATER MAIN
---	---	FIRE MAIN
---	---	SEWER MAIN
---	---	STORM DRAIN
⊙	⊙	FIRE HYDRANT
⊕	⊕	WATER METER
⊗	⊗	GATE VALVE
⊖	⊖	THRUST BLOCKING
⊞	⊞	SEWER MANHOLE
⊠	⊠	STORM CB
⊡	⊡	POWER VAULT
⊢	⊢	UTILITY POLE
⊣	⊣	STRAW WATTLE
⊤	⊤	CB PROTECTION

PROPERTY INFO

PARCEL NO: 333000011

LEGAL DESCRIPTION

Section 27 Township 20 Range 04 Quarter 23
CROCKETTS: CROCKETTS L 1 THRU 6 B 1 SEG
OUT OF 001-0, 002-0, 003-0, & 004-0 NW 27
20 04E SEG H 2080 MN

SITE AREA: 0.88 AC

PROJECT DATA

BUILDING USE: EX. FAST FOOD RESTAURANT

FIRE SPRINKLER: YES

TOTAL DISTURBED AREA: 1360 SF

NET CHANGE IMPERVIOUS AREA: -272 SF

TOTAL NEW + REPLACED IMPERVIOUS: 848 SF

EARTHWORK QUANTITIES:


CUT = 80 BCY

FILL = 80 BCY

* FOR PERMIT USE ONLY

CRPZ AREA: 452 SF

CRPZ AREA DISTURBED 35 SF (8%)

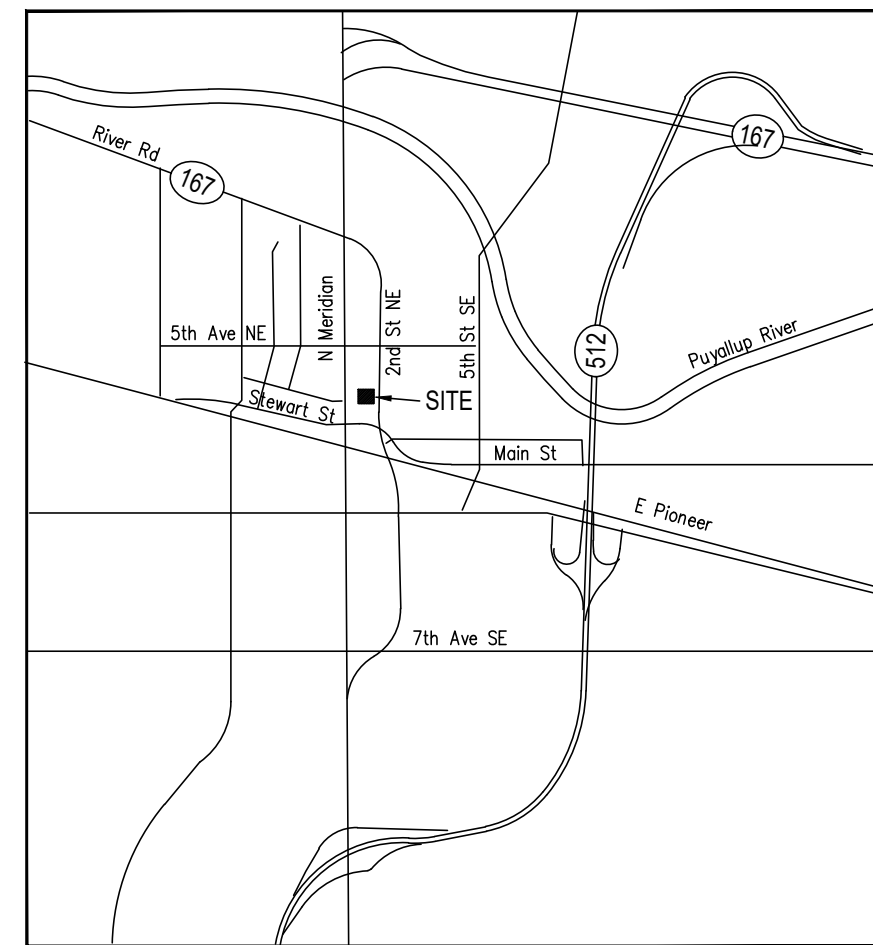

VICINITY MAP

SCALE: N.T.S.

PROJECT TEAM

OWNER / DEVELOPER

MCDONALD'S USA, LLC
CONTACT: CURT HOBBS
9805 NE 116TH STREET #A302
KIRKLAND, WA 98034
PHONE: (425) 305-0266
EMAIL: curt.hobbs@us.mcd.com

CIVIL ENGINEER

TERRAFORMA DESIGN GROUP, INC.
5027 51ST AVENUE SW
SEATTLE, WA 98136
CONTACT: PEDRO DEGUZMAN, PE
PHONE: (206) 795-9023
EMAIL: pedro@terraformdesigngroup.com

ARCHITECT

PM DESIGN GROUP, INC.
CONTACT: AMANDA MARTIN
PHONE: (206) 619-4214
EMAIL: amartin@pmdginc.com

GOVERNING AGENCIES

SITE, WATER, DRAINAGE, EROSION CONTROL, STREET

CITY OF PUYALLUP


Attn: Hans Hunger, P.E. | City Engineer
Email: hhunger@puyallupWA.gov

FIRE

CITY OF PUYALLUP
Attn: David Drake
Email: DDrake@puyallupWA.gov

SHEET INDEX


- C1.1 EXISTING CONDITIONS & TESC PLAN
- C1.2 WATER PLAN & RESTORATION
- C1.3 CIVIL DETAILS
- C1.4 CIVIL DETAILS
- C1.5 CIVIL NOTES

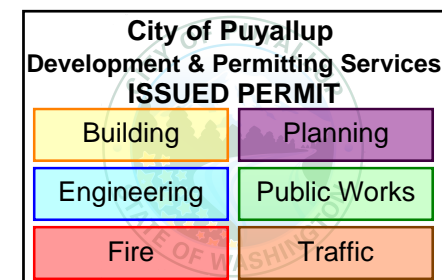

APPROVED

BY: *[Signature]*
CITY OF PUYALLUP
DEVELOPMENT ENGINEERING
DATE: 10/18/2024

NOTE: THIS APPROVAL IS VOID AFTER 180 DAYS FROM APPROVAL DATE.
THE CITY WILL NOT BE RESPONSIBLE FOR ERRORS AND/OR OMISSIONS ON THESE PLANS.
FIELD CONDITIONS MAY DICTATE CHANGES TO THESE PLANS AS DETERMINED BY THE DEVELOPMENT ENGINEERING MANAGER.

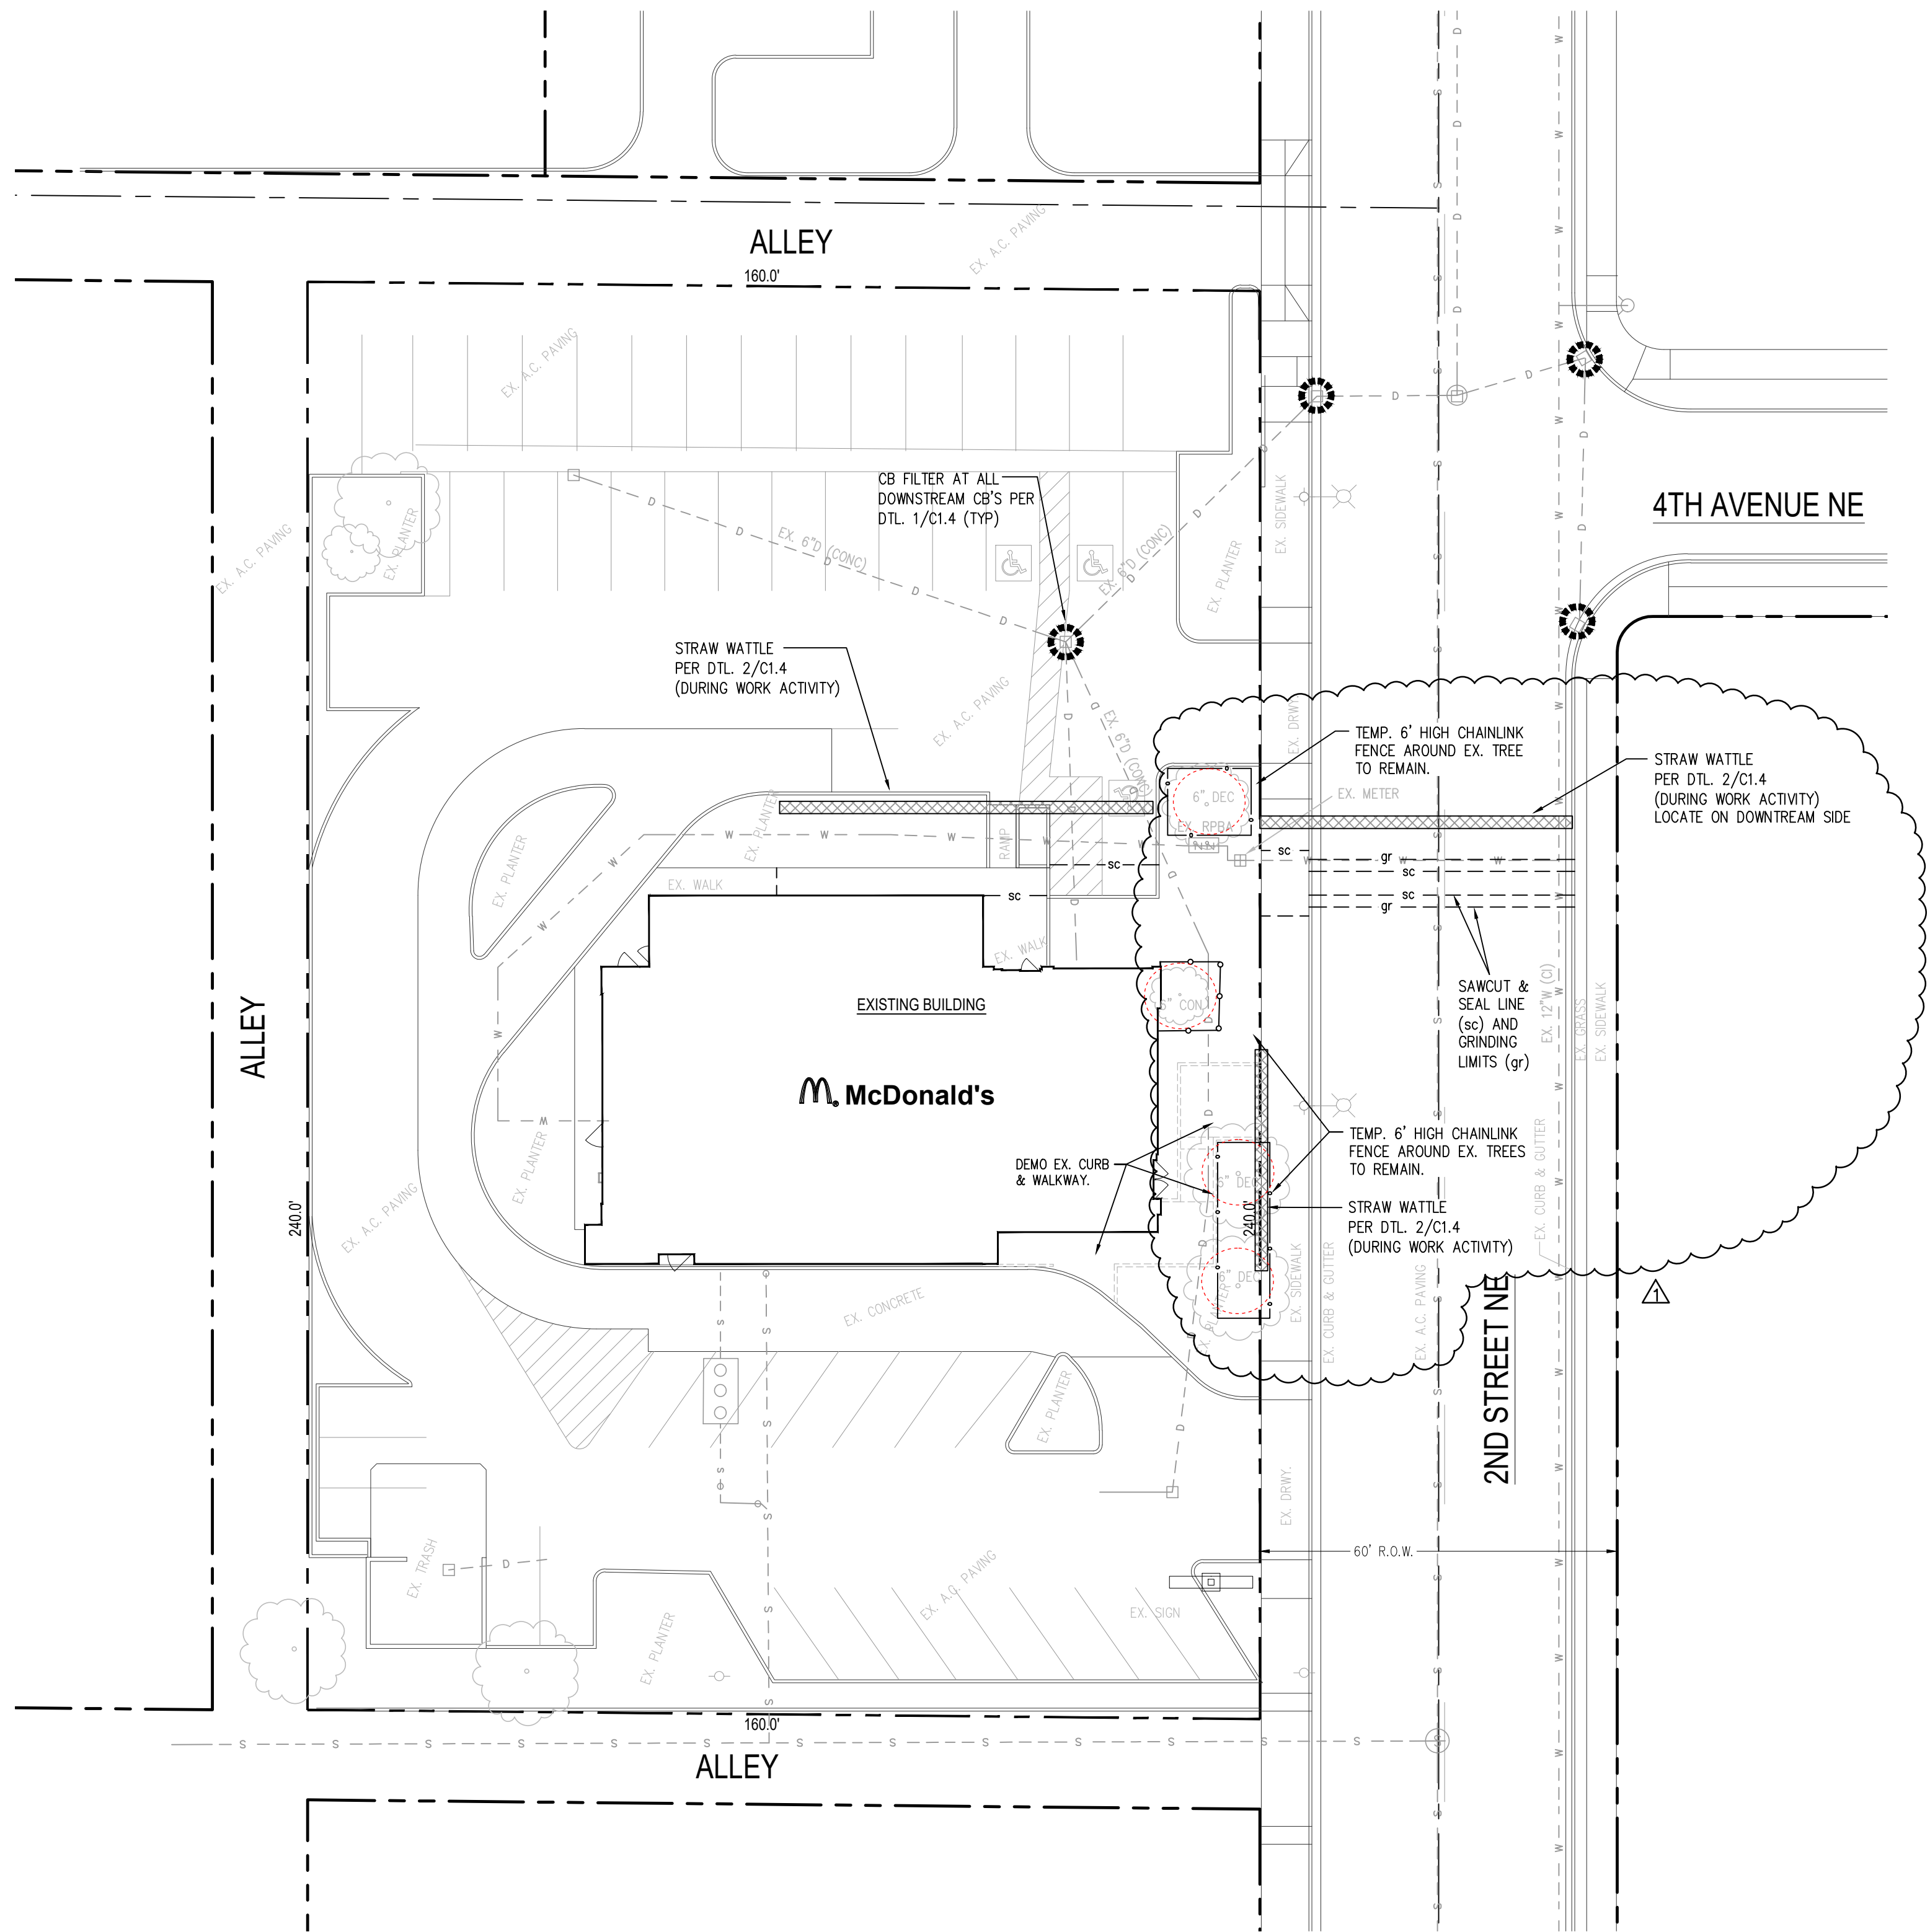

THE LOCATION OF ALL EXISTING UNDERGROUND UTILITIES IS SHOWN IN AN APPROXIMATE WAY ONLY. THE CONTRACTOR SHALL DETERMINE THE EXACT LOCATION OF ALL EXISTING UTILITIES BEFORE COMMENCING WORK.

EXISTING GRADE INFORMATION IS APPROXIMATE. THE CONTRACTOR SHALL FIELD VERIFY EXISTING GRADES AND NOTIFY ENGINEER OF ANY DISCREPANCIES BEFORE COMMENCING WORK.


CONTRACTOR AGREES TO BE FULLY RESPONSIBLE FOR ANY AND ALL DAMAGES WHICH MIGHT BE OCCASIONED BY HIS FAILURE TO CONFIRM EXISTING UTILITY AND GRADE INFORMATION.

CALL AT LEAST 2 WORKING DAYS BEFORE YOU DIG CALL '811'

BY	PAD
	REVISE PER CITY
REV DATE	8/27/24
Professional of Record:	
TERRAFORMA DESIGN GROUP, INC.	CIVIL ENGINEERING & LANDSCAPE ARCHITECTURE
	5027 51st Avenue SW Seattle WA 98136 phone 206.795.9023 website www.terraformdesigngroup.com
TD# 24009	8/27/24
PEDRO A. DEGUZMAN	REGISTERED PROFESSIONAL ENGINEER
	Seal
PREPARED FOR:	M. McDonald's USA, LLC
DRAWN BY:	P. DEGUZMAN
STD ISSUE DATE:	4/25/24
REVIEWED BY:	P. DEGUZMAN
DATE ISSUED:	4/25/24
TITLE:	MCDONALDS NSN #02978 PUYALLUP - 2ND
DESCRIPTION:	MRP PERMIT SUBMITAL
SITE ID:	046-0041
SITE ADDRESS:	304 2ND STREET NE, PUYALLUP, WA 98372
SHEET NO:	C1.1 EX. CONDITIONS & TESC PLAN

LEGEND

EXISTING	PROPOSED	PROPERTY LINE
---	---	R.O.W. CENTERLINE
---	---	EASEMENT
---	---	CONCRETE
---	---	A.C. PAVING
---	---	SAWCUT LINE
---	---	WATER MAIN
---	---	FIRE MAIN
---	---	SEWER MAIN
---	---	STORM DRAIN
○	○	FIRE HYDRANT
⊕	⊕	WATER METER
⊗	⊗	GATE VALVE
○	○	THRUST BLOCKING
○	○	SEWER MANHOLE
○	○	STORM CB
○	○	STORM MANHOLE
⊞	⊞	POWER VAULT
⊞	⊞	UTILITY POLE

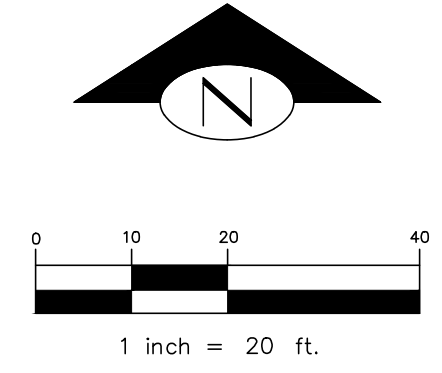


WATER NOTES

- * AVAIL. FIRE FLOW > 1950 GPM
- W1 12"x8" TAPPING TEE PER CITY STANDARDS
8" GATE VALVE (FL&M) PER CITY STD. DTL. 03.01.01
CONC. THRUST BLOCK PER CITY STD. DTL. 03.02.01-1 (TYP)
- W2 51' ~ 8" DI, CL.52
- W3 8"x6" TEE (M&FL)
8"x4" REDUCER (M.J. WEST)
6" GATE VALVE (FL&M, SOUTH)
FIRE HYDRANT ASS'Y PER CITY STD. DTL. 03.05.01
CONC. THRUST BLOCK
- W4 11' ~ 4" DI, CL.52 FIRE SERVICE
[NOTE: FIRE SERVICE SIZE SHALL BE CONFIRMED BY THE FIRE SPRINKLER DESIGNER PRIOR TO ANY CONSTRUCTION. SIZE OF THE PROPOSED FIRE LINE AND FITTINGS SHALL BE REVISED IF NECESSARY.]
- W5 POST INDICATOR VALVE PER CITY STD. DTL. 03.10.03
10' SEPARATION TO FIRE HYDRANT
- W6 64' ~ 4" DI, CL.52 FIRE SERVICE
RESTRAINED MEGA LUG JOINTS (TYP)
1 ~ 4" ~ 90-DEG BEND (RJ)
- W7 INTERIOR FIRE DCDA
DESIGN / BUILD BY CONTRACTOR
REQUIRES SEPARATE FIRE PERMIT
- W8 70' ~ 4" DI, CL.52 FIRE SERVICE
RESTRAINED MEGA LUG JOINTS (TYP)
1 ~ 4" ~ 90-DEG BEND (RJ)
- W9 FIRE DEPARTMENT CONNECTION PER CITY STD. DTL. 03.10.02
- W10 10' x 16' WATER EASEMENT TO CITY


SITE NOTES

- 1 SAWCUT EX. CURB & GUTTER FOR WATER CONNECTION
NEW CURB & GUTTER PER WSDOT STD. PLAN F-10.12
- 2 SAWCUT & PERFORM TRENCHING OF ASPHALT PAVING.
ASPHALT RESTORATION INCLUDE GRIND & OVERLAY
PER CITY STD. DTL. 01.01.20 PER SHEET C1.4
- 3 SAWCUT EX. SIDEWALK TO NEAREST JOINT
NEW CONCRETE SIDEWALK PER CITY STD. DTL. 01.02.01 PER SHEET C1.4
- 4 RESTORE WHITE SKIP STRIPE PER DTL "D" OF
PER CITY STD. DTL. 01.03.10 ON SHEET C1.4
- 5 RESTORE EX. GRASS IN KIND WITH GRASS SOIL
SOIL AMENDMENT PER CITY STD. DTL. 01.02.08 ON SHEET C1.4
- 6 SAWCUT & PATCH EX. ONSITE ASPHALT PAVING.
2" MIN. HOT-MIX ASPHALT, CLASS 1/2", OVER
COMPACTED 4" MIN. CRUSHED SURFACING TOP COURSE.
- 7 SAWCUT & REPLACE EX. CONC. CURB TO MATCH EXISTING.
- 8 SAWCUT & REPLACE EX. CONC. WALKWAY TO MATCH EXISTING.
4" MIN. CONCRETE WALKWAY, OVER
COMPACTED 2" MIN. CRUSHED SURFACING TOP COURSE.
- 9 RESTORE WHITE PARKING STRIPING TO MATCH EXISTING.

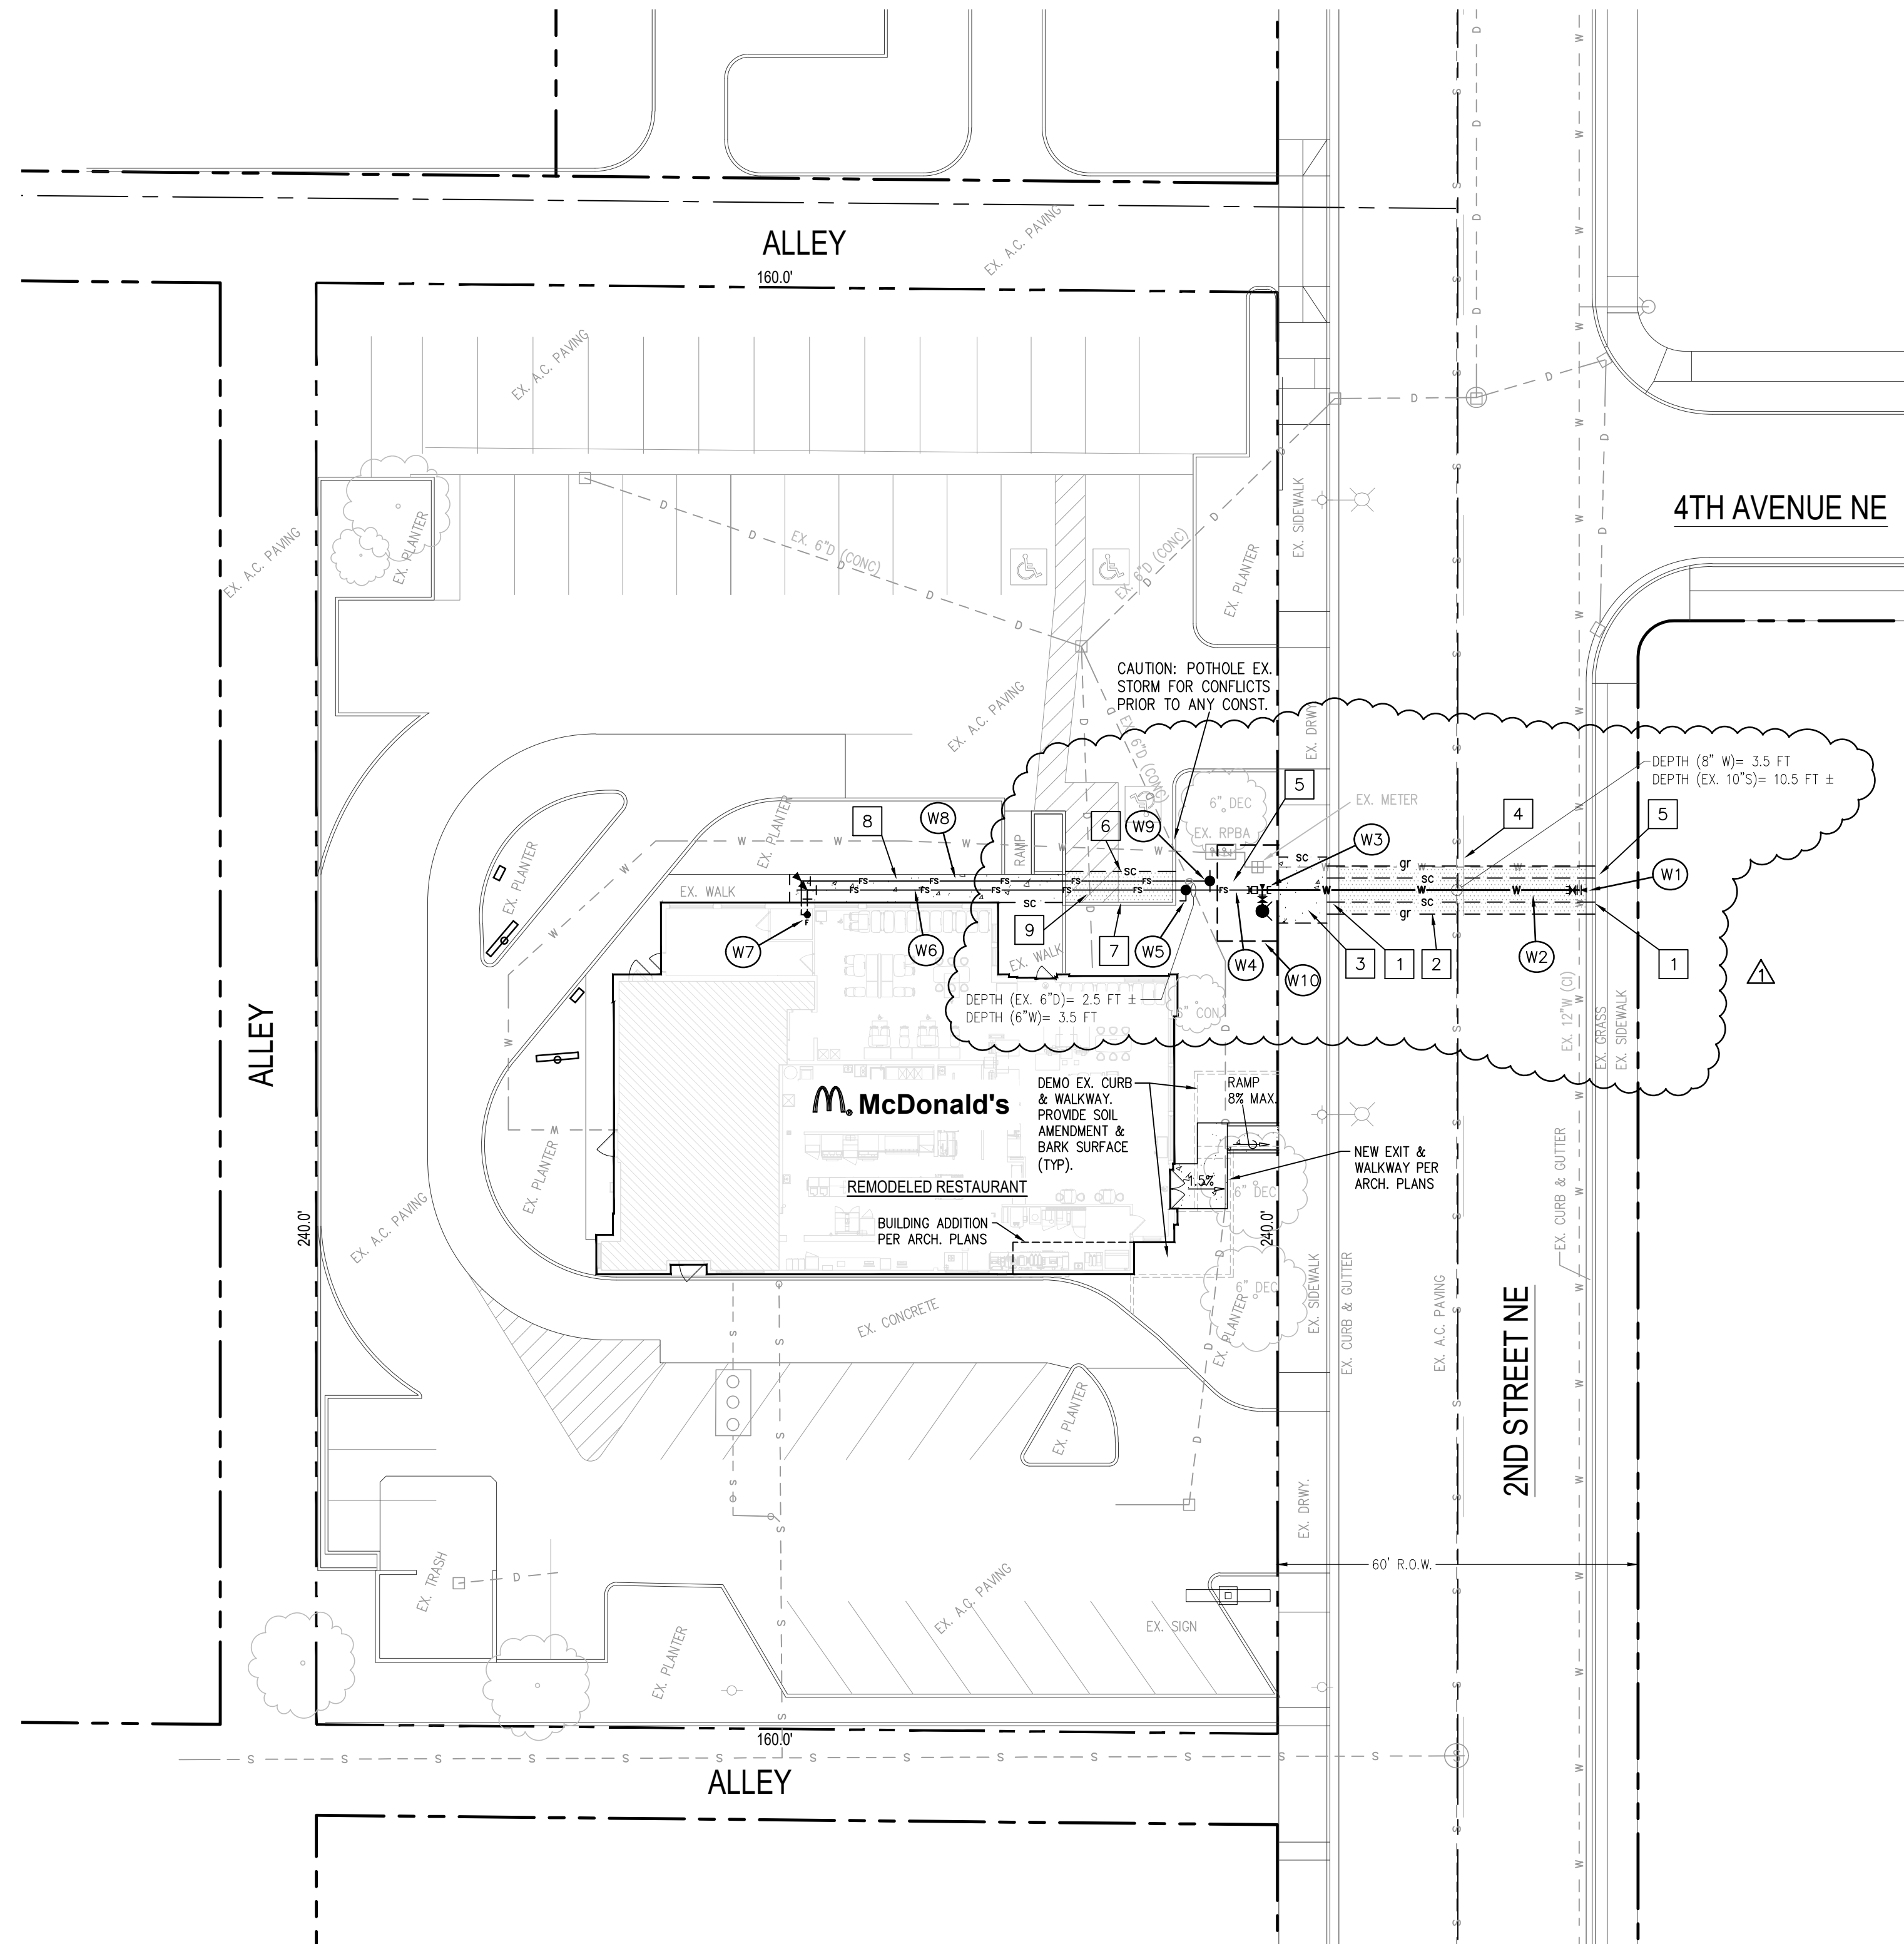

REV	DATE	DESCRIPTION
8/27/24		REVISE PER CITY
		PAD

Professional of Record:
TERRAFORMA DESIGN GROUP, INC.
 CIVIL ENGINEERING & LANDSCAPE ARCHITECTURE
 5027 51st Avenue SW Seattle WA 98136
 phone 206.795.9023 website www.terraformdesigngroup.com
 TDG# 24009
 8/27/24

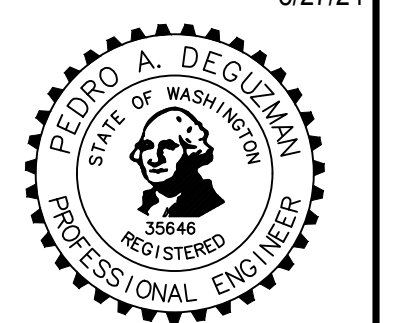

Seal
 PREPARED FOR:
McDonald's USA, LLC
 These drawings and specifications are the confidential and proprietary information of McDonald's USA, LLC. The contract documents were prepared for use on this specific site in conjunction with its issue date and are not to be used for any other project without the written consent of McDonald's USA, LLC. Reproduction of these drawings for reference or example on another project requires the services of properly licensed architects and engineers. Reproduction of the contract documents for reuse on another project is not authorized.

DATE	BY	DESCRIPTION
4/25/24	P. DECUZMAN	ISSUED PERMIT
4/25/24	P. DECUZMAN	PERMIT SUBMITTAL
4/25/24	P. DECUZMAN	DATE ISSUED
4/25/24	P. DECUZMAN	DATE

CITY PERMIT# PRCCP20240864

McDONALDS NSN #02978
 PUYALLUP - 2ND

SHEET NO. **C1.2**
 WATER PLAN & RESTORATION

046-0041 SITE ADDRESS 304 2ND STREET NE, PUYALLUP, WA 98372





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CALL AT LEAST 2 WORKING DAYS BEFORE YOU DIG CALL '811'

FIRE HYDRANT/FDC LOCATION/ACCESS APPROVED BY: <i>[Signature]</i> CITY OF PUYALLUP FIRE CODE OFFICIAL DATE: 10/21/2024 NOTE: THIS APPROVAL IS VOID AFTER 180 DAYS FROM APPROVAL DATE. THE CITY WILL NOT BE RESPONSIBLE FOR ERRORS AND/OR OMISSIONS ON THESE PLANS. FIELD CONDITIONS MAY DICTATE CHANGES TO THESE PLANS AS DETERMINED BY THE FIRE CODE OFFICIAL.	APPROVED BY: <i>[Signature]</i> CITY OF PUYALLUP DEVELOPMENT ENGINEERING DATE: 10/18/2024 NOTE: THIS APPROVAL IS VOID AFTER 180 DAYS FROM APPROVAL DATE. THE CITY WILL NOT BE RESPONSIBLE FOR ERRORS AND/OR OMISSIONS ON THESE PLANS. FIELD CONDITIONS MAY DICTATE CHANGES TO THESE PLANS AS DETERMINED BY THE DEVELOPMENT ENGINEERING MANAGER.
--	---



CITY OF PUYALLUP
OFFICE OF THE CITY ENGINEER

FIRE HYDRANT ASSEMBLY

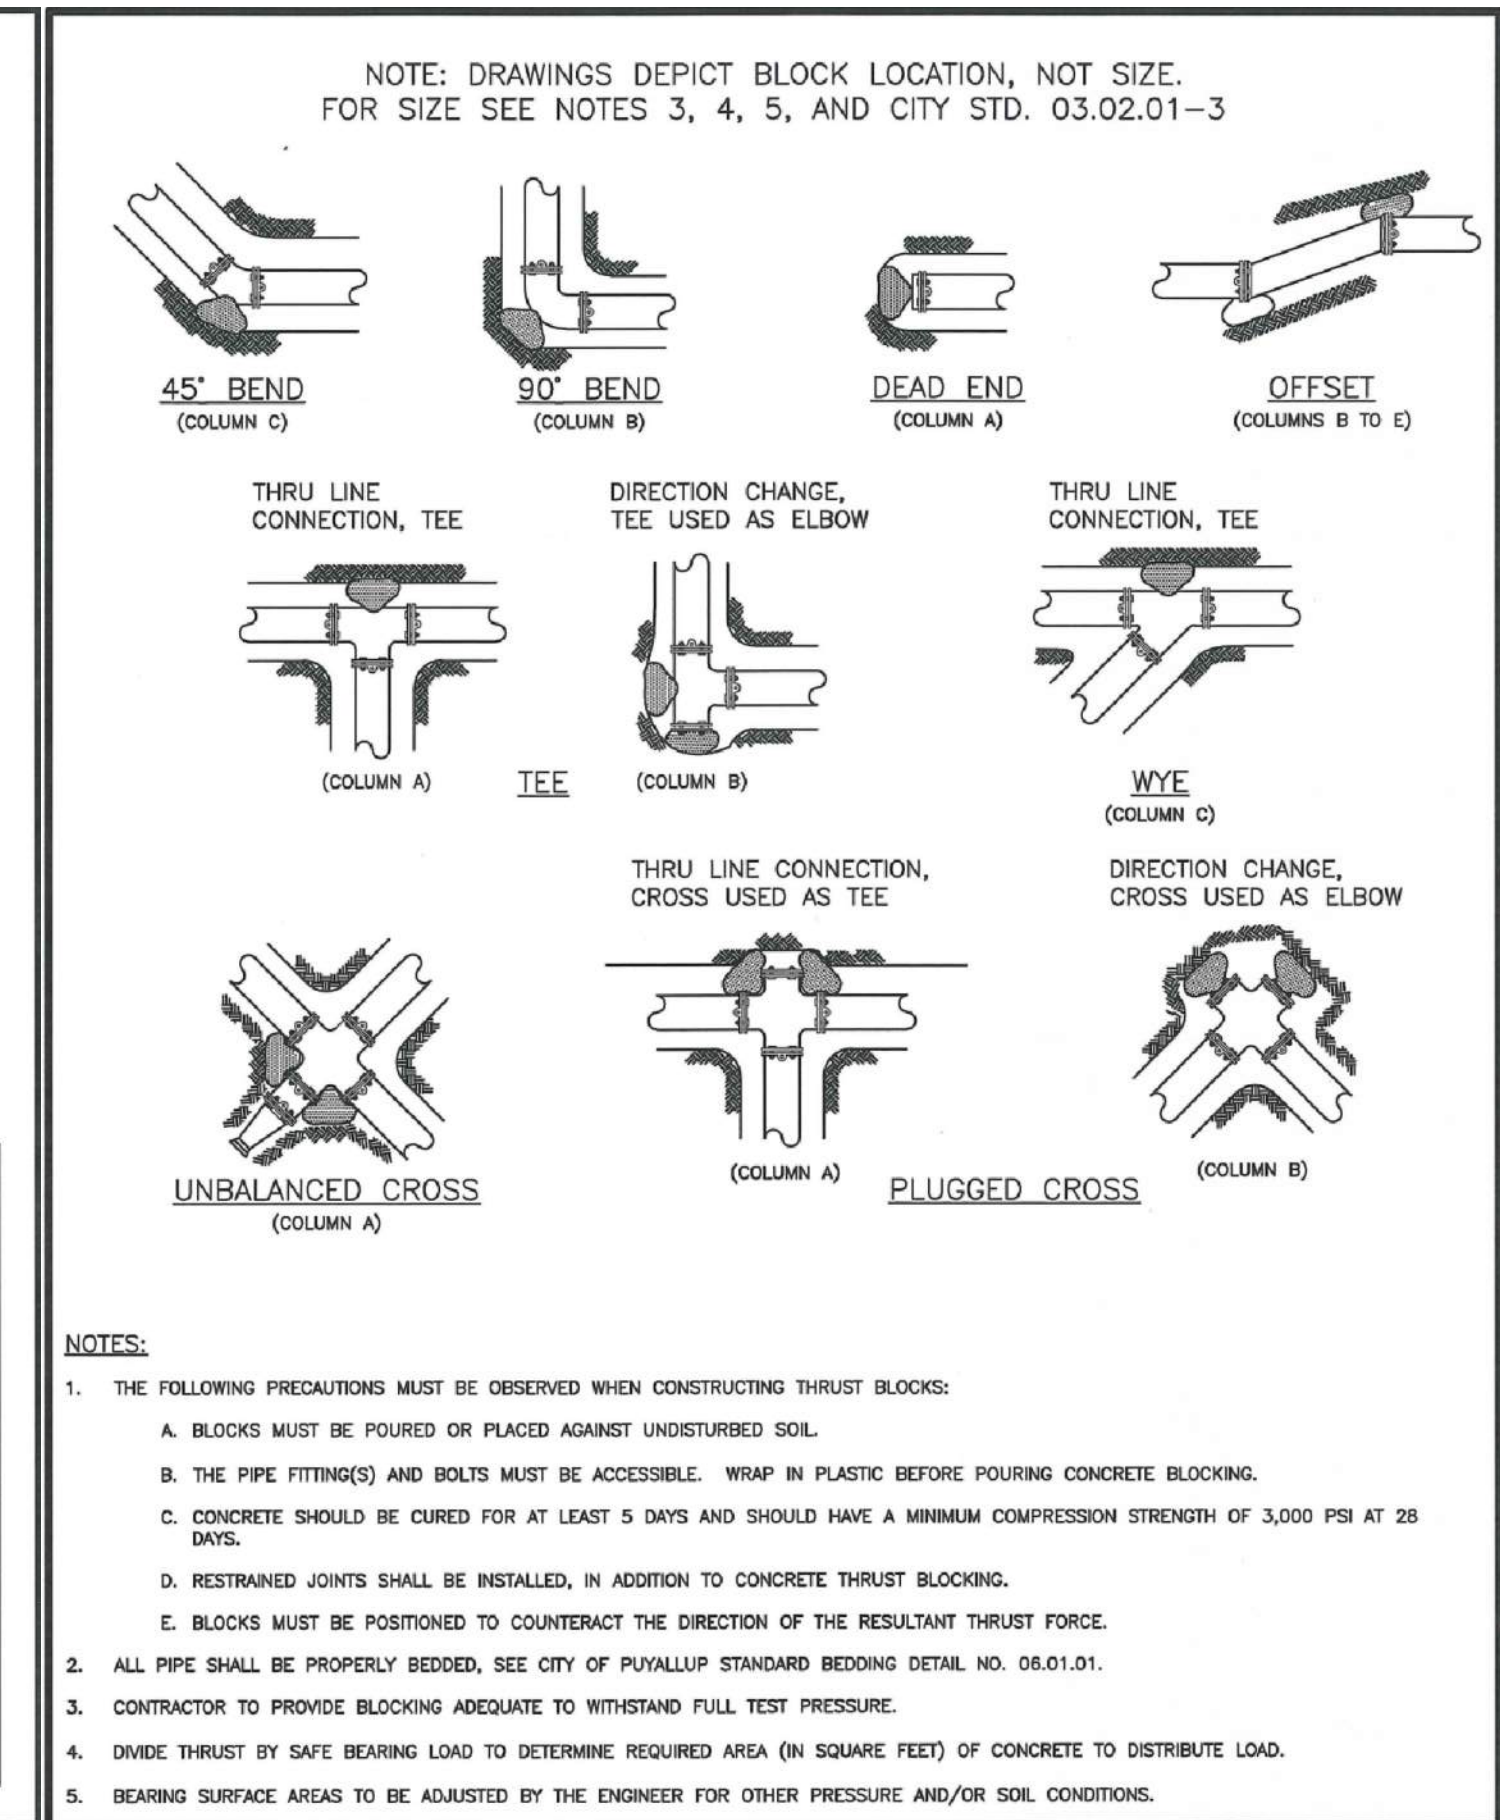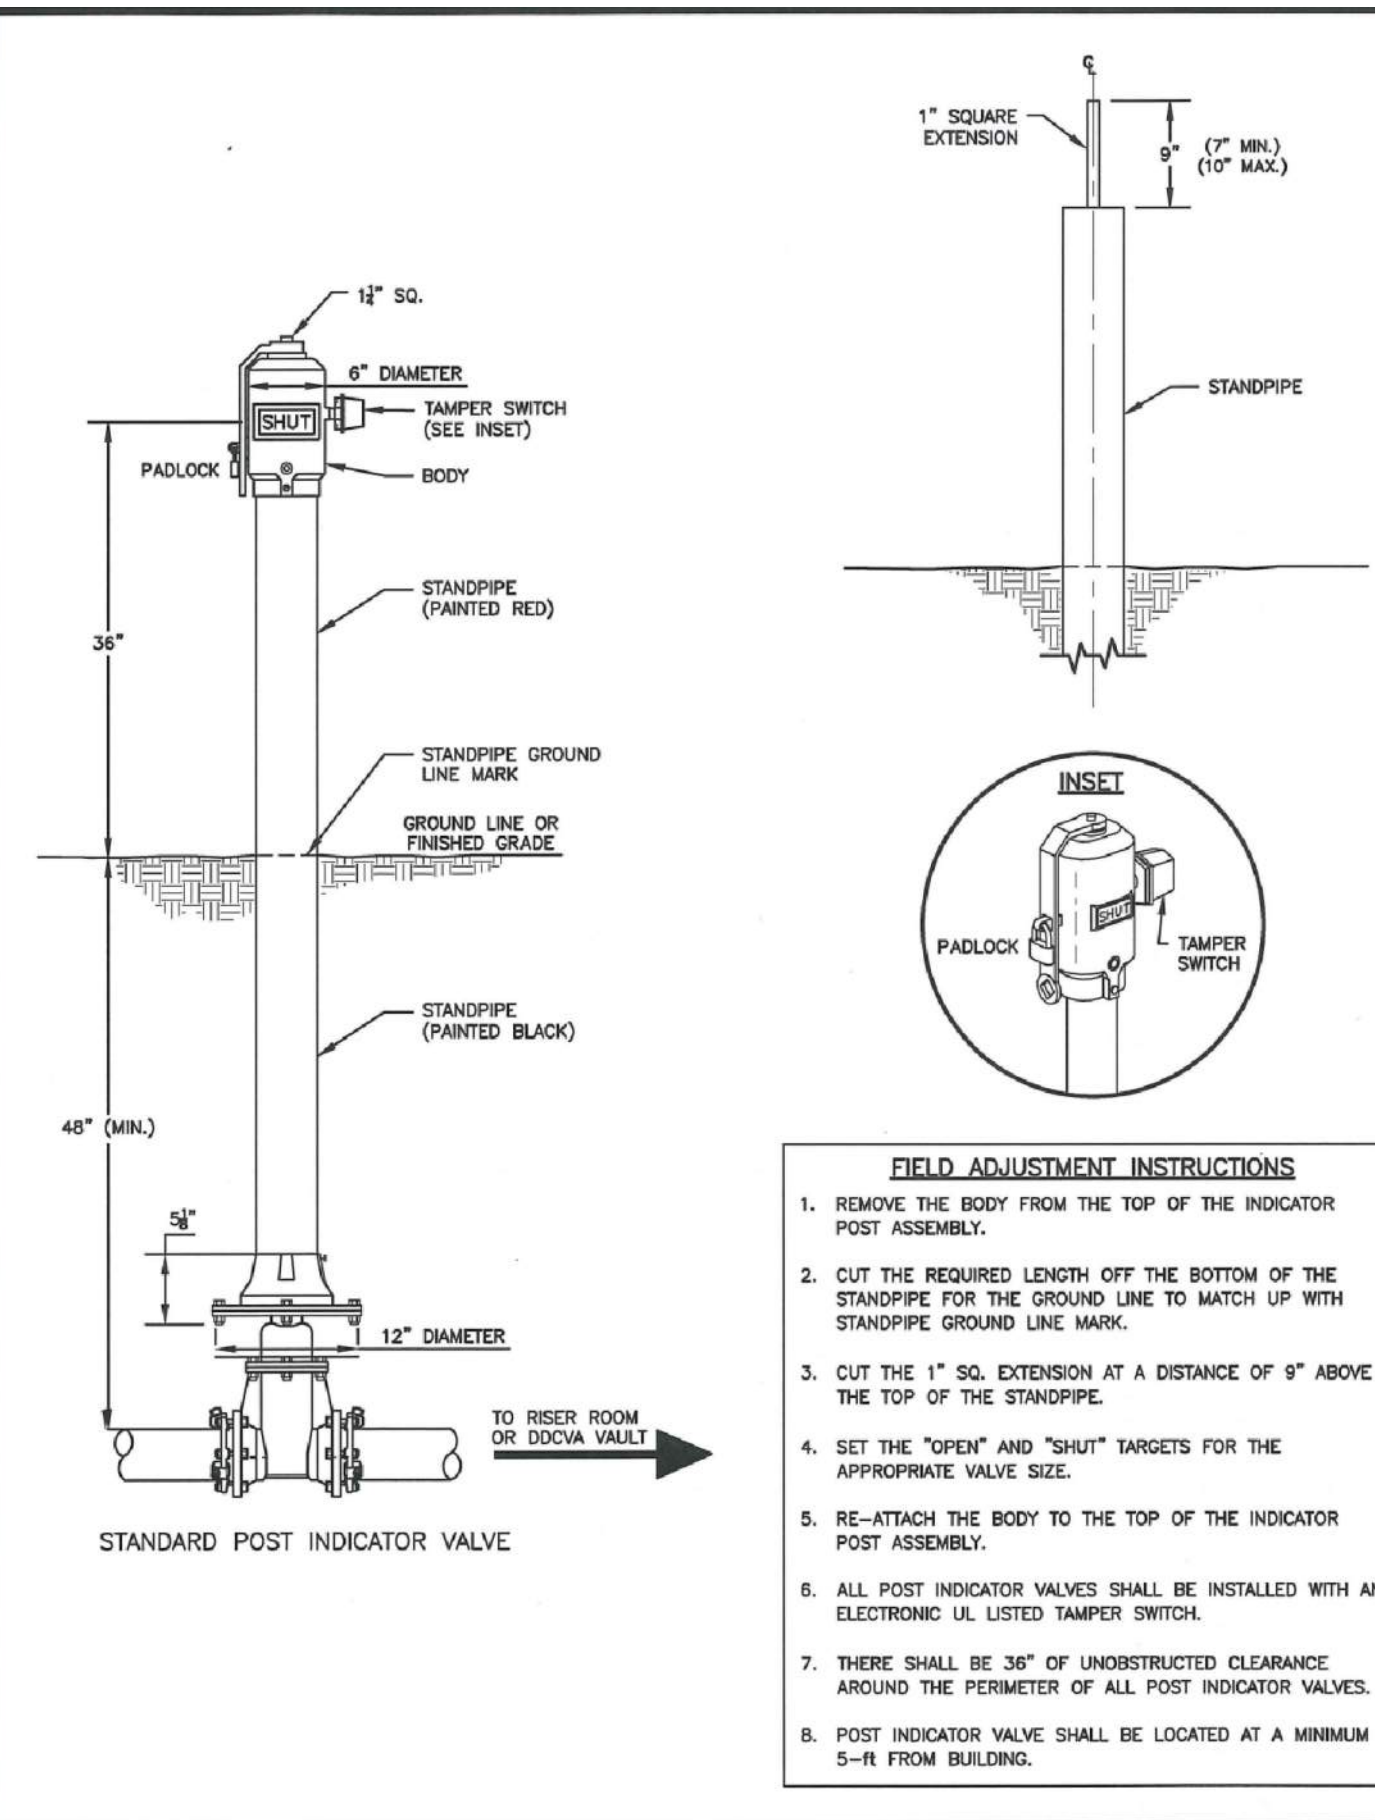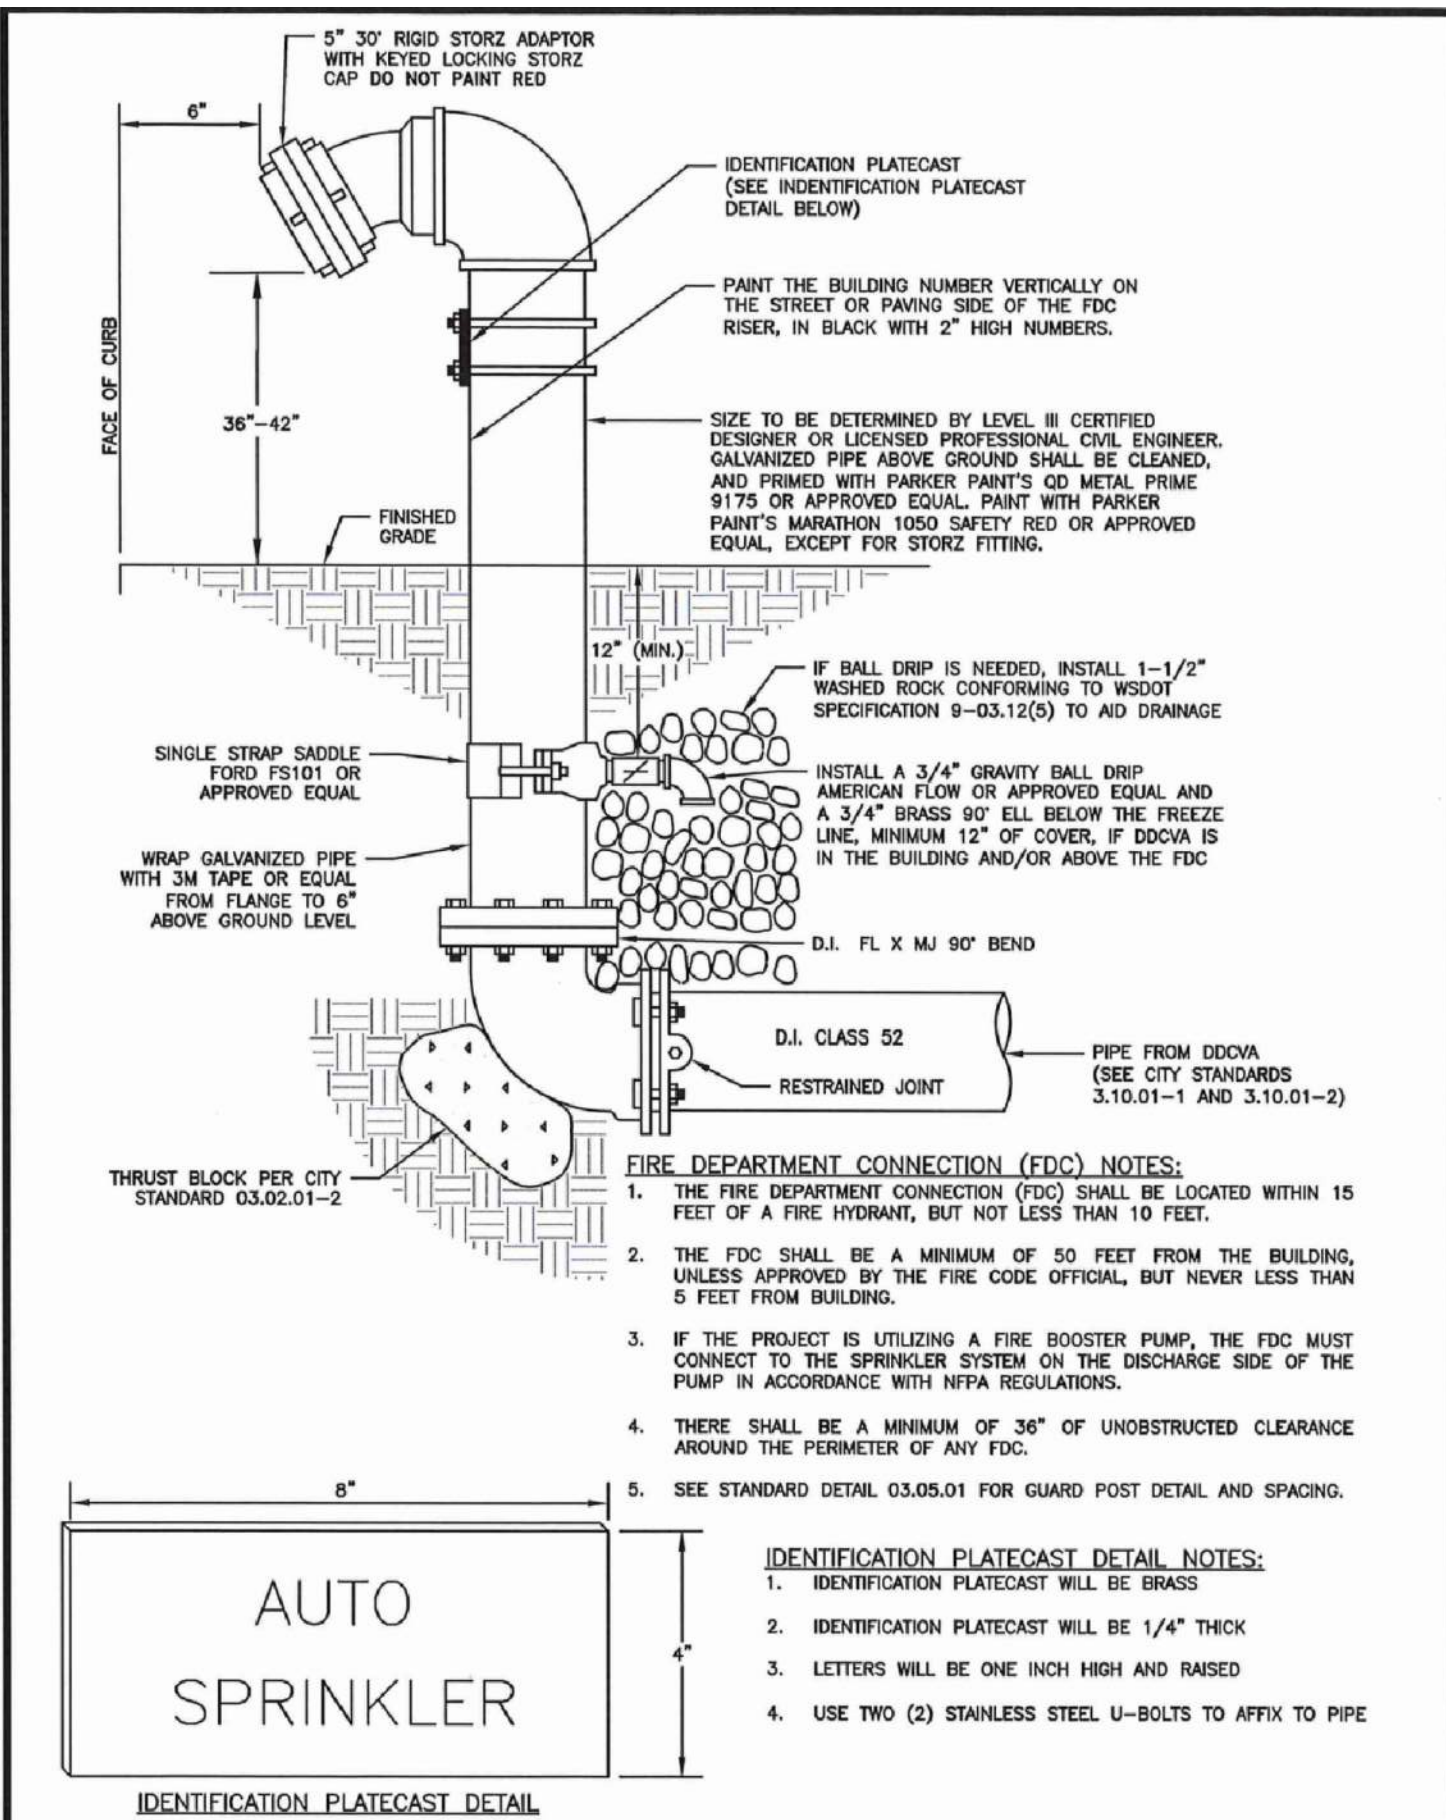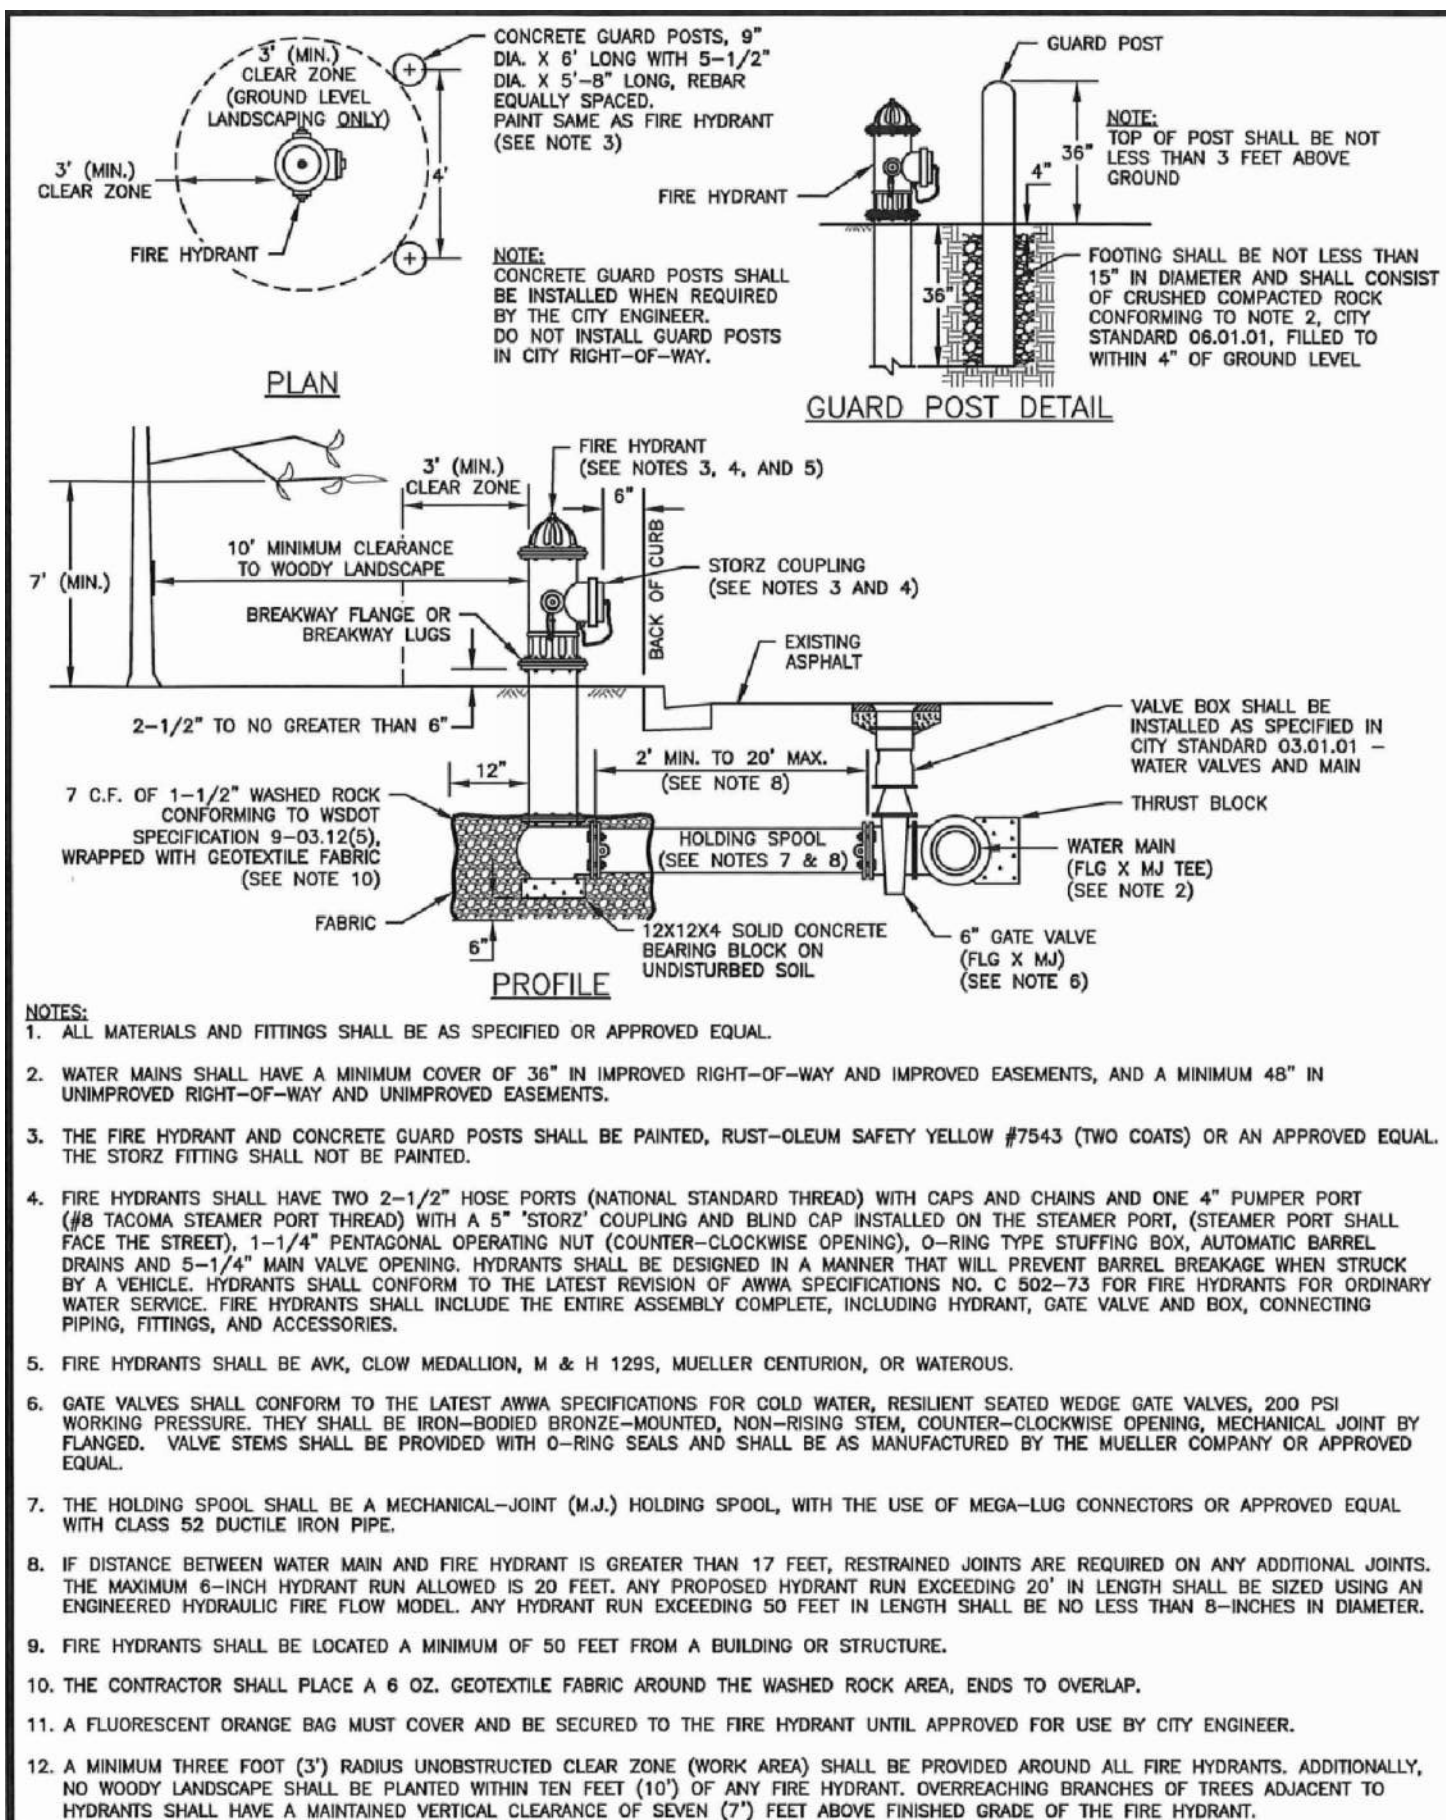APPROVED FOR PUBLICATION: [Signature]

CITY STANDARD: 03.05.01

CITY OF PUYALLUP
PUBLIC WORKS AND DEVELOPMENT ENGINEERING

FIRE DEPARTMENT CONNECTION (FDC)

APPROVED FOR PUBLICATION: [Signature]

CITY STANDARD: 03.10.02

CITY OF PUYALLUP
OFFICE OF THE CITY ENGINEER

POST INDICATOR VALVE

APPROVED FOR PUBLICATION: [Signature]

CITY STANDARD: 03.10.03

CITY OF PUYALLUP
OFFICE OF THE CITY ENGINEER

HORIZONTAL THRUST BLOCKING

APPROVED FOR PUBLICATION: [Signature]

CITY STANDARD: 03.02.01-1

TABLE 2: THRUST AT FITTINGS AT 200 PSI

SIZE	TEST PRESSURE (PSI)	THRUST FITTINGS AT 200 PSI				
		TEE AND DEAD ENDS	90° BEND	45° BEND	22.5° BEND	11.25° BEND
4"	200	3,140	4,440	2,405	1,225	615
6"	200	7,070	9,995	5,410	2,760	1,385
8"	200	12,565	17,770	9,620	4,905	2,465
10"	200	19,635	27,770	15,030	7,660	3,850
12"	200	28,275	39,985	21,640	11,030	5,545
14"	200	38,485	54,425	29,455	15,015	7,545
16"	200	50,265	71,085	38,470	19,615	9,855



TABLE 3: BEARING VALUE OF SOIL

SOIL TYPE	SAFE BEARING LOAD (LBS/SF)
MUCK, PEAT, ETC.	0
SOFT CLAY/ALLUVIAL SOIL	1,000
SAND	2,000
SAND AND GRAVEL	3,000
SAND AND GRAVEL CEMENTED WITH CLAY	4,000
HARD SHALE	10,000

SEE CITY STANDARDS 03.02.01-1 AND 03.02.01-2 FOR ADDITIONAL INFORMATION.

NOTES:

- TO DETERMINE THRUST AT PRESSURES OTHER THAN PSI SHOWN, MULTIPLY THE THRUST OBTAINED IN TABLE 2 BY THE RATIO OF THE PRESSURE TO 200 PSI.
- EXAMPLE: THE THRUST ON A 12 INCH, 90° BEND AT 300 PSI.
 $39,985 \times \frac{300}{200} = 59,978 \text{ LBS}$
- TO DETERMINE THE BEARING AREA OF THE THRUST BLOCK IN SQUARE FEET (SF):
SEE TABLE 3, BEARING VALUE OF SOIL.
- EXAMPLE: FOR SAND AND GRAVEL BEARING VALUE FROM TABLE 3 IS 3,000 LBS/SF.
 $59,978 \text{ LBS} \div 3,000 \text{ LBS/SF} = 20 \text{ SF OF AREA}$
- CONTRACTOR TO PROVIDE BLOCKING ADEQUATE TO WITHSTAND FULL TEST PRESSURE
- AREAS SHALL BE ADJUSTED FOR OTHER PRESSURE CONDITIONS.
- NO WATER MAIN SHALL DEAD END AGAINST A MAIN LINE VALVE. DEAD END WATER MAINS SHALL BE BLOCKED AGAINST A RESTRAINED MECHANICAL JOINT (M.J.), PLUG OR CAP.

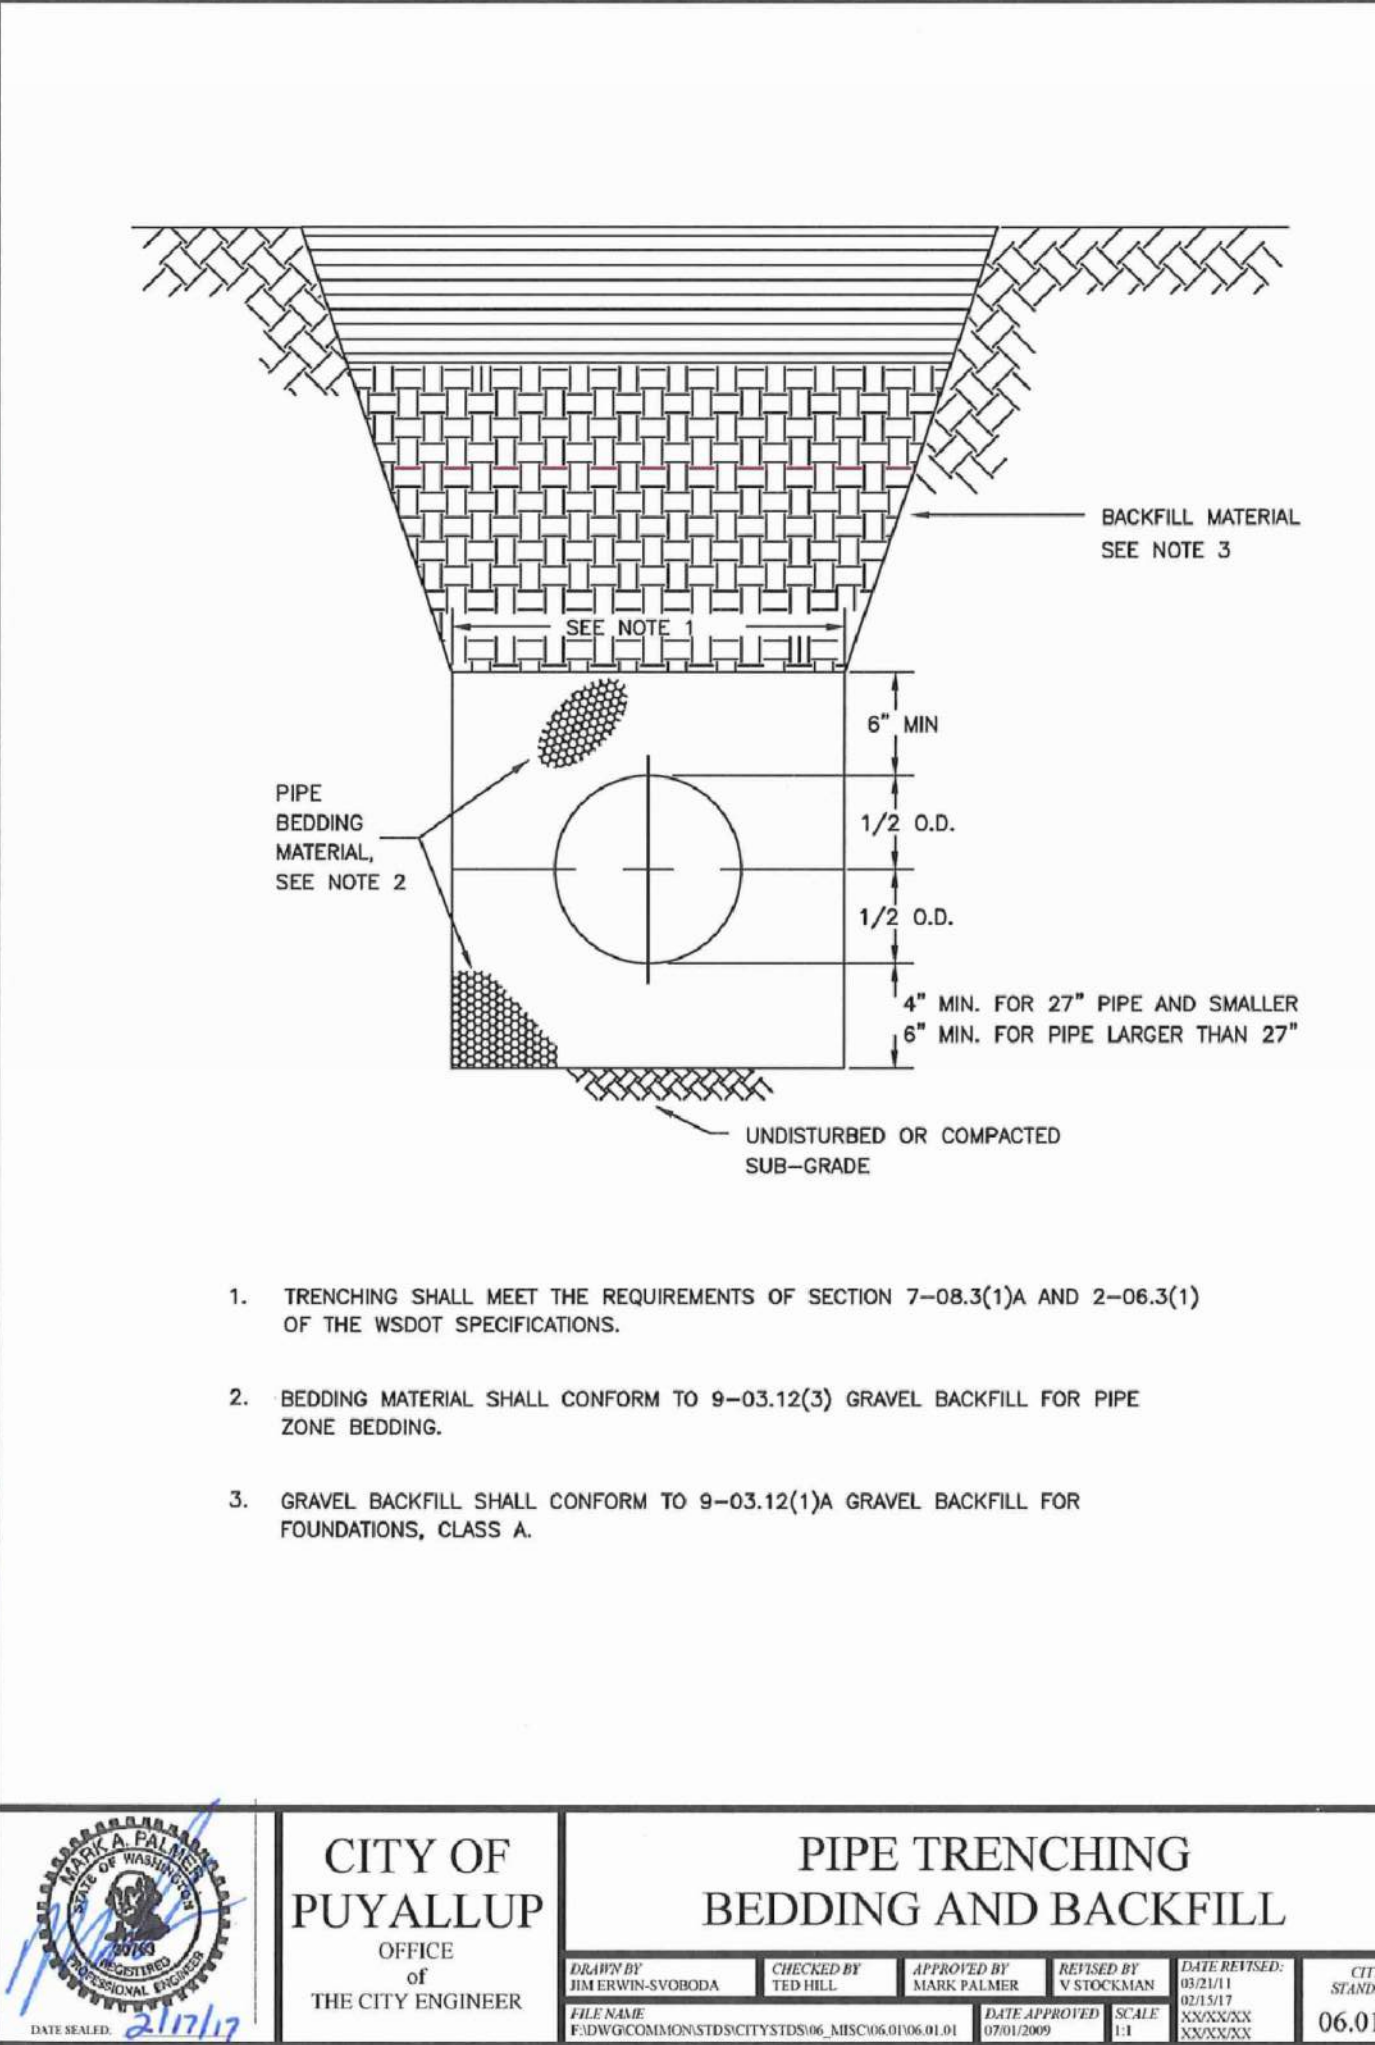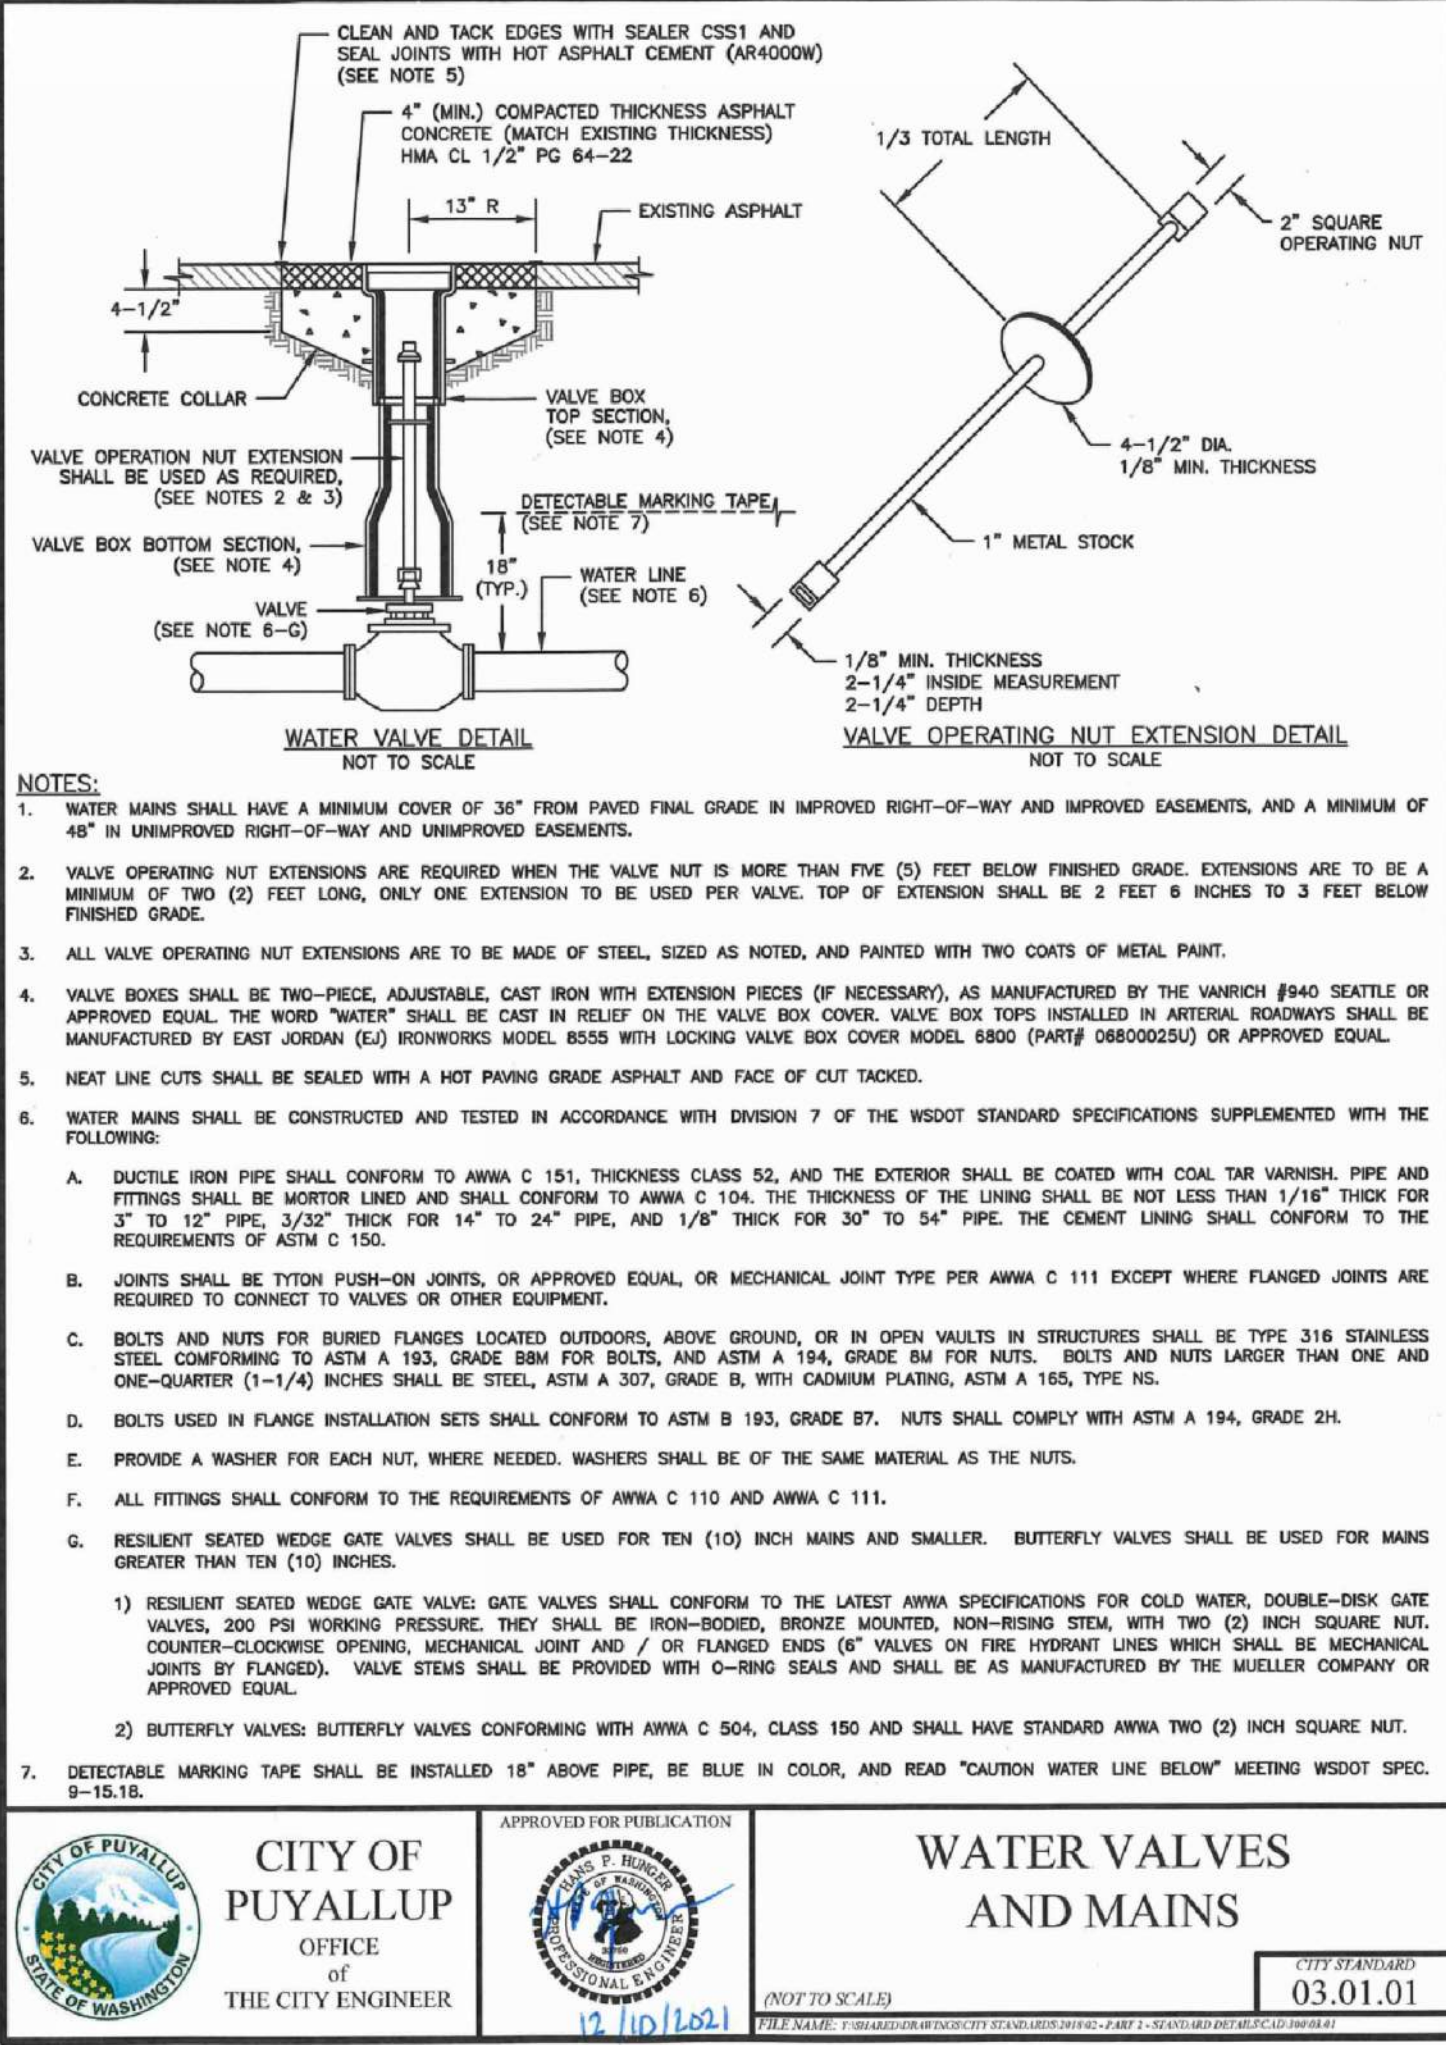

CITY OF PUYALLUP
OFFICE OF THE CITY ENGINEER

WATER VALVES AND MAINS

APPROVED FOR PUBLICATION: [Signature]

CITY STANDARD: 03.01.01

CITY OF PUYALLUP
OFFICE OF THE CITY ENGINEER

PIPE TRENCHING BEDDING AND BACKFILL

APPROVED FOR PUBLICATION: [Signature]

CITY STANDARD: 06.01.01

TERRAFORMA DESIGN GROUP, INC.
CIVIL ENGINEERING & LANDSCAPE ARCHITECTURE
5027 1st Avenue SW Seattle WA 98136
phone 206.795.9023 website www.terraformdesigngroup.com

Professional of Record:

SEAL OF A PROFESSIONAL ENGINEER
PEDRO A. DEGUZMAN
STATE OF WASHINGTON
REGISTERED PROFESSIONAL ENGINEER
TDC# 24009
8/27/24

PREPARED FOR: M. McDonald's USA, LLC

DATE: 8/27/24

PROJECT: PUYALLUP - 2ND

PERMIT: PRCPC20240864

ISSUED PERMIT: Building, Planning, Engineering, Public Works, Fire, Traffic


APPROVED: CITY OF PUYALLUP DEVELOPMENT ENGINEERING
DATE: 10/18/2024

NOTES: THIS APPROVAL IS VOID AFTER 180 DAYS FROM APPROVAL DATE. THE CITY WILL NOT BE RESPONSIBLE FOR ERRORS AND/OR OMISSIONS ON THESE PLANS. FIELD CONDITIONS MAY DICTATE CHANGES TO THESE PLANS AS DETERMINED BY THE FIRE CODE OFFICIAL.

CIVIL DETAILS


C1.3

3/5

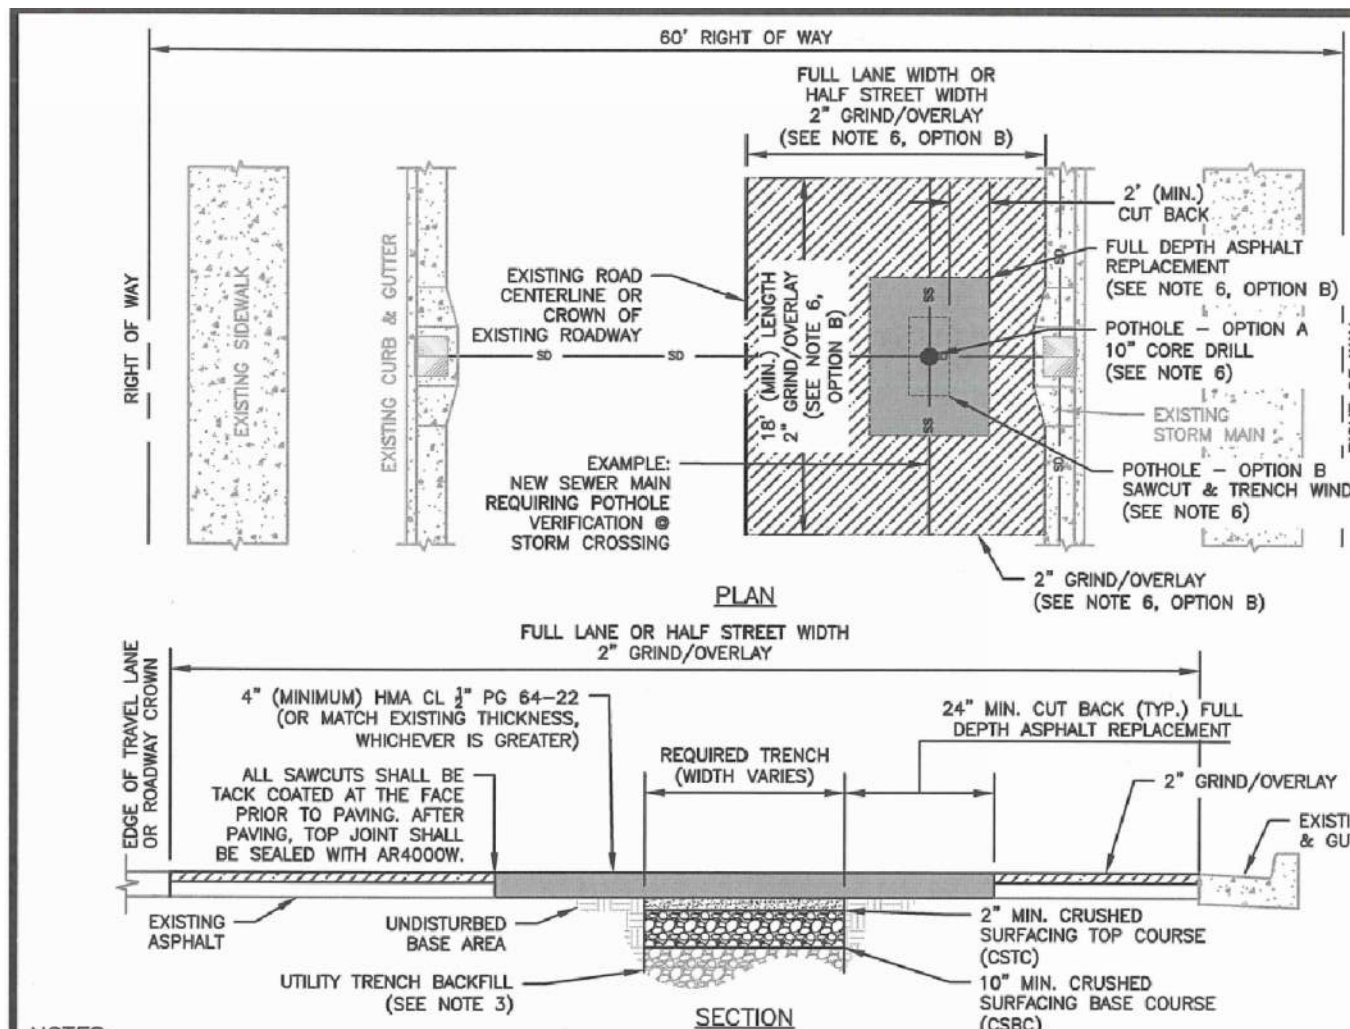


NOTES:
1. BASE AND SUBBASE MATERIAL SHALL BE COMPACTED TO 95% OF THE MODIFIED PROCTOR MAXIMUM DRY DENSITY.
2. ALL DEPTHS INDICATED ARE A MINIMUM COMPACTED DEPTH.
3. INITIAL BACKFILL SHALL BE PERFORMED ONLY AFTER INSPECTION AND APPROVAL OF THE INSTALLED PIPE OR STRUCTURE...

Table with 4 columns: CITY OF PUYALLUP, OFFICE OF THE CITY ENGINEER, CITY STANDARD 01.01.20, and STREET PATCH.

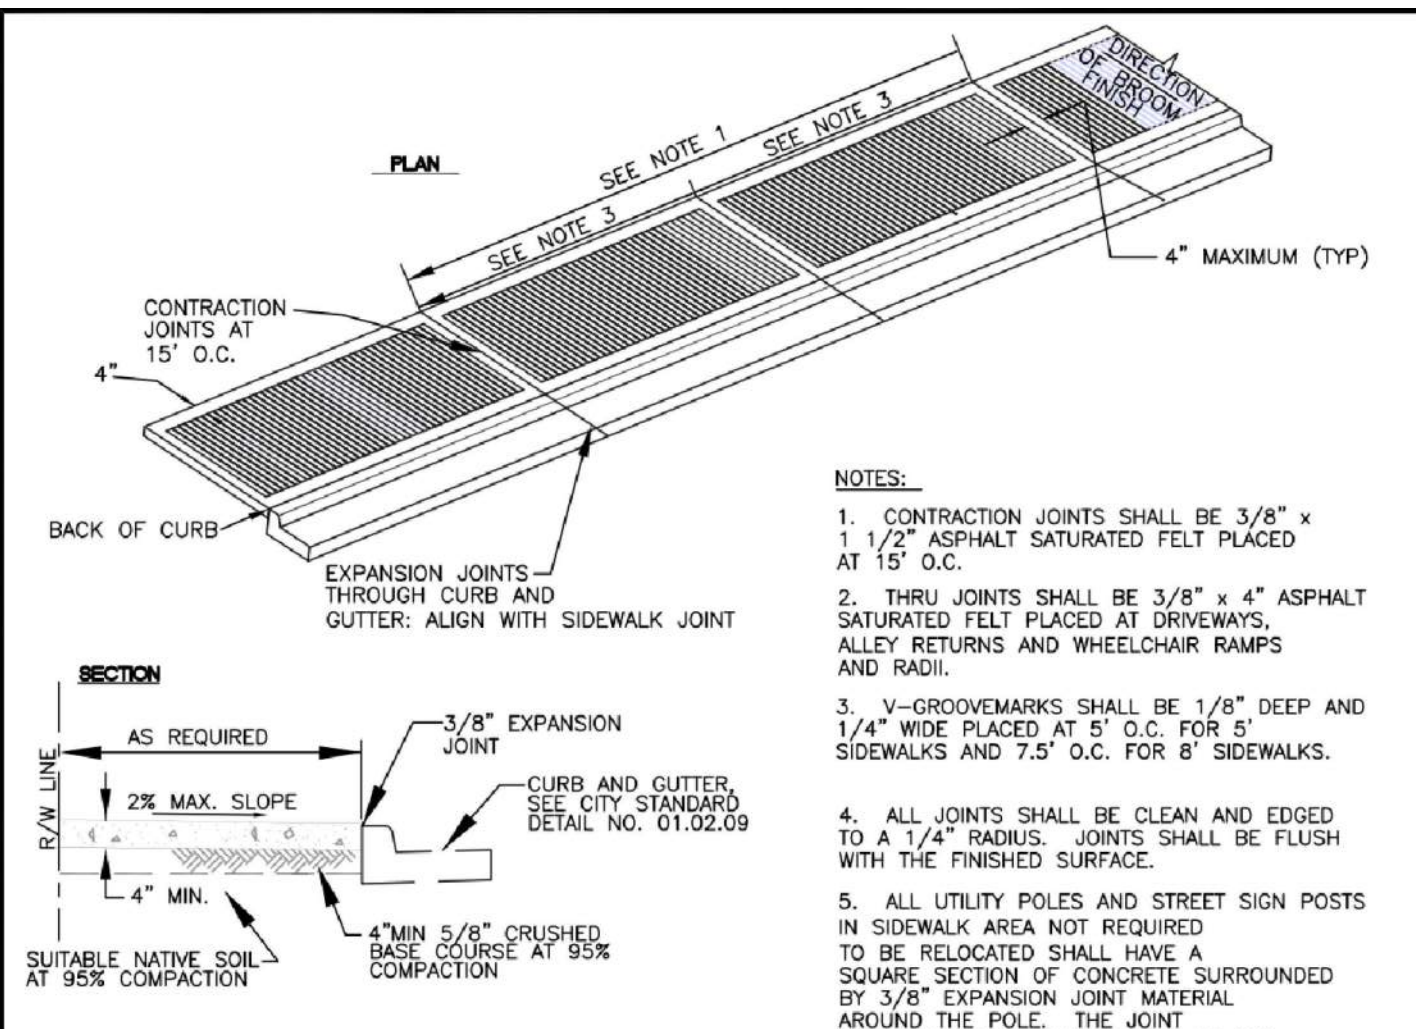


NOTES:
1. CONTRACTION JOINTS SHALL BE 3/8" x 1 1/2" ASPHALT SATURATED FELT PLACED AT 15' O.C.
2. THRU JOINTS SHALL BE 3/8" x 4" ASPHALT SATURATED FELT PLACED AT DRIVEWAYS, ALLEY RETURNS AND WHEELCHAIR RAMPS AND RADIUS.
3. V-GROOVEMARKS SHALL BE 1/8" DEEP AND 1/4" WIDE PLACED AT 5' O.C. FOR 6" SIDEWALKS AND 7.5' O.C. FOR 8" SIDEWALKS...

Table with 4 columns: CITY OF PUYALLUP, DEVELOPMENT ENGINEERING and PUBLIC WORKS DEPARTMENTS, CITY STANDARD 01.02.01, and SIDEWALK WITHOUT PLANTING STRIP.

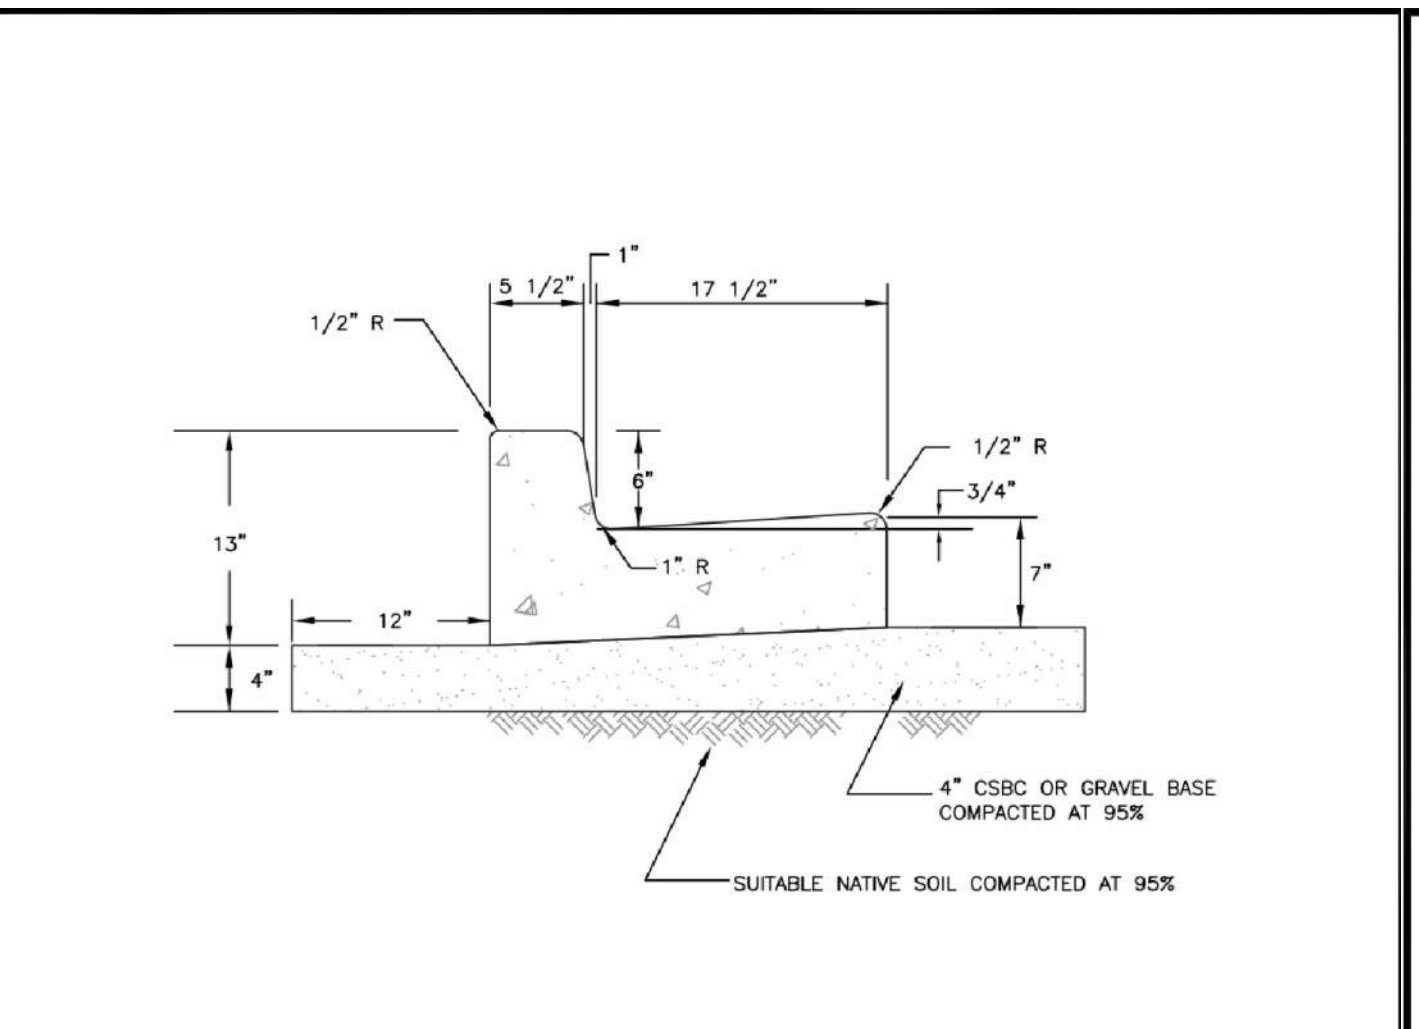

NOTES:
1. CONTRACTION JOINTS SHALL BE 3/8" x 2 1/4" ASPHALT SATURATED FELT PLACED IN ALL EXPOSED SURFACES OF CURB AND GUTTER AND SPACED AT 15' MAX. 10' MIN. O.C.
2. THRU JOINTS SHALL BE 3/8" ASPHALT SATURATED FELT PLACED AT POINTS OF TANGENCY ON CURVES, AT CATCH BASINS, AND AT EDGES OF ALLEY AND DRIVEWAYS. THE MAXIMUM DISTANCE BETWEEN THRU JOINTS SHALL BE 100'.

Table with 4 columns: CITY OF PUYALLUP, DEVELOPMENT ENGINEERING and PUBLIC WORKS DEPARTMENTS, CITY STANDARD 01.02.09, and CURB AND GUTTER.

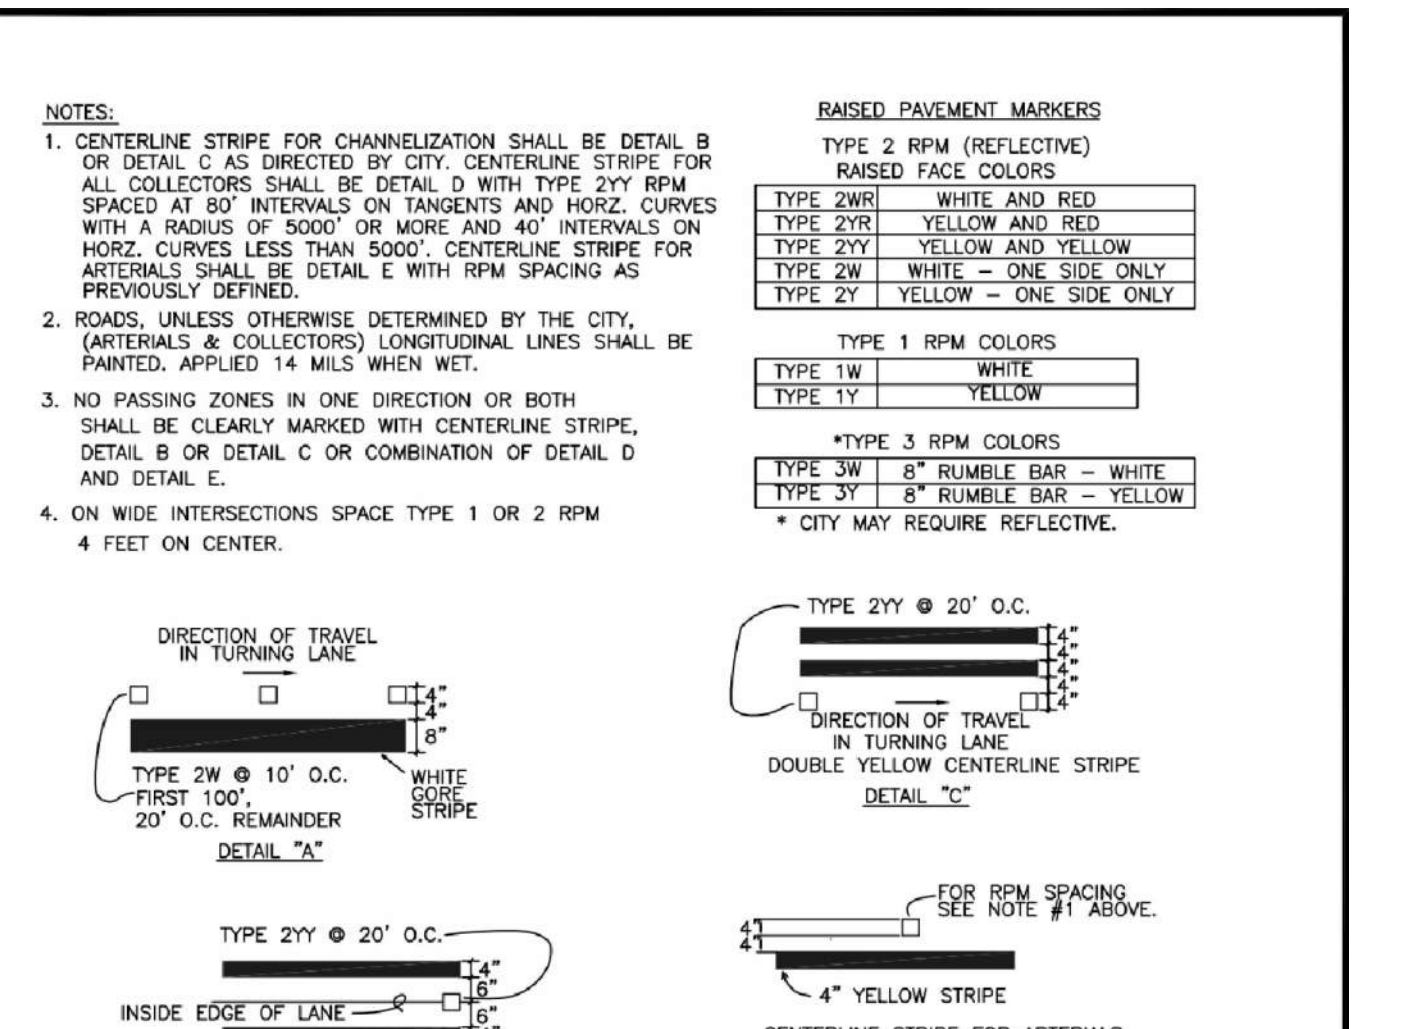

NOTES:
1. CENTERLINE STRIPE FOR CHANNELIZATION SHALL BE DETAIL B OR DETAIL C AS DIRECTED BY CITY. CENTERLINE STRIPE FOR ALL COLLECTORS SHALL BE DETAIL D WITH TYPE 2YV RPM SPACED AT 80' INTERVALS ON TANGENTS AND HORIZ. CURVES WITH A RADIUS OF 5000' OR MORE AND 40' INTERVALS ON HORIZ. CURVES LESS THAN 5000'.

Table with 4 columns: CITY OF PUYALLUP, DEVELOPMENT ENGINEERING and PUBLIC WORKS DEPARTMENTS, CITY STANDARD 01.03.10, and PAVEMENT MARKING DETAILS.


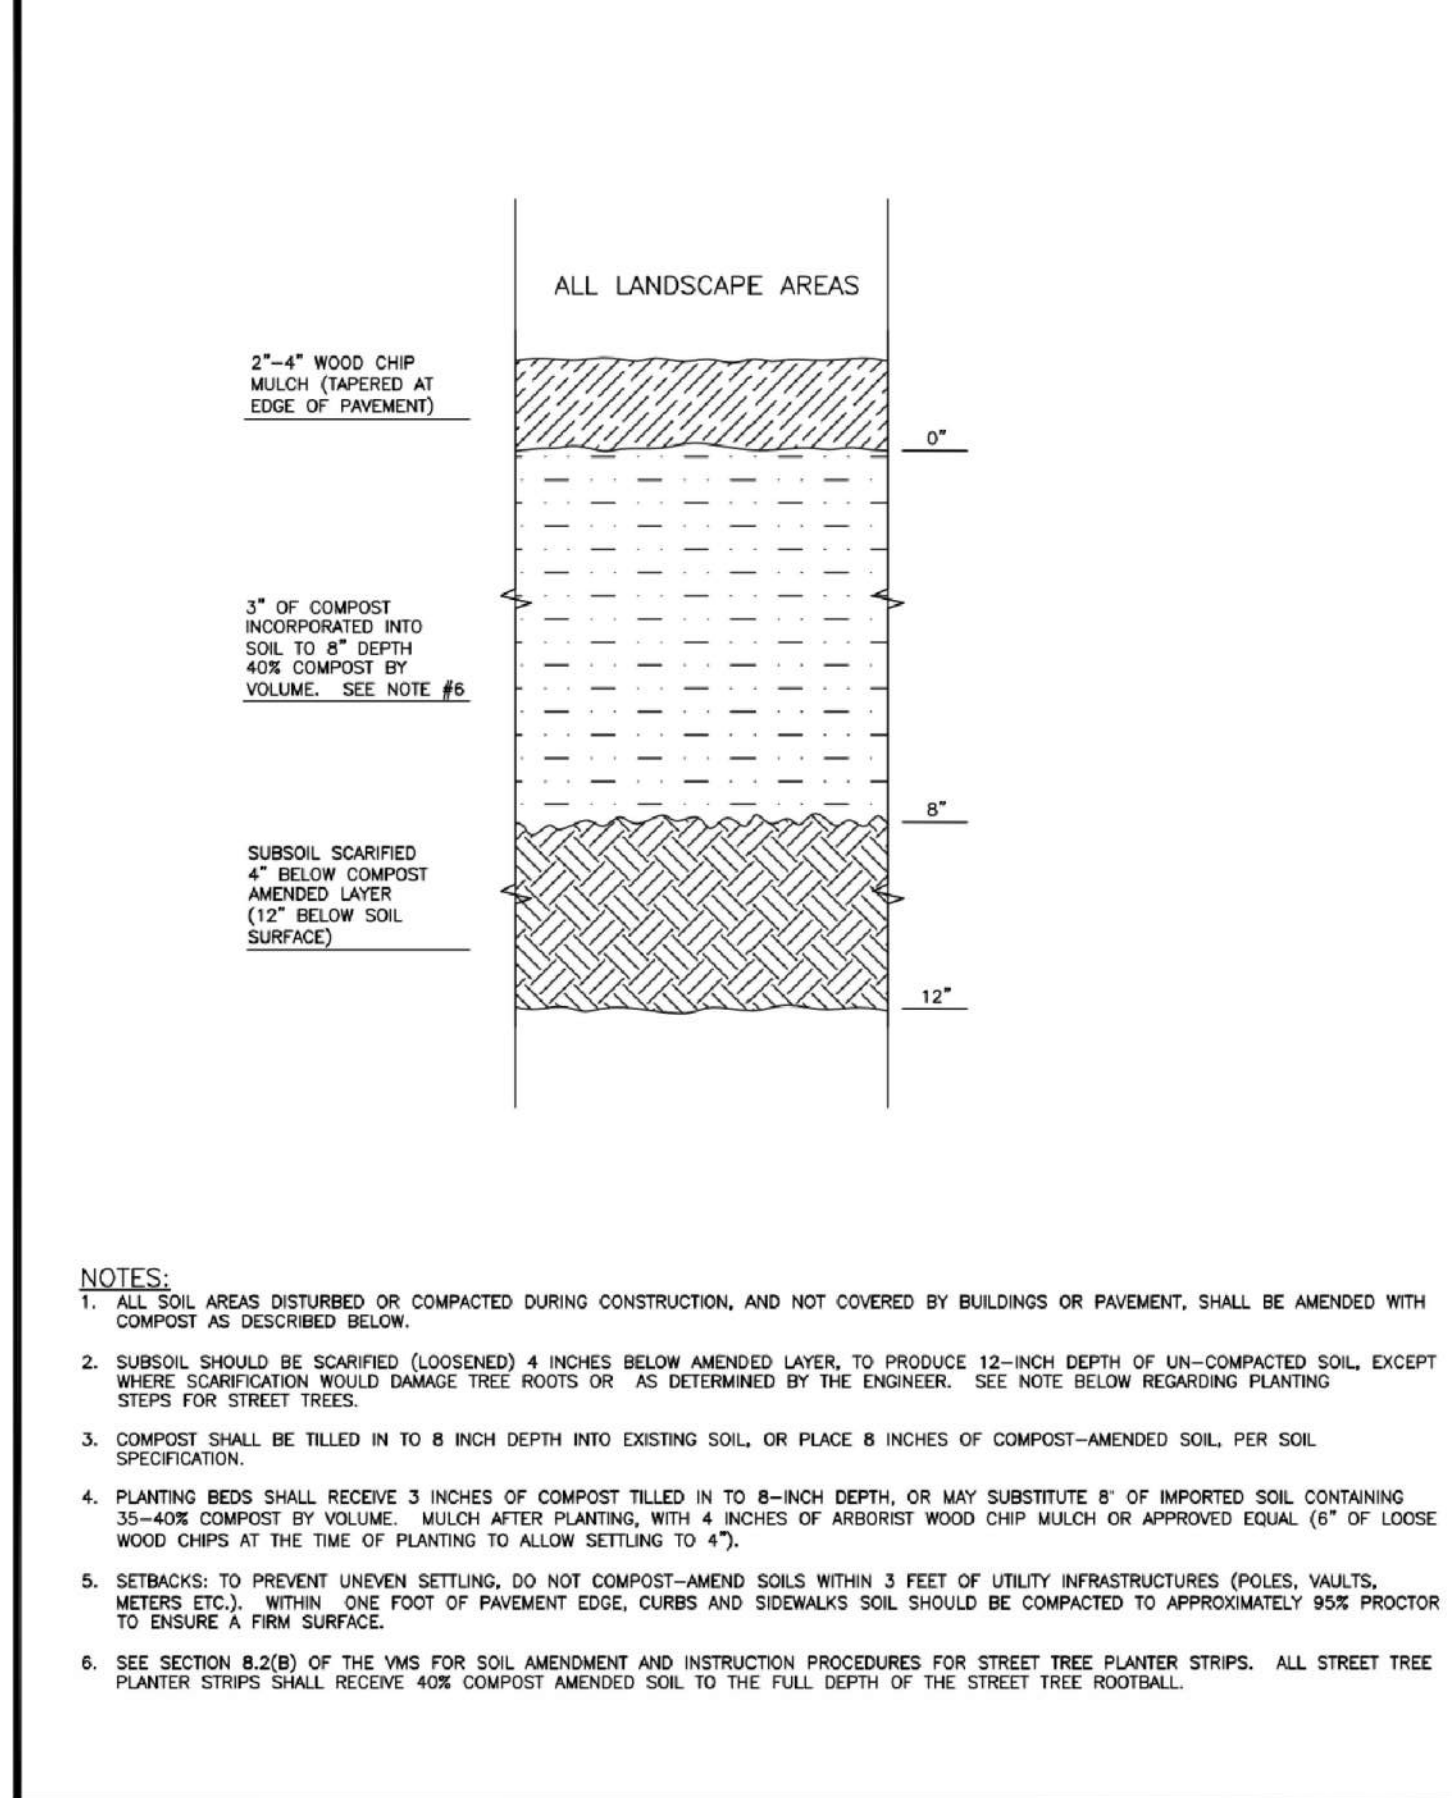



Table with 4 columns: CITY OF PUYALLUP, DEVELOPMENT ENGINEERING and PUBLIC WORKS DEPARTMENTS, CITY STANDARD 01.02.08a, and SOIL AMENDMENT AND DEPTH.

1. ALL LIMITS OF CLEARING AND AREAS OF VEGETATION PRESERVATION AS PRESCRIBED ON THE PLANS SHALL BE CLEARLY FLAGGED IN THE FIELD AND OBSERVED DURING CONSTRUCTION.
2. ALL REQUIRED SEDIMENTATION AND EROSION CONTROL FACILITIES MUST BE CONSTRUCTED AND IN OPERATION PRIOR TO ANY LAND CLEARING AND/OR OTHER CONSTRUCTION TO ENSURE THAT SEDIMENT LADEN WATER DOES NOT ENTER THE NATURAL DRAINAGE SYSTEM...

Table with 4 columns: CITY OF PUYALLUP, DEVELOPMENT ENGINEERING and PUBLIC WORKS DEPARTMENTS, CITY STANDARD 05.02.01, and GRADING, EROSION, AND SEDIMENTATION CONTROL NOTES.

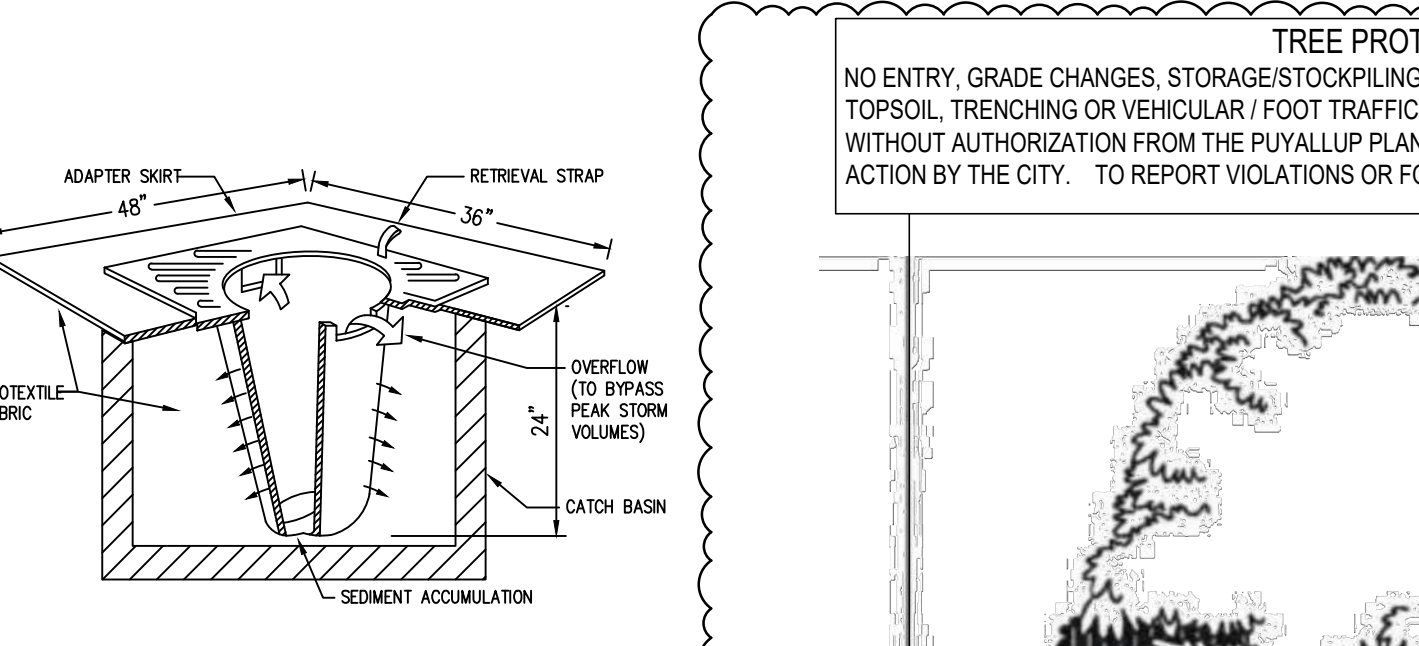

INLET PROTECTION NOTES:
1. FILTERS SHALL BE REMOVED AND CLEANED OR REPAIRED AFTER EACH STORM EVENT AND ON A WEEKLY BASIS.
CATCH BASIN FILTER SCALE: N.T.S.

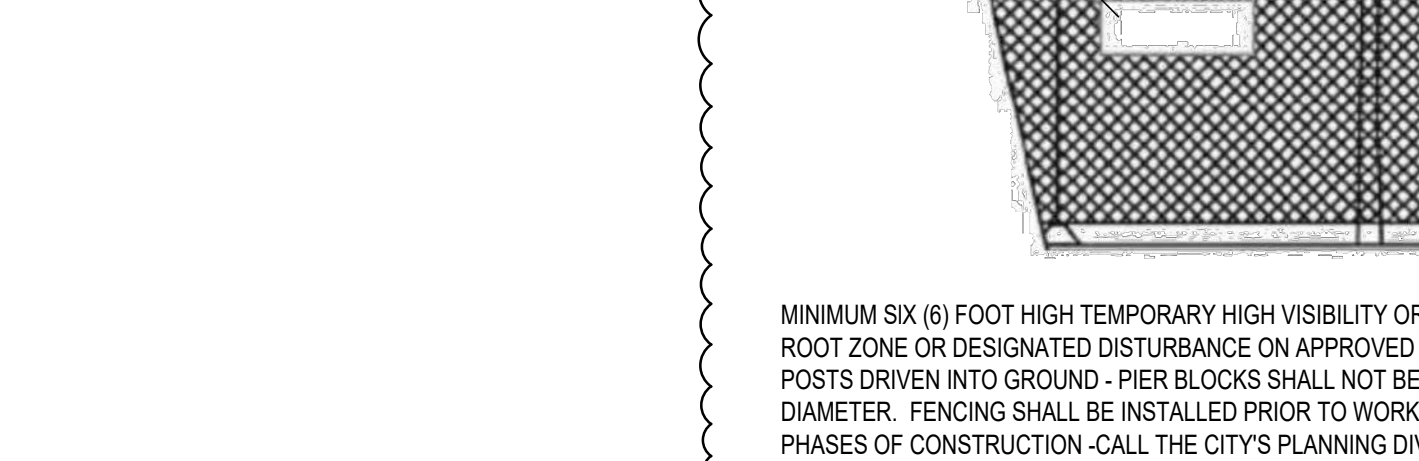

STRAW WATTLE SCALE: N.T.S.

Tree Protection Standards section containing text, diagrams of tree protection zones, and a permit approval form from the City of Puyallup.

Vertical sidebar containing project information, professional records, and permit details for Terraforma Design Group, Inc.

