
A PORTION OF THE NW 1/4 OF THE NW 1/4 OF SEC. 27, TWN. 20 N., RGE. 04 E. W.M. CITY OF PUYALLUP, PIERCE COUNTY, WASHINGTON.

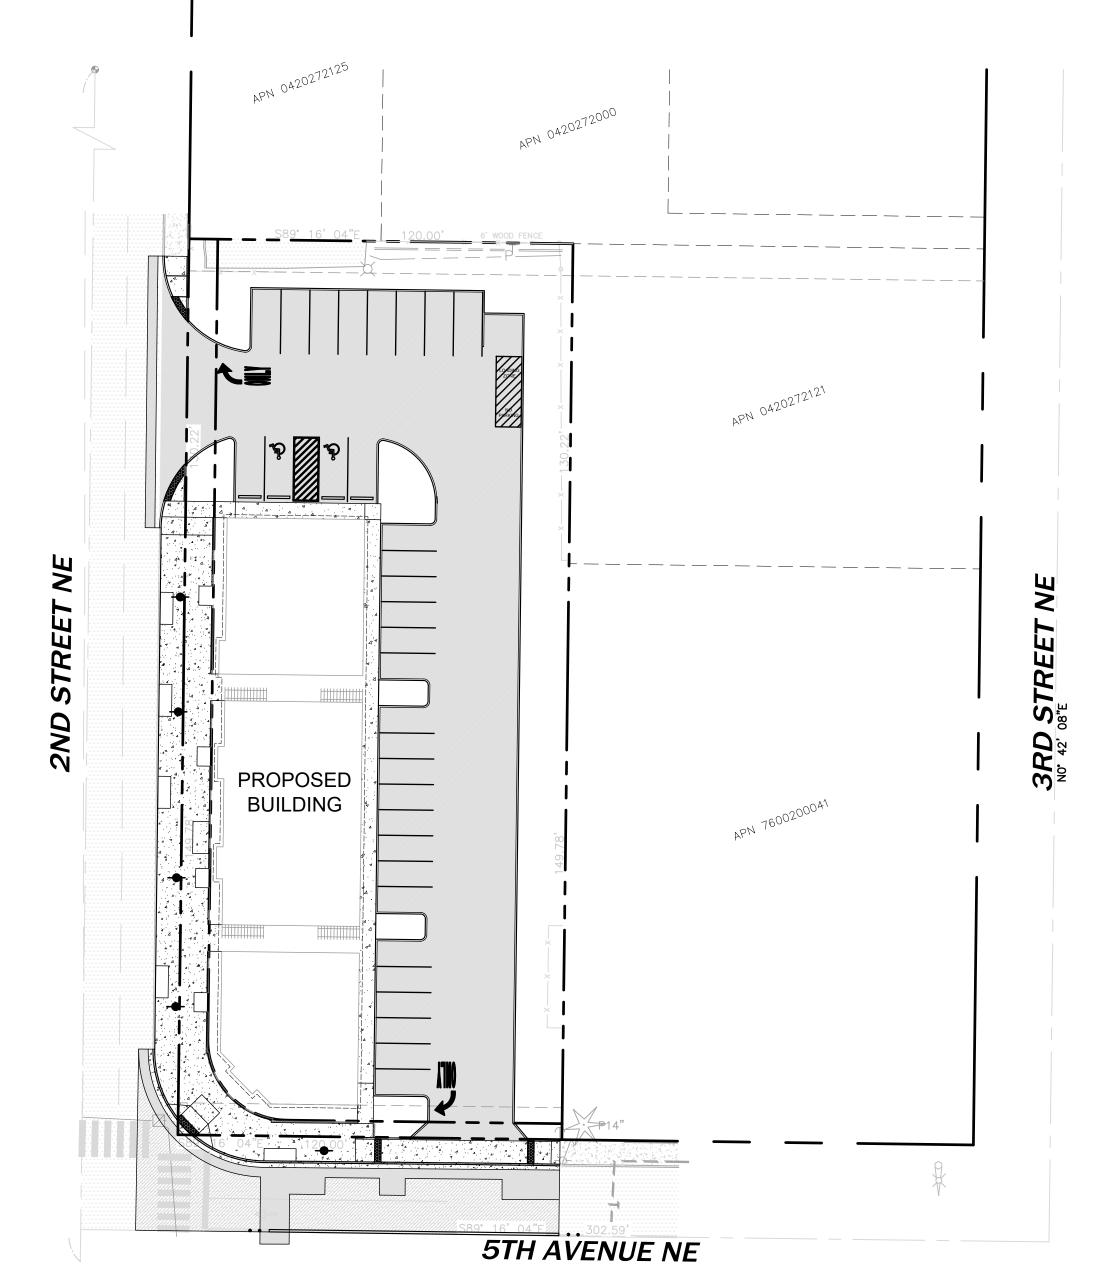

OWNER

DOCE LLC P.O.BOX 64160 TACOMA, WA 98464 CONTACT: DON HUBER

CIVIL ENGINEER

2215 NORTH 30TH STREET, SUITE 300 TACOMA, WA 98403 PH. (253) 383-2422 CONTACT: MATT WEBER, PE

SURVEYOR

2215 NORTH 30TH STREET. SUITE 300 TACOMA, WA 98403 PH. (253) 383-2422 CONTACT: DAVE FOLLANSBEE, PLS

ARCHITECT

JAMES GUERRERO ARCHITECTS 7520 BRIDGEPORT WAY W LAKEWOOD, WA 98499 PH. (253) 851-6000 CONTACT: JAMES GUERRERO, AIA

TOPOGRAPHIC NOTE

THE EXISTING CULTURAL AND TOPOGRAPHIC DATA SHOWN ON THESE DRAWINGS HAS BEEN PREPARED. IN PART, BASED UPON INFORMATION FURNISHED BY OTHERS. WHILE THIS INFORMATION IS BELIEVED TO BE RELIABLE, AHBL CANNOT ENSURE ACCURACY AND THUS IS NOT RESPONSIBLE FOR THE ACCURACY OF THAT INFORMATION OR FOR ANY ERRORS OR OMISSIONS WHICH MAY HAVE BEEN INCORPORATED INTO THESE DRAWINGS AS

FILL SPECIFICATION

FILL MATERIAL SHALL NOT CONTAIN PETROLEUM PRODUCTS. OR SUBSTANCES WHICH ARE HAZARDOUS, DANGEROUS, TOXIC, OR WHICH OTHERWISE VIOLATE ANY STATE, FEDERAL, OR LOCAL LAW, ORDINANCE, CODE, REGULATION, RULE, ORDER, OR STANDARD.

TRENCH NOTE

IF WORKERS ENTER ANY TRENCH OR OTHER EXCAVATION FOUR OR MORE FEET IN DEPTH THAT DOES NOT MEET THE OPEN PIT REQUIREMENTS OF WSDOT SECTION 2-09.3(3)B, IT SHALL BE SHORED AND CRIBBED. THE CONTRACTOR ALONE SHALL BE RESPONSIBLE FOR WORKER SAFETY AND AHBL ASSUMES NO RESPONSIBILITY. ALL TRENCH SAFETY SYSTEMS SHALL MEET THE REQUIREMENTS OF THE WASHINGTON INDUSTRIAL SAFETY AND HEALTH ACT. CHAPTER 49.17 RCW.

UTILITY NOTE

THE LOCATIONS OF EXISTING UNDERGROUND UTILITIES ARE APPROXIMATE ONLY AND HAVE NOT BEEN INDEPENDENTLY VERIFIED BY THE OWNER OR ITS REPRESENTATIVE. THE CONTRACTOR SHALL DETERMINE THE EXACT LOCATION OF ALL EXISTING UTILITIES BEFORE COMMENCING WORK AND AGREES TO BE FULLY RESPONSIBLE FOR ANY AND ALL DAMAGES THAT HAPPEN DUE TO THE CONTRACTOR'S FAILURE TO LOCATE EXACTLY AND PRESERVE ANY AND ALL UNDERGROUND UTILITIES. AHBL ASSUMES NO LIABILITY FOR THE LOCATION OF UNDERGROUND UTILITIES.

UTILITIES

WATER - CITY OF PUYALLUP SANITARY SEWER - CITY OF PUYALLUP ELECTRICITY - PUGET SOUND ENERGY NATURAL GAS - PUGET SOUND ENERGY TELEPHONE - CENTURY LINK

SITE

ZONING-

SITE ADDRESS - XXX 2ND STREET NE PUYALLUP WA 98371

CBD

PARCEL -7600200051 SITE AREA -33,600 SF (0.77 ACRES)

WASHINGTON STATE PLANE SOUTH PROJECTION, BASED ON GPS OBSERVATIONS USING WSRN AND GEOID 2012A. UNITS OF MEASUREMENT ARE US SURVEY FEET.

REFER TO APPROVED AMR E21-570 AND APPROVED AMR E21-0571 FOR APPROVED MODIFICATIONS TO PUYALLUP ROAD STANDARDS.

NAVD 1988 VERTICAL DATUM ON ORTHOMETRICALLY CORRECTED GPS OBSERVATION USING WSRN AND GEOID 2012A.

VERTICAL DATUM

LEGEND

FOUND MONUMENT AS NOTED

FOUND PROPERTY CORNER

SANITARY SEWER MANHOLE

TRAFFIC SIGNAL POLE W/ LIGHT

HUB AND TACK

SIGN AS NOTED

BOLLARD

SET NAIL AND WASHER

STORM CATCH BASIN

UTILITY POWER POLE

STORM MANHOLE

GUY ANCHOR

JUNCTION BOX

FIRE HYDRANT WATER METER WATER VALVE

U=UNKNOWN STORM LINE

SEWER LINE

 $--\top$ — COMMUNICATION LINE

ASPHALT

CONCRETE

GRAVEL

OHP — OVERHEAD UTILITIES

P=PINE

BASIS OF BEARING

NAD 1983

AMR NOTE

GENERAL NOTES

(now what's below.

Call before you dig.

1. ALL WORK IN CITY RIGHT-OF-WAY REQUIRES A PERMIT FROM THE CITY OF PUYALLUP. PRIOR TO ANY WORK COMMENCING, THE GENERAL CONTRACTOR SHALL ARRANGE FOR A PRECONSTRUCTION MEETING AT THE DEVELOPMENT CENTER TO BE ATTENDED BY ALL MAJOR CONTRACTORS, REPRESENTATIVES OF INVOLVED UTILITIES, AND THE CITY OF PUYALLUP. CONTACT ENGINEERING SERVICES AT (253-841-5568) TO SCHEDULE THE MEETING. THE CONTRACTOR IS RESPONSIBLE TO HAVE THEIR OWN SET OF PLANS AT THE MEETING.

2. AFTER COMPLETION OF ALL ITEMS SHOWN ON THESE PLANS AND BEFORE ACCEPTANCE OF THE PROJECT THE CONTRACTOR SHALL OBTAIN A "PUNCH LIST" PREPARED BY THE CITY'S INSPECTOR DETAILING REMAINING ITEMS OF WORK TO BE COMPLETED:- ALL ITEMS OF WORK SHOWN ON THESE PLANS SHALL BE COMPLETED TO THE SATISFACTION OF THE CITY PRIOR TO ACCEPTANCE OF THE WATER SYSTEM AND PROVISION OF SANITARY SEWER SERVICE.

3. ALL MATERIALS AND WORKMANSHIP SHALL CONFORM TO THE STANDARD SPECIFICATIONS FOR ROAD, BRIDGE, AND MUNICIPAL CONSTRUCTION (HEREINAFTER REFERRED TO AS THE "STANDARD SPECIFICATIONS"), WASHINGTON STATE DEPARTMENT OF TRANSPORTATION AND AMERICAN PUBLIC WORKS ASSOCIATION WASHINGTON STATE CHAPTER, LATEST EDITION, UNLESS SUPERSEDED OR AMENDED BY THE CITY OF PUYALLUP CITY STANDARDS FOR PUBLIC WORKS ENGINEERING AND CONSTRUCTION (HEREINAFTER REFERRED TO AS THE "CITY STANDARDS").

4. A COPY OF THESE APPROVED PLANS AND APPLICABLE CITY DEVELOPER SPECIFICATIONS AND DETAILS SHALL BE ON SITE DURING CONSTRUCTION.

5. ANY REVISIONS MADE TO THESE PLANS MUST BE REVIEWED AND APPROVED BY THE DEVELOPER'S ENGINEER AND THE CITY PRIOR TO ANY IMPLEMENTATION IN THE FIELD. THE CITY SHALL NOT BE RESPONSIBLE FOR ANY ERRORS AND/OR OMISSIONS ON THESE PLANS.

6. THE CONTRACTOR SHALL HAVE ALL UTILITIES VERIFIED ON THE GROUND PRIOR TO ANY CONSTRUCTION. CALL (811) AT LEAST 48 HOURS IN ADVANCE. THE OWNER AND HIS/HER ENGINEER SHALL BE CONTACTED IMMEDIATELY IF A CONFLICT EXISTS.

7. ANY STRUCTURE AND/OR OBSTRUCTION WHICH REQUIRE REMOVAL OR RELOCATION RELATING TO THIS PROJECT SHALL BE DONE SO AT THE DEVELOPER'S EXPENSE.

8. LOCATIONS OF EXISTING UTILITIES ARE APPROXIMATE. IT SHALL BE THE CONTRACTOR'S RESPONSIBILITY TO DETERMINE THE TRUE ELEVATIONS AND LOCATIONS OF HIDDEN UTILITIES. ALL VISIBLE ITEMS SHALL BE THE ENGINEER'S RESPONSIBILITY.

9. THE CONTRACTOR SHALL INSTALL, REPLACE, OR RELOCATE ALL SIGNS, AS SHOWN ON THE PLANS OR AS AFFECTED BY CONSTRUCTION, PER CITY STANDARDS. 10.POWER, STREET LIGHT, CABLE, AND TELEPHONE LINES SHALL BE IN A TRENCH LOCATED WITHIN A

10-FOOT UTILITY EASEMENT ADJACENT TO PUBLIC RIGHT-OF-WAY. RIGHT-OF-WAY CROSSINGS SHALL HAVE A MINIMUM HORIZONTAL SEPARATION FROM OTHER UTILITIES (SEWER, WATER, STORM) OF 5 FEET. 11. ALL CONSTRUCTION SURVEYING FOR EXTENSIONS OF PUBLIC FACILITIES SHALL BE DONE UNDER THE DIRECTION OF A WASHINGTON STATE LICENSED LAND SURVEYOR OR A WASHINGTON STATE LICENSED

PROFESSIONAL CIVIL ENGINEER. 12. DURING CONSTRUCTION, ALL PUBLIC STREETS ADJACENT TO THIS PROJECT SHALL BE KEPT CLEAN OF ALL MATERIAL DEPOSITS RESULTING FROM ON-SITE CONSTRUCTION, AND EXISTING STRUCTURES SHALL BE PROTECTED AS DIRECTED BY THE CITY.

13. CERTIFIED RECORD DRAWINGS ARE REQUIRED PRIOR TO PROJECT ACCEPTANCE.

14. A NPDES STORMWATER GENERAL PERMIT MAY BE REQUIRED BY THE DEPARTMENT OF ECOLOGY FOR THIS PROJECT. FOR INFORMATION CONTACT THE DEPARTMENT OF ECOLOGY AT (360)407-6300.

15. ANY DISTURBANCE OR DAMAGE TO CRITICAL AREAS AND ASSOCIATED BUFFERS, OR SIGNIFICANT TREES DESIGNATED FOR PRESERVATION AND PROTECTION SHALL BE MITIGATED IN ACCORDANCE WITH A MITIGATION PLAN REVIEWED AND APPROVED BY THE CITY'S PLANNING DIVISION. PREPARATION AND IMPLEMENTATION OF THE MITIGATION PLAN SHALL BE AT THE DEVELOPER'S EXPENSE.

LEGAL DESCRIPTION

(PER OLD REPUBLIC TITLE, LTD., ORDER NUMBER 5217024093-CB. EFFECTIVE DATE MAY 23, 2018, AT 8:00 A.M.):

PARCEL A:

THAT PORTION OF THE NORTHWEST QUARTER OF THE NORTHWEST QUARTER OF SECTION 27, TOWNSHIP 20 NORTH, RANGE 4 EAST, W.M., DESCRIBED AS FOLLOWS:

BEGINNING ON THE EAST BOUNDARY OF 2ND STREET N.E. IN THE CITY OF PUYALLUP, 149.78 FEET NORTH OF THE SOUTHWEST CORNER OF BLOCK 4, SHUMAN'S ADDITION TO PUYALLUP, PIERCE COUNTY, WASHINGTON, ACCORDING TO THE PLAT THEREOF, RECORDED IN VOLUME 5 OF PLATS, PAGE 99, RECORDS OF PIERCE COUNTY, WASHINGTON;

THENCE CONTINUE NORTH ON SAID BOUNDARY, 130.22 FEET; THENCE EAST PARALLEL WITH THE SOUTH LINE OF SAID BLOCK 4,

THENCE SOUTH PARALLEL WITH SAID EAST BOUNDARY OF 2ND STREET N.E., 130.22 FEET TO THE NORTH LINE OF SAID BLOCK 4; THENCE WEST 120 FEET TO THE POINT OF BEGINNING.

PARCEL B:


LOTS 1, 2 AND 3, BLOCK 4, SHUMAN'S SECOND ADDITION TO PUYALLUP, PIERCE COUNTY, WASHINGTON, ACCORDING TO THE PLAT THEREOF, RECORDED IN VOLUME 5 OF PLATS, PAGE 99. RECORDS OF PIERCE COUNTY, WASHINGTON.

BOTH SITUATE IN THE COUNTY OF PIERCE, STATE OF WASHINGTON.

COVER SHEET EXISTING CONDITIONS MAP TESC AND DEMOLITION PLAN TESC NOTES AND DETAILS TESC NOTES AND DETAILS HORIZONTAL CONTROL AND SURFACING PLAN SURFACING NOTES AND DETAILS SURFACING NOTES AND DETAILS C2.3 CHANNELIZATION PLAN CHANNELIZATION NOTES AND DETAILS C2.5 CHANNELIZATION NOTES AND DETAILS C3.0 GRADING AND DRAINAGE PLAN C3.1 DRAINAGE NOTES AND DETAILS C3.2 DRAINAGE NOTES AND DETAILS C3.3 DRAINAGE NOTES AND DETAILS C3.4 DRAINAGE NOTES AND DETAILS C3.5 DRAINAGE NOTES AND DETAILS C4.0 UTILITY PLAN WATER AND SEWER NOTES AND DETAILS C4.1 C4.2 WATER AND SEWER NOTES AND DETAILS C4.3 WATER AND SEWER NOTES AND DETAILS C4.4 WATER AND SEWER NOTES AND DETAILS WATER AND SEWER NOTES AND DETAILS C4.5 C4.6 WATER AND SEWER NOTES AND DETAILS WATER AND SEWER NOTES AND DETAILS

SHEET INDEX

Sheet Number | Sheet Title

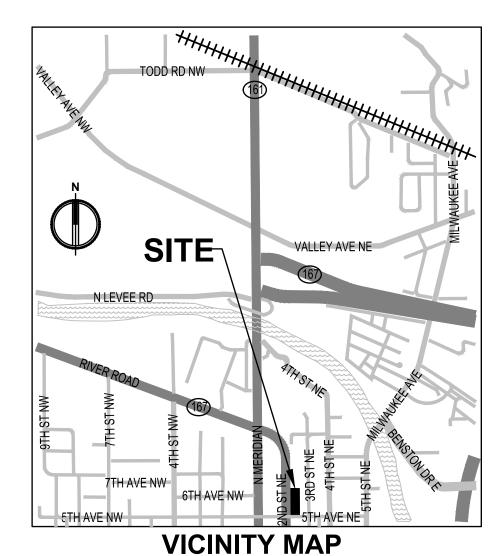

2215 North 30th Street, Suite 300, Tacoma, WA 98403 253.383.2422 TEL 253.383.2572 FAX www.ahbl.com WEB

APPROVED

molabet

CITY OF PUYALLUP DEVELOPMENT ENGINEERING

NOTE: THIS APPROVAL IS VOID AFTER 180 DAYS FROM APPROVA

THE CITY WILL NOT BE

DETERMINED BY THE

MANAGER.

RESPONSIBLE FOR ERRORS

AND/OR OMISSIONS ON THESE

CHANGES TO THESE PLANS AS

DEVELOPMENT ENGINEERING

PUYALLUP 2ND STREET **APARTMENTS**

Project Title:

SPP MANUFACTURING

P.O.BOX 64160 **TACOMA, WA 98464** DON HUBER


Project No.

2190606.10

Issue Set & Date:

SITE DEVELOPMENT **PERMIT SET**



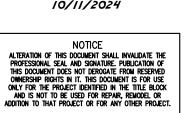

City of Puyallup **Development & Permitting Services ISSUED PERMIT** Building Planning **Public Works** Engineering

	Fire	OF W	SHITTE
<u> </u>			


Revisions:


Sheet Title:

COVER SHEET

<u>Designed by:</u> <u>Drawn by:</u> <u>Checked by:</u>

Sheet No.

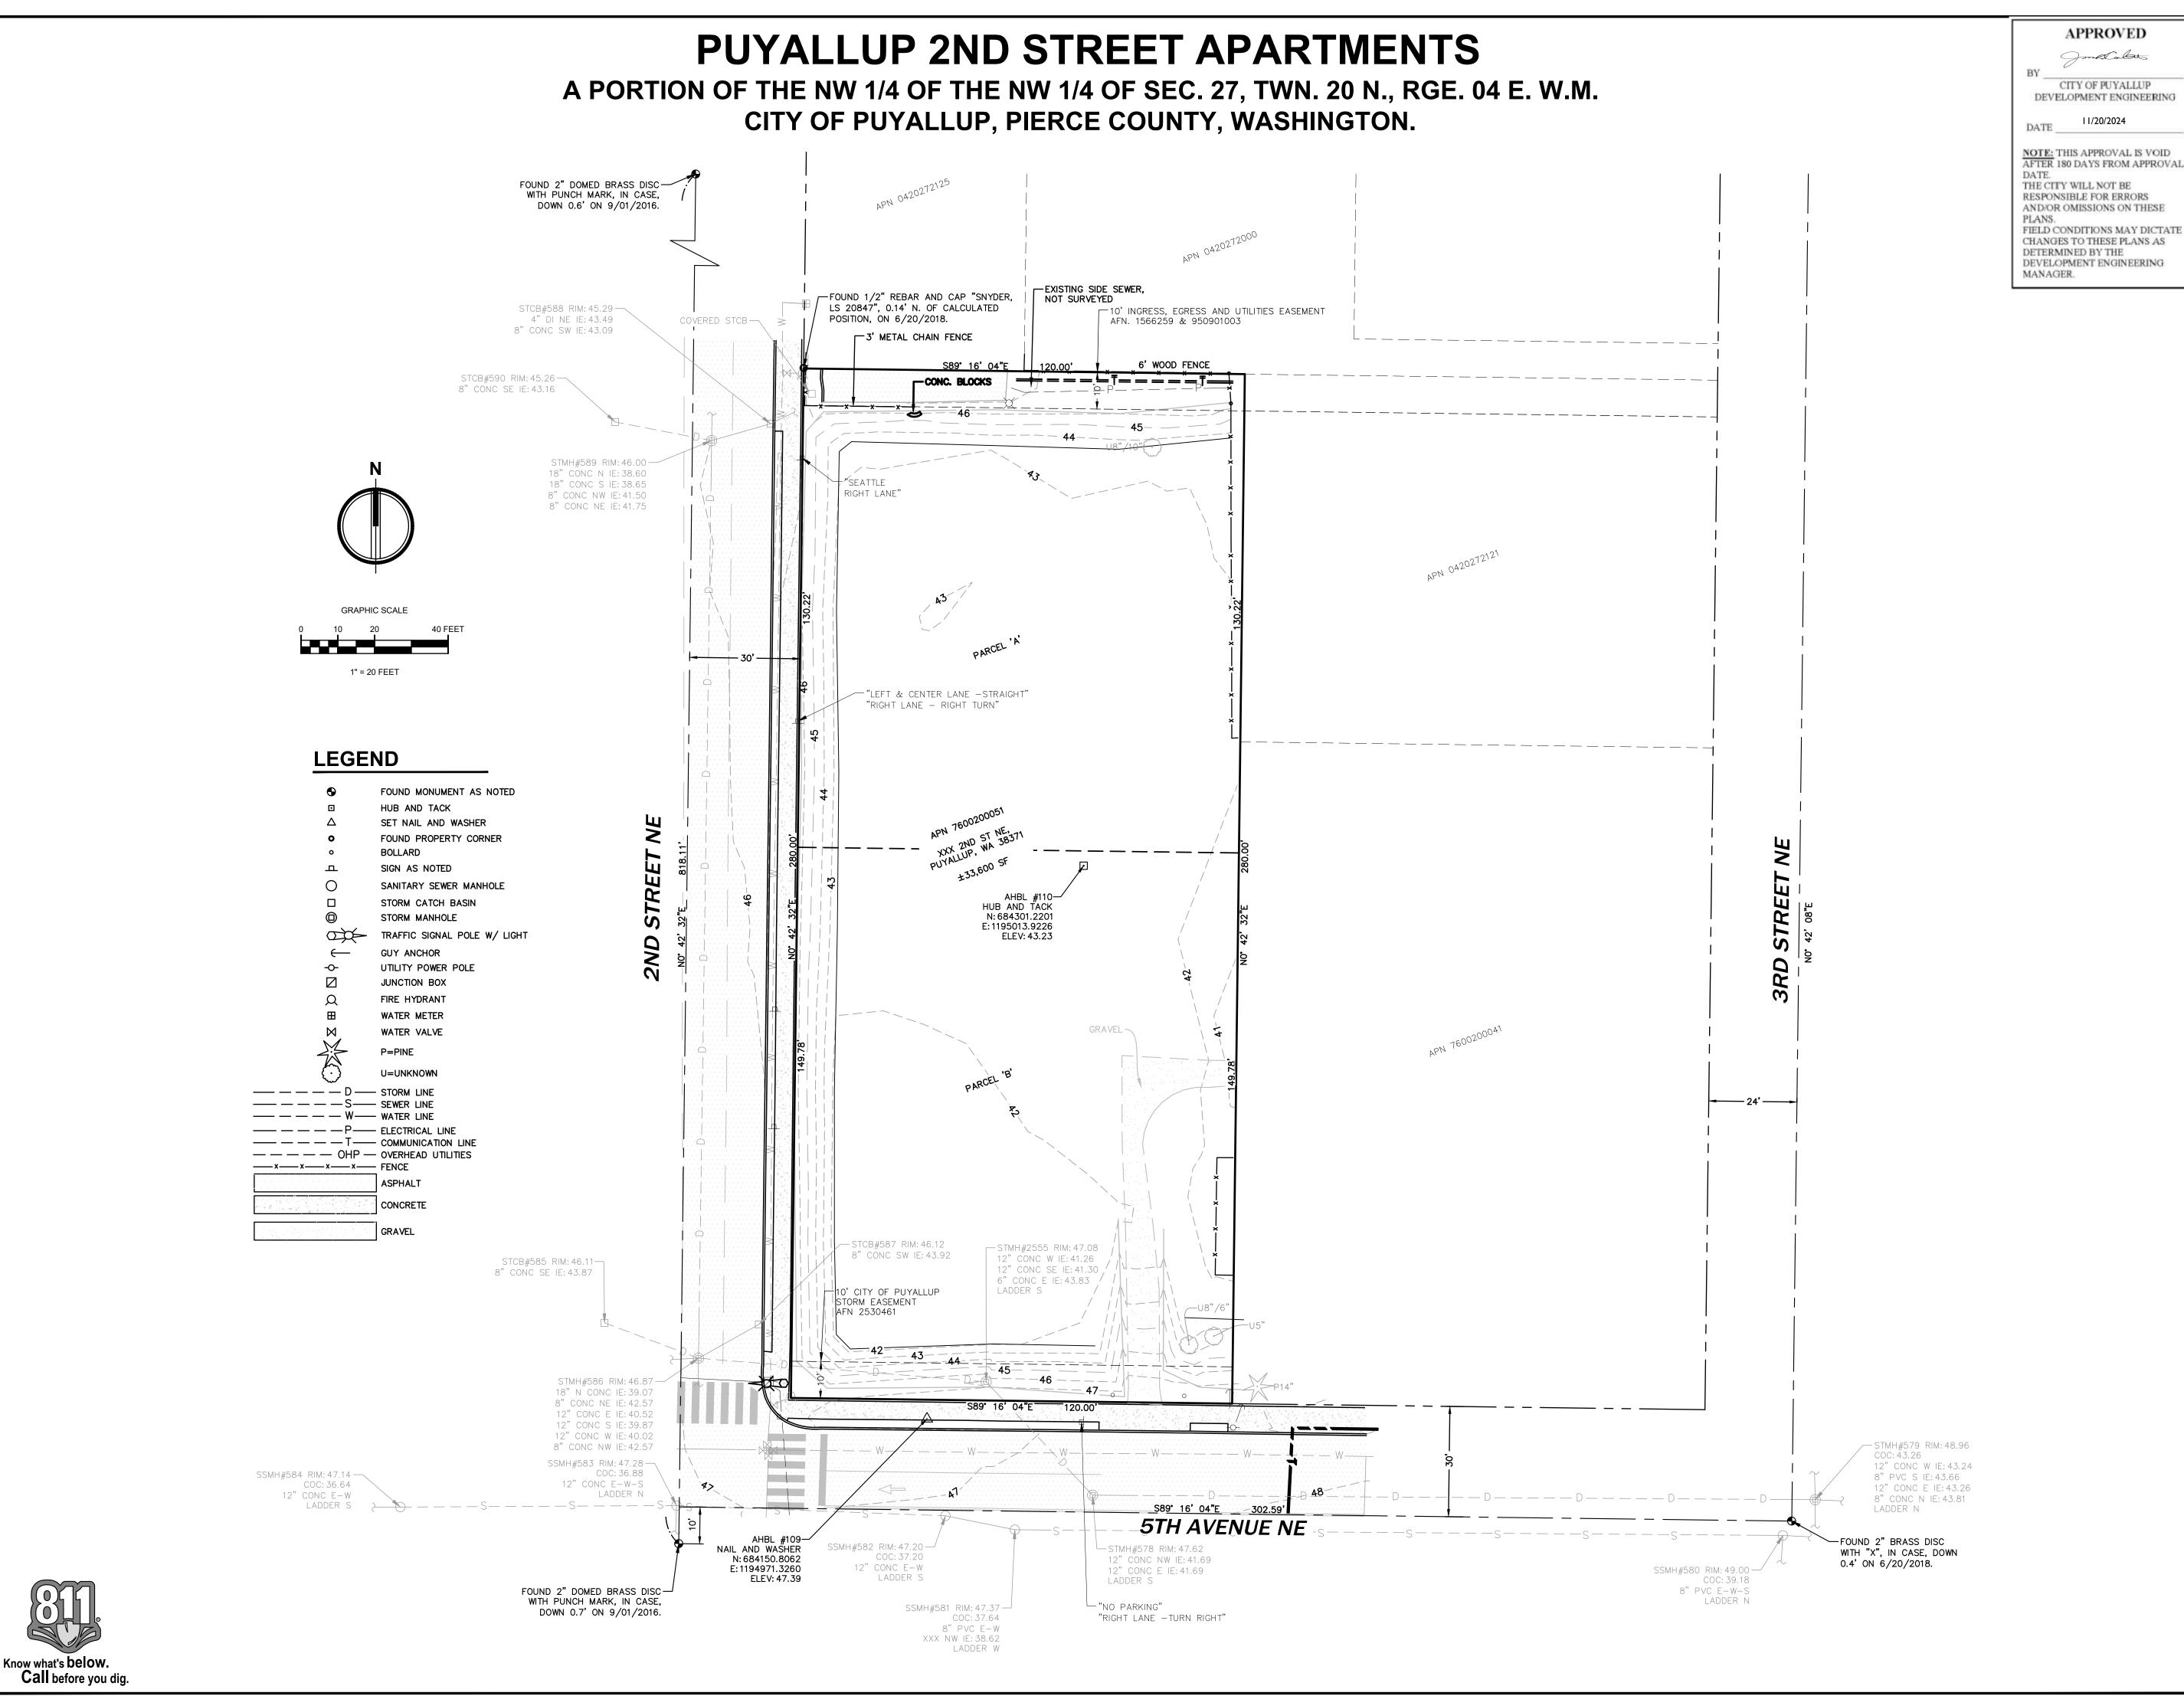

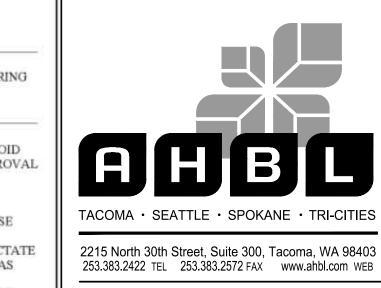

Project Title:

SPP MANUFACTURING

P.O.BOX 64160 TACOMA, WA 98464 DON HUBER

<u>Project No.</u>


2190606.10

Issue Set & Date:

SITE DEVELOPMENT **PERMIT SET**

10/8/2024



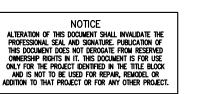

City of Puyallup velopment & Permitting Services ISSUED PERMIT					
Building	Planning				
Engineering	Public Works				
Fire F V SHI Traffic					

<u>Revisions:</u>

Sheet Title:

EXISTING CONDITIONS MAP

Designed by: Drawn by: Checked by:

Sheet No.

A PORTION OF THE NW 1/4 OF THE NW 1/4 OF SEC. 27, TWN. 20 N., RGE. 04 E. W.M. CITY OF PUYALLUP, PIERCE COUNTY, WASHINGTON.

PROVIDE TEMPORARY SEDIMENT TRAP

MIN. SURFACE AREA 404 SF

- RIPRAP 6"-8" QUARRY SPALLS

EXISTING FENCE TO REMAIN

PRIOR TO GRADING OPERATIONS.

EXISTING FENCE TO REMAIN

REMOVE CURB AND SIDEWALK

TO NEAREST JOINT (TYP)

PROTECT FUTURE INFILTRATION AREAS FROM

EQUIPMENT/VEHICLE COMPACTION AND SEDIMENT


LADEN RUNOFF. LIMITS OF FUTURE FACILITY SHALL

BE CLEARLY MARKED FOR PROTECTION. CONFIRM PROTECTED AREA WITH ENGINEER-OF-RECORD

TOP BERM: 45.5

BOTTOM ELEV: 42.5

BOTTOM DIM. : 15' x 5'

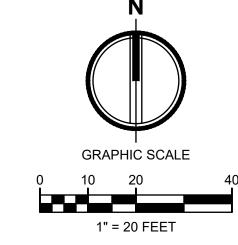

LEGEND

(CE) CONSTRUCTION ENTRANCE

SILTATION FENCE

SAWCUT LINE

(CL) CLEARING/PROJECT LIMIT

INTERCEPTOR DITCH

DEMOLISH/ABANDON

INLET SEDIMENT PROTECTION

EXISTING UTILITY

ROCK CHECK DAM

TREE TO REMAIN

TREE TO BE REMOVED

EXISTING MAJOR CONTOUR

EXISTING MINOR CONTOUR

PROPOSED MAJOR CONTOUR

PROPOSED MINOR CONTOUR

EXISTING STORM MANHOLE

EXISTING CATCH BASIN

PROPOSED CATCH BASIN

RESPONSIBILITY OF THE PERMITTEE.

COURSES, AND/OR STORM DRAINAGE SYSTEMS.

8. ALL REQUIRED SEDIMENTATION AND EROSION CONTROL FACILITIES MUST BE

OTHER CONSTRUCTION TO ENSURE THAT SEDIMENT LADEN WATER DOES NOT

AN INSPECTION OF THE EROSION CONTROL FACILITIES PRIOR TO ANY LAND

CLEARING AND/OR OTHER CONSTRUCTION. ALL EROSION AND SEDIMENT

TO THE EROSION AND SEDIMENTATION CONTROL SYSTEMS SHALL BE THE

ANTICIPATED SITE CONDITIONS. AS CONSTRUCTION PROGRESSES AND

UNEXPECTED OR SEASONAL CONDITIONS DICTATE, FACILITIES WILL BE

THE COURSE OF CONSTRUCTION, IT SHALL BE THE OBLIGATION AND

FACILITIES SHALL BE MAINTAINED IN A SATISFACTORY CONDITION AS

DETERMINED BY THE CITY, UNTIL SUCH TIME THAT CLEARING AND/OR

ENTER THE NATURAL DRAINAGE SYSTEM. THE CONTRACTOR SHALL SCHEDULE

CONSTRUCTION IS COMPLETED AND THE POTENTIAL FOR ON-SITE EROSION HAS

PASSED. THE IMPLEMENTATION, MAINTENANCE, REPLACEMENT, AND ADDITIONS

9. THE EROSION AND SEDIMENTATION CONTROL SYSTEM FACILITIES DEPICTED ON THESE PLANS ARE INTENDED TO BE MINIMUM REQUIREMENTS TO MEET

NECESSARY TO ENSURE COMPLETE SILTATION CONTROL ON THE SITE. DURING

RESPONSIBILITY OF THE PERMITTEE TO ADDRESS ANY NEW CONDITIONS THAT

MAY BE CREATED BY HIS ACTIVITIES AND TO PROVIDE ADDITIONAL FACILITIES,

OVER AND ABOVE THE MINIMUM REQUIREMENTS, AS MAY BE NEEDED TO

10. APPROVAL OF THESE PLANS IS FOR GRADING, TEMPORARY DRAINAGE,

PIPES, RESTRICTORS, CHANNELS, OR RETENTION FACILITIES.

EROSION AND SEDIMENTATION CONTROL ONLY. IT DOES NOT CONSTITUTE AN

APPROVAL OF PERMANENT STORM DRAINAGE DESIGN, SIZE OR LOCATION OF

11. ANY DISTURBED AREA WHICH HAS BEEN STRIPPED OF VEGETATION AND

WHERE NO FURTHER WORK IS ANTICIPATED FOR A PERIOD OF 30 DAYS OR

OR OTHER APPROVED EROSION CONTROL TREATMENT APPLICABLE TO THE

TIME OF YEAR IN QUESTION. GRASS SEEDING ALONE WILL BE ACCEPTABLE

ONLY DURING THE MONTHS OF APRIL THROUGH SEPTEMBER INCLUSIVE.

IN THE INTEREST OF THE PERMITTEE BUT MUST BE AUGMENTED WITH

MULCHING, NETTING, OR OTHER TREATMENT APPROVED BY THE CITY.

MORE, MUST BE IMMEDIATELY STABILIZED WITH MULCHING, GRASS PLANTING,

SEEDING MAY PROCEED OUTSIDE THE SPECIFIED TIME PERIOD WHENEVER IT IS

12. IN CASE EROSION OR SEDIMENTATION OCCURS TO ADJACENT PROPERTIES,

AGGRAVATE THE SITUATION MUST CEASE, AND THE OWNER/CONTRACTOR WILL

ALL CONSTRUCTION WORK WITHIN THE DEVELOPMENT THAT WILL FURTHER

IMMEDIATELY COMMENCE RESTORATION METHODS. RESTORATION ACTIVITY

EQUIPMENT SHALL OCCUR WITHIN CRITICAL AREAS OR ASSOCIATED BUFFERS, OR THE CRITICAL ROOT ZONE FOR VEGETATION PROPOSED FOR RETENTION.

14. AT ANY TIME DURING CONSTRUCTION IT IS DETERMINED BY THE CITY THAT

INSUFFICIENT CLEANUP, ALL WORK SHALL CEASE ON THE PROJECT UNTIL THIS

WILL CONTINUE UNTIL SUCH TIME AS THE AFFECTED PROPERTY OWNER IS

13. NO TEMPORARY OR PERMANENT STOCKPILING OF MATERIALS OR

MUD AND DEBRIS ARE BEING TRACKED ONTO PUBLIC STREETS WITH

PROTECT ADJACENT PROPERTIES, SENSITIVE AREAS, NATURAL WATER

CONSTRUCTED AND IN OPERATION PRIOR TO ANY LAND CLEARING AND/OR

ASPHALT TO BE REMOVED

CONCRETE TO BE REMOVED

CITY OF PUYALLUP DEVELOPMENT ENGINEERING DATE NOTE: THIS APPROVAL IS VOID AFTER 180 DAYS FROM APPROVA THE CITY WILL NOT BE RESPONSIBLE FOR ERRORS AND/OR OMISSIONS ON THESE FIELD CONDITIONS MAY DICTATE

APPROVED

mo Calous

CHANGES TO THESE PLANS AS

DETERMINED BY THE

MANAGER.

___ __XXX___ __

2215 North 30th Street, Suite 300, Tacoma, WA 98403

DEVELOPMENT ENGINEERING Project Title:

> PUYALLUP 2ND STREET **APARTMENTS**

253.383.2422 TEL 253.383.2572 FAX www.ahbl.com WEB

SPP MANUFACTURING

P.O.BOX 64160 **TACOMA, WA 98464**

DON HUBER

Project No.

2190606.10


Issue Set & Date:

SITE DEVELOPMENT

PERMIT SET

10/8/2024



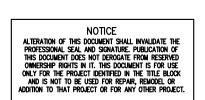

ISSUED Building	PERMIT Planning			
Engineering	Public Works			
Fire				

<u>Revisions:</u>

Sheet Title:

TESC AND DEMOLITION

<u>Designed by:</u>

<u>Drawn by:</u> <u>Checked by:</u> MW

Sheet No.

3 of 25 Sheets

CONSTRUCTION SEQUENCE

. HOLD A PRECONSTRUCTION MEETING WITH THE CITY AND OBTAIN

- 2. STAKE OR PAINT CLEARING AND GRADING LIMITS.
- 3. PROVIDE INLET PROTECTION AS SHOWN.
- 4. CONSTRUCT TEMPORARY CONSTRUCTION ENTRANCE.
- 5. INSTALL SILT FENCE AND INFILTRATION AREA PROTECTION
- 6. INSTALL TEMPORARY SEDIMENT TRAP
- 7. SCHEDULE AN EROSION CONTROL INSPECTION WITH THE CITY.
- 8. CONSTRUCT PERMANENT STORMWATER SYSTEM AND INFILTRATION
- 9. PROVIDE COVER MEASURES (ARMORING, MULCHING, AND HYDROSEEDING) AS REQUIRED TO STABILIZE DENUDED AREAS AND PREVENT THE TRANSPORT OF SEDIMENT-LADEN STORMWATER OFF-SITE.
- 10. THE CONTRACTOR SHALL INSPECT THE EROSION CONTROL MEASURES A MINIMUM OF ONCE WEEKLY AND AFTER EVERY STORM EVENT THAT PRODUCES RUNOFF FROM THE SITE. THE CONTRACTOR SHALL REPAIR OR ADD EROSION CONTROL MEASURES AS REQUIRED
- 11. COVER ALL AREAS THAT WILL BE UNWORKED FOR MORE THAN SEVEN DAYS DURING THE DRY SEASON OR TWO DAYS DURING THE WET SEASON WITH STRAW, WOOD FIBER MULCH, COMPOST, PLASTIC SHEETING OR EQUIVALENT
- 12. AFTER SITE HAS BEEN PERMANENTLY STABILIZED, REMOVE SEDIMENT FROM STORM PIPES AND CATCH BASIN SUMPS.
- 13. COORDINATE WITH THE CITY OF PUYALLUP AND ENGINEER FOR FINA
- 14. REMOVE REMAINING TEMPORARY EROSION CONTROL DEVICES WHEN AREA HAS BEEN PERMANENTLY STABILIZED WITH VEGETATION OR SURFACING, AND REMOVAL IS APPROVED BY THE ENGINEER AND

THE CITY OF PUYALLUP.

GRADING, EROSION & SEDIMENTATION CONTROL NOTES:

1. ALL WORK IN CITY RIGHT-OF-WAY REQUIRES A PERMIT FROM THE CITY OF PUYALLUP. PRIOR TO ANY WORK COMMENCING. THE GENERAL CONTRACTOR SHALL ARRANGE FOR A PRECONSTRUCTION MEETING AT CITY HALL TO BE ATTENDED BY ALL MAJOR CONTRACTORS, REPRESENTATIVES OF INVOLVED UTILITIES AND THE CITY OF PUYALLUP. CONTACT THE ENGINEERING DIVISION AT THE CITY OF PUYALLUP TO SCHEDULE THE MEETING (253-864-4165). THE CONTRACTOR IS RESPONSIBLE TO HAVE HIS SET OF PLANS AT THE MEETING.

2. AFTER COMPLETION OF ALL ITEMS SHOWN ON THESE PLANS AND BEFORE ACCEPTANCE OF THE PROJECT, THE CONTRACTOR SHALL OBTAIN A "PUNCH LIST" PREPARED BY THE CITY'S INSPECTOR DETAILING REMAINING ITEMS OF WORK TO BE COMPLETED. ALL ITEMS OF WORK SHOWN ON THESE PLANS SHALL BE COMPLETED TO THE SATISFACTION OF THE CITY PRIOR TO ACCEPTANCE OF THE WATER SYSTEM AND PROVISION OF SANITARY SEWER SERVICE.


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4. A COPY OF THESE APPROVED PLANS AND APPLICABLE CITY DEVELOPER SPECIFICATIONS AND DETAILS SHALL BE ON SITE DURING CONSTRUCTION.

5. ANY REVISIONS MADE TO THESE PLANS MUST BE REVIEWED AND APPROVED BY THE DEVELOPER'S ENGINEER AND THE CITY ENGINEER PRIOR TO ANY IMPLEMENTATION IN THE FIELD. THE CITY SHALL NOT BE RESPONSIBLE FOR ANY ERRORS AND/OR OMISSIONS ON THESE PLANS.

6. THE CONTRACTOR SHALL HAVE ALL UTILITIES VERIFIED ON THE GROUND PRIOR TO ANY CONSTRUCTION. CALL (1-800-424-5555) AT LEAST 48 HOURS IN ADVANCE. THE OWNER AND HIS ENGINEER SHALL BE CONTACTED IMMEDIATELY IF A CONFLICT EXISTS.

7. ALL LIMITS OF CLEARING AND AREAS OF VEGETATION PRESERVATION AS PRESCRIBED ON THE PLANS SHALL BE CLEARLY FLAGGED IN THE FIELD AND

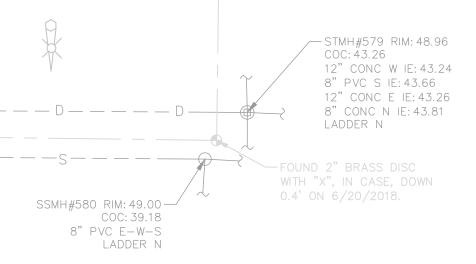

OBSERVED DURING CONSTRUCTION.

"NO PARKING" SSMH#581 RIM: 47.37 — "RIGHT LANE -TURN RIGHT" COC: 37.64 RELOCATE SIGN OUTSIDE OF 8" PVC F-W EXISTING STORM TO BE ABANDONED IN -XXX NW IE: 38.62 CONSTRUCTION ENTRANCE PLACE AND/OR DEMOLISHED WHERE LADDER W NECESSARY FOR CONSTRUCTION OF NEW STORM LINE. CONTRACTOR TO MAINTAIN DRAINAGE DURING CONSTRUCTION.

— STMH#578 RIM: 47.62

12" CONC NW IE: 41.69

12" CONC E IE: 41.69

LADDER S

GRAVEL ~

DATE: October 3, 2024 FILENAME: Q:\2019\2190606\10 CIV\CAD\ Final Design\2190606-SH-TESC.dwg

CLEAR AREA TO

-3' METAL CHAIN FENCE

POST DEDICATION

PROPERTY LINE

DISPLAY REGULATORY

"LEFT & CENTER LANE -STRAIGHT

CONTRACTOR TO

7-05.3(2)

R25.0'

ABANDON MANHOLE

FOLLOWING WSDOT

STANDARD SPECIFICATION

-STCB#587 RIM: 46.12

-10' CITY OF PUYALLUP STORM EASEMENT

SSMH#582 RIM:47.20-

12" CONC E-W

LADDER S

AFN 2530461

.

8" CONC SW IE: 43.92

POST DEDICATION

704/4/4/104

PROPERTY LINE

SIGNS THROUGHOUT

CONSTRUCTION

EXPOSE EXISTING CB

4" DI NE IE: 43.49

8" CONC SW IE: 43.09

STMH#589 RIM: 46.00

18" CONC N IE: 38.60

18" CONC S IE: 38.65

8" CONC NW IE: 41.50

8" CONC NE IE: 41.75

DISPLAY REGULATORY

STCB#585 RIM: 46.11

SIGNAL TO BE -

OTHERS

STMH#586 RIM: 46.87-

18" N CONC IE: 39.07

8" CONC NE IE: 42.57

12" CONC E IE: 40.52 12" CONC S IE: 39.87

12" CONC W IE: 40.02

8" CONC NW IE: 42.57

SSMH#583 RIM: 47.28 —

12" CONC E-W-S

REMOVE EXISTING FIRE -

HYDRANT AND GATE VALVE

PROVIDE BLIND FLANGE

COC: 36.88

LADDER N

RELOCATED BY

8" CONC SE IE: 43.87

SMH#584 RIM: 47.14 —

12" CONC E-W

(now what's below.

Call before you dig.

COC: 36.64

LADDER S

SIGNS THROUGHOUT

CONSTRUCTION

SAWCUT

BACK OF

CURB

STCB#590 RIM: 45.26 —

8" CONC SE IE: 43.16

GENERAL STORMWATER PERMIT.

SATISFIED.

CONDITION IS CORRECTED. THE CONTRACTOR AND/OR THE OWNER SHALL IMMEDIATELY TAKE ALL STEPS NECESSARY TO PREVENT FUTURE TRACKING OF MUD AND DEBRIS INTO THE PUBLIC ROW, WHICH MAY INCLUDE THE INSTALLATION OF A WHEEL WASH FACILITY ON-SITE.


15. CONTRACTOR SHALL DESIGNATE A WASHINGTON DEPARTMENT OF ECOLOGY

16. SEDIMENT-LADEN RUNOFF SHALL NOT BE ALLOWED TO DISCHARGE BEYOND THE CONSTRUCTION LIMITS IN ACCORDANCE WITH THE PROJECT'S NPDES

CERTIFIED EROSION AND SEDIMENT CONTROL LEAD PERSON, AND SHALL COMPLY WITH THE STORMWATER POLLUTION PREVENTION PLAN (SWPPP) PREPARED FOR THEIR PROJECT

A PORTION OF THE NW 1/4 OF THE NW 1/4 OF SEC. 27, TWN. 20 N., RGE. 04 E. W.M. CITY OF PUYALLUP, PIERCE COUNTY, WASHINGTON.



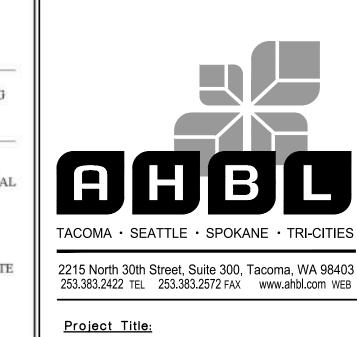

PUYALLUP 2ND STREET

APARTMENTS

SPP MANUFACTURING

P.O.BOX 64160

TACOMA, WA 98464

DON HUBER

2190606.10

SITE DEVELOPMENT

PERMIT SET

10/8/2024

10/11/2024

City of Puyallup

Development & Permitting Services

ISSUED PERMIT

TESC NOTES AND

DETAILS

Designed by: Drawn by: Checked by:

4 of 25 Sheets

Planning

Public Works

Traffic

Building

Engineering


Revisions:

Sheet Title:

Sheet No.

Project No.

Issue Set & Date:

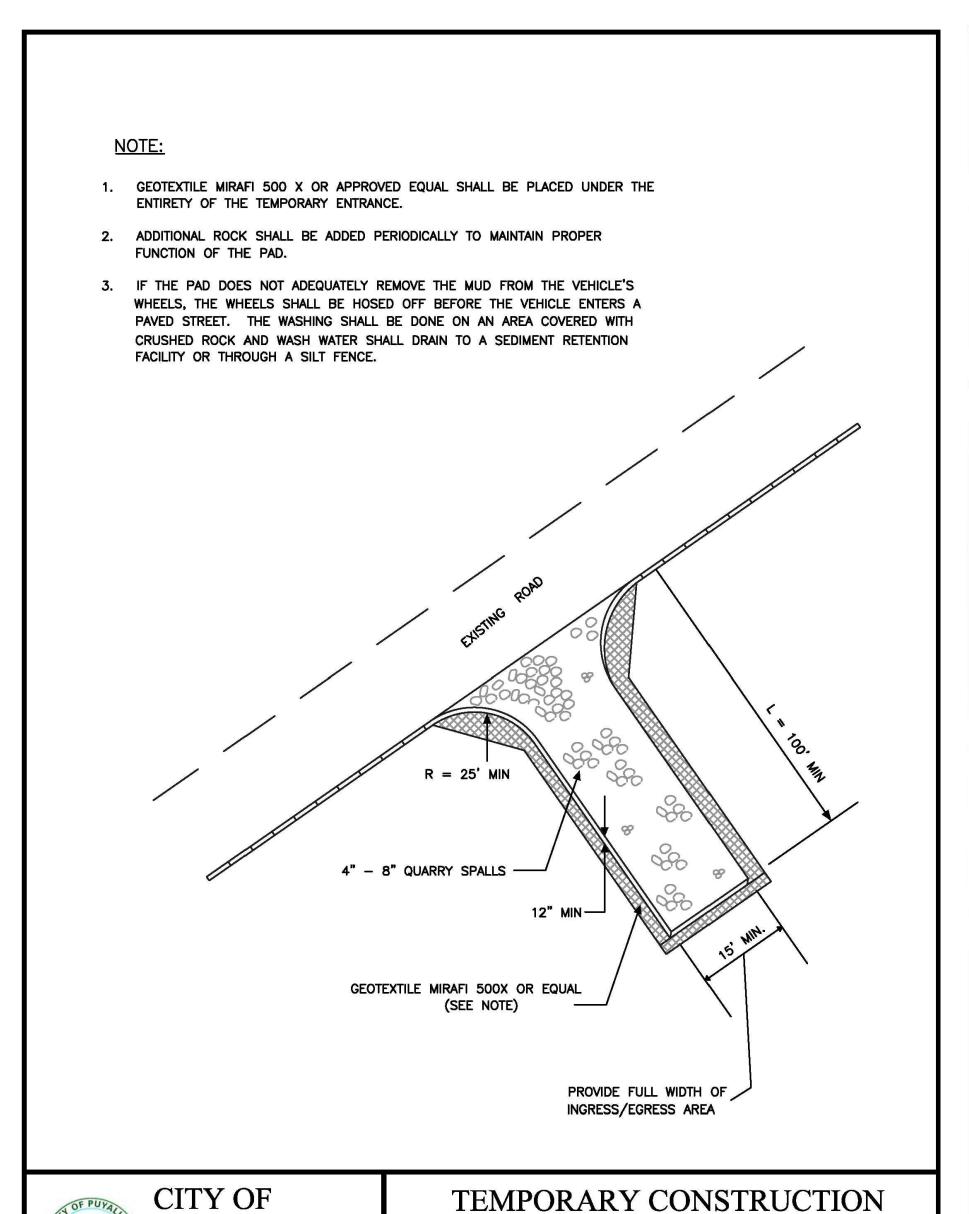

ENTRANCE

CITY STANDARD

SCALE 1:40 05.01.01

1. ALL LIMITS OF CLEARING AND AREAS OF VEGETATION PRESERVATION AS PRESCRIBED ON THE PLANS SHALL BE CLEARLY FLAGGED IN THE FIELD AND OBSERVED DURING CONSTRUCTION.

2. ALL REQUIRED SEDIMENTATION AND EROSION CONTROL FACILITIES MUST BE CONSTRUCTED AND IN OPERATION PRIOR TO ANY LAND CLEARING AND/OR OTHER CONSTRUCTION TO ENSURE THAT SEDIMENT LADEN WATER DOES NOT ENTER THE NATURAL DRAINAGE SYSTEM. THE CONTRACTOR SHALL SCHEDULE AN INSPECTION OF THE EROSION CONTROL FACILITIES PRIOR TO ANY LAND CLEARING AND/OR CONSTRUCTION. ALL EROSION AND SEDIMENT FACILITIES SHALL BE MAINTAINED IN A SATISFACTORY CONDITION AS DETERMINED.

BY THE CITY, UNTIL SUCH TIME THAT CLEARING AND/OR CONSTRUCTION IS COMPLETED AND THE POTENTIAL FOR ON-SITE EROSION

HAS PASSED. THE IMPLEMENTATION, MAINTENANCE, REPLACEMENT, AND ADDITIONS TO THE EROSION AND SEDIMENTATION CONTROL


3. THE EROSION AND SEDIMENTATION CONTROL SYSTEM FACILITIES DEPICTED ON THESE PLANS ARE INTENDED TO BE MINIMUM REQUIREMENTS TO MEET ANTICIPATED SITE CONDITIONS. AS CONSTRUCTION PROGRESSES AND UNEXPECTED OR SEASONAL CONDITIONS DICTATE, FACILITIES WILL BE NECESSARY TO ENSURE COMPLETE SILTATION CONTROL ON THE SITE. DURING THE COURSE OF CONSTRUCTION, IT SHALL BE THE OBLIGATION AND RESPONSIBILITY OF THE PERMITEE TO ADDRESS ANY NEW CONDITIONS THAT MAY BE CREATED BY HIS ACTIVITIES AND TO PROVIDE ADDITIONAL FACILITIES, OVER AND ABOVE THE MINIMUM REQUIREMENTS, AS MAY BE NEEDED TO PROTECT ADJACENT PROPERTIES, SENSITIVE AREAS, NATURAL WATER COURSES, AND/OR STORM DRAINAGE SYSTEMS.

4. APPROVAL OF THESE PLANS IS FOR GRADING, TEMPORARY DRAINAGE, EROSION AND SEDIMENTATION CONTROL ONLY. IT DOES NOT CONSTITUTE AN APPROVAL OF PERMANENT STORM DRAINAGE DESIGN, SIZE OR LOCATION OF PIPES, RESTRICTORS, CHANNELS, OR RETENTION FACILITIES.

5. ANY DISTURBED AREA WHICH HAS BEEN STRIPPED OF VEGETATION AND WHERE NO FURTHER WORK IS ANTICIPATED FOR A PERIOD OF 30 DAYS OR MORE, MUST BE IMMEDIATELY STABILIZED WITH MULCHING, GRASS PLANTING, OR OTHER APPROVED EROSION CONTROL TREATMENT APPLICABLE TO THE TIME OF YEAR IN QUESTION. GRASS SEEDING ALONE WILL BE ACCEPTABLE ONLY DURING THE MONTHS OF APRIL THROUGH SEPTEMBER INCLUSVE. SEEDING MAY PROCEED OUTSIDE THE SPECIFIED TIME PERIOD WHENEVER IT IS IN THE INTEREST OF THE PERMITEE BUT MUST BE AUGMENTED WITH MULCHING, NETTING, OR OTHER TREATMENT APPROVED BY THE CITY.

6. IN CASE EROSION OR SEDIMENTATION OCCURS TO ADJACENT PROPERTIES, ALL CONSTRUCTION WORK WITHIN THE DEVELOPMENT
THAT WILL FURTHER AGGRAVATE THE SITUATION MUST CEASE, AND THE OWNER/CONTRACTOR WILL IMMEDIATELY COMMENCE
RESTORATION METHODS. RESTORATION ACTIVITY WILL CONTINUE UNTIL SUCH TIME AS THE AFFECTED PROPERTY OWNER IS SATISFIED.

7. NO TEMPORARY OR PERMANENT STOCKPILING OF MATERIALS OR EQUIPMENT SHALL OCCUR WITHIN CRITICAL AREAS OR ASSOCIATED BUFFERS, OR THE CRITICAL ROOT ZONE FOR VEGETATION PROPOSED FOR RETENTION.

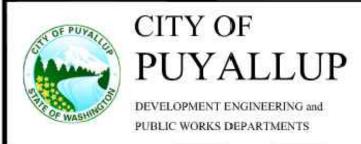

GRADING AND T.E.S.C. NOTES


SYSTEMS SHALL BE THE RESPONSIBILITY OF THE PERMITEE.

GRADING, EROSION, AND SEDIMENTATION CONTROL NOTES

DR. (IFV BY INM ERWIN-SVOBO)DA CHECKED BY LINDA LIAN COLLEEN HARRIS LINDA LIAN STANDARD

3 SILTATION FENCE

05.02.01

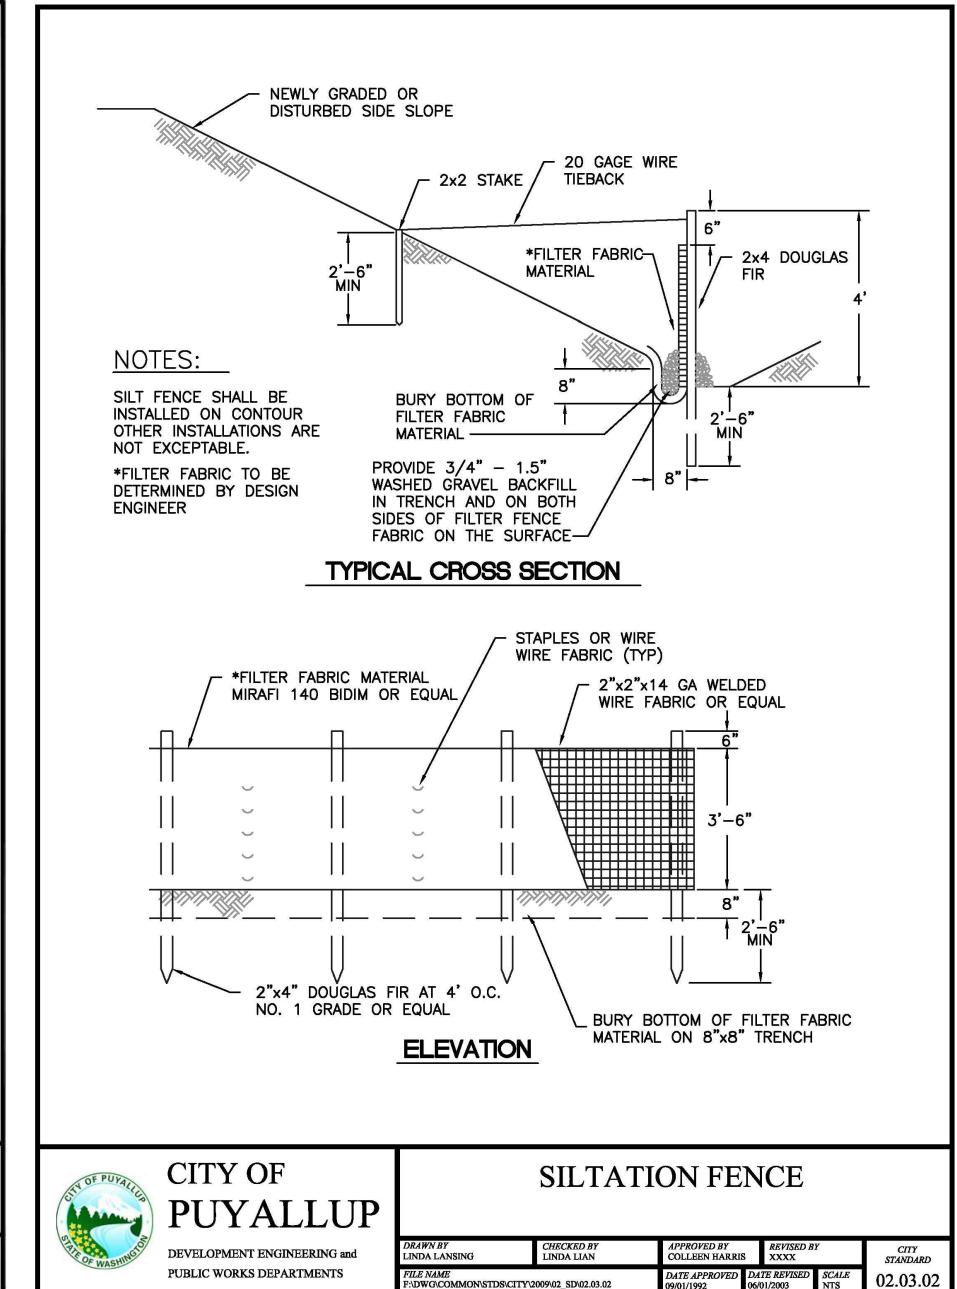

Know what's below.
Call before you dig.

PUYALLUP

DEVELOPMENT ENGINEERING and

PUBLIC WORKS DEPARTMENTS

DRAWN BY JIM ERWIN-SVOBODA

TEMPORARY CONSTRUCTION ENTRANCE

CHECKED BY LINDA LIAN

TLE NAME
?:\DWG\COMMON\STDS\CTTY\2009\05_GRD\05.01\05.01.01

A PORTION OF THE NW 1/4 OF THE NW 1/4 OF SEC. 27, TWN. 20 N., RGE. 04 E. W.M. CITY OF PUYALLUP, PIERCE COUNTY, WASHINGTON.

modalous CITY OF PUYALLUP DEVELOPMENT ENGINEERING DATE NOTE: THIS APPROVAL IS VOID AFTER 180 DAYS FROM APPROVA THE CITY WILL NOT BE RESPONSIBLE FOR ERRORS AND/OR OMISSIONS ON THESE PLANS. FIELD CONDITIONS MAY DICTATE CHANGES TO THESE PLANS AS DETERMINED BY THE DEVELOPMENT ENGINEERING MANAGER. Project Title:

APPROVED



| PUYALLUP 2ND STREET **APARTMENTS**

SPP MANUFACTURING

P.O.BOX 64160 TACOMA, WA 98464 DON HUBER

Project No.


2190606.10


Issue Set & Date:

SITE DEVELOPMENT **PERMIT SET**

10/8/2024



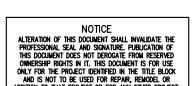

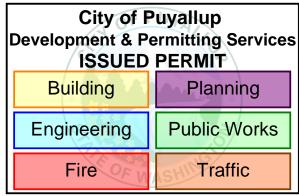

<u>Revisions:</u>


Sheet Title:

TESC NOTES AND DETAILS

Designed by: Drawn by: Checked by:

Sheet No.


5 of 25 Sheets

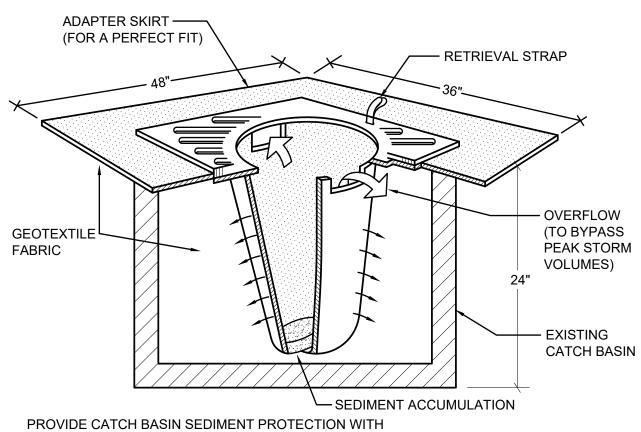


STREAMGUARD BASIN INSERT #3003, FROM BOW HEAD ENVIRONMENTAL OR EQUIVALENT. P.O. BOX 375

INLET PROTECTION

PRESTON, WA 98050 PHONE: 1-800-909-3677

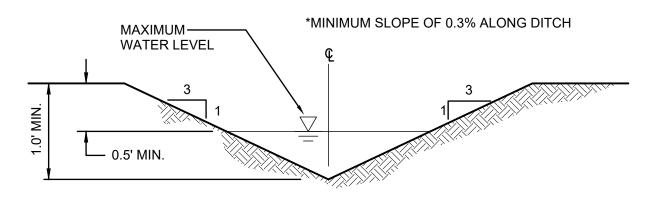


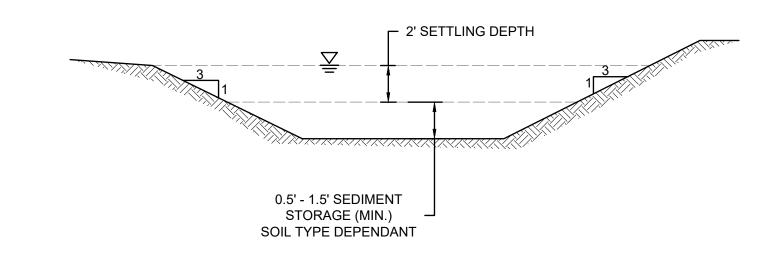



INTERCEPTOR DITCH



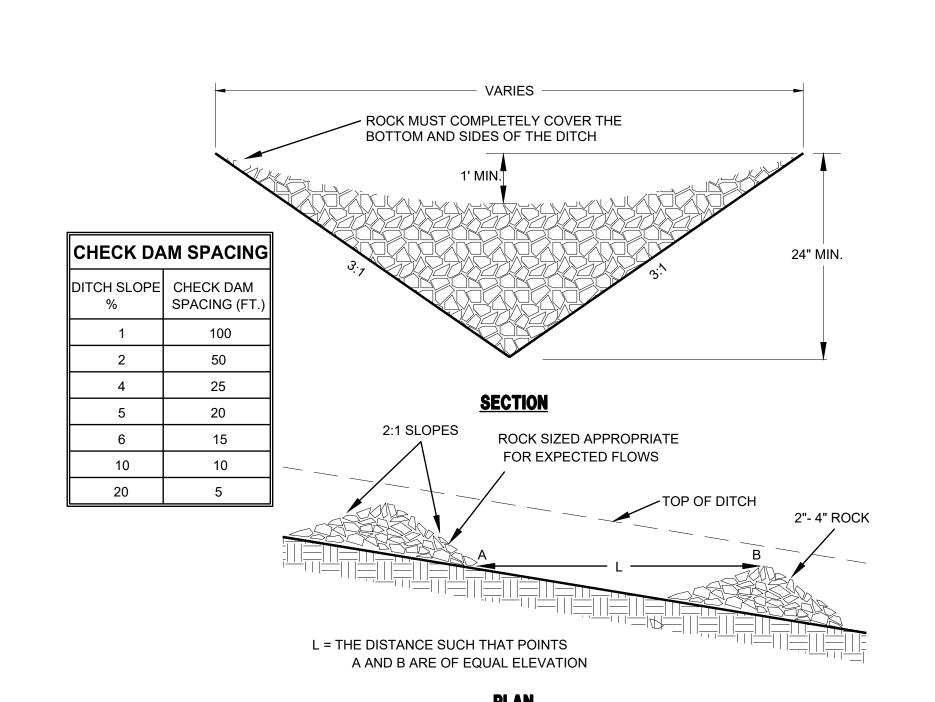


CHECK DAM NOTES:

- 1. THE MAXIMUM SPACING BETWEEN THE DAMS SHALL BE SUCH THAT THE TOE OF THE UPSTREAM DAM IS AT THE SAME ELEVATION AS THE TOP OF THE DOWNSTREAM DAM.
- 2. ROCK CHECK DAMS SHALL BE CONSTRUCTED OF 2- TO 4- INCH DIAMETER QUARRY SPALLS. THE QUARRY SPALLS MUST BE PLACED BY HAND OR MECHANICAL PLACEMENT (NO DUMPING OF SPALLS TO FORM DAM) TO ACHIEVE COMPLETE COVERAGE OF THE DITCH OR SWALE AND TO INSURE THAT THE CENTER OF THE DAM IS LOWER THAN THE EDGES.
- 3. LOG CHECK DAMS SHALL BE CONSTRUCTED OF 4- TO 6- INCH DIAMETER LOGS. THE LOGS SHALL BE EMBEDDED INTO THE SOIL AT
- 4. IN THE CASE OF GRASS-LINED DITCHES AND SWALES, CHECK DAMS SHALL BE REMOVED WHEN THE GRASS HAS MATURED SUFFICIENTLY TO PROTECT THE DITCH OR SWALE. THE AREA BENEATH THE CHECK DAMS SHALL BE SEEDED AND MULCHED IMMEDIATELY AFTER DAM REMOVAL.
- 5. CHECK DAMS SHALL BE CHECKED FOR SEDIMENT ACCUMULATION AFTER EACH SIGNIFICANT RAINFALL. SEDIMENT SHALL BE REMOVED WHEN IT REACHES ONE HALF OF THE ORIGINAL DAM HEIGHT OR BEFORE.





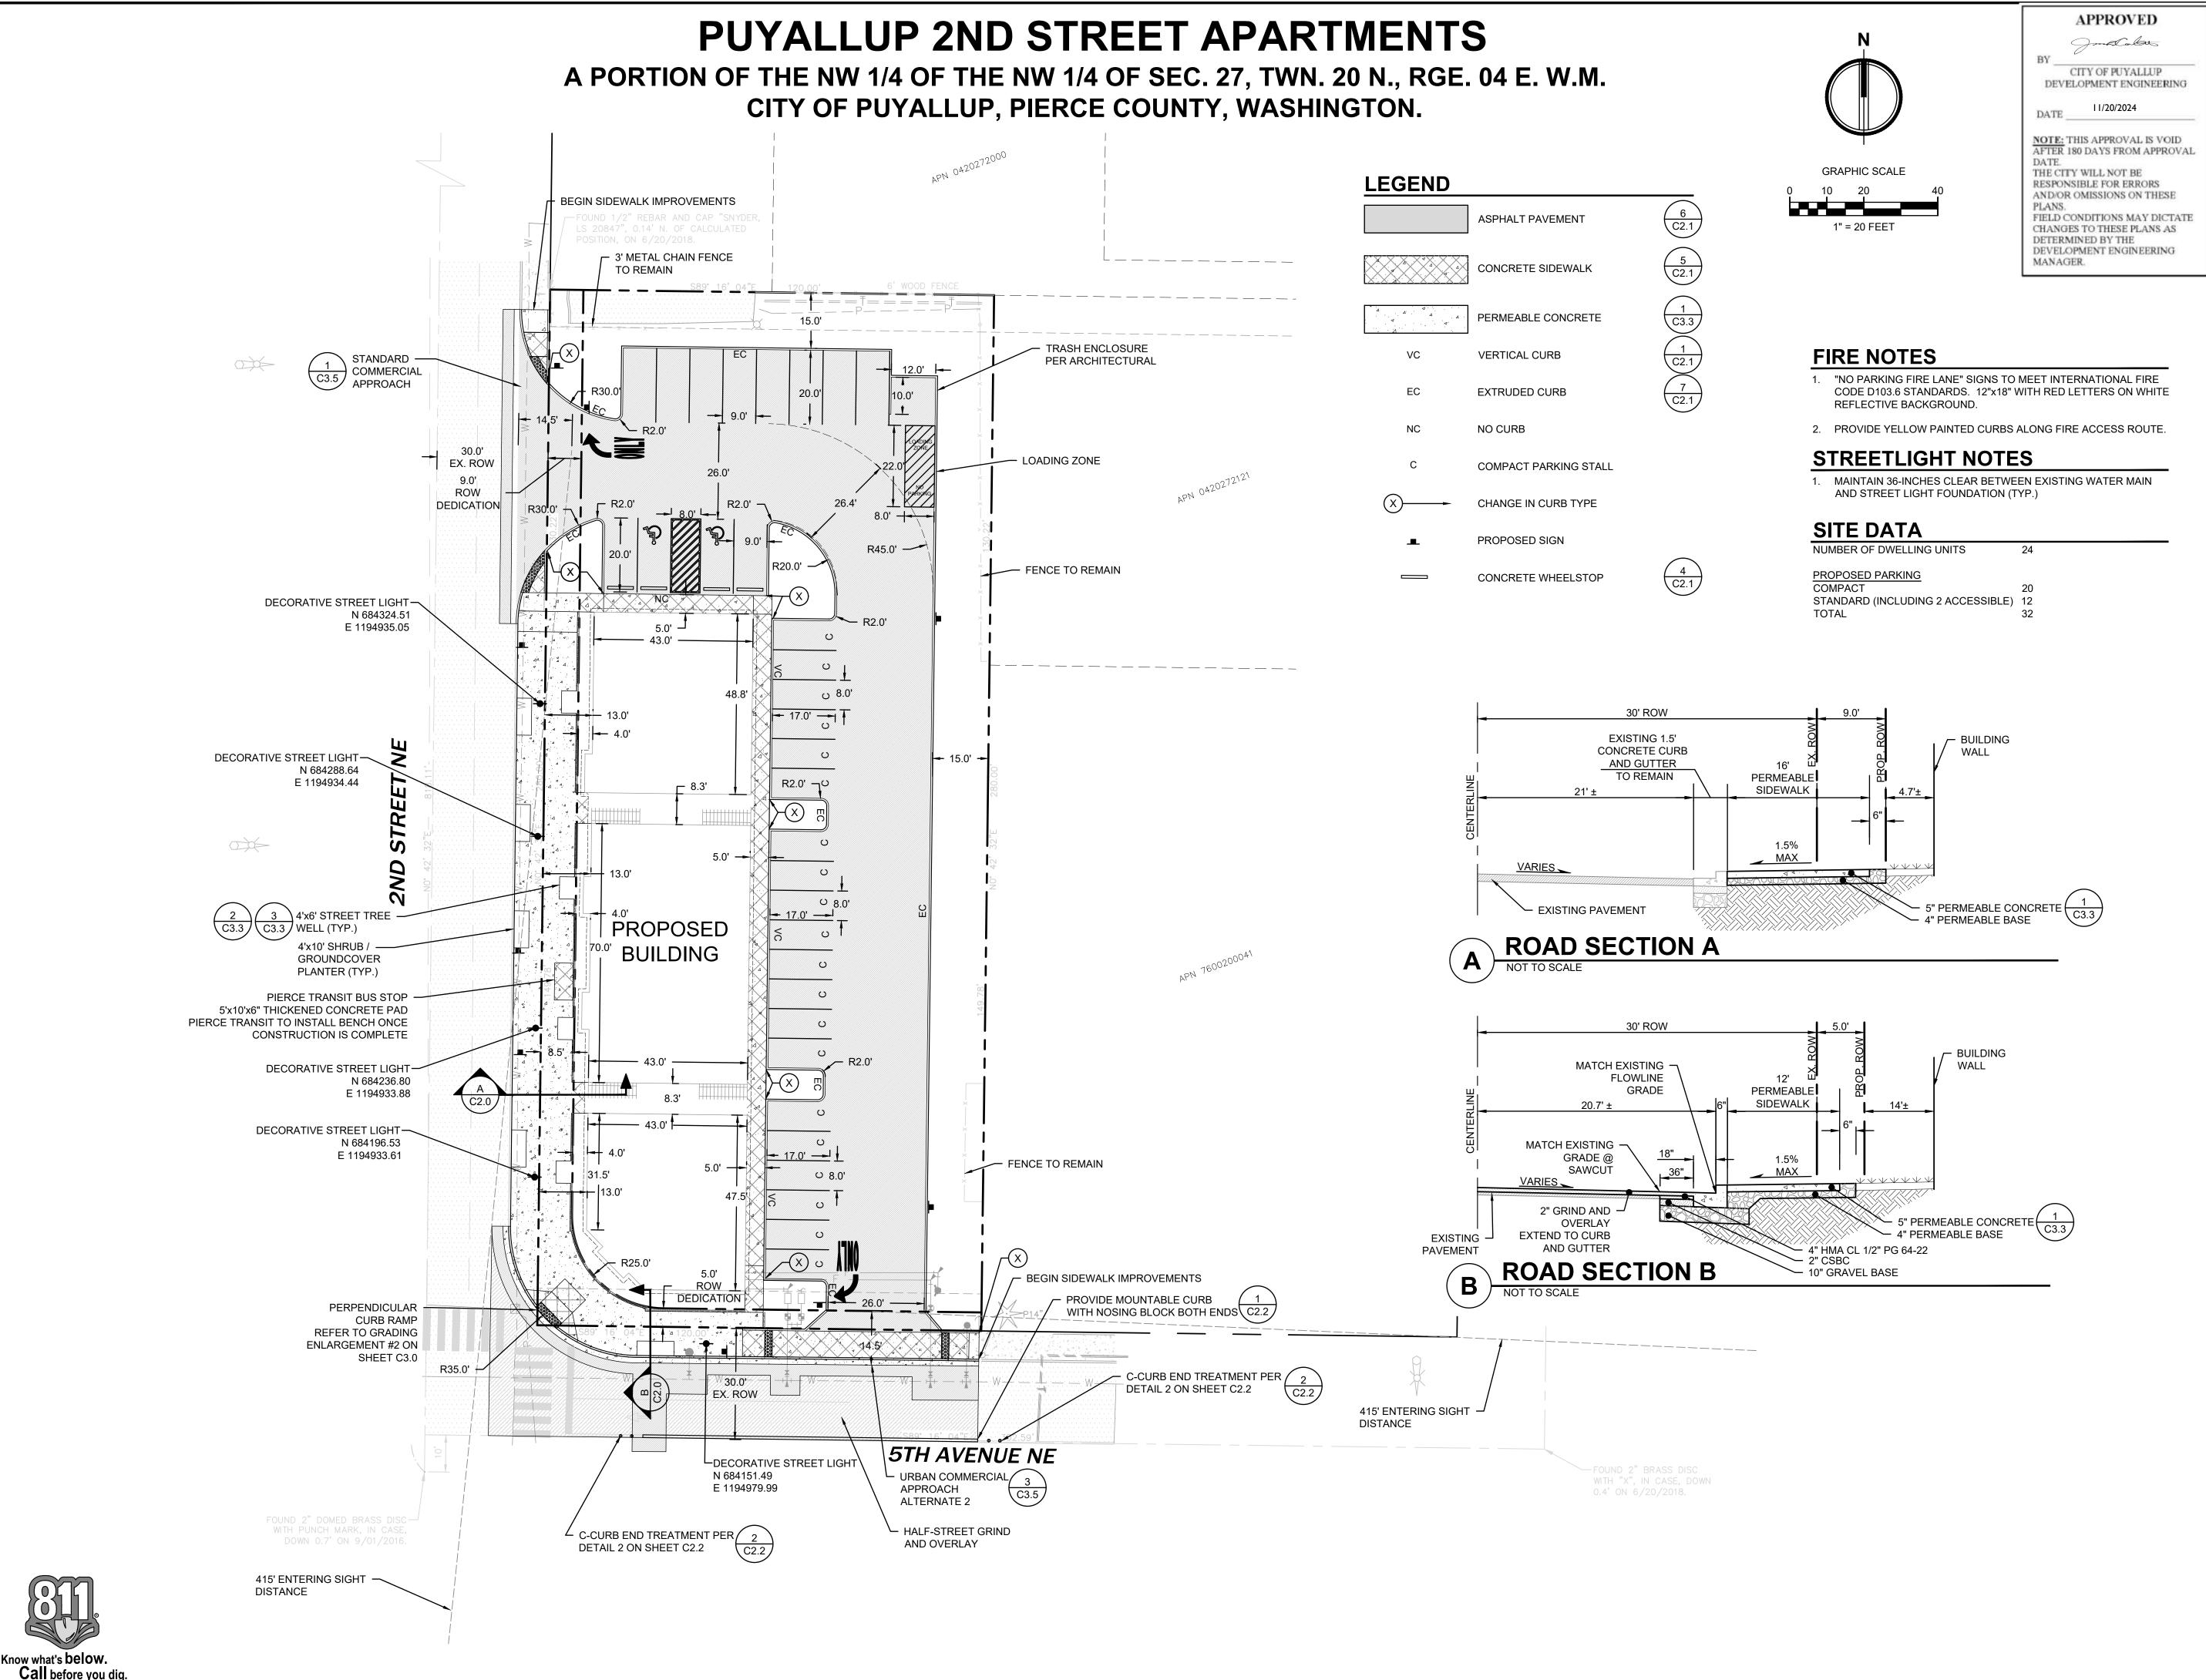

2215 North 30th Street, Suite 300, Tacoma, WA 98403 253.383.2422 TEL 253.383.2572 FAX www.ahbl.com WEB

PUYALLUP 2ND STREET **APARTMENTS**

Project Title:

SPP MANUFACTURING

P.O.BOX 64160 **TACOMA**, WA 98464 DON HUBER

<u>Project No.</u>


2190606.10

Issue Set & Date:

SITE DEVELOPMENT **PERMIT SET**





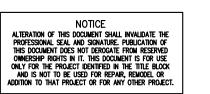

City of Puyallup evelopment & Permitting Services ISSUED PERMIT				
Building	Planning			
Engineering	Public Works			
Fire Five Traffic				

Revisions:


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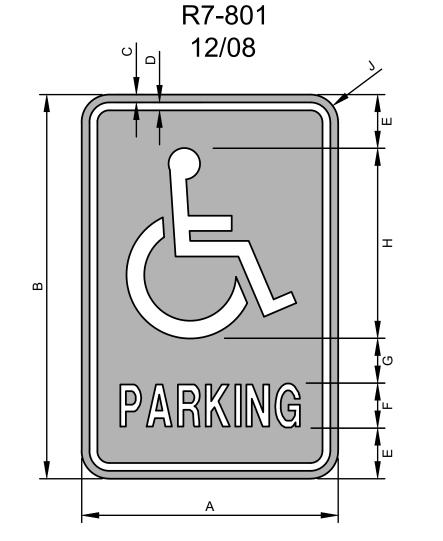
HORIZONTAL CONTROL AND SURFACING PLAN

Designed by: Drawn by: Checked by:

Sheet No.

A PORTION OF THE NW 1/4 OF THE NW 1/4 OF SEC. 27, TWN. 20 N., RGE. 04 E. W.M. CITY OF PUYALLUP, PIERCE COUNTY, WASHINGTON.



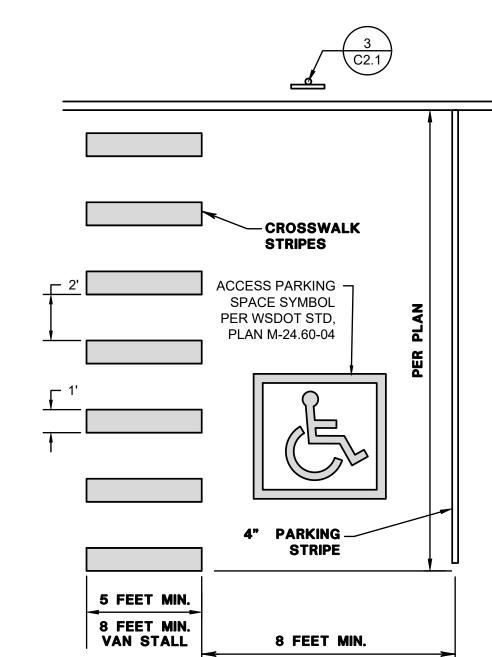

LEGEND & BORDER - WHITE (REFL)

SYMBOL - WHITE (REFL)

DIMENSIONS (INCHES)

A B C D E F G H J


12 | 18 | 3/8 | 3/8 | $2\frac{1}{2}$ | 2C | 2 | 9 | $1\frac{1}{2}$

1. PROVIDE VAN ACCESSIBLE STALL SIGN ON STALLS IDENTIFIED AS

2. PLACE NO PARKING SIGN 12 INCHES BEHIND CURB AT OUTSIDE

3. PROVIDE NO PARKING SIGN ON STALL POST IF AISLE LEADS TO

BACKGROUND - BLUE (REFL)

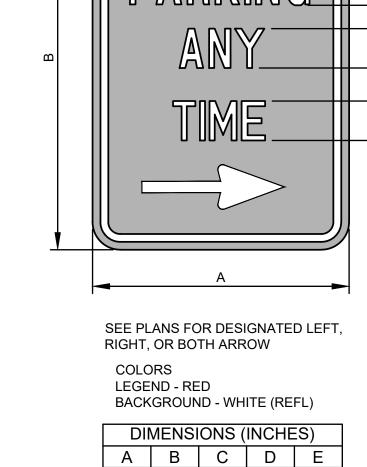

12 | 18 | 2C | 3B | 2C

1. PLACE NO PARKING SIGN 12

INCHES BEHIND CURB AT


OUTSIDE EDGE OF AISLES

NOTE:

*****R7-1

11/97



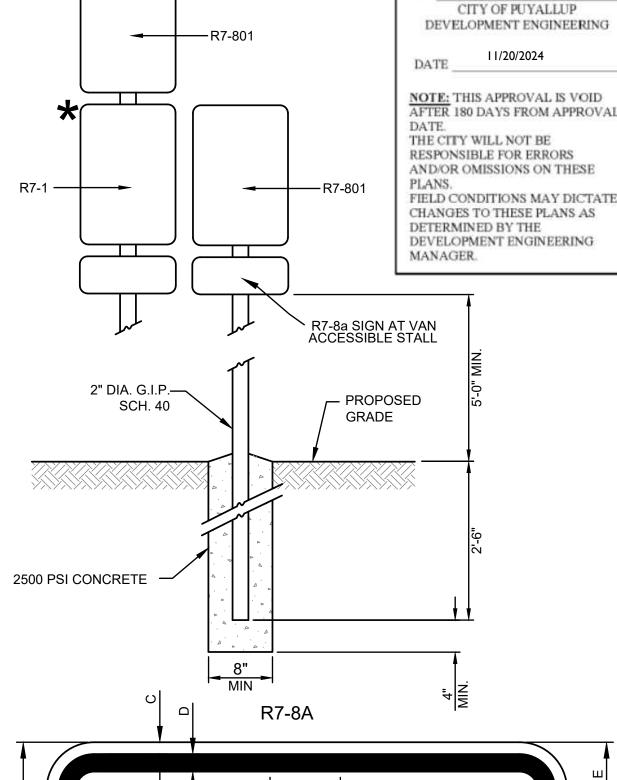

APPROVED

Jame Calous



2215 North 30th Street, Suite 300, Tacoma, WA 98403

253.383.2422 TEL 253.383.2572 FAX www.ahbl.com WEB


PUYALLUP 2ND STREET


APARTMENTS


SPP MANUFACTURING

P.O.BOX 64160 TACOMA, WA 98464 DON HUBER

Project Title:

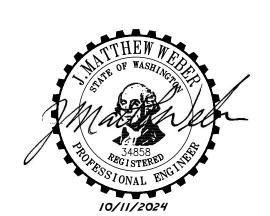

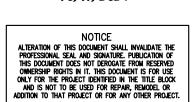

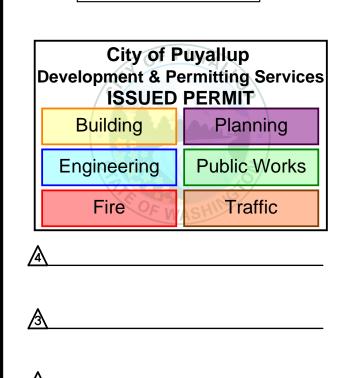

Revisions:


Sheet Title:

SURFACING NOTES AND DETAILS

Designed by: Drawn by: Checked by:


Sheet No.

7 of 25 Sheets

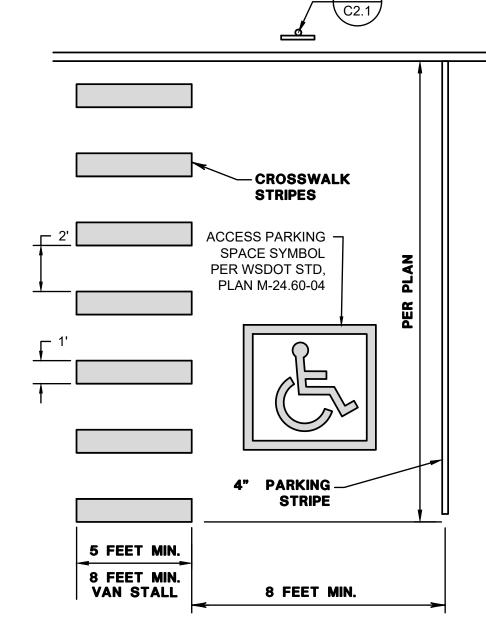






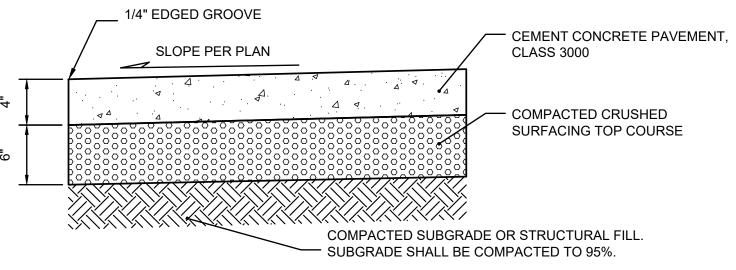

EXPANSION JOINT NOTES:


- 1. EXPANSION JOINTS CONSISTING OF 3/16" BY 2" PREMOLDED JOINT MATERIAL SHALL BE PLACED AT 15 FOOT INTERVALS.
- 2. CONTRACTION JOINTS SHALL INSTALLED EVERY 5'. EXPANSION JOINTS SHALL BE PLACED AT EVERY THIRD JOINT. ALL JOINTS SHALL BE CLEAN AND EDGED WITH AN EDGE HAVING 1/4" RADIUS. JOINTS SHALL BE FLUSH WITH THE FINISHED SURFACE.
- 3. PREMOLDED JOINT FILLER SHALL BE PER THE SPECIFICATIONS AT 21 FOOT MAX SPACING.
- 4. FORMS SHALL BE EITHER WOOD OR STEEL
- 5. CONCRETE SIDEWALK SHALL HAVE A MINIMUM COMPRESSIVE STRENGTH OF 3,000 PSI @ 28 DAYS.
- 6. A BROOMED FINISH SHALL BE PROVIDED IN TRANSVERSE DIRECTION UNLESS OTHERWISE INDICATED.



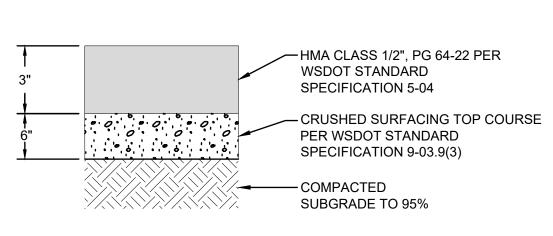


1. ALL DEPTHS SHOWN ARE COMPACTED DEPTHS. 2. RECOMPACT EXISTING STRUCTURAL FILL.



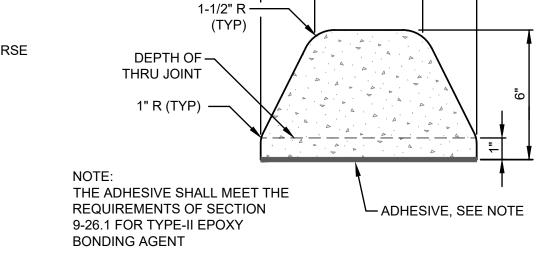

EXTRUDED CURB



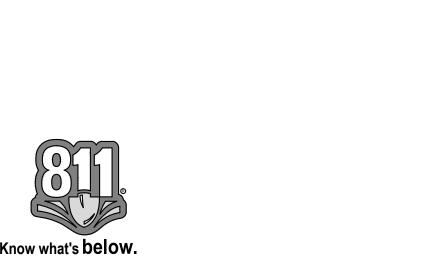

Call before you dig.

-FACE OF CURB

ROADWAY

CEMENT CONCRETE,

FACE OF SIDEWALK -

8" MIN.

18" MIN.

(2) #3 BARS-\

(2) #6 BARS ~

3:1 SAND & CEMENT —

NON-SHRINK GROUT

GROUT 1" DEPTH

2" CLEARANCE (TYP) --- |--

WHEELSTOP NOT TO SCALE


3000 PSI

8 1/4"


VERTICAL CURB


6'-0"

A PORTION OF THE NW 1/4 OF THE NW 1/4 OF SEC. 27, TWN. 20 N., RGE. 04 E. W.M. CITY OF PUYALLUP, PIERCE COUNTY, WASHINGTON.

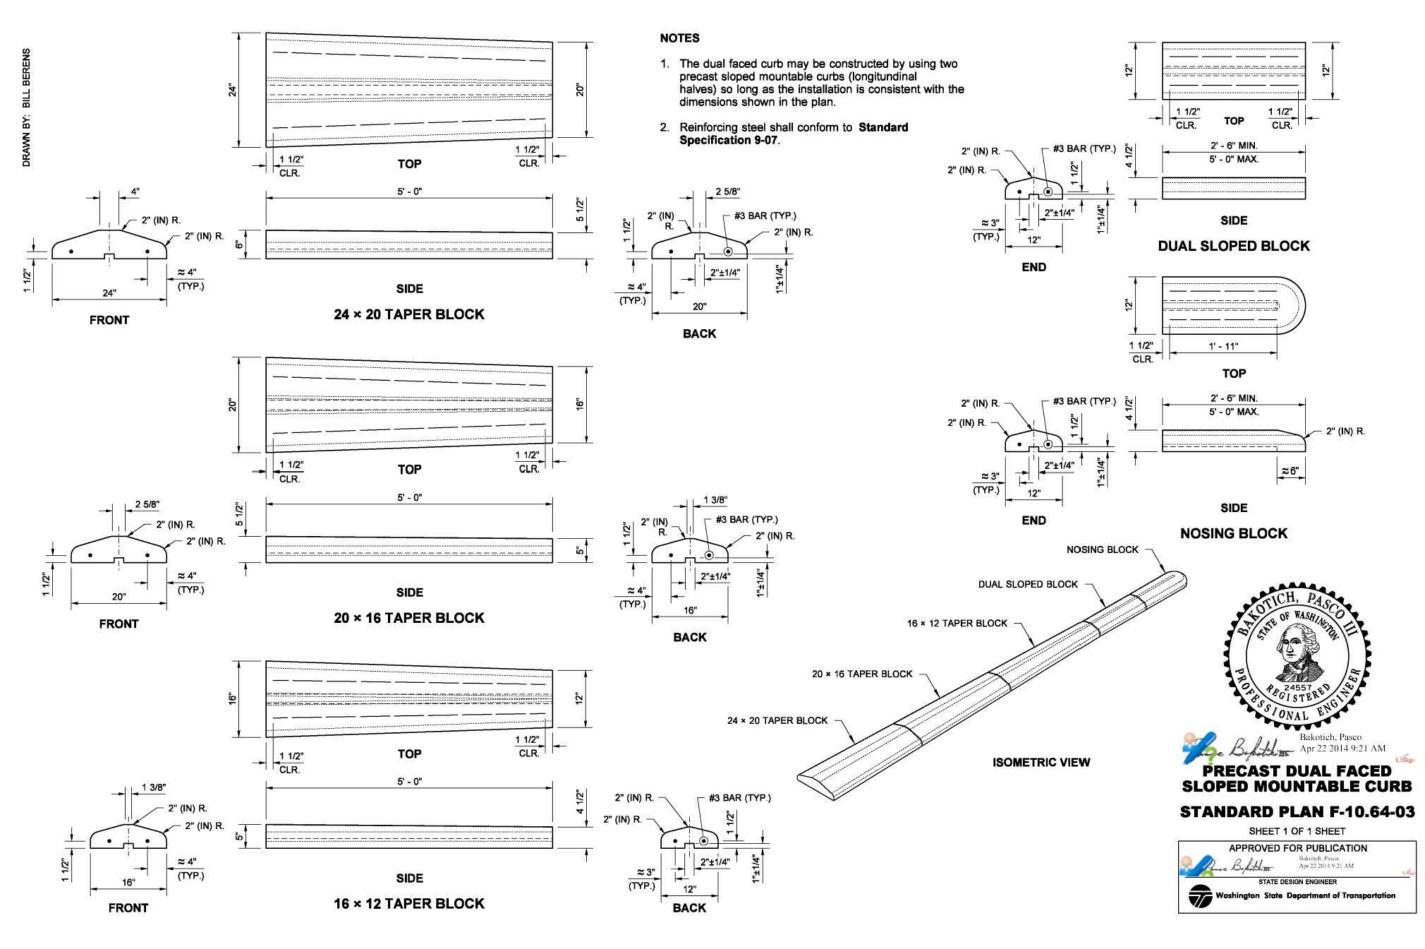


WSDOT MOUNTABLE CURB

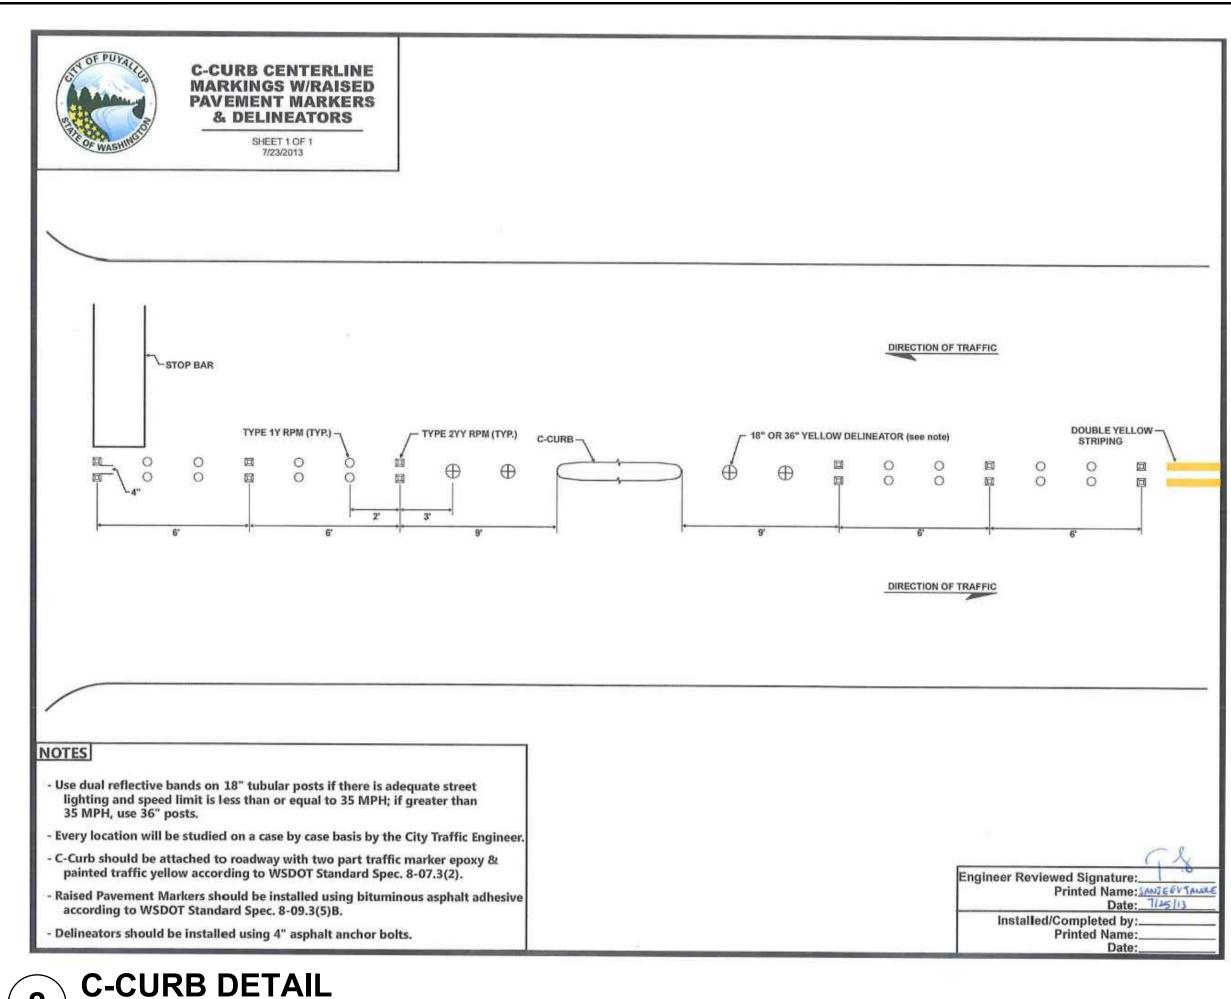

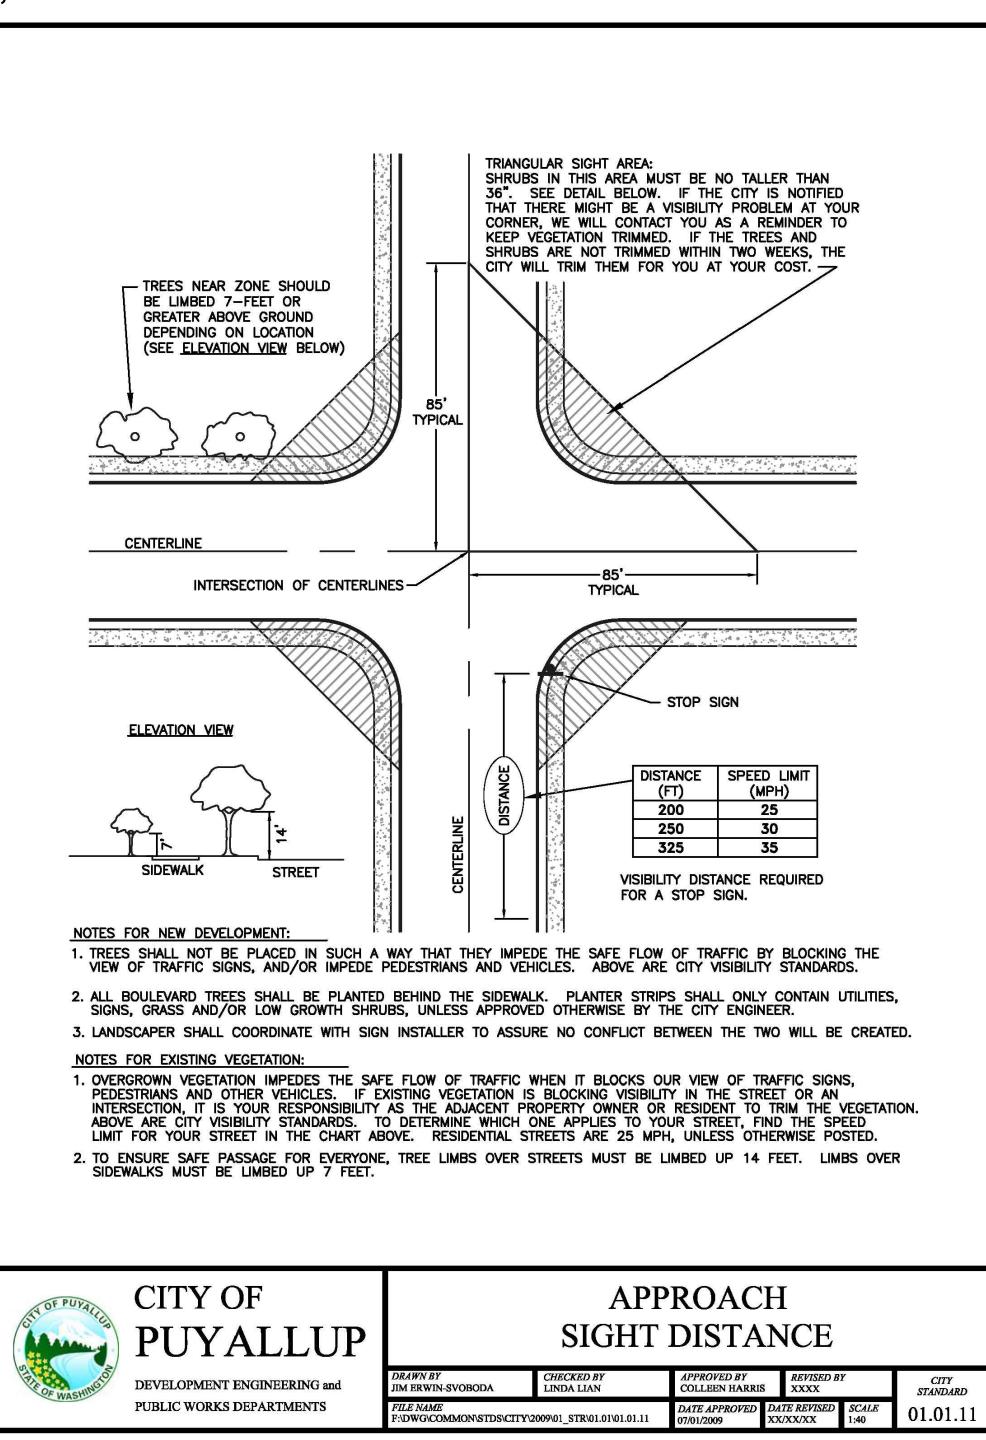

APPROACH SIGHT DISTANCE

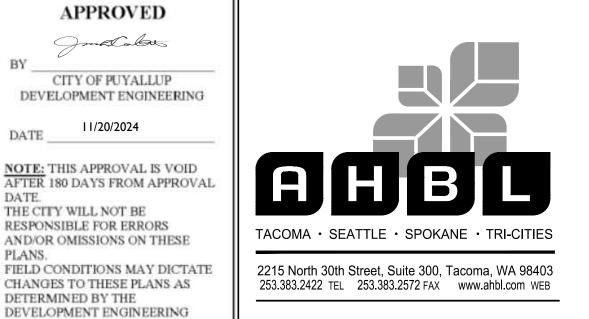

Project Title:

PLANS.

MANAGER.

PUYALLUP 2ND STREET **APARTMENTS**

SPP MANUFACTURING


P.O.BOX 64160 **TACOMA, WA 98464** DON HUBER


<u>Project No.</u>


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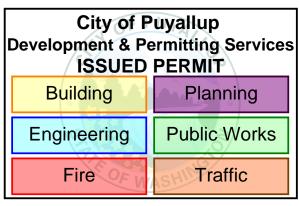
Issue Set & Date:

SITE DEVELOPMENT **PERMIT SET**



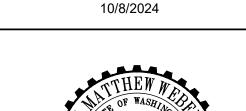

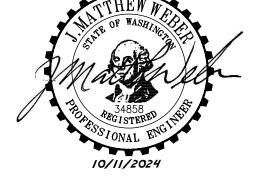

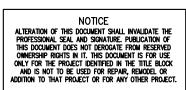

Revisions:

Sheet Title:

SURFACING NOTES AND DETAILS

Designed by: Drawn by: Checked by: MW

Sheet No.

8 of 25 Sheets

Know what's below.

A PORTION OF THE NW 1/4 OF THE NW 1/4 OF SEC. 27, TWN. 20 N., RGE. 04 E. W.M. CITY OF PUYALLUP, PIERCE COUNTY, WASHINGTON.

- REPLACE RIGHT TURN /

C-CURB END TREATMENT
MARKERS & TUBULAR
POSTS

C2.2

ONLY STRIPING

5TH AVENUE NE

- REPLACE LANE LINE
MARKING TO ORIGINAL
C2.4

RIGHT LANE - TURN RIGHT" SIGN

FOR PERMANENT LOCATION

COORDINATE WITH CITY INSPECTOR

CONDITION

RELOCATE "NO PARKING

10' INGRESS, EGRESS AND UTILITIES EASEMENT

AFN. 1566259 & 950901003

PROPOSED

BUILDING

"RIGHT TURN ONLY"

REPLACE

REPLACE STOP BAR $\frac{3}{C2.4}$


ARROW

- C-CURB END TREATMENT - C-CURB END TREATMENT 2 MARKERS & TUBULAR POSTS C2.2

- REPLACE
DIRECTIONAL
C2.5
ARROW

SIGN R3-5R

PER MUTCD

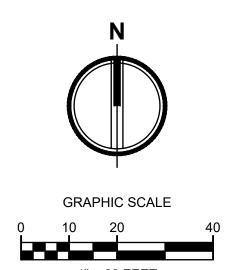

Jan Calous CITY OF PUYALLUP DEVELOPMENT ENGINEERING DATE NOTE: THIS APPROVAL IS VOID AFTER 180 DAYS FROM APPROVAL THE CITY WILL NOT BE RESPONSIBLE FOR ERRORS AND/OR OMISSIONS ON THESE PLANS. FIELD CONDITIONS MAY DICTATE

DETERMINED BY THE

MANAGER.

APPROVED



2215 North 30th Street, Suite 300, Tacoma, WA 98403 CHANGES TO THESE PLANS AS 253.383.2422 TEL 253.383.2572 FAX www.ahbl.com WEB DEVELOPMENT ENGINEERING

Project Title:

- "NO PARKING FIRE LANE" SIGNS TO MEET INTERNATIONAL FIRE CODE D103.6 STANDARDS. 12"x18" WITH RED LETTERS ON WHITE REFLECTIVE BACKGROUND
- (2) PROVIDE YELLOW PAINTED CURBS ALONG FIRE ACCESS ROUTE

FIRE NOTES

PUYALLUP 2ND STREET **APARTMENTS**

SPP MANUFACTURING

P.O.BOX 64160 TACOMA, WA 98464 DON HUBER

Project No.


2190606.10

Issue Set & Date:

SITE DEVELOPMENT **PERMIT SET**

10/8/2024



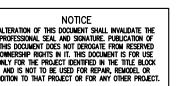

velopment & Permitting Services ISSUED PERMIT				
Building Planning				
Engineering Public Works				
Fire Five Traffic				

<u>Revisions:</u>

Sheet Title:

CHANNELIZATION

Designed by: Drawn by: Checked by:

Sheet No.

DATE: October 8, 2024 FILENAME: Q:\2019\2190606\10_CIV\CAD_Final Design\2190606-SH-CHAN.dwg

Know what's below.

Call before you dig.

RELOCATE "SEATTLE RIGHT LANE" SIGN —

COORDINATE WITH CITY INSPECTOR

RELOCATE "LEFT & CENTER LANE - -

COORDINATE WITH CITY INSPECTOR FOR

RELOCATE BUS STOP SIGN -

RELOCATE 30MPH SIGN -

EXISTING SIGNAL POLE -

REMOVED/RELOCATED

BEHIND FUTURE CURB WITH PEDESTRIAN CROSSING ACTUATOR. EXACT LOCATION AND DESIGN BY OTHERS.

AND J-BOX TO BE

REPLACE CROSSWALK - STRIPING AS REQUIRED

RIGHT LANE - RIGHT TURN" SIGN

PERMANENT LOCATION

COORDINATE WITH PIERCE TRANSIT FOR PERMANENT LOCATION

COORDINATE WITH CITY INSPECTOR FOR PERMANENT LOCATION

STRAIGHT

FOR PERMANENT LOCATION

PLAN

A PORTION OF THE NW 1/4 OF THE NW 1/4 OF SEC. 27, TWN. 20 N., RGE. 04 E. W.M. CITY OF PUYALLUP, PIERCE COUNTY, WASHINGTON.

RAISED PAVEMENT MARKERS

TYPE 2 RPM (REFLECTIVE)

WHITE AND RED

YELLOW AND RED
YELLOW AND YELLOW
WHITE - ONE SIDE ONLY
YELLOW - ONE SIDE ONLY

CITY STANDARD

RAISED FACE COLORS


TYPE 1 RPM COLORS

*TYPE 3 RPM COLORS


WHITE

YELLOW

TYPE 3W 8" RUMBLE BAR — WHITE
TYPE 3Y 8" RUMBLE BAR — YELLOW

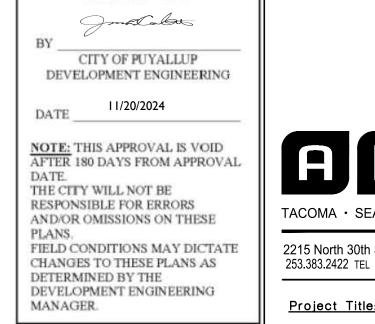

APPROVED

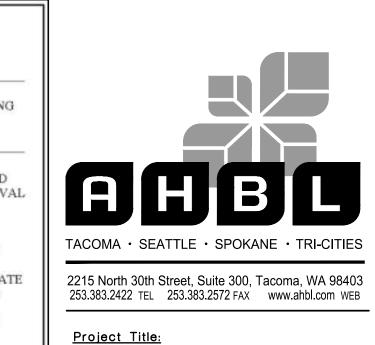

PUYALLUP 2ND STREET

APARTMENTS

SPP MANUFACTURING

P.O.BOX 64160

TACOMA, WA 98464

DON HUBER

2190606.10

SITE DEVELOPMENT

PERMIT SET

10/8/2024

10/11/2024

City of Puyallup

Development & Permitting Services

ISSUED PERMIT

Planning

Public Works

Traffic


Building

Engineering

Fire

Project No.

Issue Set & Date:

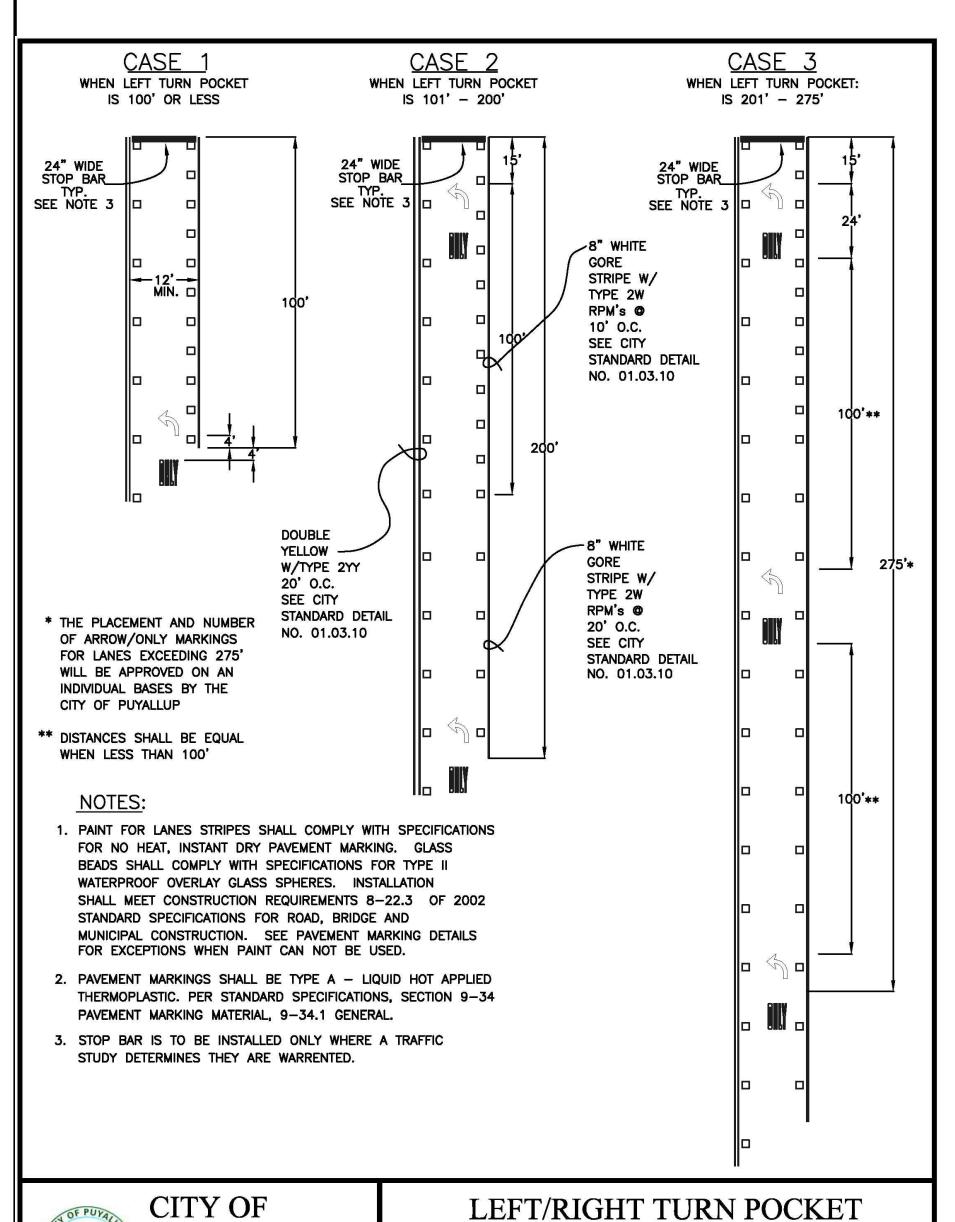

FILE NAME
F:\DWG\COMMON\STDS\CITY\2009\01_STR\01.03\01.03.0


ARROW AND ONLY LAYOUT

APPROVED BY COLLEEN HARRIS

 DATE APPROVED
 DATE REVISED
 SCALE

 07/01/2009
 09/11/2013
 1:40

01.03.06

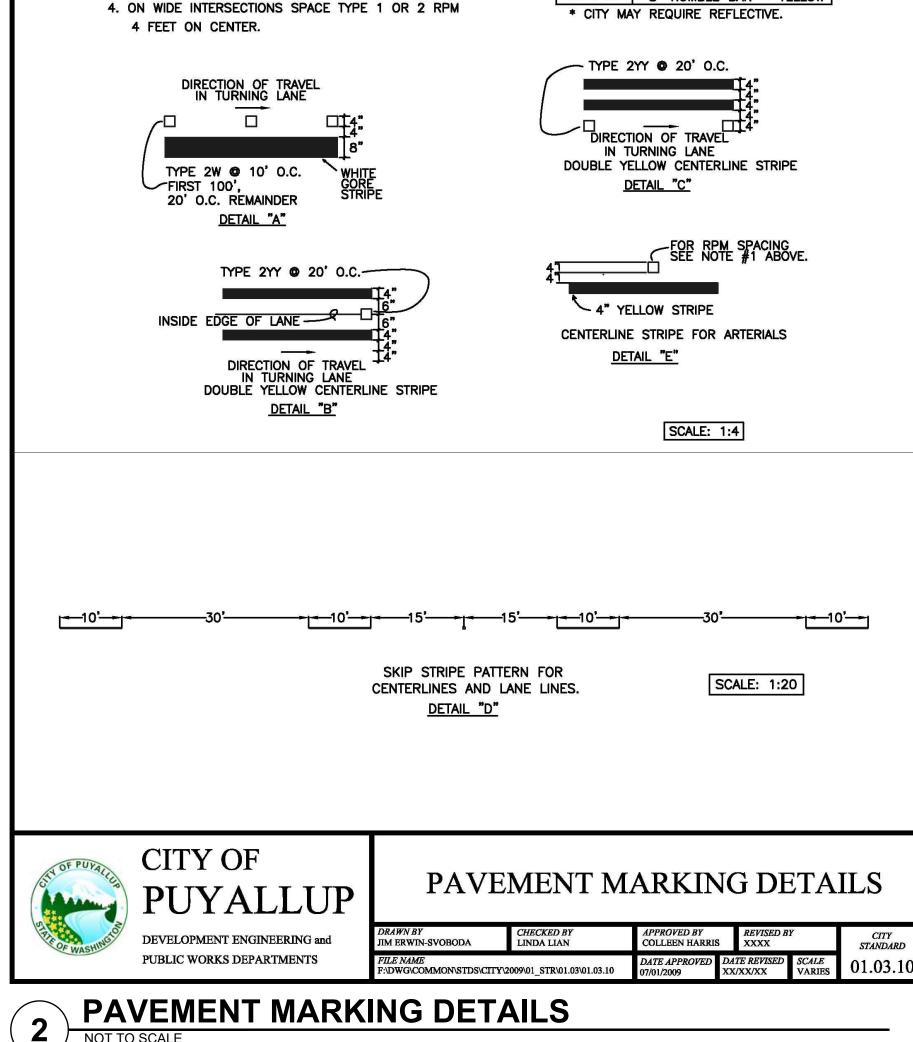

1. CENTERLINE STRIPE FOR CHANNELIZATION SHALL BE DETAIL B OR DETAIL C AS DIRECTED BY CITY. CENTERLINE STRIPE FOR

2. ROADS, UNLESS OTHERWISE DETERMINED BY THE CITY,

SHALL BE CLEARLY MARKED WITH CENTERLINE STRIPE,

DETAIL B OR DETAIL C OR COMBINATION OF DETAIL D

PAINTED. APPLIED 14 MILS WHEN WET.

AND DETAIL E.


3. NO PASSING ZONES IN ONE DIRECTION OR BOTH


ALL COLLECTORS SHALL BE DETAIL D WITH TYPE 2YY RPM

SPACED AT 80' INTERVALS ON TANGENTS AND HORZ. CURVES

WITH A RADIUS OF 5000' OR MORE AND 40' INTERVALS ON HORZ. CURVES LESS THAN 5000'. CENTERLINE STRIPE FOR ARTERIALS SHALL BE DETAIL E WITH RPM SPACING AS PREVIOUSLY DEFINED.

(ARTERIALS & COLLECTORS) LONGITUDINAL LINES SHALL BE

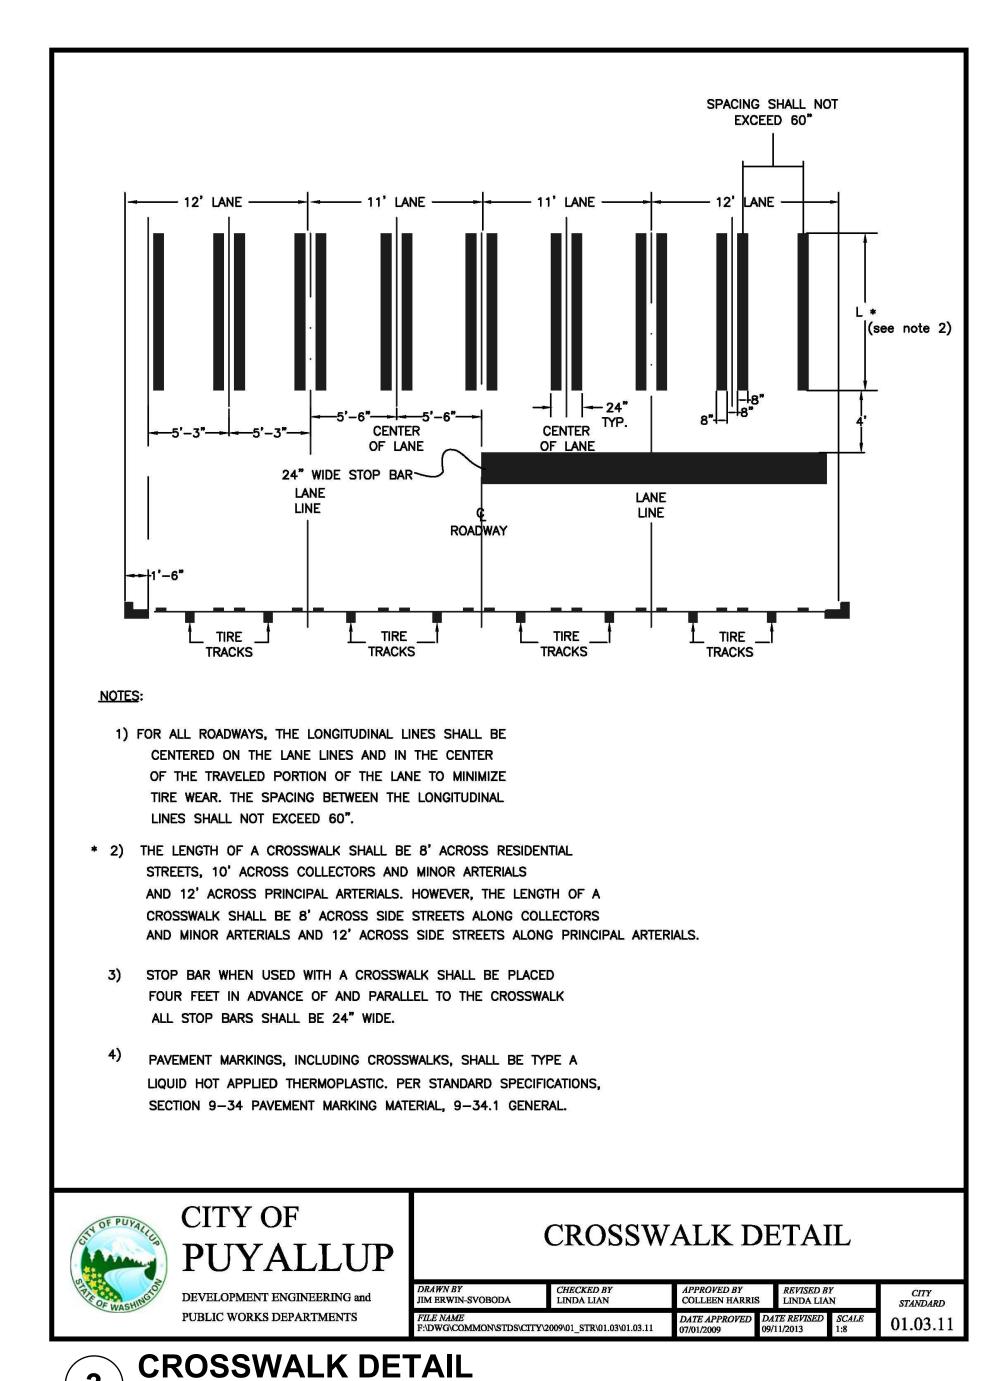

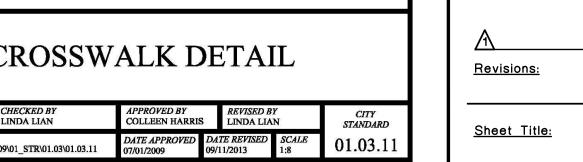



PUYALLUP

DEVELOPMENT ENGINEERING and

PUBLIC WORKS DEPARTMENTS


Know what's below. Call before you dig.


CHANNELIZATION NOTES AND DETAILS

Designed by: Drawn by: Checked by:

Sheet No.

A PORTION OF THE NW 1/4 OF THE NW 1/4 OF SEC. 27, TWN. 20 N., RGE. 04 E. W.M. CITY OF PUYALLUP, PIERCE COUNTY, WASHINGTON.

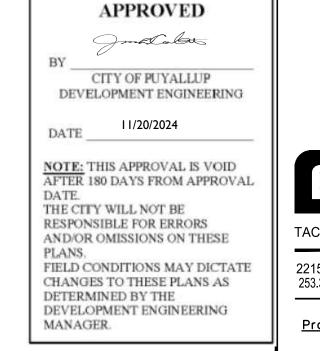

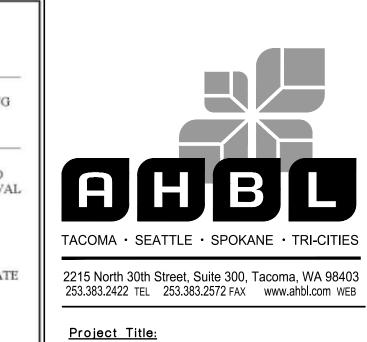

PUYALLUP 2ND STREET

APARTMENTS

SPP MANUFACTURING

P.O.BOX 64160 TACOMA, WA 98464

DON HUBER

2190606.10

SITE DEVELOPMENT

PERMIT SET

10/8/2024

10/11/2024

City of Puyallup

Development & Permitting Services

ISSUED PERMIT

Building

Engineering


Planning


Public Works


Traffic

<u>Project No.</u>

Issue Set & Date:

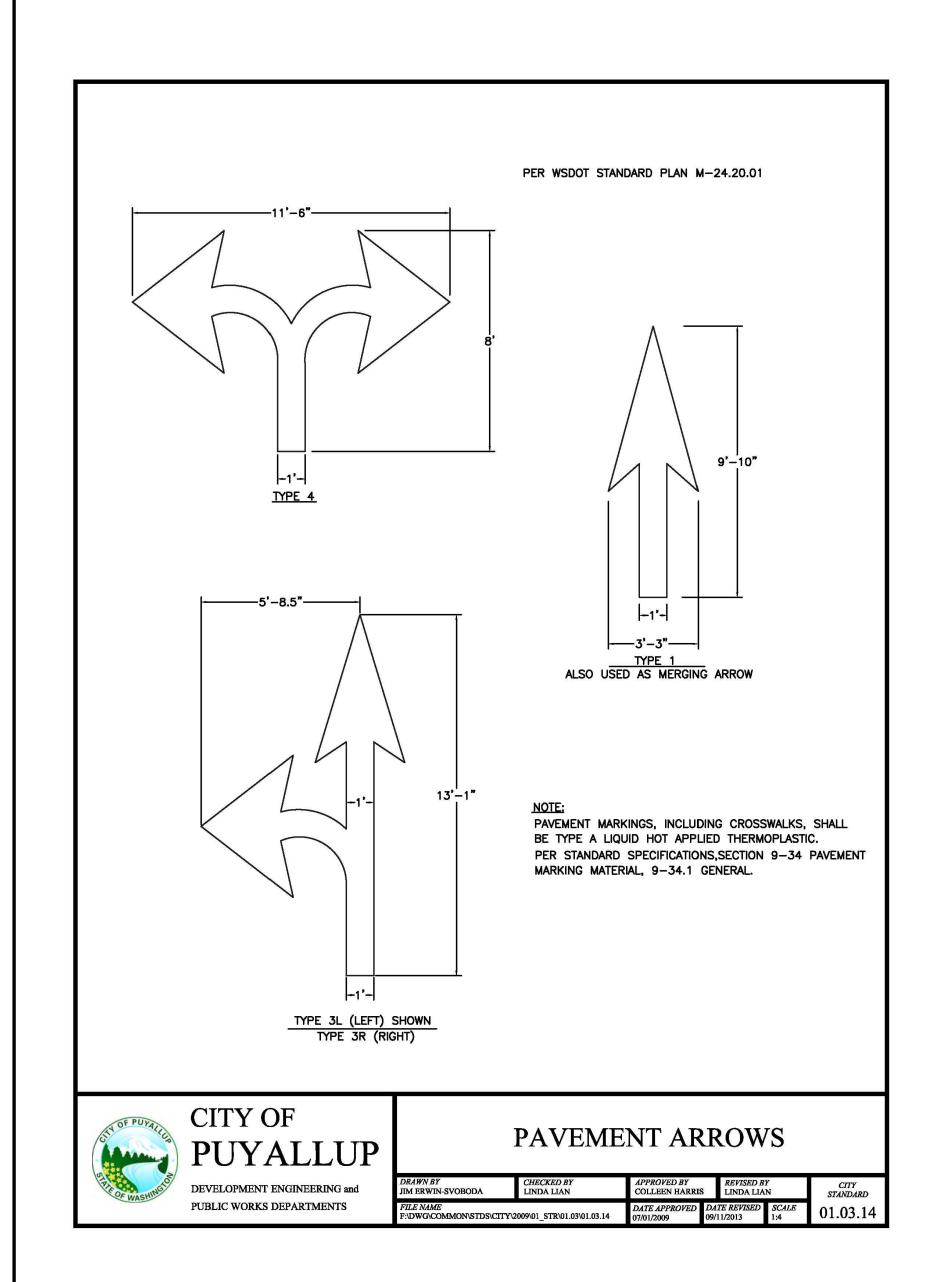

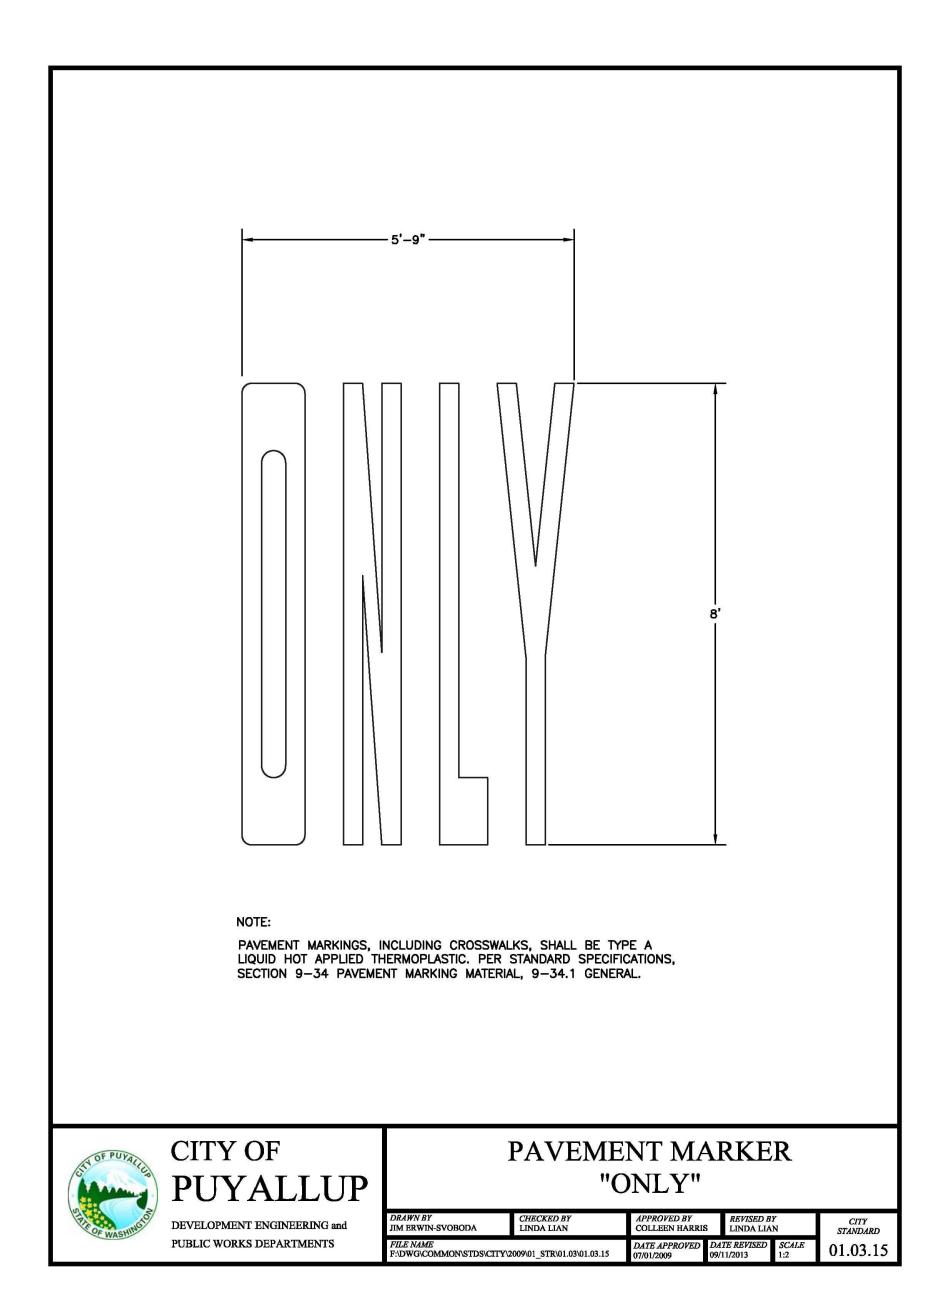

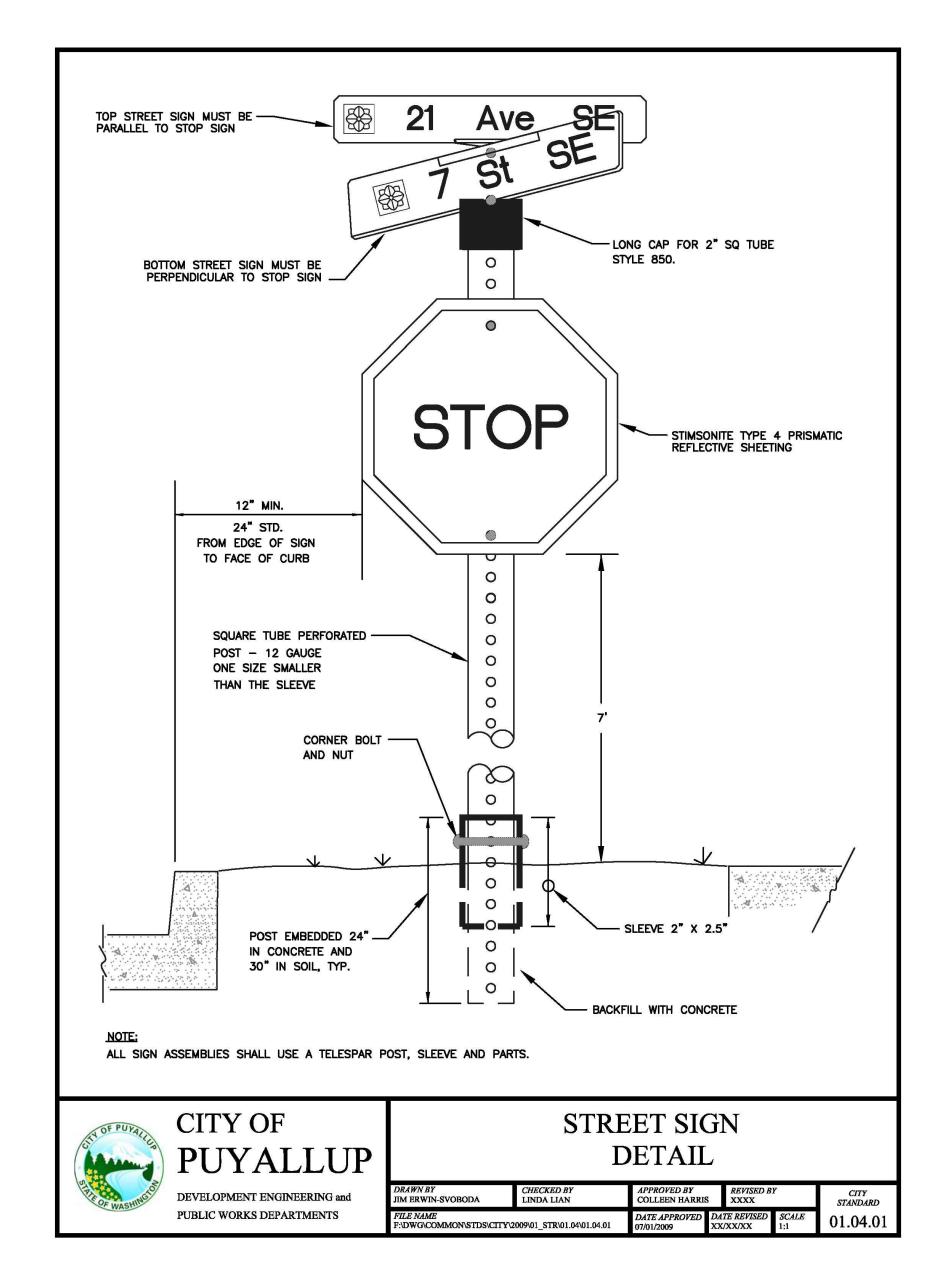










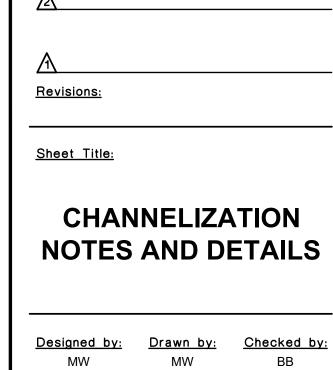

Sheet No.

A PORTION OF THE NW 1/4 OF THE NW 1/4 OF SEC. 27, TWN. 20 N., RGE. 04 E. W.M. CITY OF PUYALLUP, PIERCE COUNTY, WASHINGTON.

SDCB #7, STORMFILTER CATCH BASIN

-64 LF 12" PERF. CPEP @ 0.00% IE: 41.00

SDCB #8, STORMFILTER CATCH BASIN

1 46 LF 12" PERF. CPEP @ 0.00% IE: 41.00

46 LF 12" PERF. CPEP @ 0.00% IE: 41.00

SDCB #9, STORMFILTER CATCH BASIN

10' CITY OF PUYALLUP STORM EASEMENT

AFN 2530461

- REFER TO GRADING

ENLARGEMENT #4

14 LF 12" DI CL52

26.13% 10 LF 12" CPEP

@ 0.00%

4 LF 12" DI CL52

TC:44.94

FL: 44.44

@ 0.00%

@ 6.79%

TC:45.35

FL: 44.85

TC:45.63

FL: 45.13

FG: 41.76

SDCB #2~

TC:46.34-

SDCB #4

FL: 45.84

TC:46.42 FL: 45.92

TC:46.067

FL: 45.56

TC:46.12

5√% TC:46.42

FL: 45.62

FL: 45.92

33 LF 6" PVC-

-TC:46.43

FL: 45.93

rTC:46.42

FL: 45.92

FL: 45.92 TC:46.19 FL: 45.69

TC:46.42 FL: 45.77

TC:46.27


REFER TO GRADING

12" CONC NW IE: 41.69

12" CONC E IE: 41.69

5TH AVENUE NE

@ 4.92%

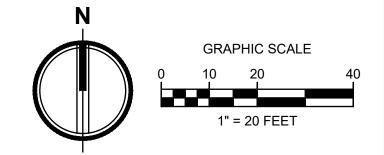

LEGEND

EG

 \times \times \times $^{\vee}$.

EXISTING GRADE

FINISH GRADE

TOP OF CURB

PROPOSED TYPE 1 CATCH BASIN

INFILTRATING RUNOFF FROM THE SITES EAST SLOPE

PROPOSED ROOF DRAIN

ROOF DRAIN CLEANOUT

THE SITES EAST SLOPE

PERMEABLE CONCRETE

CONCRETE

INFILTRATION DITCH, FOR

STORM STRUCTURE TABLE

SDCB #1

N 684379.01

E 1195036.57

SDCB #2

N 684379.14

E 1195026.57

SDCB #3

N 684314.79

E 1195035.78

SDCB #4

N 684315.00

E 1195025.78

SDCB #5

N 684269.02

E 1195035.21

SDCB #6

N 684269.15

E 1195025.21

N 684392.55

E 1195040.45

SDCB #8

N 684314.72

E 1195039.47

SDCB #9

N 684252.59

E 1195038.60

SDCB #10

N 684432.07

E 1194928.92

RDCO #1

N 684349.72

E 1194993.71

N 684350.28

E 1194948.71

RDCO #3

N 684299.48

E 1194946.08

RDCO #4

N 684291.57

E 1194992.99

RDCO #5

N 684269.14

E 1194992.66

RDCO #6

N 684221.58

E 1194992.12

N 684164.74

E 1194991.42

N 684165.09

E 1194963.06

RDCO #9

N 684181.90

E 1194946.50

RDCO #10

N 684213.79

E 1194947.02

STORM STRUCTURE TABLE

RIM = 45.14

IE = 41.00 (12" W)

IE = 41.00 (12" N)

IE = 41.00 (12" S)

RIM = 45.34

IE = 41.50 (6" SW)

IE = 41.00 (12" E)

IE = 41.00 (12" S)

RIM = 44.61

IE = 41.00 (12" S)

IE = 41.00 (12" N)

IE = 41.00 (12" E)

IE = 41.00 (12" W)

RIM = 44.96

IE = 41.00 (12" S)

IE = 41.00 (12" N)

IE = 41.00 (12" E)

RIM = 44.91

IE = 41.00 (12" W)

IE = 41.00 (12" N)

IE = 41.00 (12" S)

RIM = 45.22

IE = 41.00 (12" E

IE = 41.00 (12" N)

IE = 41.50 (6" W)

RIM = 45.05

RIM = 44.48

RIM = 44.89

IE = 42.14 (12" N)

RIM = 45.30

IE = 43.09 (8" SW)

IE = 43.09 (8" E)

RIM = 46.48

IE = 43.49 (6" W)

IE = 43.49 (6" S)

IE = 43.49 (6" NE)

RIM = 46.43

IE = 43.72 (6" E)

IE = 43.72 (6" S)

RIM = 46.46

IE = 43.97 (6" N)

RIM = 46.48

IE = 43.98 (6" N)

RIM = 46.48

IE = 43.10 (6" S)

IE = 43.10 (6" E)

RIM = 46.48

IE = 43.34 (6" S)

IE = 43.34 (6" N)

RIM = 47.11

IE = 43.62 (6" W)

IE = 43.62 (6" N)

RIM = 46.65

IE = 43.76 (6" NW)

IE = 43.76 (6" E)

RIM = 46.57

IE = 43.88 (6" SE)

IE = 43.88 (6" N)

RIM = 46.54

IE = 44.04 (6" S)

IE = 41.73 (12" W)

IE = 42.30 (12" S)

Jmb Calou CITY OF PUYALLUP DEVELOPMENT ENGINEERING 11/20/2024

> NOTE: THIS APPROVAL IS VOID AFTER 180 DAYS FROM APPROVAL THE CITY WILL NOT BE RESPONSIBLE FOR ERRORS

APPROVED

AND/OR OMISSIONS ON THESE PLANS. FIELD CONDITIONS MAY DICTATE CHANGES TO THESE PLANS AS DETERMINED BY THE DEVELOPMENT ENGINEERING MANAGER.

GENERAL NOTES

CONTRACTOR SHALL CONTACT UTILITY PURVEYORS PRIOR TO CONSTRUCTION.

2. FOR BEDDING AND BACKFILL SEE CITY STD NO. 06.01.01 ON SHEET C3.2.


3. SEE STORMWATER NOTES ON SHEET C3.2.


4. FOR STORM CLEANOUT, SEE DETAIL 3, SHEET C3.1.

5. ALL STORM DRAINS SHALL HAVE "NO DUMPING. DRAINS TO RIVER" STENCILED ADJACENT TO THEM. MARKINGS TO BE PRE-CUT 90ML TORCH DOWN HEAVY-DUTY, INTERSECTION GRADE PREFORMED THERMOPLASTIC PAVEMENT MARKING MATERIAL

PROVIDE FOUNDATION DRAINS PER STRUCTURAL PLANS. CONTRACTOR TO COORDINATE FOUNDATION DRAIN CONNECTIONS TO STORM SYSTEM. FOUNDAITION DRAINS SHALL NOT CONNECT TO ROOF DRAINS. FOUNDATION DRAIN CONNECTIONS SHALL BE 6" MIN. PVE @ 0.5% MIN. SLOPE. PROVIDE CLEANOUTS AT JUNCTIONS.

1. THE ABOVE QUANTITIES ARE ESTIMATES ONLY INTENDED FOR THE PERMITTING PROCESS DO NOT USE FOR BID PURPOSES. THE QUANTITIES DO NOT HAVE STRIPPING, COMPACTION, OR CUT OR FILL ADJUSTMENT FACTORS APPLIED TO THEM, NOR DO THEY ACCOUNT FOR PAVEMENT, SIDEWALK OR BUILDING SECTIONS.

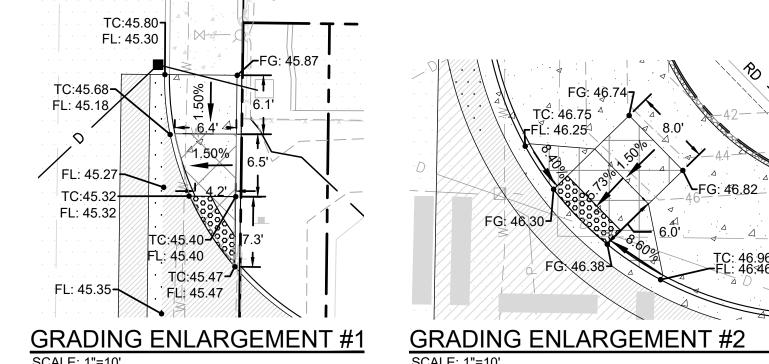

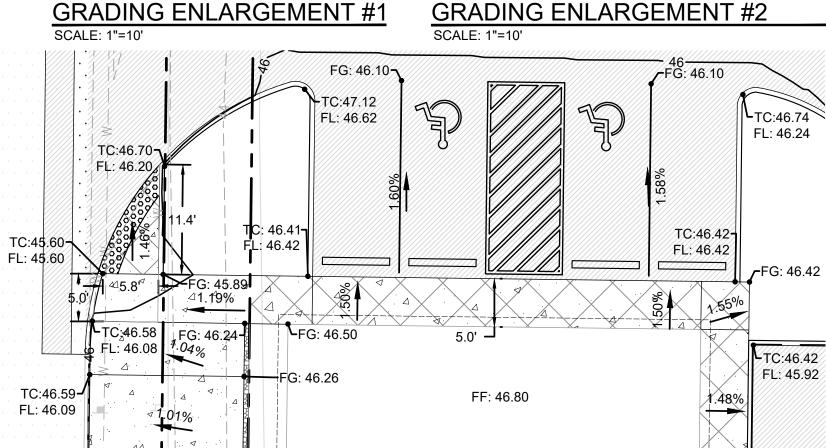

GRADING ENLARGEMENT #3 FG: 46.50 TC:46.42 FL:46.22 TC:46.74 L: 46.24 FL: 46.24 TC:47.31-FL: 46.60 FG: 47.50 FL: 46.81 TC:47.42 **r**TC:47.49 TC:47.89~ FL: 47.42 **√** FL: 46.93 FL: 47.35

GRADING ENLARGEMENT #4

EARTHWORK QUANTITIES CUT = 30 CUBIC YARDS FILL = 3,490 CUBIC YARDS NET = 3,460 CUBIC YARDS (IMPORT)

2215 North 30th Street, Suite 300, Tacoma, WA 98403 253.383.2422 TEL 253.383.2572 FAX www.ahbl.com WEB

PUYALLUP 2ND STREET APARTMENTS

Project Title:

SPP MANUFACTURING

P.O.BOX 64160 **TACOMA**, WA 98464 DON HUBER

<u>Project No.</u>


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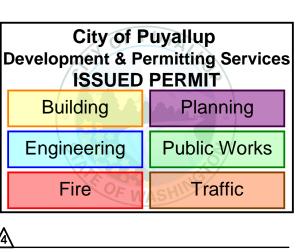
Issue Set & Date:

SITE DEVELOPMENT **PERMIT SET**

10/8/2024





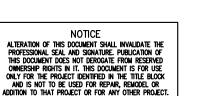

Revisions:

Sheet Title:

GRADING AND DRAINAGE PLAN

Designed by: Drawn by: Checked by:

Sheet No.

12 of 25 Sheets

SSMH#584 RIM: 47.14 —

Know what's below.

Call before you dig.

COC: 36.64

12" CONC E-W

11 LF 8" PVC-

SDCB #10 →

RELOCATE EXISTING CB

22 LF 8" PVC-@ 7.16%

REFER TO GRADING

ENLARGEMENT #3

FG: 46.39 FG: 46.35

FG: 46.42 FG: 46.38

@ 1.03%

UPDATE STCB #587 TO

STANDARD 02.01.05

STCB#587 RIM:46.12

8" CONC SW IE:43.92

C3.1 COMPLY WITH PUYALLUP

REFER TO GRADING

ENLARGEMENT #2

18" N CONC IE: 39.07

8" CONC NE IE: 42.57 12" CONC E IE: 40.52 12" CONC S IE: 39.87

12" CONC W IE: 40.02

8" CONC NW IE: 42.57

12" CONC E-W-S

COC: 36.88

LADDER N

SSMH#583 RIM: 47.28-

STCB#585 RIM: 46.11

8" CONC SE IE: 43.87

OUTSIDEOF DRIVEWAY APPROACH

STMH#589 RIM: 46.00

18" CONC N IE: 38.60

18" CONC S IE: 38.65

8" CONC NW IE: 41.50

8" CONC NE IE: 41.75

STCB#590 RIM: 45.26

8" CONC SE IE: 43.16

· CLEAR AREA TO EXPOSE

EXISTING CATCH BASIN

REFER TO GRADING

ENLARGEMENT #1

@ 0.50%

FG: 46.43

● FF: 46.80

►RDCO #10

@ 0.50%

FG: 47.17

SSMH#582 RIM: 47.20-

COC: 37.20

LADDER S

SSMH#581 RIM: 47.37 -

XXX NW IE: 38.62 LADDER W

COC: 37.64

12" CONC E-W


RDCO#6-

RDCO #7

58 LF 6" PVC—

@ 0.84%

A PORTION OF THE NW 1/4 OF THE NW 1/4 OF SEC. 27, TWN. 20 N., RGE. 04 E. W.M. CITY OF PUYALLUP, PIERCE COUNTY, WASHINGTON.

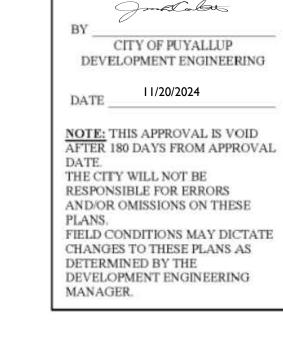

APPROVED



PUYALLUP 2ND STREET APARTMENTS

Client:
SPP MANUFACTURING

P.O.BOX 64160 TACOMA, WA 98464 DON HUBER

<u>Project No.</u>

2190606.10


Issue Set & Date:


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SITE DEVELOPMENT PERMIT SET

10/8/2024





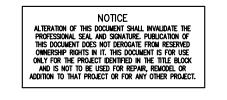
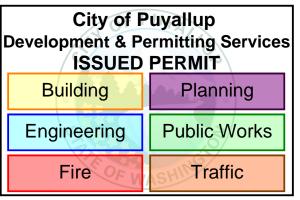
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Revisions:

Sheet Title:

Shoot Title

DRAINAGE NOTES
AND DETAILS

Designed by: Drawn by: Checked by:


MW MW BB


Sheet No.


C3.1

13 of 25 Sheets

6 CATCH BASIN FRAME AND GRATE
NOT TO SCALE

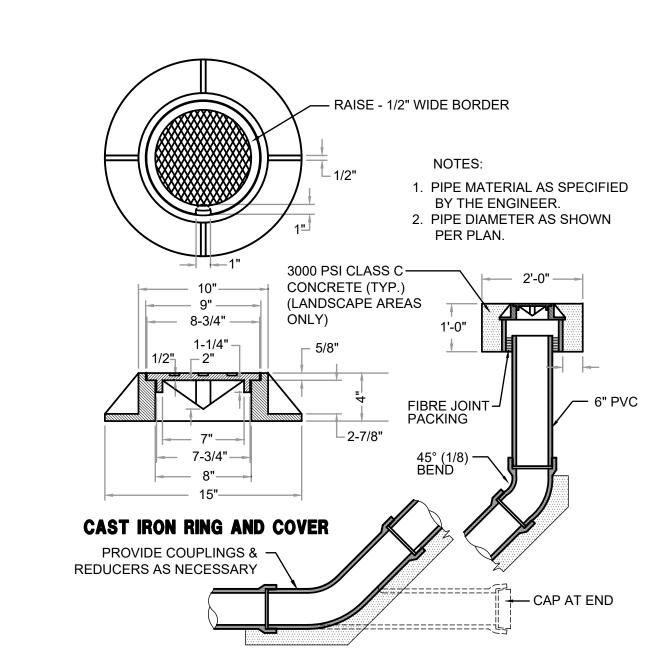

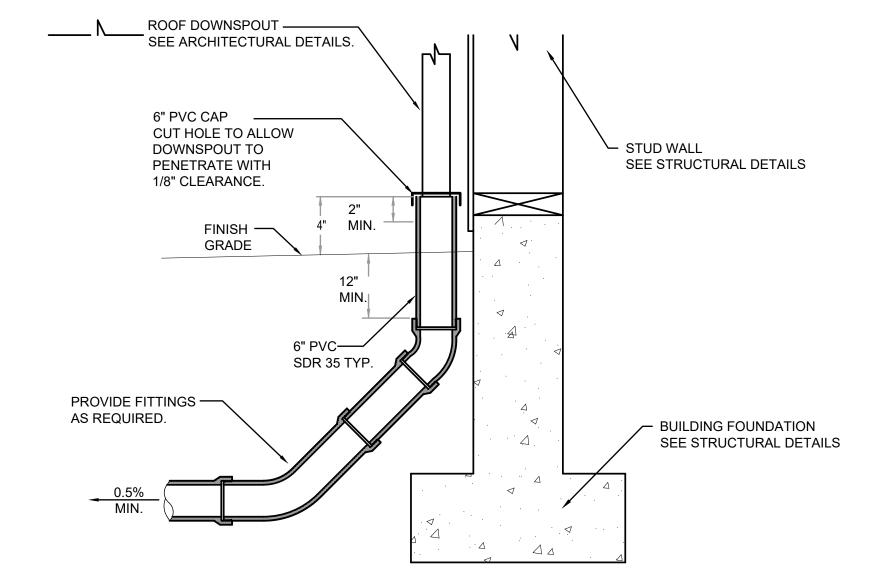

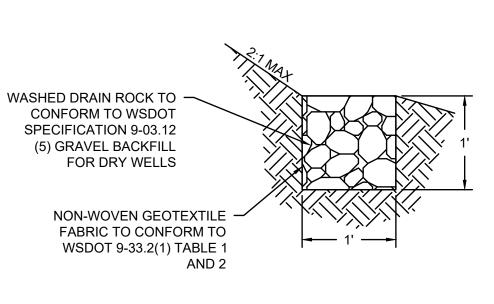

INFILTRATION DITCH

INFILTRATION TRENCH DETAIL 2

ASPHALT PAVEMENT SECTION

WASHED DRAIN ROCK,

SEE GRADATION NOTES

HIGH GROUNDWATER ELEV:

~31.2 PER PROJECT GEOTECH


NATIVE MATERIAL


DO NOT COMPACT

STORM CLEANOUT

DOWNSPOUT CONNECTION

NOT TO SCALE

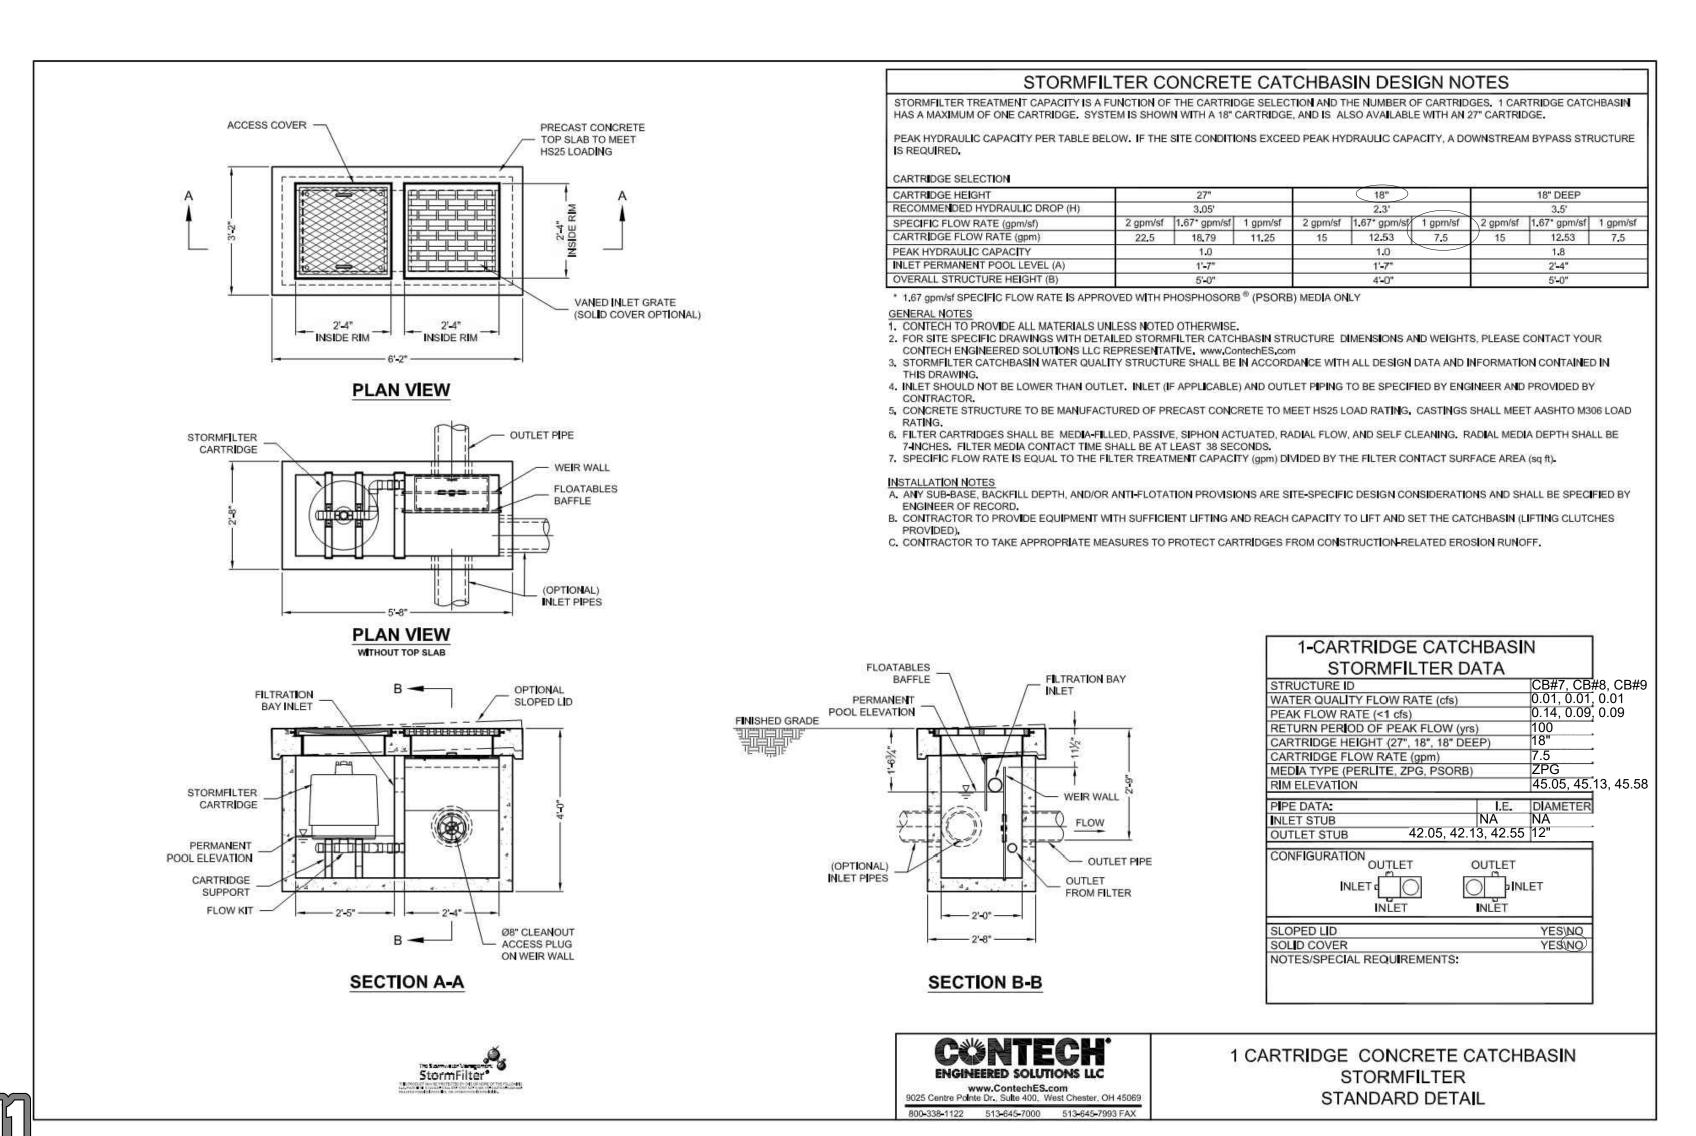

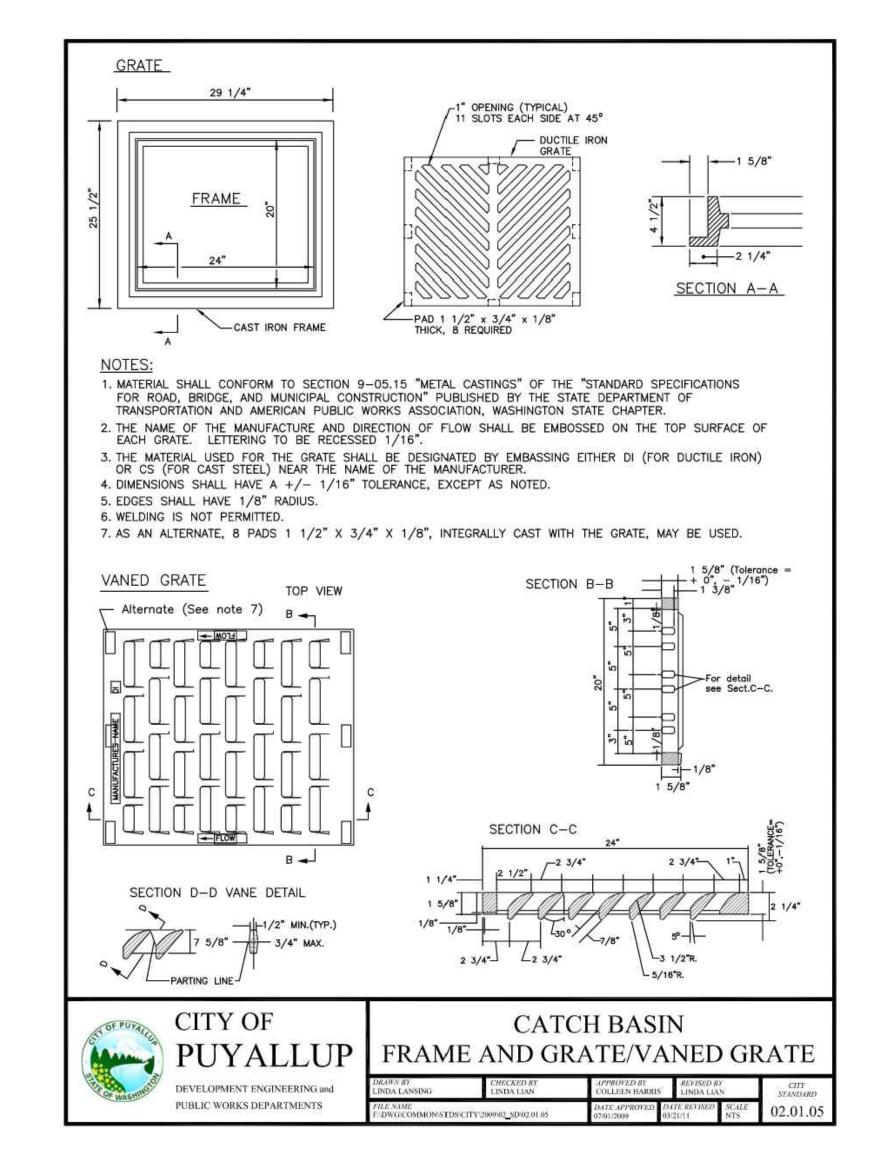



NATIVE MATERIAL

BACKFILL, COMPACT TO

90% OF MAX DENSITY

IE = 41.0 (TYP.)

BOTTOM IE: 38.5

1. WASHED DRAIN ROCK

SHALL CONFORM TO

WSDOT SPECIFICATION 9-03.12 (5) GRAVEL

BACKFILL FOR DRY WELLS

EXCAVATE INFILTRATION TRENCHES TO FINAL GRADE ONLY AFTER ALL DISTURBED AREAS IN

THE UPGRADIENT PROJECT DRAINAGE AREA HAVE BEEN PERMANENTLY STABILIZED. THE

SCARIFIED TO A MINIMUM DEPTH OF 3 INCHES AFTER FINAL EXCAVATION TO RESTORE

PRIOR TO BACKFILL OF INFILTRATION TRENCH WITH GRAVEL, CONTRACTOR SHALL

ECOLOGY STORMWATER MANAGEMENT MANUAL FOR WESTERN WASHINGTON.

COORDINATE INFILTRATION VERIFICATION TESTING WITH GEOTECHNICAL ENGINEER

INFILTRATION VERIFICATION REPORT SHALL BE PROVIDED TO ENGINEER AND CITY OF

PUYALLUP. VERIFICATION TESTING FOR INFILTRATION TRENCH SHALL CONSIST OF A MINIMUM

OF 1 MODIFIED FALLING-HEAD PERCOLATION TEST. TESTING SHALL BE IN ACCORDANCE WITH

SIDEWALLS AND BOTTOM OF THE INFILTRATION FACILITY EXCAVATION SHALL BE RAKED OR

GRADATION NOTES:

INFILTRATION RATES.

WRAP TOP AND SIDES OF

GALLERY WITH GEOTEXTILE

TOP IE: 42.5

FABRIC MIRAFI 140N OR


APPROVED EQUIVALENT

12" PERF CPEP @ 0.00%

5 STORMFILTER

NOT TO SCALE

A PORTION OF THE NW 1/4 OF THE NW 1/4 OF SEC. 27, TWN. 20 N., RGE. 04 E. W.M. CITY OF PUYALLUP, PIERCE COUNTY, WASHINGTON.

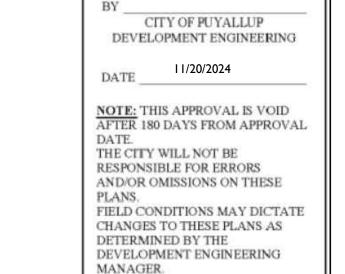

APPROVED

molabet



PUYALLUP 2ND STREET

APARTMENTS

SPP MANUFACTURING

P.O.BOX 64160 **TACOMA, WA 98464**

DON HUBER


<u>Project No.</u>

2190606.10

Issue Set & Date:

SITE DEVELOPMENT **PERMIT SET**



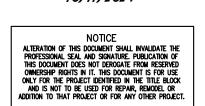

City of Puyallup **Development & Permitting Services ISSUED PERMIT** Building Planning **Public Works** Engineering

Traffic

Fire

Revisions:

Sheet Title:

DRAINAGE NOTES AND DETAILS

Drawn by: Checked by:

Sheet No.

14 of 25 Sheets

STORMWATER NOTES: MEETING. TO AS THE "CITY STANDARDS"). BE ON SITE DURING CONSTRUCTION. CONTACTED IMMEDIATELY IF A CONFLICT EXISTS.

BACKFILL MATERIAL

SEE NOTE 3

4" MIN. FOR 27" PIPE AND SMALLER

6" MIN. FOR PIPE LARGER THAN 27"

1/2 O.D.

UNDISTURBED OR COMPACTED

PIPE TRENCHING

BEDDING AND BACKFILL

V STOCKMAN

DATE APPROVED SCALE

STANDARD

06.01.01

APPROVED BY MARK PALMER

CHECKED BY TED HILL

F\DWG\COMMON\STDS\CITYSTDS\06_MISC\06.01\06.01.01

TRENCHING SHALL MEET THE REQUIREMENTS OF SECTION 7-08.3(1)A AND 2-06.3(1)

2. BEDDING MATERIAL SHALL CONFORM TO 9-03.12(3) GRAVEL BACKFILL FOR PIPE

GRAVEL BACKFILL SHALL CONFORM TO 9-03.12(1)A GRAVEL BACKFILL FOR

JIM ERWIN-SVOBODA

FILE NAME

PIPE TRENCHING BEDDING AND BACKFILL

1. ALL WORK IN CITY RIGHT-OF-WAY REQUIRES A PERMIT FROM THE CITY OF PUYALLUP. PRIOR TO ANY WORK COMMENCING, THE GENERAL CONTRACTOR SHALL ARRANGE FOR A PRECONSTRUCTION MEETING AT THE DEVELOPMENT SERVICES CENTER TO BE ATTENDED BY ALL CONTRACTORS THAT WILL PERFORM WORK SHOWN ON THE ENGINEERING PLANS, REPRESENTATIVES FROM ALL APPLICABLE UTILITY COMPANIES, THE PROJECT OWNER AND APPROPRIATE CITY STAFF. CONTACT ENGINEERING SERVICES TO SCHEDULE THE MEETING (253) 841-5568. THE CONTRACTOR IS RESPONSIBLE TO HAVE THEIR OWN APPROVED SET OF PLANS AT THE

- 2. AFTER COMPLETION OF ALL ITEMS SHOWN ON THESE PLANS AND BEFORE ACCEPTANCE OF THE PROJECT, THE CONTRACTOR SHALL OBTAIN A "PUNCH LIST" PREPARED BY THE CITY'S INSPECTOR DETAILING REMAINING ITEMS OF WORK TO BE COMPLETED. ALL ITEMS OF WORK SHOWN ON THESE PLANS SHALL BE COMPLETED TO THE SATISFACTION OF THE CITY PRIOR TO ACCEPTANCE OF THE WATER SYSTEM AND PROVISION OF SANITARY
- 3. ALL MATERIALS AND WORKMANSHIP SHALL CONFORM TO THE STANDARD SPECIFICATIONS FOR ROAD, BRIDGE. AND MUNICIPAL CONSTRUCTION (HEREINAFTER REFERRED TO AS THE "STANDARD SPECIFICATIONS"), WASHINGTON STATE DEPARTMENT OF TRANSPORTATION AND AMERICAN PUBLIC WORKS ASSOCIATION, WASHINGTON STATE CHAPTER, LATEST EDITION, UNLESS SUPERSEDED OR AMENDED BY THE CITY OF PUYALLUP CITY STANDARDS FOR PUBLIC WORKS ENGINEERING AND CONSTRUCTION (HEREINAFTER REFERRED
- 4. A COPY OF THESE APPROVED PLANS AND APPLICABLE CITY DEVELOPER SPECIFICATIONS AND DETAILS SHALL
- 5. ANY REVISIONS MADE TO THESE PLANS MUST BE REVIEWED AND APPROVED BY THE DEVELOPER'S ENGINEER AND THE ENGINEERING SERVICES STAFF PRIOR TO ANY IMPLEMENTATION IN THE FIELD. THE CITY SHALL NOT
- 6. THE CONTRACTOR SHALL HAVE ALL UTILITIES VERIFIED ON THE GROUND PRIOR TO ANY CONSTRUCTION. CALL (811) AT LEAST TWO WORKING DAYS IN ADVANCE. THE OWNER AND HIS/HER ENGINEER SHALL BE
- 7. ANY STRUCTURE AND/OR OBSTRUCTION WHICH REQUIRE REMOVAL OR RELOCATION RELATING TO THIS PROJECT, SHALL BE DONE SO AT THE DEVELOPER'S EXPENSE.
- 8. DURING CONSTRUCTION, ALL EXISTING AND NEWLY INSTALLED DRAINAGE STRUCTURES SHALL BE PROTECTED
- 9. ALL STORM MANHOLES SHALL CONFORM TO CITY STANDARD DETAIL NO. 02.01.01. FLOW CONTROL MANHOLE/OIL WATER SEPARATOR SHALL CONFORM TO CITY STANDARD DETAIL NO. 02.01.06 AND 02.01.07.
- 11. CATCH BASINS TYPE I SHALL CONFORM TO CITY STANDARD DETAIL NO.02.01.02 AND 02.01.03 AND SHALL
- 12. CATCH BASINS TYPE II SHALL CONFORM TO CITY STANDARD DETAIL NO.02.01.04 AND SHALL BE USED FOR DEPTHS GREATER THAN 5 FEET FROM TOP OF THE GRATE TO THE INVERT OF THE STORM PIPE.
- 13. CAST IRON OR DUCTILE IRON FRAME AND GRATE SHALL CONFORM TO CITY STANDARD DETAIL NO.02.01.05. GRATE SHALL BE MARKED WITH "DRAINS TO STREAM". SOLID CATCH BASIN LIDS (SQUARE UNLESS NOTED AS round) SHALL CONFORM TO WSDOT STANDARD PLAN B-30.20-04 (OLYMPIC FOUNDRY NO. SM60 OR EQUAL). VANED GRATES SHALL CONFORM TO WSDOT STANDARD PLAN B-30.30-03 (OLYMPIC FOUNDRY
- a. THE USE OF ANY OTHER TYPE SHALL BE REVIEWED AND APPROVED BY THE ENGINEERING SERVICES STAFF PRIOR TO INSTALLATION.
- b. PVC PIPE SHALL BE PER ASTM D3034, SDR 35 FOR PIPE SIZE 15-INCH AND SMALLER AND F679 FOR PIPE SIZES 18 TO 27 INCH. MINIMUM COVER ON PVC PIPE SHALL BE 3.0 FEET.
- c. CONCRETE PIPE SHALL CONFORM TO THE WSDOT STANDARD SPECIFICATIONS FOR CONCRETE UNDERDRAIN PIPE. MINIMUM COVER ON CONCRETE PIPE SHALL NOT LESS THAN 3.0 FEET.
- DUCTILE IRON PIPE SHALL BE 1.0 FOOT.
- SHALL BE PER ASTM F1417. MINIMUM COVER OVER POLYPROPYLENE PIPE SHALL BE 3-FEET.
- 16. STORM PIPE SHALL BE A MINIMUM OF 10 FEET AWAY FROM BUILDING FOUNDATIONS AND/OR ROOF LINES.
- 17. ALL STORM DRAIN MAINS SHALL BE TESTED AND INSPECTED FOR ACCEPTANCE AS OUTLINED IN SECTION 406 OF THE CITY OF PUYALLUP SANITARY SEWER SYSTEM STANDARDS.
- 18. ALL TEMPORARY SEDIMENTATION AND EROSION CONTROL MEASURES, AND PROTECTIVE MEASURES FOR CRITICAL

- BE RESPONSIBLE FOR ANY ERRORS AND/OR OMISSIONS ON THESE PLANS.

- NO. SM60V OR EQUAL).

- d. DUCTILE IRON PIPE SHALL BE CLASS 50, CONFORMING TO AWWA C151. MINIMUM COVER ON
- e. POLYPROPYLENE PIPE (PP) SHALL BE DUAL WALLED, HAVE A SMOOTH INTERIOR AND EXTERIOR CORRUGATIONS AND MEET WSDOT 9-05.24(1). 12-INCH THROUGH 30-INCH PIPE SHALL MEET OR EXCEED ASTM F2736 AND AASHTO M330, TYPE S, OR TYPE D. 36-INCH THROUGH 60-INCH PIPE SHALL MEET OR EXCEED ASTM F2881 AND AASHTO M330, TYPE S, OR TYPE D. TESTING
- 15. TRENCHING, BEDDING, AND BACKFILL FOR PIPE SHALL CONFORM TO CITY STANDARD DETAIL NO. 06.01.01.

(now what's below. Call before you dig. PIPE

BEDDING

MATERIAL

SEE NOTE 2

OF THE WSDOT SPECIFICATIONS.

FOUNDATIONS, CLASS A.

CITY OF

PUYALLUP

OFFICE

THE CITY ENGINEER

Project Title:

- 10. MANHOLE RING AND COVER SHALL CONFORM TO CITY STANDARD DETAIL 06.01.02.
- BE USED ONLY FOR DEPTHS LESS THAN 5 FEET FROM TOP OF THE GRATE TO THE INVERT OF THE STORM PIPE.
- CITY OF PUYALLUP CITY STANDARDS STORM REVISED 10/2019
- 14. STORMWATER PIPE SHALL BE ONLY PVC, CONCRETE, DUCTILE IRON, OR DUAL WALLED POLYPROPYLENE PIPE.

- AREAS AND SIGNIFICANT TREES SHALL BE INSTALLED PRIOR TO INITIATING ANY CONSTRUCTION ACTIVITIES.

ILLUMINATION NOTES:

AND SPECIFICATIONS

CONSTRUCTION START.

ILLUMINATION WORK.

DAMAGE TO UTILITIES.

CONTRACTOR IN THE FIELD.

CITY TRAFFIC ENGINEER PRIOR TO CONSTRUCTION.

LOCATED BY THE CONTRACTOR WITH DIRECTION FROM THE CITY.

9. CONTRACTOR SHALL ADJUST JUNCTION BOX LIDS TO BE FLUSH WITH TOP OF SIDEWALK.

FRAMES WITH A NON-SLIP COATING ON THE TOP SURFACE EQUAL TO MEBAC1 OR SLIPNOT#3.

ROADWAY NOTES: 1. ALL WORK IN CITY RIGHT-OF-WAY REQUIRES A PERMIT FROM THE CITY OF PUYALLUP. PRIOR TO ANY WORK COMMENCING, THE GENERAL CONTRACTOR SHALL ARRANGE FOR A PRECONSTRUCTION MEETING AT THE DEVELOPMENT SERVICES CENTER TO BE ATTENDED BY ALL CONTRACTORS THAT WILL PERFORM WORK SHOWN ON THE ENGINEERING PLANS, REPRESENTATIVES FROM ALL APPLICABLE UTILITY COMPANIES, THE PROJECT OWNER AND APPROPRIATE CITY STAFF. CONTACT ENGINEERING SERVICES TO SCHEDULE THE MEETING (253) 841-5568. THE CONTRACTOR IS RESPONSIBLE TO HAVE THEIR OWN APPROVED SET OF PLANS AT THE MEETING.

1. ALL WORK SHALL BE IN ACCORDANCE WITH CITY OF PUYALLUP PUBLIC WORKS STANDARDS AND WSDOT STANDARDS

2. THE LOCATIONS OF FEATURES SHOWN ARE APPROXIMATE AND SHALL BE VERIFIED BY THE CONTRACTOR PRIOR TO

3. UTILITY LOCATIONS ARE APPROXIMATE AND SHALL BE VERIFIED IN THE FIELD BY THE CONTRACTOR PRIOR TO ANY

4. ALL WORK SHALL BE CONSISTENT WITH UTILITY AGENCY REQUIREMENTS. THE CONTRACTOR SHALL COORDINATE WITH

AFFECTED UTILITY AGENCIES THROUGHOUT THE PROJECT. THE CONTRACTOR SHALL BE RESPONSIBLE FOR ANY

5. CONDUIT LOCATIONS ARE SHOWN FOR ILLUSTRATIVE PURPOSES. ACTUAL LOCATIONS SHALL BE DETERMINED BY THE

7. THE LOCATION OF ALL CONDUITS, JUNCTION BOXES, POLES, AND CABINETS SHOWN ON THIS PLAN MAY BE ADJUSTED IN

THE FIELD TO AVOID CONFLICTS AND MEET ADA REQUIREMENTS. ALL FINAL LOCATIONS SHALL BE APPROVED BY THE


6. CONTRACTOR SHALL COORDINATE WITH THE CITY SIGNAL/ILLUMINATION TECHNICIAN AT 253.405.4390 PRIOR TO

8. JUNCTION BOX LOCATIONS SHOWN ARE FOR ILLUSTRATIVE PURPOSES ONLY. JUNCTION BOXES SHALL BE FIELD


10. ANY NEW JUNCTION BOX WHICH WILL BE LOCATED WITHIN OR PARTIALLY WITHIN SIDEWALK SHALL HAVE LIDS AND


- 2. AFTER COMPLETION OF ALL ITEMS SHOWN ON THESE PLANS AND BEFORE ACCEPTANCE OF THE PROJECT. THE CONTRACTOR SHALL OBTAIN A "PUNCH LIST" PREPARED BY THE CITY'S INSPECTOR DETAILING REMAINING ITEMS OF WORK TO BE COMPLETED. ALL ITEMS OF WORK SHOWN ON THESE PLANS SHALL BE COMPLETED TO THE SATISFACTION OF THE CITY PRIOR TO ACCEPTANCE OF THE WATER SYSTEM AND PROVISION OF SANITARY SEWER
- 3. ALL MATERIALS AND WORKMANSHIP SHALL CONFORM TO THE STANDARD SPECIFICATIONS FOR ROAD, BRIDGE. AND MUNICIPAL CONSTRUCTION (HEREINAFTER REFERRED TO AS THE "STANDARD SPECIFICATIONS"), WASHINGTON STATE DEPARTMENT OF TRANSPORTATION AND AMERICAN PUBLIC WORKS ASSOCIATION WASHINGTON STATE CHAPTER, LATEST EDITION, UNLESS SUPERSEDED OR AMENDED BY THE CITY OF PUYALLUP CITY STANDARDS FOR PUBLIC WORKS ENGINEERING AND CONSTRUCTION (HEREINAFTER REFERRED TO AS THE "CITY STANDARDS").
- 4. A COPY OF THESE APPROVED PLANS AND APPLICABLE CITY DEVELOPER SPECIFICATIONS AND DETAILS SHALL BE ON SITE DURING CONSTRUCTION.
- 5. ANY REVISIONS MADE TO THESE PLANS MUST BE REVIEWED AND APPROVED BY THE DEVELOPER'S ENGINEER AND THE ENGINEERING SERVICES STAFF PRIOR TO ANY IMPLEMENTATION IN THE FIELD. THE CITY SHALL NOT BE RESPONSIBLE FOR ANY ERRORS AND/OR OMISSIONS ON THESE PLANS.
- 6. THE CONTRACTOR SHALL HAVE ALL UTILITIES VERIFIED ON THE GROUND PRIOR TO ANY CONSTRUCTION. CALL (811) AT LEAST TWO WORKING DAYS IN ADVANCE. THE OWNER AND HIS/HER ENGINEER SHALL BE CONTACTED IMMEDIATELY IF A CONFLICT EXISTS.
- 7. ANY STRUCTURE AND/OR OBSTRUCTION WHICH REQUIRES REMOVAL OR RELOCATION RELATING TO THIS PROJECT, SHALL BE DONE SO AT THE DEVELOPER'S EXPENSE.
- 8. MONUMENTS SHALL BE INSTALLED AT ALL STREET INTERSECTIONS, AT ANGLE POINTS, AND POINTS OF CURVATURE IN EACH STREET. ALL BOUNDARY MONUMENTS MUST BE INSTALLED ACCORDING TO THE WASHINGTON STATE SUBDIVISION LAWS.
- 9. CURB AND GUTTER INSTALLATION SHALL CONFORM TO CITY STANDARD DETAIL 01.02.09.
- 10. SIDEWALKS AND DRIVEWAYS SHALL BE INSTALLED AS LOTS ARE BUILT ON. SIDEWALKS AND DRIVEWAYS SHALL CONFORM TO CITY STANDARD DETAIL 01.02.01, 01.02.02 AND 01.02.12. IF ASPHALT IS DAMAGED DURING REPLACEMENT OF CURB AND GUTTER, THE REPAIR SHALL CONFORM TO CITY STANDARD DETAIL 01.02.10.
- 11. THE SURROUNDING GROUND (5 FEET BEYOND THE BASE) FOR ALL POWER TRANSFORMERS, TELEPHONE/TV PEDESTALS, AND STREET LIGHT MAIN DISCONNECTS SHALL BE GRADED TO A POSITIVE 2 PERCENT SLOPE FROM TOP OF CURB.
- 12. SIGNAGE AND TRAFFIC CONTROL DEVICES ARE SAFETY ITEMS AND SHALL BE INSTALLED PRIOR TO ISSUANCE OF ANY CERTIFICATE OF OCCUPANCY OR PLAT APPROVAL. HOWEVER, IN LARGER DEVELOPMENTS, EXACT LOCATIONS OF STOP AND YIELD SIGNS MAY NEED TO BE DETERMINED AFTER FULL BUILDOUT WHEN TRAFFIC PATTERNS HAVE BEEN ESTABLISHED. IN THIS CASE, CONTRACTOR SHALL PROVIDE INDICATED "CITY-PLACED" SIGNS, SIGNPOSTS, AND BRACKETS TO THE CITY SIGN SPECIALIST (253) 841-5471 FOR LATER INSTALLATION BY THE CITY. ALL SIGNAGE SHALL BE IN ACCORDANCE WITH THE MANUAL ON UNIFORM TRAFFIC CONTROL DEVICES (MUTCD).
- 13. PRIOR TO ANY SIGN OR STRIPING INSTALLATION OR REMOVAL THE CONTRACTOR SHALL CONTACT THE CITY SIGN SPECIALIST (253) 841-5471 TO ARRANGE FOR AN ON-SITE MEETING TO DISCUSS PLACEMENT AND UNIFORMITY.
- 14. NEW OR REVISED STOP SIGNS OR YIELD SIGNS SHALL BE ADVANCE WARNED USING THE PROCEDURE OUTLINED IN THE MUTCD. ADVANCE WARNING SIGNS AND FLAGS SHALL BE MAINTAINED BY INSTALLER FOR 30 DAYS AND THEN REMOVED.


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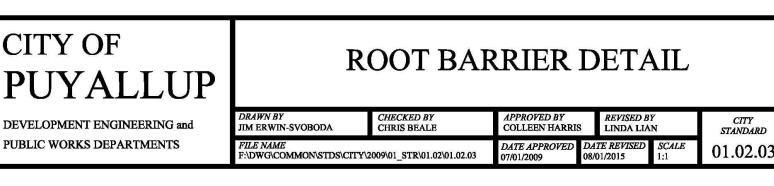


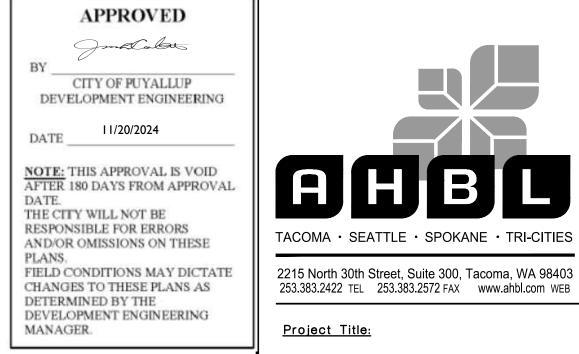



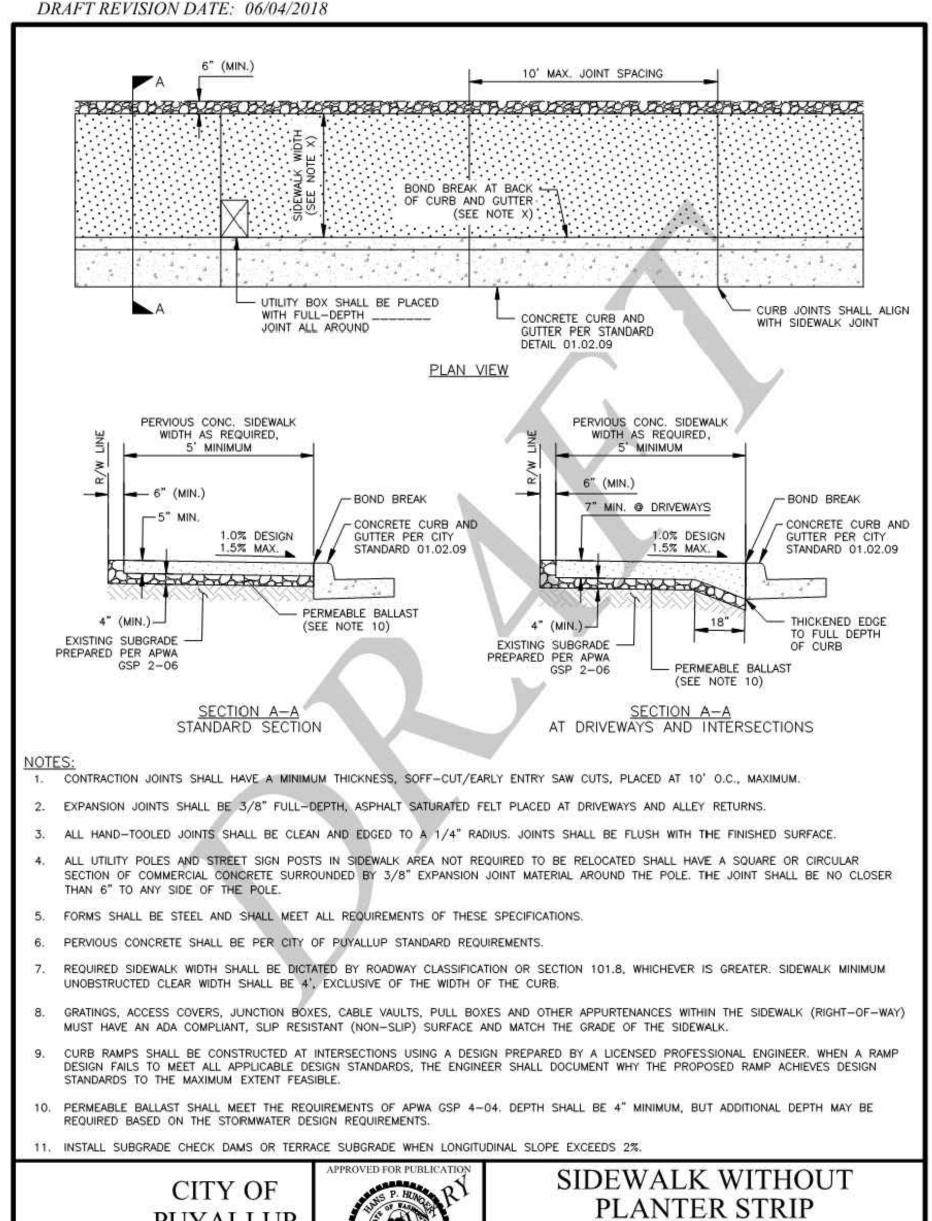

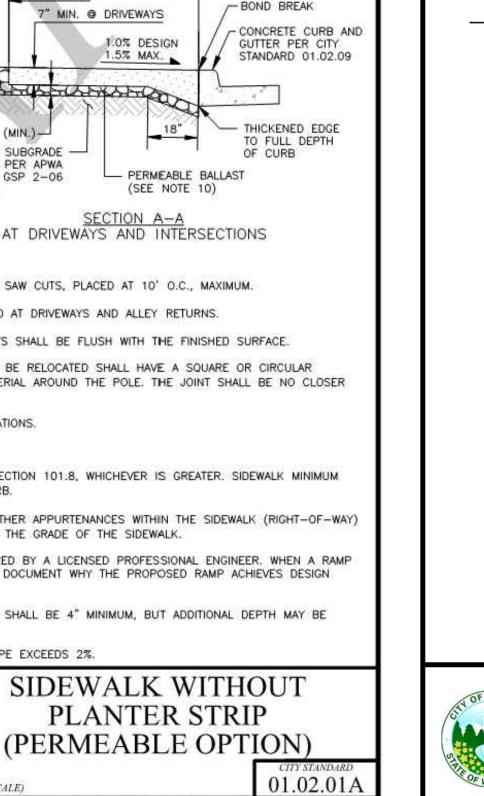

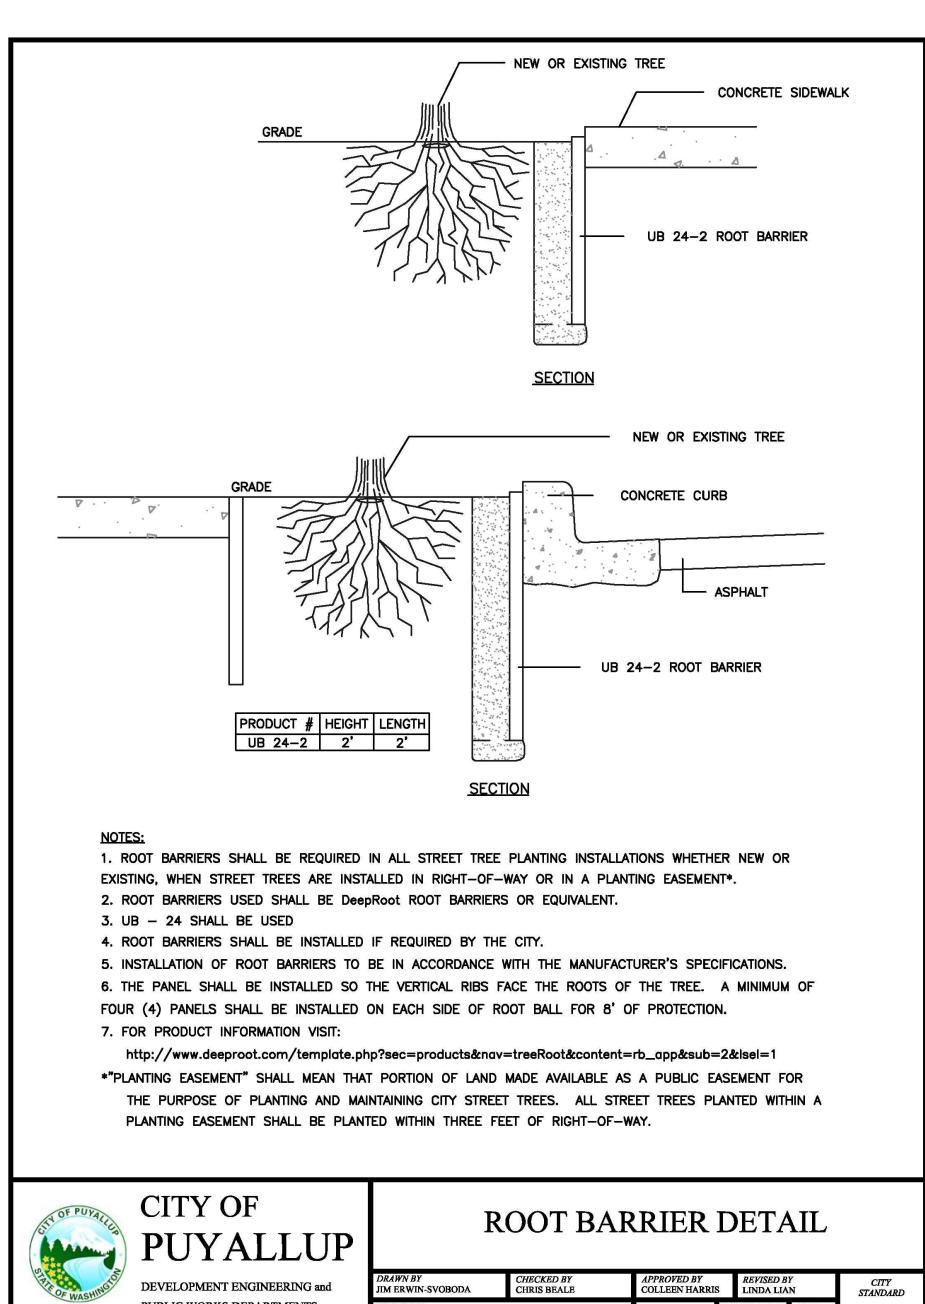



NOTE: 48" MINIMUM CLEAR

JIM ERWIN-SVOBODA

WIDTH SHALL BE

MEASURED EXCLUSIVE

OF THE CURB WIDTH

ADA COMPLIANT TREE GRATE-WHEN REQUIRED BY THE BY

THE PLANNING DEPARTMENT

PROPERTY LINE

CITY OF

PUYALLUP

PUYALLUP 2ND STREET APARTMENTS SPP MANUFACTURING

P.O.BOX 64160 **TACOMA, WA 98464** DON HUBER

<u>Project No.</u>


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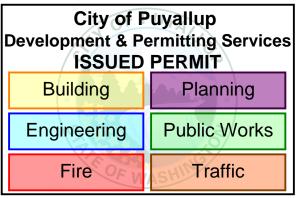
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SITE DEVELOPMENT **PERMIT SET**

10/8/2024





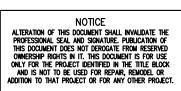

CURB

CITY STANDARD

01.02.04

SECTION VIEW A - A

8'(FT) MINIMUM

2% MAX. SLOPE

STREET TREE PLANTER

BLOCKOUTS FOR SIDEWALKS

OLLEEN HARRIS

<u>Revisions:</u>

Sheet Title:

DRAINAGE NOTES AND DETAILS

Designed by: Drawn by: Checked by:

Sheet No.

15 of 25 Sheets




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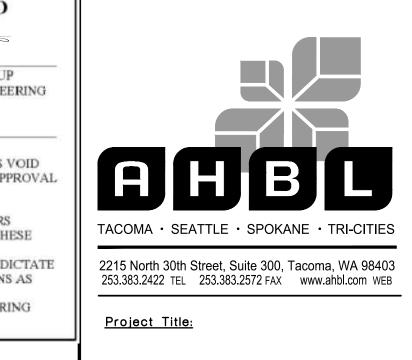
OFFICE

THE CITY ENGINEER



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PUYALLUP 2ND STREET

APARTMENTS

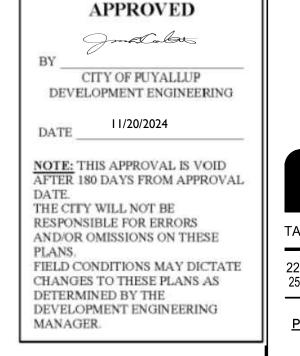SPP MANUFACTURING

P.O.BOX 64160

TACOMA, WA 98464

DON HUBER

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SITE DEVELOPMENT

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10/8/2024

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City of Puyallup


Development & Permitting Services

ISSUED PERMIT

Planning

Project No.


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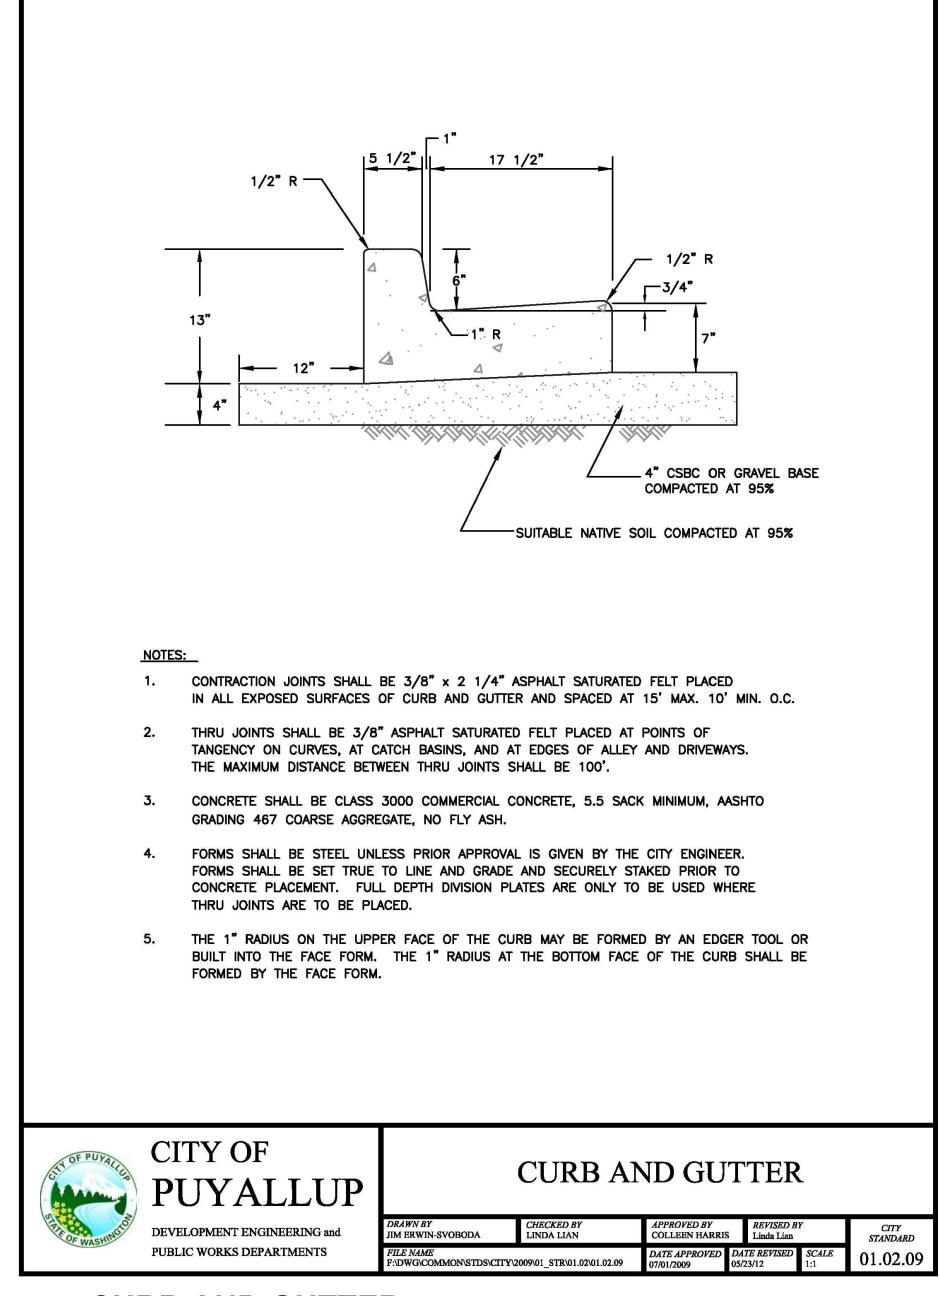


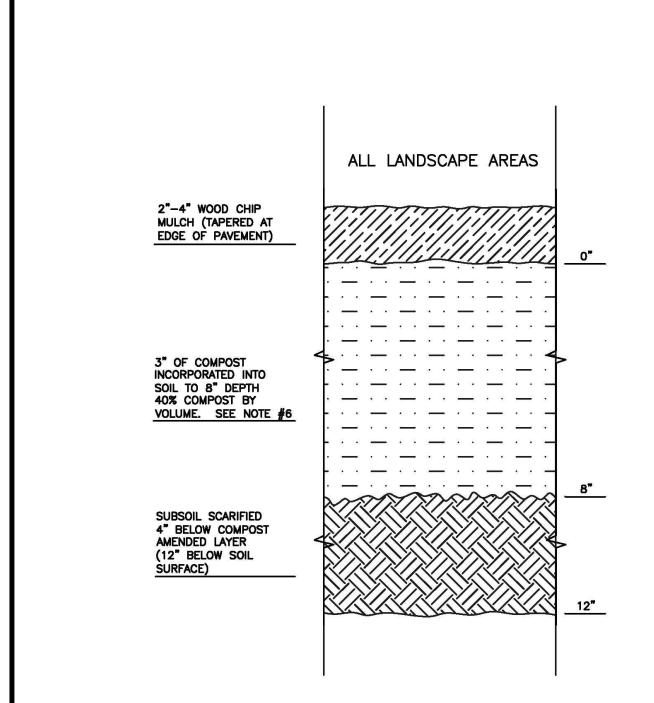
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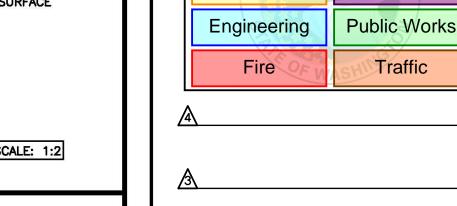
1. ALL SOIL AREAS DISTURBED OR COMPACTED DURING CONSTRUCTION, AND NOT COVERED BY BUILDINGS OR PAVEMENT, SHALL BE AMENDED WITH

- 2. SUBSOIL SHOULD BE SCARIFIED (LOOSENED) 4 INCHES BELOW AMENDED LAYER, TO PRODUCE 12—INCH DEPTH OF UN—COMPACTED SOIL, EXCEPT WHERE SCARIFICATION WOULD DAMAGE TREE ROOTS OR AS DETERMINED BY THE ENGINEER. SEE NOTE BELOW REGARDING PLANTING STEPS FOR STREET TREES.
- 3. COMPOST SHALL BE TILLED IN TO 8 INCH DEPTH INTO EXISTING SOIL, OR PLACE 8 INCHES OF COMPOST-AMENDED SOIL, PER SOIL
- SPECIFICATION. 4. PLANTING BEDS SHALL RECEIVE 3 INCHES OF COMPOST TILLED IN TO 8-INCH DEPTH, OR MAY SUBSTITUTE 8" OF IMPORTED SOIL CONTAINING 35-40% COMPOST BY VOLUME. MULCH AFTER PLANTING, WITH 4 INCHES OF ARBORIST WOOD CHIP MULCH OR APPROVED EQUAL (6" OF LOOSE WOOD CHIPS AT THE TIME OF PLANTING TO ALLOW SETTLING TO 4").
- 5. SETBACKS: TO PREVENT UNEVEN SETTLING, DO NOT COMPOST-AMEND SOILS WITHIN 3 FEET OF UTILITY INFRASTRUCTURES (POLES, VAULTS, METERS ETC.). WITHIN ONE FOOT OF PAVEMENT EDGE, CURBS AND SIDEWALKS SOIL SHOULD BE COMPACTED TO APPROXIMATELY 95% PROCTOR TO ENSURE A FIRM SURFACE.
- 6. SEE SECTION 8.2(B) OF THE VMS FOR SOIL AMENDMENT AND INSTRUCTION PROCEDURES FOR STREET TREE PLANTER STRIPS. ALL STREET TREE PLANTER STRIPS SHALL RECEIVE 40% COMPOST AMENDED SOIL TO THE FULL DEPTH OF THE STREET TREE ROOTBALL.





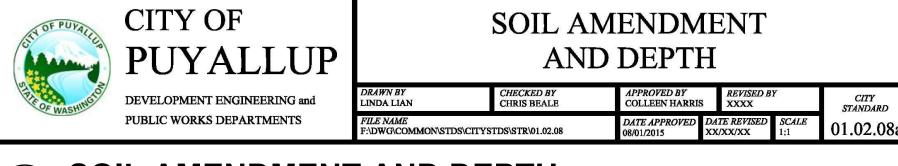

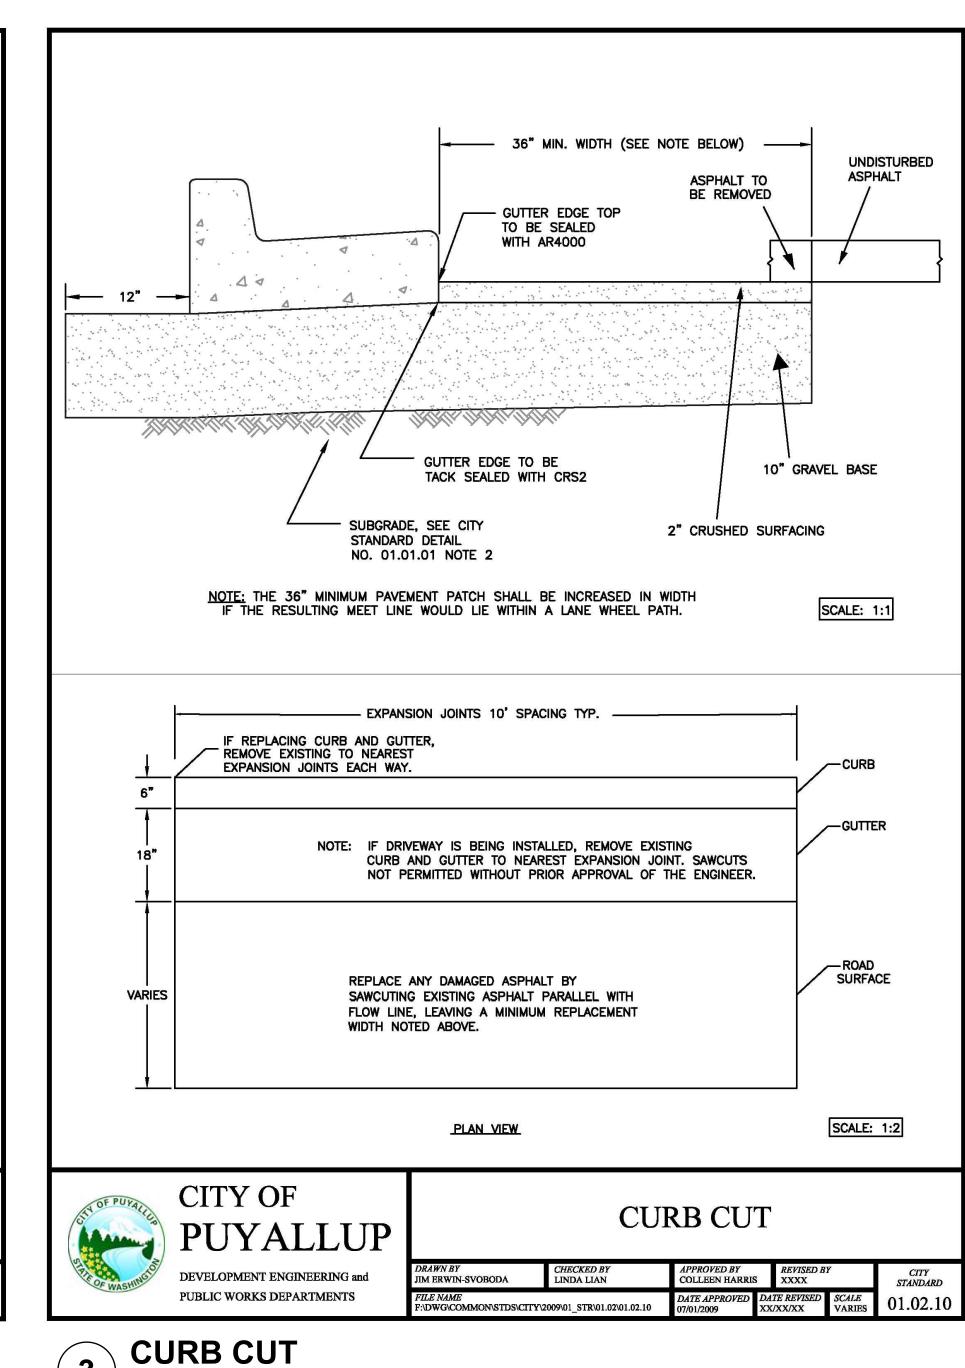

Building

Revisions:

Sheet Title:

DRAINAGE NOTES AND DETAILS

Designed by: Drawn by: Checked by:

Sheet No.

MW


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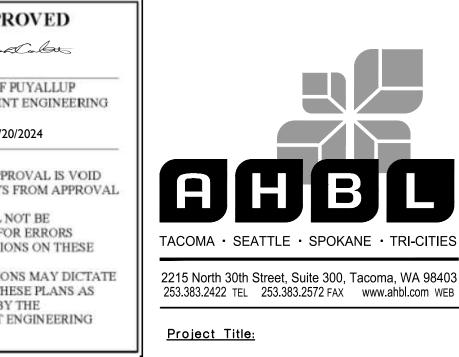


CURB AND GUTTER

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APARTMENTS

SPP MANUFACTURING

P.O.BOX 64160 **TACOMA, WA 98464**

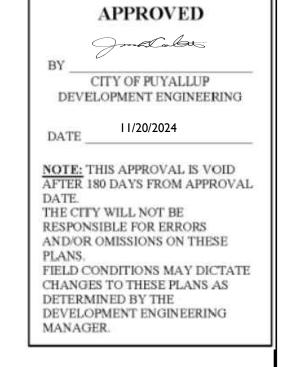DON HUBER

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10/8/2024

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City of Puyallup **Development & Permitting Services**

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Planning

Public Works

Traffic


Building


Engineering


Fire


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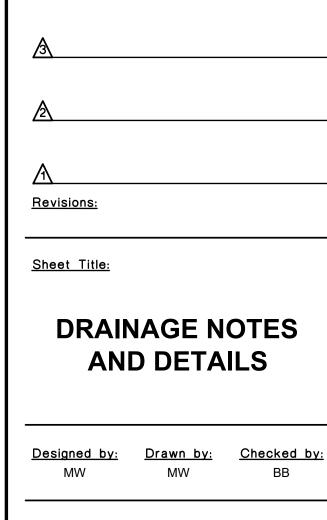




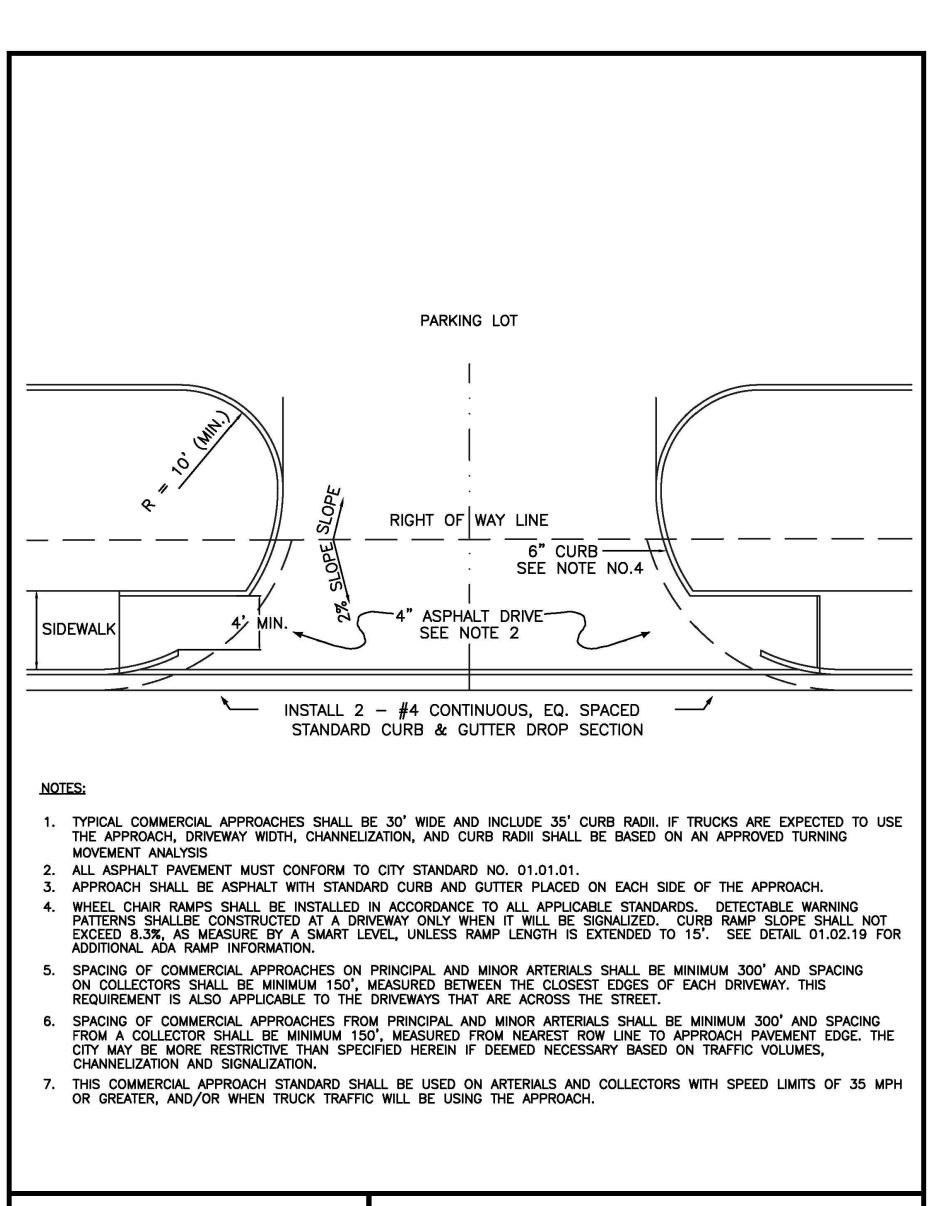

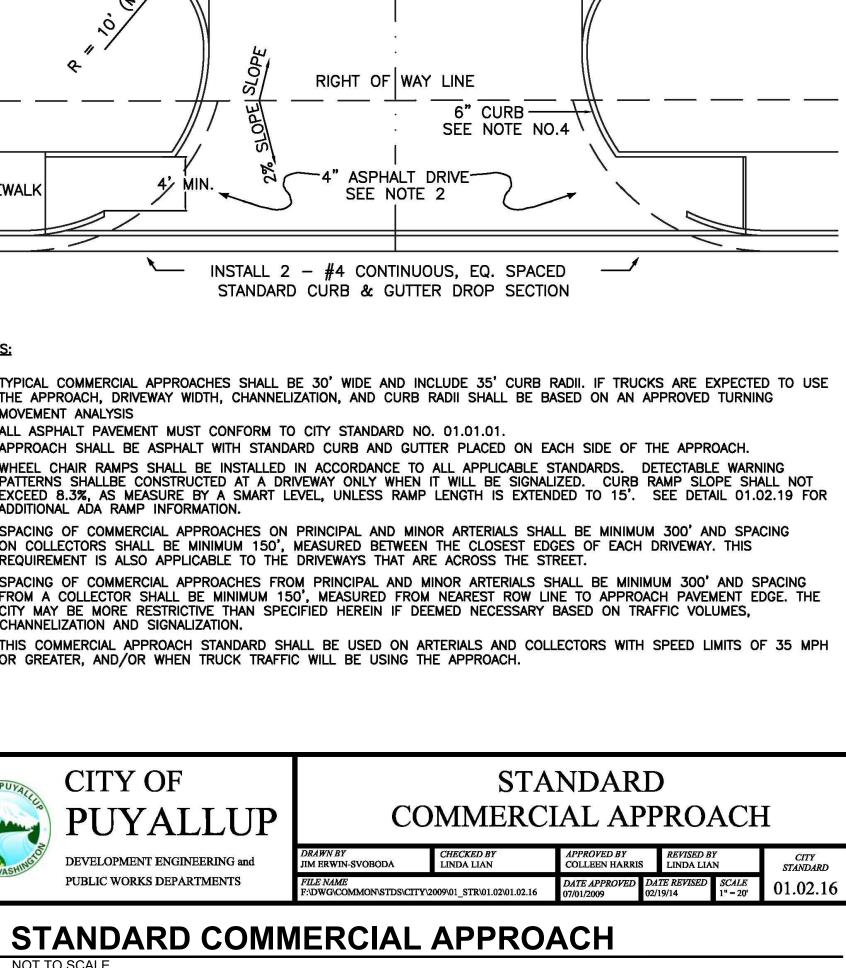SIDEWALK RAMP WITH COMMERCIAL APPROACH

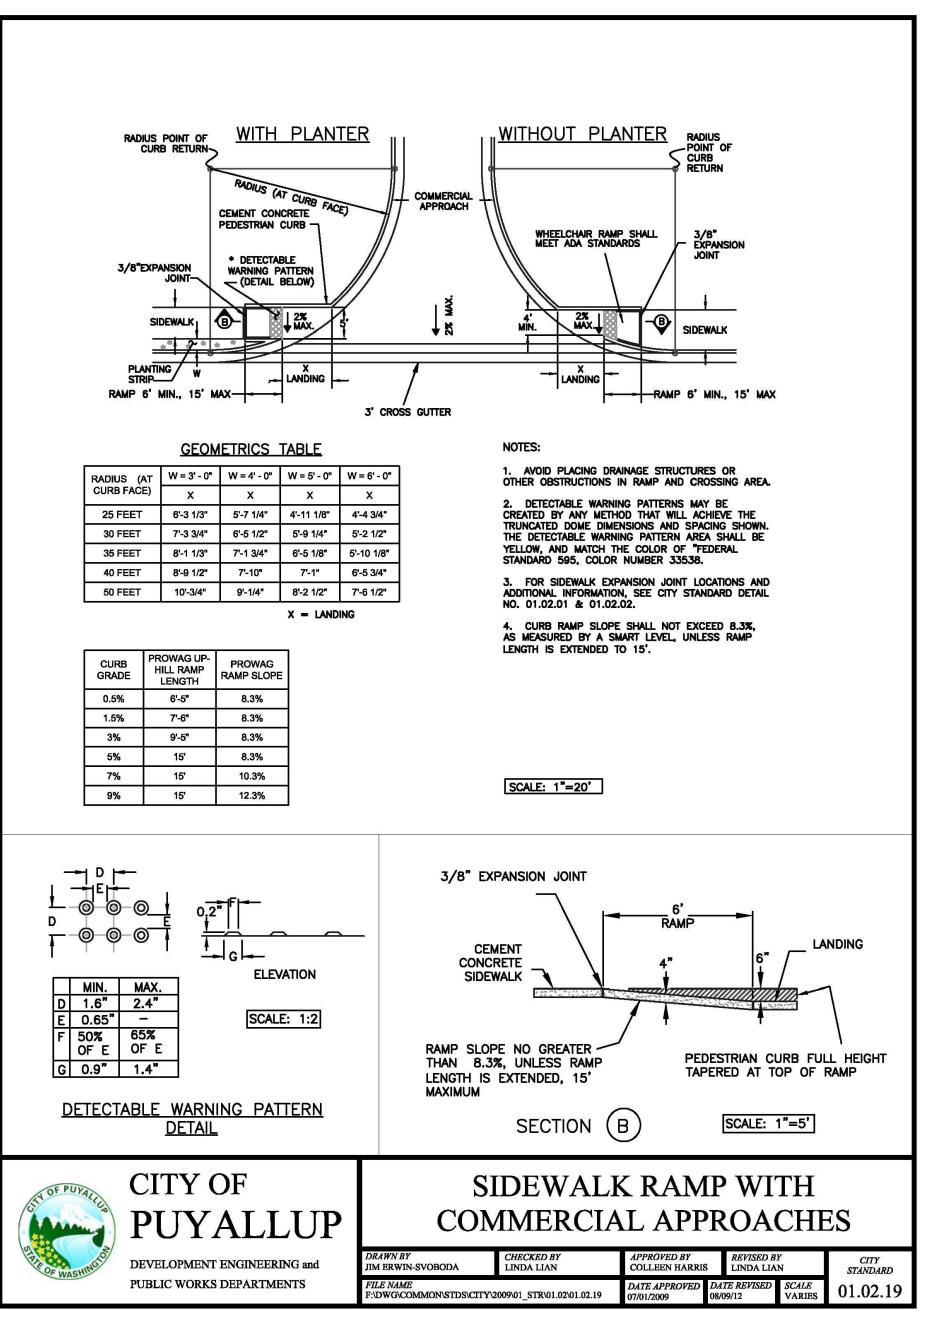

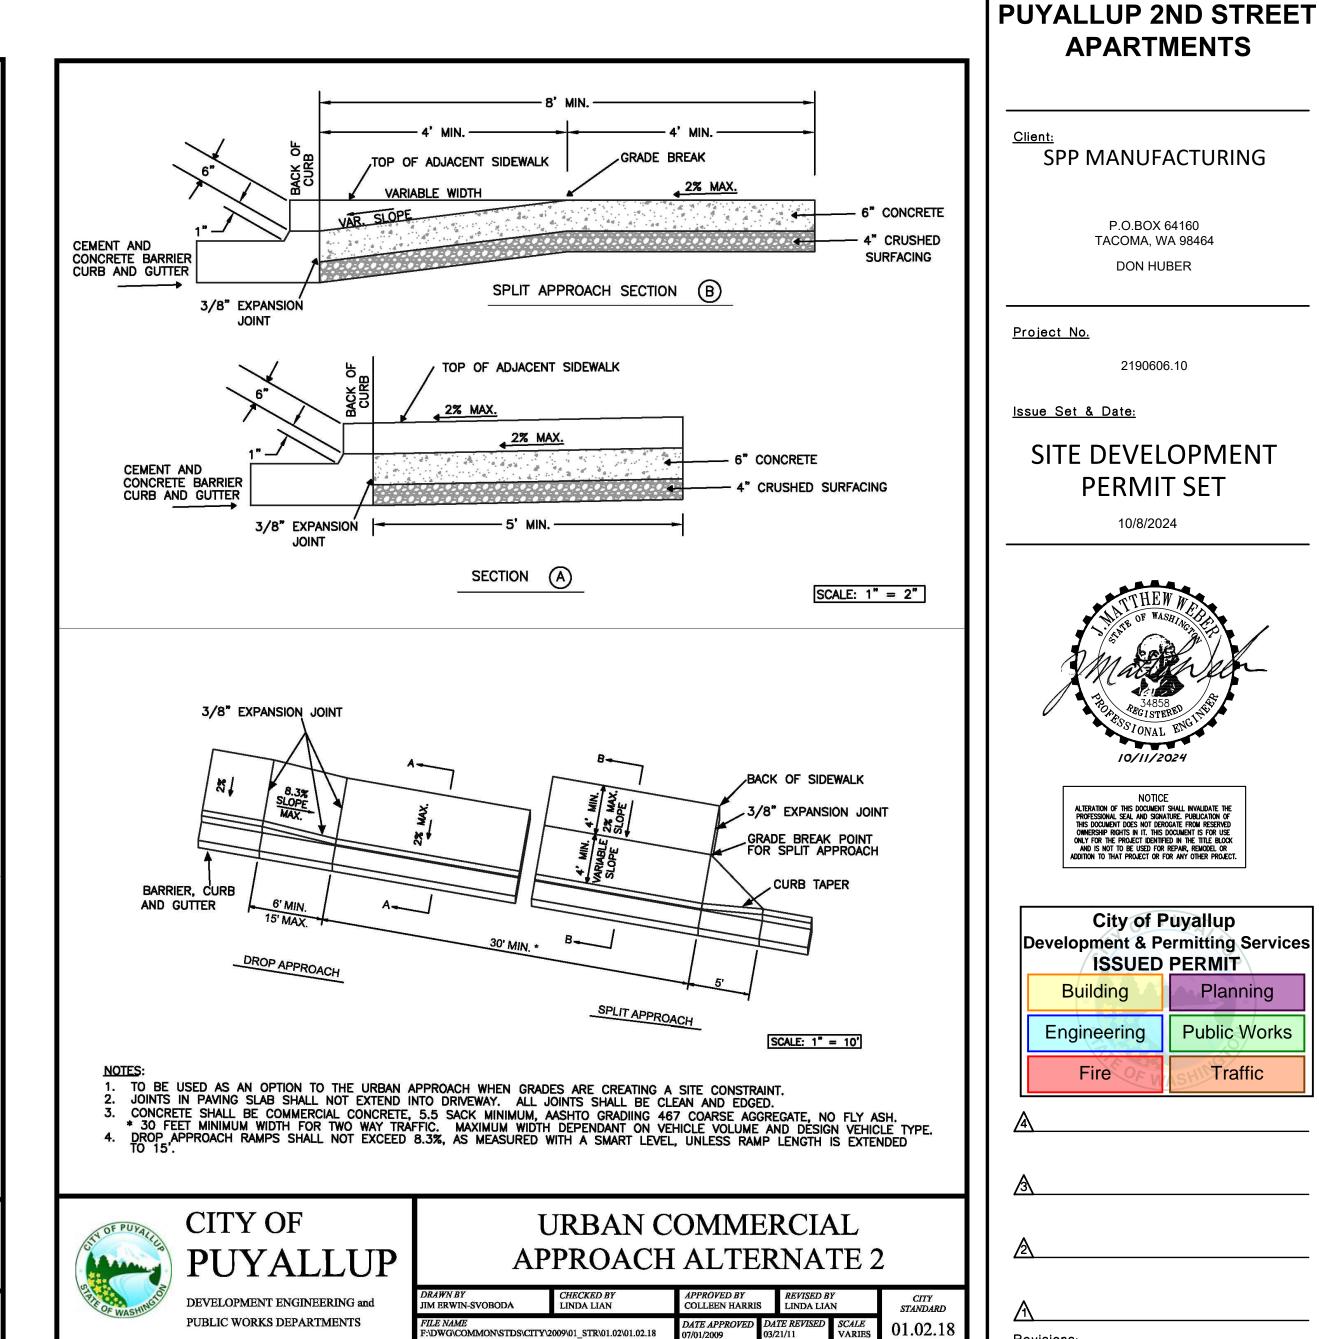


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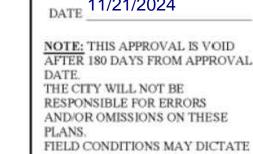
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OFFICIAL.

FIRE HYDRANT/FDC LOCATION/ACCESS APPROVED CITY OF PUYALLUP FIRE CODE OFFICIAL DATE 11/21/2024 NOTE: THIS APPROVAL IS VOID AFTER 180 DAYS FROM APPROVAL

NOTE: THIS APPROVAL IS VOID AFTER 180 DAYS FROM APPROVAL THE CITY WILL NOT BE RESPONSIBLE FOR ERRORS AND/OR OMISSIONS ON THESE PLANS. FIELD CONDITIONS MAY DICTATE CHANGES TO THESE PLANS AS CHANGES TO THESE PLANS AS DETERMINED BY THE FIRE CODE DETERMINED BY THE

APPROVED

Jmb Calou

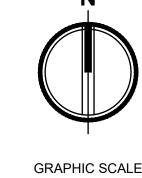CITY OF PUYALLUP

DEVELOPMENT ENGINEERING

DEVELOPMENT ENGINEERING

MANAGER.

2215 North 30th Street, Suite 300, Tacoma, WA 98403 253.383.2422 TEL 253.383.2572 FAX www.ahbl.com WEB

Project Title:

PUYALLUP 2ND STREET **APARTMENTS**

SPP MANUFACTURING

P.O.BOX 64160 **TACOMA, WA 98464** DON HUBER

<u>Project No.</u>


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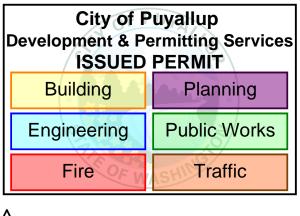
Issue Set & Date:

SITE DEVELOPMENT **PERMIT SET**

10/8/2024





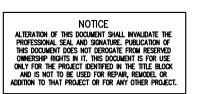

Revisions:


Sheet Title:

UTILITY PLAN

Designed by: Drawn by: Checked by:

Sheet No.

18 of 25 Sheets

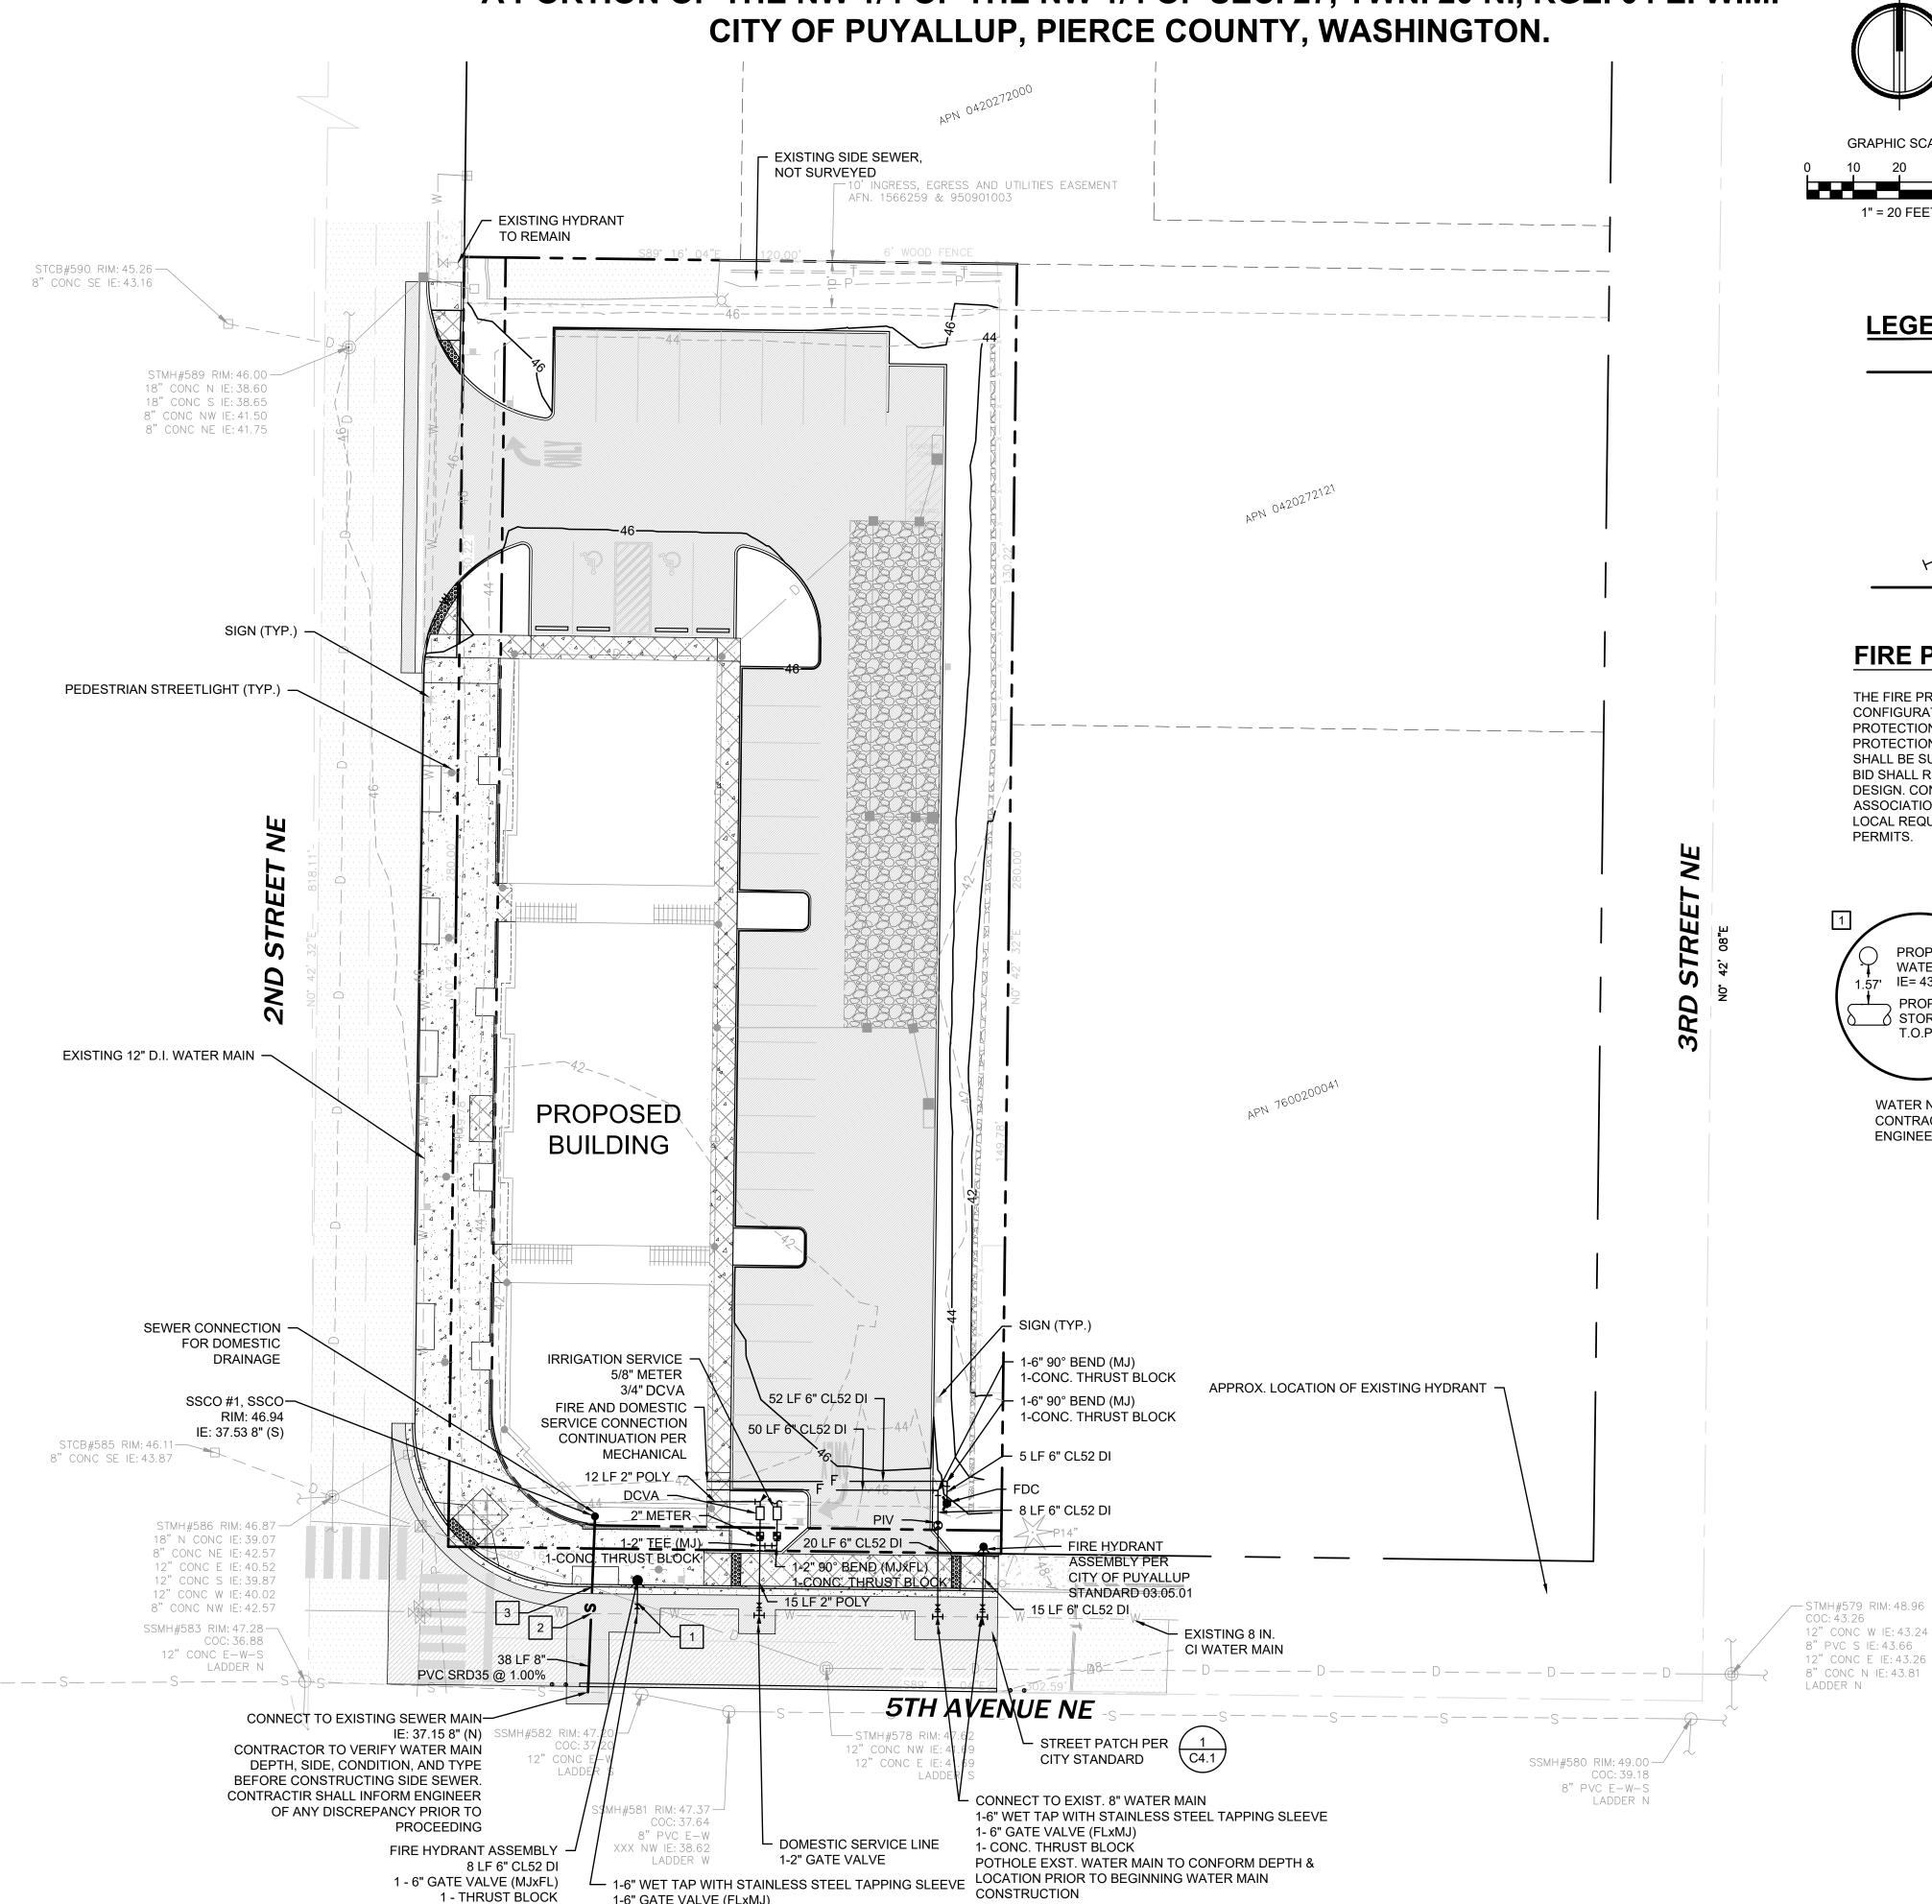

1-6" GATE VALVE (FLxMJ)

1-CONC. THRUST BLOCK

CONNECT TO EXISTING WATER MAIN CONTRACTOR TO FIELD VERIFY SIZE

DEPTH AND LOCATION OF EXISTING


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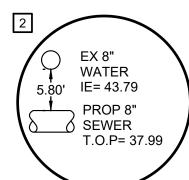
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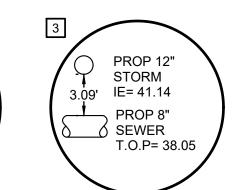
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FIRE PROTECTION NOTES

THE FIRE PROTECTION SYSTEM INCLUDING MATERIALS, SIZING, AND CONFIGURATION IS SUBJECT TO A CONTRACTOR PROVIDED DESIGN BY A FIRE PROTECTION ENGINEER, AND AS SUCH, THE FINAL DESIGN OF THE FIRE PROTECTION SYSTEM MAY DEVIATE FROM THE SYSTEM SHOWN. THE FINAL DESIGN BID SHALL REFLECT THE CONDITIONS OF THE FIRE PROTECTION ENGINEER'S DESIGN. CONTRACTOR SHALL COMPLY WITH ALL NATIONAL FIRE PROTECTION ASSOCIATION REQUIREMENTS AS SET FORTH BY "NFPA 13", ITS AMENDMENTS, AND LOCAL REQUIREMENTS, INCLUDING BUT NOT LIMITED TO ACQUISITION OF ALL





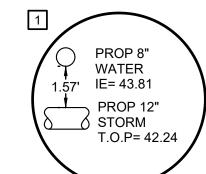

WATER NOTE: EXISTING WATER DEPTH IS ASSUMED BASED ON STANDARD COVER. CONTRACTOR TO POTHOLE AND VERIFY PRIOR TO SEWER CONSTRUCTION. NOTIFY ENGINEER OF ANY DISCREPANCY.

SMH#584 RIM: 47.14 —

12" CONC E-W


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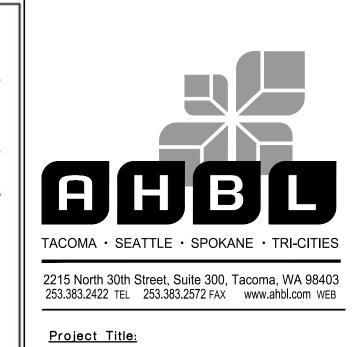
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PUYALLUP 2ND STREET

APARTMENTS

SPP MANUFACTURING

P.O.BOX 64160

TACOMA, WA 98464

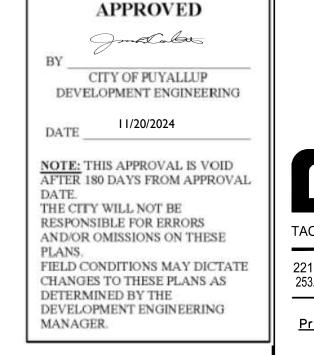DON HUBER

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SITE DEVELOPMENT

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10/8/2024

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City of Puyallup

Development & Permitting Services

ISSUED PERMIT

Planning

Public Works

Traffic

Building

Engineering

Fire


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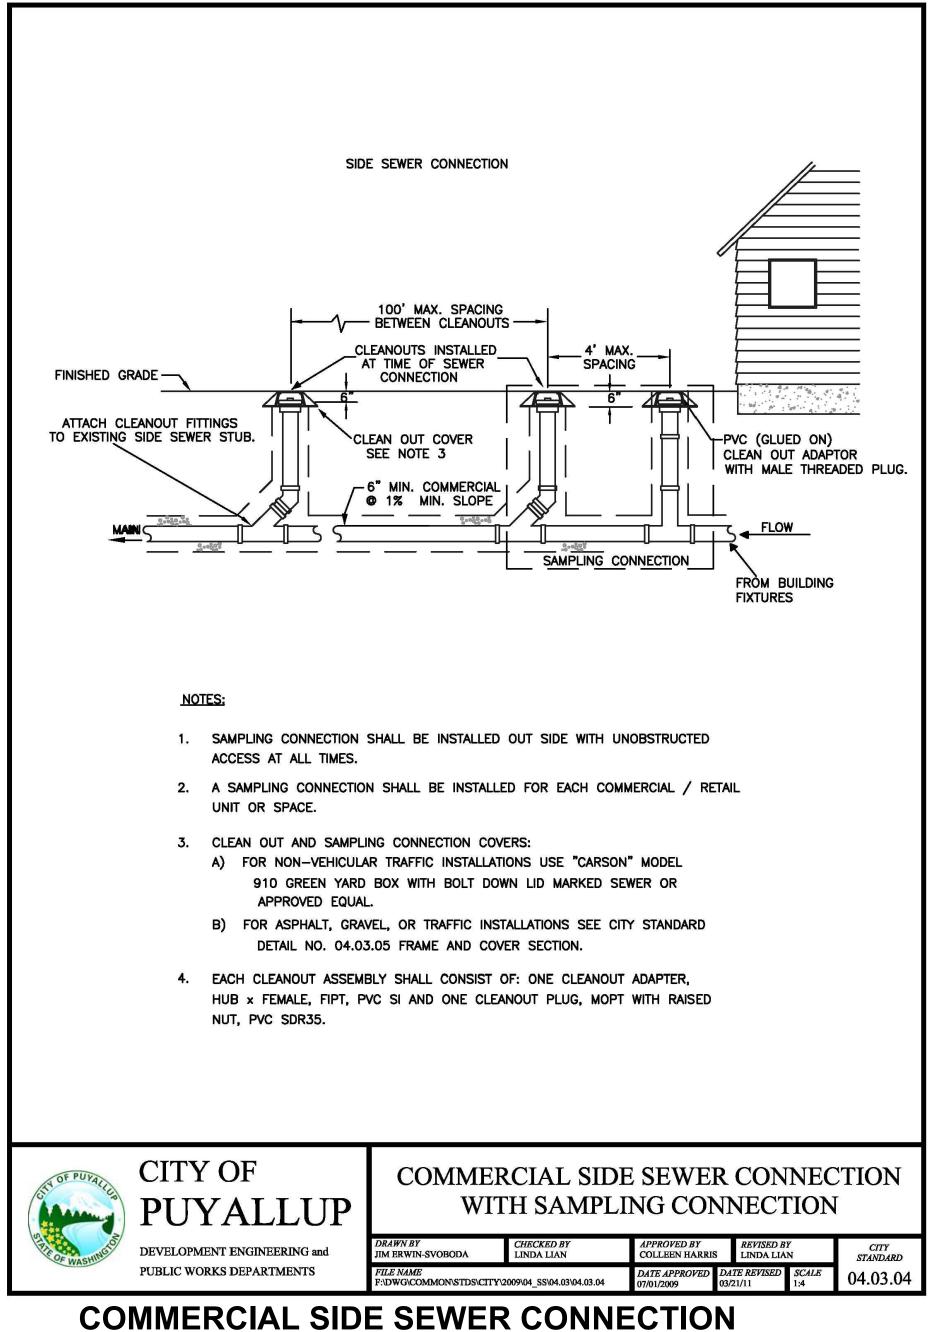
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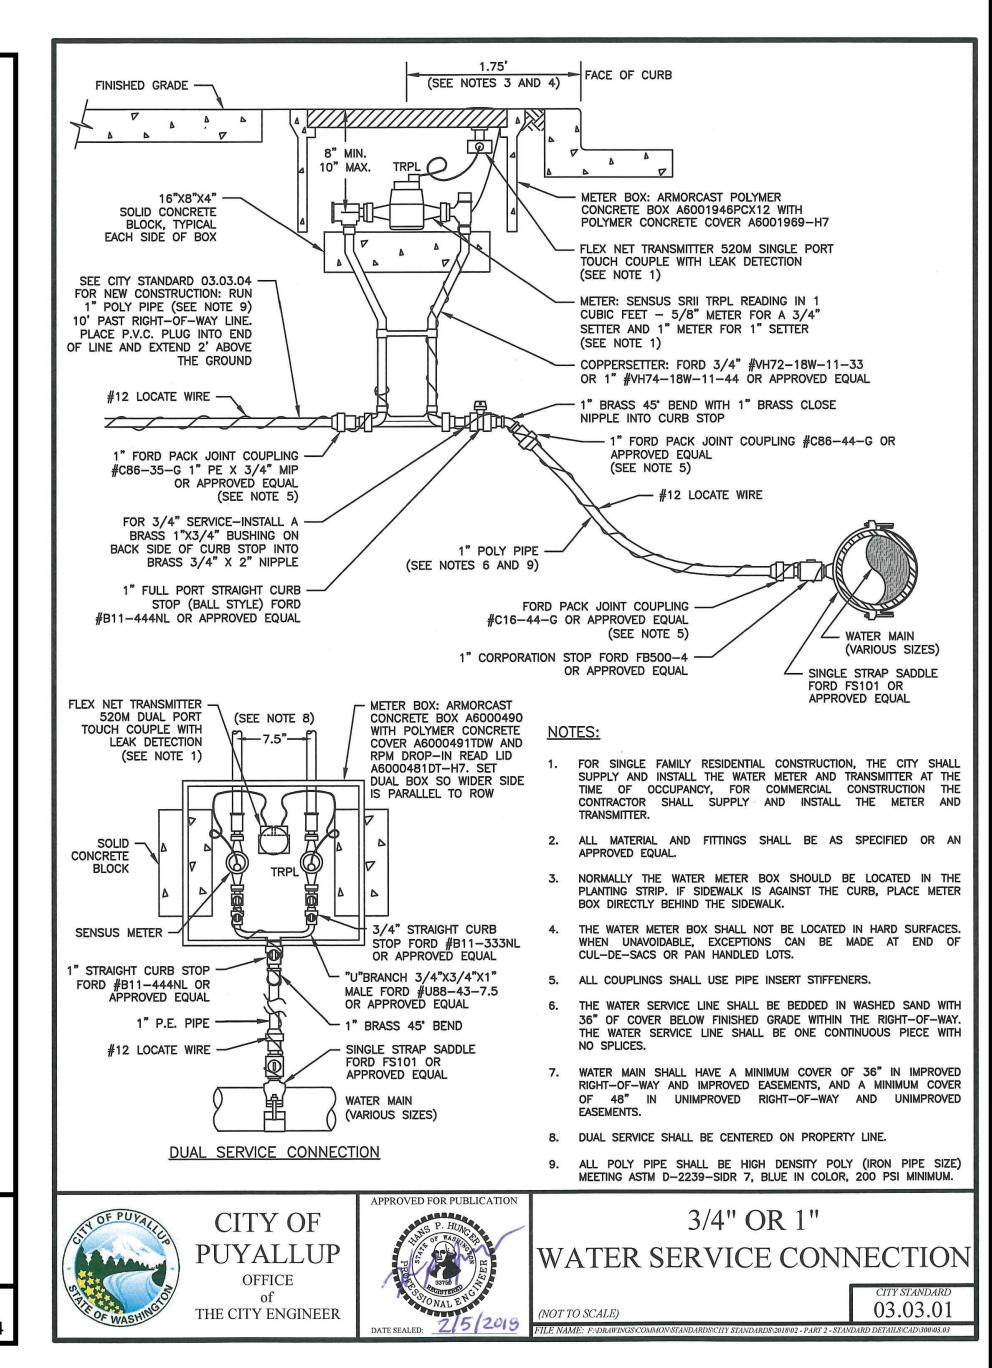
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Project No.

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MW MW BB

WATER AND SEWER

NOTES AND DETAILS

C4.119 of 25 Sheets

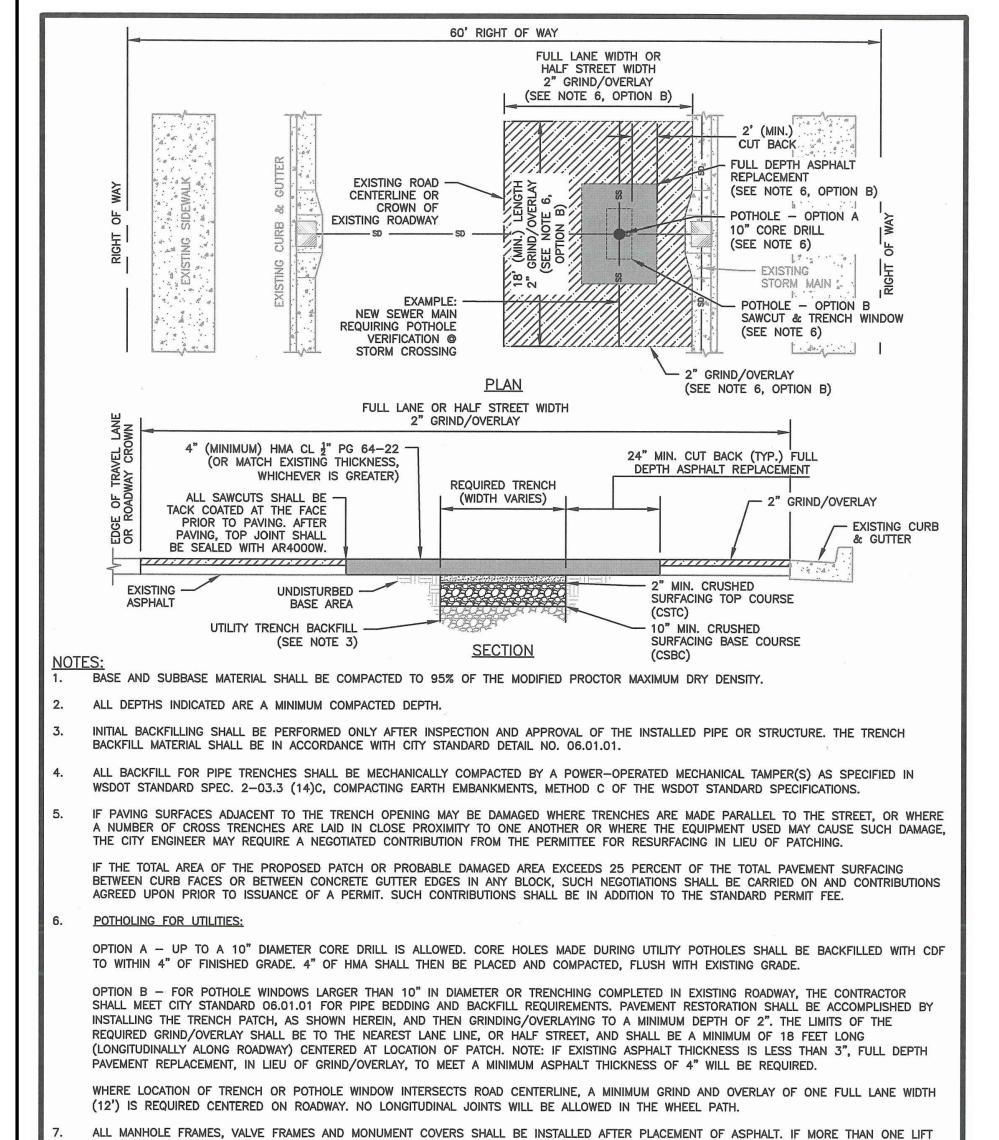IS NECESSARY, FRAMES AND LIDS WILL BE ADJUSTED TO FINISH GRADE AT FIRST LIFT AS DIRECTED BY THE CITY.

OFFICE


THE CITY ENGINEER

STREET PATCH


STREET PATCH

01.01.20

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PUYALLUP 2ND STREET **APARTMENTS**

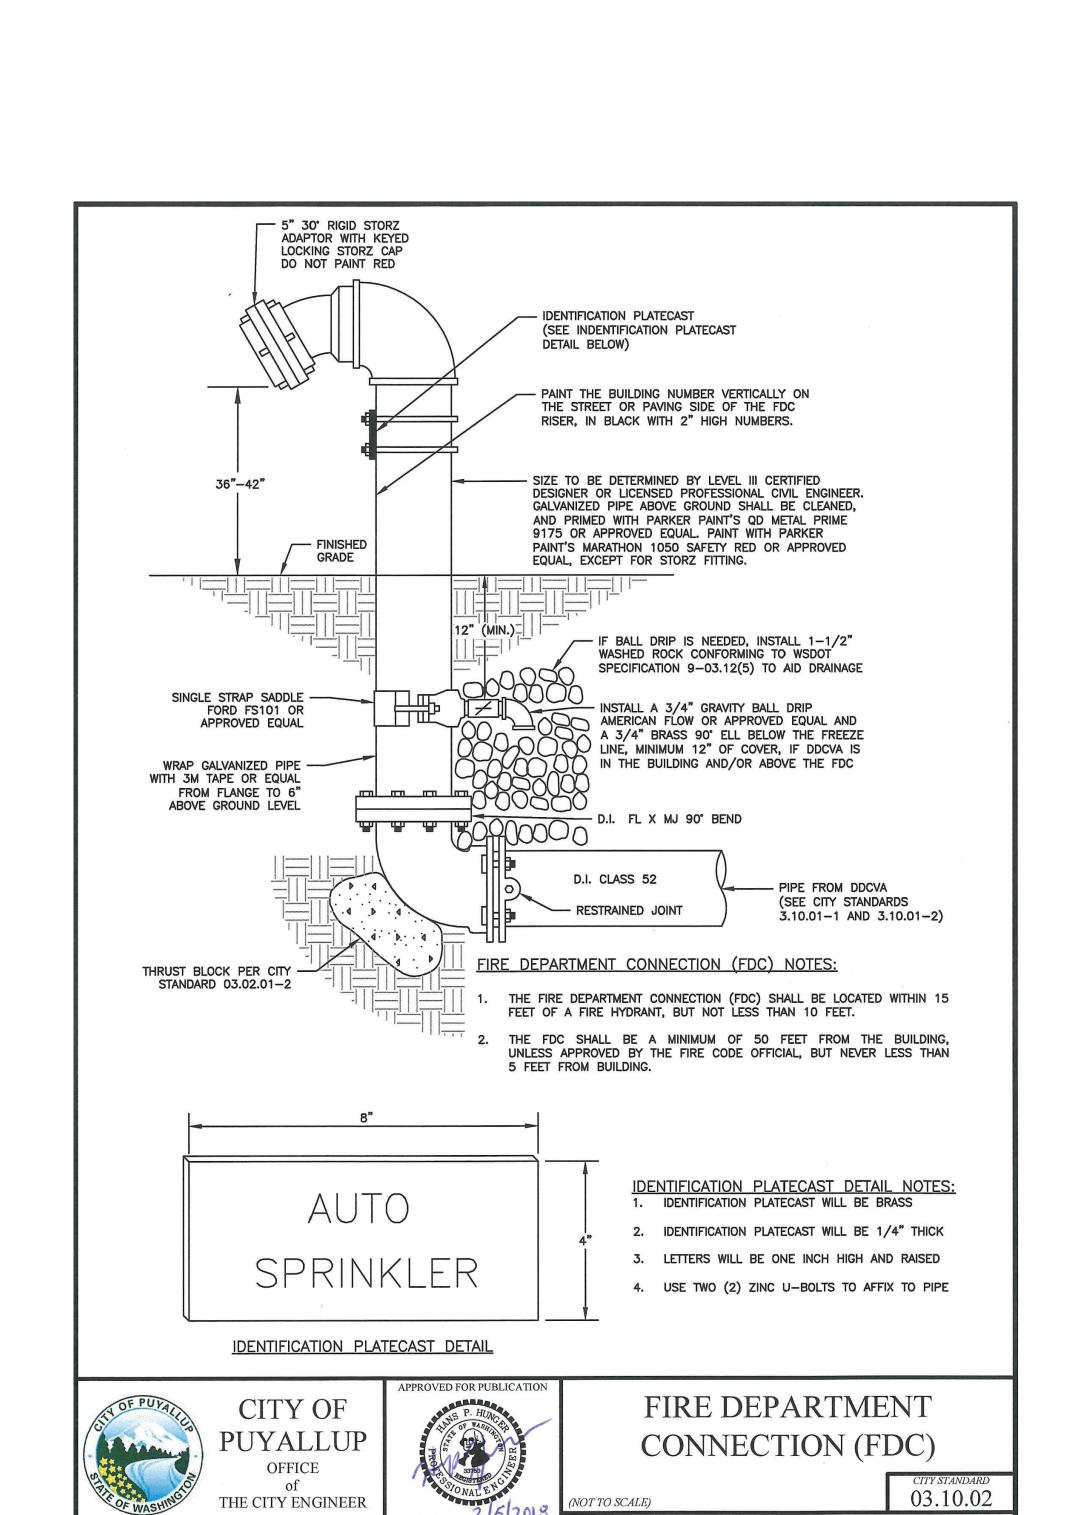SPP MANUFACTURING

P.O.BOX 64160 **TACOMA, WA 98464** DON HUBER
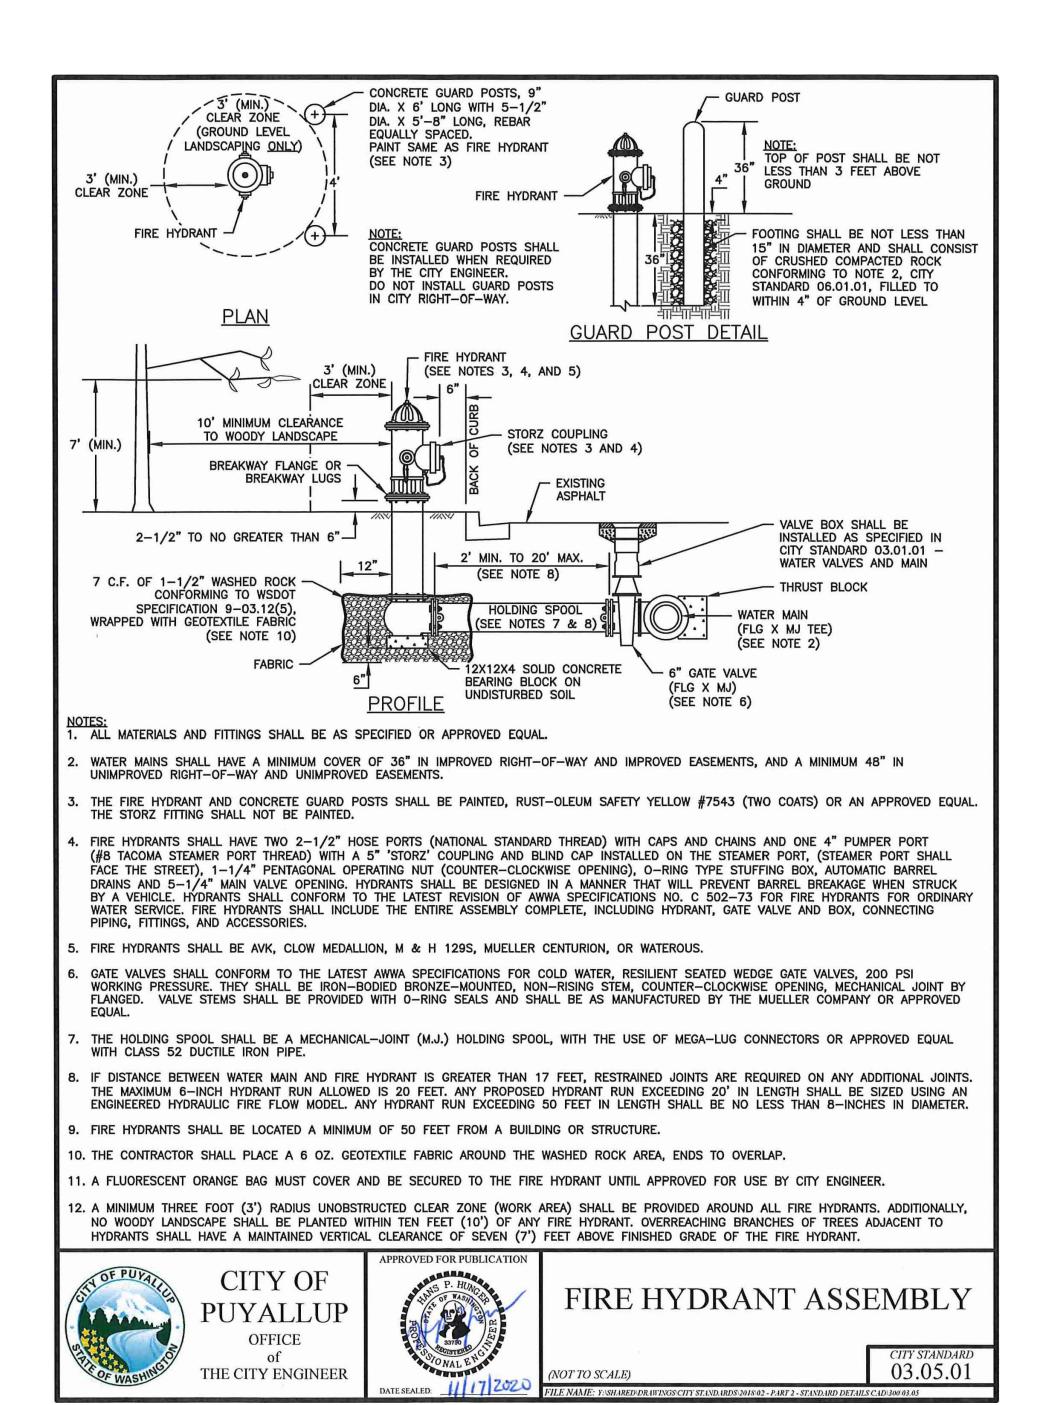
<u>Project No.</u>

APPROVED

Jame Calou

CITY OF PUYALLUP

THE CITY WILL NOT BE RESPONSIBLE FOR ERRORS

DETERMINED BY THE

DATE

PLANS.


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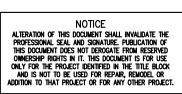
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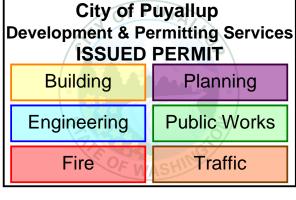
Issue Set & Date:

SITE DEVELOPMENT **PERMIT SET**

10/8/2024





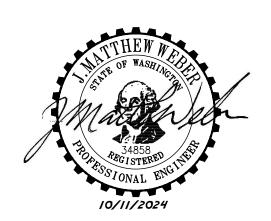

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<u>Revisions:</u>

Sheet Title:

WATER AND SEWER NOTES AND DETAILS


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Sheet No.

20 of 25 Sheets


FIRE HYDRANT ASSEMBLY


A PORTION OF THE NW 1/4 OF THE NW 1/4 OF SEC. 27, TWN. 20 N., RGE. 04 E. W.M. CITY OF PUYALLUP, PIERCE COUNTY, WASHINGTON.

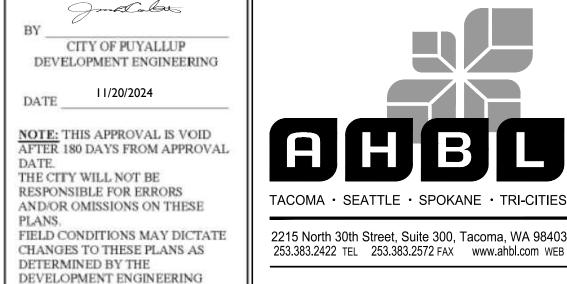

APPROVED

MANAGER.

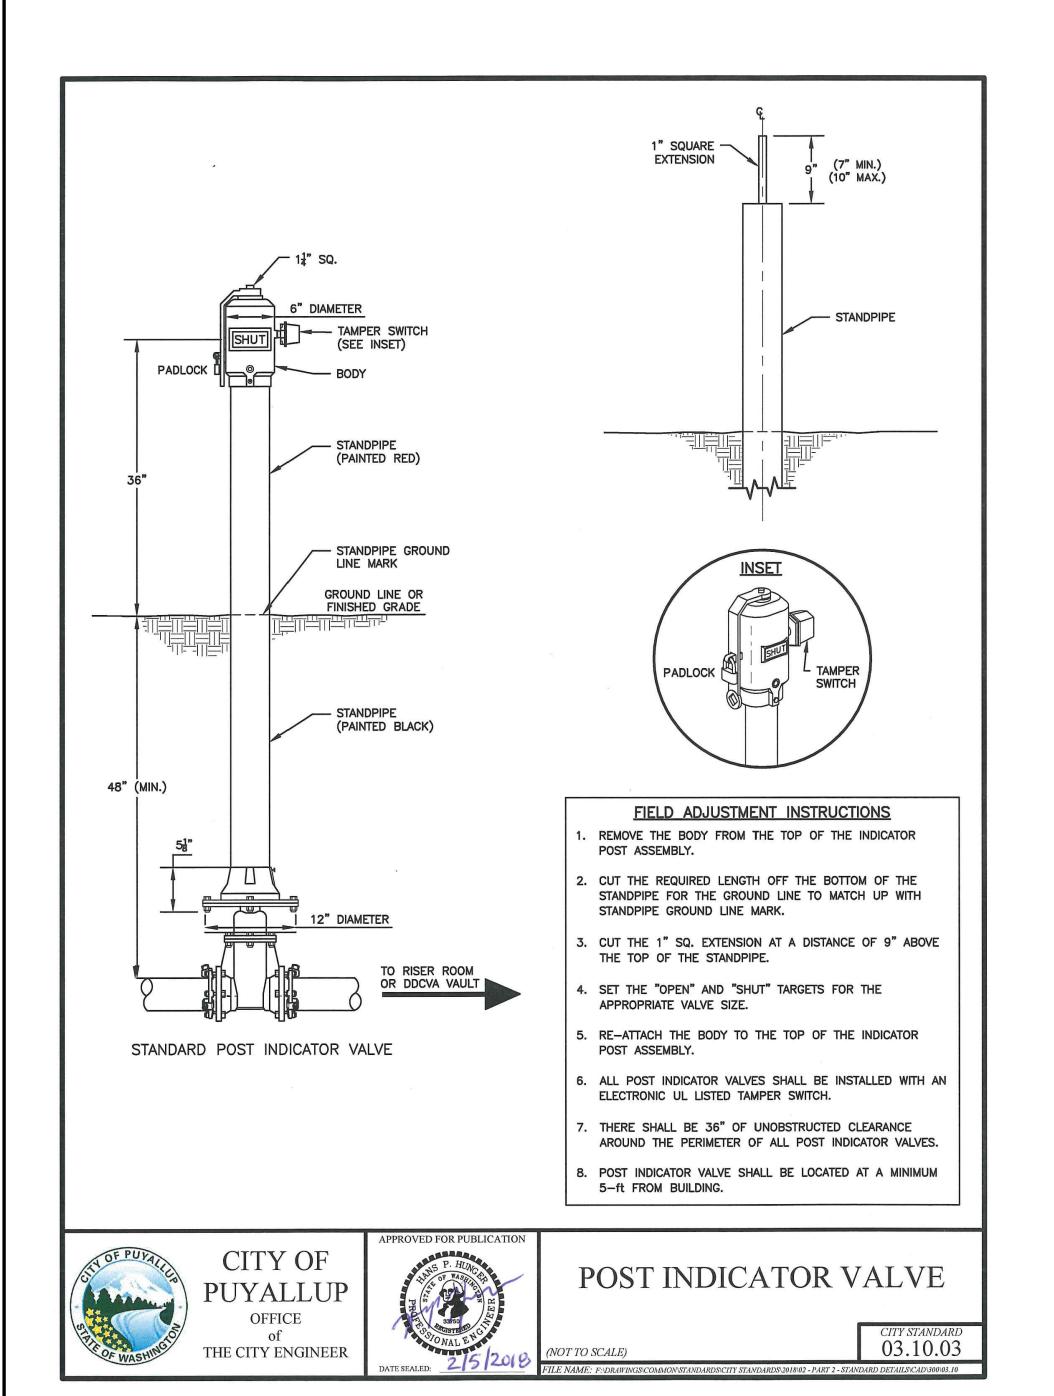

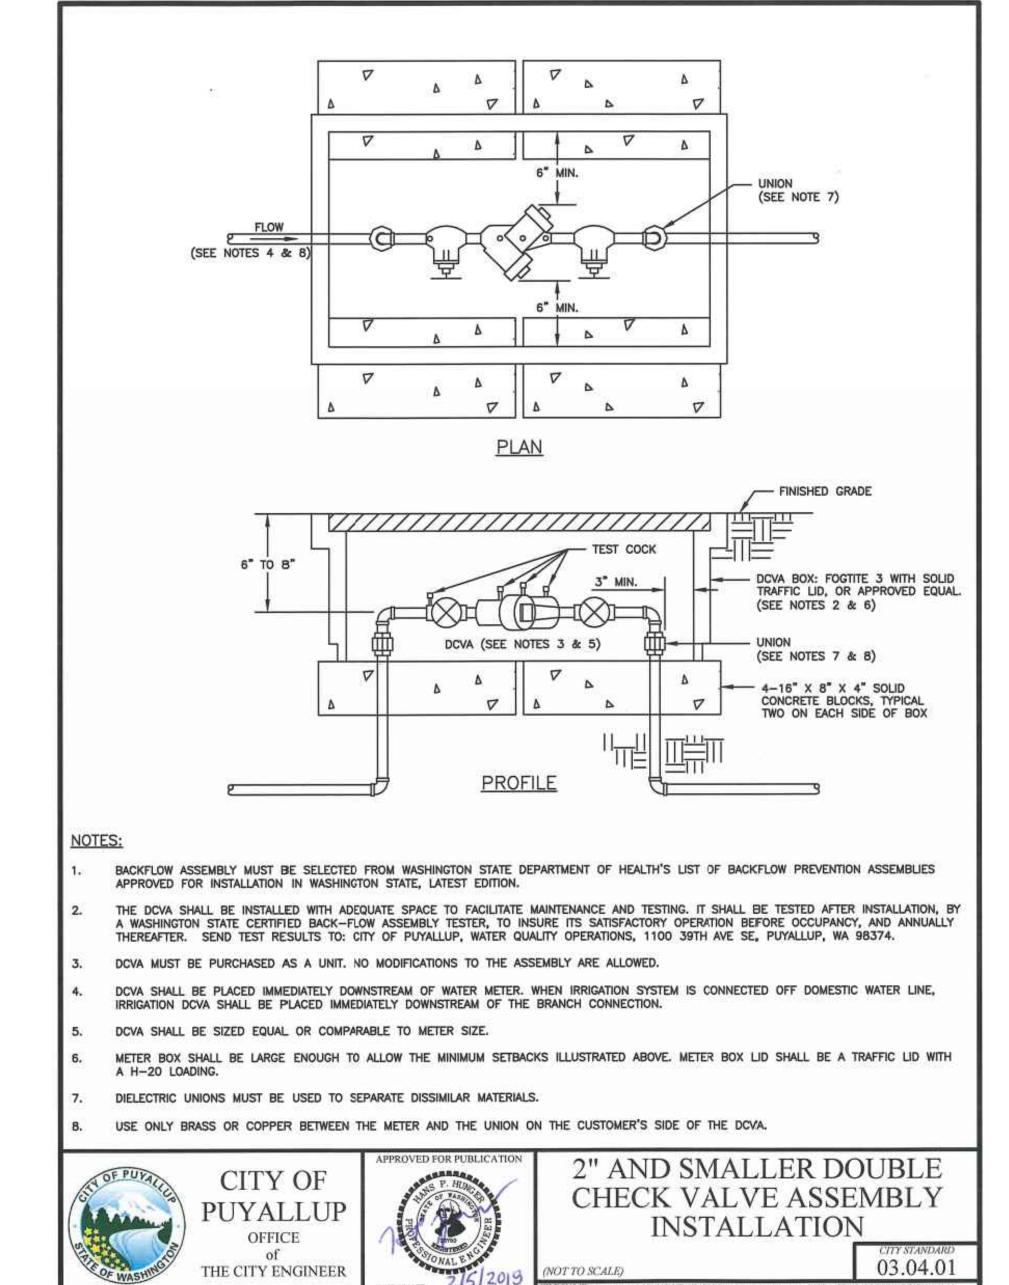

2 INCH AND SMALLER DCVA

SANITARY SEWER NOTES:

- ALL WORK IN CITY RIGHT-OF-WAY REQUIRES A PERMIT FROM THE CITY OF PUYALLUP. PRIOR TO ANY WORK COMMENCING, THE GENERAL CONTRACTOR SHALL ARRANGE FOR A PRECONSTRUCTION MEETING AT THE DEVELOPMENT SERVICES CENTER TO BE ATTENDED BY ALL CONTRACTORS THAT WILL PERFORM WORK SHOWN ON THE ENGINEERING PLANS, REPRESENTATIVES FROM ALL APPLICABLE UTILITY COMPANIES, THE PROJECT OWNER AND APPROPRIATE CITY STAFF. CONTACT ENGINEERING SERVICES TO SCHEDULE THE MEETING (253) 841-5568. THE CONTRACTOR IS RESPONSIBLE TO HAVE THEIR OWN APPROVED SET OF PLANS
- 2. AFTER COMPLETION OF ALL ITEMS SHOWN ON THESE PLANS AND BEFORE ACCEPTANCE OF THE PROJECT, THE CONTRACTORS SHALL OBTAIN A "PUNCH LIST" PREPARED BY THE CITY'S INSPECTOR DETAILING REMAINING ITEMS OF WORK TO BE COMPLETED. ALL ITEMS OF WORK SHOWN ON THESE PLANS SHALL BE COMPLETED TO THE SATISFACTION OF THE CITY PRIOR TO ACCEPTANCE OF THE SEWER SYSTEM AND PROVISION OF SANITARY SEWER SERVICE.
- ALL MATERIALS AND WORKMANSHIP SHALL CONFORM TO THE STANDARD SPECIFICATIONS FOR ROAD, BRIDGE. AND MUNICIPAL CONSTRUCTION (HEREINAFTER REFERRED TO AS THE "STANDARD SPECIFICATIONS"). WASHINGTON STATE DEPARTMENT OF TRANSPORTATION AND AMERICAN PUBLIC WORKS ASSOCIATION, WASHINGTON STATE CHAPTER, LATEST EDITION, UNLESS SUPERSEDED OR AMENDED BY THE CITY OF PUYALLUP CITY STANDARDS FOR PUBLIC WORKS ENGINEERING AND CONSTRUCTION (HEREINAFTER REFERRED TO AS THE "CITY STANDARDS")
- 4. A COPY OF THESE APPROVED PLANS AND APPLICABLE CITY DEVELOPER SPECIFICATIONS AND DETAILS SHALL BE ON SITE DURING CONSTRUCTION.
- ANY REVISIONS MADE TO THESE PLANS MUST BE REVIEWED AND APPROVED BY THE DEVELOPER'S ENGINEER AND THE ENGINEERING SERVICES STAFF PRIOR TO ANY IMPLEMENTATION IN THE FIELD. THE CITY SHALL NOT BE RESPONSIBLE FOR ANY ERRORS AND/OR OMISSIONS ON THESE PLANS.
- THE CONTRACTOR SHALL HAVE UTILITIES VERIFIED ON THE GROUND PRIOR TO ANY CONSTRUCTION. CALL (811) AT LEAST TWO WORKING DAYS IN ADVANCE. THE OWNER AND HIS/HER ENGINEER SHALL BE CONTACTED IMMEDIATELY IF A CONFLICT EXISTS.
- ANY STRUCTURE AND/OR OBSTRUCTION WHICH REQUIRE REMOVAL OR RELOCATION RELATING TO THIS PROJECT SHALL BE DONE SO AT THE DEVELOPER'S EXPENSE.
- MINIMUM GRADE ON ALL 4 INCH RESIDENTIAL SIDE SEWERS SHALL BE 2 PERCENT AND 6 INCH COMMERCIAL SIDE SEWERS SHALL BE 1 PERCENT; MAXIMUM SHALL BE 8 PERCENT. ALL SIDE SEWERS SHALL BE 6 INCHES WITHIN CITY RIGHT-OF-WAY.
- 9. SIDE SEWERS SHALL BE INSTALLED IN ACCORDANCE WITH CITY STANDARD NOS. 04.03.01, 04.03.02, 04.03.03 AND 04.03.04. SIDE SEWER INSTALLATION WORK SHALL BE DONE IN ACCORDANCE WITH THE WASHINGTON INDUSTRIAL SAFETY AND HEALTH ACT (WISHA).
- 10. ALL SEWER PIPE SHALL BE PVC, POLYPROPYLENE, OR DUCTILE IRON. PVC SEWER PIPE SHALL CONFORM TO ASTM D-3034, SDR35 FOR PIPE SIZES 15-INCH AND SMALLER AND ASTM F679 FOR PIPE SIZES 18- TO 27-INCH, DUCTILE IRON PIPE SHALL BE CLASS 51 OR GREATER, LINED WITH PROTECTO 401TM EPOXY LINING OR EQUIVALENT, UNLESS OTHERWISE NOTED. 12-INCH THROUGH 30-INCH POLYPROPYLENE PIPE (PP) SHALL BE DUAL WALLED, HAVE A SMOOTH INTERIOR AND EXTERIOR CORRUGATIONS AND MEET WSDOT 9-05.24(2). IT SHALL MEET OR EXCEED ASTM F2764. PP SHALL HAVE A MINIMUM PIPE STIFFNESS OF 46 PII WHEN TESTED IN ACCORDANCE WITH ASTM D2412. TESTING SHALL BE PER ASTM F1417. TRENCHING, BEDDING, AND BACKFILL SHALL BE IN ACCORDANCE WITH CITY STANDARD NO. 06.01.01. MINIMUM COVER ON PVC AND PP PIPE SHALL BE 3.0 FEET. MINIMUM COVER ON DUCTILE IRON PIPE SHALL BE 1.0 FOOT.
- 11. SANITARY SEWER MANHOLE FRAMES AND COVERS SHALL CONFORM TO CITY STANDARD NO. 06.01.02.
- 12. SANITARY SEWER MANHOLES SHALL CONFORM TO CITY STANDARD NOS. 04.01.01, 04.01.02, 04.01.03 AND 04.01.04. ALL MANHOLES SHALL BE CHANNELED FOR FUTURE LINES AS SPECIFIED ON THESE PLANS. MANHOLE STEPS AND LADDER SHALL CONFORM TO STANDARD NO. 06.01.03.
- 13. SANITARY SEWER PIPE AND SIDE SEWERS SHALL BE 10 FEET AWAY FROM BUILDING FOUNDATIONS AND/OR ROOF LINES WITH THE EXCEPTION OF SIDE SEWERS THAT PROVIDE SERVICE TO A SINGLE-FAMILY RESIDENCE. AT THE DISCRETION OF THE REVIEW ENGINEER, A LICENSED PROFESSIONAL ENGINEER WILL BE REQUIRED TO STAMP THE DESIGN TO ACCOUNT FOR DEPTH OR PROXIMITY TO FOUNDATION, STEEP SLOPES, OR OTHER
- 14. NO SIDE SEWERS SHALL BE CONNECTED TO ANY HOUSE OR BUILDING UNTIL ALL MANHOLES ARE ADJUSTED TO THE FINISHED GRADE OF THE COMPLETED ASPHALT ROADWAY AND THE ASPHALT PATCH AND SEAL AROUND THE RING ARE ACCEPTED.
- 15. FOR COMMERCIAL DEVELOPMENTS IN WHICH SOURCES OF GREASE AND/OR OILS MAY BE INTRODUCED TO THE CITY SANITARY SEWER SYSTEM, A CITY APPROVED GREASE INTERCEPTOR SHALL BE INSTALLED DOWNSTREAM FROM THE SOURCE.

SEWERS SHALL BE TESTED PER SECTION 406 OF THE CITY STANDARDS

16. ONCE SEWER AND ALL OTHER UTILITY CONSTRUCTION IS COMPLETED, ALL SANITARY SEWER MAINS AND SIDE



PUYALLUP 2ND STREET APARTMENTS

Project Title:

SPP MANUFACTURING

P.O.BOX 64160 **TACOMA, WA 98464** DON HUBER


Project No.


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Issue Set & Date:

SITE DEVELOPMENT **PERMIT SET**





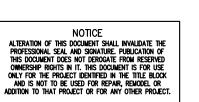
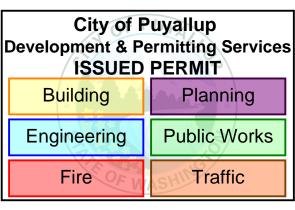
<u>Revisions:</u>

Sheet Title:

WATER AND SEWER NOTES AND DETAILS

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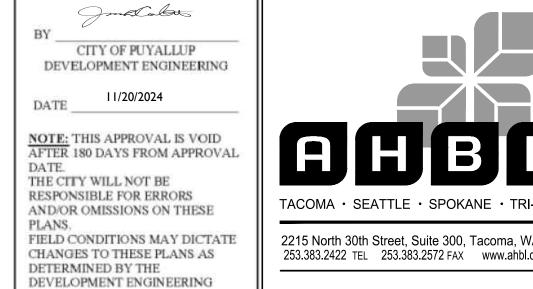
Sheet No.

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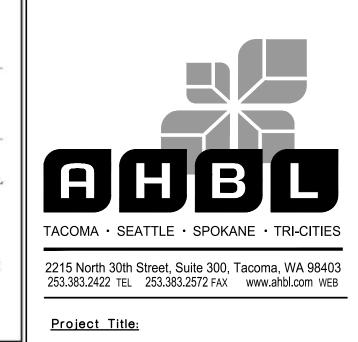
POST INDICATOR VALVE (PIV)

A PORTION OF THE NW 1/4 OF THE NW 1/4 OF SEC. 27, TWN. 20 N., RGE. 04 E. W.M. CITY OF PUYALLUP, PIERCE COUNTY, WASHINGTON.



APPROVED

MANAGER.



PUYALLUP 2ND STREET **APARTMENTS**

SPP MANUFACTURING

P.O.BOX 64160 **TACOMA, WA 98464** DON HUBER

<u>Project No.</u>


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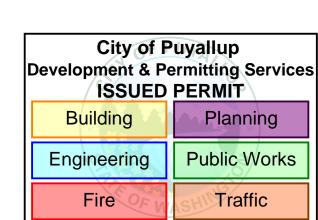
Issue Set & Date:

SITE DEVELOPMENT **PERMIT SET**

10/8/2024





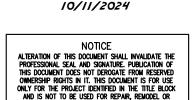


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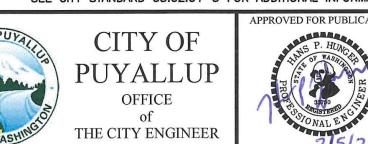
22 of 25 Sheets




TΛ	RIF	1.	CONCRETE	RI	OCKING	FOR	VERTICAL	RENDS

		· OONONLI		0 1010	VERTICAL DE		
PIPE DIAMETER (INCHES)	TEST PRESSURE (PSI)	BEND ANGLE (DEG)	CONCRETE VOLUME (FT ³)	CUBE SIZE (FEET)	CHAIN SIZE (INCHES)	CHAIN EMBEDMENT (INCHES)	
	11.25°	6	1.8				
4"	200	22.5°	12	2.3	3/8"	17"	
		45°	22	2.8			
		11.25°	14	2.4			
6"	200	22.5°	27	3.0	3/8"	17"	
		45°	50	3.7			
		11.25°	25	2.9			
8"	200	22.5*	48	3.6	3/8"	17"	
		45°	89	4.5			
10" 200		11.25°	38	3.4	3/8"	17"	
	200	22.5°	75	4.2			
		45°	139	5.2			
		11.25°	55	3.8	3/8"	17"	
12"	200	22.5°	108	4.8	3/6	''	
		45°	200	5.8	1/2"	24"	
		11.25°	75	4.2	3/8"	17"	
14"	200	22.5°	147	5.3	1/2"	20"	
		45°	272	6.5	1/2"	27"	
		11.25*	98	4.6	3/8"	17"	
16"	200	22.5°	192	5.8	1/2"	24"	
		45°	355	7.1	3/4"	30"	

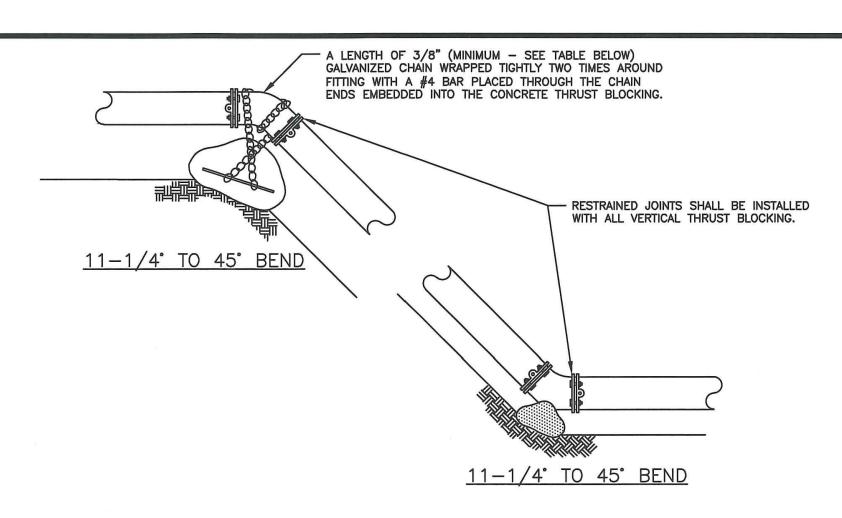ALL NOTES ON CITY STANDARD 03.02.01-1 SHALL APPLY TO THIS DETAIL. SEE CITY STANDARD 03.02.01-3 FOR ADDITIONAL INFORMATION.



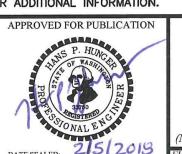

VERTICAL THRUST BLOCKING

03.02.01-2

VERTICAL THRUST BLOCKING	ı
NOT TO SCALE	

С **PRESSURE** 90° BEND | 45° BEND | 22.5° BEND | 11.25° BEND (PSI) DEAD ENDS SIZE 1,225 4" 200 3,140 4,440 2,405 615 9,995 5,410 2,760 1,385 7,070 200 12,565 17,770 9,620 4,905 2,465 8" 200 19,635 10" 200 5,545 12" 28,275 39,985 21,640 11,030 200 7,545 15,015 14" 200 38,485 54,425 29,455 200 71,085 38,470

TABLE 2: THRUST AT FITTINGS AT 200 PSI

THRUST FITTINGS AT 200 PSI

TABLE 3: BEARING VALUE OF SOIL

SOIL TYPE	SAFE BEARING LOAD LBS/SF
MUCK, PEAT, ETC.	0
SOFT CLAY/ALLUVIAL SOIL	1,000
SAND	2,000
SAND AND GRAVEL	3,000
SAND AND GRAVEL CEMENTED WITH CLAY	4,000
HARD SHALE	10,000

SEE CITY STANDARDS 03.02.01-1 AND 03.02.01-2 FOR ADDITIONAL INFORMATION.

1 TO DETERMINE THRUST AT PRESSURES OTHER THAN PSI SHOWN, MULTIPLY THE THRUST OBTAINED IN TABLE 2 BY THE RATIO OF THE PRESSURE

THE THRUST ON A 12 INCH, 90° BEND AT 300 PSI.

 $39,985 \times \frac{300 \text{ PS}}{200 \text{ PS}} = 59,978 \text{ LBS}$

2 TO DETERMINE THE BEARING AREA OF THE THRUST BLOCK IN SQUARE FEET (SF): SEE TABLE 3, BEARING VALUE OF SOIL


FOR SAND AND GRAVEL BEARING VALUE FROM TABLE 3 IS 3,000 LBS/SF

59,978 LBS ÷ 3000 LB/SF = 20 SF OF AREA

(5) NO WATER MAIN SHALL DEAD END AGAINST A MAIN LINE VALVE. DEAD END WATER MAINS SHALL BE BLOCKED AGAINST A RESTRAINED MECHANICAL

THE CITY ENGINEER

THRUST BLOCKING TABLE

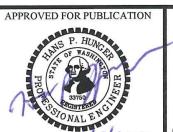

THRUST BLOCKING TABLE

CITY STANDARD 03.02.01-3

WATER AND SEWER NOTES AND DETAILS

Sheet No.



THE CITY ENGINEER

DATE: February 6, 2024 FILENAME: Q:\2019\2190606\10_CIV\CAD_Final Design\2190606-SH-SSWR-WATR-DETL.dwg

NOTE: DRAWINGS DEPICT BLOCK LOCATION, NOT SIZE. FOR SIZE SEE NOTES 3, 4, 5, AND CITY STD. 03.02.01-3

DIRECTION CHANGE,

TEE USED AS ELBOW

THRU LINE CONNECTION,

CROSS USED AS TEE

B. THE PIPE FITTING(S) AND BOLTS MUST BE ACCESSIBLE. WRAP IN PLASTIC BEFORE POURING CONCRETE BLOCKING.

DIVIDE THRUST BY SAFE BEARING LOAD TO DETERMINE REQUIRED AREA (IN SQUARE FEET) OF CONCRETE TO DISTRIBUTE LOAD.

C. CONCRETE SHOULD BE CURED FOR AT LEAST 5 DAYS AND SHOULD HAVE A MINIMUM COMPRESSION STRENGTH OF 3,000 PSI AT 28

(COLUMN B)

THE FOLLOWING PRECAUTIONS MUST BE OBSERVED WHEN CONSTRUCTING THRUST BLOCKS:

D. RESTRAINED JOINTS SHALL BE INSTALLED, IN ADDITION TO CONCRETE THRUST BLOCKING.

HORIZONTAL THRUST BLOCKING

E. BLOCKS MUST BE POSITIONED TO COUNTERACT THE DIRECTION OF THE RESULTANT THRUST FORCE.

BEARING SURFACE AREAS TO BE ADJUSTED BY THE ENGINEER FOR OTHER PRESSURE AND/OR SOIL CONDITIONS

ALL PIPE SHALL BE PROPERLY BEDDED, SEE CITY OF PUYALLUP STANDARD BEDDING DETAIL NO. 06.01.01.

A. BLOCKS MUST BE POURED OR PLACED AGAINST UNDISTURBED SOIL.

CONTRACTOR TO PROVIDE BLOCKING ADEQUATE TO WITHSTAND FULL TEST PRESSURE.

DEAD END

(COLUMN A)

(COLUMNS B TO E)

CONNECTION, TEE

(COLUMN C)

HORIZONTAL THRUST

BLOCKING

03.02.01-1

2

DIRECTION CHANGE, CROSS USED AS ELBOW



Call before you dig.

NOTES:

45° BEND (COLUMN C)

A PORTION OF THE NW 1/4 OF THE NW 1/4 OF SEC. 27, TWN. 20 N., RGE. 04 E. W.M. CITY OF PUYALLUP, PIERCE COUNTY, WASHINGTON.

METER BOX: ARMORCAST POLYMER CONCRETE BOX

A6001947TDW AND RPM DROP-IN LID A6000481DT-H7.

- 1-1/2" OR 2" METER: SENSUS OMNI R2

 FLEX NET TRANSMITTER 520M SINGLE PORT TOUCH COUPLE

JSE 316 GRADE STAINLESS

- 4-16"X8"X4" SOLID

(SEE NOTE 8)

STEEL BOLTS AND TEFLON NUTS

ON METER FLANGE CONNECTIONS

CONCRETE BLOCKS, TYPICAL

COPPERSETTER: FORD 1-1/2"

VH76-18B-11-66 OR 2" VH77-18B-11-77 OR

APPROVED EQUAL

NORMALLY THE WATER METER BOX SHOULD BE LOCATED IN THE PLANTING STRIP. IF SIDEWALK IS AGAINST THE CURB, PLACE METER BOX

WATER MAINS SHALL HAVE A MINIMUM COVER OF 36" IN IMPROVED RIGHT-OF-WAY AND IMPROVED EASEMENTS, AND A MINIMUM OF 48" IN

THE WATER SERVICE LINE SHALL BE BEDDED IN WASHED SAND WITH 36" OF COVER BELOW FINISHED GRADE WITHIN THE RIGHT-OF-WAY. THE

ALL POLY PIPE SHALL BE HIGH DENSITY POLY (IRON PIPE SIZE) MEETING ASTM D-2239-SIDR 7, BLUE IN COLOR, 200 PSI MINIMUM.

FOR A 1-1/2" WATER SERVICE, ALL MATERIAL SHALL BE 2" FROM THE WATER MAIN TO THE COPPERSETTER. REDUCE FROM 2" TO 1-1/2"

THE STAINLESS STEEL METER FLANGE BOLTS SHALL BE 5/8" DIAMETER FOR THE 1-1/2" METER, AND 3/4" DIAMETER FOR THE 2" METER.

PROVIDE A 6" CIRCULAR VALVE BOX WITH COVER (APPLIED ENGINEERING PRODUCT MODEL 708 WITH GREEN LID OR AN APPROVED EQUAL) OVER

DIRECTLY BEHIND THE SIDEWALK. THE WATER METER BOX SHALL NOT BE LOCATED IN HARD SURFACES. WHEN UNAVOIDABLE, EXCEPTIONS CAN

TWO ON EACH SIDE OF BOX

#12 LOCATE WIRE

FORD PACK JOINT COUPLING -

(SEE NOTE 4)

CONCRETE

C16-77 OR APPROVED EQUAL

A6001640TX12 WITH POLYMER CONCRETE COVER

READING IN 1 CUBIC FEET

2"X4" BRASS

(SEE NOTE 7)

(SEE NOTE 4)

(SEE NOTES 5 AND 6)

ALL MATERIALS AND FITTINGS SHALL BE AS SPECIFIED OR AN APPROVED EQUAL.

BE MADE AT END OF CUL-DE-SACS OR PAN HANDLED LOTS.

ALL POLY PIPE COUPLINGS SHALL USE PIPE INSERT STIFFENERS.

WATER SERVICE LINE SHALL BE ONE CONTINUOUS PIECE WITH NO SPLICES.

UNIMPROVED RIGHT-OF-WAY AND UNIMPROVED EASEMENTS.

IMMEDIATELY BEFORE COPPERSETTER.

BY-PASS VALVE.

FORD PACK JOINT COUPLING -

2" POLY PIPE WATER SERVICE LINE

C86-77 OR APPROVED EQUAL

FOR 1-1/2" SERVICE INSTALL

2"X1-1/2" BRASS BUSHING ON BACK SIDE OF BRASS 45° BEND

FINISHED GRADE

10" MIN.

12" MAX.

VALVE BOX AND COVER


OVER BY-PASS VALVE

#12 LOCATE WIRE


PLACE TWO 18"

LONG GALV. PIPES IN EYE BRACE

(SEE NOTE 9)

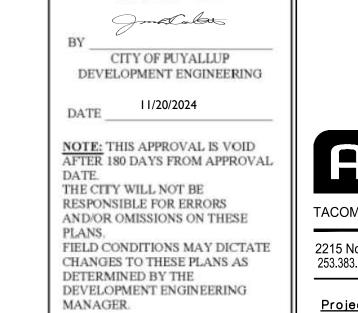

APPROVED

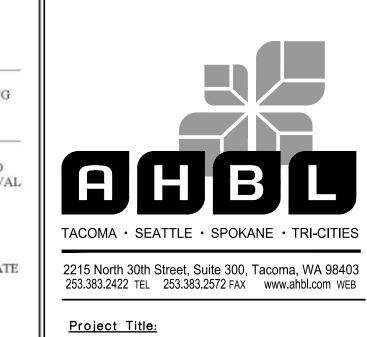

PUYALLUP 2ND STREET

APARTMENTS

SPP MANUFACTURING

P.O.BOX 64160

TACOMA, WA 98464

DON HUBER

2190606.10

SITE DEVELOPMENT

PERMIT SET

10/8/2024


10/11/2024

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Project No.

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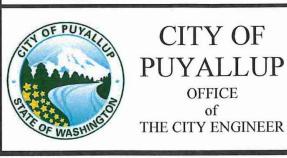


WATER MAINS SHALL HAVE A MINIMUM COVER OF 36" FROM PAVED FINAL GRADE IN IMPROVED RIGHT-OF-WAY AND IMPROVED EASEMENTS, AND A MINIMUM OF

- VALVE OPERATING NUT EXTENSIONS ARE REQUIRED WHEN THE VALVE NUT IS MORE THAN FIVE (5) FEET BELOW FINISHED GRADE. EXTENSIONS ARE TO BE A MINIMUM OF TWO (2) FEET LONG. ONLY ONE EXTENSION TO BE USED PER VALVE. TOP OF EXTENSION SHALL BE 2 FEET 6 INCHES TO 3 FEET BELOW
- ALL VALVE OPERATING NUT EXTENSIONS ARE TO BE MADE OF STEEL, SIZED AS NOTED, AND PAINTED WITH TWO COATS OF METAL PAINT.
- VALVE BOXES SHALL BE TWO-PIECE, ADJUSTABLE, CAST IRON WITH EXTENSION PIECES (IF NECESSARY), AS MANUFACTURED BY THE VANRICH #940 SEATTLE OR APPROVED EQUAL. THE WORD "WATER" SHALL BE CAST IN RELIEF ON THE VALVE BOX COVER. VALVE BOX TOPS INSTALLED IN ARTERIAL ROADWAYS SHALL BE MANUFACTURED BY EAST JORDAN (EJ) IRONWORKS MODEL 8555 WITH LOCKING VALVE BOX COVER MODEL 6800 (PART# 06800025U) OR APPROVED EQUAL.
- NEAT LINE CUTS SHALL BE SEALED WITH A HOT PAVING GRADE ASPHALT AND FACE OF CUT TACKED.
- WATER MAINS SHALL BE CONSTRUCTED AND TESTED IN ACCORDANCE WITH DIVISION 7 OF THE WSDOT STANDARD SPECIFICATIONS SUPPLEMENTED WITH THE
- A. DUCTILE IRON PIPE SHALL CONFORM TO AWWA C 151, THICKNESS CLASS 52, AND THE EXTERIOR SHALL BE COATED WITH COAL TAR VARNISH. PIPE AND FITTINGS SHALL BE MORTOR LINED AND SHALL CONFORM TO AWWA C 104. THE THICKNESS OF THE LINING SHALL BE NOT LESS THAN 1/16" THICK FOR 3" TO 12" PIPE, 3/32" THICK FOR 14" TO 24" PIPE, AND 1/8" THICK FOR 30" TO 54" PIPE. THE CEMENT LINING SHALL CONFORM TO THE
- B. JOINTS SHALL BE TYTON PUSH-ON JOINTS, OR APPROVED EQUAL, OR MECHANICAL JOINT TYPE PER AWWA C 111 EXCEPT WHERE FLANGED JOINTS ARE REQUIRED TO CONNECT TO VALVES OR OTHER EQUIPMENT.
- C. BOLTS AND NUTS FOR BURIED FLANGES LOCATED OUTDOORS, ABOVE GROUND, OR IN OPEN VAULTS IN STRUCTURES SHALL BE TYPE 316 STAINLESS STEEL COMFORMING TO ASTM A 193, GRADE B8M FOR BOLTS, AND ASTM A 194, GRADE 8M FOR NUTS. BOLTS AND NUTS LARGER THAN ONE AND ONE-QUARTER (1-1/4) INCHES SHALL BE STEEL, ASTM A 307, GRADE B, WITH CADMIUM PLATING, ASTM A 165, TYPE NS.
- D. BOLTS USED IN FLANGE INSTALLATION SETS SHALL CONFORM TO ASTM B 193, GRADE B7. NUTS SHALL COMPLY WITH ASTM A 194, GRADE 2H.
- PROVIDE A WASHER FOR EACH NUT, WHERE NEEDED. WASHERS SHALL BE OF THE SAME MATERIAL AS THE NUTS.
- F. ALL FITTINGS SHALL CONFORM TO THE REQUIREMENTS OF AWWA C 110 AND AWWA C 111.
- RESILIENT SEATED WEDGE GATE VALVES SHALL BE USED FOR TEN (10) INCH MAINS AND SMALLER. BUTTERFLY VALVES SHALL BE USED FOR MAINS GREATER THAN TEN (10) INCHES.
- 1) RESILIENT SEATED WEDGE GATE VALVE: GATE VALVES SHALL CONFORM TO THE LATEST AWWA SPECIFICATIONS FOR COLD WATER, DOUBLE-DISK GATE VALVES, 200 PSI WORKING PRESSURE, THEY SHALL BE IRON-BODIED, BRONZE MOUNTED, NON-RISING STEM, WITH TWO (2) INCH SQUARE NUT. COUNTER-CLOCKWISE OPENING, MECHANICAL JOINT AND / OR FLANGED ENDS (6" VALVES ON FIRE HYDRANT LINES WHICH SHALL BE MECHANICAL JOINTS BY FLANGED). VALVE STEMS SHALL BE PROVIDED WITH O-RING SEALS AND SHALL BE AS MANUFACTURED BY THE MUELLER COMPANY OR
- 2) BUTTERFLY VALVES: BUTTERFLY VALVES CONFORMING WITH AWWA C 504, CLASS 150 AND SHALL HAVE STANDARD AWWA TWO (2) INCH SQUARE NUT.

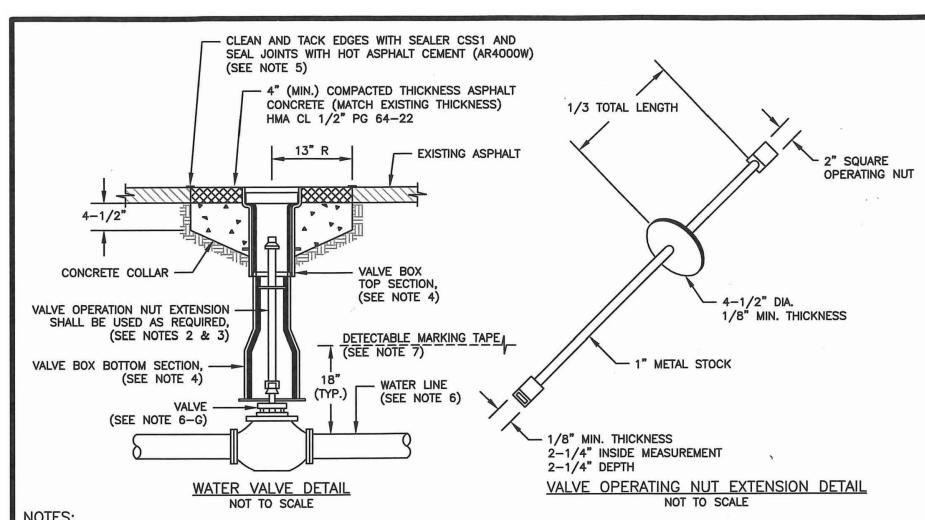NOT TO SCALE

DETECTABLE MARKING TAPE SHALL BE INSTALLED 18" ABOVE PIPE, BE BLUE IN COLOR, AND READ "CAUTION WATER LINE BELOW" MEETING WSDOT SPEC. 9-15.18.



Know what's below.

Call before you dig.

WATER VALVES

AND MAINS

03.01.01

THE CITY ENGINEER

1-1/2" AND 2" WATER SERVICE CONNECTION 03.03.02

SEWER MAIN TAP

- EXISTING

VALVE BOX SHALL BE

2" RESILIENT SEATED

DOUBLE STRAP SADDLE,

FORD FSD202 OR

APPROVED EQUAL

2"X4" BRASS

INSTALLED AS SPECIFIED I

CITY STANDARD 03.01.01

WATER VALVES AND MAIN

WEDGE GATE VALVE WITH

2" SQUARE OPERATING NU


WATER MAIN


(VARIOUS SIZES)

ASPHALT

NOTES FOR CONNECTING TAPS ON EXISTING SEWER MAINS

- 1. THE TEE FITTING SHALL BE A ROMAC INDUSTRIES STYLE "CB" SEWER SADDLE (OR APPROVED EQUAL). ONLY NEW SADDLE AND PARTS SHALL BE INSTALLED. DUE TO PIPE SIZE MATERIALS OR PIPE CONDITION, THE CITY ENGINEER MAY REQUIRE AN ALTERNATE METHOD/MATERIAL BE USED.
- 2. THE SEWER MAIN TAP SHALL BE CUT WITH A SEWER PIPE TAPPING MACHINE (HOLE SAW) CAPABLE OF RETAINING THE COUPON.
- 3. THE ROUND HOLE CUT INTO THE SEWER MAIN SHALL BE NO LARGER THAN THE INSIDE DIAMETER OF THE SADDLE GASKET. THE HOLE SAW CUT EDGES SHALL BE SMOOTH.
- 4. THE COUPON SHALL BE RETAINED AND SURRENDERED TO THE INSPECTOR. THE PERMIT HOLDER WILL PAY ALL COSTS ASSOCIATED WITH THE LOCATION AND RETRIEVAL OF A LOST COUPON. ADDITIONALLY THE PERMIT HOLDER WILL BE HELD LIABLE FOR ANY SUBSEQUENT DAMAGES CAUSED BY A LOST COUPON.
- 5. BOLTS SHALL BE TORQUED TO MANUFACTURE SPECIFICATIONS, THEN RETORQUED AFTER 10 MINUTES.
- 6. NO TAPS SHALL BE ALLOWED ON EXISTING SEWER MAINS OVER 18" IN DIAMETER. CONNECTIONS INTO SEWER MAINS OVER 18" IN DIAMETER SHALL INTERSECT THE SEWER MAIN IN A MANHOLE. IN SOME CASES THE CITY ENGINEER MAY ALLOW A VARIANCE TO THIS REQUIREMENT.
- 7. ALL TRENCHING, BEDDING, AND BACKFILL SHALL BE IN ACCORDANCE WITH CITY STANDARD DETAIL NO. 06.01.01. ALL ASPHALT REPAIR SHALL BE IN ACCORDANCE WITH CITY STANDARD NO. 01.01.20. ALL ADDITIONAL UTILITY AND RIGHT OF WAY REPAIRS SHALL BE INACCORDANCE WITH THE "CITY STANDARDS" MANUAL.
- 8. THE CITY OF PUYALLUP WILL CONDUCT A "SEWER MAIN VIDEO INSPECTION" OF THE SEWER TAP. THE PERMIT HOLDER WILL BE REQUIRED TO REPAIR ANY SEWER TAP CONSTRUCTION DEFECTS FOUND BY THE CITY INSPECTORS. THE COST OF ALL REPAIRS AND SUBSEQUENT "SEWER MAIN VIDEO INSPECTIONS" WILL BE THE RESPONSIBILITY OF THE PERMIT HOLDER. THE DAMAGE DEPOSIT POSTED BY THE BUILDER WILL BE HELD UNTIL PROBLEMS ARE CORRECTED. DUE TO PUBLIC HEALTH AND SAFETY, BUILDING OCCUPANCY WILL NOT BE ALLOWED UNTIL REPAIRS ARE COMPLETED AND ACCEPTED BY THE CITY ENGINEER.

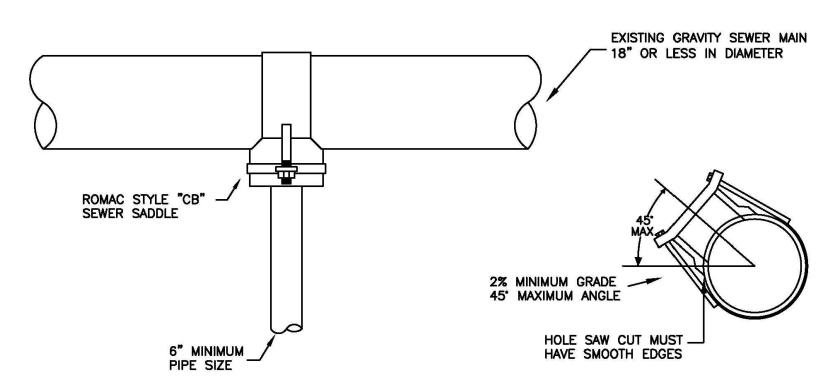

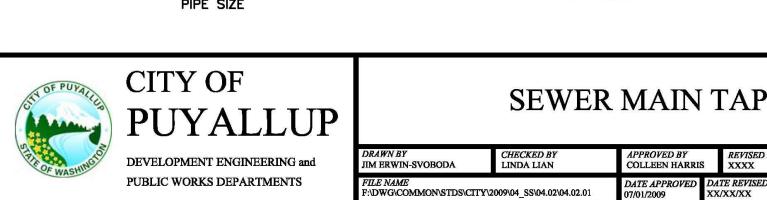

City of Puyallup Development & Permitting Services **ISSUED PERMIT** Building Planning **Public Works** Engineering

Traffic

Revisions:

Sheet Title:

04.02.01

WATER AND SEWER NOTES AND DETAILS

Designed by: Drawn by: Checked by: MW


Sheet No.

23 of 25 Sheets

WATER VALVES AND MAINS


1.5 INCH AND 2 INCH WATER SERVICE CONNECTION

A PORTION OF THE NW 1/4 OF THE NW 1/4 OF SEC. 27, TWN. 20 N., RGE. 04 E. W.M. CITY OF PUYALLUP, PIERCE COUNTY, WASHINGTON.

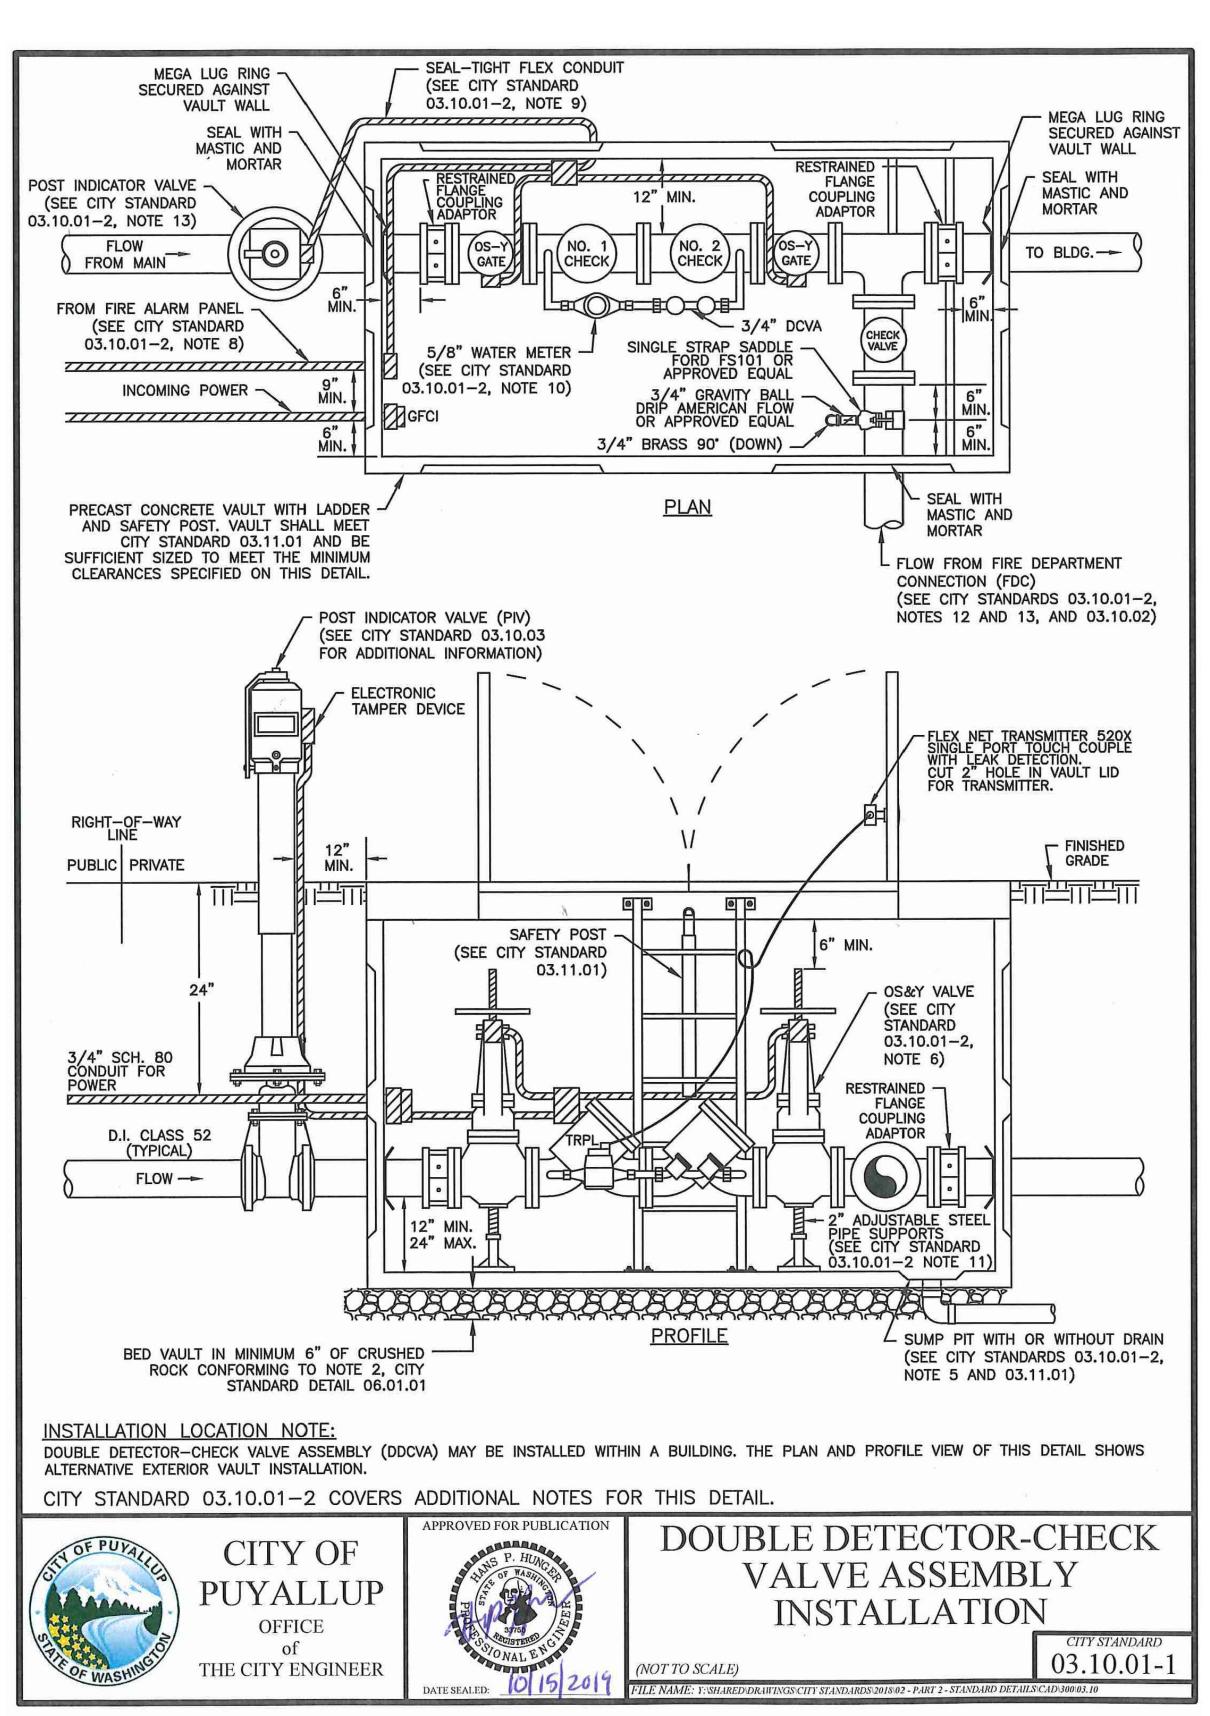

NOTES FOR: DOUBLE DETECTOR CHECK VALVE ASSEMBLY (DDCVA) INSTALLATION CITY STANDARD 03.10.01-1

- BACKFLOW ASSEMBLY MUST BE SELECTED FROM WASHINGTON STATE DEPARTMENT OF HEALTH'S LIST OF BACKFLOW PREVENTION ASSEMBLIES APPROVED FOR INSTALLATION IN WASHINGTON STATE, LATEST EDITION.
- THE DDCVA SHALL BE INSTALLED WITH ADEQUATE SPACE TO FACILITATE MAINTENANCE AND TESTING. IT SHALL BE TESTED AFTER INSTALLATION, BY A WASHINGTON STATE CERTIFIED BACK-FLOW ASSEMBLY TESTER, TO INSURE ITS SATISFACTORY OPERATION BEFORE OCCUPANCY, AND ANNUALLY THEREAFTER. SEND TEST RESULTS TO: CITY OF PUYALLUP, WATER QUALITY OPERATIONS, 1100 39TH AVE SE, PUYALLUP, WA 98374.
- 3. DDCVA MUST BE PURCHASED AS A UNIT. NO MODIFICATIONS TO THE ASSEMBLY ARE ALLOWED.
- DDCVA IS ALLOWED TO BE LOCATED WITHIN A BUILDING AS APPROVED BY THE FIRE CODE OFFICIAL. WHEN THE DDCVA IS LOCATED WITHIN A BUILDING, THE FIRE DEPARTMENT CONNECTION (FDC) BALL DRIP SHALL DRAIN TO THE NEAREST APPROVED ON-SITE STORM DRAINAGE STRUCTURE.
- IN A VAULT INSTALLATION, IF VAULT CANNOT BE DRAINED TO DAYLIGHT, A 1/4 HP SUMP PUMP SHALL BE INSTALLED IN THE SUMP PIT OF THE VAULT. IT SHALL BE WIRED PER WASHINGTON STATE ELECTRICAL CODE, AND INSPECTED BY A STATE ELECTRICAL INSPECTOR. THE DISCHARGE PIPE SHALL BE CONNECTED TO THE NEAREST APPROVED ON-SITE STORM DRAINAGE STRUCTURE.
- 6. DDCVA OUTSIDE STEM AND YOKE (OS&Y) GATE VALVES, AND THE POST INDICATOR VALVE (PIV), SHALL HAVE SUPERVISED TAMPER SWITCHES.
- 7. ALL ELECTRICAL SHALL BE INSPECTED BY A WASHINGTON STATE ELECTRICAL INSPECTOR.
- 8. IN A VAULT INSTALLATION, RUN TWO 3/4" SCHEDULE 80 P.V.C. CONDUITS TO THE VAULT. ONE WILL BE USED FOR A GFCI PROTECTED OUTLET AND ONE WILL BE FOR LOW VOLTAGE COMING FROM THE FIRE ALARM PANEL, INSTALL AN APPLETON FSCA OR FDCA CAST DEVICE BOX OR APPROVED EQUAL ON THE VAULT WALL AT THE CONDUIT PENETRATION.
- 9. IN A VAULT INSTALLATION, RUN LOW VOLTAGE WIRE INSIDE VAULT AND TO PIV THROUGH SEAL-TIGHT FLEX CONDUIT. CONDUIT SHALL BE SECURELY FASTENED PERPENDICULAR OR HORIZONTALLY TO THE WALLS OF THE VAULT.
- 10. WATER METER SHALL BE A SENSUS SRII TRPL READING IN 1 CUBIC FEET.
- 11. PIPE SUPPORTS SHALL BE RUST-PROTECTED WITH ALUMINUM PAINT.
- 12. THE FDC SHALL BE LOCATED WITHIN 15 FEET OF A FIRE HYDRANT, BUT NOT LESS THAN 10 FEET.
- 13. THE FDC AND PIV SHALL BE A MINIMUM OF 50 FEET FROM A BUILDING, UNLESS APPROVED BY THE CITY OF PUYALLUP FIRE CODE OFFICIAL, BUT NEVER LESS THAN 5 FEET FROM BUILDING.
- 14. A DDCVA INSTALLED MORE THAN 5 FEET ABOVE THE FLOOR LEVEL MUST HAVE A PLATFORM UNDER IT FOR THE TESTER OR MAINTENANCE PERSON TO STAND ON. THE PLATFORM MUST BE OSHA APPROVED AND MEET ALL APPLICABLE SAFETY STANDARDS AND CODES.

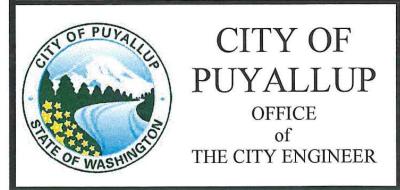



DOUBLE DETECTOR-CHECK VALVE ASSEMBLY INSTALLATION (NOTES)

03.10.01-2

DOUBLE DETECTOR-CHECK VALVE ASSEMBLY INSTALLATION



DOUBLE DETECTOR-CHECK VALVE ASSEMBLY INSTALLATION (NOTES)

APPROVED mo Calous CITY OF PUYALLUP DEVELOPMENT ENGINEERING NOTE: THIS APPROVAL IS VOID AFTER 180 DAYS FROM APPROVAL THE CITY WILL NOT BE RESPONSIBLE FOR ERRORS AND/OR OMISSIONS ON THESE PLANS. 2215 North 30th Street, Suite 300, Tacoma, WA 98403 FIELD CONDITIONS MAY DICTATE CHANGES TO THESE PLANS AS 253.383.2422 TEL 253.383.2572 FAX www.ahbl.com WEB

DETERMINED BY THE

MANAGER.

DEVELOPMENT ENGINEERING

PUYALLUP 2ND STREET **APARTMENTS**

Project Title:

SPP MANUFACTURING

P.O.BOX 64160 **TACOMA, WA 98464** DON HUBER

Project No.


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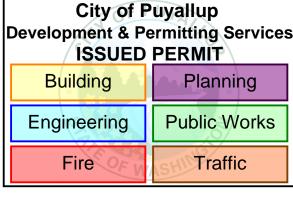
Issue Set & Date:

SITE DEVELOPMENT **PERMIT SET**

10/8/2024





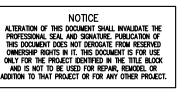

Revisions:

Sheet Title:

WATER AND SEWER NOTES AND DETAILS

<u>Drawn by:</u> <u>Checked by:</u>

Sheet No.

A PORTION OF THE NW 1/4 OF THE NW 1/4 OF SEC. 27, TWN. 20 N., RGE. 04 E. W.M. CITY OF PUYALLUP, PIERCE COUNTY, WASHINGTON.

304 Water System Plan Notes

The following notes shall also be shown on the plans.

WATER SYSTEM NOTES:

- All work in City right-of-way requires a permit from the City of Puyallup. Prior to any work commencing, the general contractor shall arrange for a preconstruction meeting at the Development Services Center to be attended by all contractors that will perform work shown on the engineering plans, representatives from all applicable Utility Companies, the project owner and appropriate City staff. Contact Engineering Services to schedule the meeting (253) 841-5568. The contractor is responsible to have their own approved set of plans at the meeting.
- After completion of all items shown on these plans and before acceptance of the project, the
 contractor shall obtain a "punch list" prepared by the City's inspector detailing remaining
 items of work to be completed. All items of work shown on these plans shall be completed to
 the satisfaction of the City prior to acceptance of the water system and provision of sanitary
 sewer service.
- 3. All materials and workmanship shall conform to the Standard Specifications for Road, Bridge, and Municipal Construction (hereinafter referred to as the "Standard Specifications"), Washington State Department of Transportation and American Public Works Association, Washington State Chapter, latest edition, unless superseded or amended by the City of Puyallup City Standards for Public Works Engineering and Construction (hereinafter referred to as the "City Standards"), or as directed by Fruitland Mutual Water Company (FMWC), Valley Water (VW), or Tacoma City Water (TCW) is the purveyor.
- 4. A copy of these approved plans and applicable city developer specifications and details shall be on site during construction.
- 5. Any revisions made to these plans must be reviewed and approved by the developer's engineer, the Engineering Services Staff, and the FMWC, VW or TCW when served by that purveyor, prior to any implementation in the field. The City shall not be responsible for any errors and/or omissions on these plans.
- The contractor shall have all utilities verified on the ground prior to any construction. Call (811) at least two working days in advance. The owner and his/her engineer shall be contacted immediately if a conflict exists.
- Any structure and/or obstruction which requires removal or relocation relating to this project shall be done so at the developer's expense.
- 8. Bacteriological (Coliform and Iron Bacteria) test samples will be taken by the City (or FMWC, VW or TCW when served by that purveyor) and paid for by the contractor, except for Capital Improvement Projects (CIP) which shall be paid for by the City.
- Water mains shall have a minimum cover of 36 inches from paved final grade in improved right-of-way and improved easements, and a minimum of 48 inches in unimproved right-ofway and unimproved easements.
- Pipe for water mains shall be ductile iron conforming to Section 7-09 of the Standard Specifications, Class 52 with tyton or approved equal joints. Pipe shall be cement lined in accordance with A.S.A. Specification A 21.4-1964.
- 11. Connections to existing water mains typically shall be wet taps through a tapping tee and tapping valve and shall be made by a city approved contractor. The tapping sleeve shall be Romac SST all stainless steel tapping sleeve or approved equal. A two-piece epoxy coated or ductile iron tapping sleeve may be used on ductile iron pipe, when the tap is smaller than the water main size i.e. 6-inch tap on 8-inch pipe. The City (or FMWC, VW or TCW when served by that purveyor) shall approve the time and location for these connections.
- 12. All water mains and appurtenances shall be hydrostatically tested at 200 psi in accordance with Standard Specification 7-09.3(23). Pressure testing shall not be performed until satisfactory purity samples have been received, except when new water mains are installed independently from the water system piping.
- 13. Fire hydrants shall be installed in accordance with City Standard Detail 03.05.01 and as directed by the City of Puyallup Fire Code Official.
- 14. Valve marker posts shall be installed where valve boxes are hidden from view or in unpaved areas. The installation shall be in accordance with City Standard Detail 03.01.02.
- 15. Resilient seated wedge gate valves shall be used for 10-inch mains and smaller. Butterfly valves shall be used for mains greater than 10 inches.
- Pipe fitting for water mains shall be ductile iron and shall be mechanical joint conforming to AWWA Specification C111-72.
- Water main pipe and service connections shall be a minimum of 10 feet away from building foundations and/or roof lines.
- 18. Where a water main crosses the Northwest Gas pipeline, the water line shall be cased with PVC pipe a minimum of 10 feet beyond each side of the gas line easement. Contact Williams Northwest Pipeline before the crossing is made.
- Trenching, bedding, and backfill for water mains shall be installed in accordance with City Standard Detail 06.01.01.
- 20. All commercial and industrial developments, irrigation systems, and multi-family water service connections shall be protected by a double check valve assembly or a reduced pressure backflow assembly as directed by the City (or FMWC, VW or TCW when served by that purveyor) conforming to City Standard Details 03.04.01, 03.04.02, and 03.04.03.
- 21. Any lead joint fitting disturbed during construction shall be replaced with a mechanical joint fitting at the contractor's expense.
- 22. When hydraulic fire flow modeling is required for a project, the City will issue a permit. The hydraulic modeling criteria is based on the projected 2030 water demand, while maintaining a minimum system pressure of 20 pounds per square inch and a maximum velocity of 10 feet per second.

- 23. When using a fire hydrant for non-firefighting purposes, a city hydrant meter must be used. Coordinate the acquisition of the hydrant meter with the City's Utility Billing Division at Puyallup City Hall. A city approved backflow protection assembly shall be installed by the person requesting use of a fire hydrant. The assembly shall be accompanied by a current backflow assembly test report. The test report shall be available at the site for the duration of the hydrant use.
- 24. Should a break occur on any City water main, the Contractor shall follow the City's adopted "Water Main Break Procedure" issued to them at the Pre-Construction Meeting and notify those connected to the system in the impacted area as outlined in the Procedure.
- Water Main Repairs (References: AWWA C651-14 and WSDOT Standard Specification Section 7-09)

(Note: A planned water main repair shall be approved by the City Inspector and/or Water Division Supervisor prior to commencing work.)

- a. Repair without depressurization Small leaks shall be repaired using repair bands while maintaining positive pressure in the water main. Valves surrounding the leak will be partially shut by the City Water Department to reduce the flow and pressure to the area. Blowoffs and hydrants in the reduced pressure area may be opened as needed to further reduce the pressure. The water main trench shall be over-excavated to allow water in the trench to be pumped out and maintained below the level of the water main. The repair shall be completed with the water main pressure remaining positive. After the repair is made, the system shall be fully pressurized and a visual leak inspection will be completed. The water main in the affected area shall be flushed to achieve three pipe volumes pulled from the pipe (distance measured from valve opened for flushing to the exit hydrant or blowoff).
- b. Repair/cut-in with depressurization Trench shall be over excavated and dewatered below the water main. Flush water from pipe from each direction until it runs clear. Immediately prior to installation of a new pipe section for repair or cut in tee, all new fittings and pipe spools shall be swabbed with a five percent (5%) chlorine solution (minimum). The interior of the existing pipe shall be swabbed with a five percent (5%) chlorine solution at least 6 feet in each direction from exposed cut ends. The water main in the affected area shall be flushed to achieve three pipe volumes pulled from the pipe (distance measured from the valve opened for flushing to the exit hydrant or blowoff). Customers shall be notified after the water main is flushed and repairs have been completed, as outlined in the "Water Main Break Procedure."

26. New Water Main Installation:

a. Each new water main section shall be delivered, stacked and stored onsite with ends plugged. The plugs shall remain in the pipe until each particular section is installed. National Sanitation Foundation (NSF) approved sixty-five percent (65%) calcium hypochlorite shall be added to the upstream end of each pipe section, and at each hydrant tee in the amount given in the table below (or per approved manufacturer specifications). The minimum amount of calcium hypochlorite added should be sufficient to achieve a 50 mg/L concentration within the impacted area.

65% Calcium Hypochlorite Addition per Pipe Section

Pipe Volume 5-gram		Hypochlori	Maximum			
Pipe Diameter (Inches)	per 18 feet (gal)	tablets per pipe section	Ounces per 500 feet	Teaspoons per 18 feet	Fill Rate (gpm)	
4	35	1	1.7	0.2	40	
6	53	1	3.8	0.4	90	
8	70	2	6.7	0.7	150	
12	106	4	15.1	1.4	350	
16	141	6	27	2.5	600	

- b. New water mains shall be filled using an approved backflow prevention assembly. The water main shall be filled from the lower elevation end so that as the water main is filled, the chorine is contacted, dissolved and spread relatively uniform through the length of the new water main. The fill rate shall be minimized so that the velocity of the water is less than 1 ft/sec (see table above). Successful pressure test and bacteriological tests shall be completed and provided to the City prior to any new mater main connection to the existing water system.
- c. The chlorinated water will be allowed to remain in contact with the new water main system for 24 to 72 hours. After 24 hours, water may be added to the water main for the purposes of pressure testing. The water in the main used for pressure testing must remain in the water main until pressure test is completed. If necessary, liquid chlorine shall be injected into the water main with fill water to maintain a concentration in the water main above 50 mg/L. Under no circumstance shall "super" chlorinated water be allowed to sit within a new water main for more than 5 days.
- d. Pressure testing includes testing against new valves and hydrants. Each valve shall be tested by closing each in turn and reducing the pressure beyond the valve. The pressure on the back side of the valve should not be eliminated. Care must be taken that, during this process, positive pressure remains throughout the system being tested at all times. All hydrant foot valves shall be open during pressure testing so that the pressure test is against the hydrant valve. Pressure testing will not be allowed against any existing valves.
- e. After successful pressure testing, the water main shall be thoroughly flushed to remove all "super" chlorinated water from the new water main. Flushing of new or extended water mains shall be conducted per WSDOT Specification 7-09.3(24)A with a minimum velocity developed within the pipe while flushing of 2.5 feet per second (fps). All flushed water shall be dechlorinated prior to disposal. The Contractor shall be responsible for disposal of all chlorinated water flushed from mains. The City shall approve the disposal method prior to implementation in the field. The Contractor shall utilize onsite disposal methods, if available. Disposal of flush water to the sanitary sewer system shall not be allowed without written permission from the Water Pollution Control Plant (WPCP) Supervisor. Any planned discharge to a stormwater system shall be dechlorinated to a concentration of 0.1 ppm or less, pH adjusted (if necessary) to be between 6.5 and 8.5, and volumetrically and velocity controlled to prevent any resuspension of sediments. The City will require independent testing throughout the water discharge process to ensure compliance of these standards are met.

- f. Samples for bacteriological analysis shall be collected after flushing and again 24 hours after the first set of samples.
- g. All closure/final connection fittings shall be sprayed clean and then swabbed with a five percent (5%) chlorine solution immediately prior to installation per AWWA Standard C651. Additional samples for bacteriological analysis shall be collected from the immediate vicinity of the new or replaced water main and analyzed after the final connections are made. If necessary, additional flushing shall be conducted and additional samples shall be collected until satisfactory results are obtained.

Jana Calous

APPROVED

CITY OF PUYALLUP
DEVELOPMENT ENGINEERING

11/20/2024

NOTE: THIS APPROVAL IS VOID
AFTER 180 DAYS FROM APPROVAL
DATE.
THE CITY WILL NOT BE
RESPONSIBLE FOR ERRORS
AND/OR OMISSIONS ON THESE
PLANS.

FIELD CONDITIONS MAY DICTATE CHANGES TO THESE PLANS AS DETERMINED BY THE DEVELOPMENT ENGINEERING MANAGER. TACOMA · SEATTLE · SPOKANE · TRI-CITIES

2215 North 30th Street, Suite 300, Tacoma, WA 98403
253.383.2422 TEL 253.383.2572 FAX www.ahbl.com WEB

PUYALLUP 2ND STREET APARTMENTS

nt:

Project Title:

SPP MANUFACTURING

P.O.BOX 64160 TACOMA, WA 98464 DON HUBER

<u>Project No.</u>

2190606.10


Issue Set & Date:

SITE DEVELOPMENT PERMIT SET

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10/8/2024



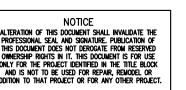

City of Puyallup Development & Permitting Services				
ISSUED PERMIT				
Building	Planning			
Engineering	Public Works			
Fire OF W	Traffic			

4

Revisions:

Sheet Title:

WATER AND SEWER NOTES AND DETAILS

Designed by:

Drawn by: Checked by:

Sheet No.

C4.7

25 of 25 Sheets

Know what's below.

Call before you dig.

