Plan Change Request

Development Services 333 S. Meridian Puyallup, WA 98371 Phone: 253-864-4165 www.cityofpuyallup.org




A plan change request is necessary for civil projects that propose substantial changes to the approved civil plans and requires additional review by City of Puyallup review staff. This application should be filled out completely and sent directly to the City Review Engineer assigned to the civil permit application via email.

Project Information

Site Address/ Parcel #:	Permit #: PRCCP2	0231620
Owner: Washington State Fair	Email:	air.com
Design Engineer: Justin Jones	Email: justin@jmjte	eam.com
Contractor: Absher Construction	Email:	@absherco.com
Originator of the Request: Owner	🔳 Design Engineer 🛛 🗆 Con	tractor 🛛 City of Puyallup
• Does this request require a <u>deviation</u> f	rom city standards? 🗆 Yes 🔳 N	lo
• If yes, submit an <u>Alternative Method's</u>	Request via the <u>CityView Portal</u> in	nstead of this form
> Indicate the development infrastructure be	ing affected	
	e avandance en anno	rading 🛛 Erosion Control
Specify the approved civil plans affected: <u>C</u>	25-101, C5-201, C5-202, C5-2	201, C6-101, C6-201
Describe the change(s) being requested: A new fountain structure and 4 vendor hookups (Sewer, Water, Policy 1)	ower, Comm.) will be installed. The fountain will be p	ermitted under a separate permit. A water connection will be
made from the previously Installed water stub to the proposed for	untain mechanical vault. In addition, a new pre-buil	t sewer lift station will be installed that will pump the fountain
overflow/flushed water and vendor hookup discharge to a previo	ously installed force main that connects out to a sic	de sewer along 9th Ave SW.
All signatures are required to process this be made by the City Review Engineer. All requested changes. Any work completed p approved by the City.	changes must be fully approved/de	enied prior to any work on the
Digitally signed by Marin Mattes Dividually Senar Workenfaircom, Of Washington State Fair, Of Washington State Fair, Operations, CN-Marin Mattes Reasoft I am approving this document Dividual State Fair, Reasoft I am approving this document Dividual State Fair, Owner	Design Engineer	Contractor
		Approved
City Inspector	City Reviewer	Approved/ Denied

City Reviewer

11/26/2024 Date:

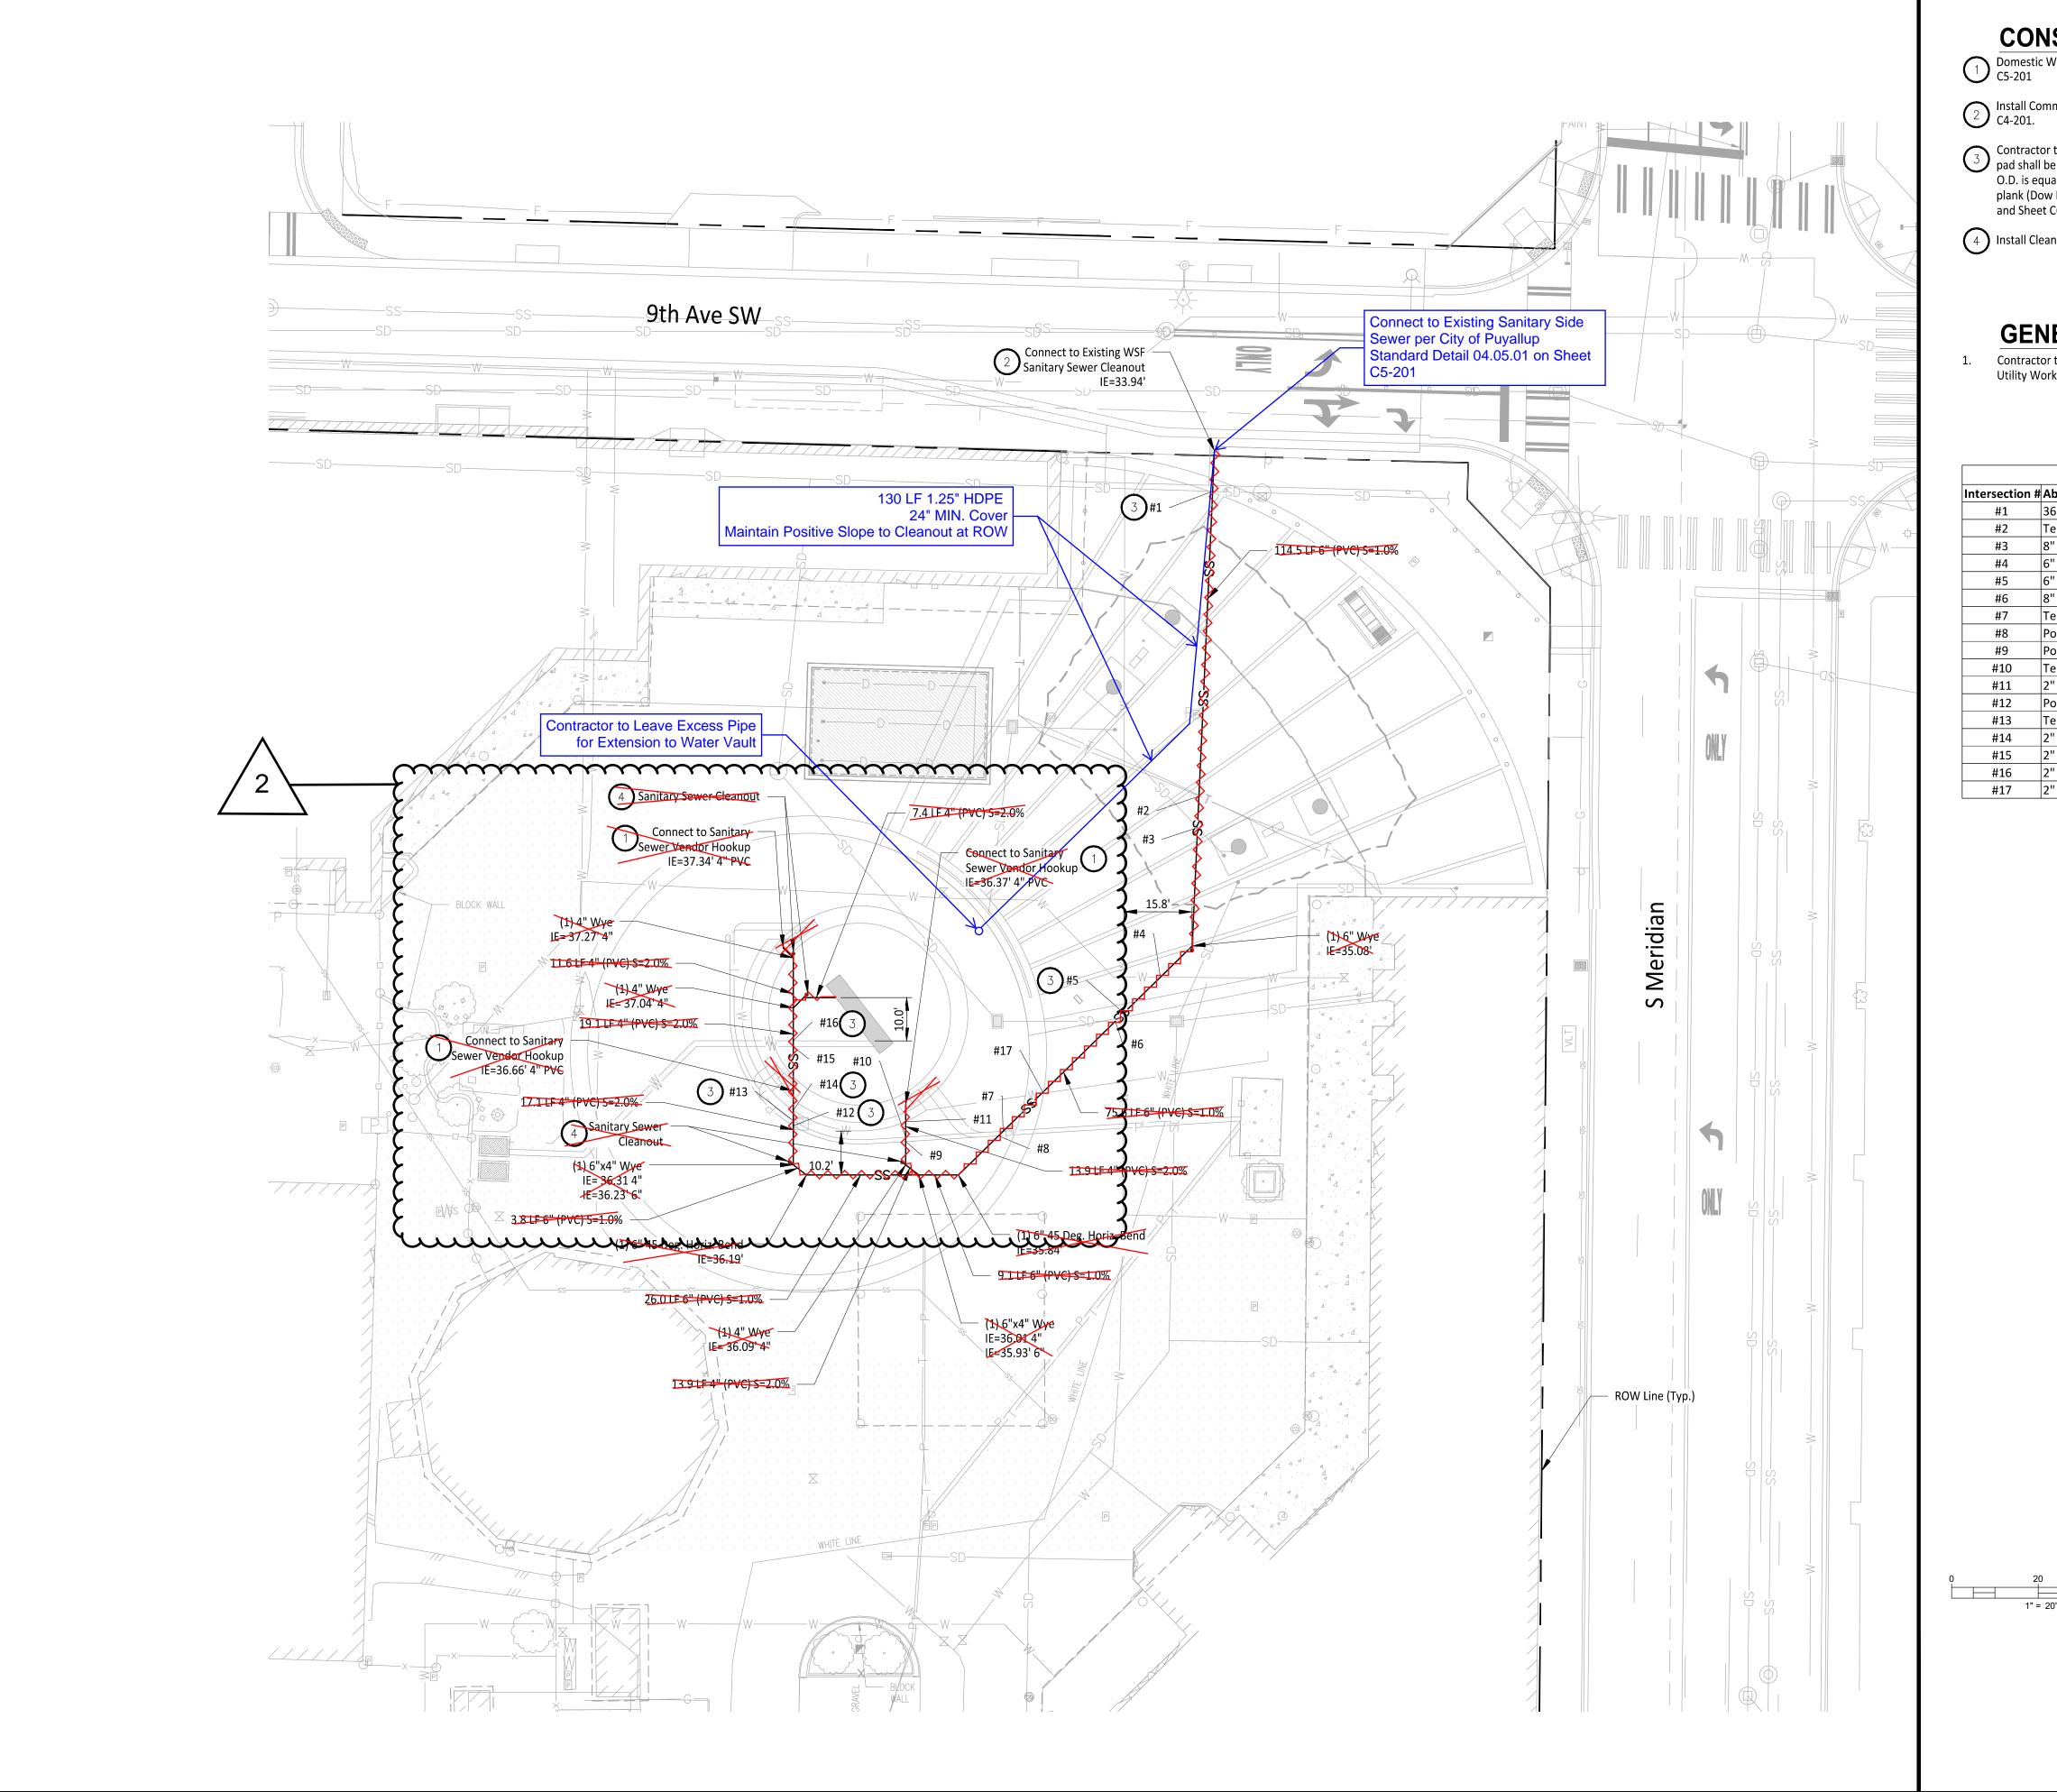



CONSTRUCTION NOTES

Domestic Water Service and Sanitary Sewer Vendor Hook Ups to be Installed per Detail A on Sheet C5-201

Install Commercial Side Sewer Connection per City of Puyallup Standard Detail 04.03.04 on Sheet C4-201.

Contractor to install foam pad between pipe crossings with less than 18" of vertical clearance. The pad shall be O.D. x O.D. x 2.5 inches thick minimum or as required to protect the pipes. Above O.D. is equal to the outside diameter of the larger pipe. The pad shall be a polyethylene foam plank (Dow Plastics Ethafoam 220), or approved equal. See Detail B on Sheet C5-201 for detail, and Sheet C6-201 for City of Puyallup Utility Crossing Standard Details.


4 Install Cleanout per City of Puyallup Standard Detail 04.03.04 on Sheet C4-201.

GENERAL NOTES

1" = 20'

Contractor to Pothole, Locate Horizontal and Vertical Utilities and Verify with Engineer prior to any Utility Work.

	Ut	ility Crossing Table	
on #	Above Crossing Line	Below Crossing Line	Material Vertical Seperation (ft
	36" Conc. Stormwater Pipe	6" PVC Sanitary Sewer Pipe	0.58
	Telecommunications Line	6" PVC Sanitary Sewer Pipe	3.64
	8" DI Stormwater Pipe	6" PVC Sanitary Sewer Pipe	3.16
	6" Cast Iron Water Pipe	6" PVC Sanitary Sewer Pipe	1.59
	6" Cast Iron Water Pipe	6" PVC Sanitary Sewer Pipe	1.17
	8" DI Stormwater Pipe	6" PVC Sanitary Sewer Pipe	2.10
	Telecommunications Line	6" PVC Sanitary Sewer Pipe	1.97
	Power Line	6" PVC Sanitary Sewer Pipe	1.95
	Power Line	6" PVC Sanitary Sewer Pipe	2.46
	Telecommunications Line	6" PVC Sanitary Sewer Pipe	2.44
	2" Poly Water Pipe	6" PVC Sanitary Sewer Pipe	2.00
	Power Line	6" PVC Sanitary Sewer Pipe	1.48
	Telecommunications Line	6" PVC Sanitary Sewer Pipe	1.45
	2" Poly Water Pipe	6" PVC Sanitary Sewer Pipe	1.56
	2" Poly Water Pipe	6" PVC Sanitary Sewer Pipe	1.26
	2" Poly Water Pipe	6" PVC Sanitary Sewer Pipe	1.23
	2" Poly Water Pipe	6" PVC Sanitary Sewer Pipe	1.37

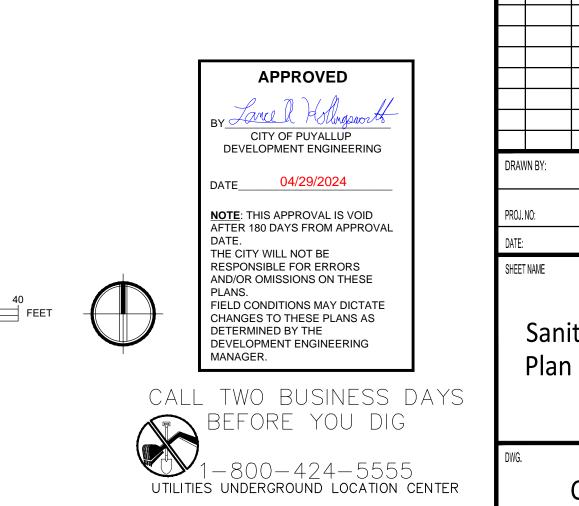

Washington

Owner/Developer:

STATE FAIR PUYALLUP

Washington State Fair 110 9th Ave SW Puyallup, WA 98371 (253) 841-5356

Architect:

Jeff Brown Architecture 12181 C Street South Tacoma, WA 98444 (253) 606-8324 Contact: Jeff Brown




Justin Jones, PE 905 Main St. Suite 200 Sumner, WA 98390 (206) 596-2020

Project:

WSF Gold Gate Redevelopment

Civil Construction Permit

ONE INCH AT FULL SCALE. IF NOT, SCALE ACCORDINGLY

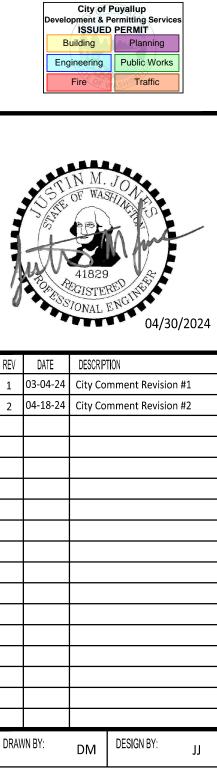


1507-012 April 30, 2024

Sanitary Sewer

<u> 22 ^{0F} 27 </u>

C5-101

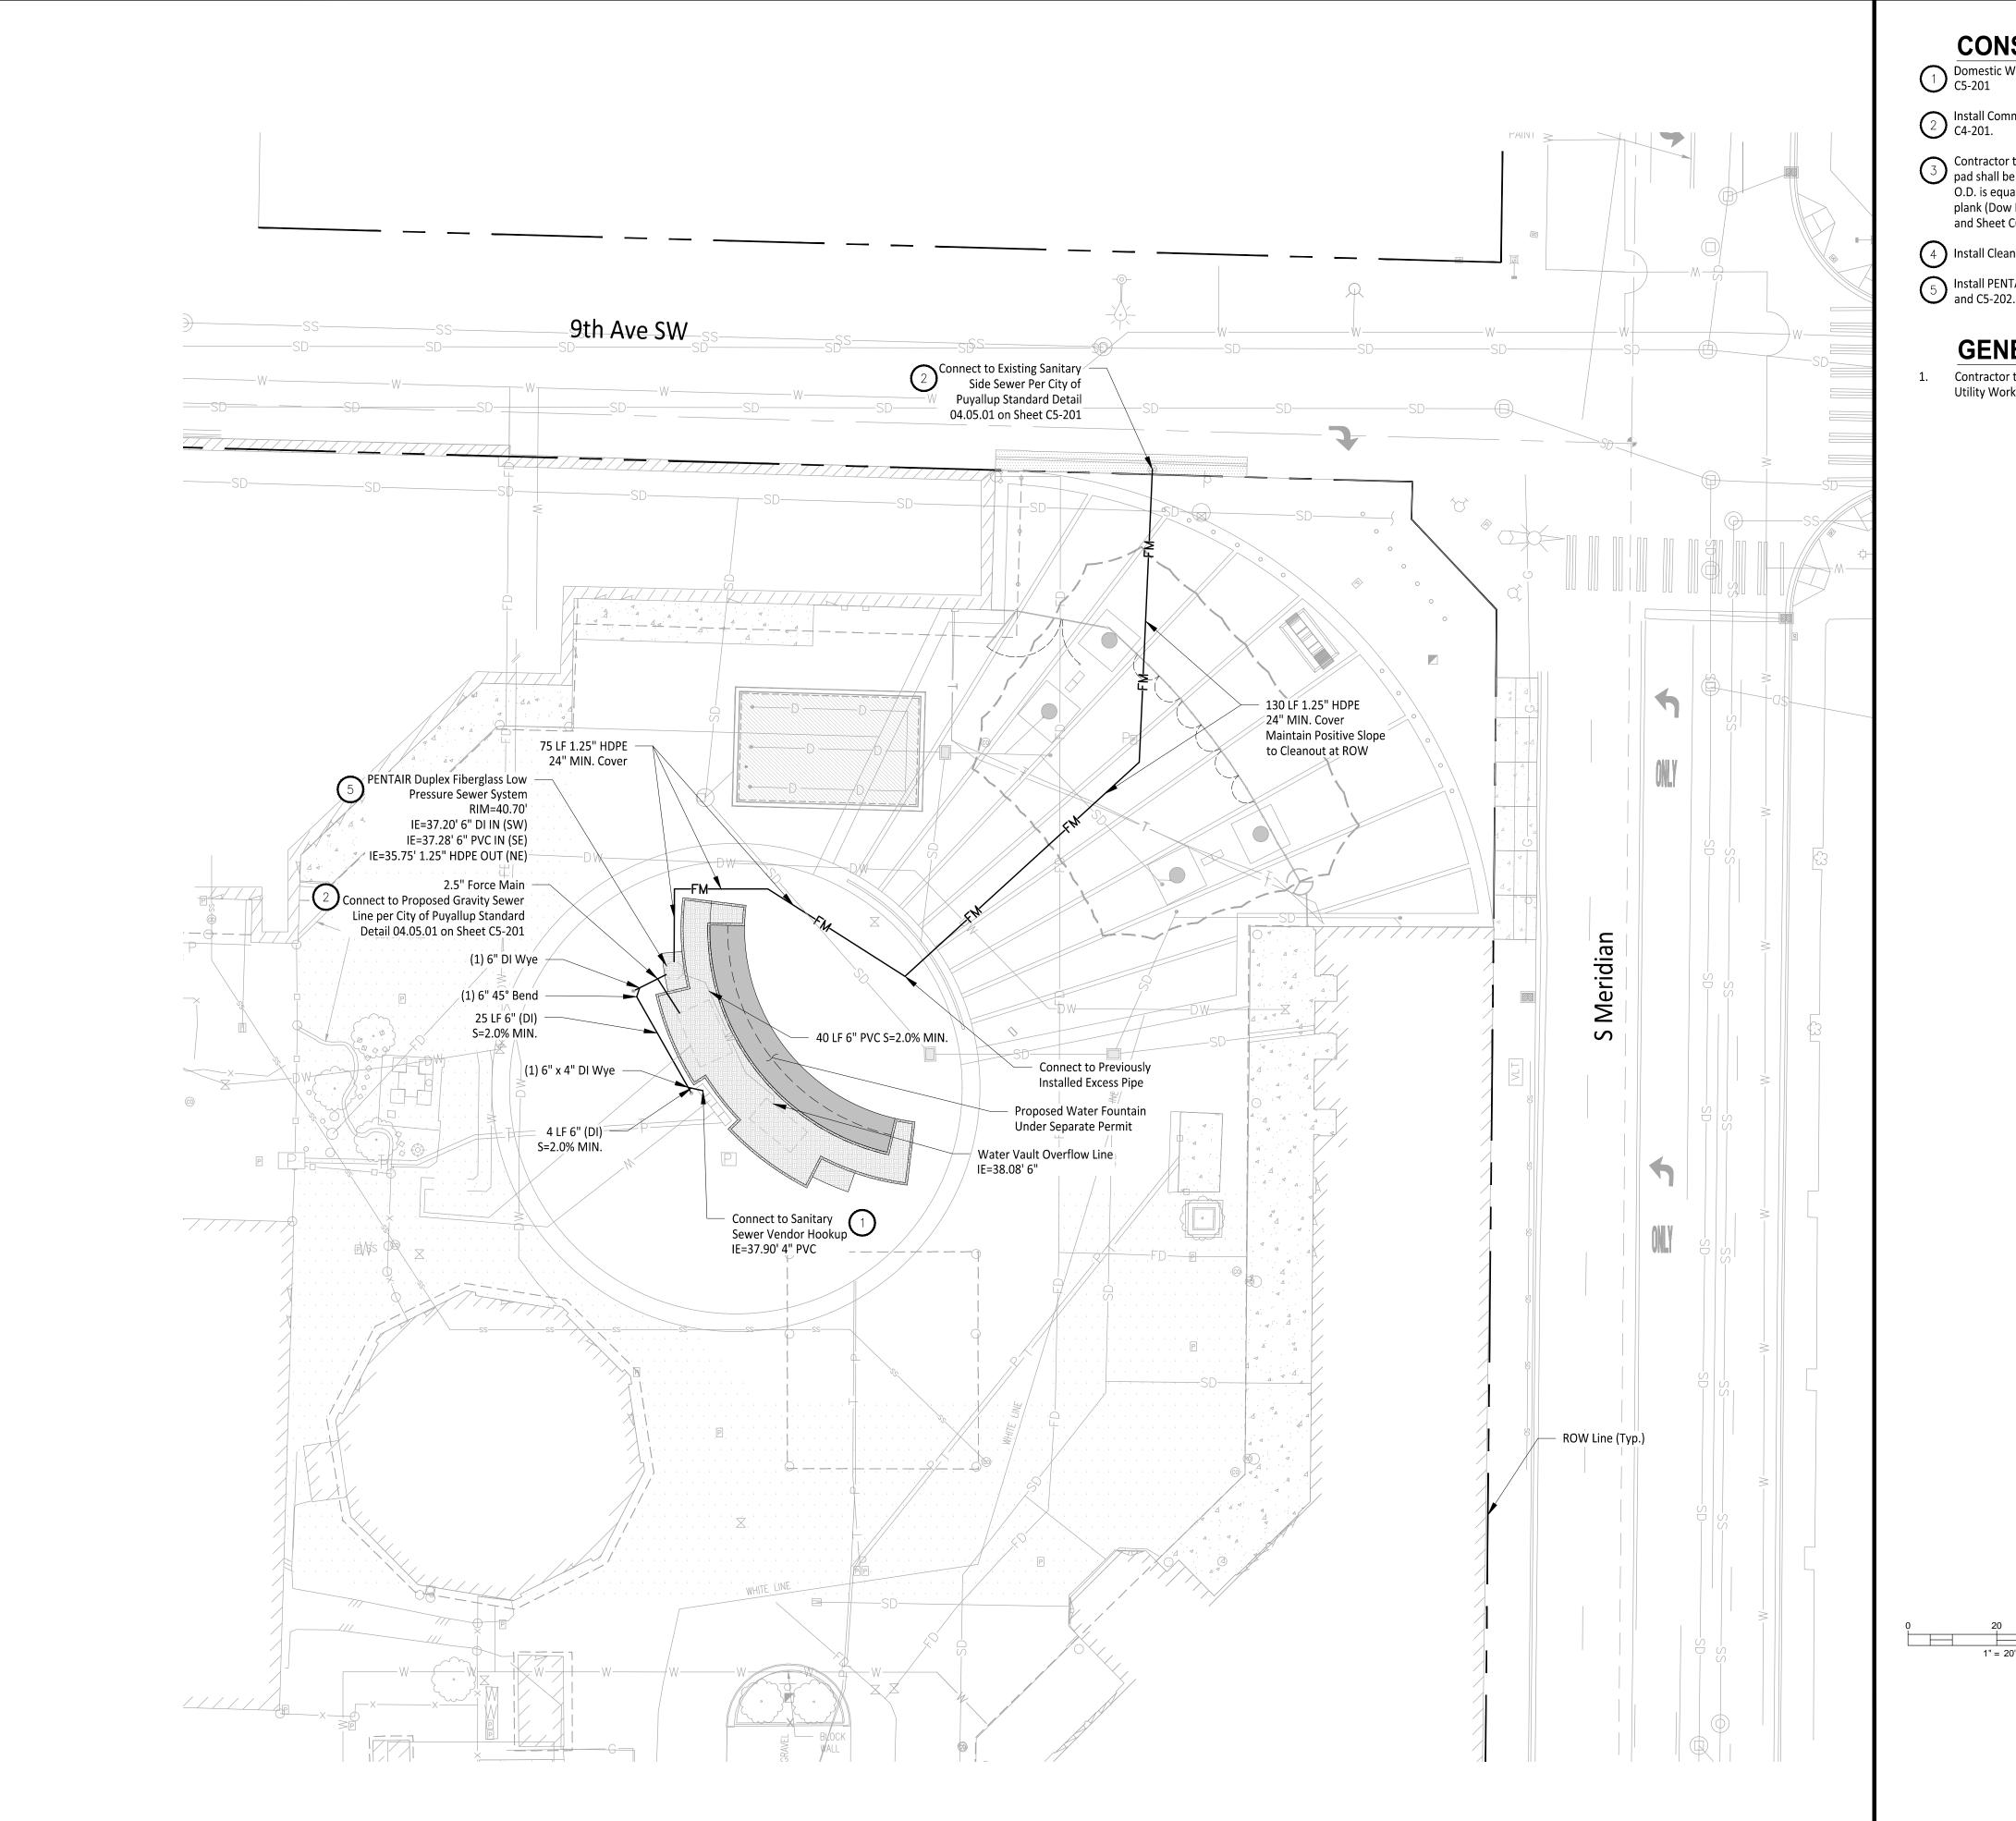

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CONSTRUCTION NOTES

Domestic Water Service and Sanitary Sewer Vendor Hook Ups to be Installed per Detail A on Sheet C5-201

Install Commercial Side Sewer Connection per City of Puyallup Standard Detail 04.03.04 on Sheet C4-201.

Contractor to install foam pad between pipe crossings with less than 18" of vertical clearance. The pad shall be O.D. x O.D. x 2.5 inches thick minimum or as required to protect the pipes. Above O.D. is equal to the outside diameter of the larger pipe. The pad shall be a polyethylene foam plank (Dow Plastics Ethafoam 220), or approved equal. See Detail B on Sheet C5-201 for detail, and Sheet C6-201 for City of Puyallup Utility Crossing Standard Details.

(4) Install Cleanout per City of Puyallup Standard Detail 04.03.04 on Sheet C4-201.

5 Install PENTAIR Duplex fiberglass Low Pressure Sewer System per specifications on Sheets C5-201 and C5-202.

GENERAL NOTES

Contractor to Pothole, Locate Horizontal and Vertical Utilities and Verify with Engineer prior to any Utility Work.

Puyallup, WA 98371 (253) 841-5356 Architect: Jeff Brown Architecture 12181 C Street South Tacoma, WA 98444 (253) 606-8324 Contact: Jeff Brown



Owner/Developer:

_\1807-002 Shouplex II & South Farm\01 - SEPA\CA

Washington State Fair 110 9th Ave SW

Justin Jones, PE 905 Main St. Suite 200 Sumner, WA 98390 (206) 596-2020

Project: WSF Gold Gate Redevelopment

Civil Construction Permit





REV	DATE	DESCRIP	TION	
1	03-04-24	City Co	mment Revisio	n #1
2	04-18-24	City Co	mment Revisio	n #2
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PROJ.	NO:		150	07-012
DATE:			April 30,	2024
SHEET	NAME			

Sanitary	Sewer
Plan	



APPROVED

BY _____ CITY OF PUYALLUP DEVELOPMENT ENGINEERING

NOTE: THIS APPROVAL IS VOID AFTER 180 DAYS FROM APPROVAL

FIELD CONDITIONS MAY DICTATE CHANGES TO THESE PLANS AS DETERMINED BY THE DEVELOPMENT ENGINEERING

THE CITY WILL NOT BE RESPONSIBLE FOR ERRORS AND/OR OMISSIONS ON THESE

DATE ____


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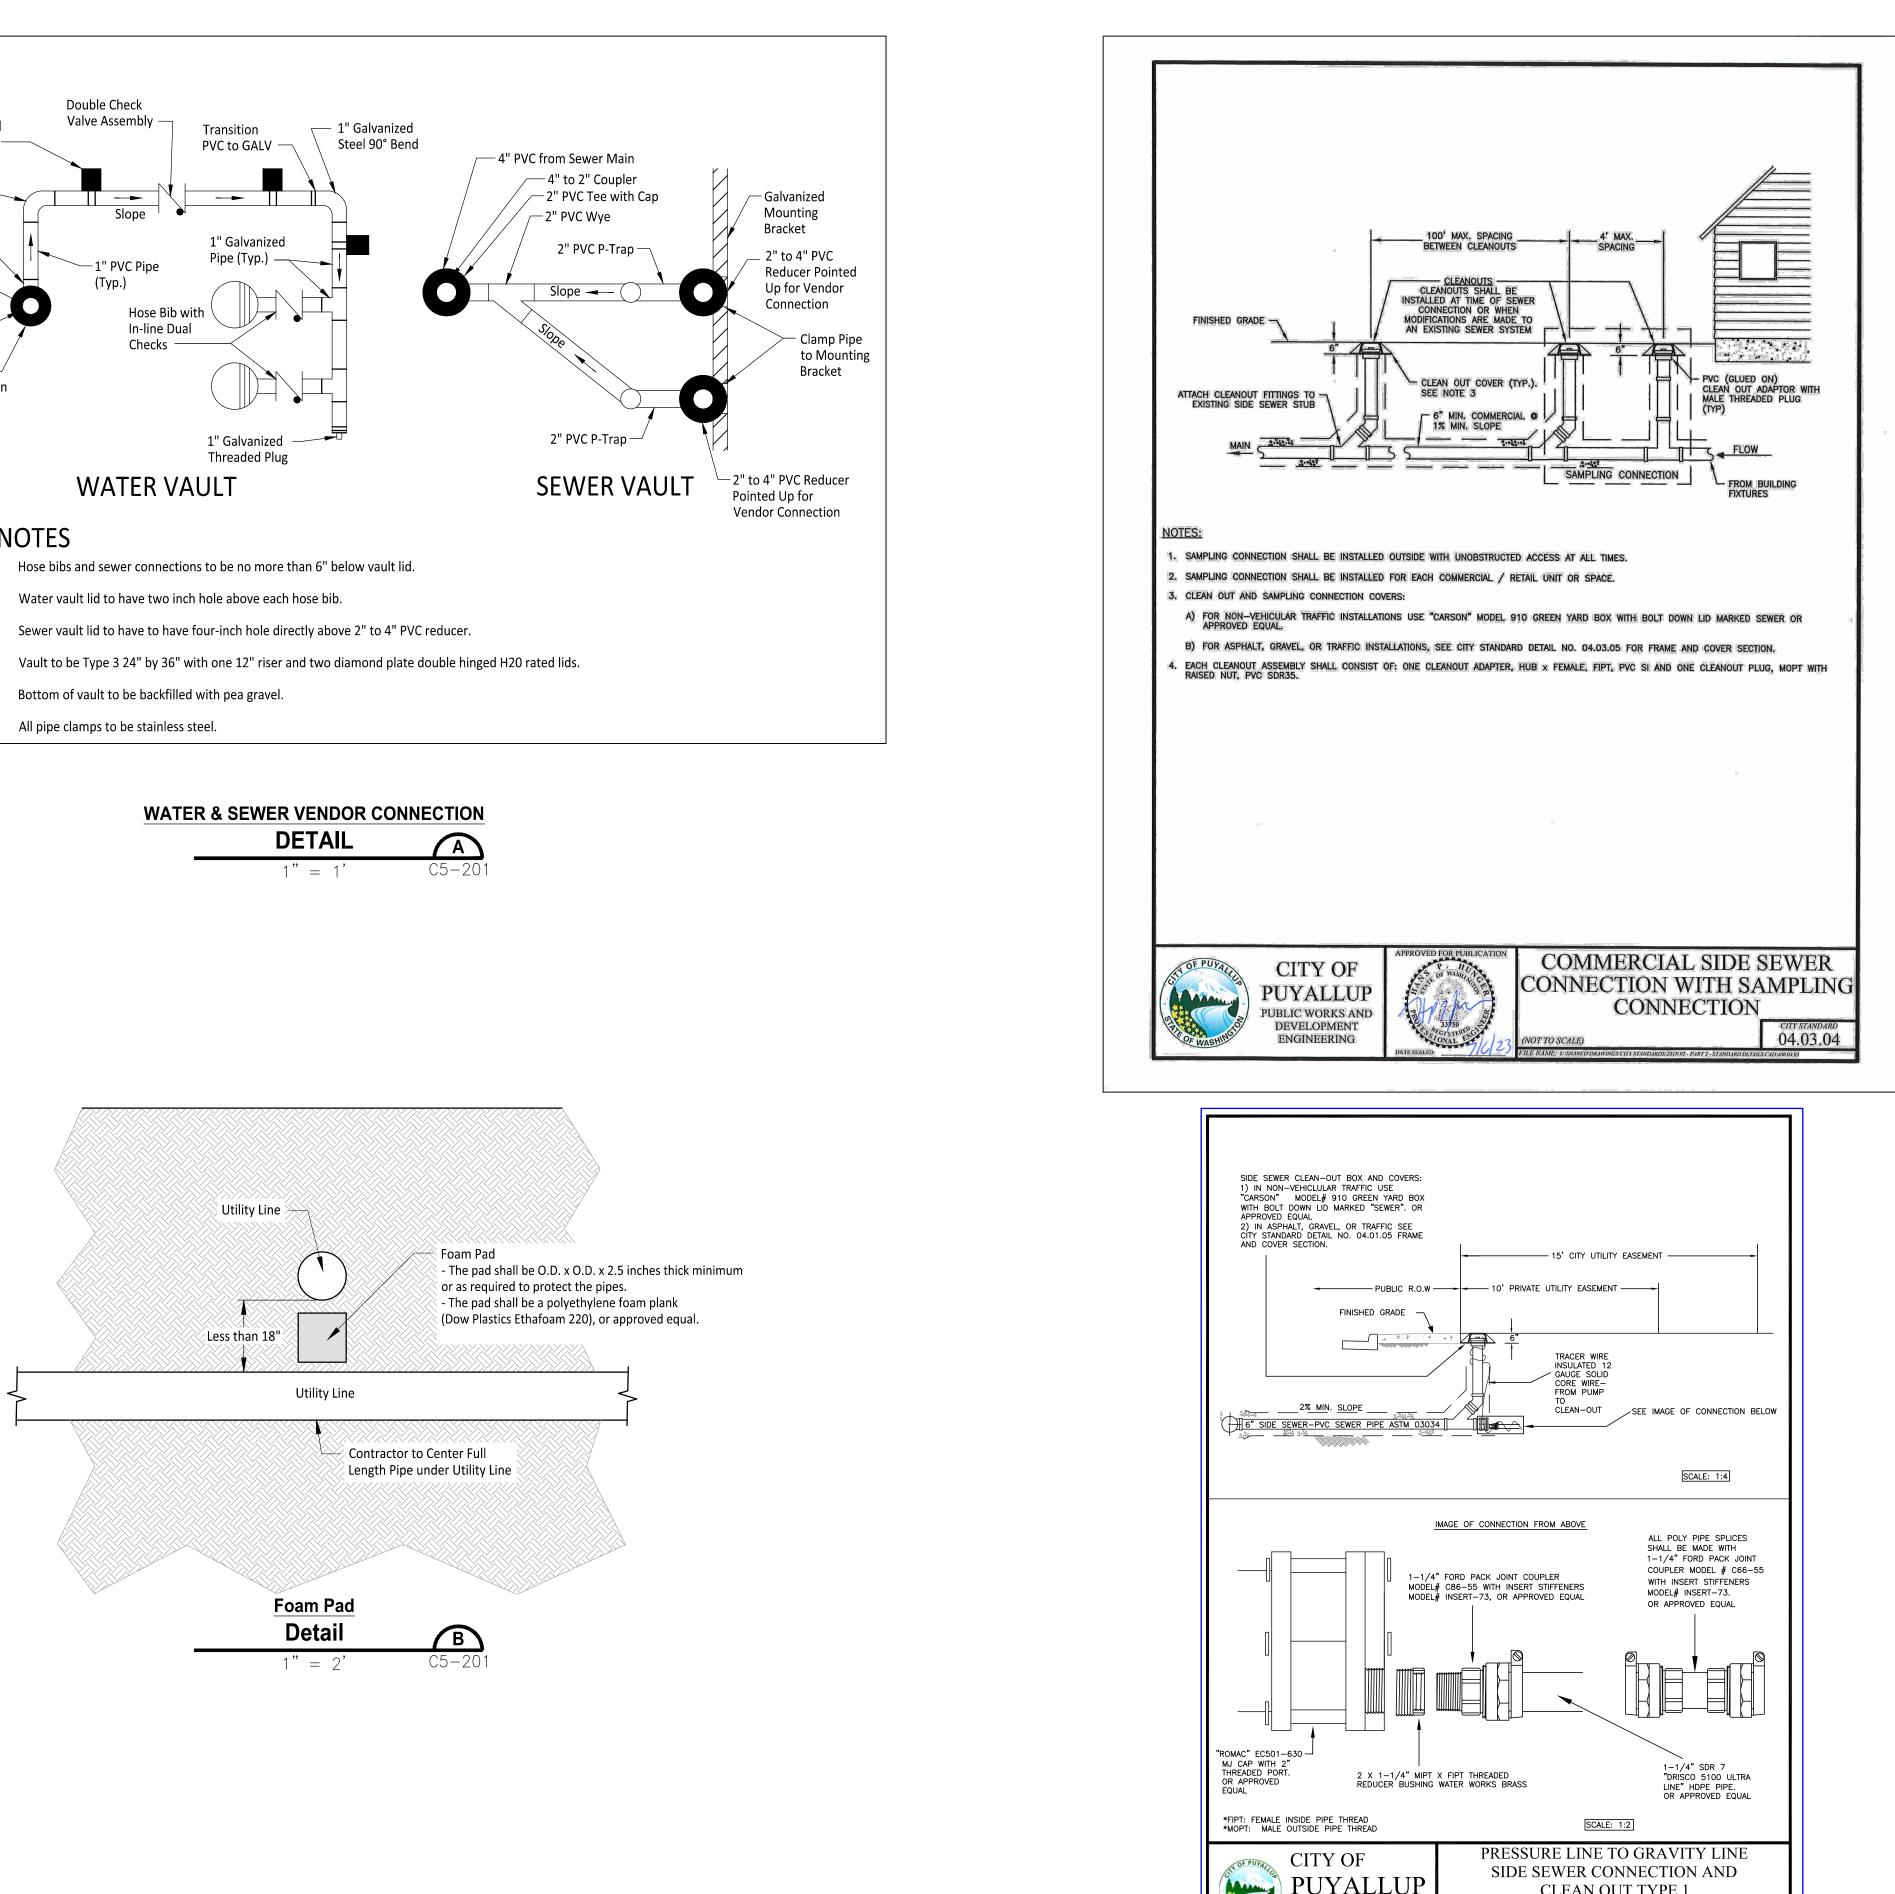
MANAGER.

FEET

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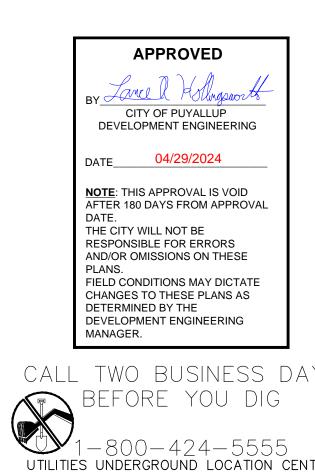






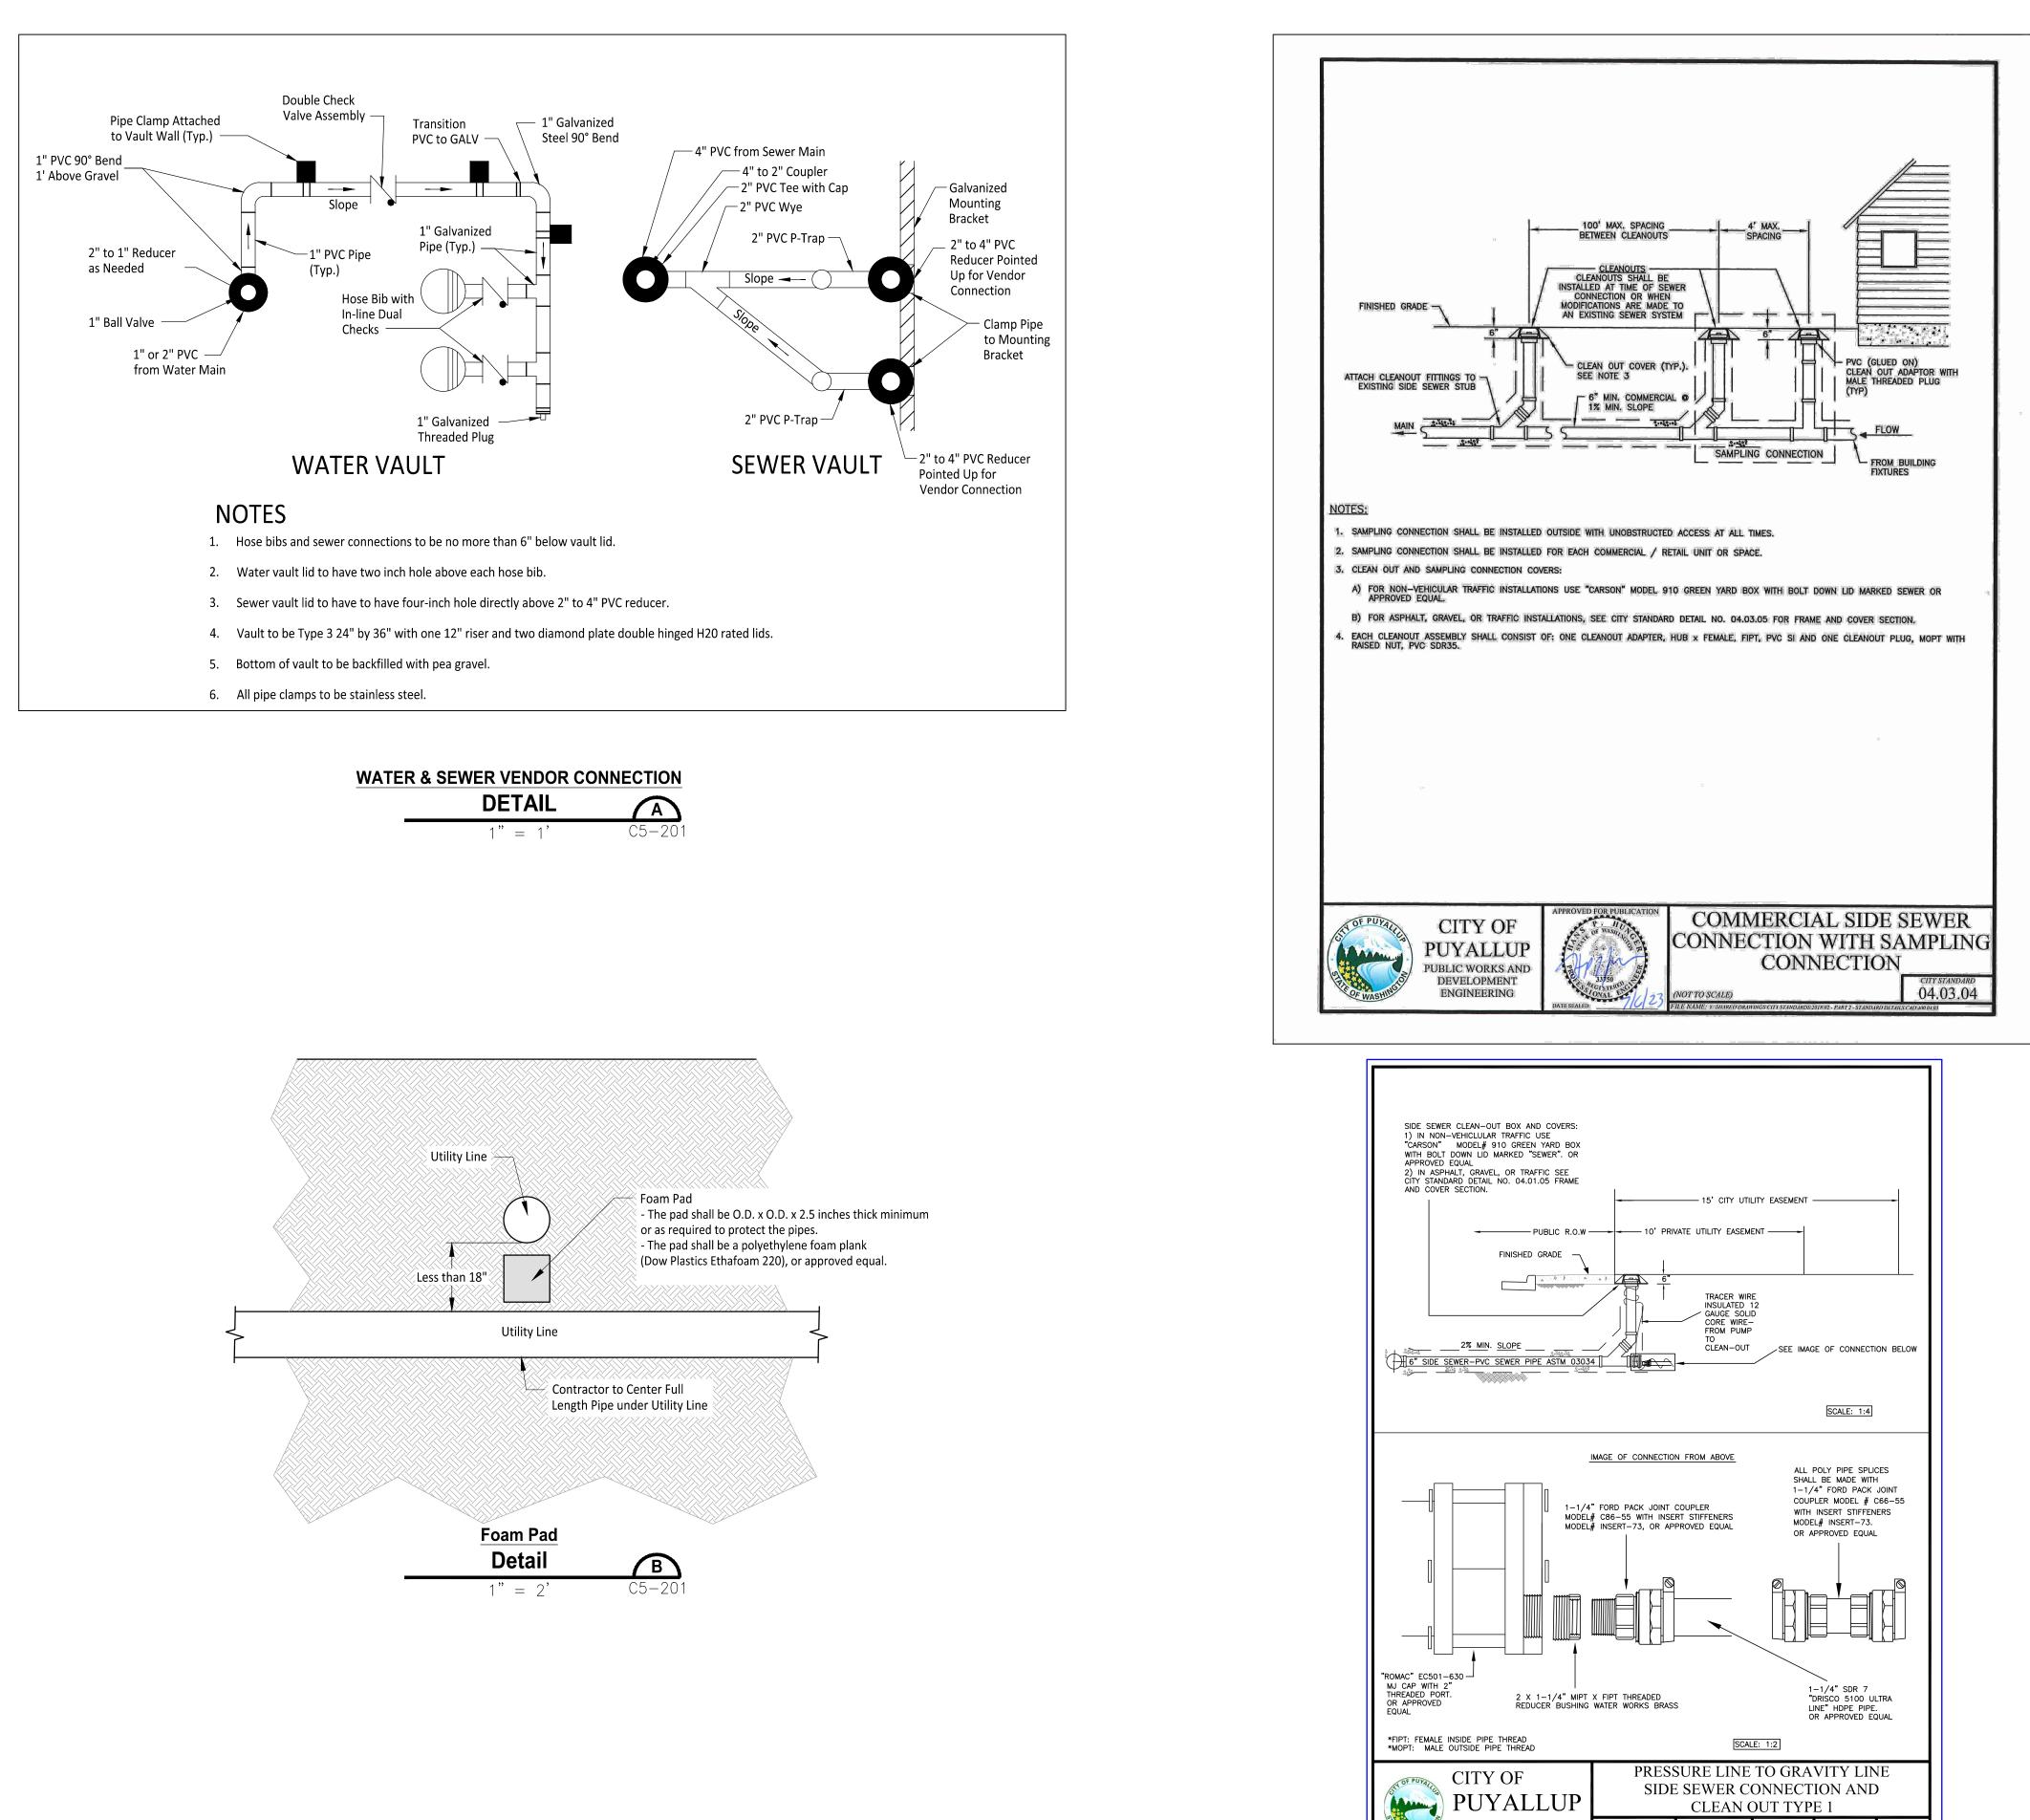

	Owner/Developer:
	Washington STATE FAIR PUYALLUP
	Washington State Fair 110 9th Ave SW Puyallup, WA 98371 (253) 841-5356
	Architect: Jeff Brown Architecture 12181 C Street South Tacoma, WA 98444 (253) 606-8324 Contact: Jeff Brown
	Engineer: Justin Jones, PE 905 Main St. Suite 200 Sumner, WA 98390 (206) 596-2020
	Project: WSF Gold Gate Redevelopment
	Civil Construction Permit
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	2 04-18-24 City Comment Revision #2
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	PROJ.NO: 1507-012
	DATE: April 18, 2024
	SHEET NAME
	Sanitary
	Sewer Details
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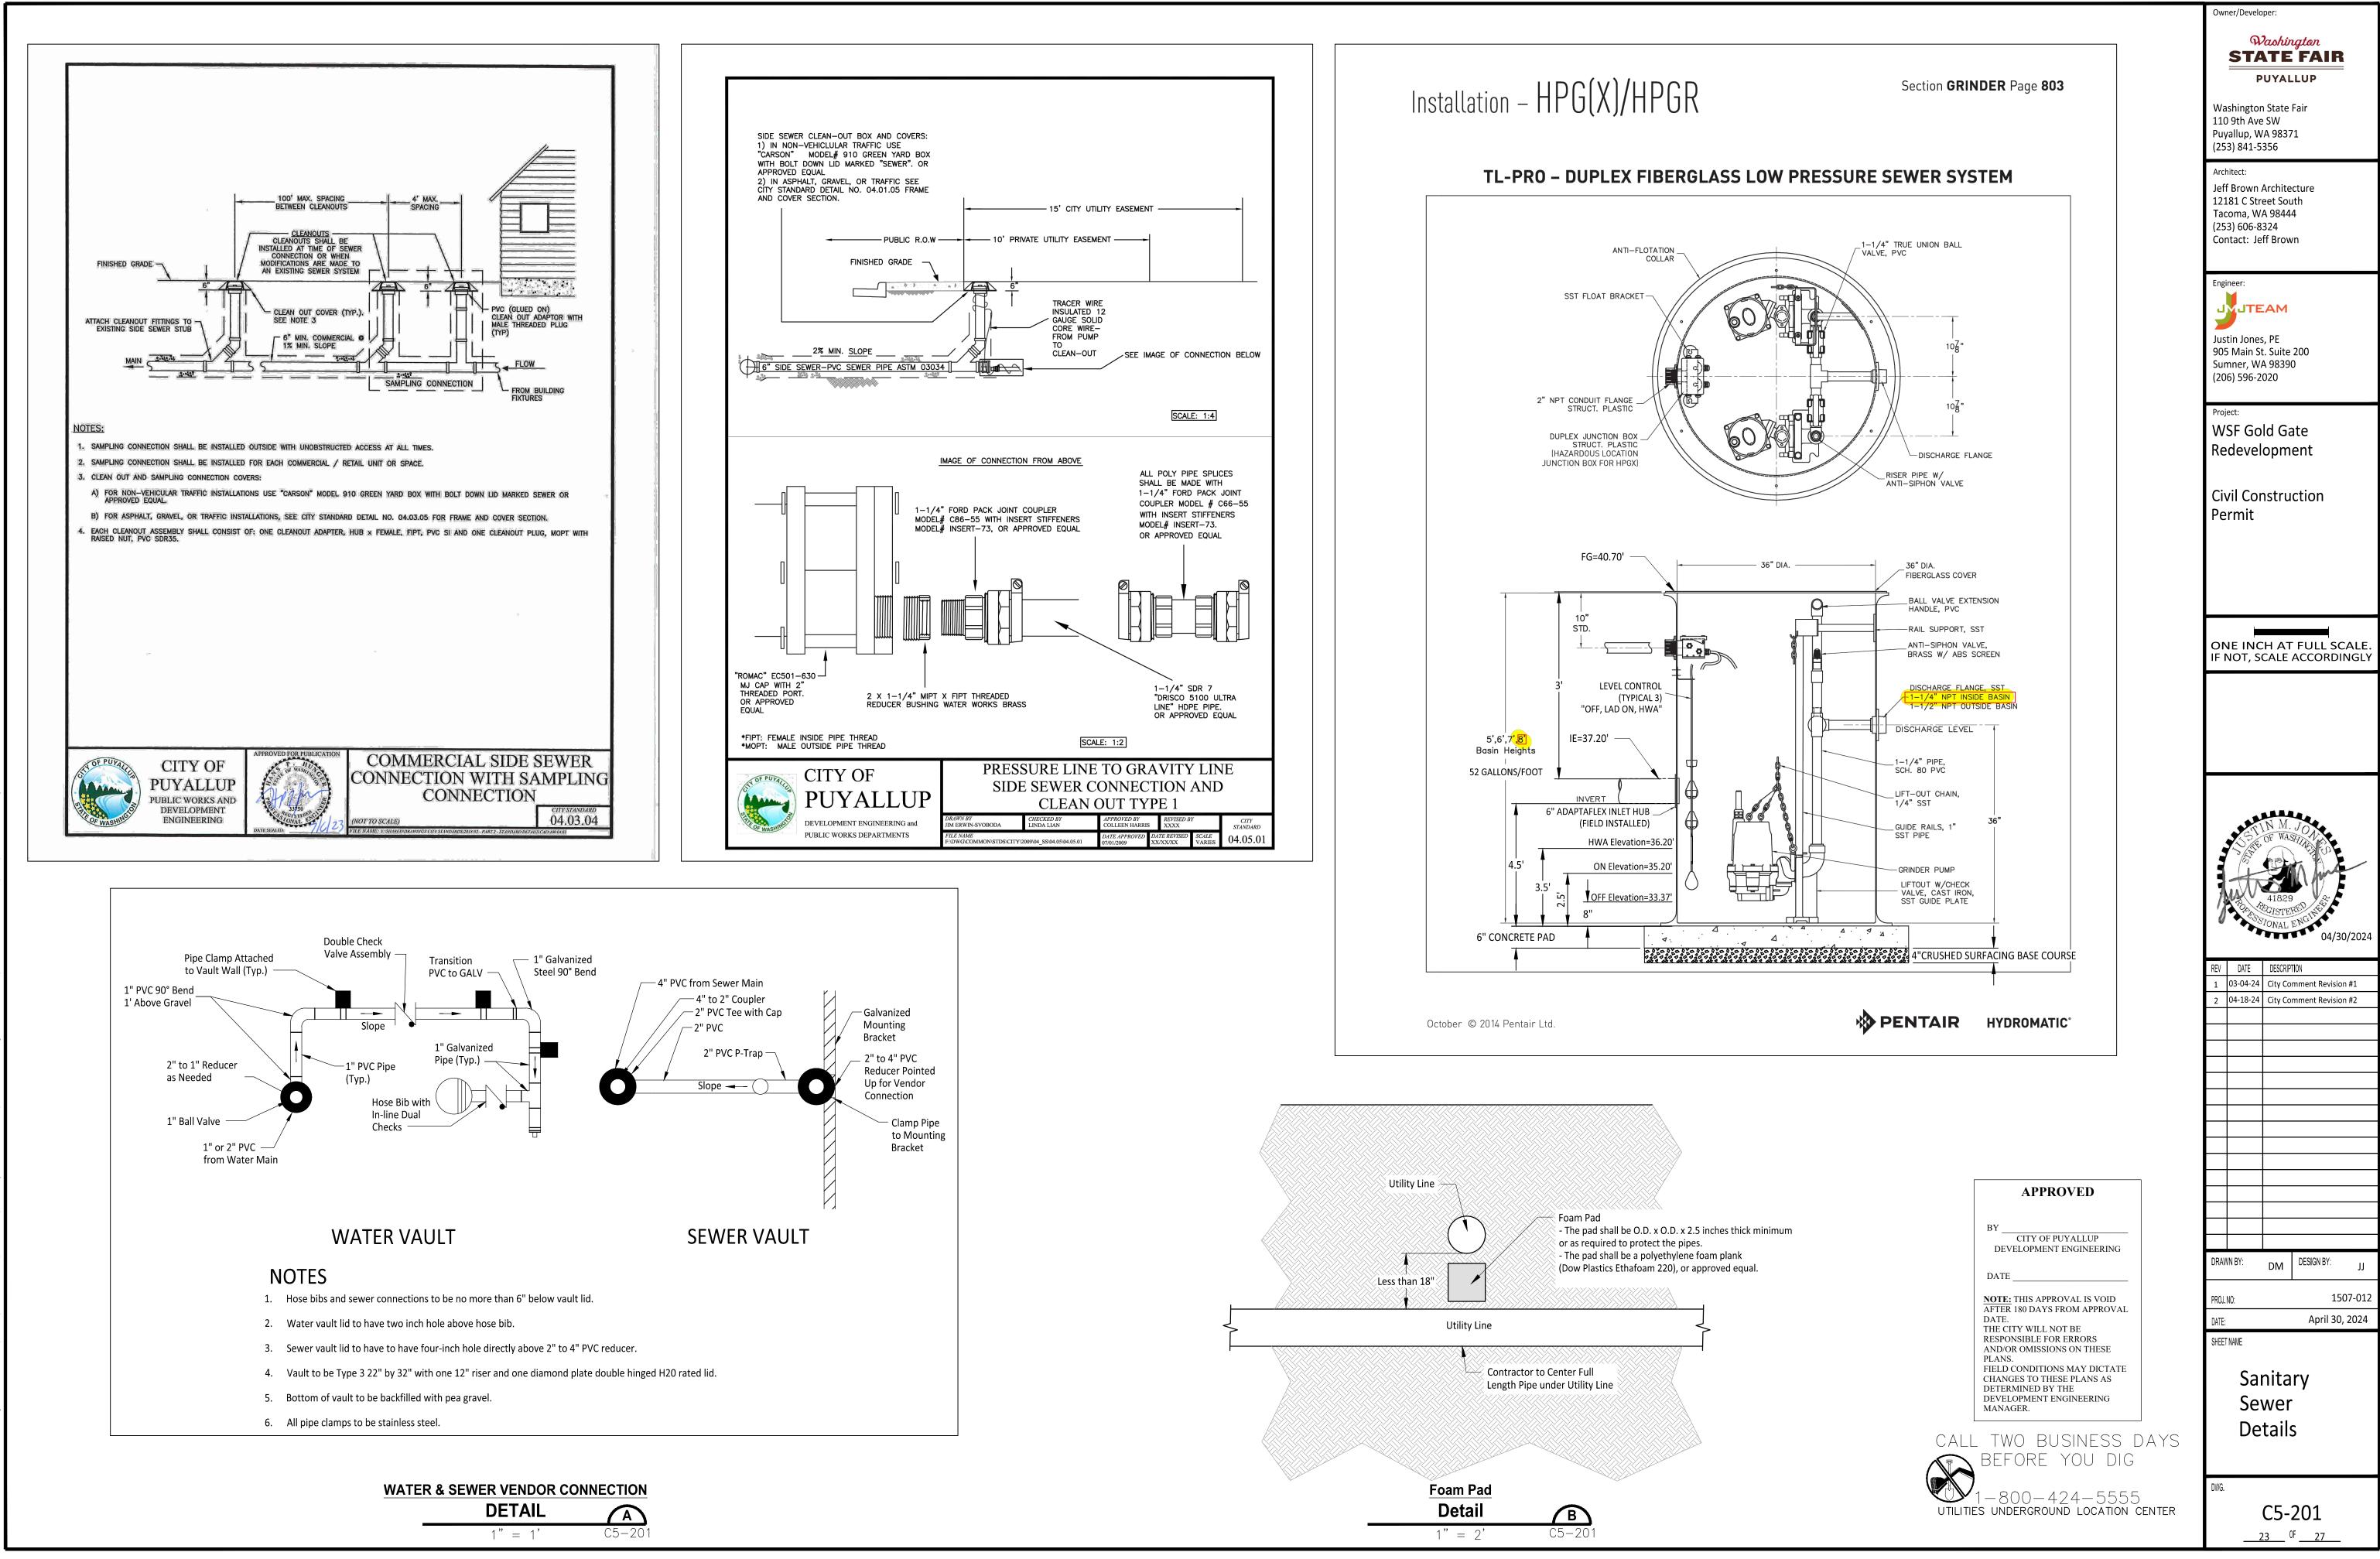



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DATE APPROVED DATE REVISED SCALE 04.05.01 DATE APPROVED XX/XX/XX VARIES 04.05.01


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DEVELOPMENT ENGINEERING and PUBLIC WORKS DEPARTMENTS





	Owner/Developer:
	Washington STATE FAIR
	PUYALLUP
	Washington State Fair 110 9th Ave SW Puyallup, WA 98371 (253) 841-5356
	Architect: Jeff Brown Architecture 12181 C Street South Tacoma, WA 98444 (253) 606-8324
	Contact: Jeff Brown
	Justin Jones, PE 905 Main St. Suite 200 Sumner, WA 98390 (206) 596-2020
	Project:
	WSF Gold Gate Redevelopment
	Civil Construction Permit
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BY CITY OF PUYALLUP	
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DATE	PROJ. NO: 1507-012
AFTER 180 DAYS FROM APPROVAL DATE. THE CITY WILL NOT BE	DATE: April 30, 2024
RESPONSIBLE FOR ERRORS AND/OR OMISSIONS ON THESE PLANS.	SHEET NAME
FIELD CONDITIONS MAY DICTATE CHANGES TO THESE PLANS AS DETERMINED BY THE	Sanitary
DEVELOPMENT ENGINEERING MANAGER.	Sewer
CALL TWO BUSINESS DAYS	Details
1-800-424-5555	DWG.
UTILITIES UNDERGROUND LOCATION CENTER	C5-202

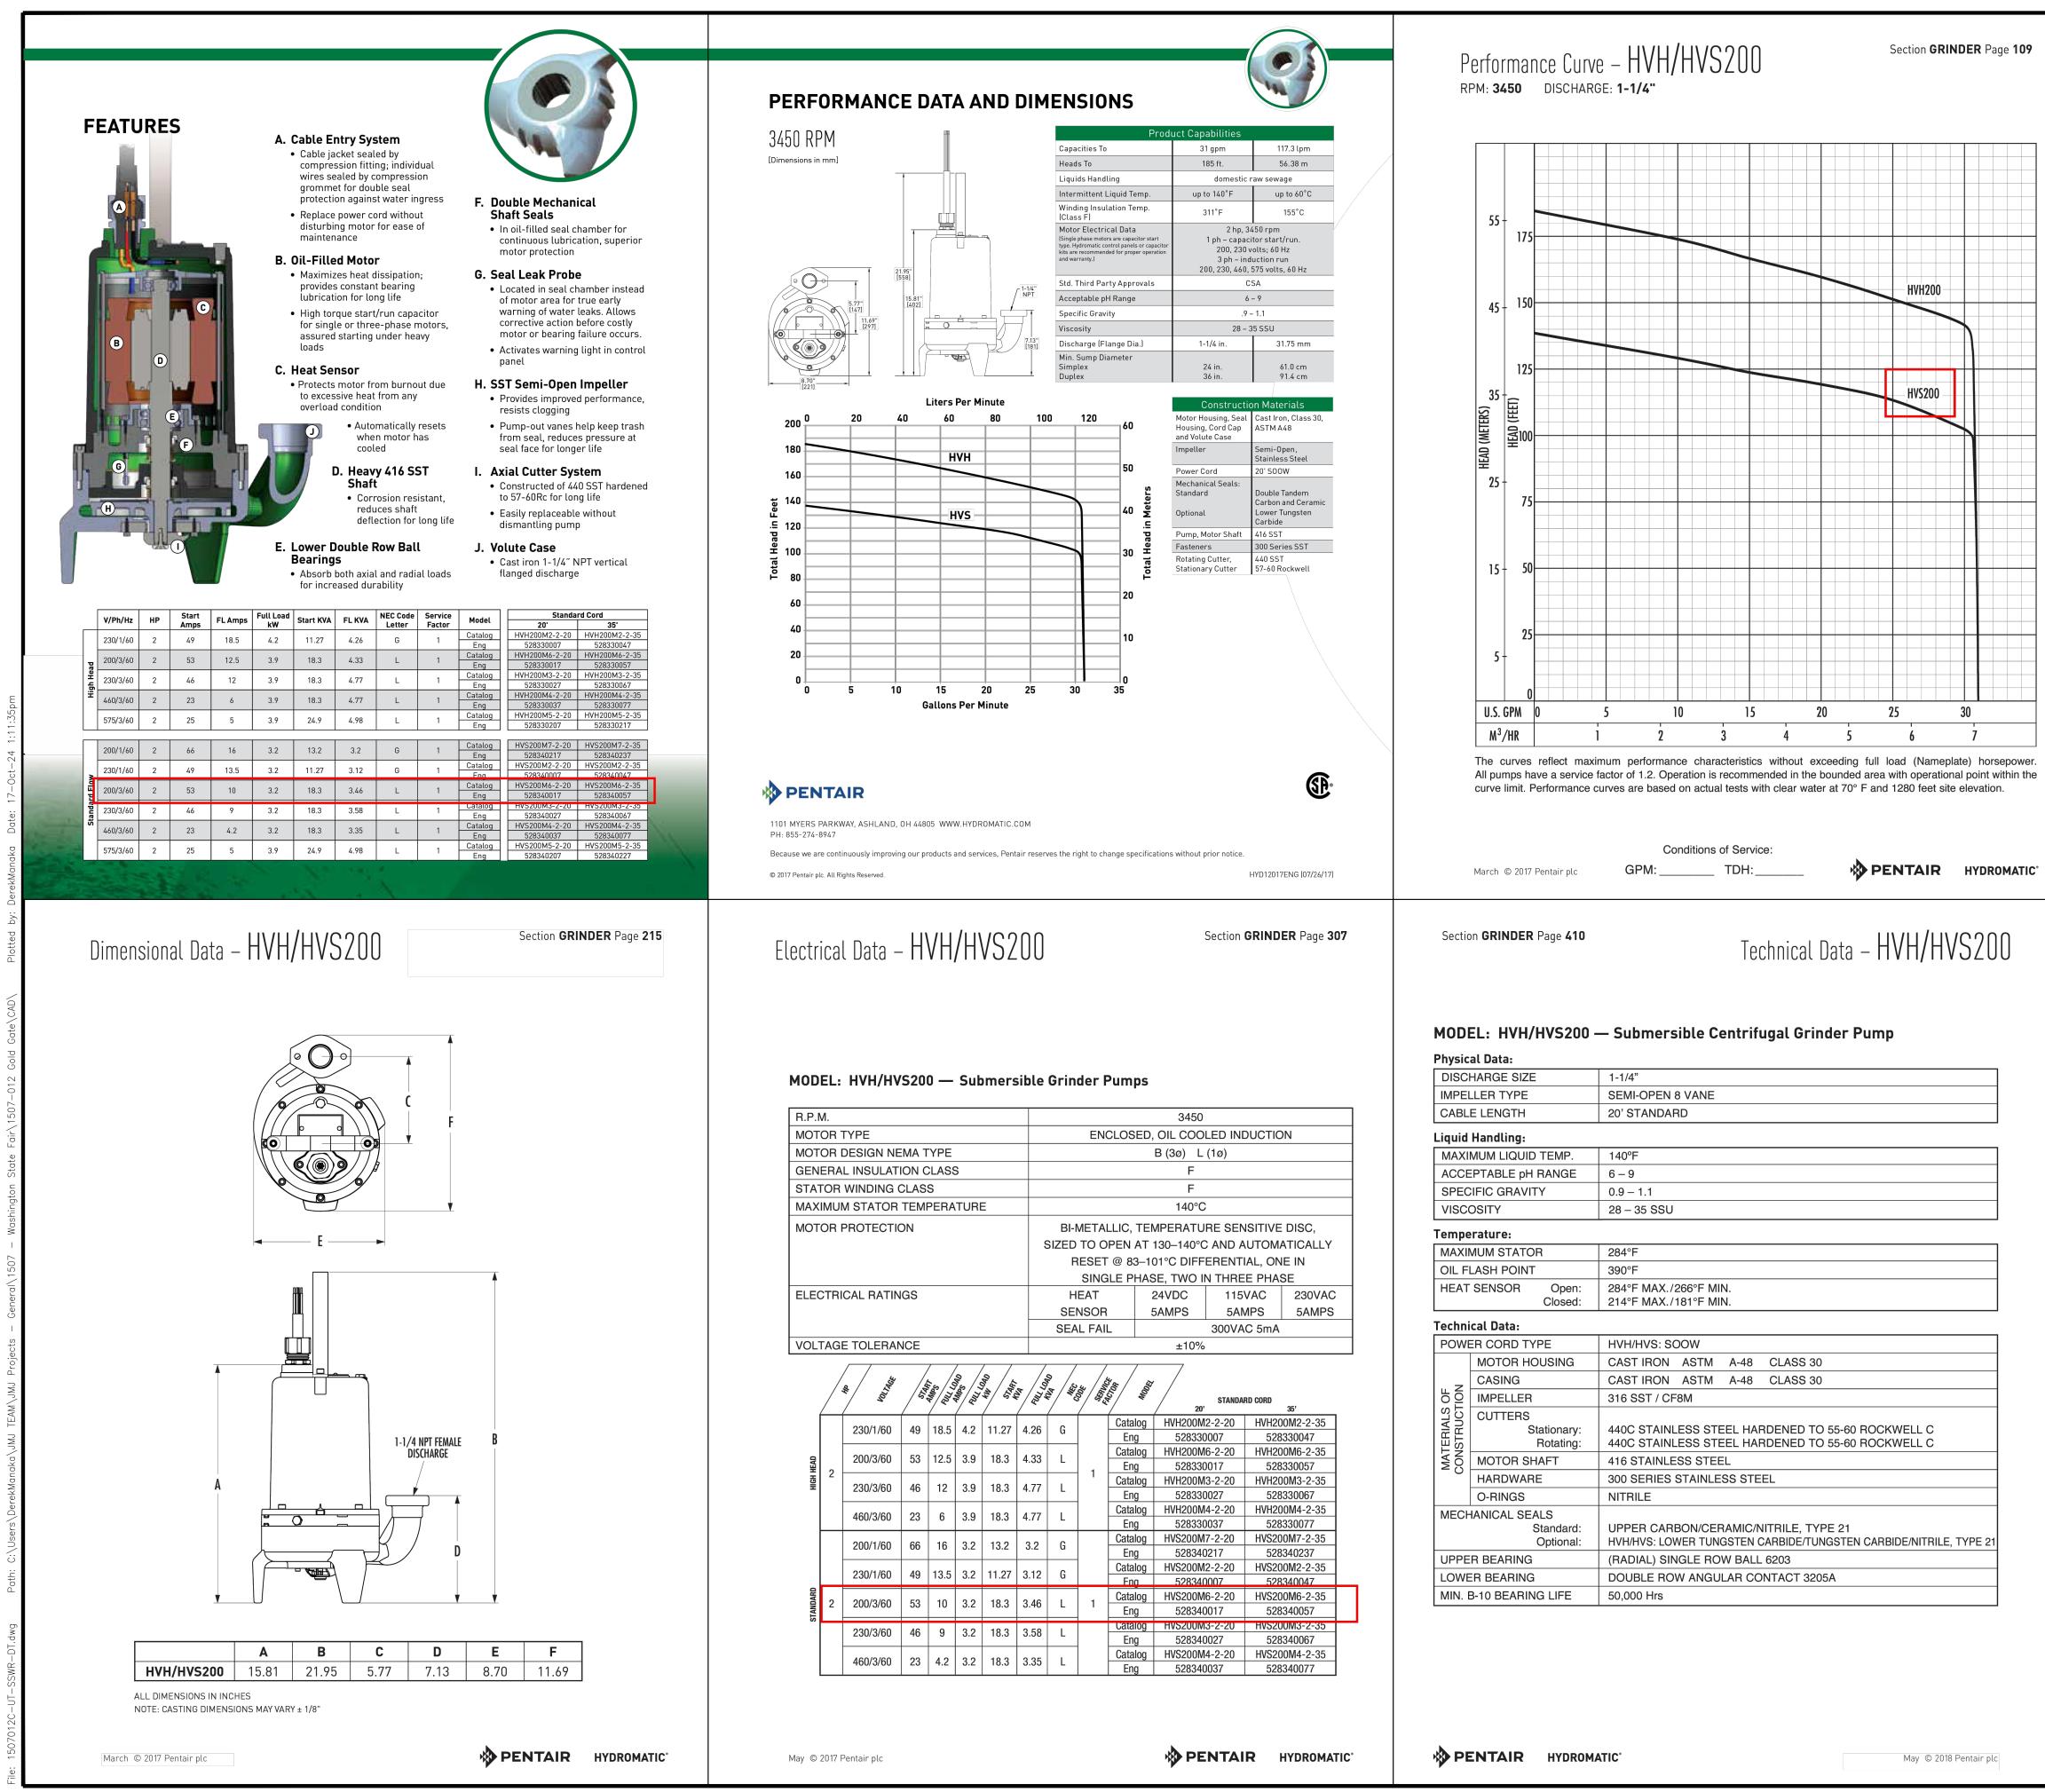

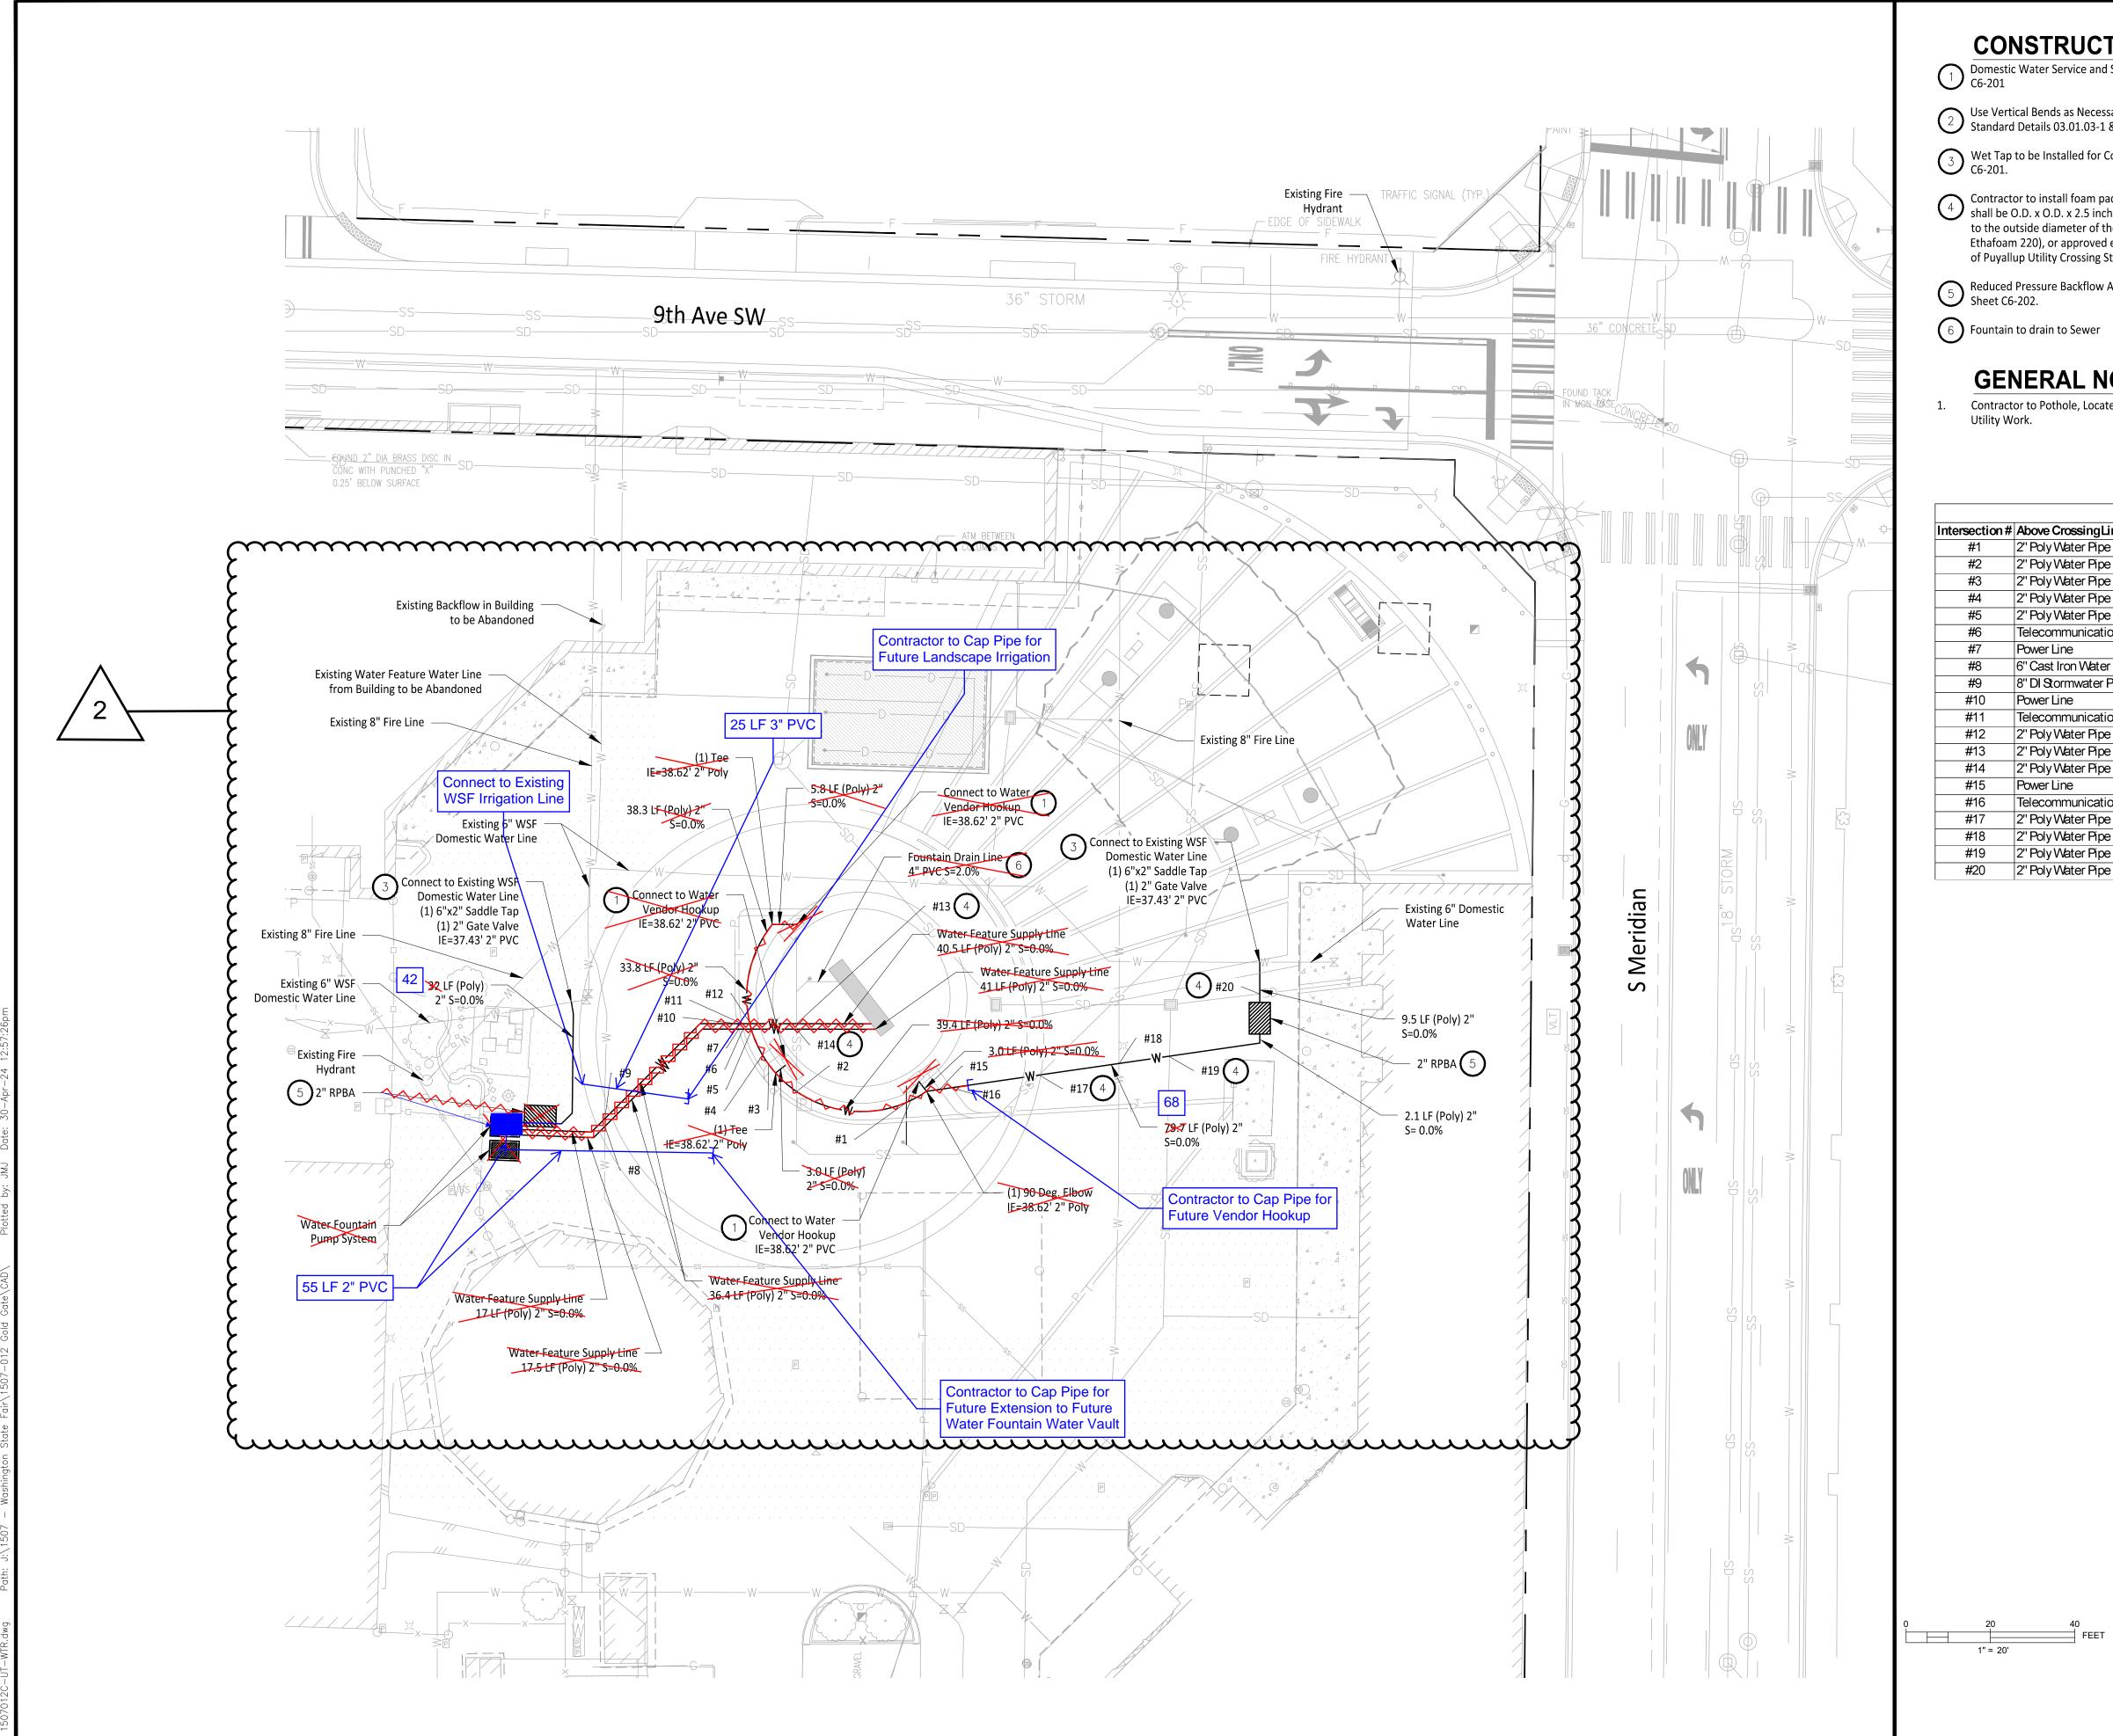CONSTRUCTION NOTES

Domestic Water Service and Sanitary Sewer Vendor Hook Ups to be Installed per Detail A on Sheet C6-201

Use Vertical Bends as Necessary to Install Water Pipe, Allowing Clearances from City of Puyallup Standard Details 03.01.03-1 & 03.01.03-2.

Wet Tap to be Installed for Connection to Existing WSF Domestic Water Line per Detail B on Sheet C6-201.

Contractor to install foam pad between pipe crossings with less than 18" of vertical clearance. The pad 4 shall be O.D. x O.D. x 2.5 inches thick minimum or as required to protect the pipes. Above O.D. is equal to the outside diameter of the larger pipe. The pad shall be a polyethylene foam plank (Dow Plastics Ethafoam 220), or approved equal. See Detail B on Sheet C5-201 for detail, and Sheet C6-201 for City of Puyallup Utility Crossing Standard Details.

5 Reduced Pressure Backflow Assembly to be installed Per City of Puyallup Standard Detail 03.04.02 on Sheet C6-202.

6 Fountain to drain to Sewer

GENERAL NOTES

Contractor to Pothole, Locate Horizontal and Vertical Utilities and Verify with Engineer prior to any Utility Work.

	U	tility Crossing Table	
m#	Above CrossingLine	BelowCrossingLine	Material Vertical Seperation (ft)
	2" Poly Water Pipe	6" PVC Sanitary Sewer Pipe	2.00
	2" Poly Water Pipe	6" PVC Sanitary Sewer Pipe	1.56
	2" Poly Water Pipe	Power Line	0.50
	2" Poly Water Pipe	Telecommunications Line	0.50
	2" Poly Water Pipe	2" Poly Water Pipe	0.50
	Telecommunications Line	2" Poly Water Pipe	0.50
	Power Line	2" Poly Water Pipe	0.50
	6" Cast Iron Water Pipe	2" Poly Water Pipe	0.50
	8" DI Stormwater Pipe	2" Poly Water Pipe	0.50
	Power Line	2" Poly Water Pipe	0.50
	Telecommunications Line	2" Poly Water Pipe	0.50
	2" Poly Water Pipe	2" Poly Water Pipe	0.50
	2" Poly Water Pipe	6" PVC Sanitary Sewer Pipe	1.26
	2" Poly Water Pipe	6" PVC Sanitary Sewer Pipe	1.23
	Power Line	2" Poly Water Pipe	0.50
	Telecommunications Line	2" Poly Water Pipe	0.50
	2" Poly Water Pipe	6" PVC Sanitary Sewer Pipe	1.37
	2" Poly Water Pipe	8" DI Fire Water Line	0.50
	2" Poly Water Pipe	8'' PVC Stormwater Line	0.66
	2" Poly Water Pipe	8'' PVC Stormwater Line	1.22



FIELD CONDITIONS MAY DICTATE CHANGES TO THESE PLANS AS DETERMINED BY THE DEVELOPMENT ENGINEERING MANAGER.



Washington

Owner/Developer:

STATE FAIR PUYALLUP

Washington State Fair 110 9th Ave SW Puyallup, WA 98371 (253) 841-5356

Architect: Jeff Brown Architecture 12181 C Street South Tacoma, WA 98444 (253) 606-8324 Contact: Jeff Brown




Justin Jones, PE 905 Main St. Suite 200 Sumner, WA 98390 (206) 596-2020


Project:

WSF Gold Gate Redevelopment

Civil Construction Permit



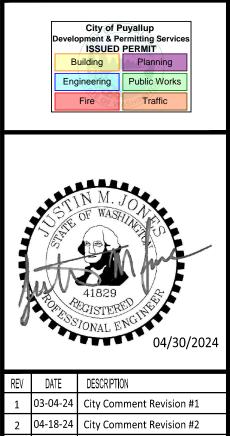


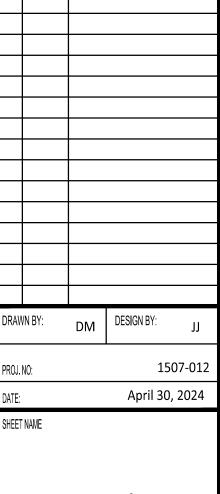

Water Plan

<u>24</u> ^{OF} <u>27</u>

C6-101

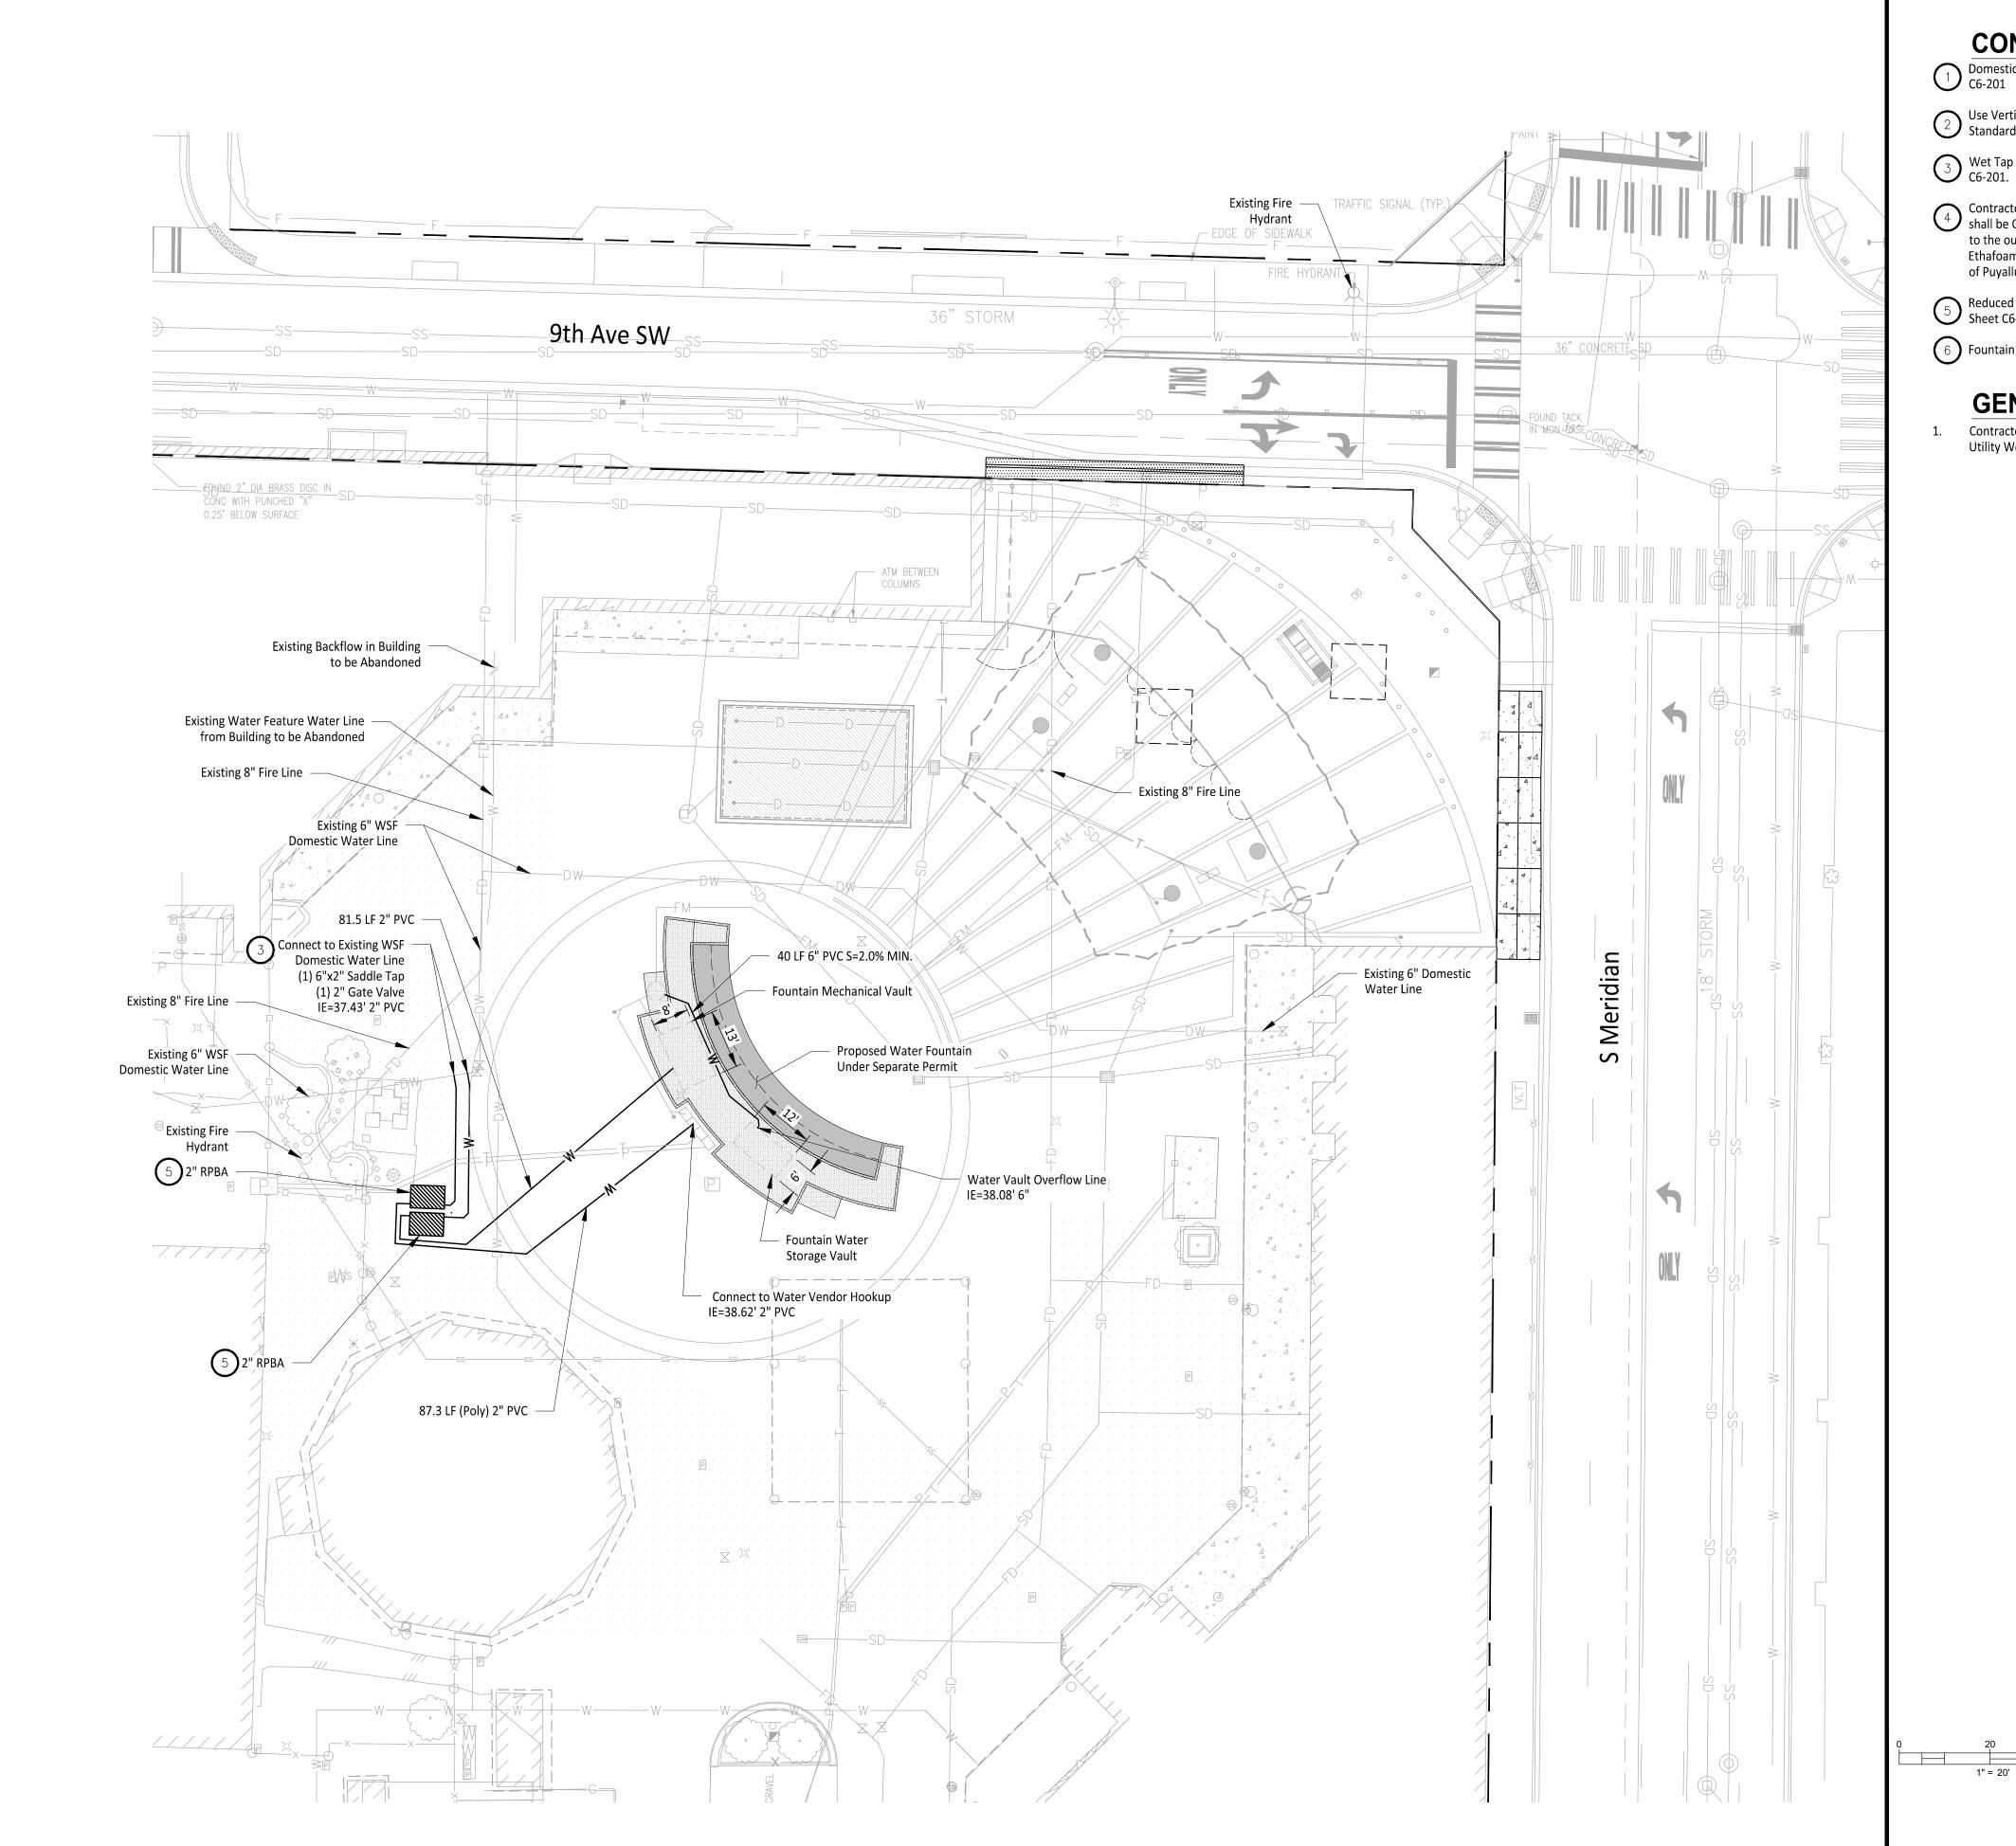

CONSTRUCTION NOTES

Domestic Water Service and Sanitary Sewer Vendor Hook Ups to be Installed per Detail A on Sheet C6-201

Use Vertical Bends as Necessary to Install Water Pipe, Allowing Clearances from City of Puyallup Standard Details 03.01.03-1 & 03.01.03-2.

Wet Tap to be Installed for Connection to Existing WSF Domestic Water Line per Detail B on Sheet C6-201.

Contractor to install foam pad between pipe crossings with less than 18" of vertical clearance. The pad shall be O.D. x O.D. x 2.5 inches thick minimum or as required to protect the pipes. Above O.D. is equal to the outside diameter of the larger pipe. The pad shall be a polyethylene foam plank (Dow Plastics Ethafoam 220), or approved equal. See Detail B on Sheet C5-201 for detail, and Sheet C6-201 for City of Puyallup Utility Crossing Standard Details.

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6 Fountain to drain to Sewer

GENERAL NOTES

Contractor to Pothole, Locate Horizontal and Vertical Utilities and Verify with Engineer prior to any Utility Work.

Washington

STATE FAIR PUYALLUP

Washington State Fair 110 9th Ave SW Puyallup, WA 98371 (253) 841-5356

Owner/Developer:

Architect: Jeff Brown Architecture 12181 C Street South Tacoma, WA 98444 (253) 606-8324 Contact: Jeff Brown



Justin Jones, PE 905 Main St. Suite 200 Sumner, WA 98390 (206) 596-2020

Project: WSF Gold Gate Redevelopment

Civil Construction Permit





REV DATE DESCRIPTION 03-04-24 City Comment Revision #1 2 04-18-24 City Comment Revision #2 DM DESIGN BY: DRAWN BY: 1507-012 PROJ. NO: April 30, 2024 DATE:

SHEET NAME

APPROVED

DEVELOPMENT ENGINEERING

NOTE: THIS APPROVAL IS VOID AFTER 180 DAYS FROM APPROVAL

FIELD CONDITIONS MAY DICTATE CHANGES TO THESE PLANS AS

CALL TWO BUSINESS DAYS

BEFORE YOU DIG

UTILITIES UNDERGROUND LOCATION CENTER

THE CITY WILL NOT BE RESPONSIBLE FOR ERRORS AND/OR OMISSIONS ON THESE

DETERMINED BY THE DEVELOPMENT ENGINEERING

BY CITY OF PUYALLUP

DATE

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PLANS.

MANAGER.


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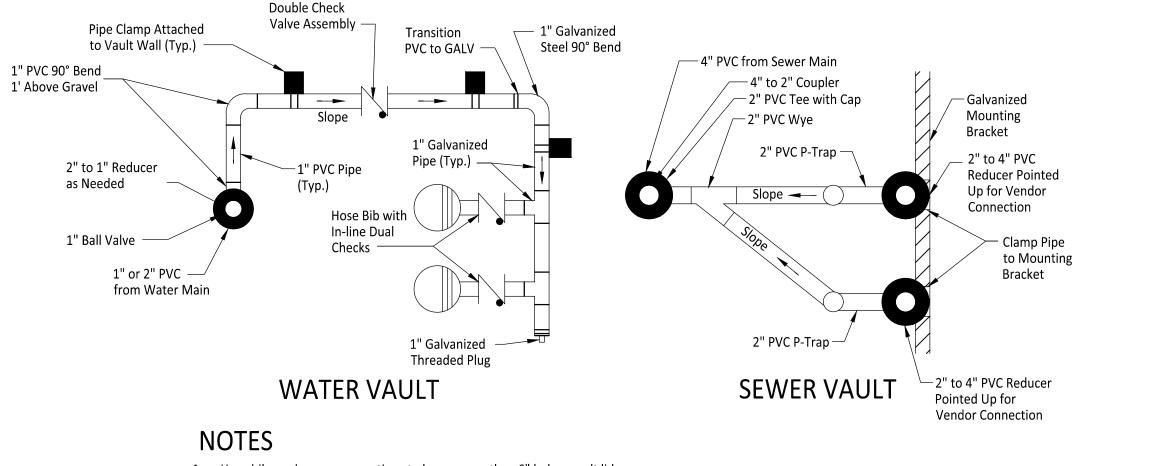
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Water Plan

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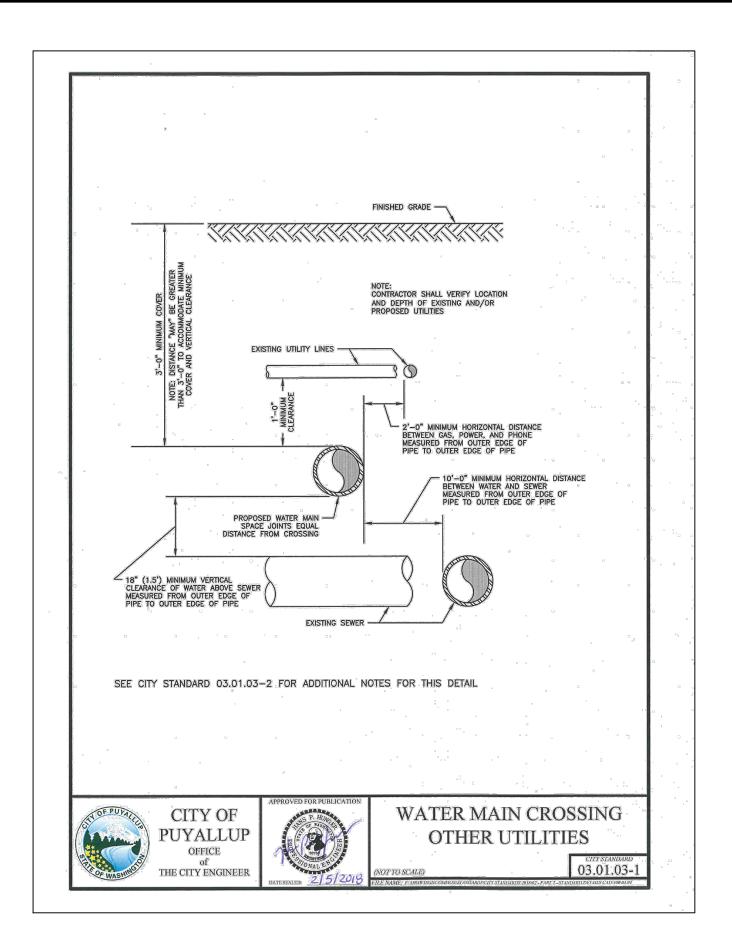





1. Hose bibs and sewer connections to be no more than 6" below vault lid.

- 2. Water vault lid to have two inch hole above each hose bib.
- 3. Sewer vault lid to have to have four-inch hole directly above 2" to 4" PVC reducer.
- 4. Vault to be Type 3 24" by 36" with one 12" riser and two diamond plate double hinged H20 rated lids.
- 5. Bottom of vault to be backfilled with pea gravel.
- 6. All pipe clamps to be stainless steel.

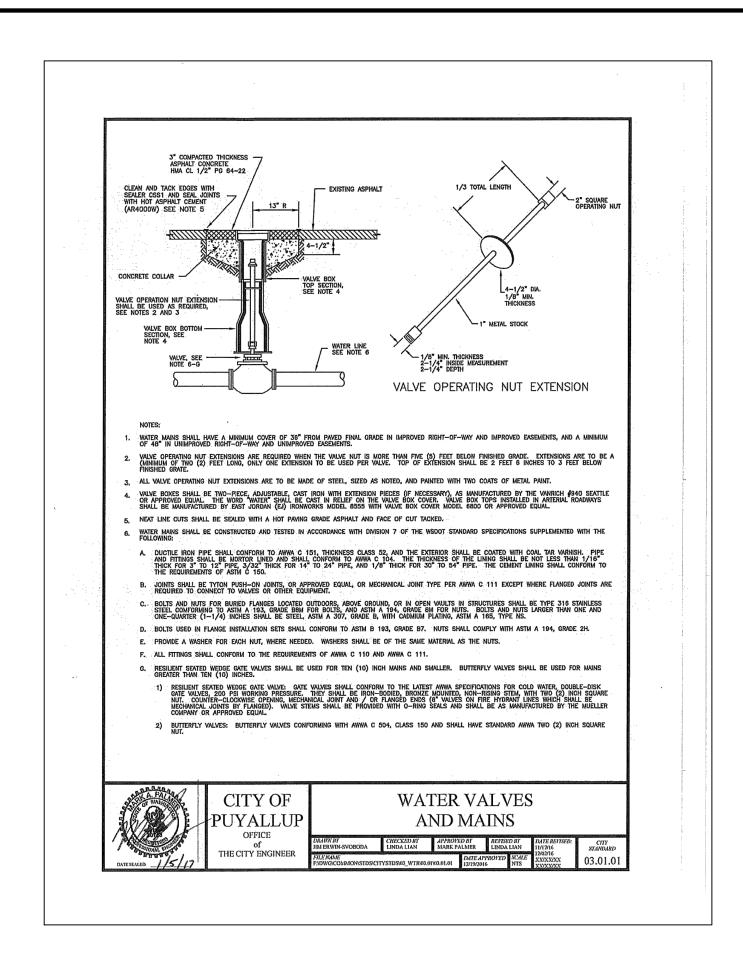WATER & SEWER VENDOR CONNECTION DETAIL 1" = 1 $C6 - 20^{-1}$



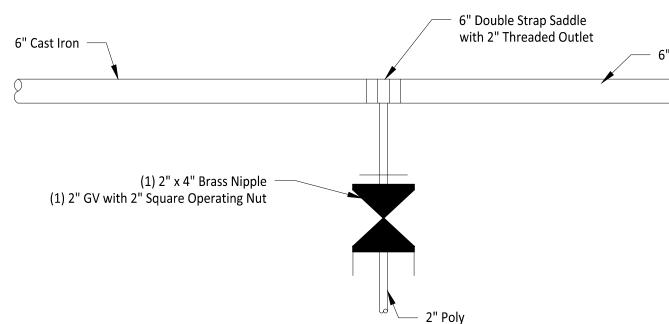



6" Cast Iron

	APPROVED					
	BY Lance & Hollingeworth					
	CITY OF PUYALLUP DEVELOPMENT ENGINEERING					
	DATE04/29/2024		DRAV	VN BY:	DM	DESIGN BY:
	NOTE: THIS APPROVAL IS VOID		PROJ.	NO:		15
	AFTER 180 DAYS FROM APPROVAL DATE.		DATE:			April 18
	THE CITY WILL NOT BE RESPONSIBLE FOR ERRORS AND/OR OMISSIONS ON THESE PLANS. FIELD CONDITIONS MAY DICTATE CHANGES TO THESE PLANS AS DETERMINED BY THE DEVELOPMENT ENGINEERING MANAGER.			Γ NAME	ater	Detail
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UTILITIE	1-800-424-5555 is underground location (DWG.			201 ^{™27}



Owner/Developer:

Washington **STATE FAIR**

PUYALLUP

Washington State Fair

Jeff Brown Architecture 12181 C Street South

Tacoma, WA 98444

Contact: Jeff Brown

(253) 606-8324

110 9th Ave SW Puyallup, WA 98371

(253) 841-5356

Architect:


Engineer:


905 Main St. Suite 200 Sumner, WA 98390 (206) 596-2020


Project: WSF Gold Gate Redevelopment

Civil Construction Permit

ONE INCH AT FULL SCALE. IF NOT, SCALE ACCORDINGLY

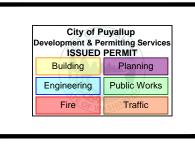

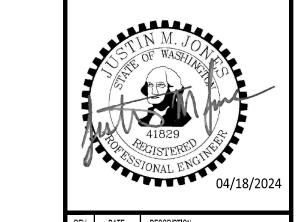


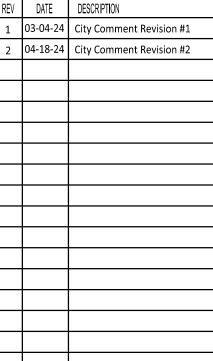


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April 18, 2024


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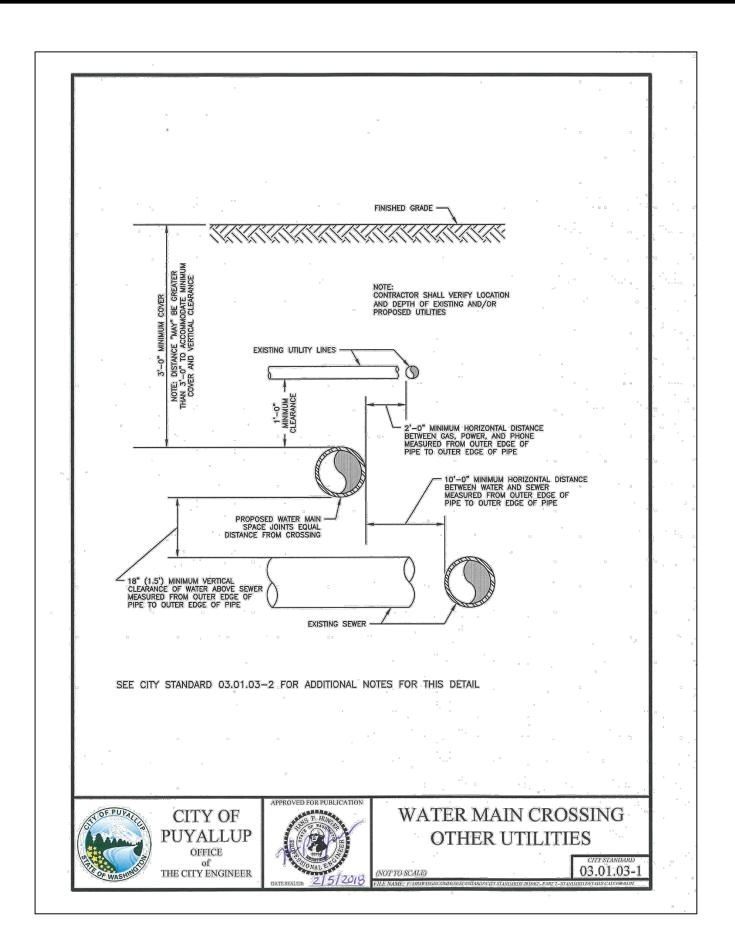


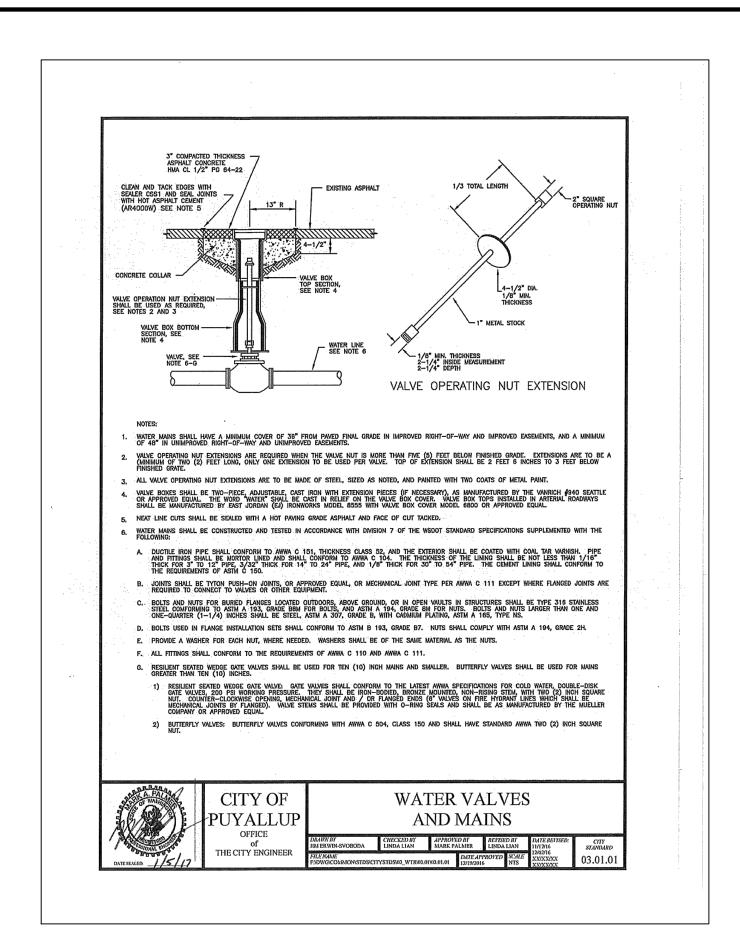


- 1. Hose bibs and sewer connections to be no more than 6" below vault lid.
- 2. Water vault lid to have two inch hole above hose bib.
- 3. Sewer vault lid to have to have four-inch hole directly above 2" to 4" PVC reducer.
- 4. Vault to be Type 3 22" by 32" with one 12" riser and one diamond plate double hinged H20 rated lid.
- 5. Bottom of vault to be backfilled with pea gravel.
- 6. All pipe clamps to be stainless steel.

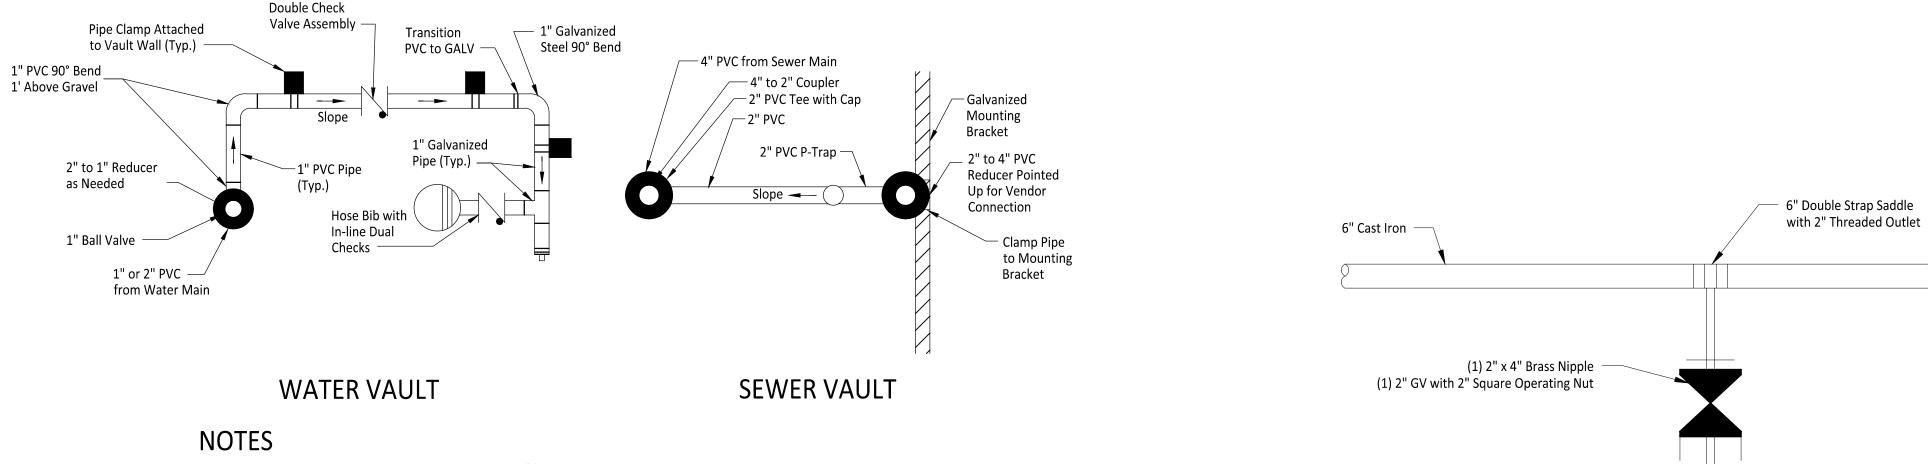WATER & SEWER VENDOR CONNECTION DETAIL



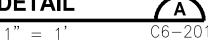

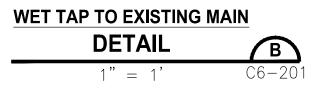

— 2" Poly

6" Cast Iron

2 04-18-24 City Comment Revision #2 DM DESIGN BY: DRAWN BY: 1507-012 PROJ. NO: April 30, 2024 DATE: SHEET NAME Water Details UTILITIES UNDERGROUND LOCATION CENTER C6-201 <u>25</u>^{0F} 27

Owner/Developer:

Washington **STATE FAIR**

PUYALLUP

Washington State Fair

Jeff Brown Architecture 12181 C Street South

Tacoma, WA 98444

Contact: Jeff Brown

JTEAM

Justin Jones, PE

(206) 596-2020

Project:

Permit

905 Main St. Suite 200 Sumner, WA 98390

WSF Gold Gate Redevelopment

Civil Construction

ONE INCH AT FULL SCALE.

IF NOT, SCALE ACCORDINGLY

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03-04-24 City Comment Revision #1

REV DATE DESCRIPTION

04/30/2024

(253) 606-8324


110 9th Ave SW Puyallup, WA 98371


(253) 841-5356

Architect:

Engineer:

	APPROVED
	BY CITY OF PUYALLUP DEVELOPMENT ENGINEERING
	DATE
	NOTE: THIS APPROVAL IS VOID AFTER 180 DAYS FROM APPROVAL DATE. THE CITY WILL NOT BE RESPONSIBLE FOR ERRORS AND/OR OMISSIONS ON THESE PLANS. FIELD CONDITIONS MAY DICTATE CHANGES TO THESE PLANS AS DETERMINED BY THE DEVELOPMENT ENGINEERING MANAGER.
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GEND

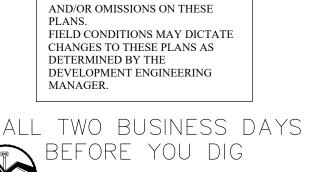Proposed Power Line

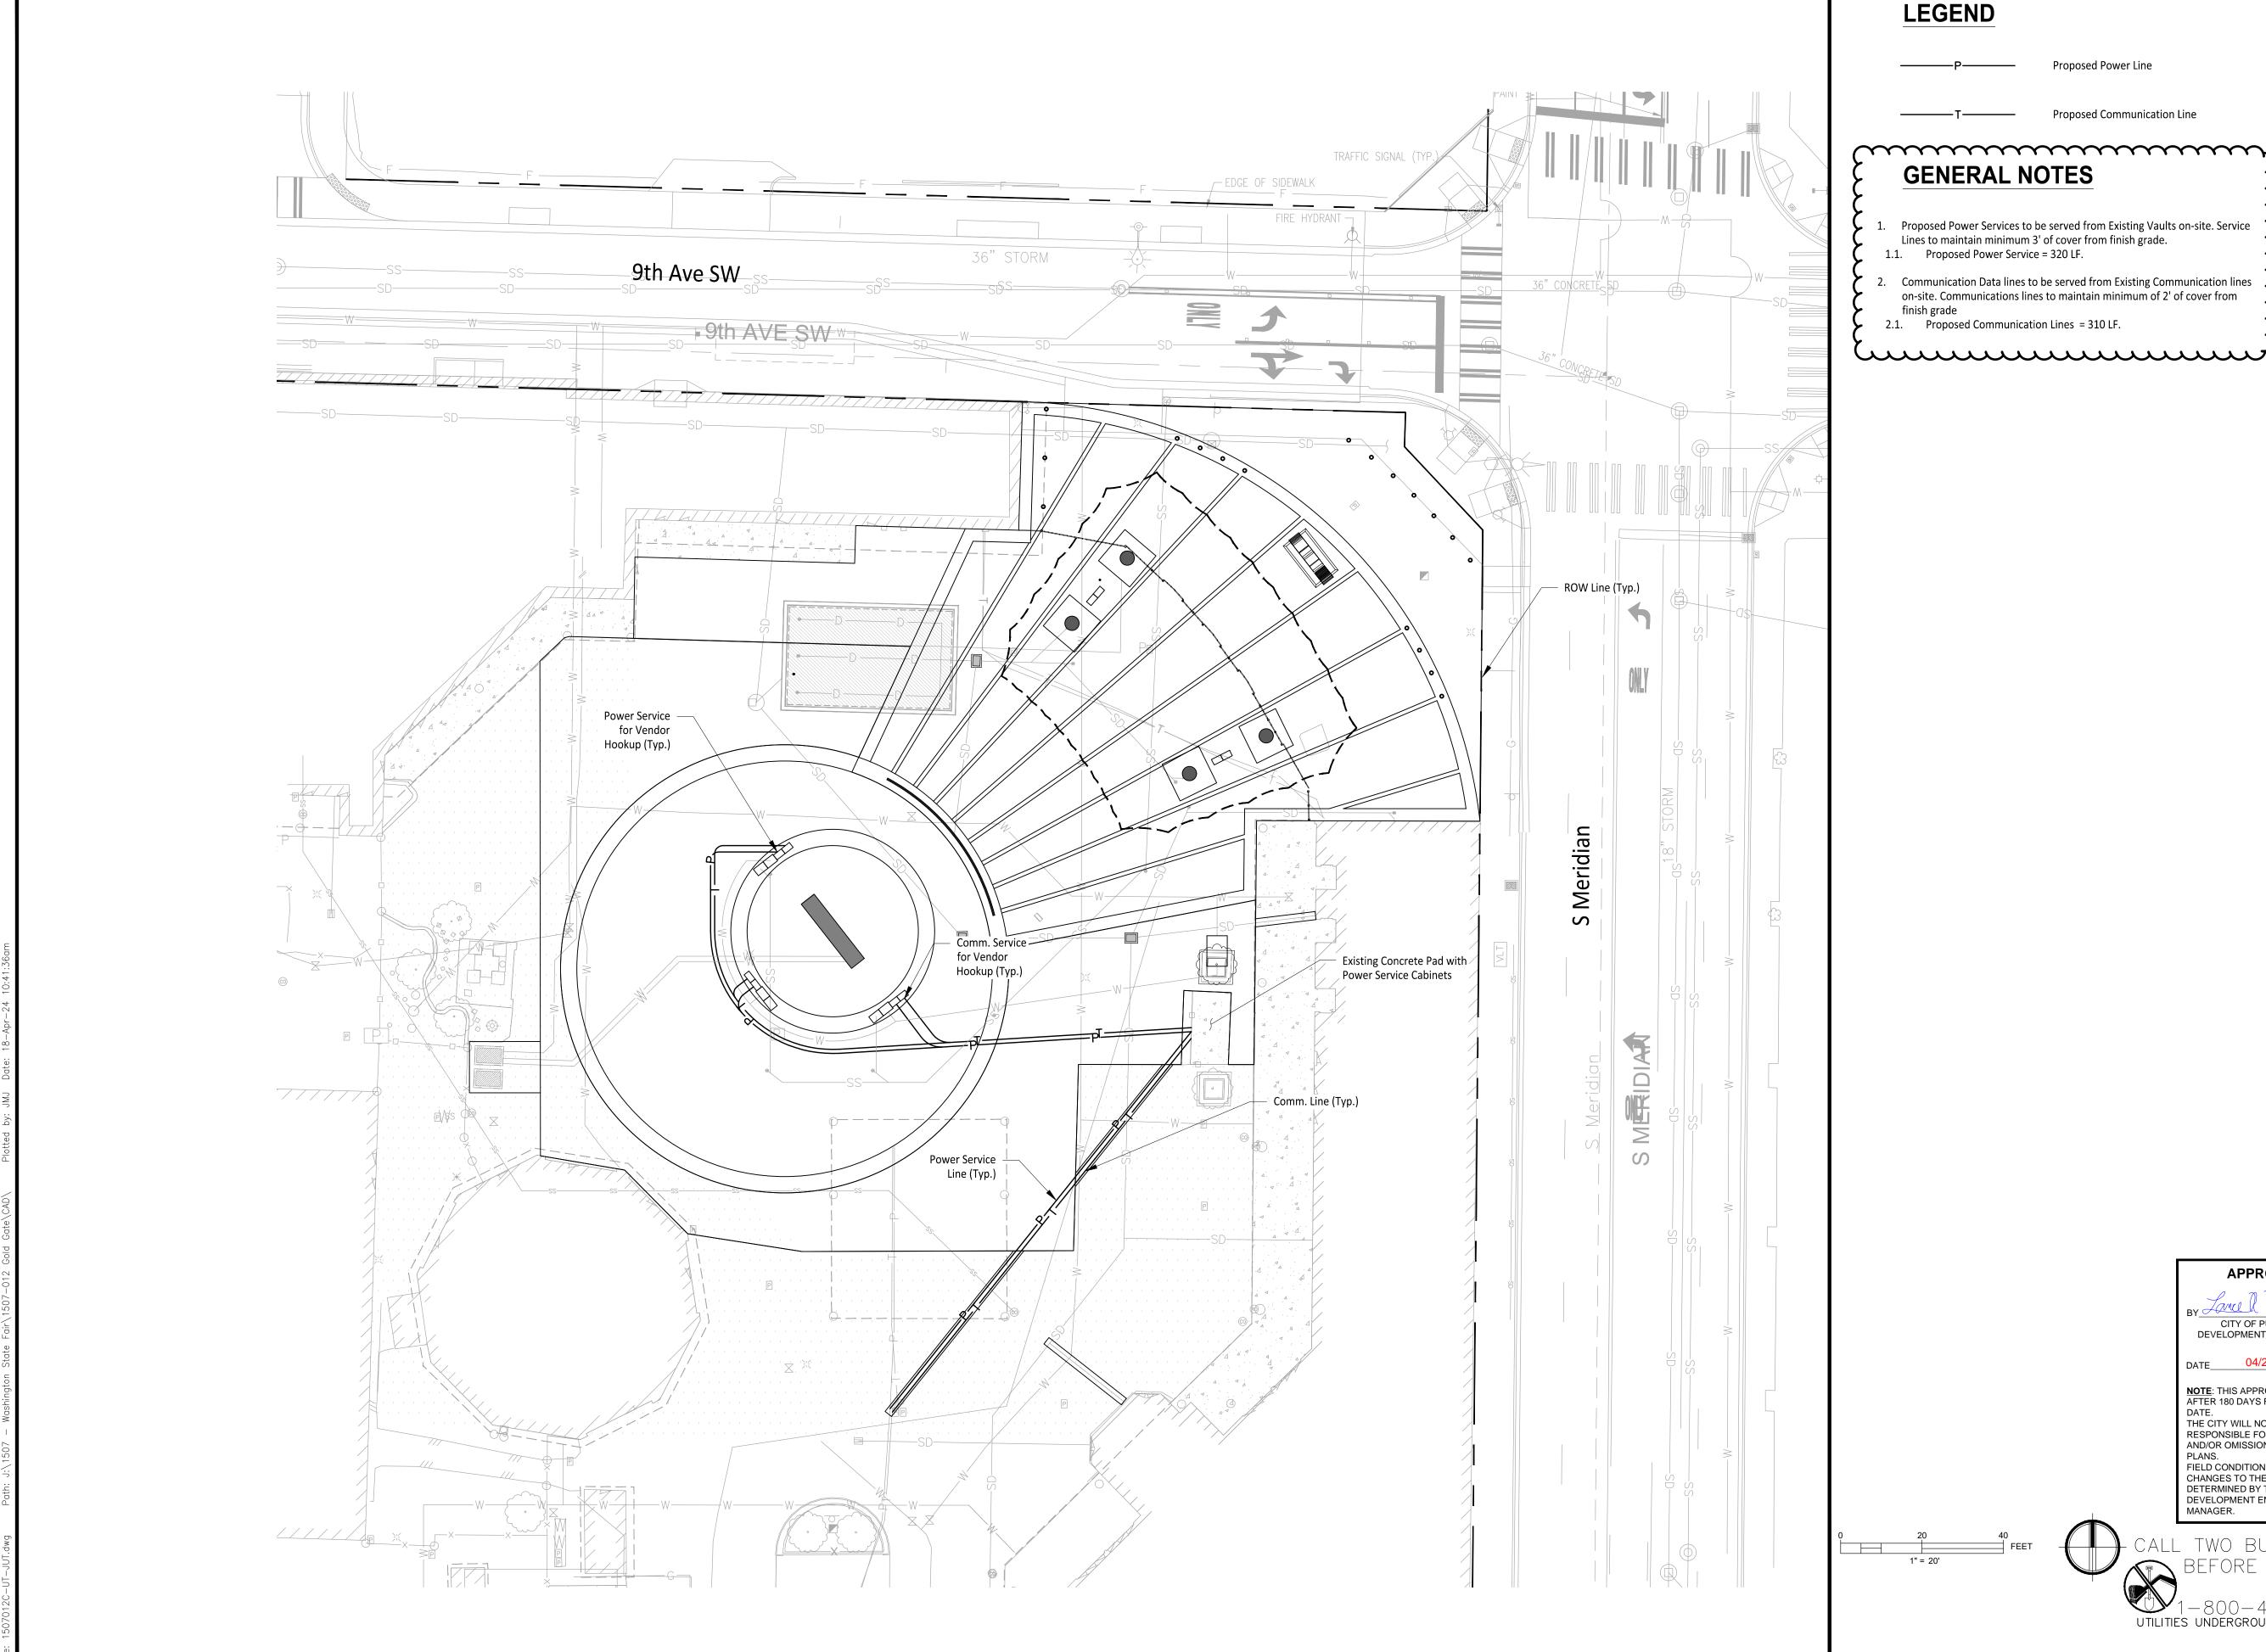Proposed Communication Line

GENERAL NOTES

Proposed Power Services to be served from Existing Vaults on-site. Service Lines to maintain minimum 3' of cover from finish grade. 1.1. Proposed Power Service = 320 LF.

Communication Data lines to be served from Existing Communication lines on-site. Communications lines to maintain minimum of 2' of cover from 2.1. Proposed Communication Lines = 310 LF.

2



Owner/Developer:

PUYALLUP

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Engineer:




Justin Jones, PE 905 Main St. Suite 200 Sumner, WA 98390 (206) 596-2020


Project:

WSF Gold Gate Redevelopment

Civil Construction Permit



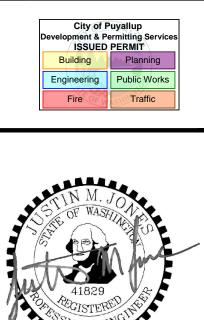

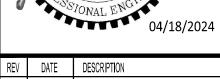

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2	04-18-24		mment Revisior	
1	03-04-24	City Co	mment Revisior	1 #1

1507-012 April 18, 2024

DATE: SHEET NAME


Proj. No:

Joint Utility Trench Plan

<u>27</u> ^{OF} <u>27</u>

C7-101

	APPROVED			
	BY Land Wingsworth CITY OF PUYALLUP DEVELOPMENT ENGINEERING			
	DATE04/29/2024			
	NOTE : THIS APPROVAL IS VOID AFTER 180 DAYS FROM APPROVAL DATE. THE CITY WILL NOT BE RESPONSIBLE FOR ERRORS AND/OR OMISSIONS ON THESE PLANS. FIELD CONDITIONS MAY DICTATE CHANGES TO THESE PLANS AS DETERMINED BY THE DEVELOPMENT ENGINEERING MANAGER.			
CALL TWO BUSINESS DAYS				
UTILITIE	1-800-424-5555	ENTER		

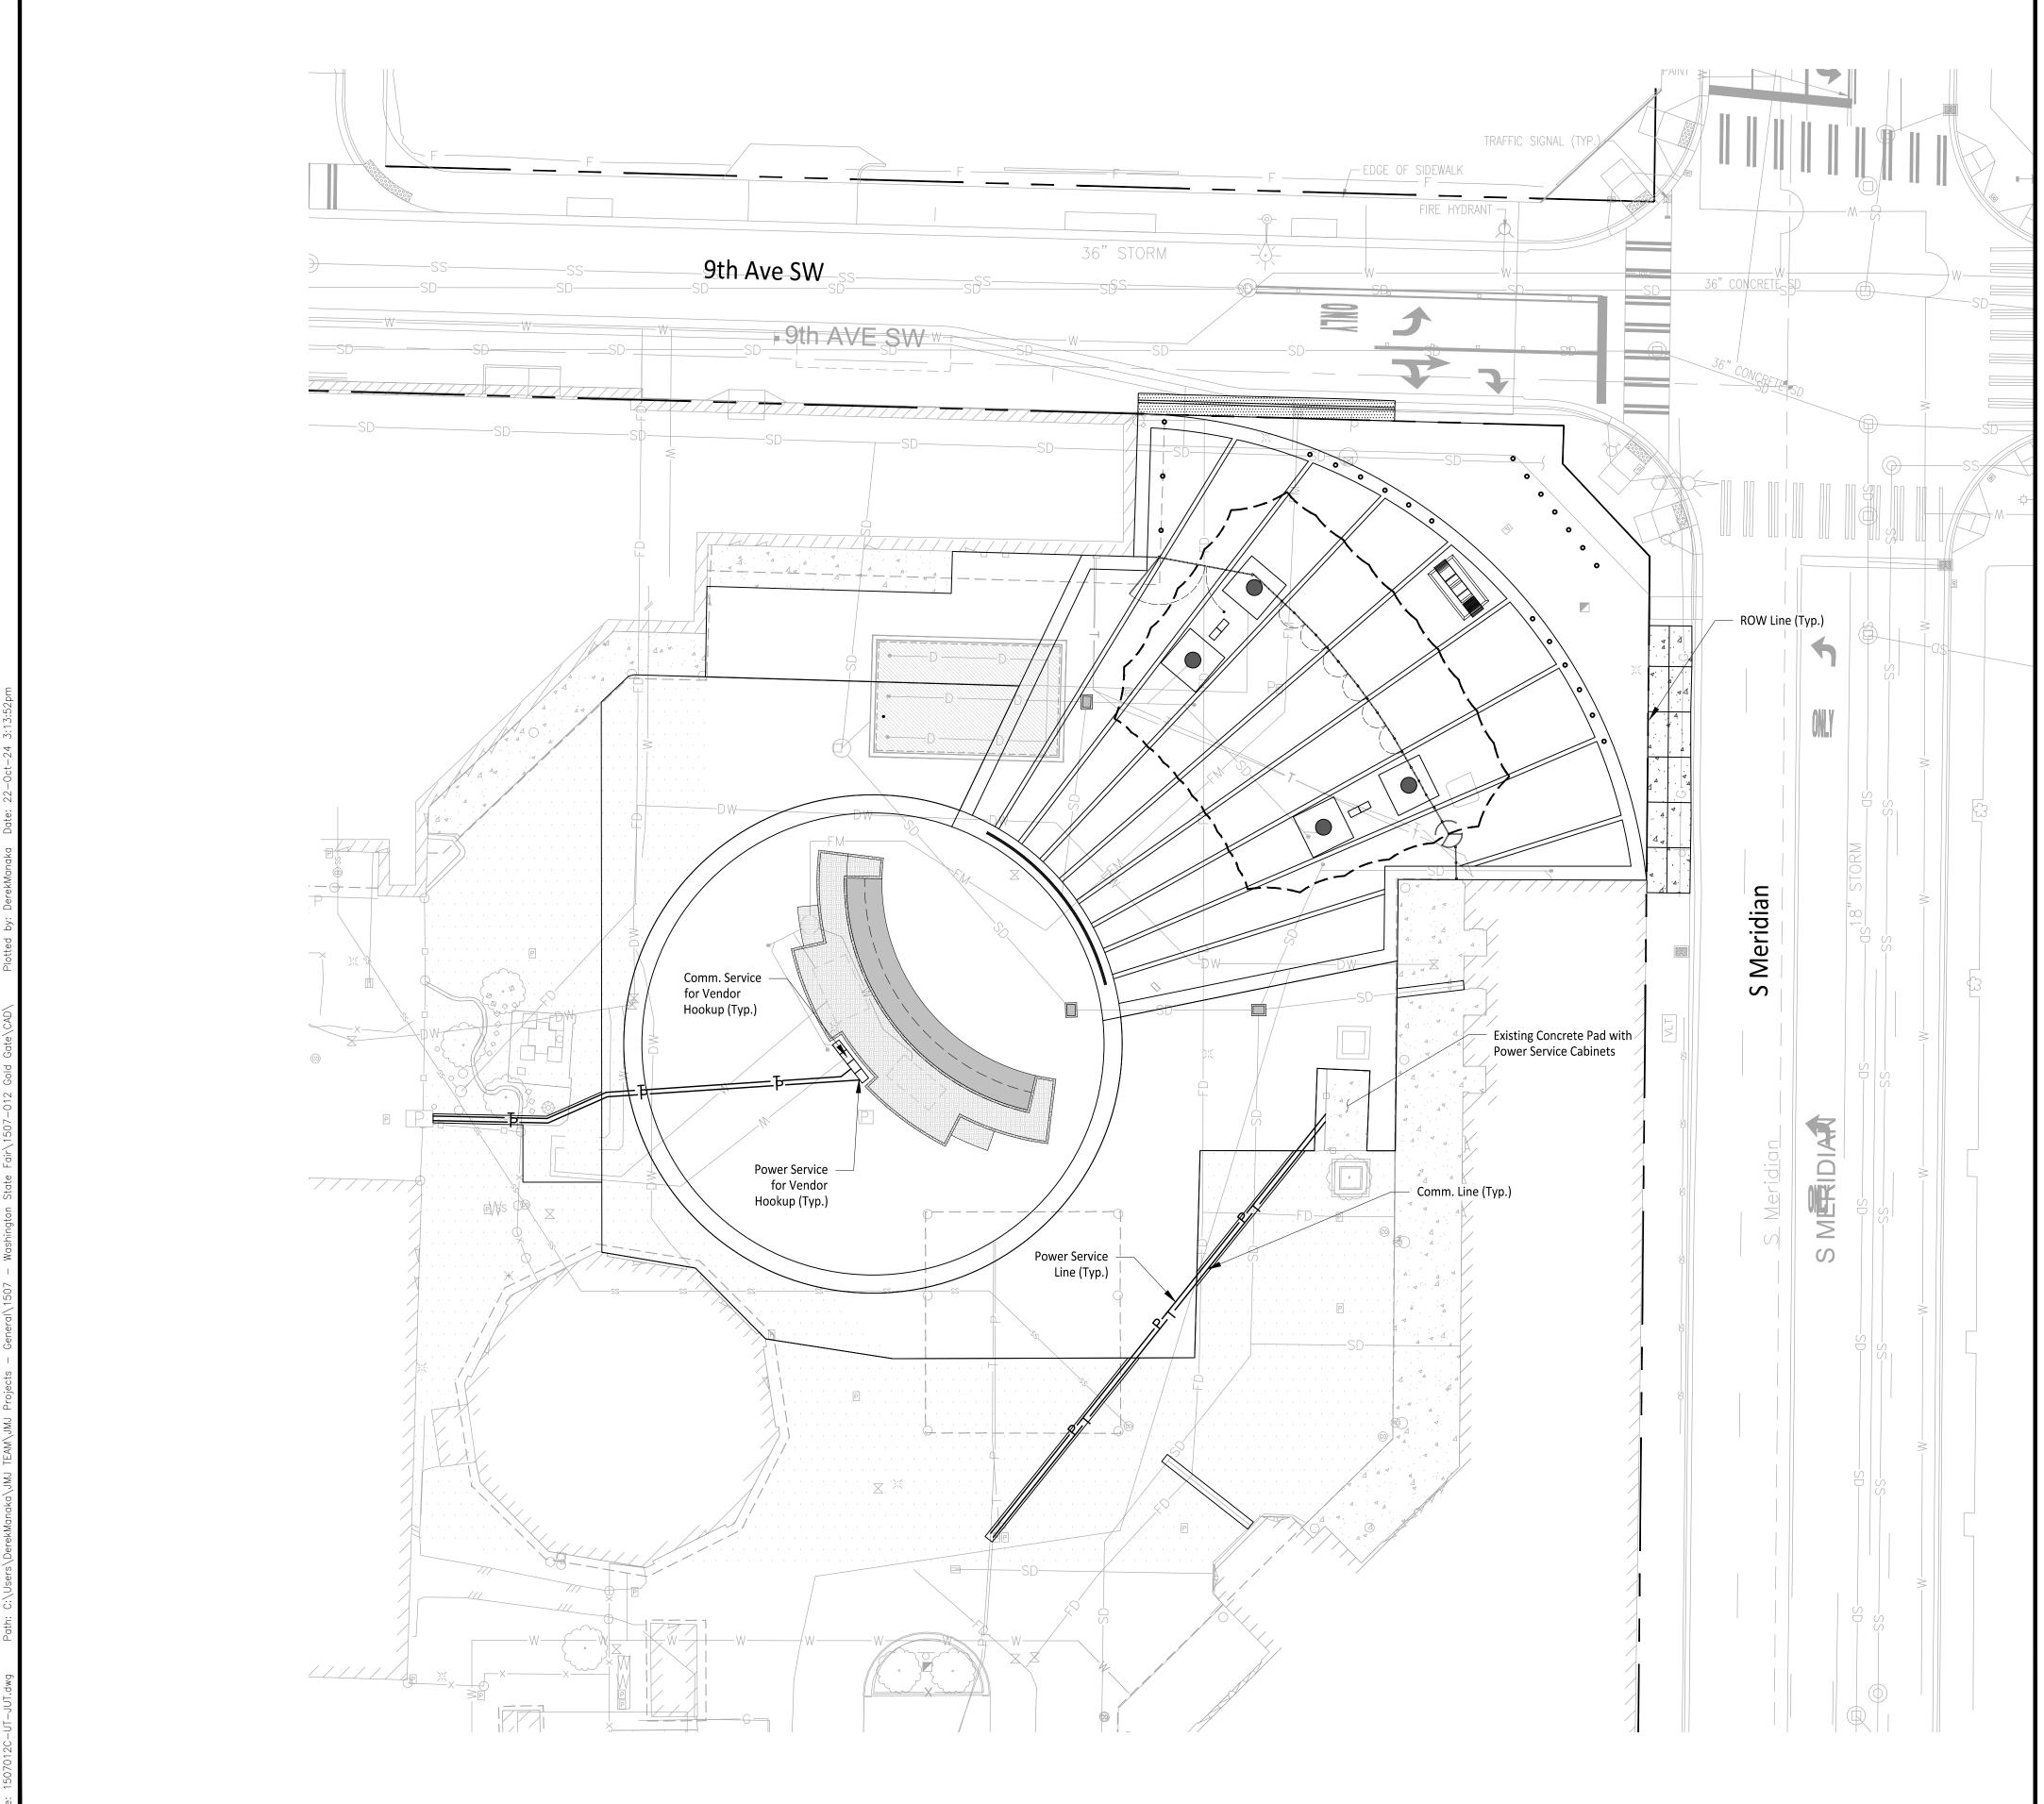





LEGEND

Proposed Power Line

Proposed Communication Line

GENERAL NOTES

1. Proposed Power Services to be served from Existing Vaults on-site. Service Lines to maintain minimum 3' of cover from finish grade. 1.1. Proposed Power Service = 415 LF.

2. Communication Data lines to be served from Existing Communication lines on-site. Communications lines to maintain minimum of 2' of cover from finish grade

2.1. Proposed Communication Lines = 405 LF.

41829 OIUNAL D. 04/30/2024 REV DATE DESCRIPTION 03-04-24 City Comment Revision #1 2 04-18-24 City Comment Revision #2 DM DESIGN BY: DRAWN BY: 1507-012 PROJ. NO: April 30, 2024 DATE: SHEET NAME Joint Utility Trench Plan CALL TWO BUSINESS DAYS UTILITIES UNDERGROUND LOCATION CENTER C7-101 <u>27</u> ^{OF} <u>27</u>

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BY _____ CITY OF PUYALLUP DEVELOPMENT ENGINEERING

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BEFORE YOU DIG

DATE. THE CITY WILL NOT BE RESPONSIBLE FOR ERRORS AND/OR OMISSIONS ON THESE

DATE

PLANS.

MANAGER.

40

FEET

1" = 20'

Owner/Developer:

Washington STATE FAIR

PUYALLUP

Washington State Fair 110 9th Ave SW

Jeff Brown Architecture

12181 C Street South Tacoma, WA 98444

Puyallup, WA 98371

(253) 841-5356

(253) 606-8324

Contact: Jeff Brown

Justin Jones, PE

(206) 596-2020

Project:

Permit

905 Main St. Suite 200

WSF Gold Gate Redevelopment

Civil Construction

ONE INCH AT FULL SCALE. IF NOT, SCALE ACCORDINGLY

ALLA.

Sumner, WA 98390

Architect:

Engineer: