

PRE-CONSTRUCTION NOTES
1. PRIOR TO START OF CONSTRUCTION, A PRE-CONSTRUCTION MEETING IS TO BE HELD INCLUDING A RESPONSIBLE REPRESENTATIVE OF THE ARCHITECT...


ABBREVIATIONS
ANGLE, CENTERLINE, POUND OR NUMBER, AND, EXISTING, AT, DIAMETER OR ROUND DIAMETER, AREA DRAIN, ACOUSTICAL, ACOUSTICAL TILE, ADJUST, ADJUSTABLE or ADJACENT, ABOVE FINISH FLOOR, AGGREGATE, ALUMINUM, APPROX. APPROXIMATE(LY), ARCHITECTURAL, ASPHALT, BOTTOM OF CONCRETE, BOTTOM OF CONCRETE MASONRY UNIT, BOTTOM OF DECK, BOTTOM OF MULLION, BOTTOM OF PANEL, BOTTOM OF REVEAL, BUILDING STANDARD BOARD, BITUMINOUS, BUILDING, BLOCK, BLOCKING, BEAM, BOTTOM, CATCH BASIN, CORNER GUARD, CAST IRON, CASED OPENING, CENTER OF MULLION, CENTER OF REVEAL, COLD WATER, CABINET, CEMENT(ITIOUS), CERAMIC, CONT. FURNISHED / CONT. INSTALLED, CONT. FURNISHED / OWNER INSTALLED, CEILING, CAULKING, CLOSET, CLEAR, COUNTER, COLUMN, CONCRETE, CONNECTION, CONSTRUCTION, CONTINUOUS, CONTRACTOR, CORRIDOR, CARPET, CENTER, COUNTER-SUNK, DEEP, DRINKING FOUNTAIN, DOOR OPENING, DOWNSPOUT, DRY STANDPIPE, DOUBLE, DEPARTMENT, DETAIL, DIAMETER, DIAGONAL, DIFFUSER, DIMENSION, DISPENSER, DOWN, DOOR, DRAWING, DRAWER, EAST, EXPANSION JOINT, ELECTRIC PANELBOARD, ELECTRIC WATER COOLER, EACH, ELEVATION, ELECTRICAL, ELEVATOR, EMERGENCY, ENCLOSED or ENCLOSURE, EQUAL, EQUIPMENT, EXPANSION, EXPOSED, EXISTING, EXTERIOR, FIRE ALARM, FIRE HOSE CABINET, FIRE ALARM, FIRE ALARM, FLOOR DRAIN, FIRE EXTINGUISHER, FIRE EXTINGUISHER CABINET, FLOOR FINISH ELEVATION, FIRE HOSE CABINET, FACE OF CONCRETE, FACE OF CONCRETE MASONRY UNIT, FACE OF FINISH FLOOR, FACE OF INSULATED METAL PANEL, FACE OF SHEATHING, FIREPROOF, FULL SIZE, FOUNDATION, FINISH(ED), FLASH, FLUORESCENT, FOOT or FEET, FOOTING, FURRING, FUTURE, GRAB BAR, GENERAL CONTRACTOR, GAUGE, GALVANIZED, GLASS, GROUND, GRADE, GYPSUM, HOSE BIBB, HOLLOW CORE, HOLLOW METAL, HARDWOOD, HARDWARE, HORIZONTAL, HOUR, HEIGHT, INSIDE DIMENSION, INSULATION or INSULATED INTERIOR, JANITOR, JOINT, KNOCK-OUT, KITCHEN, LABORATORY, LAMINATE(D), LAVATORY, LOCKER, LIGHT, MEDICINE CABINET, MASONRY OPENING, MECHANICAL, MEMBRANE, METAL, MFR. MANUFACTURER, MANHOLE, MINIMUM, MIRROR, MISCELLANEOUS, MOUNTED, MULLION, NORTH, NOT IN CONTRACT, NOT TO SCALE, NUMBER, NOMINAL, OVERALL, ON CENTER, OUTSIDE DIAMETER, OBSOLETE, OWNER FURNISHED / CONT. INSTALLED, OFFICE, OWNER FURNISHED / OWNER INSTALLED, OPENING, OPPOSITE, PRECAST, PANEL JOINT, PLASTIC LAMINATE, PAPER TOWEL DISPENSER, PAPER TOWER RECEPTACLE, PLATE, PLASTER, PLYWOOD, PAIR, POINT, PARTITION, QUARRY TILE, RISER, ROOF DRAIN, ROUGH OPENING, RAIN WATER LEADER, RADIUS, REFERENCE, REFRIGERATOR, REINFORCE(D), REQUIRED, RESILIENT, REGISTER, ROOM, REDWOOD, SOUTH, SOLID CORE, SEAT COVER DISPENSER, SOAP DISPENSER, SANITARY NAPKIN DISPENSER, SANITARY NAPKIN RECEPTACLE, STAINLESS STEEL, SERVICE SINK, SCHEDULE, SECTION, SHELF, SHOWER, SHEET, SIMILAR, SPECIFIED or SPECIFICATION, SQUARE, STATION, STEEL, STORAGE, STRUCTURE or STRUCTURAL, SUSPENDED, SYMMETRICAL, TONGUE AND GROOVE, TREAD, TOWEL BAR, TO BE DETERMINED, TOP OF CURB, TOP OF CONCRETE MASONRY UNIT, TOP OF MULLION, TOP OF PARAPET, TOP OF REVEAL, TOP OF RECESS, TOP OF WALL, TOP OF PAVEMENT, TOILET PAPER DISPENSER, T.O.R. TOP OF REVEAL, T.V. TELEVISION, TELEPHONE, TERRAZZO, THICK, TYPICAL, UNLESS OTHERWISE NOTED, UNFINISHED, UR, VERTICAL, VESTIBULE, WEST, WATER CLOSET, WITH, WITHOUT, WOOD, WATERPROOF, WAINGSCOT, WEIGHT

G.C. INSTRUCTIONS
SUBMITTALS
1. AT THE START OF JOB PROVIDE A SCHEDULE OF ALL ANTICIPATED SUBMITTALS AND DATES. FLAG SUBMITTALS WHICH ARE OR COULD BE CRITICAL PATH. FLAG SUBMITTALS THAT WILL BE REQUESTED TO BE EXPEDITED FASTER THAN THE STANDARD 7-10 DAYS.

REQUESTS FOR INFORMATION (RFIs)
1. THE GENERAL CONTRACTOR IS TO REVIEW ALL PROSPECTIVE RFIs AND MAKE EVERY EFFORT TO ANSWER THEM BEFORE SUBMITTING TO THE DESIGN TEAM.

CHANGE ORDERS
1. A COMPLETE SCHEDULE OF VALUES OF THE BASE CONTRACT IS TO BE PROVIDED TO THE OWNER AND ARCHITECT PRIOR TO THE START OF ANY WORK.

PROJECT SCHEDULE
1. A COMPLETE CONSTRUCTION SCHEDULE OF ALL PORTIONS OF THE WORK TO BE PROVIDED TO THE OWNER AND ARCHITECT PRIOR TO START OF ANY WORK.

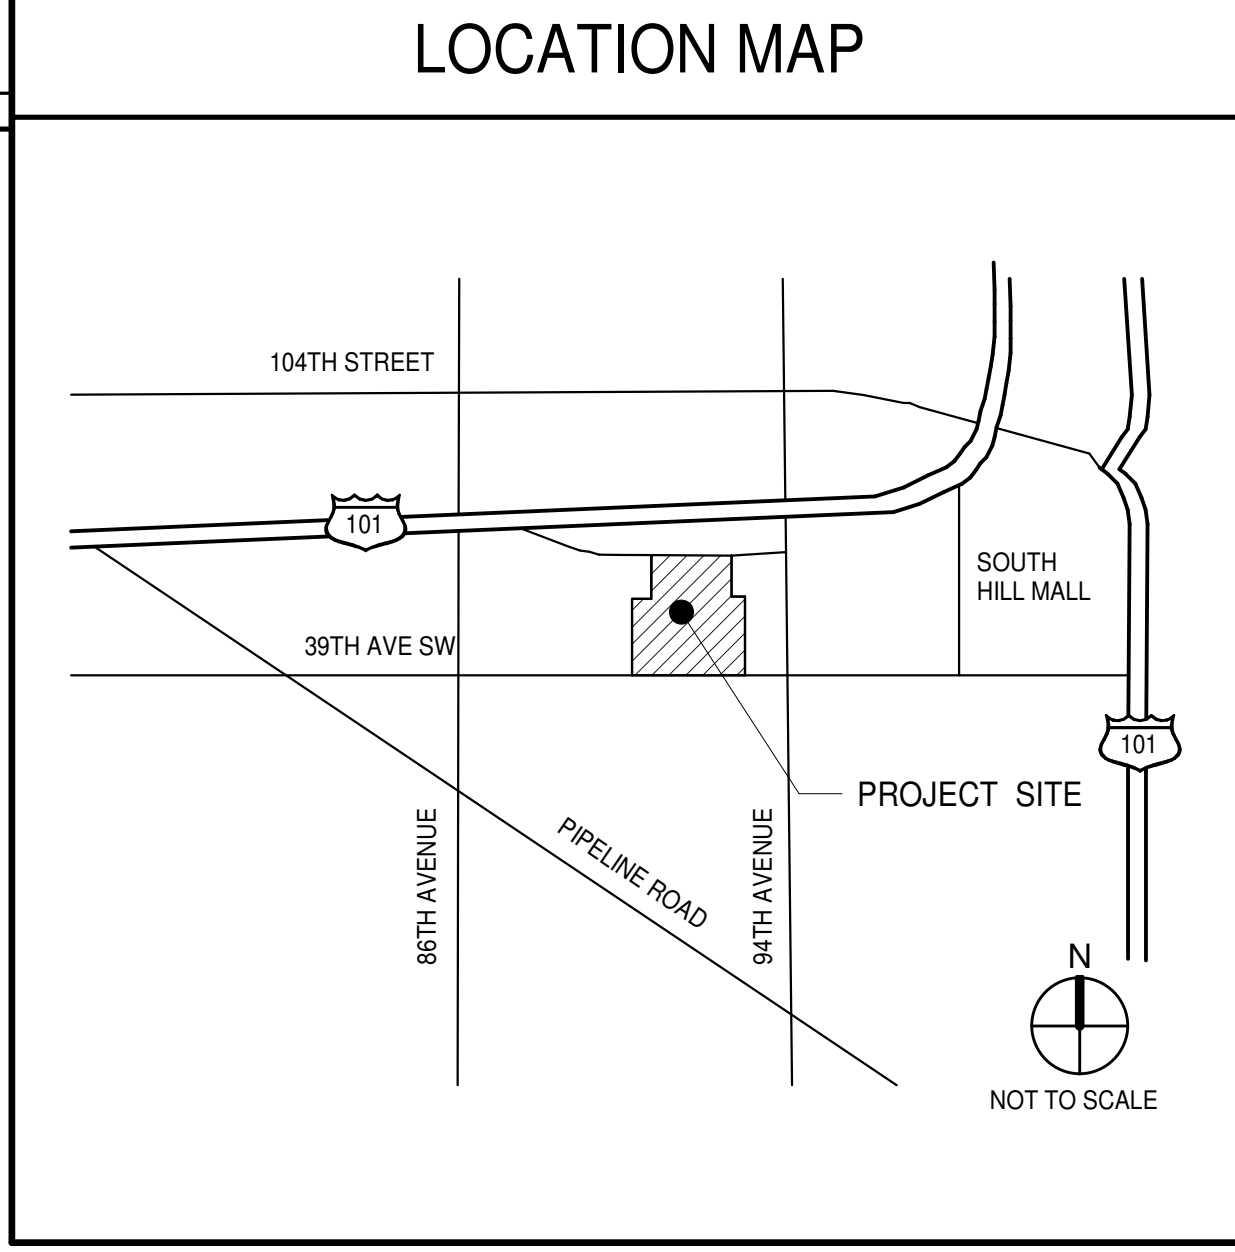

PROJECT DIRECTORY
ARCHITECT: WARE MALCOMB
BUILDING OWNER: COSTCO WHOLESALE
ARCHITECT'S CONSULTANTS: MECHANICAL & PLUMBING ENGINEER (RTM ENGINEERING), ELECTRICAL ENGINEER (RTM ENGINEERING)
TENANT: COSTCO WHOLESALE
GENERAL CONTRACTOR: GC COMPANY NAME

PROJECT DIRECTORY (continued)
ARCHITECT: WARE MALCOMB
BUILDING OWNER: COSTCO WHOLESALE
ARCHITECT'S CONSULTANTS: MECHANICAL & PLUMBING ENGINEER (RTM ENGINEERING), ELECTRICAL ENGINEER (RTM ENGINEERING)
TENANT: COSTCO WHOLESALE
GENERAL CONTRACTOR: GC COMPANY NAME

PROJECT DIRECTORY (continued)
ARCHITECT: WARE MALCOMB
BUILDING OWNER: COSTCO WHOLESALE
ARCHITECT'S CONSULTANTS: MECHANICAL & PLUMBING ENGINEER (RTM ENGINEERING), ELECTRICAL ENGINEER (RTM ENGINEERING)
TENANT: COSTCO WHOLESALE
GENERAL CONTRACTOR: GC COMPANY NAME

COSTCO FLEET RESTROOM
PUYALLUP WH0660
RESTROOM REFRESH
1201 39TH AVE SW, PUYALLUP, WA. 98373-3803
(For Tenant Improvement Permit Only)

PROJECT DESCRIPTION & SCOPE
PROJECT DESCRIPTION: EXISTING SCOPE
SCOPE OF WORK: SCOPE OF WORK UNDER THIS PERMIT: THE SCOPE OF WORK INCLUDES THE INSTALLATION OF NEW INTERIOR PARTITIONS, PLUMBING FIXTURES, RESTROOM ACCESSORIES, FINISHES, CEILING AND LIGHTING. RESTROOMS ARE TO MEET LOCAL REQUIREMENTS.

BUILDING & CODE INFORMATION
BUILDING DEPARTMENT: CITY OF PUYALLUP, WASHINGTON
APPLICABLE BUILDING CODES: 2021 INTERNATIONAL BUILDING CODE, 2021 INTERNATIONAL MECHANICAL CODE, 2021 NATIONAL ELECTRICAL CODE, 2021 INTERNATIONAL PLUMBING CODE, 2021 INTERNATIONAL FIRE CODE, 2021 WASHINGTON STATE ENERGY CODE, 2021 INTERNATIONAL FUEL GAS CODE, 2017 ICC A117-1 AMERICAN NATIONAL STANDARD INSTITUTE

DEFERRED SUBMITTALS
DEFERRED SUBMITTAL ITEMS SHALL BE SUBMITTED TO THE ARCHITECT AND ENGINEERS OF RECORD WHO SHALL REVIEW AND PROVIDE NOTATION INDICATING DOCUMENTS HAVE BEEN REVIEWED AND FOUND TO BE IN GENERAL CONFORMANCE WITH THE BUILDING DESIGN.

SHEET INDEX
SHEET ISSUED ON DATE INDICATED, WITH MODIFICATIONS
ARCHITECTURAL: G010 TITLE SHEET, 1000 PROJECT DATA, 1010 GENERAL NOTES, 1020 ACCESSIBILITY DETAILS, 1100 SITE PLAN, 1200 OVERALL FLOOR PLAN, 1420 INTERIOR RESTROOM PLANS AND ELEVATIONS, 1510 DETAILS, 1620 SCHEDULES
STRUCTURAL: S1.1 GENERAL NOTES, PARTIAL CEILING FRAMING PLAN AND SECTIONS, S2.1 SECTIONS
MECHANICAL: M-0 MECHANICAL SPECIFICATIONS, GENERAL NOTES, SYMBOLS, AND LEGENDS, M-1 MECHANICAL PLANS, SCHEDULES, & DETAILS
ELECTRICAL: E-0 ELECTRICAL GENERAL NOTES, SYMBOLS, AND LEGENDS, E-1 ELECTRICAL PLANS AND SCHEDULES
PLUMBING: P-0 PLUMBING GENERAL NOTES, SYMBOLS, AND LEGENDS, P-1 PLUMBING PLANS

MECHANICAL
ELECTRICAL
PLUMBING

THE APPROVED CONSTRUCTION PLANS, DOCUMENTS, AND ALL ENGINEERING MUST BE POSTED ON THE JOB AT ALL INSPECTIONS IN A VISIBLE AND READILY ACCESSIBLE LOCATION.
Full sized legible color plans are required to be provided by the permittee on site for inspection.
Approval of submitted plans is not an approval of omissions or oversights by this office or non compliance with any applicable regulations of local government. The contractor is responsible for making sure that the building complies with all applicable codes and regulations of the local government.
Separate Electrical Permit is required with the Washington State Department of Labor & Industries.
PAPM: L LUCERO
DRAWN BY: A. M.
JOB NO.: SE424-0053-00
SHEET G010

WARE MALCOMB
ARCHITECTURE
ENGINEERING
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BELLEVUE, WA 98004
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REGISTERED ARCHITECT
ADAM SEGALLA
STATE OF WASHINGTON



COSTCO FLEET RESTROOM
PUYALLUP WH0660
1201 39TH AVE SW, PUYALLUP, WA. 98373-3803

TITLE SHEET
REMARKS
PERMIT ISSUANCE
DATE: 09/20/2024
CITY OF PUYALLUP
Development & Permitting Services
ISSUED PERMIT
Building, Planning, Engineering, Public Works, Fire, Traffic
City of Puyallup Development & Permitting Services
ISSUED PERMIT
Building, Planning, Engineering, Public Works, Fire, Traffic
City of Puyallup Planning Division APPROVED
See permit conditions.
Chris BEALE
11/07/2024
10:44:01 AM
CITY OF PUYALLUP
Development & Permitting Services
ISSUED PERMIT
Building, Planning, Engineering, Public Works, Fire, Traffic
City of Puyallup Development & Permitting Services
ISSUED PERMIT
Building, Planning, Engineering, Public Works, Fire, Traffic
CITY OF PUYALLUP
Development & Permitting Services
ISSUED PERMIT
Building, Planning, Engineering, Public Works, Fire, Traffic
CITY OF PUYALLUP
Development & Permitting Services
ISSUED PERMIT
Building, Planning, Engineering, Public Works, Fire, Traffic

**City of Puyallup
Development & Permitting Services
ISSUED PERMIT**

Building	Planning
Engineering	Public Works
Fire	Traffic

FIRE AUTHORITY NOTES

- FINAL INSPECTION BY FIRE DEPARTMENT IS REQUIRED - SCHEDULE 72 HOURS IN ADVANCE.
- THE PROJECT ADDRESS SHALL BE PROVIDED FOR ALL NEW AND EXISTING BUILDINGS IN A POSITION AS TO BE PLAINLY VISIBLE AND LEGIBLE FROM THE STREET OR ROAD FRONTING THE PROPERTY PER LOCAL FIRE DEPARTMENT STANDARDS.
- AN UNOBSTRUCTED ALL-WEATHER FIRE APPARATUS ACCESS ROAD SHALL BE IN PLACE PRIOR TO DELIVERY OF COMBUSTIBLE BUILDING MATERIALS TO THE SITE.
- FIRE PREVENTION WATER SERVICE SHALL BE IN SERVICE PRIOR TO DELIVERY OF COMBUSTIBLE BUILDING MATERIALS TO THE SITE.
- ACCESS GATES SHALL BE APPROVED PRIOR TO INSTALLATION AND SHALL BE IN COMPLIANCE WITH LOCAL FIRE AUTHORITY.
- FIRE SPRINKLER SYSTEM(S) SHALL MEET STATE & LOCAL FIRE CODES AND BE PROVIDED TO PROTECT ENTIRE BUILDING INCLUDING PROJECTIONS OVER 4'-0".
- FIRE SPRINKLER SYSTEM(S) AND ALL CONTROL VALVES, INCLUDING EXTERIOR SHALL BE SUPERVISED BY A U.L. LISTED CENTRAL ALARM STATION OR PER STATE & LOCAL FIRE CODES.
- ALL VALVES CONTROLLING THE WATER SUPPLY FOR AUTOMATIC SPRINKLER SYSTEMS AND WATER FLOW SWITCHES ON ALL SPRINKLER SYSTEMS SHALL BE ELECTRICALLY MONITORED WHERE THE NUMBER OF SPRINKLERS IS (100) OR MORE.
- ELECTRICAL SUBCONTRACTORS TO INSTALL WIRING FOR FIRE SPRINKLER, ALARM BELL AND TELEPHONE WARNING AS REQUIRED BY FIRE DEPARTMENT.
- INSTALLATION OF FIRE ALARM SYSTEMS SHALL BE IN ACCORDANCE WITH STATE & LOCAL FIRE CODES.
- COMPLETE PLANS AND SPECIFICATIONS FOR ALL FIXED FIRE PROTECTION EQUIPMENT INCLUDING AUTOMATIC SPRINKLERS AND OTHER FIRE PROTECTION SYSTEMS, SHALL BE SUBMITTED BY INSTALLING CONTRACTOR. SUCH PLANS SHALL BE APPROVED BY LOCAL FIRE AUTHORITY PRIOR TO INSTALLATION.
- LOCATIONS AND CLASSIFICATIONS OF FIRE EXTINGUISHERS SHALL BE IN ACCORDANCE WITH STATE & LOCAL FIRE CODES AND PLACEMENT IS SUBJECT TO THE APPROVAL OF THE FIRE INSPECTOR. VERIFY QUANTITY & EXACT LOCATION FROM FIRE DEPARTMENT PRIOR TO ORDERING.
- AT OFFICE AREAS PROVIDE MULTIPURPOSE DRY CHEMICAL PORTABLE FIRE EXTINGUISHERS RATED 4-A80-B-C AT THE RATE OF ONE EXTINGUISHER PER 11,250 SF MAXIMUM AS INDICATED ON PLANS. SUBJECT TO FIRE DEPARTMENT INSPECTION AND FINAL APPROVAL. TRAVEL DISTANCE FROM REMOTE LOCATIONS TO THE NEAREST EXTINGUISHER SHALL BE 75' MAXIMUM. EACH EXTINGUISHER SHALL BE SIZED AS REQUIRED TO PROTECT MAXIMUM FLOOR AREAS LISTED IN NFPA 11, TABLE 5.1. LIGHT HAZARD OCCUPANCY ASSUMED. FINAL DETERMINATION OF LIGHT, ORDINARY AND EXTRA HAZARD CLASSIFICATION REQUIRES FIRE DEPARTMENT REVIEW AND APPROVAL.
- STORAGE, DISPENSING OR USE OF ANY FLAMMABLE AND COMBUSTIBLE LIQUIDS, FLAMMABLE AND COMPRESSED GASES, AND OTHER HAZARDOUS MATERIALS SHALL COMPLY WITH STATE & LOCAL FIRE CODES. THE STORAGE AND USE OF HAZARDOUS MATERIALS SHALL BE APPROVED BY THE FIRE AUTHORITY PRIOR TO ANY MATERIALS BEING STORED OR USED ON SITE. A SEPARATE PLAN SUBMITTAL IS REQUIRED PRIOR TO THE STORAGE AND USE OF HAZARDOUS MATERIALS.
- BUILDING(S) NOT APPROVED FOR HIGH-PILED STOCK (MATERIALS IN CLOSELY PACKED PILES OR ON PALLETS, OR IN RACKS WHERE THE TOP OF STORAGE EXCEEDS 12'-0" IN HEIGHT, AND 6'-0" FOR GROUP "A" PLASTICS AND CERTAIN OTHER HIGH-HAZARD COMMODITIES). HIGH-PILED STOCK SHALL BE APPROVED BY THE FIRE AUTHORITY PRIOR TO MATERIALS BEING STORED ON SITE. A SEPARATE PLAN SUBMITTAL IS REQUIRED FOR HIGH-PILED STORAGE IN ACCORDANCE WITH STATE & LOCAL FIRE CODES.
- A LETTER OF INTENDED USE MAY BE REQUIRED BY THE FIRE INSPECTOR.
- ALL REQUIRED FIRE DOORS SHALL BEAR A LABEL FROM A RECOGNIZED AGENCY SHOWING THE SPECIFIC RATING.
- EXIT SIGNS AND ILLUMINATION SHALL CONFORM TO ALL APPLICABLE BUILDING AND FIRE CODES.
- EXIT DOORS SHALL BE OPERABLE FROM THE INSIDE WITHOUT THE USE OF A KEY OR ANY SPECIAL KNOWLEDGE OR EFFORT.
- PROVIDE OR MODIFY AS NEEDED SPRINKLER ALARM AND SMOKE DETECTION SYSTEM PER APPLICABLE CODES INCLUDING IF NECESSARY FOR HORNS, STROBE LIGHTS, CONTROL PANEL CONNECTIONS, SMOKE DETECTORS, AUDIO VISUAL ALARMS. SUBMIT SHOP DRAWINGS TO THE FIRE MARSHAL FOR APPROVAL.

WARE MALCOMB
 3015 112th Ave NE, Suite #205
 Burien, WA 98148
 P: 425.670.6706

ARCHITECTURE
 PLANNING
 INTERIORS

CIVIL ENGINEERING
 BRIDGES
 BUILDING MEASUREMENT

19194 REGISTERED ARCHITECT
 ADAM SEGALLA
 STATE OF WASHINGTON



COSTCO FLEET RESTROOM
PUYALLUP WH0660
 1201 39TH AVE SW,
 PUYALLUP, WA. 98373-3803

SPECIAL INSPECTION

IN ADDITION TO THE SPECIAL INSPECTION REQUIREMENTS NOTED ON THE STRUCTURAL DRAWINGS IN THESE DOCUMENTS, PERIODIC SPECIAL INSPECTION IS REQUIRED PER BC 1707 FOR THE FOLLOWING BUILDING COMPONENTS:

- IN SEISMIC DESIGN CATEGORIES C, D, E, AND F: ANCHORAGE OF ELECTRICAL EQUIPMENT USED FOR EMERGENCY OR STANDBY POWER SYSTEMS.
- IN SEISMIC DESIGN CATEGORIES D, E, AND F: SUSPENDED CEILING SYSTEMS AND THEIR ANCHORAGE.
- IN SEISMIC DESIGN CATEGORIES E, AND F: ALL ELECTRICAL EQUIPMENT.

SEE STRUCTURAL DRAWINGS FOR DESIGNATION OF SEISMIC DESIGN CATEGORY

SYMBOLS


	ALIGN		INTERIOR ELEVATION REFERENCE
	ROOM NAME		SHEET NUMBER
	ROOM NUMBER		WALL MATERIAL TYPE
	DOOR NUMBER		WALL NOTE
	EXISTING DOOR		FLOOR MATERIAL TYPE
	DETAIL REFERENCE SHEET NUMBER		FLOOR NOTE
	DETAIL SECTION REFERENCE SHEET NUMBER		MISC. MATERIAL TYPE
	SECTION REFERENCE SHEET NUMBER		TYPE NUMBER
	EXT. ELEVATION REFERENCE SHEET NUMBER		KEYNOTE INDICATOR
			WALL PARTITION TAG
			EQUIPMENT TAG
			REVISION CLOUD & DELTA NUMBER

PROJECT DATA

DATE	REMARKS
09/20/2024 <td>PERMIT ISSUANCE</td>	PERMIT ISSUANCE

PA/PM: L. LUCERO
 DRAWN BY: A. M.
 JOB NO.: SE424-0053-00

SHEET
1000

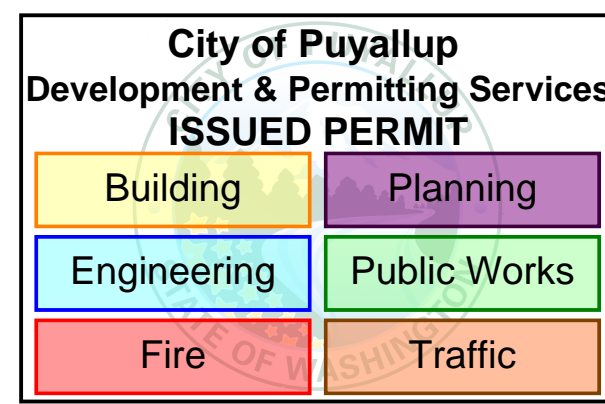

DEMOLITION NOTES

- 1. DRAWINGS OF EXISTING CONDITIONS HAVE BEEN COMPILED FROM EXISTING DATA SUPPLIED BY THE OWNER TO THE ARCHITECT. THE ARCHITECT MAKES NO WARRANTY EITHER EXPRESSED NOR IMPLIED FOR THE ACCURACY OR THE COMPLETENESS OF THE EXISTING INFORMATION RECORDED. THE CONTRACTOR SHALL VERIFY ALL EXISTING CONDITIONS AND NOTIFY THE ARCHITECT IMMEDIATELY OF ANY DISCREPANCIES OR CONFLICTS THAT MIGHT ARISE IN THE COURSE OF THE DEMOLITION WORK.

FINISH NOTES

- 1. NO FINISH SUBSTITUTIONS MAY BE MADE UNLESS APPROVED BY ARCHITECT.
- 2. CONTRACTOR MUST NOTIFY THE ARCHITECT OF ANY DISCREPANCY IN PLANS. FINISH ITEMS CLEARLY SHOWN IN PLANS, BUT OMITTED FROM SCHEDULES OR LEGENDS MUST STILL BE PROVIDED AND INSTALLED BY CONTRACTOR. CONTRACTOR TO VERIFY COMPLETED FINISH WITH ARCHITECT PRIOR TO ORDERING PRODUCTS.

CEILING NOTES

- 1. SEE ELECTRICAL ENGINEERING DRAWINGS FOR SPECIFICATIONS OF LIGHT FIXTURES, SWITCHES, EXIT SIGNS, ETC.
- 2. CONTRACTOR TO VERIFY COMPATIBILITY OF LIGHT FIXTURES WITH THE CEILING SYSTEM.
- 3. ALL REPLACEMENT FLOURESCENT LAMPS TO MATCH BUILDING STANDARD OR ADJACENT EXISTING CONSTRUCTION - SAME COLOR AND MANUFACTURER.

GENERAL PROJECT NOTES

- GENERAL NOTES
1. ALL WORK SHALL BE PERFORMED SO AS TO COMPLY WITH ALL LEGAL, INDUSTRY AND PROJECT SPECIFIC REQUIREMENTS AND STANDARDS INCLUDING WITHOUT LIMITATION OF THE FOLLOWING:
A. ALL APPLICABLE BUILDING CODES
B. ALL APPLICABLE SPECIALTY CODES INCLUDING THE MOST CURRENT ISSUES AND SUPPLEMENTS
C. THE PROJECT MANUAL AND ASSOCIATED SPECIFICATIONS WHEN PROVIDED
D. THE MANUFACTURER'S REQUIREMENTS OR RECOMMENDATIONS
E. ALL APPLICABLE LANDLORD BUILDING STANDARDS

FLOOR PLAN NOTES

- 1. CONTRACTOR AND ARCHITECT TO REVIEW & APPROVE CHALK LINES OF PARTITION LAYOUT PRIOR TO COMMENCEMENT OF PARTITION CONSTRUCTION.
- 2. CONTRACTOR TO VERIFY DIMENSIONS FOR ALL PLUMBING PARTITIONS.
- 3. EXTEND ALL STUDS AND PARTITION MATERIALS TO CONSTRUCTION ABOVE, U.O.N.
- 4. ALL CONDUIT PIPING TO BE CONCEALED WITHIN THE PARTITION CONSTRUCTION.

DOOR NOTES

- 1. CONTRACTOR SHALL SUBMIT A COMPLETE HARDWARE SCHEDULE WITH HARDWARE CUT SHEETS PREPARED BY A QUALIFIED HARDWARE CONSULTANT FOR ARCHITECT'S REVIEW AND APPROVAL.
- 2. GENERAL CONTRACTOR TO PRODUCE AND COORDINATE USE OF A MASTER KEYING SYSTEM DEVELOPED WITH AND APPROVED BY THE BUILDING OWNER AND TENANT.
- 3. CONTRACTOR TO VERIFY THAT ALL NEW AND EXISTING TO REMAIN DOORS AND DOOR HARDWARE COMPLY WITH REQUIREMENTS OF GOVERNING CODES & STANDARDS. NOTIFY THE ARCHITECT IMMEDIATELY OF ANY NON-COMPLIANCE.

WARE MALCOMB ARCHITECTURE PLANNING BUILDINGS INTERIORS 3015 112th Ave SW, Suite 4002 Burien, WA 98148 P: 206.670.6706


REGISTERED ARCHITECT ADAM SEGALLA STATE OF WASHINGTON

COSTCO WHOLESALE


COSTCO FLEET RESTROOM PUYALLUP WH0660 1201 39TH AVE SW, PUYALLUP, WA. 98373-3803

GENERAL NOTES REMARKS PERMIT ISSUANCE DATE 09/20/2024 PERMIT SET


PAF#: L LUCERO DRAWN BY: A. M. JOB NO.: SE424-0053-00 SHEET 1010

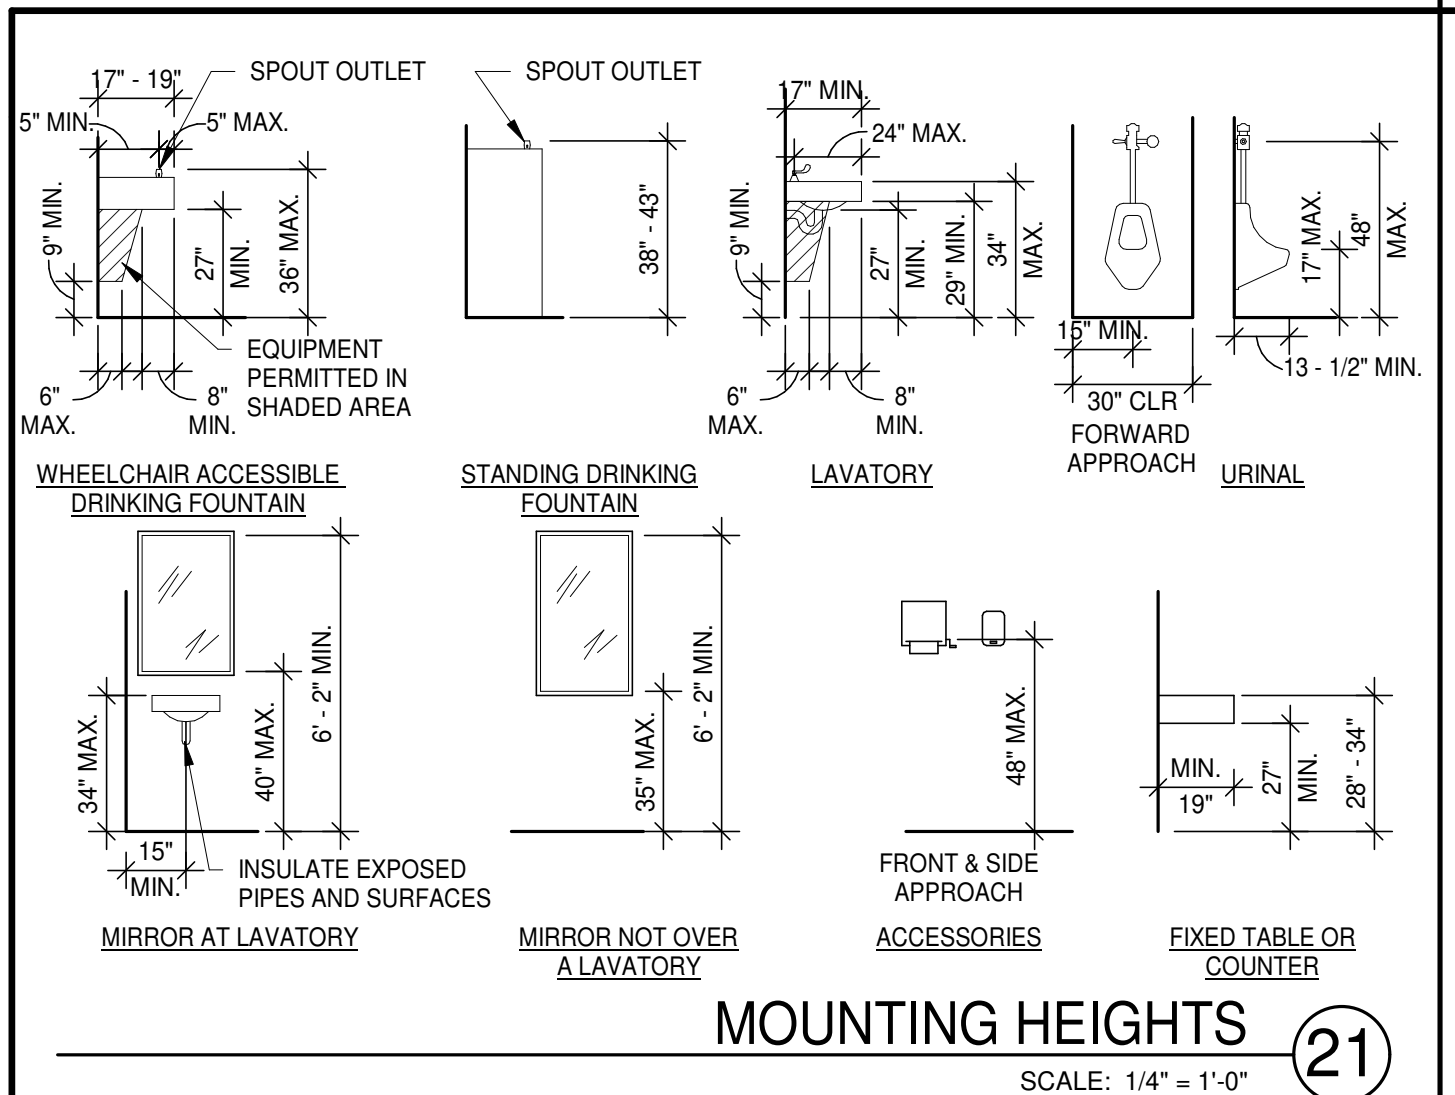


MOUNTING HEIGHTS SCALE: 1/4" = 1'-0" 21

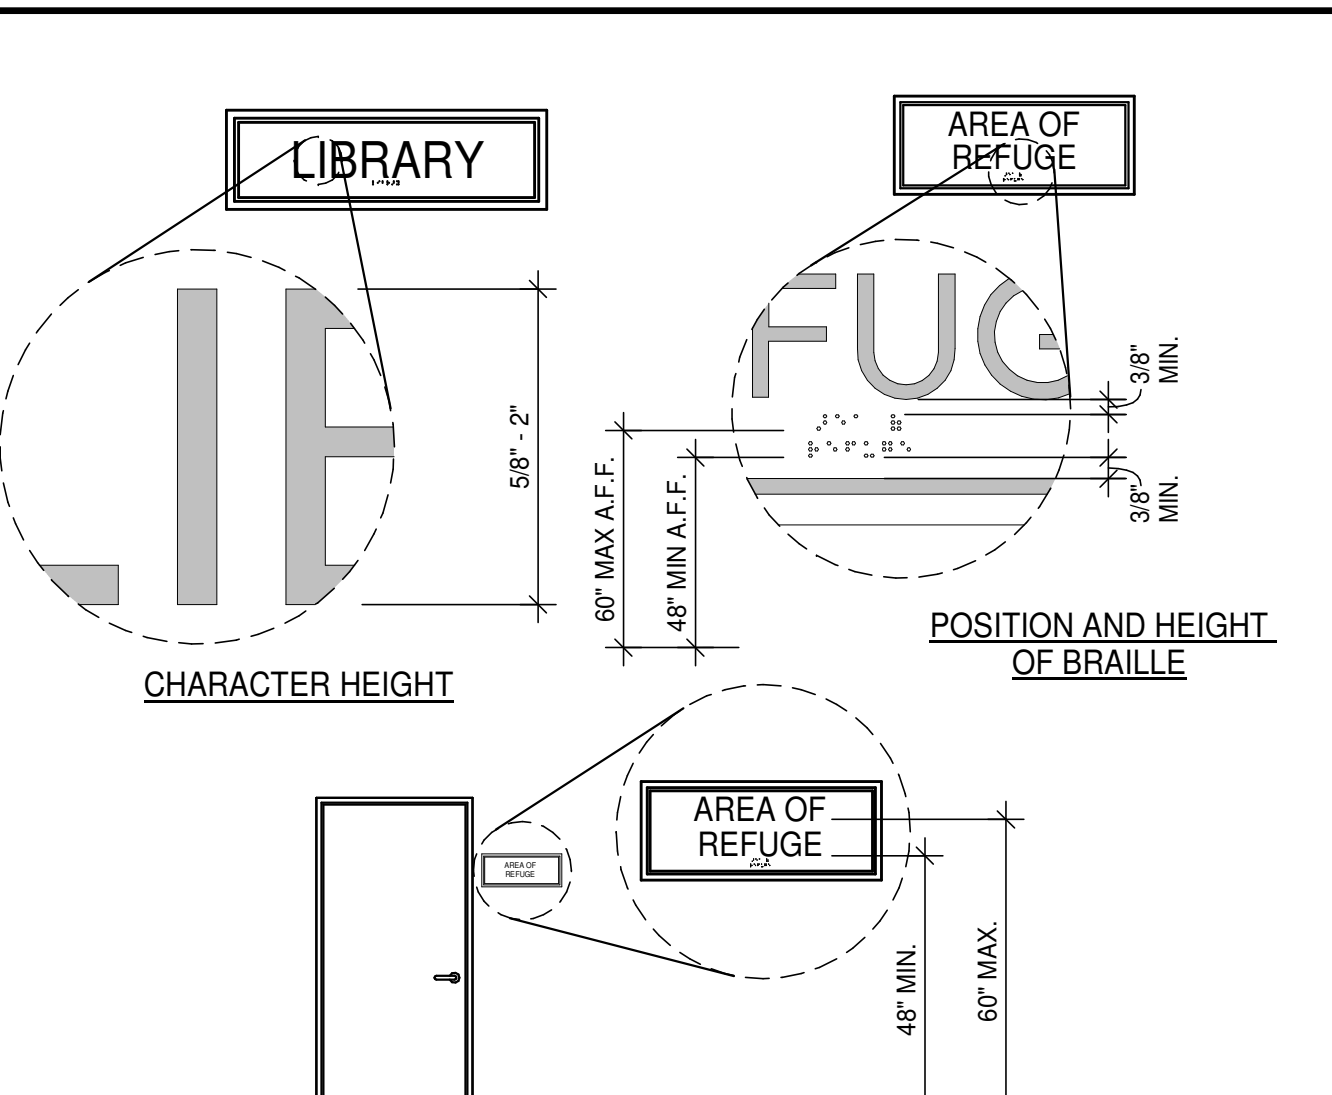


POSITION AND HEIGHT OF BRAILLE SCALE: 1/4" = 1'-0"

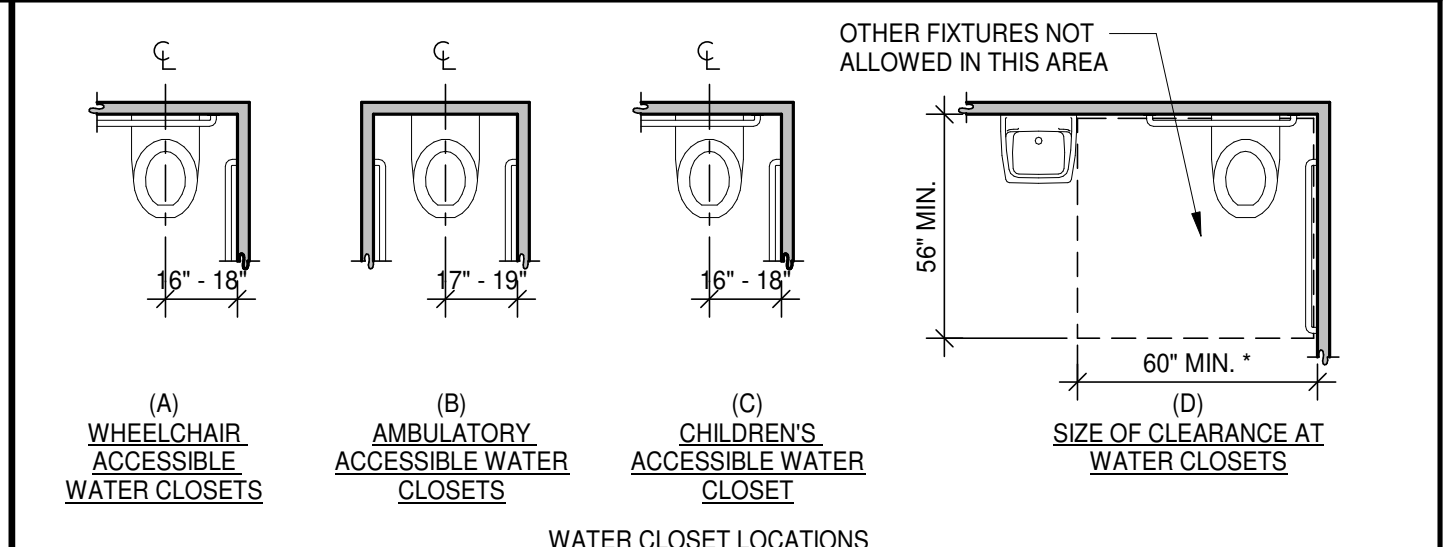


WATER CLOSET LOCATIONS

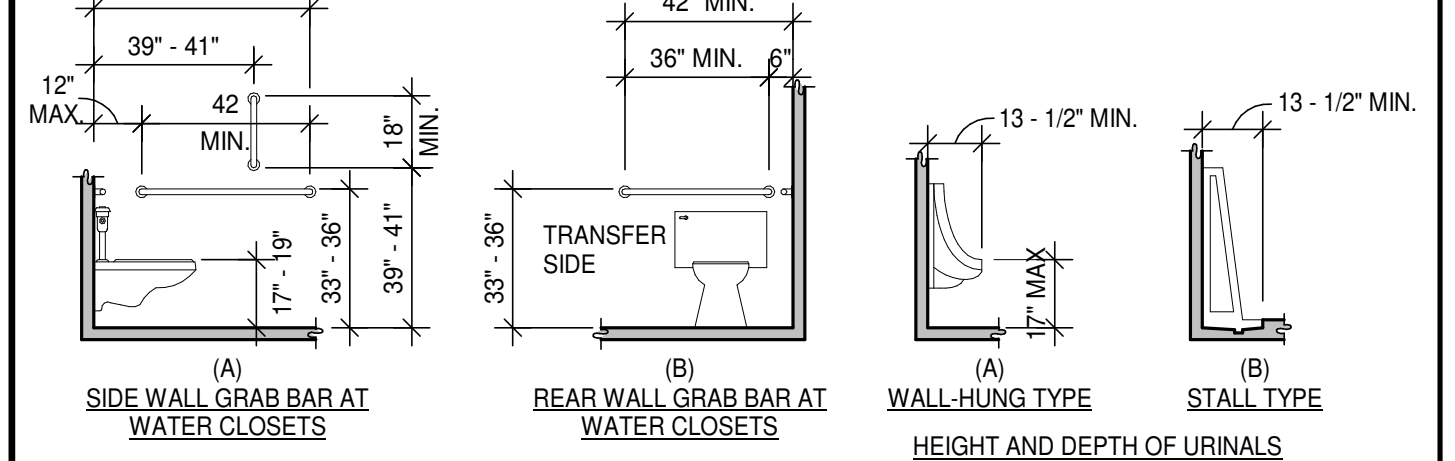


TRANSFER SIDE WALL-HUNG TYPE STALL TYPE

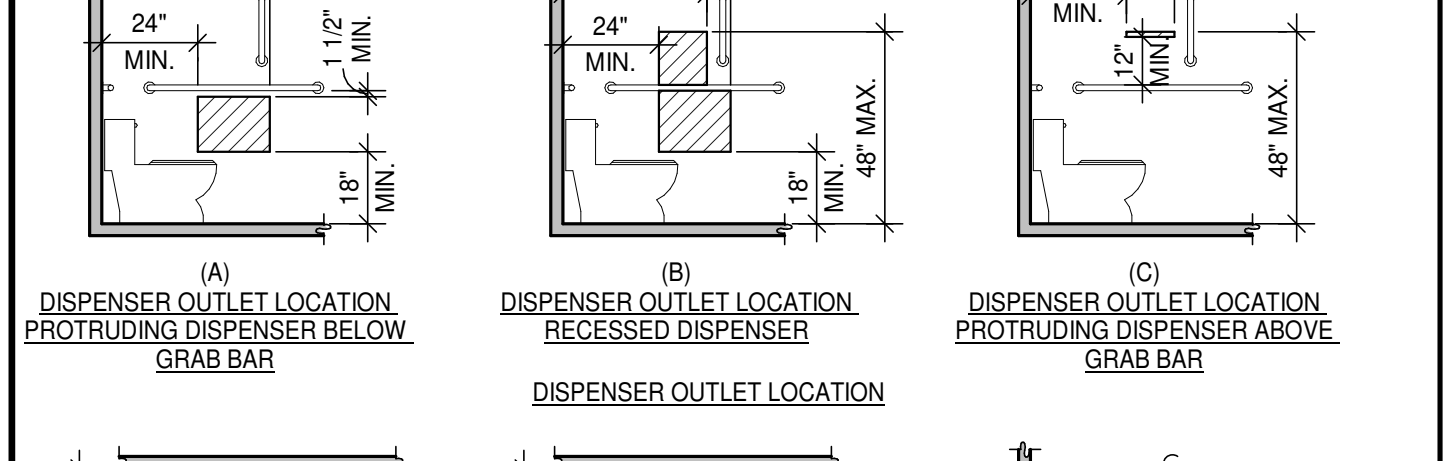


DISPENSER OUTLET LOCATION

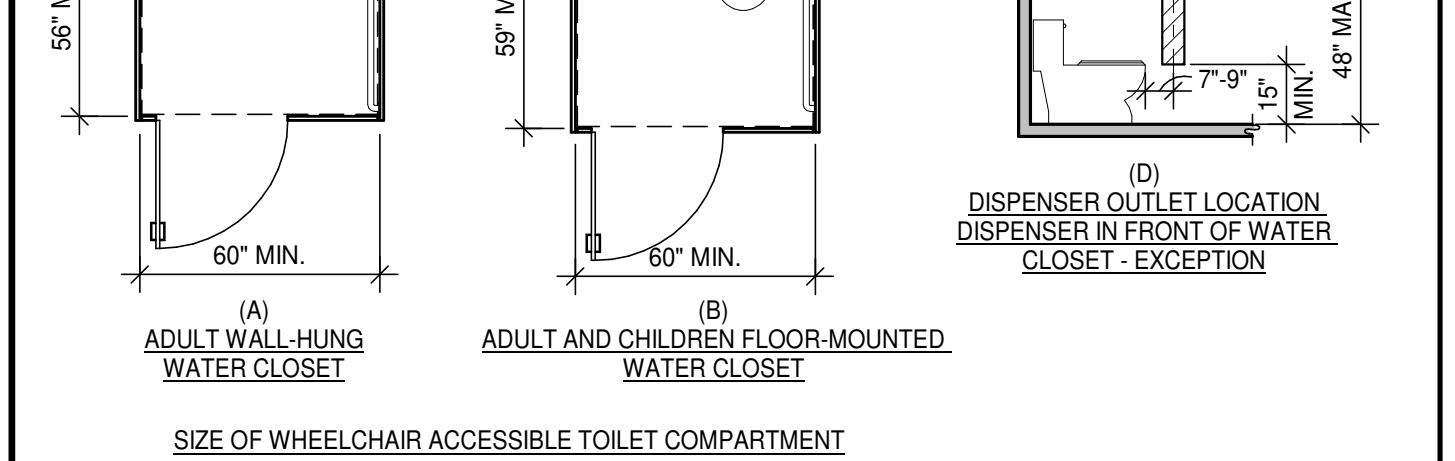


ADULT WALL-HUNG TOILET ADULT AND CHILDREN FLOOR-MOUNTED TOILET

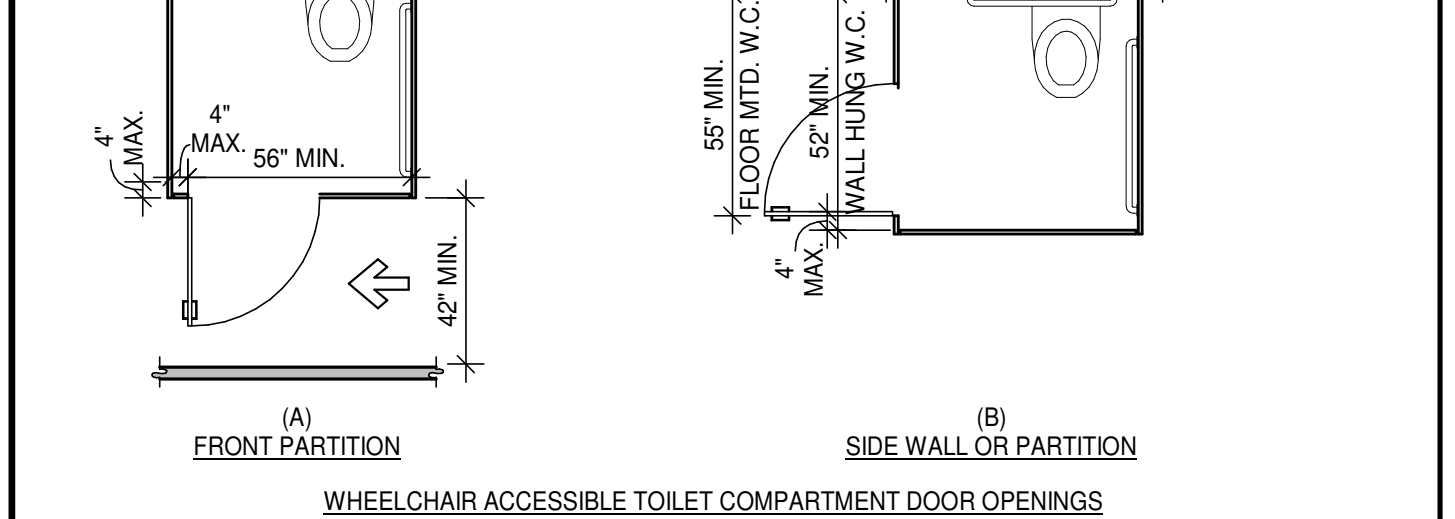

WHEELCHAIR ACCESSIBLE TOILET COMPARTMENT DOOR OPENINGS

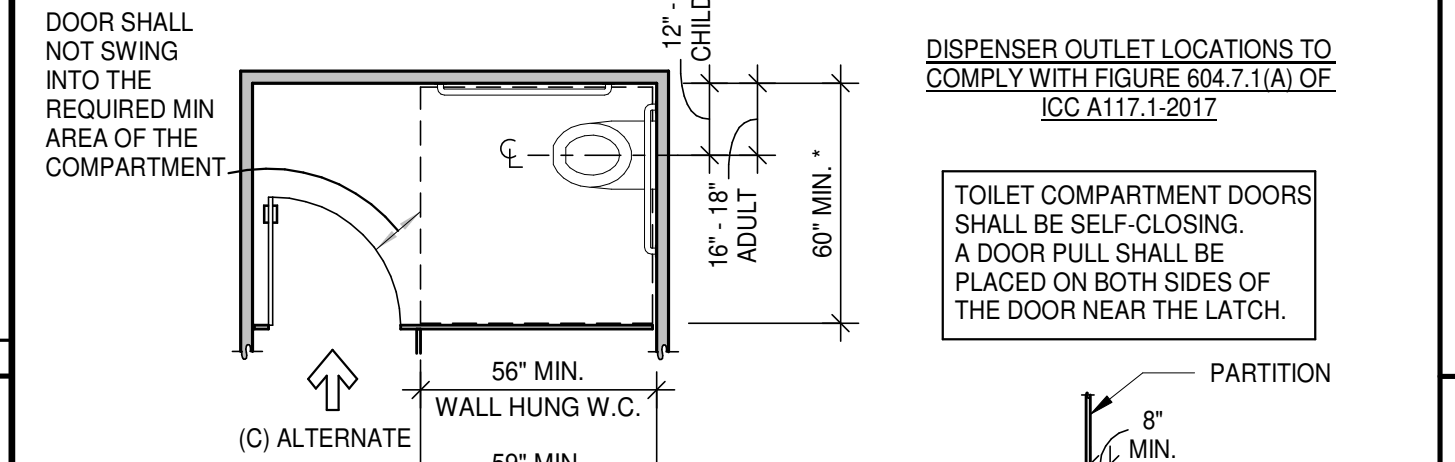


TOILET COMPARTMENT DISPENSER OUTLET LOCATIONS

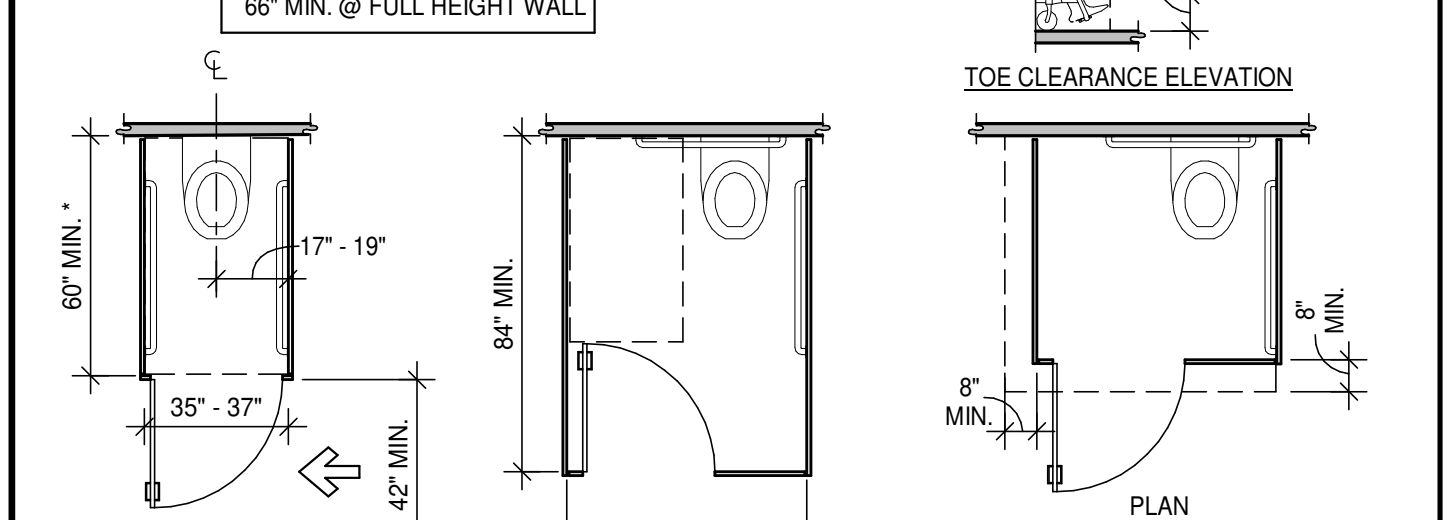


AMBULATORY ACCESSIBLE TOILET COMPARTMENT WHEELCHAIR ACCESSIBLE TOILET COMPARTMENT

WATER CLOSETS AND TOILET COMPARTMENTS & URINALS SCALE: 1/4" = 1'-0" 25

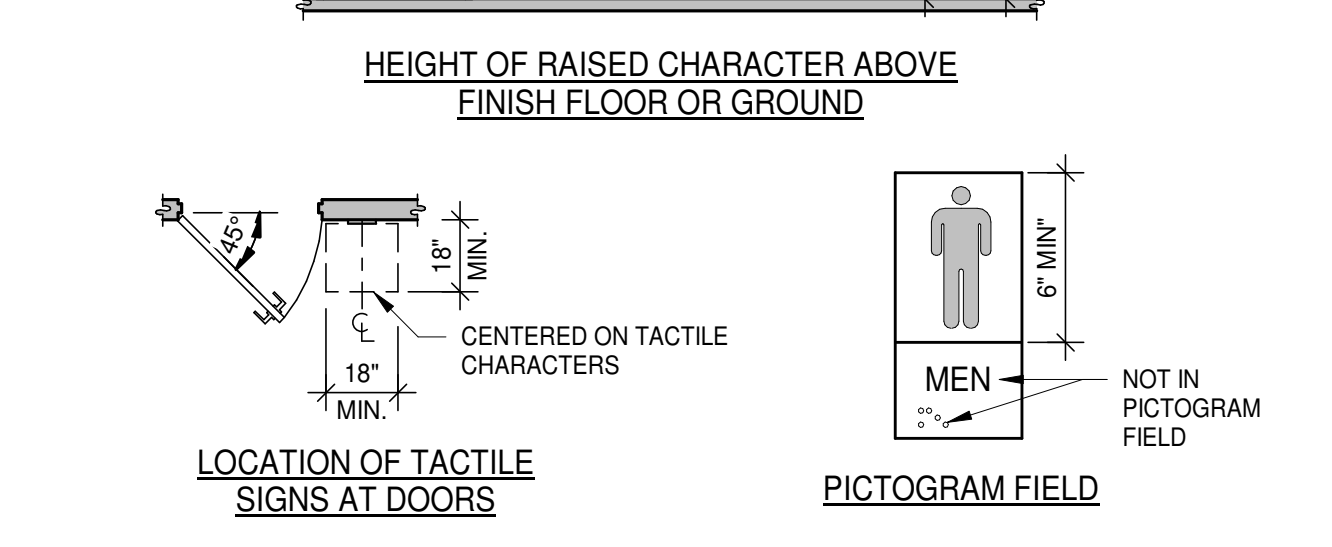


HEIGHT OF RAISED CHARACTER ABOVE FINISH FLOOR OR GROUND

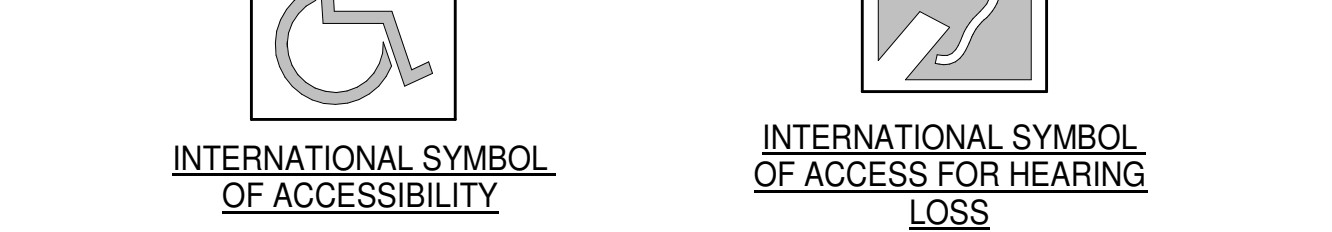


INTERNATIONAL SYMBOL OF ACCESSIBILITY INTERNATIONAL SYMBOL OF ACCESS FOR HEARING LOSS


SIGNS N.T.S. 17

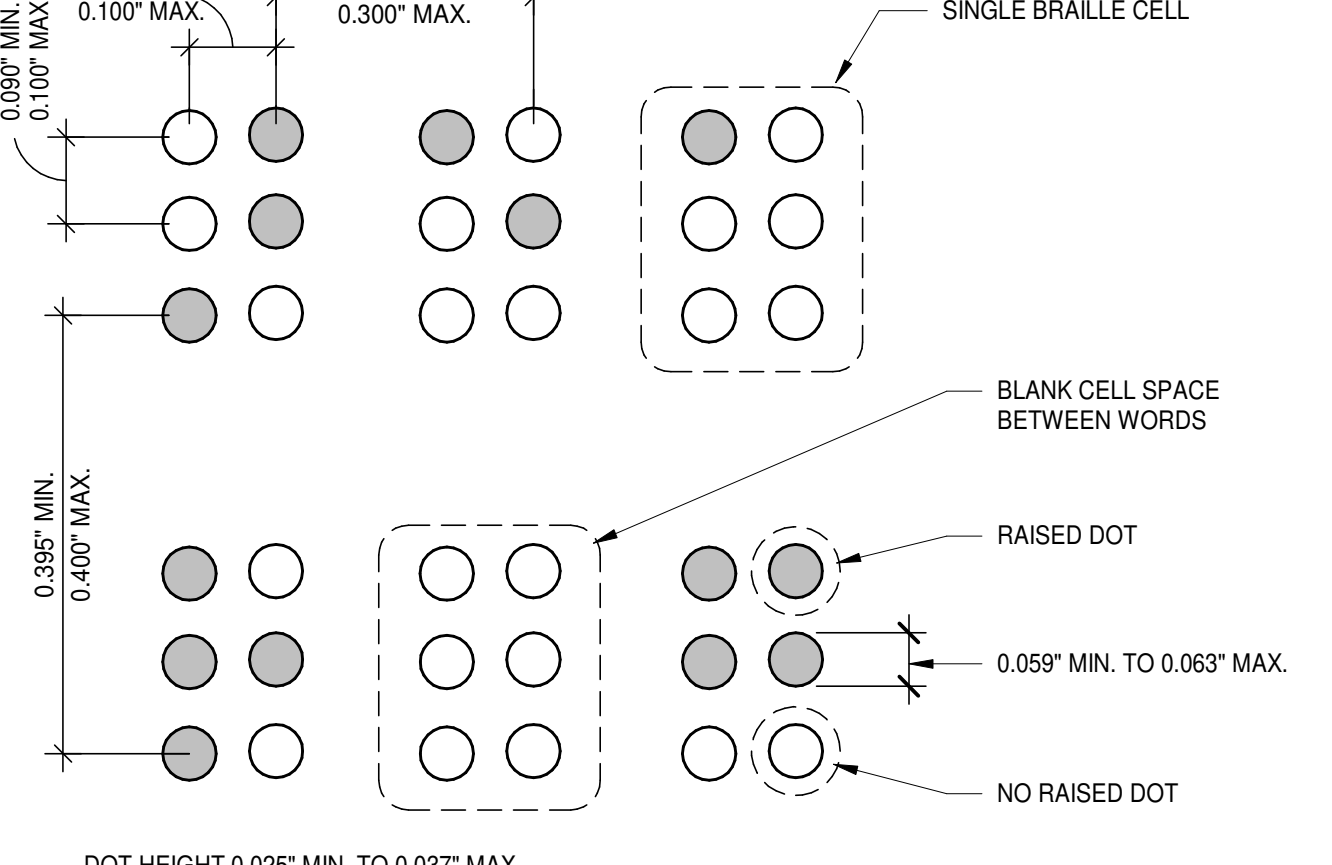


BRaille MEASUREMENT N.T.S. 18

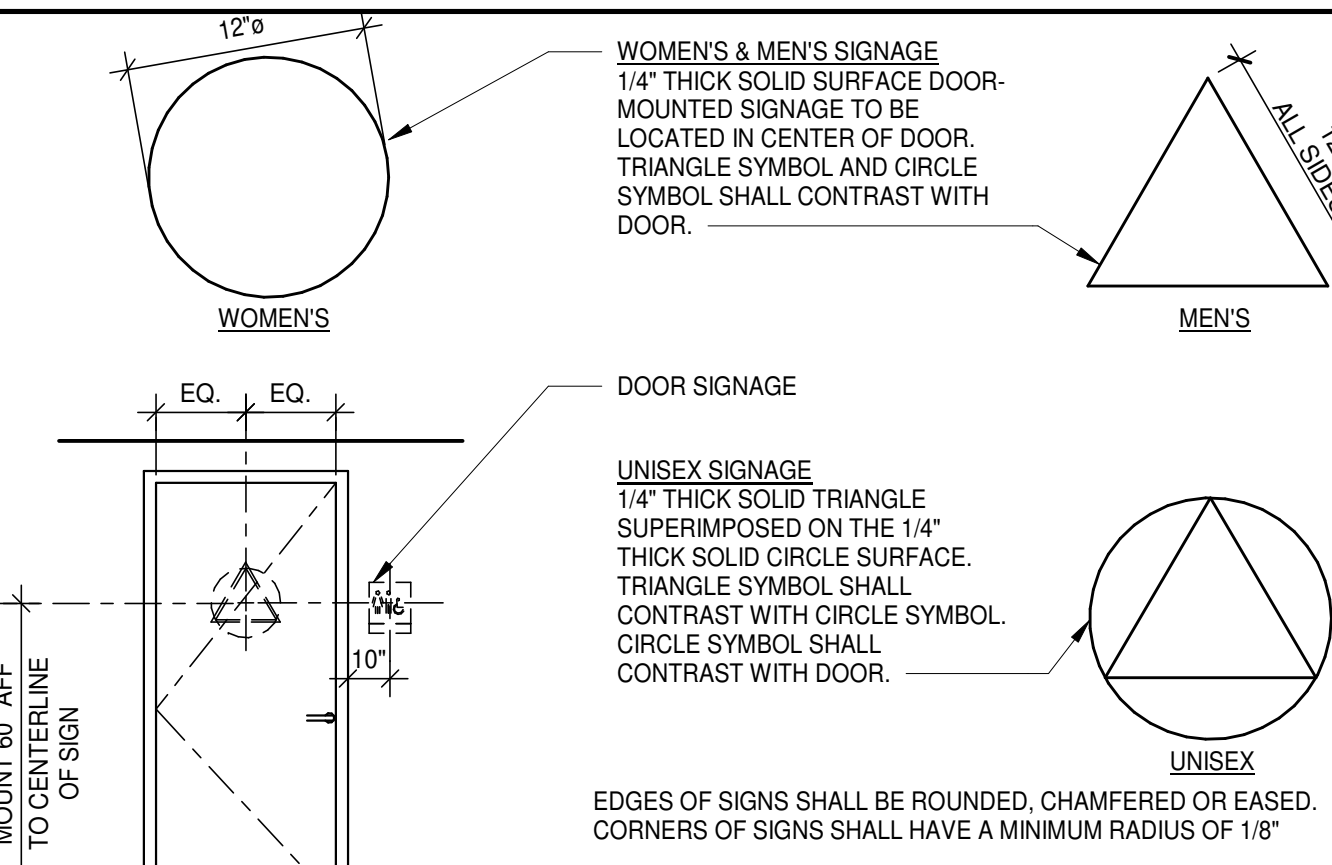

GEOMETRIC SYMBOLS (DOOR MOUNTED) SCALE: 1/2" = 1'-0" 19

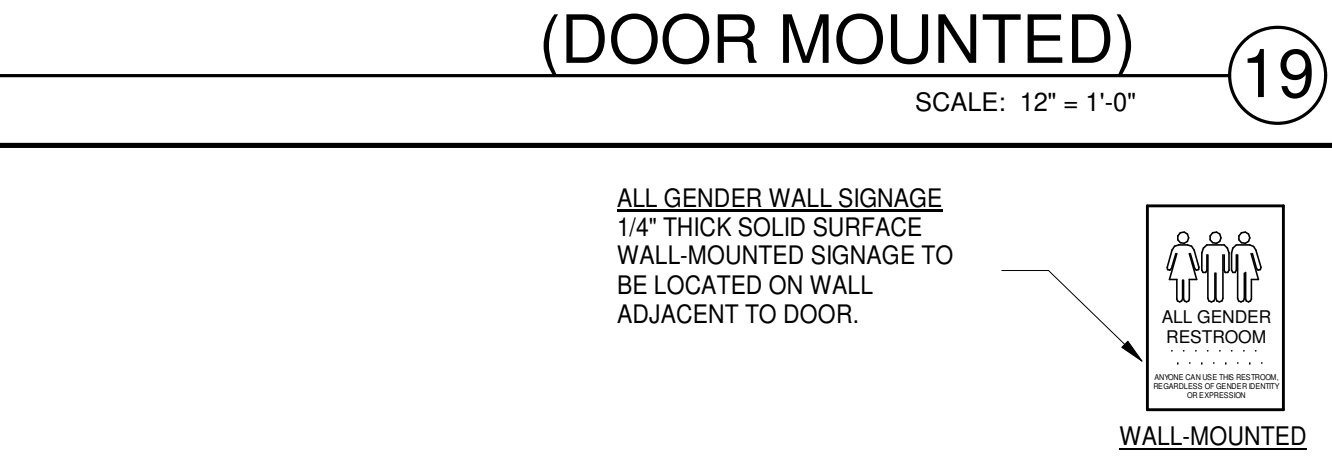


ALL GENDERS SIGNAGE SCALE: 1/2" = 1'-0" 20

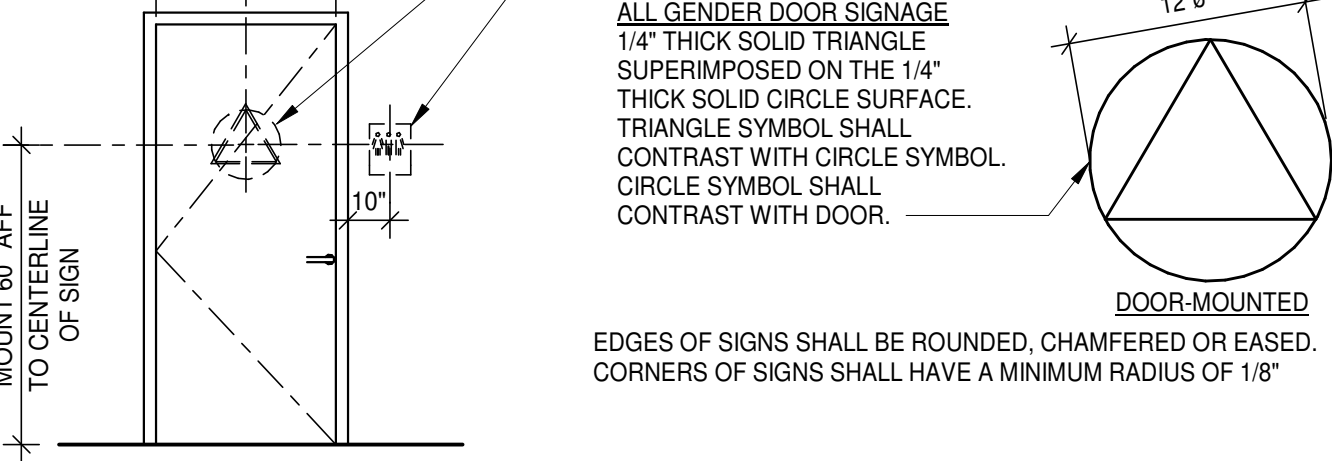


DOORS, DOORWAYS & GATES SCALE: 1/4" = 1'-0" 15


NOTES: 1. FLOOR OR GROUND SURFACE WITHIN REQUIRED MANEUVERING CLEARANCES AND LANDINGS ON BOTH SIDES OF DOORS SHALL COMPLY WITH FLOOR OR GROUND SURFACES & CHANGES IN LEVEL DETAIL AND SHALL HAVE A SLOPE NOT STEEPER THAN 1:48 IN ANY DIRECTION. VERTICAL CHANGES IN LEVEL ARE NOT PERMITTED...

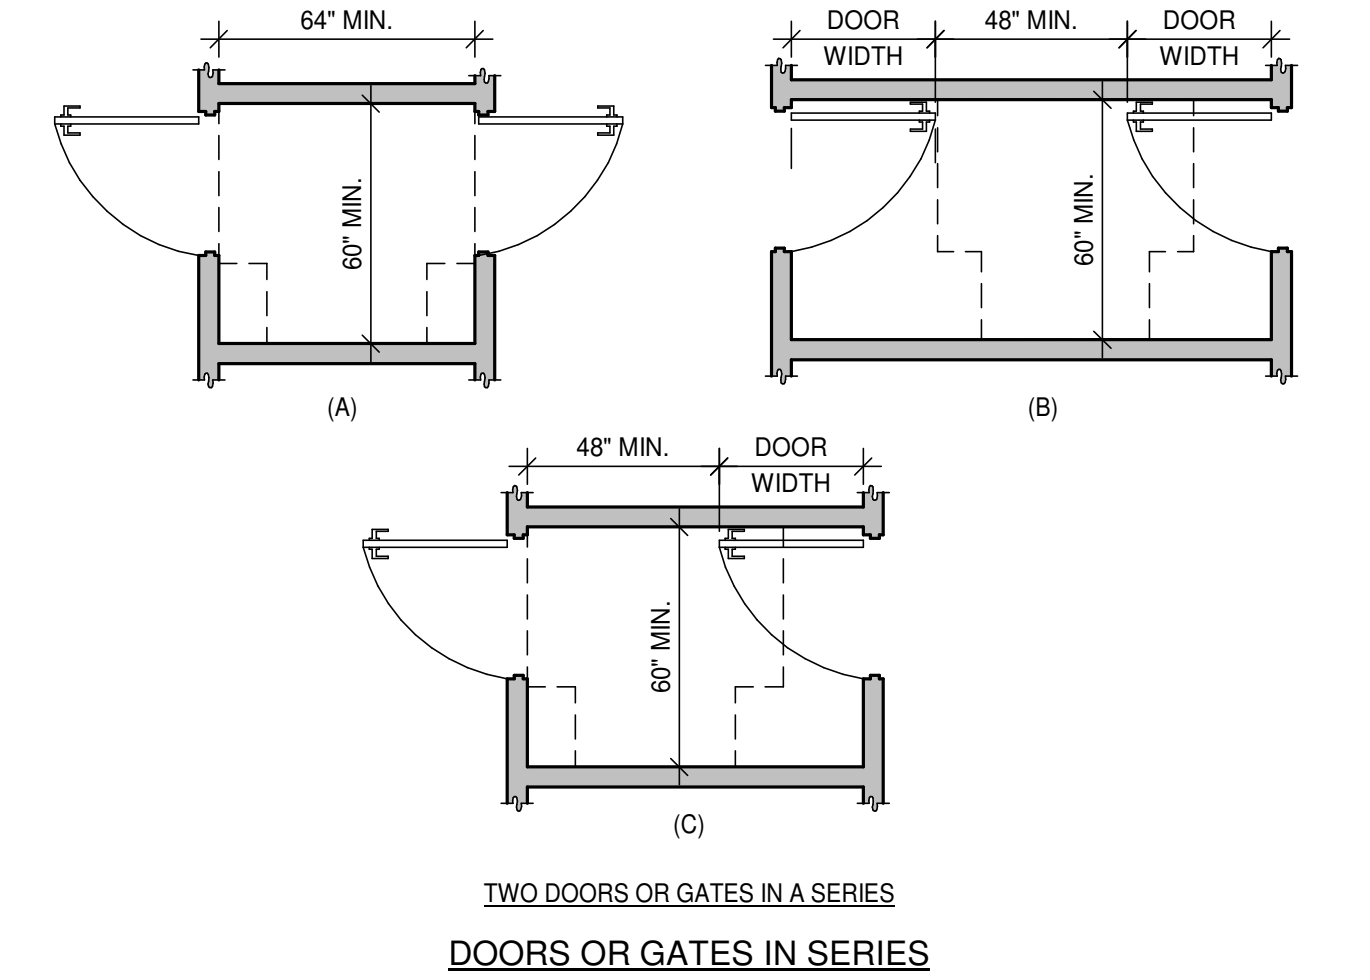


DOORS OR GATES IN SERIES DOORS OR GATES IN SERIES

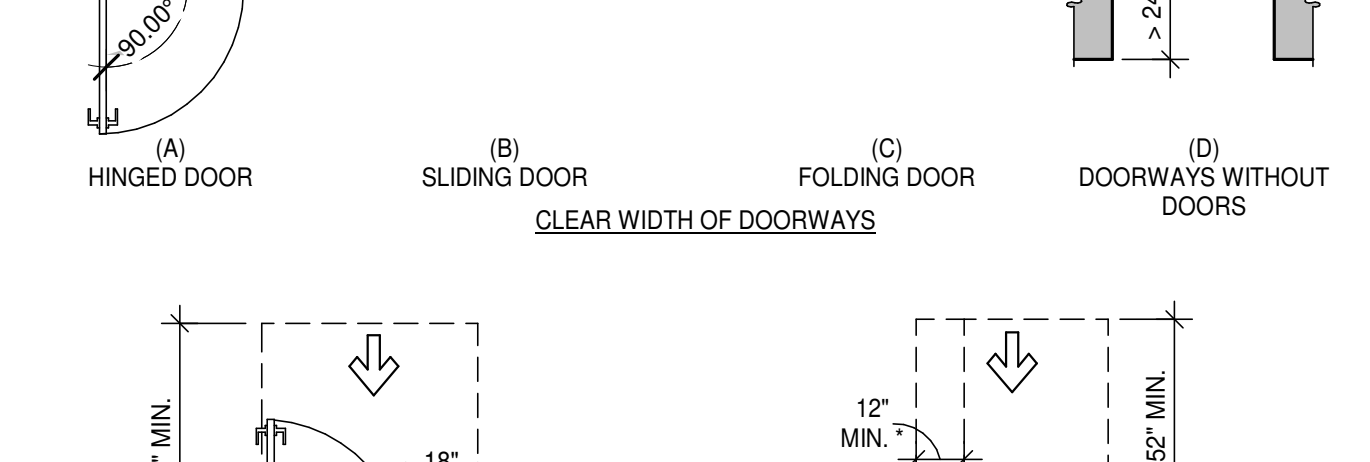


HINGE APPROACH, PULL SIDE HINGE APPROACH, PUSH SIDE

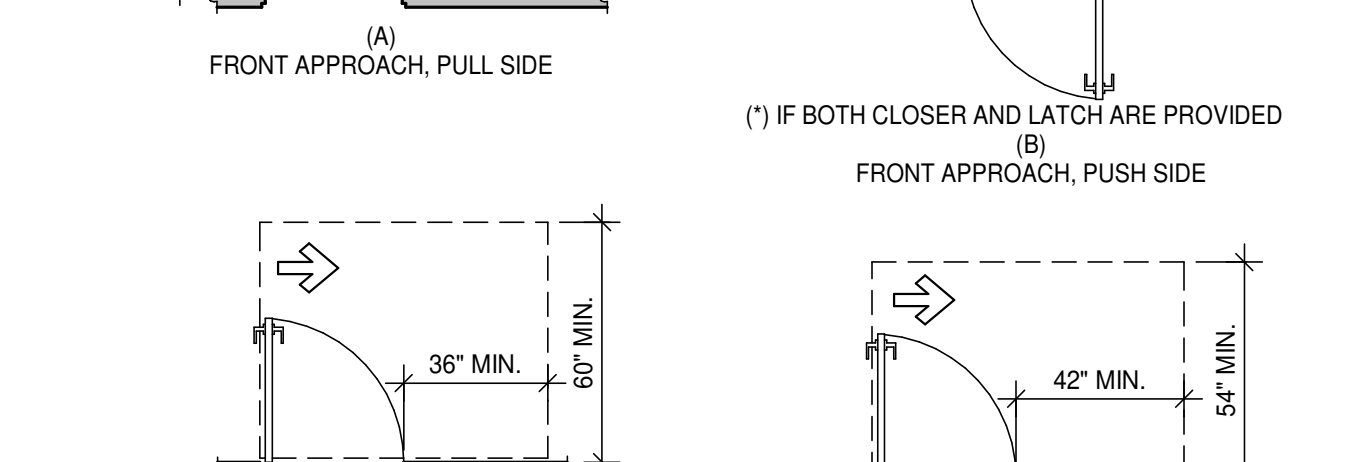


LATCH APPROACH, PULL SIDE LATCH APPROACH, PUSH SIDE

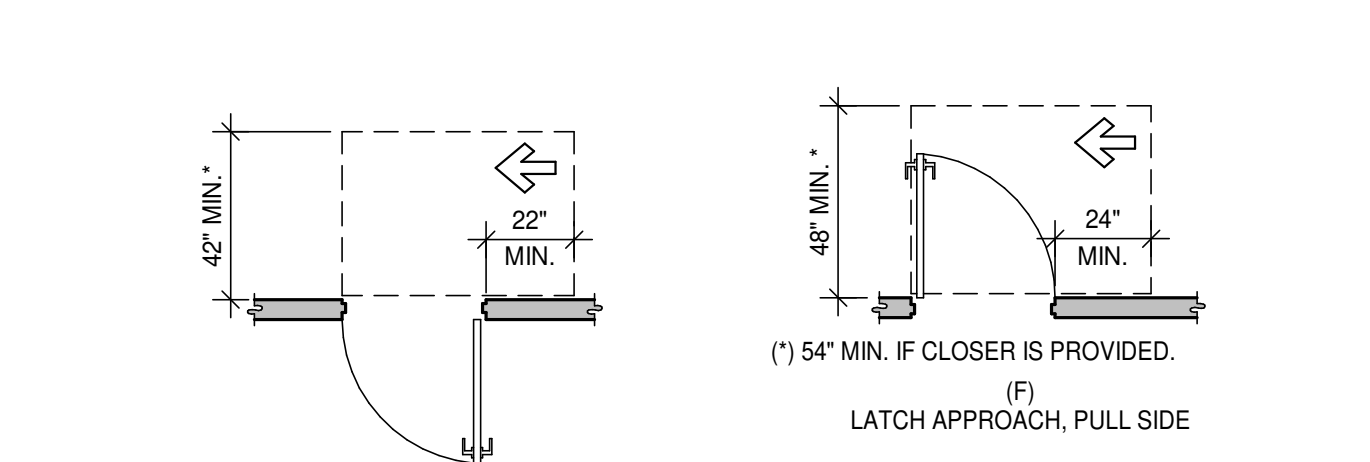

MANEUVERING CLEARANCE AT RECESSED DOORS AND GATES

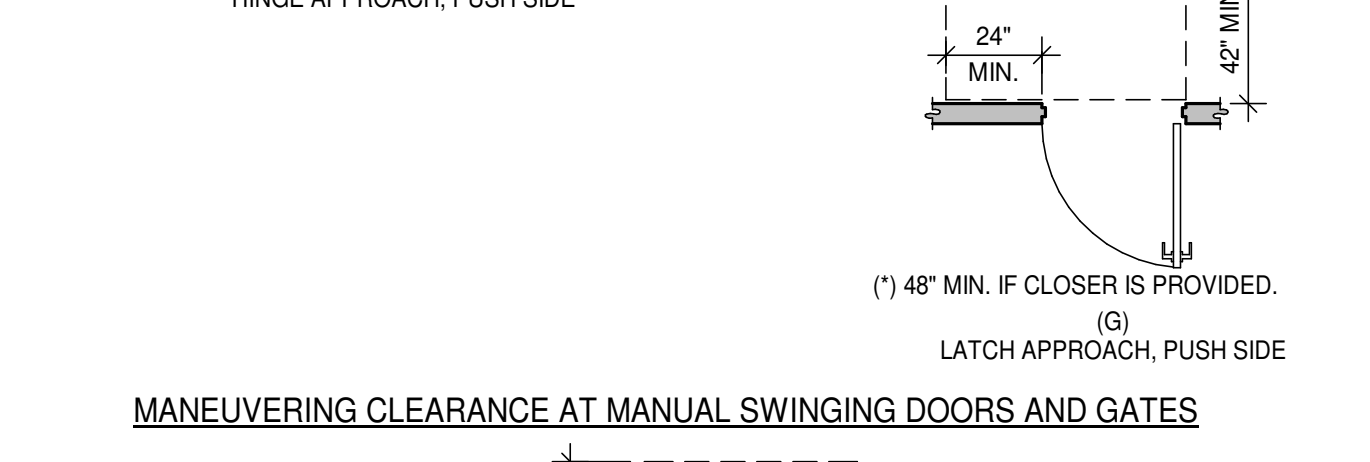


KNEE AND TOE CLEARANCE SCALE: 1/4" = 1'-0" 9

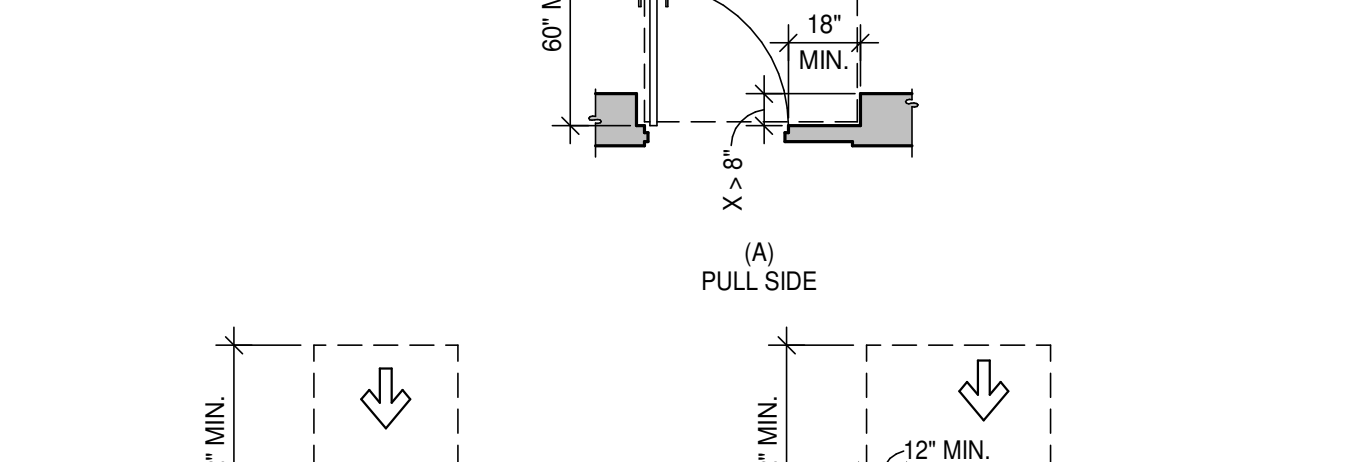


SPACING OF GRAB BARS




GRAB BAR NON-CIRCULAR CROSS SECTION GRAB BARS N.T.S. 10

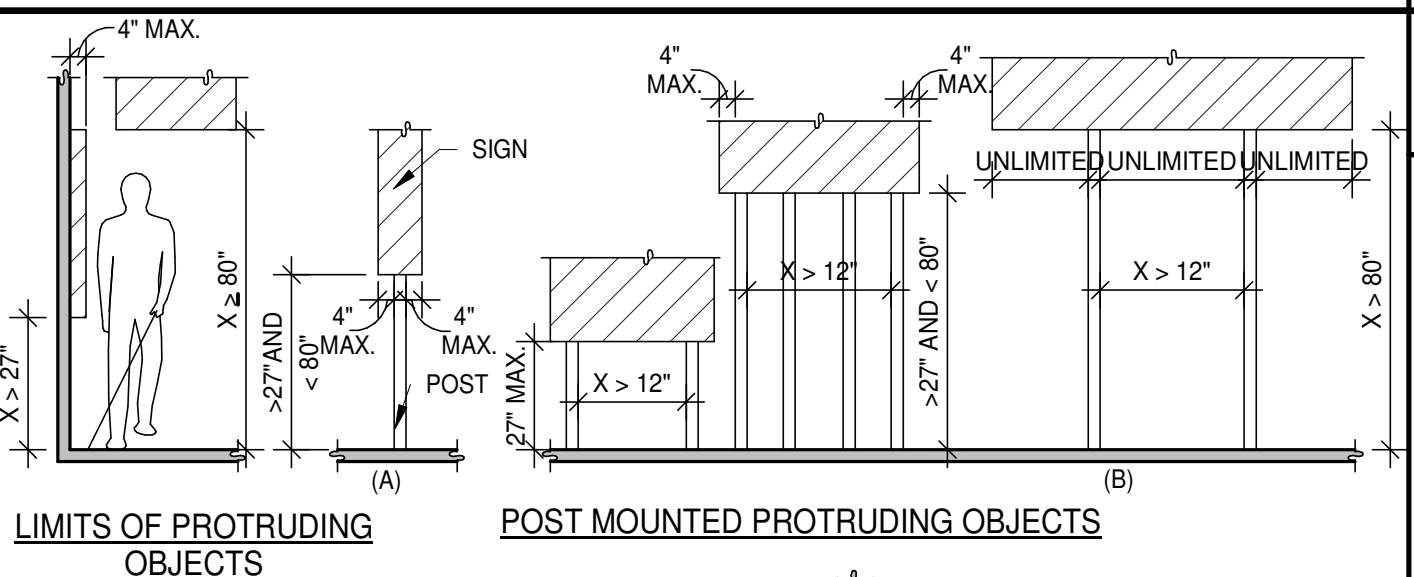

LIMITS OF PROTRUDING OBJECTS POST MOUNTED PROTRUDING OBJECTS

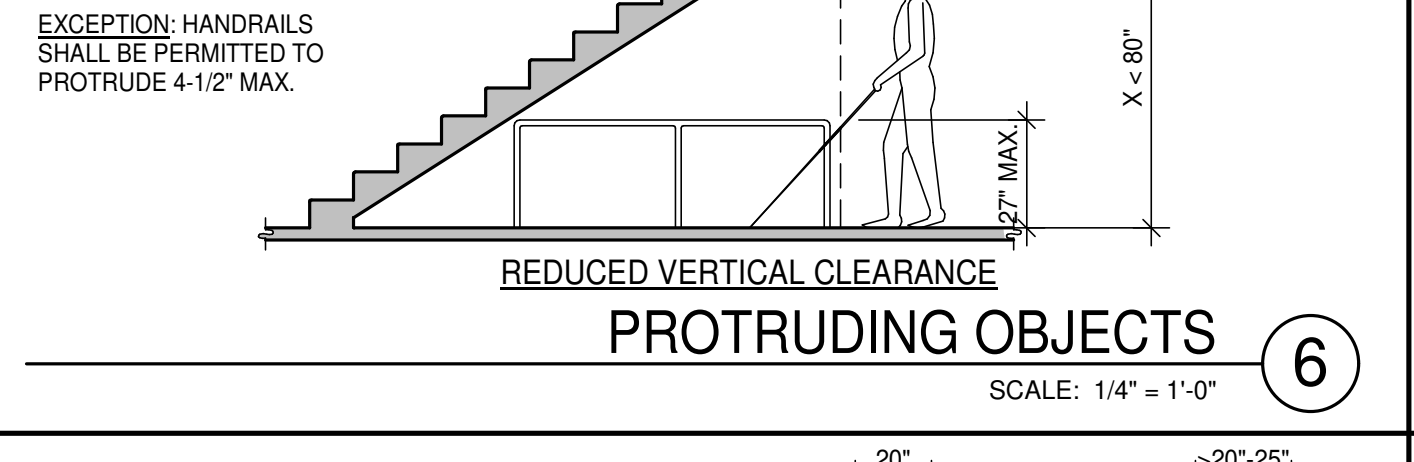


REDUCED VERTICAL CLEARANCE PROTRUDING OBJECTS SCALE: 1/4" = 1'-0" 6

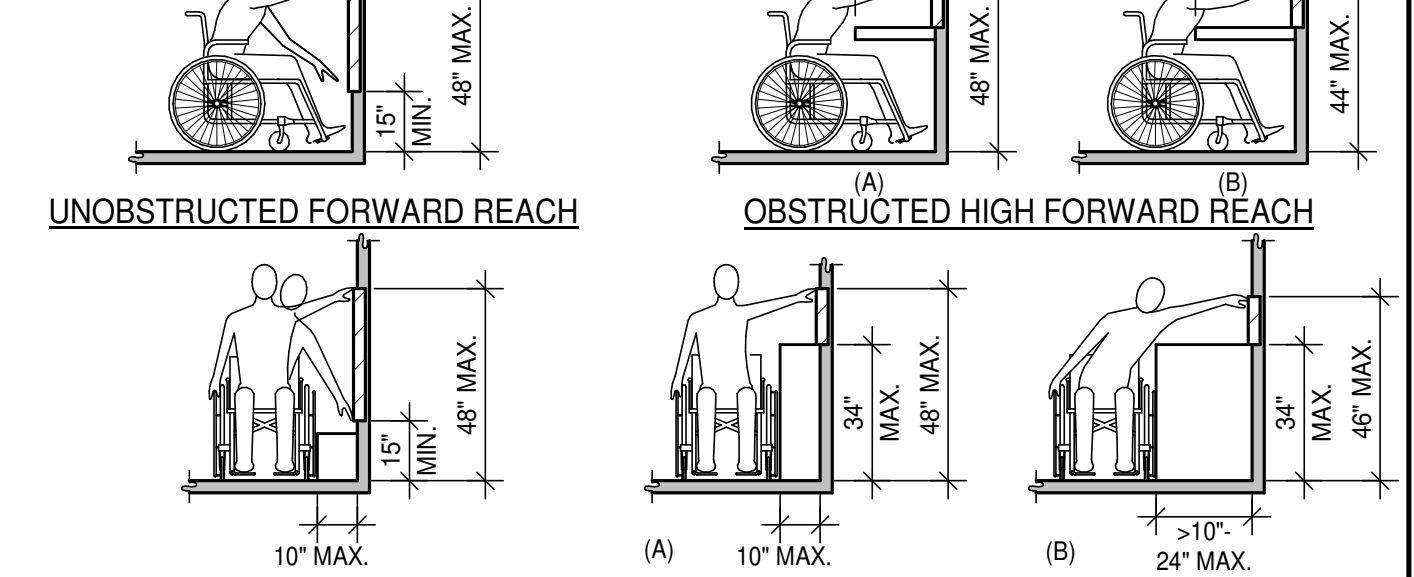


UNOBSTRUCTED FORWARD REACH OBSTRUCTED HIGH FORWARD REACH UNOBSTRUCTED HIGH SIDE REACH OBSTRUCTED HIGH SIDE REACH

Table with 2 columns: Reaches (Maximum Reach Depth, Maximum Reach Height) and Reach Ranges (0.5", 2", 5", 6", 9, 11").


REACH RANGES SCALE: 1/4" = 1'-0" 7

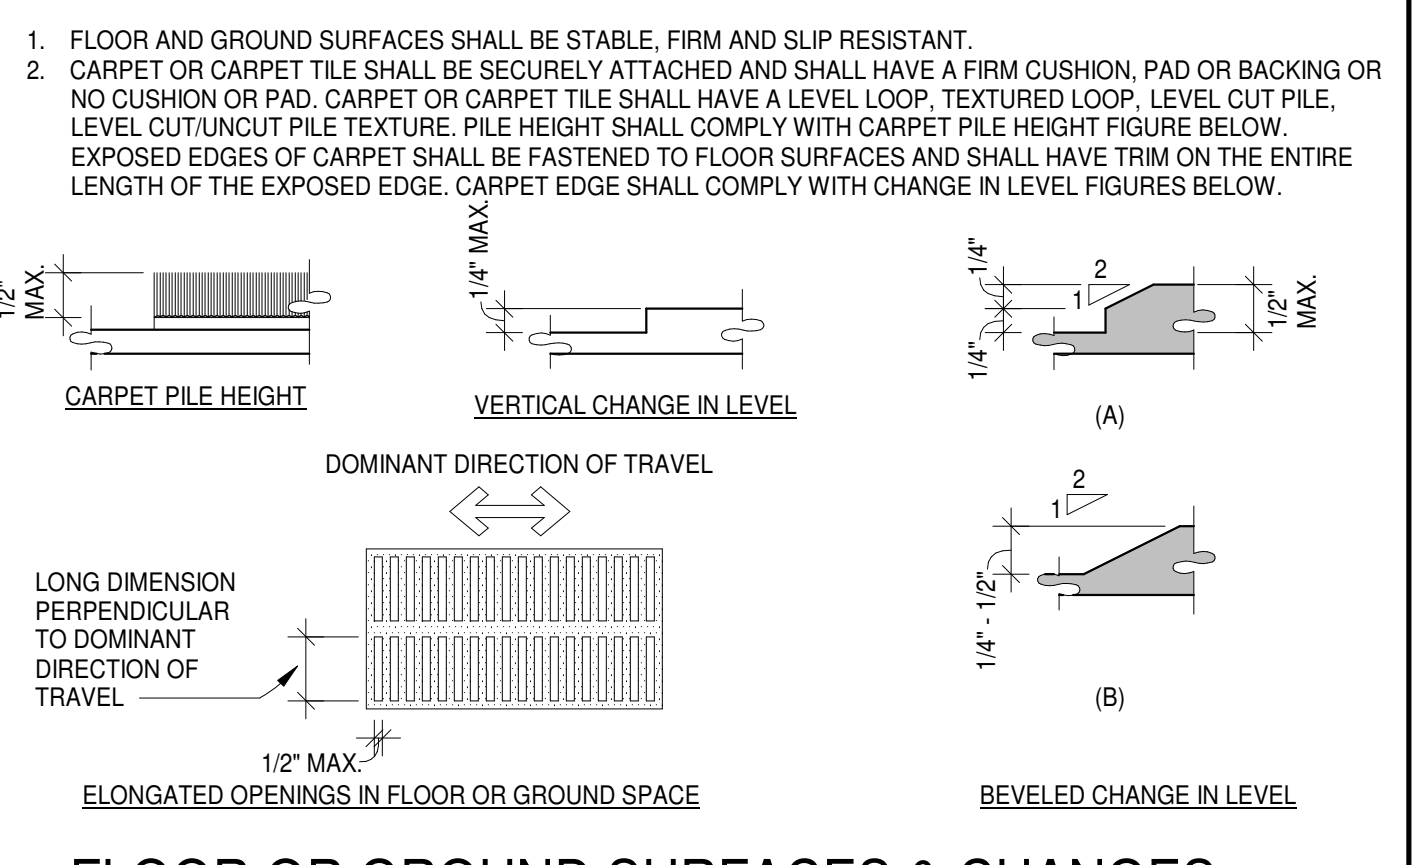


FLOOR OR GROUND SURFACES & CHANGES IN LEVEL SCALE: 1/2" = 1'-0" 8

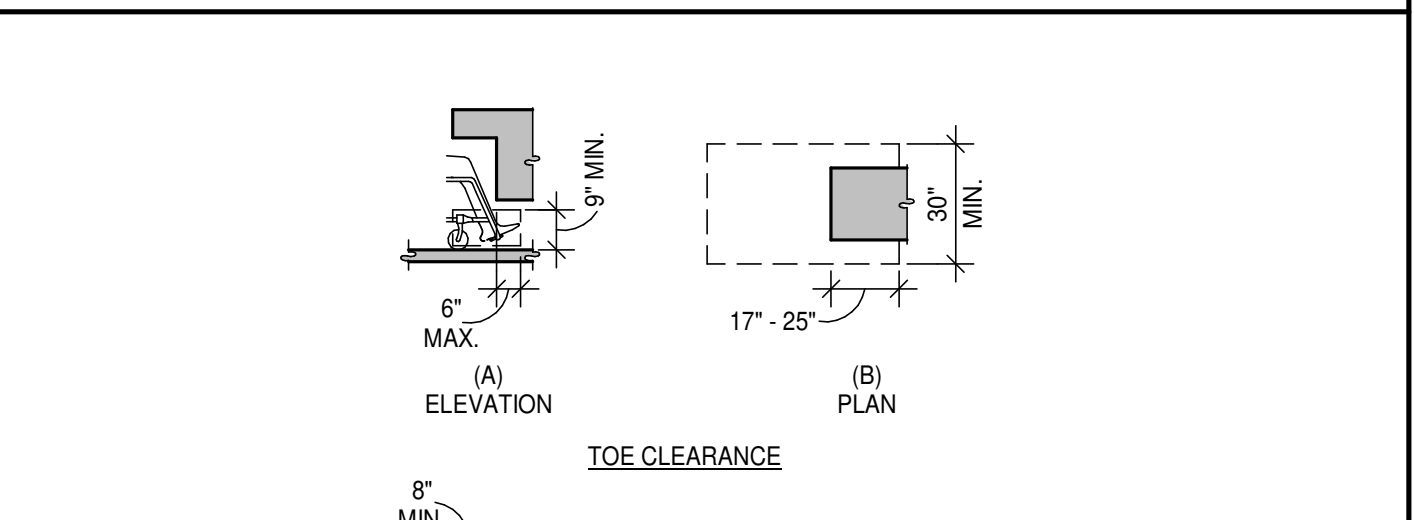

KNEE AND TOE CLEARANCE SCALE: 1/4" = 1'-0" 9

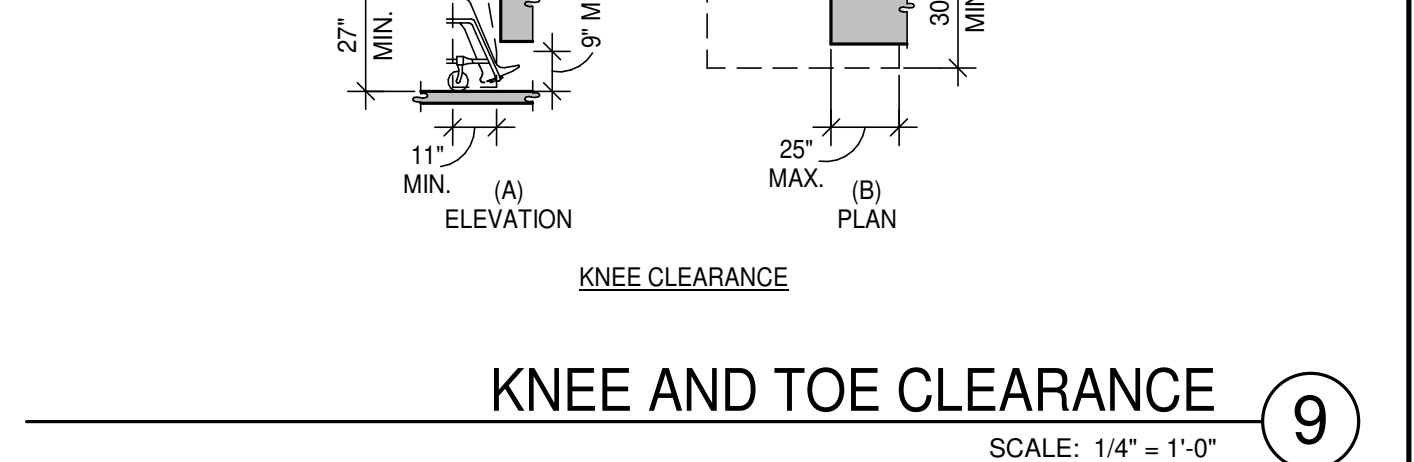

SPACING OF GRAB BARS

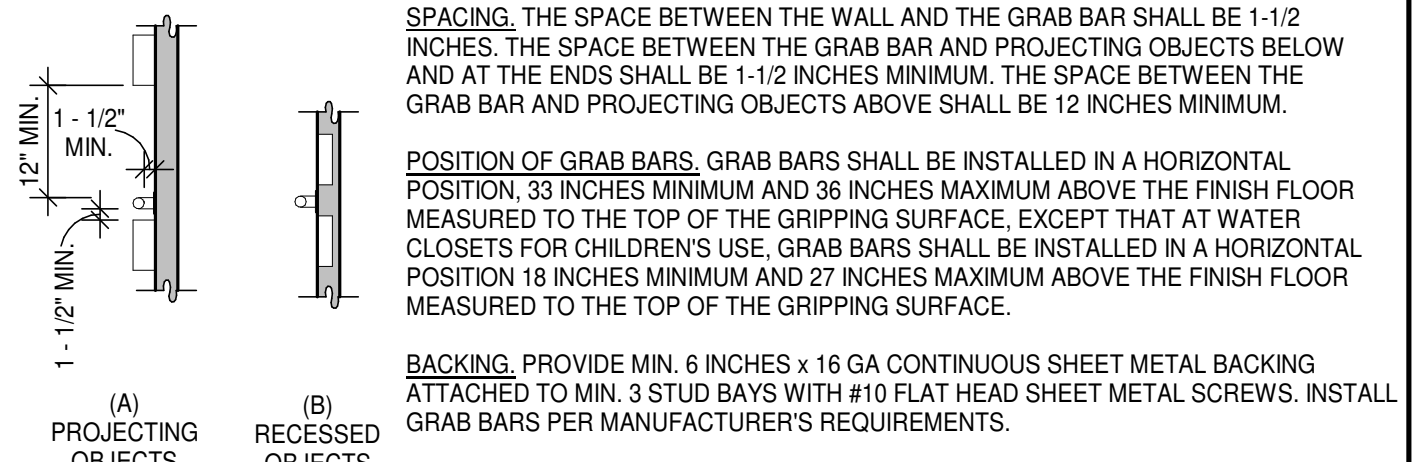


GRAB BAR NON-CIRCULAR CROSS SECTION GRAB BARS N.T.S. 10


ACCESSIBILITY NOTES

- 1. THE ACCESSIBILITY GUIDELINES AND CODES MENTIONED BELOW REFER TO ALL APPLICABLE LOCAL/STATE BUILDING CODES REFERENCED ON THE PROJECT DATA SHEET OF THIS SET IN ADDITION TO THE FEDERAL REQUIREMENTS OF THE ADA (THE AMERICANS WITH DISABILITIES ACT)...


City of Puyallup Development & Permitting Services ISSUED PERMIT Building Planning Engineering Public Works Fire Traffic

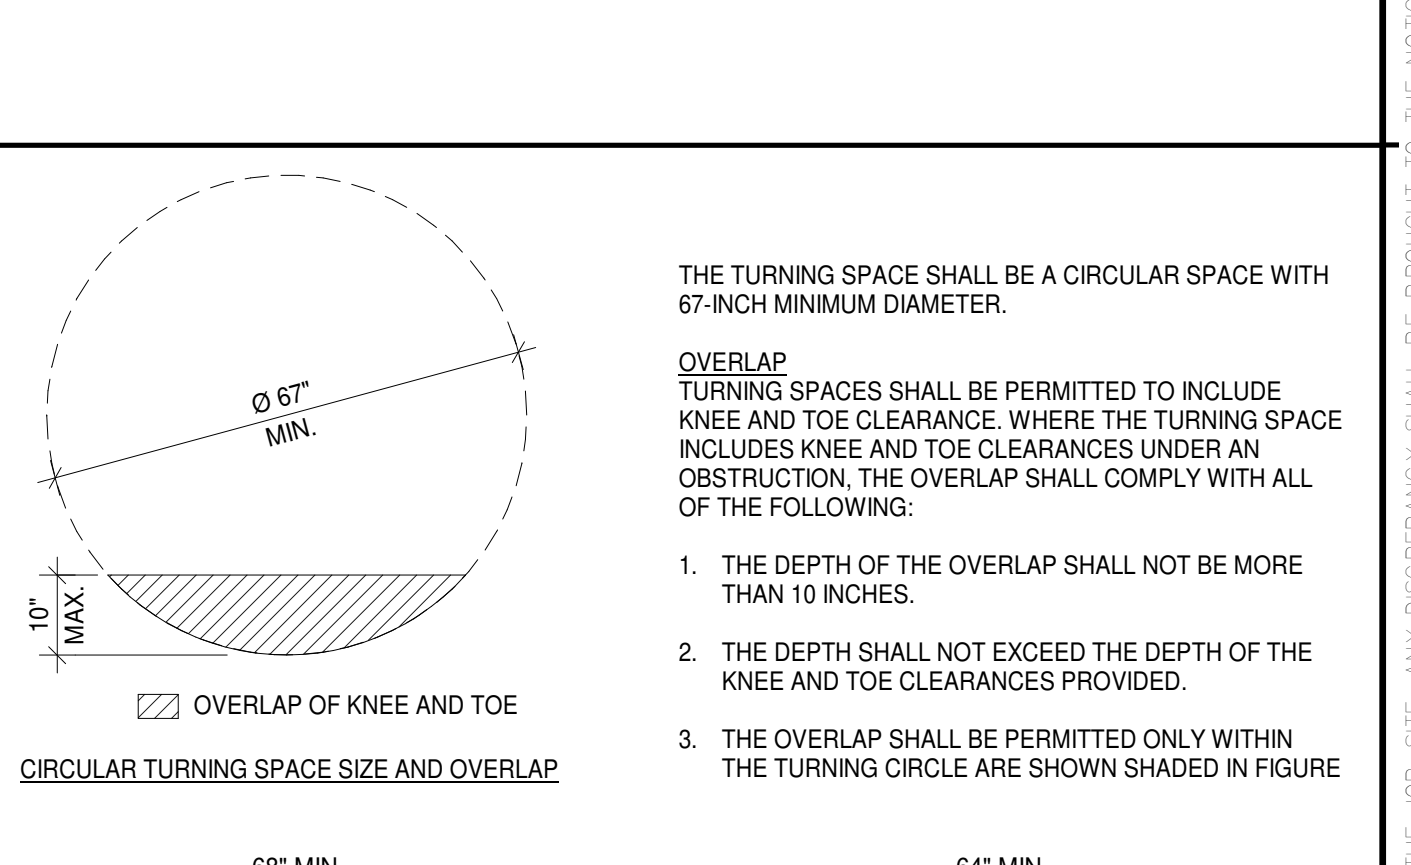


CIRCULAR TURNING SPACE SIZE AND OVERLAP

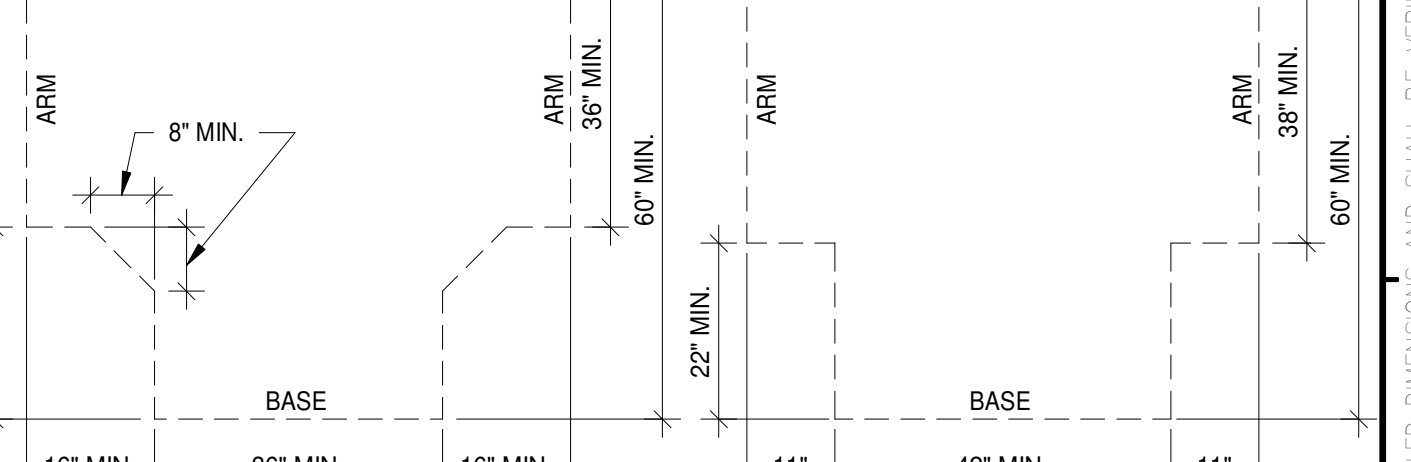


T-SHAPED TURNING SPACE - (OPTION 1) T-SHAPED TURNING SPACE - (OPTION 2) T-SHAPED TURNING SPACE - (OPTION 3)

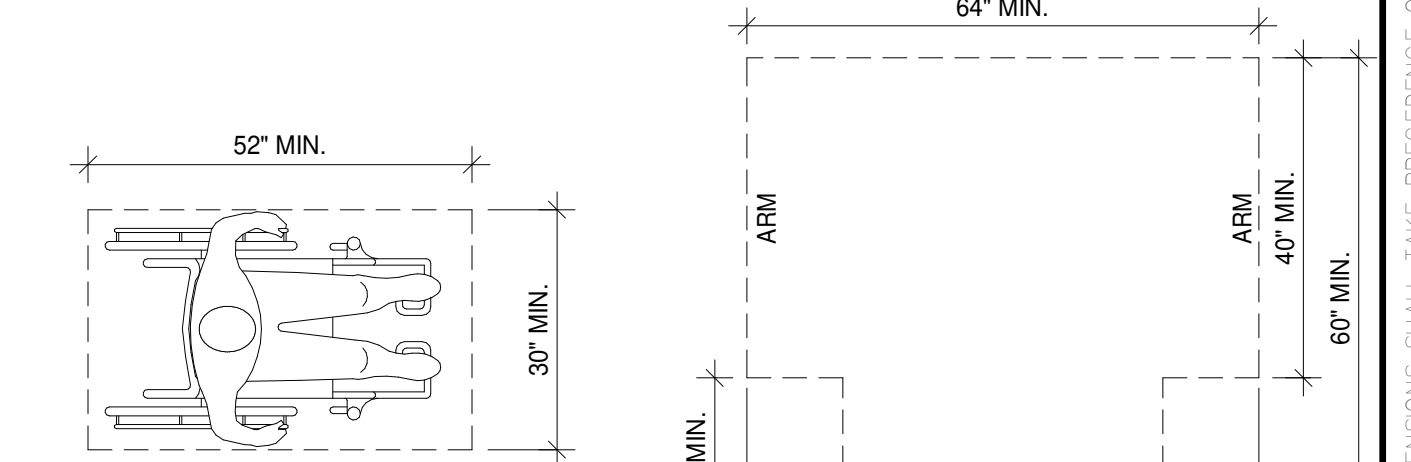


SIZE OF CLEAR FLOOR SPACE

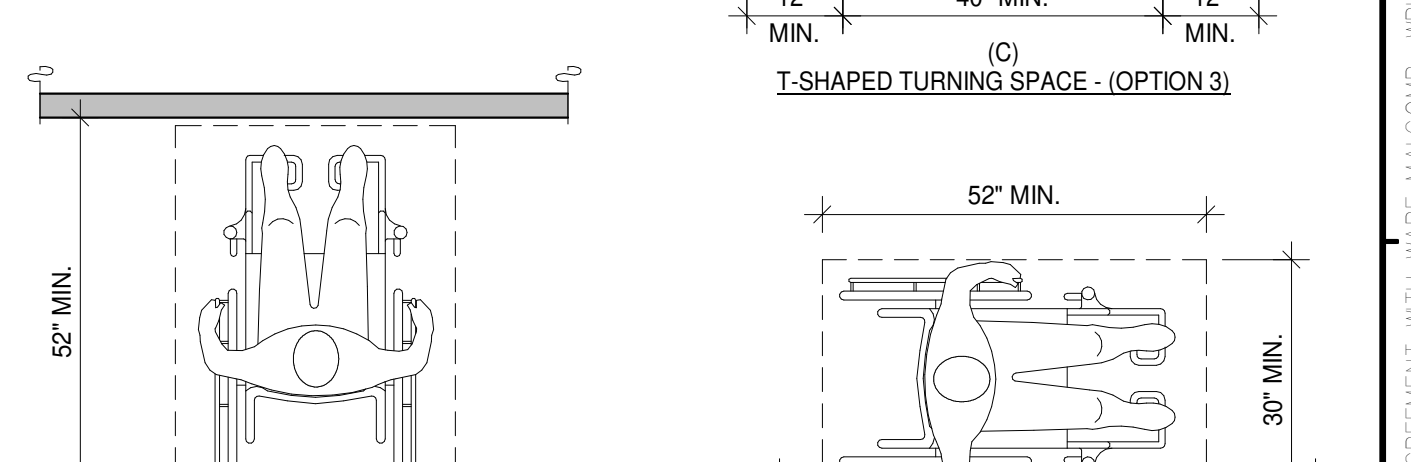

MANEUVERING CLEARANCE IN ALCOVE

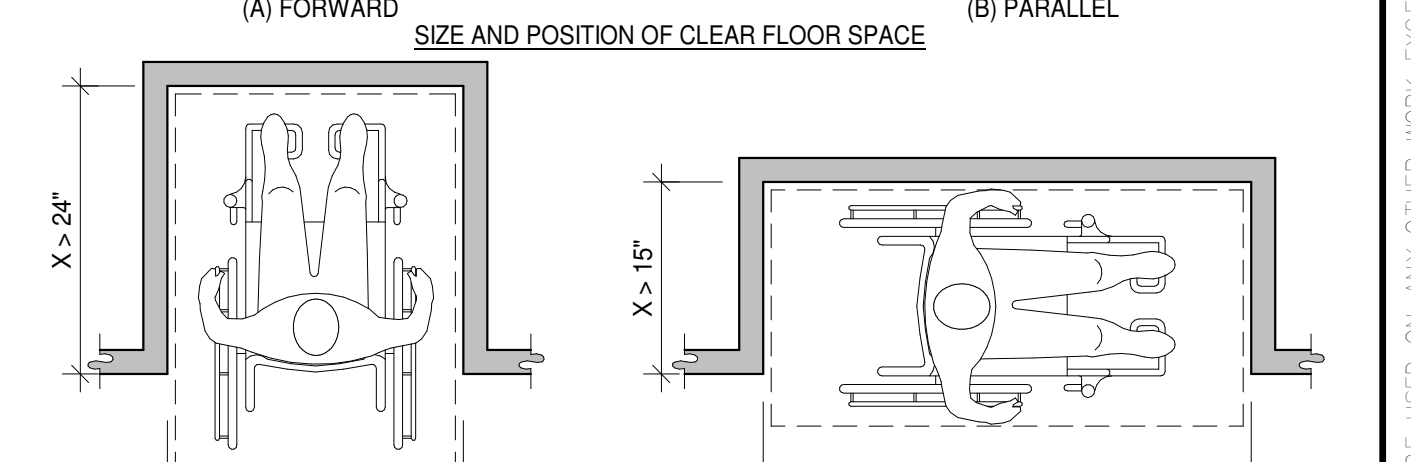

CLEAR FLOOR OR GROUND SPACE SCALE: 1/2" = 1'-0" 4

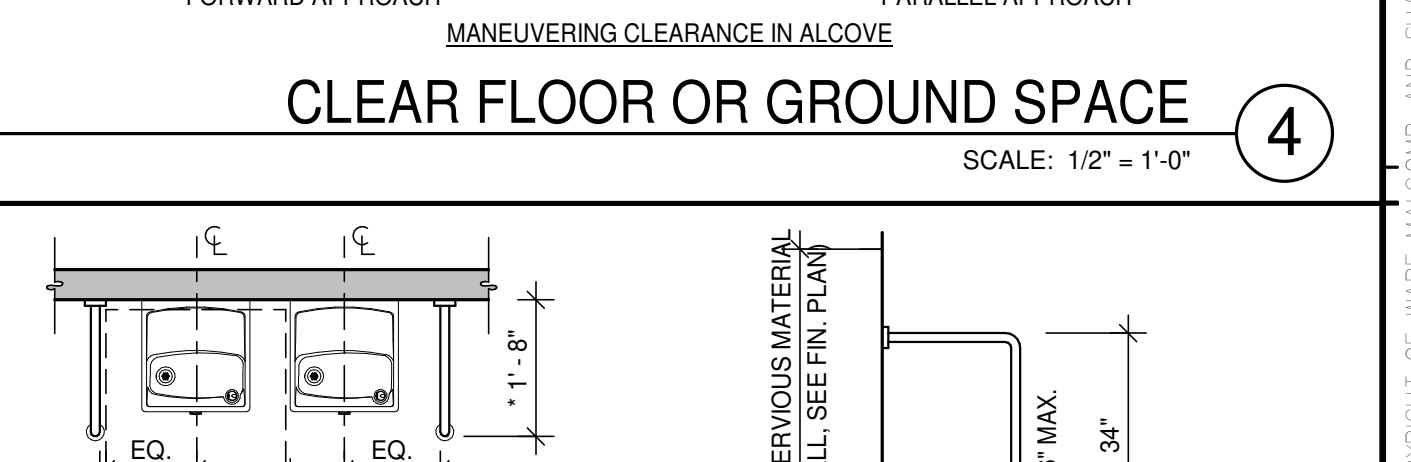

D.F. PROTECTION ALCOVES OR WITH BARRIERS SCALE: 3/8" = 1'-0" 5

WARE MALCOMB ARCHITECTURE PLANNING BUILDINGS INTERIORS 19194 REGISTERED ARCHITECT ADAM SEGALLA STATE OF WASHINGTON P. 426.670.6706

COSTCO FLEET RESTROOM PUYALLUP WH0660 1201 39TH AVE SW, PUYALLUP, WA. 98373-3803


COSTCO WHOLESALE

ACCESSIBILITY DETAILS REMARKS PERMIT ISSUANCE DATE PERMIT NUMBER

DATE 06/20/2024

P.A.M.: L. LUCERO DRAWN BY: A. M. JOB NO.: SE24-0053-00

SHEET 1020

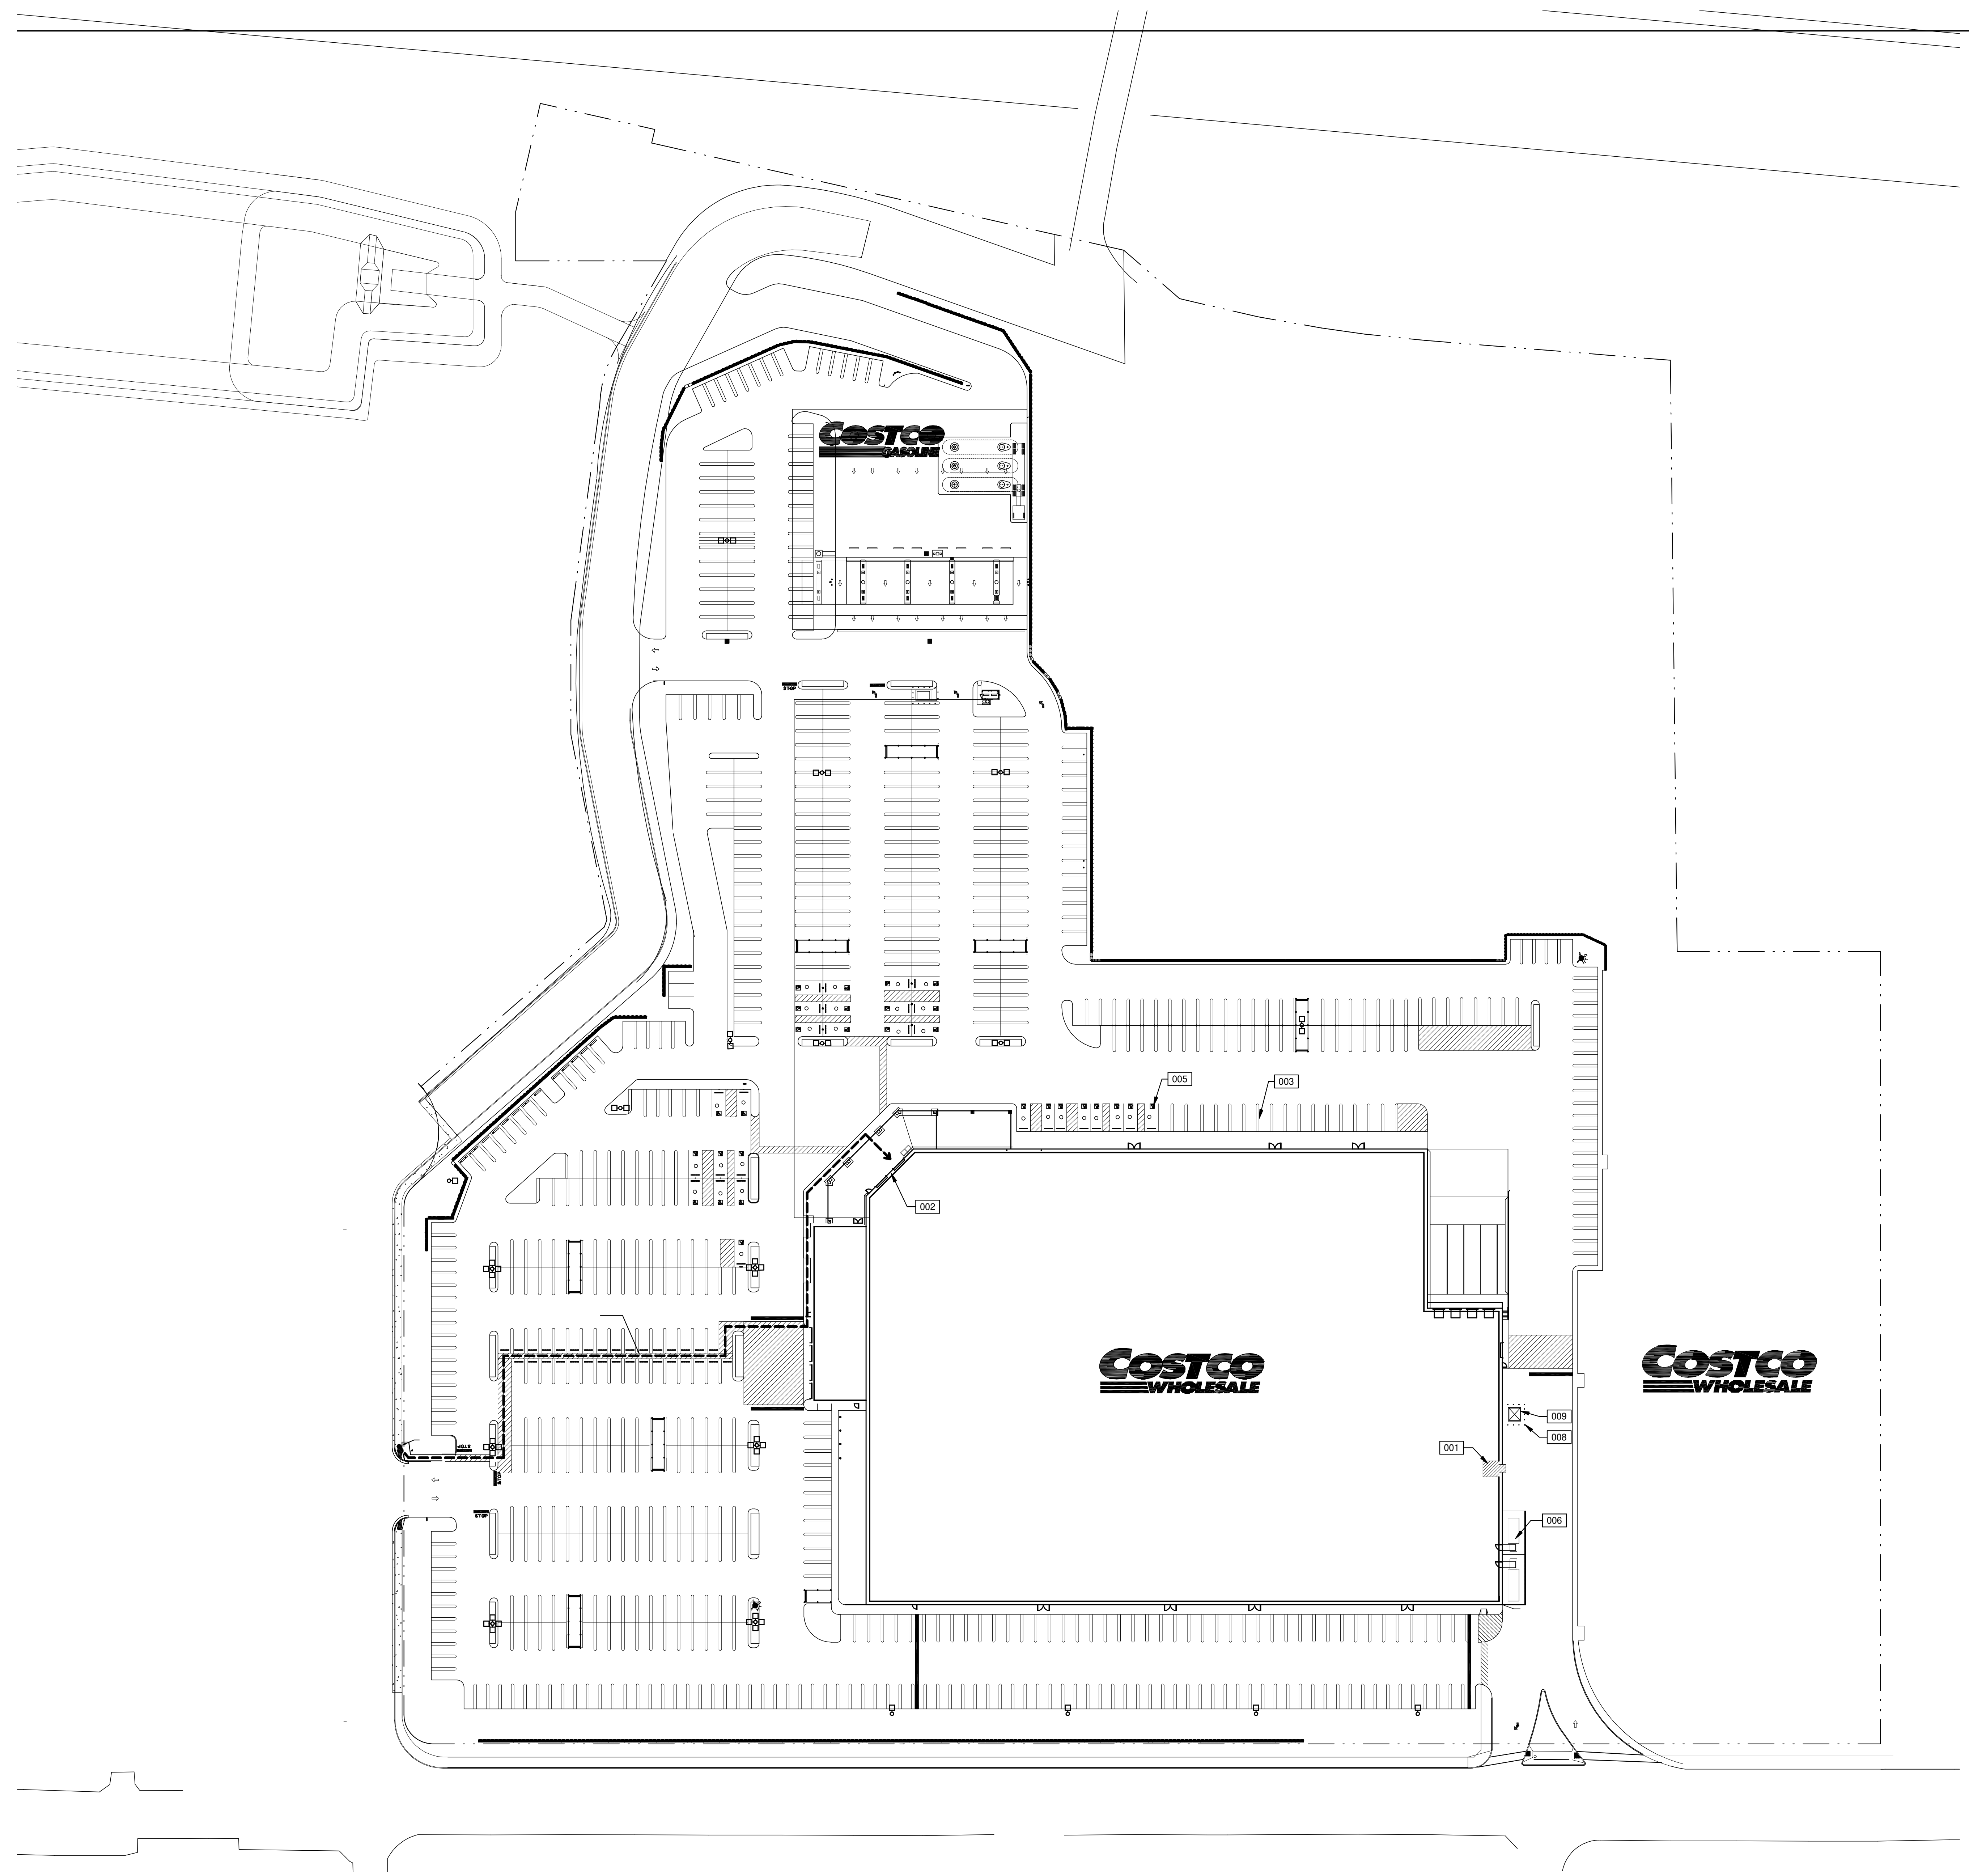

KEYNOTES:

SEE SHEETS 010-110 FOR GENERAL NOTES

- 001 AREA OF WORK.
- 002 EXISTING PRIMARY ENTRANCE TO REMAIN.
- 003 EXISTING PARKING TO REMAIN.
- 005 EXISTING ACCESSIBLE PARKING TO REMAIN.
- 006 EXISTING TRASH COMPACTOR TO REMAIN.
- 008 EXISTING EXTERIOR BOLLARD TO REMAIN.
- 009 EXISTING ELECTRICAL EQUIPMENT.

**City of Puyallup
Development & Permitting Services
ISSUED PERMIT**

Building	Planning
Engineering	Public Works
Fire	Traffic

LEGEND

- ACCESSIBLE PATH OF TRAVEL, 1:20 MAX. SLOPE, 2% MAX. CROSS SLOPE.
- - - PROPERTY LINE.

WARE MALCOMB
ARCHITECTURE
CIVIL ENGINEERING
PLANNING
INTERIORS
BRANDS
BUILDING MEASUREMENT

10 Goldway
Puyallup, WA 99109
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18194 REGISTERED ARCHITECT
Adam Segalla
ADAM SEGALLA
STATE OF WASHINGTON



COSTCO FLEET RESTROOM
PUYALLUP WH0660
1201 39TH AVE SW,
PUYALLUP, WA. 98373-3803

SITE PLAN	
DATE	REMARKS
09/20/2024	PERMIT ISSUANCE

PA/PM: L. LUCERO
DRAWN BY: A. M.
JOB NO.: SE24-0053-00

SHEET
I100

ANY SITE IMPROVEMENT CONSTRUCTION SHOWN ON THE ARCHITECTURAL DRAWINGS IS INTENDED AS INFORMATION TO BE ADDRESSED AND CLARIFIED BETWEEN THE GENERAL CONTRACTOR AND THE BUILDING LANDLORD AND/OR AFFECTED TENANT.
UNLESS OTHERWISE DEVELOPED AND DETAILED SEPARATELY BY A REGISTERED ENGINEER, LANDSCAPE DESIGNER OR OTHER RECOGNIZED SITE DEVELOPMENT PROFESSIONAL, THE ARCHITECT MAKES NO GUARANTEES AS TO THE ACCURACY OF (A) ANY SITE IMPROVEMENTS SHOWN ON ANY ARCHITECTURAL DRAWINGS INCLUDED HERE OR, (B) THE EXISTING SITE CONDITIONS IN THE IMPROVEMENT AREA.

1" = 50'
0 25' 50' 100' 250'

SITE PLAN (FOR REFERENCE ONLY)

SCALE: 1" = 50'-0"

1 N

**City of Puyallup
Development & Permitting Services
ISSUED PERMIT**

Building	Planning
Engineering	Public Works
Fire	Traffic

GENERAL NOTES

- SEE SHEETS G010 - 0110 FOR GENERAL NOTES
SEE SHEET I200 FOR FINISH, PLUMBING FIXTURES, RESTROOM ACCESSORIES, LIGHT FIXTURE, AND DOOR SCHEDULES
- THE CONTRACTOR SHALL FIELD VERIFY ALL EXISTING CONDITIONS AND NOTIFY THE ARCHITECT IMMEDIATELY OF ANY DISCREPANCIES OR CONFLICTS THAT MIGHT ARISE.
- WALL / PARTITION**
- CONTRACTOR SHALL NOTIFY ARCHITECT TO PERFORM AN ON-SITE REVIEW ONCE ALL PARTITIONS HAVE BEEN LAID OUT PRIOR TO ERECTING THE PARTITIONS, AND ADDRESS ANY DISCREPANCIES WITH DIMENSIONS SHOWN ON THE CONTRACT DOCUMENTS.
 - ALL PARTITION METAL STUDS TO BE 3-8" DEPTH - GAUGE AND SPACING PER U240 SPAN TABLE, ON THE FRAMING DETAILS SHEET, U.O.N.
 - ALL RESTROOM PARTITION METAL STUDS AT SINGLE-STUD RESTROOM TO BE MINIMUM 6" DEEP, AND FULLY INSULATED WITH R-13 UNFACED FIBERGLASS INSULATION (OR EQUIVALENT), U.O.N.
 - USE MOISTURE RESISTANT BOARD AT ALL RESTROOM PARTITIONS AND WHERE FRP IS USED.
 - ALL NEW INTERIOR PARTITIONS TO BE FULLY INSULATED WITH A MINIMUM OF R-11 UNFACED FIBERGLASS INSULATION (OR EQUIVALENT), U.O.N.
 - DRYWALL GYPSUM BOARD SHALL BE FINISHED AS FOLLOWS, U.O.N. REFER TO GYPSUM ASSOCIATION PUBLICATION, GA-214: <https://www.gypsum.org/press/whats-recommended-levels-finish/>
 - FOR PLENUM AND NON-VISIBLE AREAS - LEVEL-1 AREAS WITH OPEN-CEILING OR CLOUDS TO BE FINISHED AS FOR VISIBLE PARTITIONS.
 - ALL VISIBLE PARTITION SURFACES - LEVEL-4, UNLESS NOTED AS LEVEL-5 BY OTHER NOTES OR KEYNOTE.
 - PROVIDE DRYWALL EXPANSION & CONTROL JOINTS PER "WALL AND CEILING BUREAU" (WCB) STANDARDS. PROVIDE SHOP DRAWINGS FOR REVIEW PRIOR TO INSTALLATION.
 - ALL DRYWALL CORNERS AND COLUMN EDGES TO BE FINISHED WITH CORNER "L" BEAD. DIMENSIONS OF COLUMN FURRING IN A COMMON AREA ARE TO BE EQUAL & CONSISTENT.
 - PATCH AND REPAIR ANY DAMAGE TO EXISTING WINDOW SILLS CAUSED BY DEMOLITION: MATCH EXISTING SILL CONDITION FINISH TO MATCH EXISTING WINDOW FRAMES.
 - ELECTRICAL ACCESS SHALL BE FLUSH FRAMELESS GYPSUM BOARD PANELS.
 - ALL BLOCKING IN PARTITION TO BE FIRE RETARDANT TREATED SOLID WOOD BLOCKING, OR CONTINUOUS METAL STRAPPING. COORDINATE EXACT LOCATIONS AND EXTENT IN FIELD. GC TO PROVIDE BLOCKING FOR ALL OWNER-SUPPLIED MILLWORK, IN ADDITION TO MILLWORK SUPPLIED BY THE GC, AND WALL-FINISH EQUIPMENT.

REFLECTED CEILING

- NOTIFY ARCHITECT OF ANY DISCREPANCIES BETWEEN ARCHITECTURAL, ELECTRICAL, AND MECHANICAL DRAWINGS BEFORE PROCEEDING WITH INSTALLING THE WORK.
- SEE FIXTURE SCHEDULE FOR FIXTURE TYPE DESIGNATIONS, AND TYPICAL MOUNTING HEIGHTS (U.O.N).
- ALL MATERIALS USED WITHIN CEILING PLENUM SHALL BE NON-COMBUSTIBLE.
- IN GYPSUM BOARD CEILING THE LIGHTS, HVAC ELEMENTS, FIRE DEVICES, ETC. ARE TO ALIGN IN A NEAT AND REGULAR PATTERN. REVIEW LAYOUT WITH ARCHITECT PRIOR TO ROUGH-IN.
- GENERAL CONTRACTOR TO IDENTIFY QUANTITY AND LOCATIONS OF ALL ACCESS PANELS TO CEILING PLENUM SPACES IN GYPSUM BOARD CEILING: ACCESS PANELS TO BE AVOIDED WHERE POSSIBLE. IF AN ACCESS PANEL IS REQUIRED, COORDINATE LOCATION WITH ARCHITECT. CEILING ACCESS PANELS TO BE FLUSH-FRAMELESS GYPSUM BOARD INFILL PANELS.
- SEE KEYNOTE INFORMATION FOR ANY REQUIRED CEILING INSULATION.
- GANG MULTIPLE ADJACENT OUTLETS AND SWITCHES TOGETHER WITH MULTI-OUTLET COVER PLATE, U.O.N.
- ALL SWITCHES/MOTION SENSORS SHALL NOT BE PLACED BEHIND DOORS WHEN IN OPEN POSITION.

FINISHES

- CONTRACTOR TO INCLUDE ALL FLOOR PREPARATIONS IN BASE BID.
- SEE ENLARGED PLANS, ELEVATIONS AND DETAILS FOR ADDITIONAL FINISH INFORMATION.
- ALL FINISHES TO BE INSTALLED PER THE MANUFACTURER'S INSTRUCTIONS.
- ALL FINISH TRANSITIONS AT DOORS TO BE LOCATED CENTERED UNDER THE DOOR, U.O.N.
- PROVIDE FLOORING TRANSITIONS AS FOLLOWS, U.O.N.:
 - STAINLESS STEEL TRIM BY SCHLUTER OR EQUAL, AT ALL TRANSITIONS BETWEEN TILE/STONE AND OTHER FINISHES.

RESTROOM NOTES



- PROVIDE DRAIN WITH TRAP PRIMER FOR EACH RESTROOM IF THERE ARE TWO OR MORE FIXTURES. SLOPE FLOOR TO DRAIN A MIN. 1/8" PER FOOT.
- VERIFY BUILDING STANDARD FOR WALL-HUNG/DROP-IN COUNTER SINK WHERE APPLICABLE.
- TOILET PAPER DISPENSERS SHALL NOT BE OF TYPE THAT CONTROLS DELIVERY, OR THAT DO NOT ALLOW CONTINUOUS PAPER FLOW. OPERABLE PARTS SHALL BE OPERABLE WITH ONE HAND AND SHALL NOT REQUIRE TIGHT GRASPING, PINCHING OR TWISTING OF THE WRIST. THE FORCE REQUIRED TO ACTIVATE OPERABLE PARTS SHALL BE 5 POUNDS MAX.
- OPERABLE PARTS OF ALL ACCESSORIES SHALL COMPLY WITH ALL APPLICABLE ACCESSIBILITY CODES AND STANDARDS.

KEYNOTES:

- SEE SHEETS G010 - 0110 FOR GENERAL NOTES
- 011 EXISTING CHAINLINK FENCE TO REMAIN.
 - 014 EXISTING CHAINLINK FENCE TO REMOVE.

LEGENDS

-  INDICATES AREA NOT IN SCOPE

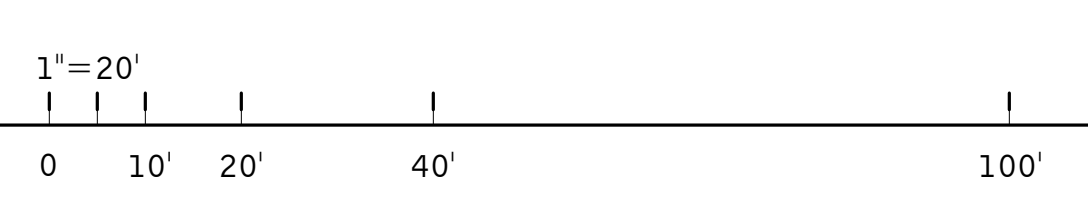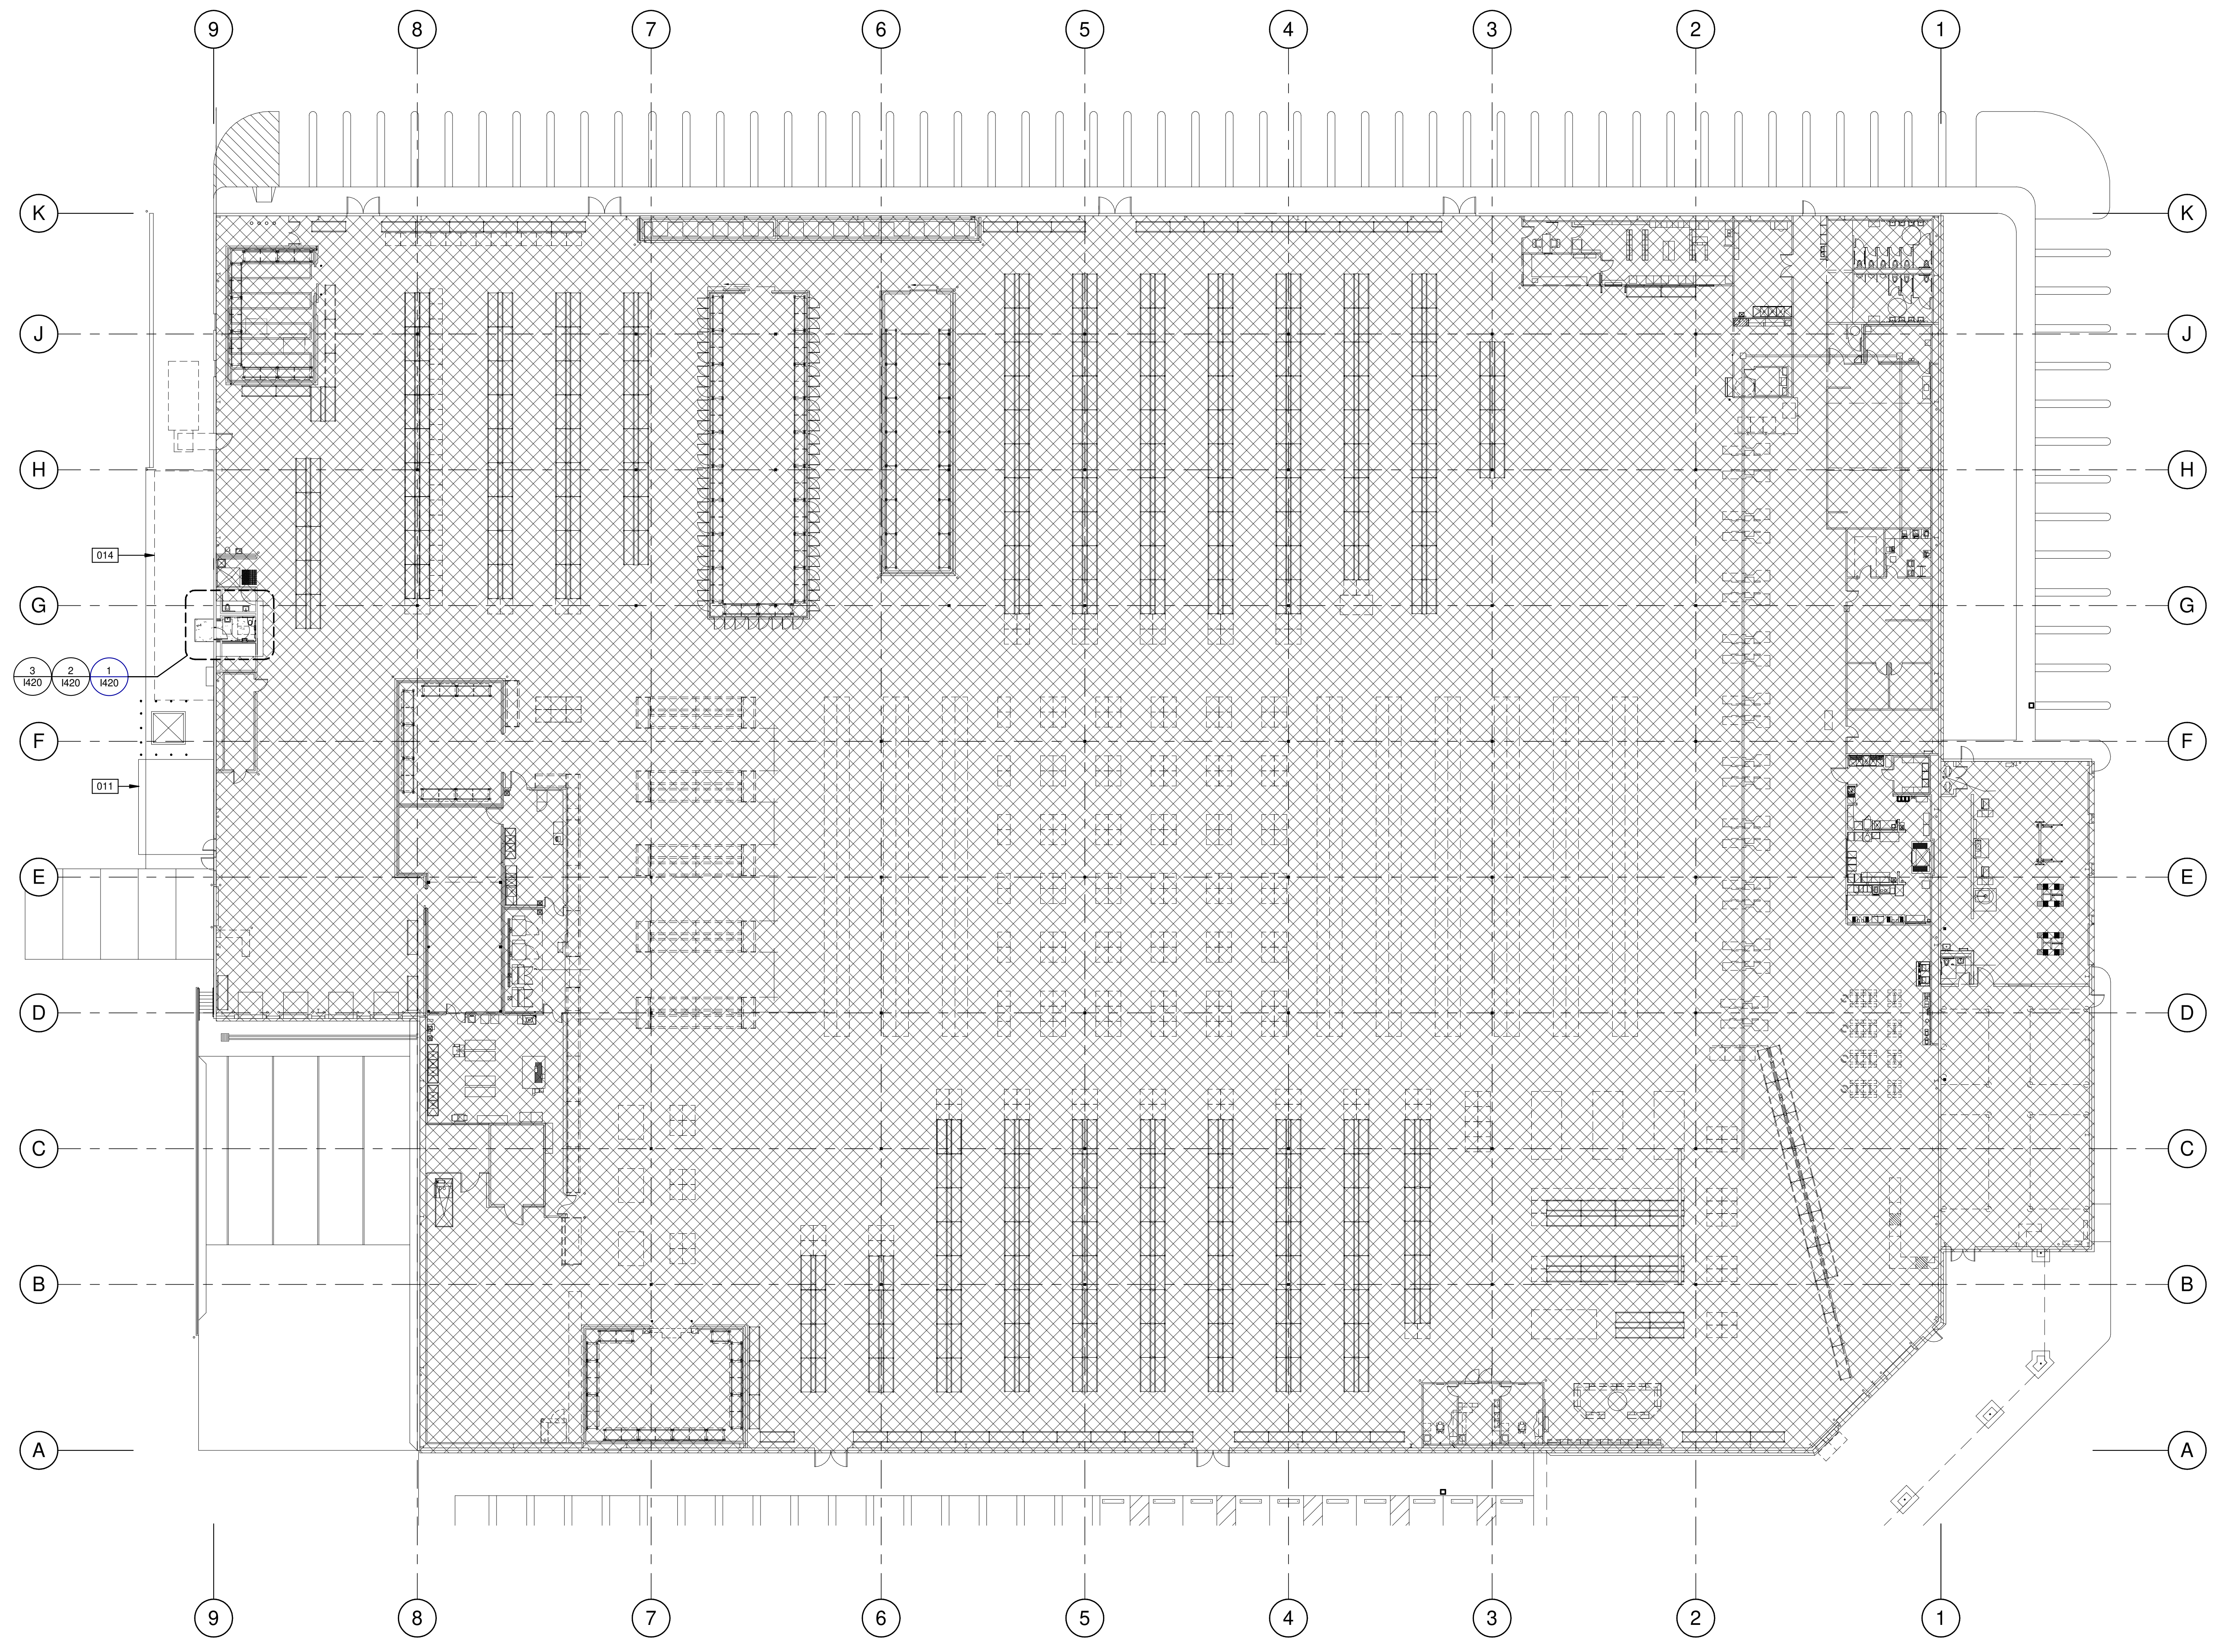

SITE PLAN
SCALE: 1" = 20'-0"

WARE MALCOMB
3015 117th Ave NE, Suite 400
Bellevue, WA 98008
P: 425.670.6706

CIVIL ENGINEERING
PLUMBING
BUILDING MEASUREMENT
INTERIORS

19194 REGISTERED ARCHITECT
ADAM SEGALLA
STATE OF WASHINGTON



COSTCO FLEET RESTROOM
PUYALLUP WH0660
1201 39TH AVE SW,
PUYALLUP, WA. 98373-3803

OVERALL FLOOR PLAN	
DATE	REMARKS
09/20/2024	PERMIT ISSUANCE

PAPM: L LUCERO
DRAWN BY: A. M.
JOB NO.: SE424-0053-00

SHEET
I200





**City of Puyallup
Development & Permitting Services
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Building	Planning
Engineering	Public Works
Fire	Traffic

- KEYNOTES:**
- DEMOLITION FLOOR PLAN**
- D02 REMOVE EXISTING ASPHALT AS REQUIRED TO ACCOMMODATE NEW DOOR LANDING.
 - D09 CUT-IN OPENING AT EXTERIOR WALL TO ACCOMMODATE NEW 3070 HOLLOW METAL DOOR. SEE DOOR SCHEDULE.
 - D17 CUT-IN OPENING AT INTERIOR WALL.
 - D22 REMOVE DOOR ASSEMBLY. SAVE FOR POSSIBLE RELOCATION OR RETURN TO BUILDING STOCK.
- FLOOR / FINISH PLAN**
- 221 PROVIDE NEW CONCRETE SLAB WITH VAPOR RETARDER OVER SAND BASE AT PROPOSED LOCATION PER SOILS REPORT. SEE CIVIL FOR GRADING INFORMATION.
 - 222 PROVIDE NEW CONCRETE PAD. SEE STRUCTURAL FOR INFORMATION.
 - 251 NEW WALLS OF THIS ROOM TO BE INSULATED WITH R-19 THERMAL BATT INSULATION.
 - 256 SAW-CUT EXISTING CONCRETE FLOOR IN THIS AREA AS REQUIRED FOR NEW PLUMBING.
 - 701 EXISTING FINISHES TO REMAIN IN THIS ROOM.
- ELEVATIONS**
- 202 EXISTING EXTERIOR WALL TO REMAIN.
 - 406 WALL PACK LIGHT MOUNTED AT CENTERLINE WITH DOOR AT CONSISTENT ELEVATION. COORDINATE MOUNTING HEIGHT WITH ELECTRICAL DRAWINGS.
- REFLECTED CEILING PLAN**
- 302 EXHAUST FAN.
 - 622 NEW CEILING WITH PAINTED 5/8" GYPSUM BOARD OVER METAL JOISTS WITH METAL DECK SECURITY BARRIER. RE: DETAIL UI-510.
 - 623 NEW CEILING OF THIS ROOM IS TO BE PROVIDED WITH (1) LAYER OF FIBERGLASS INSULATION, MECHANICAL DRAWINGS TO DETERMINE R-VALUE OF INSULATION.
 - 624 NEW LIGHT FIXTURE TO BE CENTERED IN THIS ROOM.


- LEGENDS**
- INDICATES AREA NOT IN SCOPE
- WALL/PARTITION TYPES**
- INTERIOR GYPSUM BOARD PARTITION SHALL CONFORM TO ICC REPORT ESR-1338. MIN. FASTENER: #6 1-1/4" SCREW. SPACING: 12" FIELD, 0" EDGES.
 - SEE DETAIL SHEET B510 FOR PARTITION TYPE DETAILS.
- PARTITION TAG
 - STUD SIZE, PER DETAIL
 - PARTITION TYPE
- WALL / PARTITION**
- EXISTING WALL / PARTITION
 - EXISTING EXTERIOR WALL WITH NEW FURRING PARTITION
 - FULL HEIGHT PARTITION TO STRUCTURE ABOVE
- REFLECTED CEILING**
- NEW 5/8" GYPSUM BOARD CEILING OR SOFFIT.
 - NEW 1'x4' FLUORESCENT FIXTURE. F-1
- NOTE: REFER TO ELECTRICAL DRAWINGS FOR LIGHT FIXTURE SPECIFICATIONS.
- FINISHES**
- SEE SHEET B20 FOR FINISHES
- INDICATES LINE OF FLOOR TRANSITION NUMBER REFERENCES TRANSITION ACCESSORY (TR-#) LOCATED ON FINISH SCHEDULE
 - INDICATES LOCATION OF NON-TYPICAL WALL FINISH
 - INDICATES WALL FINISHES
 - INDICATES FLOOR FINISHES
 - INDICATES MISCELLANEOUS FINISHES

- RESTROOM MOUNTING HEIGHTS**
- NOTE: PROVIDE BACKING AS REQUIRED FOR ALL WALL HUNG, ATTACHED FIXTURES AND EQUIPMENT AS REQUIRED PER STANDARD GOOD PRACTICES.
-

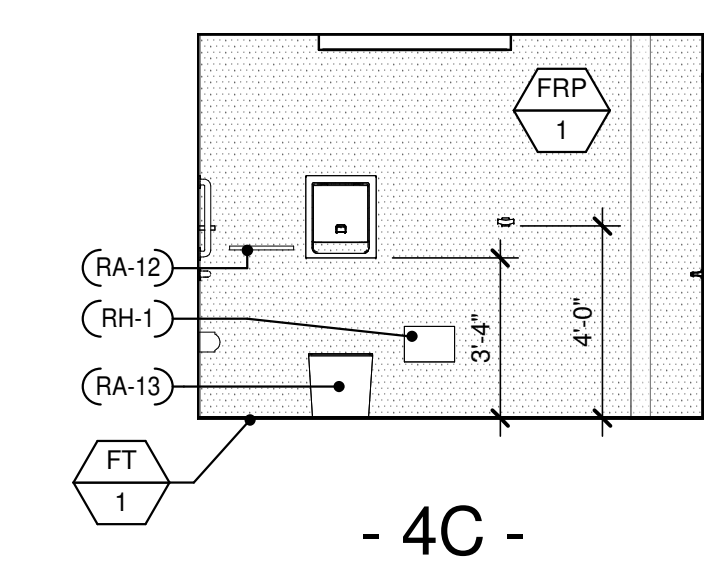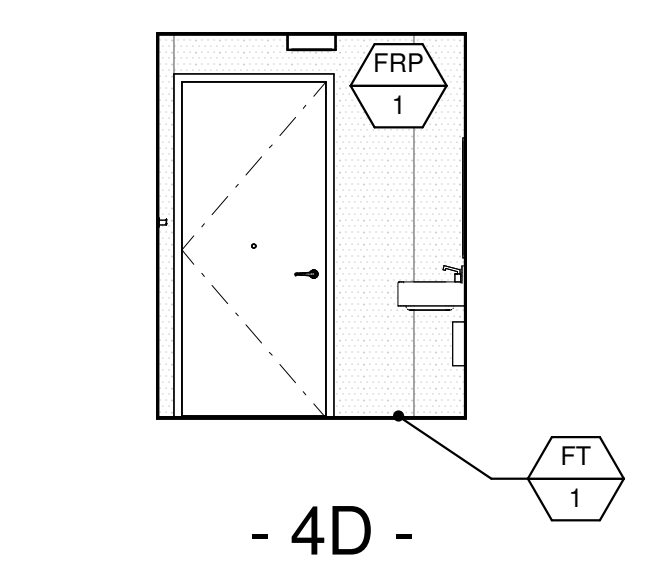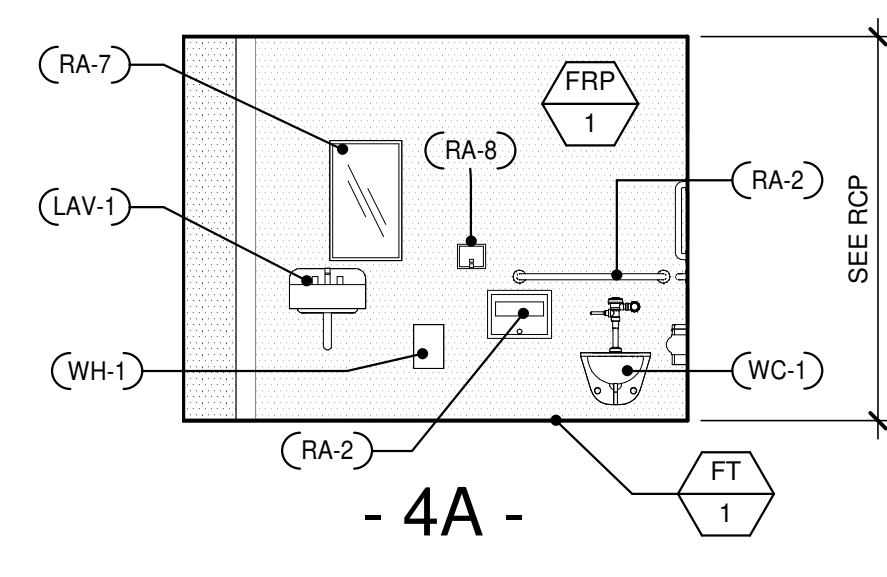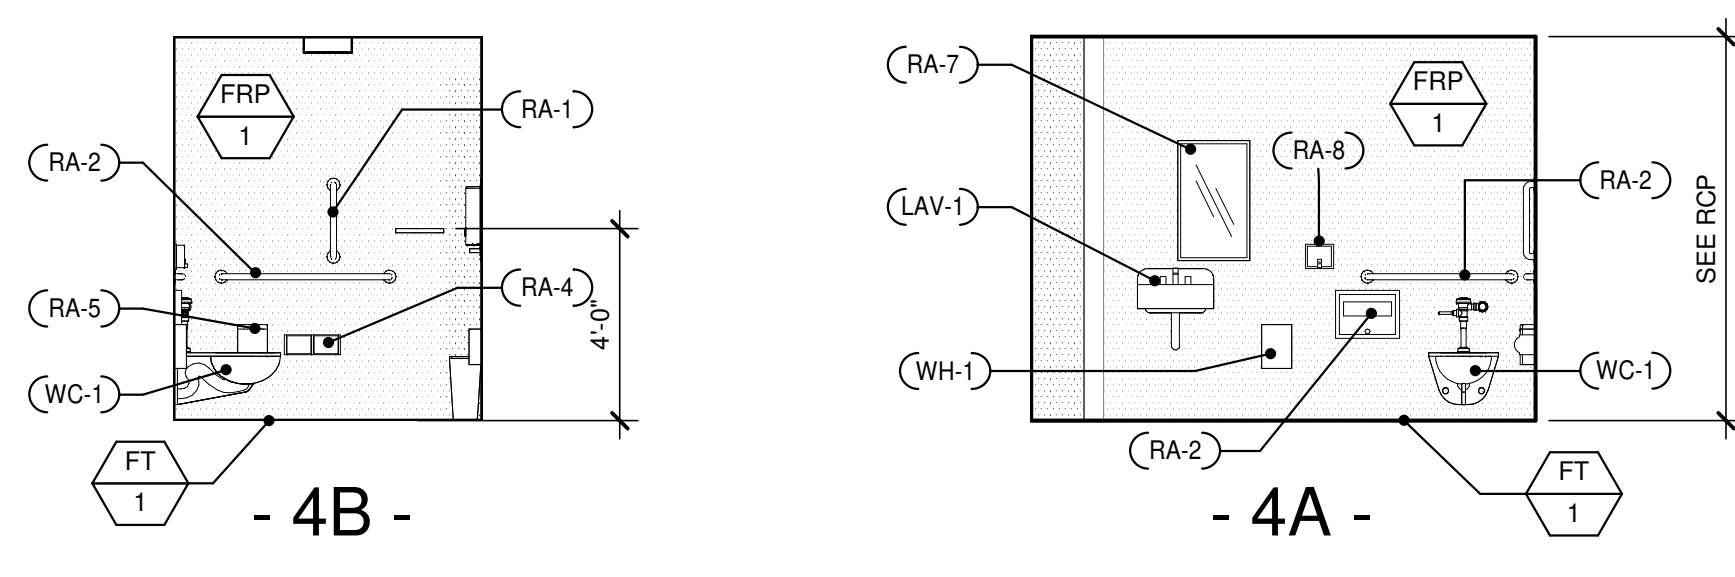


INTERIOR RESTROOM ELEVATIONS
SCALE: 1/4" = 1'-0"


1/4" = 1'-0"
0 2' 4' 8' 16'

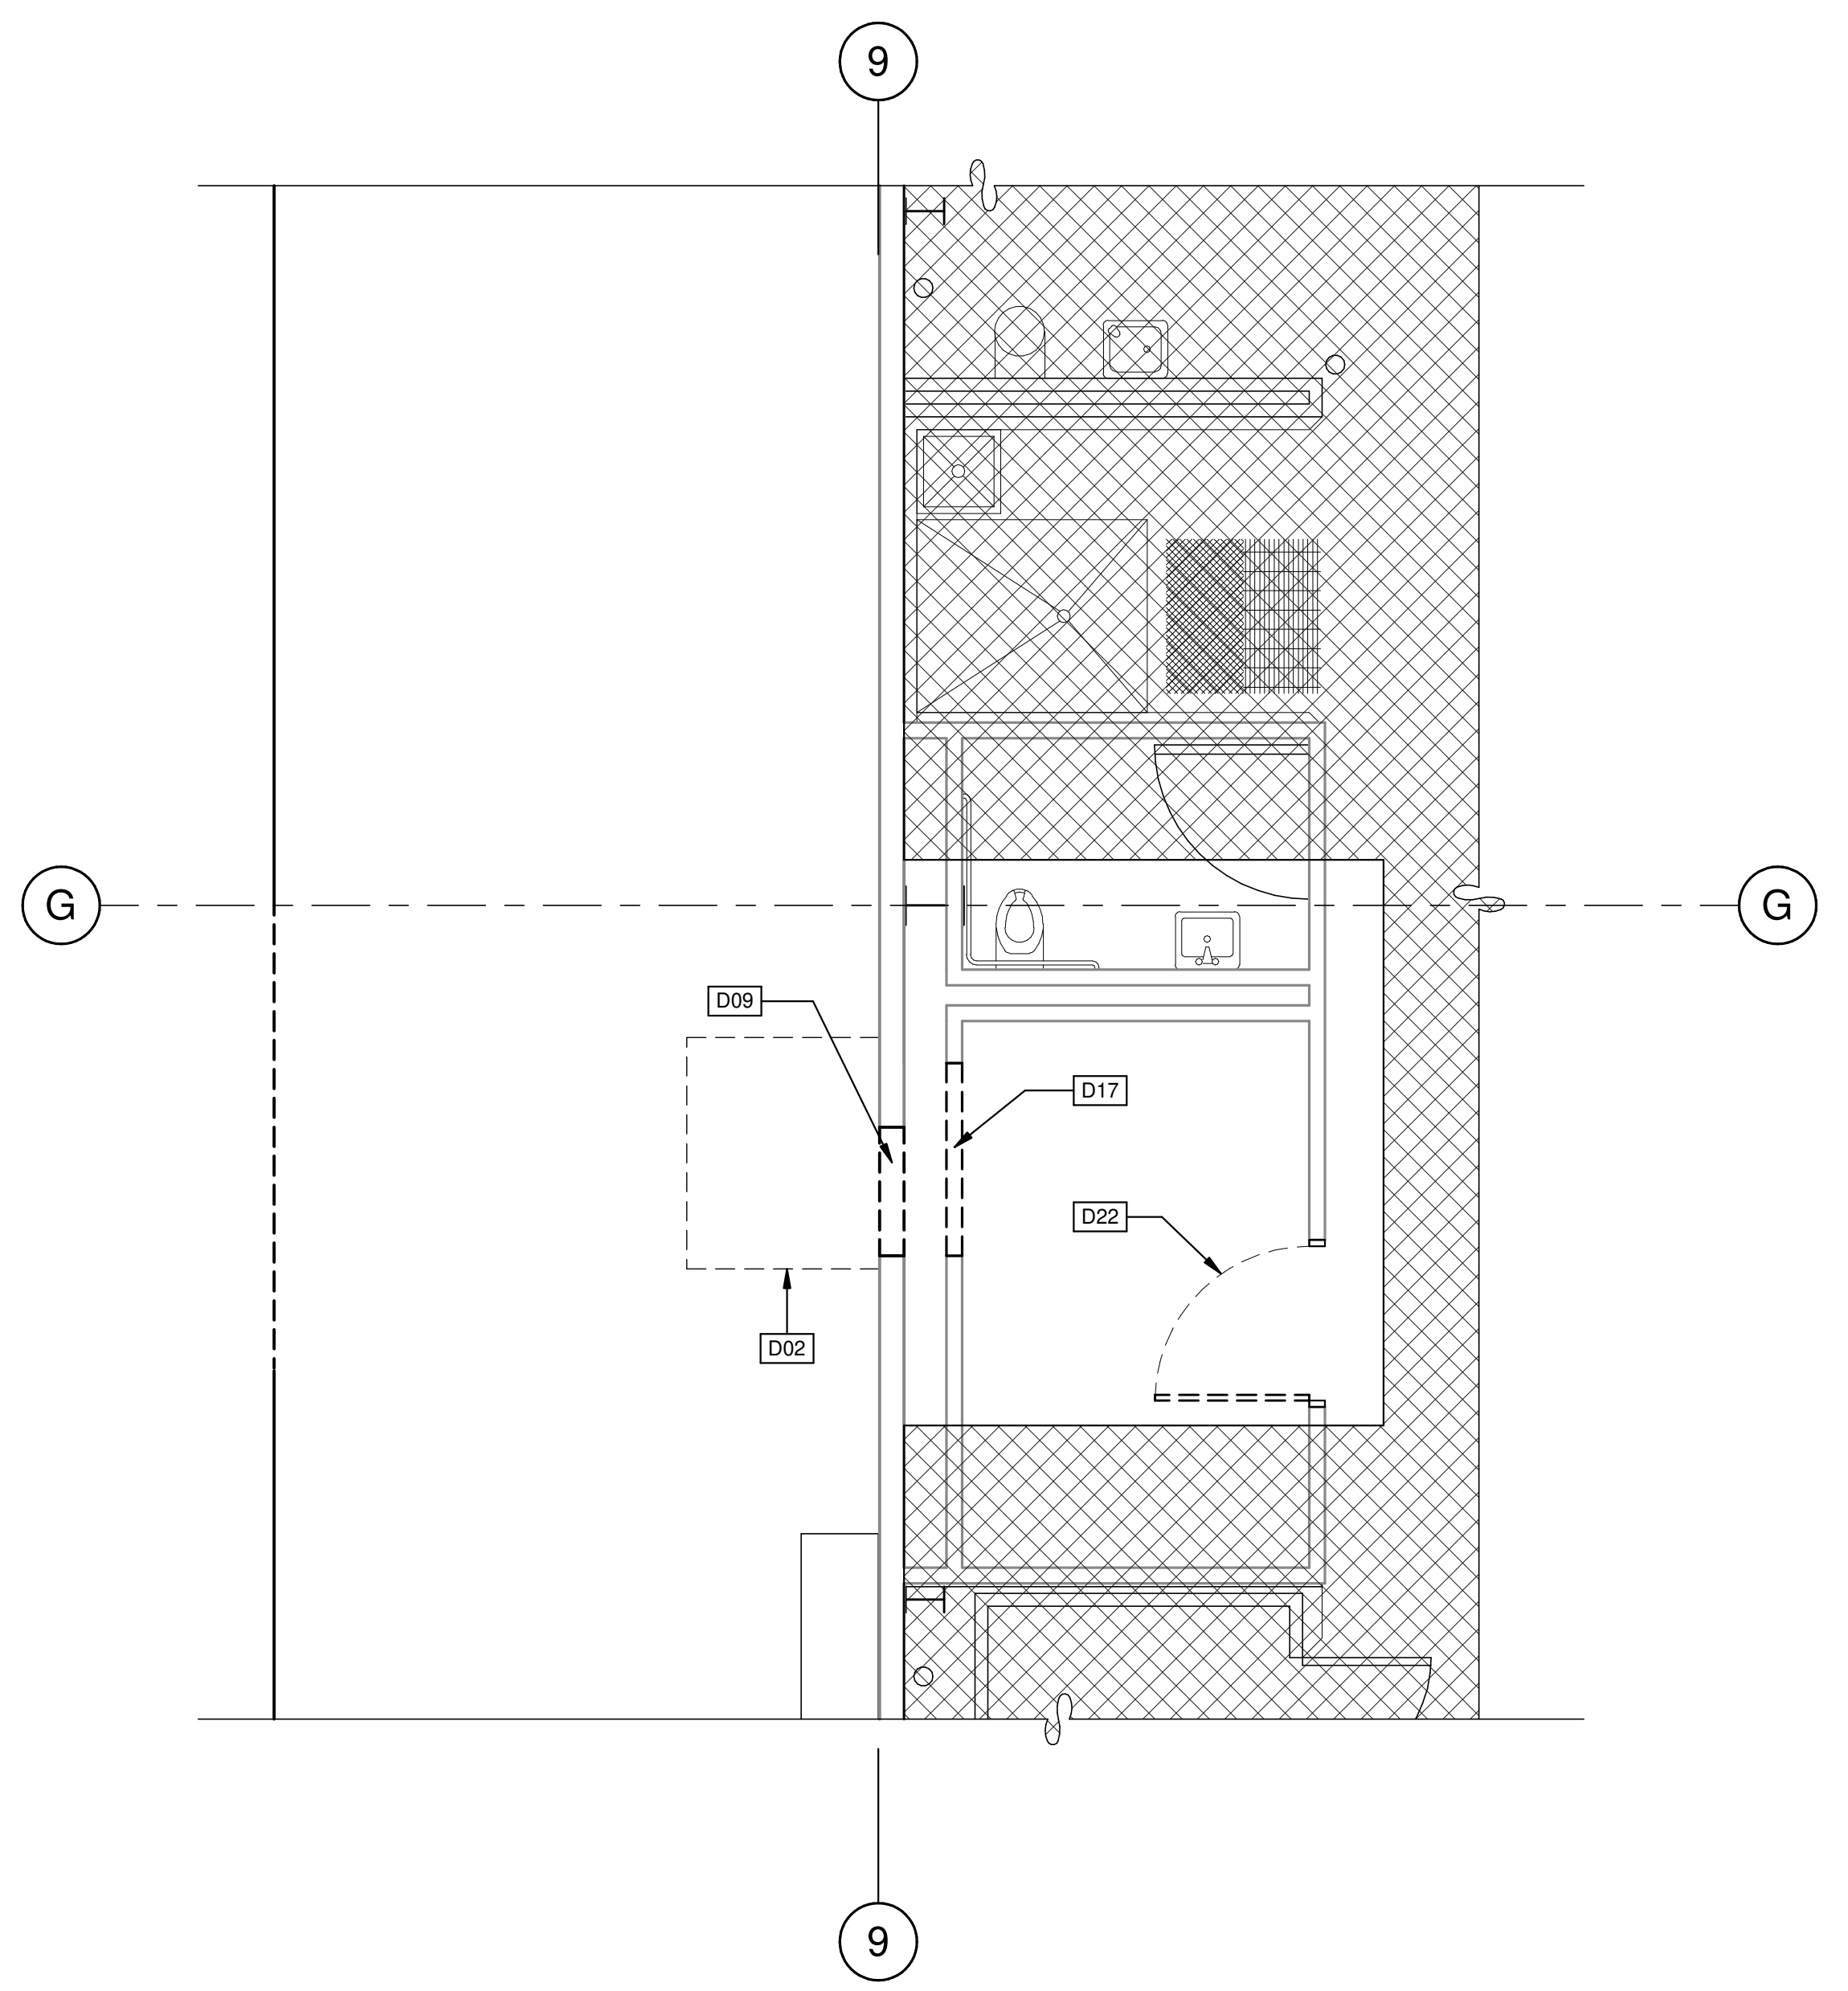


DEMOLITION FLOOR PLAN
SCALE: 1/4" = 1'-0"

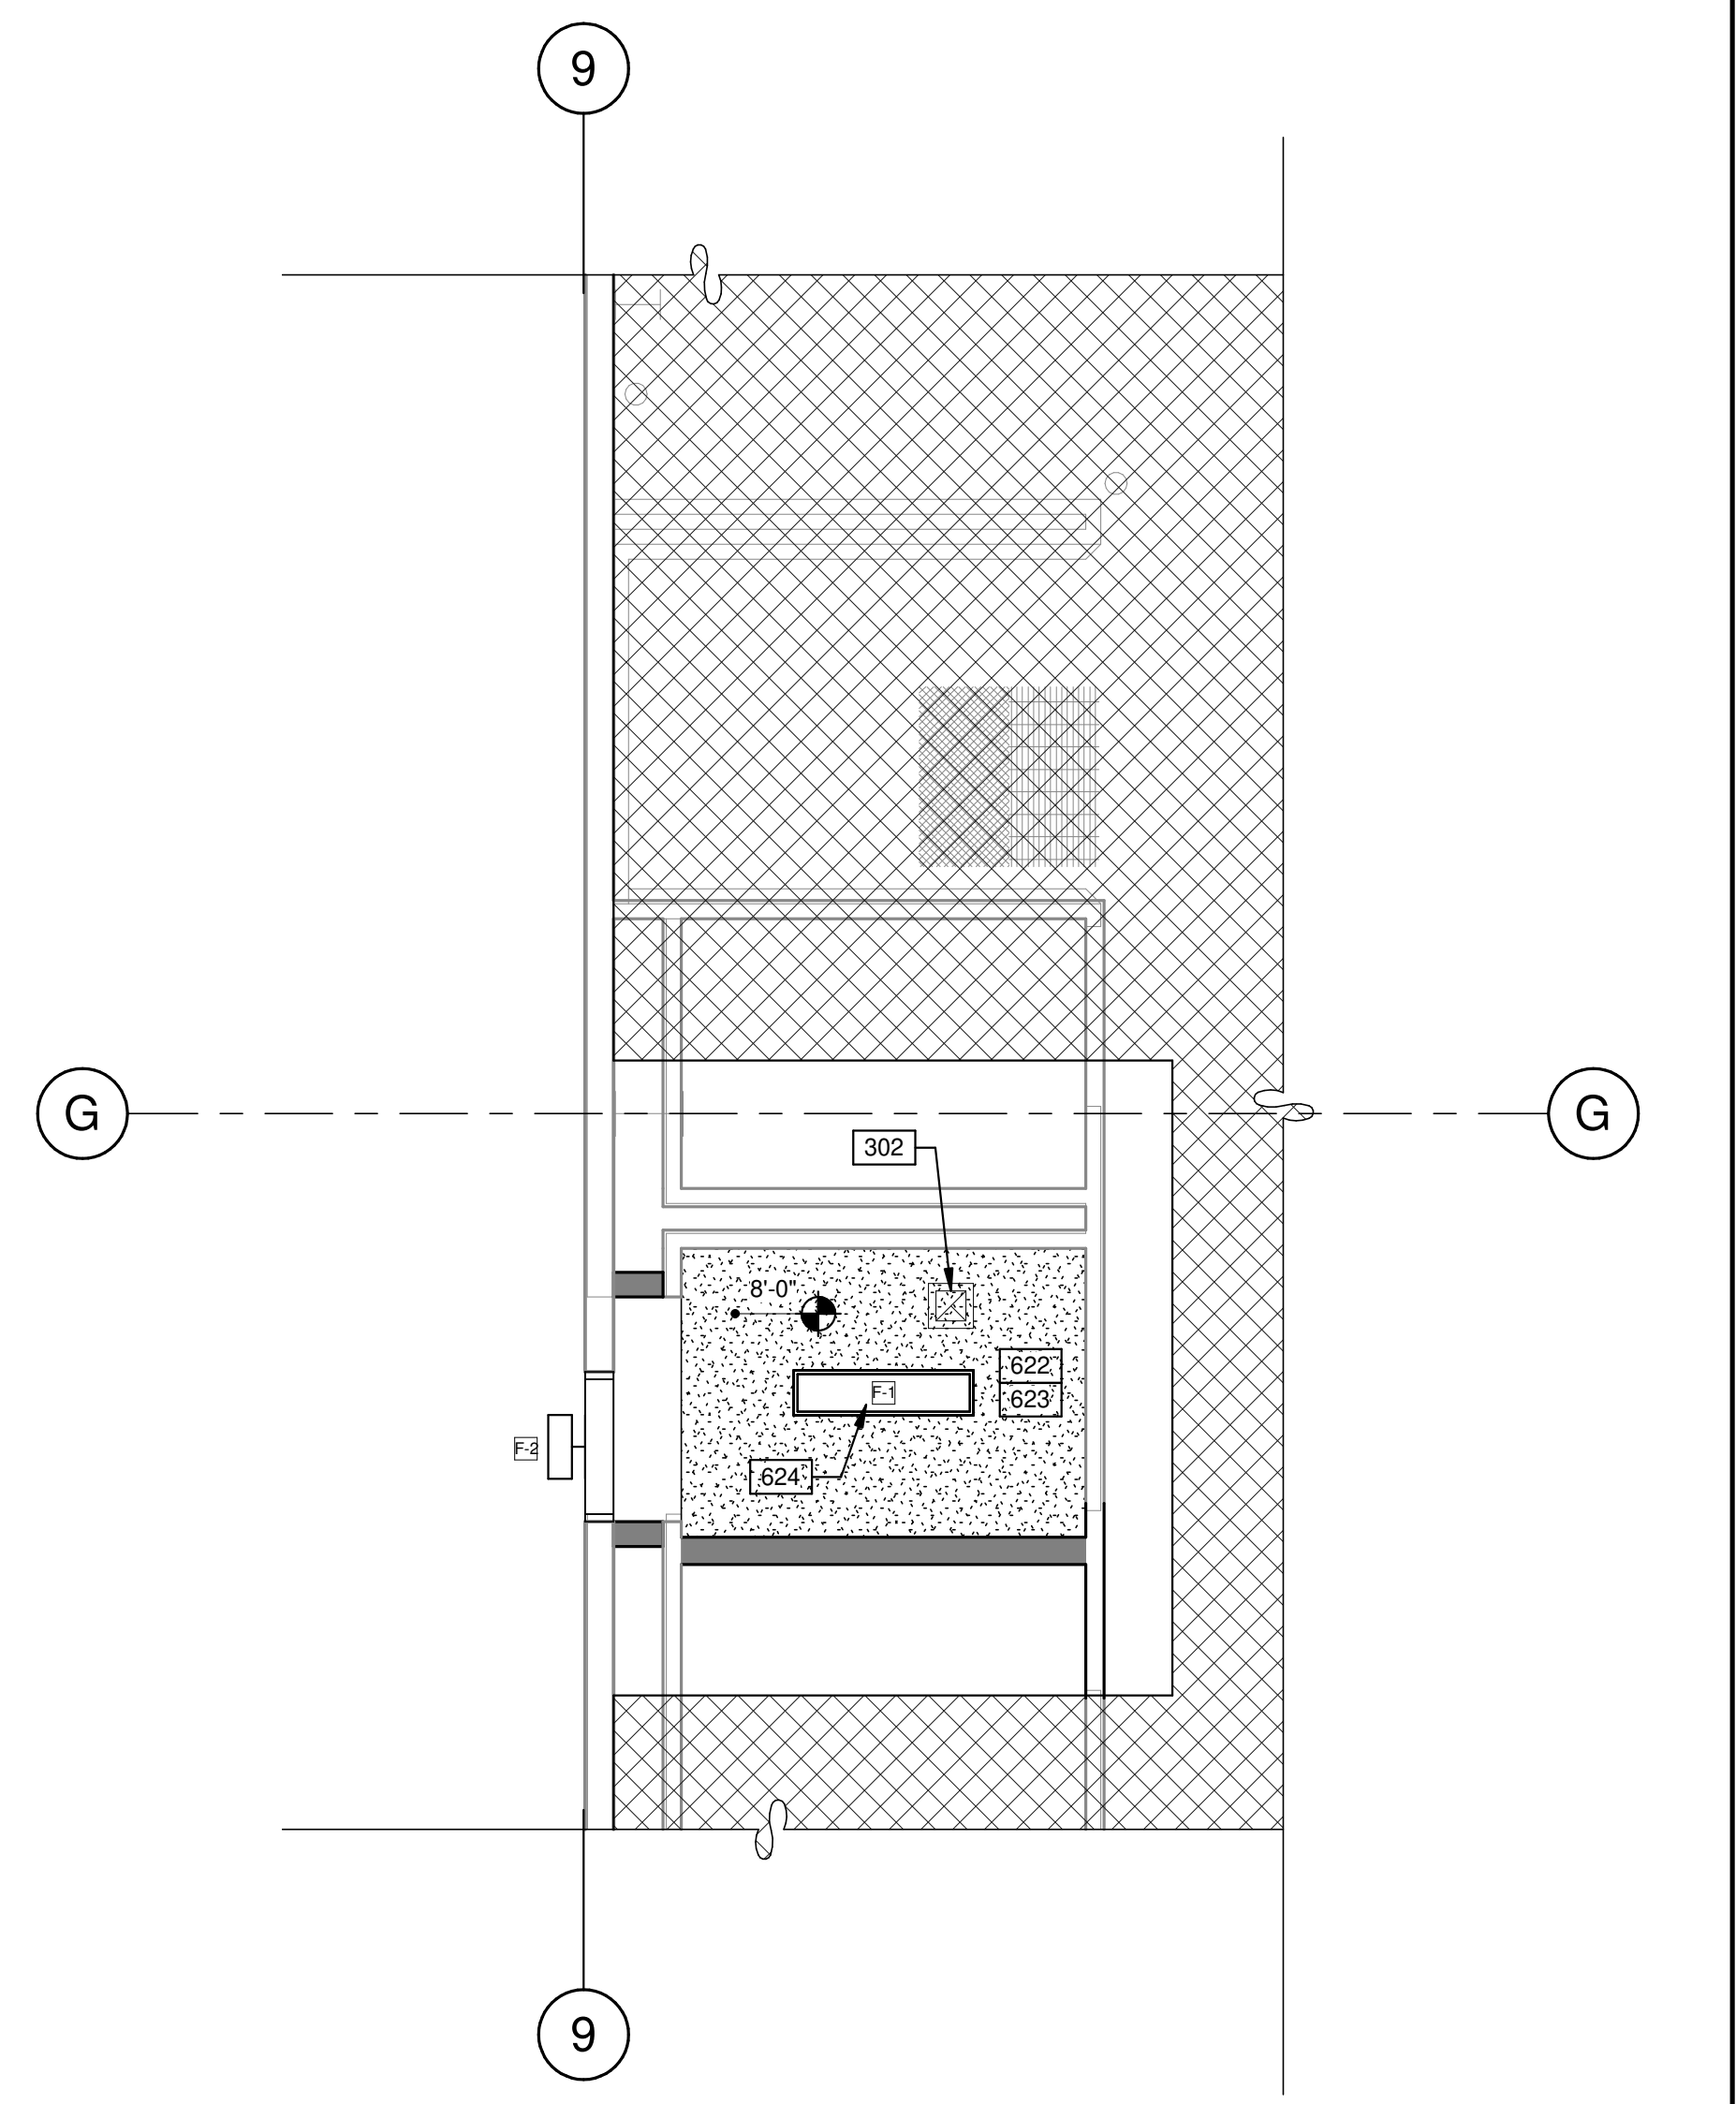

REFLECTED CEILING PLAN
SCALE: 1/4" = 1'-0"

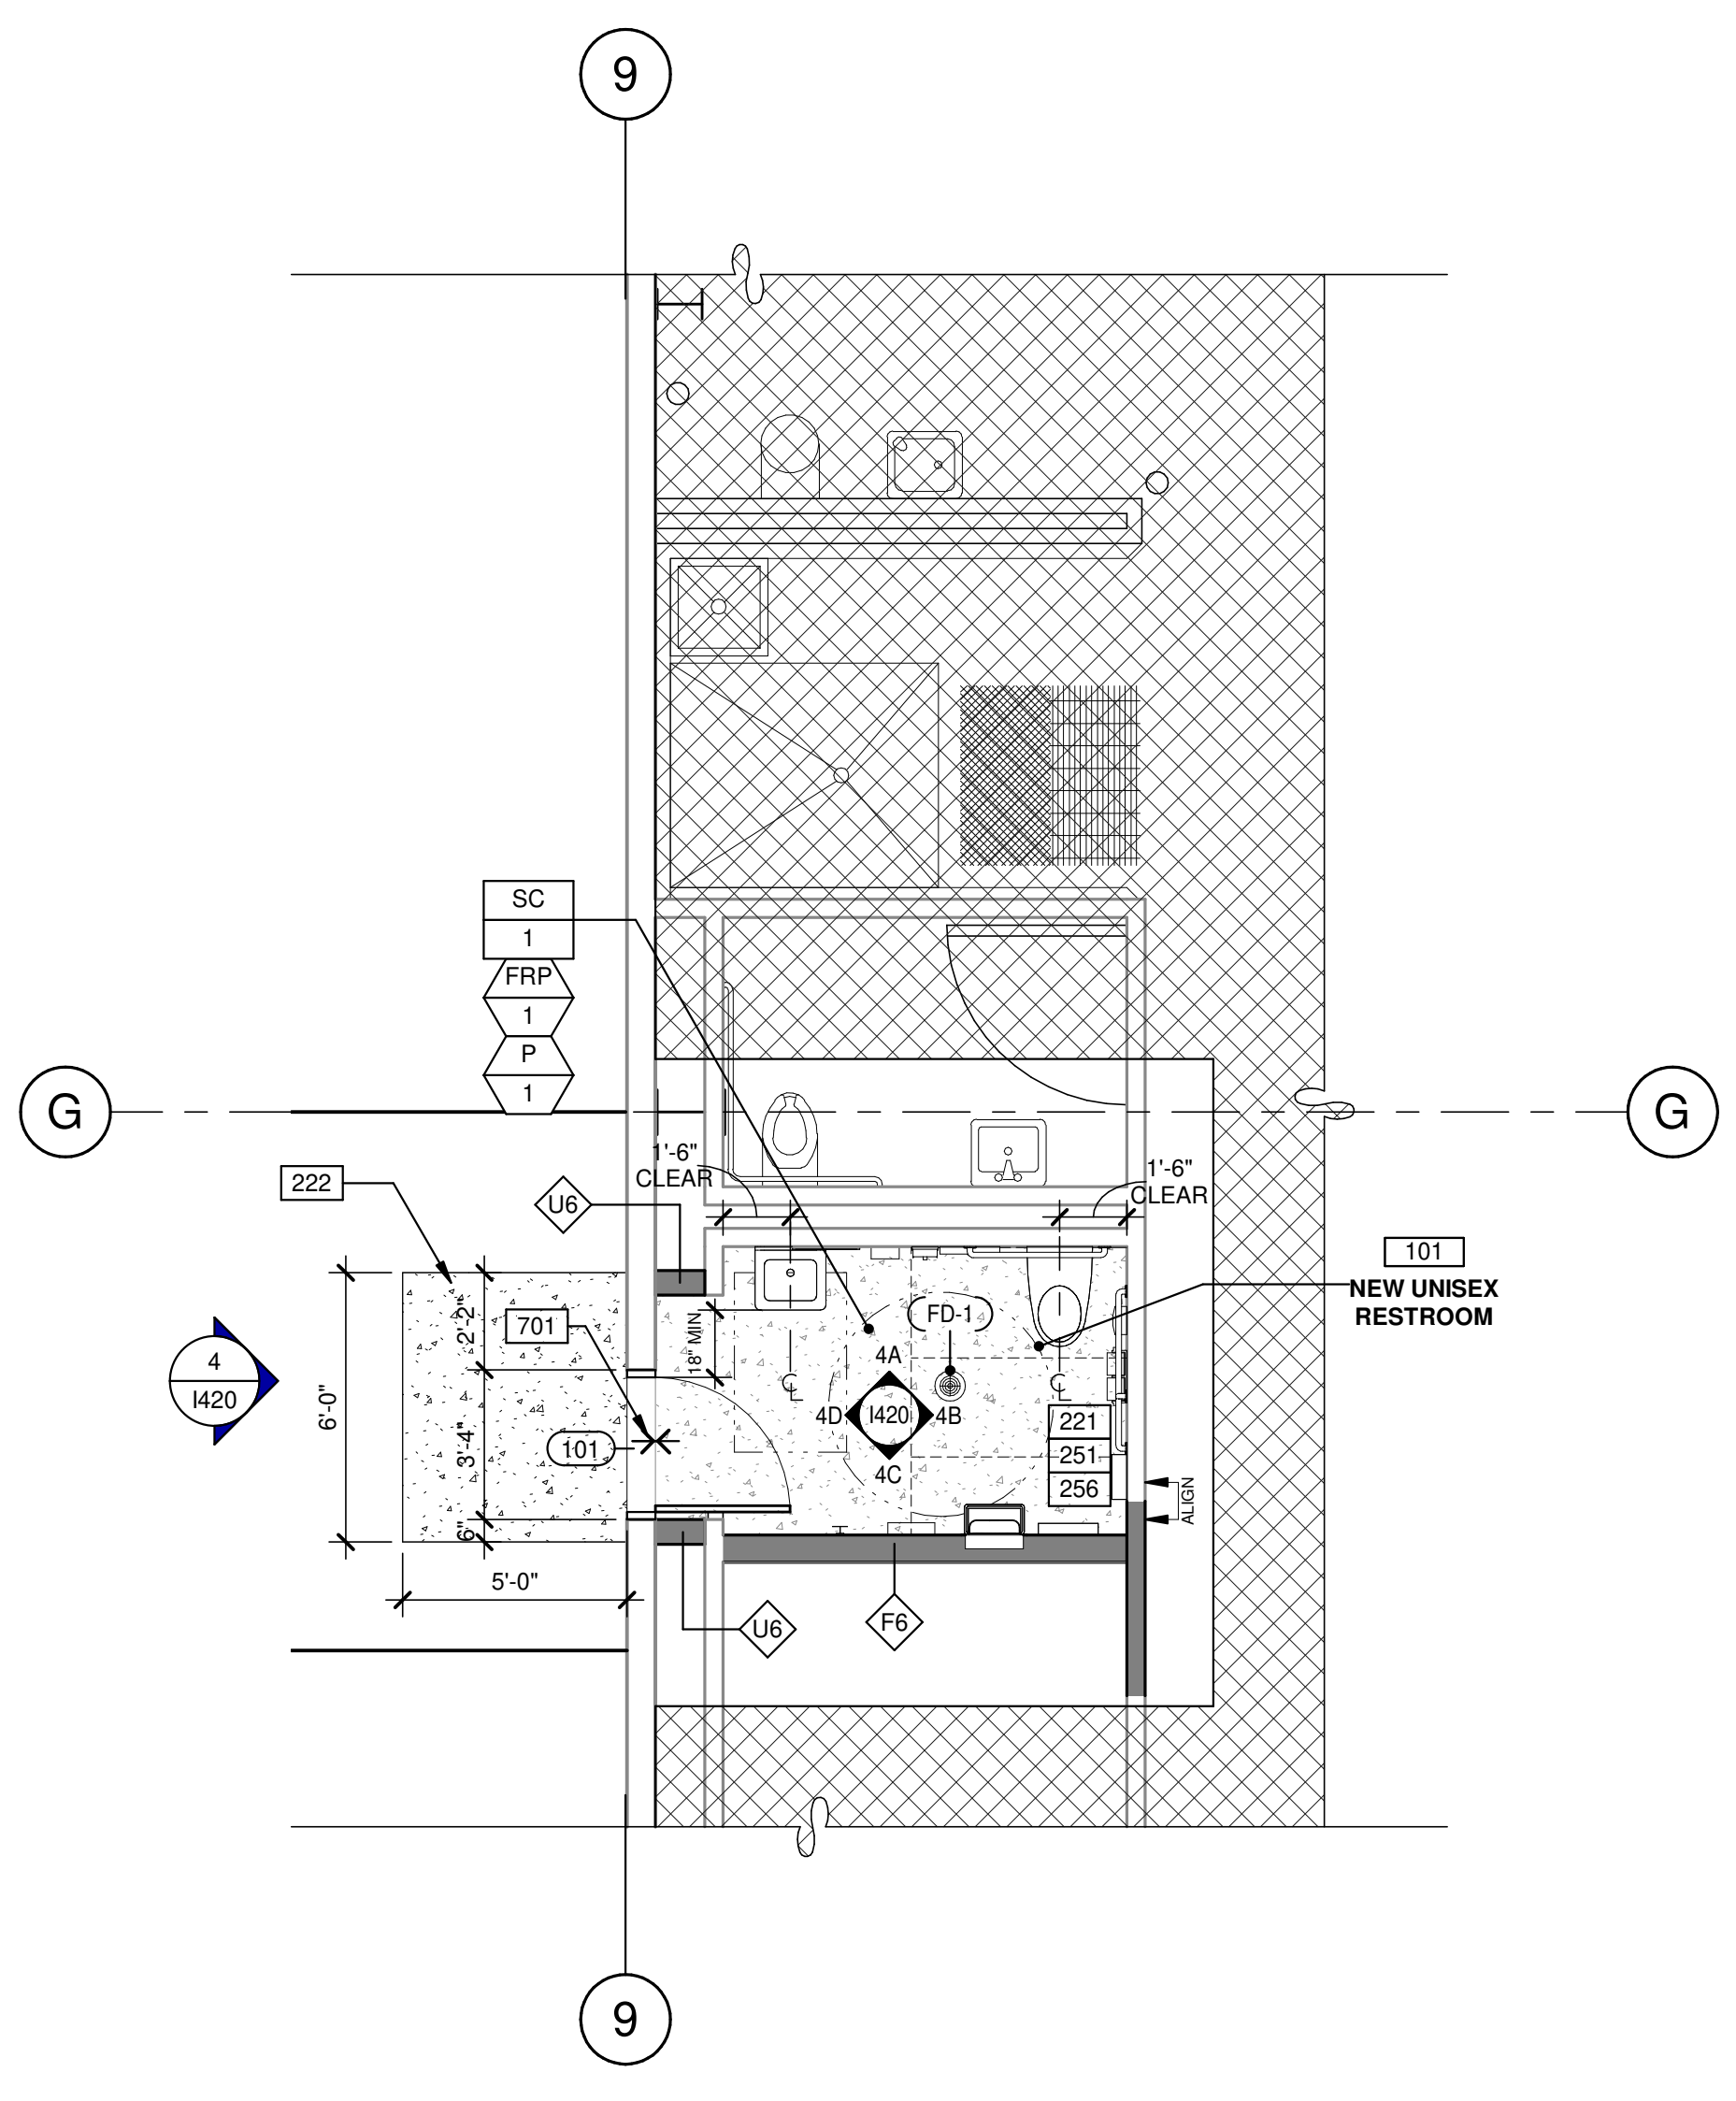

FLOOR AND FINISH PLAN
SCALE: 1/4" = 1'-0"

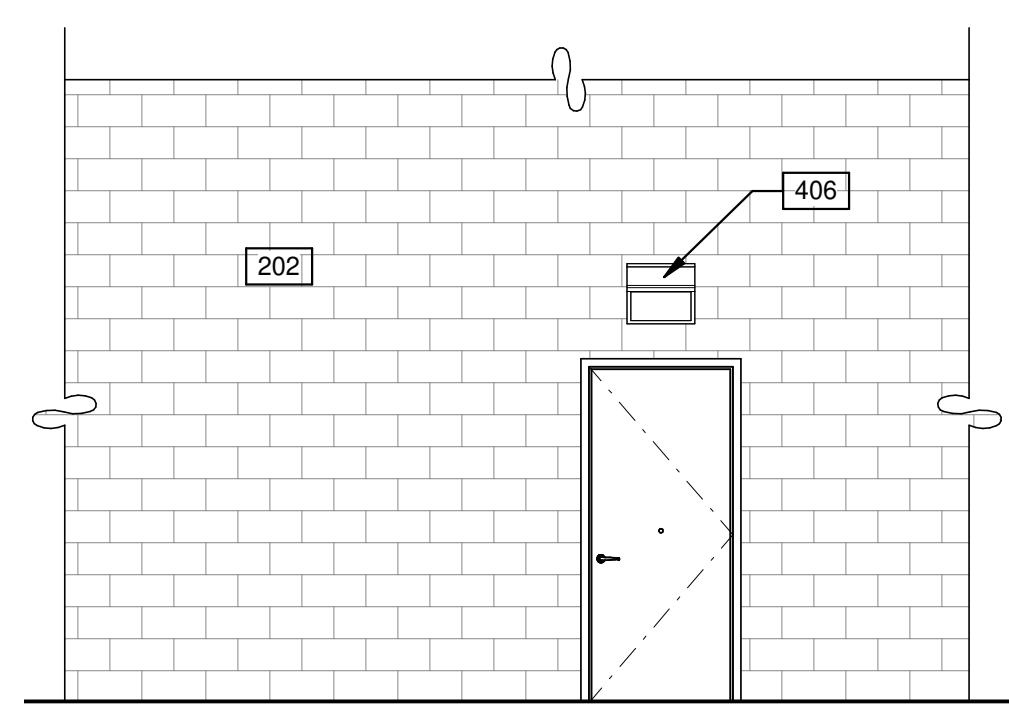

EXTERIOR ELEVATION
SCALE: 1/4" = 1'-0"

WARE MALCOMB
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3015 117th Ave NE, Suite #205
Bellevue, WA 98005
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19194 REGISTERED ARCHITECT
ADAM SEGALLA
STATE OF WASHINGTON

COSTCO WHOLESALE

**COSTCO FLEET RESTROOM
PUYALLUP WH0660
1201 39TH AVE SW,
PUYALLUP, WA. 98373-3803**

INTERIOR RESTROOM PLANS AND ELEVATIONS

DATE	PERMIT ISSUANCE	REMARKS
09/20/2024		

PA/PM: L LUCERO
DRAWN BY: A. M.
JOB NO.: SE24-0053-00

SHEET
I420
09/20/2024 4:57:42 PM

City of Puyallup
Development & Permitting Services
ISSUED PERMIT

Building	Planning
Engineering	Public Works
Fire	Traffic

FINISH SCHEDULE

FLOORING FINISHES													
SEALED CONCRETE													
MARK	PRODUCT TYPE	GENERAL LOCATION, U.O.N.	MANUFACTURER	COLLECTION/STYLE/#	COLOR/COLOR#	SIZE	INSTALLATION LAYOUT	BACKING/ FINISHING	ADHESIVE	NOTES	MARK		
SC-1	SEALED CONCRETE	RESTROOM FLEET FLOOR	N/A	N/A	NATURAL	N/A	FLAT	SEALED	N/A	SEALED	SC-1		
FLOOR TRANSITION													
MARK	PRODUCT TYPE	GENERAL LOCATION, U.O.N.	MANUFACTURER	COLLECTION/STYLE/#	COLOR/COLOR#	SIZE	PROFILE/TEXTURE	INSTALLATION LAYOUT	INSTALLATION METHOD	SEAMING	COLOR	NOTES	MARK
TR-1	Schluter	RESTROOM THRESHOLD	TBD	TBD	TBD	TBD	TBD	AT RESTROOM DOOR	TBD	TBD	TBD		TR-1
WALL FINISHES													
PAINT													
MARK	PRODUCT TYPE	GENERAL LOCATION, U.O.N.	MANUFACTURER	SERIES	COLOR/COLOR#	SHEEN	NOTES					MARK	
P-1	CEILING PAINT	RESTROOM CEILING	SHERWIN-WILLIAMS	PROMAR 200 B20-2600	SW 7003 'TOQUE WHITE'	EGG-SHELL						P-1	
WALL APPLICATION													
MARK	PRODUCT TYPE	GENERAL LOCATION, U.O.N.	MANUFACTURER	COLLECTION/STYLE/#	COLOR/COLOR#	SIZE	INSTALLATION LAYOUT	THICKNESS	GROUT	NOTES	MARK		
FRP-1	FIRE RETARDANT PLYWOOD	RESTROOM WALLS COVERING	TBD	TBD	TBD	FULL HEIGHT				FULL HEIGHT	FRP-1		
WALL BASE													
MARK	PRODUCT TYPE	GENERAL LOCATION, U.O.N.	MANUFACTURER	COLLECTION/STYLE/#	COLOR/COLOR#	SIZE	INSTALLATION LAYOUT	THICKNESS	GROUT	NOTES	MARK		
FT-1	Schluter - Dilex - Ahka	RESTROOM WALLS	Schluter	COVE-SHAPED PROFILE	TBD						FT-1		

LIGHT FIXTURE SCHEDULE

F.#	GENERAL TYPE	MOUNTING TYPE	NAME	MANUFACTURER	HOUSING/FINISHES/LENS DESCRIPTION	COLOR TEMP	CRI	NOTES
F-1	1'x4' FLUORESCENT FIXTURE	SURFACE MOUNTED	1'x4' FLUORESCENT FIXTURE	MAXLITE	MLFP14G420WCS	TBD	TBD	20W. WITH OCCUPANCY SENSOR
F-2	WALL PACK FIXTURE	SURFACE MOUNTED	WALL PACK	PER ELECTRICAL	PER ELECTRICAL	PER ELECTRICAL	PER ELECTRICAL	PER ELECTRICAL

RESTROOM ACCESSORIES


RA-#	TYPE	MANUFACTURER	MODEL NUMBER	FINISH	DESCRIPTION / NOTES
RA-1	GRAB BAR 18" X 1-1/2"	BOBRICK	B-6806118 (OR EQUAL)	SATIN-FINISH STAINLESS STEEL	W/ B-2583 CONCEALED ANCHOR PLATES
RA-2	GRAB BAR 36" X 1-1/2"	BOBRICK	B-680636 (OR EQUAL)	SATIN-FINISH STAINLESS STEEL	W/ B-2583 CONCEALED ANCHOR PLATES
RA-3	GRAB BAR 42" X 1-1/2"	BOBRICK	B-680648 (OR EQUAL)	SATIN-FINISH STAINLESS STEEL	W/ B-2583 CONCEALED ANCHOR PLATES
RA-4	DOUBLE-ROLL TOILET TISSUE DISPENSER	BOBRICK	B-2740 (OR EQUAL)	SATIN-FINISH STAINLESS STEEL	SURFACE MOUNTED
RA-5	NAPKIN/TAMPON DISPOSAL	BOBRICK	B-270 (OR EQUAL)	SATIN-FINISH STAINLESS STEEL	SURFACE MOUNTED, OWNER/TENANT TO APPROVE COIN CHARGE.
RA-6	SEAT COVER DISPENSER	BOBRICK	B-221 (OR EQUAL)	SATIN-FINISH STAINLESS STEEL	WALL MOUNTED
RA-7	MIRROR 1'-6" X 2'-6"	BOBRICK	B-1651 1824 (OR EQUAL)	BEVELED EDGES	WALL MOUNTED
RA-8	SOAP DISPENSER	BOBRICK	B-4112 (OR EQUAL)	SATIN-FINISH STAINLESS STEEL	WALL MOUNTED
RA-9	PAPER TOWEL DISPENSER	BOBRICK	B-262	SATIN-FINISH STAINLESS STEEL	RECESSED
RA-10	DOUBLE COAT HOOK	BOBRICK	B-6727	SATIN-FINISH STAINLESS STEEL	WALL MOUNTED
RA-12	SHELF	TBD	TBD	SATIN-FINISH STAINLESS STEEL	WALL MOUNTED

PLUMBING FIXTURES

#	FIXTURE TYPE	MANUFACTURER	MODEL NUMBER	FINISH	DESCRIPTION / NOTES
FD-1	FLOOR DRAIN	ZURN	ZN-415-P	IRON	TYPE N STRAINER, ADJUSTABLE STRAINER HEAR FLOOR DRAIN WITH DUGO-COATED CAST IRON BODY, FLASHING COLLAR, NICKEL BRONZE ADJ. HEAD, WASTE 2", VENT. 2"
LAV-1	LAVATORY - WALL HUNG	KOHLER	K-2005-0	WHITE VITREOUS CHINA	LAVATORY WITH BACK 21 1/4" LENGTH, 18 1/8" WIDTH, WALL MOUNTED WITH HANGERS, DRILLED FOR CONCEALED ARN CARRIER, OPTIONAL SOAP DISPENSER HOLE ON LEFT OR RIGHT. PROVIDE CHICAGO #802A MODEL FOR FAUCET EQUIPMENT.
RH-1	ROOM HEATER	TBD	TBD	TBD	REFER TO MECHANICAL DRAWINGS
WC-1	ACCESSIBLE WATER CLOSET- WALL MOUNTED W/ FLUSH VALVE	ZURN	Z5615 258.00.00.00 Z5000AV-HET Z5955SS-EL	WHITE VITREOUS CHINA	WALL MOUNTED TOILET WITH FLUSH VALVE AT OPEN SIDE
WH-1	WATER HEATER - INSTA-HOT	EEMAX	EMT 2.5	WATER PROOF	2.5 GALLON ELECTRIC WATER HEATER, 1.2KW, 120V, 10 AMP, 6.0 GPH, 100 DEGREES RISE.

DOOR SCHEDULE

DOOR NO.	ROOM NAME	DOOR TYPE ELEVATION	DOOR SIZE		DOOR SPECIFICATION	FRAME SPECIFICATION	FIRE RATING (MINUTES)	HARDWARE GROUP	KEYPAD	KICKPLATES	DOOR KEYNOTES	COMMENTS
			WIDTH	HEIGHT								
101	NEW UNISEX RESTROOM	F1	3'-0"	7'-0"	D1	FR-1	NA	HW-45	YES	YES	1,2,3,4	

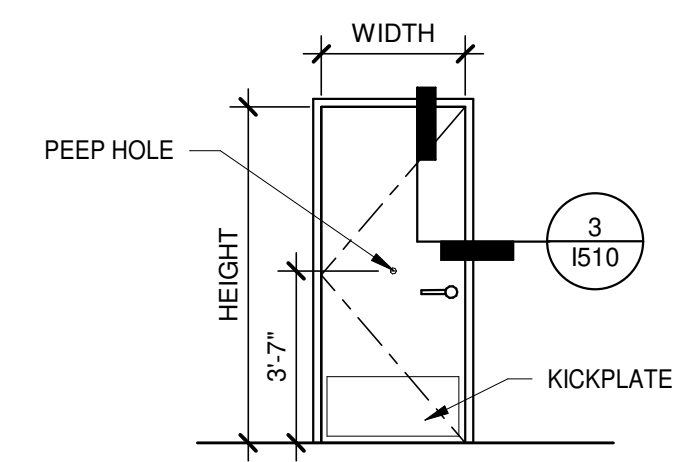

F1
SOLID FLUSH

HARDWARE SPECIFICATIONS	DOOR AND FRAME SPECIFICATIONS	DOOR KEYNOTES	GENERAL NOTES
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HW-45 SINGLE, INTERIOR AND EXTERIOR FLEET RESTROOM EACH DOOR SHALL HAVE: MANUFACTURER 2 HINGES: IVES 58B1 652 1 MECHANICAL PUSH/BOTTOM LOCKSET: KABA SIMPLEX 5000 1 SURFACE CLOSER: SATIN CHROME FINISH LCN 4440XP SCUSH AL TBWMS 689 1 WEATHERSTRIP SET: PEMKO 290APK AL 1 KICKPLATE: ROCKWOOD K1050 10" x 2" LTDW 630 1 DOOR SWEEP: PEMKO 315CN AL 1 RAIN DRIP CAP: PEMKO 346C AL 1 THRESHOLD: PEMKO 171A x FHSL25 AL 1 DOOR VIEWER: PEEKO HOME PROTECTOR 585 x 628	D1 DOOR: STEEL DOOR MANUFACTURER: T.B.D. STYLE/SERIES: T.B.D. CONSTRUCTION: STEEL FINISH: PAINT T.B.D. THICKNESS: 1 3/4" F1 FRAME: STEEL MANUFACTURER: TIMELY MATERIAL: STEEL FINISH: ALUMITONE # SC108	1. PREPARE DOOR TO RECEIVE KEYPAD. 2. DOOR CLOSER PER DOOR MANUFACTURER. 3. WIDE ANGLE PEEPHOLE TO BE MOUNTED CENTERED ON THE DOOR AT 48" HEIGHT. 4. KICKPLATE TO BE INSTALLED ON PUSH SIDE OF DOOR.	1. SEE SHEET 1010 FOR GENERAL DOOR NOTES. 2. ALL HARDWARE SHALL MEET ALL APPLICABLE FEDERAL, STATE AND LOCAL BUILDING CODES. 3. ALL DOOR FRAMES TO BE FACTORY FINISHED, U.O.N.
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18194 REGISTERED ARCHITECT
ADAM SEGALLA
STATE OF WASHINGTON



COSTCO FLEET RESTROOM
PUYALLUP WH0660
1201 39TH AVE SW,
PUYALLUP, WA. 98373-3803

SCHEDULES	
DATE	REMARKS
09/20/2024	PERMIT ISSUANCE

P.A.P.M.: L LUCERO
DRAWN BY: A. M.
JOB NO.: SE424-0053-00

SHEET
1620
9/20/2024 8:27:07 AM

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GENERAL NOTE
REMODEL

THE FOLLOWING NOTES APPLY UNLESS NOTED OTHERWISE - ASTM'S NOTED ARE TO BE LATEST EDITION.

- 1. DESCRIPTION
Building Name & Site Location - Costco Wholesale - Puyallup, WA
2. DESIGN CODE AND STANDARDS
Applicable Code (Edition/Name) - 2021 International Building Code (IBC)
Other documents referenced by these notes shall be the specific edition referenced by the building code specified above, or if not specified, shall be the latest edition.
Code supplement & Date - ASCE 7-16
3. DESIGN LOADS
a. Ceiling Live Load 20 psf
b. Seismic Risk Category II
Ss = 1.268, S1 = 0.438, Ie = 1.0, Site Class "D" and
Sps = 0.845, S11 = 0.544
Seismic Design Category = "D"
Risk Category II
c. Wind Load
Basic wind speed (3 sec. gust) VULT = 110 mph, VASD = 85 mph
Exposure C
Kz1=1.0
Kd=1.0
IBC Load Cases per sec. 1605.2.1 or 1605.3.1 only Kp = 0.85
Importance factor 1.0.
All Code required load combinations are to be used in the building design.
d. Load Combinations

OSHA STANDARDS
THE GENERAL CONTRACTOR SHALL BE RESPONSIBLE FOR ALL PROVISIONS OF THE CURRENT OSHA STANDARDS. THE GENERAL CONTRACTOR SHALL REVIEW THESE STRUCTURAL DRAWINGS FOR ANY NONCOMPLIANCE WITH OSHA STANDARDS. TAKING INTO ACCOUNT THE GENERAL CONTRACTOR'S MEANS AND METHODS. THE GENERAL CONTRACTOR SHALL INFORM ENV OF ANY NONCOMPLIANCE SO THE DRAWINGS MAY BE MODIFIED FOR COMPLIANCE PRIOR TO CONSTRUCTION. THE GENERAL CONTRACTOR IS TOTALLY RESPONSIBLE FOR MEANS AND METHODS AS WELL AS JOBSITE SAFETY ON THIS PROJECT.


CONCRETE
FC=4000 PSI, @ 28 DAYS 5-1/2 SACKS MINIMUM CEMENT PER CUBIC YARD FOR ALL CONCRETE SLABS.
F'c=3000 PSI, @ 28 DAYS 5-1/2 SACKS MINIMUM CEMENT PER CUBIC YARD FOR ALL OTHER.
USE TYPE III/II CEMENT. USE TYPE III (HIGH EARLY STRENGTH) CEMENT IS ACCEPTABLE FOR SCHEDULE. FOR SPECIAL CONDITIONS ANOTHER TYPE CEMENT MAY BE REQUIRED. SUBMIT FOR APPROVAL. ULTIMATE STRENGTH DESIGN METHOD USED. MIXING AND PLACING OF ALL CONCRETE AND SELECTION OF MATERIALS SHALL BE IN ACCORDANCE WITH THE ACI CODE 318. PROPORTIONING OF AGGREGATE TO CEMENT SHALL BE SUCH AS TO PRODUCE A DENSE WORKABLE MIX WITH 4" MAXIMUM SLUMP (UNLESS SUPERPLASTICIZERS ARE USED) WHICH CAN BE PLACED WITHOUT SEGREGATION OR EXCESS FREE SURFACE WATER. FOR ADMIXTURES, SEE SPECIFICATIONS. MAXIMUM WATER/CEMENT RATIO = 0.49. 3/4" CHAMFER ALL EXPOSED EDGES, UNLESS INDICATED OTHERWISE ON ARCHITECTURAL DRAWINGS. WATER CURING SHALL BE USED. AIR ENTRAIN ALL HORIZONTAL CONCRETE EXPOSED TO WEATHER WITH 3% TO 6% AIR BY VOLUME. DO NOT USE AIR ENTRAINMENT FOR INTERIOR SLABS ON GRADE. LIMIT WATER CEMENT RATIO TO 0.45 AND USE TYPE V CEMENT WHERE SOILS WATER SOLUBLE SULFATE EXCEEDS 0.20 PERCENT BY WT. ADD NO WATER TO CONCRETE AT SITE. IF INCREASED WORKABILITY IS REQUIRED, CONTRACTOR IS TO SUBMIT A MIX DESIGN THAT WILL ALLOW THE ADDITION OF A FIXED AMOUNT WATER REDUCING AGENT OR A FIXED AMOUNT OF SUPER-PLASTICIZER AT THE CONCRETE PLANT.
A. DO NOT USE FLY ASH, SLAG OR OTHER SUPPLEMENTARY CEMENTITIOUS MATERIALS IN CONCRETE EXCLUDING TO VIEW INCLUDING, BUT NOT LIMITED TO, INTERIOR FLOOR SLABS, ENTRY CANOPY SLABS, LOADING DOCK SLABS AND STAIRS, STEM WALLS, FOUNDATION WALLS, GRADE COLUMNS OR PILASTERS, AND EXTERIOR WALKS /PADS.
1. FLY ASH, SLAG AND OTHER SUPPLEMENTARY CEMENTITIOUS MATERIALS MAY BE USED ONLY IN BELOW GRADE CONCRETE SUCH AS FOOTINGS, FOUNDATION WALLS, GRADE BEAMS, AND SIMILAR CONCEALED LOCATIONS.
2. FLY ASH, SLAG AND OTHER SUPPLEMENTARY CEMENTITIOUS MATERIALS MAY BE USED IF DETERMINED THAT THE USE OF SUPPLEMENTARY CEMENTITIOUS MATERIALS WOULD IMPROVE RESISTANCE TO ALKALI-AGGREGATE REACTIVITY IN CONCRETE. OBTAIN WRITTEN APPROVAL FROM OWNER PRIOR TO USE.
ACI 308R IS TO BE FOLLOWED FOR COLD WEATHER CONCRETING. ACI 305R IS TO BE FOLLOWED FOR HOT WEATHER CONCRETING. THE TESTING LAB MUST APPROVE THE CONTRACTORS METHOD OF COMPLIANCE AND CERTIFY THEIR APPROVAL WITH EACH CONCRETE TEST CYLINDER THEY CAST. TESTING LAB TO NOTIFY THE ARCHITECT IMMEDIATELY BY FAX AND PHONE OF ANY NONCOMPLIANCE.

REINFORCING STEEL
ALL CONCRETE REINFORCING STEEL SHALL BE DEFORMED PER ASTM A615, GRADE 60 (fy=60,000 psi) LAP CONTINUOUS REINFORCING BARS 44 BAR DIAMETERS, 1" MINIMUM UNLESS NOTED OTHERWISE. CORNER BARS (1'-10" BEND) TO BE PROVIDED FOR ALL HORIZONTAL REINFORCEMENT. DETAIL STEEL IN ACCORDANCE WITH "ACI MANUAL OF STANDARD PRACTICE OF DETAILING REINFORCED CONCRETE STRUCTURES". WELDED WIRE FABRIC (W/F) TO CONFORM WITH ASTM A185. REINFORCING HOOKS TO COMPLY WITH STANDARD ACI HOOKS.
COVER TO MAIN REINFORCEMENT TO BE:
BOTTOM OF FOOTINGS 3 INCHES
FORMED SURFACES WEATHER & EARTH FACE 1-1/2 INCHES
FORMED SURFACES INTERIOR FACE 3/4 INCHES
SHOULD THE REINFORCING SUPPLIER AND/OR DETAILER CHOOSE TO USE METRIC, EACH AND EVERY REBAR CALLOUT MUST BE INDICATED WITH BOTH SIZES WITH THE IMPERIAL SIZE FIRST THUS: #4#13 NO EXCEPTIONS. A CONVERSION TABLE ALONE IS UNACCEPTABLE. WE WILL CHECK THE SHOP DRAWINGS TO THE IMPERIAL SIZES ONLY. IT WILL BE THE RESPONSIBILITY OF THE REINFORCING SUPPLIER AND THE GENERAL CONTRACTOR TO VERIFY THAT ALL CONVERSIONS TO METRIC SUPPLY AT LEAST THE SAME AREA OF STEEL AS THE IMPERIAL.

LIGHT GAGE STEEL FRAMING: VERIFY SIZE, GAGE AND SPACING. INSPECT WELDING. VERIFY CERTIFICATION OF WELDERS.


SPECIAL CONDITIONS
CONTRACTOR SHALL VERIFY ALL DIMENSIONS IN THE FIELD AND SHALL PROVIDE ADEQUATE SHORING AND BRACING OF ALL STRUCTURAL MEMBERS DURING CONSTRUCTION. CONTRACTOR SHALL NOTIFY ENGINEER OF ALL FIELD CHANGES PRIOR TO INSTALLATION.
NOTE TO MECHANICAL AND ELECTRICAL TRADES
CONTRACTOR SHALL SUBMIT PLANS SHOWING LOCATION, LOAD AND ANCHORAGE OF ALL HANGERS SUPPORTING ANY MECHANICAL, ELECTRICAL, PLUMBING OR SPRINKLER LOADS IN EXCESS OF 50 POUNDS. ANY ROOF MOUNTED EQUIPMENT SHALL BE INCLUDED IN THESE PLANS AND SHALL SHOW LOADS AND LOCATIONS. THESE SHALL BE SUBMITTED TO ENGINEERS NORTHWEST FOR REVIEW PRIOR TO INSTALLATION OF ANY OF THIS EQUIPMENT. SEE DETAILS ON DRAWING SS-1 FOR SUPPORTING LOADS FROM ROOF JOISTS. ALL DETAILS OF CONNECTIONS TO THE STRUCTURE FOR EQUIPMENT SHALL BE BY THE SUPPLIER OF THAT EQUIPMENT. THE BUILDING DEPARTMENT REQUIRES A SUBMITTAL FOR PLAN CHECK REGARDING THE DESIGN OF THESE DETAILS. IT IS THE RESPONSIBILITY OF THE EQUIPMENT SUPPLIER TO PROVIDE THIS SUBMITTAL.

ABBREVIATIONS
ARCH ARCHITECT
BAL BALANCE
B OR BOT. BOTTOM
BTWN. BETWEEN
BLDG. BUILDING
BRG. BEARING
C.I.P. CAST IN PLACE
C.J. CONSTRUCTION JOINT
CLR. CENTERLINE
CMU CONCRETE MASONRY UNIT
COL. COLUMN
COND. CONCRETE
C.S.J. CLOSURE STRIP JOINT
E.A. EACH
E.E. EACH END
E.F. EACH FACE
E.J. EXPANSION JOINT
EL. OR ELEV. ELEVATION
E.N.W. OR ENW. ENGINEERS NORTHWEST
EQ. EQUAL
E.S. EACH SIDE
E.W. EACH WAY
F.O.C. FACE OF CONCRETE
F.O.S. FACE OF STUD
F.O.W. FACE OF WALL
FTG. FOOTING
GA. GAGE
GALV. HOT DIP GALVANIZED
G.W.B. GYPSUM WALL BOARD
H. OR HORIZ. HORIZONTAL
I.B.A. INTERNATIONAL BUILDING CODE
I.C.C. INTERNATIONAL CODE COUNCIL
I.F. INSIDE FACE
INC. INCLUDING
K. KIP (1000 POUNDS)
L.W. LONG WAY
M.B.S. METAL BLDG SUPPLIER
N.F. NEAR FACE
N.T.S. NOT TO SCALE
OR ON CENTER
O.F. OUTSIDE FACE
O.S. OUTSIDE
O.T.O. OUT TO OUT
PL. PLATE
REINF. REINFORCING
REMAIN. REMAINDER
R.O. ROUGH OPENING
SECT. SECTIONS
SIM. SIMILAR
S.J. SHRINKAGE JOINT
S.O.G. SLAB ON GRADE
STL. STEEL
SW. SHEARWALL
SYMM. SYMMETRICAL
T.O.B. TOP OF BEAM
T.O.F. TOP OF FOOTING
T.O.S. TOP OF STEEL
T.O.S. TOP OF SLAB
T.O.W. TOP OF WALL
TYP. TYPICAL AT ALL SIMILAR PLACES
UNL.G. UNLESS NOTED OTHERWISE
V.E.F. VERTICAL EACH FACE
VERT. VERTICAL
V.F.F. VERTICAL FAR FACE
V.F. VERTICAL INSIDE FACE
V.N.F. VERTICAL NEAR FACE
V.N.O. VERTICAL OUTSIDE FACE
W/ WITH
W/O. WITH OUT
W.H.S. WELD HEAD STUD
@ AT

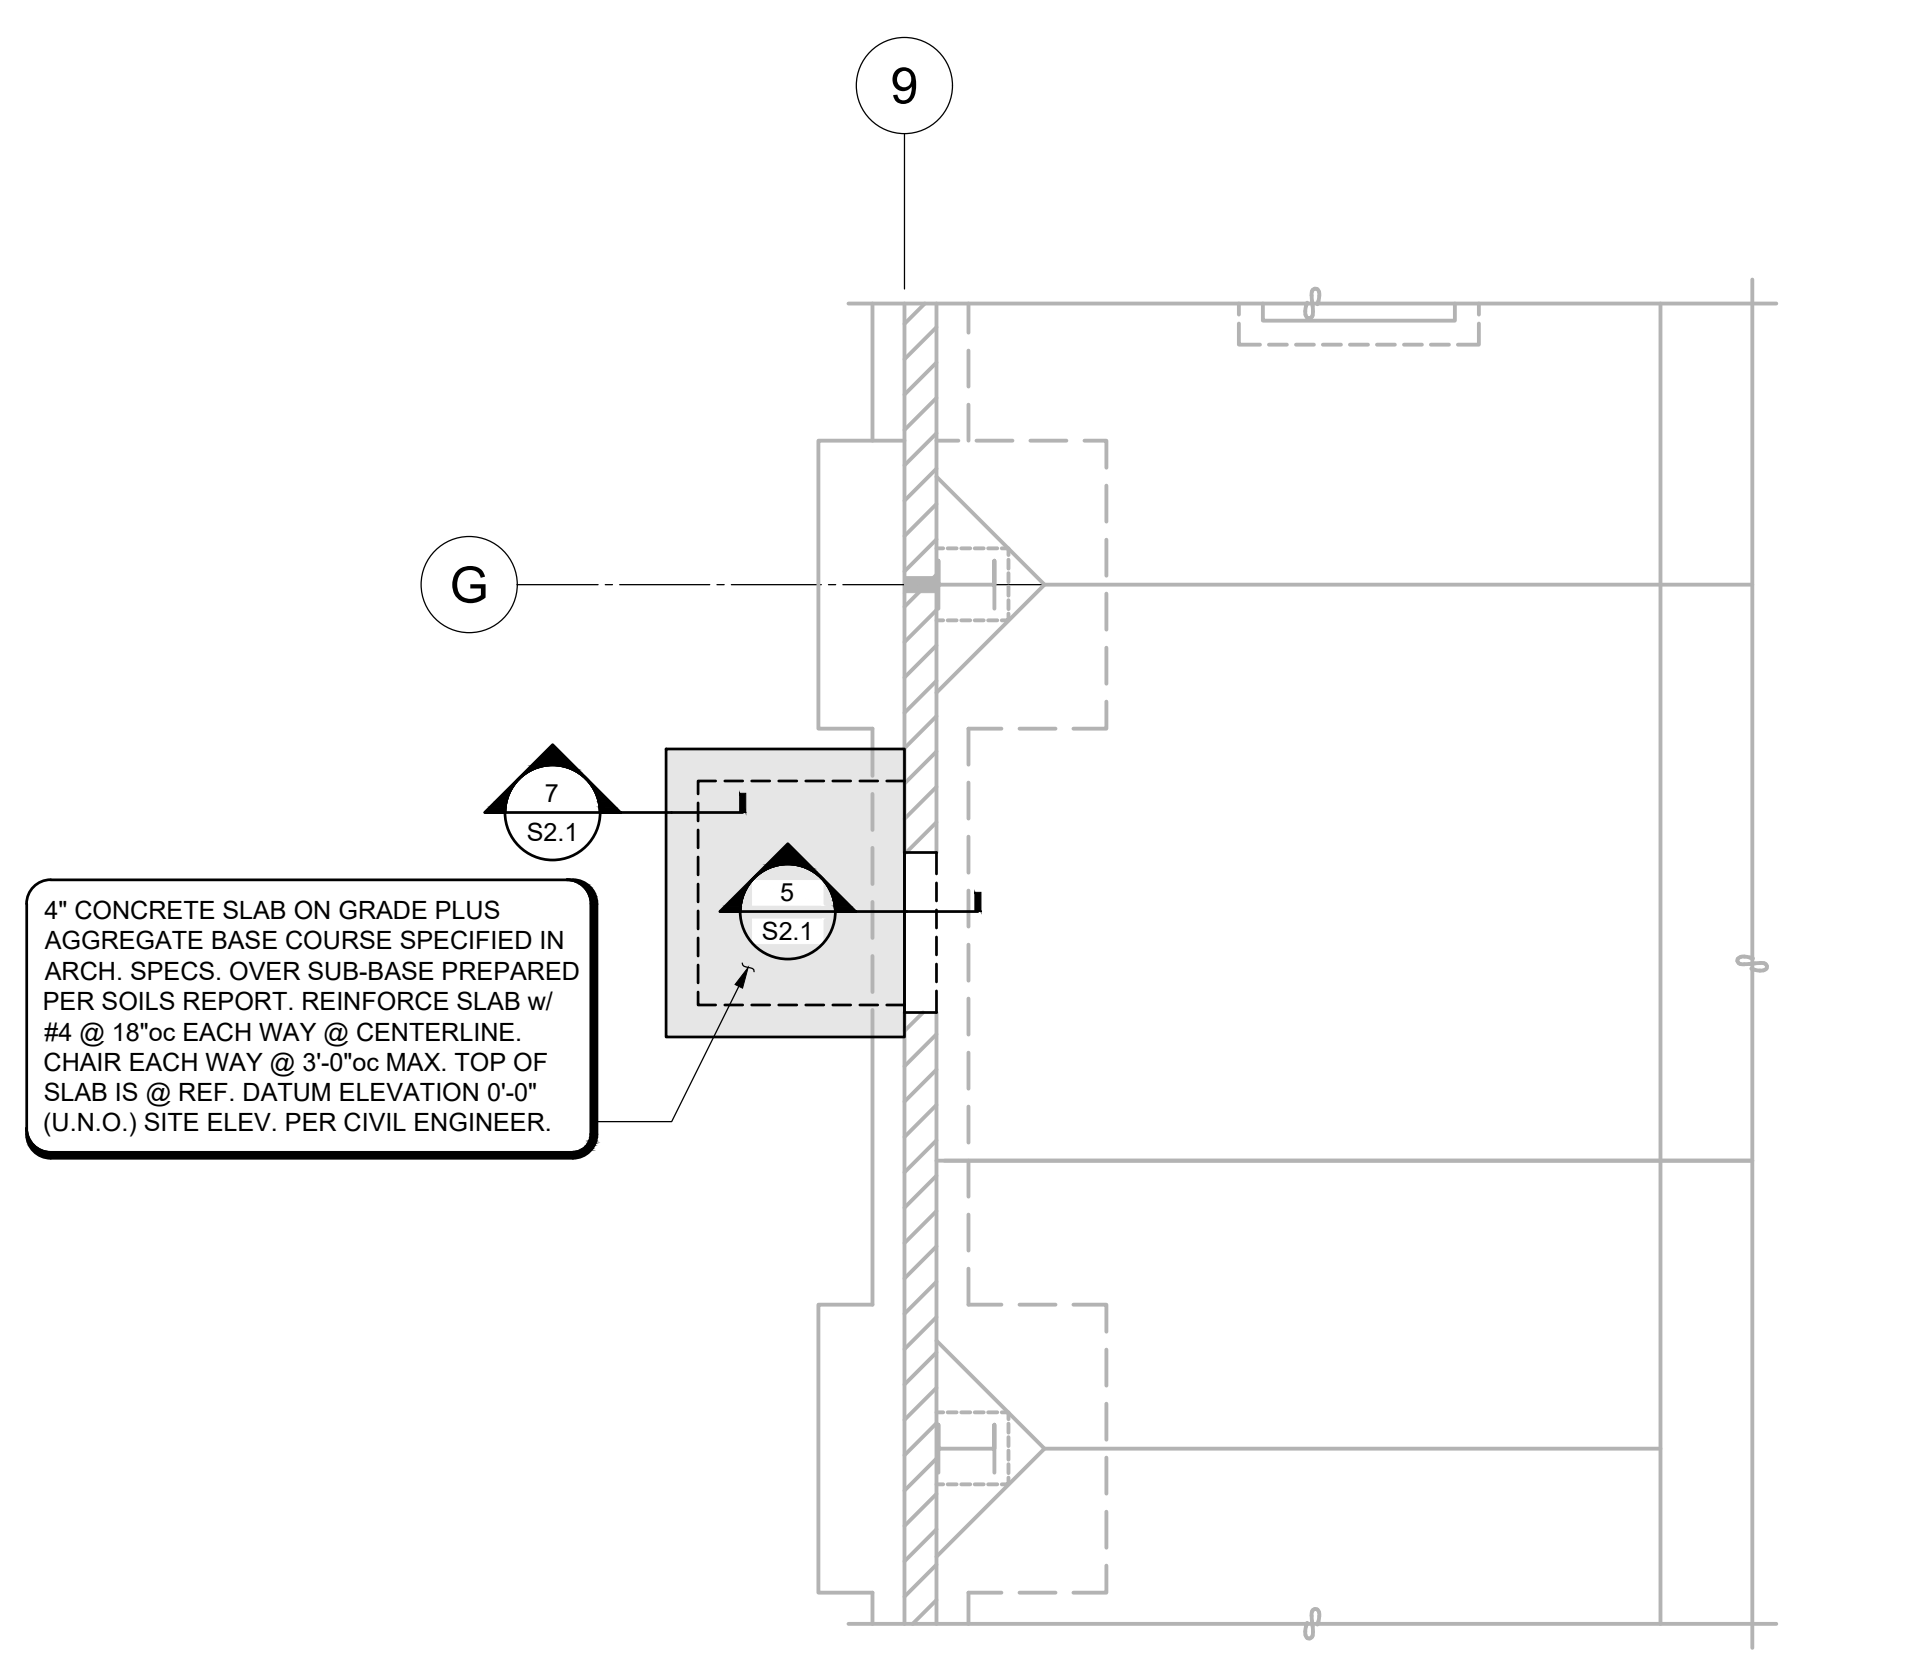

1 FLEET RESTROOM SITE PLAN

- NOTES:
1. ALL ITEMS ARE EXISTING (E) UNLESS NOTED AS NEW (N).
2. FIELD VERIFY ALL DIMENSIONS AND EXISTING CONDITIONS PRIOR TO CONSTRUCTION. NOTIFY ENV IF EXISTING DIMENSIONS AND EXISTING CONDITIONS ARE NOT AS SHOWN ON PLANS AND SECTIONS.
3. VERIFY ALL DIMENSIONS w/ ARCH.

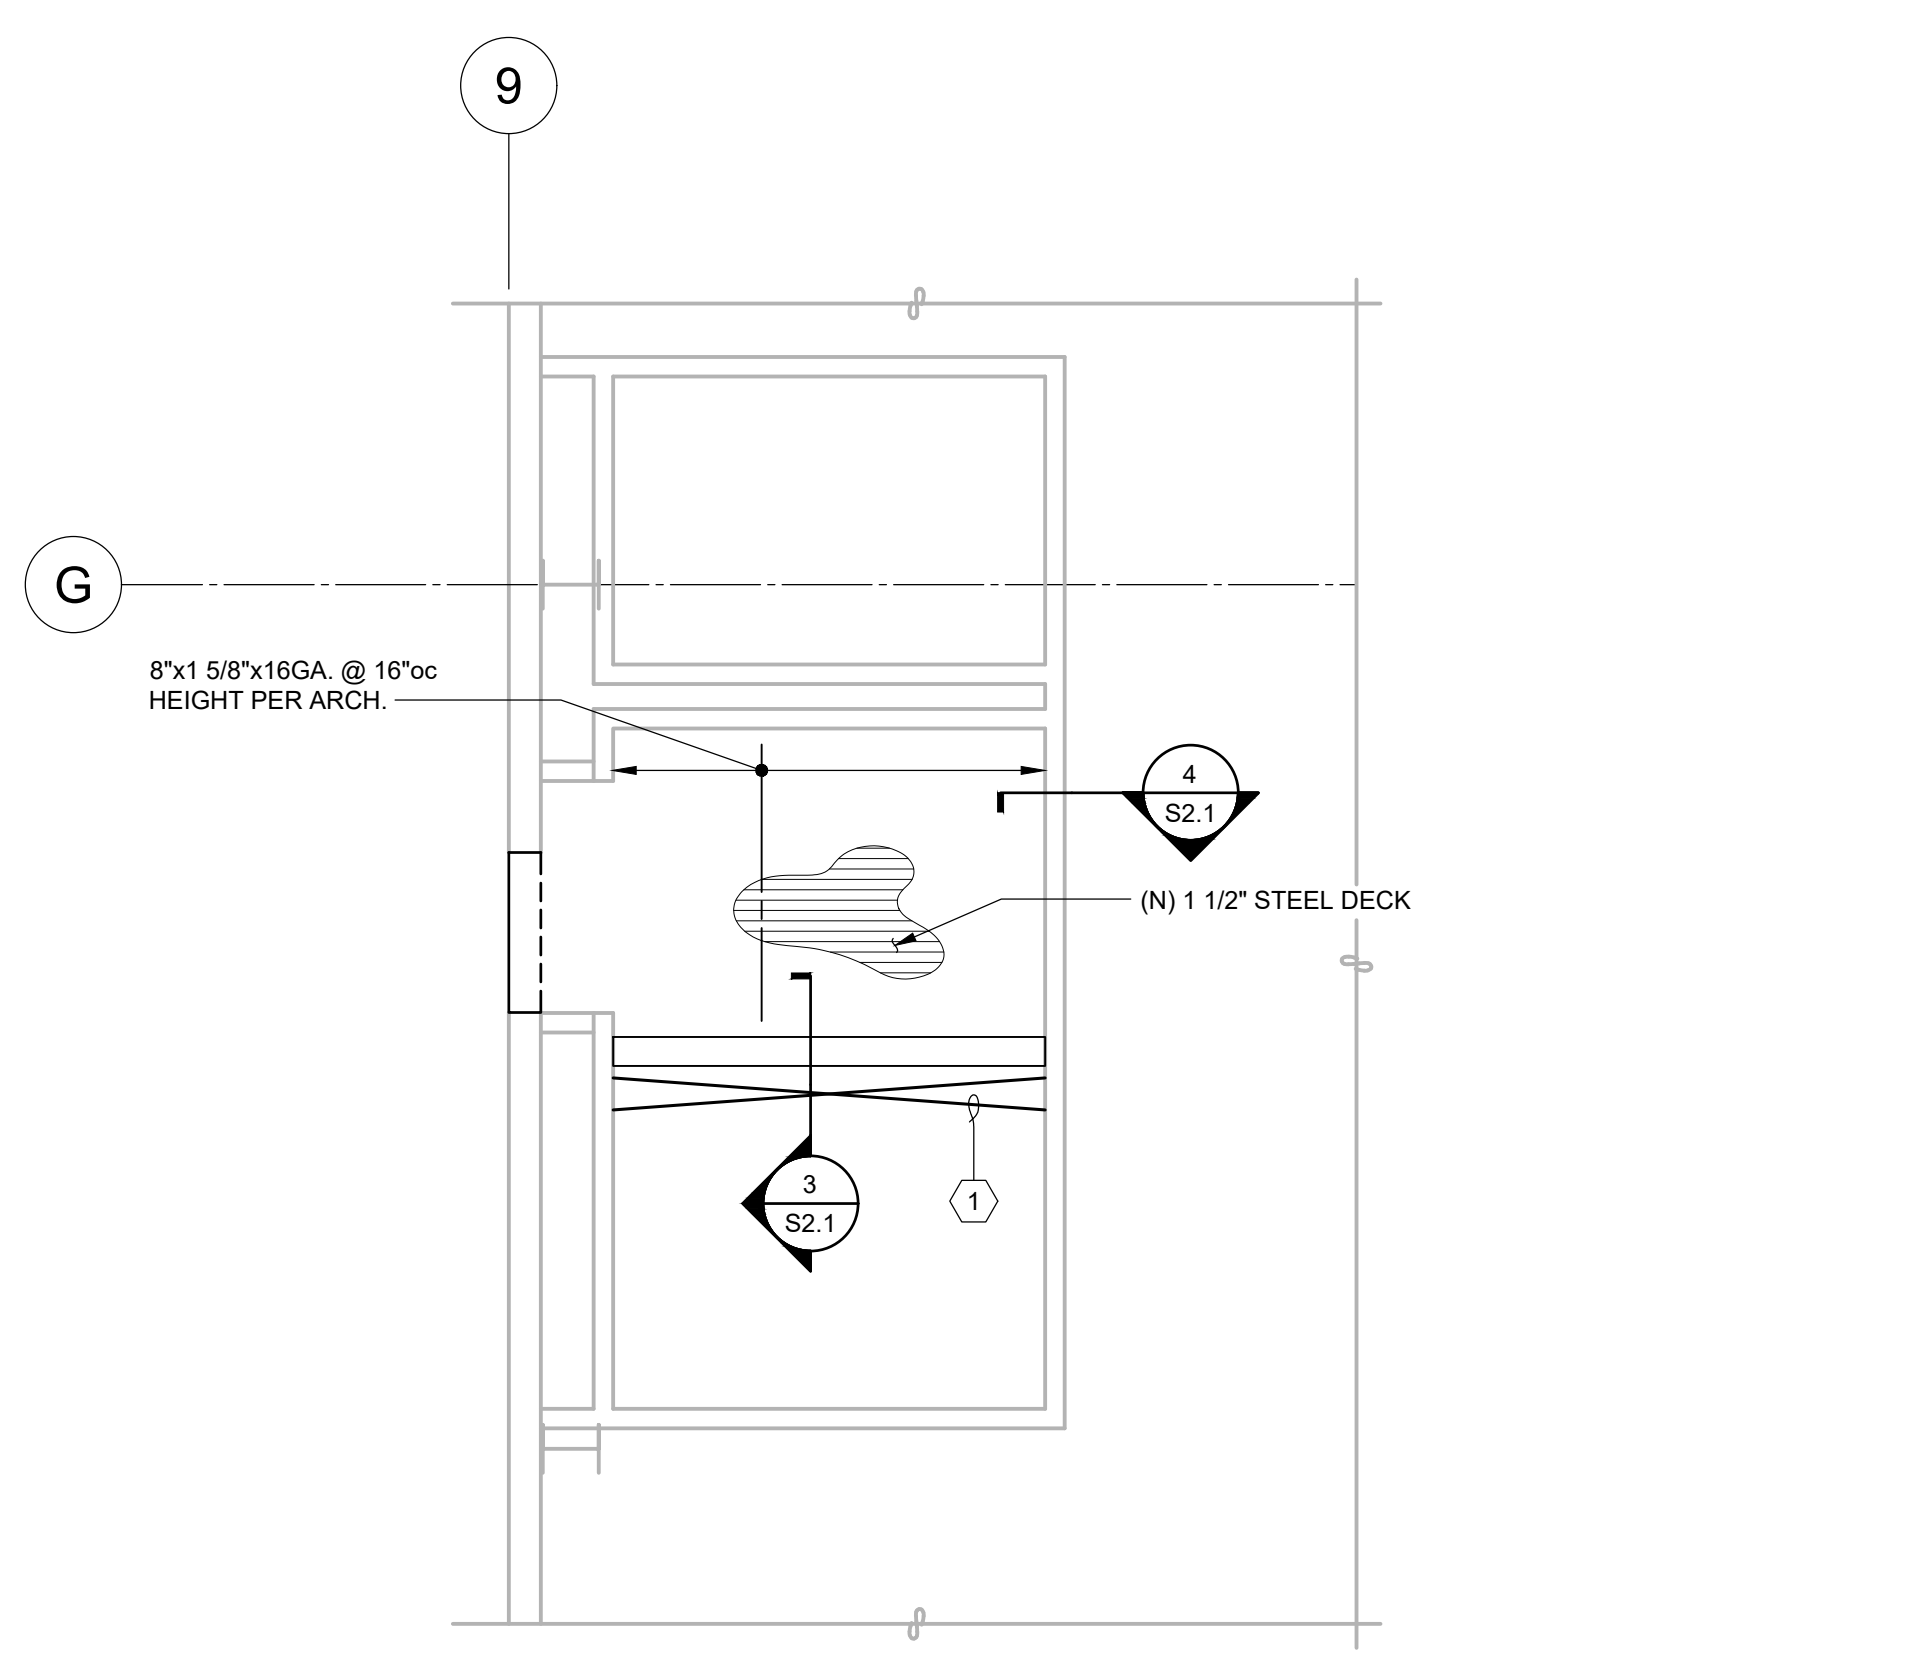

2 FLEET RESTROOM FRAMING PLAN

- NOTES:
1. ALL ITEMS ARE EXISTING (E) UNLESS NOTED AS NEW (N).
2. FIELD VERIFY ALL DIMENSIONS AND EXISTING CONDITIONS PRIOR TO CONSTRUCTION. NOTIFY ENV IF EXISTING DIMENSIONS AND EXISTING CONDITIONS ARE NOT AS SHOWN ON PLANS AND SECTIONS.
3. VERIFY ALL DIMENSIONS w/ ARCH.

LIGHT GAGE & MISC. PARTS SCHEDULE

Table with columns: ITEM, CALLOUT, MINIMUM PROPERTIES (Fy, I, S, A, ry), and *APPROVED SUPPLIERS & THEIR CALLOUT FOR THESE ITEMS (SSMA I.C.C. ESR-3084P).

- NOTES:
1.) SUBSTITUTION OF OTHER SUPPLIERS FOR THESE ITEMS NOT ALLOWED.
** THESE JOIST & TRACK MEMBERS TO BE UNPUNCHED.
2.) SINGLE FRAMING MEMBER SHOWN THUS: [Symbol]
3.) DOUBLE FRAMING MEMBER SHOWN THUS: [Symbol]

THICKNESS OF STEEL COMPONENTS 1

Table with columns: GAGE, DESIGN THICKNESS, and MINIMUM THICKNESS 2.

- NOTES:
1.) UNCOATED STEEL THICKNESS. THICKNESS IS FOR CARBON SHEET STEEL.
2.) MINIMUM THICKNESS REPRESENTS 95% OF DESIGN THICKNESS AND IS THE MINIMUM ACCEPTABLE THICKNESS DELIVERED TO THE JOB SITE BASED ON SECTION A2.4 OF THE 2007 A.I.S.I. CODE.

LIGHT GAGE BEAM SCHEDULE

Table with columns: MARK, BUILT UP BEAM, and TRACKS & SCREWS.

- NOTES:
1.) WHERE BEAM IS USED IN WALL BOTTOM TRACK MAY TURNED FLANGE DOWN FOR WALL STUDS.
2.) SEE LIGHT GAGE PARTS SCHEDULE FOR MINIMUM PROPERTIES AND REMAINDER OF DETAILS.
3.) SEE APPLICABLE SECTIONS FOR CONNECTIONS EA END.

JOIST BRACING SCHEDULE

Table with columns: JOIST SPAN and TOP AND BOTTOM FLANGE BRACING.

- NOTES:
1.) USE 1 1/2" x 16GA. FLAT STRAP ON TOP & BOT. OF JOIST. OMIT TOP STRAP IF DECK OCCURS. OR 1 1/2" CRG ON TOP OF JOIST. FASTEN TO EA. JOIST w/2 SCREWS.
2.) SPACE BRACING AS NOTED ABOVE EXCEPT WHEN NOTED OTHERWISE ON PLANS.
3.) SEE SECT. 1/52.2 FOR DETAILS AND EXCEPTIONS.

CEILING BRACING SCHEDULE

Table with columns: MARK, STRAP/CRC (50 k.s.i.), NUMBER OF SCREWS (GUSSET TO TRACK, GUSSET TO STRAP, STRAP SPLICE).

- NOTES:
1.) SCREWS MUST BE PLACED AT LEAST 3/4" APART AND MUST BE 3/4" FROM EDGE OR END OF ALL METAL PIECES.
2.) SEE SECTION 1/52.2 FOR BALANCE OF INFO.

WALL STUD WIDTH SCHEDULE

Table with columns: MARK, STUD WIDTH.

- NOTES:
1.) ALL WALLS ARE 3 5/8" UNLESS NOTED THUS: [Symbol]
2.) SEE LIGHT GAGE PARTS SCHEDULE FOR GAGE AND MINIMUM PROPERTIES.

WALL BRACING SCHEDULE


Table with columns: MARK, STRAP (50 k.s.i.), HOLDOWN, NUMBER OF SCREWS (GUSSET TO T. & B. TRACK, GUSSET TO DBL STUDS, GUSSET TO STRAP).

- NOTE:
1.) SCREWS MUST BE PLACED AT LEAST 3/4" APART AND MUST BE 3/4" FROM EDGE OR END OF ALL METAL PIECES.

HOLDOWN SCHEDULE

Table with columns: HOLDOWN, ANCHORS, and SCREWS.


KEY PLAN

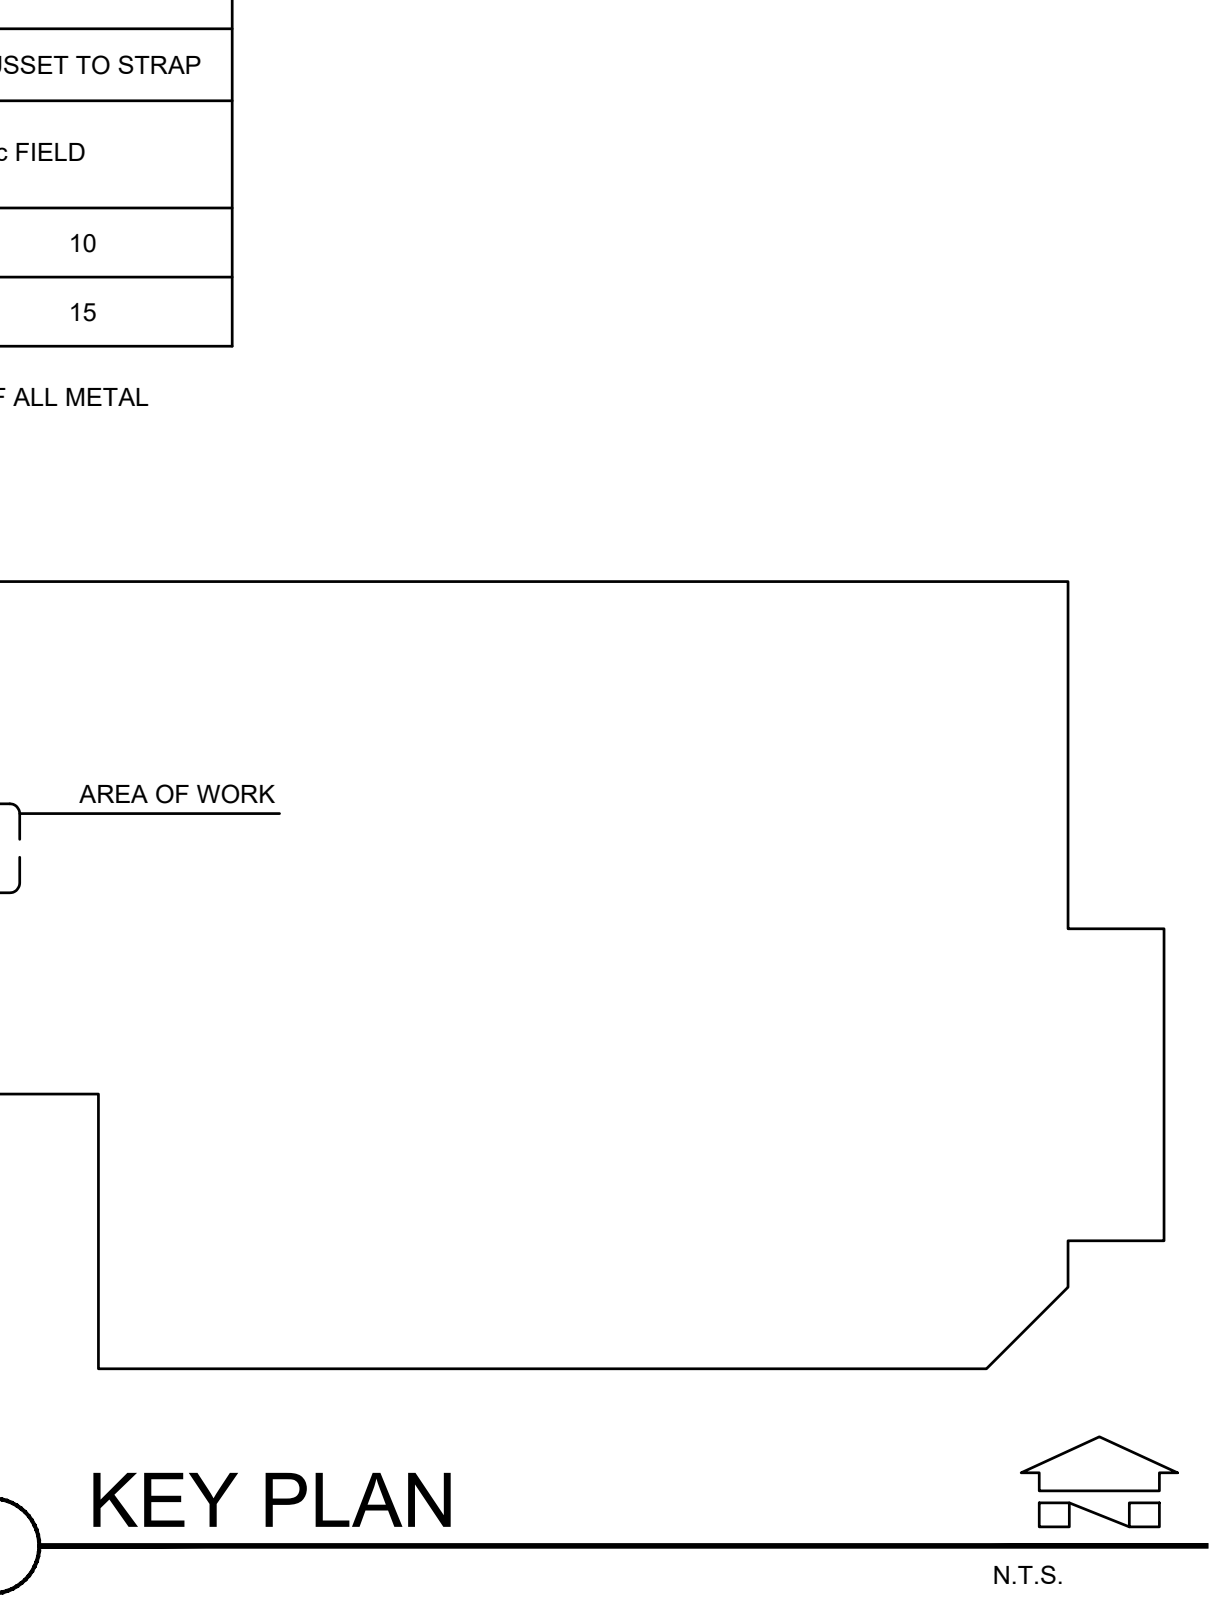

City of Puyallup Development & Permitting Services ISSUED PERMIT
Building Planning
Engineering Public Works
Fire Traffic

DRAWING REVISIONS table with columns: NO, DATE, DESCRIPTION.

DRAWING REVISIONS table with columns: NO, DATE, DESCRIPTION.

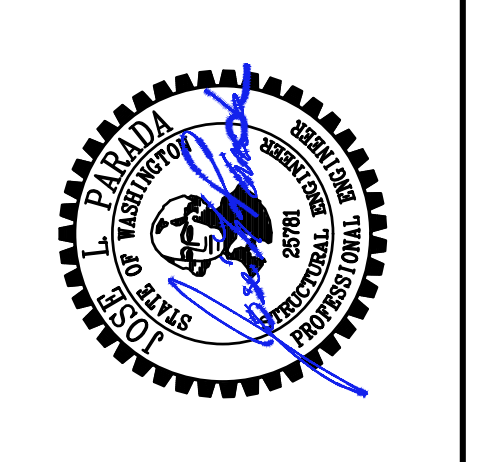


ENW STRUCTURAL ENGINEERS
Engineers Northwest Inc., P.S.
10020 35th AVE W., Suite 530, Lynnwood, WA 98036
www.enwengineers.com

GENERAL NOTES, PARTIAL PLANS, AND SCHEDULES
SHEET CONTENTS:
FLEET RESTROOM REMODEL
1201 39TH STREET
PUYALLUP, WA. 98373


JOB NO: 99090017
ENGINEER: J. SAGDAHL
DRAWN: P. PATEL
DATE: 09-18-2024
SHEET NO: S1.1

L:\99090017\Costco Puyallup-S1-1-General Notes, Partial Ceiling Framing Plan, and Schedules-99090017.dwg; 09-20-24, 2:59pm, ppatel, 48

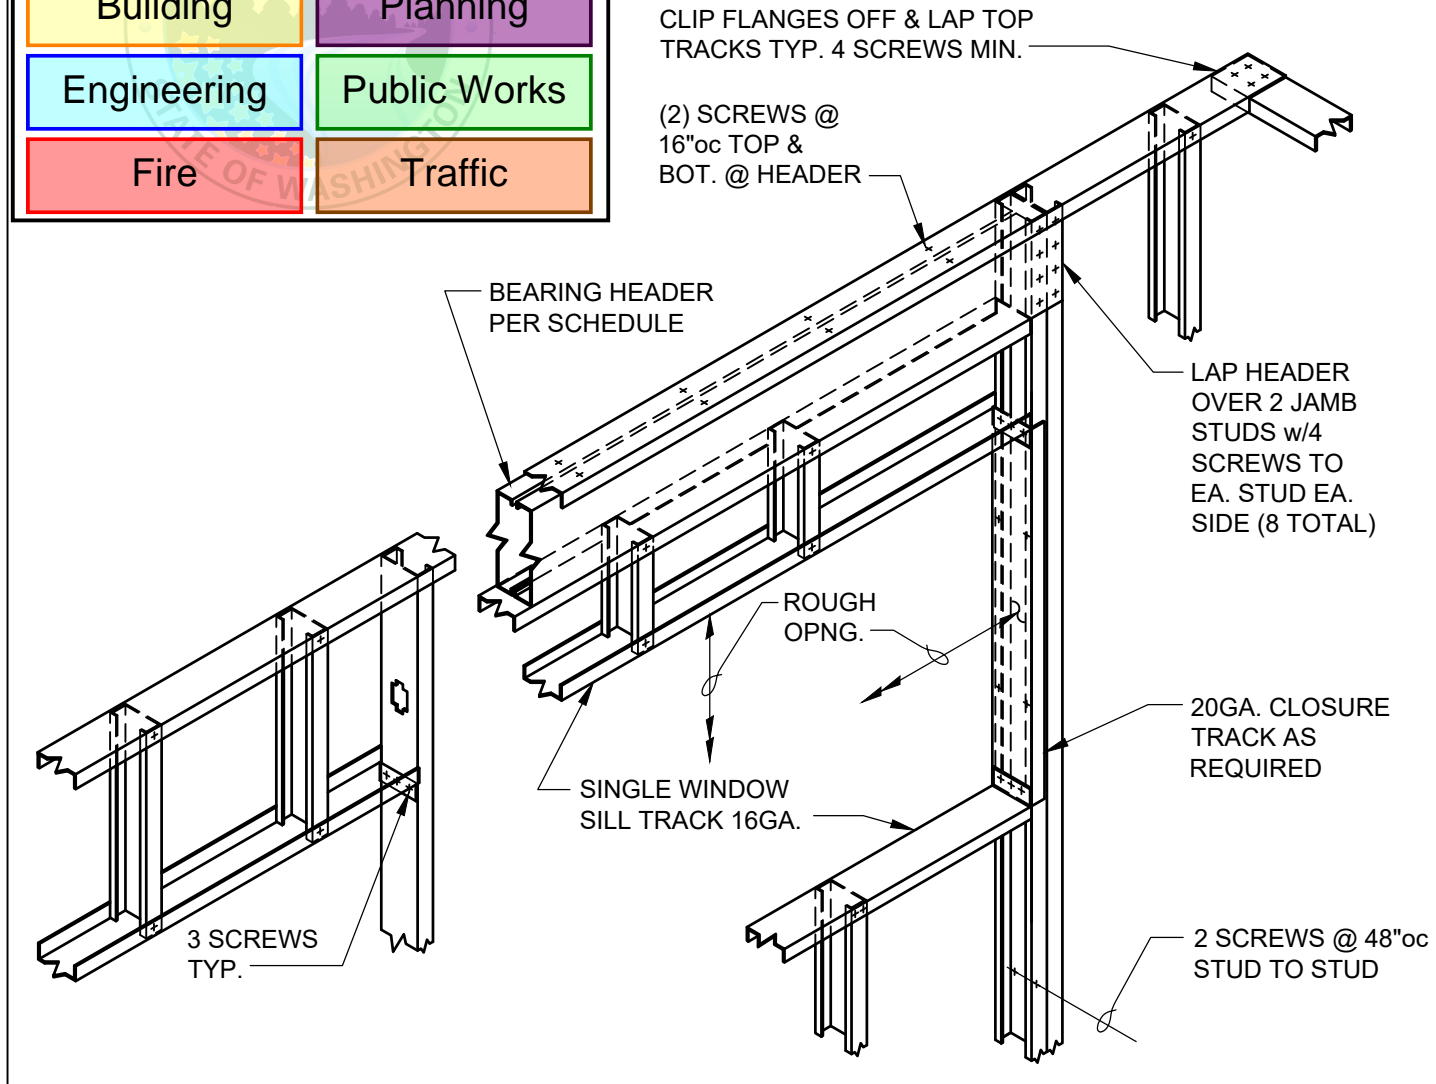


1A TYPICAL WALL HEADER DETAIL

HEADERS NOTED ON THE PLAN AS "HDR." ARE BEARING HEADERS & ARE NOTED IN THE PARTS SCHEDULE BELOW. HEADERS RUNNING PARALLEL TO THE JOISTS ARE NON-BEARING (U.N.O.)

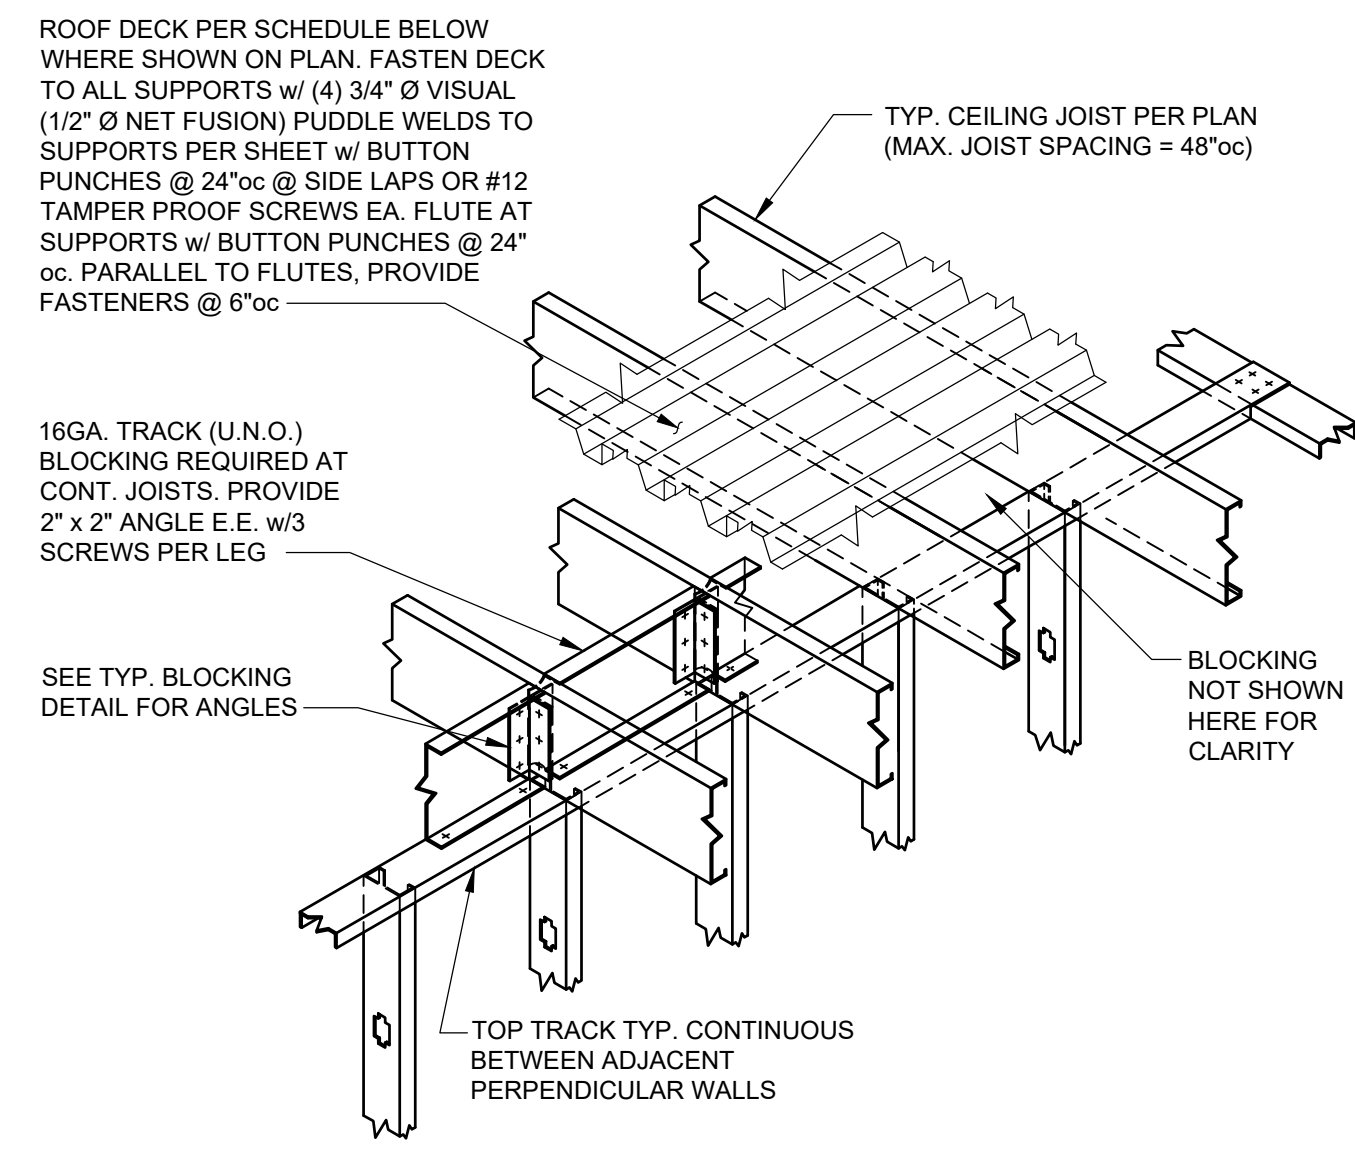

1B TYPICAL JOIST OVER INTERIOR WALL

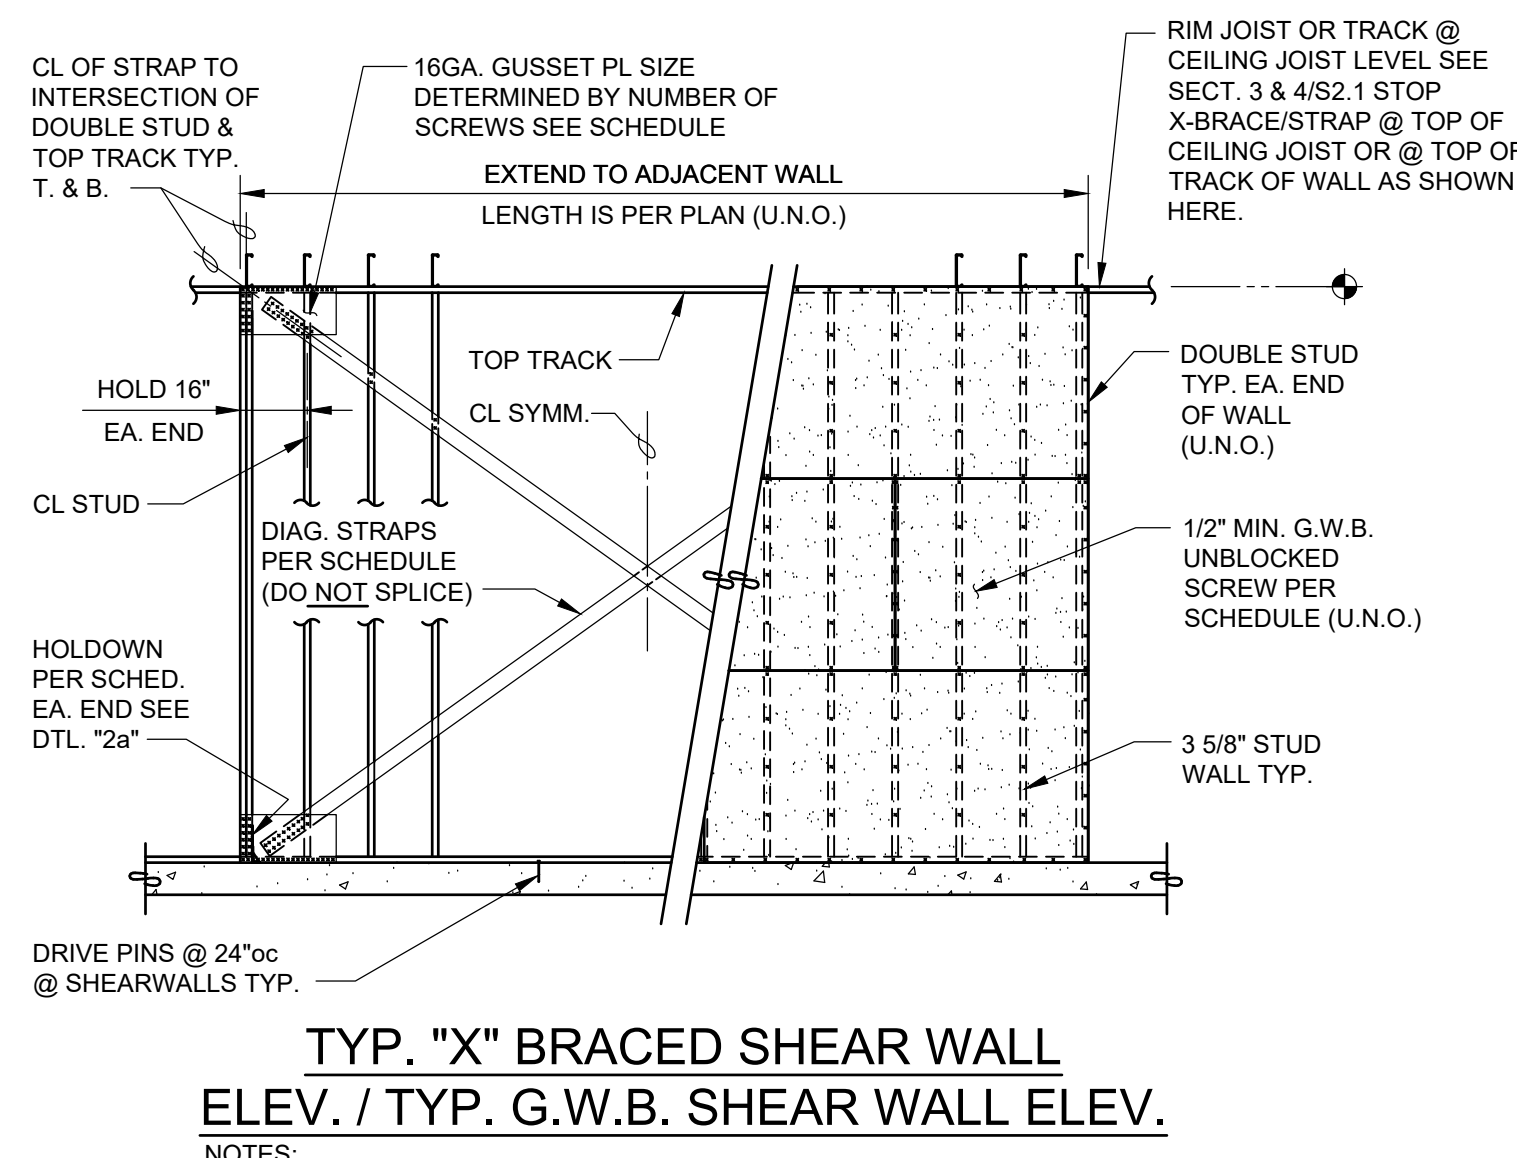


TYP. "X" BRACED SHEAR WALL ELEV. / TYP. G.W.B. SHEAR WALL ELEV.


NOTES:
1) BRACES MUST BE TIGHT & STRAIGHT. NO SLACK ALLOWED BTWN. STUDS.
2) G.W.B. MUST RUN FULL HEIGHT TO CEILING JOIST WHERE NOTED AS SHEAR WALL.

2 ELEVATION

2a DETAIL

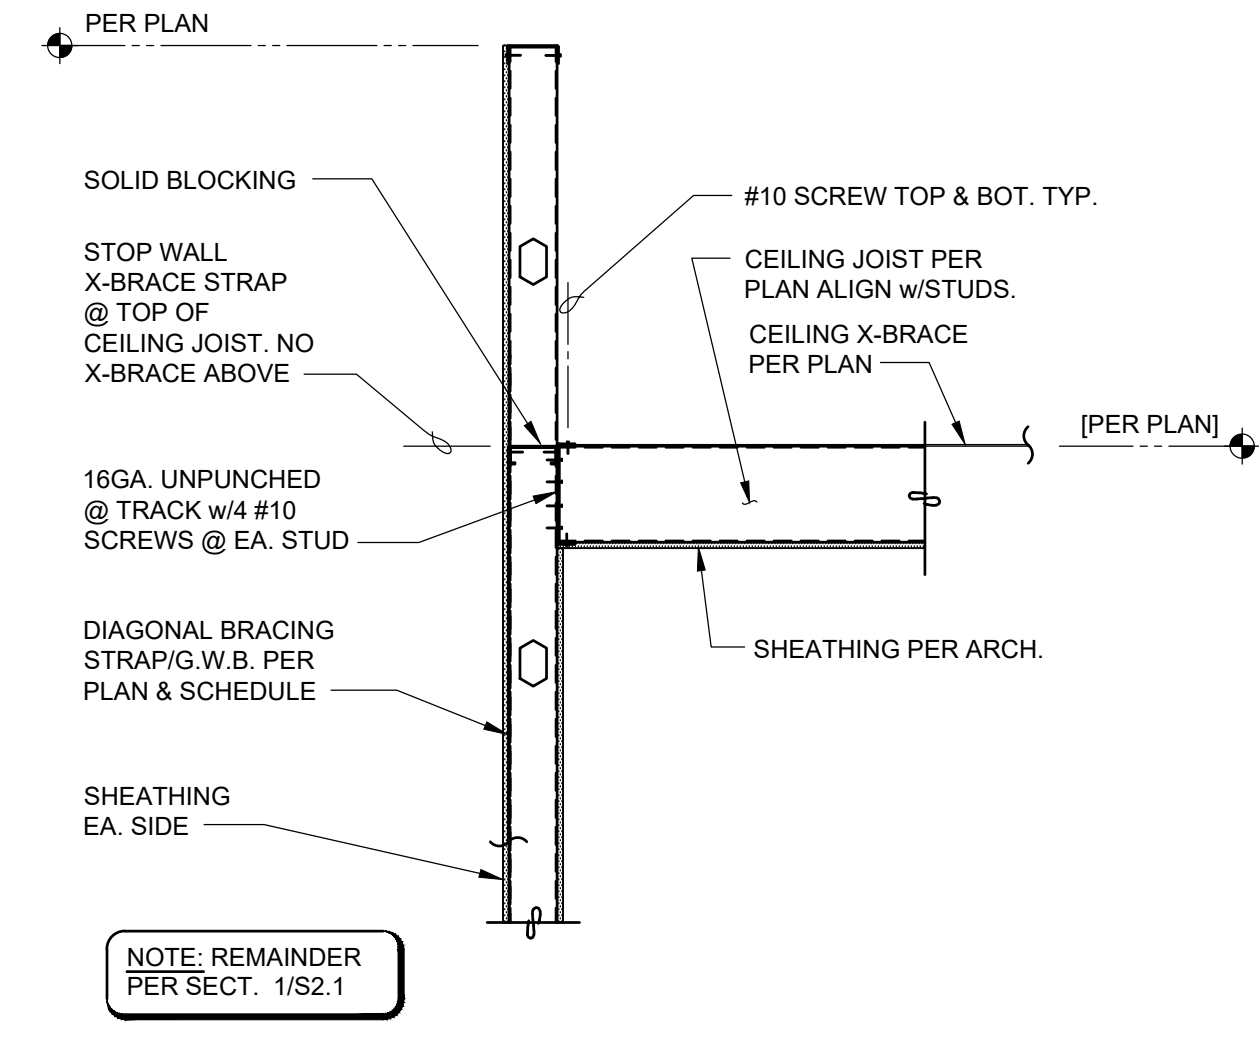


3 SECTION

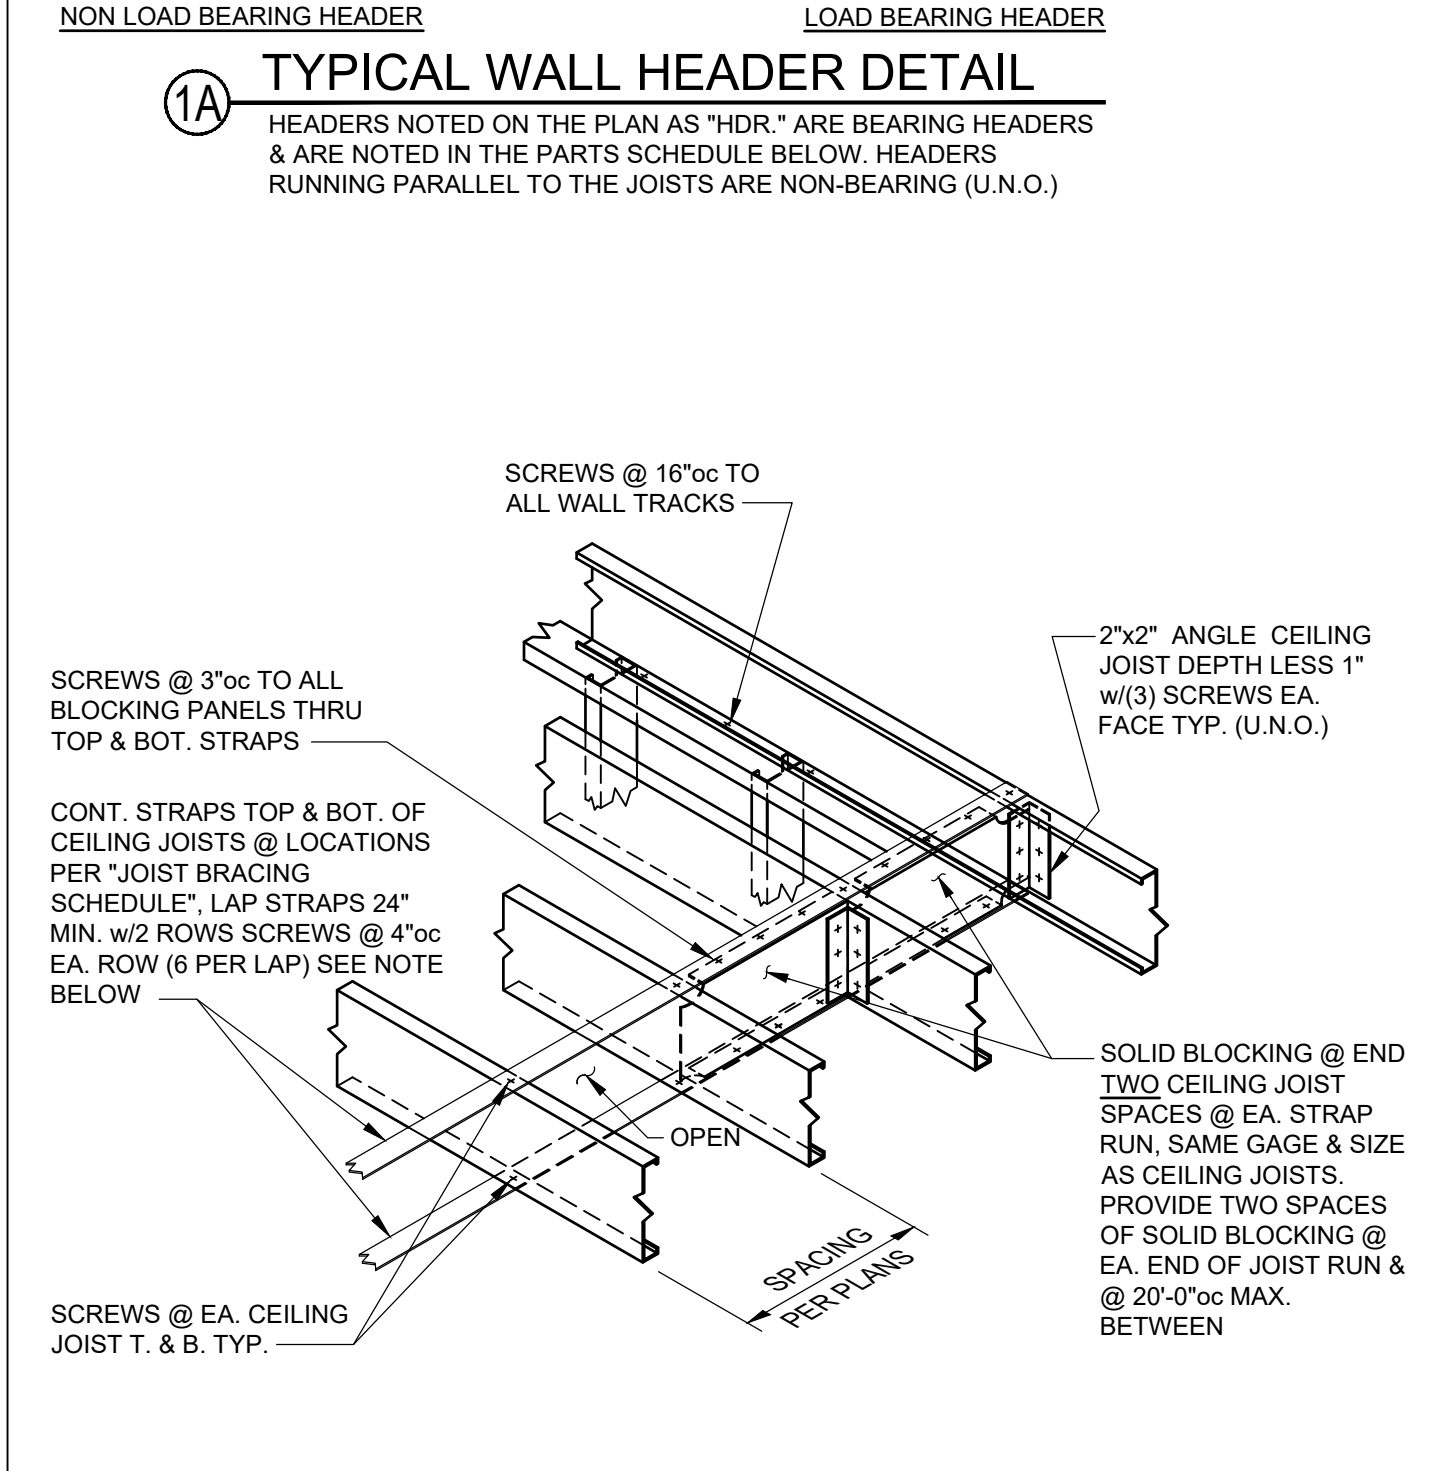


1C TYPICAL JOIST BLOCKING & STRAP DETAIL

CEILING JOIST BLOCKING WHERE NOTED ON PLANS. THE TOP STRAP NOT REQUIRED IF DECKING IS APPLIED TO TOP OF JOIST. THE BOTTOM STRAP IS NOT REQUIRED IF G.W.B. IS APPLIED TO BOTTOM OF JOIST.

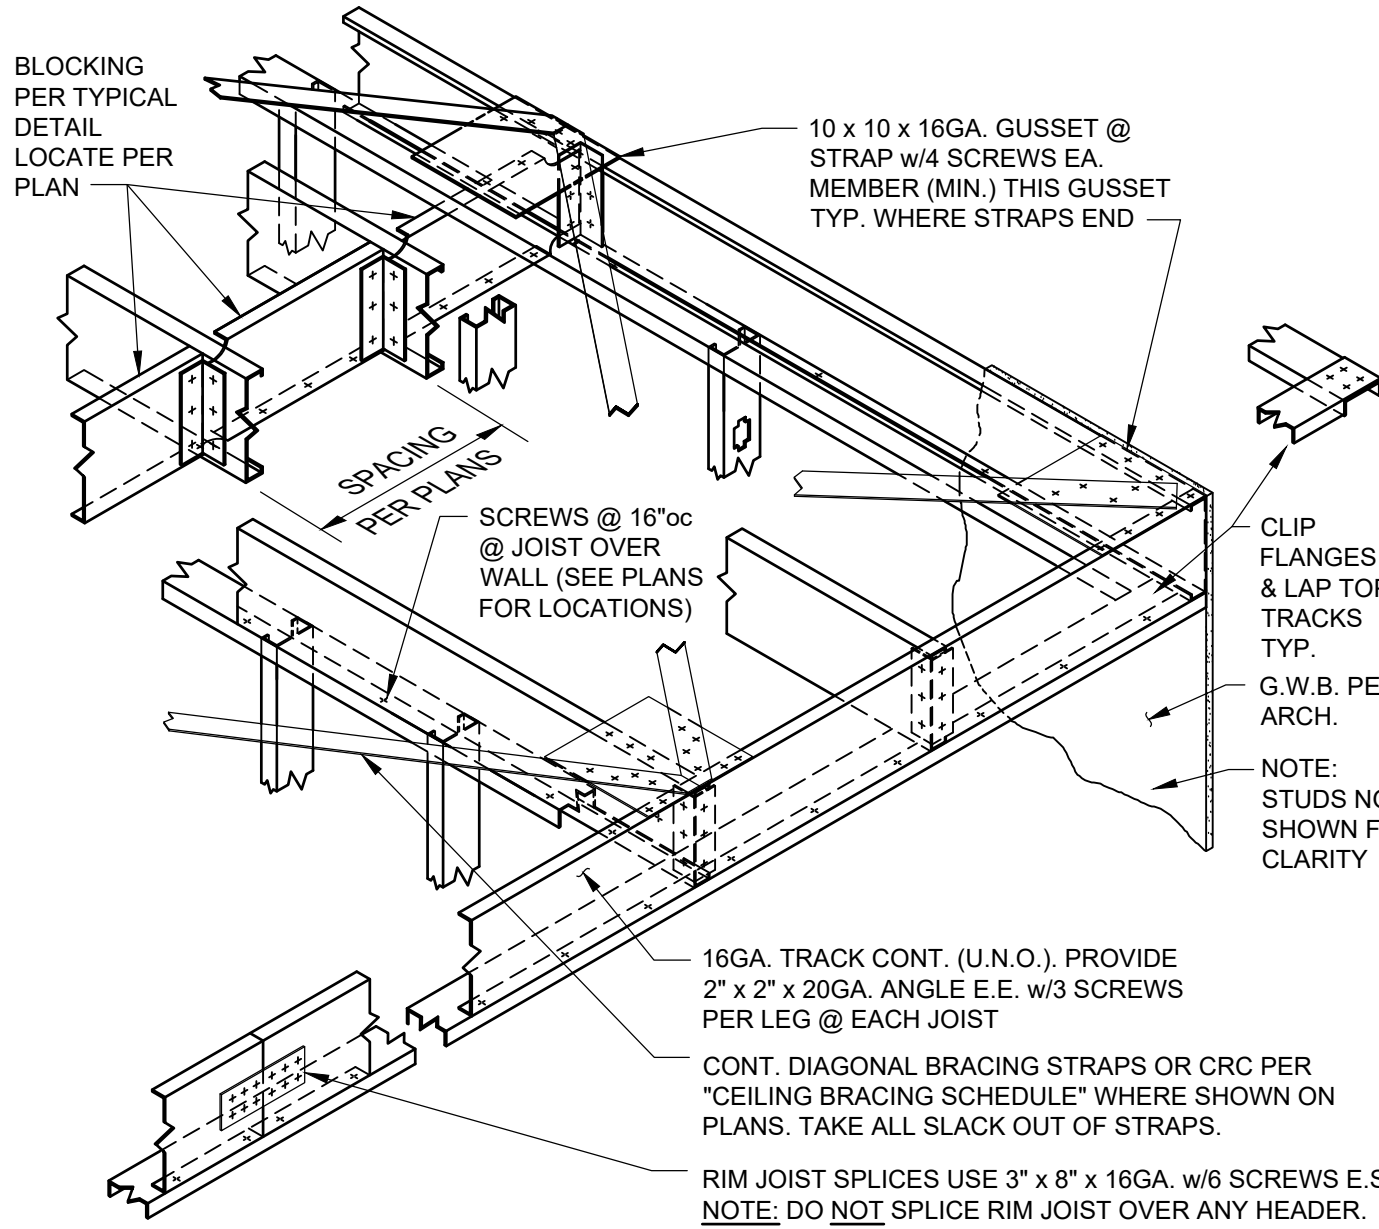


1D TYPICAL JOIST TO RIM JOIST w/DIAGONAL STRAPS

CEILING DIAGONAL STRAP BRACING NOT REQUIRED WHERE DECKING OCCURS.

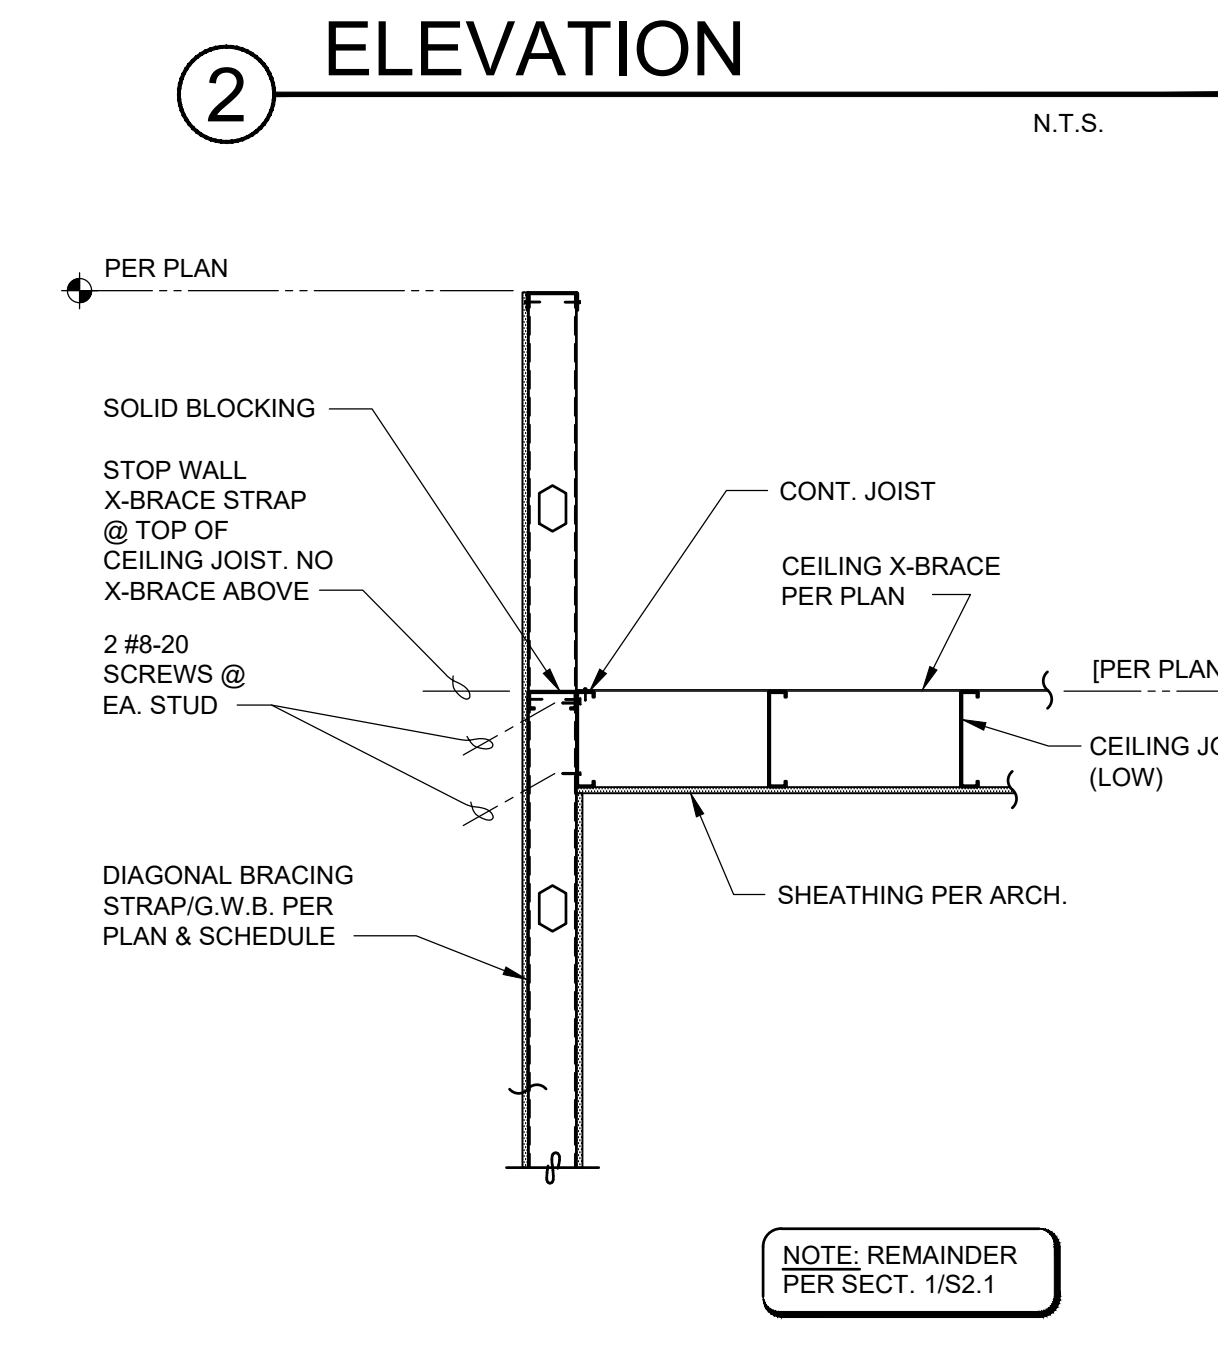

4 SECTION


5 SECTION

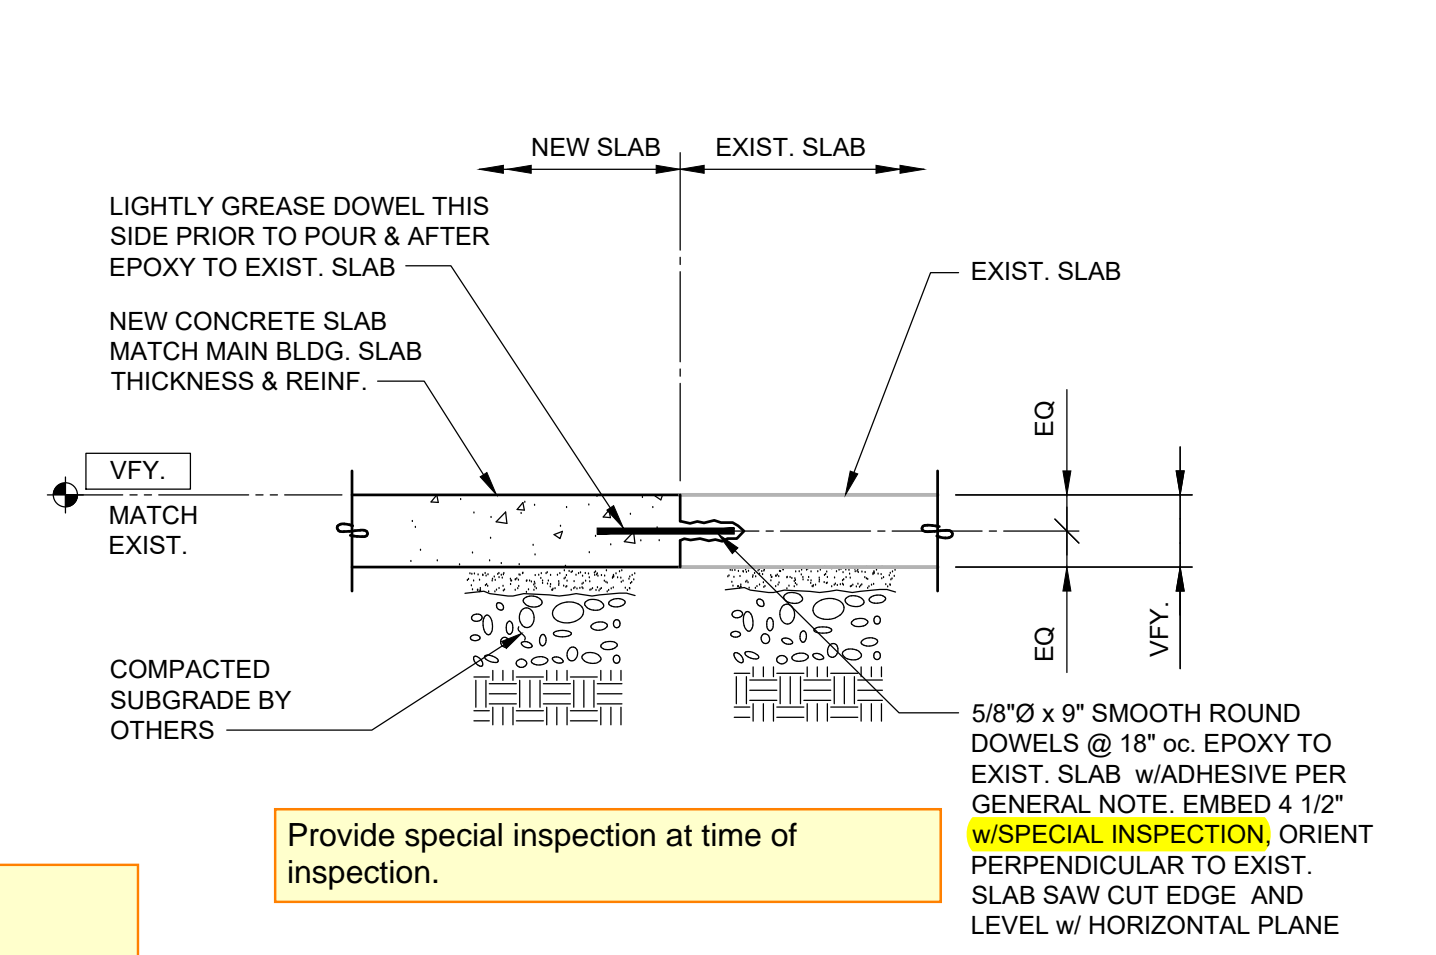

SLAB REPAIR/REPLACEMENT JOINT


6 SECTION

(N/A FOR DUCTILCRETE SLABS)

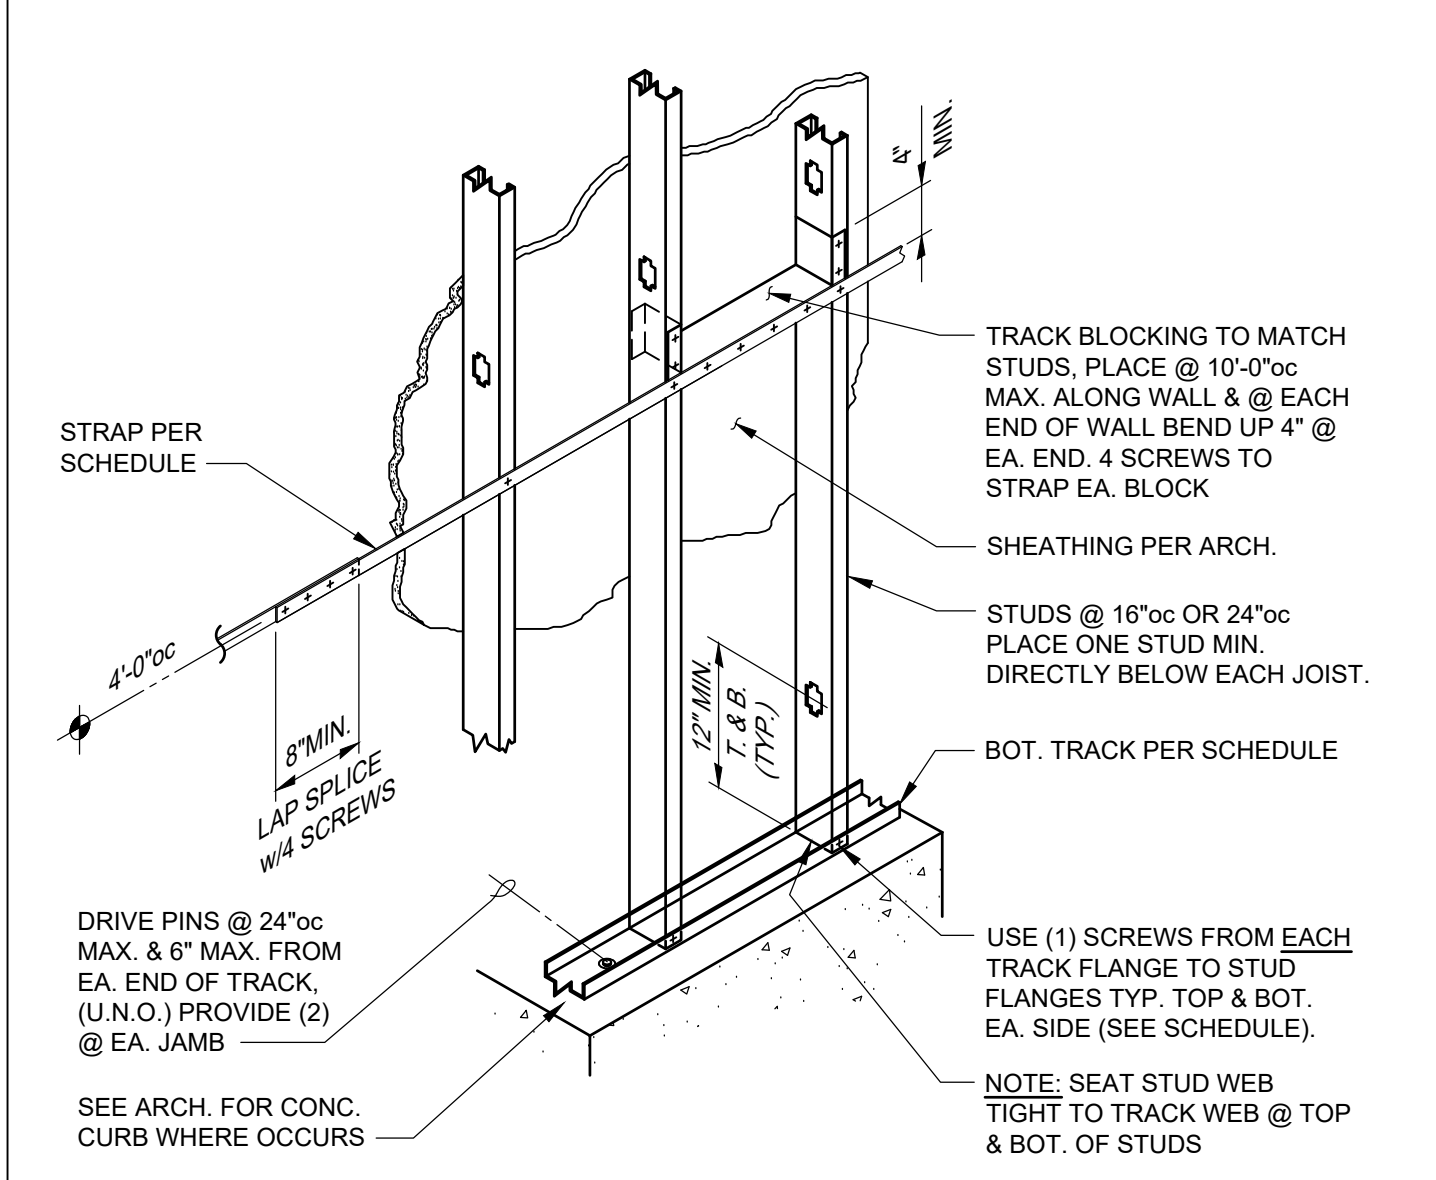


1E TYPICAL WALL, BLOCKING & STRAP DETAIL

STRAP BLOCKING IS REQUIRED ONLY IF STUDS ARE SHEATHED ONE SIDE ONLY.

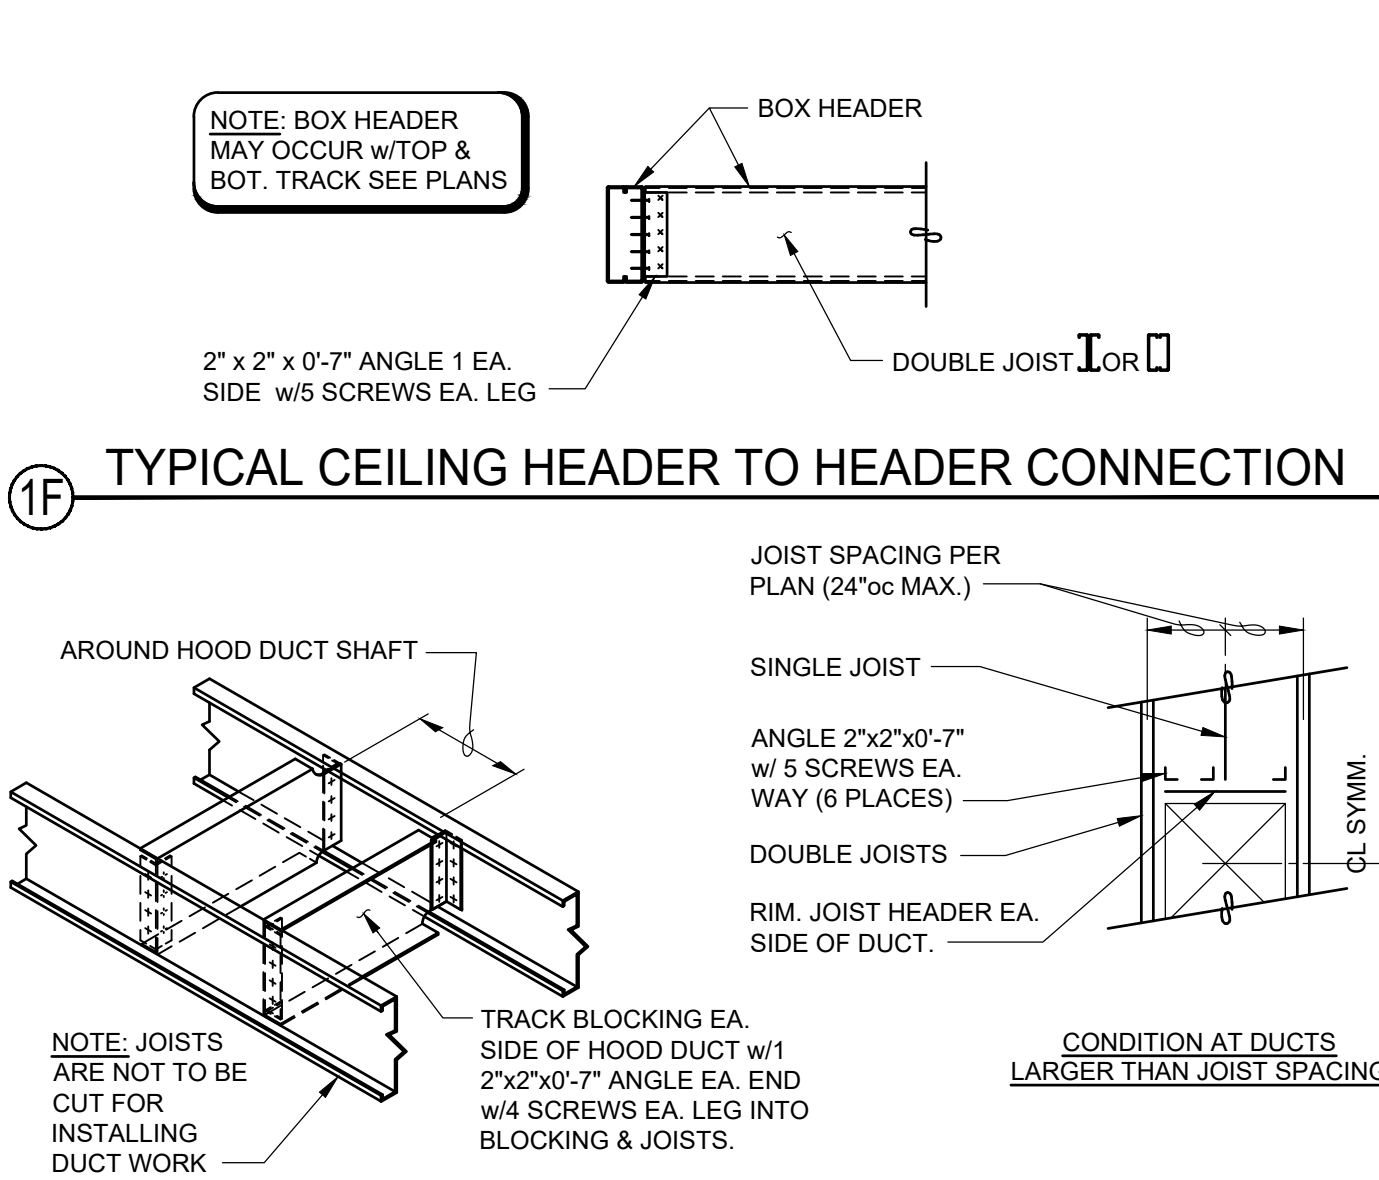

1F TYPICAL CEILING HEADER TO HEADER CONNECTION

NOTE: SEE ARCH. FOR LOCATIONS

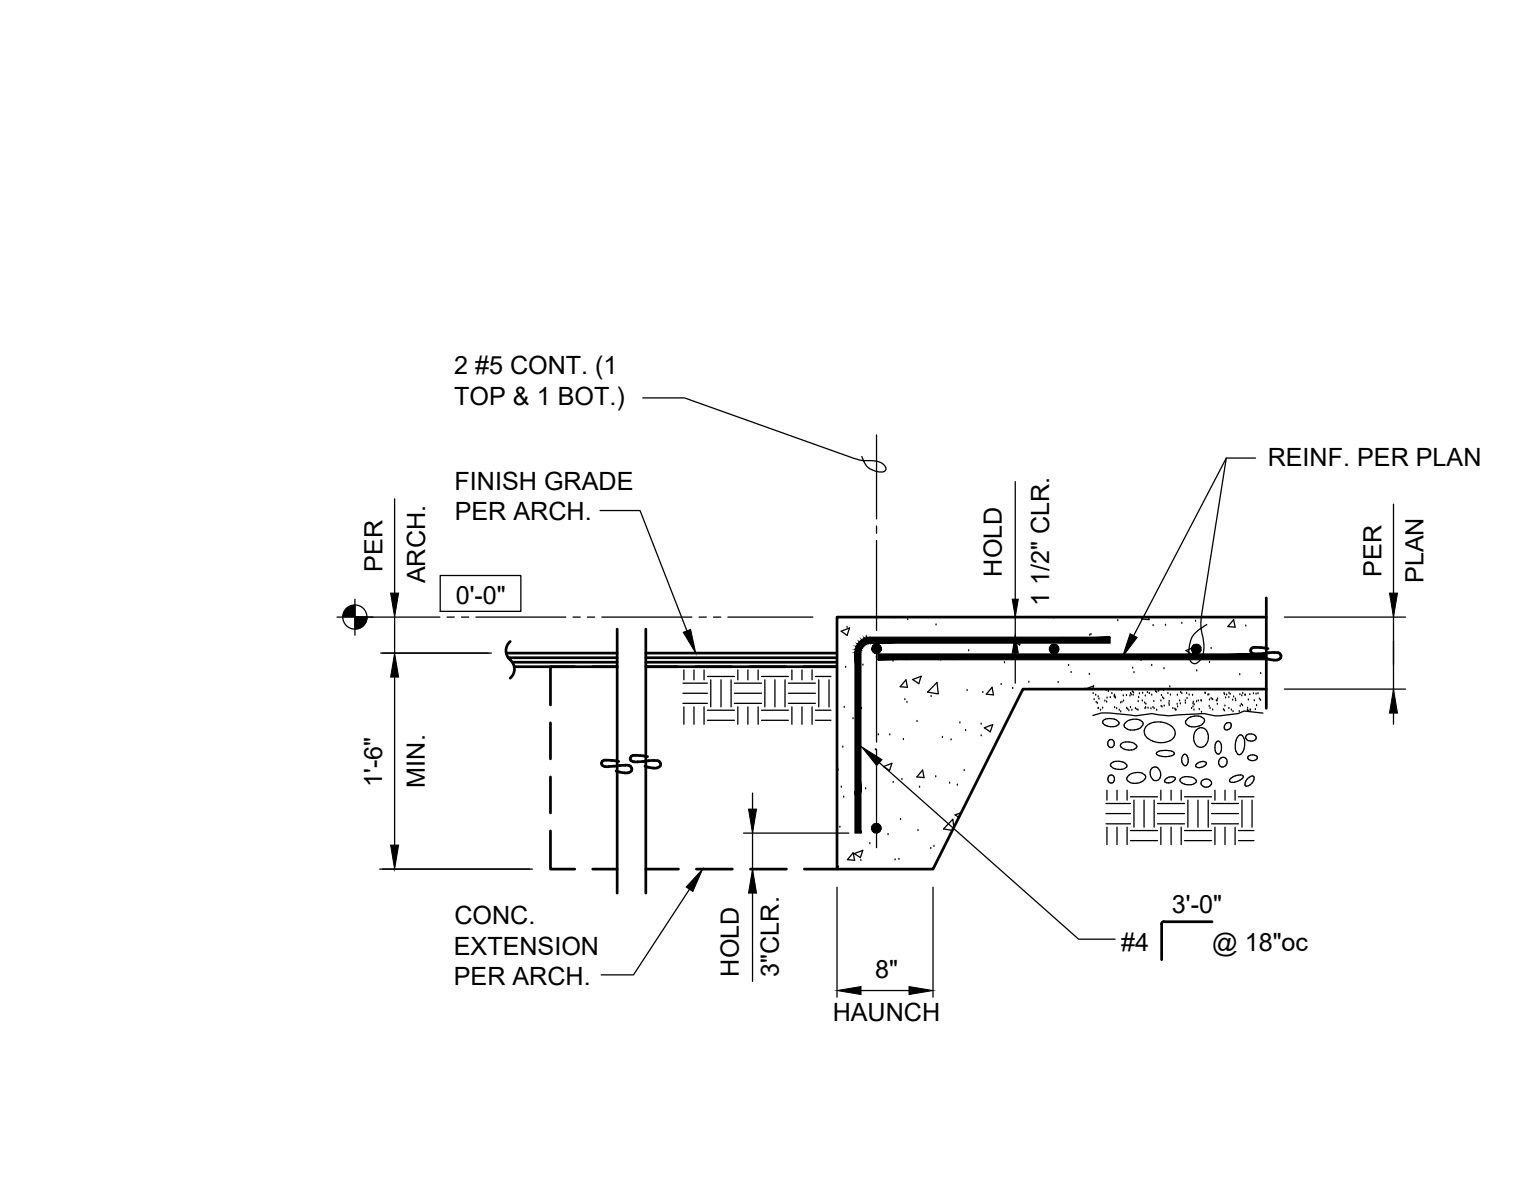

7 SECTION

8 SECTION


NOTE:
1. PRIOR TO ANY DEMOLITION REFER TO ARCHITECTURAL DRAWINGS FOR EXACT LOCATION OF DOOR CUT OUT. CUT MUST BE LOCATED ON VERT. C.M.U. GROUT.
2. VIEW IS FROM INSIDE

8 SECTION

(N) SAW-CUT DOOR. DO NOT OVERCUT. LOCATE CUT IN VERT. C.M.U. GROUT
(E) SLAB ON GRADE

NO.	DATE	DRAWING REVISIONS
	09-20-2024	

NO.	DATE	DRAWING REVISIONS

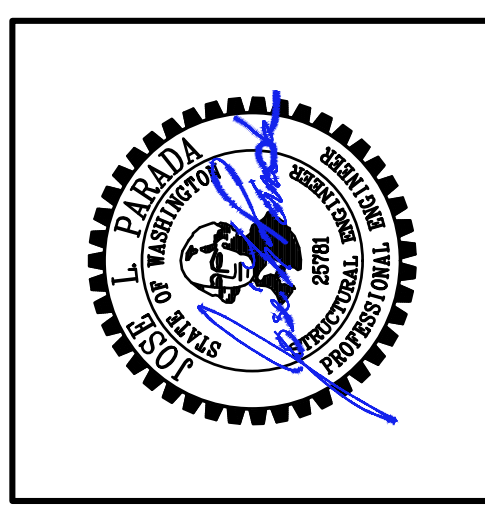

ENW STRUCTURAL ENGINEERS
Engineers Northwest Inc., P.S.
10000 1st Avenue, Puyallup, WA 99008
Ph: (206) 835-7530 | Fax: (206) 835-4998
www.enwengineers.com

COSTCO WHOLESALE
FLEET RESTROOM REMODEL
1201 39TH STREET
PUYALLUP, WA. 98373

JOB NO:	99090017
ENGINEER:	J. SAGDAHL
DRAWN:	P. PATEL
DATE:	09-18-2024
SHEET NO:	S2.1

**City of Puyallup
Development & Permitting Services
ISSUED PERMIT**

Building	Planning
Engineering	Public Works
Fire	Traffic

GENERAL NOTES

- REFER TO GENERAL NOTES ON SHEET M-0.
- REFER TO SPECIFICATIONS ON SHEET M-0.
- TEST & BALANCE SYSTEM PRIOR TO CLOSEOUT OF PROJECT. PROVIDE A DETAILED REPORT TO OWNER, ARCHITECT, & ENGINEER.
- ENVIRONMENTAL EXHAUST TERMINATION SHALL BE 10'-0" AWAY FROM ANY O.A. INTAKE, 3'-0" FROM PROPERTY LINES, AND 3'-0" FROM OPERABLE OPENINGS INTO BUILDINGS.
- DRAWINGS ARE TO BE REVIEWED IN FULL DETAIL, WITH SHEET SPECIFICATIONS. IN THE EVENT THAT THERE IS A CROSS DIRECTION, A REQUEST FOR INFORMATION (RFI) IS TO BE SENT TO THE ENGINEER OF RECORD. AS STATED IN SPECIFICATIONS THE HIGHER COST OF THE TWO OPTIONS IS TO BE TAKEN AS THE OPTION W HILE AT BID UNLESS CLARIFICATION FROM RFI.
- AIR INTAKE OPENINGS SHALL BE LOCATED NOT LESS THAN 10'-0" HORIZONTALLY FROM LOT LINES, HAZARDOUS OR NOXIOUS CONTAMINANT SOURCES SUCH AS GAS METERS, VENTS, STREETS, ALLEYS, PARKING LOTS, AND LOADING DOCKS. INTAKE OPENINGS SHALL BE NOT LESS THAN 3'-0" BELOW CONTAMINANT SOURCES WHERE SUCH SOURCES ARE LOCATED WITHIN 10'-0" OF THE OPENING.

KEY NOTES

- FURNISH AND INSTALL NEW TOILET EXHAUST FAN WITH BACKDRAFT DAMPER. INSTALL FAN PER MANUFACTURER'S RECOMMENDATIONS. 8"Ø EXHAUST DUCT TO DISCHARGE UP THRU ROOF. PROVIDE WITH EXHAUST VENT CAP AND BIRDSCREEN. IF EXHAUSTING OUT THE ROOF IS NOT FEASIBLE IT IS ALSO ACCEPTABLE TO TERMINATE OUT THE SIDEWALL WITH A MANUFACTURER RECOMMENDED LOUVER. EXHAUST PENETRATION TO MAINTAIN 10'-0" FROM ANY OUTDOOR AIR INTAKES AND 3'-0" FROM OPENINGS INTO BUILDINGS.
- FURNISH AND INSTALL SURFACE MOUNTED ELECTRIC WALL HEATER W/ INTEGRAL THERMOSTAT. PROVIDE WITH ELECTRICAL DISCONNECT.
- TRANSFER DUCT WITH 8"x8" TYPE 'A' GRILLE MOUNTED IN UNISEX RR 105 CEILING & TYPE 'B' GRILLE ON STORAGE SIDE (AS APPLICABLE). TRANSFER DUCT TO HAVE A LOW LEAK COUNTER-BALANCING BACKDRAFT DAMPER BALANCED TO 125 CFM. COORDINATE FINISH AND MOUNTING HEIGHT WITH ARCHITECT.
- FIELD VERIFY EXISTING MECHANICAL SYSTEM IN THIS AREA AND DEMO/CAP DUCTWORK AS NECESSARY FOR NEW WORK. REFER TO 2M-1 FOR NEW WORK IN THIS AREA. ROOF PENETRATION CAN BE RE-USED IF APPLICABLE.

CONTRACTOR PLAN NOTES

- THIS CONTRACTOR SHALL DO A DETAILED INVESTIGATION TO DETERMINE ALL EXISTING CONDITIONS AND SHALL PRODUCE LAYOUTS WITH ADJUSTMENTS THAT SUIT FIELD CONDITIONS AT NO ADDED COSTS TO OWNER. FAILURE TO DO PROPER FIELD INVESTIGATION AND DUE DILIGENCE WILL NOT JUSTIFY CHANGE ORDERS.
- THIS CONTRACTOR TO VISIT THE SITE PRIOR TO FINALIZING HIS BID AND VERIFY IF INSTALLATION OF DUCTWORK IS REQUIRED FOR ANY PORTION OF THE JOB AND SUBMIT BIDS TO COVER ALL COST.
- CONTRACTOR SHALL DO A DETAILED INVESTIGATION TO DETERMINE ALL OBSTRUCTIONS IN THE FIELD AND SHALL PRODUCE SHOP DRAWINGS FOR DUCT LAYOUTS AND EQUIPMENT LAYOUTS WITH ADJUSTMENTS THAT SUIT FIELD CONDITIONS AND TO AVOID CONFLICTS WITH PROPOSED CEILING HEIGHTS - AT NO ADDED COSTS TO OWNER. FAILURE TO DO PROPER FIELD INVESTIGATION AND DUE DILIGENCE WILL NOT JUSTIFY CHANGE ORDERS.
- CONTRACTOR TO PROVIDE ALL NECESSARY SEISMIC/WIND BRACING AND SUPPORTS (AS NEEDED).

SEQUENCE OF OPERATIONS	
INPUT	OUTPUT
NO MOTION DETECTIONS	EXHAUST: OFF
MOTION DETECTION BELOW 40F	EXHAUST: OFF
MOTION DETECTION ABOVE 40F	EXHAUST: ON (100%)

ELECTRIC WALL HEATER SCHEDULE

TAG	MAKE / MODEL	SERVES	MOUNTING	ELECTRICAL			WEIGHT (LBS)	REMARKS
				WATTS	TOTAL AMPS	V/PH/Hz		
EVH-1	BERKO / SED1012	UNISEX RR 105	WALL	1000	8.3	120/1/60	15	ALL

REMARKS:
 1. PROVIDE WITH MANUFACTURER'S MOUNTING KIT.
 2. COLOR TO BE SELECTED BY ARCHITECT.
 3. PROVIDE WITH INTEGRAL THERMOSTAT.
 4. MECHANICAL CONTRACTOR TO PROVIDE LOCKABLE DISCONNECT SWITCH & ELECTRICAL CONTRACTOR TO WIRE.
 5. ELECTRIC HEAT ALLOWED PER WSEC C403.1.4 EXCEPTION 15. HEATING DESIGNED FOR FREEZE PROTECTION.

VENTILATION SCHEDULE


ROOM NUMBER	ROOM NAME	OCCUPANCY CLASSIFICATION	ZONE FLOOR AREA	ZONE POPULATION	2021 WASHINGTON STATE MECHANICAL CODE			ACTUAL			EQUIPMENT		
					PEOPLE OUTDOOR AIR RATE	AREA OUTDOOR AIR RATE	BREATHING ZONE OUTDOOR AIRFLOW	E.A. CFM	SUPPLY CFM	O.A. CFM	EXHAUST CFM	SUPPLY FAN	EXHAUST FAN
105	UNISEX RR	BATHROOMS/TOILETS	60.0	1	0.0	0.00	0.0	70	0	0	100	-	CEF-1
TOTAL			60.0	1.0	-	-	0.0	70.0	0.0	0.0	100.0		

CEILING EXHAUST FAN SCHEDULE


EQUIPMENT TAG	AREA SERVED	MANUFACTURER/MODEL	TYPE	DRIVE	CFM	S.P. (IN. WC)	MOTOR			WEIGHT (LB)	CONTROL	REMARKS		
							RPM	HP	WATTS					
CEF-1	UNISEX RR 105	LOREN COOK / GC-166	CEILING	DIRECT	100	0.25	1100	-	36.8	1	115	15	CONTROLLED BY MOTION SENSOR AND T-STAT. T-STAT TO DISABLE FAN BELOW 40F.	ALL

REMARKS:
 1. FAN SHALL BE CEILING MOUNTED. PROVIDE WITH CEILING GRILLE, SPEED CONTROL, ISOLATION HANGERS, BACKDRAFT DAMPER, AND DISCONNECT.
 2. EXHAUST TERMINATION SHALL BE 10'-0" AWAY FROM ANY O.A. INTAKE.
 3. TERMINATE VENT ON ROOF A MINIMUM OF 12" ABOVE ANTICIPATED SNOW LOAD WITH 8" EXHAUST VENT CAP.
 4. ALL SWITCHES AND T-STATS MOUNTED AT 42" AFF UNLESS NOTED OTHERWISE.
 5. PROVIDE FAN SPEED CONTROLLER MOUNTED IN ACCESSIBLE LOCATION. DO NOT ADJUST SPEED CONTROLLER SLOWER THAN 60% OF FAN MOTOR SPEED.

MECHANICAL ENLARGED PLAN

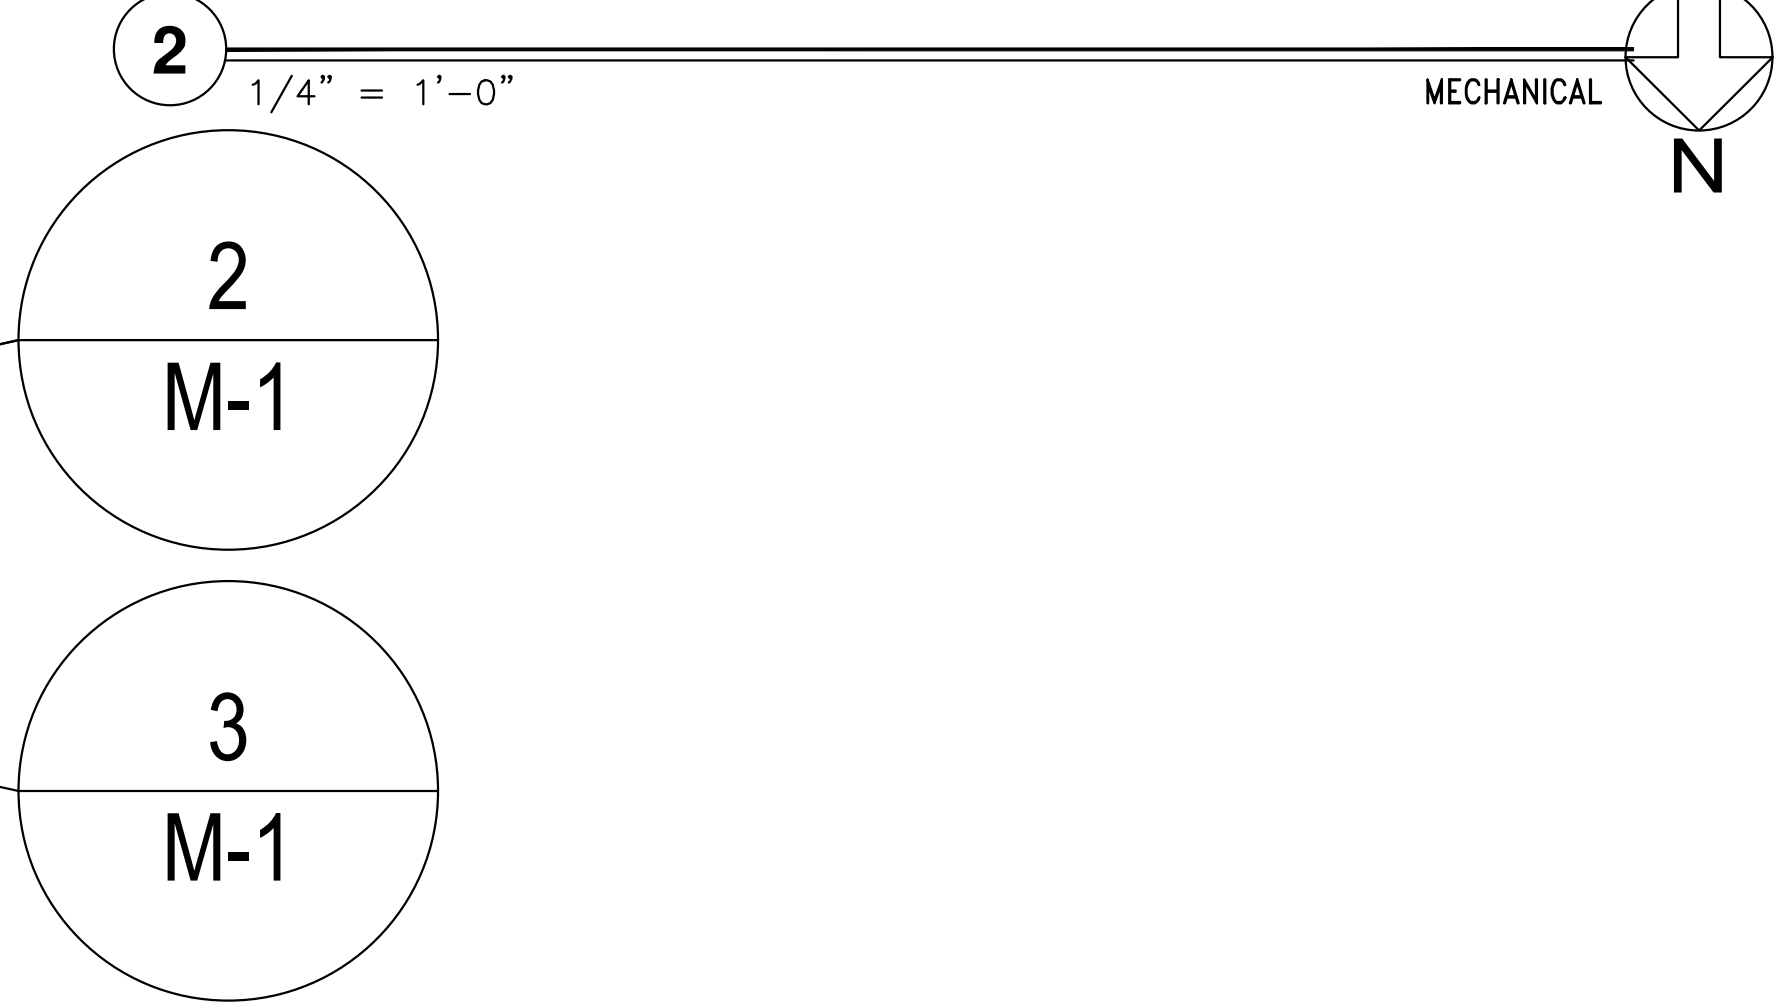


MECHANICAL DEMOLITION PLAN

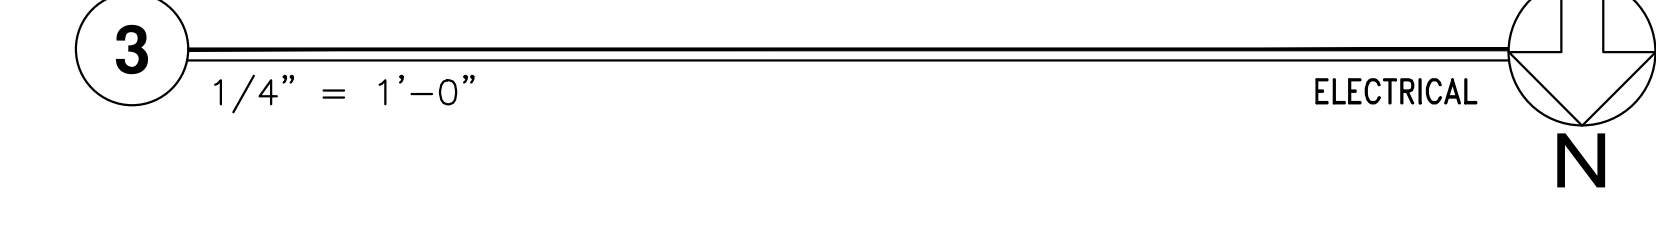

AIR DEVICE SCHEDULE

TAG	TYPE	MAKE/MODEL	AIR STREAM	MOUNTING TYPE	NECK SIZE	SIZE	REMARKS
A	SECURITY TRANSFER GRILLE	KEES / SEG-9TG	TRANSFER	SURFACE	SEE PLAN	8"x8"	ALL
B	TRANSFER GRILLE	TITUS / 350FL	TRANSFER	SURFACE	SEE PLAN	8"x8"	ALL

REMARKS:
 1. PROVIDE WITH SURFACE MOUNTING FRAME WHERE APPLICABLE.
 2. COORDINATE FINISH AND MOUNTING LOCATION WITH ARCHITECT.

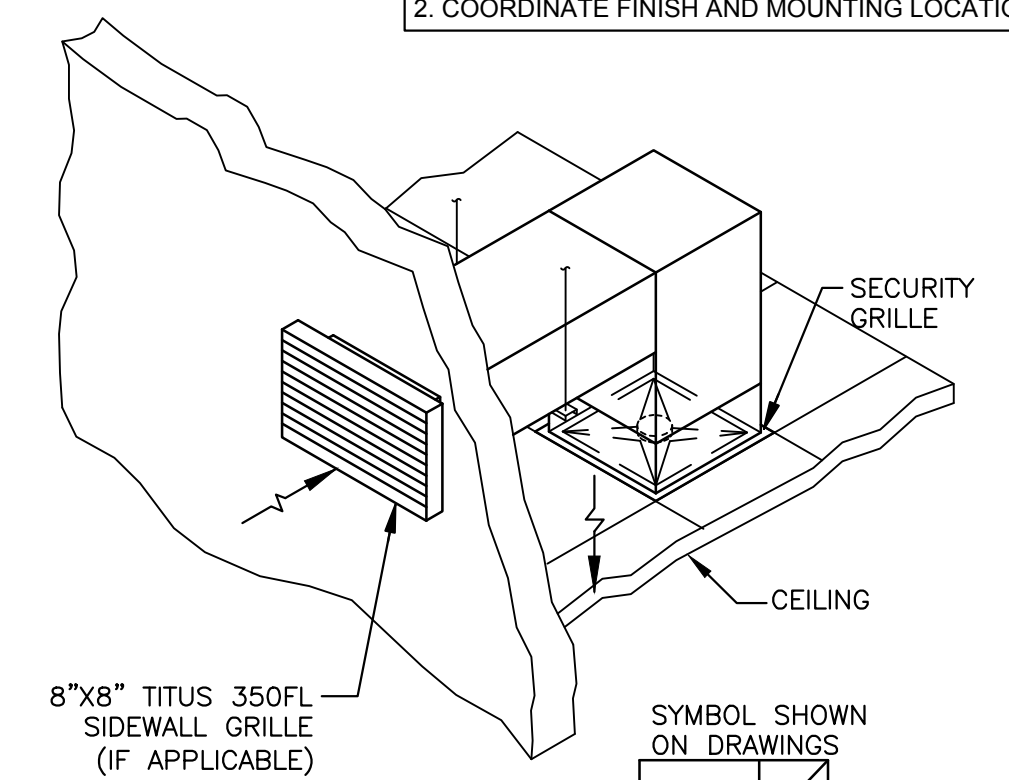


TRANSFER DUCT DETAIL

SCALE: NTS

MECHANICAL OVERALL PLAN

N.T.S. MECHANICAL

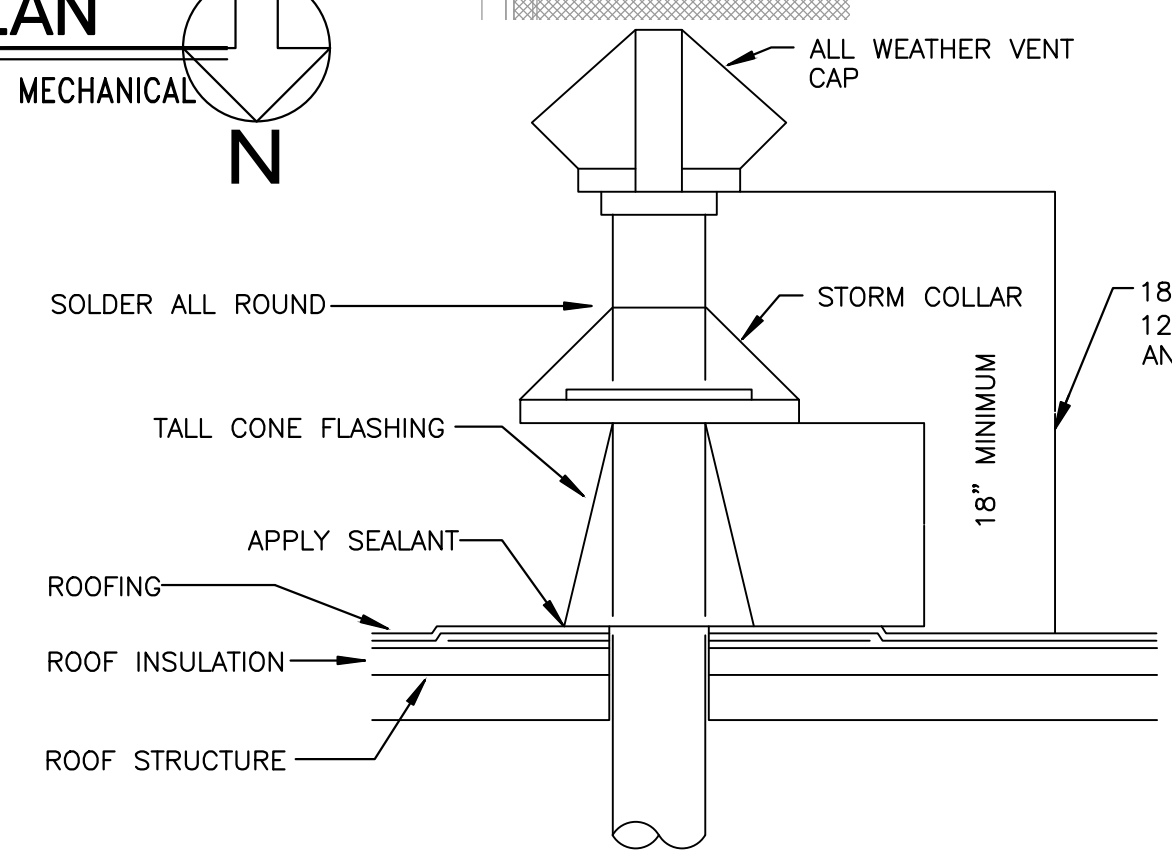


DUCT THRU ROOF DETAIL

SCALE: NTS


TYPICAL CABINET EXHAUST FAN DETAIL

SCALE: NTS

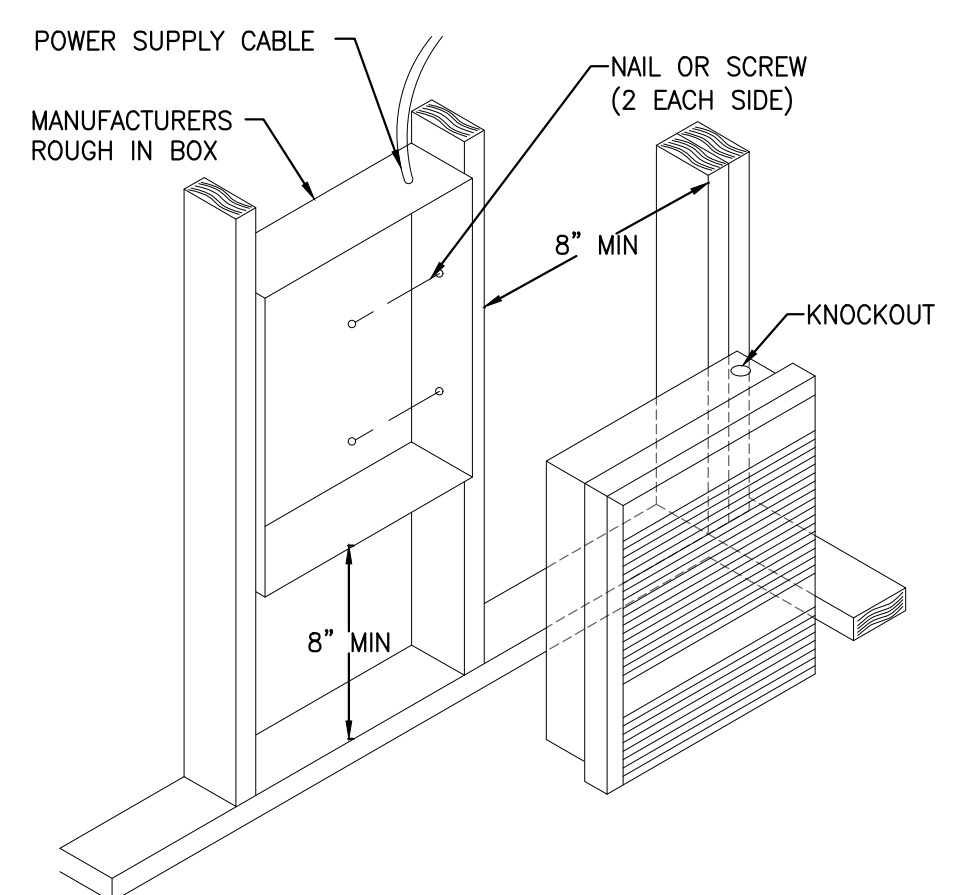

ELECTRIC WALL HEATER DETAIL

SCALE: NTS

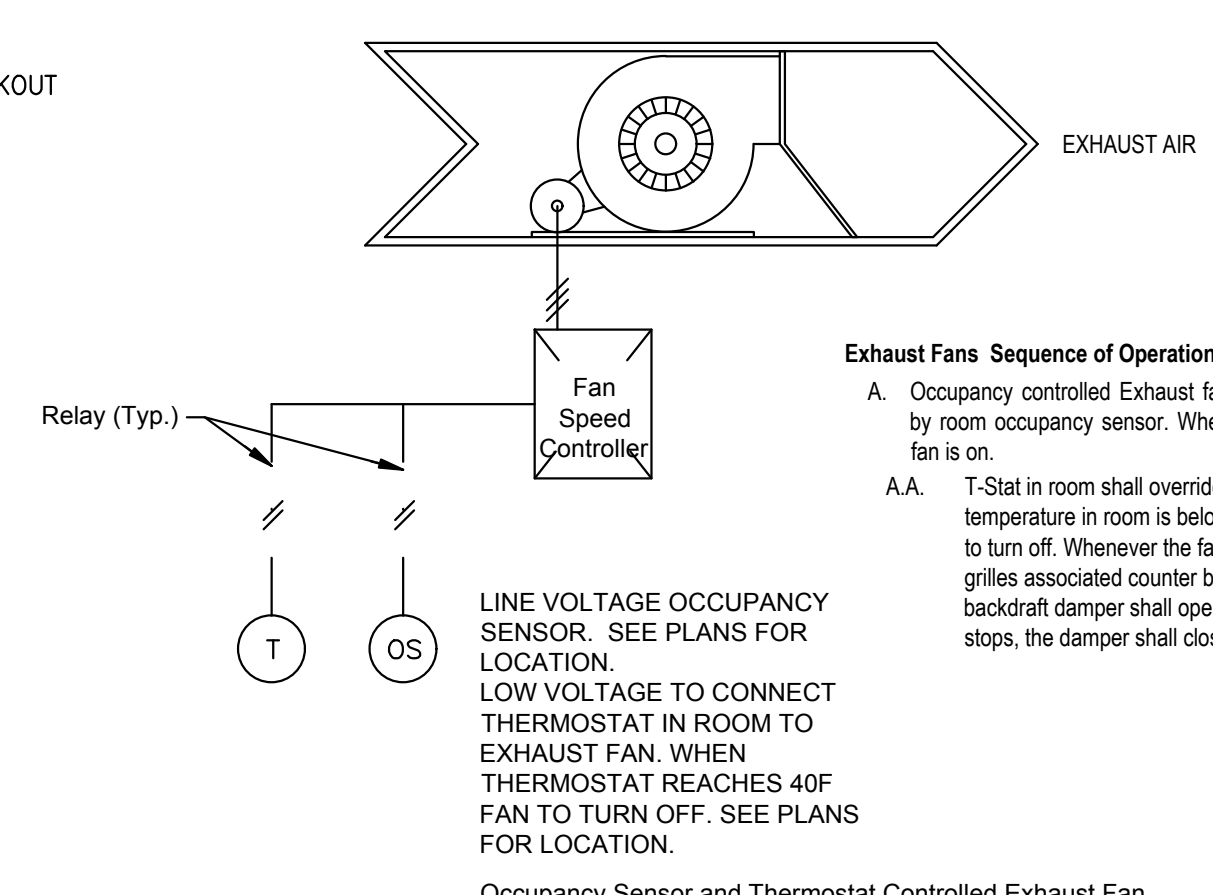

EXHAUST FAN CONTROL DIAGRAM

SCALE: NTS

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**COSTCO FLEET R.R.
 PUYALLUP WH# 660
 1201 39TH AVE SW
 PUYALLUP, WA 98373-3803**

MECHANICAL PLANS, SCHEDULES, & DETAILS

DATE	ISSUE FOR PLAN CHECK SUBMITTAL
02/28/24	ISSUE FOR PLAN CHECK SUBMITTAL

PA/PM:	JLI
DRAWN BY:	NW, BD, JC
JOB NO.:	SEA24-0053-00

SHEET
M-1

rtm
 engineering consultants
 2800 156th Ave Southeast, Suite 115
 Bellevue, WA 98007
 rtmassociates.com | 847.758.4180

ELECTRICAL SPECIFICATIONS

A. GENERAL REQUIREMENTS

1. SCOPE OF WORK
FURNISH AND INSTALL A COMPLETE ELECTRICAL SYSTEM AS SHOWN ON THE CONTRACT DRAWINGS...

2. MISCELLANEOUS SUPPORTING MEMBERS
THE INSTALLATION OF ANGLES, CHANNELS, AND OTHER MISCELLANEOUS STEEL BOLTS, ETC. REQUIRED TO SUPPORT LIGHT FIXTURES, CONDUIT, RACEWAY, LADDER TRAY, OR OTHER ELECTRICAL EQUIPMENT OR DEVICES SHALL BE COORDINATED WITH THE G.C.

3. EQUAL, SIMILAR TO "GFL" TYPE.
NO OTHER CIRCUITS ARE TO BE RUN IN SAME CONDUIT FEEDING ISOLATED GROUND RECEPTACLES.


GENERAL DEMOLITION NOTES

1. EACH CONTRACTOR SHALL REVIEW THE EXISTING SYSTEMS IN THE FIELD ALONG WITH BID DOCUMENTS AND DETERMINE SELECTIVE DEMO AND ADDITION OF TEMPORARY SYSTEMS (IF REQUIRED) TO MAKE PHASED DEMO AND PROPOSED REWORKS FULLY ASSURE THE UNINTERRUPTED SAFE OPERATION OF AREAS THAT ARE AFFECTED BY DEMO AND ADDITION OF PROPOSED SYSTEMS AT ALL TIMES...

GENERAL NOTES

1. THIS INSTALLATION SHALL BE IN COMPLIANCE WITH THE ADOPTED NEC AND ALL APPLICABLE LOCAL CODES.
BEFORE COMMENCING WORK THE CONTRACTOR SHALL VISIT THE JOB SITE TO FULLY INFORM HIMSELF OF ALL CONDITIONS THAT AFFECT THE WORK, EXAMINE THE DRAWINGS AND SPECIFICATIONS, AND SUBMIT ANY QUESTIONS IN WRITING TO THE ENGINEER.

MOUNTING HEIGHTS

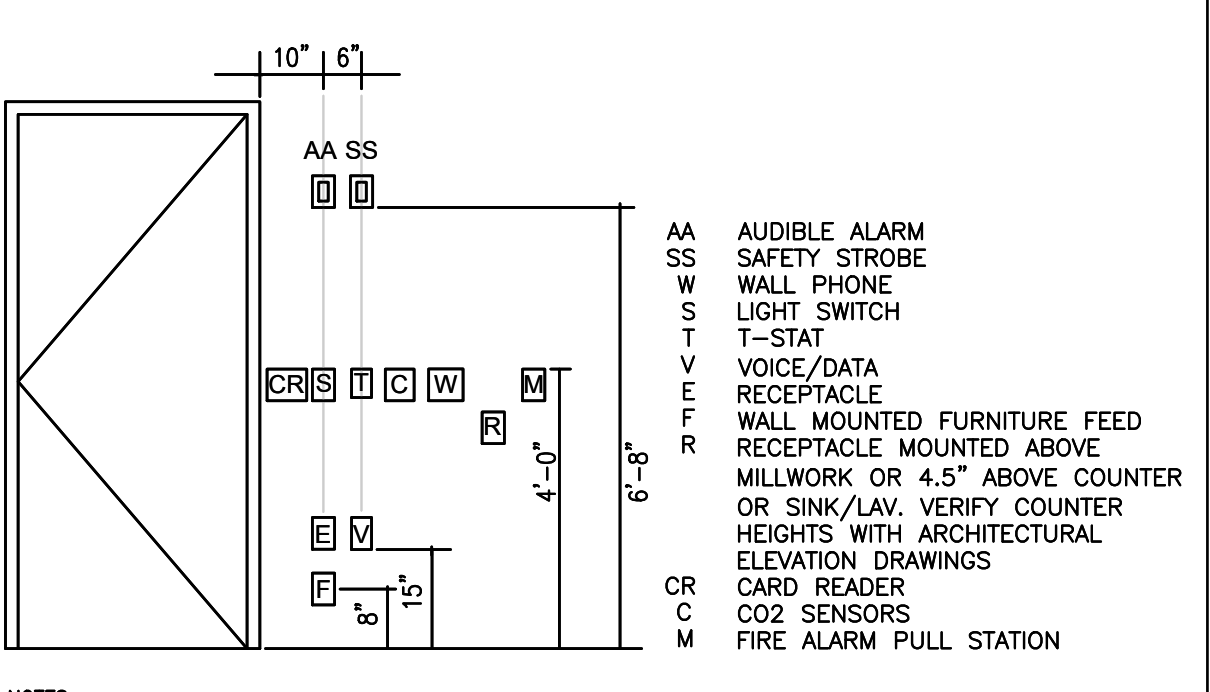

NOTES:
1. ALL HEIGHTS FOR OUTLETS ARE TO TOP OR BOTTOM OF DEVICE (UNLESS OTHERWISE INDICATED) COORDINATE WITH ARCHITECTURAL DRAWINGS. WHERE DIFFERENCES EXIST, USE ARCHITECTURAL MOUNTING HEIGHTS.

ABBREVIATIONS

Table with 2 columns: Abbreviation and Description. Includes WP (Weather Proof), W (Wall Mounted Device), AC (Above the Counter), N (New), X (Existing to Remain), C (Ceiling Mounted Device), NL (Night Light), WH (Tank Gas Water Heater), EWH (Instantaneous Electric Water Heater), EWC (Electrical Water Cooler), HD (Electric Hand Dryer), AFF (Above Finish Floor).

LEGEND

Table with 2 columns: Symbol and Description. Includes X (Existing Fixture to Remain), XO (Existing to be Removed), XRL (Existing to be Relocated), XRC (Existing to be Re-Circuited), XRP (Existing to be Replaced with New), XRPC (Existing to be Replaced with New & Re-Circuited), XRLC (Existing to be Relocated & Re-Circuited), N (New Fixture), XNC (Existing Fixture on New Circuit), XNP (Existing Location with New Fixture), XNFC (Existing Location with New Fixture & Circuit), XNLC (Existing Fixture in New Location & on New Circuit).

ELECTRICAL SYMBOL LIST

Table with 2 columns: Symbol and Description. Includes # (Duplex Receptacle), # (Ground Fault Circuit Interrupter Duplex Receptacle), WP (Ground Fault Circuit Interrupter, Weatherproof in Use Cover), # (Above Counter Duplex Receptacle, Mount at +42" AFF unless noted otherwise), # (Heavy Duty Disconnect Switch), # (Junction Box), # (Card Reader), # (Dual Tech Wall Mounted Occupancy Sensor with Auto-On/Auto-Off Function), # (Toggle Switch), # (Ceiling Mounted Occupancy Sensor (15 Minute Setting)), # (Conduit Concealed in Wall/Above the Ceiling), # (Universal Mounted (Ceiling/Wall) Exit Sign with Chevrons), # (Security Door Contact (Prepare Door, Rough-In Only up to Above Accessible Ceiling)), # (Single Pole Disconnect Switch Toggle Style).

ELECTRICAL DRAWING LIST


Table with 2 columns: Drawing ID and Description. E-0 Electrical General Notes, Symbols, Legends, and Specifications; E-1 Electrical Plans and Schedules.

ELECTRICAL GENERAL NOTES, SYMBOLS, AND LEGENDS

ISSUE FOR PLAN CHECK SUBMITTAL
08.26.2024

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WARE MALCOMB ARCHITECTURE CIVIL ENGINEERING PLANNING BUILDING MEASUREMENT INTERIORS. 3015 122nd Ave NE Suite #205 Bellevue, WA 98004 P:425.670.0706

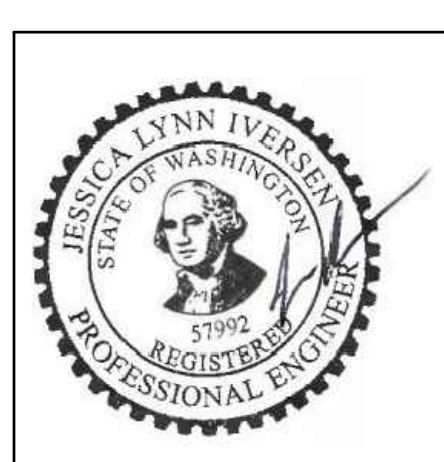

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ELECTRICAL GENERAL NOTES, SYMBOLS, AND LEGENDS. ISSUED FOR PLAN CHECK SUBMITTAL. 08.26.2024

City of Puyallup Development & Permitting Services ISSUED PERMIT. Includes Building, Planning, Engineering, Public Works, Fire, and Traffic logos. SHEET E-0 DRAWN BY: NW, BD, JC JOB NO.: SE24-0053-00

rtm engineering consultants 2800 156th Ave Southeast, Suite 115 Bellevue, WA 98007 rtmassociates.com | 347.756.4180

E-O SHEET E-1

City of Puyallup
Development & Permitting Services
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Building	Planning
Engineering	Public Works
Fire	Traffic

- GENERAL NOTES**
- SEE SHEET E-0 FOR DEMOLITION & GENERAL NOTES.
 - ELECTRICAL DEVICES ARE NEW, UNLESS NOTED OTHERWISE.
 - LIGHTING FIXTURES ARE NEW, UNLESS NOTED OTHERWISE.
 - FOR ALL ROOMS WITH OCCUPANCY SENSORS, CONTRACTOR SHALL PROVIDE ALL REQUIRED SENSORS, POWERPACKS, RELAYS, OVERRIDE SWITCHES, ETC. TO PROVIDE A COMPLETE AND OPERATIONAL SYSTEM.
 - EMERGENCY BATTERY PACKS SHALL BE CIRCUITED TO LOCAL CIRCUIT AHEAD OF SWITCHING AND CONTROLS.
 - REFER TO FIRE ALARM AND FIRE PROTECTION DESIGN SPECIFICATIONS FOR ALL REQUIRED ROUGH-INS, CONDUIT, AND REQUIRED POWER (IF APPLICABLE). FIELD-COORDINATE FIRE ALARM AND FIRE PROTECTION DEVICES AND REQUIREMENTS WITH GENERAL CONTRACTOR.

- KEY NOTES**
- EXHAUST FAN TO BE CONTROLLED WITH LIGHTING VIA OCCUPANCY SENSOR.
 - PROVIDE 1/2" CONDUIT AND PULL STRING ALONG WITH BACKBOX FOR MECHANICAL CONTROLS. REFER TO MECHANICAL DRAWINGS FOR ADDITIONAL INFORMATION.
 - PROVIDE GFCI DUPLEX RECEPTACLE UNDER SINK AT +22" AFF FOR PLUG-IN CORD PROVIDED WITH IWH-1 AND FOR POWERED FAUCET. E.C. SHALL INSTALL AND MAKE ALL FINAL CONNECTIONS FOR POWERED FAUCET VALVE, INCLUDING LOW VOLTAGE WIRING.
 - ALL ELECTRICAL DEVICES, LIGHTING FIXTURES, AND EQUIPMENT LOCATED ON WALLS OR CEILINGS WHICH ARE TO BE REMOVED SHALL BE REMOVED UNLESS NOTED OTHERWISE. RECONNECT EXISTING CIRCUITS AND WIRING AS NECESSARY SO THAT FIXTURES AND DEVICES OUTSIDE OF THE SCOPE OF WORK REMAIN OPERATIONAL.

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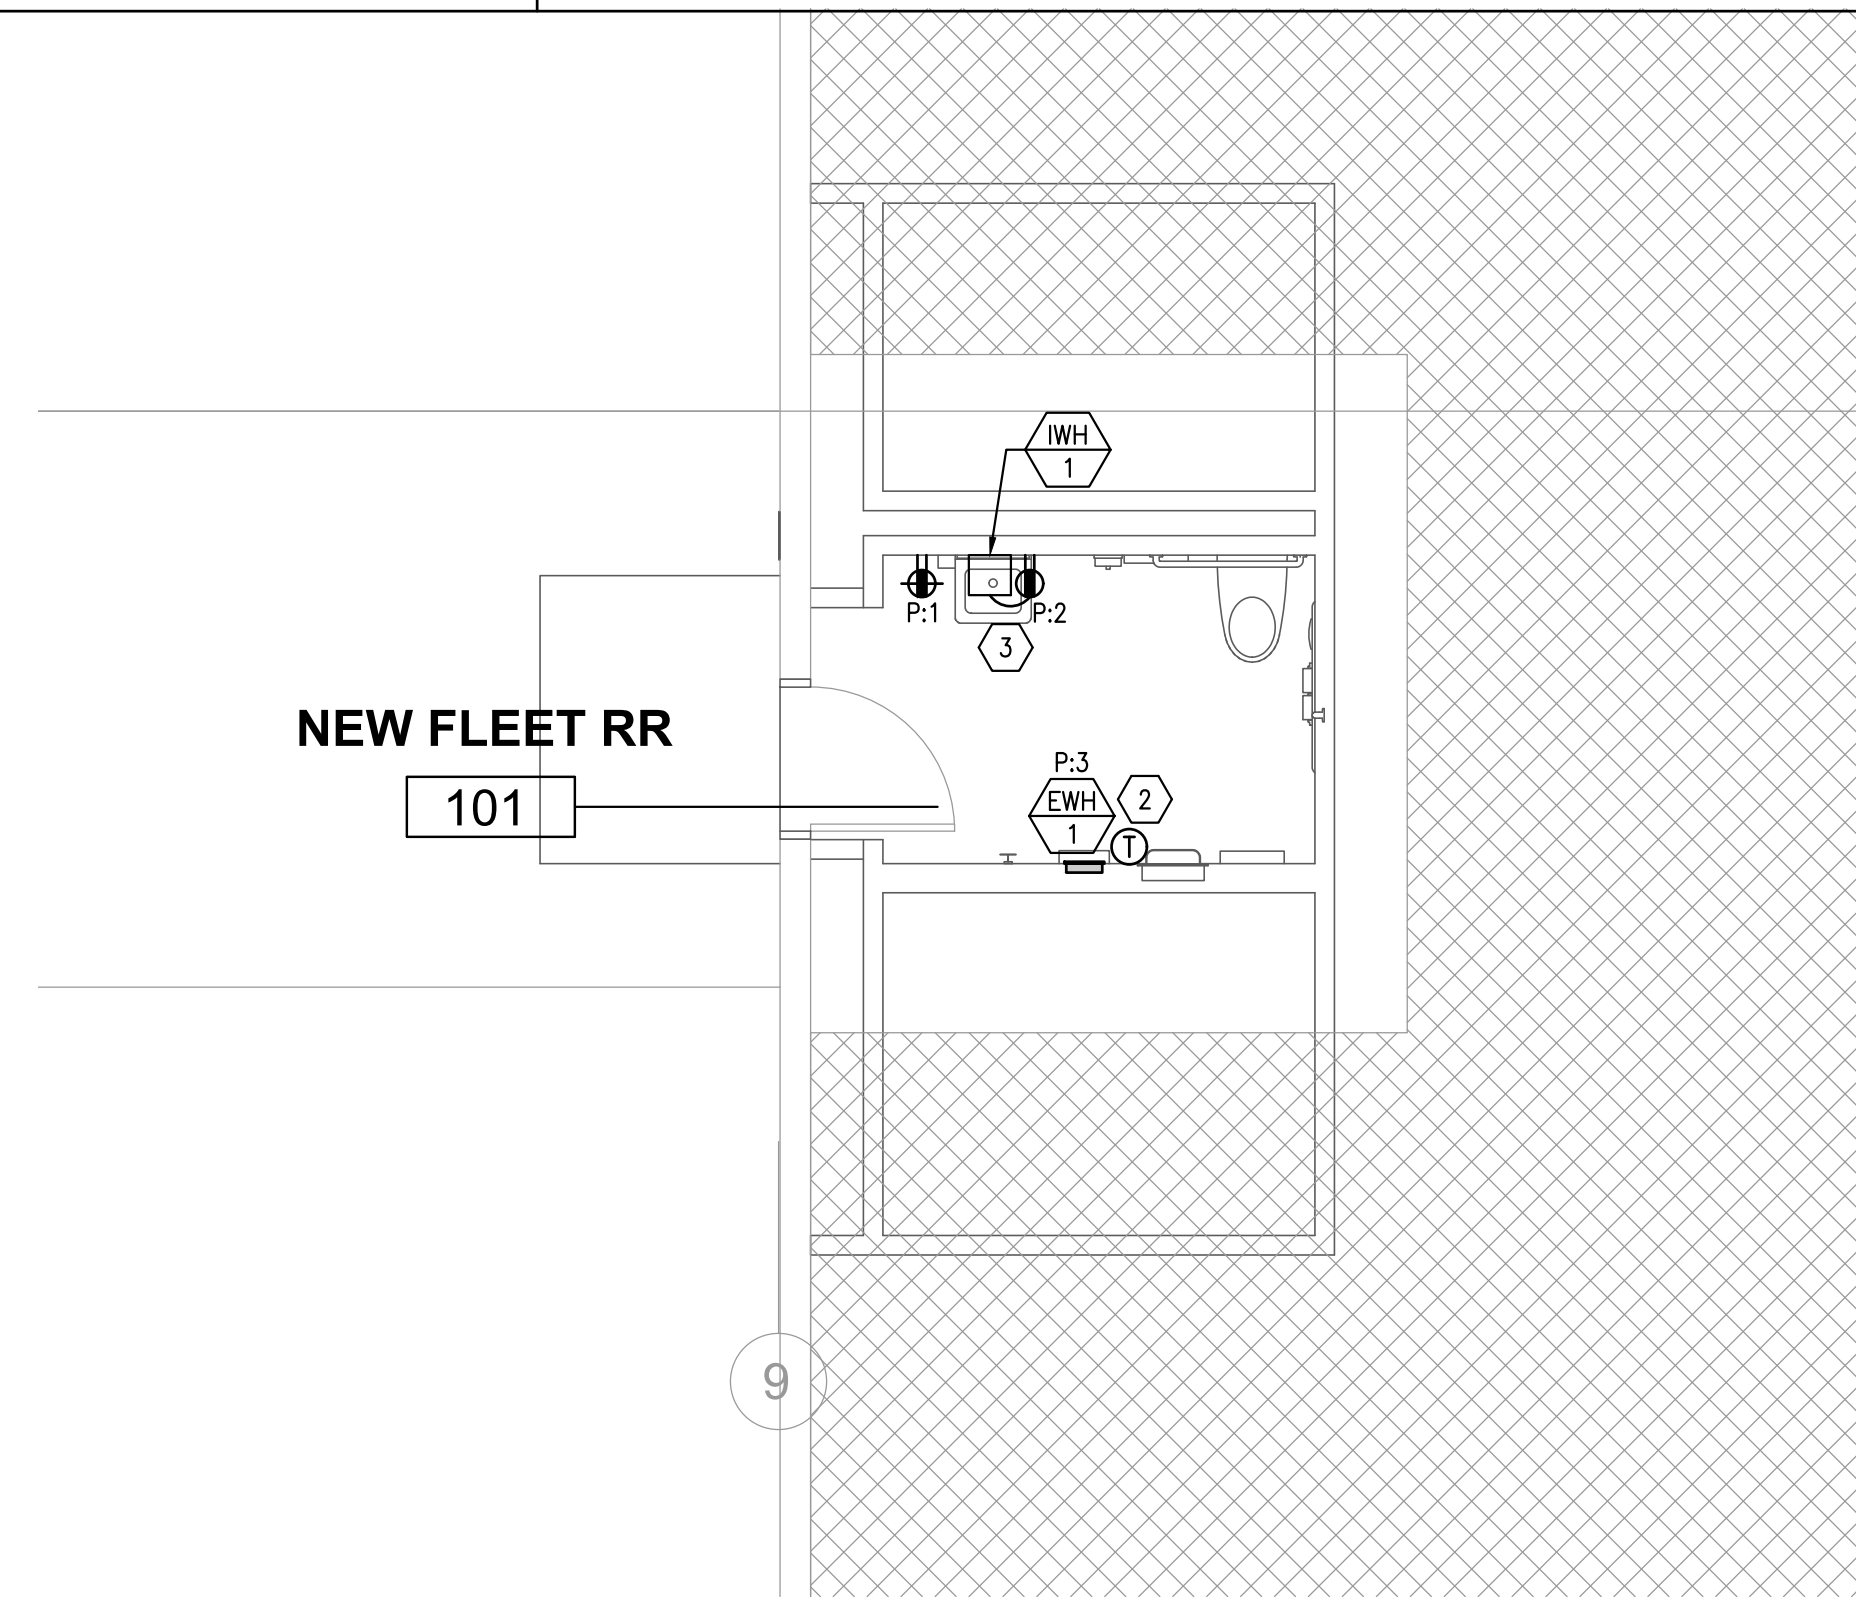
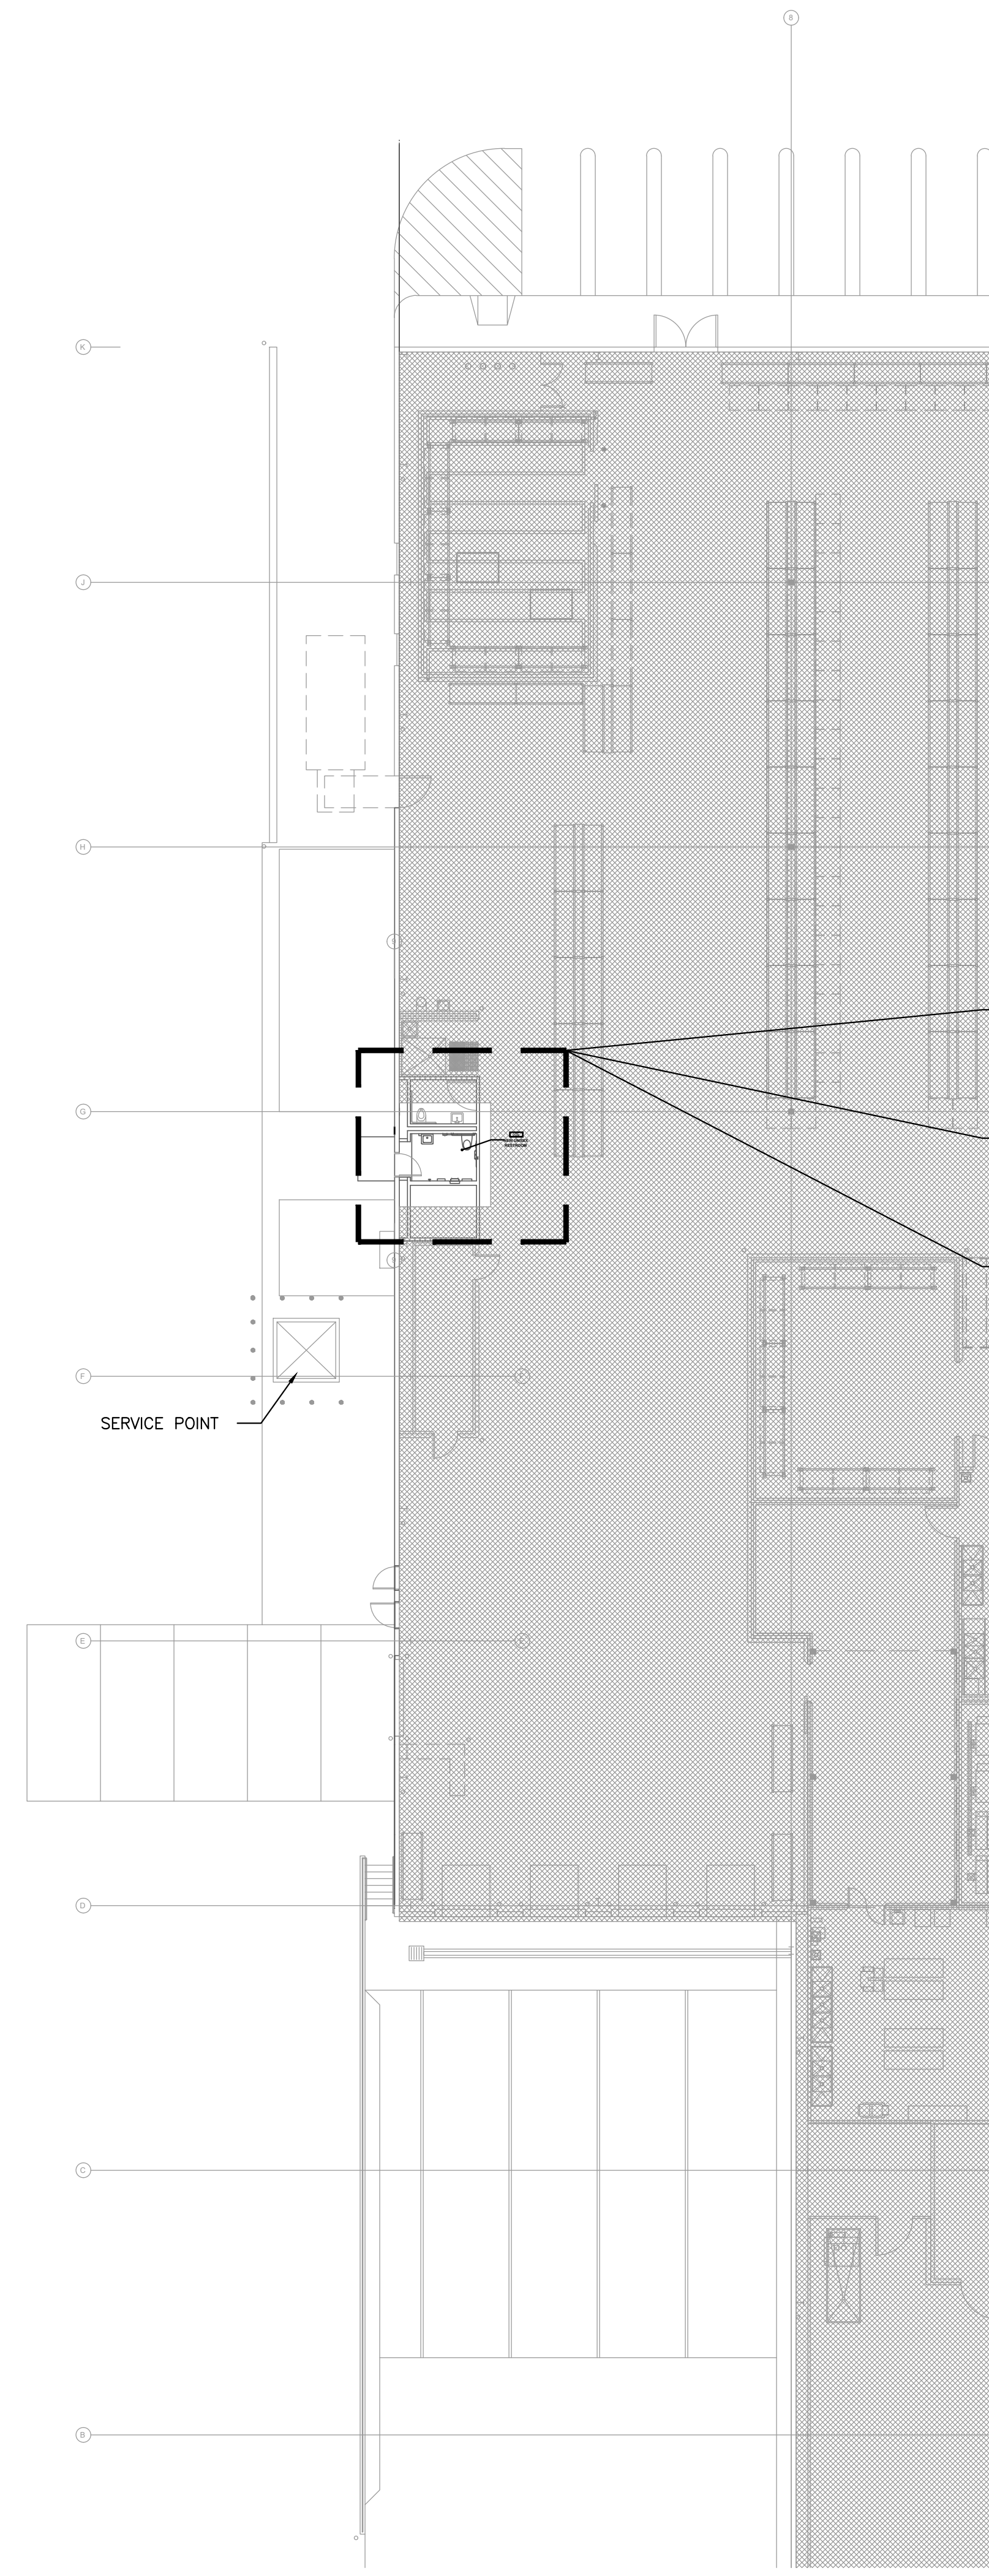
ELECTRICAL PLANS

DATE	02/22/24
REVISION	ISSUE FOR PLAN CHECK SUBMITTAL


PA/PM: JLI
DRAWN BY: NW, BD, JC
JOB NO.: SE24-0053-00

SHEET
E-1


09.20.2024 - ISSUE FOR PLAN CHECK SUBMITTAL



2 ELECTRICAL ENLARGED - POWER AND DATA PLAN
1/4" = 1'-0" ELECTRICAL N

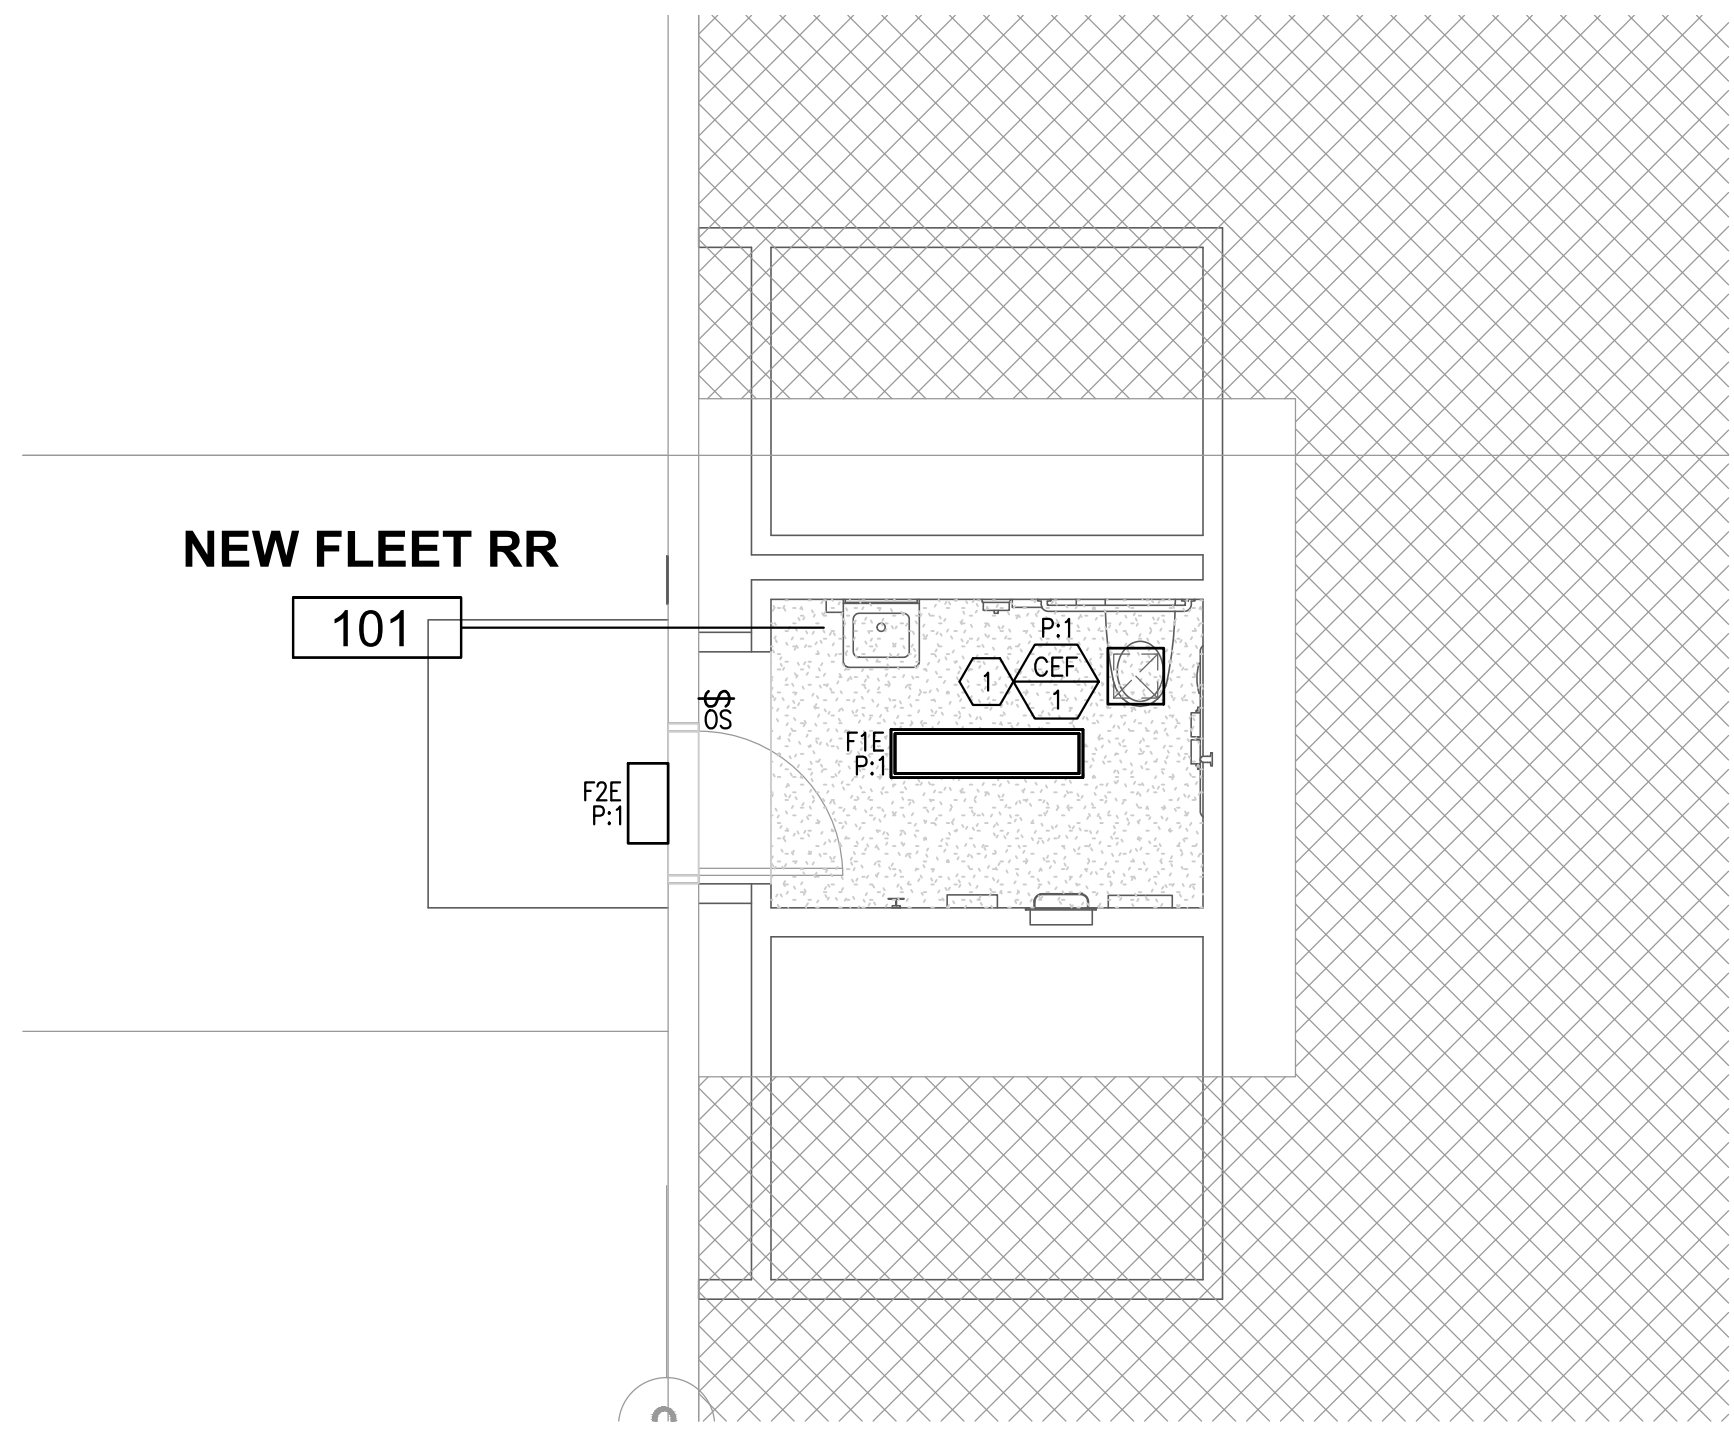

3 ELECTRICAL ENLARGED - LIGHTING PLAN
1/4" = 1'-0" ELECTRICAL N

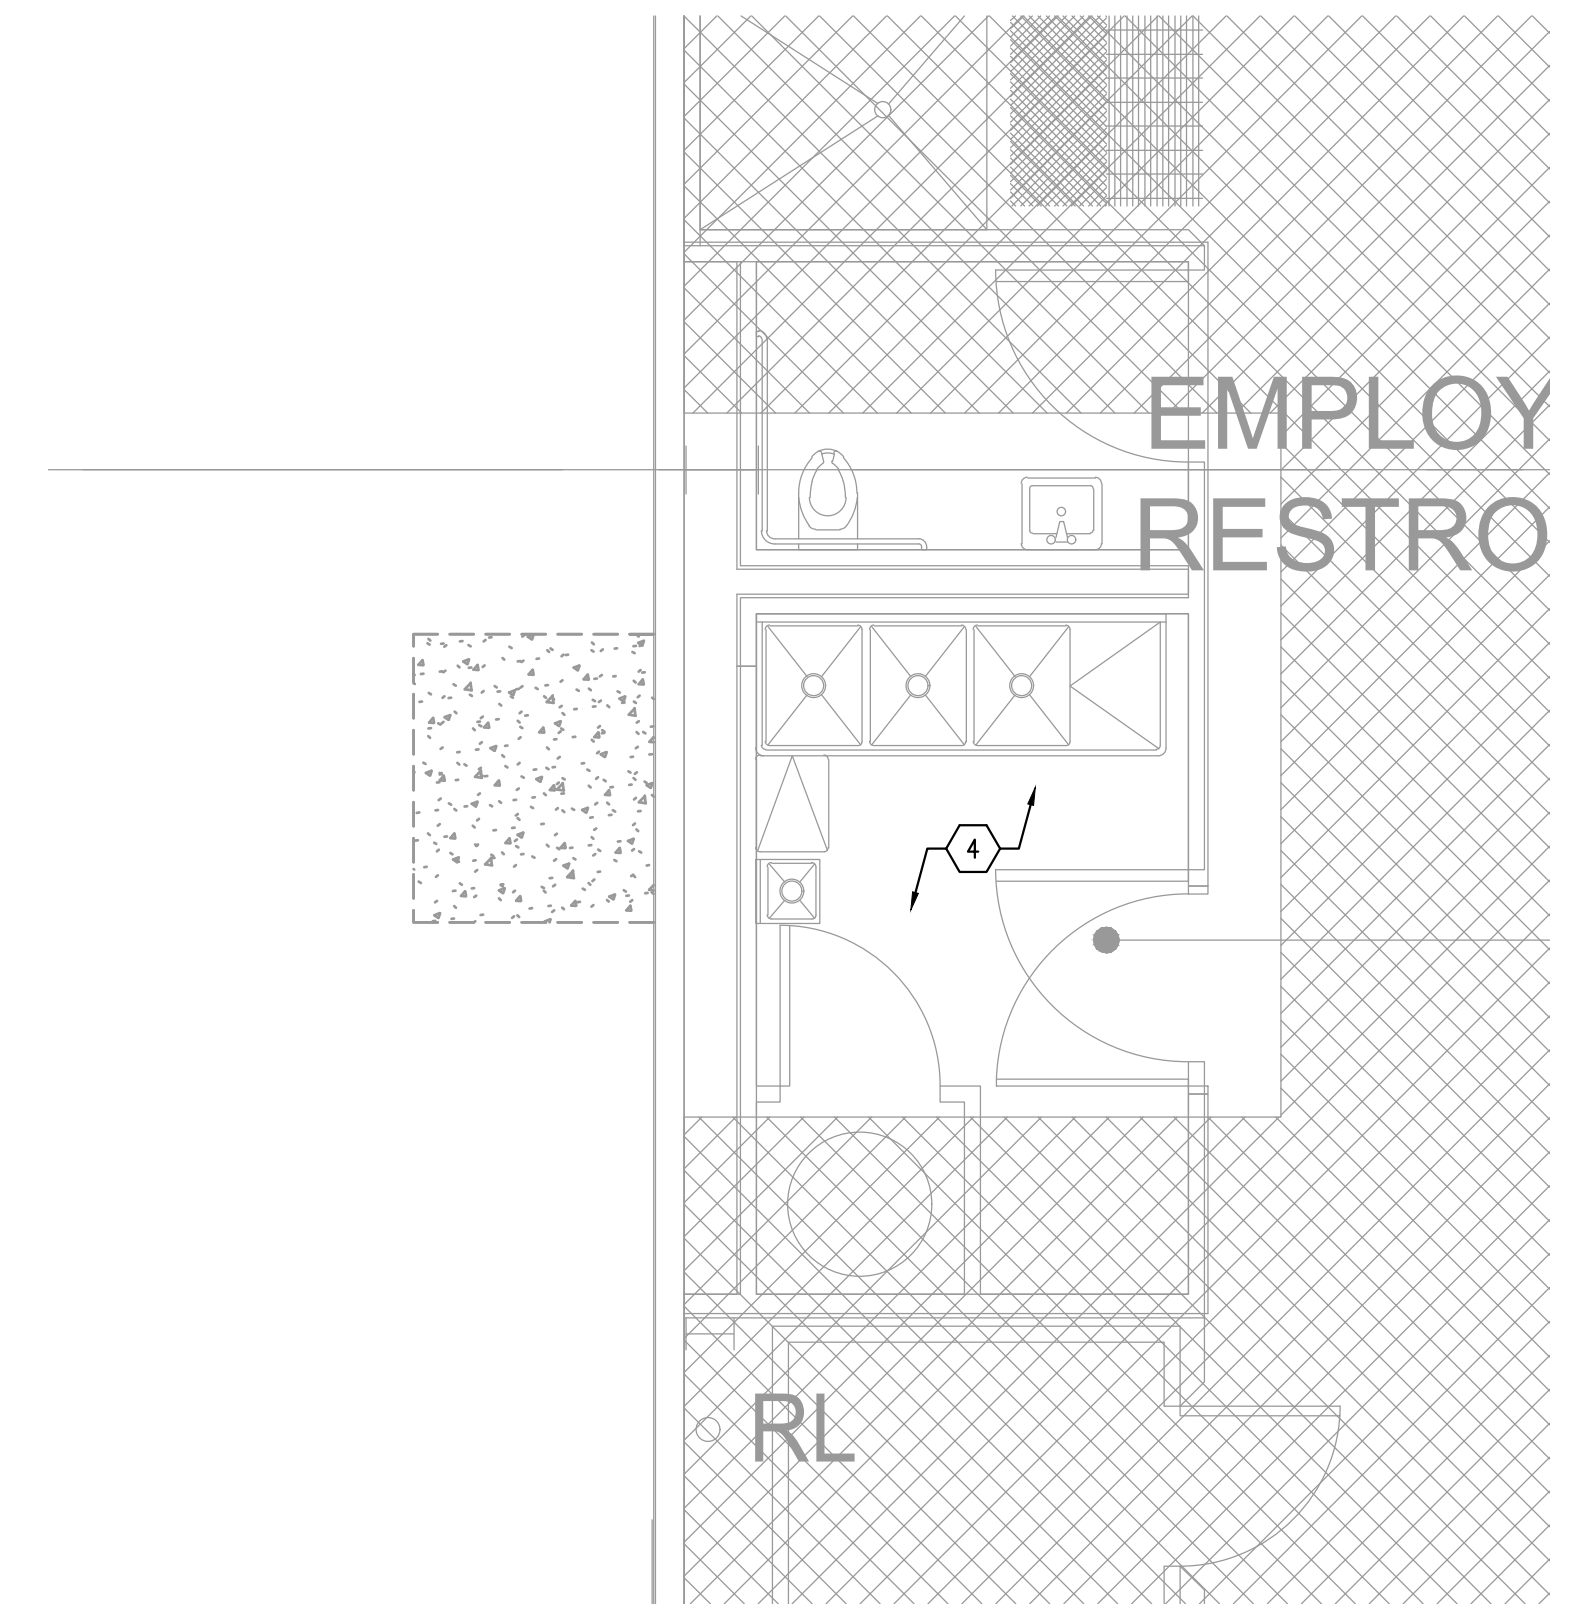

4 ELECTRICAL ENLARGED - DEMOLITION PLAN
1/4" = 1'-0" ELECTRICAL N

MECHANICAL EQUIPMENT CONNECTION SCHEDULE

TAG	DESCRIPTION	LOAD	WIRE/CONDUIT	STARTER/DISCONNECT/OCD	VOLTAGE	FEED	LOCAL DISCONNECT	REMARKS
CEF-1	EXHAUST FAN	45.7 W	2#12 AWG 1#12 AWG EQ. GND 3/4"	<input checked="" type="checkbox"/> INTEGRAL TO EQUIPMENT <input type="checkbox"/> IN MCC	120V 1#	REFER TO CIRCUIT LISTING SCHEDULE	<input type="checkbox"/> FUSED <input type="checkbox"/> NON-FUSED <input type="checkbox"/> THERMAL SWITCH, 120V, 1#P	DISCONNECT PROVIDED WITH EXHAUST FAN
EWH-1	ELECTRIC WALL HEATER	1000 W	2#12 AWG 1#12 AWG EQ. GND 3/4"	<input type="checkbox"/> INTEGRAL TO EQUIPMENT <input type="checkbox"/> IN MCC	120V 1#	REFER TO CIRCUIT LISTING SCHEDULE	<input type="checkbox"/> FUSED <input type="checkbox"/> NON-FUSED <input type="checkbox"/> THERMAL SWITCH, 120V, 1#P	DISCONNECT PROVIDED BY MC, INSTALLED BY EC. DISCONNECT TO BE LOCKABLE TYPE.
IWH-1	INSTANTANEOUS WATER HEATER	1400 W	2#12 AWG 1#12 AWG EQ. GND 3/4"	<input type="checkbox"/> INTEGRAL TO EQUIPMENT <input type="checkbox"/> IN MCC	120V 1#	REFER TO CIRCUIT LISTING SCHEDULE	<input type="checkbox"/> FUSED <input type="checkbox"/> NON-FUSED <input type="checkbox"/> THERMAL SWITCH, 120V, 1#P	IWH IS PROVIDED WITH PLUG-IN POWER CORD.

EQUIPMENT CONNECTION SCHEDULE GENERAL NOTES:

- PROVIDE POWER CONNECTIONS TO ALL ARCHITECTURAL, MECHANICAL, PLUMBING, FIRE PROTECTION, AND OWNER FURNISHED EQUIPMENT. REFER TO ARCHITECTURAL, MECHANICAL, PLUMBING, AND FIRE PROTECTION DRAWINGS FOR LOCATIONS AND POWER REQUIREMENTS. VERIFY ALL TECHNICAL DATA WITH FINAL SHOP DRAWINGS.
- OVER CURRENT PROTECTION SIZES LISTED ARE FROM MANUFACTURER'S AND STANDARD MOTOR DATA. FURNISH FUSES BASED ON FUSE MANUFACTURER'S STANDARDS, ACTUAL FIELD MEASURED FULL LOAD CURRENT, AND EQUIPMENT MANUFACTURER'S REQUIREMENTS.
- FLEXIBLE CONNECTIONS TO MOTORS SHALL BE IN FLEXIBLE CONDUIT. PROVIDE COPPER EQUIPMENT GROUND FROM DISCONNECT TO MOTOR CONNECTION.

EQUIPMENT CONNECTION SCHEDULE KEY NOTES:

- VERIFY FINAL LOCATION OF ALL EQUIPMENT WITH EQUIPMENT INSTALLER BEFORE INSTALLING FEEDERS.
- SEE ARCHITECTURAL, MECHANICAL, PLUMBING AND FIRE PROTECTION DRAWINGS FOR MORE INFORMATION.
- SIZE STARTER/FEEDER DISCONNECT PER FINAL EQUIPMENT REQUIREMENTS.
- PROVIDE FEEDER AS INDICATED, VERIFY WITH EQUIPMENT REQUIREMENTS.
- PROVIDE OVERLOAD PROTECTION (FUSES OR MOTOR CIRCUIT PROTECTOR) PER SPECIFICATIONS, ACTUAL FIELD MEASURED FULL LOAD CURRENT, AND EQUIPMENT MANUFACTURER'S REQUIREMENTS.
- VERIFY FINAL VOLTAGE AND PHASE REQUIREMENTS OF ALL EQUIPMENT WITH INSTALLER BEFORE INSTALLING FEEDERS.
- COORDINATE SHORT CIRCUIT OCD RATING WITH FINAL EQUIPMENT REQUIREMENTS.
- EC TO PROVIDE LOCAL DISCONNECT WITHIN 5'-0" OF EQUIPMENT.
- NON-STANDARD ITEMS, TIMERS, METERS, INTERLOCKS, ETC.

LIGHTING FIXTURE SCHEDULE

TYPE	SYMBOL	FIXTURE	VOLTS	LAMPS		MOUNTING		MANUFACTURER & CATALOG # OR APPROVED EQUAL	DESCRIPTION
				TYPE	WATT	LOCATION	HEIGHT		
F1E	[Symbol]	LED 120/277V	32.4W LED	32.4W	RECESSED IN CEILING	SEE ARCH RCP	LITHONIA LIGHTING LBL4 4000LM 80CRI 40K MINI ZT MVOLT ETWOLCP	CEILING-MOUNTED STRIP LIGHTING WITH INTEGRAL 90-MINUTE BATTERY BACK-UP. SET COLOR TEMPERATURE 40K AND WATTAGE TO 32W.	
F2E	[Symbol]	LED 120/277V	25W LED	25W	SURFACE	SEE ARCH RCP	LITHONIA LIGHTING WST LED P2 40K VW MVOLT PH1FC3V E20WC DOBXD	EXTERIOR WALL PACK WITH 90-MINUTE BATTERY BACK-UP AND INTEGRAL PHOTOCELL & OCCUPANCY SENSOR.	

LIGHTING FIXTURE SCHEDULE NOTES


- INSTALLATION OF LIGHTING FIXTURES SHALL BE ACCORDING TO MANUFACTURER'S RECOMMENDATIONS AND APPLICABLE CODE REQUIREMENTS.
- ALL LIGHT FIXTURES SHALL BE FURNISHED AND INSTALLED BY THE ELECTRICAL CONTRACTOR UNLESS NOTED OTHERWISE.
- COORDINATE ALL MOUNTING HEIGHTS WITH ARCHITECT.

120/208V PANELBOARD SCHEDULE CIRCUIT LISTING

NUMBER*	QCP SIZE	POLES	VOLTAGE	WATTAGE
P-1	20A	1P	120V	271W RECEPTACLES, LIGHTING, EF-1
P-2	20A	1P	120V	1400W IWH-1, AUTO-FAUCET
P-3	20A	1P	120V	1000W EWH-1

* E.C. SHALL VERIFY EXACT CIRCUIT NUMBERS. THESE CIRCUIT NUMBERS ARE PROVIDED FOR REFERENCE ONLY. VERIFY SPARE CIRCUITS/EMPTY CIRCUIT IN FIELD. BALANCE LOAD BETWEEN PHASES SO AS NOT TO EXCEED +/-5%. VERIFY THAT PANEL IS NEVER LOADED OVER 80%.

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PLUMBING SYMBOLS

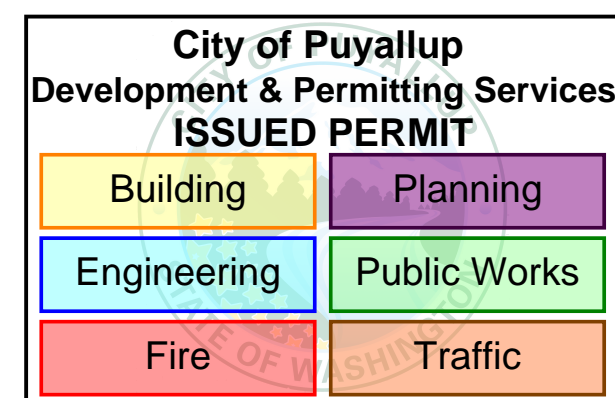Table with columns for ANNOTATION, PIPING, and ABBREVIATIONS. Includes symbols for connection points, mounting heights, and various pipe components like valves and traps.

PLUMBING GENERAL NOTES:

- List of 26 plumbing general notes covering drawing standards, construction requirements, material specifications, and installation details.

PLUMBING SPECIFICATIONS

- Standards and Codes (A, B, C) and Insulating Adapters (A, B) specifications.

RECORD DRAWINGS:

Maintain a complete and accurate record of all changes or deviations to the contract documents and shop drawings.

- 1. Provide nipples and valves as required to introduce disinfectant and water.
2. Fill the system uniformly with a disinfection solution...

TESTING - SOIL, WASTE & VENT:

- A. General: After portions of drainage, waste and vent systems are completed...
B. Water test: Apply water test to piping in its entirety or in sections...

TESTING - POTABLE WATER:

After portions of the potable water system has been completed, the work shall be hydrostatically tested...

FLUSHING:

- A. Building domestic cold water and hot water piping shall be cleaned and flushed...
1. Remove screens from all in-line strainers...
2. Open all control valves to fully open position...

DISINFECTING:


All piping material and joining methods contingent on authority having jurisdiction approval...

PLUMBING SHEET LIST table with columns for sheet number and description.


BASIS OF DESIGN: PLUMBING SYSTEM WAS DESIGNED BASED ON THE BEST AVAILABLE INFORMATION AT THE TIME OF DRAWING PREPARATION...

PIPE MATERIAL SCHEDULE table with columns for APPLICATION, LOCATION, SIZE, MATERIAL, and JOINING METHOD.


PIPE INSULATION SCHEDULE table with columns for TYPE, SIZE, FLUID TEMP RANGE (F), INSULATION CONDUCTIVITY, and INSULATION THICKNESS.

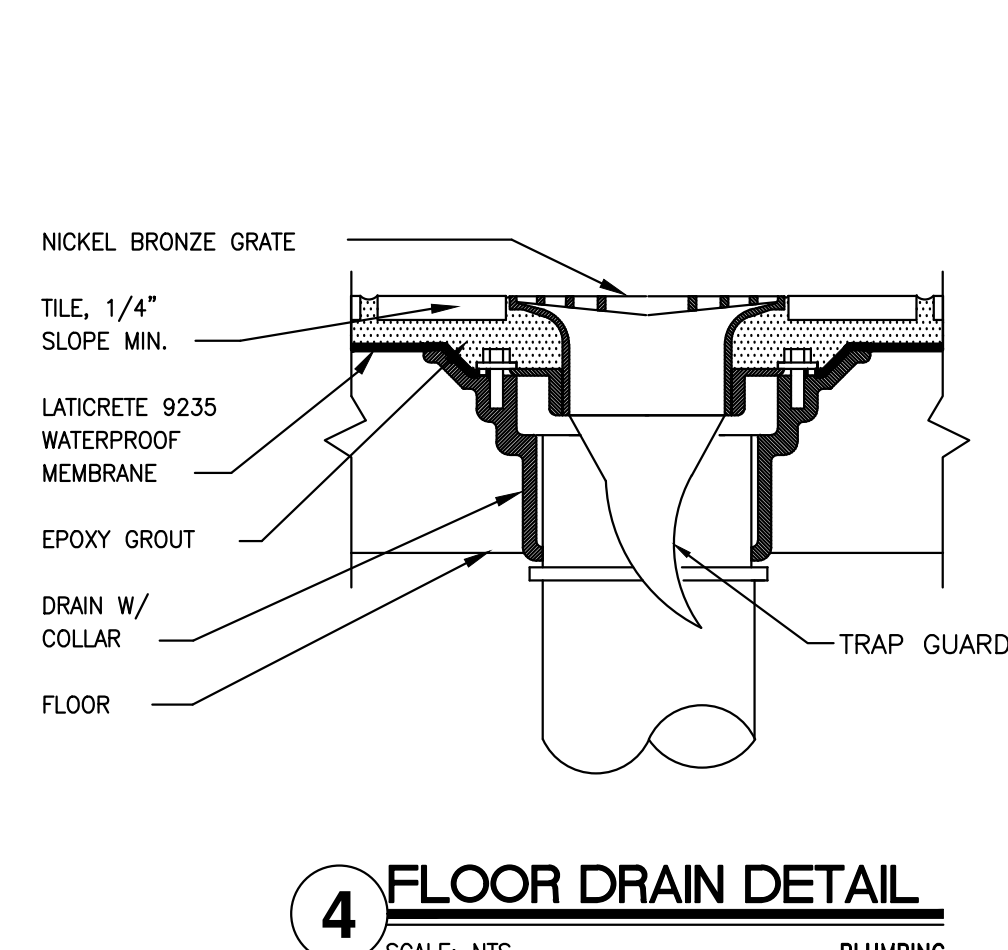


4 FLOOR DRAIN DETAIL SCALE: NTS PLUMBING

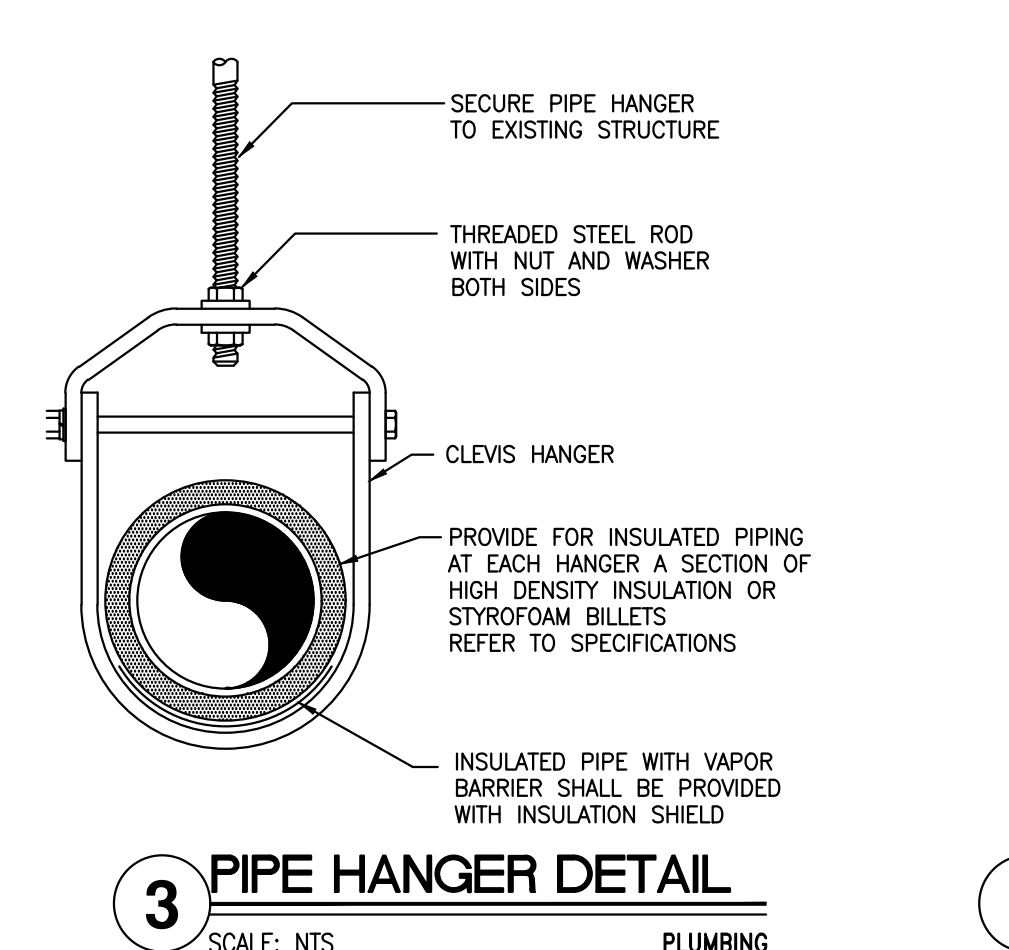

3 PIPE HANGER DETAIL SCALE: NTS PLUMBING

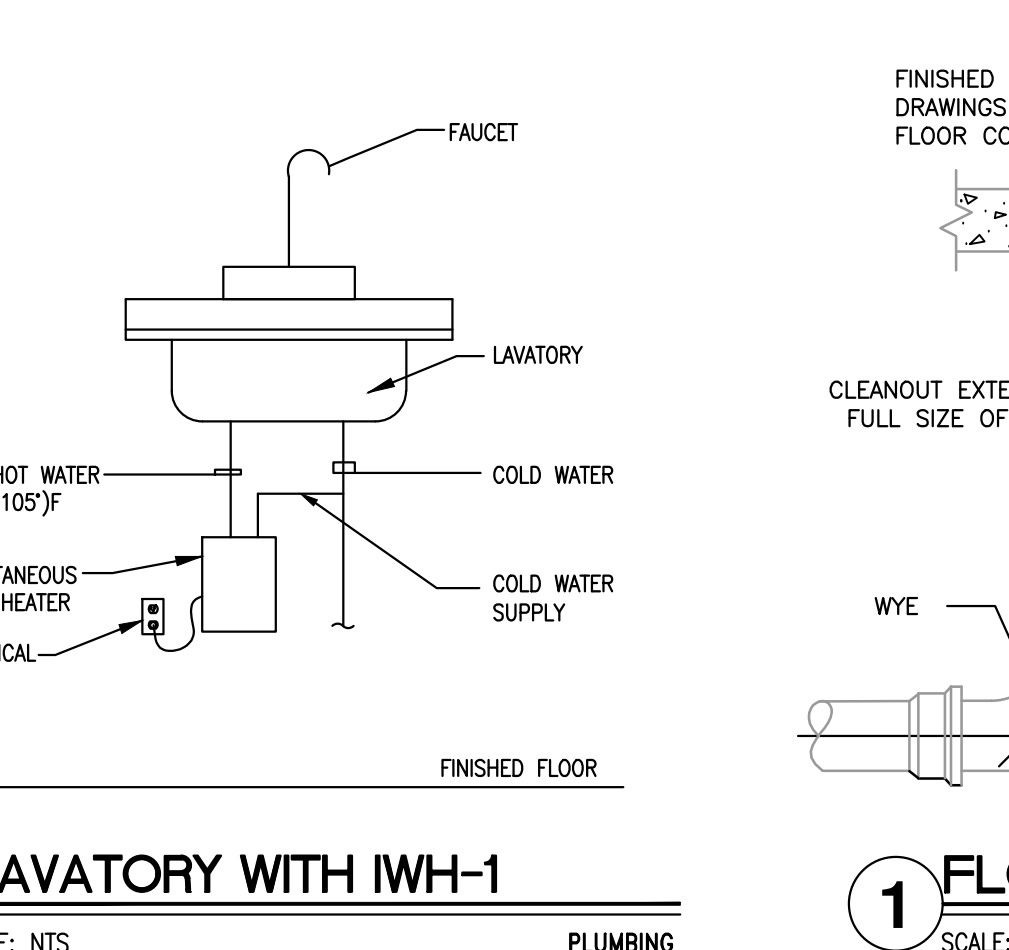


2 LAVATORY WITH IWH-1 SCALE: NTS PLUMBING

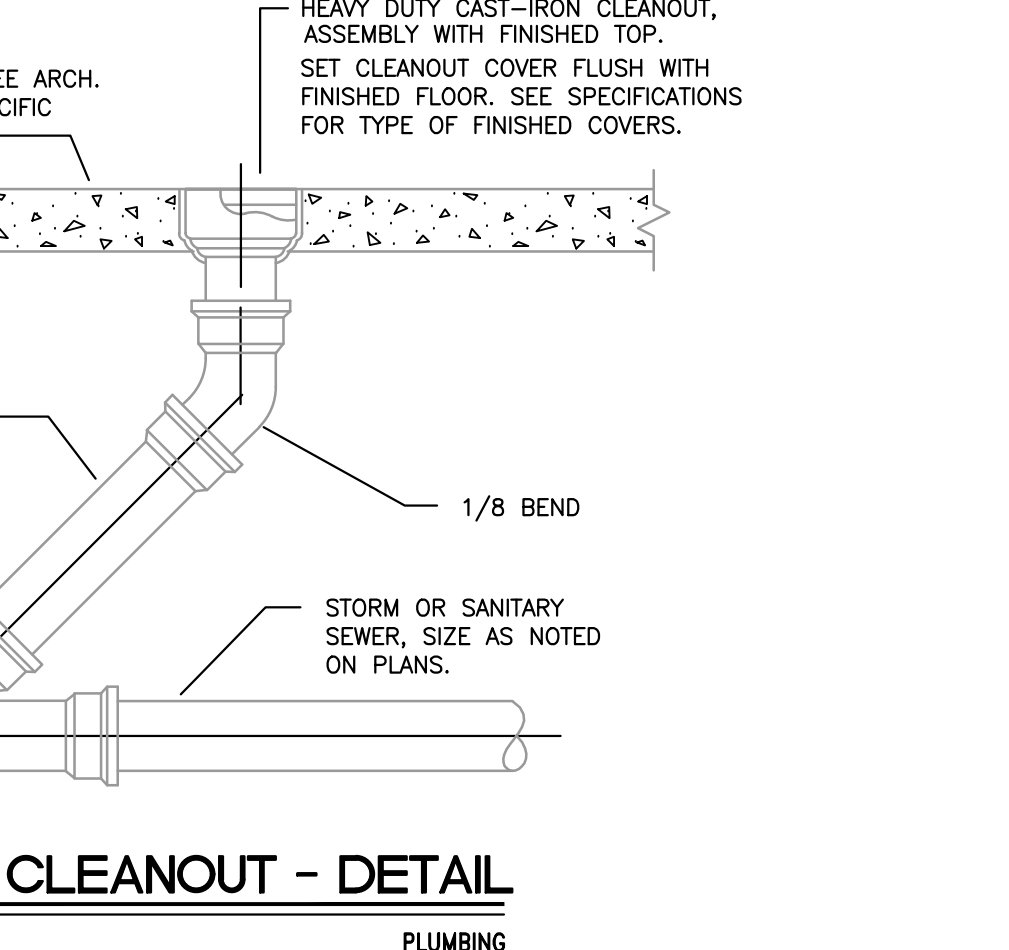

1 FLOOR CLEANOUT - DETAIL SCALE: NTS PLUMBING


WARE MALCOMB logo and contact information including address, phone, and email.

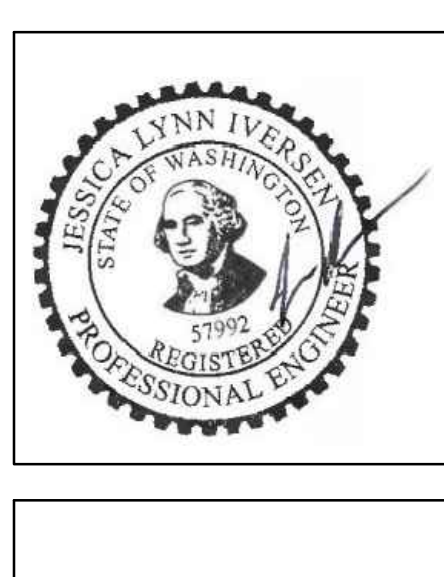

COSTCO FLEET R.R. PUYALLUP WH# 660 1201 39TH AVE SW PUYALLUP, WA 98373-3803

PLUMBING GENERAL NOTES, SYMBOLS, AND LEGENDS SUBMITTAL table with columns for date and description.

PA/PM: JLI DRAWN BY: NW, BD, JC JOB NO.: SE24-0053-00 SHEET P-0

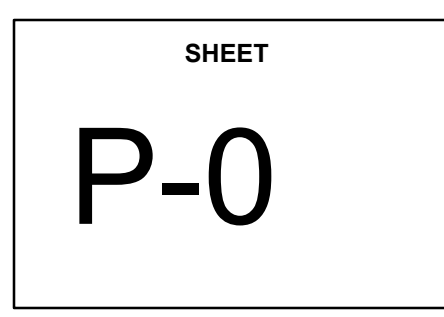

GENERAL NOTES

1. REFER TO GENERAL NOTES AND SPECIFICATIONS ON SHEET P-0.

KEY NOTES

1. EXTEND NEW 4" SAN TO NEAREST EXISTING 4" SAN LINE OR LARGER LOCATED INSIDE EXISTING BUILDING. CONTRACTOR TO FIELD VERIFY EXACT LOCATION OF CONNECTION POINT.
2. 2" VENT TO 3" VTR. VTR TO MAINTAIN 10"-0" CLEARANCE FROM ANY MECHANICAL FRESH AIR INTAKE.
3. EXTEND NEW 1-1/4" CW FROM NEAREST EXISTING 1-1/4" CW LINE OR LARGER LOCATED INSIDE EXISTING BUILDING. CONTRACTOR TO FIELD VERIFY EXACT LOCATION OF CONNECTION POINT.
4. IWH-1 TO BE INSTALLED ON WALL BELOW LAV-1. COORDINATE EXACT LOCATION WITH ARCHITECT.

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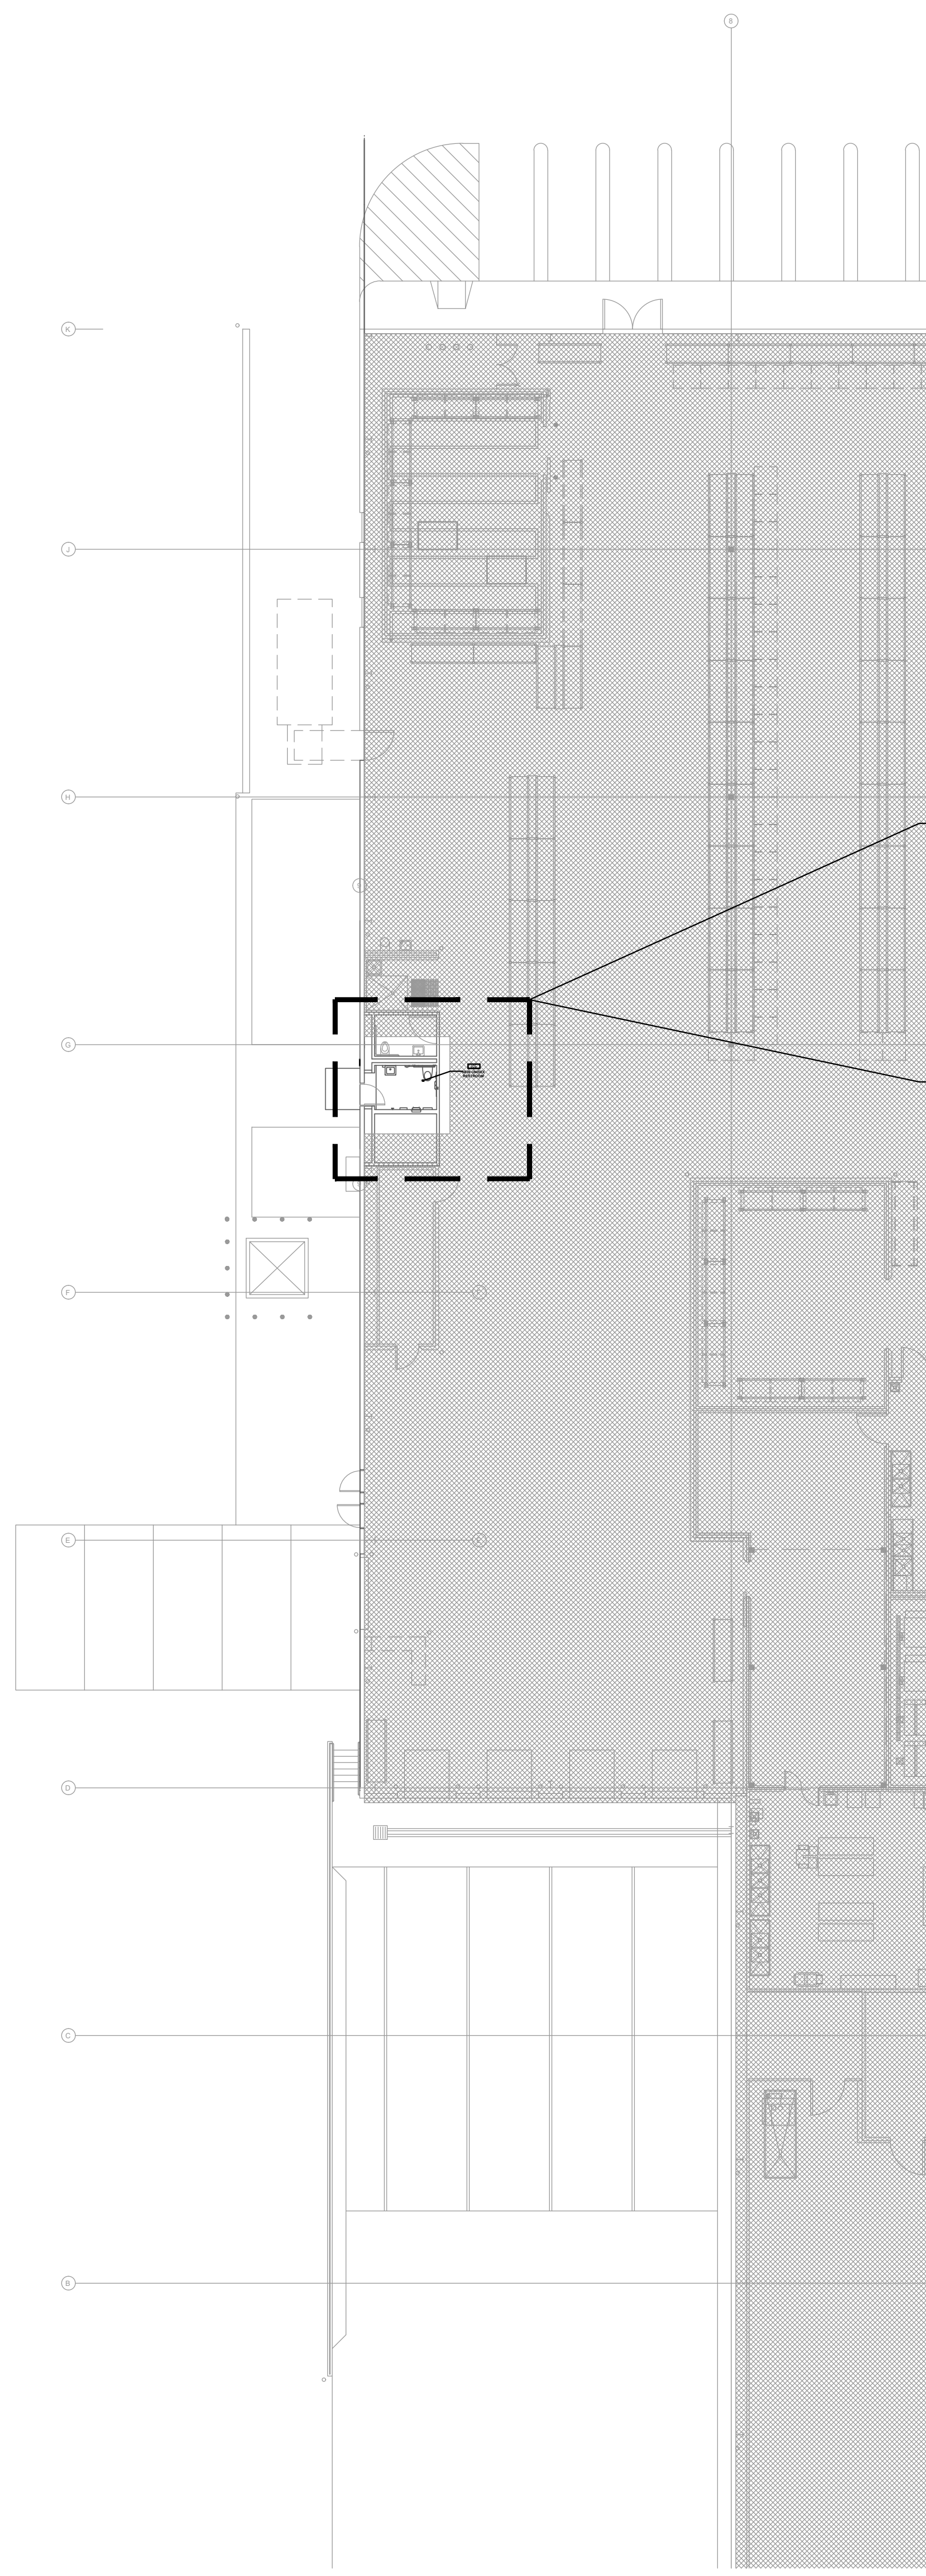
ELECTRICAL WATER HEATER SCHEDULE

TAG	DESCRIPTION	STORAGE (GAL)	TEMP RISE F	ELECTRIC					WEIGHT (lbs)	MANUFACTURER	MODEL NO.
				AMPS	KW	V	PH	HZ			
IWH-1	ELECTRIC WATER HEATER	2.5	50	10	1.4	120	1	60.0	17.6	EEMAX	EMT2.5


REMARKS:
1. PROVIDED WITH POWER CORD.
2. SET TEMPERATURE TO 105 DEG F.

PLUMBING FIXTURES SCHEDULE

TAG	PLUMBING FIXTURE	MANUFACTURER	MODEL	WASTE	VENT	CW	HW	REMARKS
WC-1	WATER CLOSET	ZURN	Z5615	4"	2"	1-1/4"	-	ECOVANTAGE MANUAL FLUSH VALVE TOILET SYSTEM. WALL HUNG SIPHON JET, ELONGATED BOWL, WHITE VITREOUS CHINA. PROVIDE WITH Z5600AV-HET MANUAL FLUSH VALVE, 1.28 GPF. PROVIDE WITH Z5955SS-EL, WHITE, ELONGATED, OPEN FRONT SEAT, LESS COVER WITH STAINLESS STEEL CHECK HINGE. PROVIDE ZURN ZN1201-N CARRIER.
LAV-1	LAVATORY	KOHLER	K-2005-0	1-1/2"	1-1/4"	1/2"	1/2"	WALL MOUNTED LAVATORY WITH HANGERS, DRILLED FOR CONCEALED ARM CARRIER, WITH 4" CENTERS. PROVIDE WITH SLOAN ETF-600 OPTIMA SENSOR FAUCET, PLUG ADAPTER, BELOW DECK THERMOSTATIC MIXING VALVE, POLISHED CHROME, 0.5 GPM, MULTI-LAMINAR
FD-1	FLOOR DRAIN	ZURN	ZN-415	2"	2"	-	-	TYPE N STRAINER, ADJUSTABLE FLOOR DRAIN WITH DUCCO-COATED CAST IRON BODY, FLASHING COLLAR, NICKEL BRONZE FINISH.




2 PLUMBING ENLARGED - SANITARY AND VENT PLAN
1/4" = 1'-0"

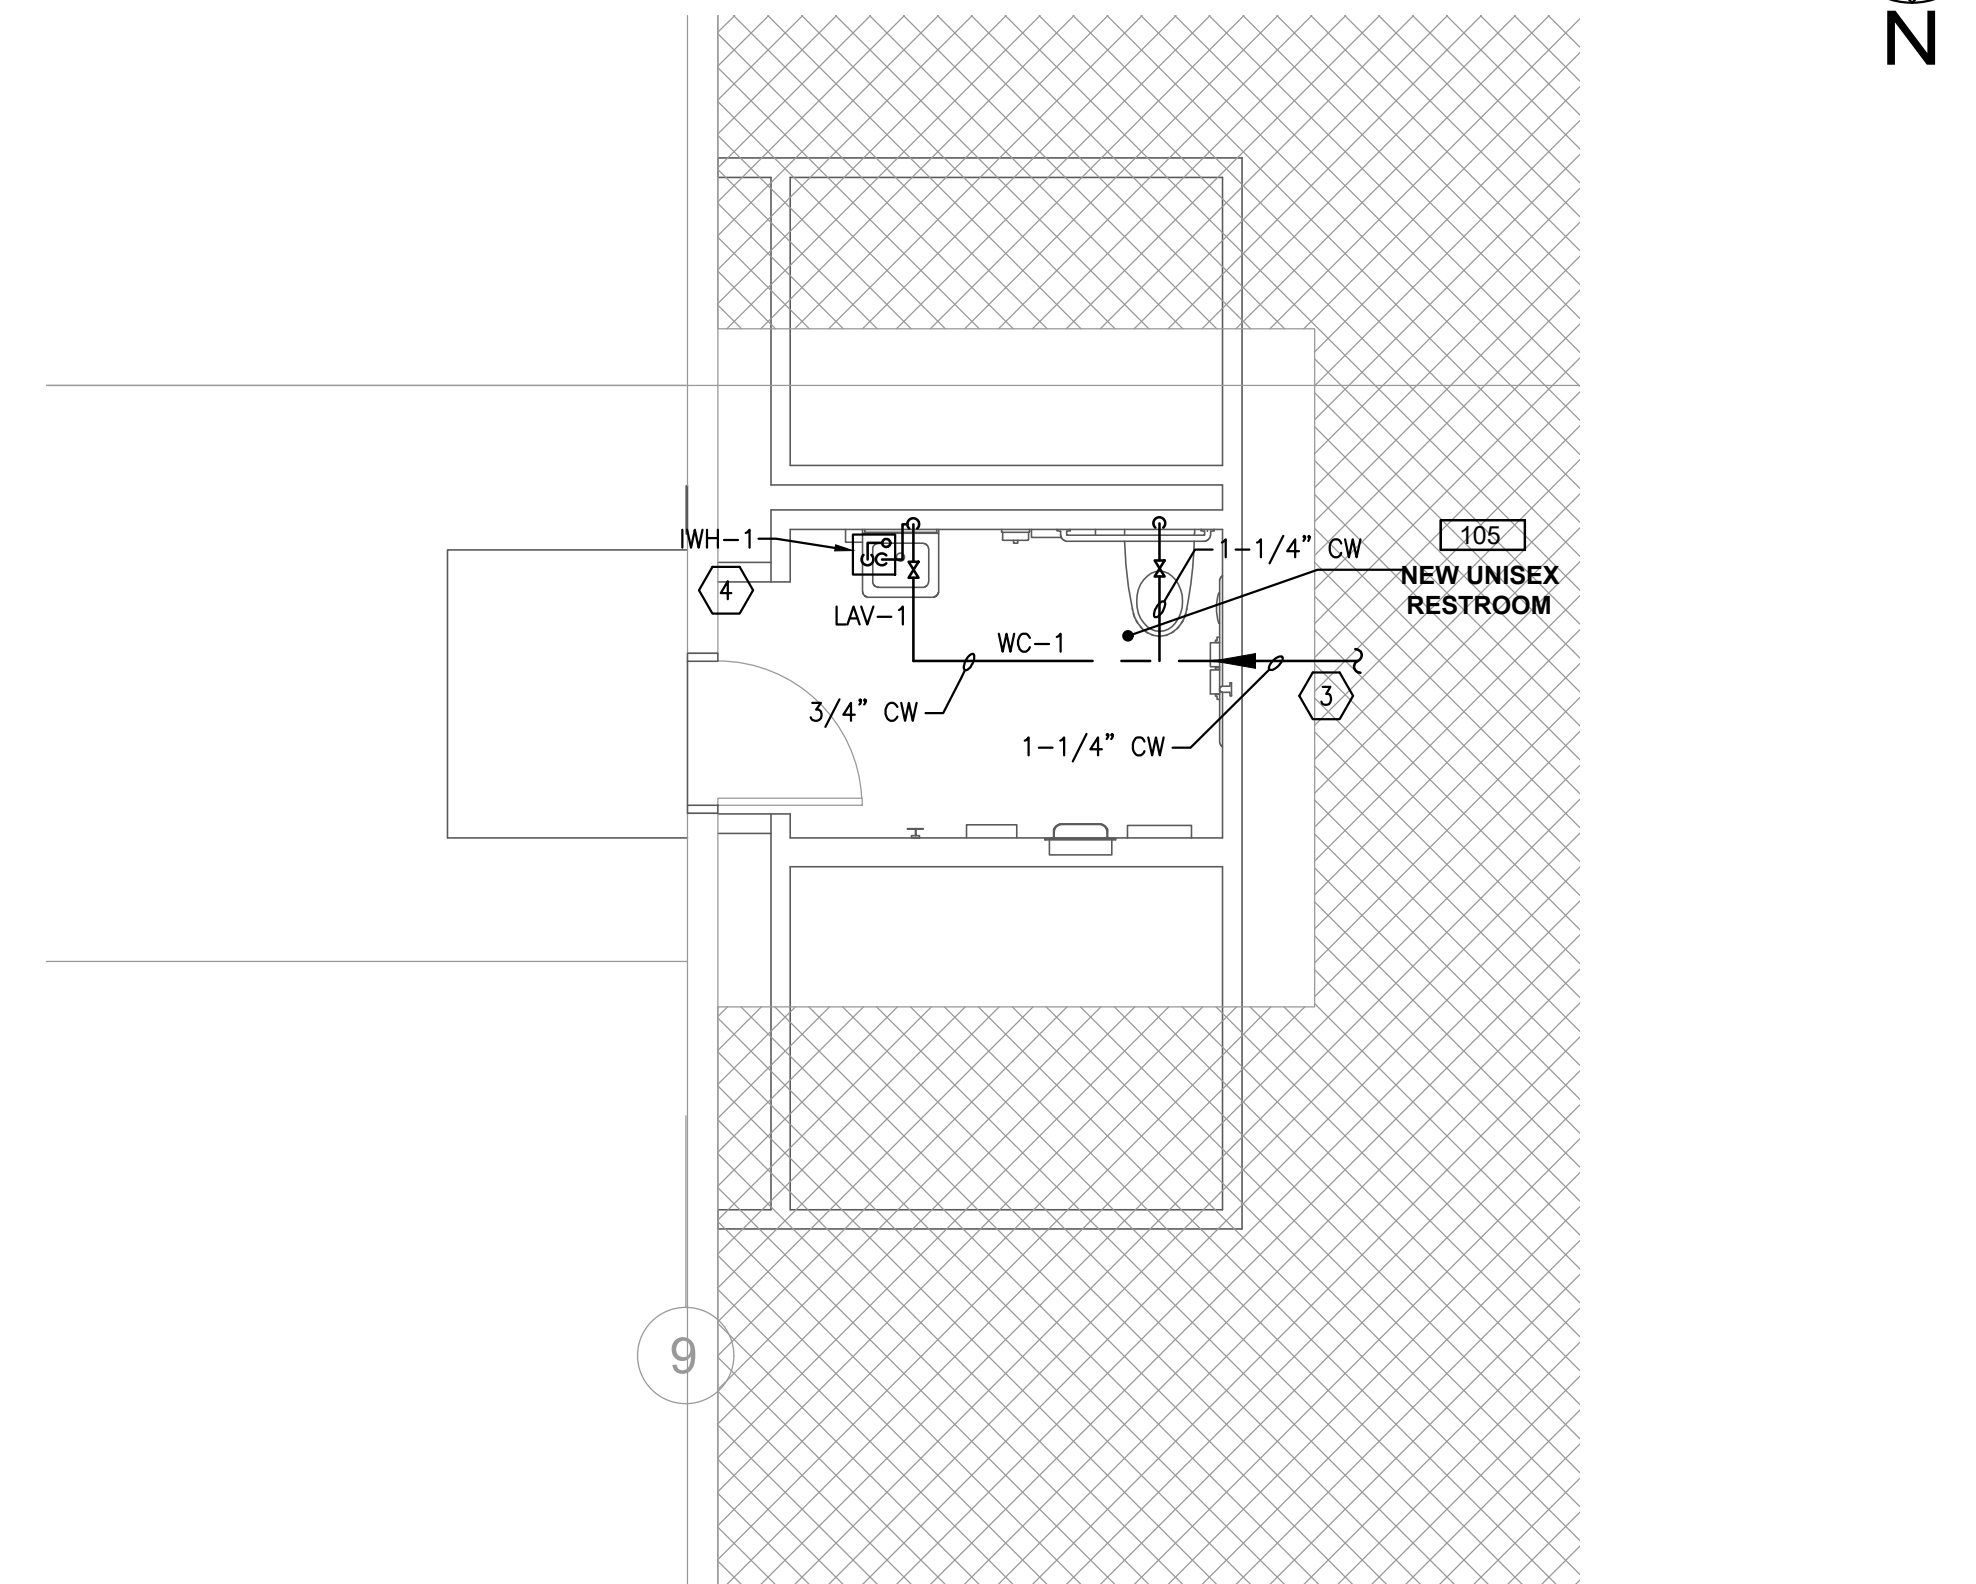


3 PLUMBING ENLARGED - DOMESTIC WATER PLAN
1/4" = 1'-0"



4 PLUMBING - SANITARY + VENT RISER DIAGRAM
N.T.S

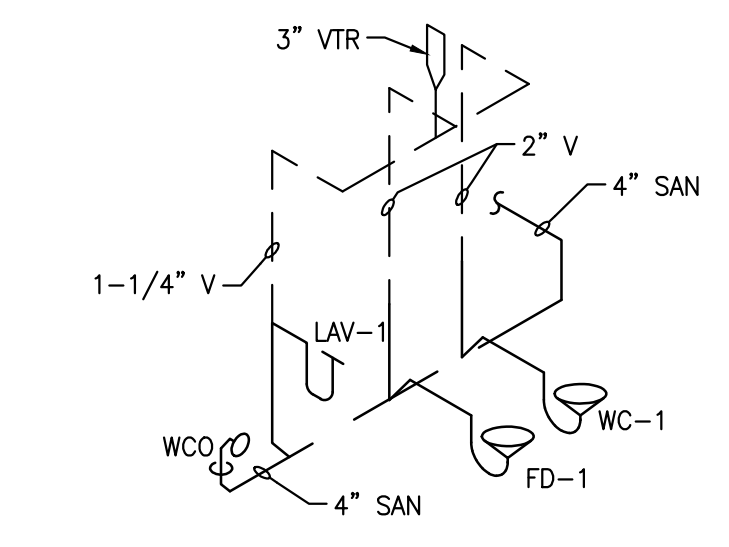

5 PLUMBING - DOMESTIC WATER RISER DIAGRAM
N.T.S

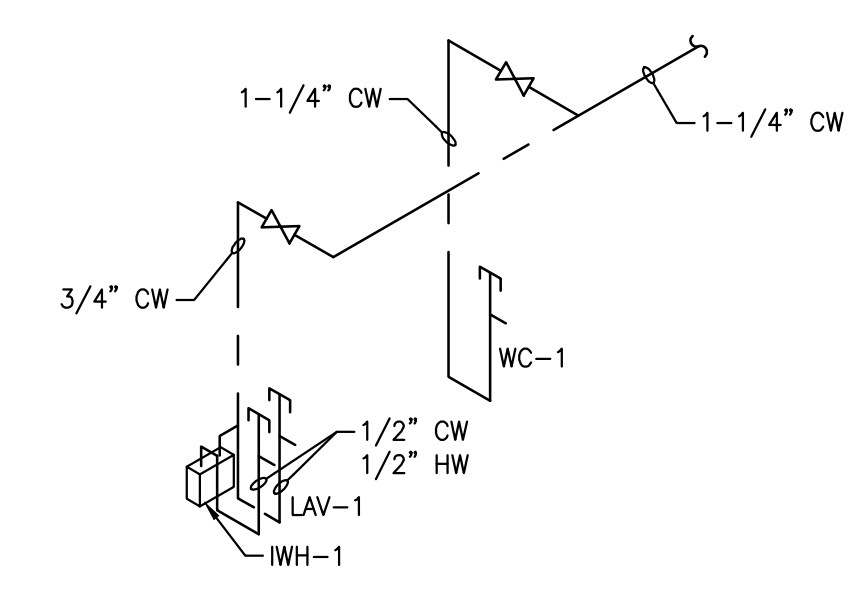

1 PLUMBING OVERALL PLAN
1/16" = 1'-0"

PLUMBING PLANS

DATE	REVISIONS
03/22/2024	ISSUE FOR PLAN CHECK SUBMITTAL

PA/PM:	JLI
DRAWN BY:	NW, BD, JC
JOB NO.:	SEA24-0053-00

SHEET
P-1

