

- INTEGRAL ELECTRONIC DISTANCE MEASURING METER (TRIMBLE S-6) AND REAL TIME KINEMATIC (RTK) / STATIC GLOBAL POSITIONING SYSTEM (TRIMBLE R-12). LINEAR AND ANGULAR CLOSURE OF THE
- TRAVERSES MEET THE STANDARDS OF WAC 332-130-090. 2) UTILITIES OTHER THAN THOSE SHOWN MAY EXIST ON THIS SITE. ONLY THOSE WHICH ARE VISIBLE OR HAVING VISIBLE EVIDENCE OF THEIR INSTALLATION ARE SHOWN HEREON. THENCE SOUTHWESTERLY TO A POINT THAT LIES 55 FEET NORTH OF A POINT

THENCE NORTHEASTERLY TO A POINT ON THE SOUTHWESTERLY LINE OF

THE OLD PACIFIC HIGHWAY WHICH IS 219 FEET NORTHWESTERLY OF THE

INTERSECTION OF THE SOUTHWESTERLY LINE OF SAID ROAD AND THE

THAT IS 120 FEET WEST OF THE INTERSECTION OF THE SOUTH LINE OF

SECTION 16 AND THE SOUTHWESTERLY LINE OF OLD PACIFIC HIGHWAY;

ALL SITUATE IN THE SOUTHWEST QUARTER OF SECTION 16, TOWNSHIP 20

RECORDED UNDER RECORDING NO. 202209270351, RECORDS OF PIERCE

THENCE SOUTHEASTERLY ALONG SAID ROAD 96 FEET;

SOUTH LINE OF SECTION 16;

THENCE SOUTH TO SAID POINT;

RECORDING NUMBER 9111010472.

RECORDED UNDER

NORTH, RANGE 4

COUNTY, WASHINGTON)

- 3) THIS SURVEY REPRESENTS PHYSICAL IMPROVEMENT CONDITIONS AS THEY EXISTED FEBRUARY 9, 2022, THE DATE OF THIS FIELD SURVEY.
- 4) FULL RELIANCE FOR LEGAL DESCRIPTIONS AND RECORDED EASEMENTS THENCE WEST 320 FEET, MORE OR LESS, TO THE TRUE POINT OF BEGINNING; HAVE BEEN PLACED ON THE TITLE REPORT FROM FIDELITY NATIONAL TITLE INSURANCE COMPANY COMMITMENT ORDER NO. EXCEPT THAT PORTION THEREOF CONVEYED TO PIERCE COUNTY BY DEED 611301826-SECOND DATED NOVEMBER 9, 2021 AT 8:00 AM. NO
 - ADDITIONAL RESEARCH HAS BEEN ATTEMPTED. 5) OFFSET DIMENSIONS SHOWN HEREON ARE MEASURED PERPENDICULAR
- 6) THE PURPOSE OF THIS SURVEY IS TO SUPPORT FUTURE DEVELOPMENT. 7) ELEVATION CONTOURS SHOWN HEREON ARE DERIVED FROM FIELD EAST, W.M., CITY OF PUYALLUP, COUNTY OF PIERCE, STATE OF WASHINGTON; MEASUREMENTS AND MEET OR EXCEED THE MINIMUM ACCURACY (ALSO KNOWN AS REVISED PARCEL A OF DELARATION OF LOT COMBINATION CRITERIA OF THE NATIONAL MAPPING STANDARD, BEING ONE-HALF THE CONTOUR INTERVAL.

SITE #1: CE 601 SET HUB AND MAG ON THE EAST SIDE OF VALLEY AVENUE EAST AS SHOWN HEREON. ELEVATION: 42.68' (NAVD88)

SITE #2: CE 604 SET HUB AND MAG EAST OF THE SOUTHEAST CORNER OF 1106 VALLEY AVENUE EAST AS SHOWN HEREON. ELEVATION: 35.72' (NAVD88)

PROJECT INFORMATION

PARCEL NUMBERS: 0420163077 AND 0420163042 ADDRESS: 1042 VALLEY AVE NW, PUYALLUP, WA 98371 JURISDICTION: CITY OF PUYALLUP ZONING: LIMITED MANUFACTURING (ML) TOTAL SITE AREA: 1.70 AC (PARCEL #0420163077) 0.14 AC (PARCEL #0420163042)

TOTAL: 79,953 SF (1.84 AC) TOTAL NEW HARD SURFACE: 63,746 SF (1.46 AC) TOTAL DISTURBED: 81,603 SF (1.87 AC)

4809 PACIFIC HIGHWAY E. FIFE, WA 98424 PHONE: (253) 896-1011

SITE **VICINITY MAP** NOT TO SCALE LEGEND

	LEGEND				
SURVEY		PROPOSED			
	CONTOURS				
	DDODEDTY LINE/DICHT OF WAY				
	PROPERTY LINE/RIGHT-OF-WAY RIGHT-OF-WAY DEDICATION				
	RIGHT-OF-WAY DEDICATION RIGHT-OF-WAY CENTERLINE				
	EASEMENT				
SD	BUILDING SETBACK STORM DRAIN LINE	CD.			
—— SS———	SANITARY SEWER LINE	—— SD——— —— SS———			
— 55—— — FM——	SANITARY SEWER LINE SANITARY SEWER FORCE MAIN LINE	— 55—— — FM——			
— OHP —	OVERHEAD POWER LINE	— OHP —			
—— P ———	UNDERGROUND POWER LINE	—— P ———			
— G —	GAS LINE	— G —			
— W——	WATER LINE	——w——			
VV (ST)	TYPE 2 CATCHBASIN	"			
	TYPE 1/TYPE 1L CATCHBASIN	_			
S	SANITARY SEWER MANHOLE	-			
Ø	SANITARY SEWER CLEANOUT (SSCO)	•			
\mathbf{v}	HYDRANT				
	WATER VALVE	x			
<	WATER METER	•			
+0+	FIRE DEPARTMENT CONNECTION (FDC)	_			
G	GAS MARKING POST				
Ī	GAS METER (GM)				
<u>-</u>	GAS VALVE (GV)				
•	MONUMENT	•			
•	POWER POLE (PP)				
	GUY WIRE (GW)				
0	WATER MARKING POST (WMP)				
×	LIGHT STANDARD/YARD LIGHT (LS/YL)				
®	POWER MANHOLE (PMH)				
PV	POWER VAULT				
TP	TRANSFORMER PAD				
×	TELEPHONE JUNCTION BOX				
<i>p</i>	CABLE JUNCTION BOX (CJB)				
	SIGNAL BOX (SB)				
♦	MONITORING WELL				
à	BOLLARD				
	ASPHALT				
	CONCRETE				
75,400,75	GRAVEL				

VERIFICATION NOTE

TOPOGRAPHY IS CONSISTENT WITH WHAT IS SHOWN ON PLANS AND IF THERE ARE ANY POTENTIAL CONFLICTS WITH PROPOSED CONSTRUCTION ACTIVITIES. CONTACT PROJECT ENGINEER IMMEDIATELY IF ANY

C4 TESC NOTES & DETAILS

C6 DEMOLITION PLAN

C8 ADA GRADING PLAN

C15 WATER PLAN

L1 PLANTING PLAN

HOURS BEFORE YOU DIG

CALL 811 AT LEAST 48

DRAİNAGE PLAN

C10 DRAINAGE PLAN & PROFILE

C11 DRAINAGE NOTES & DETAILS

C12 DRAINAGE NOTES & DETAILS

C13 DRAINAGE NOTES & DETAILS

C16 SEWER & WATER NOTES & DETAILS

C14 , SEWER PLAN & PROFILE

C17 SIGHT DISTANCE ANALYSIS

L2 LANDSCAPE DETAILS & NOTES

C7 GRADING PLAN

C5 TEMPORARY SEDIMENT POND

ALL EXISTING UTILITIES IN THE CONSTRUCTION AREA SHALL BE IDENTIFIED AND VERIFIED FOR DEPTH AND LOCATION PRIOR TO ANY CONSTRUCTION ACTIVITIES SO TO IDENTIFY ANY POTENTIAL CONFLICTS WITH PROPOSED CONSTRUCTION. CONTACT PROJECT ENGINEER IMMEDIATELY IF ANY CONFLICTS ARE IDENTIFIED.

PRIOR TO ANY CONSTRUCTION ACTIVITIES, VERIFY EXISTING


DESIGNER: K. MAUREN ENGINEER: B. ALLEN DRAWN: K. MAUREN S16 T20N R04E WM DATE: 2023-08-10 REVISED: -.-.-PROJECT: 21-247

DWG NAME: 21-247-C

2023-11-17

SHEET REV. 1 OF 17

CONFLICTS ARE IDENTIFIED.

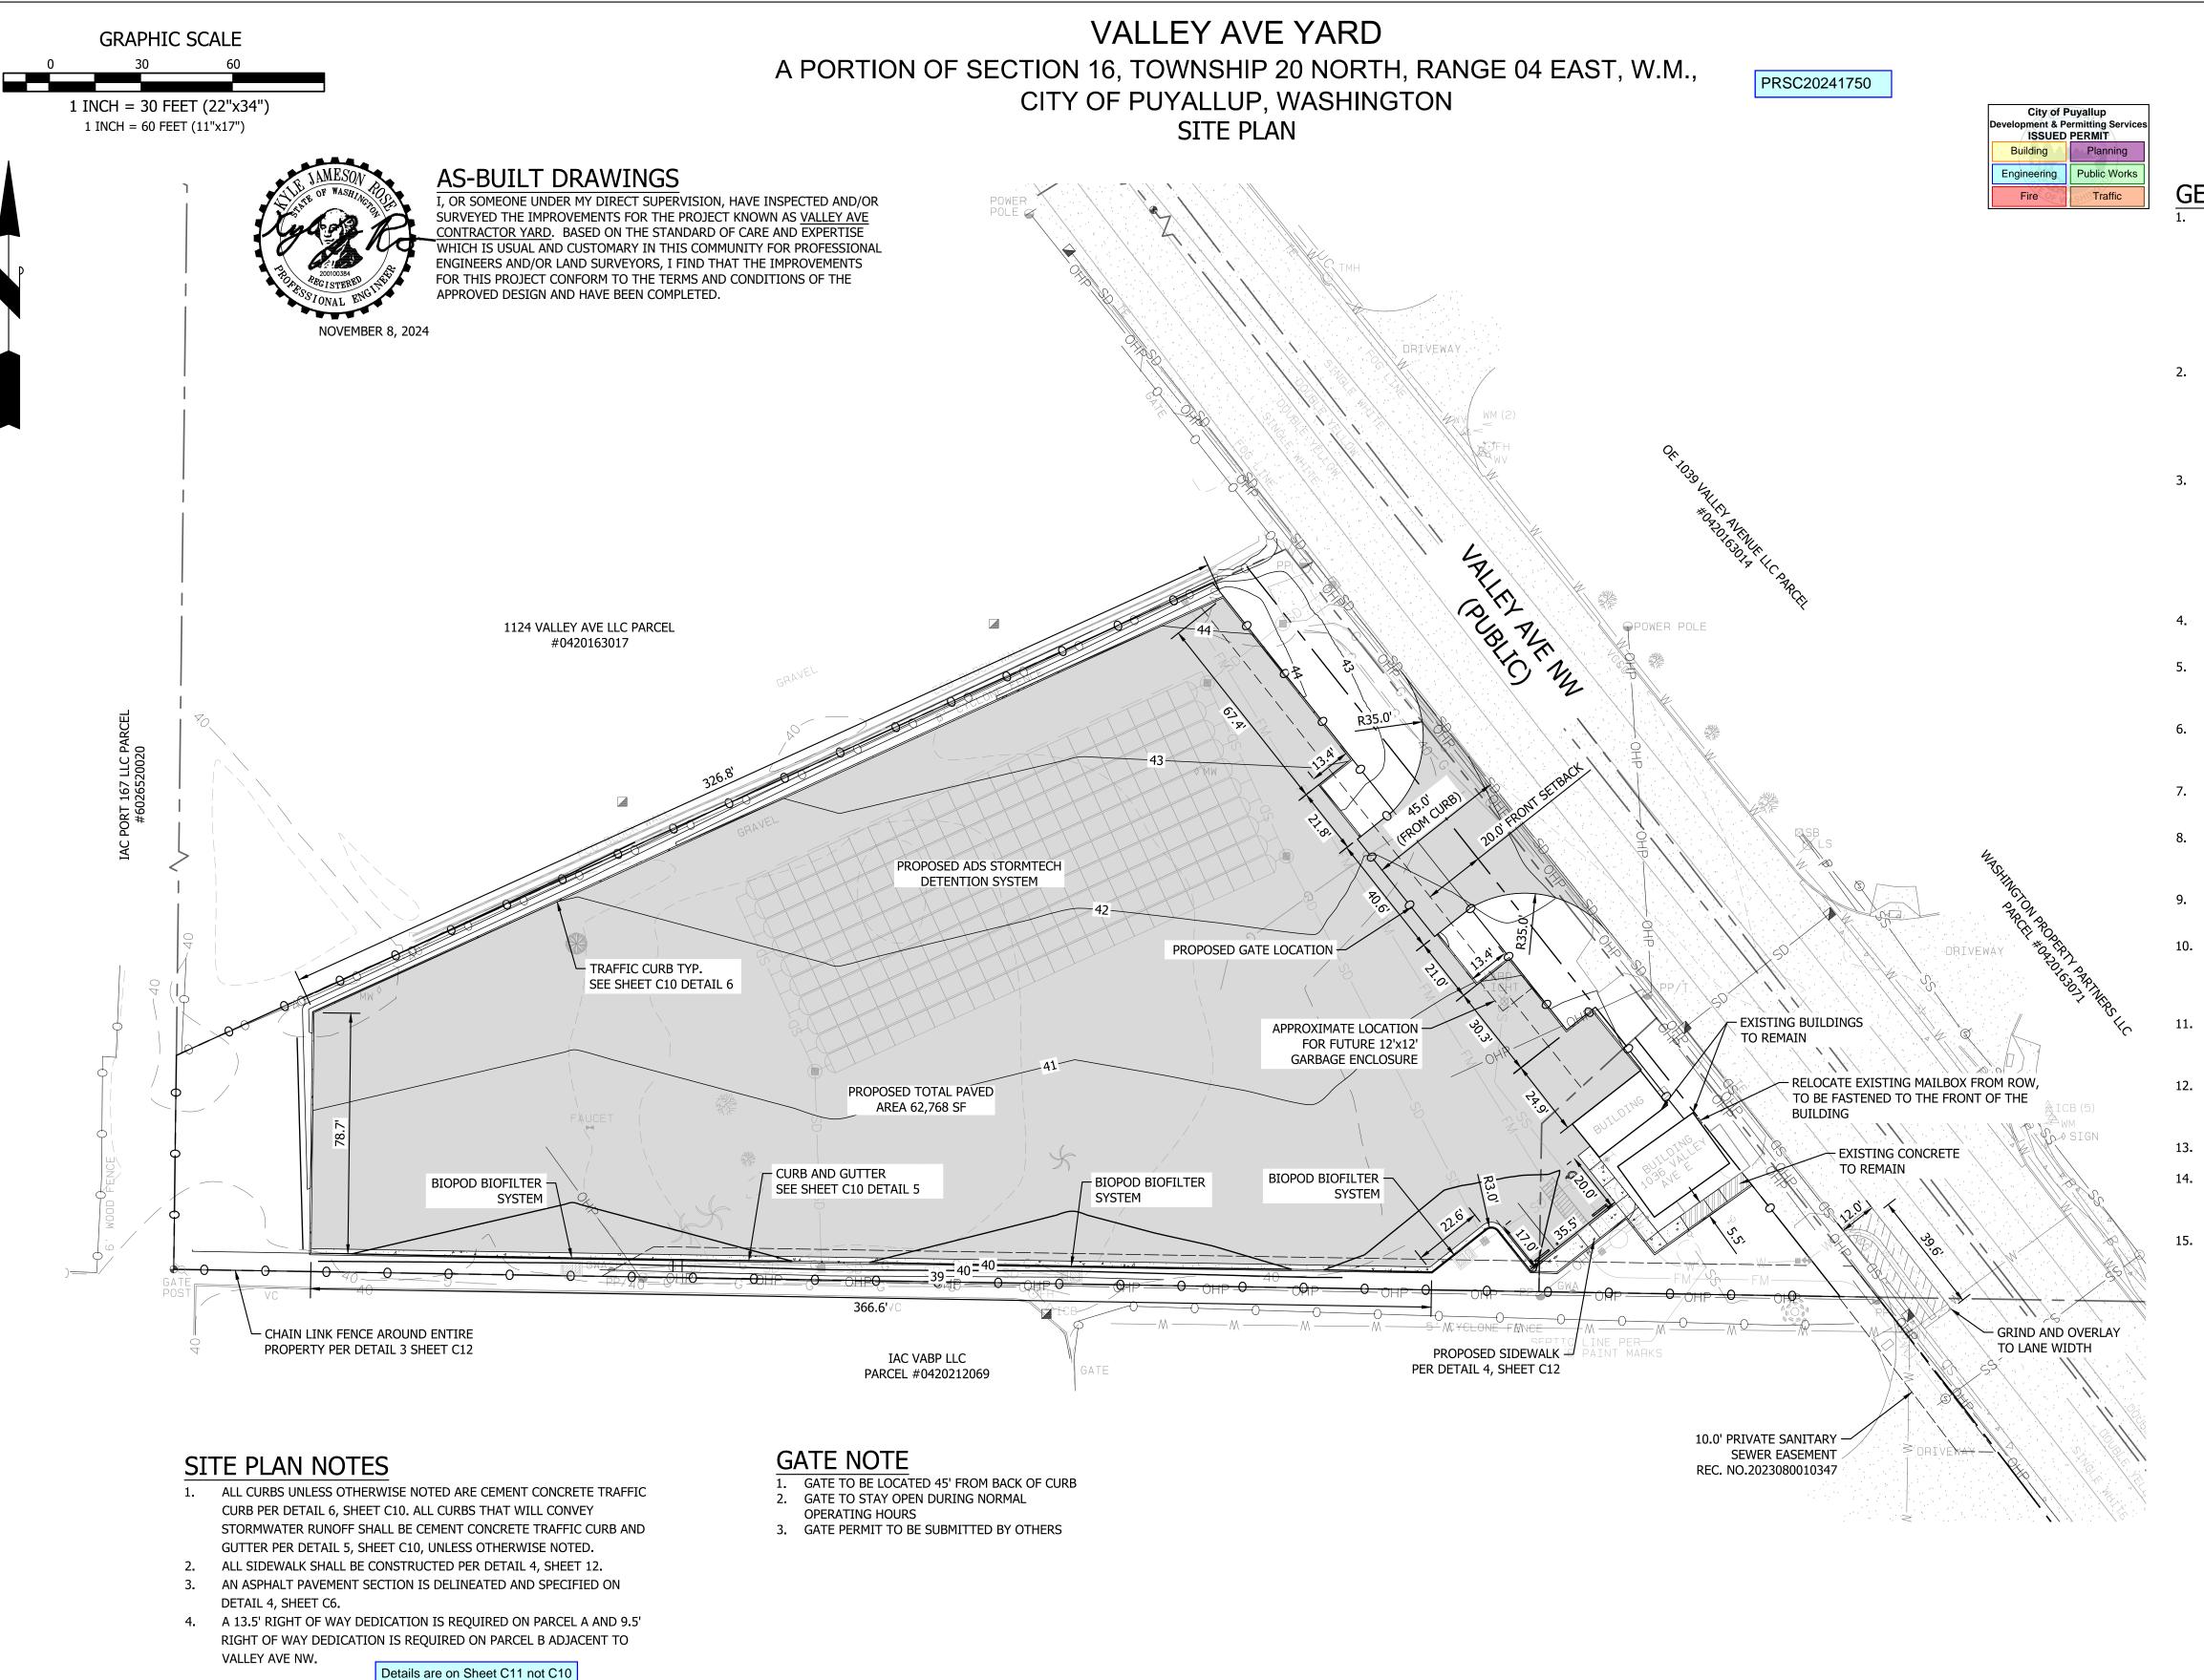

GENERAL NOTES

- 1. ALL WORK IN CITY RIGHT-OF-WAY REQUIRES A PERMIT FROM THE CITY OF PUYALLUP. PRIOR TO ANY WORK COMMENCING, THE GENERAL CONTRACTOR SHALL ARRANGE FOR A PRECONSTRUCTION MEETING AT THE DEVELOPMENT SERVICES CENTER TO BE ATTENDED BY ALL CONTRACTORS THAT WILL PERFORM WORK SHOWN ON THE APPROVED ENGINEERING PLANS, REPRESENTATIVES FROM ALL APPLICABLE UTILITY COMPANIES, THE PROJECT OWNER AND APPROPRIATE CITY STAFF. CONTACT ENGINEERING SERVICES AT (253-841-5568) TO SCHEDULE THE MEETING. THE CONTRACTOR IS RESPONSIBLE TO HAVE THEIR OWN SET OF APPROVED PLANS AT THE MEETING.
- 2. AFTER COMPLETION OF ALL ITEMS SHOWN ON THESE PLANS AND BEFORE ACCEPTANCE OF THE PROJECT THE CONTRACTOR SHALL OBTAIN A "PUNCH LIST" PREPARED BY THE CITY'S INSPECTOR DETAILING REMAINING ITEMS OF WORK TO BE COMPLETED. ALL ITEMS OF WORK SHOWN ON THESE PLANS SHALL BE COMPLETED TO THE SATISFACTION OF THE CITY PRIOR TO ACCEPTANCE OF THE WATER SYSTEM AND PROVISION OF SANITARY SEWER SERVICE.
- 3. ALL MATERIALS AND WORKMANSHIP SHALL CONFORM TO THE STANDARD SPECIFICATIONS FOR ROAD, BRIDGE, AND MUNICIPAL CONSTRUCTION (HEREINAFTER REFERRED TO AS THE "STANDARD SPECIFICATIONS"), WASHINGTON STATE DEPARTMENT OF TRANSPORTATION AND AMERICAN PUBLIC WORKS ASSOCIATION, WASHINGTON STATE CHAPTER, LATEST EDITION, UNLESS SUPERSEDED OR AMENDED BY THE CITY OF PUYALLUP CITY STANDARDS FOR PUBLIC WORKS ENGINEERING AND CONSTRUCTION (HEREINAFTER REFERRED TO AS THE "CITY STANDARDS").
- 4. A COPY OF THESE APPROVED PLANS AND APPLICABLE CITY DEVELOPER SPECIFICATIONS AND DETAILS SHALL BE ON SITE DURING CONSTRUCTION.
- 5. ANY REVISIONS MADE TO THESE PLANS MUST BE REVIEWED AND APPROVED BY THE DEVELOPER'S ENGINEER AND THE CITY PRIOR TO ANY IMPLEMENTATION IN THE FIELD. THE CITY SHALL NOT BE RESPONSIBLE FOR ANY ERRORS AND/OR OMISSIONS ON THESE PLANS.
- 6. THE CONTRACTOR SHALL HAVE ALL UTILITIES VERIFIED ON THE GROUND PRIOR TO ANY CONSTRUCTION. CALL AT LEAST TWO WORKING DAYS IN ADVANCE. THE OWNER AND HIS/HER ENGINEER SHALL BE CONTACTED IMMEDIATELY IF A CONFLICT EXISTS.
- 7. ANY STRUCTURE AND/OR OBSTRUCTION THAT REQUIRES REMOVAL OR RELOCATION RELATING TO THIS PROJECT SHALL BE DONE SO AT THE DEVELOPER'S EXPENSE.
- 8. LOCATIONS OF EXISTING UTILITIES ARE APPROXIMATE. IT SHALL BE THE CONTRACTOR'S RESPONSIBILITY TO DETERMINE THE TRUE ELEVATIONS AND LOCATIONS OF HIDDEN UTILITIES. ALL VISIBLE ITEMS SHALL BE THE ENGINEER'S RESPONSIBILITY.
- 9. THE CONTRACTOR SHALL INSTALL, REPLACE, OR RELOCATE ALL SIGNS, AS SHOWN ON THE PLANS OR AS AFFECTED BY CONSTRUCTION, PER CITY STANDARDS.
- 10. POWER, STREET LIGHT, CABLE, AND TELEPHONE LINES SHALL BE IN A TRENCH LOCATED WITHIN A 10-FOOT UTILITY EASEMENT ADJACENT TO PUBLIC RIGHT-OF-WAY. RIGHT-OF-WAY CROSSINGS SHALL HAVE A MINIMUM HORIZONTAL SEPARATION FROM OTHER UTILITIES (SEWER, WATER, AND STORM) OF 5 FEET.
- 11. ALL CONSTRUCTION SURVEYING FOR EXTENSIONS OF PUBLIC FACILITIES SHALL BE DONE UNDER THE DIRECTION OF A WASHINGTON STATE LICENSED LAND SURVEYOR OR A WASHINGTON STATE LICENSED PROFESSIONAL CIVIL ENGINEER.
- 12. DURING CONSTRUCTION, ALL PUBLIC STREETS ADJACENT TO THIS PROJECT SHALL BE KEPT CLEAN OF ALL MATERIAL DEPOSITS RESULTING FROM ON-SITE CONSTRUCTION, AND EXISTING STRUCTURES SHALL BE PROTECTED AS DIRECTED BY THE CITY.
- 13. CERTIFIED RECORD DRAWINGS ARE REQUIRED PRIOR TO PROJECT ACCEPTANCE.
- 14. A NPDES STORMWATER GENERAL PERMIT MAY BE REQUIRED BY THE DEPARTMENT OF ECOLOGY FOR THIS PROJECT. FOR INFORMATION CONTACT THE DEPARTMENT OF ECOLOGY, SOUTHWEST REGION OFFICE AT (360)407-6300.
- 15. ANY DISTURBANCE OR DAMAGE TO CRITICAL AREAS AND ASSOCIATED BUFFERS, OR SIGNIFICANT TREES DESIGNATED FOR PRESERVATION AND PROTECTION SHALL BE MITIGATED IN ACCORDANCE WITH A MITIGATION PLAN REVIEWED AND APPROVED BY THE CITY'S PLANNING DIVISION. PREPARATION AND IMPLEMENTATION OF THE MITIGATION PLAN SHALL BE AT THE DEVELOPER'S EXPENSE.

VERIFICATION NOTE


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PRIOR TO ANY CONSTRUCTION ACTIVITIES, VERIFY EXISTING TOPOGRAPHY IS CONSISTENT WITH WHAT IS SHOWN ON PLANS AND IF THERE ARE ANY POTENTIAL CONFLICTS WITH PROPOSED CONSTRUCTION ACTIVITIES. CONTACT PROJECT ENGINEER IMMEDIATELY IF ANY CONFLICTS ARE IDENTIFIED.

CALL 811 AT LEAST 48
HOURS BEFORE YOU DIG

	REVISION	DESCRIPTION	DATE	ВУ
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98332				

GINEERING - LL S ~ SURVEYORS ~ LAND PLANNE 5454 ~ Fax: 253-509-0044 ~ info@contourpllc.cor Idress: P.O. Box 949, Gig Harbor, WA 98335

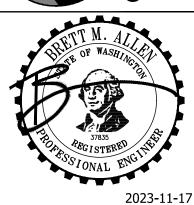

VALLEY AVE YARD

VE, LLC

N STREET

8108

SHEET TITLE: SITE PLAI


VALL

CLIENT: 1124 VALLEY AVE, LLC
550 S MICHIGAN STREET

DESIGNER: K. MAUREN
ENGINEER: B. ALLEN
DRAWN: K. MAUREN
S 16 T 20N R 04E WM
DATE: 2023-08-10
REVISED: -.--.----

DWG NAME: 21-247-C
SHEET RI

C2 2 OF 17

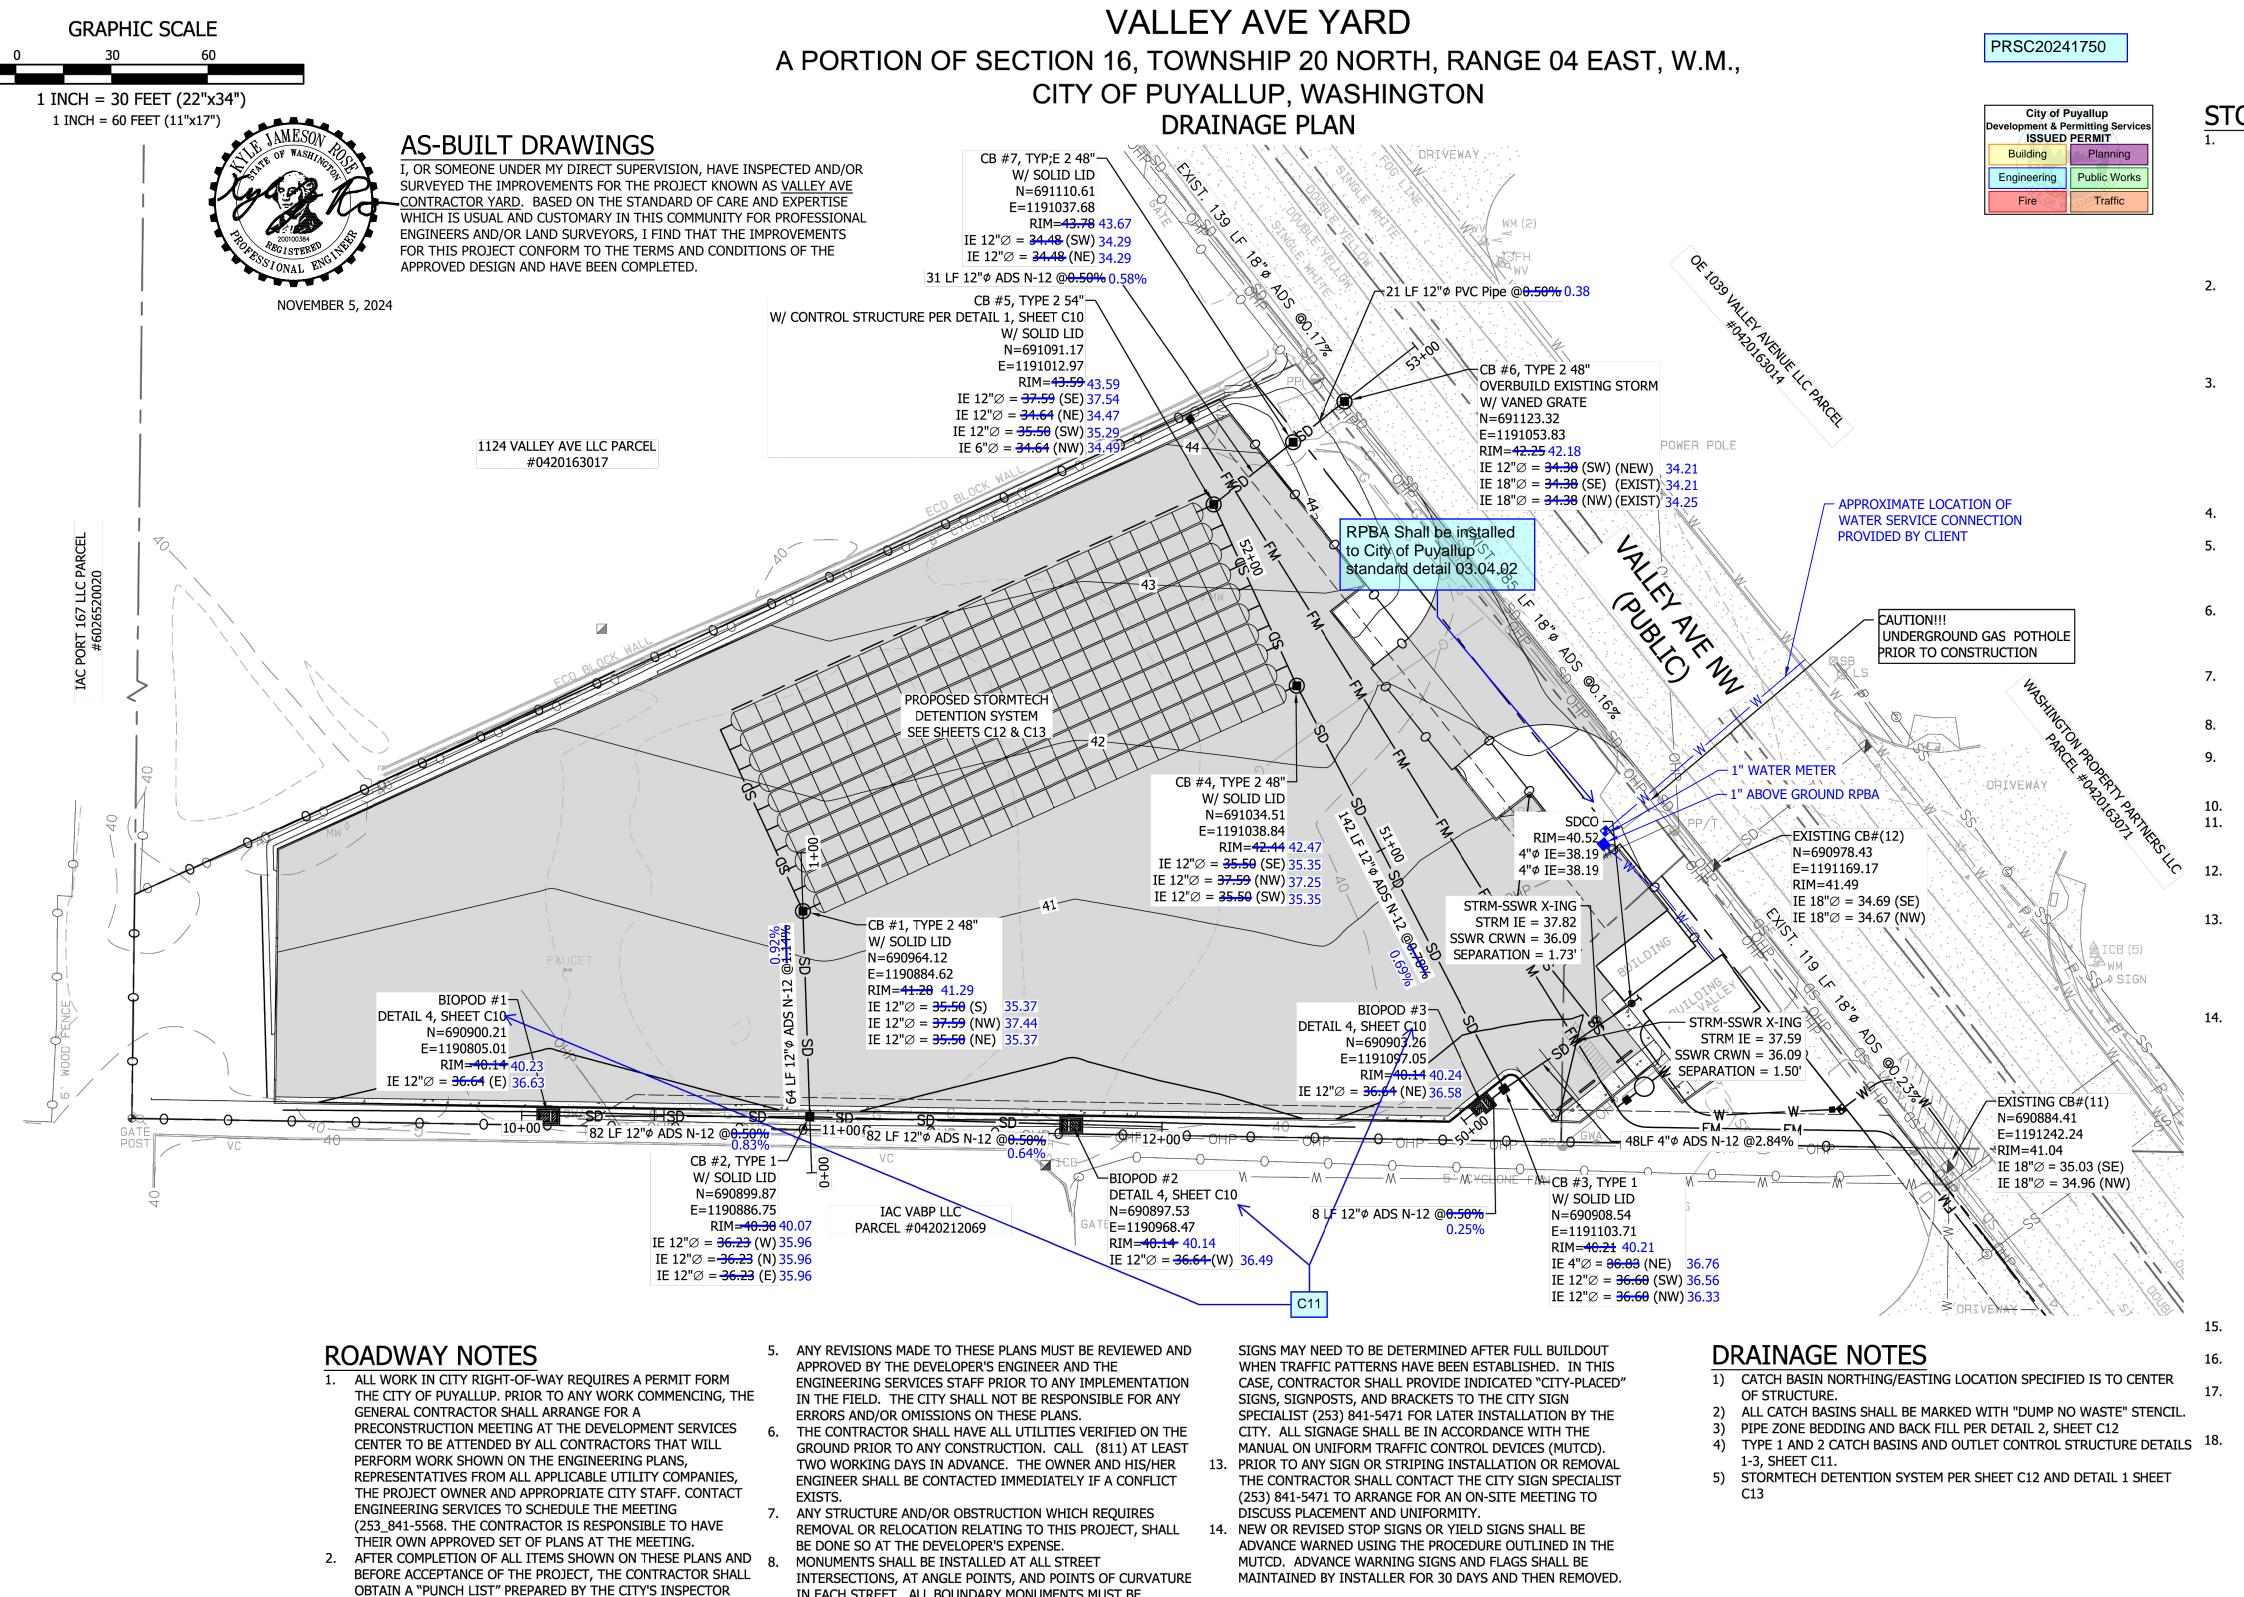

IN EACH STREET. ALL BOUNDARY MONUMENTS MUST BE

CURB AND GUTTER INSTALLATION SHALL CONFORM TO CITY

10. SIDEWALKS AND DRIVEWAYS SHALL BE INSTALLED AS LOTS ARE

BUILT ON. SIDEWALKS AND DRIVEWAYS SHALL CONFORM TO

CITY STANDARD DETAIL 01.02.01, 01.02.02 AND 01.02.12. IF

ASPHALT IS DAMAGED DURING REPLACEMENT OF CURB AND

GUTTER, THE REPAIR SHALL CONFORM TO CITY STANDARD

11. THE SURROUNDING GROUND (5 FEET BEYOND THE BASE) FOR

ALL POWER TRANSFORMERS, TELEPHONE/TV PEDESTALS, AND

CERTIFICATE OF OCCUPANCY OR PLAT APPROVAL. HOWEVER, IN

LARGER DEVELOPMENTS, EXACT LOCATIONS OF STOP AND YIELD

STREET LIGHT MAIN DISCONNECTS SHALL BE GRADED TO A

12. SIGNAGE AND TRAFFIC CONTROL DEVICES ARE SAFETY ITEMS

AND SHALL BE INSTALLED PRIOR TO ISSUANCE OF ANY

POSITIVE 2 PERCENT SLOPE FROM TOP OF CURB.

INSTALLED ACCORDING TO THE WASHINGTON STATE

SUBDIVISION LAWS.

DETAIL 01.02.10.

STANDARD DETAIL 01.02.09.

DETAILING REMAINING ITEMS OF WORK TO BE COMPLETED. ALL

ITEMS OF WORK SHOWN ON THESE PLANS SHALL BE COMPLETED

TO THE SATISFACTION OF THE CITY PRIOR TO ACCEPTANCE OF

STANDARD SPECIFICATIONS FOR ROAD, BRIDGE, AND MUNICIPAL

THE WATER SYSTEM AND PROVISION OF SANITARY SEWER

DEPARTMENT OF TRANSPORTATION AND AMERICAN PUBLIC

WORKS ASSOCIATION, WASHINGTON STATE CHAPTER, LATEST

EDITION, UNLESS SUPERSEDED OR AMENDED BY THE CITY OF

PUYALLUP CITY STANDARDS FOR PUBLIC WORKS ENGINEERING

DEVELOPER SPECIFICATIONS AND DETAILS SHALL BE ON SITE

A COPY OF THESE APPROVED PLANS AND APPLICABLE CITY

AND CONSTRUCTION (HEREINAFTER REFERRED TO AS THE "CITY

3. ALL MATERIALS AND WORKMANSHIP SHALL CONFORM TO THE

CONSTRUCTION (HEREINAFTER REFERRED TO AS THE

"STANDARD SPECIFICATIONS"), WASHINGTON STATE

SERVICE.

STANDARDS").

DURING CONSTRUCTION.

ACRONYMS

ME MATCH EXISTING EXISTING GRADE

DETENTION CHAMBERS SUMMARY

OUTLET CONTROL STRUCTURE

= 39.14

= 40.14

= 35.39

= 43.59

= 37.44

= 37.84

= 39.14

= 18 INCH

= 0.625 INCH

= 0.875 INCH

= 0.75 INCH

= 35,327 CF

BOTTOM OF SYSTEM ELEVATION

MAX DESIGN WATER SURFACE

RESTRICTOR PLATE DIAMETER

TOP OF SYSTEM ELEVATION

DESIGN STORAGE VOLUME

TOP OF GRAVEL

RIM ELEVATION

RISER DIAMETER

TOP OF RISER

ORIFICE #2 DIAMETER

ORIFICE #2 ELEVATION

ORFICIE #3 DIAMETER

ORIFICE #3 ELEVATION

- FINISH GRADE
- POINT OF CURVATURE
- POINT OF TANGENCY
- MID POINT
- FLOWLINE TOP OF CURB
- BOTTOM OF CURB
- TW TOP OF WALL
- BW BOTTOM OF WALL
- CL CENTERLINE

ROW RIGHT OF WAY

STORMWATER NOTES

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- ANY STRUCTURE AND/OR OBSTRUCTION WHICH REQUIRE REMOVAL OR RELOCATION RELATING TO THIS PROJECT, SHALL BE DONE SO AT THE **DEVELOPER'S EXPENSE**
- DURING CONSTRUCTION, ALL EXISTING AND NEWLY INSTALLED DRAINAGE STRUCTURES SHALL BE PROTECTED FROM SEDIMENTS.
- ALL STORM MANHOLES SHALL CONFORM TO CITY STANDARD DETAIL NO. 02.01.01. FLOW CONTROL MANHOLE/OIL WATER SEPARATOR SHALL CONFORM TO CITY STANDARD DETAIL NO. 02.01.06 AND 02.01.07.
- MANHOLE RING AND COVER SHALL CONFORM TO CITY STANDARD DETAIL 06.01.02. CATCH BASINS TYPE I SHALL CONFORM TO CITY STANDARD DETAIL NO.02.01.02 AND 02.01.03 AND SHALL BE USED ONLY FOR DEPTHS LESS THAN 5 FEET FROM TOP OF THE GRATE TO THE INVERT OF THE STORM PIPE.
- CATCH BASINS TYPE II SHALL CONFORM TO CITY STANDARD DETAIL NO.02.01.04 AND SHALL BE USED FOR DEPTHS GREATER THAN 5 FEET FROM TOP OF THE GRATI TO THE INVERT OF THE STORM PIPE.
- CAST IRON OR DUCTILE IRON FRAME AND GRATE SHALL CONFORM TO CITY STANDARD DETAIL NO.02.01.05. GRATE SHALL BE MARKED WITH "DRAINS TO STREAM". SOLID CATCH BASIN LIDS (SOUARE UNLESS NOTED AS ROUND) SHALL CONFORM TO WSDOT STANDARD PLAN B-30.20-04 (OLYMPIC FOUNDRY NO. SM60 OR EQUAL). VANED GRATES SHALL CONFORM TO WSDOT STANDARD PLAN B-30.30-03 (OLYMPIC FOUNDRY NO. SM60V OR EOUAL).
- STORMWATER PIPE SHALL BE ONLY PVC, CONCRETE, DUCTILE IRON, OR DUAL WALLED POLYPROPYLENE PIPE.
- THE USE OF ANY OTHER TYPE SHALL BE REVIEWED AND APPROVED BY THE ENGINEERING SERVICES STAFF PRIOR TO INSTALLATION.
- PVC PIPE SHALL BE PER ASTM D3034, SDR 35 FOR PIPE SIZE 15-INCH AND SMALLER AND F679 FOR PIPE SIZES 18 TO 27 INCH. MINIMUM COVER ON PV
- CONCRETE PIPE SHALL CONFORM TO THE WSDOT STANDARD SPECIFICATIONS FOR CONCRETE UNDERDRAIN PIPE. MINIMUM COVER ON CONCRETE PIPE SHALL NOT LESS THAN 3.0 FEET.
- DUCTILE IRON PIPE SHALL BE CLASS 50, CONFORMING TO AWWA C151.
- MINIMUM COVER ON DUCTILE IRON PIPE SHALL BE 1.0 FOOT. POLYPROPYLENE PIPE (PP) SHALL BE DUAL WALLED, HAVE A SMOOTH INTERIOR AND EXTERIOR CORRUGATIONS AND MEET WSDOT 9-05.24(1). 12-INCH THROUGH 30-INCH PIPE SHALL MEET OR EXCEED ASTM F2736 AND AASHTO M330, TYPE S, OR TYPE D. 36-INCH THROUGH 60-INCH PIPE SHALL MEET OR EXCEED ASTM F2881 AND AASHTO M330, TYPE S, OR TYPE D. TESTING SHALL BE PER ASTM F1417. MINIMUM COVER OVER POLYPROPYLENE
- PIPE SHALL BE 3-FEET. TRENCHING, BEDDING, AND BACKFILL FOR PIPE SHALL CONFORM TO CITY STANDARD DETAIL NO. 06.01.01. PER DETAIL 2 SHEET C12.
- STORM PIPE SHALL BE A MINIMUM OF 10 FEET AWAY FROM BUILDING
- FOUNDATIONS AND/OR ROOF LINES. ALL STORM DRAIN MAINS SHALL BE TESTED AND INSPECTED FOR ACCEPTANCE AS
- OUTLINED IN SECTION 406 OF THE CITY OF PUYALLUP SANITARY SEWER SYSTEM STANDARDS.
- ALL TEMPORARY SEDIMENTATION AND EROSION CONTROL MEASURES, AND PROTECTIVE MEASURES FOR CRITICAL AREAS AND SIGNIFICANT TREES SHALL BE INSTALLED PRIOR TO INITIATING ANY CONSTRUCTION ACTIVITIES.

VERIFICATION NOTE

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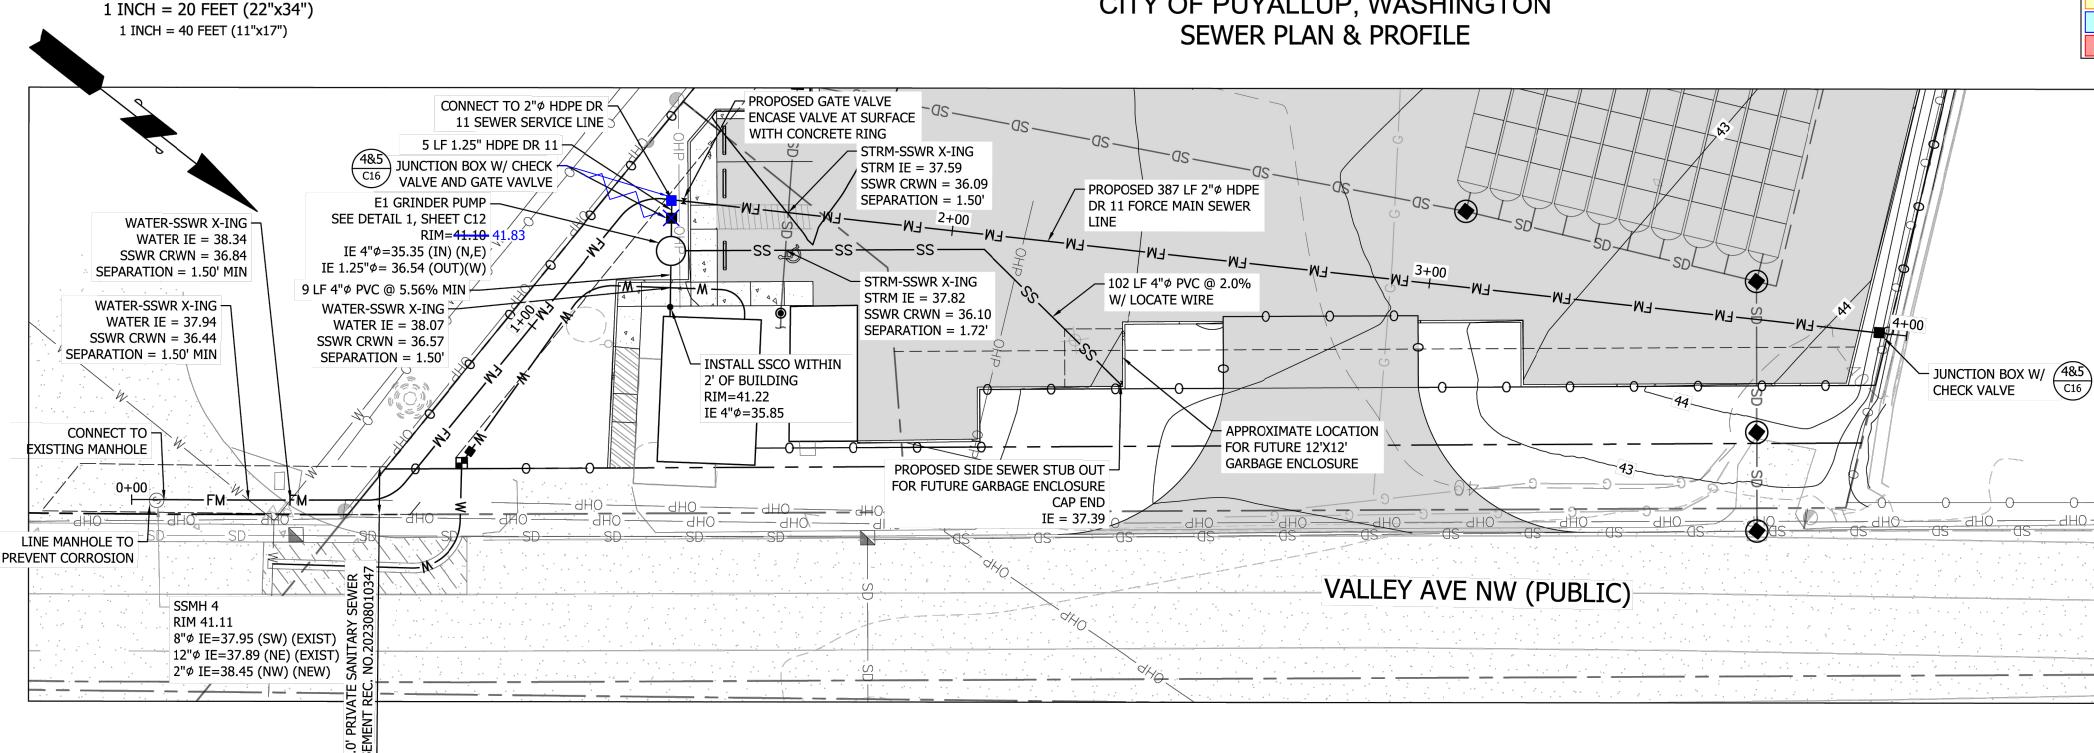
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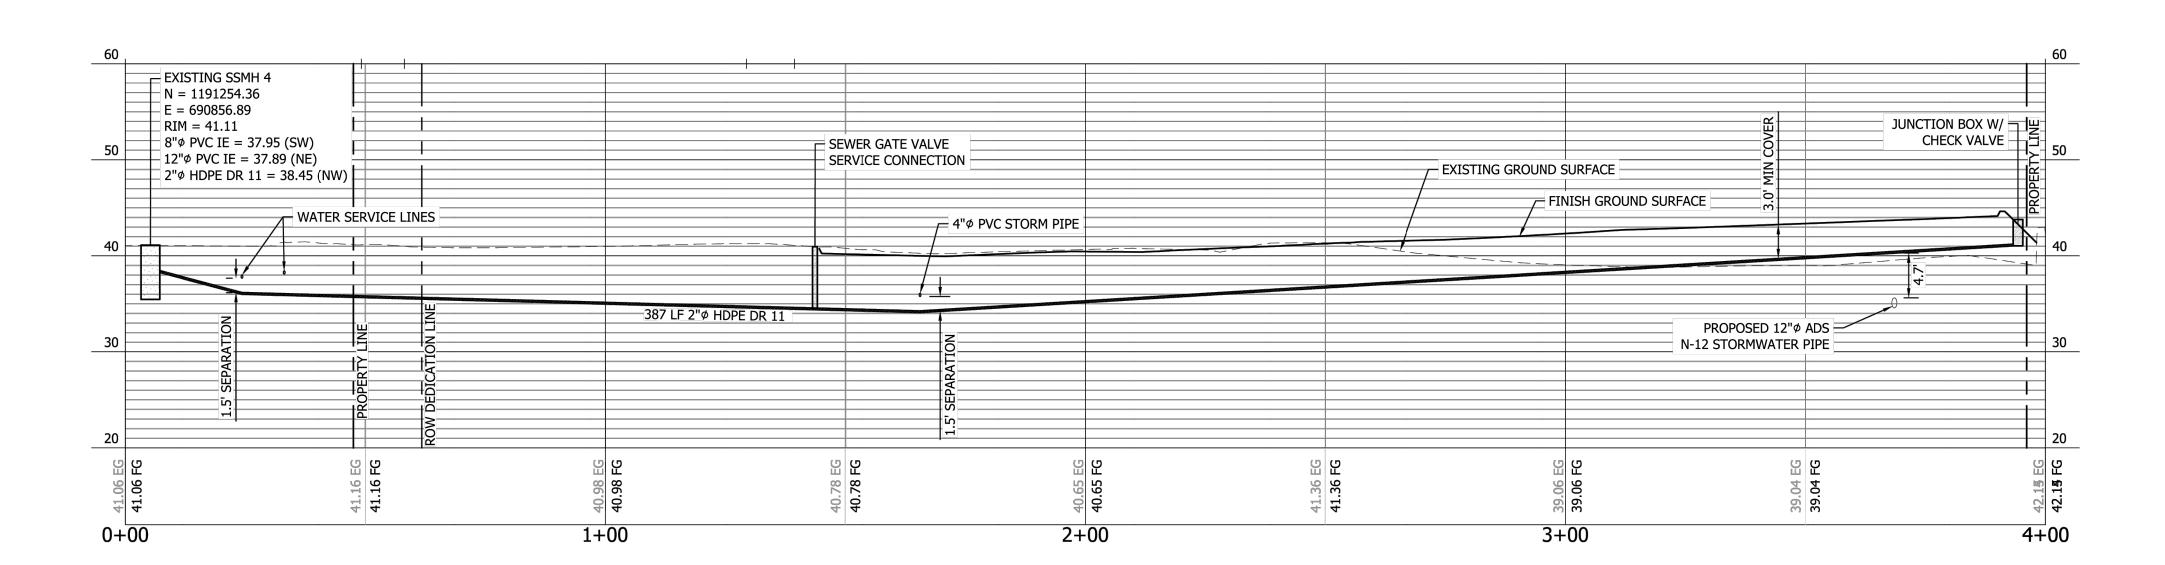
CALL 811 AT LEAST 48 **HOURS BEFORE YOU DIG**

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	DATE					
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5	DESCRIPTION					
. P =	REVISION			CTVII FNGTNEEDS ~ SLIBVEYORS	Phone:	Mailing Address: P.O. Box 949, Gig Harbor, WA 98335 Dhysical Address: 4706 97th Street NW, Suite 100, Gig Harbor, WA 98332
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	ENG DRA S 16 DAT REV	IGNER SINEER WN: T 201 E: (ISED:	VALLEY AVE YARD K B K B C C C C C C C C C C C C C C C C	Solution CLIENT: 1124 VALLEY AVE, LLC	MA SEATTLE, WA 98108 SEATTLE, WA 98108 SEATTLE, WA 98108	CONTACT: KERMIT JORGENSEN PHONE: (206) 787-1475
	DES ENG DRA S16 DAT REV	IGNER SINEER WN: T 20	K B K R 202: 21- 21- 21- 21- 21- 21- 21- 21- 21-	25 - 1 - 2 - 2 - 2 - 2 - 2 - 2 - 2 - 2 - 2	SEATTLE, WA 98108 SEATTLE, WA 98108 SEATTLE, WA 98108	PHONE: (206) 787-1475
	DES ENG DRA S16 DAT REV	IGNER SINEER WN: T 201 E: (ISED: DJECT: G NAMI SHE	K B K R 202: 21- 21- 21- 21- 21- 21- 21- 21- 21-	20 CLIENT: 1124 VALLEY AVE, LLC 550 S MICHIGAN STREET 550 S MICHIGAN STREET	SEATTLE, WA 98108 SEATTLE, WA 98108 SEATTLE, WA 98108	CONTACT: KERMIT JORGENSEN PHONE: (206) 787-1475

A PORTION OF SECTION 16, TOWNSHIP 20 NORTH, RANGE 04 EAST, W.M., CITY OF PUYALLUP, WASHINGTON







PROPOSED FORCE MAIN SEWER LINE PROFILE

HORIZONTAL SCALE: 1"=20' VERTICAL SCALE: 1"=10'

MINIMUM GRINDER PUMP REQUIREMENTS

E/ONE WH231-73 STATION

PACKAGE:

GRAPHIC SCALE

PUMP TYPE: E/ONE W200P10AAF SIZE OF PUMP: 1 HP, 1,725 RPM, HIGH TORQUE CAPACITOR

START, THERMALLY PROTECTED, 120/240 V /

60HZ, ONE PHASE

1-1/4" PIPE OUTLET:

PIPE SIZE: 1-1/4" (MIN) CONTROL PANEL/ALARM: E/ONE SENTRY

FINISH FLOOR (FT)	WET WELL BASE (FT)	PUMP OFF (FT)	PUMP ON (FT)	ALARM ELEV (FT)	INVERT IN ELEV (FT)	WET WELL TOP (FT)	INVERT OUT ELEV (FT)
43.00	33.64	34.62	34.96	35.62	35.74	42.12	36.77

AS-BUILT DRAWINGS

NOVEMBER 8, 2024

I, OR SOMEONE UNDER MY DIRECT SUPERVISION, HAVE INSPECTED AND/OR SURVEYED THE IMPROVEMENTS FOR THE PROJECT KNOWN AS VALLEY AVE CONTRACTOR YARD. BASED ON THE STANDARD OF CARE AND EXPERTISE WHICH IS USUAL AND CUSTOMARY IN THIS COMMUNITY FOR PROFESSIONAL ENGINEERS AND/OR LAND SURVEYORS, I FIND THAT THE IMPROVEMENTS FOR THIS PROJECT CONFORM TO THE TERMS AND CONDITIONS OF THE APPROVED DESIGN AND HAVE BEEN COMPLETED.

ACRONYMS

ME MATCH EXISTING

EXISTING GRADE

FINISH GRADE

POINT OF CURVATURE

POINT OF TANGENCY

MP MID POINT FLOWLINE

TC TOP OF CURB

BC BOTTOM OF CURB

TW TOP OF WALL BW BOTTOM OF WALL

ROW RIGHT OF WAY

CL CENTERLINE

CITY OF PUYALLUP SANITARY SEWER NOTES:

- ALL WORK IN CITY RIGHT-OF-WAY REQUIRES A PERMIT FORM THE CITY OF PUYALLUP. PRIOR TO ANY WORK COMMENCING, THE GENERAL CONTRACTOR SHALL ARRANGE FOR A PRECONSTRUCTION MEETING AT THE DEVELOPMENT SERVICES CENTER TO BE ATTENDED BY ALL CONTRACTORS THAT WILL PERFORM WORK SHOWN ON THE ENGINEERING PLANS, REPRESENTATIVES FROM ALL APPLICABLE UTILITY COMPANIES, THE PROJECT OWNER AND APPROPRIATE CITY STAFF. CONTACT ENGINEERING SERVICES TO SCHEDULE THE MEETING (253)841-5568. THE CONTRACTOR IS RESPONSIBLE TO HAVE THEIR OWN APPROVED SET OF PLANS AT
- AFTER COMPLETION OF ALL ITEMS SHOWN ON THESE PLANS AND BEFORE ACCEPTANCE OF THE PROJECT, THE CONTRACTOR SHALL OBTAIN A "PUNCH LIST" PREPARED BY THE CITY'S INSPECTOR DETAILING REMAINING ITEMS OF WORK TO BE COMPLETED. ALL ITEMS OF WORK SHOWN ON THESE PLANS SHALL BE COMPLETED TO THE SATISFACTION OF THE CITY PRIOR TO ACCEPTANCE OF THE SEWER SYSTEM AND PROVISION OF SANITARY SEWER SERVICE.
- ALL MATERIALS AND WORKMANSHIP SHALL CONFORM TO THE STANDARD SPECIFICATIONS FOR ROAD, BRIDGE, AND MUNICIPAL CONSTRUCTION (HEREINAFTER REFERRED TO AS THE "STANDARD SPECIFICATIONS"), WASHINGTON STATE DEPARTMENT OF TRANSPORTATION AND AMERICAN PUBLIC WORKS ASSOCIATION, WASHINGTON STATE CHAPTER, LATEST EDITION, UNLESS SUPERSEDED OR AMENDED BY THE CITY OF PUYALLUP CITY STANDARDS FOR PUBLIC WORKS ENGINEERING AND CONSTRUCTION (HEREINAFTER REFERRED TO AS THE "CITY STANDARDS").
- A COPY OF THESE APPROVED PLANS AND APPLICABLE CITY DEVELOPER SPECIFICATIONS AND DETAILS SHALL BE ON SITE DURING CONSTRUCTION.
- ANY REVISIONS MADE TO THESE PLANS MUST BE REVIEWED AND APPROVED BY THE DEVELOPER'S ENGINEER AND THE ENGINEERING SERVICES STAFF PRIOR TO ANY IMPLEMENTATION IN THE FIELD. THE CITY SHALL NOT BE RESPONSIBLE FOR ANY ERRORS AND/OR OMISSIONS ON THESE PLANS.
- THE CONTRACTOR SHALL HAVE ALL UTILITIES VERIFIED ON THE GROUND PRIOR TO ANY CONSTRUCTION. CALL (811) AT LEAST TWO WORKING DAYS IN ADVANCE. ANY STRUCTURES AND/OR OBSTRUCTION WHICH REQUIRE REMOVAL OR
- RELOCATION RELATING TO THIS PROJECT SHALL BE DONE SO AT THE DEVLEPOER'S EXPENSE. MINIMUM GRADE ON ALL 4 INCHES RESIDENTIAL SIDE SEWERS SHALL BE 2 PERCENT AND 6 INCH COMMERCIAL SIDE SEWERS SHALL BE 1 PERCENT; MAXIMUM
- RIGHT-OF-WAY. SIDE SEWERS SHALL BE INSTALLED IN ACCORDANCE WITH CITY STANDARD NOS. 04.03.01, 04.03.02, 04.03.03, AND 04.03.04. SIDE SEWER INSTALLATION WORK SHALL BE DONE IN ACCORDANCE WITH THE WASHINGTON INDUSTRIAL SAFETY AND HEALTH ACT (WISHA)

SHALL BE 8 PERCENT. ALL SIDE SEWERS SHALL BE 6 INCHES WITHIN CITY

- ALL SEWER PIPE SHALL BE PVC, POLYPROPYLENE, OR DUCTILE IRON. PVC SEWER PIPE SHALL CONFORM TO ASTM D-3034, SDR35 FOR PIPE SIZES 15-INCH AND SMALLER AND ASTM F679 FOR PIPE SIZES 18- TO 27-INCH, DUCTILE IRON PIPE SHALL BE CLASS 51 OR GREATER, LINED WITH PROTECTO 401TM EPOXY LINING OR EOUIVALENT, UNLESS OTHERWISE NOTED. 12-INCH THROUGH 30-INCH POLYPROPYLENE PIPE (PP) SHALL BE DUAL WALLED, HAVE A SMOOTH INTERIOR AND EXTERIOR CORRUGATIONS AND MEET WSDOT 9-05.24(2). IT SHALL MEET OR EXCEED ASTM F2764. 36-INCH THROUGH 60-INCH PP PIPE SHALL BE TRIPLED WALLED AND MEET WSDOT 9-05.24(2). IT SHALL MEET OR EXCEED ASTM F2764. PP SHALL HAVE A MINIMUM PIPE STIFFNESS OF 46 PII WHEN TESTED IN ACCORDANCE WITH ASTM D2412. TESTING SHALL BE PER ASTM F1417. TRENCHING, BEDDING, AND BACKFILL SHALL BE IN ACCORDANCE WITH CITY STANDARD NO. 06.01.01. MINIMUM COVER ON PVC AND PP PIPE SHALL BE 3.0 FEET. MINIMUM COVER ON DUCTILE IRON PIPE SHALL BE 1.0 FOOT.
- SANITARY SEWER MANHOLE FRAMES AND COVERS SHALL CONFORM TO CITY STANDARD NO. 06.01.02.
- 12. SANITARY SEWER MANHOLES SHALL CONFORM TO CITY STANDARD NOS. 04.01.01, 04.01.02, 04.01.03, AND 04.01.04. ALL MANHOLES SHALL BE CHANNELED FOR FUTURE LINES AS SPECIFIED ON THESE PLANS. MANHOLE STEPS AND LADDER
- SHALL CONFORM TO STANDARD NO. 06.01.03. 13. SANITARY SEWER PIPE AND SIDE SEWERS SHALL BE 10 FEET AWAY FORM BUILDING FOUNDATIONS AND/OR ROOF LINES WITH THE EXCEPTION OF SIDE SEWERS THAT PROVIDE SERVE TO A SINGLE-FAMILY RESIDENCE. AT THE DISCRETION OF THE REVIEW ENGINEER, A LICENSE PROFESSIONAL ENGINEER WILL BE REQUIRED TO STAMP THE DESIGN TO ACCOUNT FOR DEPTH OR PROXIMITY TO FOUNDATION, STEEP SLOPES, OR OTHER FACTORS.
- 14. NO SIDE SEWERS SHALL BE CONNECTED TO ANY HOUSE OR BUILDING UNTIL ALL MANHOLES ARE ADJUSTED TO THE FINISHED GRADE OF THE COMPLETED ASPHALT ROADWAY AND THE ASPHALT PATCH AND SEAL AROUND THE RING ARE ACCEPTED.
- 15. FOR COMMERCIAL DEVELOPMENTS IN WHICH SOURCES OF GREASE AND/OR OILS MAY BE INTRODUCED TO THE CITY SANITARY SEWER SYSTEM, A CITY APPROVED GREASE INTERCEPTOR SHALL BE INSTALLED DOWNSTREAM FORM THE SOURCE.
- ONCE SEWER AND ALL OTHER UTILITY CONSTRUCTION IS COMPLETED, ALL SANITARY SEWER MAINS AND SIDE SEWERS SHALL BE TESTED PER SECTION 406 OF THE CITY STANDARDS.

EXISTING UTILITY NOTE

EXISTING UTILITIES DEPICTED BASED UPON FIELD SURVEY. CONTRACTOR SHALL FIELD VERIFY ALL EXISTING UTILITIES.

VERIFICATION NOTE

ALL EXISTING UTILITIES IN THE CONSTRUCTION AREA SHALL BE IDENTIFIED AND VERIFIED FOR DEPTH AND LOCATION PRIOR TO ANY CONSTRUCTION ACTIVITIES SO TO IDENTIFY ANY POTENTIAL CONFLICTS WITH PROPOSED CONSTRUCTION. CONTACT PROJECT ENGINEER IMMEDIATELY IF ANY CONFLICTS ARE IDENTIFIED.

PRIOR TO ANY CONSTRUCTION ACTIVITIES, VERIFY EXISTING TOPOGRAPHY IS CONSISTENT WITH WHAT IS SHOWN ON PLANS AND IF THERE ARE ANY POTENTIAL CONFLICTS WITH PROPOSED CONSTRUCTION ACTIVITIES. CONTACT PROJECT ENGINEER IMMEDIATELY IF ANY CONFLICTS ARE IDENTIFIED

CALL 811 AT LEAST 48 **HOURS BEFORE YOU DIG**

DATE					
DESCRIPTION					
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2023-11-17

PROFILI

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DESIGNER: K. MAUREN ENGINEER: B. ALLEN DRAWN: K. MAUREN S16 T20N R04E WM DATE: 2023-08-10

REVISED: --.--PROJECT: 21-247

DWG NAME: 21-247-C SHEET REV.

C14 14 OF 17

