	1	2	3
	DRAWING S	YMBOLS	ABBREVIATIONS
Η		SECTION NUMBER DRAWING NUMBER SECTION CALLOUT SECTION CALLOUT ELEVATION NUMBER DRAWING NUMBER DRAWING NUMBER	A AMP AB ANCHOR BOLT AC ALTERNATING CURRENT ACC ACCESSIBLE ACP ACOUSTICAL CEILING PANEL ACT ACOUSTIC CEILING TILE AD AREA DRAIN ADA AMERICANS WITH DISABILITIES ACT ADD ADDENDUM ADDN ADDITION ADDL ADDITIONAL ADJ ADJUSTABLE AFF ABOVE FINISHED FLOOR AGGR AGGREGATE AHJ AUTHORITY HAVING JURISDICTION AHU AIR HANDLING UNIT AISC AMERICAN INSTITUTE OF STEEL CONSTRUCTION ALT ALTERNATE ALUM ALUMINUM ANCH ANCHOR ANOD ANODIZED AP ACCESS PANEL APPROX APPROXIMATE
G	XX NUMBER AXXX DRAWING NUMBER DETAIL CALLOUTS MATCH LINE	ELEVATION CALLOUT ELEVATION NUMBER AXXX DRAWING NUMBER INTERIOR ELEVATION CALLOUT	AR ACID RESISTANT ARCH ARCHITECT, ARCHITECTURAL ASST ASSISTANT ASTM AMERICAN SOCIETY FOR TESTING MATERIALS ASSY ASSEMBLY ATM ATMOSPHERIC ATS AUTOMATIC TRANSFER SWITCH AUTO AUTOMATIC AV AUDIO VISUAL AVE AVENUE AVG AVERAGE AWP ACOUSTICAL WALL PANEL
F	$\overrightarrow{AXXX} \overrightarrow{DRAWING NUMBERFOR CONTINUATION}$ $\overrightarrow{MATCH LINE}$ $\overrightarrow{1}$ \overrightarrow{C} \overrightarrow{A} $$	ROOM NAME XXXX ROOM NUMBER RECOUNT ACC	B BA BA BA BA BA BA BA BA BARRIER BARARIER CA
D	PLAN SYMB PLAN SYMB PLAN SYMB Image: Provide the symplectic sympl	OLS SUPPLY AIR DIFFUSER RETURN AIR GRILLE EXHAUST FAN PUBLIC ANNOUNCEMENT SPEAKER	CORR CORRIDOR CP CENTER POINT CPT CARPET CR CARD READER CRAC COMPUTER ROOM AIR CONDITIONING UNIT CRB CARD READER WITH BIOMETRIC SCAN CRAH COMPUTER ROOM AIR HANDLING UNIT CSK COUNTERSINK, COUNTERSUNK CT CERAMIC TILE CTR COUNTER CTWR COOLING TOWER CU CONDENSING UNIT CUB CUBIC CW COLD WATER CY CUBIC YARD D d PENNY (NAILS) D DEEP db DECIBLES DBL DOUBLE DC DIRECT CURRENT DEG DEGREE(S) DEMODEMOLISH, DEMOLITION DEPT DEPARTMENT DET DETAIL DF DRINKING FOUNTAIN
С	FXRECESSED TROFFER LIGHTING FIXTUREFXRECESSED CAN LIGHITNG FIXTUREFXRECESSED STRIP LIGHITNG FIXTUREFXSURFACE MOUNTED STRIP LIGHITNG FIXTUREFXVALL MOUNTED LIGHITNG FIXTURE	EPO EMERGENCY BOWER OFF SWITCH	DIA DIAMETER DIAG DIAGONAL DICA DRILLED IN CONCRETE ANCHOR DIFF DIFFUSER DIM DIMENSION(S) DIR DIRECTOR DISC DISCONNECT DISP DISPENSER DIV DIVISION DL DEAD LOAD DMPF DAMP PROOF, DAMP PROOFING DN DOWN DO DITTO DP DEEP DR DOOR/DRAIN DRC DOOR CONTACT DS DOWNSPOUT DW DISHWASHER DWG DRAWING DWL DOWEL DWR DRAWER DWTR DISTILLED WATER E E EAST EA EXHAUST AIR
В	SECURITY SECURITY CR CRB CRB COMBINATION CARD READER/BIOMETRIC SCANNER DC	RF RFID READER	EA EXHAUST AIR EB EXPANSION BOLT EF EXHAUST FAN EJ EXPANSION JOINT EL ELEVATION ELEC ELECTRICAL ELEV ELEVATION / ELEVATOR ELIM ELIMINATE EMER EMERGENCY EPWREMERGENCY POWER ENAM ENAMEL(ED) ENCL ENCLOSURE ENG ENGINEER ENT ENTRANCE EP EXPLOSION PROOF EPOXFL EPOXY FLOORING EPOXPT EPOXY FLOORING EPOXPT EPOXY PAINT EQ EQUAL EQUIPEQUIPMENT EPO EMERGENCY POWER OFF ES EMERGENCY SHOWER ESDF ELECTRO STATIC DISSAPATIVE FLOORING EST ESTIMATE(D) ETC ET CETERA ETR EXISTING TO REMAIN EVAC EVACUATE, EVACUATION EW EYE WASH
A	DBDURESS BUTTONICINTERCOMICCINTERCOM W/CAMERAPIRPASSIVE INFRARED DETECTORMDMOTION DETECTORPINPIN PAD		EXAM EXAMINATION EXC EXCAVATE, EXCAVATED, EXCAVATION EXH EXHAUST EXIST EXISTING EXP EXPOSED, EXPANSION EXT EXTERIOR EXTR EXTRUDED

5

6

VICINITY MAP

FARENHEIT FIRE ALARM

FAB FABRICATE, FABRICATOR / FABRIC FAC FACILITY FACP FIRE ALARM CONTROL PANEL FAS FIRE ALARM SYSTEM FB FLAT BAR FD FLAT DAN FC FURRING CHANNEL FCU FAN COIL UNIT FD FLOOR DRAIN FDC FIRE DEPARTMENT CONNECTION FDC FIRE DEPARTMENT CONNECTION FDN FOUNDATION FE-X FIRE EXTINGUISHER, "X" DENOTES TYPE FEC-X______FIRE EXTINGUISHER CABINET, "X" DENOTES TYPE FGL FIBERGLAS FH FIRE HYDRANT FHC FIRE HOSE CABINET

FIG FIGURE FIN FINISH, FINISHED FLASH FLASHING

FLEX FLEXIBLE FLR FLOOR, FLOORING FLUOR FLUORESCENT FO FINISHED OPENING

FOIB FURNISHED BY OTHERS, INSTALLED BY OTHERS FOIC FURNISHED BY OTHERS, INSTALLED BY CONTRACTOR FOW FACE OF WALL FP FIRE PROOFING, FIRE PROTECTION FPM FEET PER MINUTE FPS FEET PER SECOND

FR FIRE RATED, FIRE RATING FREQFREQUENCÝ FRTW FIRE RETARDANT TREATED WOOD FS FLOOR SINK FSD FIRE/SMOKE DAMPER FT FOOT, FEET FTG FOOTING F TO F FACE TO FACE FURRFURRING

FUT FUTURE FWC FABRIC WALL COVERING FXD FIXED

GE

ΗZ

JAN

KIT

GFRG

HIGH

GA GAUGE / GYPS GAL GALLON GALV GALVANIZED GAUGE / GYPSUM ASSOCIATION GALLON

GRAB BAR GENERAL CONTRACTOR GEN GENERAL / GENERATOR GFRCGLASS FIBER REINFORCED CONCRETE GLASS FIBER REINFORCED GYPSUM GALVANIZED IRON GLASS OR GLAZING

GLAMGLUE LAMINATED GLP GYPSUM LATH AND PLASTER GSL GYPSUM SHAFT LINER GWB GYPSUM WALLBOARD GYP GYPSUM

HB HOSE BIBB HC HOLLOW CORE HD HAND DRYER HDB HARD BOARD HDF HIGH DENSITY FIBERBOARD HDW HARDWARE HDWDHARDWOOD

HM HOLLOW METAL HO HOLD OPEN HORIZHORIZONTAL HR HOUR HT HEIGHT HERTZ (FREQUENCY) HEIGHT HVAC HEATING, VENTILATION AND AIR CONDITIONING

IBC INTERNATIONAL BUILDING CODE INTERCOM INSIDE DIAMETER INSIDE DIAMETER INTERNATIONAL ENERGY CODE INTERNATIONAL FIRE CODE INTERNATIONAL MECHANICAL CODE INCL INCLUDE, INCLUDING INFO INFORMATION

INSUL INSULATION IPC INTERNATIONAL PLUMBING CODE

JANITOR JANITOR'S SINK JOINT

KITCHEN KILO-VOLT KV KILO-VOLT KVA KILO-VOLT-AMPERE KW KILO-WATT

LONG LAM LAMINATE, LAMINATED LAWINATE, LAWINATED LAU LAUNDRY LAV LAVATORY LH LEFT HAND LHR LEFT HAND REVERSED LS LAG SCREW

LAG SCREW LIGHT LTG LIGHTING MAS MASONRY MATL MATERIAL MAX MAXIMUM MDF MEDIUM DENSITY FIBERBOARD MDF(T) MAIN DISTRIBUTION FRAME-TELECOM

MECH MECHANICAL MED MEDIUM MEMB MEMBRANE MEZZ MEZZANINE MFR MANUFACTURE, MANUFACTURER MGMT MANAGEMENT MH MANHOLE MIN MINIMUM, MINUTE MTD MOUNTED MTD MOUNTED MTL METAL MTS MANUAL TRANSFER SWITCH MP METAL PANEL MPOE MINIMUM POINT OF ENTRY (TELECOM)

MS METAL STUD MVA MEGA-VOLT-AMPERE MVBL MOVABLE MW MEGA-WATT NORTH

NEC NATIONAL ELECTRIC CODE NFPA NATIONAL FIRE PROTECTION ASSOCIATION NIC NOT IN CONTRACT NOM NUMBER NOM NOMINAL NS NO SCALE NTS NOT TO SCALE

ON CENTER OUTSIDE DIAMETER OVERHEAD O OVERFLOW DRAIN O OVERHEAD DOOR **OPNG OPENING** OPP OPPOSITE OFRD OVERFLOW ROOF DRAIN OTS OPEN TO STRUCTURE ABOVE


OH OFD OHD

PA PUBLIC ANNOUNCEMENT SYSTEM PB PUSH BUTTON PBD PARTICLE BOARD

PC PRECAST PDU PLANTER DRAIN PDU POWER DISTRIBUTION UNIT PERP PERPINDICULAR PIR PASSIVE INFRARED DETECTOR PL PROPERTY LINE PLAM PLASTIC LAMINATE PLAS PLASTER PLYWD PLYWOOD

PNL PANEL PR PAIR PRK PARK, PARKING PROP PROPERTY PROPERTY POC POINT OF CONNECTION PT PAINT, PAINTED, POINT, PRESSURE TREATED PTD PAPER TOWEL DISPENSER PTN PARTITION PVMT PAVEMENT

QT QUARRY TILE

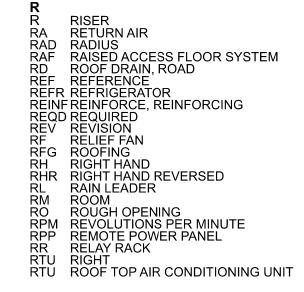

SOUTH SUPPLY AIR SOLID CORE SCHED SCHEDULE SD___SMOKE DETECTOR, STORM DRAIN SECT SECTION SECT SECTION SGL SINGLE SHT SHEET SHTGSHEATHING SIM SIMILAR SJ SIESMIC JOINT SMACNA SHEET METAL AND AIRCONDITIONING CONTRACTORS NATIONAL ASSOCIATION SMD SMOKE DAMPER SMR SHEET METAL ROOFING SMP SHEET METAL PANEL SPD SOAP DISPENSER SPEC SPECIFICATION SPKLR SPRINKLER SPKLR SPRINKLER SPKR SPEAKER SPR SINGLE PLY ROOFING SQ SQUARE SR SERVER RACK SS SERVICE SINK SSM SOLID SURFACING MATERIAL SSTL STAINLESS STEEL STC SOUND TRANSMISSION OF ASS SPKR SPEAKER SOUND TRANSMISSION CLASS

STORSTORAGE STRUCT STRUCTURE, STRUCTURAL SVF SHEET VINYL FLOORING SW SIDEWALK SWBD SWITCHBOARD SWG SWITCHGEAR TREAD


TBB TELEPHONE BACKBOARD TBD TILE BACKER BOARD TD TRENCH DRAIN TELEPHONE TEMPTEMPERATURE, TEMPORARY TERZ TERRAZZO T&G TONGUE AND GROOVE THK THICK, THICKNESS TO TOP OF TO TOP OF TPD TOILET PAPER DISPENSER TS TUBE STEEL TSTAT THERMOSTAT TELEVISION TYP TYPICAL

U URINAL UF UNDER FLOOR UL UNDERWRITERS LABORATORIES UNFIN UNFINISHED UNGRD UNDERGROUND UON UNLESS OTHERWISE NOTED UPS UNITERRUPTIBLE POWER SUPPLY

VOLT /B VAPOR BARRIER VC VIDEO CAMERA VCT VINYL COMPOSITION TILE VERT VERTICAL VEST VESTIBULE VIF VERIFY IN FIELD VNR VENEER VTF VINYL TILE FLOORING VM/C VINYL WALL COVERING VWC VINYL WALL COVERING

WATT WEST, WIDE WITH WATER CLOSET WD WOOD WF WIDE FLANGE WH WALL HYDRANT WM WATER METER WMP WIRE MESH PARTITION W/O WITHOUT WP WEATHER PROOF, WATER PROOF WWF WELDED WIRE FABRIC

XRAY XRAY PROCESS OR MACHINE XFMR TRANSFORMER YD YARD **ZN** ZINC

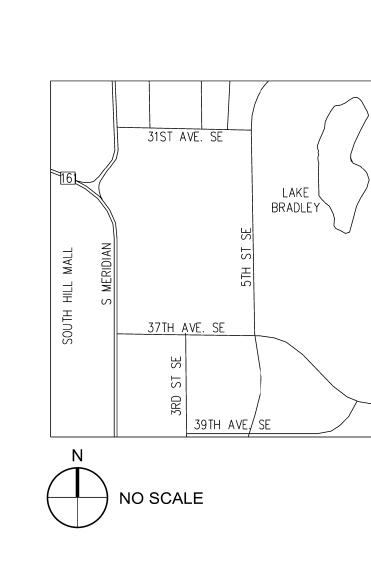

PROJECT INFOR

PROJECT ADDRESS 1023 39TH AVENUE SE PUYALLUP, WA 98374-2121

PARCEL NUMBER 0419034037

LEGAL DESCRIPTION SECTION 03 TOWNSHIP 19 RANGE 04 QUARTE ROS 2007-04-30-5001 (AFF OF MIN OR CORR SU 2007102600450) COM AT S $\frac{1}{4}$ COR OF SEC TH N SEC W 2621.06 FT FROM SE COR TH N OO DEG 676.33 FT TO POB TH CONT N 00 DEG 00 MIN 24 TO A PT S 00 DEG 00 MIN 24 SEC W 30.21 FT TH 17 SEC E 1258.61 FT TH S 00 DEG 13 MIN 45 SEC S 42 DEG 55 MIN 23 W 659.07 FT TH S 07 DEG 42 686.42 FT TH N 87 DEG 01 MIN 38 SEC W 169.45 MIN 42 SEC E 672.42 FT TH N 89 DEG 59 MIN 36 TO POB APPROVED SUBD BY CY OF PUYALLU 04/03/07 OUT OF 4-028 SEG 2008-0246 10/23/07

CODE INFORMA

APPLICABLE CODES

WASHINGTON BUILDING CODE, 2021 EDITION WASHINGTON FIRE CODE, 2021 EDITION WASHINGTON MECHANICAL CODE, 2021 EDIT WASHINGTON PLUMBING CODE, 2021 EDITION NATIONAL ELECTRIC CODE, 2023 EDITION WASHINGTON STATE ENERGY CODE, 2021 EDI

LAND USE CODES

PUYALLUP MUNICIPAL CODE EXISTING ZONING DESIGNATION: MP - BUSINE PROPOSED ZONING DESIGNATION: MP - BUSI CHANGE OF USE REQUIRED: NO

BUILDING CODE INFORMATION

BUILDING OCCUPANCY GROUP: TYPE U, UTIL TYPE OF CONSTRUCTION: TYPE IIIB, NON-SP ALLOWABLE BUILDING HEIGHT (TABLE 504.3): PROPOSED BUILDING HEIGHT: ALLOWABLE NUMBER OF STORIES (TABLE 504 PROPOSED NUMBER OF STORIES: 1 TABULAR ALLOWABLE AREA (TABLE 506.2): 8,5 PROPOSED AREA: 625 SF REQUIRED FIRE RESISTANCE OF EXTERIOR \ (TABLE 705.5): 1 HOUR, FIRE SEPARATION DIS GREATER OR EQUAL TO 5', LESS THAN 10' - AP TO SOUTH WALL OF BUILDING ONLY.


LAND USE CODE INFORMATION

EXISTING SITE AREA: 15.77ACRES

GENERAL NOTE

- DO NOT SCALE THE DRAWINGS.
- THE DRAWINGS AND SPECIFICATIONS AF **REQUIRED BY BOTH.**
- THE CONTRACTOR SHALL VERIFY ALL FI 3. PRIOR TO COMMENCING ANY WORK. NOTIFY THE ARCHITECT IMMEDIATELY IF IMPACT THE IMPLEMENTATION OF THE I ALL EXISTING ELEMENTS SHOWN ON TH ARE INCLUDED WITHOUT ANY GUARAN
- ALL DIMENSIONS ARE SHOWN TO THE S 4
- OR FINISHED SURFACES, UNLESS NOTE DETAILS ARE SHOWN ON THE DRAWINGS OCCURANCE OF THE CONDITION AND AF OTHER SIMILAR CONDITIONS.
- PROVIDE A MINIMUM OF 6" FROM AN ADJ SURFACE TO THE EDGE OF ANY FINISHE 6

8	9	10		11				12
		PROJECT DI	RE	CTORY	S	HE	ΕT	INE
PROJECT SITE PL PL PL PL PL PL PL 39TH AVE. SE		OWNER BENAROYA CAPITAL, LLC 9675 SE 36TH STREET, SUITE 115 MERCER ISLAND, WA 98040 MAIN PHONE: 253-200-4120 CONTACT: DAVID VRANIZAN 206-774-1011 DAVEV@BENAROYA.COM ARCHITECT CASCADE MISSION CRITICAL, LLC 6210 36TH AVENUE N.E. SEATTLE, WA 98115 MAIN PHONE: 206-294-1288 CONTACT: LEONARD A. RUFF, AIA PHONE: 206-294-1288 EMAIL: LEONARD.RUFF@CASCADE MISSIONCRITICAL.COM STRUCTURAL ENGINEER (RACK SUPPORT & BRACING, MISC. SUPPORTS) QUANTUM CONSULTING ENGINEERS 1511 THIRD AVENUE, SUITE 323 SEATTLE, WA 98101 MAIN PHONE: 206-957-3900 CONTACT: SCOTT TINKER, PE 206-957-3917 SCOTTTINKER@QUANTUMCE.COM	(WALL BRIEN 1316 C SUITE KENT, MAIN F CONTA PHONE STANT 720 3R SEATT MAIN F CONTA PHONE EMAIL	WA 98032 PHONE: 206-397-0000 ACT: BRANDON BAUDETTE, F E: 206-397-000 X104 : BBAUDETTER@BSE-PS.CO ANICAL ENGINEER	S A-000 A-102 A-102 PE A-102 M A-102 A-102 A-102 A-102 A-102 A-102 A-302 A-302 A-302 A-507 STRU (RAC A1.0 S1.1 S4.6 STRU MS1.	1-23 C 2-23 C 3-23 E 4-23 E 5-23 E 5-23 E 5-23 C 5-23 C 1-23 C 1-23 C 1-23 C 5-23 C 1-23 C 5-23 C 1-23 C 5-23 C 1-23 C 5-23 C 5-25 C 5-25 C 5-25 C 5-25 C 5-25 C 5-25 C 5-25 C 5-	GENERAL IN DVERALL S DVERALL LI PLAN ENLARGED JNDERFLOG ENLARGED CABLE TRA ENLARGED CABLE TRA ENLARGED CONGITUDIO CROSS SEC DETAILS CHEDULES CHEDULES CHEDULES CHEDULES CHERAL S CONTAILS CONTAILS	EVEL 02 FLO LEVEL 02 OR PLAN - A LEVEL 02 N - AREA B LEVEL 02 Y PLAN - AF LEVEL 02 D CEILING P NAL SECTIO TION S ING-MISC. S TRUCTURA TRUCTURA TRUCTURA
ORMATION		SCOPE OF W	/OF	RK	MS2. MS3.	8 1 II	& DETAILS	PARTITION S
ARTER 43 PARCEL "1" OF RR SURVEY TH N 86 DEG 31 MIN 42 DEG OO MIN 24 SEC E MIN 24 SEC E 1923.18 FT FT TH S 87 DEG 44 MIN 35 SEC W 1391.90 FT TH 36 G 42 MIN 49 SEC E 69.45 FT TH N 00 DEG 52 IN 36 SEC W 736.66 FT ALLUP PLANNING DEPT 23/07CL DC11/19/07CL		DATA CENTER BUILDING (PARCEL 041903403 INTERIOR TENANT IMPROVEMENTS WORK UNDER THIS PERMIT CONSTRUCT NEW INTERIOR DATA HA NEW STRUCTURAL RACK SUPPORT A INSTALL NEW AIR HANDLING UNIT ANI WATER DISTRIBUTION PIPING. WORK UNDER SEPARATE PERMITS ELECTRICAL AND TELECOMMUNICATI FIRE SPRINKLER MODIFICATIONS	LL OF 6 ND BRA D NEW (CING SYSTEMS. CHILLED	MEC M.FT M.FT M.FT M.FT M.FT M.FT M.FT M.FT	.010 N .012 N .103 N .104 N .202 N .203 N .204 N .301 N .501 N	AECHANICA AECHANICA AECHANICA AECHANICA AECHANICA AECHANICA AECHANICA AECHANICA FOR REFEI AECHANICA AECHANICA AECHANICA AECHANICA AECHANICA City of Bui REVII COMP SKir 01/21	AL GENERA AL SCHEDU AL CALCULA AL LEVEL 2 AL LEVEL 3 AL LEVEL 3 AL LEVEL 3 AL LEVEL 3 AL SOUTH Y RENCE ONL AL DETAILS AL DIAGRAM AL DIAGRAM AL DIAGRAM AL DIAGRAM AL DIAGRAM AL DIAGRAM AL DIAGRAM
/IATION							STRIKOFY	VASHINGON
TION EDITION TION I 1 EDITION					appro office regul contr that t code	oval of or or non o ations of actor is r he buildi	missions complian f local go responsik ing comp	plans is r or oversi oce with a vernment ole for ma lies with a of the loo
JSINESS PARK BUSINESS PARK					docu poste	ments, a ed on the	ind all en i job at al	ction plar gineering Il inspecti essible lo
UTILITY N-SPRINKLERED 4.3): 55' E 504.4): 2					Full s to be	sized leç	gible col	or plans permitee
): 8,500 SF OR WALLS N DISTANCE V - APPLIES					the V & Inc https elect or ca	Vashingto lustries. ://lni.wa.o rical-perr	on State gov/licen mits-fees ensing In	ermit is re Departmo sing-pern -and-insp formation
ΓES								
NS ARE COMPLEMENTARY. CONSTRUED TO BE								
								City Development ISSL Building Engineerir Fire

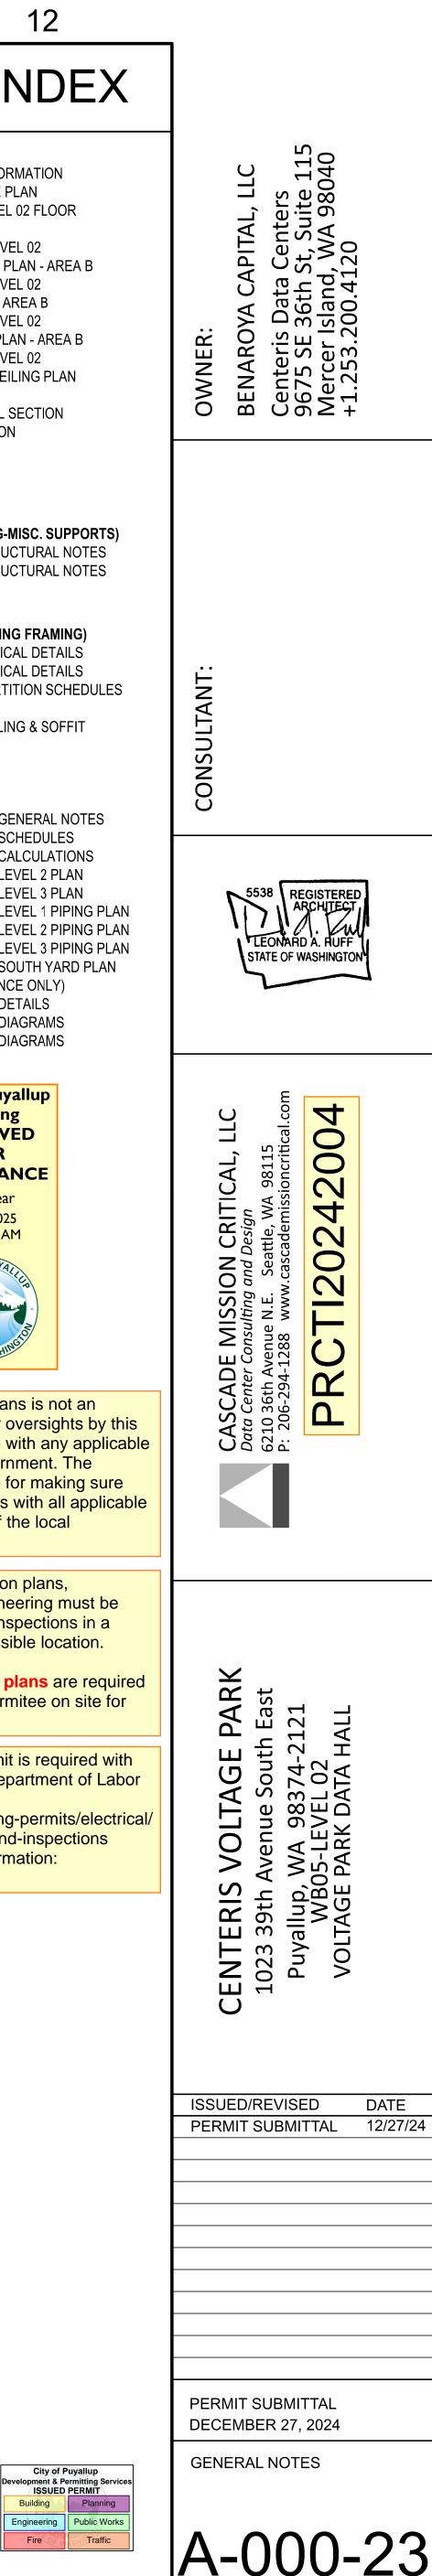

SITE INFORMATION

PARCEL NO. 0419034037 ADDRESS: 1023 39TH AVENUE S.E.

PARCEL AREA: 15.77 ACRES

LEGAL DESCRIPTION Section 03 Township 19 Range 04 Quarter 42 LOT 2 OF BLR 2022-03-22-5003 A POR OF BLR 2019-05-22-5002 LY IN CY OF PUYALLUP MORE PARTICULARLY DESC AS FOLL COM AT STONE MON MARKING S 1/4 COR OF SEC 3 SD STONE MON LIES N 86 DEG 31 MIN 42 SEC E 2621.06 FT FROM SE COR OF SD SEC 3 TH N 00 DEG 00 MIN 24 SEC E 2599.51 FT TH S 87 DEG 44 MIN 17 SEC E 496.53 FT TO POB TH S 00 DEG 04 MIN W 132.96 FT TH S 16 DEG 29 MIN 57 SEC E 15.96 FT TH S 00 DEG 00 MIN 36 SEC E 335.82 FT TH S 52 DEG 49 MIN 01 SEC E 132.81 FT TH S 89 DEG 15 MIN 41 SEC E 28.82 FT TH S 82 DEG 14 MIN 13 SEC E 58.63 FT TH S 53 DEG 48 MIN 38 SEC E 78.9 FT TH S 89 DEG 41 MIN 48 SEC E 655.79 FT TH S 83 DEG 08 MIN 36 SEC E 199.54 FT TH N 00 DEG 13 MIN 45 SEC E 602.4 FT TH N 87 DEG 44 MIN 17 SEC W 1118.01 FT TO POB EASE OF REC OUT OF 04-19-03-4-031 & 4-034 SEG 2019-0472 05/30/19 JP 20190652DC 03/31/22 JP



Η

В


Α

OVERALL SCOPE OF WORK


DATA CENTER BUILDING (PARCEL 0419034037) INTERIOR TENANT IMPROVEMENTS

WORK UNDER THIS PERMIT CONSTRUCT NEW INTERIOR DATA HALL OF 6,594 SF INCLUDING NEW STRUCTURAL RACK SUPPORT AND BRACING SYSTEMS. INSTALL NEW AIR HANDLING UNIT AND NEW CHILLED WATER DISTRIBUTION PIPING.


WORK UNDER SEPARATE PERMITS ELECTRICAL AND TELECOMMUNICATIONS WORK FIRE SPRINKLER MODIFICATIONS

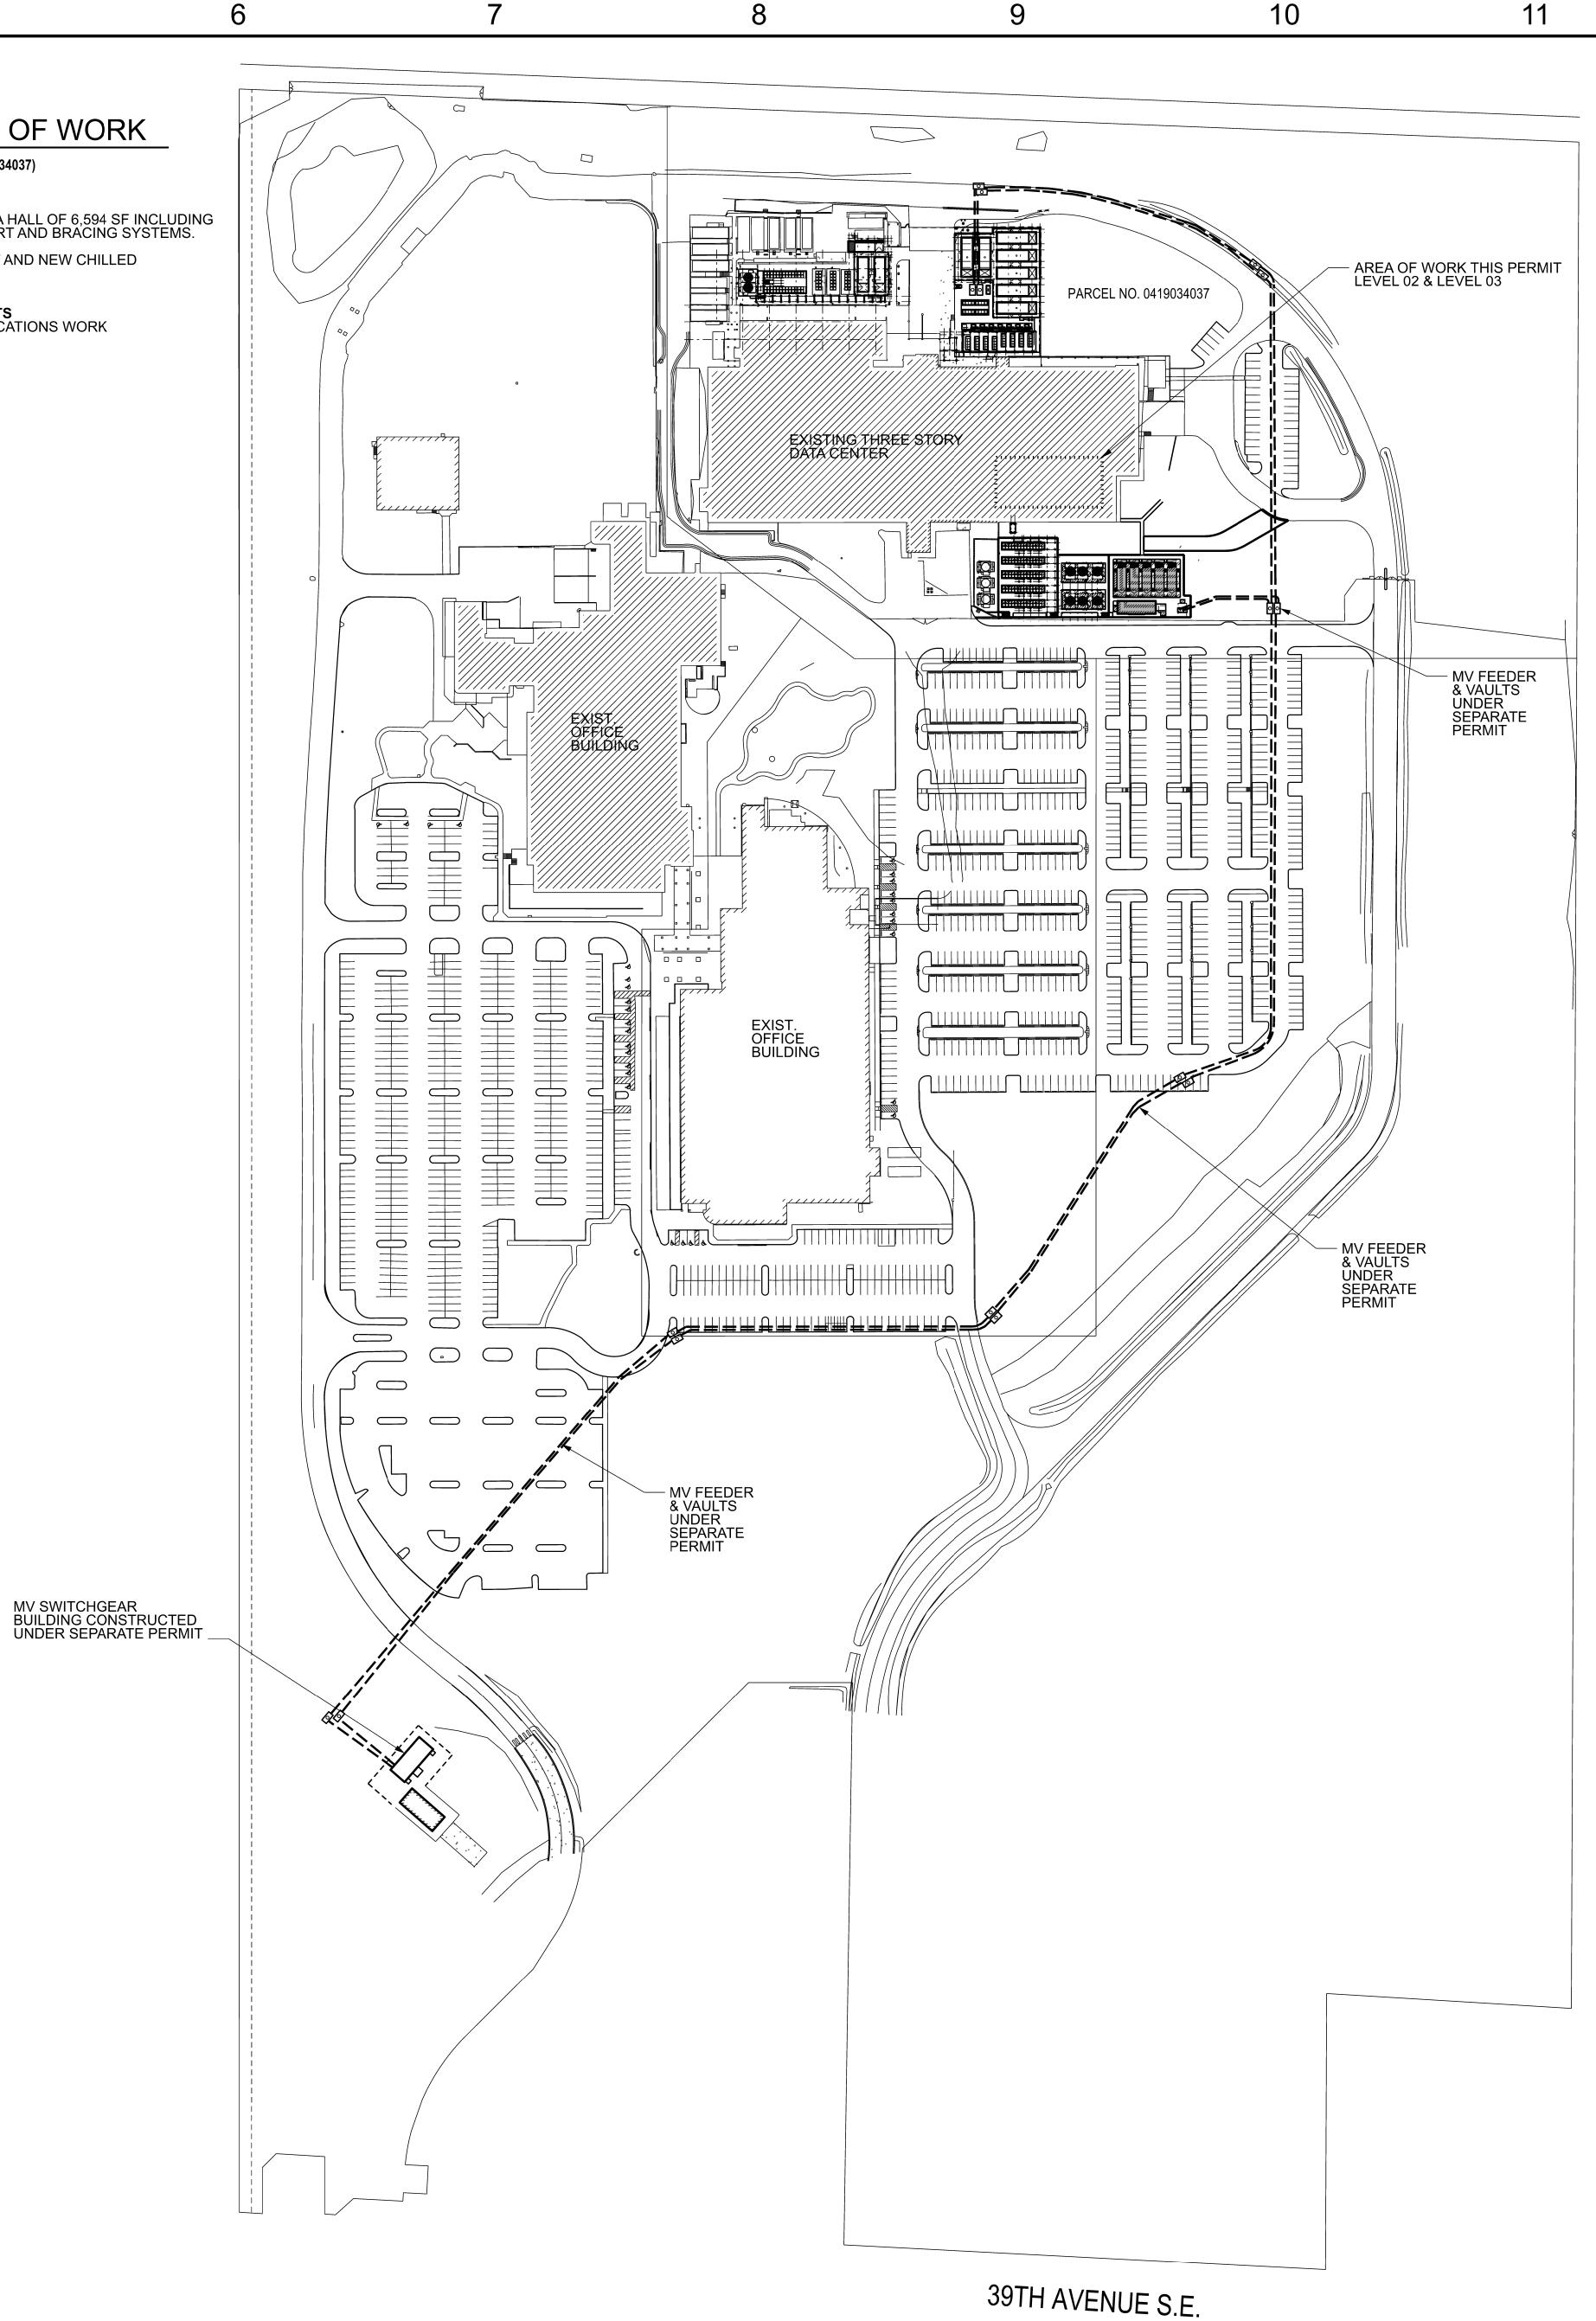



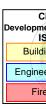



12

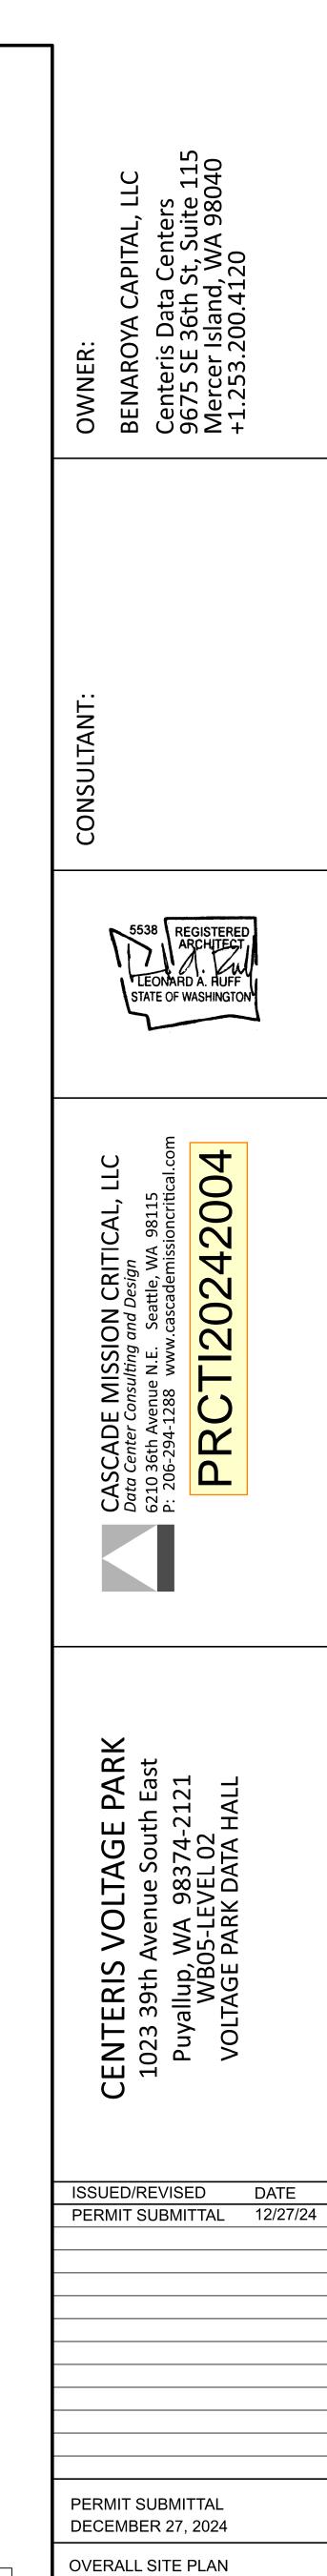

City of Puyallup Development & Permitting Services ISSUED PERMIT Building Planning Engineering Public Works Fire Traffic

A-101-23

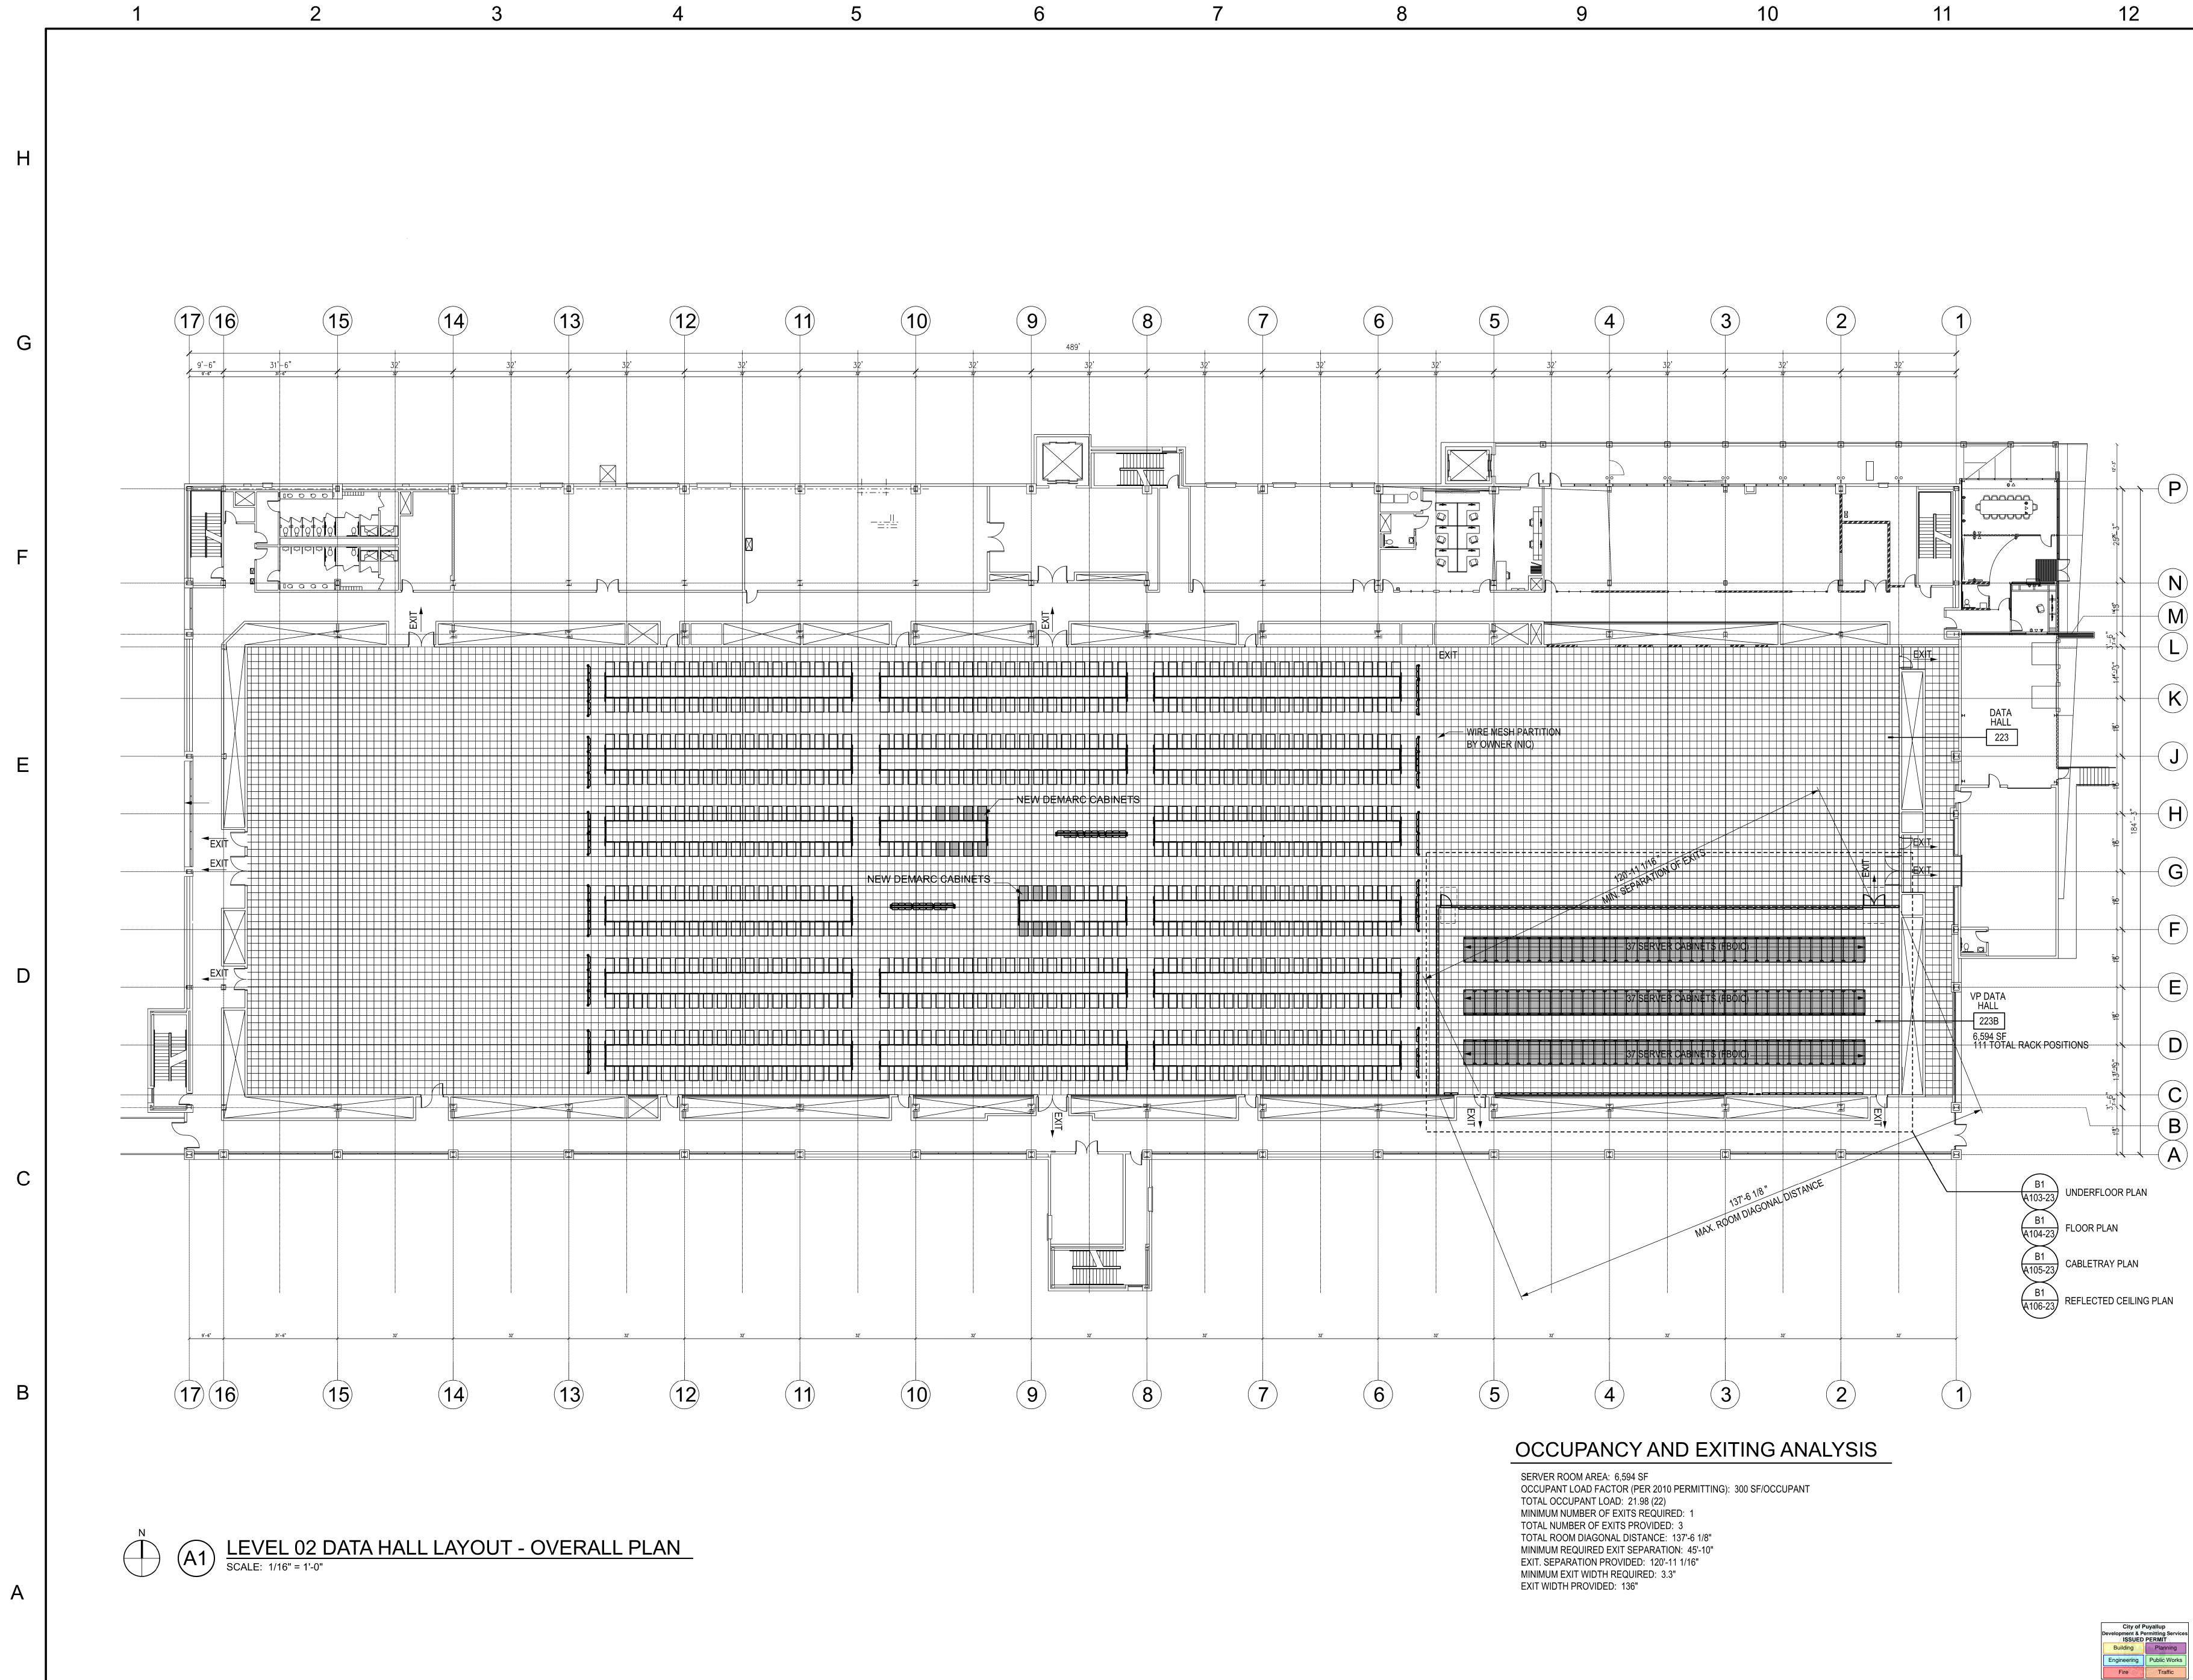

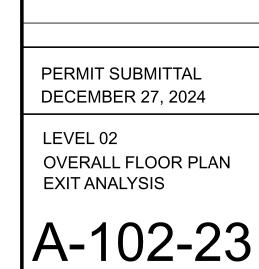

SULTANT 200 CAL 4 CRIT 202 NO MISSI PRCT

CASCADE Data Center Co. 6210 36th Aver P: 206-294-128


CENTERIS VOLTAGE F 1023 39th Avenue South Puyallup, WA 98374-21 WB05-LEVEL 02 VOLTAGE PARK DATA H²

ISSUED/REVISED

PERMIT SUBMITTAL


DATE

12/27/24

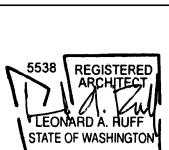


OWNER:

BENAROY Centeris | 9675 SE 3 Mercer |s +1.253.20

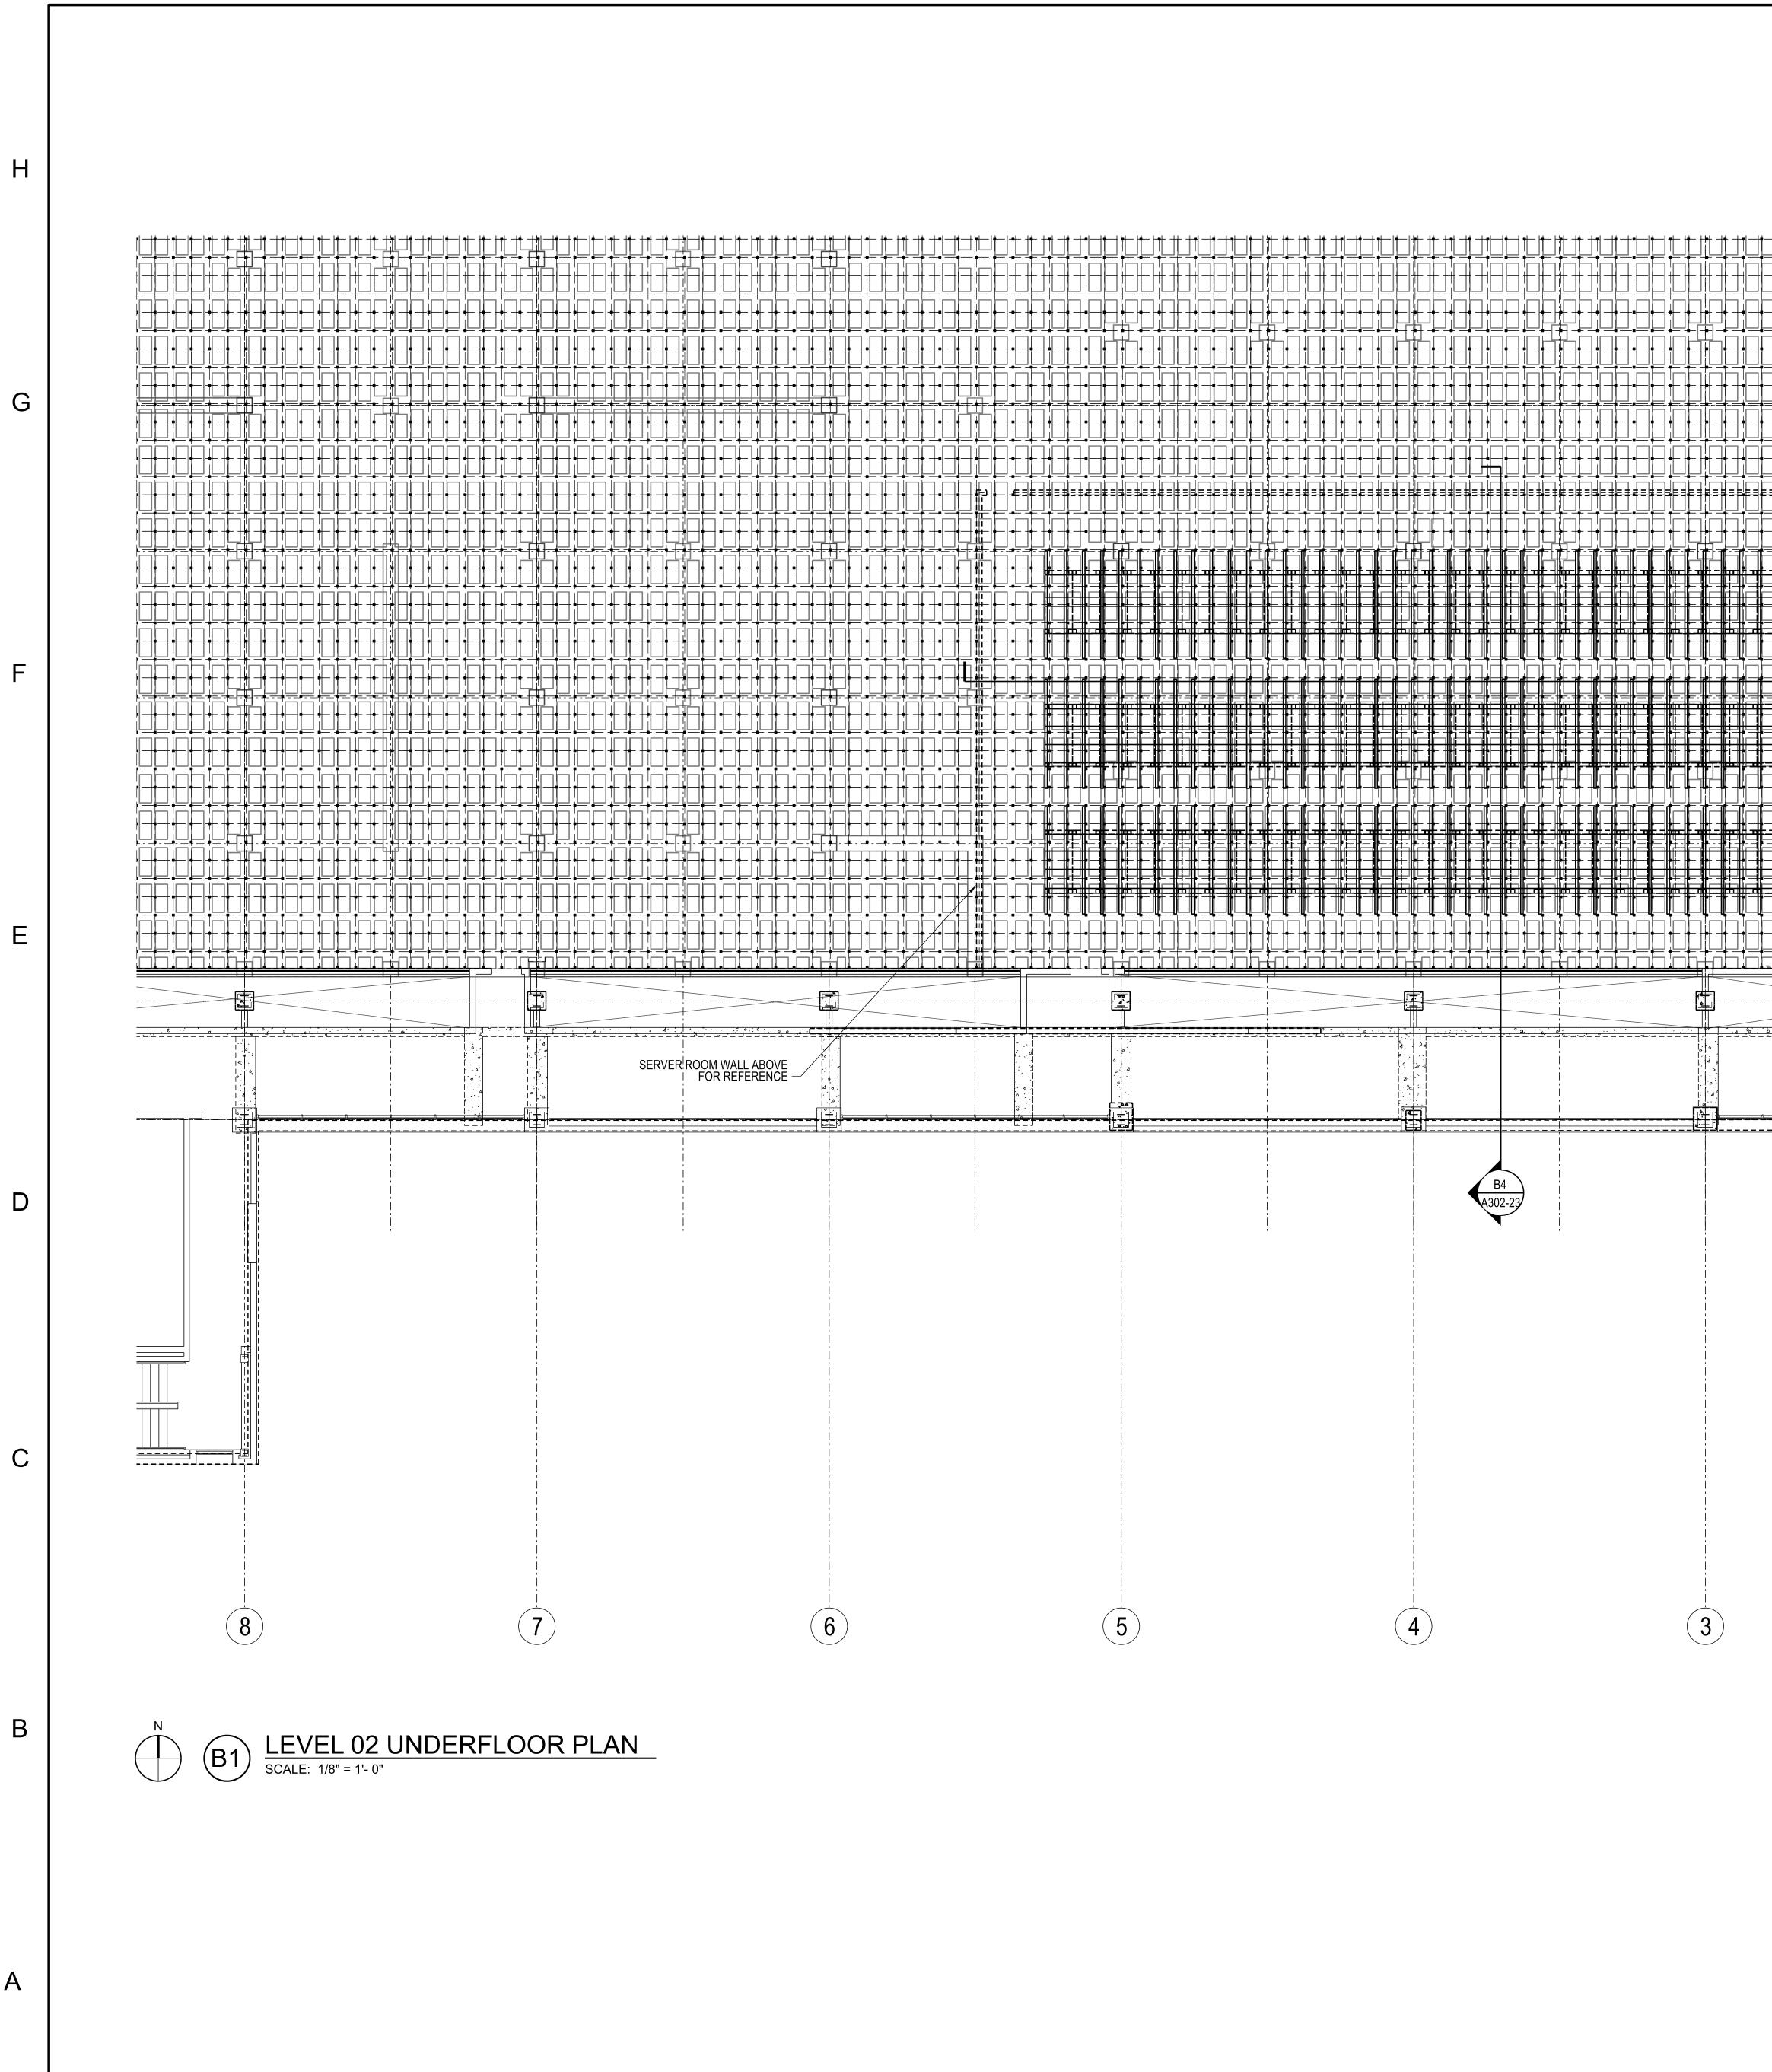

	H SERVER ROOM WALL ABOVE FOR REFERENCE RAISED FLOOR GRID ABOVE
	SERVER CABINETS ABOVE CABINET SUPPORT & BRACING SYSTEM PER STRUCT.
	CABINET SUPPORT & BRACING SYSTEM PER STRUCT. SERVER CABINETS ABOVE CABINET SUPPORT & BRACING SYSTEM PER STRUCT. CABINET SUPPORT & BRACING SYSTEM PER STRUCT. EXIST. OPEN CONC. FLOOR STRUCTURE EXIST. RAISED FLOOR PEDESTALS-TYP.
2	1 0.5 0

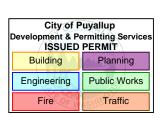



LEVEL 02 UNDERFLOOR PLAN SHEET DESCRIPTION

PERMIT SUBMITTAL

DECEMBER 27, 2024

ISSUED/REVISED

PERMIT SUBMITTAL 12/27/24

DATE


A-103-23











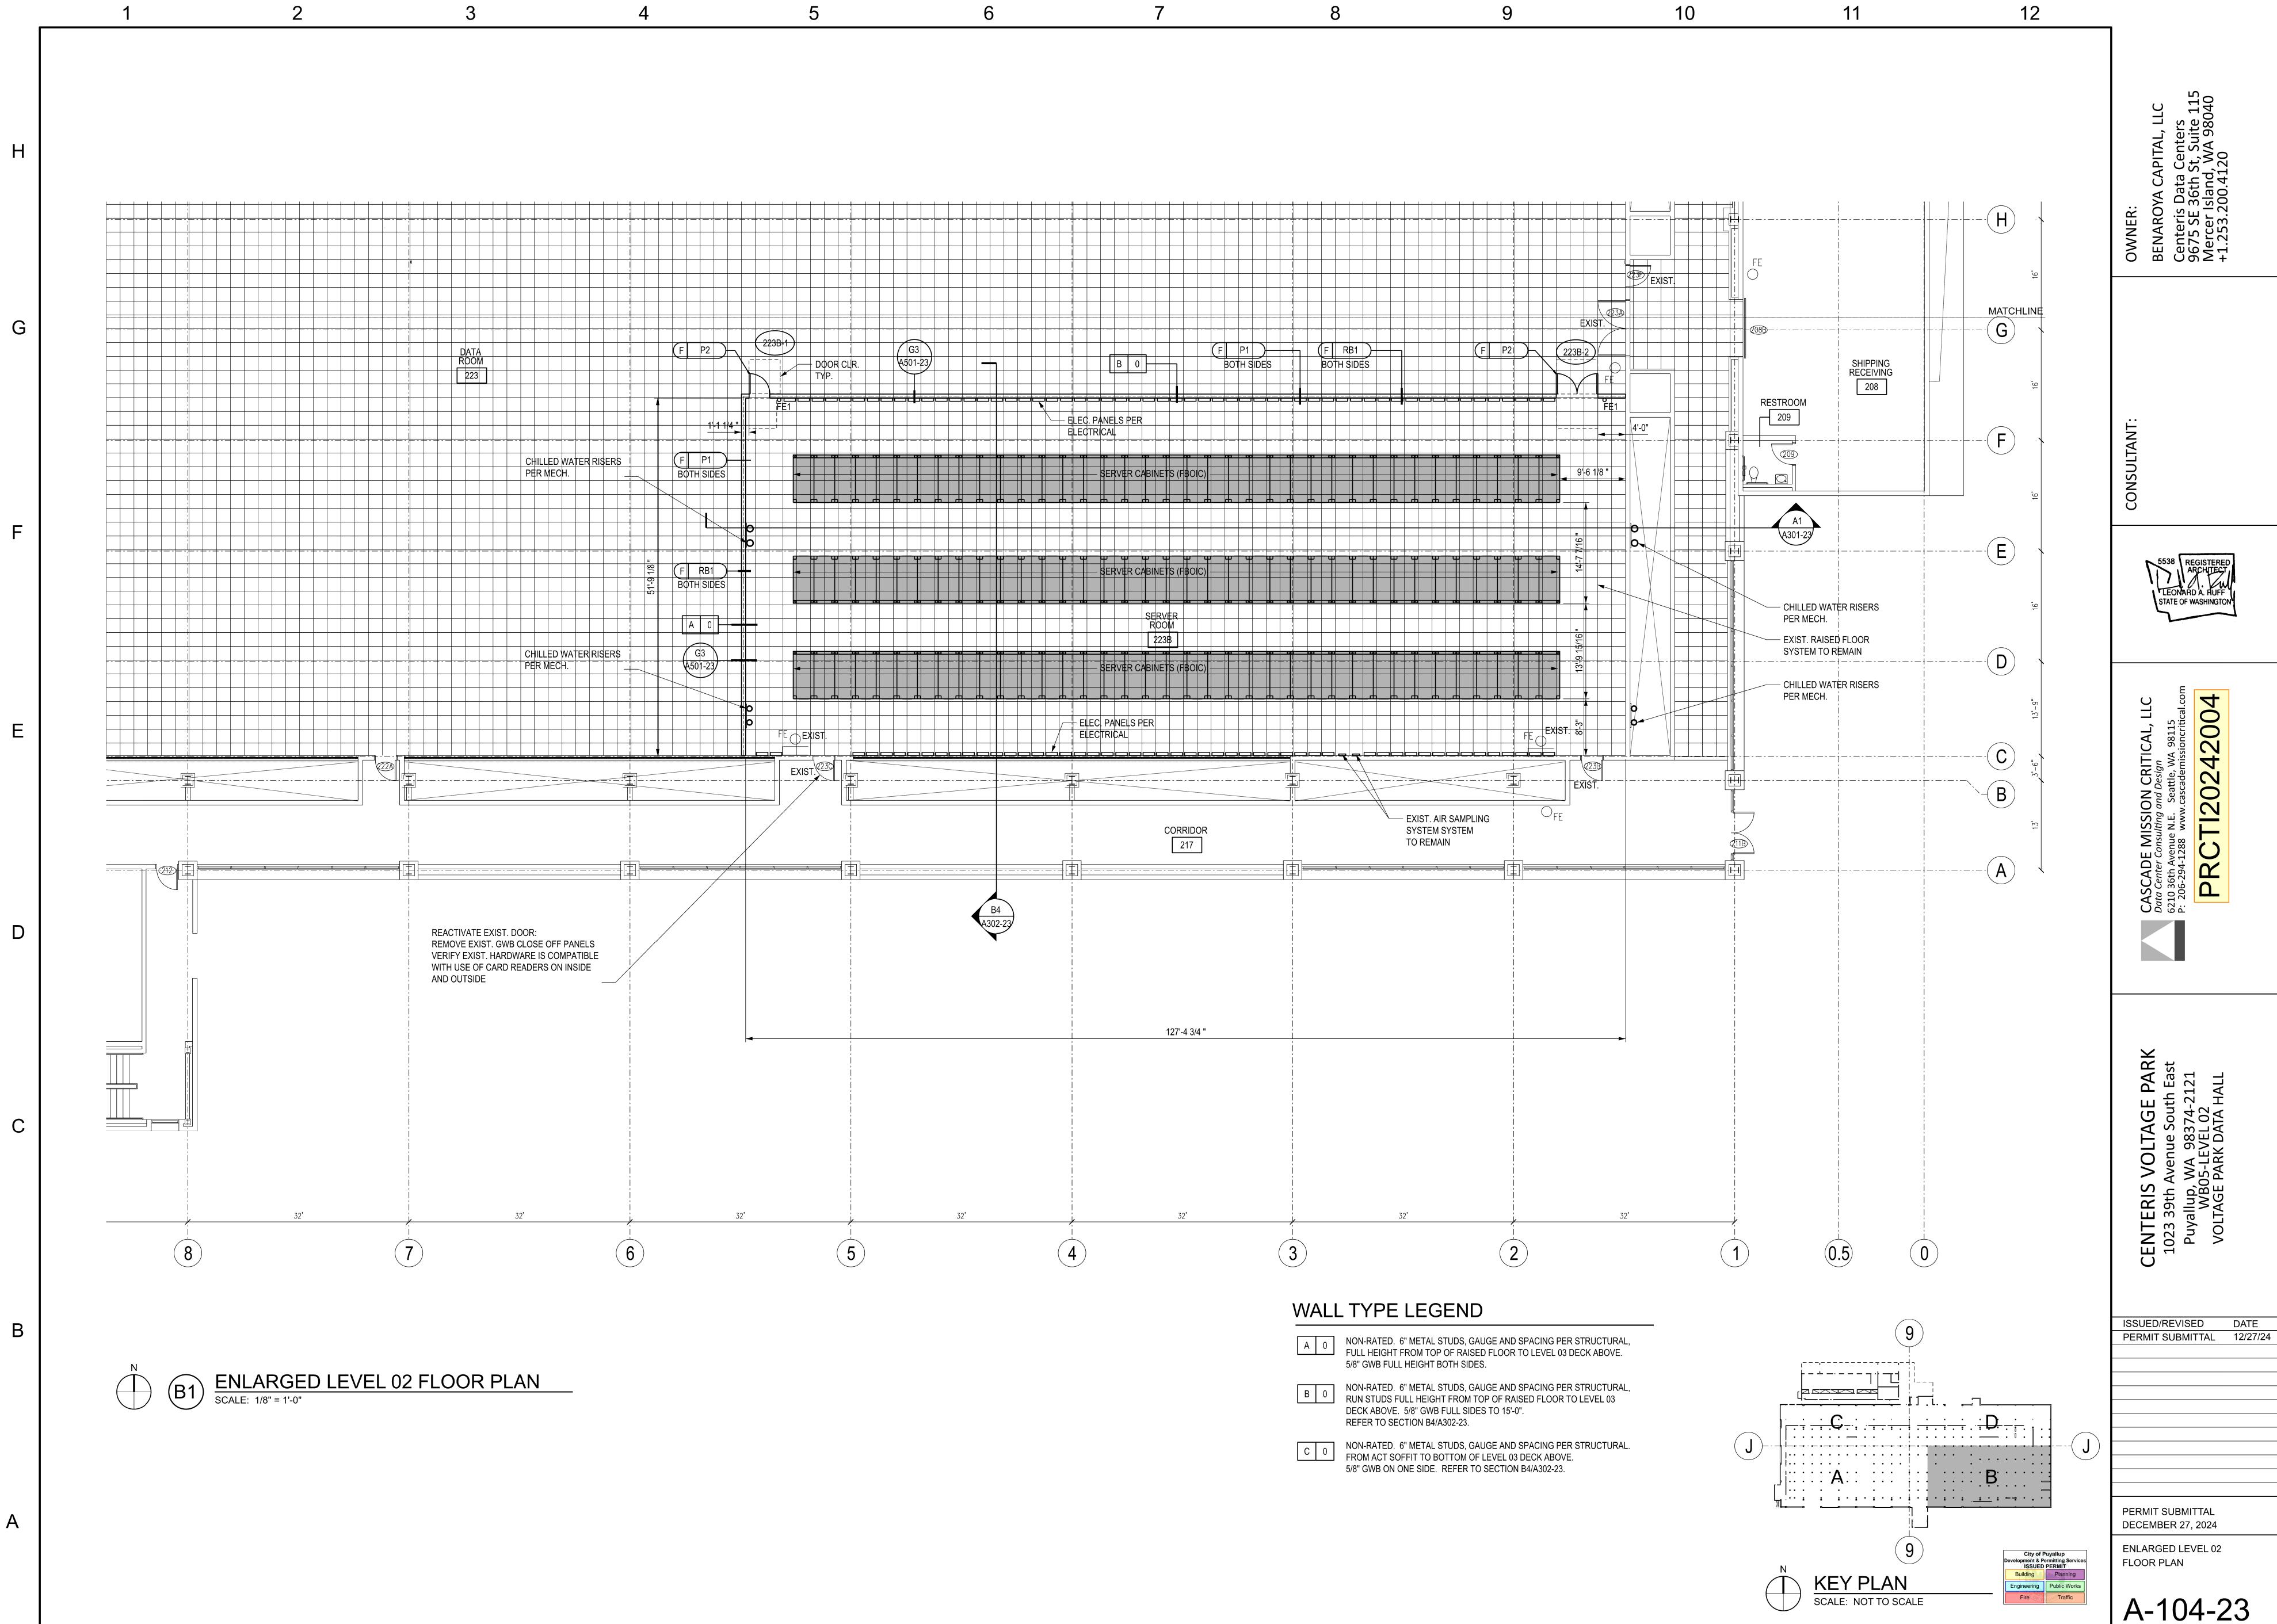

COPYRIGHT ⓒ CASCADE MISSION CRITICAL, LLC 2024

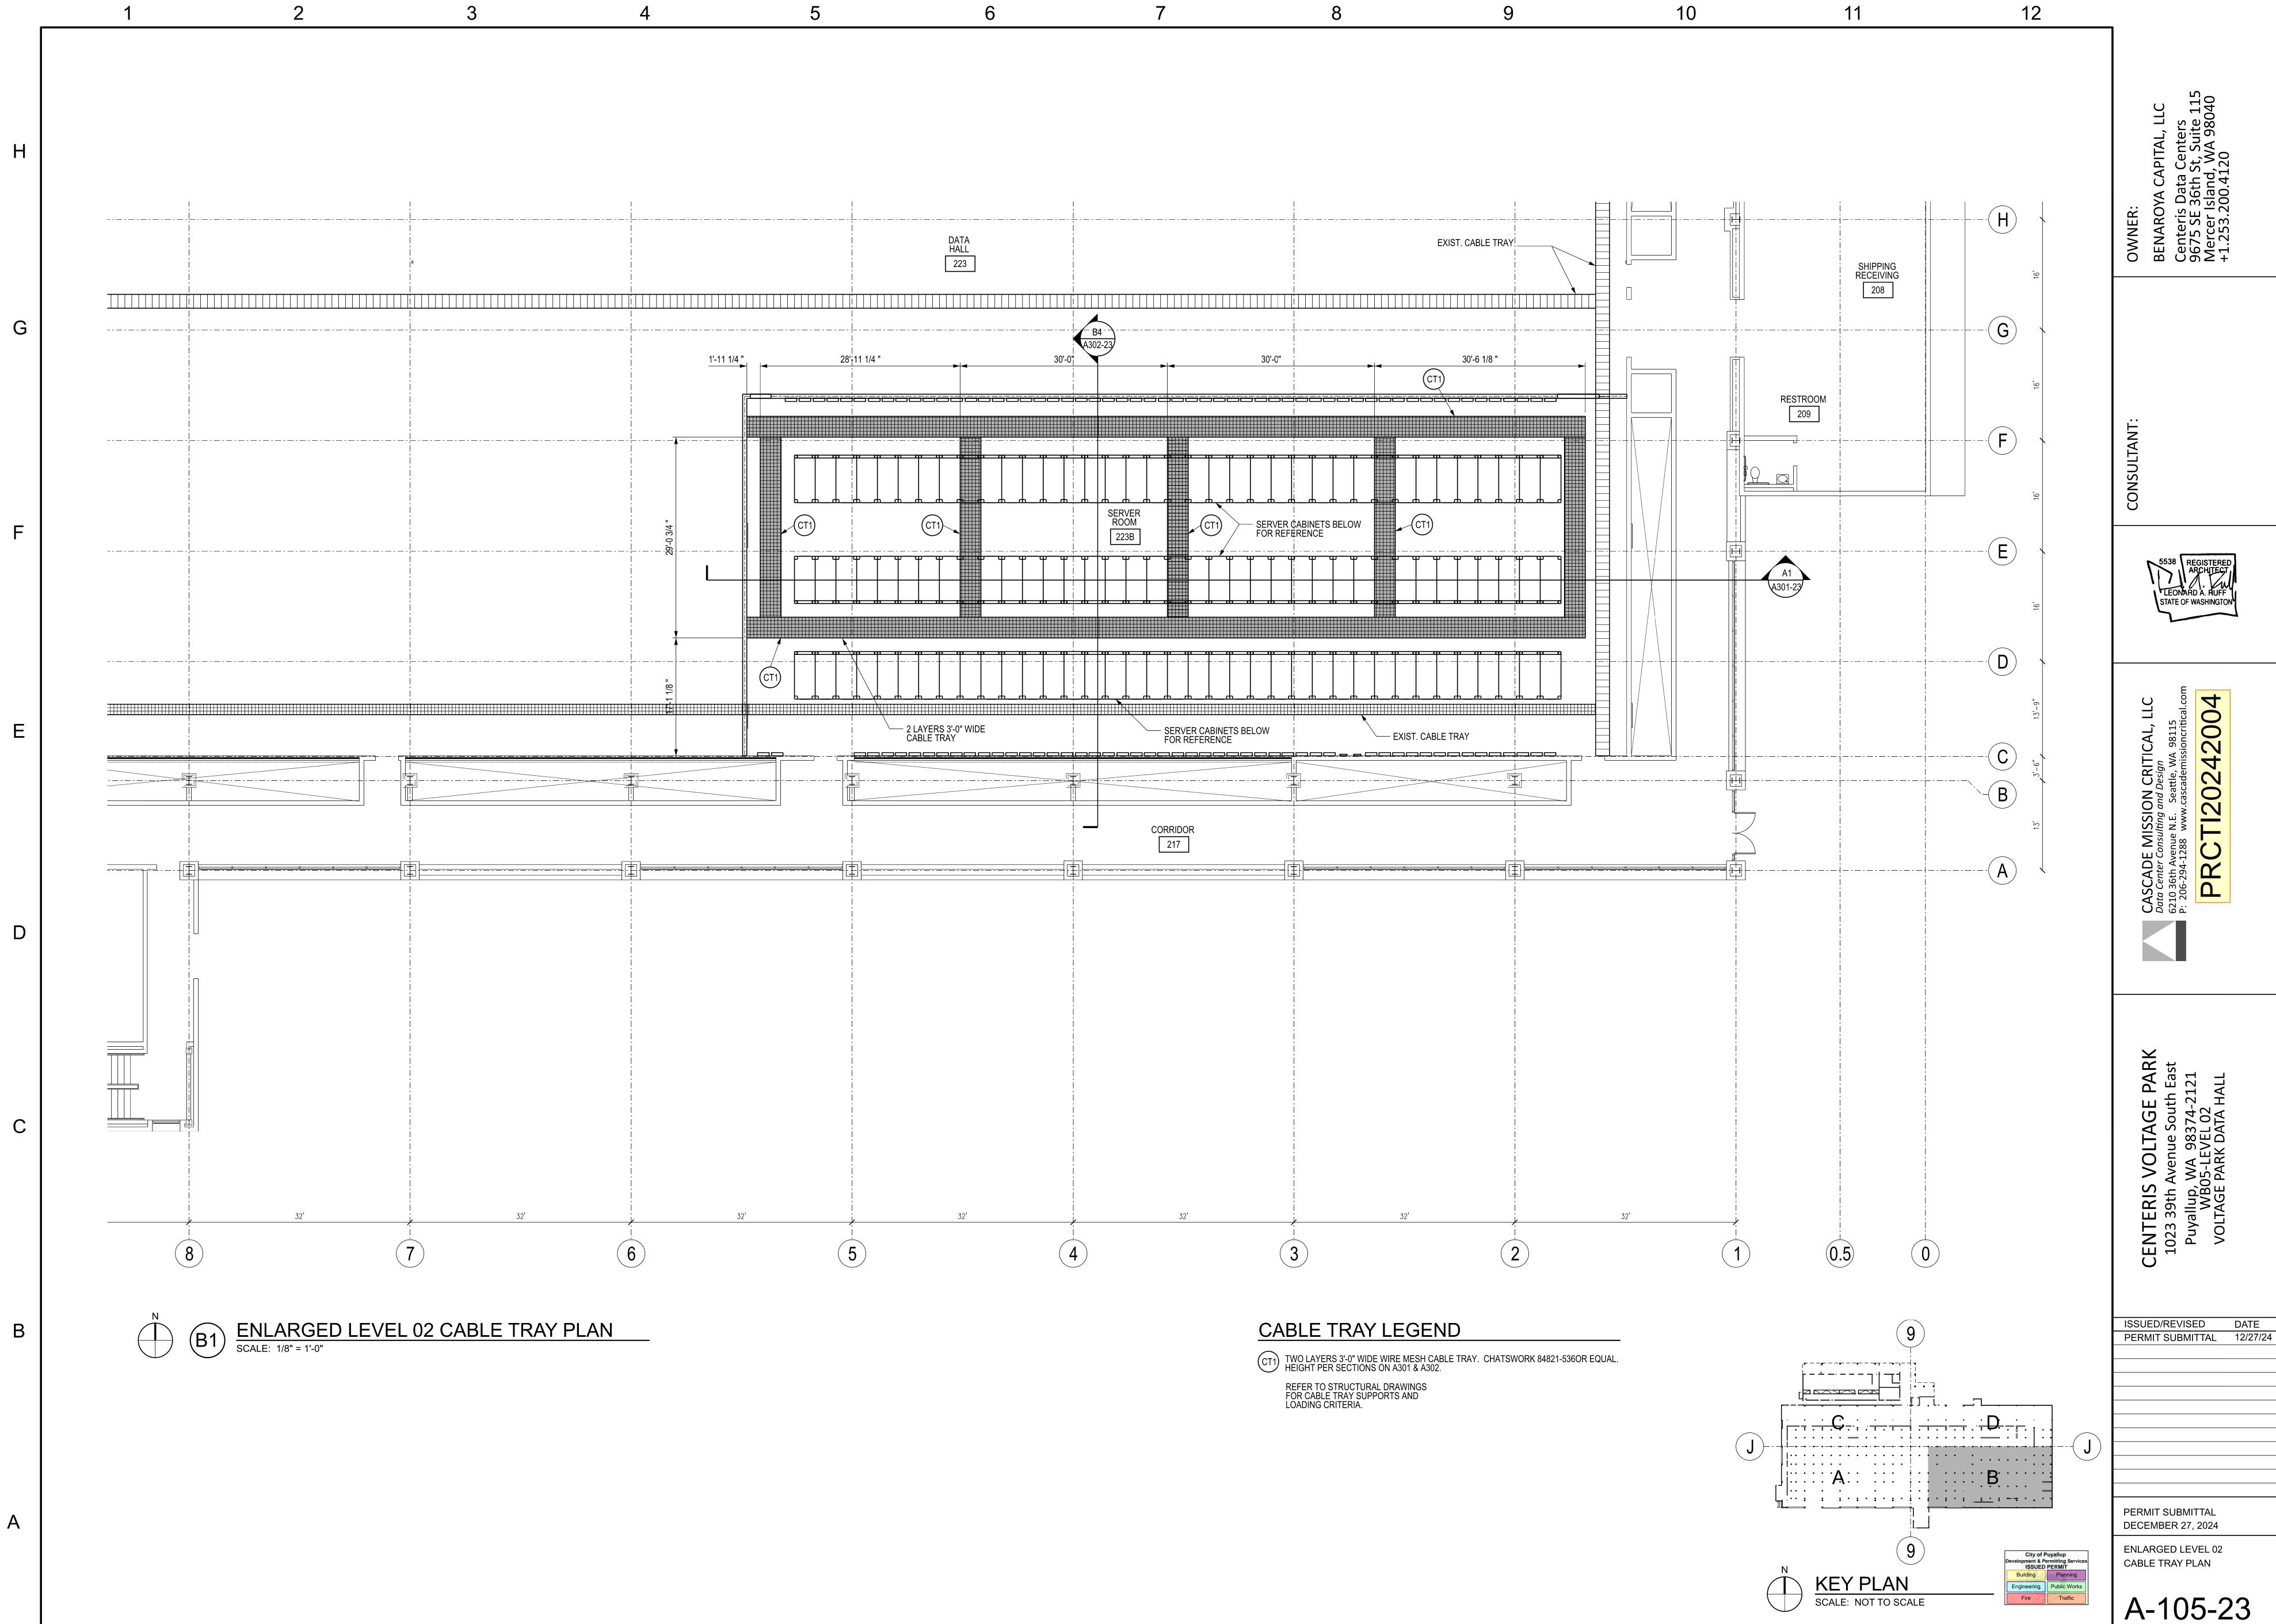


8	9	10	
	EXIST. CABLE TRAY		

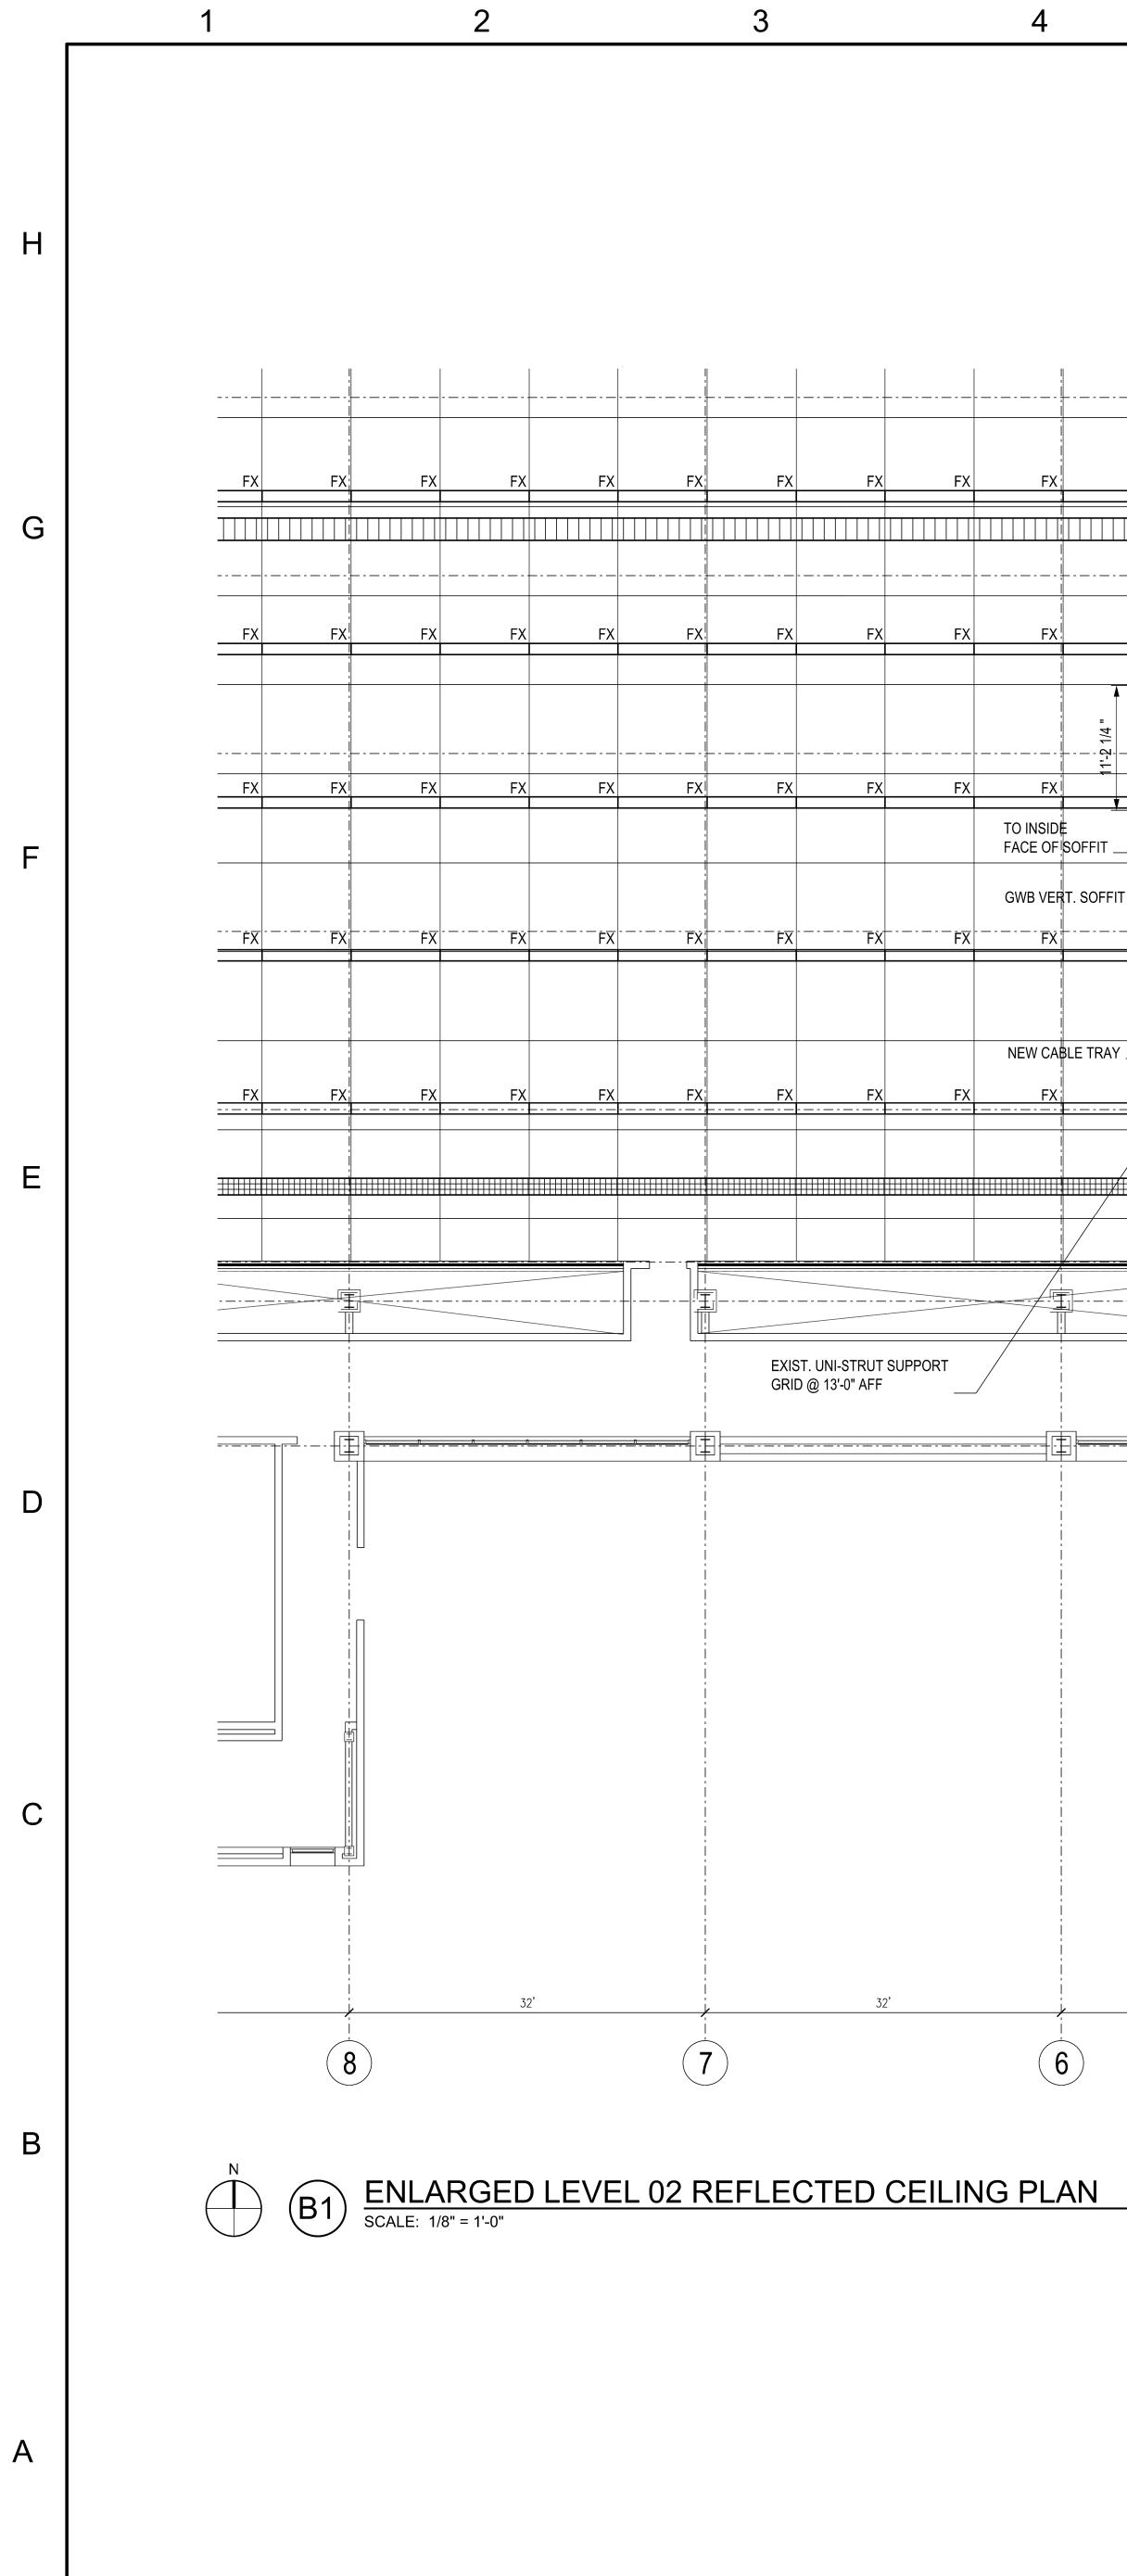

- COMPRESSION POST - -@-12-0" OC SEE DETAIL −-B4−[−] A302-23 E9/A501-23 FX FX FX G9 A501-23 - <u>-</u> וּיָם FX FACE OF SOFFIT _ ∕_ G9 _` A501-23/ SERVER CABINETS BELOW FOR REF. \checkmark GWB VERT. SOFFIT FX FX NEW CABLE TRAY _ G1 A501-23 \dashv SERVER CABINETS BELOW FOR REF. <u>F3X</u>Ø (6) 〔5〕 3 LIGHT FIXTURE LEGEND REFER TO ELECTRICAL FOR LIGHT FIXTURE SPECIFICATIONS FX EXIST. SUSPENDED FIXTURE TO REMAIN FXR EXIST. SUSPENDED FIXTURE TO BE REMOVED. TURN OVER TO OWNER F1 NEW 8' STRIP LED SUSPENDED FROM EXIST. UNI-STRUT SUPPORT GRID - MATCH ELEVATION OF FIXTURE F2


- F2 NEW 8' STRIP LED ATTACHED TO THE BOTTOM OF THE
- CABLE TRAY SUPPORT STRUCTURE FX WALL MOUNTED EXIT SIGN
- FX3 EXIST. WALL MOUNTED EXIT SIGN TO REMAIN

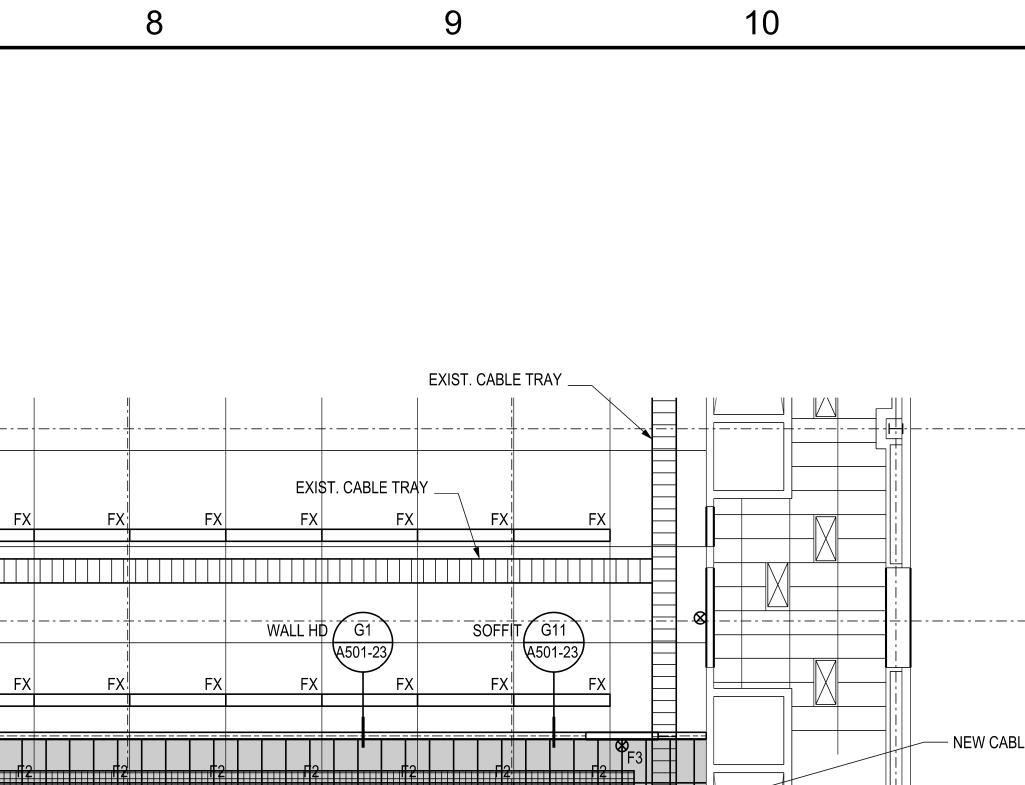


EXIST. CABLE TRAY




2

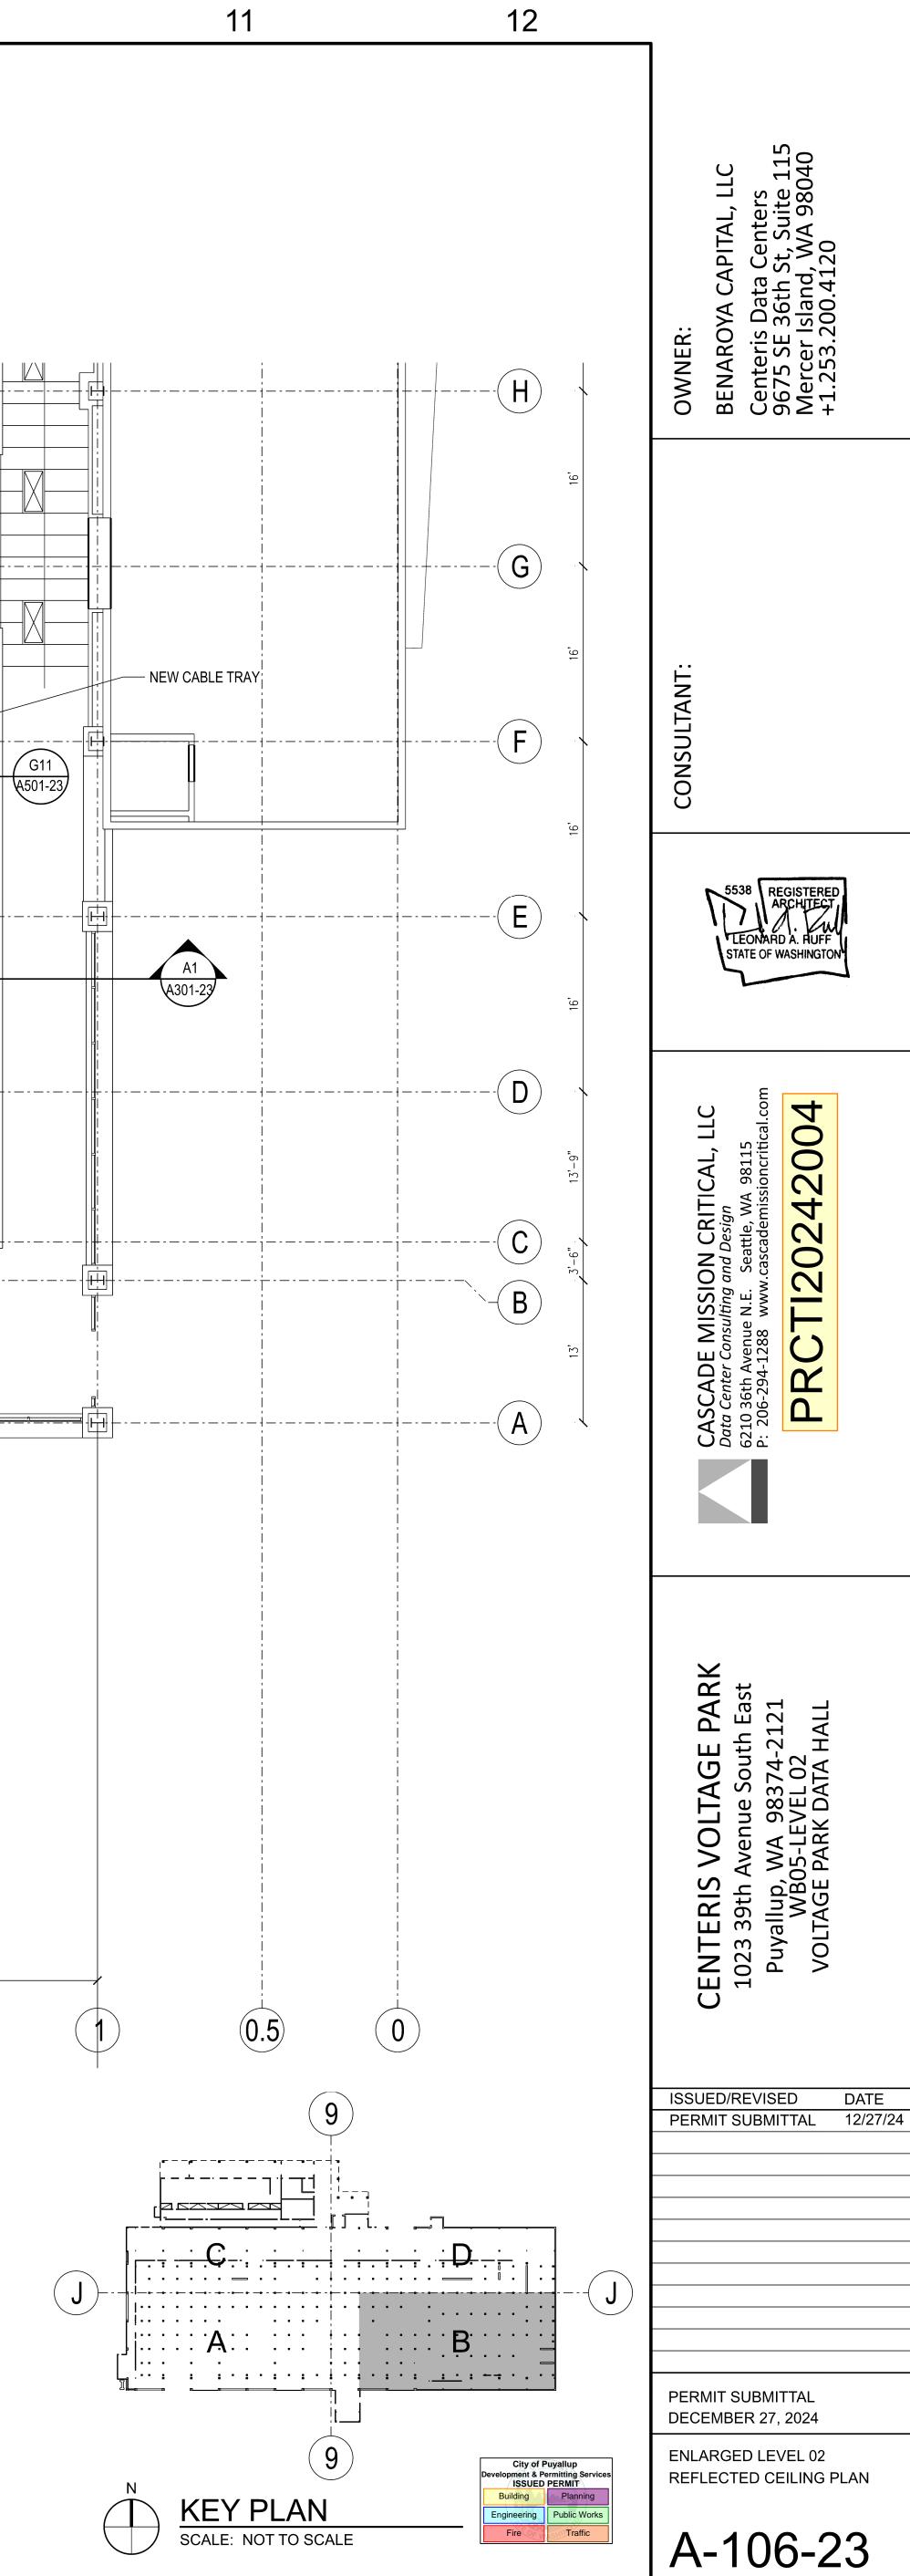


COPYRIGHT ⓒ CASCADE MISSION CRITICAL, LLC 2024

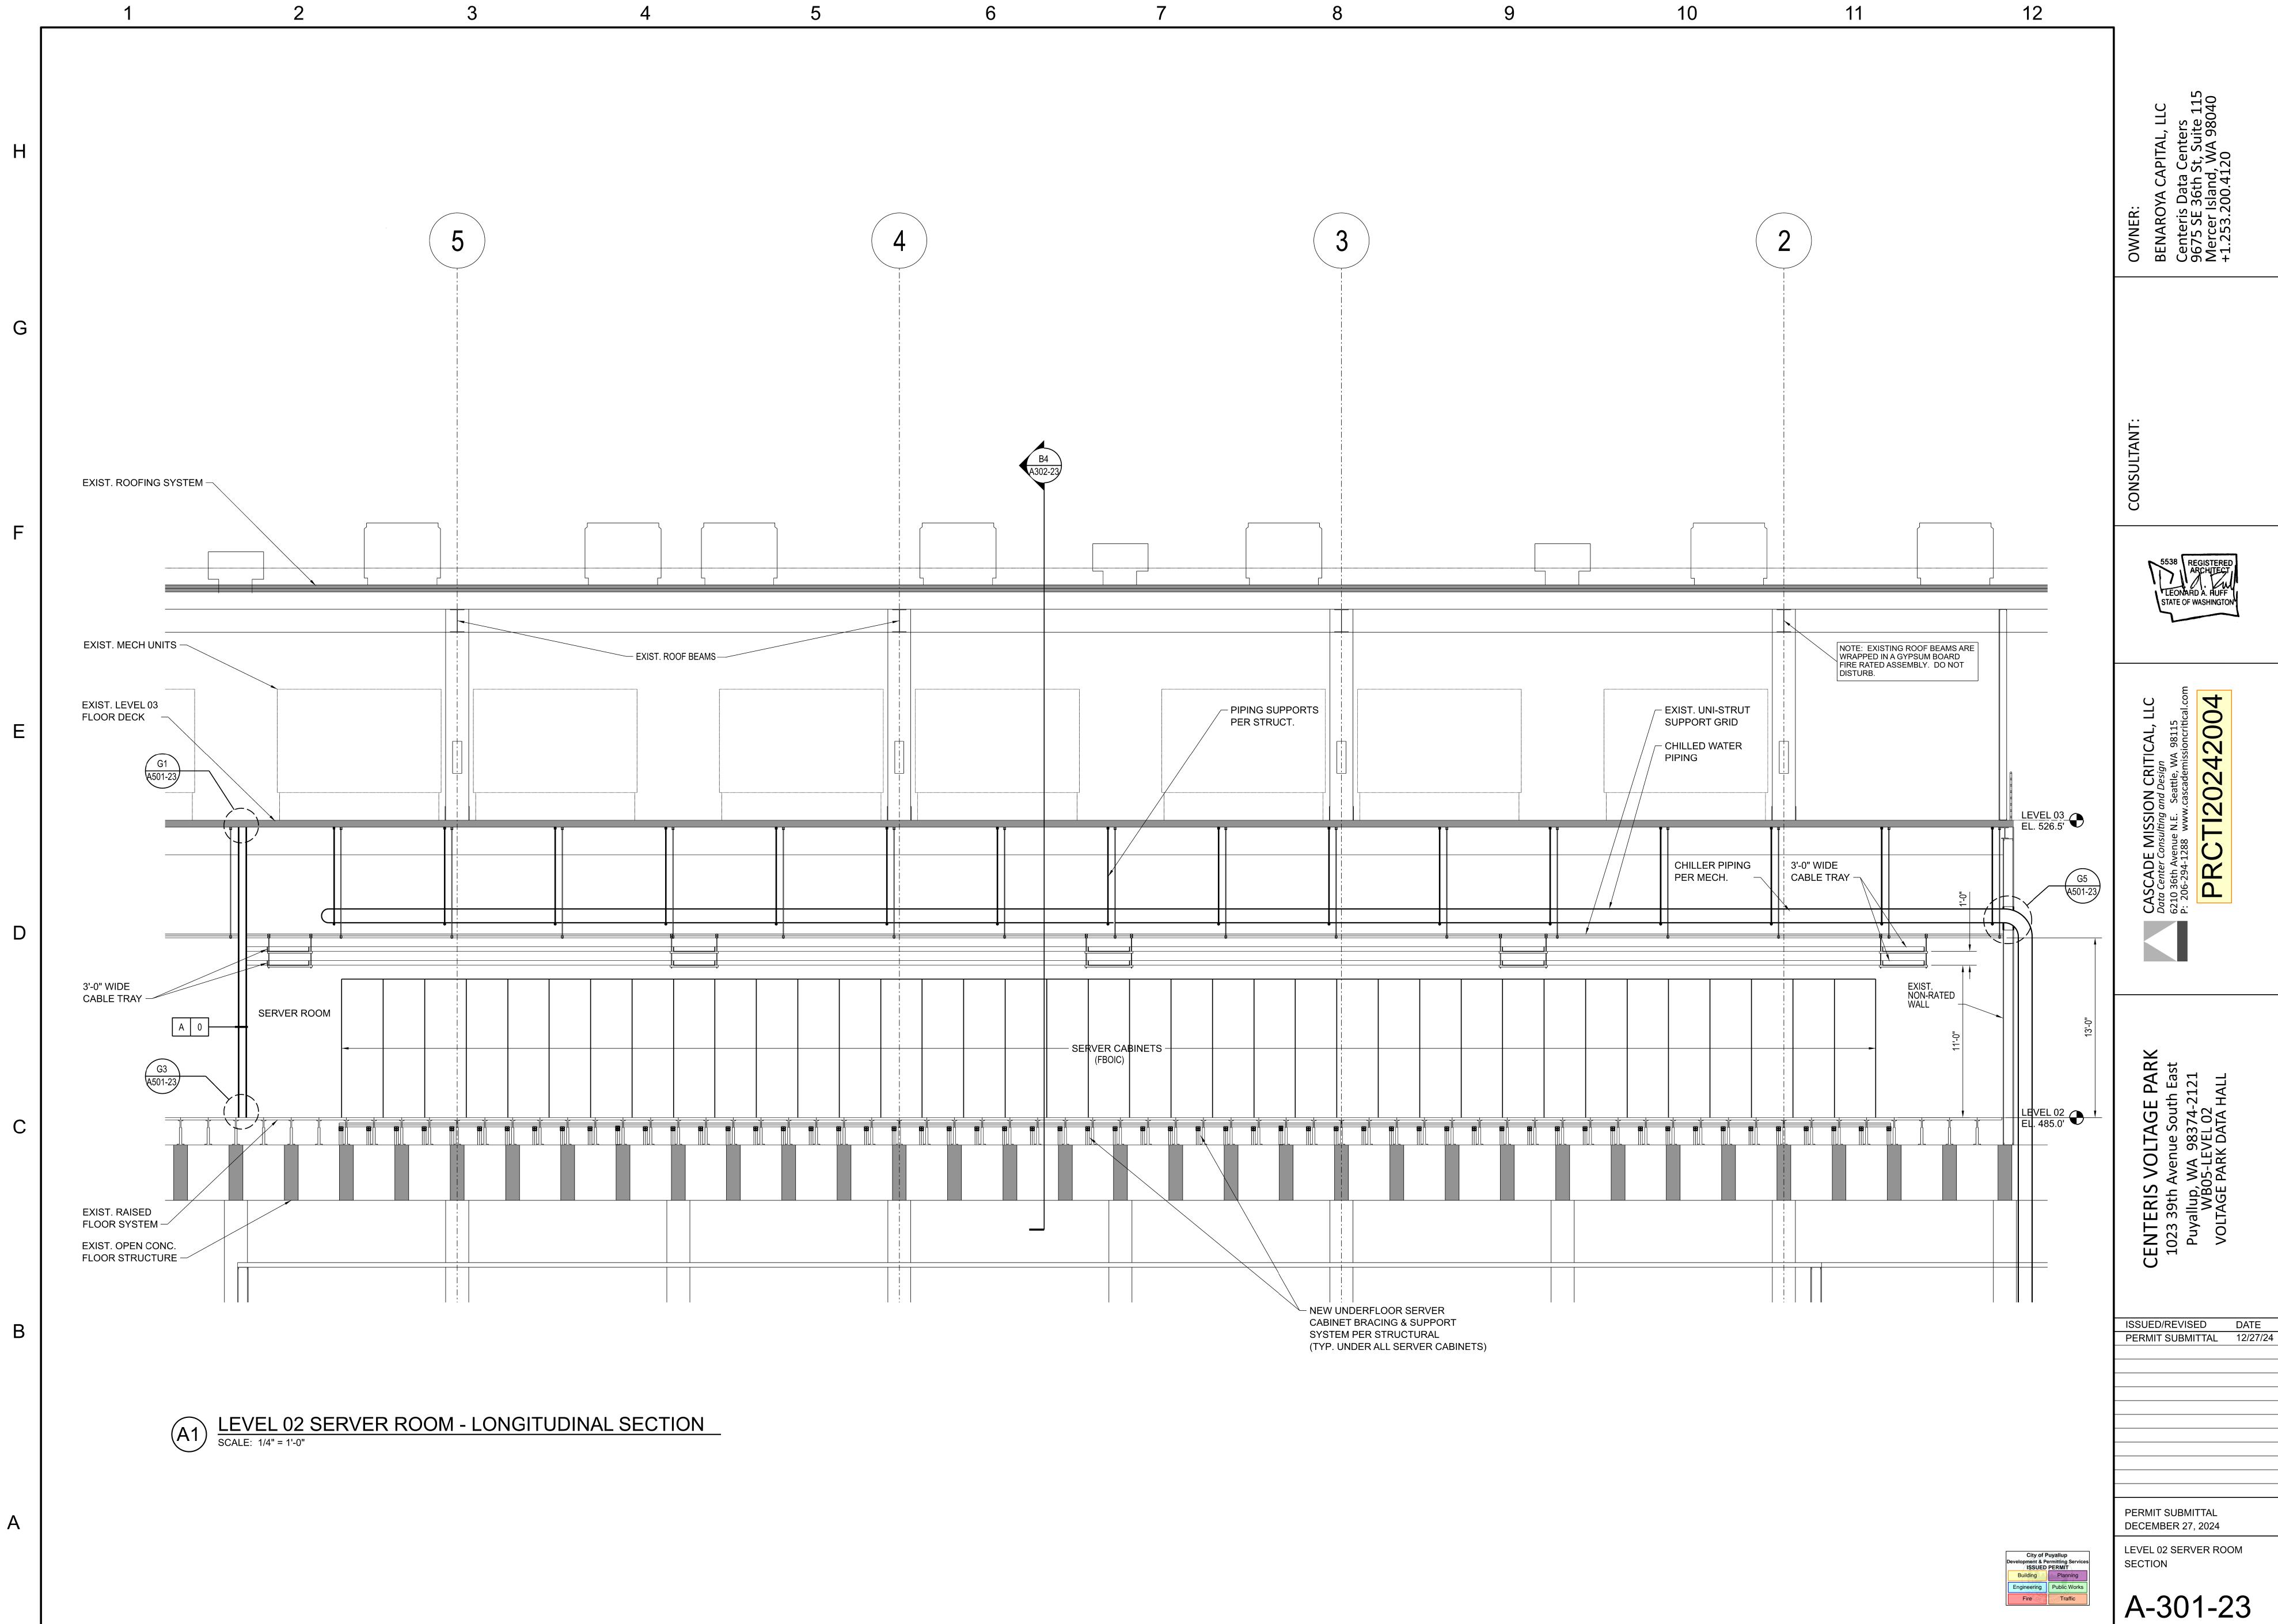


	1	2	3	4
Н				
G				
F				
E				
D				
С				
В				Œ
A				

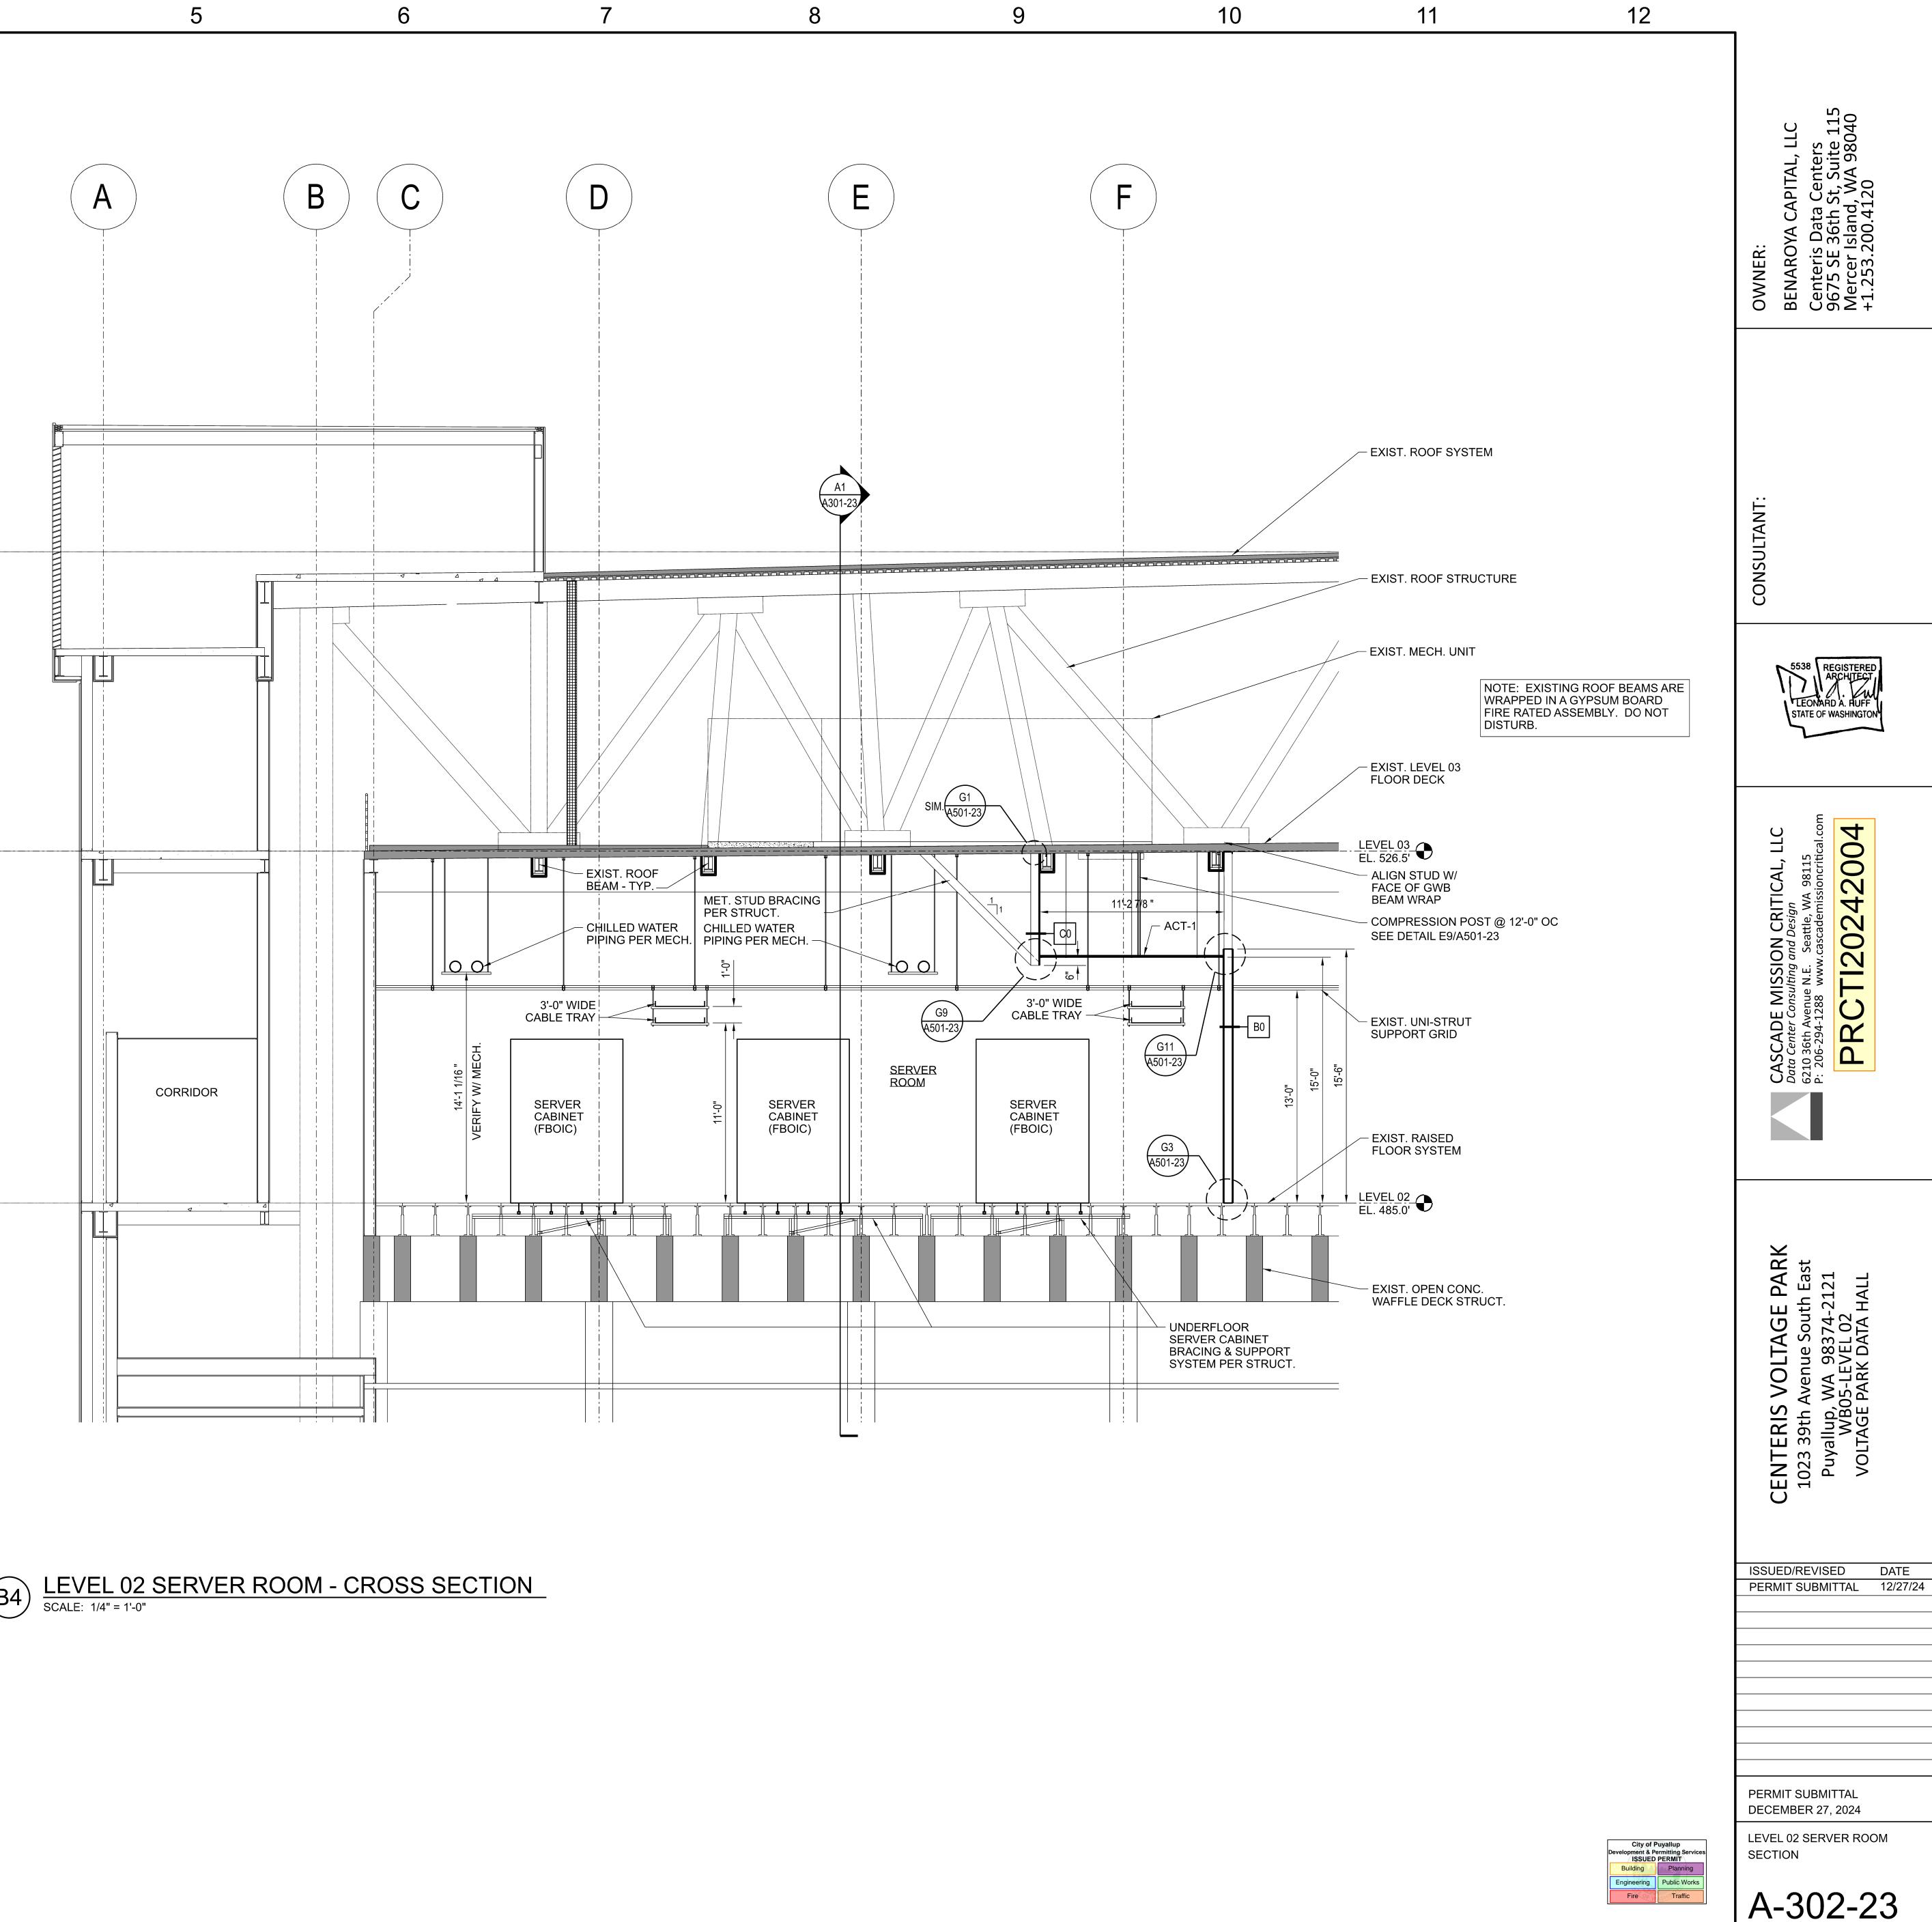

B4)

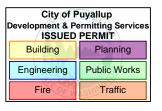

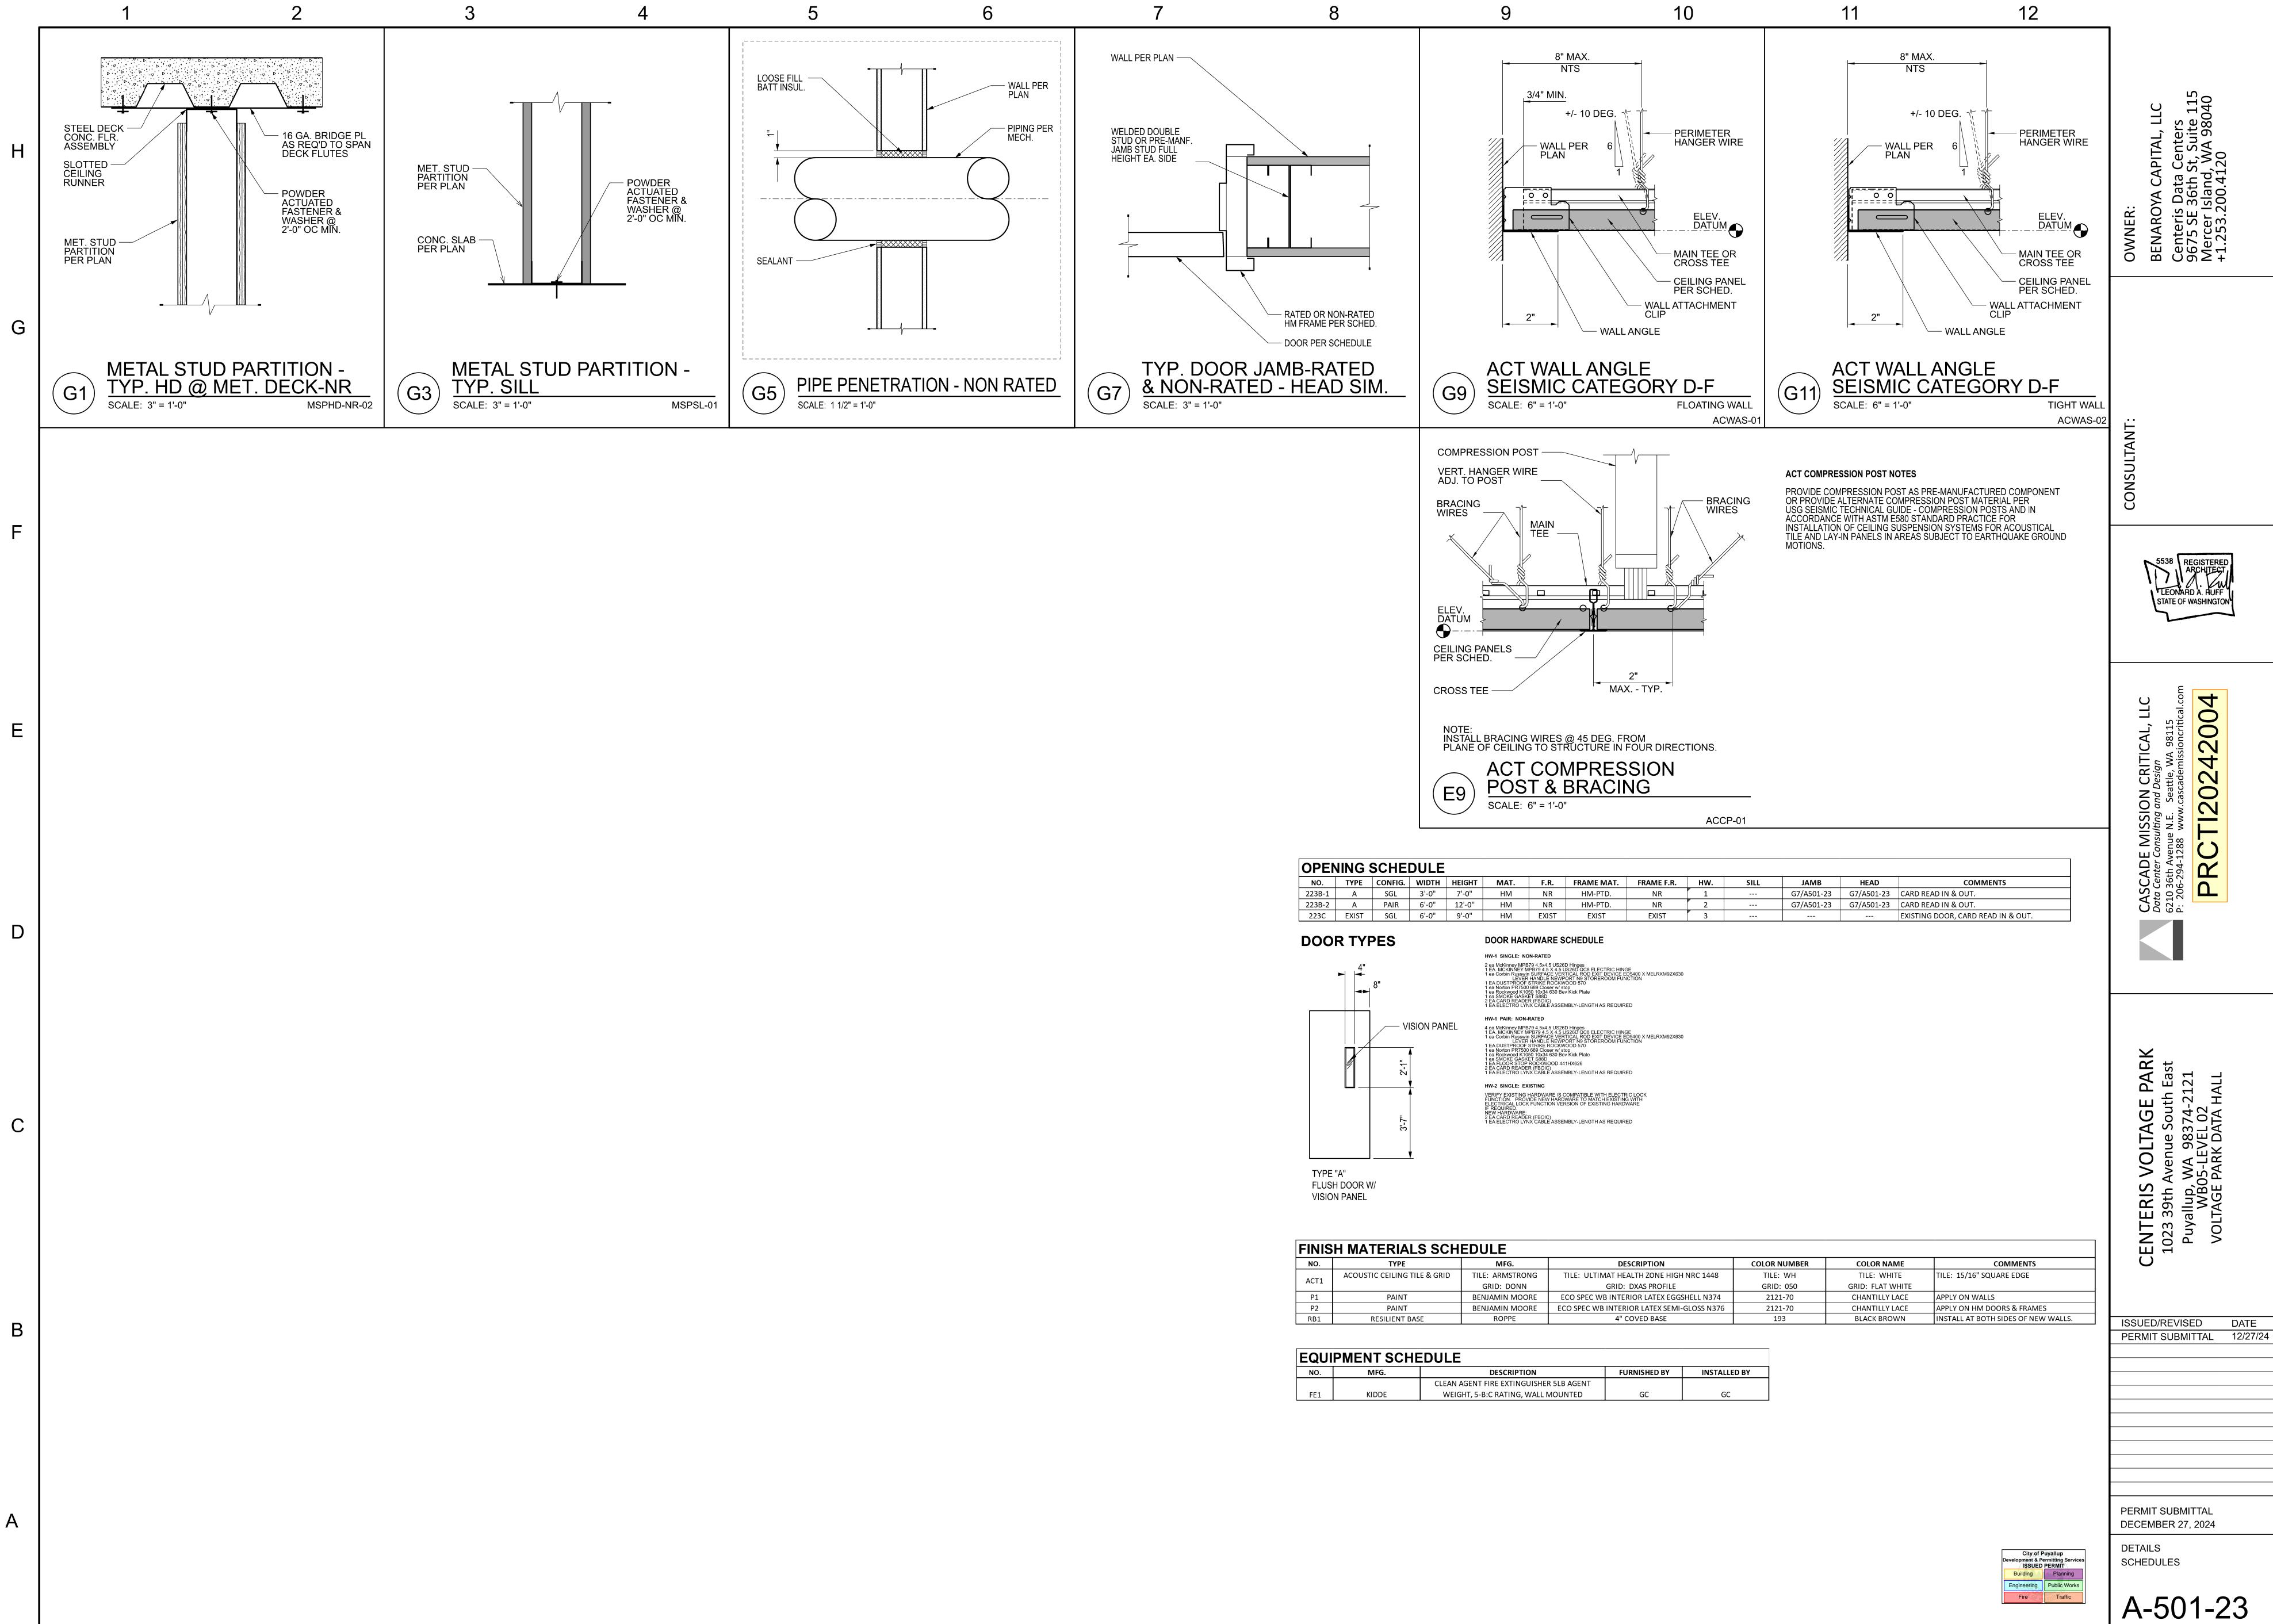

1	
	FINIS
	NO.
	ACT1
	P1
	P2
	RB1
	_
	EQUI

	ΤΥΡΕ	CONFIG.	WIDTH	HEIGHT	MAT.	F.R.	FRAME MAT.	FRAME F.R.	HW.	SILL	JAMB	HEAD	COMMENTS
	А	SGL	3'-0"	7'-0"	HM	NR	HM-PTD.	NR	1		G7/A501-23	G7/A501-23	CARD READ IN & OUT.
	А	PAIR	6'-0"	12'-0"	HM	NR	HM-PTD.	NR	2		G7/A501-23	G7/A501-23	CARD READ IN & OUT.
	EXIST	SGL	6'-0"	9'-0"	HM	EXIST	EXIST	EXIST	3				EXISTING DOOR, CARD READ IN & OUT.
)	R TYF	PES			DOOR HAR		CHEDULE						
	► 4"	8"			2 ea McKinney MPE 1 EA. MCKINNEY M 1 ea Corbin Russwi LEVER 1 EA DUSTPROOF 1 ea Norton PR7500 1 ea Pockwood K10	/IPB79 4.5 X 4.5 L n SURFACE VER R HANDLE NEWP STRIKE ROCKW 0 689 Closer w/ st	JS26D QC8 ELECTRIC HING TICAL ROD EXIT DEVICE E ORT N9 STOREROOM FUN /OOD 570 .00	SE D5400 X MELRXM92X630 CTION					

1 E	A. MCKINŃEY MPB79 4.5 X 4.5 US26Ď QC8 ELECTRIC HINGE
1 e	a Corbin Russwin SURFACE VERTICAL ROD EXIT DEVICE ED5400 X MELRXM92X630
	LEVER HANDLE NEWPORT N9 STOREROOM FUNCTION
1 E	A DUSTPROOF STRIKE ROCKWOOD 570
1 e	a Norton PR7500 689 Closer w/ stop
1 e	a Rockwood K1050 10x34 630 Bev Kick Plate
1 e	a SMOKE GASKET S88D
2 E	A CARD READER (FBOIC)
1 E	A ELECTRO LYNX CABLE ASSEMBLY-LENGTH AS REQUIRED

ТҮРЕ	MFG.	DESCRIPTION	COLOR NUMBER	COLOR NAME	COMMENTS
ACOUSTIC CEILING TILE & GRID	TILE: ARMSTRONG	TILE: ULTIMAT HEALTH ZONE HIGH NRC 1448	TILE: WH	TILE: WHITE	TILE: 15/16" SQUARE EDGE
	GRID: DONN	GRID: DXAS PROFILE	GRID: 050	GRID: FLAT WHITE	
PAINT	BENJAMIN MOORE	ECO SPEC WB INTERIOR LATEX EGGSHELL N374	2121-70	CHANTILLY LACE	APPLY ON WALLS
PAINT	BENJAMIN MOORE	ECO SPEC WB INTERIOR LATEX SEMI-GLOSS N376	2121-70	CHANTILLY LACE	APPLY ON HM DOORS & FRAM
RESILIENT BASE	ROPPE	4" COVED BASE	193	BLACK BROWN	INSTALL AT BOTH SIDES OF N

_				
	MFG.	DESCRIPTION	FURNISHED BY	INSTALLED BY
T		CLEAN AGENT FIRE EXTINGUISHER 5LB AGENT		
	KIDDE	WEIGHT, 5-B:C RATING, WALL MOUNTED	GC	GC