APPLICABLE CODES

WASHINGTON STATE RESIDENTIAL CODE
WASHINGTON STATE EXISTING BUILDING CODE
WASHINGTON STATE FIRE CODE
WASHINGTON STATE MECHANICAL CODE

THE EVENT OF CONFLICT, THE MOST RESTRICTIVE CODE SHALL PREVAI

GENERAL NOTES

THE FACILITY IS UNMANNED AND NOT FOR HUMAN HABITATION, HANDICAPPED ACCESS REQUIREMENTS ARE NOT REQUIRED IN ACCORDANCE WITH THE ACCESS REQUIREMENTS ARE NOT REQUIRED IN ACCORDANCE WITH THE 2021 WASHINGTON BUILDING CODE. A TECHNICIAN WILL VISIT THE SITE AS REQUIRED FOR ROUTINE MAINTENANCE. THE PROJECT WILL NOT RESULT IN ANY SIGNIFICANT DISTURBANCE OR EFFECT ON DRAINAGE; NO SANITARY SEWER SERVICE, POTABLE WATER, OR TRASH DISPOSAL IS REQUIRED AND NO COMMERCIAL SIGNAGE IS PROPOSED.

SITE INFORMATION

T-MOBILE - PLANNING & SITE ACQUISITION MASTEC NETWORK SOLUTIONS 3443 AIRPORT ROAD SACRAMENTO, CALIFORNIA 95831 APPLICANT:

WASH ST DEPT OF TRANSPORTATION 11211 41ST AVENUE SW PROPERTY OWNER:

LAKEWOOD, WASHINGTON 98499

STRUCTURE TYPE: MONOPLE

ASSESSORS PARCEL NUMBER: 0419044084

LATITUDE 47' 09' 43.48"N 47.16208

LONGITUDE: 122 17 40.04 W - 122.29446

LAT/LONG TYPE:

ELEVATION: ±438.0' AMSL

EXISTING ZONING: GC (GENERAL COMMERCIAL) PROPOSED PROJECT AREA NO INCREASE IN S.F.

TYPE OF CONSTRUCTION: OCCUPANCY GROUP:

JURISDICTION: CITY OF PUYALLUP

PROJECT TEAM

CLIENTS REPRESENTATIVE:

MASTEC NETWORK SOLUTIONS 3443 AIRPORT ROAD

SACRAMENTO, CALIFORNIA 95831 CONTACT: ROSHELL YOCUM PHONE: 916-837-6494

ENGINEER:

MASTEC NETWORK SOLUTIONS

507 AIRPORT BLVD, SUITE 111 MORRISVILLE, NORTH CAROLINA 27560 CONTACT: RAPHAEL MOHAMED 919-674-5895 PHONE:

305-925-8514 RAPHAEL.MOHAMED@MASTEC.COM EMAIL:

SITE ACQUISITION:

MASTEC NETWORK SOLUTIONS

125 KLUG CIRCLE CORONA, CALIFORNIA 92880 CONTACT: JESSICA O'BRIEN

JESSICA.OBRIEN@MASTEC.COM

City of Puyallup Division **APPROVED**

> See permit NComstock 03/10/2025



City of Puyallup Development Engineering **APPROVED**

> See permit conditions.

ycharitou 03/17/2025 2:36:00 PM



T--Mobile


SE05408A - REMOVE/DEMO & RESTORE

SOUTH HILL RELO

3150 S MERIDIAN **PUYALLUP, WASHINGTON 98373**

MODIFICATION OF TELECOMMUNICATION SITE

LOCATION MAP

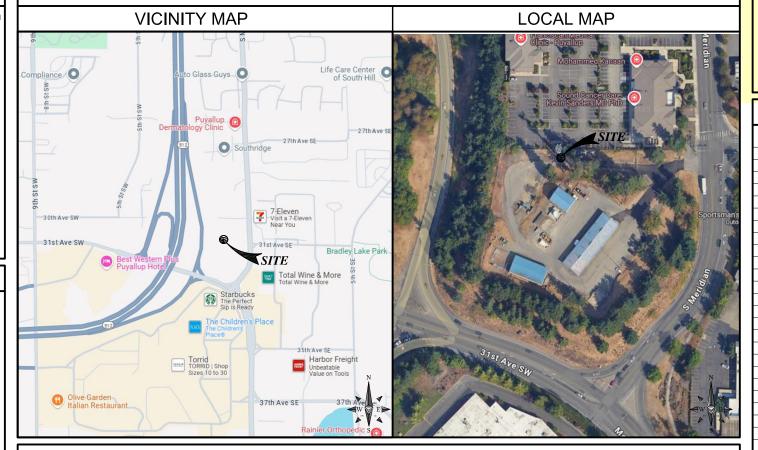

DRIVING DIRECTIONS

FROM: 3625 132ND AVENUE SE, BELLEVUE, WASHINGTON 98006

- HEAD EAST TOWARD 132ND AVE SE TURN RIGHT ONTO 132ND AVE SE TURN LEFT TOWARD 129TH PL SE
- CONTINUE ONTO 129TH PL SE
- USE THE LEFT 2 LANES TO TURN LEFT ONTO 128TH AVE SE/FACTORIA BLVD SE TURN RIGHT ONTO COAL CREEK PKWY SE
- CONTINUE ONTO COAL CREEK PKWY SE
- TURN LEFT TO MERGE ONTO 1-405 S
- MERGE ONTO 1-405 S
 TAKE EXIT 2 TO MERGE ONTO WA-167 S TOWARD AUBURN
 KEEP RIGHT
 USE THE LEFT 2 LANES TO KEEP LEFT
- 14. MERGE ONTO WA-167 S 15. USE THE RIGHT LANE TO TAKE THE WA-512 W EXIT TOWARD WA-161 S/PUYALLUP/OLYMPIA
- 16. CONTINUE ONTO WA-161 S/WA-512 W 17. TAKE THE EXIT TOWARD MERIDIAN ST S
- 18. TURN LEFT ONTO S MERIDIAN TURN RIGHT ONTO 30TH AVE SW TURN LEFT, TURN RIGHT, TURN LEFT

Building REVIEWED FOR COMPLIANCE **BSnowden**

City of Puyallup

Approval of submitted plans is not an approval of omissions or

oversights by this office or non compliance with any applicable

regulations of local government. The contractor is responsible

for making sure that the building complies with all applicable

engineering must be posted on the job at all inspections in a

Full sized legible color plans are required to be provided by

codes and regulations of the local government.

visible and readily accessible location.

the permitee on site for inspection.

The approved construction plans, documents, and all

03/05/2025 8:41:57 AM



City of Puyallup

Development & Permitting Services **ISSUED PERMIT**

Building

Engineering

PROJECT DESCRIPTION

DRAWING INDEX

SHEET TITLE

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T-MOBILE PROPOSES TO MODIFY AN EXISTING UNMANNED WIRELESS COMMUNICATIONS FACILITY. THIS MODIFICATION WILL CONSIST OF THE FOLLOWING:

GROUND EQUIPMENT - TO BE REMOVED BY GC:

REMOVE EXISTING (2) EQUIPMENT CABINETS REMOVE EXISTING (1) METER REMOVE EXISTING (1) GPS ANTENNA

REMOVE EXISTING (1) GPS AINTENNA
REMOVE EXISTING (2) COVP RAYCAP BOX
REMOVE EXISTING ICE BRIDGE
REMOVE EXISTING H-FRAME

TITLE SHEET

SCALE

THE DRAWING SCALES SHOWN IN THIS SE REPRESENT THE CORRECT SCALE ONLY WHEN THESE DRAWINGS ARE PRINTED IN

11"X17" OR 24"X36" FORMAT

GENERAL NOTES

OVERALL SITE PLAN

EXISTING AND FINAL ENLARGED SITE PLAN SOUTH EXISTING AND FINAL ELEVATION

SHEET NO:

GN-1

A-0

REMOVE EXISTING (1) 15"-0" X 10"-0" CONCRETE PAD
 REMOVE EXISTING (1) TELCO CABINET
 REMOVE EXISTING (1) PPC CABINET

PRCTI20250265 T··Mobile



Planning

Public Works

Traffic

MasTec Network Solutions

Γ-MOBILE SITE #: SE05408A JPC 55807

ı					
	Α	02/06/25	100% FINAL CD'S		
	REV	DATE	DESCRIPTION		



T-MOBILE SITE NUMBER

SE05408A T-MOBILE SITE NAME

SOUTH HILL RELO

3150 S MERIDIAN PUYALLUP, WASHINGTON 98373

SHEET TITLE

TITLE SHEET

SHEET NUMBER

LIMITS OF LIABILITY:

MNS HAS MADE EVERY EFFORT TO CREATE COMPLETE AND ACCURATE CONTRACT DOCUMENTS WITH THE BEST INFORMATION AVAILABLE AT THE TIME OF THEIR COMPLETION, CONTRACTORS ARE CAUTIONED THAT MINOR OMISSIONS OR ERRORS THE CONTRACT DOCUMENTS MAY OCCUR AND SHALL NOT EXCUSE THE CONTRACT OF FROM COMPLETING THE PROJECT AND IMPROVEMENTS THE ACCORDANCE WITH THE INTENT OF THE DOCUMENTS. REFERENCE ADMINISTRATIVE

CONTRACT DOCUMENTS:

- 1. THE CONTRACT DOCUMENTS INCLUDE THE AGENCY APPROVED PROJECT SPECIFICATIONS, PLANS, AND THEIR LATEST REVISIONS, ADDENDA, AND CLARIFICATIONS. THE CONTRACT DOCUMENTS MAY ALSO INCLUDE NETWORK CARRIER STANDARDS FOR INSTALLATION OF TELECOMMUNICATIONS EQUIPMENT.
- THE CONTRACTOR SHALL KEEP A MINIMUM OF ONE SET OF CONTRACT DOCUMENTS ON FILE IN THE PROJECT OFFICE AT THE JOB SITE. COPIES OF THE PROJECT DOCUMENTS USED BY SITE STAFF SHALL BE UP TO DATE WITH THE PROJECT OFFICE COPY.
- THE CONTRACTOR SHALL NOTIFY THE PROJECT TEAM OF ANY ERRORS. OMISSIONS, AND INCONSISTENCIES FOUND IN THE CONTRACT DOCUMENTS. THE NOTIFICATION SHALL BE GIVEN BOTH VERBALLY AND IN WRITING WITHIN 24
- IF AN ERROR OR OMISSION IN THE PROJECT DOCUMENTS REQUIRES RECTIFICATION, THE CONTRACTOR SHALL SUBMIT A PROPOSAL TO THE PROJECT TEAM TO RECTIFY THE ISSUE. THE PROPOSAL MUST BE APPROVED PRIOR TO WORK.
- THE CONTRACT DRAWINGS ARE PREPARED TO SCALE WITH THE BEST KNOWLEDGE OF THE SITE GIVEN TO MNS. WHERE DIMENSIONS ARE NOT SHOWN IN THE DRAWINGS, THE CONTRACTOR SHOULD CLARIFY WITH THE PROJECT TEAM WHEN THE INFORMATION IS CRITICAL TO PROPER INSTALLATION.
- THE CONTRACTOR SHALL DOCUMENT ALL CHANGES AND SUBSTITUTIONS ON THE PROJECT OFFICE COPY OF THE CONTRACT DOCUMENTS.
- WHEN FABRICATION OF STRUCTURAL ITEMS ARE REQUIRED, IT MAY BE NECESSARY TO SUBMIT SHOP DRAWINGS FOR REVIEW BY MNS. SEE STRUCTURAL NOTES.
- 8. DEFERRED SUBMITTALS ARE REQUIRED FOR MATERIALS TO BE PROVIDED BY THE CONTRACTOR. WHERE MATERIALS IN THE PLANS ARE DESIGNATED AS PROVIDED BY CONTRACTOR, THE CONTRACTOR SHALL SUBMIT THE PREFERRED MATERIAL TO THE PROJECT TEAM FOR REVIEW AND APPROVAL PRIOR TO

ADMINISTRATIVE REQUIREMENTS:

- ALL ACCESS TO THE SITE, FOR SITE VISITS AND CONSTRUCTION, SHALL BE DURING $7{:}00\!-\!3{:}30$ AND MUST BE COORDINATED WITH THE PROPERTY OWNER.
- AT THE COMPLETION OF THE PROJECT, THE T-MOBILE PROPERTY MANAGER AND THE DISTRICT WILL DO A FINAL WALK THROUGH AND APPROVE ALL WORK PRIOR TO ACCEPTANCE.
- THE PROPERTY OWNER WILL RECEIVE ONSET OF FULL SIZE AND 11X17 ASBUILTS AT THE COMPLETION OF THE PROJECT
- THE CONTRACTOR IS RESPONSIBLE FOR OBTAINING ALL PERMITS REQUIRED (INCLUDING FEES) TO COMPLETE THE WORK DESCRIBED BY THE CONSTRUCTION DOCUMENTS.
- PRIOR TO BIDDING. THE CONTRACTOR IS RESPONSIBLE FOR REVIEW OF THE PROJECT SITE AND CONTRACT DOCUMENTS TO UNDERSTAND THE DESIGN AND CONDITIONS AFFECTING THE WORK TO BE PERFORMED. ANY ERRORS, OMISSIONS, AND DISCREPANCIES MUST BE SUBMITTED TO THE PROJECT TEAM
- THE CONTRACTOR SHALL PROVIDE A WARRANTY FOR WORK FOR A PERIOD OF ONE YEAR. THE CONTRACTOR SHALL BE RESPONSIBLE FOR AND SHALL REMEDY ALL FAULTY, INFERIOR, AND/OR IMPROPER MATERIALS, DAMAGED REMEDIT ALL FAULIT, INTERIOR, AND/OF MINEROPER MATERIALS, DAMAGED GOODS, AND/OR FAULITY WORKMANSHIP. ALL ROOFING AND WATERPROOFING MUST BE WARRANTED FOR A PERIOD OF TWO YEARS. THE PERIOD BEGINS AT SUBSTANTIAL COMPLETION OF THE PROJECT.
- 7. THE CONTRACTOR SHALL PROVIDE A COPY OF LICENSE AND INSURANCE TO THE TELECOMMUNICATIONS CARRIER.

- THE CONTRACTOR SHALL PROVIDE OSHA COMPLIANT PROTECTION FOR THE SAFETY OF THE SITE STAFF AT ALL TIMES DURING THE CONSTRUCTION OF THE PROJECT.
- CONTRACTOR SHALL KEEP GENERAL WORK AREA CLEAN AND HAZARD FREE DURING CONSTRUCTION. SITE SHALL BE LEFT IN CLEAN CONDITION AND FREE FROM DIRT AND DEBRIS. SURFACES SHALL BE CLEANED OF GREASE, PAINT, OR OTHER MATERIALS NOT SPECIFIED IN THE CONSTRUCTION DOCUMENTS.
- THE CONTRACTOR IS TO PROVIDE PROTECTION FOR ADJOINING PROPERTIES FROM PHYSICAL HARM, NOISE, DUST, DIRT, AND FIRE AS REQUIRED BY THE GOVERNING AGENCIES. THE CONTRACTOR IS RESPONSIBLE FOR REPAIR OF ANY
- 4. THE CONTRACTOR IS RESPONSIBLE FOR THE SECURITY OF THE PROJECT SITE
- 5. WHERE WORK REQUIRES OPEN HAZARDS TO SITE STAFF, THE HAZARD SHALL BE TEMPORARILY MITIGATED TO OSHA STANDARD UNTIL THE HAZARD IS CLOSED.
- 6. SEE STRUCTURAL NOTES.

UTILITY REQUIREMENTS:

- 1. THE CONTRACTOR IS RESPONSIBLE FOR COORDINATING WITH UTILITY AGENCIES PRIOR TO WORK WITH UTILITIES.
- 2. CONTRACTOR TO LOCATE ALL UTILITIES PRIOR TO WORK.
- CONTRACTOR TO PROTECT, REPLACE AND/OR REPOUTE ANY EXISTING UTILITIES ENCOUNTERED DURING THE COURSE OF WORK.

SPECIAL CONSIDERATIONS FOR WEATHERPROOFING:

- ALL PENETRATIONS TO EXISTING STRUCTURES MUST BE SEALED WITH APPROVED WEATHERPROOFING. IF WEATHERPROOFING IS OMITTED, CONTACT THE PROJECT TEAM FOR CLARIFICATION OR PROVIDE A WEATHERPROOFING PROPOSAL FOR APPROVAL.
- CONTRACTOR SHALL COORDINATE WITH OWNER AND THE EXISTING ROOFING CONTRACTOR OF RECORD FOR ANY AUGMENTATION TO THE ROOF MEMBRANE, AND HAVING THE WORK GUARANTEED UNDER THE ROOFING CONTRACTOR'S

WORK REQUIREMENTS:

- 1. ALL WORK MUST BE PERFORMED DURING THE OWNERS PREFERRED HOURS.
- 2. THE CONTRACTOR SHALL BE SOLELY RESPONSIBLE FOR ALL CONSTRUCTION MEANS, METHODS, TECHNIQUES, SEQUENCES, AND PROCEDURES FOR COORDINATING ALL PORTIONS OF THE WORK UNDER THE
- 3. ALL WORK PERFORMED ON THE PROJECT SHALL BE IN ACCORDANCE WITH ALL APPLICABLE CODES AND STANDARDS. SEE STRUCTURAL NOTES.
- 4. IF INSPECTION OF WORK IS REQUIRED, THE CONTRACTOR SHALL NOTIFY THE INSPECTION ENTITY 24 HOURS IN ADVANCE OF THE WORK TO BE
- 5. THE CONTRACTOR IS RESPONSIBLE FOR COORDINATING WITH UTILITY AGENCIES PRIOR TO WORK WITH UTILITIES. REFERENCE UTILITIES SECTION.
- 6. THE CONTRACTOR SHALL COORDINATE ON—SITE STORAGE WITH OWNER IN ADVANCE OF WORK. PERMITS MAY BE REQUIRED FOR STORAGE ON PUBLIC RIGHT OF WAY.
- ALL NEW CONSTRUCTION SHALL MATCH EXISTING CONSTRUCTION IN FORM, TEXTURE, FINISH, AND IN MATERIALS EXCEPT AS NOTED IN THE CONSTRUCTION DOCUMENTS.
- 8. THE CONTRACTOR SHALL MAKE EVERY EFFORT TO PROTECT EXISTING WORK FROM DAMAGE DURING THE COURSE OF WORK FOR THIS PROJECT.
- 9. THE CONTRACTOR SHALL PROVIDE WORK WHICH IS LEVEL, PLUMB, AND WITHIN TOLERANCES SPECIFIED BY CODES AND STANDARDS INCLUDED IN THE STRUCTURAL NOTES.
- 10. THE CONTRACTOR SHALL INSTALL ALL EQUIPMENT AND MATERIALS ACCORDING TO MANUFACTURER'S SPECIFICATIONS UNLESS NOTED OTHERWISE OR WHERE LOCAL CODES OR ORDINANCES TAKE PRECEDENCE.
- 11. ANY SUBSTITUTIONS OF MATERIALS MUST BE APPROVED BY THE PROJECT TEAM IN WRITING.
- 12. THE CONTRACTOR SHALL SUPPLY ALL MATERIALS INCIDENTAL TO THE WORK DESCRIBED BY THE CONTRACT DOCUMENTS.
- TO IT'S PRE-WORK CONDITION. WHERE THE WORK PERFORMED DOES NOT ALLOW FOR PRE-WORK RESTORATION, WORK AREAS MUST BE REPAIRED OR REPLACED TO MATCH EXISTING FINISH AND SITE GRADING
- 14. THE CONTRACTOR IS RESPONSIBLE FOR ALL DISPOSAL OF DEBRIS AND ITEMS WHICH ARE SPECIFIED TO BE REMOVED IN THE COURSE OF WORK.


EXISTING STRUCTURES:

THE EXISTING FRAMING IS REPRODUCED FROM THE LATEST INFORMATION PROVIDED. SOME FRAMING AND MATERIALS ENCOUNTERED AT THE TIME OF CONSTRUCTION MAY VARY FROM THAT SHOWN IN THE PLANS. IF THE PLAN CONDITION VARIES FROM THE AS-BUILT CONDITION, THE CONTRACTOR SHOULD CONSULT THE PROJECT TEAM FOR A REVISED DETAIL OR DIRECTION TO PROCEED.

ABBREVIATIONS: AIR CONDITIONING ABOVE GROUND LEVEL ABOVE MEAN SEA LEVEL AMERICAN WIRE GAGE BARE COPPER WIRE BUILDING BLOCKING CLEAR COAXIAL CABLE CONCCONCRETE CONSTRUCTION CONTINUOUS DIAMETER DRAWING ELEVATION ELECTRICAL EQUAL EQUIPMENT EXTERIOR FINISH FLUORESCENT FIN FLUOR FLR FT FRP GA GALV FIBER-REINFORCED POLYMER GAUGE GALVANIZED GENERAL CONTRACTOR
GLOBAL POSITIONING SYSTEM GC GPS GRND HORZ GROUND HORIZONTAL HEIGHT HEATING VENTILATION AIR CONDITIONING INSIDE DIAMETER IN INCH
INFORMATI
INSUL INFORMATI
INSULATION
INT INTERIOR
IBC INTERNATION
IBS POUNDS
LMU LOCATION ME
LTE LONG TERM L
MAXIMUM
MECHMECHANICAL
METAL
METAL
METAL
METAL
METAL
METAL
METAL
MIN MINIMUM
ISC MISCELLANEOUS
IN OT APPLICABLE
IN OT IN CONTRACT
NOT TO SCALE
ON CENTER
OUTSIDE DIAMETER
D LYWOOD
PROJECT
PROPERTY
PRESSURE TREATED
REQUIRED
ROOM
ROOM INCH INFORMATION INSULATION INTERIOR INTERNATIONAL BUILDING CODE RADIO FREQUENCY RADIO FREQUENCY
ROOM
ROUGH OPENING
REMOTE RADIO UNIT
SHEET
SIMILAR
SPECIFICATION
SQUARE FOOT
STAINLESS STEEL
STEFL STEEL STRUCTURAL SUSPENDED TOWER MOUNTED AMPLIFIER UNLESS NOTED OTHERWISE VERTICAL VERIFY IN FIELD WATER PROOF

PRCTI20250265 T··Mobile City of Puyallup **Development & Permitting Services ISSUED PERMIT** Building Planning Engineering Public Works Traffic **⊹MasTec Network Solutions** 125 KLUG CIRCLE CORONA, CALIFORNIA 92880

T-MO	BILE SITE #:	SE05408A			
DRAV	VN BY:	JPG			
JOB #	#:	55807			
A	02/06/25	100% FINAL CD'S			
REV	DATE	DESCRIPTION			

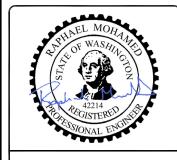

IT IS A VIOLATION OF LAW FOR ANY PERSON, UNLESS THEY ARE ACTING UNDER THE DIRECTION OF A LICENSED PROFESSIONAL ENGINEER, TO ALTER THIS DOCUMENT.

T-MOBILE SITE NUMBER

SE05408A

T-MOBILE SITE NAME

SOUTH HILL RELO


3150 S MERIDIAN PUYALLUP, WASHINGTON 98373


SHEET TITLE

GENERAL NOTES

SHEET NUMBER

GN-1

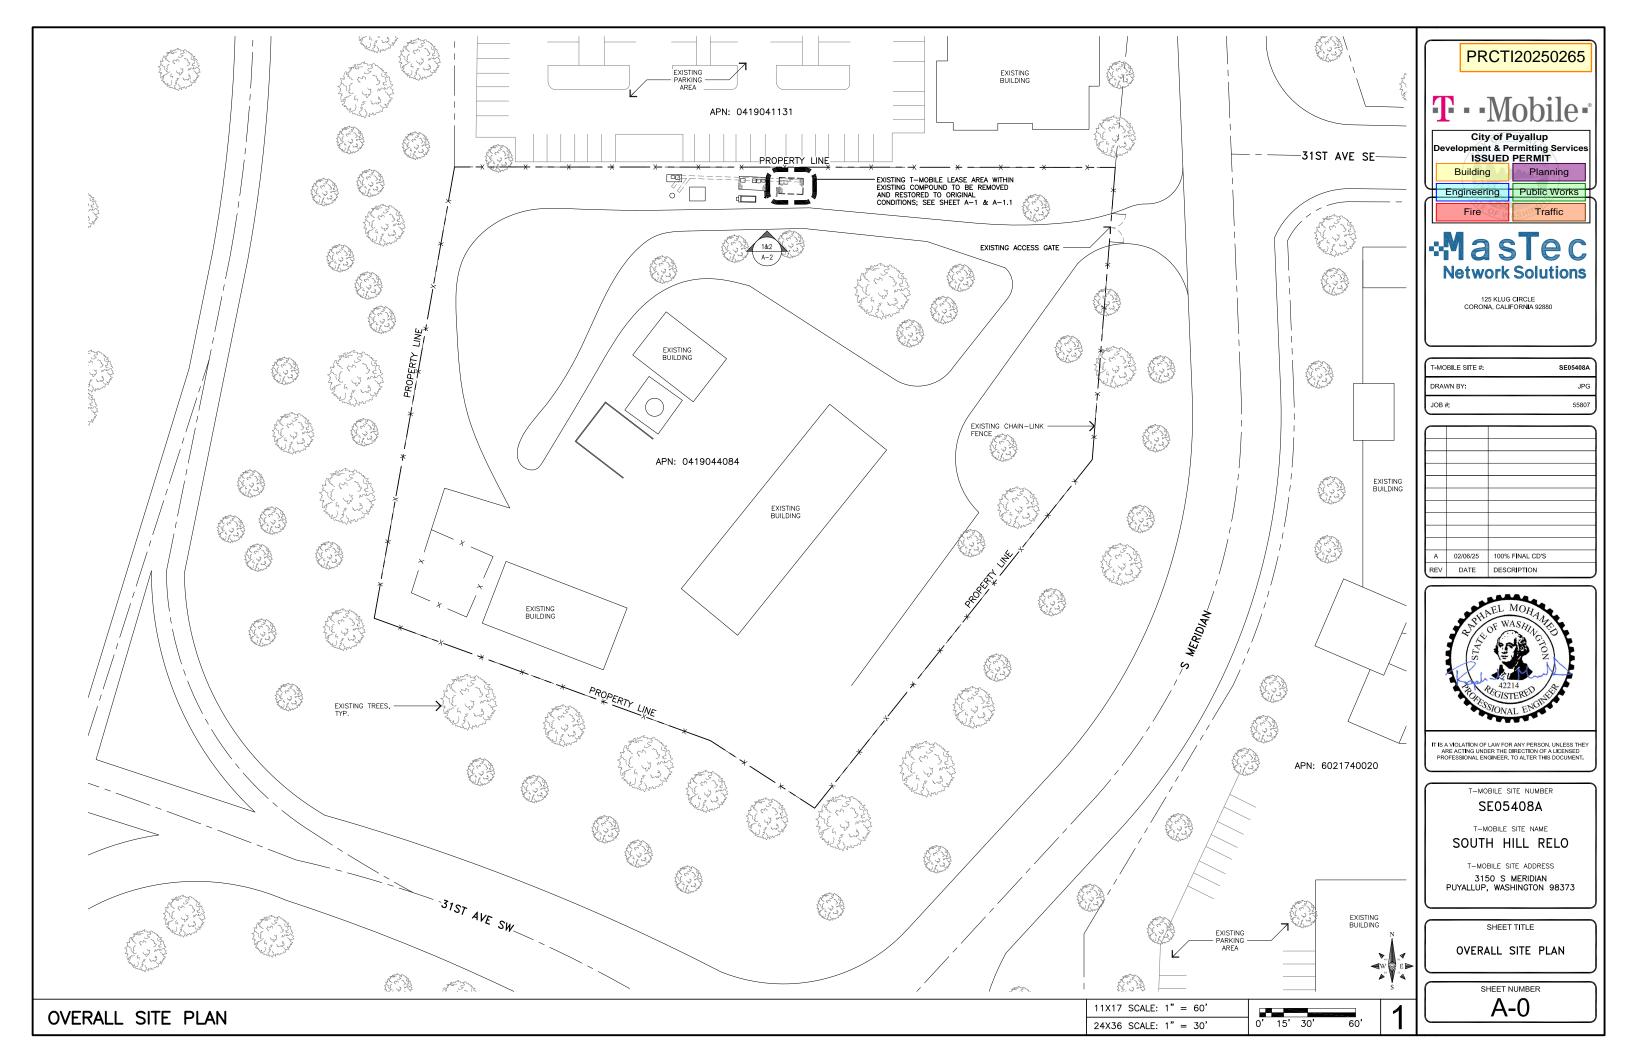

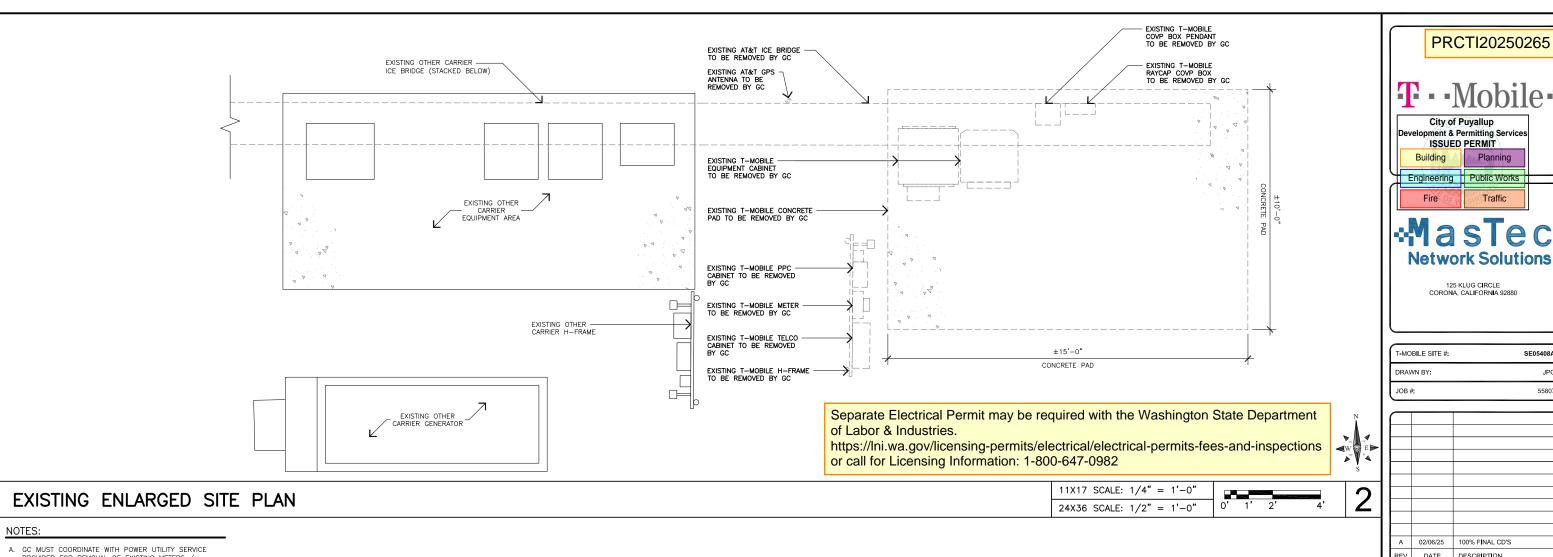



PROVIDER FOR REMOVAL OF EXISTING METERS / POWER DISCONNECT. PRIOR TO ANY WORK

B. GC MUST CONFIRM IF POWER UTILITY SERVICE PROVIDER REQUIRES INSPECTIONS FOR PROPOSED DCX SOW, PRIOR TO START OF ANY WORK.

C. GC IS RESPONSIBLE FOR COSTS & COORDINATION OF ANY ACCESS, CRANE SERVICE AND PICKING / RIGGING PLAN, LOGISTIC HAULING, EQUIP. RENTAL / DELIVERY AND DISPOSAL FEE'S. (IF APPLICABLE).

- D. GC TO REMOVE EXISTING (1) 15.0' X 10.0' = 150 SQFT CONCRETE PAD AND FOUNDATION ITEMS 2' BELOW GRADE.
- E. GC TO FOAM—FILL ENDS OF EXISTING U.G. POWER CONDUIT LINES AND RESTORE SOIL TO ORIGINAL GRADE LEVEL. AFTER POWER UTILITY SERVICE PROVIDER REMOVES / TERMINATES EXISTING POWER LINES.
- F. GC TO HAUL OFF ALL COAX, DEBRIS AND ASSOCIATED CELLULAR SITE ITEMS.

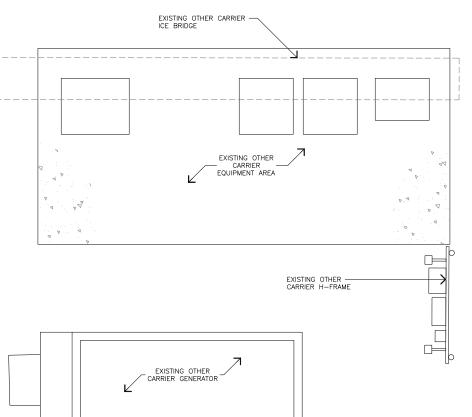

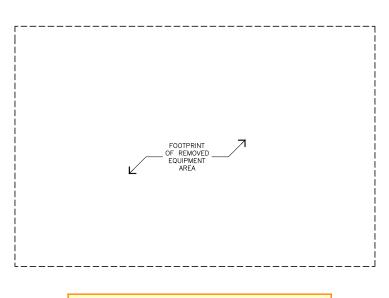

Ensure site is clear of all hazards and debris prior to scheduling Final inspection.




11X17 SCALE: 1/4" = 1'-0"24X36 SCALE: 1/2" = 1'-0"

PRCTI20250265 City of Puyallup ISSUED PERMIT Building Engineering Public Works Traffic Fire

T-MOBILE SITE #:	SE05408A
DRAWN BY:	JPG
JOB#:	55807

125 KLUG CIRCLE CORONA, CALIFORNIA 92880

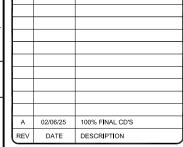



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T-MOBILE SITE NUMBER

SE05408A

T-MOBILE SITE NAME SOUTH HILL RELO


3150 S MERIDIAN PUYALLUP, WASHINGTON 98373

SHEET TITLE

EXISTING AND FINAL **ENLARGED SITE PLAN**

SHEET NUMBER

FINAL ENLARGED SITE PLAN

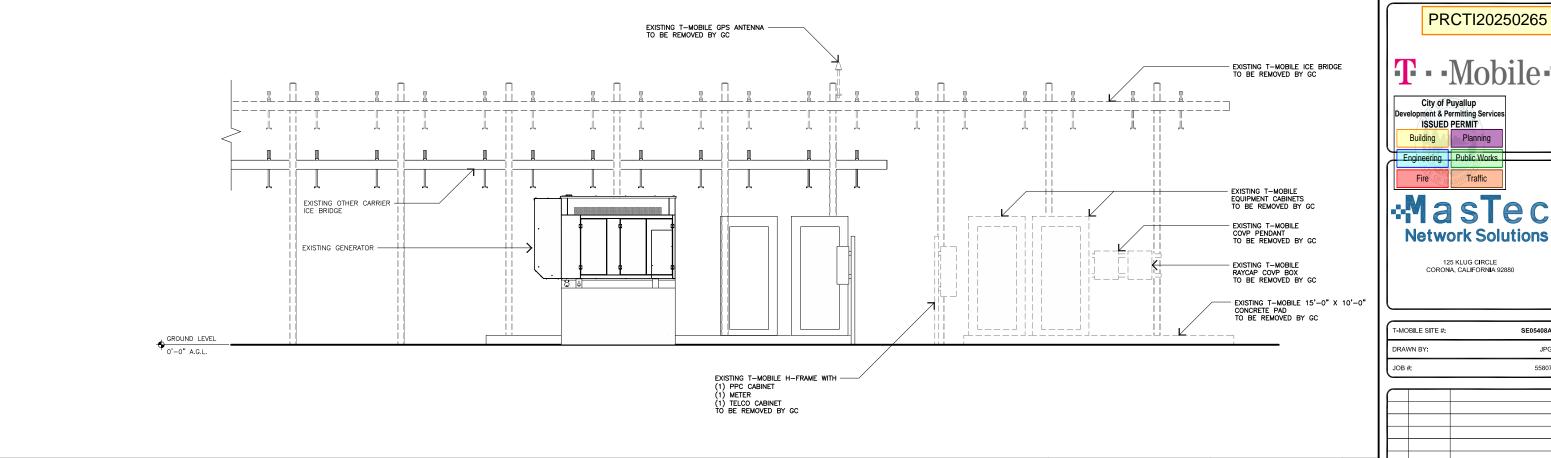


EXISTING SOUTH ELEVATION

A. GC MUST COORDINATE WITH POWER UTILITY SERVICE PROVIDER FOR REMOVAL OF EXISTING METERS / POWER DISCONNECT, PRIOR TO ANY WORK PERFORMED.

B. GC MUST CONFIRM IF POWER UTILITY SERVICE PROVIDER REQUIRES INSPECTIONS FOR PROPOSED DCX SOW, PRIOR TO START OF ANY WORK.

NOTES:

11X17 SCALE: 3/16" = 1'-0" 24X36 SCALE: 3/8" = 1'-0"

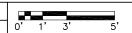

100% FINAL CD'S DATE DESCRIPTION

PRCTI20250265

City of Puyallup oment & Permitting Service ISSUED PERMIT

Planning

Traffic

125 KLUG CIRCLE CORONA, CALIFORNIA 92880

SE05408A

JPG

55807



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T-MOBILE SITE NUMBER

SE05408A

T-MOBILE SITE NAME

SOUTH HILL RELO


3150 S MERIDIAN

PUYALLUP, WASHINGTON 98373 SHEET TITLE

SOUTH ELEVATION

SHEET NUMBER

A-2

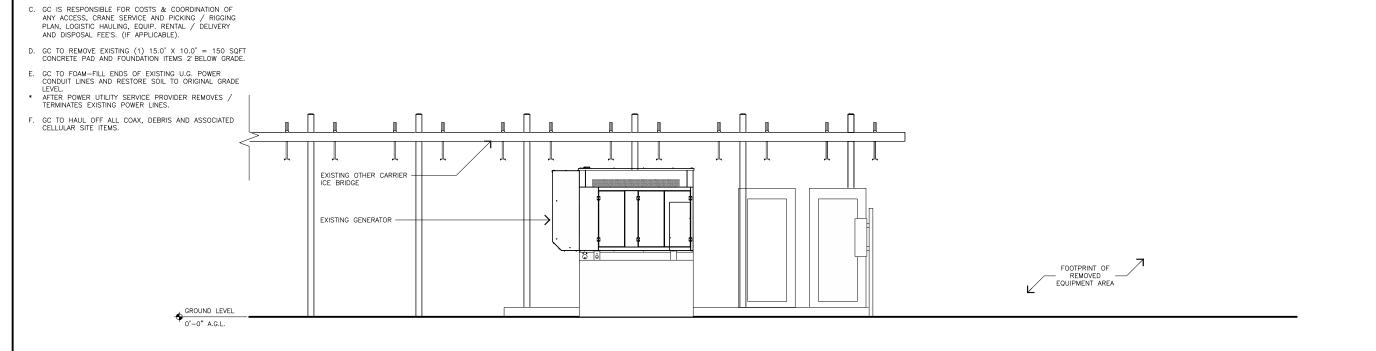

FINAL SOUTH ELEVATION

11X17 SCALE: 3/16" = 1'-0" 24X36 SCALE: 3/8" = 1'-0"