

Separate Electrical Permit is required with the Washington State Department of Labor & Industries. https://lni.wa.gov/licensing-permits/electrical/ electrical-permits-fees-and-inspections or call for Licensing Information:


1-800-647-0982

Approval of submitted plans is not an approval of omissions or oversights by this office or non compliance with any applicable regulations of local government. The contractor is responsible for making sure that the building complies with all applicable codes and regulations of the local government.

The approved construction plans, documents, and all engineering must be posted on the job at all inspections in a visible and readily accessible location.

Full sized legible color plans are required to be provided by the permitee on site for inspection.

City of Puyallup

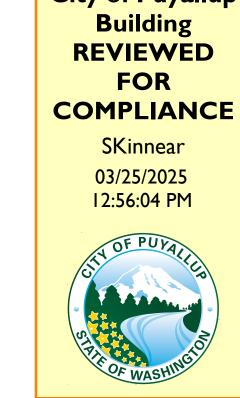

PRCTI20241902 COPYRIGHT NOTICE: RD

T Mobile[®]

12920 SE 38TH STREET BELLEVUE, WA 98006 www.T-Mobile.com

PROJECT TYPE:
CORPORATE NEW 8022

PROTOTYPE RELEASE:

WILLIAM LOUIS PALUCH STATE OF WASHINGTON

03/12/2025

FUZION

SUITE 200 SCOTTSDALE, AZ 85255

www.fuzionad.com

DESCRIPTION: PORTAL/ BAFFLE ASI 02.07.2025 PRE-CONSTRUCTION 02.12.2025 COORDINATION 03.12.2025 RTU RELOCATION

11/13/2024 DRAWN BY:

COVER SHEET

SOUTH MERIDIAN & 43RD AVE SE

4227 S MERIDIAN SUITE E PUYALLUP, WA 98373

ADDENDUM - REVISION #3 ISSUE DATE: REVISED DRAWINGS ARE PER FIELD COORDINATION REGARDING SITE CONDITIONS THAT REQUIRED THE (2) RTU'S TO RELOCATE. SHEETS AFFECTED: G000, AD131, A131, M101, M102, E101, E301,S102, S201. THESE SUPPLEMENTAL INSTRUCTIONS MODIFY THE CONTRACT DOCUMENTS AND SHALL BE CARRIED OUT IN ACCORDANCE WITH THE CONTRACT WITHOUT CHANGE IN THE GMP OR CONTRACT TIME. PROCEEDING WITH THE WORK DESCRIBED BY THESE INSTRUCTIONS INDICATES THE ADDENDUM - REVISION #2 DESCRIPTION: REVISED DRAWINGS ARE PER PRE-CONSTRUCTION COORDINATION. SHEETS AFFECTED: G000, AD131, A131, A141, A201, A401A, A401B. THESE SUPPLEMENTAL INSTRUCTIONS MODIFY THE CONTRACT DOCUMENTS AND SHALL BE CARRIED OUT IN ACCORDANCE WITH THE CONTRACT WITHOUT CHANGE IN THE GMP OR CONTRACT TIME. PROCEEDING WITH THE WORK DESCRIBED BY THESE INSTRUCTIONS INDICATES THE CONTRACTOR'S ACCEPTANCE THAT THERE WILL BE NO CHANGE IN THE CMP OR CONTRACT TIME. **ADDENDUM - REVISION #1** ISSUE DATE: 02.07.2025 DESCRIPTION: REVISED DRAWINGS ARE OWNER REVISIONS. SHEETS AFFECTED: G000, A121, A520

THESE SUPPLEMENTAL INSTRUCTIONS MODIFY THE CONTRACT DOCUMENTS AND SHALL BE CARRIED OUT IN ACCORDANCE WITH THE CONTRACT WITHOUT CHANGE IN THE GMP OR CONTRACT TIME. PROCEEDING WITH THE WORK DESCRIBED BY THESE INSTRUCTIONS INDICATES THE CONTRACTOR'S ACCEPTANCE THAT THERE WILL BE NO CHANGE IN THE CMP OR CONTRACT TIME.

SCOPE OF WORK - ALTERATION LEVEL 1

NO CHANGES PROPOSED FOR BUILDING TYPE OR OCCUPANCY

- FIXTURE, FURNITURE, EQUIPMENT AND GRAPHICS INTERIOR PARTITIONS AND DOORS
- FINISHES IN ALL AREAS
- CEILING IN ALL AREAS
- LIGHTING IN ALL AREAS
- PLUMBING FIXTURES
- ELECTRICAL SYSTEM
- MECHANICAL SYSTEM • FIRE SAFETY EQUIPMENT
- EGRESS




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ARRANGEMENT AND COMPOSITION OF SPACES AND ELEMENTS OF THE DESIGN. UNDER SUCH
PROTECTION, UNAUTHORIZED USE OF THESE DRAWINGS AND SPECIFICATIONS MAY RESULT I
CESSATION OF CONSTRUCTION, BUILDING SEIZURE, AND/OR MONETARY LIABILITY.

PROJECT TYPE:
CORPORATE NEW

8022

PROTOTYPE RELEASE:

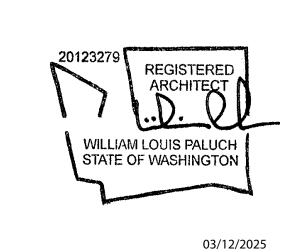

FUZION

SUITE 200 SCOTTSDALE, AZ 85255

design@fuzionad.com (480) 463-4764 www.fuzionad.com

<u>#</u>	DESCRIPTION:	DATE
2	PRE-CONSTRUCTION	02.12.2025
	COORDINATION	
		-


DRAWN BY:

DATE:

SAW-CUTTING DEMOLITION PLAN

11/13/2024

AD131

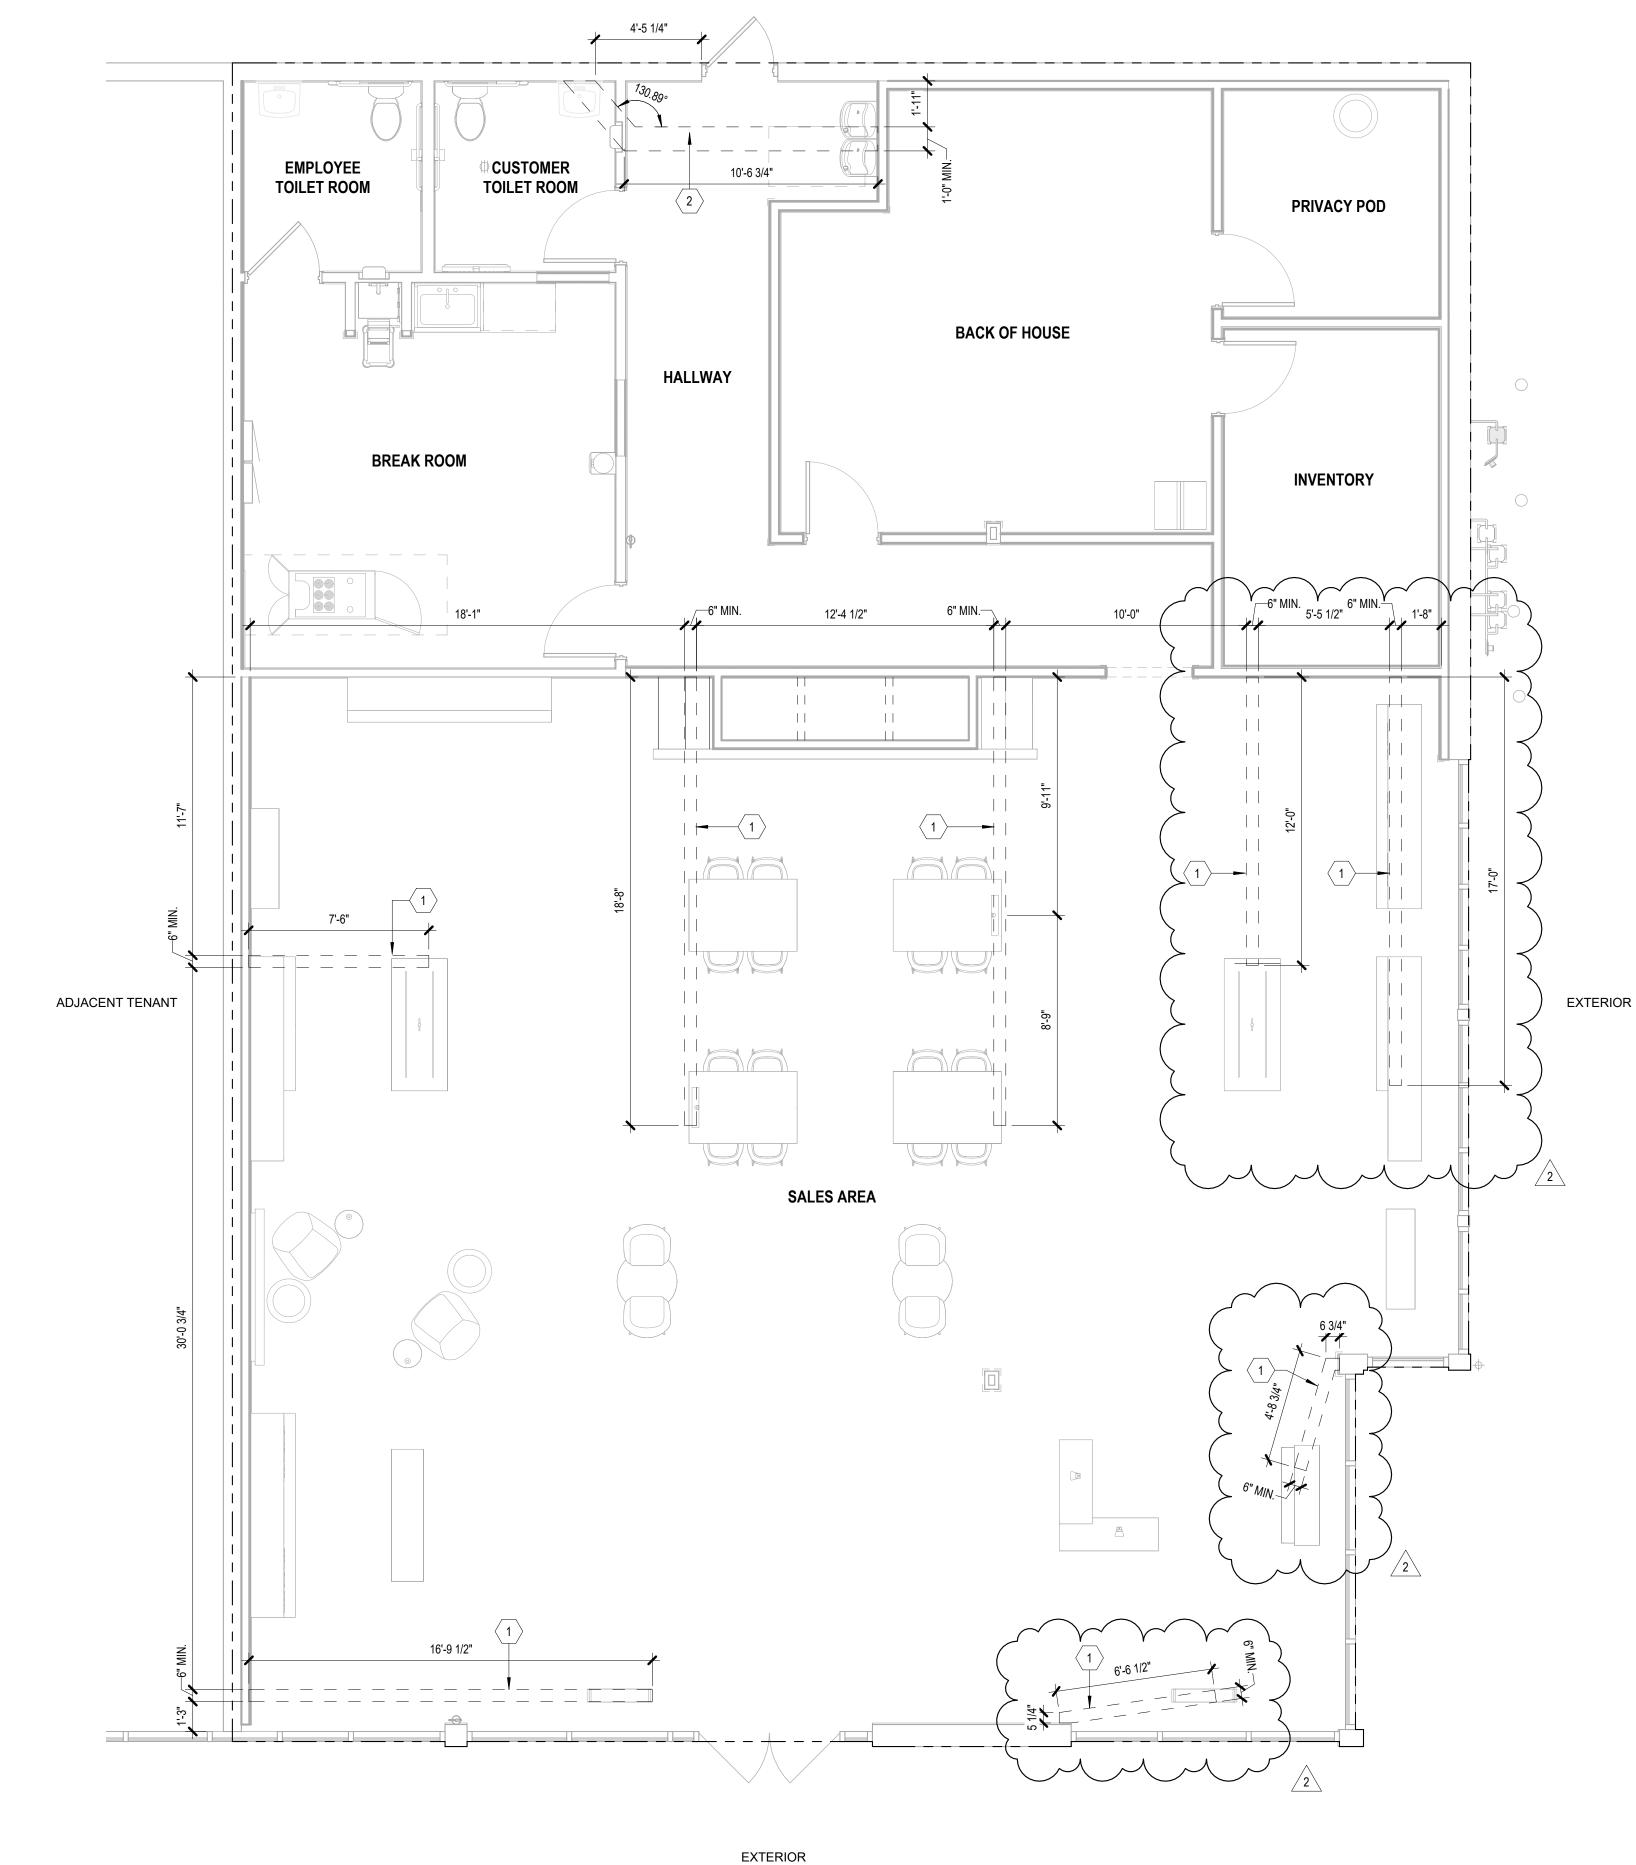

SAW-CUTTING DEMOLITION PLAN 1/4" = 1'-0"

KEY NOTES

SLAB PENETRATIONS SHALL BE MADE WITH PROPER LOCATION AND X-RAY IDENTIFICATION OF EXISTING REBAR AND / OR POST TENSION CABLES.

DIMENSIONS TO GIVE LOCATION OF TRENCH/CORE DRILL. SEE SHEET A501 FOR ADDITIONAL TRENCH/SLAB INFORMATION. SEE SHEET E101 FOR CONDUIT DETAILS AND LOCATION. SAW CUT EXISTING CONCRETE SLAB FOR NEW SUPPLY/WASTE TO DRINKING FOUNTAIN. GC SHALL XRAY SLAB TO LOCATE ANY REBAR AND SHALL OBTAIN LANDLORD APPROVAL PRIOR TO COMMENCING ANY WORK. ALL ROUGH-INS TO BE DETERMINED IN FIELD WITH PLUMBING SUB-CONTRACTOR USING EXACT PLUMBING FIXTURE SPECIFICATIONS. REPAIR CONCRETE SLAB AS REQUIRED, SEE DETAIL A2/A501 AND PLUMBING SHEETS FOR MORE INFORMATION.

GENERAL NOTES

- CHECK MECHANICAL AND ELECTRICAL DRAWINGS PRIOR TO DEMOLITION WITH REGARD TO UTILIZING ANY EXISTING WIRING, LINES, COMPONENTS, ETC.
- NOTIFY ARCHITECTS IMMEDIATELY OF ANY DISCREPANCIES OR UNFORESEEN ITEMS NOT SHOWN ON THE DRAWINGS.
- ALL REMOVED MATERIAL AND DEBRIS, NOT OTHERWISE DESIGNATED, BECOMES THE PROPERTY OF THE CONTRACTOR, WHO SHALL REMOVE IT FROM THE SITE.
- SAW-CUTTING SHOWN ON PLANS IS AN INDICATION OF THE INTENDED WORK FOR BIDDING AND COORDINATION PURPOSES ONLY. IT IS NOT INTENDED TO BE FOR SPECIFICATION OR METHOD.

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PRCTI20241902

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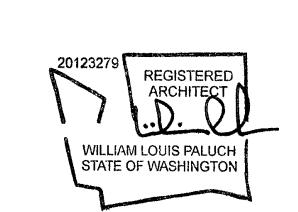
AMERINED JANUARY 2003. HE PROTECTION HOLDERS, WITHOUT LIMIT AND COMPOSITION OF SPACES AND ELEMENTS OF THE DESIGN. UNDEPROTECTION, UNAUTHORIZED USE OF THESE DRAWINGS AND SPECIFICATIONS MAY RECESSATION OF CONSTRUCTION, BUILDING SEIZURE, AND/OR MONETARY LIABILITY.

AVE SE
4227 S MERIDIAN
SUITE E
PUYALLUP, WA 98373

8022


PROJECT TYPE:
CORPORATE NEW CD

PROTOTYPE RELEASE:



03/12/2025




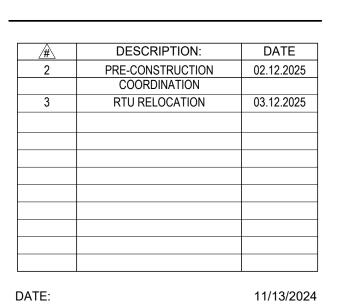


DRAWN BY:

REFLECTED CEILING PLAN

A131

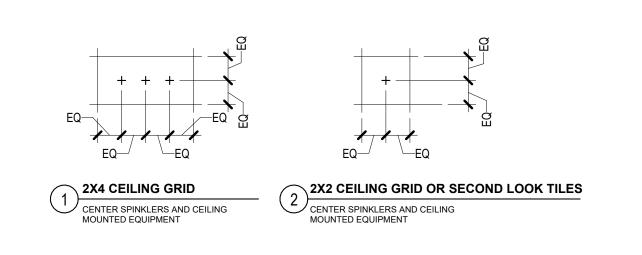



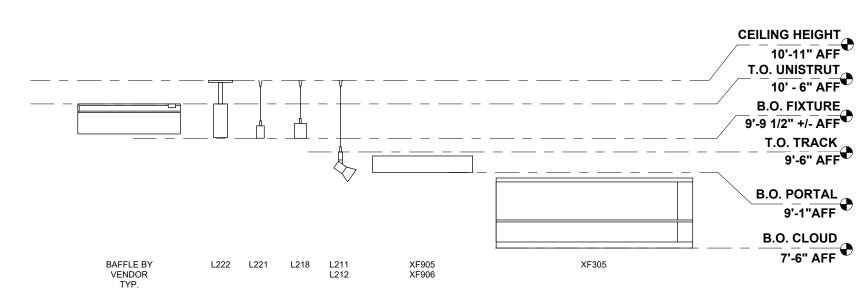

B4 TYPICAL CEILING ELEMENT HEIGHTS


GENERAL NOTES


- . G.C. TO VERIFY ALL DIMENSIONS AND NOTIFY ARCHITECTS IMMEDIATELY OF ANY DISCREPANCIES OR UNFORESEEN ITEMS NOT SHOWN ON DRAWINGS, INCLUDING CEILING HEIGHT.
- 2. UNLESS OTHERWISE NOTED ON PLANS, ALL CEILING EQUIPMENT SHOULD FOLLOW THE LAYOUT GUIDE ON THIS SHEET.
- 3. G.C. SHALL FIELD VERIFY EXISTING EGRESS LIGHTING AND PROVIDE EMERGENCY LIGHT FIXTURES AS REQUIRED BY THE FIRE MARSHALL.
- 4. REFER TO MECHANICAL DRAWINGS FOR FURTHER INFORMATION ON SCOPE AND LOCATION OF MECHANICAL ITEMS.
- 5. REFER TO VENDOR INSTALLATION GUIDE AND MANUFACTURER INSTRUCTIONS FOR FIXTURE
- 6. REFER TO ELECTRICAL DRAWINGS FOR FIXTURE TYPES AND LIGHT FIXTURE SCHEDULE.

MANUFACTURER'S RECOMMENDATIONS, SEE A600 SERIES SHEETS FOR ALL SCHEDULES.

INSTALLATION.

	FINISH SUMMARY
SYMBOL	DESCRIPTION
C1##	CEILING - LAY IN TILE
GYP	GYP BOARD CEILING, SEE DETAILS ON SHEET A541
P1##	PAINT

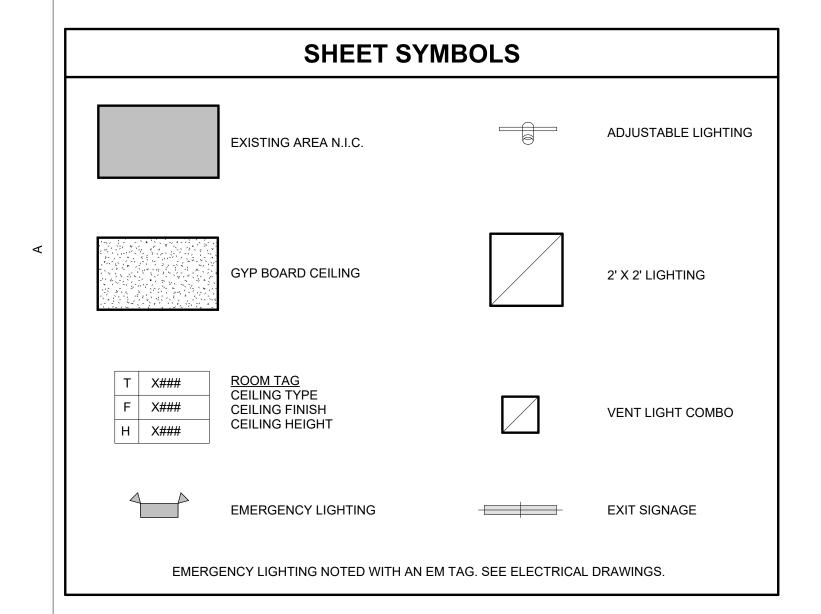

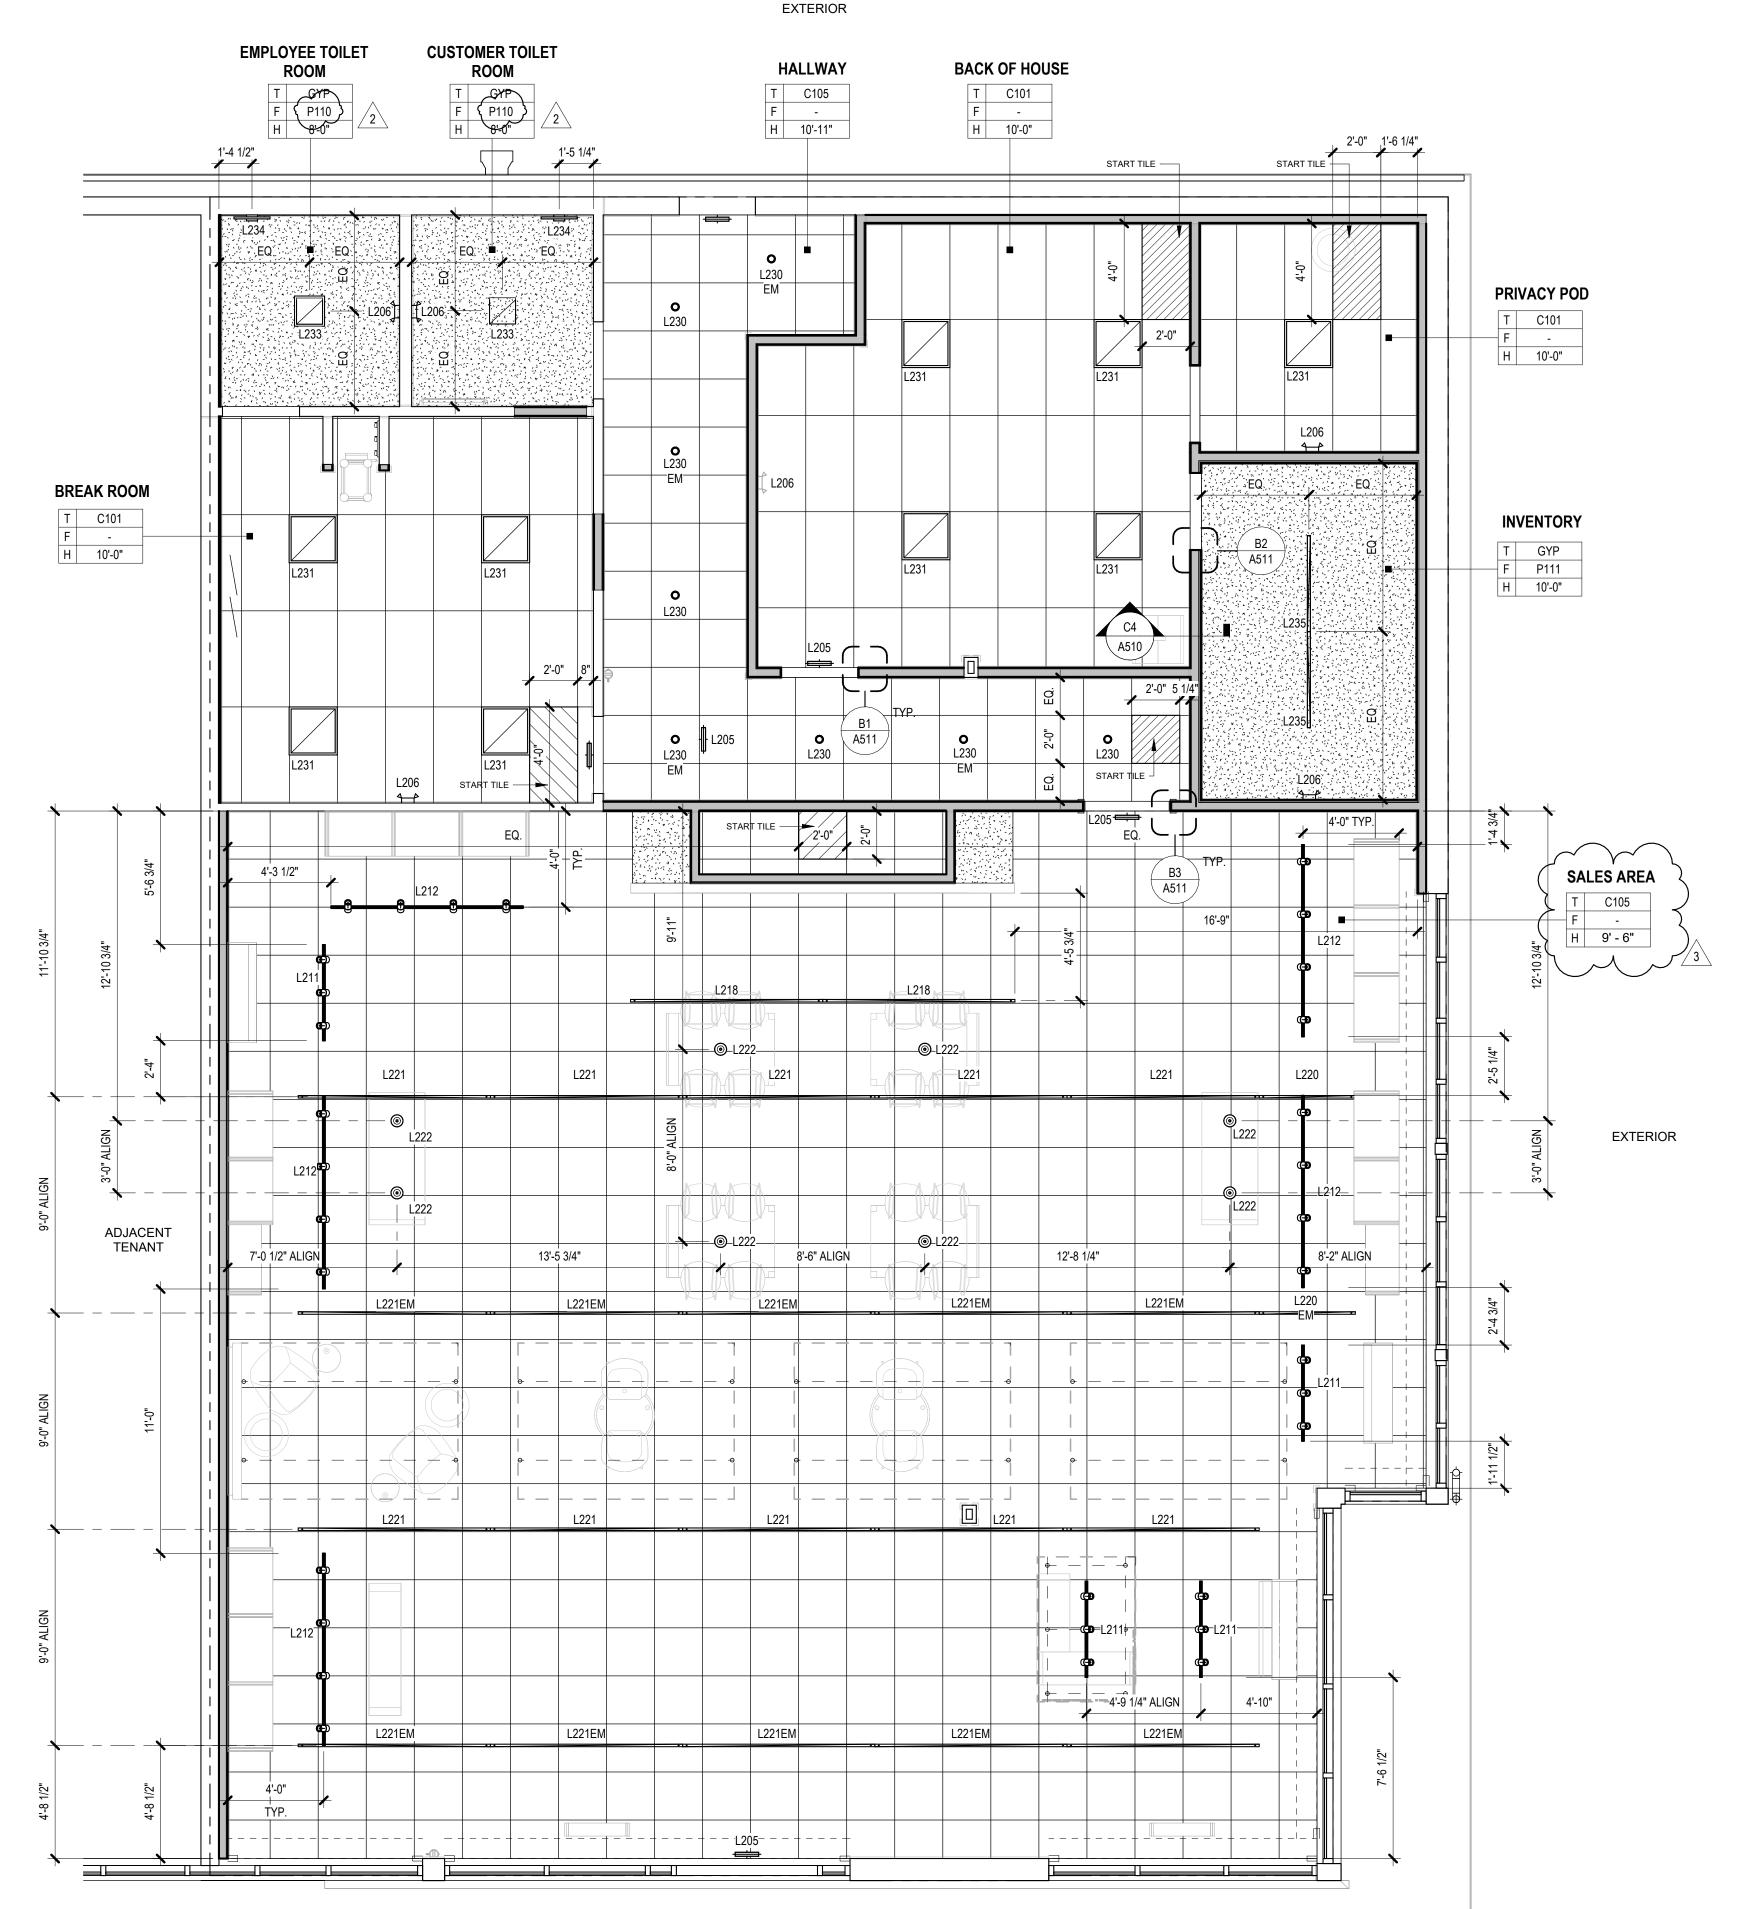

EXTERIOR

REFLECTED CEILING PLAN


1/4" = 1'-0"

FIELD VERIFY ALL CONDITIONS

DESIGN DRAWINGS ARE DIAGRAMMATIC. CONTRACTOR SHALL VISIT THE SITE PRIOR TO BIDDING OR AWARD OF CONTRACT TO INSPECT EXISTING FIELD CONDITIONS. CONTRACT SHALL INCLUDE ALL LABOR AND MATERIALS NECESSARY FOR FIELD MODIFICATIONS DUE TO EXISTING CONDITIONS. WHERE EXISTING CONDITIONS EXIST THAT PREVENT COMPLETION OF WORK, CONTRACTOR SHALL NOTIFY ENGINEER OF RECORD.

THE CONTRACTOR SHALL CONTACT THE ARCHITECT, ENGINEER OR OWNER PRIOR TO BIDDING FOR INTERPRETATIONS AND CLARIFICATIONS OF THE DESIGN AND INCLUDE IN HIS BID ALL COSTS TO MEET THE DESIGN INTENT. CLARIFICATIONS MADE BY THE ARCHITECT. ENGINEER OR OWNER AFTER BIDDING WILL BE FINAL AND SHALL BE IMPLEMENTED AT CONTRACTOR'S COST.

BIDDING CONTRACTORS SHALL HAVE A WORKING KNOWLEDGE OF LOCAL CODES AND ORDINANCES AND SHALL INCLUDE IN THEIR BIDS THE COSTS FOR ALL WORK INSTALLED IN STRICT ACCORDANCE WITH GOVERNING CODES. THE PLANS AND SPECIFICATIONS NOT WITHSTANDING, THE CONTRACTOR SHALL ALERT ARCHITECT, ENGINEER OR OWNER OF ANY APPARENT DISCREPANCIES BETWEEN GOVERNING CODES AND DESIGN INTENT.

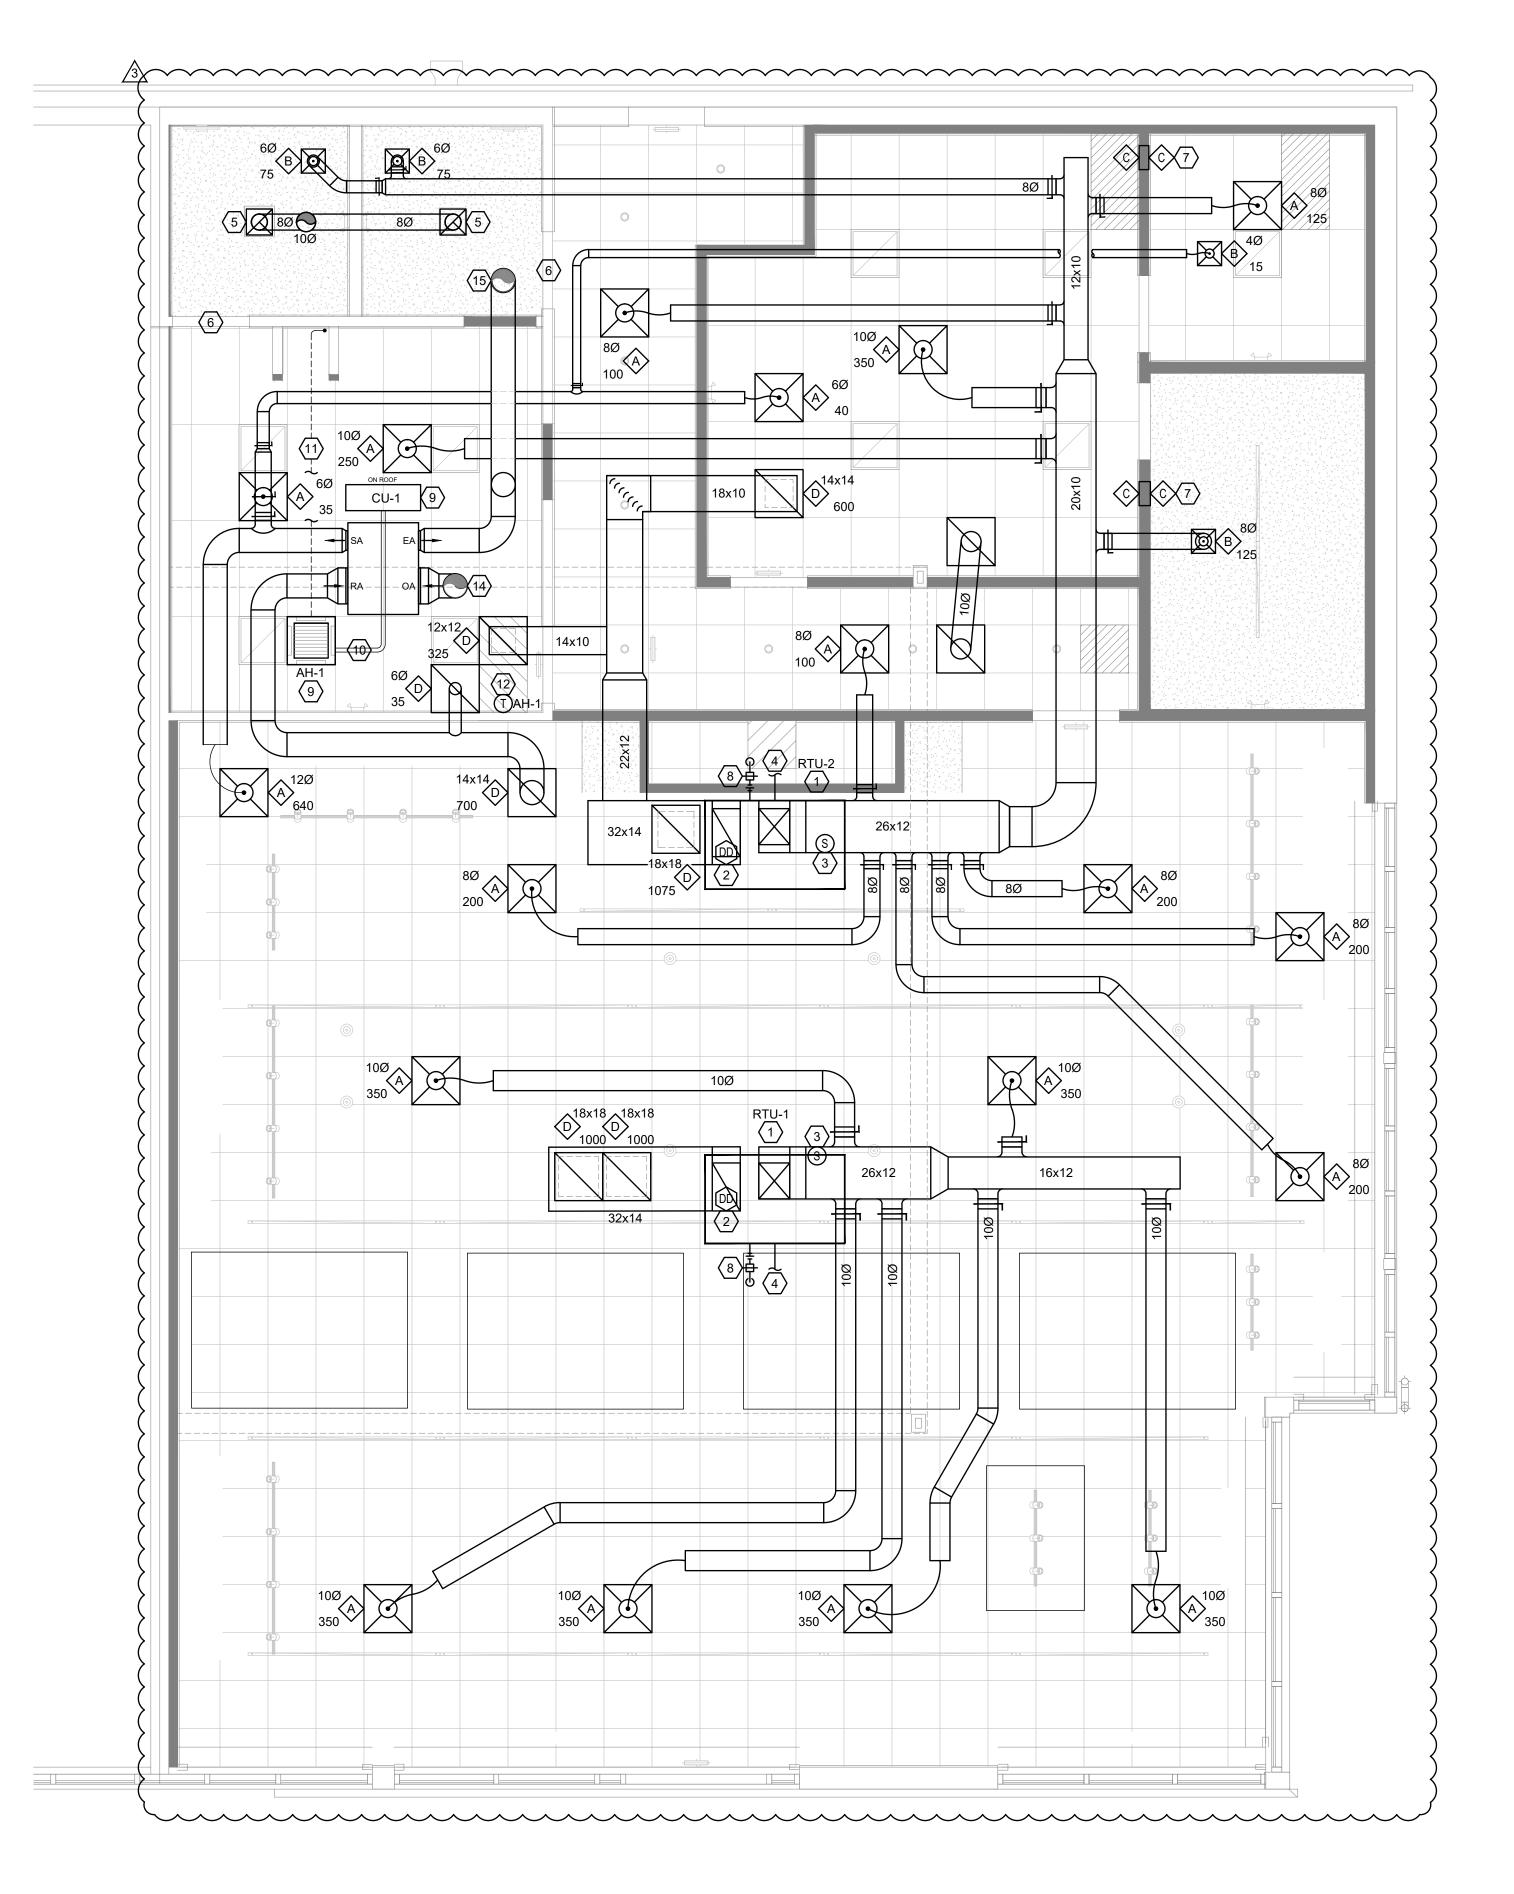





NOTES

- NEW ROOFTOP UNIT. CONNECT NEW DUCTWORK TO SUPPLY AND RETURN DROPS DOWN THRU ROOF. VERIFY EXACT LOCATION IN FIELD.
- PROVIDE NEW DUCT MOUNTED SMOKE DETECTOR WITH REMOTE TEST STATION IN THE RETURN DUCT UPSTREAM OF ANY FILTERS. DETECTOR SHALL SHUT DOWN UNIT UPON DETECTION OF SMOKE. INSTALL REMOTE TEST STATION IN CEILING GRID BENEATH UNIT.
- INSTALL OWNER SUPPLIED ENTOUCH.one MASTER CONTROLLER THERMOSTAT, ZONE TEMPERATURE SENSOR AND DUCT TEMPERATURE SENSOR. MOUNT THERMOSTAT AT 48" A.F.F.. PROVIDE AND PULL CAT5 CABLE FROM ET1 THERMOSTAT TO OPEN PORT ON CUSTOMER NETWORK SWITCH. MOUNT ZONE TEMPERATURE SENSOR AT 60" A.F.F. AND WIRE TO THE S2 & S2 RTN. MOUNT DUCT TEMPERATURE SENSOR IN THE MAIN SUPPLY DUCT WITHIN 6 FEET FROM
- PROVIDE CONDENSATE PER CODE. EXTEND TO LANDLORD APPROVED RECEPTOR AS REQUIRED. VERIFY POSSIBLE REUSE OF EXISTING CONDENSATE

UNIT AND WIRE TO S2 & S2 RTN. CABLE RUNS AND TERMINATIONS BY MC/GC

- NEW CEILING EXHAUST FAN/LIGHT COMBO PROVIDED WITH THE LIGHTING PACKAGE. ROUTE EXHAUST DUCT UP THROUGH ROOF. MAINTAIN 10'-0" FROM ANY FRESH AIR INTAKE. PROVIDE GOOSENECK FITTING WITH INSECT SCREEN AT DISCHARGE. PROVIDE INSULATED DUCT CURB AT ROOF PENETRATION. SEE
- UNDERCUT DOOR A MINIMUM OF 1" (MAXIMUM 1-1/4".)
- PROVIDE NEW TRANSFER GRILLE THRU INVENTORY/TELCO ROOM WALL. INSTALL TOP OF GRILLE 6" BELOW FINISHED CEILING. PROVIDE MESH SCREENING OVER OPENING IN WALL. SEE SCHEDULE FOR SIZE.
- PROVIDE GAS LINES PER CODE. CONNECT TO EXISTING METER & COORDINATE WITH UTILITY. VERIFY POSSIBLE REUSE OF EXISTING GAS LINE.
- PROVIDE AND INSTALL NEW DUCTLESS SPLIT SYSTEM UNITS PER SCHEDULE. CU LOCATED ON ROOF. G.C. TO COORDINATE WITH LANDLORD AS REQUIRED FOR ALL LANDLORD ROOF WORK RULES AND REGULATIONS.
- PROVIDE AND INSTALL CONDENSER LINES AND OIL RETURN LOOP.
- PROVIDE AND INSTALL CONDENSATE LINES PER LOCAL CODE REQUIREMENTS. ROUTE LINE TO TERMINATE AT UTILITY SINK.

INSTALL OWNER SUPPLIED ENTOUCH.ONE MASTER CONTROLLER THERMOSTAT, AND DUCT TEMPERATURE SENSOR. MOUNT THERMOSTAT AT 48" A.F.F.. PROVIDE AND PULL CATS CABLE FROM ET1 THERMOSTAT TO OPEN PORT ON CUSTOMER NETWORK SWITCH. MOUNT ZONE TEMPERATURE SENSOR AT 60" A.F.F. AND WIRE TO THE S2 & S2 RTN. MOUNT DUCT TEMPERATURE SENSOR IN THE MAIN SUPPLY DUCT WITHIN 6 FEET FROM UNIT AND WIRE TO S2 & S2 RTN. CABLE RUNS AND TERMINATIONS BY MC/GC (CABLE PULL). PROVIDE MITSUBISHI PAC-US444CN-1 THERMOSTAT INTERFACE FOR CN105-IT TERMINAL CONNECTION TO ENTOUCH

PROVIDE ERV UNIT FOR COMPLIANCE WITH DOAS SECTION C403.6.

CONTROLS.

OUTSIDE AIR INTAKE DUCT FROM ROOF. PROVIDE GREENHECK GRSI FITTING WITH BIRD SCREEN AT INTAKE. PROVIDE INSULATED CURB AT ROOF PENETRATION. PROVIDE MOTORIZED BACKDRAFT DAMPER AND INTERLOCK DAMPER WITH UNIT TO SHUT DOWN BELOW 38 DEGREES F. PROVIDE 15 FOOT FREEZE PROBE IN OUTSIDE AIR DUCT TO BE CONNECTED TO UNIT CONTROLS. COORDINATE EXACT ROUTING & INTAKE LOCATION WITH LANDLORD PRIOR TO BID. MIN 10'-0" FROM ANY EXHAUST VENT.

EXHAUST AIR RELIEF DUCT TO ROOF. PROVIDE GREENHECK GRSI FITTING WITH BIRD SCREEN AT DISCHARGE. PROVIDE INSULATED CURB AT ROOF PENETRATION. PROVIDE MOTORIZED BACKDRAFT DAMPER AND INTERLOCK DAMPER WITH UNIT TO SHUT DOWN BELOW 38 DEGREES F. PROVIDE 15 FOOT FREEZE PROBE IN EXHAUST AIR DUCT TO BE CONNECTED TO UNIT CONTROLS. COORDINATE EXACT ROUTING & DISCHARGE LOCATION WITH LANDLORD PRIOR TO BID. MIN 10'-0" FROM ANY FRESH AIR INTAKE.

GENERAL NOTES

- A. ALL ROOF WORK IS TO BE DONE BY THE LANDLORD'S ROOFING CONTRACTOR AND AT THE TENANT'S EXPENSE.
- B. ALL DUCTWORK SHALL BE GALVANIZED SHEETMETAL PER SMACNA STANDARDS.
- NO DUCTBOARD PERMITTED. C. ALL DUCT WORK SHALL BE INSULATED WITH A MINIMUM R-6 INSULATION FOR INTERIOR DUCTWORK AND A MINIMUM R-8 INSULATION FOR EXTERIOR DUCTWORK

PER IECC (IN CALIFORNIA PROVIDE MINIMUM R-8 INTERIOR / EXTERIOR.)

- D. PROVIDE INSULATED FLEXIBLE DUCT CONNECTIONS TO DIFFUSERS. FLEX DUCT LENGTH NOT TO EXCEED 5 FT.
- E. VERIFY THE EXACT MOUNTING FRAME REQUIRED FOR EACH DIFFUSER.
- F. PROVIDE ALL MANUAL BALANCE DAMPERS REQUIRED TO BALANCE THE ENTIRE
- G. ALL NEW RESTROOM DOORS SHALL BE UNDERCUT A MINIMUM 1". TENANT GENERAL CONTRACTOR SHALL ENSURE THAT EXISTING DOORS COMPLY.
- H. PROVIDE AND SIZE CONDENSATE LINES AS REQUIRED. ROUTE TO NEAREST ROOF DRAIN WHERE PERMITTED, ELSE TO THE NEAREST APPROVED RECEPTOR.
- MODIFY THE SPRINKLER SYSTEM (WHERE EXISTING) TO ACCOMMODATE NEW FLOOR PLAN LAYOUT PER NFPA 13. REPLACE SPRINKLER HEADS AS REQUIRED. ALL HEADS IN THE SALES AREA ARE TO BE CONCEALED PENDANT TYPE. NON-SALES AREAS ARE TO BE PENDANT TYPE. CONTACT THE LANDLORD FOR ADDITIONAL REQUIREMENTS AND A LIST OF APPROVED FIRE PROTECTION CONTRACTORS.
- J. REPLACE FILTERS PRIOR TO TURNOVER.
- K. PROVIDE RFI/RFQ TO P.M. & ARCHITECT FOR ALL DISCREPANCIES PRIOR TO COMMENCING WORK.
- TENANT GENERAL CONTRACTOR SUB TO PROVIDE REDLINES OF ALL DEVIATIONS
- FROM THE PLANS AND PROVIDE A COMPLETE TEST & BALANCE REPORT AS REQUIRED BY THE CONTRACT.

MECHANICAL LEGEND

MANUAL BALANCING DAMPER TO BE PLACED IN ACCESSIBLE LOCATION

NOTE: SEE SHEET M102 FOR MECHANICAL SCHEDULES AND SHEET M501 FOR MECHANICAL DETAILS

WHEN REQUIRED, IT IS THE OWNER'S RESPONSIBILITY TO CONTRACT WITH A COMMISSIONING AUTHORITY TO COMPLY WITH LOCAL CODES.

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PRCTI20241902

3RD

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1227 PU

PROJECT TYPE: CORP NEW

DCD: XX

11.11.2024

11.11.2024

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www.fuzionad.com

PROTOTYPE RELEASE: Q3 2024



SUITE 103

SCOTTSDALE, AZ 85260



101 Nightlinger Lane Millsap, TX 76066 (817) 901-5191

	1	1
##	DESCRIPTION	DATE
3	CONSTRUCTION COORDINATION	3/11/2025

MECHANICAL FLOOR

DRAWN BY:

PLAN

	NOTE: NOT ALL USED AT THIS LOCATION	
SINGLE LINE	DESCRIPTION	DOUBLE LINE
	90° ELBOW DOWN	<u> </u>
	90° ELBOW UP	8 9
	ROUND RADIUS ELBOW	
	90° STRAIGHT TEE	
	90° CONICAL TEE	
	45° BRANCH	
	45° CONICAL TEE	
	SIZE OR SHAPE TRANSITION	
	ROUND FLEXIBLE DUCT	£
	90° ELBOW DOWN	
	90° ELBOW UP	
	RECTANGULAR RADIUS ELBOW	
	RECTANGULAR ELBOW WITH TURNING VANES	
	BRANCH TAKE-OFF WITH 45° TAP	
	LINED DUCTWORK	
<u></u>	(UNLESS NOTED OTHERWISE) SIDEWALL SUPPLY GRILLE OR REGISTER WITH	† †
	AIR EXTRACTOR SUPPLY DUCT RISER	
	RETURN, EXHAUST OR	
→	OUTSIDE AIR DUCT RISER DOOR GRILLE	→
<u> </u>	MANUAL BALANCING DAMPER	
	MOTORIZED DAMPER	
FD FD	FIRE DAMPER	
FSD FSD	COMBINATION FIRE AND SMOKE DAMPER WITH SMOKE DETECTOR	FSD FSD
	SMOKE DAMPER (AUTOMATIC) WITH SMOKE DETECTOR	
(S) -	DUCT MOUNTED SMOKE DETECTOR	\(\sigma\)
	RETURN AIR DUCT / CEILING RETURN AIR GRILLE OR REGISTER	AND/ OR ✓
	SUPPLY AIR DUCT / SUPPLY DIFFUSER LINEAR DIFFUSER	AND/ OR I
	EXHAUST AIR DUCT / CEILING MOUNTED EXHAUST FAN	ND AND NO
$\dashv = \vdash$	CANVAS CONNECTOR WITH VIBRATION	
H	CONNECT TO EXISTING	X
•	REMOVE TO THIS POINT	lacktriangle
─ ─₩₩	FLEXIBLE CONNECTION	
T	THERMOSTAT	Ū
<u>(S)</u>	SENSOR	<u>(S)</u>
<u> </u>	UNIT HEATER	
	EXHAUST FAN	
	CONDENSING UNIT	
[]	FAN COIL UNIT / AIR HANDLER UNIT	[[]
	ROOFTOP AIR CONDITIONING UNIT	
0.A. —∕ →	OUTSIDE AIR INTAKE	0.A. — ∤ —
<u></u>	TRANSFER GRILLE	<u></u>
-#-	DUCT SLEEVE	-#-

MECHANICAL SYMBOLS

ME	CHANICAL ABREVIATIONS
	NOTE: NOT ALL USED AT THIS LOCATION
A.C.U. OR A.C.	AIR CONDITIONING UNIT (SPLIT-DX OR WATER COOLED)
A.F.F.	ABOVE FINISHED FLOOR
A.H.U.	AIR HANDLING UNIT
B.O.H.	BACK OF HOUSE
B.T.U.H.	BRITISH THERMAL UNIT / HOUR
C.H.	CABINET HEATER
C.U.	CONDENSING UNIT (SPLIT-DX SYSTEMS)
C.F.M.	CUBIC FEET PER MINUTE
E.A.T.	ENTERING AIR TEMPERATURE
E.B.H.	ELECTRIC BASEBOARD HEATER
E.D.H.	ELECTRIC DUCT HEATER
E.E.R.	ENERGY EFFICIENCY RATIO
E.F.	EXHAUST FAN
E.S.P.	EXTERNAL STATIC PRESSURE
F.C.U.	FAN COIL UNIT
F.F.C.H.	FORCED FLOW CABINET HEATER
F.L.A.	FULL LOAD AMPS
G.F.I.	GROUND FAULT INTERRUPTER
I.O.M.	INSTALLATION AND OPERATION MANUAL
K.W.	KILOWATT
L.A.T.	LEAVING AIR TEMPERATURE
M.C.A.	MINIMUM CIRCUIT AMPACITY
N.C.	NOISE CRITERIA
O.A.	OUTSIDE AIR
P.S.I.	POUNDS PER SQUARE INCH
R.L.A.	RUNNING LOAD AMPS
R.T.U.	ROOF TOP UNIT
S.E.E.R.	SEASONAL ENERGY EFFICIENCY RATIO
T.G.C.	TENANT GENERAL CONTRACTOR
U.H.	UNIT HEATER
U.N.O.	UNTIL NOTED OTHERWISE
V.F.	VENTILATION FAN
W.C.	WATER COLUMN
W.G.	WATER GAUGE

			LATIONS	
		T-Mobile 8022	_	
		4227 S Meriian Suite	E	
		Puyallup, WA 98373		
		3263 Square Feet		
	ASHRA	E DESIGN CONDITION	ONS	
COOLING OA DB	89		COOLING OA WB	 67
COOLING IA DB	70		COOLING IA WB	63
HEATING OA	19		HEATING IA	72
ROOF U-FACTOR	0.050		LIGHTING WATTS	2400
LIGHT DIVERS.	1.1		MISC. WATTS	10005
VENT CFM - MIN OA	740		SQ FT/PERSON	75
VENT CFM/PERSON	15.0		NO OF PEOPLE	44
WALL AREA	3024		WALL U-FACTOR	0.07
PEOPLE SENS HEAT	250		PEOPLE LATENT	200
	COOLIN	 IG LOAD SUMMARY		
SENSIBLE HEAT GAIN			LATENT HEAT GAIN	 J
PEOPLE	10877		PEOPLE	8701
VENTILATION	15255		VENTILATION	6789
ROOF LOAD	15010			
LIGHT LOAD	9010			
MISC LOAD	34147			
WALL LOAD	18084			
TOTAL SENSIBLE	102382		TOTAL LATENT	 15491
TOTAL COOLING LOAD		117873	BTUH	
SENS/TOTAL RATIO		87		
NOMINAL CFM			CFM	
	HEATIN	 G LOAD SUMMARY		
SENSIBLE HEAT GAIN			LATENT HEAT GAIN	 J
VENTILATION	42554		VENTILATION	0
ROOF LOAD	8647			
WALL LOAD	10418			

		AIR	O.A.	EXT.	С	X COOLING	COIL		GAS HEAT			ELECT	RICAL			APPROX.	
SYMBOL	BASIS FOR DESIGN	FLOW (CFM)	FLOW (CFM)	S.P. (IN W.C.)	TONS	TOTAL LOAD (MB	SENSIBLE LOAD (MBH)	INPUT (MBH)	OUTPUT (MBH/HR)	STAGES	VOLTS/Ø	S/HZ. MCA	МОСР	EER2	SEER2	WEIGHT (LBS.)	NOTES
RTU-1	TRANE YSK060	2,000	440	.70	5	61.4	47.8	100	70	2	208/3/6	50 29	45	11.0	13.4	1,100	1
RTU-2	TRANE YSK060	2,000	290	.70	5	61.4	47.8	100	70	2	208/3/6	50 29	45	11.0	13.4	1,100	1
	NO	ΓES			VENT	ILATION	REQUIREME	NT CALC	ULATION							PER IMC T	TABLE 403.3
1. SEE	EXISTING SYSTEM NOTES TH	IIS SHEET			ROOM	1 NAME	UNIT SERVICING	PEOPLE	CFM/PERSON	CFM/SF	AREA (SF)	PEOPLE X CFM/PERSON	SF X CFM/SF	TOTAL O.A. CFM	ZONE AIR DIST EFF TABLE 403.2.1.2	REQUIRED O.A. CFM	PROVIDE O.A. CFN
					SALES		ERV-1	32	7.5	0.12	2104	240	252.48	492.48	0.8	615.6	620
					CORRIDO	R	ERV-1	-	-	0.06	264	-	15.84	15.84	0.8	19.8	20
					BOH-1		ERV-1	2	5	0.06	252	10	15	25	0.8	31.4	35
					BOH-2		ERV-1	2	5	0.06	311	10	19	29	0.8	35.825	40
					OFFICE		ERV-1	1	5	0.06	86	5	5	10	0.8	12.7	15
					RESTROO	MS		-	-	-	120	-	-	-	0.8	-	-
															REQUIRED PER	CODE	730
									,		T		TOTAL O.A. P	ROVIDED	<u> </u>		7
					RESTROO	MS -	70 CFM / FIXTURE			# FIXTURES=	2	150	CFM EXHAUST	150	CFM EXHAUST	150	CFM EXI

				DI	UCTL	ESS	DX S	SPLIT	SY	STEM	SCH	HED	ULE	Ξ						
				,	AIR HAND	LER				AIR COOL	ED CON	DENSIN	IG UNI	Т			COOL	ING PERFO	RMANCE D	ATA
SYMBOL	MITSUBISHI MODEL	MOUNTING	CFM	OA	FLA	POWER	R CONN.	WEIGHT	COMP	RESSORS	REF.	POW	ER CC	NNEC	ΓΙΟΝ	WEIGHT	CAPACI	ΓΥ (MBH)	SEER2	EER2
	OBLL	MOUNTING	CFIVI	UA	FLA	V.	Ph.	(LBS.)	NO.	RLA	TYPE	V.	Ph.	MCA	МОСР	(LBS.)	TOTAL	SENS.		
AH-1	PLA-A24EA8	CEILING	710	-	0.28	_	RED BY OR UNIT	57									24.0	20.6	24.7	14.3
CU-1	PUY-A24NHA7								1	7	R410A	208	1	19	26	151	24.0	20.0	24.7	14.3

- 1. PROVIDE 3RD PARTY THERMOSTAT INTERFACE MODEL #PAC-US445CN-1 FOR CN105-IT TERMINAL CONNECTION TO ENTOUCH CONTROLS.
 - INSTALL INTERFACE CARD AT EACH UNIT AND RUN THERMOSTAT WIRES DOWN TO EACH LOCATION.
- 3. EACH UNIT WILL NEED A STEP-DOWN TRANSFORMER TO CONVERT 120VAC TO 24VAC TO POWER THE T-STAT INTERFACE AND SUPPLY POWER TO THE ENTOUCH T-STAT. 4. SIZE, ROUTE, INSULATE AND PROVIDE APPURTENANCES FOR DX PIPING SYSTEMS, PER MANUFACTURER RECOMMENDATIONS.
- 5. COORDINATE OUTDOOR UNIT MOUNTING REQUIREMENTS AND ROOF PENETRATIONS WITH ROOFING CONTRACTOR. 6. PROVIDE WITH CONDENSATE PUMP EQUAL TO LITTLE GIANT VCC-20. REFER TO DRAWINGS FOR CONDENSATE ROUTING REQUIREMENTS.
- 7. MITSUBISHI IS THE BASIS OF DESIGN. ALTERNATES TO BE APPROVED BY OWNER AND ENGINEER PRIOR TO ORDERING. CONTRACTOR IS RESPONSIBLE FOR VARIATIONS IN FIT AND ELECTRICAL SERVICE.

NOTES: REPRESENTS CONDITIONS DURING NORMAL OPERATIONS AND NOT CONSIDERING ECONOMIZER OPERATION.

8. FOR REFRIGERANT LINESETS LONGER THAN 70'-0", FOLLOW MANUFACTURER'S LONG LINESET GUIDELINES.

		ENE	ERGY RE	COVE	RY VEN	TILATOR					
				PERFO	RMANCE	ELECTF	RICAL			ADDDOV	
SYMBOL	MANUFACTURER	MODEL	DRIVE TYPE	AIR FLOW (CFM)	EXT. STATIC (IN W.C.)	VOLTS/Ø/HZ.	FAN MOTOR HP	MCA	MOCP	APPROX. WEIGHT (LBS.)	NOTES
ERV-1	GREENHECK	MINIVENT-750-VG	DIRECT	730	0.25	208/1/60	3/4	12.5	15	240	

		_		DIFFUS	ER SCHEDU	LE			_
MARK	MANUF.	MODEL	SERVICE	MODULE SIZE (L" x W")	FRAME TYPE	FINISH	MOUNTING	N.C.	NOTES
A	TITUS	TMSA	SUPPLY DIFFUSER	24" x 24"	SEE PLANS	#26 WHITE	CEILING GRID	<25	1,2,3,4
B	TITUS	TMSA	SUPPLY DIFFUSER	12" x 12"	SEE PLANS	#26 WHITE	CEILING GRID	<25	1,2,3,4
⟨C⟩	TITUS	350R	RETURN GRILLE	12" x 10"	SEE PLANS	#26 WHITE	WALL	<25	1,5
D	TITUS	50F	RETURN GRILLE	24" x 24"	SEE PLANS	SALES - BLACK IRON BOH - #26 WHITE	CEILING GRID	<25	1,2,3
F	NOT	USED V						Y	

- 2. COORDINATE EXACT FRAME MOUNTING TYPE WITH ARCHITECTURAL CEILING PLAN.
- 3. BRANCH DUCT SIZE SHALL BE SAME AS NECK SIZE UNLESS OTHERWISE NOTED.
- 4. SELECT TMSA DIFFUSER PER NECK SIZE. SEE PLANS. 5. MOUNT TOP OF GRILLE 6" BELOW FINISHED CEILING.

SALES FLOOR SUPPLY DIFFUSERS AND RETURN GRILLES TO BE PAINTED BENJAMIN MOORE "BLACK IRON" MATTED IN THE FIELD.

NOT USED	
NOTOSED	

	EXHAUST FAN SCHEDULE												
					PERFORM	IANCE			ELECT	RICAL		ADDDOV	
MARK	MANUF.	MODEL	DRIVE TYPE	AIR FLOW (CFM)	EXT STATIC (W.C.)	FAN SPEED (RPM)	SONES	V	Р	MOTOR HP	MOUNTING	APPROX. WEIGHT (LBS)	NOTES
L233	BROAN	QTXE110150DCL	DIRECT	110	0.1	1	0.8	208	3	-	CEILING	14	1,2,3

- OR APPROVED EQUAL.
 PROVIDE INSULATED ROOF CURB FOR MOUNTING.
- 3. PROVIDE WITH BACKDRAFT DAMPER.
- 4. PROVIDE GOOSENECK FITTING/INSECT SCREEN AT DISCHARGE ON ROOF.

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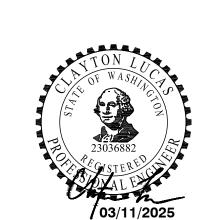
JTH MERIDIAN & AVE SE

4227 S MERIDIAN SUITE E PUYALLUP, WA 98373

PROJECT TYPE: CORP NEW

DCD: XX

PROTOTYPE RELEASE: Q3 2024



11.11.2024

FUZION SUITE 103 SCOTTSDALE, AZ 85260 (480) 463 - 4764 www.fuzionad.com



101 Nightlinger Lane Millsap, TX 76066 (817) 901-5191

##	DESCRIPTION	DATE
3	CONSTRUCTION COORDINATION	3/11/2025
ļ		
DATE: DRAWN B	v .	11.11.202 H

MECHANICAL SCHEDULES

12920 SE 38th STREET BELLEVUE, WA 98006 WWW.T-MOBILE.COM

PRCTI20241902

3RD

TH MERIDIA

AVE SE

4227 S MERIDIAN S
PUYALLUP, WA S

PROJECT TYPE: CORP NEW

DCD: XX

8022



11.11.2024

FUZION

W/ 2 CAT6A SHIELDED WIRES

X4(S) OVERHEAD RAN W/ 4 CAT6A SHIELDED WIRES

X1 N OVERHEAD AP CABLING

X1 OVERHEAD SHOPPER

X2(S) OVERHEAD RAN

TRACKER CABLING

X3 W/ 3 CAT6 WIRES QUADPLEX RJ45 JACK

X4 W/ 4 CAT6 WIRES

NOTES

WINDOW (NEC 210.62).

SHOW WINDOW RECEPTACLE(S). LOCATE MAXIMUM 18" FROM TOP OF

COORDINATE W/ AP VENDOR FOR EXACT LOCATIONS.

CEILING FOR CONDUIT TRENCH TO FLOOR FIXTURES.

FOR ADDITIONAL INFORMATION AND RESPONSIBILITIES.

(1) 1" GENERAL POWER, (1) 1" DATA

VENDOR FOR EXACT LOCATIONS.

(1) 3/4" GENERAL POWER & (1) 3/4" DATA

LOCATION WITH SECURITY COMPANY.

PROVIDE (1) 3" CONDUIT FOR JCI CABLES.

ARCHITECTURAL DETAILS FOR LOCATION.

BY MC/GC (CABLE PULL).

RESPONSIBILITIES.

RESPONSIBILITIES.

CONDUIT SCHEDULE:

 ■ DUPLEX RJ45 JACK W/ 1 CAT6 WIRE

⚠ DUPLEX RJ45 JACK

SHIELDED WIRES

DUPLEX RJ45 JACK W/ 2 CAT6 WIRES

QUADPLEX RJ45 JACK

X2(S) W/ 2 CAT6A

PROVIDE (2) 4" CONDUIT FOR CAT6 RT CABLES.

PROVIDE ALL NEC CLEARANCES.

DETAILS.

ON SHEETS E502 AND E503.

CONDUIT SCHEDULE:

CONDUIT SCHEDULE:

PROVIDE OVERHEAD AP CABLING ABOVE CEILING W/ 3'-0" MIN. SERVICE LOOP.

PROVIDE POWER CIRCUIT AND LOW VOLTAGE WIRING TO J-BOXES ABOVE

SAW CUT (TRENCH) TO XF310 FIXTURE. SEE WIRING DETAILS ON SHEET E501

PROVIDE OVERHEAD AP CAT6A SHEILDED CABLING ABOVE CEILING FOR RAN. PROVIDE 20'-0" SERVICE LOOP COILED ABOVE CEILING. COORDINATE W/ AP

PROVIDE DEDICATED CIRCUIT FOR DIGITAL DISPLAY EQUIPMENT. SEE DETAILS

SAW CUT (TRENCH) TO XF212 OEM TABLE. SEE WIRING DETAILS ON SHEET

SAW CUT (TRENCH) TO WORKSHOP TABLE. SEE WIRING DETAILS ON SHEET

PROVIDE DATA BOX ABOVE CEILING FOR SHOPPER TRACKER. OWNER'S VENDOR WILL EXTEND CABLING BACK TO TELEPHONE BACK BOARD.

ROUGH IN FOR JCI KEYPAD. MOUNT AT 48" A.F.F.. COORDINATE EXACT

ELECTRICAL EQUIPMENT. SEE ONE LINE DIAGRAM ON SHEET E301. T.G.C. TO

PROVIDE TELEPHONE BACKBOARD. SEE ELEVATION ON SHEET E302 FOR

PROVIDE CONNECTION TO AUTOMATIC HAND DRYER AT 34" A.F.F. (HAND

SENSOR. MOUNT THERMOSTAT AT 48" A.F.F.. PROVIDE AND PULL CAT5 CABLE FROM ET1 THERMOSTAT TO OPEN PORT ON CUSTOMER NETWORK SWITCH. MOUNT

ZONE TEMPERATURE SENSOR AT 60" A.F.F. AND WIRE TO THE S2 & S2 RTN. MOUNT DUCT TEMPERATURE SENSOR IN THE MAIN SUPPLY DUCT WITHIN 6

REFER TO MONITOR MOUNTING DETAILS ON ARCHITECTURAL DRAWINGS.

PROVIDE MOTOR RATED SWITCH FOR RECIRCULATION PUMP DISCONNECT. CONNECT TO CIRCUIT INDICATED USING 2#12, #12G, IN 3/4" CONDUIT AND

SAW CUT (TRENCH) TO FREESTANDING XW302 GRAB & GO. SEE DETAILS ON

SAW CUT (TRENCH) TO FREESTANDING XW180 T-MOBILE BENTO. SEE WIRING

SAW CUT (TRENCH) TO FREESTANDING XW186 T-MOBILE BENTO. SEE WIRING

PROVIDE FINAL CONNECTIONS AFTER PLUMBER INSTALLATION.

(1) 1" DEDICATED POWER, (1) 1" GENERAL POWER & (1) 1" DATA

DETAILS ON SHEET E503.1 FOR ADDITIONAL INFORMATION AND

DETAILS ON SHEET E503.1 FOR ADDITIONAL INFORMATION AND

WIRING SYMBOLS

• <u>CONDUIT SCHEDULE:</u> (1) 1-1/4" DEDICATED POWER & (1) 2" DATA

(1) 1-1/4"" DEDICATED POWER & (1) 2" DATA

SHEET E501 FOR ADDITIONAL INFORMATION AND RESPONSIBILITIES.

FEET FROM UNIT AND WIRE TO S2 & S2 RTN. CABLE RUNS AND TERMINATIONS

DRYER FURNISHED BY OWNER THROUGH LIGHTING VENDOR). SEE

INSTALL OWNER SUPPLIED ENTOUCH.ONE MASTER CONTROLLER THERMOSTAT, ZONE TEMPERATURE SENSOR AND DUCT TEMPERATURE

MOUNT GFI RECEPTACLE PER MANUFACTURES TEMPLATE.

PROVIDE 2" CONDUIT AND PULL CORD FROM LANDLORD TELEPHONE

BACKBOARD TO THE TENANT TELEPHONE BACKBOARD.

E502 FOR ADDITIONAL INFORMATION AND RESPONSIBILITIES.

E502 FOR ADDITIONAL INFORMATION AND RESPONSIBILITIES.

(1) 1" GENERAL POWER & (1) 1" DATA TO EACH TABLE

A. PROVIDE CAT6A SHIELDED DATA CABLINF FOR ALL NANOLUMEN LED DIGITAL DISPLAYS AND RAN EQUIPMENT. B. UPSIZE CONDUIT FOR CAT6A SHIELDED CABLE AS REQUIRED.

C. RIGID CONDUIT ONLY FOR DATA CABLING. NO FLEXIBLE CONDUIT ALLOWED.

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DESIG E1Y

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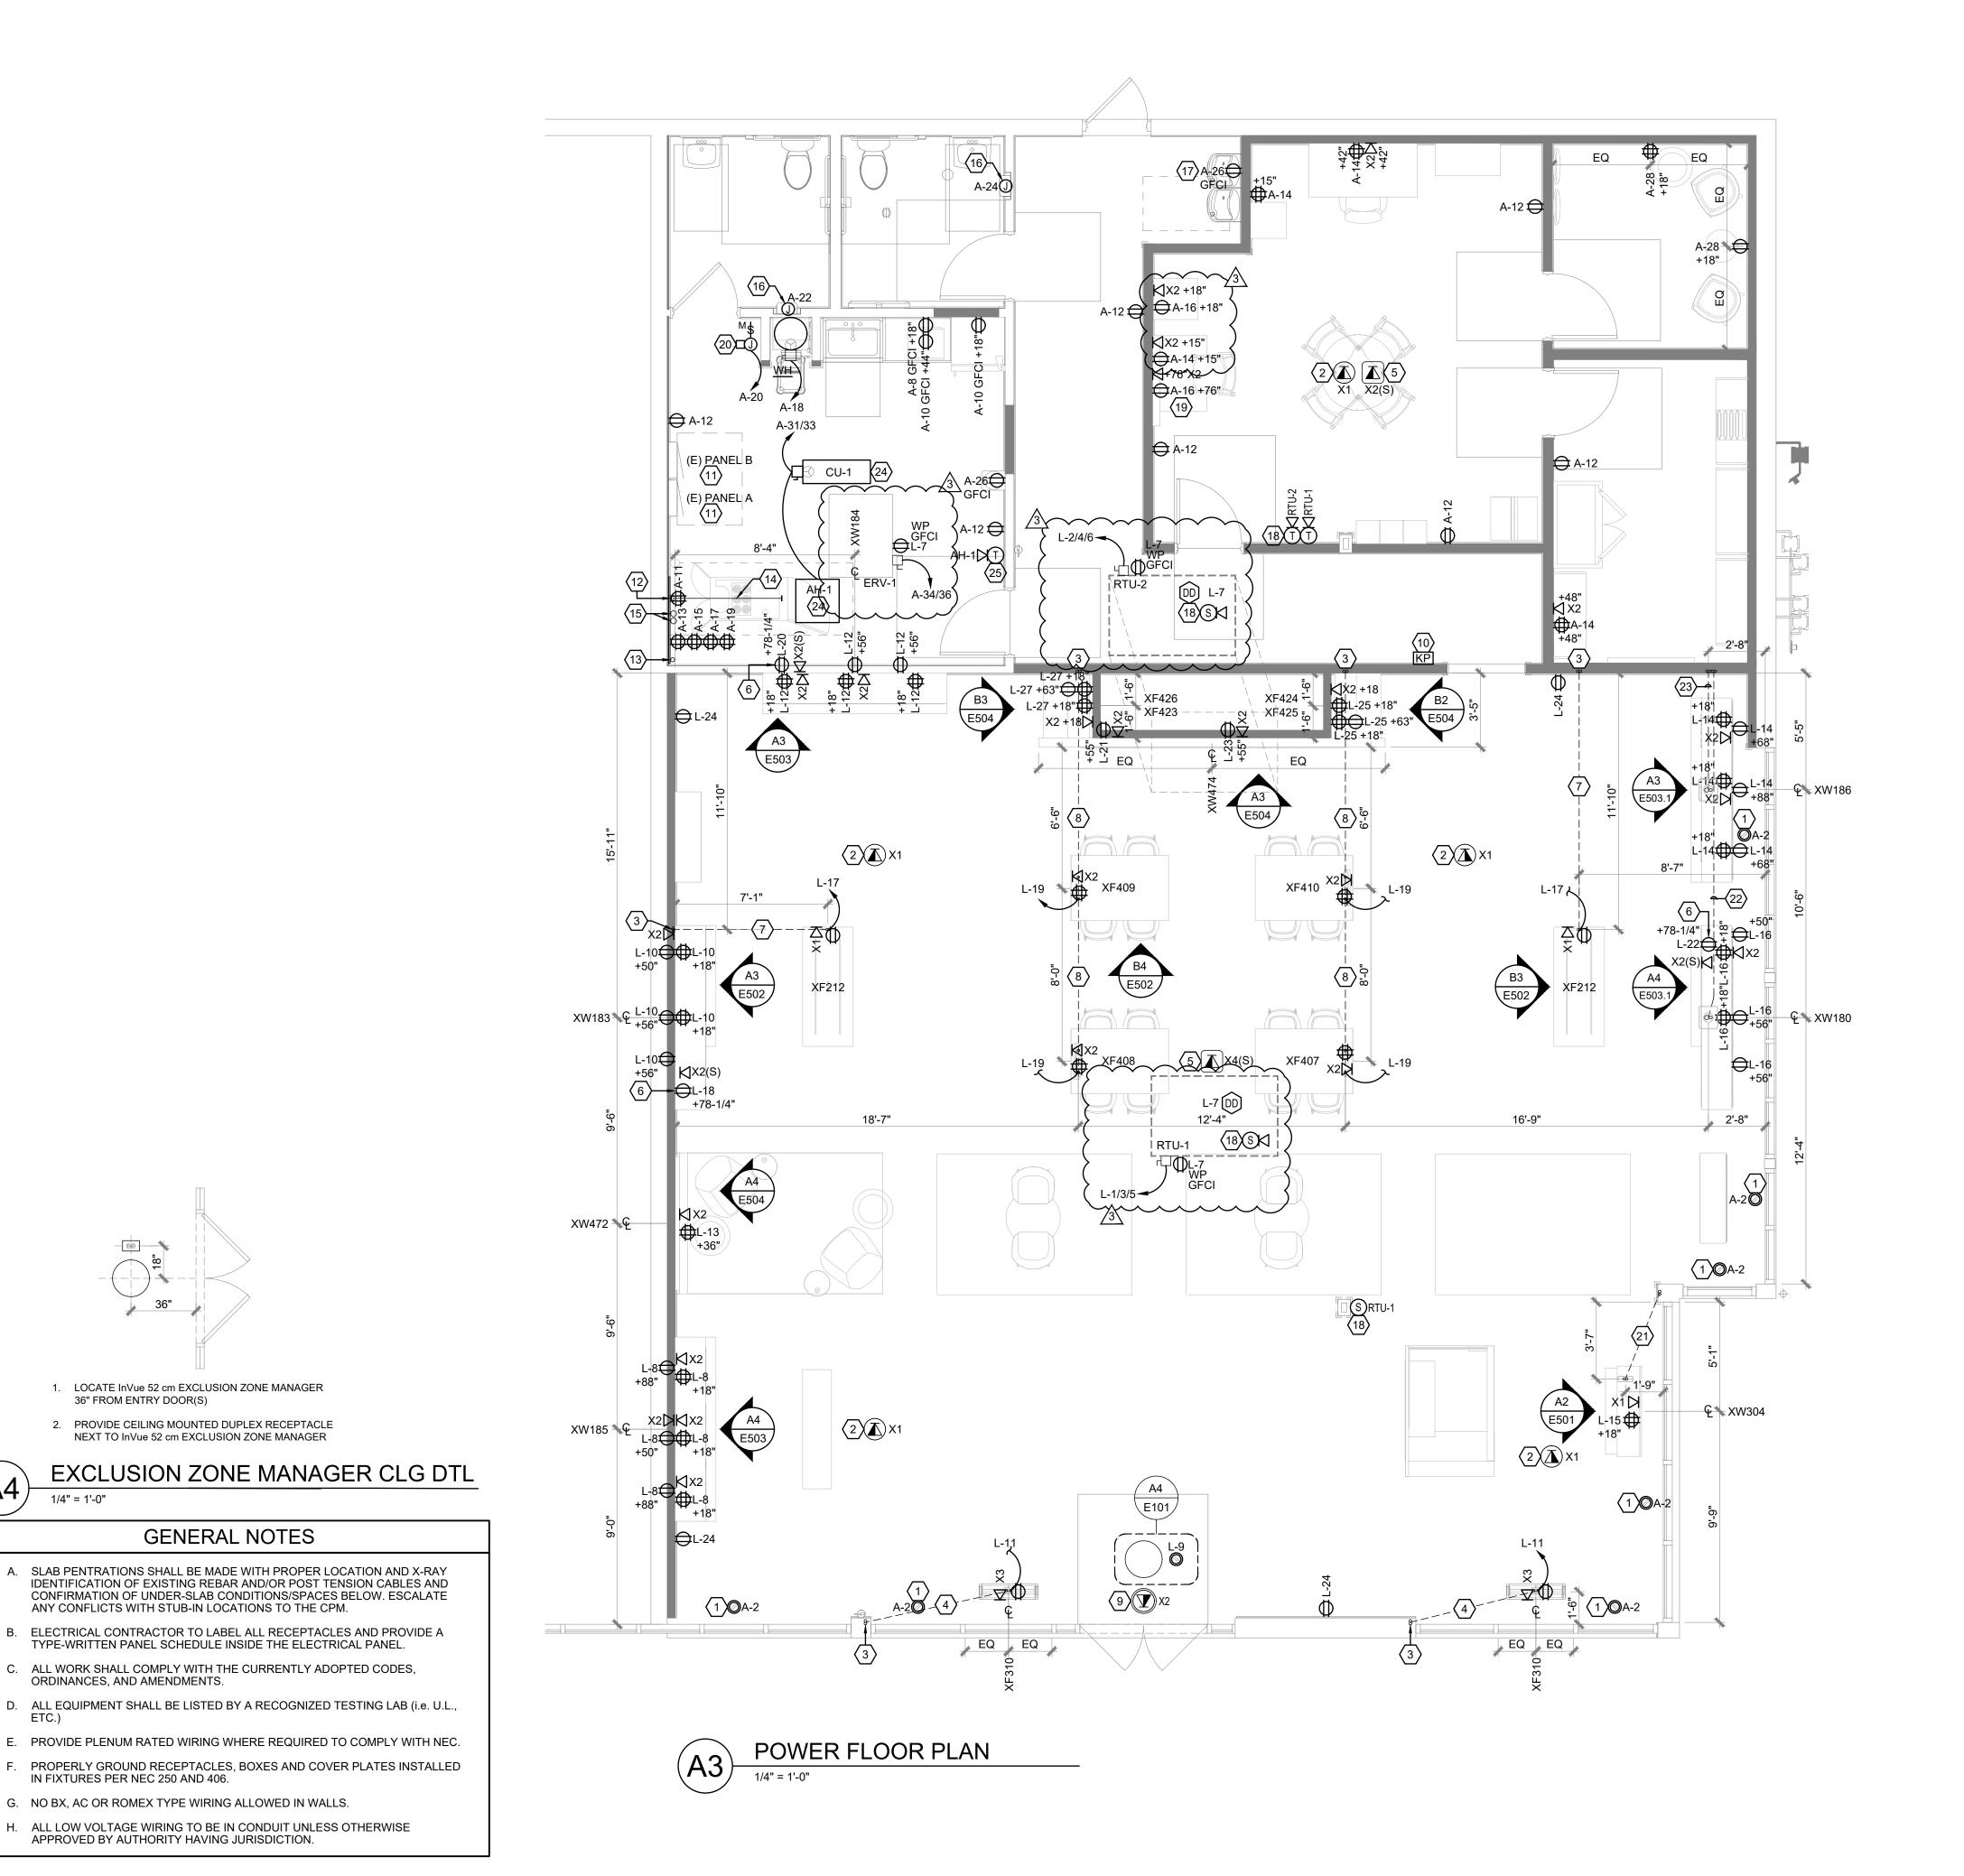
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DRAWN BY:

##	DESCRIPTION	DATE
3	CONSTRUCTION COORDINATION	3/11/2025
	1	

POWER FLOOR PLAN



88

36" FROM ENTRY DOOR(S)

ORDINANCES, AND AMENDMENTS.

IN FIXTURES PER NEC 250 AND 406.

1/4" = 1'-0"

1. LOCATE InVue 52 cm EXCLUSION ZONE MANAGER

2. PROVIDE CEILING MOUNTED DUPLEX RECEPTACLE

ANY CONFLICTS WITH STUB-IN LOCATIONS TO THE CPM.

G. NO BX, AC OR ROMEX TYPE WIRING ALLOWED IN WALLS.

APPROVED BY AUTHORITY HAVING JURISDICTION.

NEXT TO InVue 52 cm EXCLUSION ZONE MANAGER

GENERAL NOTES

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BELLEVUE, WA 98006 WWW.T-MOBILE.COM

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3RD

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DESIGI E1Y

TH MERIDIAN & AVE SE

4227 S MERIDIAN SUITE E PUYALLUP, WA 98373

PROJECT TYPE: CORP NEW 8022

DCD: XX

11.11.2024

11.11.2024

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PROTOTYPE RELEASE: Q3 2024



DATE:

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##	DESCRIPTION	DATE
3	CONSTRUCTION COORDINATION	3/11/2025

DRAWN BY:

ELECTRICAL PANELS

PANEL A (EXISTING) Service: 120/208 Volts 3 Phase Wire Cabinets: Surface Mounted Service: 120/208 Volts 27.045 NEMA 225 Amp Total Watts: Mains: REM CKT DESCRIPTION WATTS WIRE BKR A B C BKR WIRE DESCRIPTION WATTS CKT REM REM CKT DESCRIPTION
 708
 12
 1/20
 X
 1/20
 12
 SHOW WINDOW REC

 524
 12
 1/20
 X
 1/20
 12
 DIGITAL CLOUD REC

 600
 12
 1/20
 X
 1/20
 12
 PORTAL CEILING REC
 LTG-SALES GENERAL TG-SALES GENERAL/EM L4 5 LTG-SALES DISPLAY 12 1/20 X 1/20 12 MICROWAVE REC 7 LTG-BOH 1200 12 1/20 X 1/20 12 REFRIG/COUNTER REC 9 SECURITY REC 680 11 TELE BOARD REC X 1/20 12 BOH GENERAL REC 11 XF310 REC 12 1/20 12 13 TELE BOARD REC 360 12 1/20 X 1/20 12 MNGR/SAFE/TCRT/RC 1260 14 13 PORTAL WALL REC 15 TELE BOARD REC 360 12 1/20 X 1/20 12 DASH BD / PRINTER REC 540 16 17 TELE BOARD REC 12 1/20 X 1/20 12 WATER HEATER
12 1/20 X 1/20 12 RECIRCULATION PUMP 19 TELE BOARD REC 21 SPARE 23 SPARE 25 SPARE 1/20 X 1/20 12 HAND DRYER
 1/20
 X
 1/20
 12
 HAND DRYER

 1/20
 X
 1/20
 12
 EWC REC
 27 SPARE 1/20 X 1/20 12 PRIVACY POD REC 27 OPS DEPOT REC 29 SPARE X 1/20 SPARE 29 SPARE 1/20 , 10 2/25 X 2/15 12 ERV-1 1500 34 HR HR 31 AH-1/CU-1 33 SPARE 1976 35 SPARE 37 SPARE L5 39 SIGN White the state of 1/20 X 1200 12 1/20 X 3/20 12 TVSS L5 41 SIGN 1200 12 1/20 X

OTAL LOAD PHASE 'A' 8141 TOTAL LOAD PHASE 'B' REMARKS 9544 TOTAL LOAD PHASE 'C' (L#) LIGHTING CONTACTOR 9360 (LO) LOCK-OFF DEVICE TOTAL LOAD ALL PHASES 27045 WATTS (HR) HACR RATED CB 75.13 AMPS

ALL BREAKERS TO BE 20A BOLT-ON UNLESS NOTED OTHERWISE

100% OF FIRST 10,000 WATTS, PLUS 50% OF REMAINING LOAD.

100% OF A/C LOAD, PLUS 25% OF HIGHEST LOAD.

F	PANEL A - ELEC	TRICAL LO	AD SUMMARY	
	120/2	208 3PH - 4	W	
LOAD DESCRIPTION	CONNECTED LOAD	DEMAND	DEMAND LOAD	DEMAND LOAD
LOAD DESCRIPTION	(WATTS)	FACTOR	(WATTS)	(AMPS)
LIGHTING	2279	1.25	2849	
RECEPTACLES	10284	NOTE #1	10142	
WATER HEATERS	1650	1.25	2063	
SIGNAGE	2400	1.25	3000	
MISC.	3480	1.00	3480	
HVAC	6952	NOTE #2	8690	
TOTAL	27045		30223	84
NOTES:				

	120/2	208 3PH - 4	W	
LOAD DESCRIPTION	CONNECTED LOAD (WATTS)	DEMAND FACTOR	DEMAND LOAD (WATTS)	DEMAND LOAD (AMPS)
LIGHTING	0	1.25	0	
RECEPTACLES	17476	NOTE #1	13738	
WATER HEATERS	0	1.25	0	
SIGNAGE	0	1.25	0	
MISC.	180	1.00	180	
HVAC	20880	NOTE #2	26100	
TOTAL	38536		40018	111

100% OF FIRST 10,000 WATTS, PLUS 50% OF REMAINING LOAD.

ALL BREAKERS TO BE 20A BOLT-ON UNLESS NOTED OTHERWISE

PANEL L (EXISTING)

225 Amp

DUCT DET/RTU GFI REC

WORKSHOP TABLE REC

DIGITAL DISP BACK WALL

DIGITAL DISP BACK WALL

15 GRAB N GO REC

OEM TABLE REC

25 DEMO DEPOT REC

35 SPARE

39 TVSS

(L#) LIGHTING CONTACTOR

(LO) LOCK-OFF DEVICE

(HR) HACR RATED CB

REMARKS

3 Phase

760

3/45

12 | 1/20 | X |

180 12 1/20 X

360 12 1/20 X

1/20

12 1/20

360 12 1/20 X

12 1/20

1440 | 12 | 1/20 | X

1338 12 1/20

Wire

WATTS WIRE BKR A B C BKR WIRE DESCRIPTION

1338 12 1/20 X 1/20 12 TV MONITOR REC

900 12 1/20 X 1/20

1/20 X 1/20

1/20 X 1/20

900 12 1/20 X 1/20

1/20 X

12 3/20 X

Cabinets:

1/20 12 WALL REC PLAN WEST

SPARE

SPARE

SPARE

SPARE

SPARE

SPARE

SPARE

SPARE

TOTAL LOAD PHASE 'A'

TOTAL LOAD ALL PHASES

TOTAL LOAD PHASE 'B' 12678

TOTAL LOAD PHASE 'C' 11778

TV MONITOR REC

X 1/20 12 WALL REC PLAN NORTH

1/20 12 TV MONITOR REC

Total Watts:

3/45 6 RTU-2

X 1/20 12 GENERAL REC

1/20

1/20 1/20

X 1/20

X 1/20

Surface

Mounted

3480 3480

3480

1620

1260

1620

1620

1260

WATTS CKT REM

14

32

34

42

14080


38536 WATTS

107.04 AMPS

38,536 NEMA

100% OF A/C LOAD, PLUS 25% OF HIGHEST LOAD.

PANEL SCHEDULES

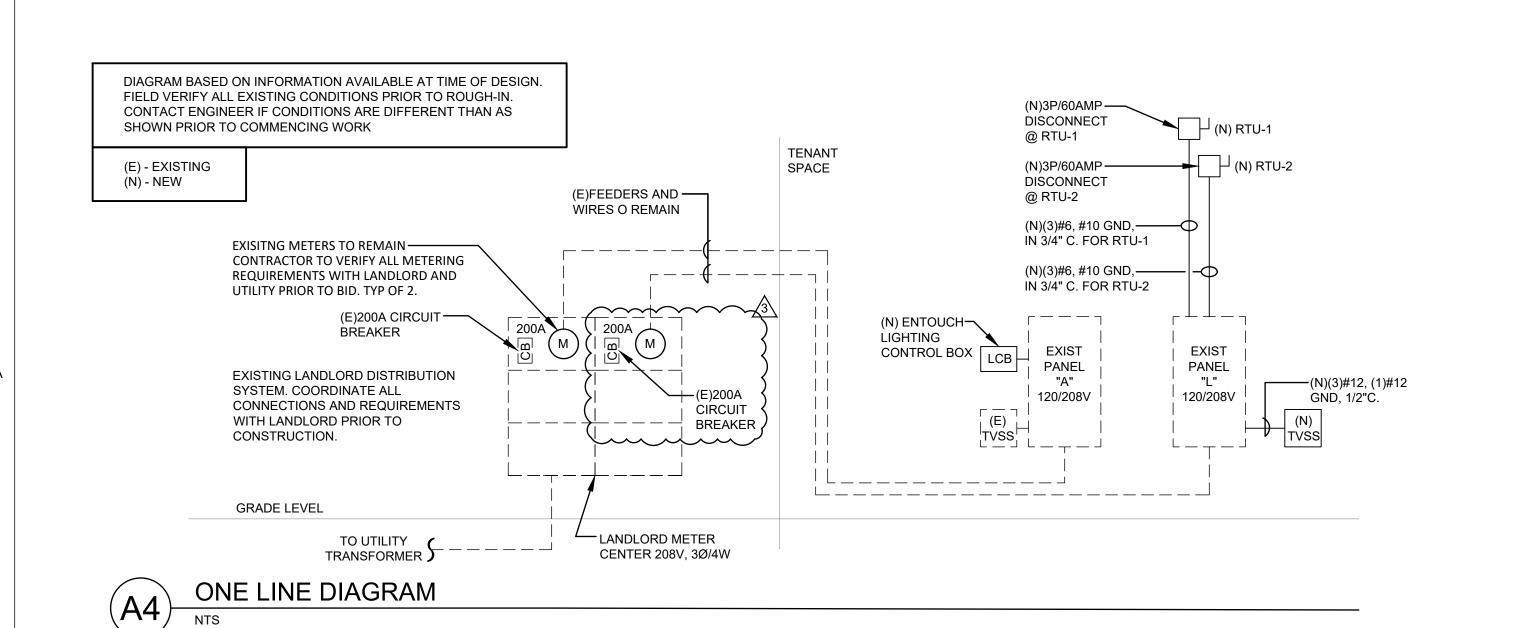

TVSS SCHEDULE		
DESCRIPTION	MODEL	
EATON SPC SERIES	SPC100208Y3P	
TVSS IS OWNER FURNISHED, GC INS	TALLED AS PART OF THE LIGHTING	

GENERAL NOTES

NOTE REGARDING EXAMINATION OF PREMISES/FIELD CONDITIONS:

DESIGN DRAWINGS ARE SCHEMATIC. ONCE ONSITE GENERAL CONTRACTOR IS TO INSPECT EXISTING FIELD CONDITIONS AND FAMILIARIZE HIMSELF WITH ANY CONDITIONS THAT MAY AFFECT HIS WORK IN ANY MANNER PRIOR TO START OF CONSTRUCTION.

IF THE GENERAL CONTRACTOR FINDS THAT THERE ARE DISCREPANCIES BETWEEN THE EXISTING CONDITIONS AND THE INFORMATION SHOWN ON THESE DRAWINGS, GC IS TO NOTIFY THE TENANT'S REPRESENTATIVE AND ARCHITECT OF THOSE DISCREPANCIES PRIOR TO COMMENCEMENT OF WORK.

RFI SHALL BE SUBMITTED FOR ALL LABOR AND MATERIALS NECESSARY FOR FIELD MODIFICATIONS DUE TO EXISTING CONDITIONS.

NOTE REGARDING ELECTRICAL DISTRIBUTION SYSTEM

THE ELECTRICAL RISER DIAGRAM INDICATED HAS BEEN PROPERLY DESIGNED TO ACCOMMODATE TENANT'S POWER REQUIREMENTS AND MEETS ALL APPLICABLE BUILDING CODES. IT IS THE RESPONSIBILITY OF THE GC TO VERIFY ALL EXISTING CONDITIONS AND DETERMINE IF ANY EXISTING EQUIPMENT AND WIRING IS SUITABLE FOR REUSE IN THE SYSTEM PRIOR TO START OF CONSTRUCTION.

ELECTRICAL CONTRACTOR SHALL PERFORM ALL WORK NECESSARY TO RESULT IN A COMPLETE AND LEGAL INSTALLATION INCLUDING THE UPGRADING AND/OR MODIFICATION OF THE EXISTING SERVICE FEEDERS, CONDUITS AND TAP-INS EXTENDED TO PROPER POINT OF ORIGIN AS COORDINATED WITH THE LANDLORD.


1. GENERAL CONTRACTOR TO VERIFY ALL METERING REQUIREMENTS WITH LANDLORD AND UTILITY PRIOR TO START OF CONSTRUCTION.


AUTHORITY HAVING JURISDICTION."


- 2. CONTRACTOR TO VERIFY EXACT DISTANCE AND ROUTING OF SERVICE FEEDERS FROM LANDLORD DISTRIBUTION/SERVICE ENTRANCE EQUIPMENT TO TENANT
- 3. PROVIDE COMPLIANCE WITH NEC 110.26 "SPACES ABOUT ELECTRICAL EQUIPMENT."

5. IT IS THE ELECTRICAL CONTRACTOR'S RESPONSIBILITY TO PROPERLY BALANCE

- 4. PROVIDE COMPLIANCE WITH NEC 408.4 "CIRCUIT DIRECTORY OR CIRCUIT IDENTIFICATION."
- ALL BRANCH CIRCUITS BETWEEN THE PHASES OF THE SYSTEM REGARDLESS OF THE CIRCUITING INDICATED. 6. "ALL LOW VOLTAGE WIRING TO BE IN CONDUIT UNLESS OTHERWISE APPROVED BY
- 7. GENERAL CONTRACTOR SHALL VERIFY ANY THIRD PARTY INSPECTIONS REQUIRED BY THE LOCAL JURISDICTION PRIOR TO START OF CONSTRUCTION.

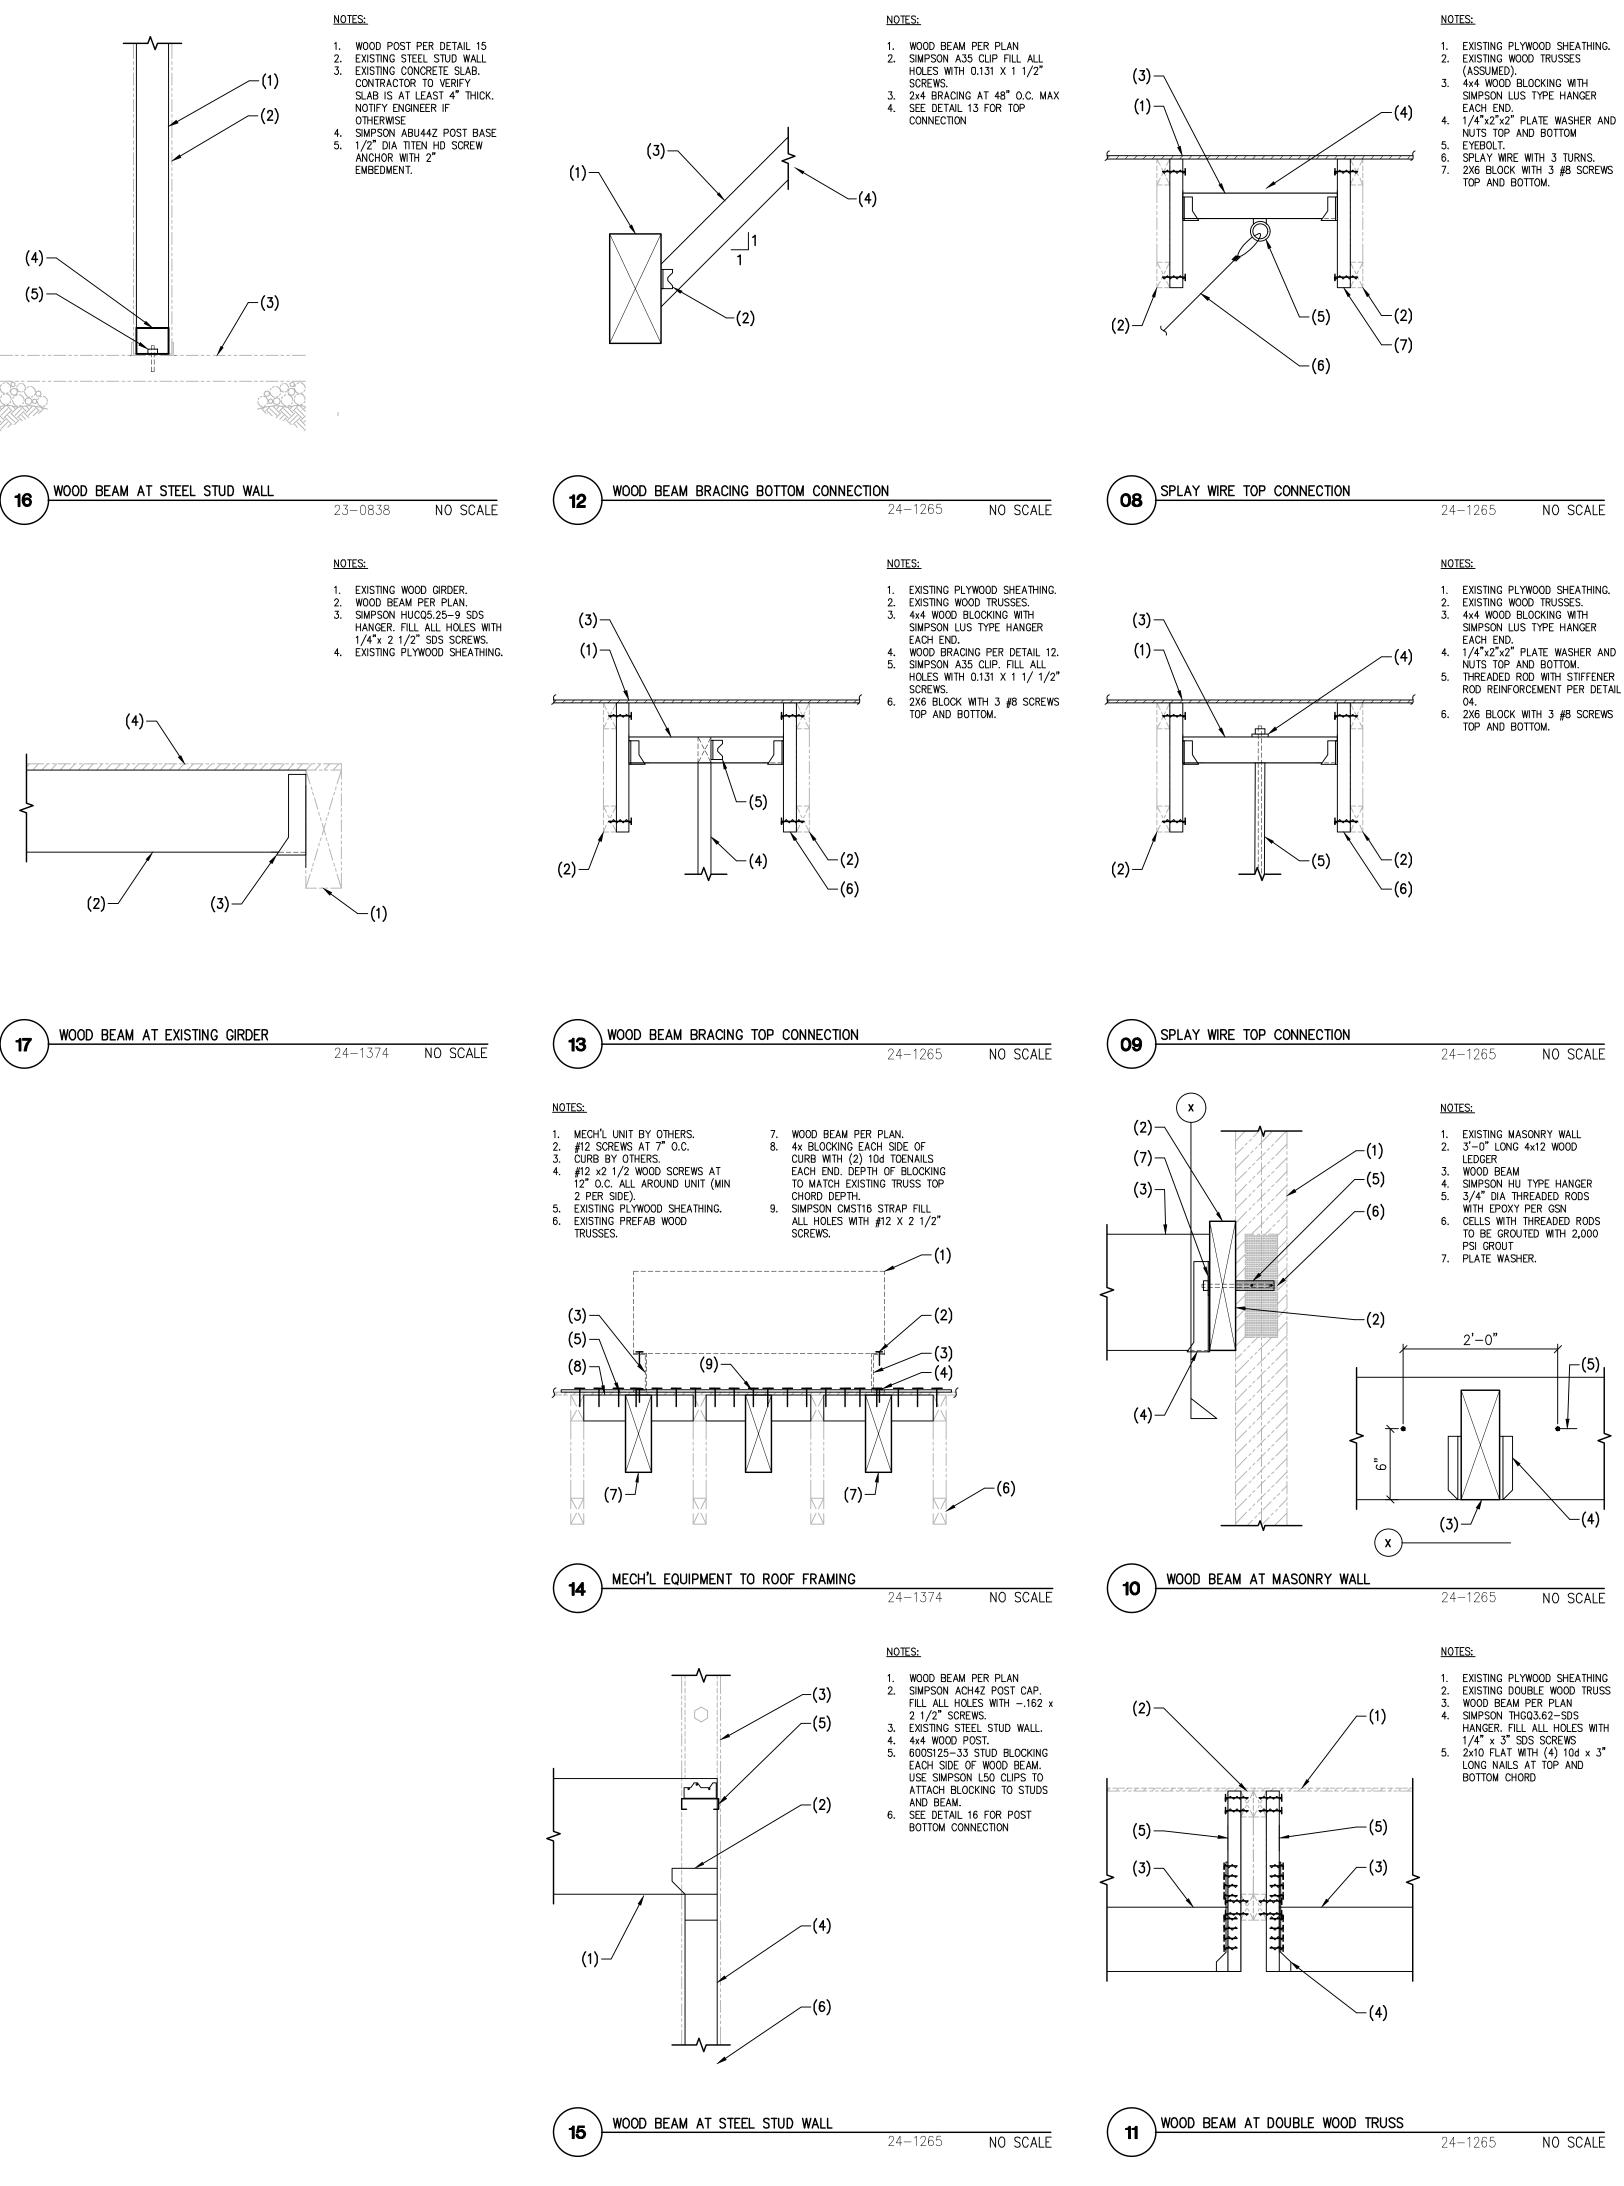

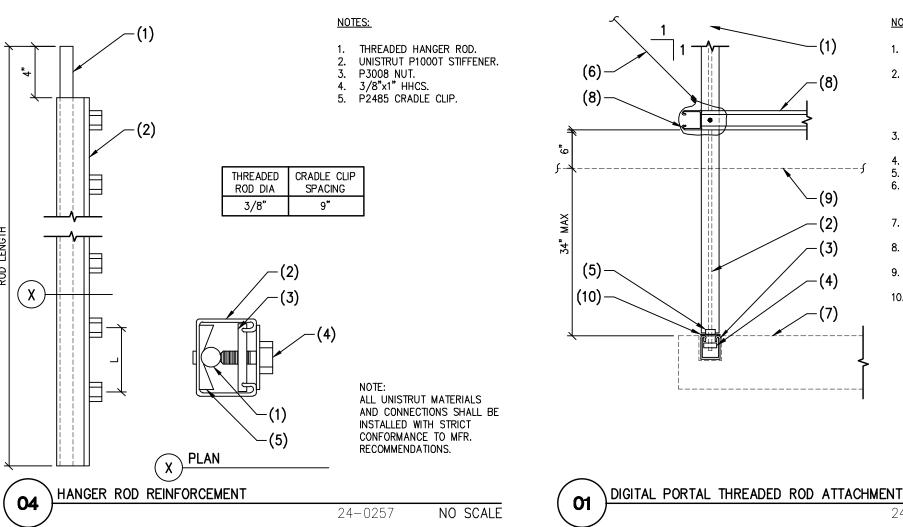

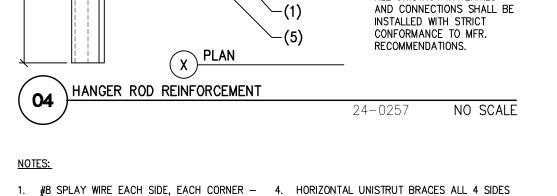


WITH CONNECTIONS PER DETAIL 01 AND 07.

NO SCALE

NO SCALE


24-0257

INTEGRAL UNISTRUT PER VENDOR.

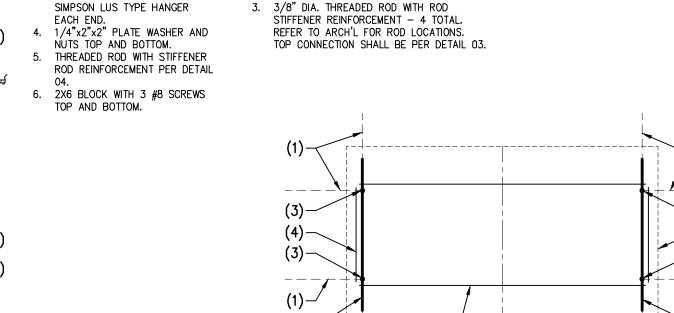



8 TOTAL PER DETAIL 01.


2. OUTLINE OF DIGITAL PORTAL BY OTHERS.

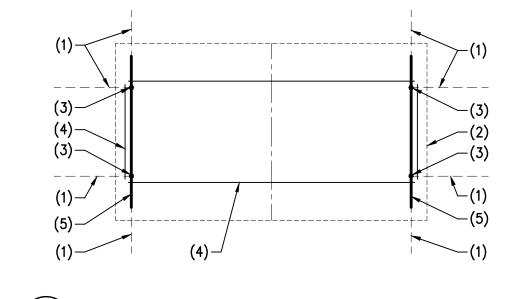


PLAN - SUSPENDED DIGITAL PORTAL

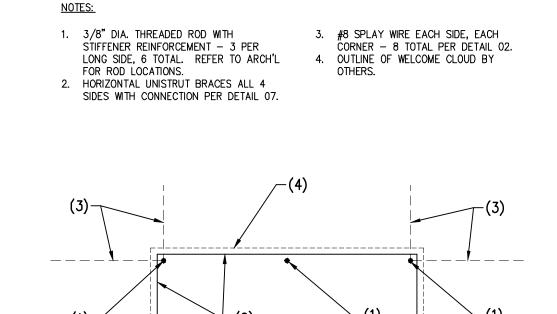


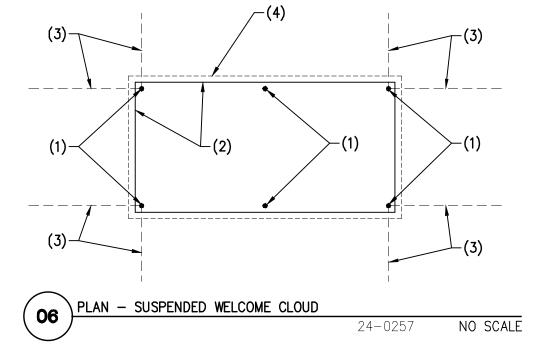


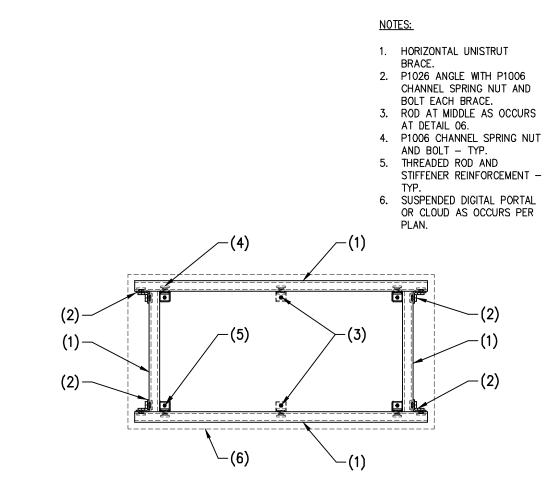


PLAN - HORIZONTAL BRACE AT STIFFENER CONNECTION

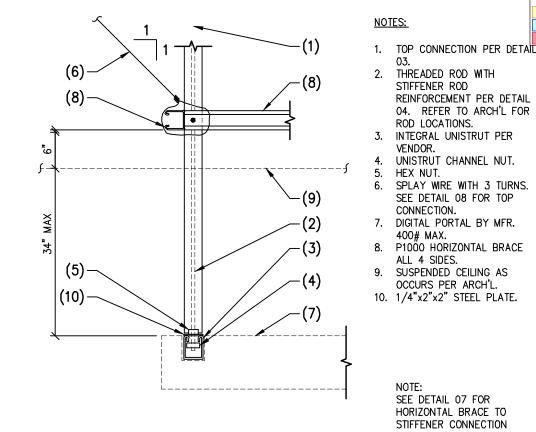

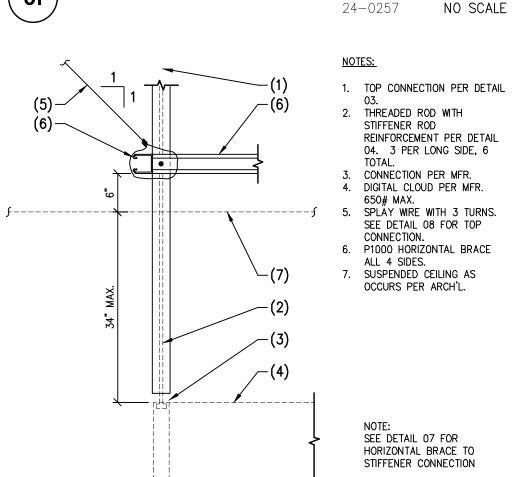

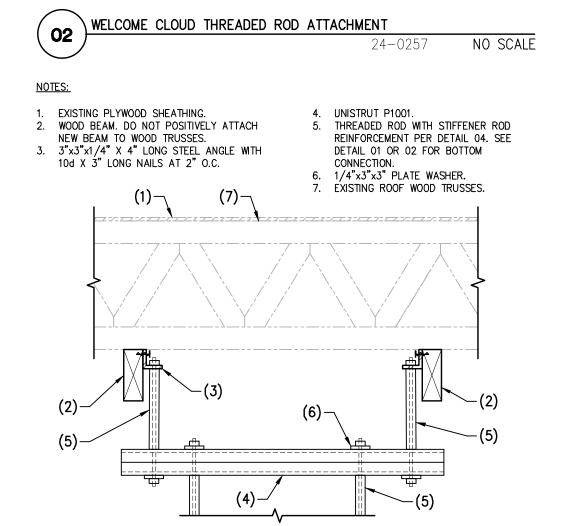

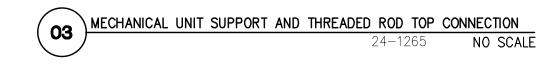

FOR ADDITIONAL INFORMATION SHOWN BUT NOT NOTED, SEE GENERAL STRUCTURAL NOTES ON SHEET S101 AND TYPICAL DETAIL SHEETS.

CONSTRUCTION OR RECORDING UNLESS THE STRUCTURAL ENGINEER OF

PROJECT NUMBER 24-1374 PROJECT MANAGER

RECORD'S SEAL IS AFFIXED WITH WRITTEN SIGNATURE.

CARUSO

TURLEY

SCOTT

structural

engineers

PROJECT ENGINEER

THESE DRAWINGS/CALCULATIONS ARE CONSIDERED PRELIMINARY -NOT FOR

JKC PROJECT DRAFTER


1215 West Rio Salado Parkway

Tempe, Arizona 85281

Suite 200

(480) 774-1700

www.ctsaz.com

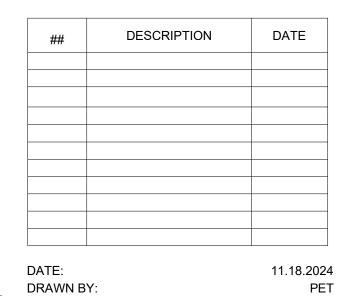

DETAILS

S102

H MERIDIAN
AVE SE
A227 S MERIDIAN SUIT
PUYALLUP, WA 9837

12920 SE 38th STREET

BELLEVUE, WA 98006

WWW.T-MOBILE.COM

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IN CESSATION OF CONSTRUCTION, BUILDING SEIZURE, AND/OR MONETARY LIABILITY.

PROJECT TYPE: CORP NEW 8022

PROTOTYPE RELEASE: Q3 2024





PARTIAL ROOF FRAMING PLAN

EXISTING WOOD TRUSSES AT 24" O.C. MAX.

SCALE: 1/4" = 1'-0"

12920 SE 38th STREET

BELLEVUE, WA 98006 WWW.T-MOBILE.COM

PRCTI20241902

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ROOF FRAMING NOTES - TYP U.N.O.:

VERIFY ALL DIMENSIONS AND ELEVATIONS WITH THE ARCHITECTURAL DRAWINGS AND FIELD CONDITIONS. BUILDING DIMENSIONS AND ELEVATIONS, WHERE SHOWN, WERE PROVIDED BY THE ARCHITECT AND IT IS THE CONTRACTOR'S RESPONSIBILITY TO VERIFY AND COORDINATE ALL DIMENSIONS PRIOR TO PROCEEDING WITH THE WORK. ANY DISCREPANCIES SHALL BE RESOLVED THROUGH THE ARCHITECT.

FOR CLARITY, DETAILS MAY SHOW ONLY ONE SIDE OF FRAMING CONDITIONS. ALL OPENINGS MAY NOT BE SHOWN ON THIS PLAN. FOR EXACT SIZE, NUMBER AND LOCATION OF OPENINGS, SEE ARCHITECTURAL, MECHANICAL, PLUMBING, ELECTRICAL, SPRINKLER AND THEIR RELATED DRAWINGS. FOR FRAMING AT OPENINGS, SEE TYPICAL

- VERIFY EXACT SIZE, WEIGHT AND LOCATION OF EQUIPMENT AND SUPPORTS INDICATED ON PLAN WITH ARCHITECTURAL, MECHANICAL, PLUMBING, ELECTRICAL, SPRINKLER AND THEIR RELATED DRAWINGS. EQUIPMENT INDICATED ARE ONLY THOSE THAT EXCEED LOADS SPECIFIED IN THE G.S.N. FOR SUPPORT OF EQUIPMENT, SEE TYPICAL DETAILS AND OTHER TRADES.
- THE EXISTING CONDITIONS DEPICTED ON THESE DRAWINGS ARE BASED ON APEX TECH SOLUTIONS SURVEY DATA DATED 10/15/2024 AND SHALL BE VERIFIED BY THE CONTRACTOR PRIOR TO CONSTRUCTION. ANY DISCREPANCIES SHALL BE BROUGHT TO

25 BRACE WOOD BEAM PER DETAIL 12.

THE ATTENTION OF THE STRUCTURAL ENGINEER IMMEDIATELY.

FRAMING KEYNOTES

940-11

CONTRACTOR TO VERIFY TRUSSES ARE 19'-2" LONG (MAX). NOTIFY ENGINEER IF OTHERWISE.

23 EXISTING INTERIOR DEMISING WALL.

(24) EXISTING STEEL COLUMN.

(22) EXISTING EXTERIOR WALL.

43RD

 ∞

JTH MERIDIAN & AVE SE

4227 S MERIDIAN SUITE E
PUYALLUP, WA 98373

PROJECT TYPE: CORP NEW

DESIG E1Y

8022

PROTOTYPE RELEASE: Q3 2024





##	DESCRIPTION	DATE

11.18.2024

PET

DATE:

DRAWN BY:

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