


UNDERGROUND NOTES:

- ALL UNDERGROUND BY OTHERS. CONTRACTOR TO BE STATE LICENSED AND CERTIFIED TO INSTALL UNDERGROUND PIPING PER WAC 212-80.
- 2) PIPE TYPE AND CLASS TO MEET LOCAL JURISDICTION APPROVAL.
- 3) ALL UNDERGROUND PIPING SHALL HAVE A MINIMUM 3'-0" BURY.
- 4) ALL UNDERGROUND PIPING SHALL BE U.L. LISTED
- AND/OR FM APPROVED FOR FIRE PROTECTION.
 5) ALL UNDERGROUND PIPING SHALL BE RODDED AND/OF
- BLOCKED IN ACCORDANCE WITH THE SPECIFICATIONS
 AND NFPA 24.
- 6) ALL UNDERGROUND PIPING SHALL BE
 HYDROSTATICALLY TESTED AT NOT LESS THAN 200 PS
 FOR TWO HOURS IN ACCORDANCE WITH NFPA 24.
 7) ALL UNDERGROUND PIPING SHALL BE FLUSHED IN
- ACCORDANCE WITH NFPA 24. FLOW THE REQUIRED RATE UNTIL WATER IS CLEAR AS INDICATED BY NO COLLECTION OF FOREIGN MATERIAL IN BURLAP BAGS AT OUTLETS.
- 4" 390 GPM 10" 2,400 GPM
- 6" 880 GPM 12" 3,520 GPM
- 8" 1,560 GPM
- 8) ALL UNDERGROUND INSTALLATION AND TESTING TO BI WITNESSED BY THE LOCAL AUTHORITY HAVING JURISDICTION.
- 9) WHERE PIPES PASSES THROUGH HOLES IN FOUNDATIONS, WALLS, OR FLOORS, THE HOLES OR SLEEVE SHALL BE SIZED 4 IN. LARGER THAN THE SUPPLY PIPE SIZE ON PIPES SIZED 4" OR LARGER.

₹	PROJECT EAST TOWN CROSSING BUILDING	ADDRESS 2902 E PIONEER			INCE OF I AILS				A Fire	01-02-12-	Corporation EST.	Cont. Lic. # SPKINFP01	Date: 12/03/2024 Drawn: AJP
		BY											
	REVISIONS	DESCRIPTION											
		DATE											
	O I I ONIT II ISNOO NOITOI I GESNOO a & a		ADDRESS 7809 PACIFIC AVE	arv TACOMA, WA 98408		SUPER. ADAIN RATGOR	0.00-1.00-2	TINSPECTIONS			MAME OILLOFFOIALLOF	PHONE # (253) 864-4165	
	STANDARD SYMBOLS	Pipe Coupling	Pipe Drop	Pipe Rise	Pipe End Cap	2-WAY EARTHQUAKE BRACE	4-WAY EARTHQUAKE BRACE	PIPE HANGER	Hydraulic Reference Points		Elev. Below Top of Steel	Elev. Above Finished Floor	Ceiling Height
		+	ф	ψ	T	1	1	1)	[18 Bts]	[8-6]	<u>-</u>
		EX EC 3	pires 1, 25	7 Y	VASI	IIN IFI	EV GTON CATE	N ST	TATE	M		EN:	:

City of Puyallup
Development & Permitting Services
ISSUED PERMIT
Building Planning
Engineering Public Works

Traffic

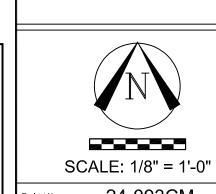

Joseph G. Faulkner 9491-0699-CEG Level 3

Sprinx Fire Protection, Inc.

Joseph D hardfor 03/17/2029 Signature Date

SPRINFP011LS/

SYMBOL COUNT THREAD K-FACTOR DESCRIPTION NOTE

1 266 1/2" 4.9 HEAD1= VIKING VK468 WHITE RESIDENTIAL RECESSED PENDENT 175"F. on Drop

1 72 1" 5.6 SIDE1= VIKING VK178 QR CHROME DRY HORIZONTAL SIDEWALL 200"F.


338 = TOTAL NUMBER OF HEADS BUILDING D


Project No. 24-093CM
Sheet Title:

DETAILS

Sheet Number:

File Name: ETC SITE PLAN.dwg

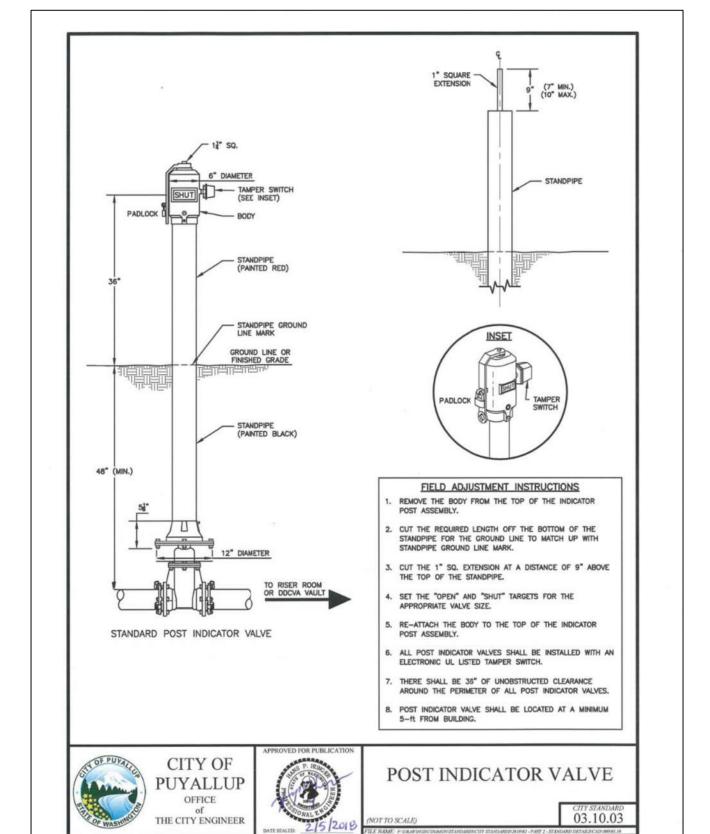

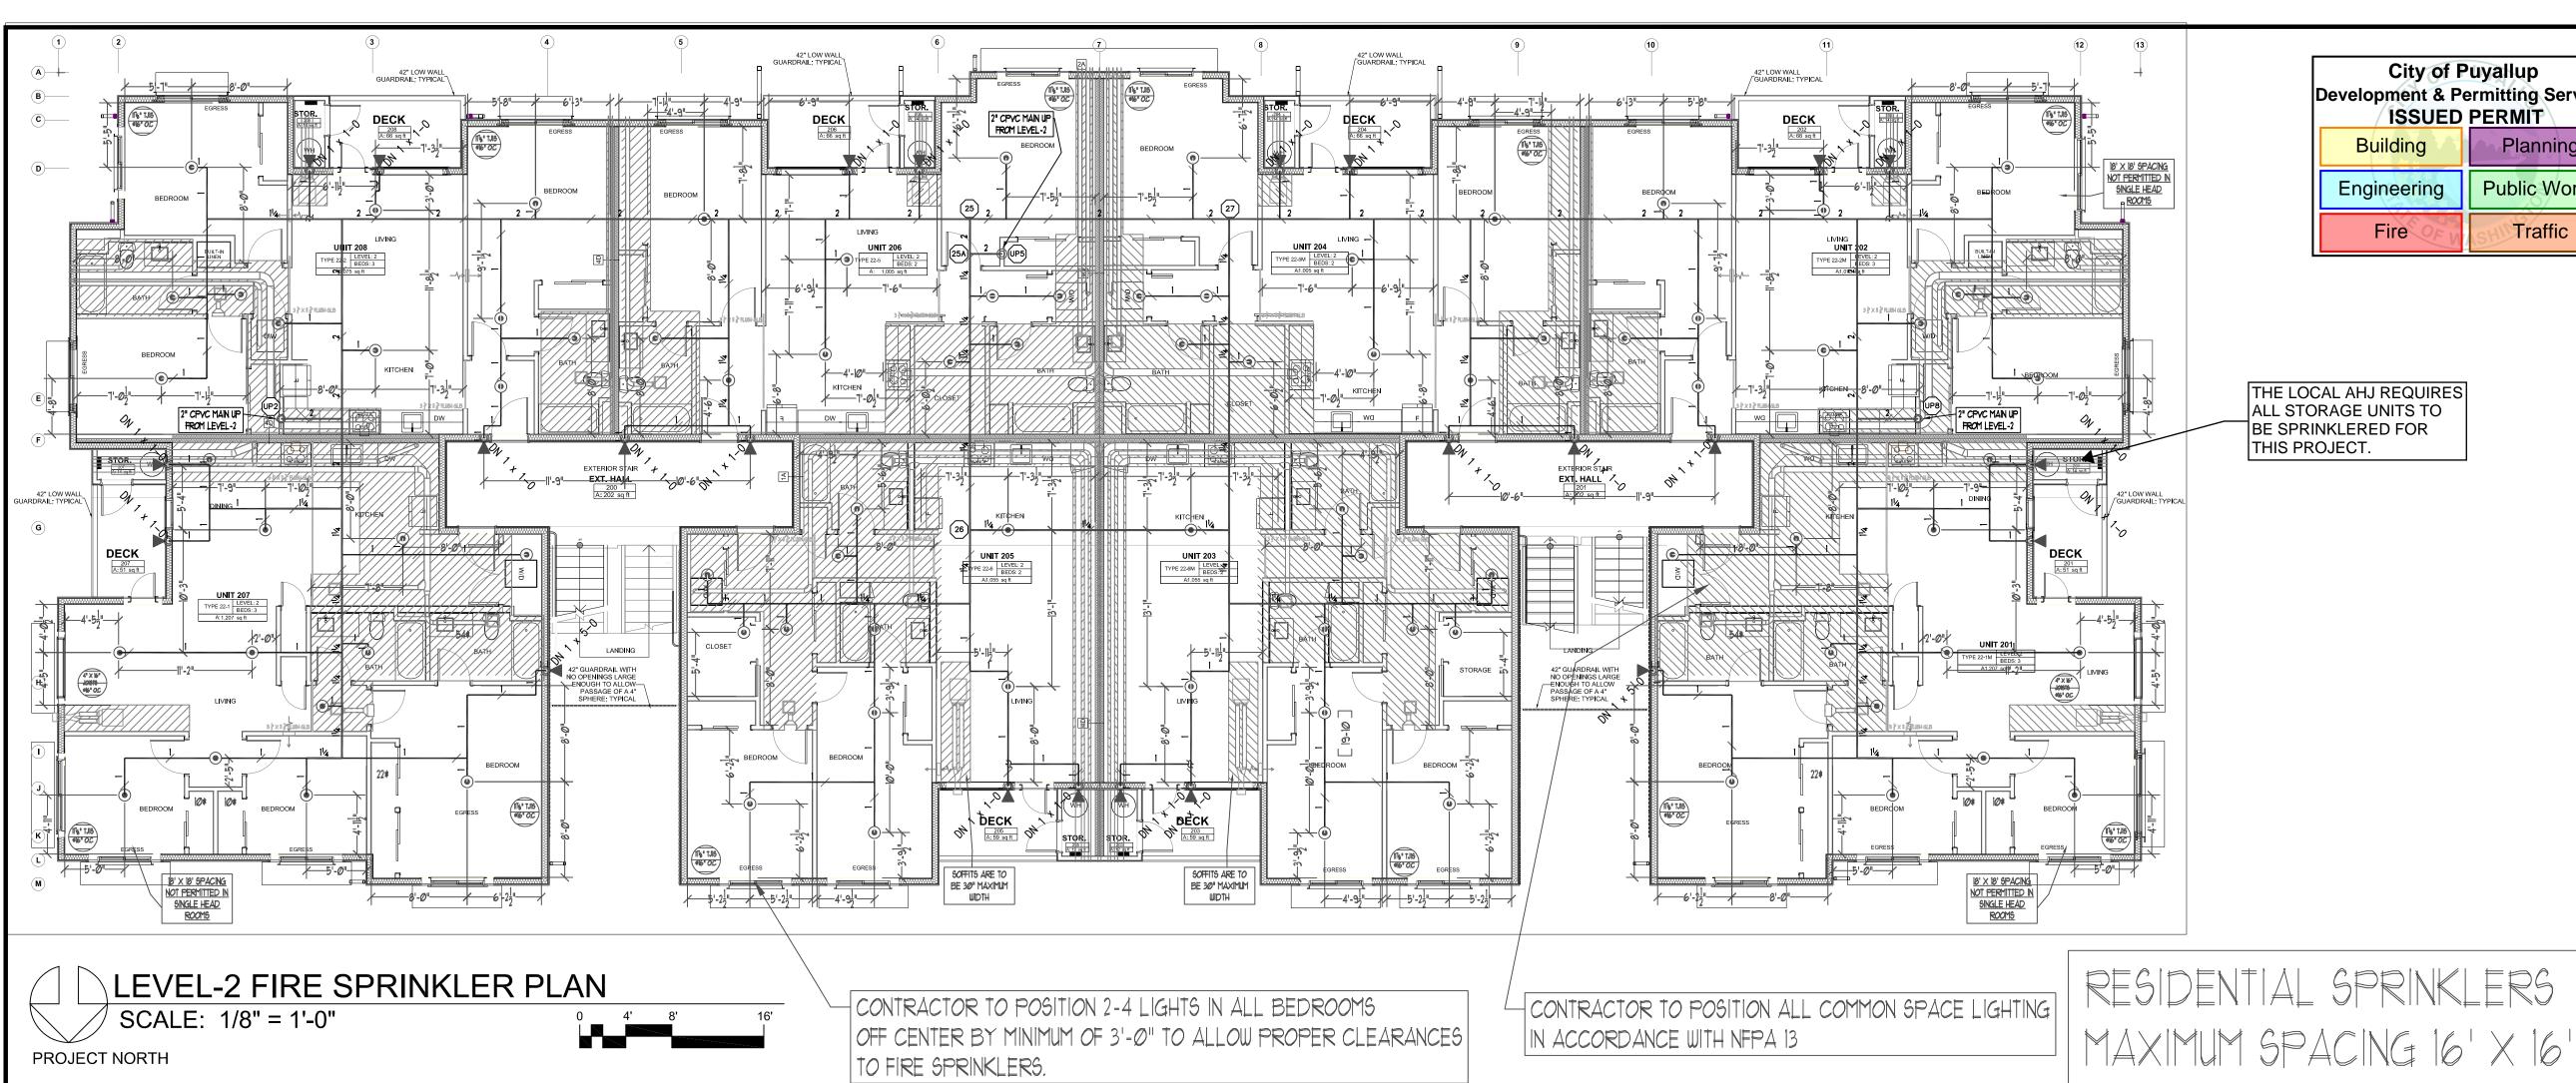

City of Puyallup **Development & Permitting Services ISSUED PERMIT** Planning Building

Public Works Engineering Fire Traffic

THE LOCAL AHJ REQUIRES ALL STORAGE UNITS TO BE SPRINKLERED FOR THIS PROJECT.

SCOPE OF WORK

INSTALL AUTOMATIC WET FIRE SPRINKLER SYSTEM FOR MULTI FAMILY DWELLING IN ACCORDANCE WITH NFPA 13R 2019 EDITION AND LOCAL AUTHORITY.

GENERAL NOTES

ALL PIPING AND SPRINKLERS SHALL BE U.L. LISTED AND/OR F.M. APPROVED. AND SHALL BE NEW AND FREE OF DEFECTS.
HANGER TYPES AND SPACING SHALL BE INSTALLED PER NFPA 13R AND

MANUFACTURER'S LISTING. SPRINKLER LOCATIONS AND SPACING PER NFPA 13R AND MANUFACTURERS LISTING. ANY AND ALL ALARM SYSTEM WIRING AND INSTALLATION IS BY OTHERS. ALL DRILLING AND BORING OF HOLES SHALL BE DONE IN STRICT ACCORDANCE WITH THE STRUCTURAL ENGINEER'S REQUIREMENTS. DO NOT UNDER ANY

CIRCUMSTANCES CUT OR MODIFY PRE-MANUFACTURED TRUSSES. INSTALLER SHALL VERIFY FINISH CEILING ELEVATION, OBSTRUCTIONS, LIGHT FIXTURES, CABINETS, ETC PRIOR TO INSTALLATION OF SPRINKLER HEADS. ALL PENETRATIONS THROUGH FIRE RATED ASSEMBLIES SHALL BE FIRE STOPPED. FIRE STOPPING MATERIAL SHALL BE INSTALLED PER MANUFACTURERS INSTRUCTION

SPRINKLER PIPE SIZING HAS BEEN ESTABLISHED BY HYDRAULIC CALCULATIONS. IT IS THE OWNER'S RESPONSIBILITY TO PROVIDE A RELIABLE WATER SUPPLY THAT IS CAPABLE OF MEETING THE MOST DEMANDING AREA.

PROJECT DETAILS

NFPA CODE: 13R 2019

SYSTEM TYPE: WET SYSTEM PIPE TYPE: BLAZEMASTER CPVC

MAX SPRINKLER SPACING REQUIREMENTS: 16'x16' @13 GPM, 18'x18' @17 GPM (1 HEAD RM.) MINIMUM SPRINKLER SPACING: 8' BETWEEN SPRINKLERS

MINIMUM DESIGN DENSITY: 0.05 GPM/SQ.FT.

NFPA & AHJ REQUIREMENTS

1. THE DESIGN DISCHARGE SHALL BE ALL OF THE SPRINKLERS WITHIN A SINGLE COMPARTMENT, UP TO A MAXIMUM OF FOUR SPRINKLERS, THAT REQUIRE THE

- GREATEST HYDRAULIC DEMAND. SPRINKLERS SHALL NOT BE REQUIRED IN BATHROOMS OF 55 SQ. FT. AND LESS. SPRINKLERS SHALL NOT BE REQUIRED IN CLOTHES CLOSETS, LINEN CLOSETS, AND PANTRIES THAT DO NOT EXCEED 24 SQ. FT. AND HAVE WALLS AND CEILINGS SURFACED WITH NONCOMBUSTIBLE OR LIMITED COMBUSTIBLE MATERIALS.
- SPRINKLERS SHALL NOT BE REQUIRED IN ATTICS OR CRAWLSPACES. SPRINKLER HEADS SHALL BE AT LEAST 3 FT, AWAY FROM CEILING FANS AND SURFACE MOUNTED LIGHT FIXTURES.
 ALL SPRINKLERS SHALL MAINTAIN THE MINIMUM REQUIRED DISTANCES FROM HEAT
- SOURCES IN ACCORDANCE WITH NFPA 13R. SPRINKLER HEADS UNDER SLOPE CEILINGS TO BE MEASURED ALONG THE SLOPE.

CPVC FIRE SPRINKLER PIPE GUIDELINES

INSTALLING CONTRACTOR TO PROVIDE AN INSTALLATION THAT IS IN 100% COMPLIANCE WITH THESE GUIDELINES. RESIDENTIAL DESIGN CANNOT BE RESPONSIBLE FOR THE WILLFUL OR NEGLIGENT ACTIONS OF OTHER PARTIES THAT DO NOT FOLLOW THE BELOW

THESE GUIDELINES ARE:

DO NOT STACK, SUPPORT, HANG EQUIPMENT, OR HANG FLEXIBLE WIRE/CABLE, ESPECIALLY COMMUNICATIONS CABLE, OR OTHER MATERIAL ON THE FIRE SPRINKLER DO NOT EXPOSE CPVC PRODUCTS TO INCOMPATIBLE SUBSTANCES, SUCH AS CUTTING OILS, NON-WATER-BASED PAINTS, PACKING OILS, TRADITIONAL PIPE THREAD PASTE AND DOPE, FUNGICIDES, TERMITICIDES, INSECTICIDES, DETERGENTS, BULKING CAULKING, ADHESIVE TAPE, SOLDER FLUX, FLEXIBLE WIRE/CABLE (WITH SPECIAL CONSIDERATION FOR COMMUNICATIONS CABLING), AND NON-APPROVED SPRAY FOAM INSULATION MATERIALS.

 DO NOT EXPOSE CPVC PRODUCTS TO EDIBLE OILS, SOLVENTS, OR GLYCOL-BASED ANTI-FREEZE FLUIDS. DO NOT EXPOSE CPVC PRODUCTS TO OPEN FLAME, SOLDER, AND SOLDERING

DO NOT DROP, DISTORT, OR IMPACT CPVC PRODUCTS OR ALLOW OBJECTS TO BE DROPPED ON THEM.

• DO NOT HANDLE CPVC PRODUCTS WITH GLOVES CONTAMINATED WITH OILS

HYDROCARBONS) OR OTHER INCOMPATIBLE MATERIALS.


DO NOT INJECT SYSTEM WITH M.I.C. INHIBITORS UNLESS THEY ARE LISTED IN FAILURE TO FOLLOW THIS NOTICE MAY CAUSE CRACKS OR FRACTURES TO DEVELOP IN

CPVC PRODUCTS RESULTING IN PROPERTY DAMAGE DUE TO LEAKS OR FLOODING. THE PRESENCE OF ANY VISIBLE CRACKS MAY REQUIRE PARTIAL OR FULL SYSTEM


FREEZE PROTECTION


REPLACEMENT.

THIS SYSTEM IS A WET SYSTEM, PRECAUTION MUST BE TAKEN TO PROTECT THE PIPING FROM EXTREME FREEZING TEMPERATURES. IT IS THE RESPONSIBILITY OF THE OWNER AND INSULATION INSTALLER TO ENSURE SUFFICIENT INSULATION IS PROVIDED AND INSTALLED CORRECTLY TO MAINTAIN ALL PIPING AT 40 DEG MINIMUM IN ALL AREAS, THE METHOD TO ACHIEVE THIS CONTROL OF TEMPERATURE SHALL BE IN ACCORDANCE WITH NFPA 13R. DESIGNER AND ENGINEER OF RECORD WILL NOT BE

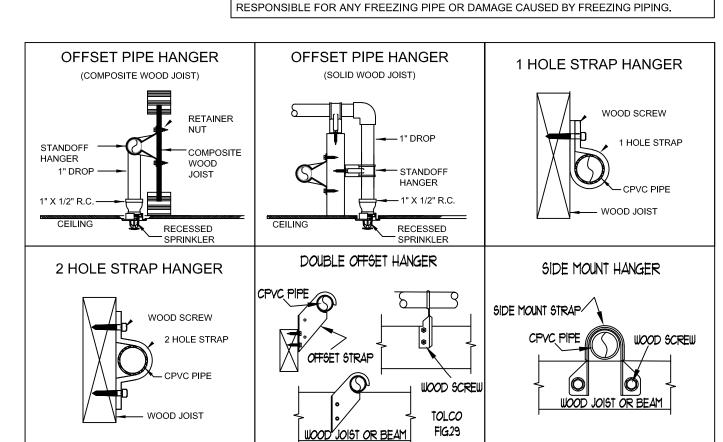

THE LOCAL AHJ REQUIRES ALL STORAGE UNITS TO BE SPRINKLERED FOR THIS PROJECT.

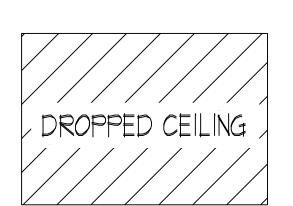

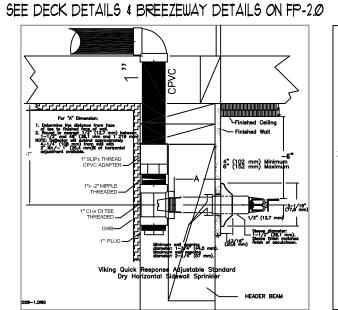

* DO NOT STUB DOWN DSW'S ON LEVELS 142

	Installed with a Microfast Model F—1 Adjustable Escutcheon
)	2" (50.8 mm) Maximum Figure 3 Viking Residential Pendent K4.9 Sprinkler 13637 (VK468)
	Technical data page 149m-t VIKING VK-468 RESIDENTIAL RECESSED PENDENT

EXPIRES CERTIFICATE OF COMPETENCE SPRINKLER SYSTEMS Joseph G. Faulkner 9491-0699-CEG Level 3 Signature Date


WA. STATE LEVEL 3 STAMP

SCALE: 1/8" = 1'-0"

24-093CM

BLDG-D LEVELS 1 & 2

File Name: ETC Building D.dwg

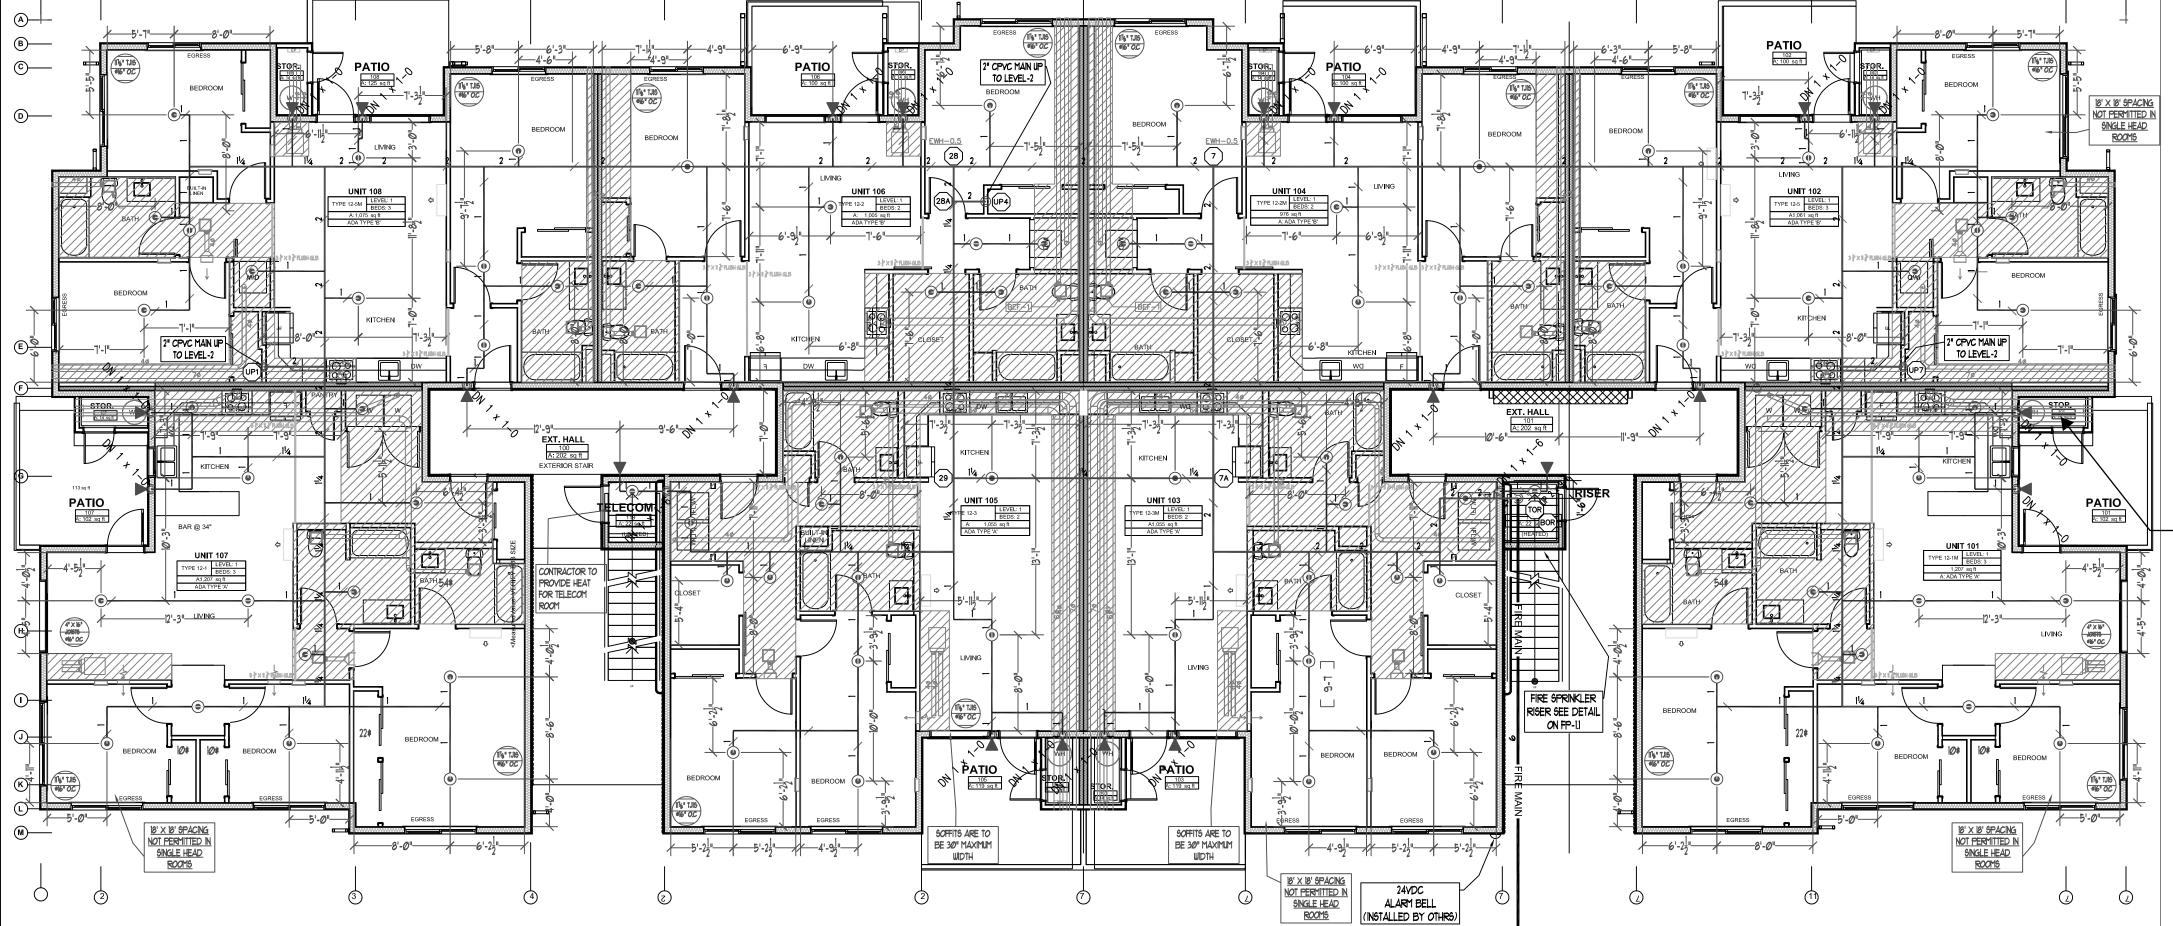

LEVEL-1 FIRE SPRINKLER PLAN

SCALE: 1/8" = 1'-0"

PROJECT NORTH

				CDDINKLED HEAD CCHEDIHE			
SPRINKLER HEAD SCHEDULE							
SYMBOL	COUNT	THREAD	K-FACTOR	DESCRIPTION	NOTE		
L O TIVIDOL	1000111	1111112/10	17.0101	BESSIAII IISIA	1101		
	266	1 /2"	4.9	HEAD1= VIKING VK468 WHITE RESIDENTIAL RECESSED PENDENT 175°F.	on Drop		
●	200	1/2	7.3	TIEADT WINNO WITTE RESIDENTIAL REGESSED FENDENT 1751.	l ou prob		
	70	4 22	E 6	CIDE1_ VIVING VIVITE OD CUDOME DRY HODIZONITAL CIDEWALL 200°F			
	72	1	5.6	SIDE1= VIKING VK178 QR CHROME DRY HORIZONTAL SIDEWALL 200°F.			
		'	'	338 = TOTAL NUMBER OF HEADS BUILDING D			
				JJO - TOTAL NOWIDER OF FILADS BUILDING D			

