Applies unless noted otherwise on drawings

2021 EDITION OF THE INTERNATIONAL BUILDING CODE AND STANDARDS REFERENCED THEREIN,

ALL POST-INSTALLED ANCHORS SHALL UTILIZE THE EXACT ANCHORAGE SYSTEM SPECIFIED IN THE STRUCTURAL DETAILS. WHERE ANCHORAGE "PER GSN" IS SPECIFIED, SEE BELOW. ANCHORAGE PRODUCTS MAY NOT BE SWAPPED BETWEEN MANUFACTURERS WITHOUT APPROVAL OF THE ENGINEER OF RECORD. ALL REQUESTS FOR EQUIVALENT ANCHORAGE PRODUCTS MUST BE SUBMITTED TO THE ENGINEER OF RECORD FOR APPROVAL PRIOR TO BEING INSTALLED IN THE

UNLESS NOTED OTHERWISE POST INSTALLED ANCHORS SHALL NOT BE INSTALLED UNTIL CONCRETE OR MASONRY MATERIAL HAVE REACHED DESIGN STRENGTH AND HAVE BEEN FULLY

INSTALLERS OF POST-INSTALLED ANCHORS. ALL ANCHORS SHALL BE INSTALLED WITH STEEL WASHERS AT SHORT SLOTTED HOLES IN ACCORDANCE WITH THE MANUFACTURERS PRINTED NSTALLATION INSTRUCTIONS (MPII). ALL ANCHORS SHALL TIGHTENED/TORQUED AS REQUIRED

ALL EXPANSION TYPE ANCHORAGE FOR MASONRY INSTALLATION ONLY SHALL BE PER HILTI 'KWIK BOLT-TZ2' EXPANSION ANCHOR PER ICC ESR-4561 OR APPROVED ICC EQUIVALENT. ALL EPOXY ADHESIVE TYPE ANCHORAGE FOR MASONRY INSTALLATION ONLY SHALL BE PER HILTI 'HIT-HY 270' ADHESIVE ANCHOR ICC ESR-4143 OR APPROVED ICC EQUIVALENT. ALL SCREW TYPE ANCHORAGE FOR MASONRY INSTALLATION ONLY SHALL BE PER HILTI 'KWIK HUS-EZ' SCREW

ALL STEEL CONSTRUCTION SHALL BE PER THE REFERENCED AISC STEEL CONSTRUCTION MANUAL. ALL MISCELLANEOUS STEEL, INCLUDING THREADED ROD STEEL, UNLESS NOTED

UNLESS NOTED OTHERWISE, ALL BOLTS SHALL BE ASTM A307. A325 BOLTS MAY BE SUBSTITUTED FOR A307 BOLTS AT THE CONTRACTOR'S OPTION, REVERSE SUBSTITUTION IS NOT PERMITTED. ALL BOLTS SHALL BE INSTALLED WITH STEEL WASHERS AT SHORT SLOTTED HOLES

UNLESS SPECIFICALLY EXCLUDED ON PLAN, CONTRACTOR MAY PROVIDE SEALED SHOP DRAWINGS AND CALCULATIONS FOR 16, 12 OR 10 GAGE (50 KSI) QUICKFRAMES ADJUSTABLE FRAMES AT THE MECHANICAL ROOFTOP UNITS AND/OR ROOF PENETRATIONS. (NOTE: THIS MUST

THESE QUICKFRAMES, OR THE OPENING THEY SPAN, SHALL NOT BE PLACED SO AS TO INTERFERE WITH THE REQUIREMENTS OF OTHER STRUCTURAL ELEMENTS (I.E. DRAG STRUTS, BEAMS, PURLINS, SUBPURLINS, ANGLES, ETC.) WITHOUT THE PRIOR APPROVAL OF THE STRUCTURAL

FOR ADDITIONAL INFORMATION AT OPENINGS IN STEEL ROOF FRAMING, SEE TYPICAL DETAILS. QUICKFRAMES ADJUSTABLE FRAMES SHALL BE AS MANUFACTURED BY QUICKFRAMES USA, LLC,

WOOD FRAMING MEMBERS SHALL NOT BE NOTCHED OR DRILLED WITHOUT PRIOR APPROVAL OF THE STRUCTURAL ENGINEER THROUGH THE ARCHITECT. STRUCTURAL WOOD FRAMING MEMBERS SHALL HAVE A MAXIMUM MOISTURE CONTENT OF 19% WHEN DELIVERED TO THE JOB SITE. ALL NAILING NOT NOTED SHALL BE PER TYPICAL DETAIL AND COMMON NAIL DIAMETER TABLE BELOW. ALL BOLTING SHALL BE PER STRUCTURAL STEEL SECTION. WOOD CONNECTORS SHALL BE AS MANUFACTURED BY SIMPSON STRONG-TIE COMPANY, INC. OR OTHER MANUFACTURER WITH CURRENT AND EQUIVALENT ICC APPROVAL. WHERE "TYPE" OF CONNECTOR IS INDICATED ON THE DRAWINGS, THE CONNECTOR AND ATTACHMENT SHALL BE PER THE MAXIMUM MODEL NUMBER BASED ON THE SIZE OF THE MEMBERS CONNECTED.

NAIL TYPE REQ'D DIA REQ'D GA LENGTH NAIL TYPE REQ'D DIA REQ'D GA LENGTH 0.148" 9

FRAMING LUMBER SHALL COMPLY WITH THE REFERENCED EDITION OF THE GRADING RULES OF THE WWPA OR THE WCLIB. ALL SAWN LUMBER SHALL BE STAMPED WITH THE GRADE MARK OF AN APPROVED LUMBER GRADING AGENCY AND SHALL HAVE MINIMUM PROPERTIES WHICH MEET OR

ALL BEAMS SHALL BE FABRICATED USING WATERPROOF GLUE. FABRICATION AND HANDLING PER REFERENCED AITC AND WCLA STANDARDS. SUPPLIER SHALL VERIFY WITH ARCHITECT THE GRADE FINISH OF ALL ARCHITECTURALLY EXPOSED FRAMING MEMBERS. BEAMS TO BEAR GRADE STAMP AND AITC STAMP AND CERTIFICATE. CAMBER AS SHOWN ON DRAWINGS. STANDARD CAMBER (STD) IS DEFINED AS RADIUS OF CURVATURE EQUAL TO 3,500 FEET MINIMUM.

ALL STRUCTURAL GLUED-LAMINATED BEAMS RATED FOR FIRE ENDURANCE SHALL MEET THE REQUIREMENTS OF CHAPTER 16 OF THE AF & PA NATIONAL DESIGN SPECIFICATION. MEMBERS RATED FOR 1-HOUR FIRE ENDURANCE SHALL HAVE THE OUTERMOST INTERIOR CORE LAMINATION SUBSTITUTED WITH AN ADDITIONAL TENSION LAMINATION ON THE TENSION SIDE FOR UNBALANCED (SIMPLE SPAN) BEAMS AND ON BOTH SIDES FOR BALANCED (CANTILEVER) BEAMS.

DEFERRED SUBMITTALS:

T&G ---- TONGUE AND GROOVE

W.W.F.- - - - WELDED WIRE FABRIC

W/O --- -- WITHOUT

VERT - - - - VERTICAL REINFORCING

U.N.O.- - - - UNLESS NOTED OTHERWISE

W/C---- Water to cement ratio

WCLA - - - - - WEST COAST LUMBER ASSOCIATION

WCLIB - - - - - WEST COAST LUMBER INSPECTION

ASSOCIATION

BUREAU

SHOP DRAWING SUBMITTALS REQUIRED BY THESE GENERAL STRUCTURAL NOTES WHICH CONTAIN DESIGN CALCULATIONS SEALED BY A REGISTERED ENGINEER OTHER THAN THE ENGINEER OF RECORD, SHALL BE SUBMITTED DURING CONSTRUCTION TO THE CITY FIELD INSPECTOR FOR REVIEW. THE DOCUMENTS WILL FIRST BE REVIEWED BY THE ENGINEER OF RECORD AND DETERMINED TO BE IN GENERAL CONFORMANCE WITH THE BUILDING DESIGN. THESE DEFERRED SUBMITTAL ITEMS SHALL NOT BE INSTALLED LINTIL THEIR DESIGN AND SUBMITTAL DOCUMENTS HAVE BEEN APPROVED BY THE BUILDING OFFICIAL. THE FOLLOWING ITEMS SHALL BE SUBMITTED PER THIS SECTION:

QUICKFRAMES ADJUSTABLE ROOF FRAMES BELOW ROOF TOP MECHANICAL UNITS OR OPENINGS

SHOP DRAWINGS:

SHOP DRAWINGS SHALL BE SUBMITTED FOR ALL STRUCTURAL ITEMS IN ADDITION TO ITEMS REQUIRED BY ARCHITECTURAL SPECIFICATIONS. CONTRACTOR SHALL PROVIDE A MINIMUM OF : HARD COPY SUBMITTAL SETS OF EACH ITEM TO CTS FOR REVIEW UNLESS NOTED OTHERWISE IN ARCHITECTURAL SPECIFICATIONS. ELECTRONIC SUBMITTALS ARE ALSO ACCEPTABLE

THE CONTRACTOR SHALL REVIEW ALL SHOP DRAWINGS PRIOR TO SUBMITTAL. ITEMS NOT IN ACCORDANCE WITH CONTRACT DOCUMENTS SHALL BE FLAGGED UPON CONTRACTOR'S REVIEW. THE CONTRACTOR SHALL VERIFY ALL DIMENSIONS WITH ARCHITECTURAL DRAWINGS AND FIELD

MANUFACTURER OR FABRICATOR SHALL CLOUD ANY CHANGES, SUBSTITUTIONS, OR DEVIATIONS FROM CONTRACT DOCUMENTS. CONTRACTOR SHALL BE RESPONSIBLE FOR ALL NECESSARY CHANGES, APPROVALS AND THE COORDINATION OF THE WORK WITH ALL RELATED TRADES AND SUPPLIERS. ANY OF THE AFOREMENTIONED WHICH ARE NOT CLOUDED OR FLAGGED BY SUBMITTING PARTIES, SHALL NOT BE CONSIDERED APPROVED AFTER ENGINEER'S REVIEW, UNLESS NOTED ACCORDINGLY.

THE ENGINEER HAS THE RIGHT TO APPROVE OR DISAPPROVE ANY CHANGES TO CONTRACT DOCUMENTS AT ANYTIME BEFORE OR AFTER SHOP DRAWING REVIEW.

THE SHOP DRAWINGS DO NOT REPLACE THE CONTRACT DOCUMENTS. ITEMS OMITTED OR SHOWN INCORRECTLY AND ARE NOT FLAGGED BY THE STRUCTURAL ENGINEER OR ARCHITECT SHALL NOT BE CONSIDERED CHANGES TO CONTRACT DOCUMENTS. IT IS THE CONTRACTOR'S RESPONSIBILITY TO ENSURE ITEMS ARE CONSTRUCTED TO CONTRACT DOCUMENTS.

THE ADEQUACY OF ENGINEERING DESIGNS AND LAYOUT PERFORMED BY OTHERS RESTS WITH THE DESIGNING OR SUBMITTING AUTHORITY.

REVIEWING IS INTENDED ONLY AS AN AID TO THE CONTRACTOR IN OBTAINING CORRECT SHOP DRAWINGS. RESPONSIBILITY FOR CORRECTNESS SHALL REST WITH THE CONTRACTOR.

GENERAL NOTES:

THE STRUCTURAL CONSTRUCTION DOCUMENTS REPRESENT THE FINISHED STRUCTURE. EXCEPT WHERE NOTED, THEY DO NOT INDICATE THE METHOD OF CONSTRUCTION. THE CONTRACTOR SHALL PROVIDE ALL MEASURES NECESSARY TO PROTECT THE STRUCTURE DURING CONSTRUCTION. SUCH MEASURES SHALL INCLUDE, BUT NOT BE LIMITED TO, BRACING, SHORING FOR LOADS DUE TO CONSTRUCTION EQUIPMENT, ETC. THE STRUCTURAL ENGINEER OF RECORD SHALL NOT BE RESPONSIBLE FOR THE CONTRACTOR'S MEANS, METHODS, TECHNIQUES, SEQUENCES FOR PROCEDURE OF CONSTRUCTION, OR THE SAFETY PRECAUTIONS AND THE PROGRAMS INCIDENT THERETO (NOR SHALL OBSERVATION VISITS TO THE SITE INCLUDE INSPECTION OF THESE ITEMS).

WHERE REFERENCE IS MADE TO VARIOUS TEST STANDARDS FOR MATERIALS, SUCH STANDARDS SHALL BE THE REFERENCED EDITION AND/OR ADDENDA. ANY ENGINEERING DESIGN, PROVIDED BY OTHERS AND SUBMITTED FOR REVIEW, SHALL BEAR THE SEAL OF A REGISTERED ENGINEER RECOGNIZED BY THE BUILDING CODE JURISDICTION OF THIS PROJECT.

NOTES AND DETAILS ON DRAWINGS SHALL TAKE PRECEDENCE OVER GENERAL STRUCTURAL NOTES AND TYPICAL DETAILS. WHERE NO DETAILS ARE SHOWN, CONSTRUCTION SHALL CONFORM TO SIMILAR WORK ON THE PROJECT, AND/OR AS PROVIDED FOR IN THE CONTRACT DOCUMENTS. WHERE DISCREPANCIES OCCUR BETWEEN PLANS, DETAILS, GENERAL STRUCTURAL NOTES AND SPECIFICATIONS, THE GREATER REQUIREMENTS SHALL GOVERN.

THE CONTRACTOR SHALL VERIFY ALL DIMENSIONS AND ELEVATIONS WITH THE ARCHITECTURAL DRAWINGS AND FIELD CONDITIONS. BUILDING DIMENSIONS AND ELEVATIONS, WHERE SHOWN, WERE PROVIDED BY THE ARCHITECT AND IT IS THE CONTRACTOR'S RESPONSIBILITY TO VERIFY AND COORDINATE ALL DIMENSIONS PRIOR TO PROCEEDING WITH THE WORK. ANY DISCREPANCIES SHALL BE RESOLVED THROUGH THE ARCHITECT. ESTABLISH AND VERIFY ALL OPENINGS AND INSERTS FOR ARCHITECTURAL, CIVIL, MECHANICAL, PLUMBING AND ELECTRICAL ITEMS WITH THE APPROPRIATE TRADE DRAWINGS AND SUBCONTRACTORS PRIOR TO CONSTRUCTION.

TYPICAL DETAILS MAY NOT NECESSARILY BE CUT ON PLANS, BUT APPLY UNLESS NOTED

CONSTRUCTION MATERIALS SHALL BE SPREAD OUT IF PLACED ON FRAMED CONSTRUCTION. LOAD SHALL NOT EXCEED THE DESIGN LIVE LOAD PER SQUARE FOOT.

OPTIONS AND SUBSTITUTIONS ARE FOR CONTRACTOR'S CONVENIENCE. IF AN OPTION OR SUBSTITUTION IS CHOSEN, CONTRACTOR SHALL BE RESPONSIBLE FOR ALL NECESSARY CHANGES, APPROVALS AND THE COORDINATION OF THE WORK WITH ALL RELATED TRADES AND

SPECIAL INSPECTION — STRUCTURAL ONLY:

SPECIAL INSPECTIONS SHALL BE PERFORMED UNDER THE DIRECT SUPERVISION OF A STATE REGISTERED STRUCTURAL ENGINEER WHO IS FAMILIAR WITH THE STRUCTURAL DESIGN OF THIS PROJECT. THE SUPERVISING STRUCTURAL ENGINEER SHALL SEAL THE SPECIAL INSPECTION

SPECIAL INSPECTION IS TO BE PROVIDED FOR THE ITEMS LISTED BELOW IN ADDITION TO THE INSPECTIONS CONDUCTED BY THE BUILDING JURISDICTION. "SPECIAL STRUCTURAL INSPECTION" SHALL NOT RELIEVE THE OWNER OR THEIR AGENT FROM REQUESTING THE BUILDING JURISDICTION INSPECTIONS REQUIRED BY SECTION 110 OF THE INTERNATIONAL BUILDING CODE. SPECIAL INSPECTION IS REQUIRED PER CHAPTER 17 FOR THE FOLLOWING: SPECIAL CASES:

. EXPANSION, EPOXY, ADHESIVE, AND SCREW ANCHORS: DURING THE PLACEMENT OF ALL ANCHORS SHOWN ON STRUCTURAL DRAWINGS. ADDITIONAL INSPECTIONS REQUIRED FOR REPAIR DETAILS SHALL BE PERFORMED AT THE CONTRACTOR'S EXPENSE A. INSPECTION OF HOLE DIAMETER, HOLE DEPTH AND DRILL BIT CONFORMANCE.

INSPECTION OF HOLE CLEANING WITH WIRE BRUSH AND COMPRESSED AIR. INSPECTION OF ANCHOR INSTALLATION USING SPECIFIED PRODUCT AND MANUFACTURER'S RECOMMENDED INSTALLATION PROCEDURES. INSPECTION OF EXPANSION ANCHORS SHALL INCLUDE THE VERIFICATION OF THE TIGHTENING TORQUE THAT IS SPECIFIED BY THE ANCHOR MANUFACTURER.

DUTIES AND RESPONSIBILITIES OF THE SPECIAL INSPECTOR:

AUTHORIZED TO OPERATE CONTRACTOR'S EQUIPMENT.

A. THE SPECIAL INSPECTOR SHALL OBSERVE THE WORK ASSIGNED TO BE CERTAIN IT CONFORMS TO THE APPROVED DESIGN DRAWINGS AND SPECIFICATION. . THE SPECIAL INSPECTOR IS NOT AUTHORIZED TO APPROVE DEVIATIONS FROM THE DESIGN DRAWINGS OR SPECIFICATIONS. AND ALL DEVIATIONS MUST BE APPROVED BY THE STRUCTURAL ENGINEER OF RECORD PRIOR TO PROCEEDING WITH THE WORK. ALL REQUESTS FOR DEVIATIONS SHALL BE INITIATED BY THE CONTRACTOR VIA WRITTEN REQUEST FOR INFORMATION (RFI). . THE SPECIAL INSPECTOR SHALL FURNISH INSPECTION REPORTS TO THE BUILDING OFFICIAL, AND TO THE ENGINEER OR ARCHITECT OF RECORD. ALL DISCREPANCIES SHALL BE BROUGHT TO THE IMMEDIATE ATTENTION OF THE CONTRACTOR FOR CORRECTION, THEN, IF UNCORRECTED, TO THE DESIGN AUTHORITY AND THE BUILDING OFFICIAL.). THE CONTRACTOR SHALL PROVIDE THE SPECIAL INSPECTOR ACCESS TO ALL ITEMS REQUIRING SPECIAL INSPECTION. ACCESS SHALL BE PROVIDED BY IN-PLACE LADDERS, SCAFFOLDS, LIFTS AND/OR OTHER EQUIPMENT OPERATED BY THE CONTRACTOR'S PERSONNEL AS REQUIRED FOR SAFE OBSERVATION. THE SPECIAL INSPECTOR IS NOT RESPONSIBLE OR

UPON COMPLETION OF THE ASSIGNED WORK THE ENGINEER OR ARCHITECT IN CHARGE OF

TO THE BEST OF THEIR KNOWLEDGE THE WORK IS IN CONFORMANCE WITH THE APPROVED PLANS

SPECIAL INSPECTIONS SHALL COMPLETE AND SIGN THE APPROPRIATE FORMS CERTIFYING THAT

AND SPECIFICATIONS, AND THE APPLICABLE WORKMANSHIP PROVISIONS OF THE CODE.

BELLEVUE, WA 98006 WWW.T-MOBILE.COM

Approval of submitted plans is not an

regulations of local government. The

codes and regulations of the local

The approved construction plans,

government.

inspection.

& Industries.

1-800-647-0982

contractor is responsible for making sure

documents, and all engineering must be

Full sized legible color plans are required

to be provided by the permitee on site for

Separate Electrical Permit is required with

the Washington State Department of Labor

https://lni.wa.gov/licensing-permits/electrical

City of Puyallup

Building

REVIEWED

FOR

COMPLIANCE

SKinnear

05/20/2025

1:14:37 PM

FOR ADDITIONAL INFORMATION SHOWN BUT NOT NOTED, SEE GENERAL

CONSTRUCTION OR RECORDING UNLESS THE STRUCTURAL ENGINEER OF

THESE DRAWINGS/CALCULATIONS ARE CONSIDERED PRELIMINARY -NOT FOR

PROJECT NUMBER 24-1374 PROJECT MANAGER TRM

1215 West Rio Salado Parkway

Suite 200

(480) 774-1700

www.ctsaz.com

Tempe, Arizona 85281

STRUCTURAL NOTES ON SHEET S101 AND TYPICAL DETAIL SHEETS.

PROJECT ENGINEER JKC PROJECT DRAFTER

RECORD'S SEAL IS AFFIXED WITH WRITTEN SIGNATURE.

CARUSO

SCOTT

structural

engineers

OF PUYALL

/electrical-permits-fees-and-inspections

or call for Licensing Information:

posted on the job at all inspections in a

visible and readily accessible location.

approval of omissions or oversights by this

office or non compliance with any applicable

that the building complies with all applicable

COPYRIGHT NOTICE: THESE DRAWINGS AND SPECIFICATIONS ARE COPYRIGHTED AND SUBJECT TO COPYRIGHT PROTECTION AS AN "ARCHITECTURAL WORK" UNDER SEC. 102 OF THE COPYRIGHT ACT, 17 U.S.C. AS AMENDED JANUARY 203. THE PROTECTION INCLUDES, WITHOUT LIMITATION, THE OVERALL FORM, ARRANGEMENT AND COMPOSITION OF SPACES AND ELEMENTS OF THE DESIGN. UNDER UCH PROTECTION, UNAUTHORIZED USE OF THESE DRAWINGS AND SPECIFICATIONS MAY RESULT IN CESSATION OF CONSTRUCTION, BUILDING SEIZURE, AND/OR MONETARY LIABILITY

3

UITE 8373 ၂၂ ഗေ

.227 PU

DESIG E1Y

NEW

PROJECT CORP

PROTOTYPE RELEASE: Q3 2024

City of Puyallup velopment & Permitting Service ISSUED PERMIT



PRCTI20241902





##	DESCRIPTION	DATE


DATE:


DRAWN BY:

G.S.N.

11.18.2024

PET

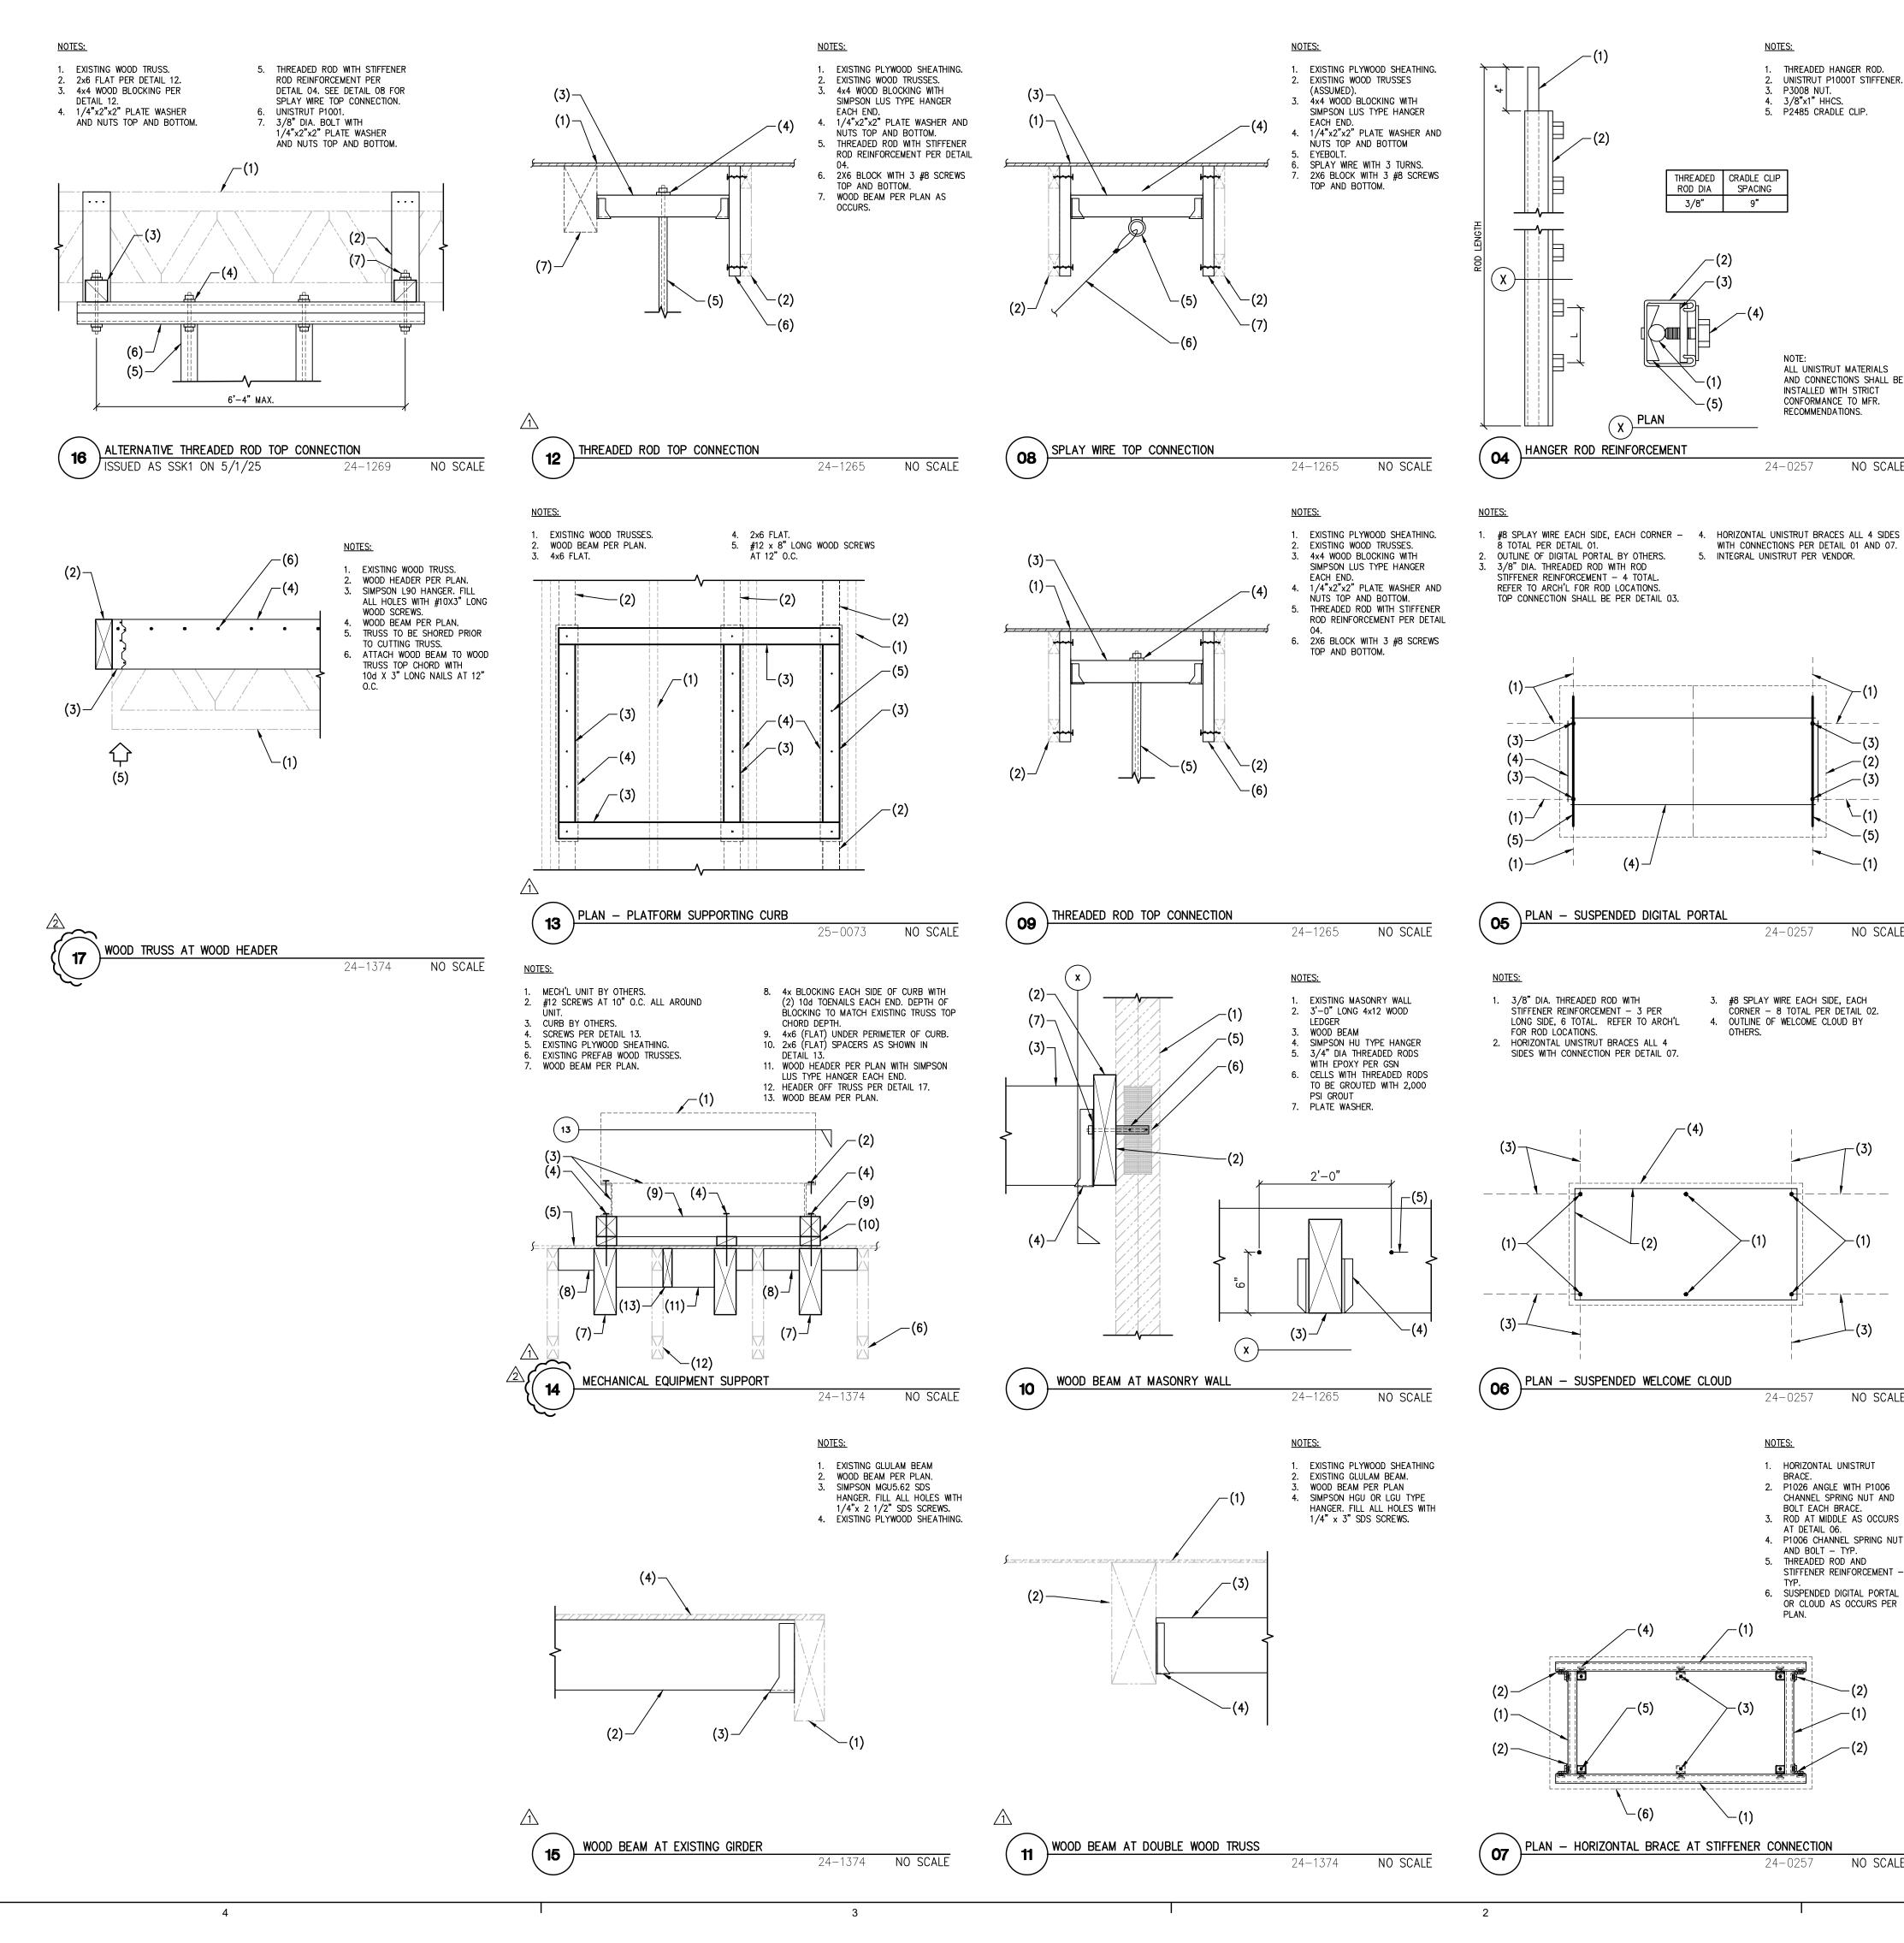

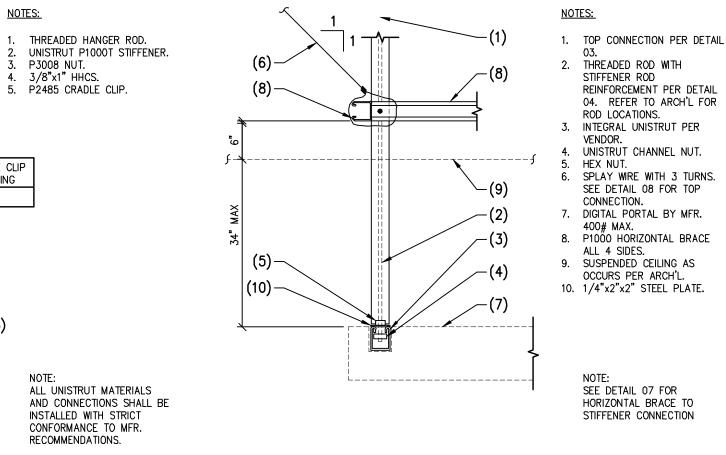

NO SCALE

NO SCALE

CHANNEL SPRING NUT AND

STIFFENER REINFORCEMENT


OR CLOUD AS OCCURS PER

NO SCALE


BOLT EACH BRACE.


AND BOLT - TYP.

AT DETAIL 06.

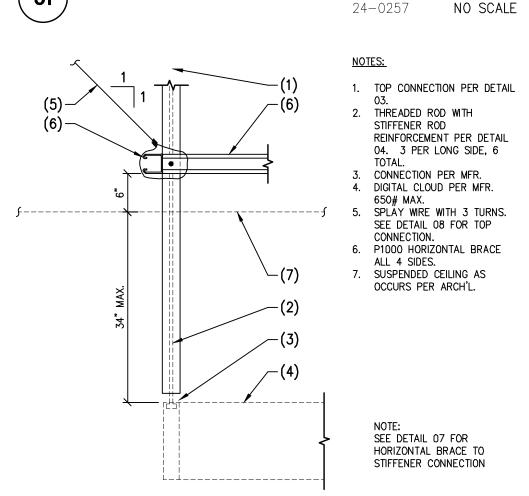

DIGITAL PORTAL THREADED ROD ATTACHMENT

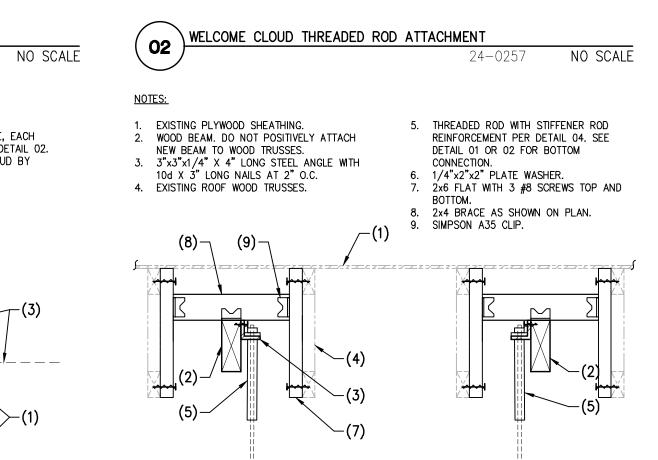

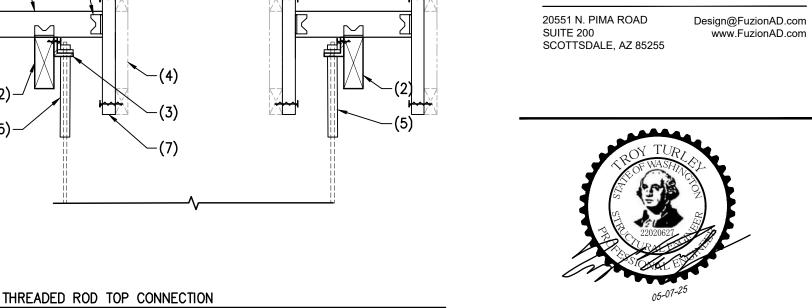

NO SCALE

24-1265

FOR ADDITIONAL INFORMATION SHOWN BUT NOT NOTED, SEE GENERAL STRUCTURAL NOTES ON SHEET S101 AND TYPICAL DETAIL SHEETS.

CONSTRUCTION OR RECORDING UNLESS THE STRUCTURAL ENGINEER OF

PROJECT NUMBER 24-1374 PROJECT MANAGER

RECORD'S SEAL IS AFFIXED WITH WRITTEN SIGNATURE.

CARUSO

TURLEY

SCOTT

structural

engineers

PROJECT ENGINEER

THESE DRAWINGS/CALCULATIONS ARE CONSIDERED PRELIMINARY -NOT FOR

JKC PROJECT DRAFTER

1215 West Rio Salado Parkway

Tempe, Arizona 85281

Suite 200

(480) 774-1700

www.ctsaz.com

##	DESCRIPTION	DATE
1	STRUCTURAL REVISIONS	4-2-2
2	STRUCTURAL REVISIONS	5-6-2

T Mobile:

12920 SE 38th STREET

WWW.T-MOBILE.COM

THESE DRAWINGS AND SPECIFICATIONS ARE COPYRIGHTED AND SUBJECT TO COPYRIGHT PROTECTION AS AN "ARCHITECTURAL WORK" UNDER SEC. 102 OF THE COPYRIGHT ACT, 17 U.S.C. AS AMENDED JAVIARY 2003. THE PROTECTION INCLUDES, WITHOUT LIMITATION, THE OVERALL FORM, ARRANGEMENT AND COMPOSITION OF SPACES AND ELEMENTS OF THE DESIGN. UNDER SUCH PROTECTION, UNAUTHORIZED USE OF THESE DRAWINGS AND SPECIFICATIONS MAY RESULT MACEDIATION OF CONTROL OF THE PROTECTION.

IN CESSATION OF CONSTRUCTION, BUILDING SEIZURE, AND/OR MONETARY LIABILITY.

COPYRIGHT NOTICE:

TH MERIDIAN

AVE SE

4227 S MERIDIAN SUIT
PUYALLUP, WA 9837

PROTOTYPE RELEASE: Q3 2024

PROJECT TYPE: CORP NEW

8022

City of Puyallup Development & Permitting Services ISSUED PERMIT

Building Planning Engineering Public Works

Fire Traffic

PRCTI20241902


BELLEVUE, WA 98006

DATE: DRAWN BY:

DETAILS

S102

PET

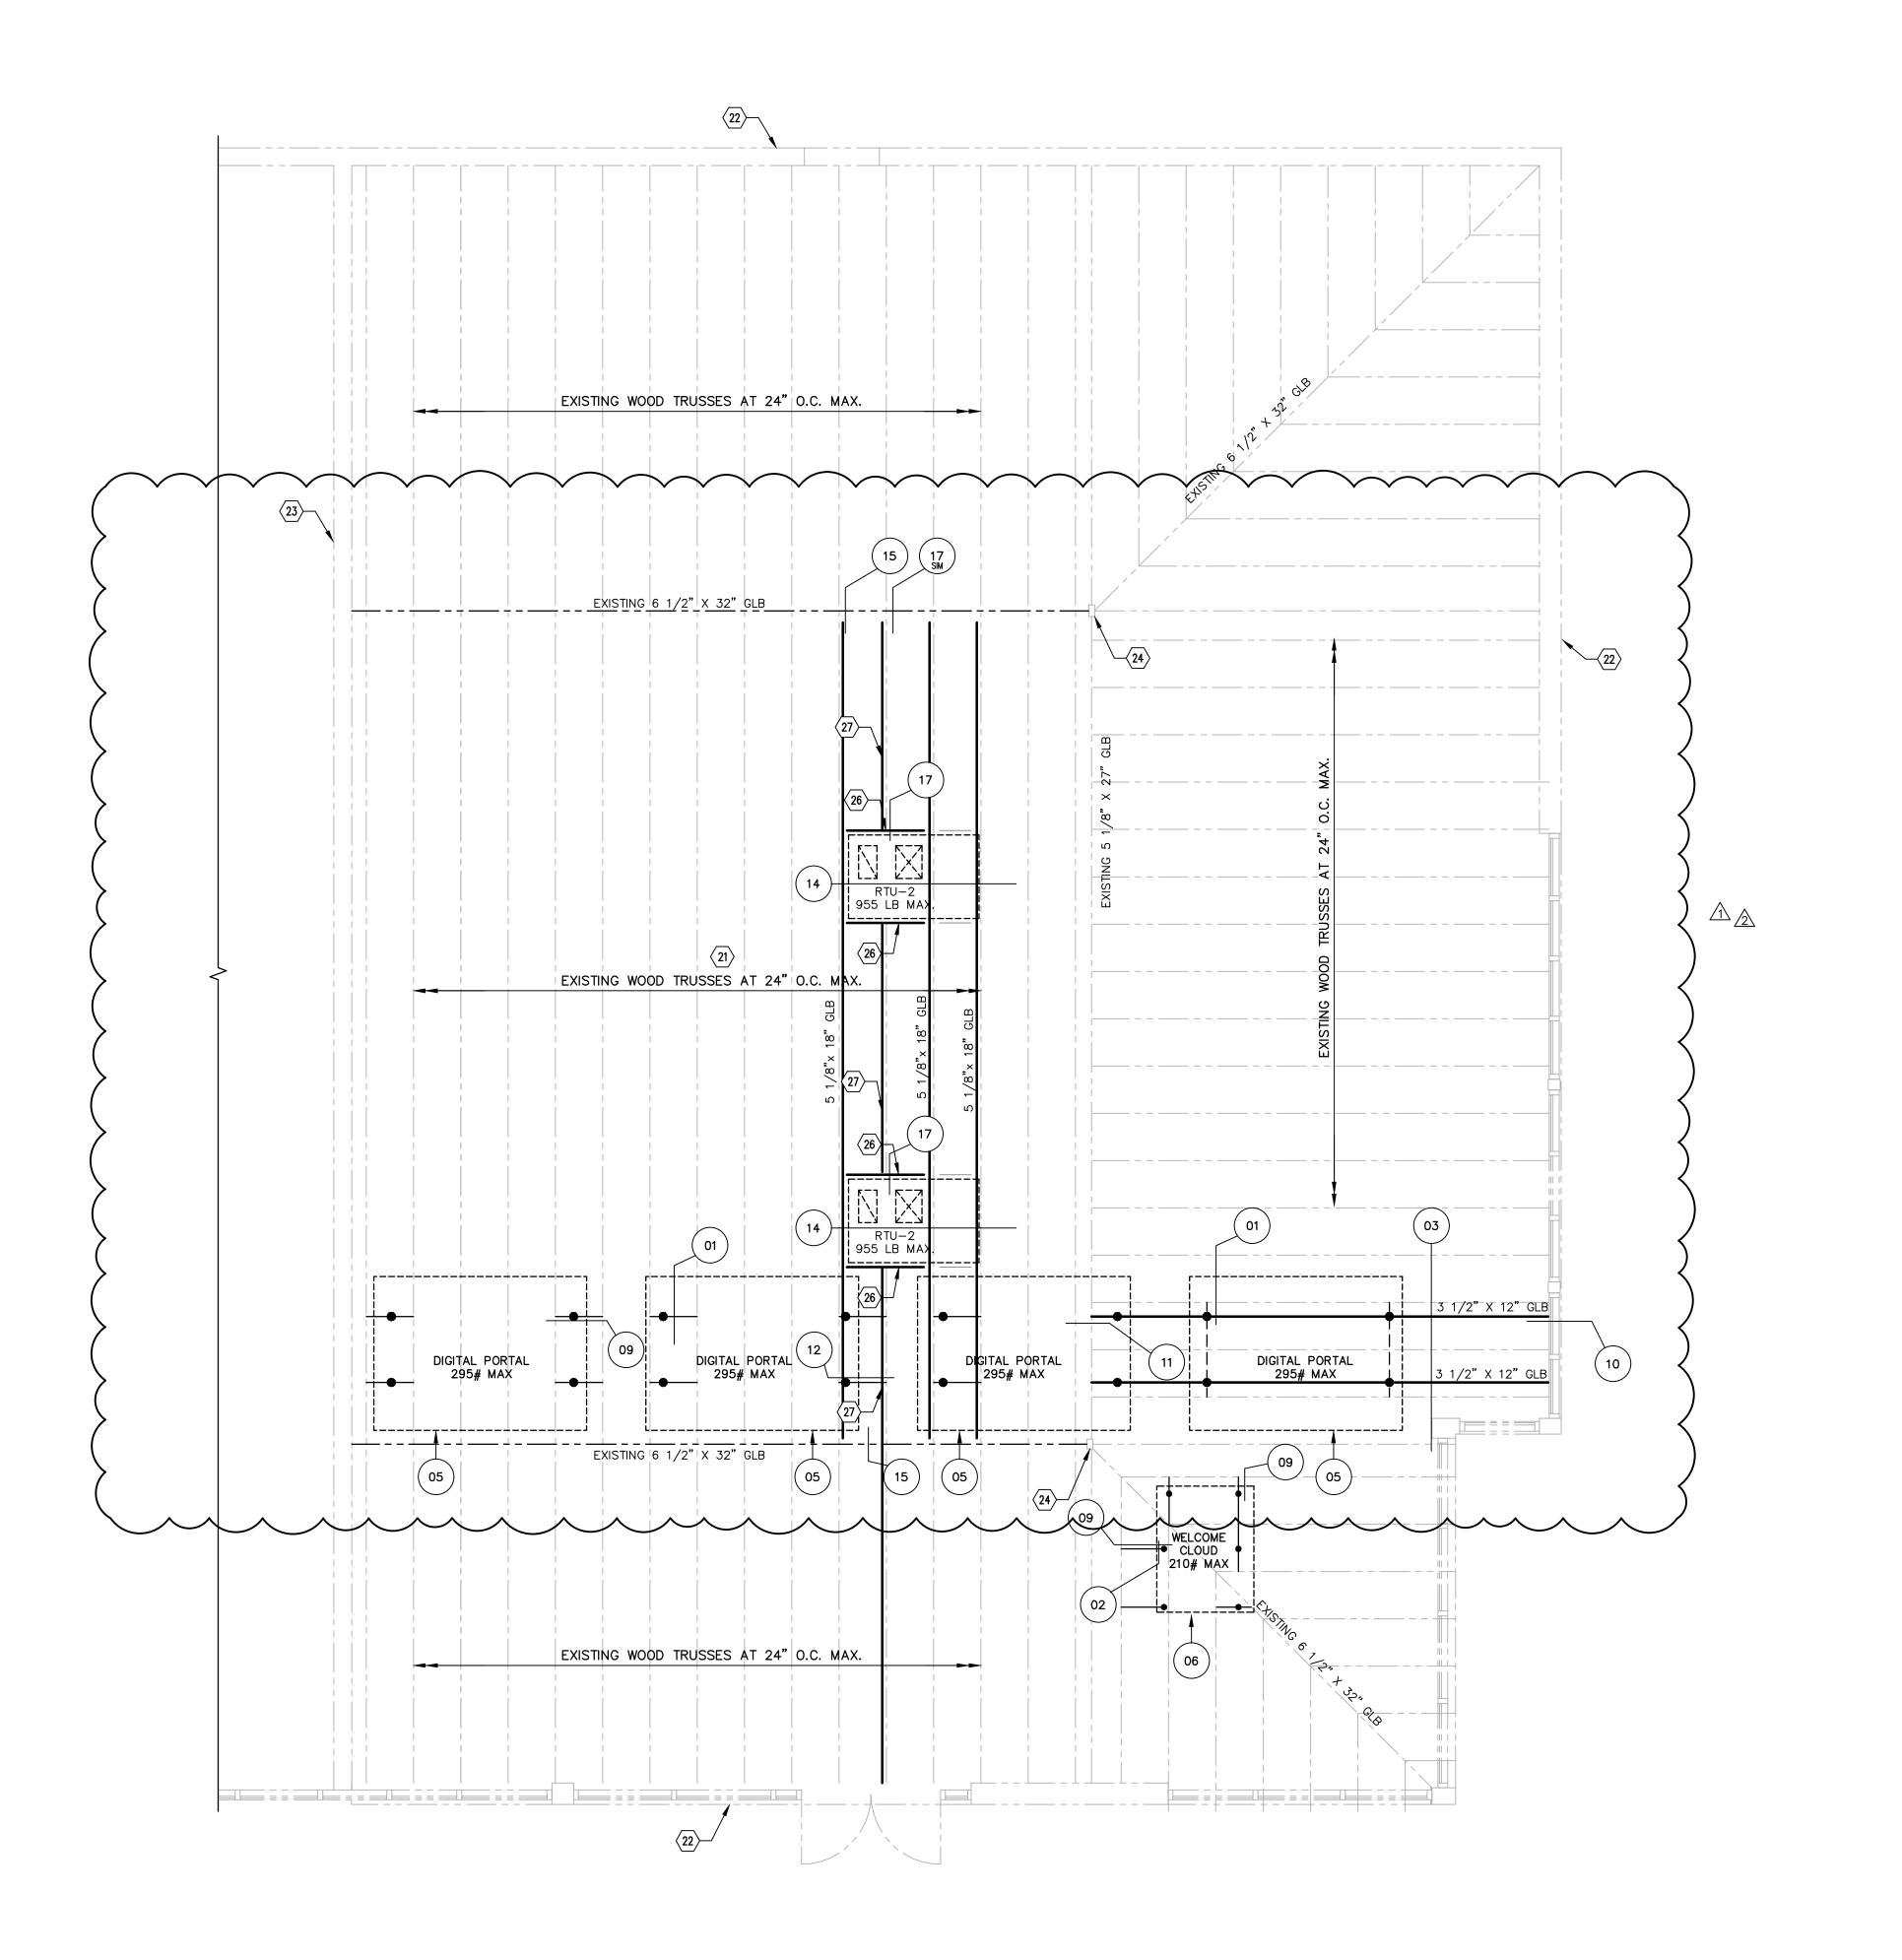

PARTIAL ROOF FRAMING PLAN

SCALE: 1/4" = 1'-0"

T Mobile

940-11

ROOF FRAMING NOTES - TYP U.N.O.:

VERIFY ALL DIMENSIONS AND ELEVATIONS WITH THE ARCHITECTURAL DRAWINGS AND FIELD CONDITIONS. BUILDING DIMENSIONS AND ELEVATIONS, WHERE SHOWN, WERE PROVIDED BY THE ARCHITECT AND IT IS THE CONTRACTOR'S RESPONSIBILITY TO VERIFY AND COORDINATE ALL DIMENSIONS PRIOR TO PROCEEDING WITH THE WORK. ANY DISCREPANCIES SHALL BE RESOLVED THROUGH THE ARCHITECT.

FOR CLARITY, DETAILS MAY SHOW ONLY ONE SIDE OF FRAMING CONDITIONS. ALL OPENINGS MAY NOT BE SHOWN ON THIS PLAN. FOR EXACT SIZE, NUMBER AND LOCATION OF OPENINGS, SEE ARCHITECTURAL, MECHANICAL, PLUMBING, ELECTRICAL, SPRINKLER AND THEIR RELATED DRAWINGS. FOR FRAMING AT OPENINGS, SEE TYPICAL

VERIFY EXACT SIZE, WEIGHT AND LOCATION OF EQUIPMENT AND SUPPORTS INDICATED ON PLAN WITH ARCHITECTURAL, MECHANICAL, PLUMBING, ELECTRICAL, SPRINKLER AND THEIR RELATED DRAWINGS. EQUIPMENT INDICATED ARE ONLY THOSE THAT EXCEED LOADS SPECIFIED IN THE G.S.N. FOR SUPPORT OF EQUIPMENT, SEE TYPICAL DETAILS AND OTHER TRADES.

THE EXISTING CONDITIONS DEPICTED ON THESE DRAWINGS ARE BASED ON APEX TECH SOLUTIONS SURVEY DATA DATED 10/15/2024 AND SHALL BE VERIFIED BY THE

CONTRACTOR PRIOR TO CONSTRUCTION. ANY DISCREPANCIES SHALL BE BROUGHT TO

FRAMING KEYNOTES

CONTRACTOR TO VERIFY TRUSSES ARE 35'-10" LONG (MAX). NOTIFY ENGINEER IF OTHERWISE.

27 2x12 WOOD BEAM. ATTACH WOOD BEAM TO TRUSS PER DETAIL 17.

THE ATTENTION OF THE STRUCTURAL ENGINEER IMMEDIATELY.

(22) EXISTING EXTERIOR WALL.

(24) EXISTING STEEL COLUMN.

26 4x12 WOOD HEADER.

23 EXISTING INTERIOR DEMISING WALL.

25 BRACE WOOD BEAM PER DETAIL 12.

BELLEVUE, WA 98006 WWW.T-MOBILE.COM

THESE DRAWINGS AND SPECIFICATIONS ARE COPYRIGHTED AND SUBJECT TO COPYRIGHT PROTECTION AS AN "ARCHITECTURAL WORK" UNDER SEC. 102 OF THE COPYRIGHT ACT, 17 U.S.C. AS AMENDED JANUARY 2003. THE PROTECTION INCLUDES, WITHOUT LIMITATION, THE OVERALL FORM, ARRANGEMENT AND COMPOSITION OF SPACES AND ELEMENTS OF THE DESIGN, UNDER SUCH PROTECTION, UNAUTHORIZED USE OF THESE DRAWINGS AND SPECIFICATIONS MAY RESULT IN CESSATION OF CONSTRUCTION, BUILDING SEIZURE, AND/OR MONETARY LIABILITY.

43RD ∞

JTH MERIDIAN & AVE SE


4227 S MERIDIAN SUITE E
PUYALLUP, WA 98373


PROJECT TYPE: CORP NEW

8022


PROTOTYPE RELEASE: Q3 2024

S

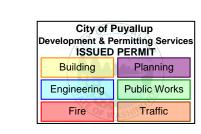

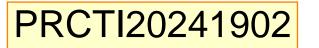



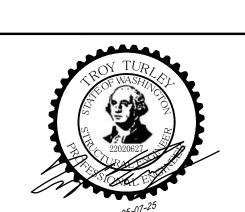

##	DESCRIPTION	DATE
1	STRUCTURAL REVISIONS	4-2-25
2	STRUCTURAL REVISIONS	5-6-25

DATE: DRAWN BY:

PARTIAL ROOF FRAMING PLAN

11.18.2024

PET

FOR ADDITIONAL INFORMATION SHOWN BUT NOT NOTED, SEE GENERAL STRUCTURAL NOTES ON SHEET S101 AND TYPICAL DETAIL SHEETS.

THESE DRAWINGS/CALCULATIONS ARE CONSIDERED PRELIMINARY -NOT FOR CONSTRUCTION OR RECORDING UNLESS THE STRUCTURAL ENGINEER OF RECORD'S SEAL IS AFFIXED WITH WRITTEN SIGNATURE.

PROJECT NUMBER 24-1374 PROJECT MANAGER JKC PROJECT DRAFTER PROJECT ENGINEER **CARUSO** 1215 West Rio Salado Parkway

TURLEY SCOTT structural engineers

Tempe, Arizona 85281 (480) 774-1700 www.ctsaz.com

Suite 200