# 3500 S. MERIDIAN UNIT #800 PUYALLUP WA 98373

Approval of submitted plans is not an approval of omissions or oversights by this office or non compliance with any applicable regulations of local government. The contractor is responsible for making sure that the building complies with all applicable codes and regulations of the local government.

The approved construction plans, documents, and all engineering must be posted on the job at all inspections in a visible and readily accessible location.

Full sized legible color plans are required to be provided by the permitee on site for inspection.

Separate Electrical Permit is required with the Washington State Department of Labor https://lni.wa.gov/licensing-permits/electrical/ electrical-permits-fees-and-inspections or call for Licensing Information: 1-800-647-0982

> Building **REVIEWED** 1:01:17 PM

City of Puyallup COMPLIANCE

WJCA

## CUSTOM DESIGN AND ENGINEERING

# ECLIPSE ENGINEERING

# AUE ENGINEERING

Designer

299 MARKET STREET

SUITE 340

SADDLE BROOK, NJ 07663


Mechanical, Electrical & Plumbing Consultant

153 EAST MAIN STREET ROCKAWAY, NJ 07866 P: 973.784.4258

Structural Engineer (Back Of House Shelving)

365 NE QUIMBY AVE. BEND, OR 97701

Structural Engineer (Seismic Details) 13228 NE 20TH ST., SUITE 100 BELLEVUE, WA 98005

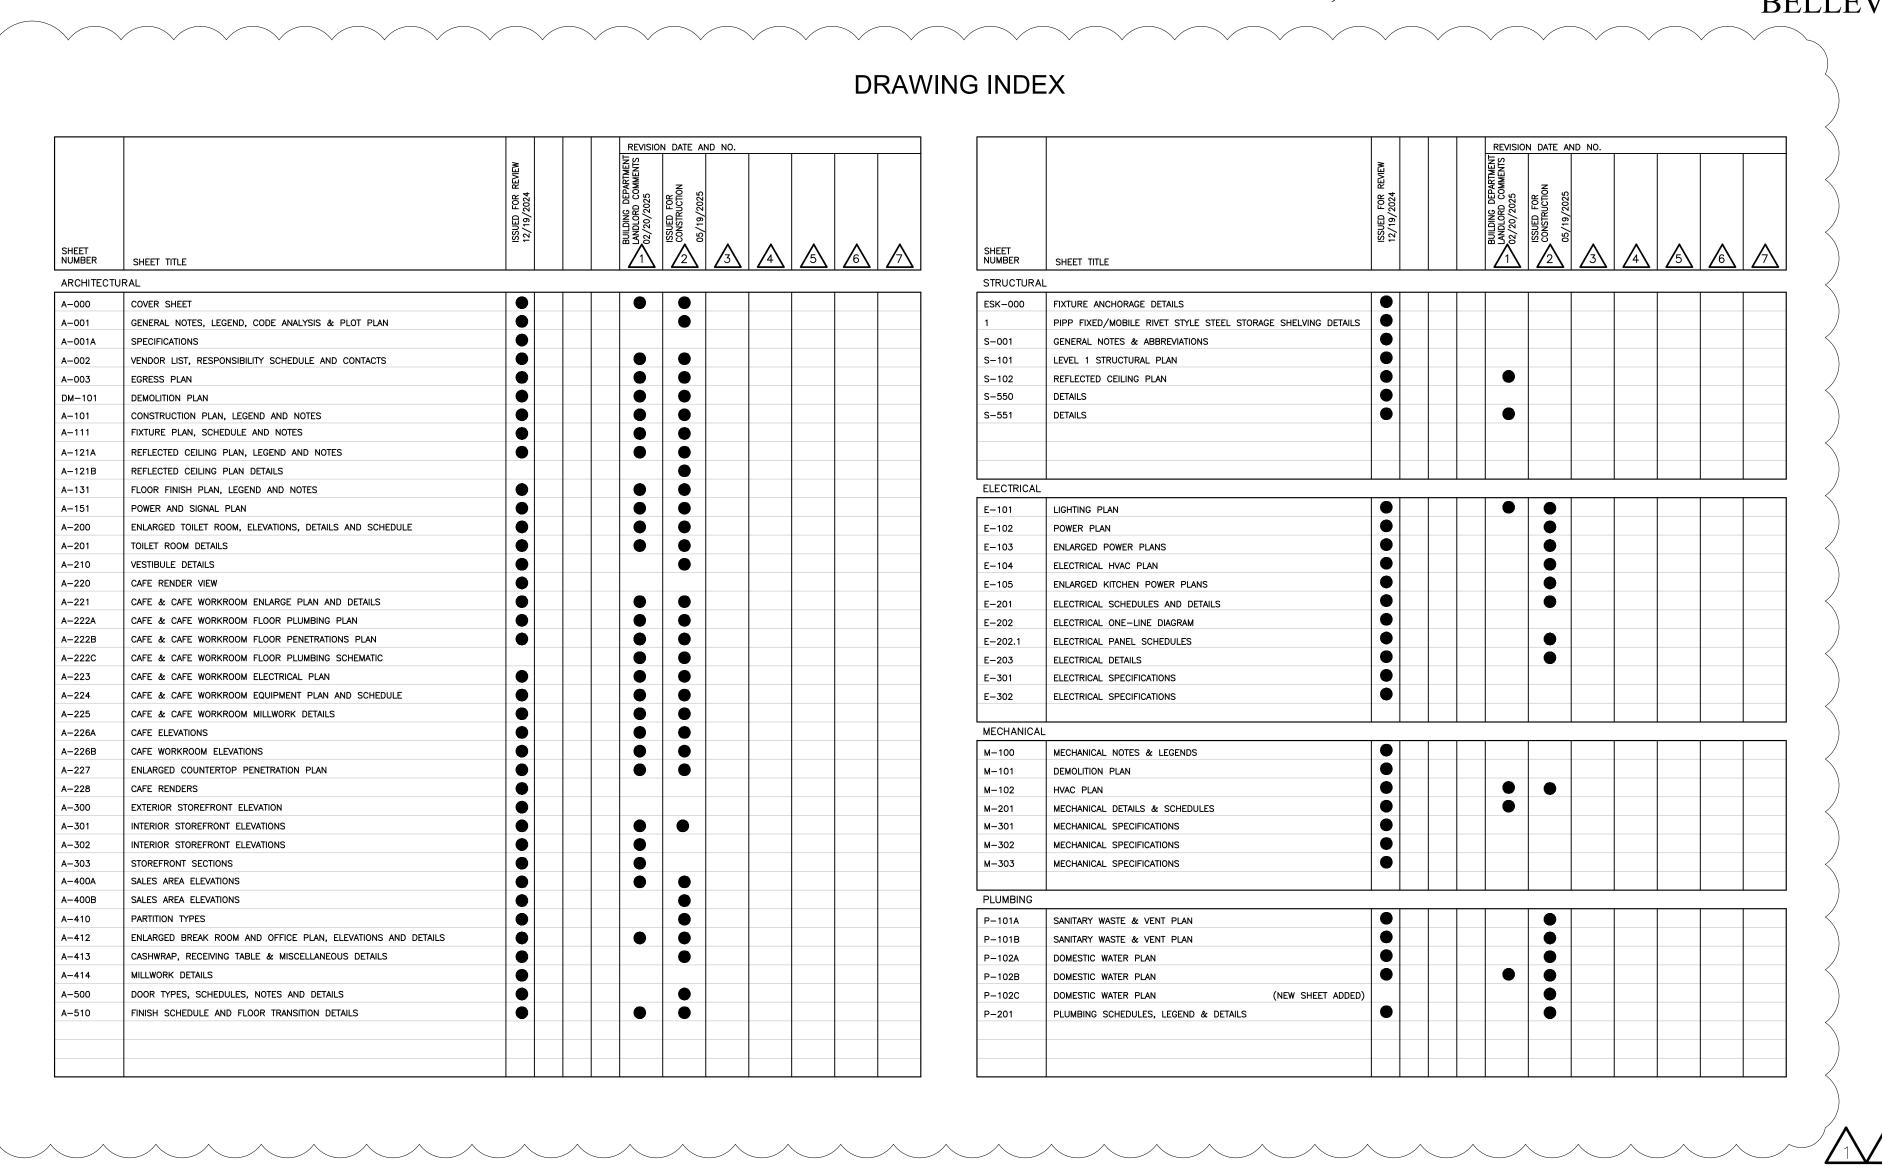

UNIT #800

BARNES&NOBLE

PRCTI20250011

**BUILDING VALUE SINCE 1994** 

ARCHITECT:

JOEL TORIELLI 422 BOGERT AVE

RIDGEWOOD, NJ 07450

PROJECT DESIGNER:

City of Puyallup
Development & Permitting Services
ISSUED PERMIT
Building Planning
Engineering Public Works
Fire Traffic


PUYAĽLUP, WA 98373 Project Number 33247 Store Number

Revision Log: Description ISSUED FOR PERMIT, BID,
LANDLORD & CLIENT REVIEW
BUILDING DEPARTMENT AND
LANDLORD COMMENTS 12-19-24 05-19-25 ISSUED FOR CONSTRUCTION

service and the property of the Architect, infringements will be premises. Discrepancies shall be reported to the Architect prior to

Professional Seal:


commencement of any work.

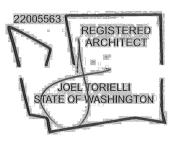

EXP. DATE : 10/02/25

Cover Sheet


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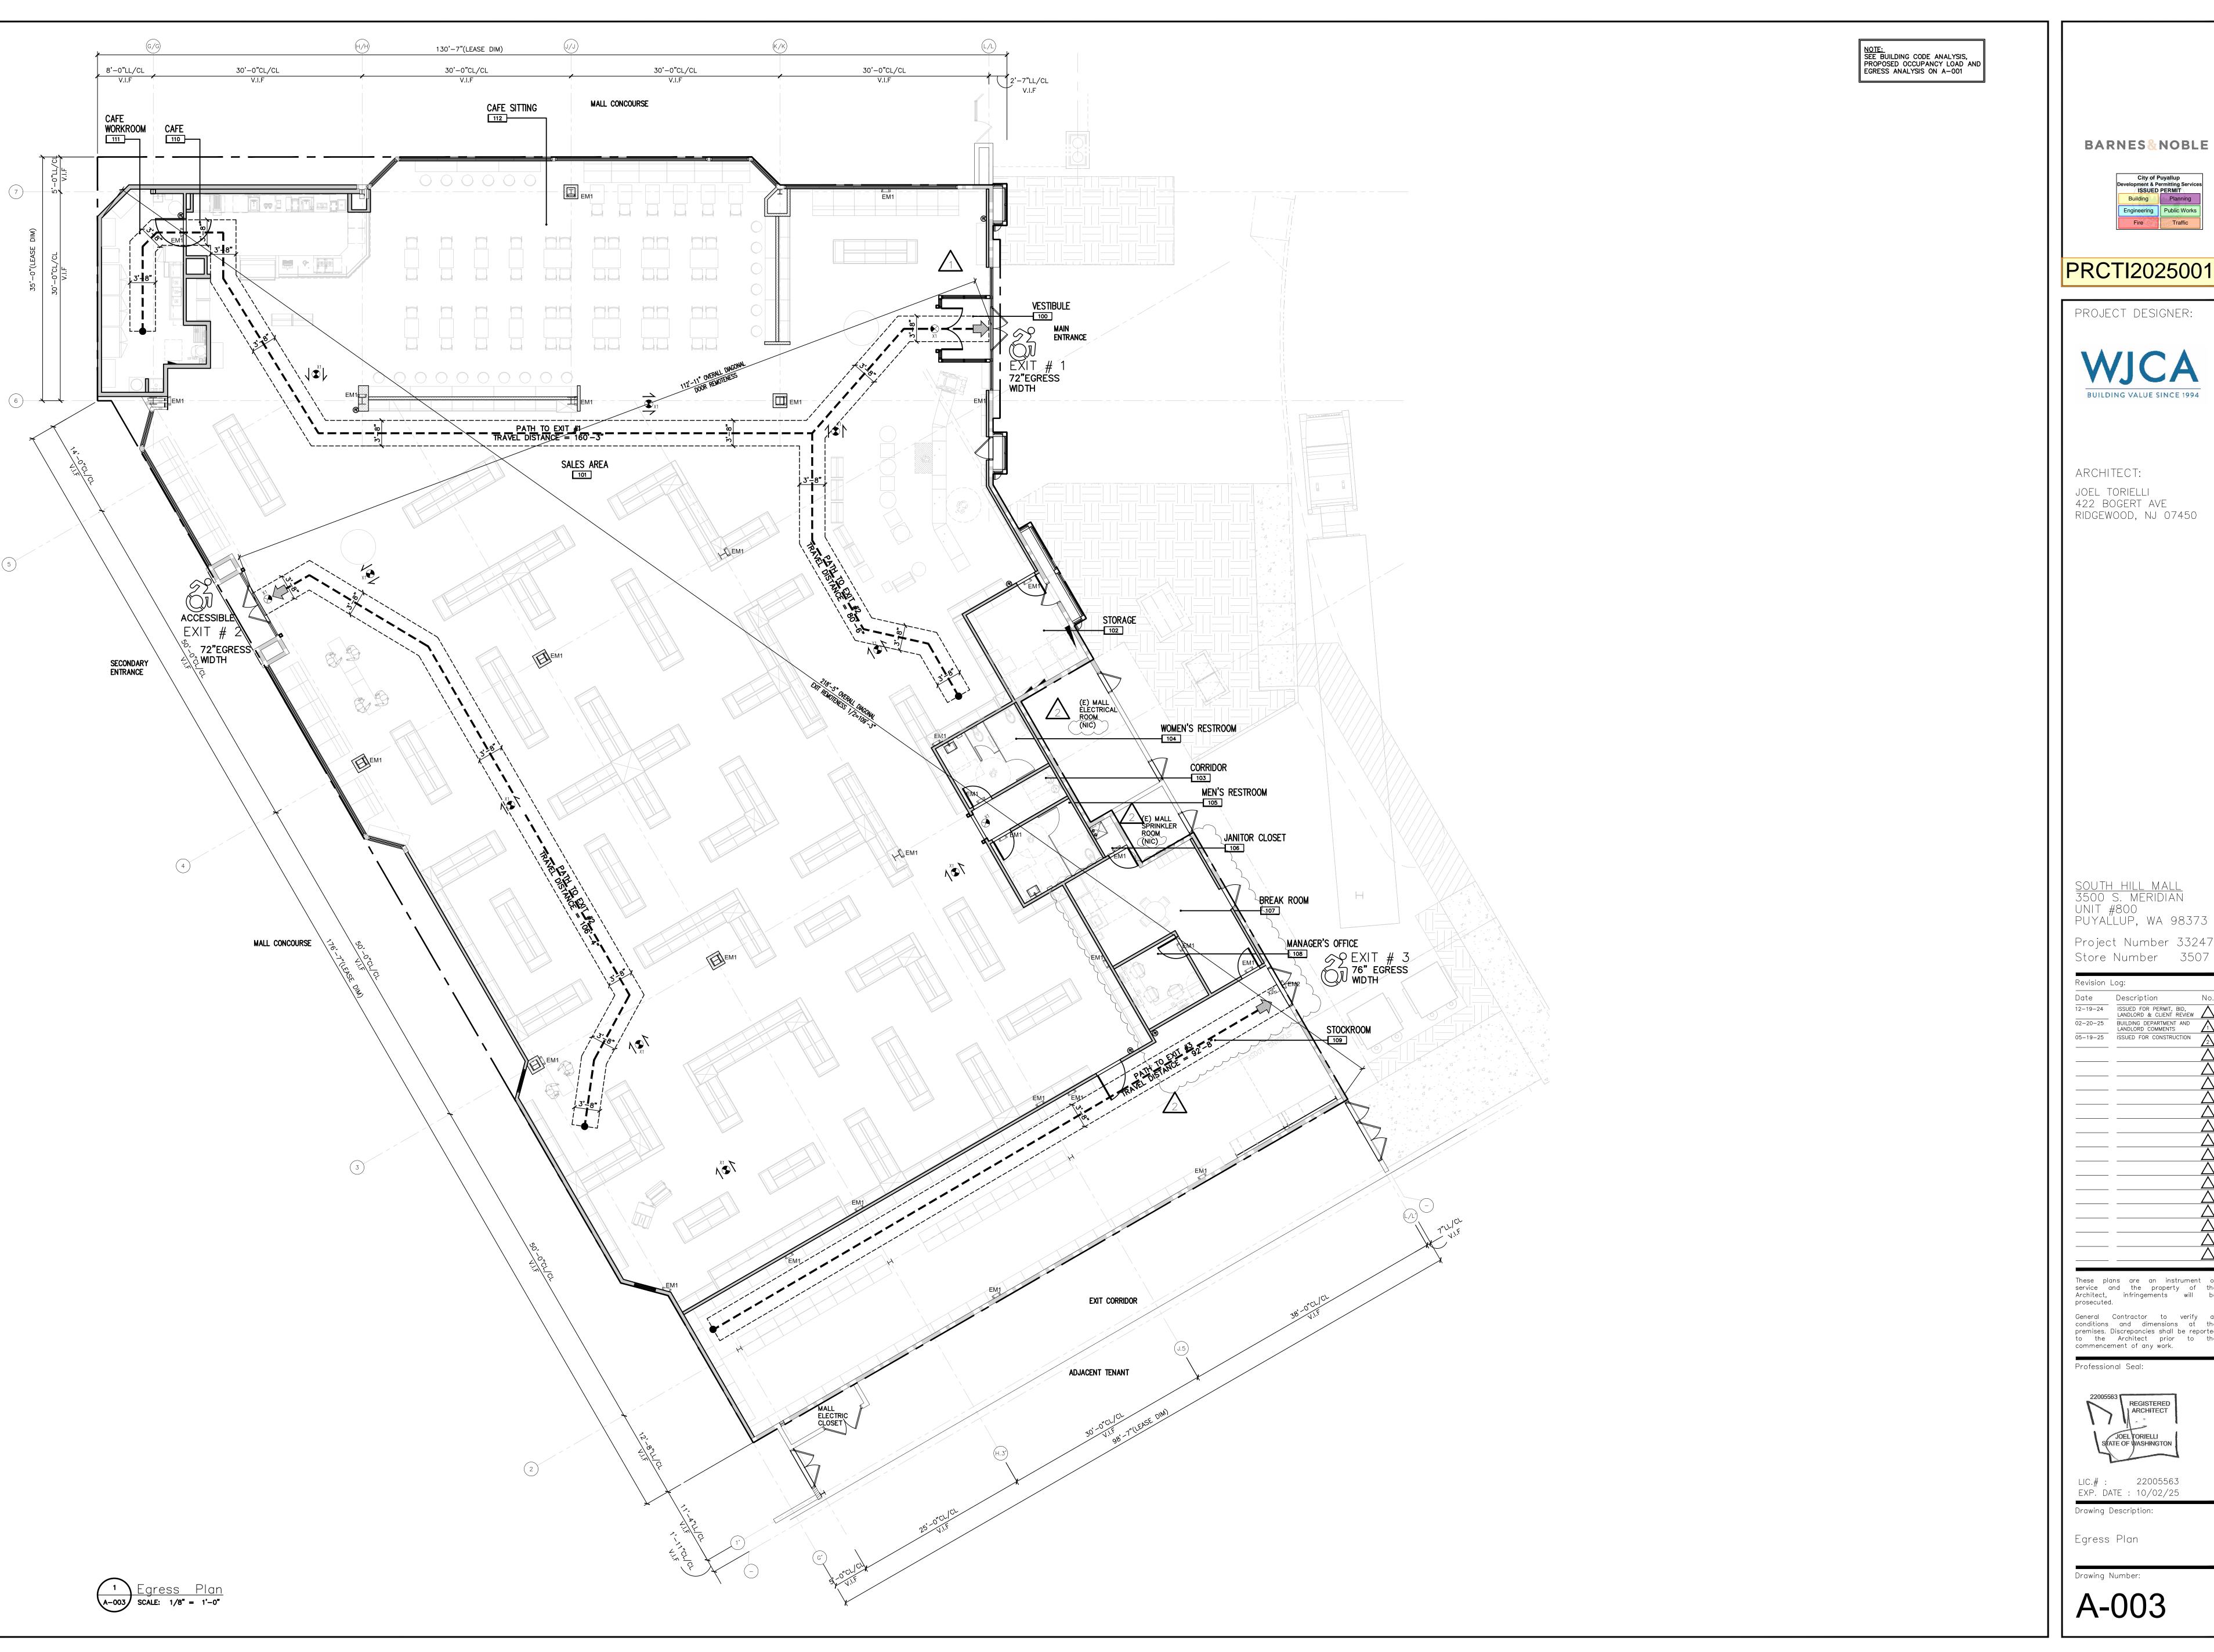


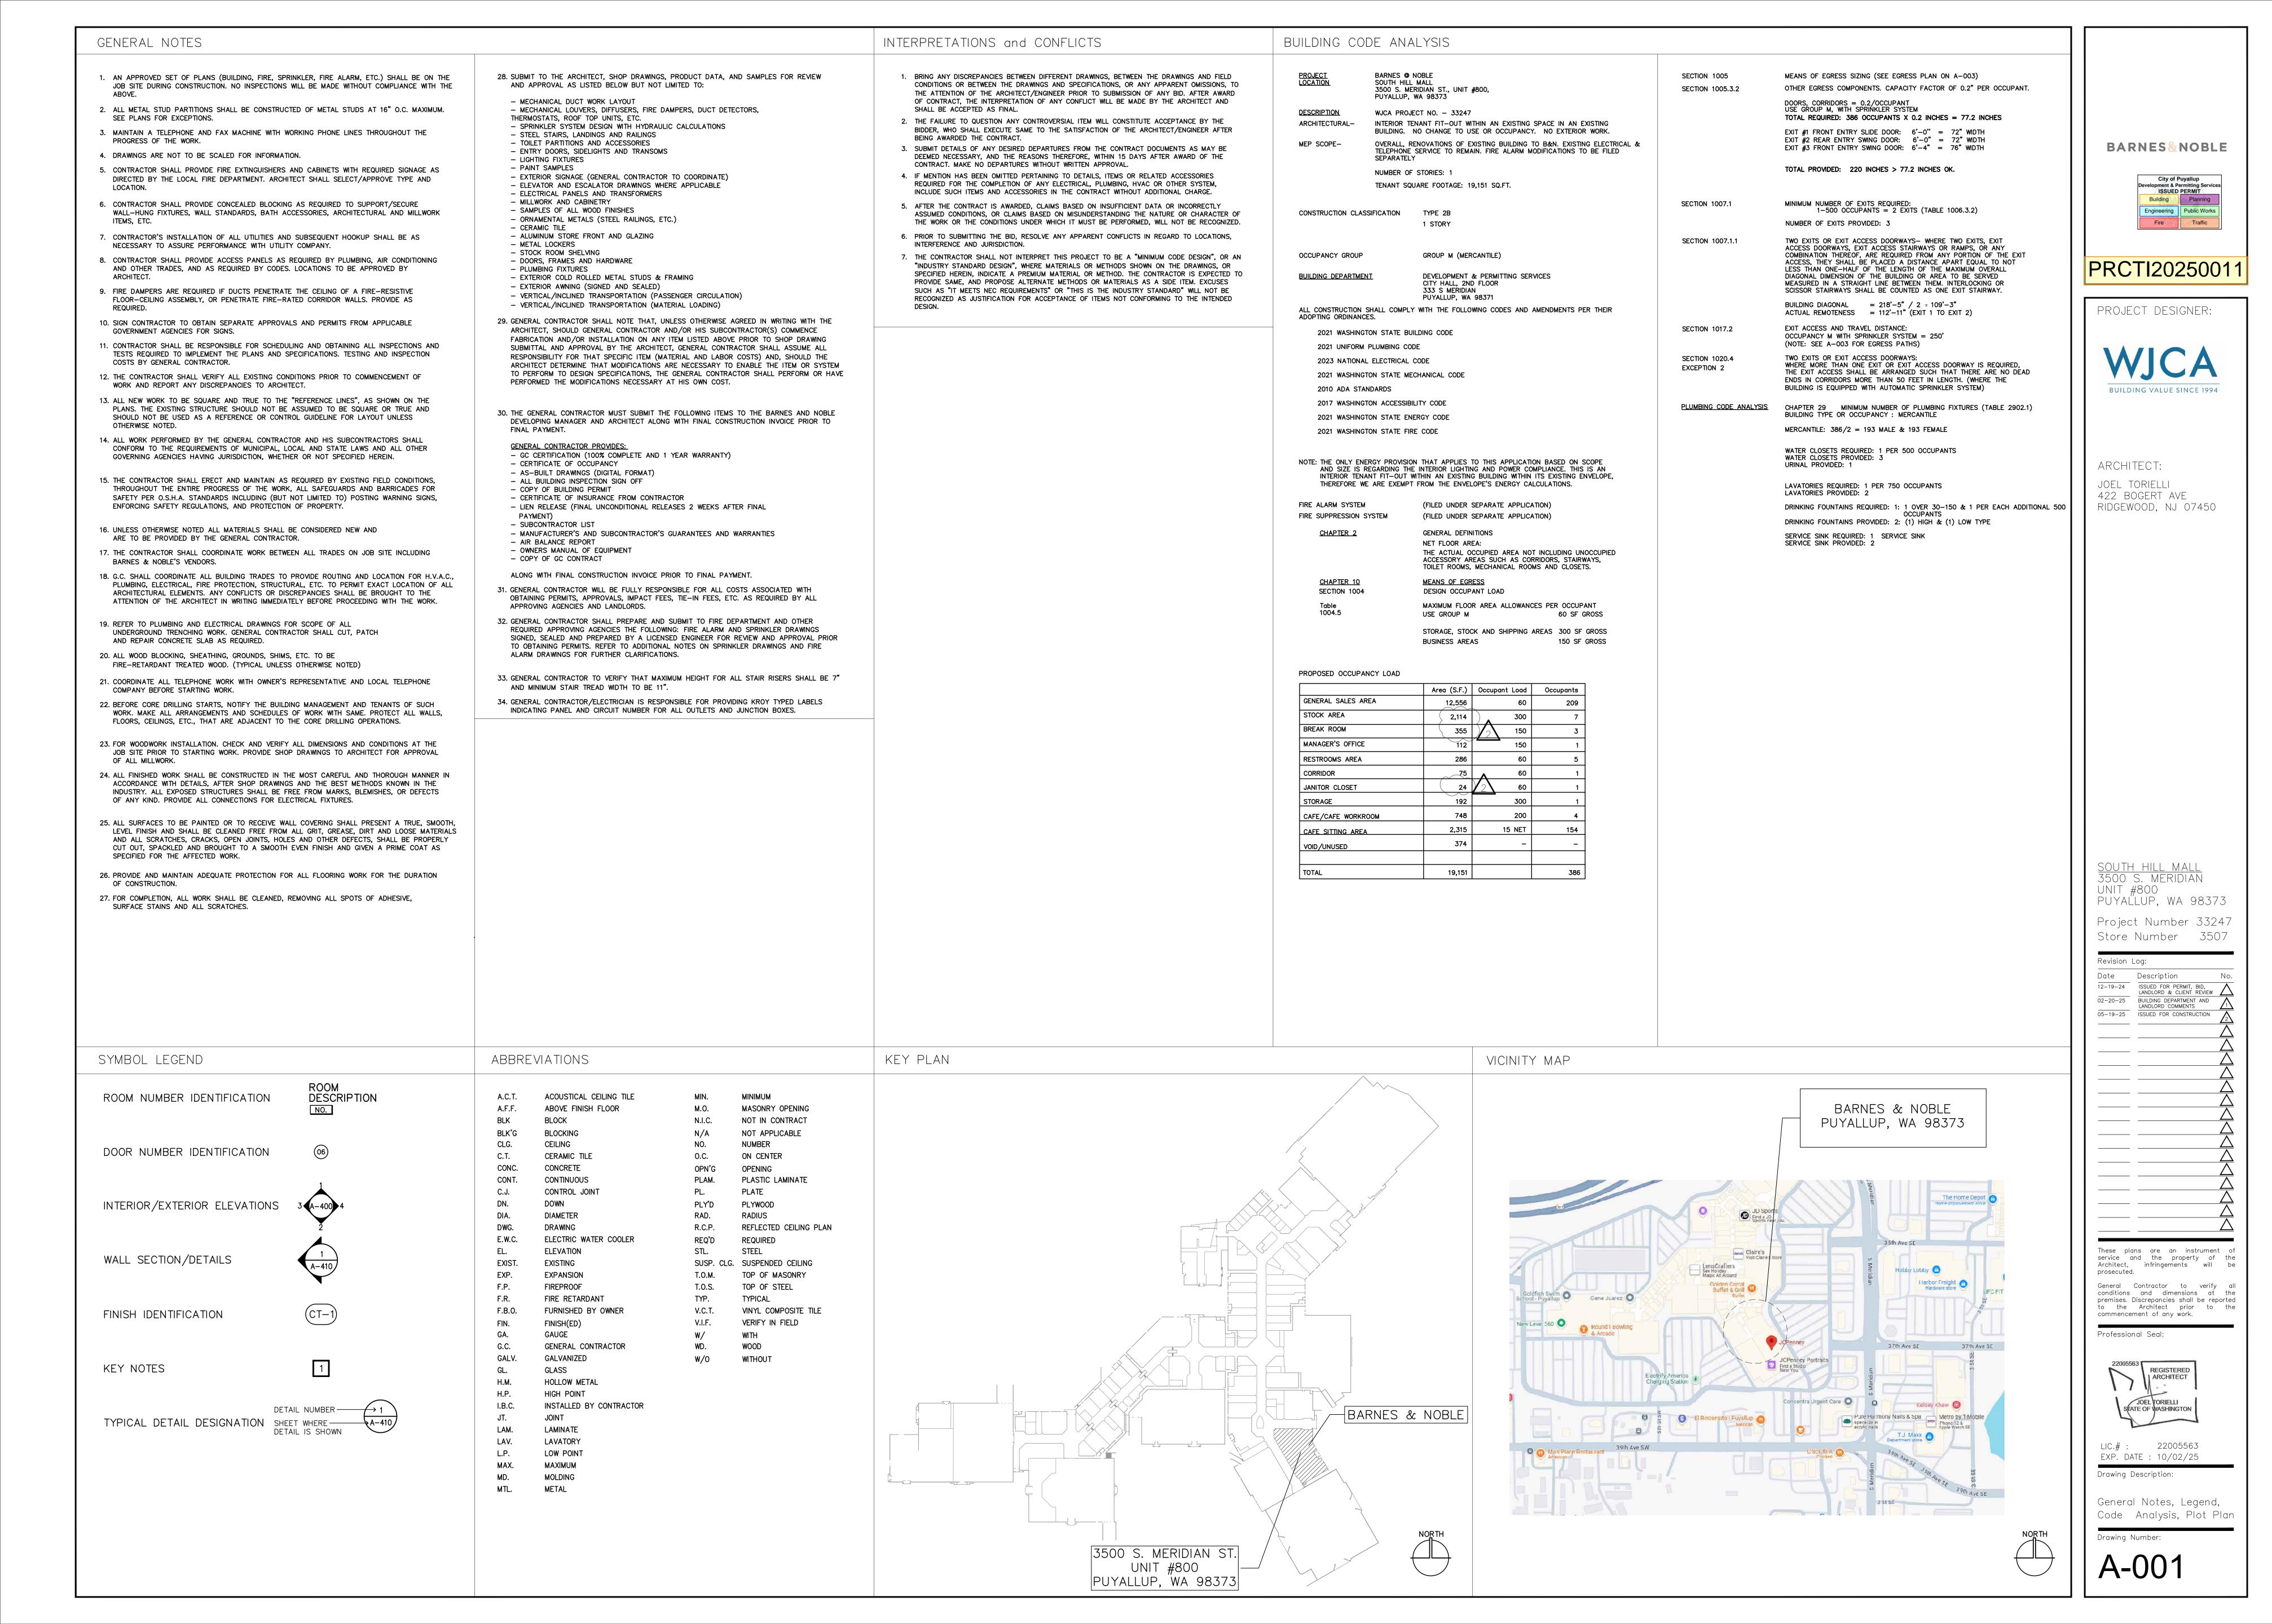
VENDOR L	IST								RESPONSIBILITY SCHEDUL	 E			
<u>VENDOR</u> <u>SINAGE</u>	NEW STORE RESPONSIBILITY	CONTACT INFORMATION	VENDOR	NEW STORE RESPONSIBILITY	CONTACT INFORMATION	VENDOR	NEW STORE RESPONSIBIL	ITY CONTACT INFORMATION	NOTES:  1. ALL ITEMS SUPPLIED BY BARNES & NOBLE SHATTER THE GENERAL CONTRACTOR WILL ASSUME FULL			COORDINATED, STORED, AND SUPERVISED BY THE GENERAL CONTRACTOR. SUPPLIED MATERIALS / ITEMS.	
Ruggles Signs		93 Industry Drive   PO BOX 349 Versailles, KY 40383	CAFE EQUIPM				<u>ON / CAFÉ INSTALLATION</u>					ICATIONS DO NOT RELIEVE THE GENERAL CONTRACTOR FROM	
	lluminated Signage	Contacts:	DWM	Water Filtration	Contacts: Dovie Wood Email:dwood@dwminc.com	Patterson McClain	Café Installation / Millwork Installation	P.O. Box 369 Cary, NC 27512	Responsibility Schedule				1
		Tim Cambron Email: tim@rugglessign.com Phone: 859—879—1199 ext. 104			Phone:888-396-9111, x215			Contacts: Greg Morf Email: gmorf@pattersonmcclain.com	BARNES & NOBLE PUYALLUP, WA	Furnish	Install	Date:12/17/24	BARNES&NOBLE
		Farriah Hardin Email: farriah@rugglessign.com Phone: 859—879—1199 ext. 163						Phone: (919) 380-0772	SCOPE OF WORK	Existing Landlord Tenant Tenant Contractor	dlord ant ant tractor	REMARKS	City of Puyallup Development & Permitting Services /ISSUED PERMIT
		Phone: 859-879-1199 ext. 163	Wasserstrom	Café Equipment	4500 E Broad St Columbus OH 43213	D&S Millwork	Millwork Installation	Contacts; Mike Gish	DIVISION 01-GENERAL REQUIREMENTS PERMITS, FEES, INSURANCE CERTIFICATES, ETC.		Ten Ten Cor	SIGN PERMIT BY TENANT'S SIGN CONTRACTOR	City of Puyallup Development & Permitting Services ISSUED PERMIT Building Planning Engineering Public Works Fire Traffic
Color Image, Ir	/ Receiving Room	9148 King St Franklin Park, IL 60131			Contacts: Jim Miller			Email: gmorf@pattersonmcclain.com Phone: 541-654-2380	BARRICADE TEMP WINDOW GRAPHICS TEMP UTILITIES & EQUIPMENT	X X	X X X	TGC TO REMOVE BARRICADE AT COMPLITION OF WORK AND PATCH / PAINT AS REQ'D.	
	Decal	Contacts: Kyle O'Donnell			Email: jimmiller@wasserstrom.com Phone: (800) 999—9277 X 8592				RECEIVING & UNLOADING TENANT PROVIDED MATERIALS  FINAL PROFESSIONAL CLEANUP & TRASH REMOVAL	X	X	DAILY SWEEP CLEANING DURING CONSTRUCTION 2 CLEANS PRIOR TO OPS TURNOVER: ONE BEFORE PUNCH AND WHITE GLOVE BEFORE OPS TURNOVER	PRCTI20250011
		Email:kyle@colorimage.com Phone: 847—226—5645				Nicon Construction	Millwork Installation	1004 Ionia Avenue Staten Island, NY 10309	FINAL JOB SITE PLANS CERTIFICATE OF OCCUPANCY DIVISION 02-EXISTING CONDITIONS	X	X		PROJECT DESIGNER:
LOW VOLTAGE			Woodin	Café Millwork (Cabinets an	d 280 Gannett Drive			Contacts: Angelo Nicastro	DEMOLITION & HAUL OFF DIVISION 03-CONCRETE CONCRETE SLAB	X			
MRF Tek	LV Wiring and Installation	8342 Milky Way		Countertops)	South Portland, ME 04106  Contacts:			Email: angelonicastro@aol.com Phone: 917 567 1694	CONCRETE SLAB TRENCHING, PATCHING, LEVELING DIVISION 05-METALS	X	Х		WJCA
	Lv Willing and motanation	Zionsville PA 18092 Contacts:			Troy Fredericks Email: troy@woodinco.com Phone: 207—671—9551	Sunrise Installations	Millwork Installation	19737 Canary Way	STRUCTURAL STEEL STRUCTURAL & LIGHT GAUGE METAL FRAMING ALUMINUM STOREFRONT FRAMING (EXTERIOR)	X	X		BUILDING VALUE SINCE 1994
		Angel Veloz Email: aveloz2580@gmail.com Phone: 484-538-3249						Queen Creek AZ 85242  Contacts:	ALUMINUM STOREFRONT FRAMING (INTERIOR)  DEMISING WALL STUDS  DIVISION 06-WOODS, PLASTICS & COMPOSITES		X		
TDX	LV Wiring and Installation	5735 W Old Shakopee Rd #100 Bloomington, MN 55437	Melitta	Espresso Machines	2150 Point Blvd., Suite 200			Lee Tomczak Email: lee.tomczak@gmail.com Phone: 562—355—3303	ROUGH FRAMING, BLOCKING AND FURRING FINISH CARPENTRY	XX	X	MISC WOOD TRIM BOH CARPENTRY BY GC, MILLWORK PACKAGE BY BN MILLWORKER	
		Contacts: Michael Matt			Elgin, IL 60123 Contacts:			11660 Theatre Drive N	DIVISION 07-THERMAL & MOISTURE PROTECTION  WATERPROOF MEMBRANE & SEALANTS  BATT INSULATION	X	X		ARCHITECT:  JOEL TORIELLI
		Email: mmatt@tdxtech.com Phone: 952-912-9281			Karie Van Sistine Email: karie.vansistine@melitta.com	Installation Solutions	Millwork Installation	Suite 250 Champlin, MN 55316	SOUND BATTING ROOFING PENETRATIONS / FLASHINGS / CURBS FIRE PROOFING / STOPPING	XXX	XXX	FOR CELL BOOSTER AND CAFÉ VENTS	422 BOGERT AVE RIDGEWOOD, NJ 07450
TST Network Corp.		/ Contacts: Frank Stantos	-		Phone: (847) 717–8887			Contacts:  Issac Bindert	SEALANTS & CAULKING EXPANSION JOINTS	<b>x</b>	X	x	
J 55, p.	Cell Booster / CCTV	Email: frank.santos@tstcorporation.com Phone: 347-755-0393						Email: ibindert@installationsolutionsinc.cor Phone: 763.315.0492	DOORS, FRAMES & HARDWARE  REAR DOOR AND HARDWARE  ACCESS PANELS	X X X	X	SEE DOOR SCHEDULE	
			SUPPORT ARE	EA FIXTURES					STOREFRONT DOORS AND DOOR HARDWARE VESTIBULE STOREFRONT GLAZING SYSTEM (EXTERIOR)	X X X	XX	VERIFY CYLINDER HOUSING WILL ACCOMODATE 7 PIN CORE INCLUDING SHOP DRAWINGS	
LightStat	Lighting / HVAC Controls	22 W West Hill Rd Barkhamsted, CT 06063	PIPP	Receiving Room Shelving	2966 Wilson Dr. NW Walker MI 49534				STOREFRONT GLAZING SYSTEM (INTERIOR) KEYS AND DOS DIVISION 09-FINISHES	X X X	X	PATCH & REPAIR EXISTING STOREFRONT IF REQ'D.	
		Contacts: Kevin Ellis			Contacts: Cassandra Beach Email:				GYPSUM BOARD, DEMISING PARTITIONS GYPSUM BOARD ACOUSTICAL CEILING SYSTEM	X X X	XXX	PATCH/ REPAIR AS REQUIRED	
		Email: k.ellis@lightstat.com Phone: 800-292-2444 ext. 277			cbeach@pippmobile.com Phone: 616—988—4060				PORCELAIN FLOORING WALK OFF MATT AND TRAY VINYL FLOORING	X X X	X		
		Karen Simons Email: k.simons@lightstat.com Phone: 860.738.4111 Ext: 279							CARPET AND GLUE WALL TILE VINYL BASE	X X	XXX		
			mmi Storage Solutions	Receiving Room Shelving	45 Turner Drive, Suite 2A Middletown, NY 10941				TRANSITION STRIP & REDUCERS	X	X X		
Mood Media	Music	Contacts: Eve DeForest Email: eve.deforest@moodmedia.com			Contacts: Paul Ruksenas Email: pr@mobilemediastorage.com				WALL BASE - WOOD PAINT/PAINTING & ACCESSORIES REVEALS	X	X	1 PRIMER, 2 COATS FINISH MIN.  MALL STOREFRONT	
		Phone: 512.788.4103			Phone: 216-849-1469				DIVISION 10-SPECIALTIES STOREFRONT SIGNS SIGNAGE FOR STORE FIXTURES	X	X	GC MUST INITIATE AND COOR. WITH B&N VENDOR	
PSI	CCTV	598 Hillsboro Technology Drive Deerfield Beach, FL 33441	SALES FLOOR	R FIXTURES		CONTACT LIST			BLADE SIGN CAFÉ SIGNAGE - ILLUMINATED CAFÉ FLOOR MOUNTED BLADE SIGN-ILLUMINATED	X	X	GC TO PROVIDE POWER AND BLOCKING GC TO PROVIDE POWER	
		Contacts: Andrew Creta Email: andy.creta@prosegur.com	Nicewood	Sales Floor Fixtures / Café Wood Paneling	9001 Westmont Drive Toano, VA 23168	LANDLORD CONTACT			BABY CHANGING SIGNAGE TOILET ROOM MIRRORS BLOCKING/POWER FOR SIGNAGE	XXX	XXX	GC TO COOR, WITH B&N VENDOR	SOLITH HILL MALL
		Phone: 845-325-9455	-		Contacts: John Finney	Rick Partika, AIA, ICC—E 5577 Youngstown — Wo Niles, Ohio 44446	BPE Director of Architecture a Irren Road	nd Engineering	TOILET ROOM ACCESSORIES INTERIOR GRAPHICS TOILET ROOM SIGNS SEISMIC BRACING	XXXX	XX	GC TO COOR. WITH B&N V ENDOR	<u>South Hill Mall</u> 3500 S. Meridian Unit #800
Global Security Services	EAS	Contacts: Chris Saporito Email:			Email: jfinney@davidnicebuilders.com Phone: 757-566-2156	P: 330-743-4876, C: 330-550-6598			ELEVATORS FIRE EXTINGUISHER(S) AND CABINETS DIVISION 12-FURNISHINGS	X	X	X COORDINATE WITH A.H.J. ON LOCATIONS	PUYAËLUP, WA 98373 Project Number 33247
		chris.saporito@global—security—solutions.com Phone:			Jacob Oberding Email: joberding@davidnicebuilders.com Phone: 757.566.2156	TENANT REPRESENTATIV	F·		DISPLAY FIXTURES AND TABLES CASHWRAP RECEIVING TABLE WALL SHELVING	X	XXX	SEE FIXTURE/FURNITURE SCHEDULE	Store Number 3507
Checkpoint	EAS	101 Wolf Drive Thorofare NJ, 08086			Kelsi Foster Email: kfoster@nicewood.com	Mack Williams Barnes & Noble Bookse			RECEIVING TABLE  JANITOR'S CLOSET SHELVING AND HARDWARE  NON SALES SHELVING	XX	X	2	Revision Log:  Date Description No.
		Contacts: Allan Beam			Phone: 757.566.2156	33 East 17 <sup>th</sup> Street New York, NY 10003 E: Mwilliams1@bn.com			BREAKROOM APPLIANCES SAFES BULLETIN BOARDS	X	XXX	REFRIDGERATOR FURNISHED BY BN  BN VENDOR INSTALLS	12-19-24 ISSUED FOR PERMIT, BID, LANDLORD & CLIENT REVIEW  02-20-25 BUILDING DEPARTMENT AND LANDLORD COMMENTS  05-19-25 ISSUED FOR CONSTRUCTION 2
		Email: ABeam@checkpt.com Phone: (937) 522 5118	PCL/Ardent	Sales Floor Fixtures /	81 Legget ST.	P: 858-386-6598			BREAKROOM LOCKERS BREAKROOM CABINETS OFFICE SHELVING AND COUNTERTOP OFFICE FURNISHINGS	X X X	XXX	GC INSTALLS NICEWOOD FURNISHES. GC INSTALLS NICEWOOD FURNISHES. GC INSTALLS	$\frac{1}{2}$
		Jerry O'Leary Email: joleary@checkpt.com Phone: (1)— 800— 257— 5540 X 2311		Cafe Furniture	East Hartford, CT 06108  Contacts:				CARTS SALES PERIMETER WALL SYSTEM DIVISION 21-FIRE SUPPRESSION SPRINKLER SYSTEMS	Î X X	XX	BN MILLWORKER INSTALLS	
Scarsdale	Burglar Alarm / Fire Alarm		-		Donald Budnick Email: dbudnick@ardentdisplays.com Phone: 860.214.2233				SPRINKLER STUB SPRINKLER MAIN	XXX			
	Monitoring	Email: rmartinez@scarsdalesecurity.com Phone: 914-722-2389			Brenda Winter Email: bwinter@pclfixtures.net				SPRINKLER GRID MODIFICATIONS  DIVISION-22 PLUMBING  PLUMBING STUBS (SAN, DCW, VENT)		X	INCLUDING PERMITTING AND DRAWINGS	
			_		Phone: 860-904-6906  Larry Cahill				WATER FILTRATION SYSTEM BREAKROOM FAUCET PLUMBING WORK & FIXTURES GAS SERVICE LINE	XXX	XXX	SEE PLUMBING SHEETS	
FLOORING / TIL			_		Email: Icahill@ardentdisplays.com Phone: 972-691-5603				WATER METER PAPER TOWEL DISPENSER SOAP DISPENSERS	X	X		
Associated Flooring	Flooring— Carpet and Tile Wall — Tile	North Venice, FL 34275	Visual	Sales Floor Fixtures	500 Narragansett Park Drive				CAFÉ PAPER TOWEL DISPENSER MOP HOLDER DIVISION 23-HVAC	X X	XX		
		Contacts: Richard Goodman Email: rgoodman@assocint.com	Creations	/ Merchandise Accessories	Pawtucket, RI 02861 Contacts:				MECHANICAL EQUIPMENT HVAC PIPING/REFRIGERANT LINES OUTSIDE AIR ACCESS AND DUCTWORK	X X X	X	SEE MECHANICAL DRAWINGS  X	
		Phone: 917-328-1462 Robert Odgis			Kathleen Rohrman Email: krohrman@vci—displays.com Phone: 401—862—7462				RELIEF AIR ACCESS AND DUCTWORK DUCTWORK & AIR DEVICES FIRE DAMPERS	X X	X	X X	These plans are an instrument of service and the property of the Architect, infringements will be prosecuted.
		Email:bodgis@assocint.com Phone: (973) 376 1111	SAMA	Sales Floor Fixtures /	20 Sand Park Road Cedar Grove, NJ 07009				TEMPERATURE CONTROL SYSTEM DUCT SMOKE DETECTORS SMOKE EVAC & CONTROLS	XX		LIGHTSTAT  X	General Contractor to verify all conditions and dimensions at the premises. Discrepancies shall be reported to the Architect prior to the
RHI Inc.	Tile and Carpet Installation		-	Café Furniture / Merchandise Accessories	Contacts:				TOILET EXHAUST FAN, DUCTWORK, ROOF CAP AIR BALANCE REPORT DIVISION 26-ELECTRICAL / DIVISION 27-COMMUNICATION MAIN SWITCH/BREAKER IN LL'S ELECTRICAL ROOM	X X X X X X X X X X X X X X X X X X X		CERTIFIED REPORT BY INDEPENDENT AGENCY REQUIRED.	commencement of any work.  Professional Seal:
	(Flooring and Wall)	Suite 106 Elkridge, MD 21075			Mark Wolfberg Email: mlwolfberg@samaplastics.com Phone: (973) 239—7200				TENANT ELECTRICAL METER  MAIN SERVICE CONDUIT  MAIN SERVICE WIRING	X			
		Contact: Marty Hilliard Email: mhilliard@rhi—flooring.com	IMG	n/a					TELEPHONE CONDUIT & PULL WIRE TO SPACE TELEPHONE CONDUIT & PULL WIRE FROM STUB TO BOARD TELEPHONE WIRE FROM LL ROOM TO TENANT BOARD	x x	X	Y	22005563 REGISTERED ARCHITECT
		Phone: 443-677-8408	TinkerTin	n/a					TENANT ELECTRICAL PANELS (SWITCHGEAR) TENANT ELECTRICAL TRANSFORMERS HVAC POWER CONNECTION AND DISCONNECT	X X X	<b>X</b>	SEE ELECTRICAL DRAWINGS  LL IS RESPONSIBLE FOR PROVIDING UNITS IS GOOD WORKING CONDITION	JOEL TORIELLI STATE OF WASHINGTON
<u>LIGHTING</u>			FURNITURE  Japon Chair		534 E OTU CTDEET				CONDUIT, WIRING & DEVICES LIGHTING FIXTURES /LAMPS LIGHTING AND SIGNAGE CONTROLS	A X X	X	DELIVERY BY BN MDS - ANY CHANGES TO GO THROUGH BN	LIC.# : 22005563
Specialty Lighting	Lighting	74 Pickering Street Portland, CT 06480	Jasper Chair	Café Seating / Sales Floo Seating	OASI ER, IN 47540				TELEPHONE SYSTEM PHONE AND DATA CONDUIT PHONE AND DATA CABLING	X	X		EXP. DATE : 10/02/25  Drawing Description:
		Contacts: Meghan Donooghue Email: meghan.donoghue@sslighting.com			Contacts: David Laforest Email: dlaforest@jasperchair.com				SOUND SYSTEM WIRING SOUND SYSTEM AND SPEAKERS FIRE ALARM	X X X	XXXX	MOOD MEDIA INCLUDING PERMITTING AND DRAWINGS	Vendor List, Responsibility Schedule
		Phone: (860)767-0110 x232	CF Group	Kids Ottomans / Café	Phone: 401.578.7382  Contacts:		•		SECURITY SYSTEM  COMPUTERS  LOW VOLTAGE PERMITS  LOW VOLTAGE EMPLOYEE BUZZER	X X	X	GC TO PROVIDE CONDUIT PULL STRINGS AND J-BOXES	and Contacts  Drawing Number:
		Email: paul.odonnell@sslighting.com Phone: (203) 499-7030		Table Bases & Legs	Steve Cohen Email: scohen@mycfgroup.com Phone: 636-448-3465				LOW VOLTAGE EMPLOYEE BUZZER  LOW VOLTAGE DELIVERY BUZZER  CCTV  POINT OF SALE (POS)	X X	XXX		A-002







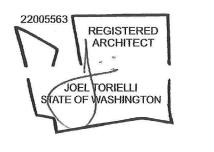

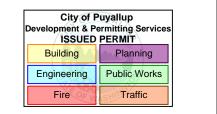

PRCTI20250011

PROJECT DESIGNER:



ARCHITECT: JOEL TORIELLI 422 BOGERT AVE RIDGEWOOD, NJ 07450

UNIT #800 PUYAĽLUP, WA 98373 Project Number 33247


Revision Log:

е	Description	No.
9-24	ISSUED FOR PERMIT, BID, LANDLORD & CLIENT REVIEW	$\overline{\Delta}$
20-25	BUILDING DEPARTMENT AND LANDLORD COMMENTS	$\overline{\Lambda}$
19-25	ISSUED FOR CONSTRUCTION	2
		$\triangle$
		$\overline{\Lambda}$


These plans are an instrument of service and the property of the Architect, infringements will be


General Contractor to verify all conditions and dimensions at the premises. Discrepancies shall be reported to the Architect prior to the commencement of any work.

Professional Seal:

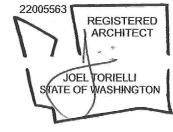

LIC.# : 22005563 EXP. DATE : 10/02/25

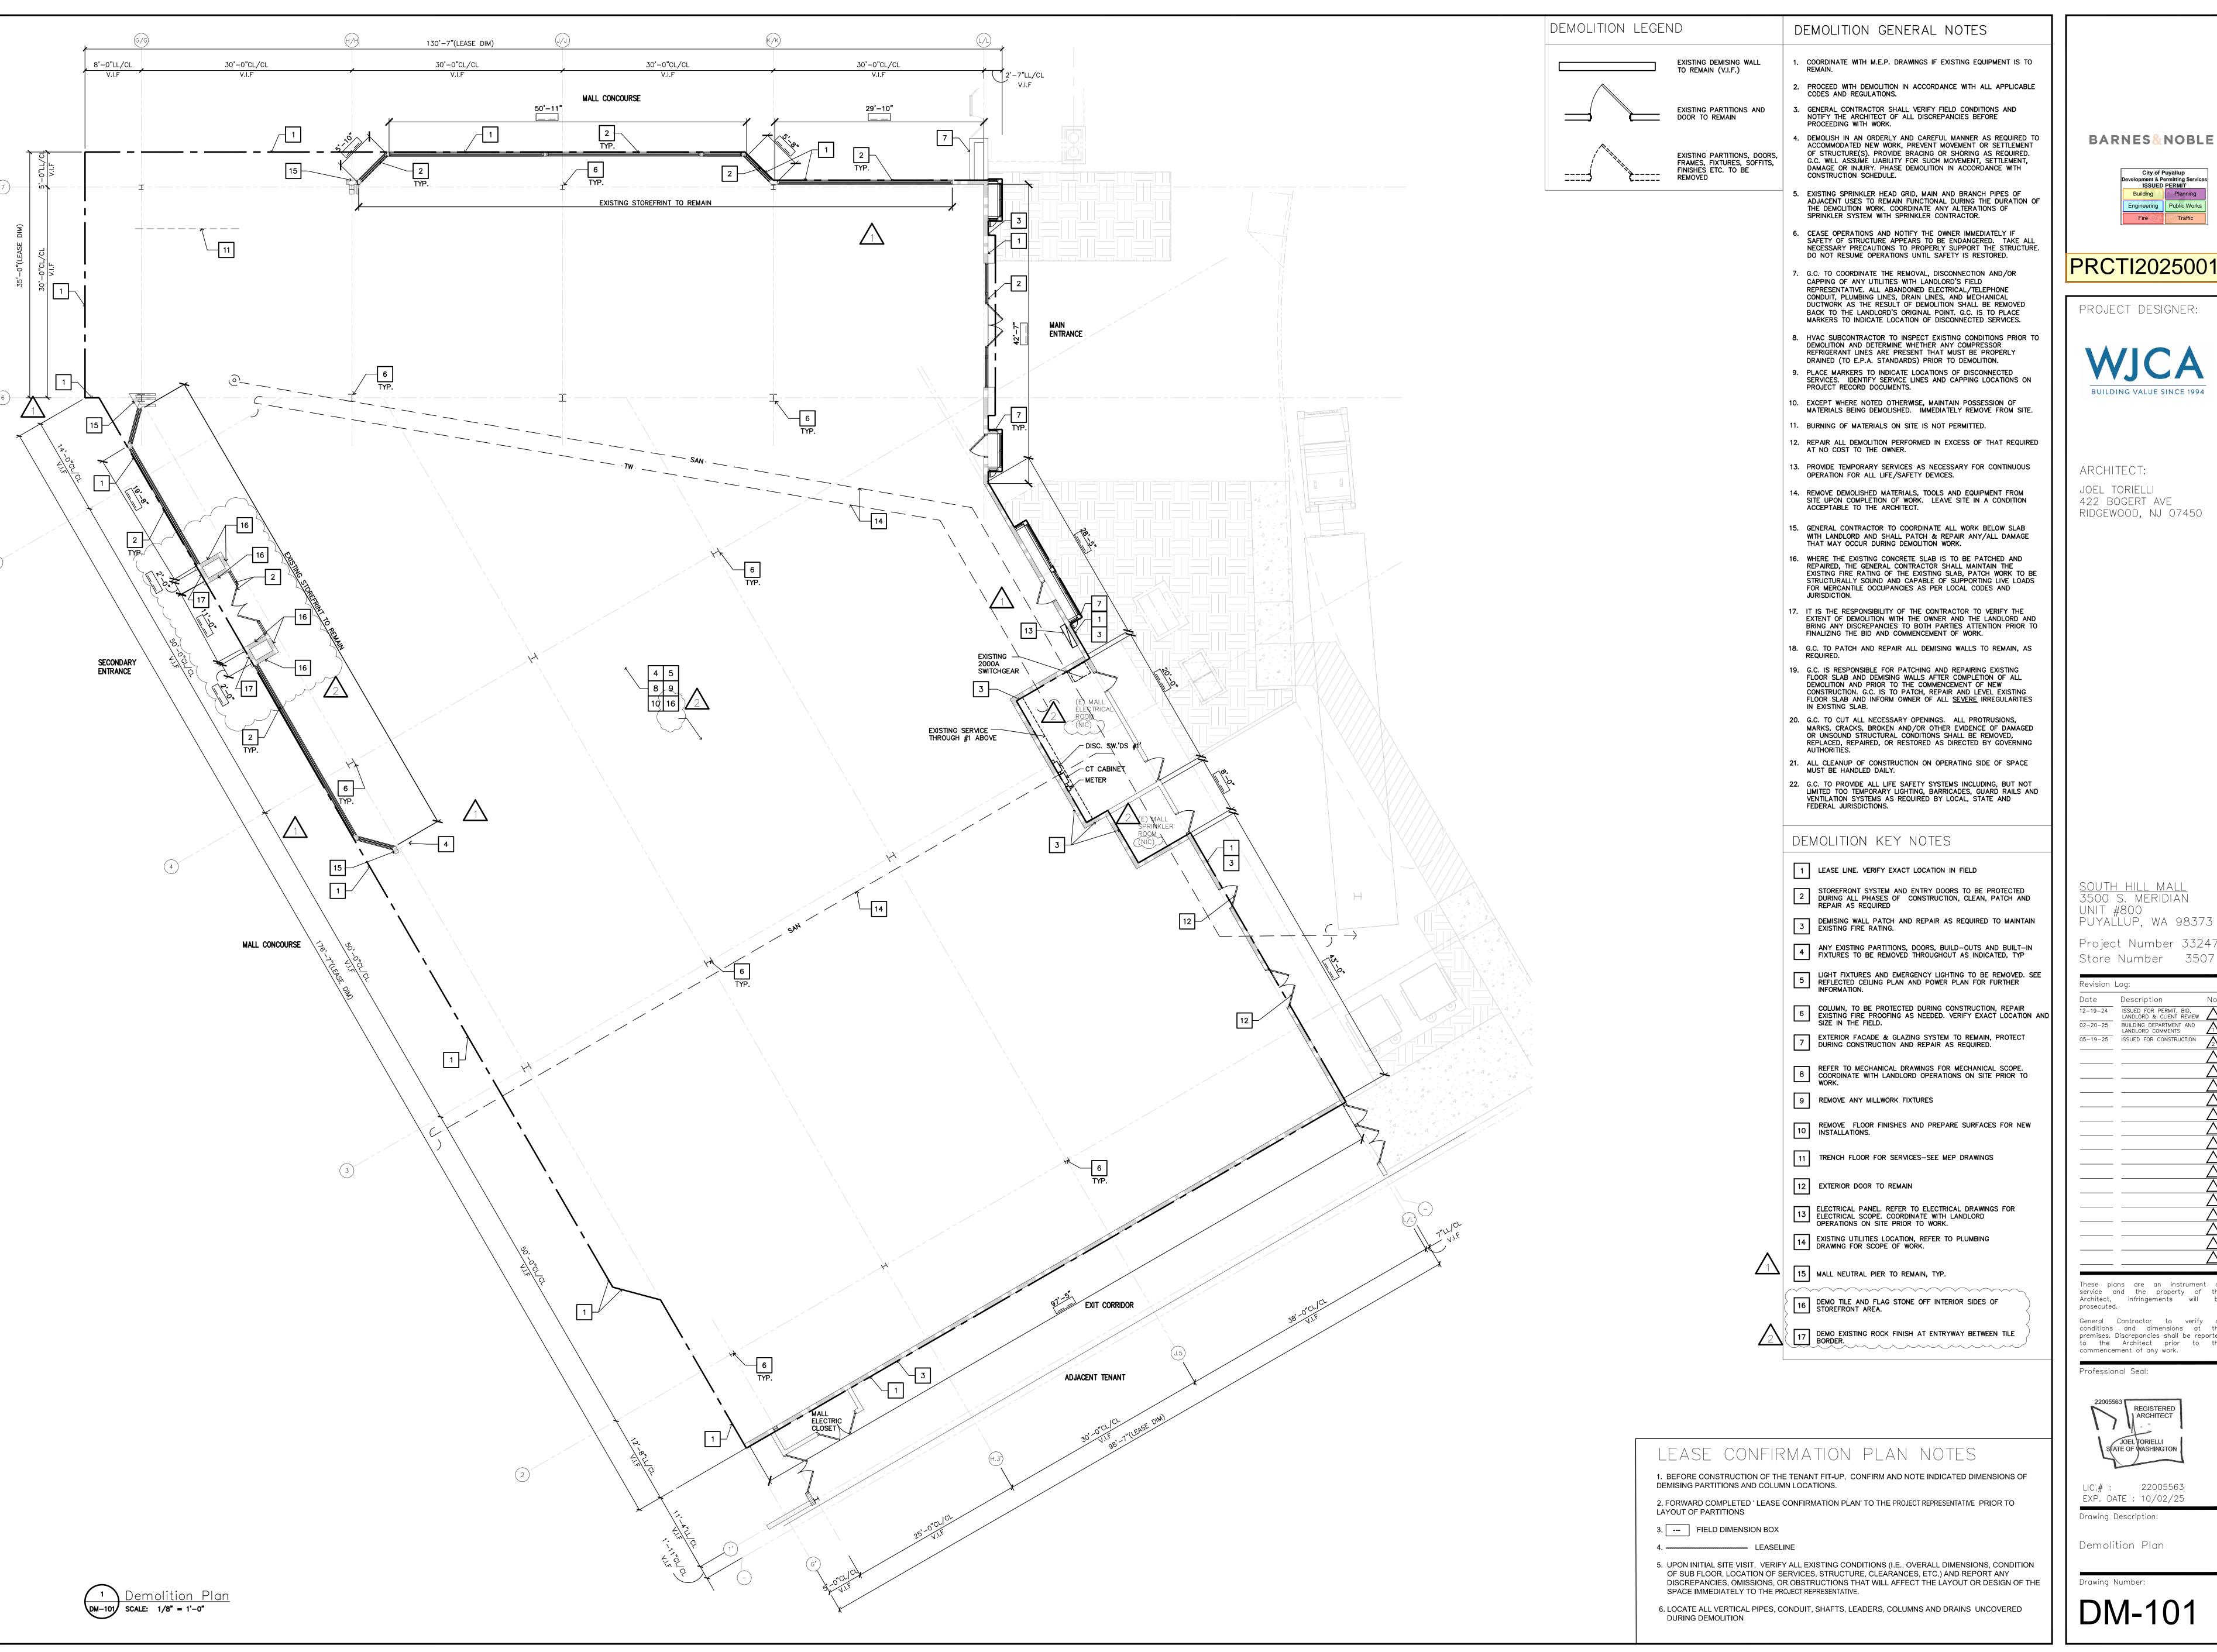

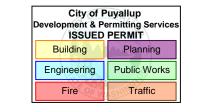



ARCHITECT: 422 BOGERT AVE RIDGEWOOD, NJ 07450


PUYAĽLUP, WA 98373 Project Number 33247 Store Number 3507

Description 12-19-24 ISSUED FOR PERMIT, BID, LANDLORD & CLIENT REVIEW 02-20-25 BUILDING DEPARTMENT AND LANDLORD COMMENTS 05-19-25 ISSUED FOR CONSTRUCTION

These plans are an instrument of service and the property of the Architect, infringements will be

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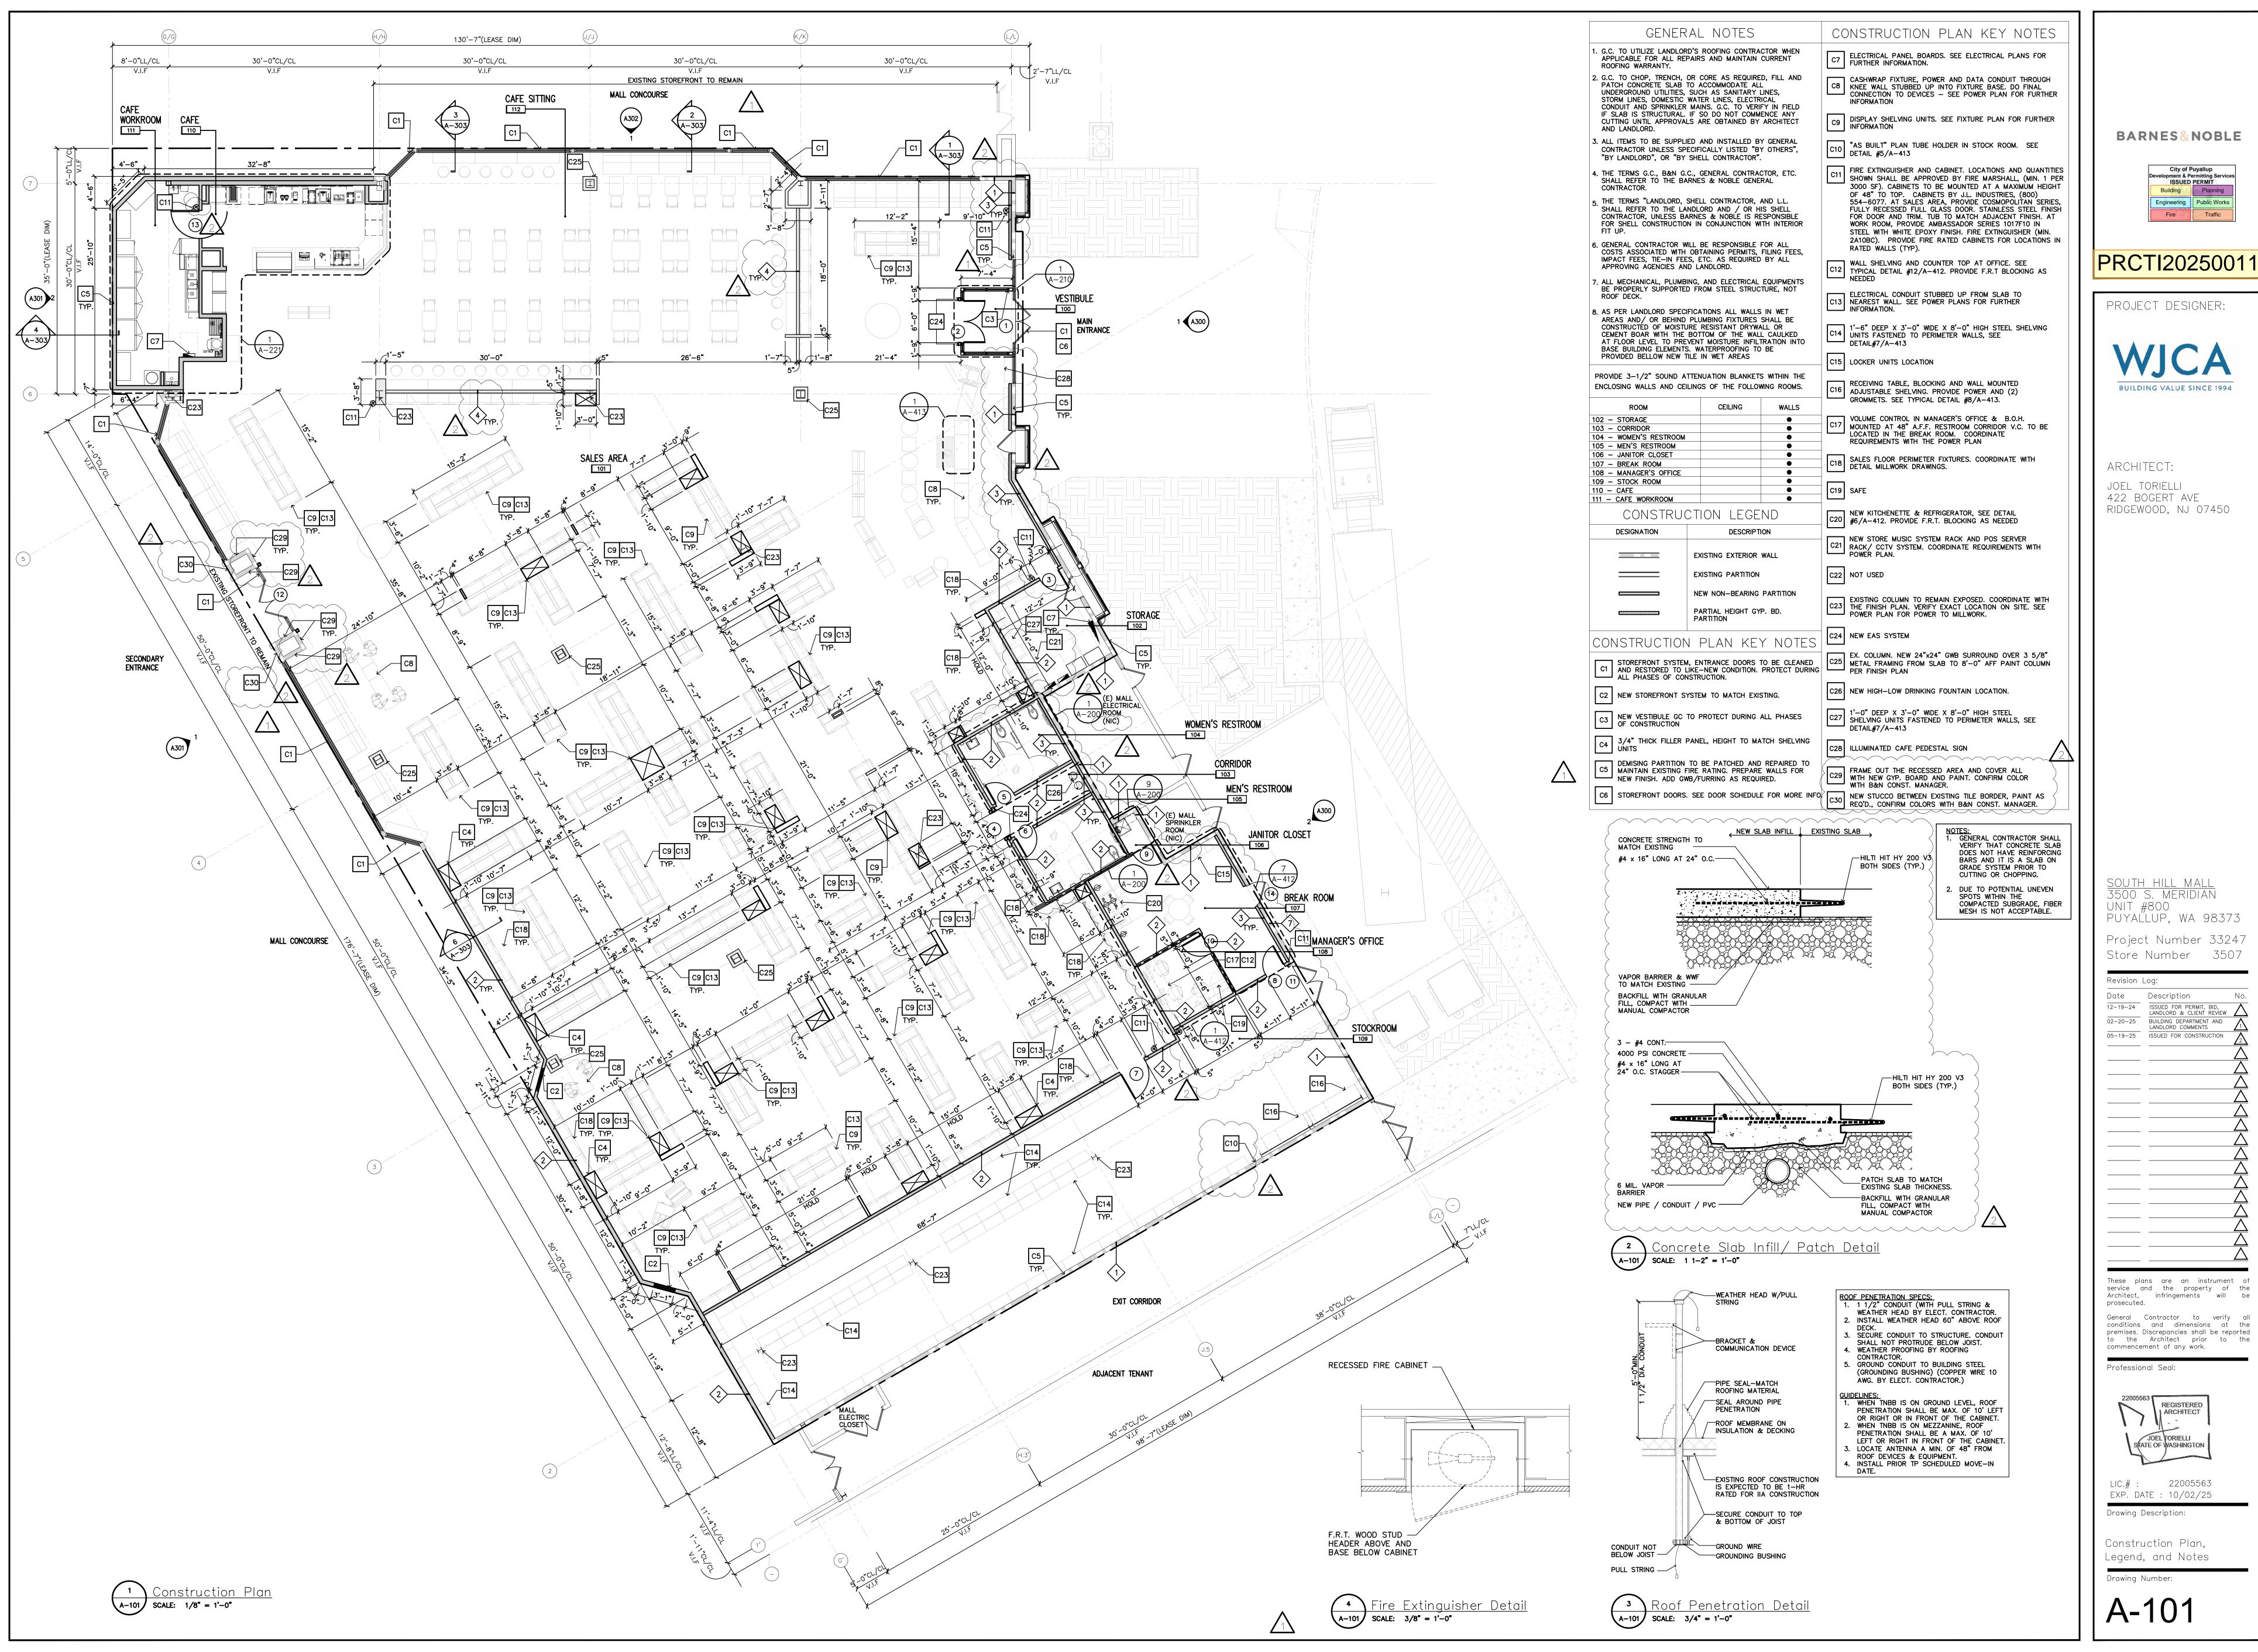
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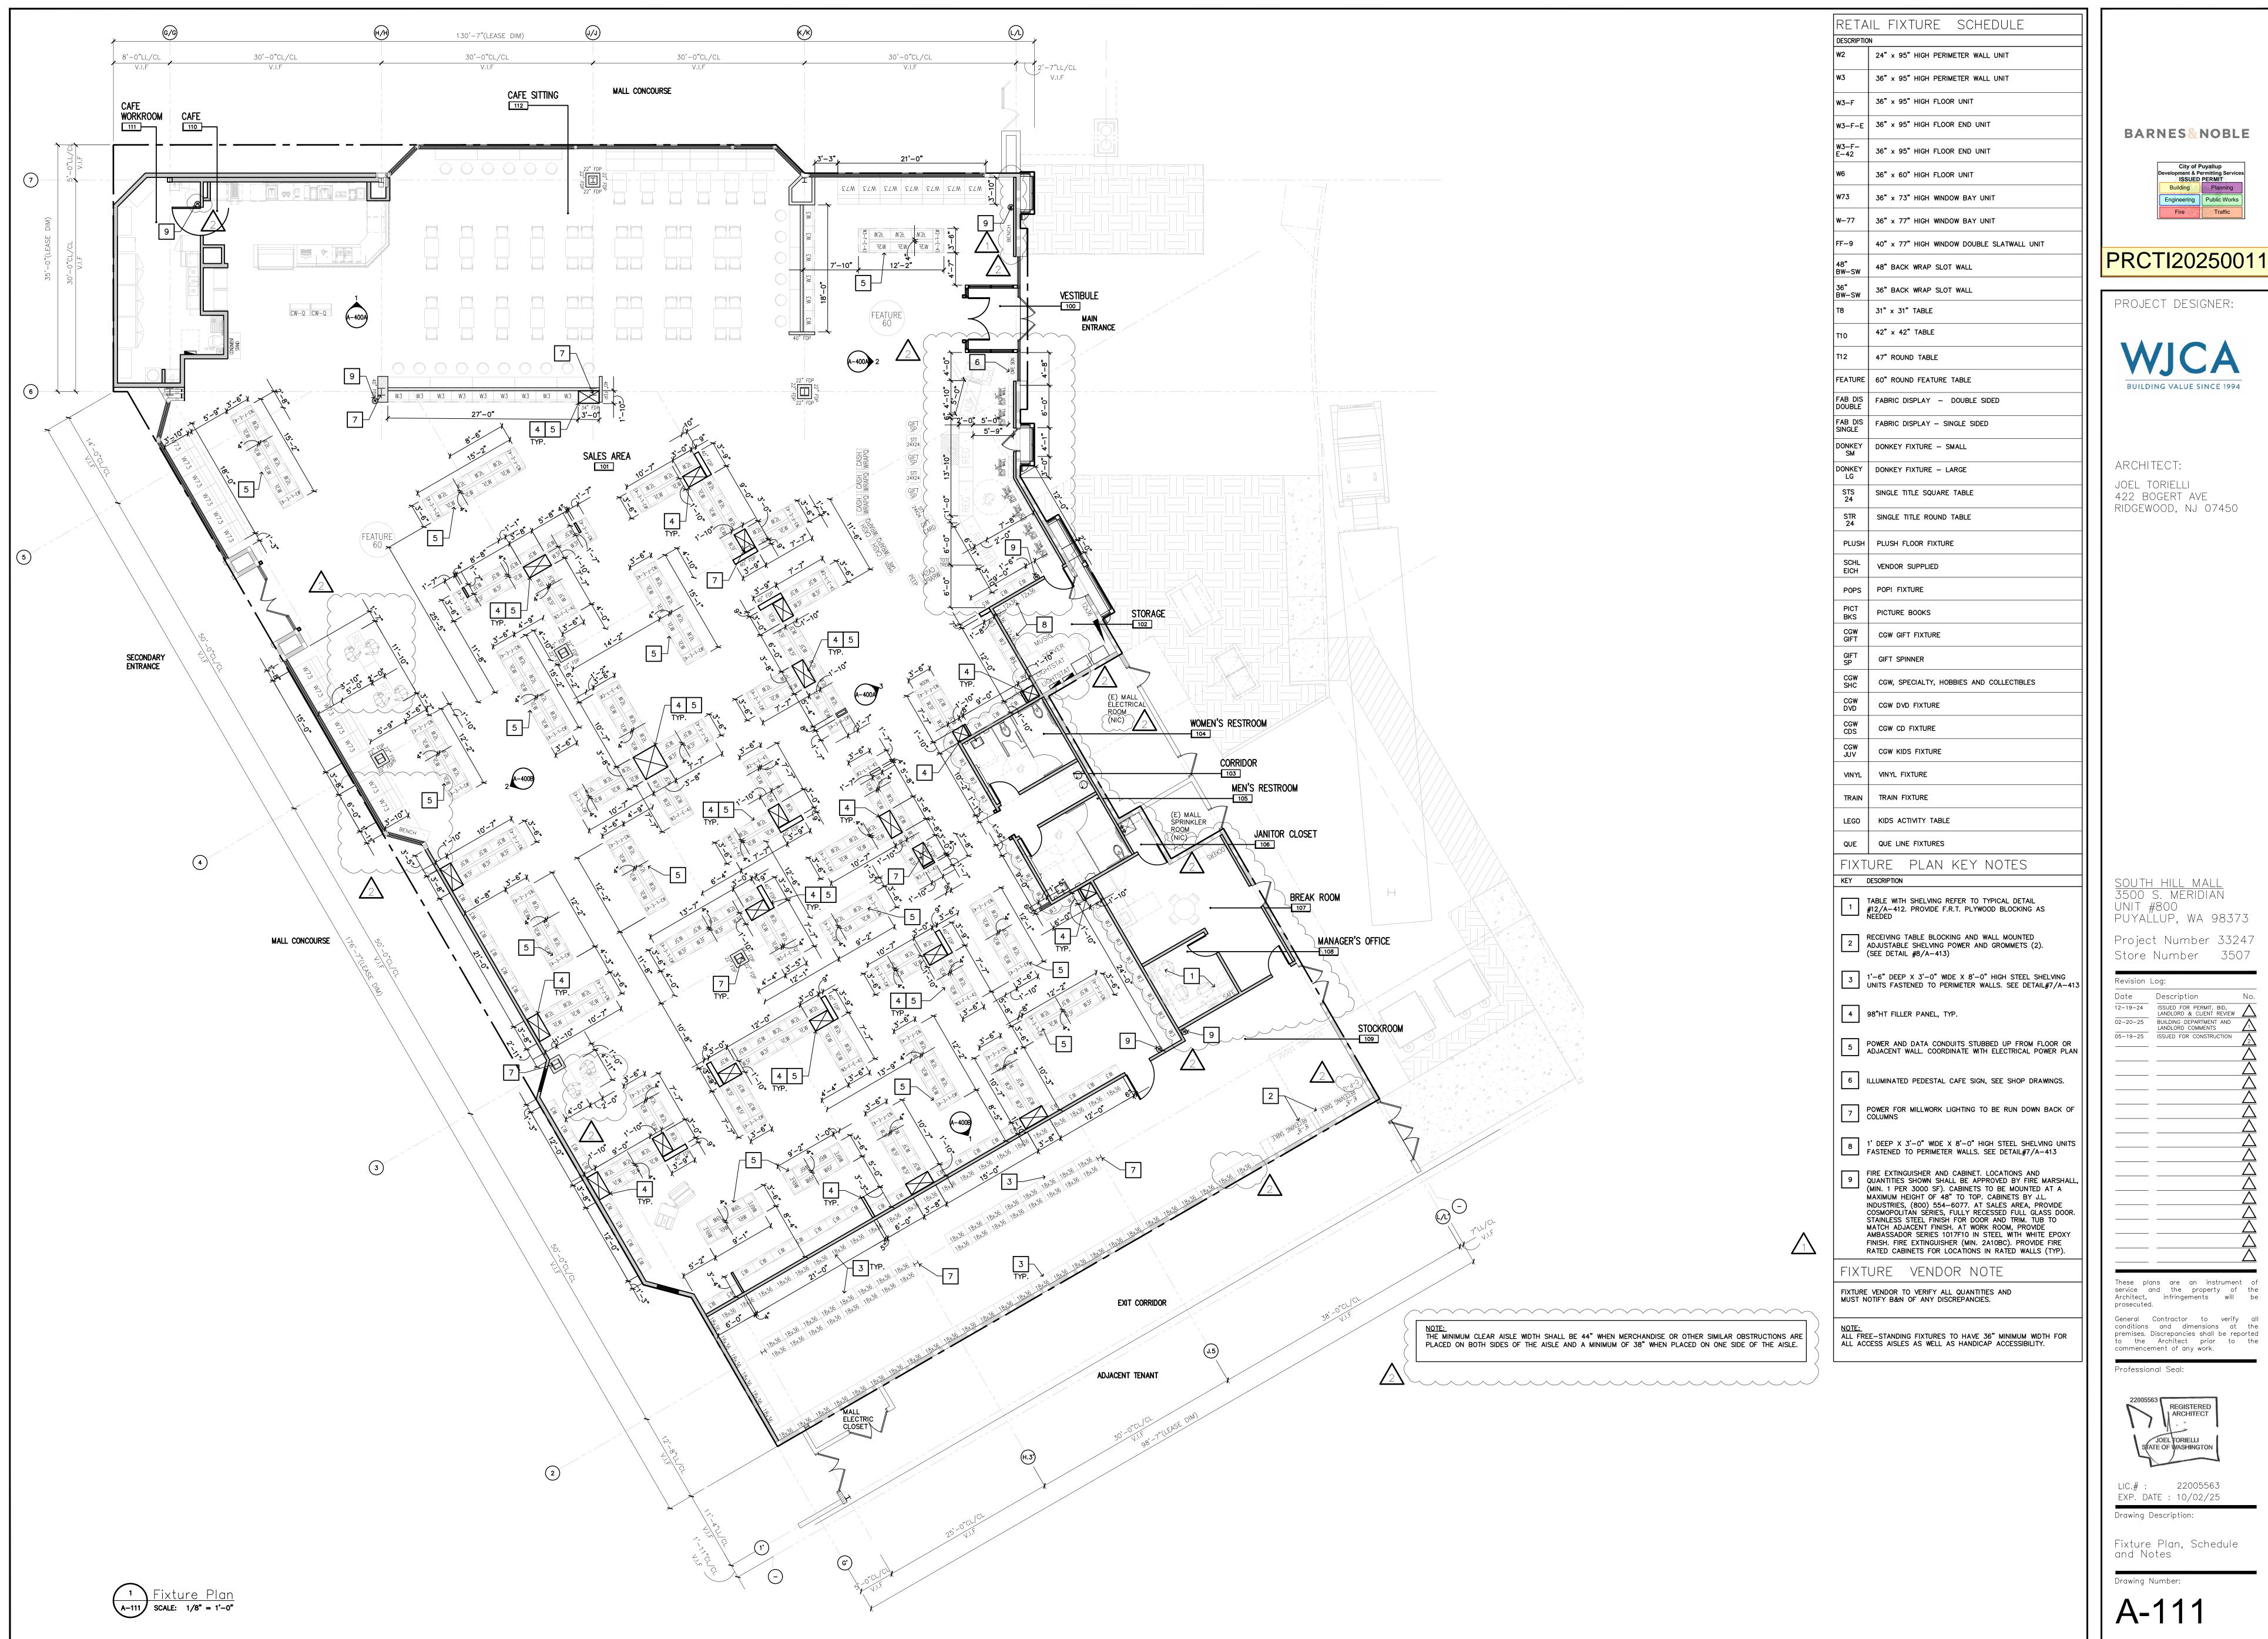



EXP. DATE : 10/02/25

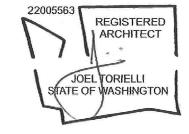Drawing Description:

Demolition Plan





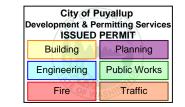



CEILING NOTES

USE ONLY 12 GAUGE STEEL WIRE FOR ALL SUSPENDED CEILING SYSTEMS AT 48" O.C. WRAP 3 FULL TIMES. SEE A-420 DRAWINGS REGARDING CEILING BRACING REQUIREMENTS. 2. REFER TO MECHANICAL DRAWINGS FOR LOCATION OF ALL FIRE DAMPERS AND DIFFUSERS.

3. G.C. TO PROVIDE FIRESTOPPING/DRAFTSTOPPING ABOVE CEILING AS REQUIRED BY CODE. 4. LOCATE RECESSED DOWN LIGHTS CENTERED IN TILES U.O.N.

5. G.C. TO PAINT ALL SUPPLY / RETURN GRILLES, AND LIGHTING TRIM SET IN DRYWALL CEILINGS AND SOFFITS SAME COLOR TO MATCH ADJACENT DRYWALL SURFACE. SEMI-GLOSS

6. G.C. TO PAINT ALL SUPPLY / RETURN GRILLES, AND LIGHTING TRIM SET IN A.C.T. CEILINGS OTHER THAN WHITE TO MATCH COLOR OF A.C.T.

7. FOR EMERGENCY LIGHT FIXTURE LOCATIONS REFER TO ELECTRICAL ENGINEER'S DRAWINGS

8. ALL CEILING HEIGHTS SHALL BE REFERENCED FROM FLOOR SLAB ELEVATION 0'-0" 9. ALL LIGHTING FIXTURES SPECIFIED WITHIN THE CAFE SERVICE AREA AS WELL AS THE CAFE WORK ROOM SHALL BE LENSED AS REQUIRED BY THE LOCAL HEALTH DEPARTMENT. 10. GENERAL CONTRACTOR TO OBTAIN LIGHTING FIXTURE CUT SHEETS FROM LIGHTING SUPPLIER AND COORDINATE ALL MOUNTING DETAILS AND INSTALLATION PROCEDURES WITH

11. ALL CEILING GRID SUPPORTS ATTACHED TO BAR JOISTS SHALL BE ATTACHED TO THE TOP CHORD OR THE BOTTOM CHORD AT A PANEL POINT ONLY WITH THE APPROVAL FROM THE BUILDING STRUCTURAL ENGINEER.

CEILING KEY NOTES

1 NEW SUSPENDED HIGH BAY FIXTURES THROUGHOUT THE SALES FLOOR.

2 NEW TRACK LIGHTING THROUGHOUT THE SALES FLOOR

EXTERIOR SIGNAGE MOUNTED TO FASCIA. REFER TO VENDOR SHOP DRAWINGS AND ELECTRICAL PLANS FOR FURTHER INFORMATION. PROVIDE POWER AS REQ'D

4 MECHANICAL DUCTS - REFER TO MECHANICAL PLANS FOR NEW SCOPE OF WORK.

5 NEW GWB CEILING AT ENTRY VESTIBULE, UNDERSIDE OF VESTIBULE CLG. TO ALIGN WITH TOP OF EXISTING TRANSOM WINDOW

6 VERIFY ALL EXTERIOR LIGHTING IS IN GOOD WORKING ORDER, REPLACE AS NEEDED 7 UNDERSIDE OF DECK, STRUCTURE AND DUCTWORK TO BE PAINTED

8 ALL NEW EMERGENCY LIGHT FIXTURES THROUGHOUT WALL MOUNTED OR SUSPENDED FROM CEILING

9 ADJUST ANY CEILING DEVICES DUCTWORK, ETC. IF THERE IS CONFLICT WITH NEW LIGHT FIXTURE LOCATIONS.

10 MODIFY SPRINKLER HEAD LOCATION AS REQUIRED FOR NEW PLAN 

DRYWALL MISSING AT SOME SOFFIT AREAS THROUGHOUT JOBSITE. PATCH, REPAIR AND/OR ADD AD REQ'D.

LICHT FIVIUSE SCHEDINE (LICHT CONCEST)

SYMBOL	TAG	LOAD (VAE)	DESCRIPTION	AREA
<b>©</b>	НВ	15	HIGH BAY HALOGEN LIGHTINGS NUVO SF76-283, L16A19N1530K FINISH: WHITE	SUSPENDED IN SALES FLOOR AT 8'-0" A.F.F.
<b>©</b>	HB-B	15	HIGH BAY HALOGEN LIGHTINGS NUVO SF76—283, L16A19N153OK FINISH: BLACK	SUSPENDED ABOVE CAFE SEATING AREA AT 8'-0" A.F.F.
	LW-01	22	NEW TRACK HEADS MANUFACTURER: ATTAIN LED TRACK HEAD HP MODEL: AT-25-35-95-24-WH-J	TRACK MOUNTED IN SALES AREA
	LWT-01 TRACK	-	NEW PENDANT MOUNTED MANUFACTURER: CONTECH SINGLE CIRCUIT LINE VOLTAGE TRACK VARIOUS LENGTHS— WHITE UNISTRUT AND HANGING HARDWARE	SUSPENDED IN SALES FLOOR AT 12'-0" A.F.F.
0 0	A1	68	BOH LIGHTING MANUFACTURER: LITHONIA LIGHTING MODEL: TZL1N LED L96 10000LM FST MVOLT 30K 80CRI PLR E7W WH	SUSPENDED AT 12'-0" A.F.F. IN STOCK ROOM
A2	A2	-	OFFICE AND BREAK ROOM LIGHTING MANUFACTURER: DT BY TCP MODEL: DTF2UZD3835K	LAY-IN CEILING
A3	A3	46	ATTAIN 2 FT. X 4 FT. INTEGRATED LED 4000 LUMENS 4000K 120V COMMERCIAL GRADE RECESSED TROFFER W/ PRISMATIC LENSES	LAY-IN CEILING
0 0	A14	34	MANUFACTURER: LITHONIA LIGHTING MODELS: ZL1N LED STRIPLIGHT L48 5000LM FST MVOLT 30K 80CRI PLR E7W WH	SURFACE MOUNTED TO CEILING OR SUSPENDED AT 12FT A.F.F.
<b>⊗</b> X1	X1	3.8	THERMOPLASTIC LED EXIT SIGN MANUFACTURER: BEST LIGHTING MODEL: EZXTEU-2RW-EM	SUSPENDED OR WALL MOUNTED AT 8'-0" A.F.F. MIN. B.O. SIGN
X2	X2	5	LED EXIT SIGN AND EMERGENCY LIGHT, THERMOPLASTIC COMBO MANUFACTURER: BEST LIGHTING MODEL: LEDCXTEU-2-R-W-RC	SUSPENDED OR WALL MOUNTED AT 8'-0" A.F.F. MIN. B.O. FIXTURE
EM1	EM1	5	EMERGENCY LIGHT MANUFACTURER: ASTRALITE MODEL: EU-5-LED	SUSPENDED OR WALL, MOUNTED AT 10'-0" A.F.F. MIN. B.O. FIXTURE (SALES AREA) OR AS HIGH AS POSSIBLE (NON-SALES)
EM2	EM2	2	EXTERIOR EMERGENCY LIGHT MANUFACTURER: BEST LIGHTING MODEL: LED HIGH LUMEN THERMOPLASTIC HPEM	WALL MOUNTED AT 8'-0" A.F.F. MIN. B.O. FIXTURE
Ф	D4	12	4" DIAMETER LED DOWNLIGHT MANUFACTURER: ATTAIN LED MODEL: AT-DL4-12-35-WH	RECESSED IN CAFE CEILING

6" DIAMETER LED DOWNLIGHT

MANUFACTURER: MAXI LUME

MODEL: H6-LED-2000L-DIM10-120-

MD-35K-90/ L607 SHZ WH

LED TUBE PENDANT ADJUSTABLE MANUFACTURER: CORONET LED MODEL:

8ft: CRD3-8-30-HIGH-UNV-DB-BLK -AC-SD

6ft: CRD3-6-30-HIGH-UNV-DB-BLK -AC-SD

4ft: CRD3-4-30-HIGH-UNV-DB-BLK -AC-SD

2ft: CRD3-2-30-HIGH-UNV-DB-BLK

\_\_\_\_

OCCUPANCY

SENSOR (LIGHTSTAT)

22" DIAMETER LED PENDANT
MANUFACTURER: WAYFAIR
MODEL: METAIRIE 1 LIGHT SINGLE
DOME PENDANT


SUSPENDED ABOVE
CASHWRAP AT
7'-6" AFF FROM
J-BOX AT DECK

RECESSED IN

SUSPENDED ABOVE COUNTER AT 9'-0" AFF

DECK MOUNTED
J-BOX WITH 3/4"
CONDUIT DROP
10'-6" AFF

BARNES&NOBLE

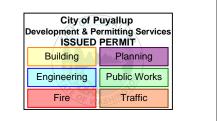

PRCTI20250011

PROJECT DESIGNER:



ARCHITECT: JOEL TORIELLI 422 BOGERT AVE RIDGEWOOD, NJ 07450

UNIT #800 PUYAÜLUP, WA 98373


Project Number 33247 Store Number 3507

Revision Log: Date Description 12-19-24 ISSUED FOR PERMIT, BID, LANDLORD & CLIENT REVIEW

02-20-25 BUILDING DEPARTMENT AND LANDLORD COMMENTS

05-19-25 ISSUED FOR CONSTRUCTION These plans are an instrument of service and the property of the Architect, infringements will be prosecuted.


General Contractor to verify all conditions and dimensions at the premises. Discrepancies shall be reported to the Architect prior to the commencement of any work.

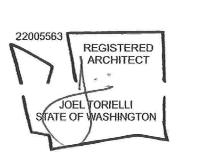



Professional Seal:

EXP. DATE : 10/02/25

Drawing Description: Reflected Ceiling Plan Legend, and Notes

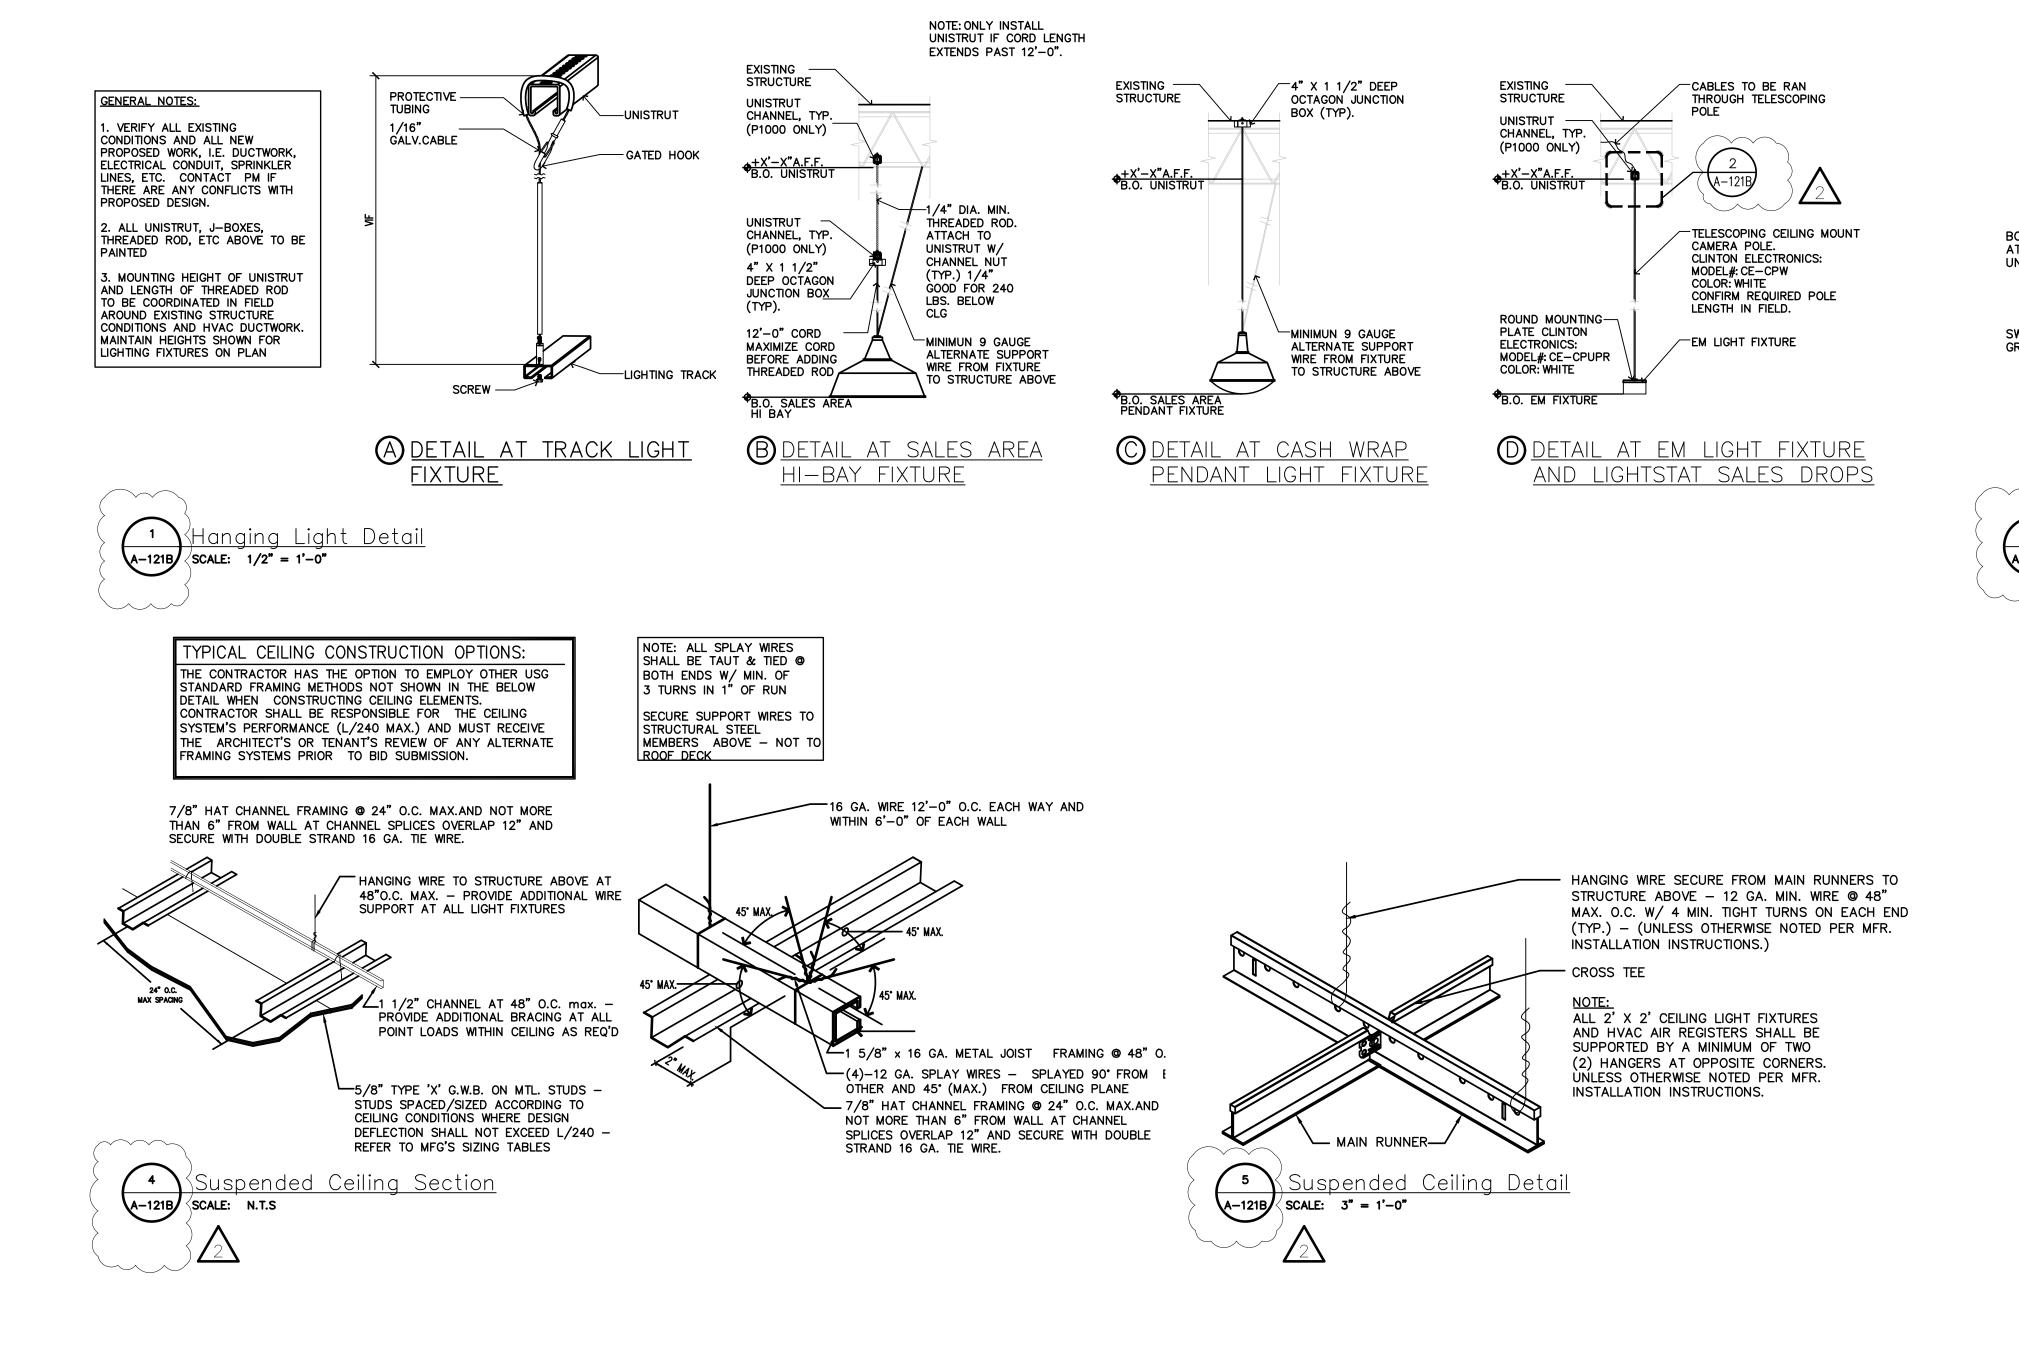

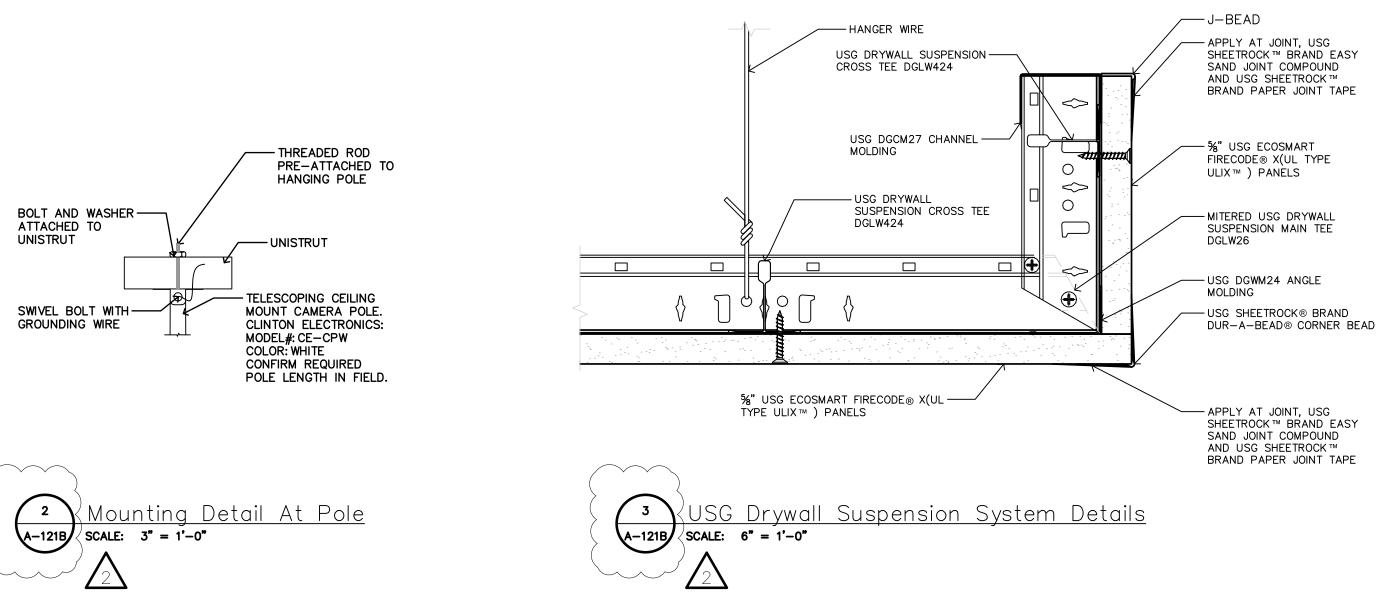

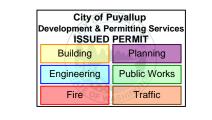

PRCTI20250011

PROJECT DESIGNER:



ARCHITECT:

JOEL TORIELLI

422 BOGERT AVE
RIDGEWOOD, NJ 07450

<u>SOUTH HILL MALL</u> 3500 S. MERIDIAN

UNIT #800 PUYALLUP, WA 98373 Project Number 33247

Store Number 3507


Revision Log:

Revision	Log:	
Date	Description	No.
12-19-24	ISSUED FOR PERMIT, BID, LANDLORD & CLIENT REVIEW	$\overline{\Delta}$
02-20-25	BUILDING DEPARTMENT AND LANDLORD COMMENTS	$\overline{\Lambda}$
05-19-25	ISSUED FOR CONSTRUCTION	2
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General Contractor to verify all conditions and dimensions at the premises. Discrepancies shall be reported to the Architect prior to the commencement of any work.

Professional Seal:




LIC.# : 22005563 EXP. DATE : 10/02/25

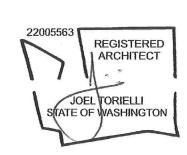Drawing Description:

Reflected Ceiling Plan

Orawina Number

A-121B

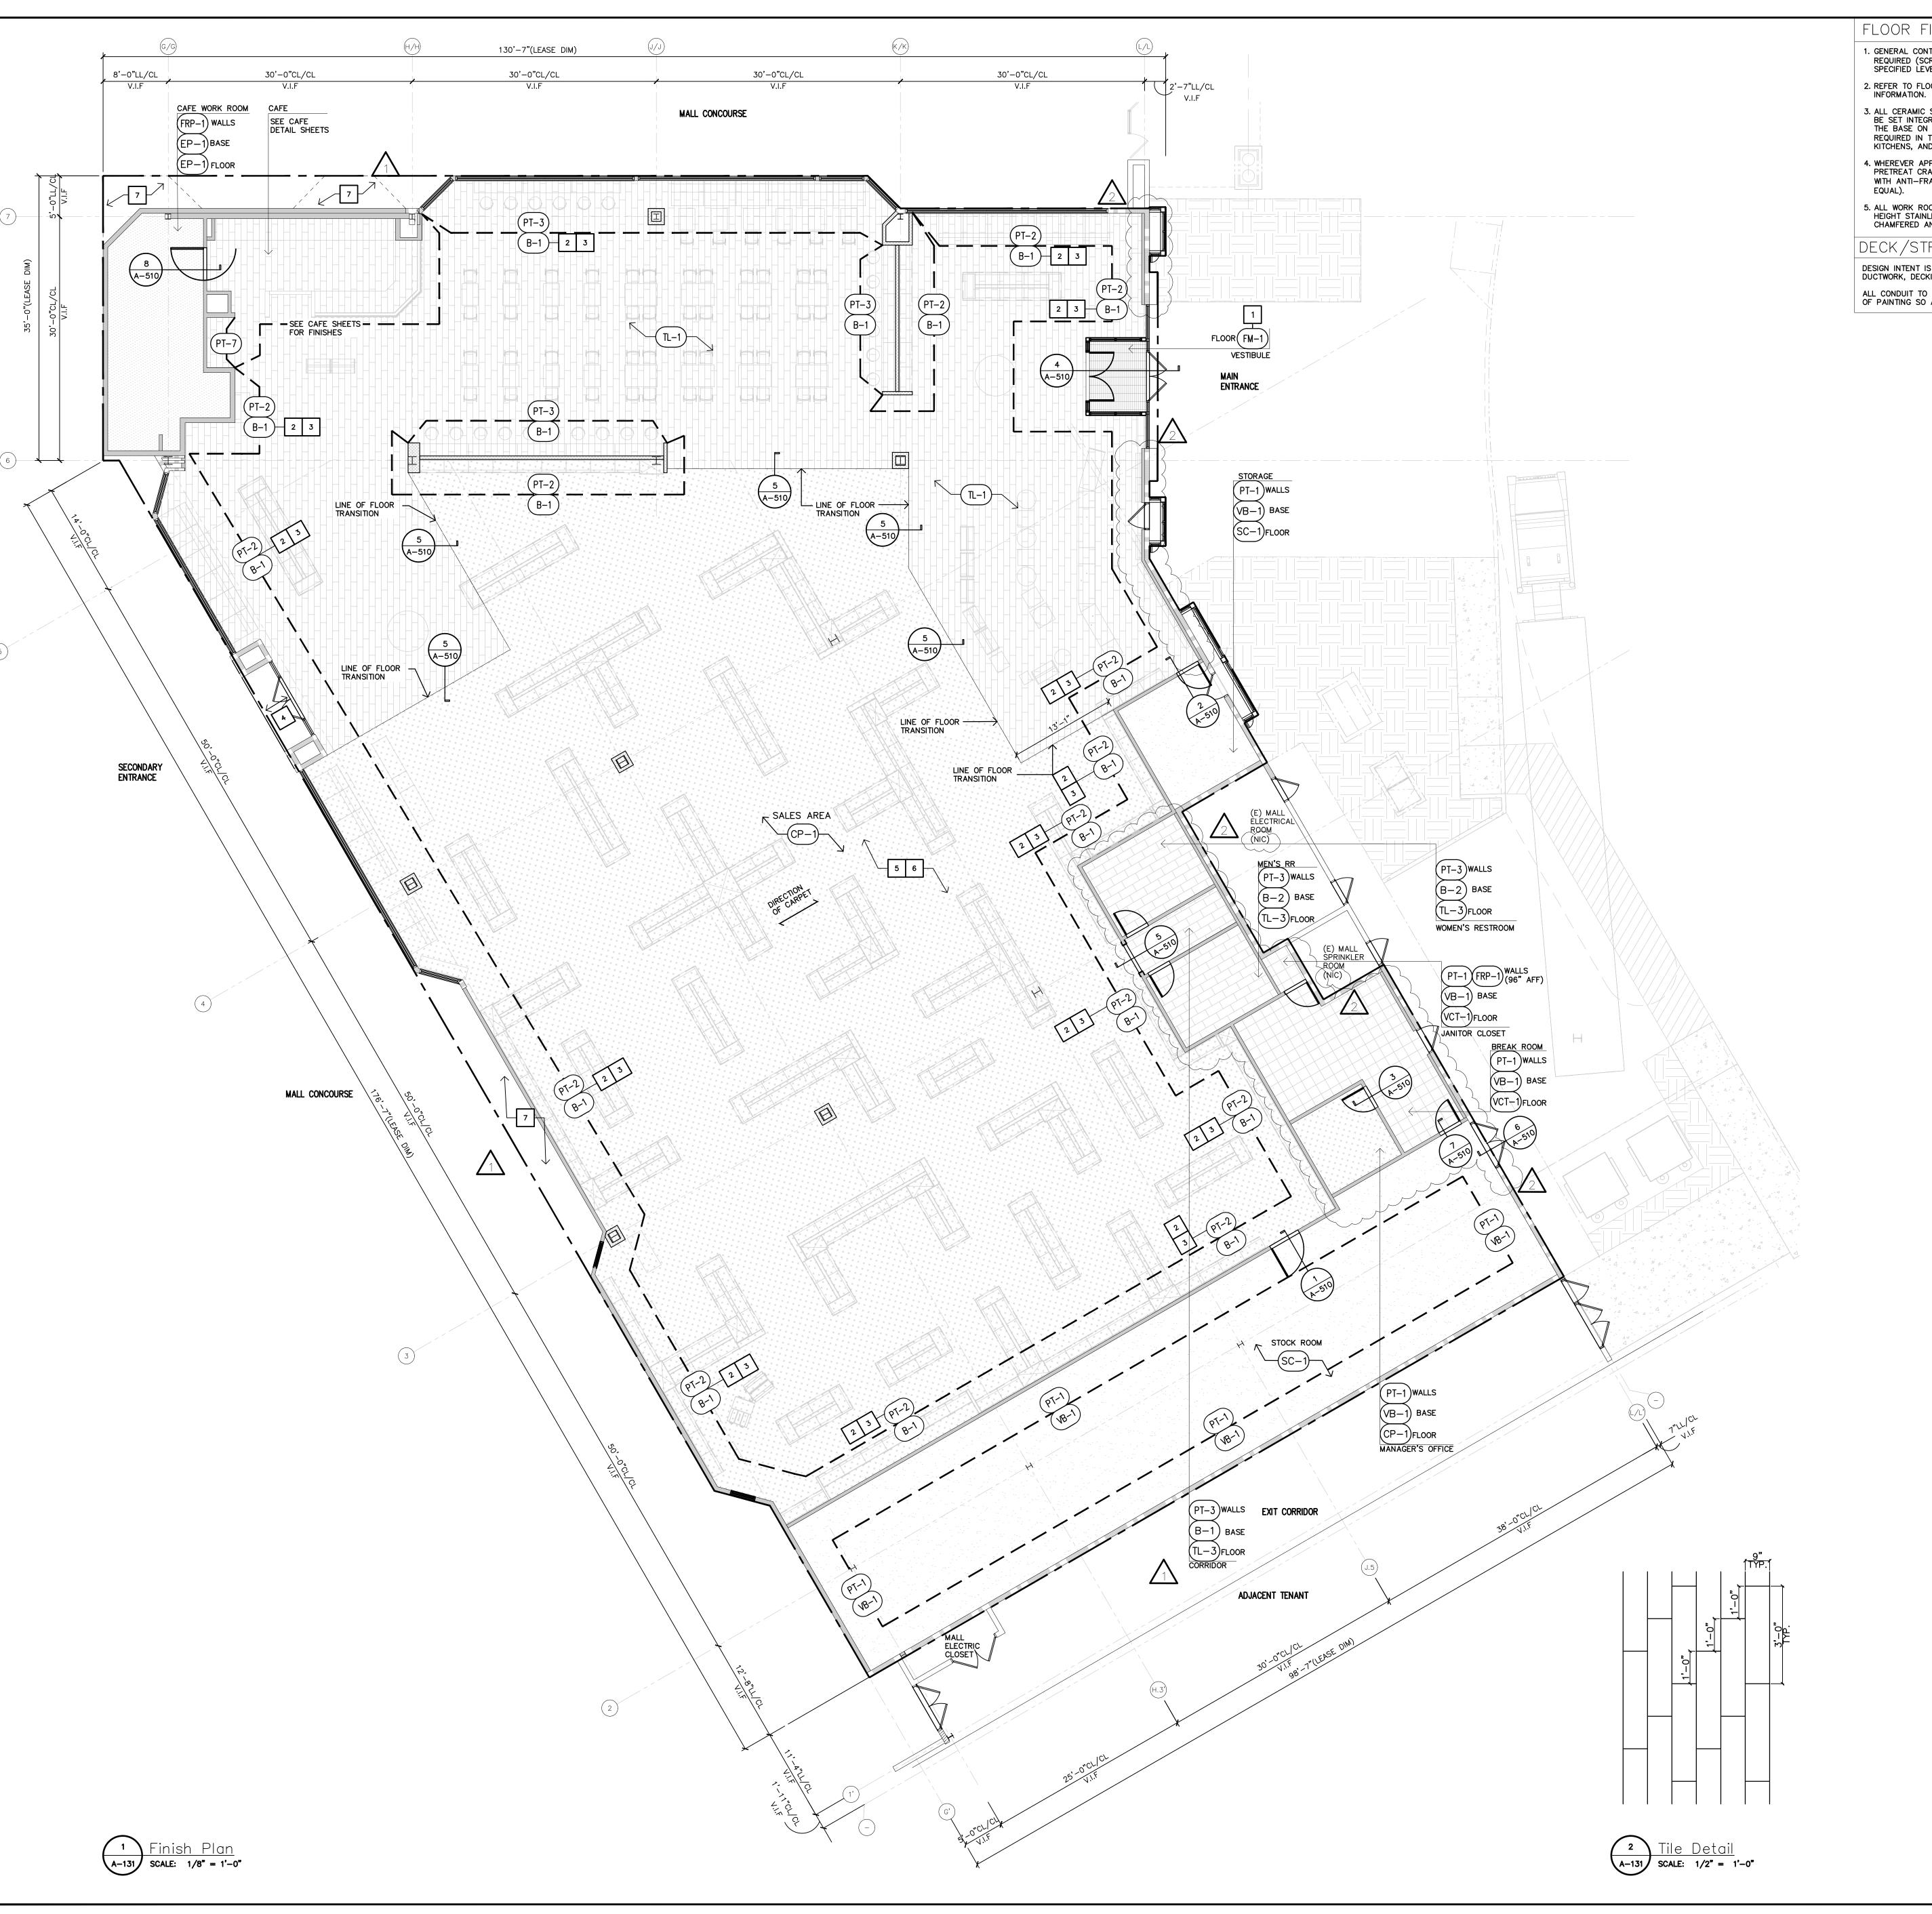

FLOOR FINISH REQUIREMENTS

1. GENERAL CONTRACTOR TO PREPARE FLOOR AS REQUIRED (SCRAPING, LATEXING ETC.) TO RECEIVE SPECIFIED LEVEL FLOOR FINISHES.

2. REFER TO FLOORING TRANSITION DETAILS FOR MORE 3. ALL CERAMIC SANITARY COVE BASE MATERIAL MUST BE SET INTEGRAL WITH FLOOR TILE. <u>DO NOT</u> SET THE BASE ON TOP OF FLOOR TILE. THIS IS

REQUIRED IN THE TOILET ROOMS, JANITOR'S CLOSET, KITCHENS, AND SERVICE AREA. 4. WHEREVER APPLICATION OF TILE FLOORING, PRETREAT CRACKS, COLD JOINTS, CONTROL JOINTS WITH ANTI-FRACTURE MEMBRANE (LATICRETE OR

5. ALL WORK ROOM WALLS TO RECEIVE 2X2 FULL HEIGHT STAINLESS STEEL CORNER GUARDS WITH CHAMFERED AND SILICONE EDGES.

DECK/STRUCTURAL FINISHING DESIGN INTENT IS TO PAINT ALL STRUCTURAL ELEMENTS, DUCTWORK, DECKING, PIPING, ETC ALL CONDUIT TO BE PAINTED. COORDINATE SEQUENCING OF PAINTING SO ALL ELEMENTS ARE PAINTED

FLOOR FINISH LEGEND

REFER TO SHEET A-510 FOR ALL FINISHES, SPECIFICATIONS, AND SCHEDULES (WALLS, FLOORS, CEILINGS, ETC)

> CERAMIC FLOOR TILE (SEE FINISH SCHEDULE) (SEE NOTE #10) VINYL COMPOSITE TILE (SEE FINISH SCHEDULE) SEALED CONCRETE FLR SLAB (SEE FINISH SCHEDULE)

POURED EPOXY FLOORING (SEE FINISH SCHEDULE)

VESTIBULE FLOOR MAT (SEE FINISH SCHEDULE)

FIELD CARPET (SEE FINISH SCHEDULE)

WOOD BASE

FINISH PLAN KEY NOTES

NEW ENTRY MAT AT VESTIBULE

PAINT WALLS AND COLUMNS PT-2 FROM 7'-6" TO UNDER SIDE OF DECK WHERE THERE ARE DISPLAY WALL UNITS.

WOOD BASE IN SALES FLOOR AT WALLS WITHOUT FIXTURES.

4 NEW TILE TO MATCH ADJACENT WALL TILE

PAINT ALL DOORS SEMI GLOSS-COLOR TO MATCH THE ADJACENT WALL.

PREP AND PAINT MILLWORK FILLER PANELS TYP.

PATCH AND REPAIR MALL FLOORING AT ALL AREAS WITHIN THE TENANT'S LEASE LINE WHERE MALL FLOORING IS MISSING OR DAMAGED DUE TO TENANT STOREFRONT BUILD-BACK. THIS CONTRACTOR TO COORDINATE WITH MALL PROPERTY MANAGER REGARDING STOCK OF THIS MALL FLOORING.

FINISH NOTES

 ALL INTERIOR FINISHES, SPECIFIED WALL COVERINGS AND CEILING MATERIALS, SHALL HAVE A FLAME SPREAD RATING NOT TO EXCEED 75 AND SMOKE-DEVELOPED INDEX NOT TO EXCEED 450. 2. THE GENERAL CONTRACTOR SHALL BE RESPONSIBLE FOR PROPER PREPARATION OF ALL NEW AND EXISTING SURFACES IN A SATISFACTORY MANNER TO RECEIVE NEW FINISHES. THIS INCLUDES THE DEMOLITION AND REMOVAL OF NECESSARY ITEMS. TOUCH-UP AND/OR REFINISH OF SURFACES DAMAGED BY SUBSEQUENT WORK SHALL BE THE RESPONSIBILITY OF THE GENERAL CONTRACTOR. ALL WORK SHALL BE PERFORMED IN CONFORMANCE WITH THE MANUFACTURERS RECOMMENDED INSTALLATION METHODS. THE GENERAL CONTRACTOR SHALL PREPARE THE EXISTING FLOOR PRIOR TO THE APPLICATION OF FINISH FLOORING. THE EXISTING CONCRETE SLAB MUST BE SMOOTH AND LEVEL WITH A TOLERANCE OF ONE-EIGHT INCH PER FOOT. LATEX CEMENT PATCHING COMPOUND SHALL BE UTILIZED (NO ASPHALT BASED COMPOUNDS). 3. G.C. TO PROVIDE GROUT SAMPLE FOR APPROVAL AT ALL TILE LOCATIONS, ARCHITECT TO APPROVE PRIOR TO COMPLETE INSTALLATION. GROUT SPECIFIED DOES NOT REQUIRE SEALING. 4. ALL JOINTS IN GYPSUM BOARD WALLS SHALL BE FINISHED WITH PAPER TAPE 2" WIDE AND THREE COATS OF VINYL, DRY OR PREMIXED JOINT COMPOUND. ALL OUTSIDE CORNERS SHALL BE

HAVE FORMED IN SANDING GENERAL NOTES

1. G.C. TO PROVIDE WATERPROOFING AS SPECIFIED FOR THE

FINISHED WITH METAL CORNER BEADS, TAPED AND SPACKLED. ALL AREAS TO BE PAINTED SHALL BE SANDED SMOOTH, JUST PRIOR TO APPLICATION OF FIRST COAT OF PAINT, WIPE SANDED SURFACES

WITH DAMP CLOTH IN ORDER TO LAY FLAT ANY NAP WHICH MAY

FOLLOWING CONDITIONS: A. AT RESTROOM SLAB-ON-GRADE CONDITIONS, G.C. TO PROVIDE WATERPROOFING MEMBRANE 12" UP WALL AND 12" ON TO FLOOR.

LATICRETE 9235 OR MAPEI MAPELASTIC HPG OR EQUAL AS APPROVED BY LANDLORD. MUST BE FLOOD TESTED AND APPROVED BY ON—SITE LANDLORD REPRESENTATIVE PRIOR

TO THE INSTALLATION OF NEW FLOORING].

REFER THE FINISH LEGEND ON SHEET A-510 FOR MORE

INFORMATION ON FINISHES.

3. AT THE BACK WORKROOM AND JANITOR'S CLOSET PROVIDE CONTINUOUS SEALANT JOINT AT ALL FRP AND STAINLESS STEEL INTERSECTIONS AT TILE BASE, CEILINGS, DOOR FRAMES, PLUMBING/GAS/ELECTRICAL ROUGH-INS, AND MISCELLANEOUS PENETRATIONS.

. CAULK ALL JOINTS BETWEEN WALL TILE AND DOOR FRAMES, COLOR TO MATCH GROUT, U.N.O. INSTALL CLEAR SEALANT JOINTS WHERE WINDOWS ABUT A WOOD/METAL FINISH, U.N.O. INSTALL COLORED SEALANT JOINTS WHERE WINDOWS ABUT AN INTERIOR WALL SURFACE, COLOR TO MATCH STOREFRONT,

5. TILE CONTRACTOR TO ENSURE THAT FLOOR TILE IS FLUSH W/ COVED BASE TILE PER HEALTH DEPARTMENT AT CAFE AND TOILET ROOMS.

6. G.C. TO ENSURE THAT THE FLOOR SLAB IS AT AN ACCEPTABLE TOLERANCE LEVEL TO MINIMIZE THE LIPPAGE FOR THE REQUIRED FLOOR FINISH INSTALLATION, REFER TO FINISH SPECIFICATIONS FOR MORE INFORMATION, G.C. TO INFORM ARCHITECT OF DISCREPANCIES.

7. FLOOR TILES TO BE NON-SLIP WITH A MIN. SLIP COEFFICIENT OF FRICTION OF 0.6 OR BETTER. 8. ALL MATERIAL TRANSITIONS TO MEET A.D.A. GUIDELINES.

9. MAXIMUM FLOOR SLOPE IN ANY DIRECTION IS 1 IN 20. 10. ALL INTERIOR WOOD BLOCKING TO BE FIRE TREATED (F.T.), U.N.O., V.I.F.

11. TILE NOTES (PER TCNA HANDBOOK 2011):

A. FOR TILE SIZES 15" OR SMALLER, MORTAR BED TO BE NO GREATER THAN 1/4" THICK B. FOR TILE SIZES GREATER THAN 15", MORTAR BED TO BE NO GREATER THAN ⅓6" THICK


12. ALL FLOOR PENETRATIONS TO BE WATERPROOFED, U.N.O. 13. G.C. TO PROVIDE LATICRETE EPOXY GROUT AT ALL TILE LOCATIONS. DESIGNER TO APPROVE TYPE AND COLOR.

WATERPROOFING FOR TOILETS

PROVIDE WATERPROOFING MEMBRANE THROUGHOUT EXTENTS: TOILET ROOMS: ENTIRE EXTENTS OF FLOOR AND A MIN. OF 12" UP PERIMETER WALLS. MUST USE LATICRETE 9235 OR EQUAL AND REFER TO MANUFACTURER SPECIFICATIONS FOR INSTALLATION.

FLOOR PENETRATIONS: MUST PATCH AND REPAIR ALL EXISTING WATERPROOFING AT ALL FLOOR SINKS, FLOOR DRAINS, AND CORE DRILLS. COORDINATE WITH LANDLORD'S EXISTING CONDITIONS FOR ALL PATCH AND REPAIR

BARNES&NOBLE

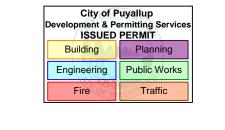

PRCTI2025001

PROJECT DESIGNER:



ARCHITECT: JOEL TORIELLI 422 BOGERT AVE RIDGEWOOD, NJ 07450

PUYAÜLUP, WA 98373 Project Number 33247


Store Number 3507 Revision Log:

Date	Description	No.
12-19-24	ISSUED FOR PERMIT, BID, LANDLORD & CLIENT REVIEW	$\triangle$
02-20-25	BUILDING DEPARTMENT AND LANDLORD COMMENTS	$\overline{\Lambda}$
05-19-25	ISSUED FOR CONSTRUCTION	2
		$\Delta$
		$\triangle$
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		$\Delta$
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General Contractor to verify all conditions and dimensions at the premises. Discrepancies shall be reported to the Architect prior to the commencement of any work.


Professional Seal:



EXP. DATE : 10/02/25

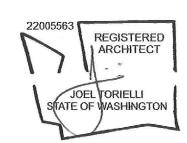Drawing Description: Floor Finish Plan Legend, and Notes

Drawing Number:

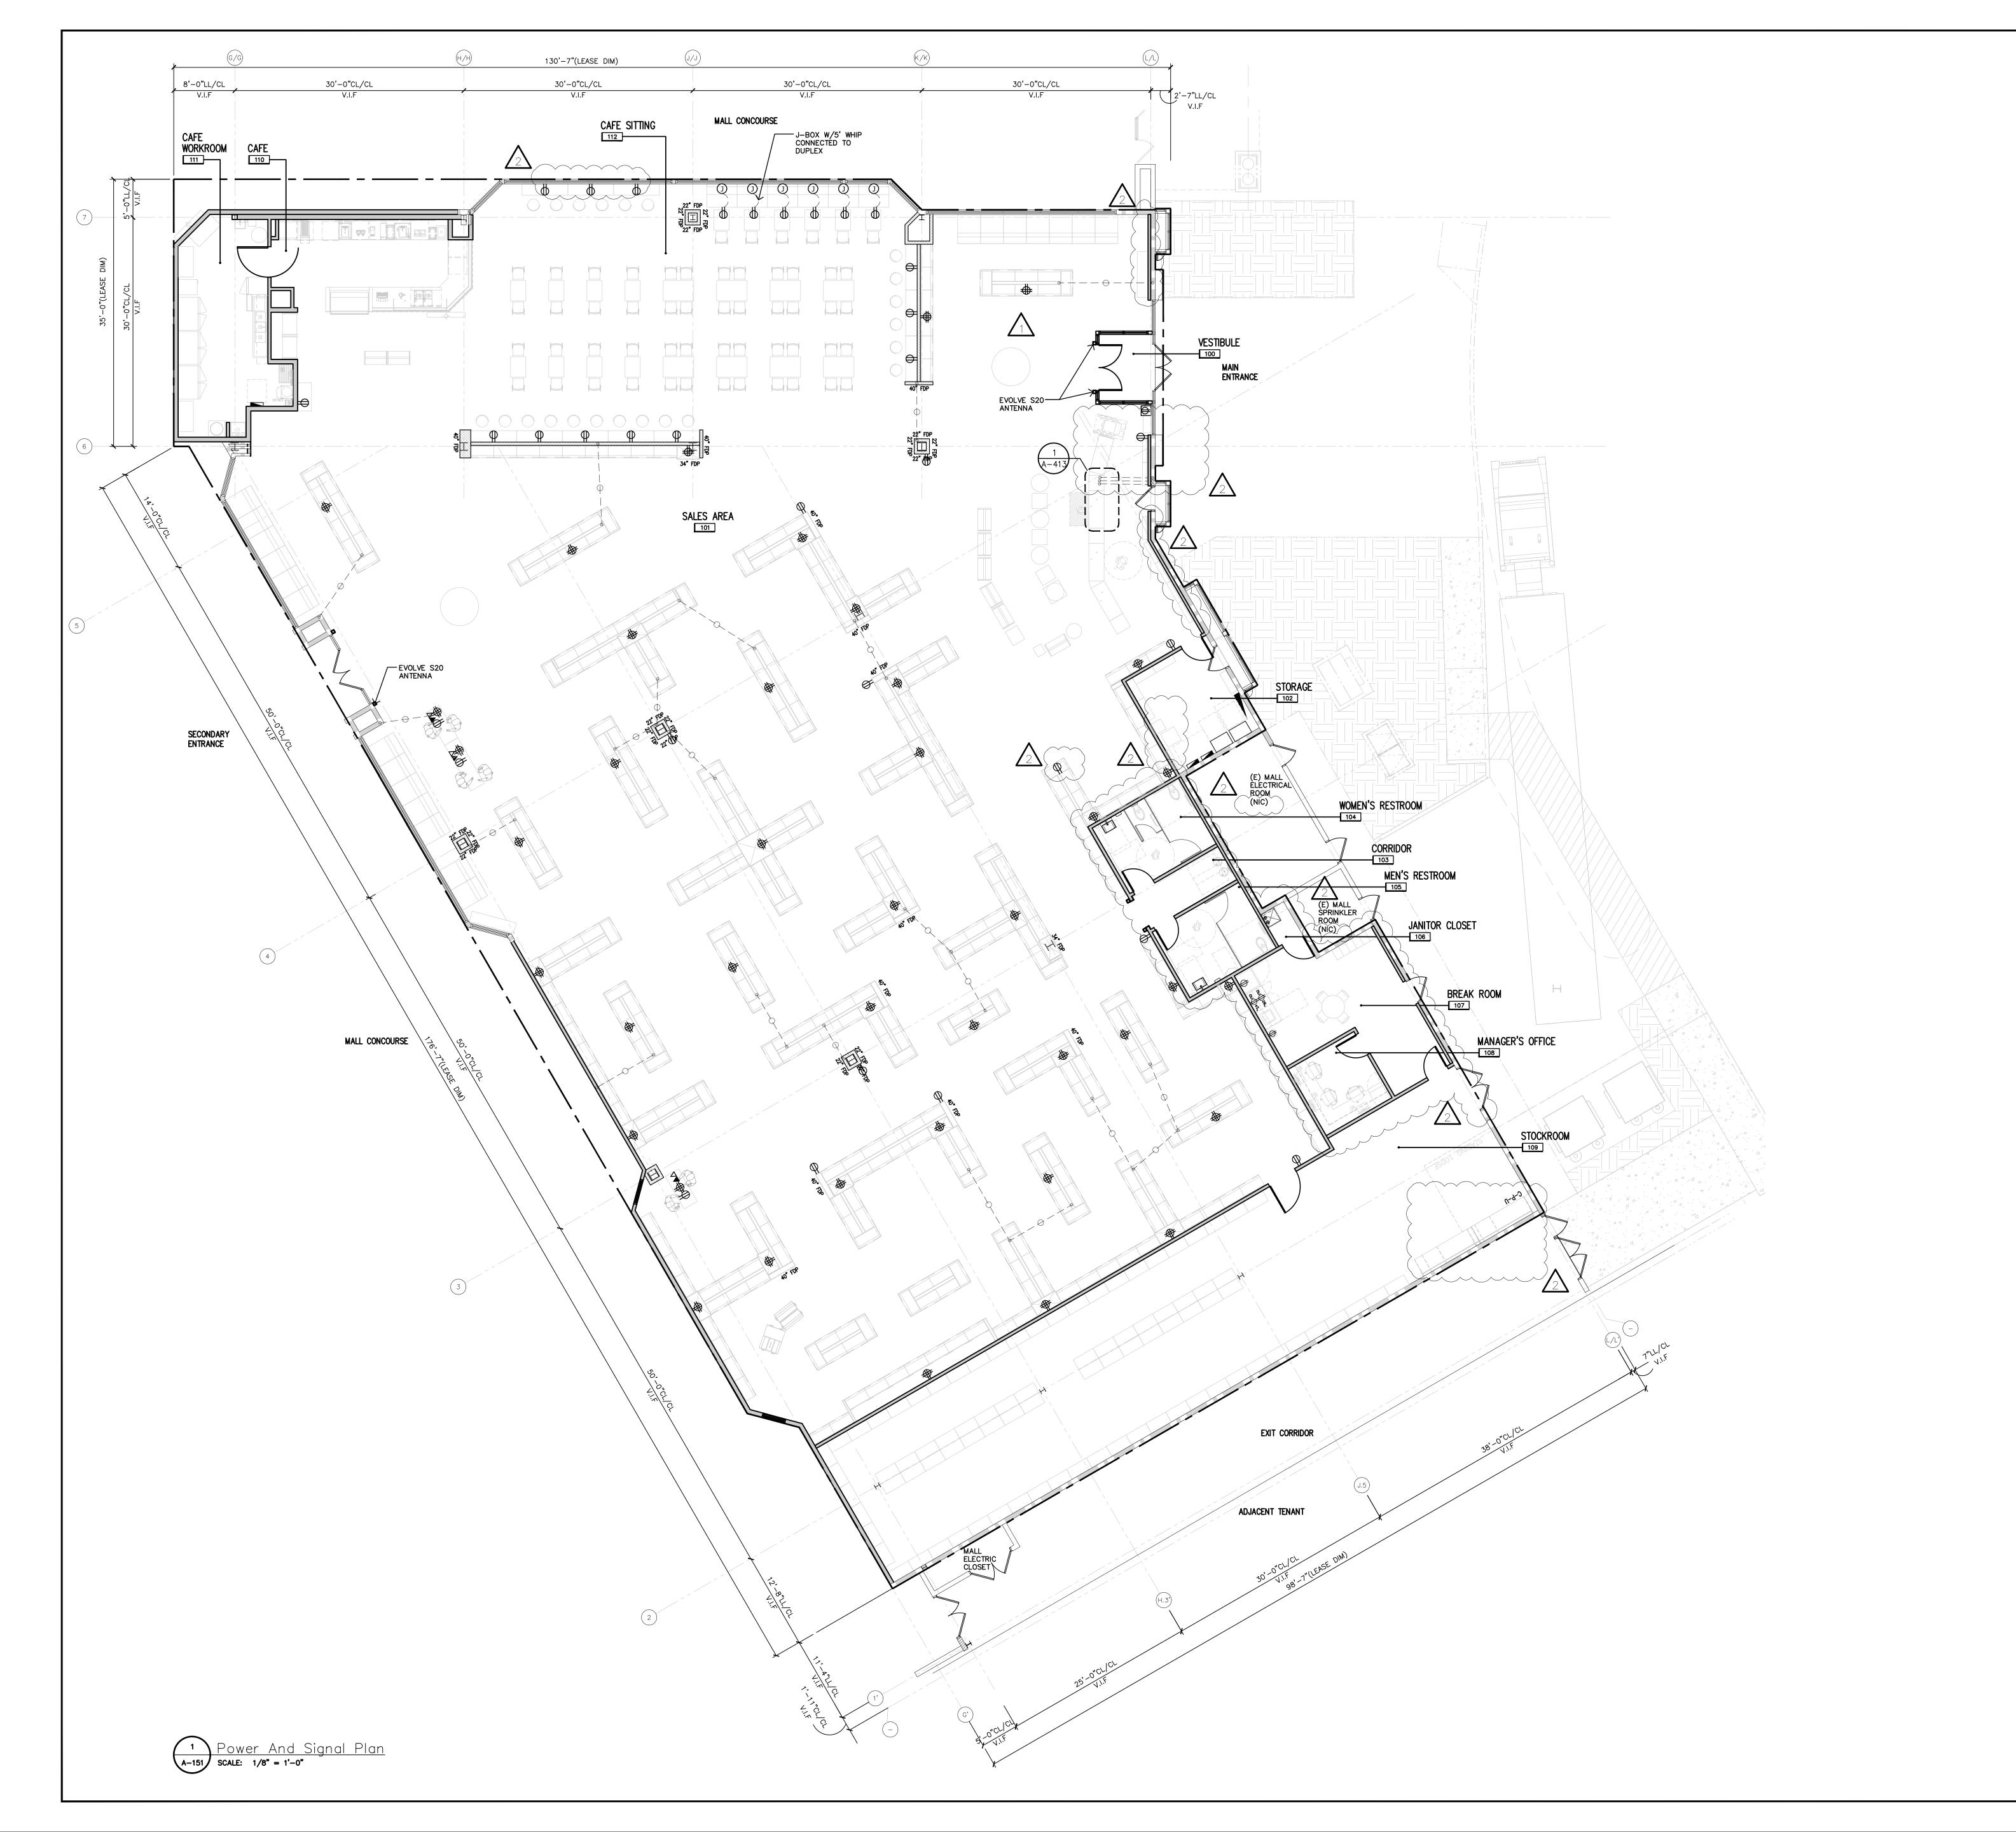

ELECTRICAL SYMBOL LEGEND DESCRIPTION

- CONDUIT WITH WIRING RUN CONCEALED IN OR ABOVE CEILING OR WALL, OR RUN EXPOSED IN UNFINISHED AREAS.
- CONDUIT WITH WIRING RUN CONCEALED BELOW FLOOR.
- ← PANELBOARD SEE ELECTRICAL ONE—LINE DIAGRAM.
- DISCONNECT SWITCH TYPE & RATING AS SHOWN ON
- 20A 120V/277V SINGLE POLE TOGGLE SWITCH
  MOUNTED 48" AFF TO TOP OF BOX, UNLESS NOTED
  OTHERWISE. IF APPLICABLE, LOWER CASE SUBSCRIPT
  "x" KEYS SWITCH TO FIXTURES BEING CONTROLLED
  (TYPICAL OF ALL SWITCH SYMBOLS) \$100 LINE VOLTAGE PASSIVE INFRARED WALL SWITCH OCCUPANCY SENSOR MOUNTED 48"AFF TO TOP OF BOX, UNLESS NOTED OTHERWISE (OC2 = DUAL RELAY).
  MANUFACTURER SHALL BE WATTSTOPPER, HUBBELL,
  SENSOR SWITCH, COOPER CONTROLS, OR LUTRON)
- LOW VOLTAGE CEILING MOUNTED OCCUPANCY SENSOR.
  LOCATE AS DIRECTED PER MANUFACTURER AND
  PROVIDE STANDARD VS. EXTENDED COVERAGE RANGE
  AS DIRECTED BY MANUFACTURER. REFER TO TYPICAL
  LOW VOLTAGE OCCUPANCY SENSOR WIRING DIAGRAM ON SHEET E101. (1 = DUAL TECHNOLOGY 360° COVERAGE PATTERN, 2 = DUAL TECHNOLOGY CORNER MOUNTED WITH WIDE VIEW COVERAGE PATTERN, 3 = PIR NARROW HALLWAY COVERAGE PATTERN).
  MANUFACTURER SHALL BE WATTSTOPPER, HUBBELL,
- SENSOR SWITCH, COOPER CONTROLS, OR LUTRON,) GROUNDING TYPE SIMPLEX RECEPTACLE
- GROUNDING TYPE DUPLEX RECEPTACLE
- 20A 125V GROUNDING TYPE QUADRAPLEX
  RECEPTACLE

MOUNTED


- GROUND FAULT INTERRUPTING TYPE DUPLEX RECEPTACLE, GROUND FAULT INTERRUPTING TYPE DUPLEX RECEPTACLE
- GROUNDING TYPE DUPLEX RECEPTACLE WITH (2) USB PORTS MOUNTED
- GROUNDING TYPE QUADRAPLEX RECEPTACLE WITH (4)
- USB PORTS MOUNTED 18" AFF, UNLESS NOTED OTHERWISE
- © COMPLETE FLOOR BOX SYSTEM WHICH INCLUDES, BUT IS NOT LIMITED TO THE FOLLOWING: SINGLE GANG, CAST IRON, FULLY ADJUSTABLE FLOOR BOX RECESSED IN CONCRETE FLOOR SLAB
- COMPLETE FLOOR BOX SYSTEM WHICH INCLUDES, BUT IS NOT LIMITED TO THE FOLLOWING: 2—GANG, CAST IRON, FULLY ADJUSTABLE MULTI—SERVICE FLOOR BOX RECESSED IN CONCRETE FLOOR SLAB
- STANDARD GANG BOX REFER TO TERMINAL LIST BELOW FOR INDIVIDUAL DEVICES: □ TELEPHONE SPARE CONDUIT (RAN UP TO CEILING)
   □ DATA □ J-BOX WITH GENERAL POWER DUPLEX J-BOX POWER FROM LIGHTING CONTACTOR ☐ DEDICATED QUAD
  - DOOR BELL ASSEMBLY

ISOLATED GROUND

- CHIME ASSEMBLY
- PUSH-BUTTON ASSEMBLY
- JUNCTION BOX
- ▼ TELEPHONE OUTLET
- □ DATA OUTLET MOUNTED
- COMBINATION TELEPHONE/DATA
- PLUG MOLD

NOTE: NOT ALL SYMBOLS MAY APPLY TO PROJECT.

BARNES&NOBLE

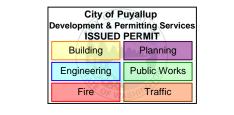

PRCTI20250011

PROJECT DESIGNER:



ARCHITECT: JOEL TORIELLI 422 BOGERT AVE RIDGEWOOD, NJ 07450

UNIT #800 PUYALLUP, WA 98373

Project Number 33247 Store Number 3507

Revision Log:


Date Description 12-19-24 ISSUED FOR PERMIT, BID, LANDLORD & CLIENT REVIEW

02-20-25 BUILDING DEPARTMENT AND LANDLORD COMMENTS 05-19-25 ISSUED FOR CONSTRUCTION

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General Contractor to verify all conditions and dimensions at the premises. Discrepancies shall be reported to the Architect prior to the commencement of any work.

Professional Seal:

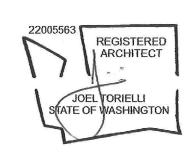


LIC.# : 22005563 EXP. DATE : 10/02/25

Drawing Description:

Power And Signal Plan

Drawing Number:

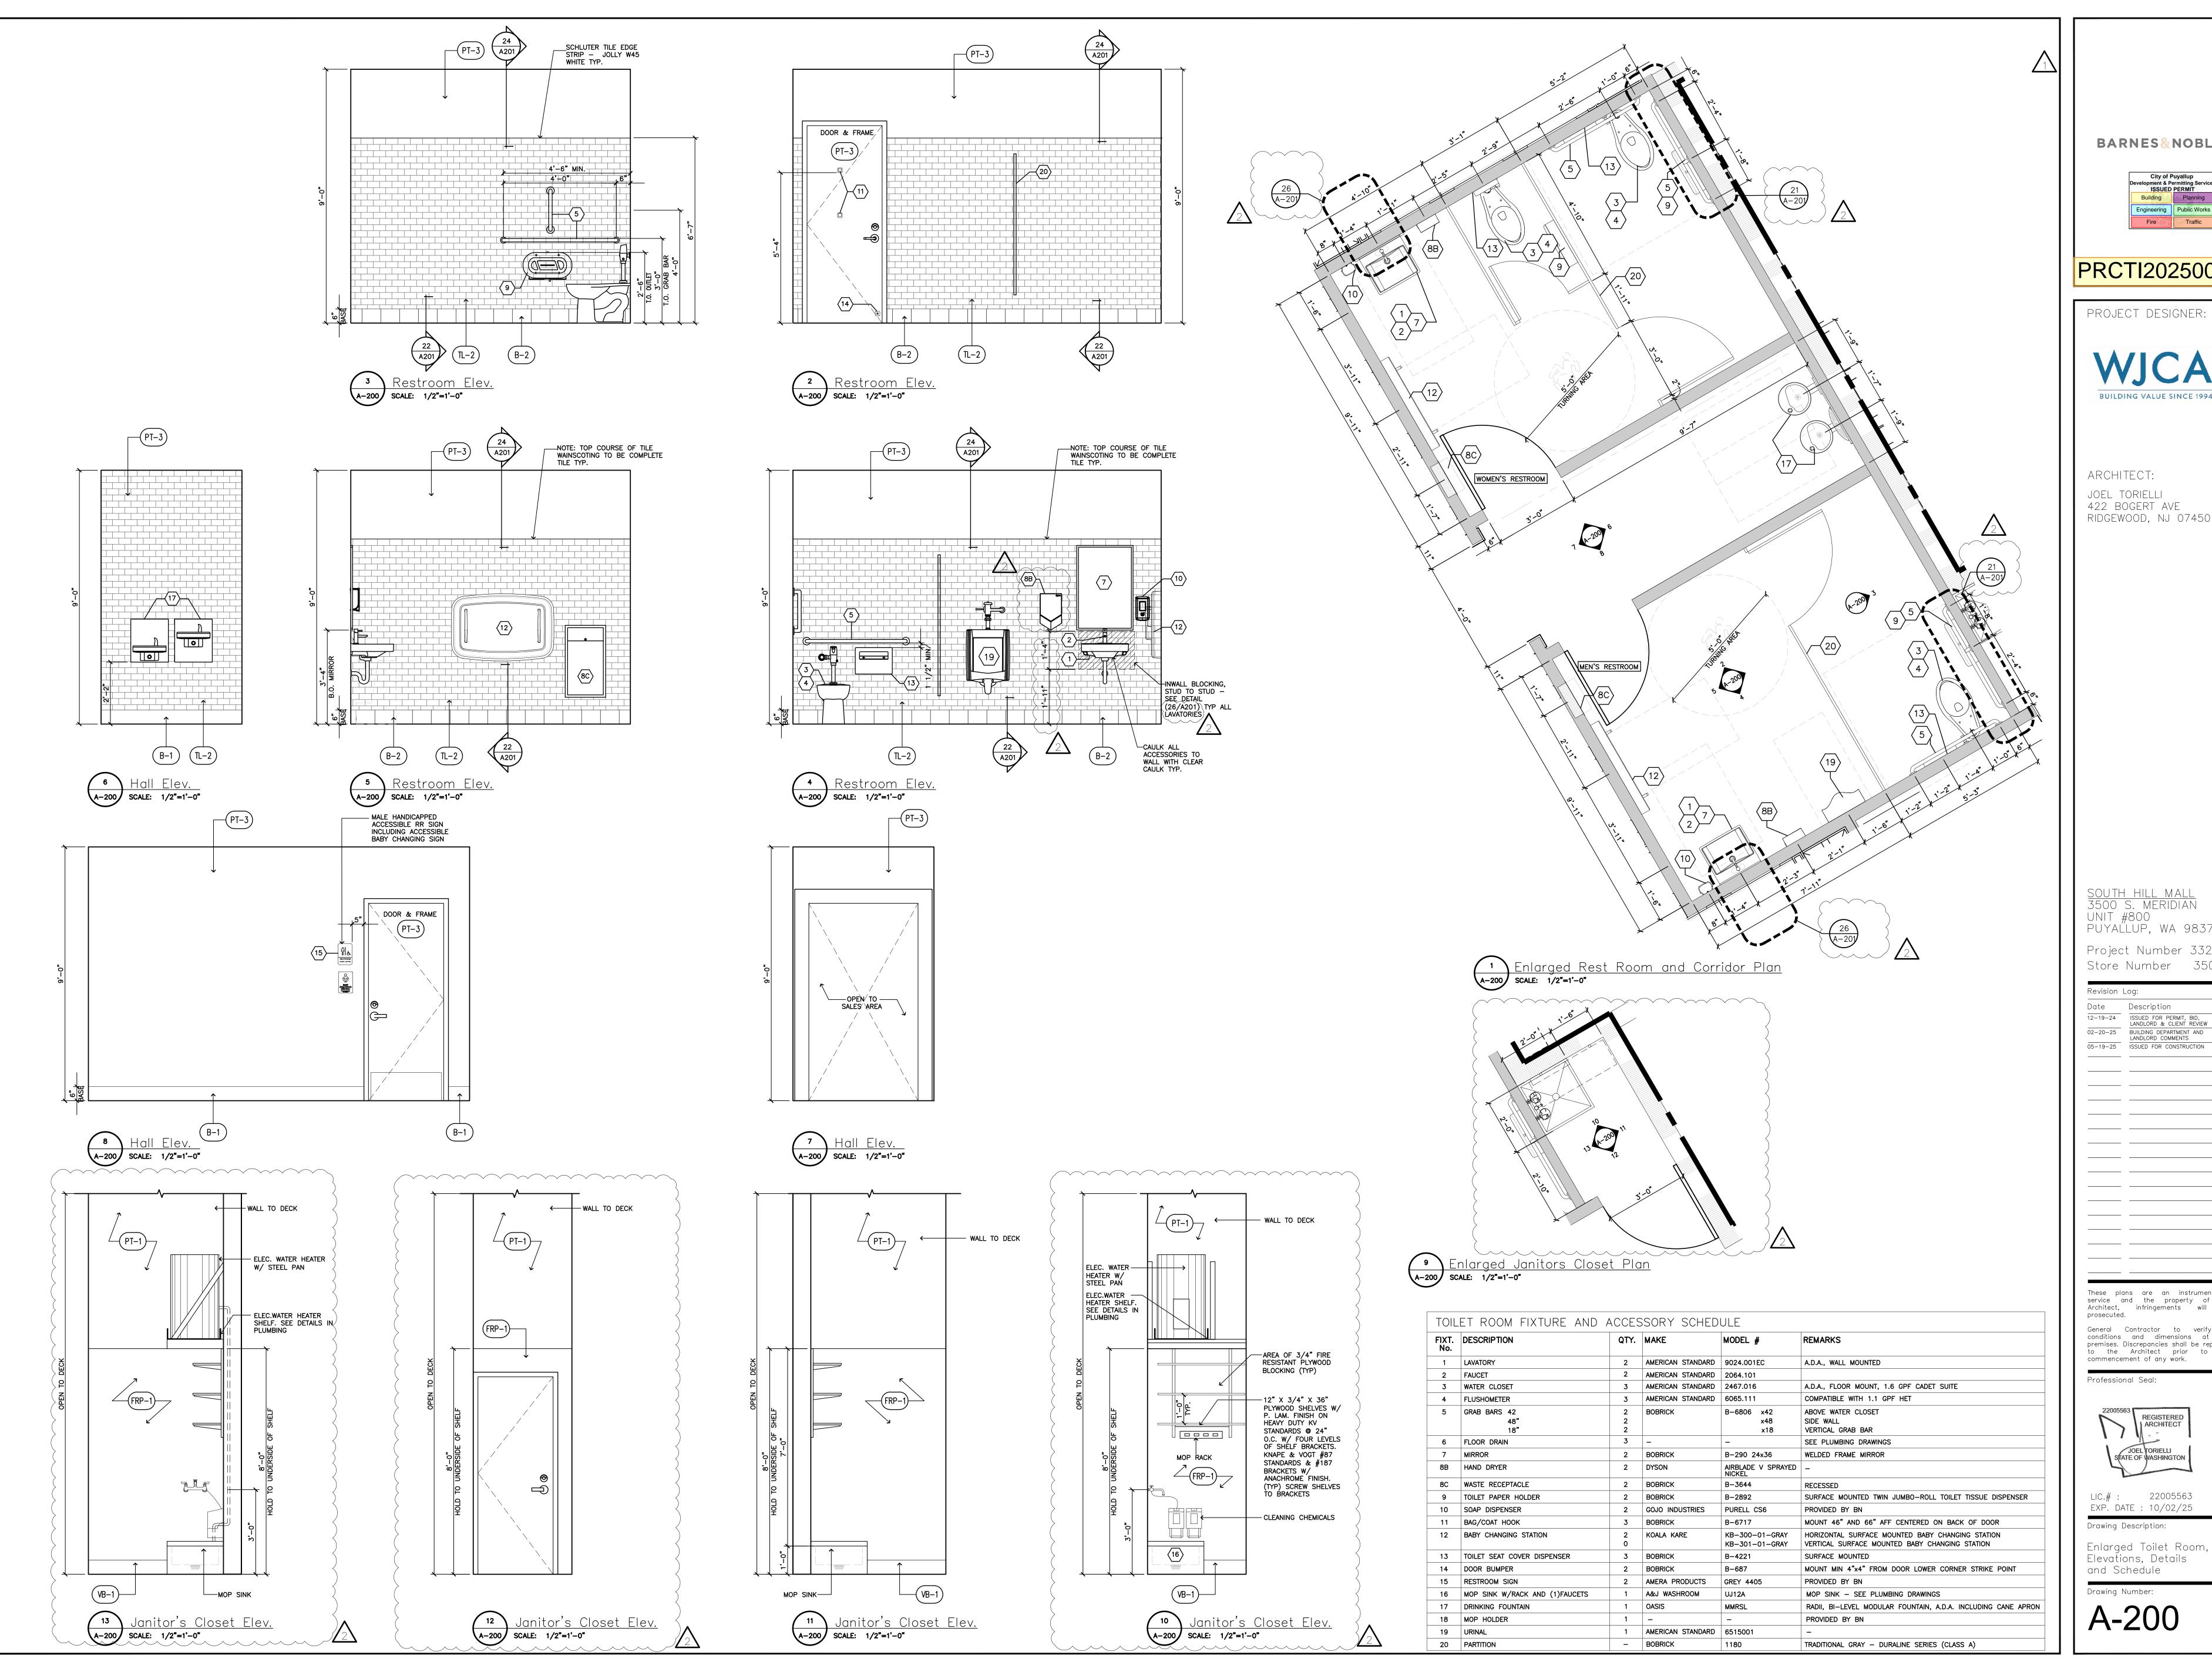



PRCTI20250011

PROJECT DESIGNER:



ARCHITECT: JOEL TORIELLI 422 BOGERT AVE RIDGEWOOD, NJ 07450


PUYAÜLUP, WA 98373 Project Number 33247 Store Number 3507

Revision	Log:	
Date	Description	No.
12-19-24	ISSUED FOR PERMIT, BID, LANDLORD & CLIENT REVIEW	Δ
02-20-25	BUILDING DEPARTMENT AND LANDLORD COMMENTS	1
05-19-25	ISSUED FOR CONSTRUCTION	2
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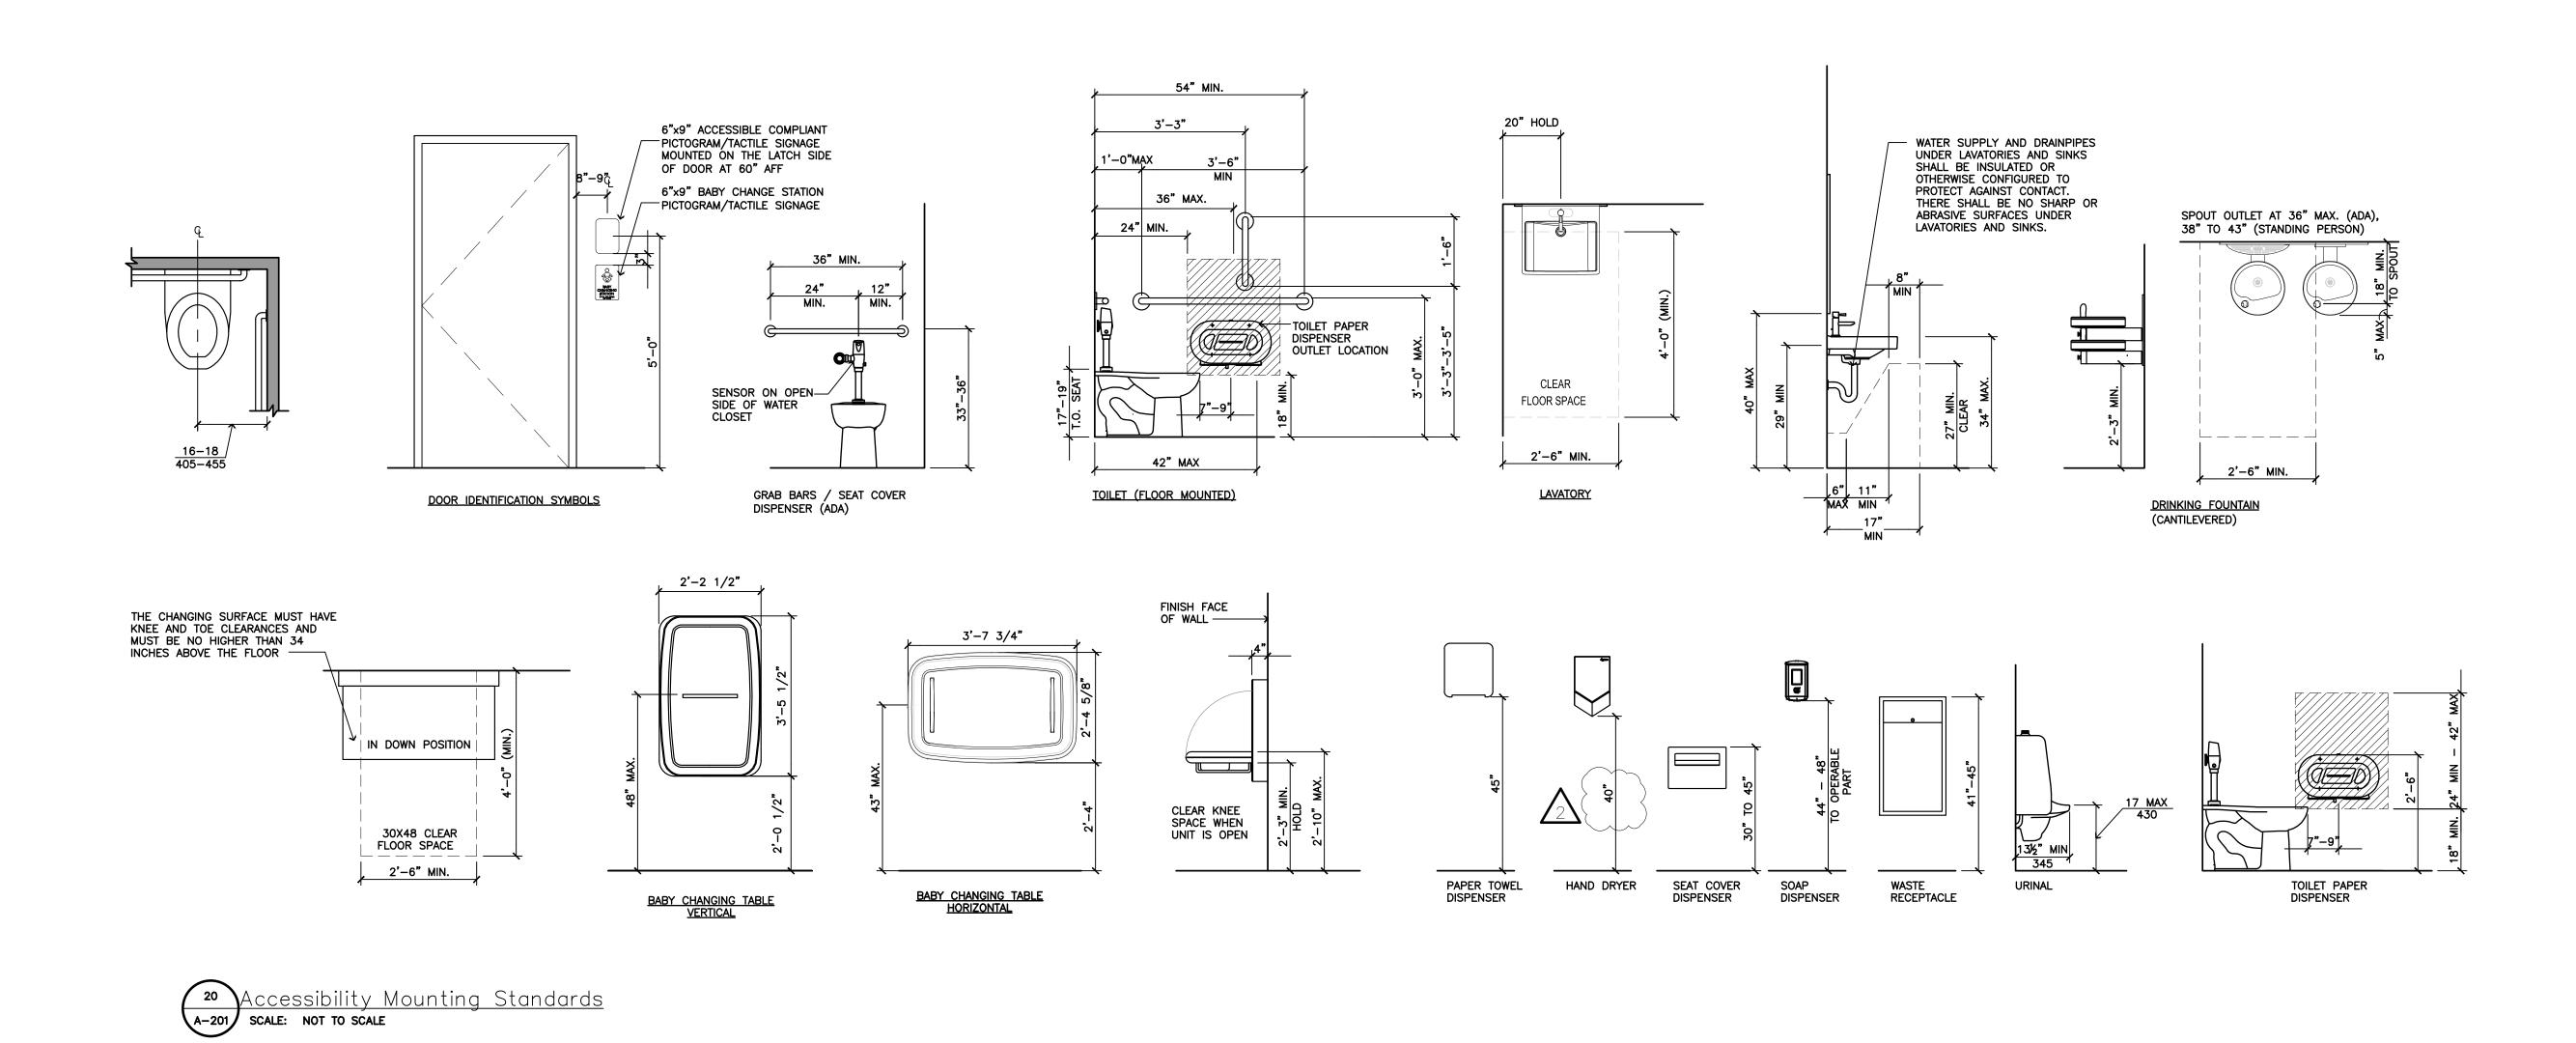
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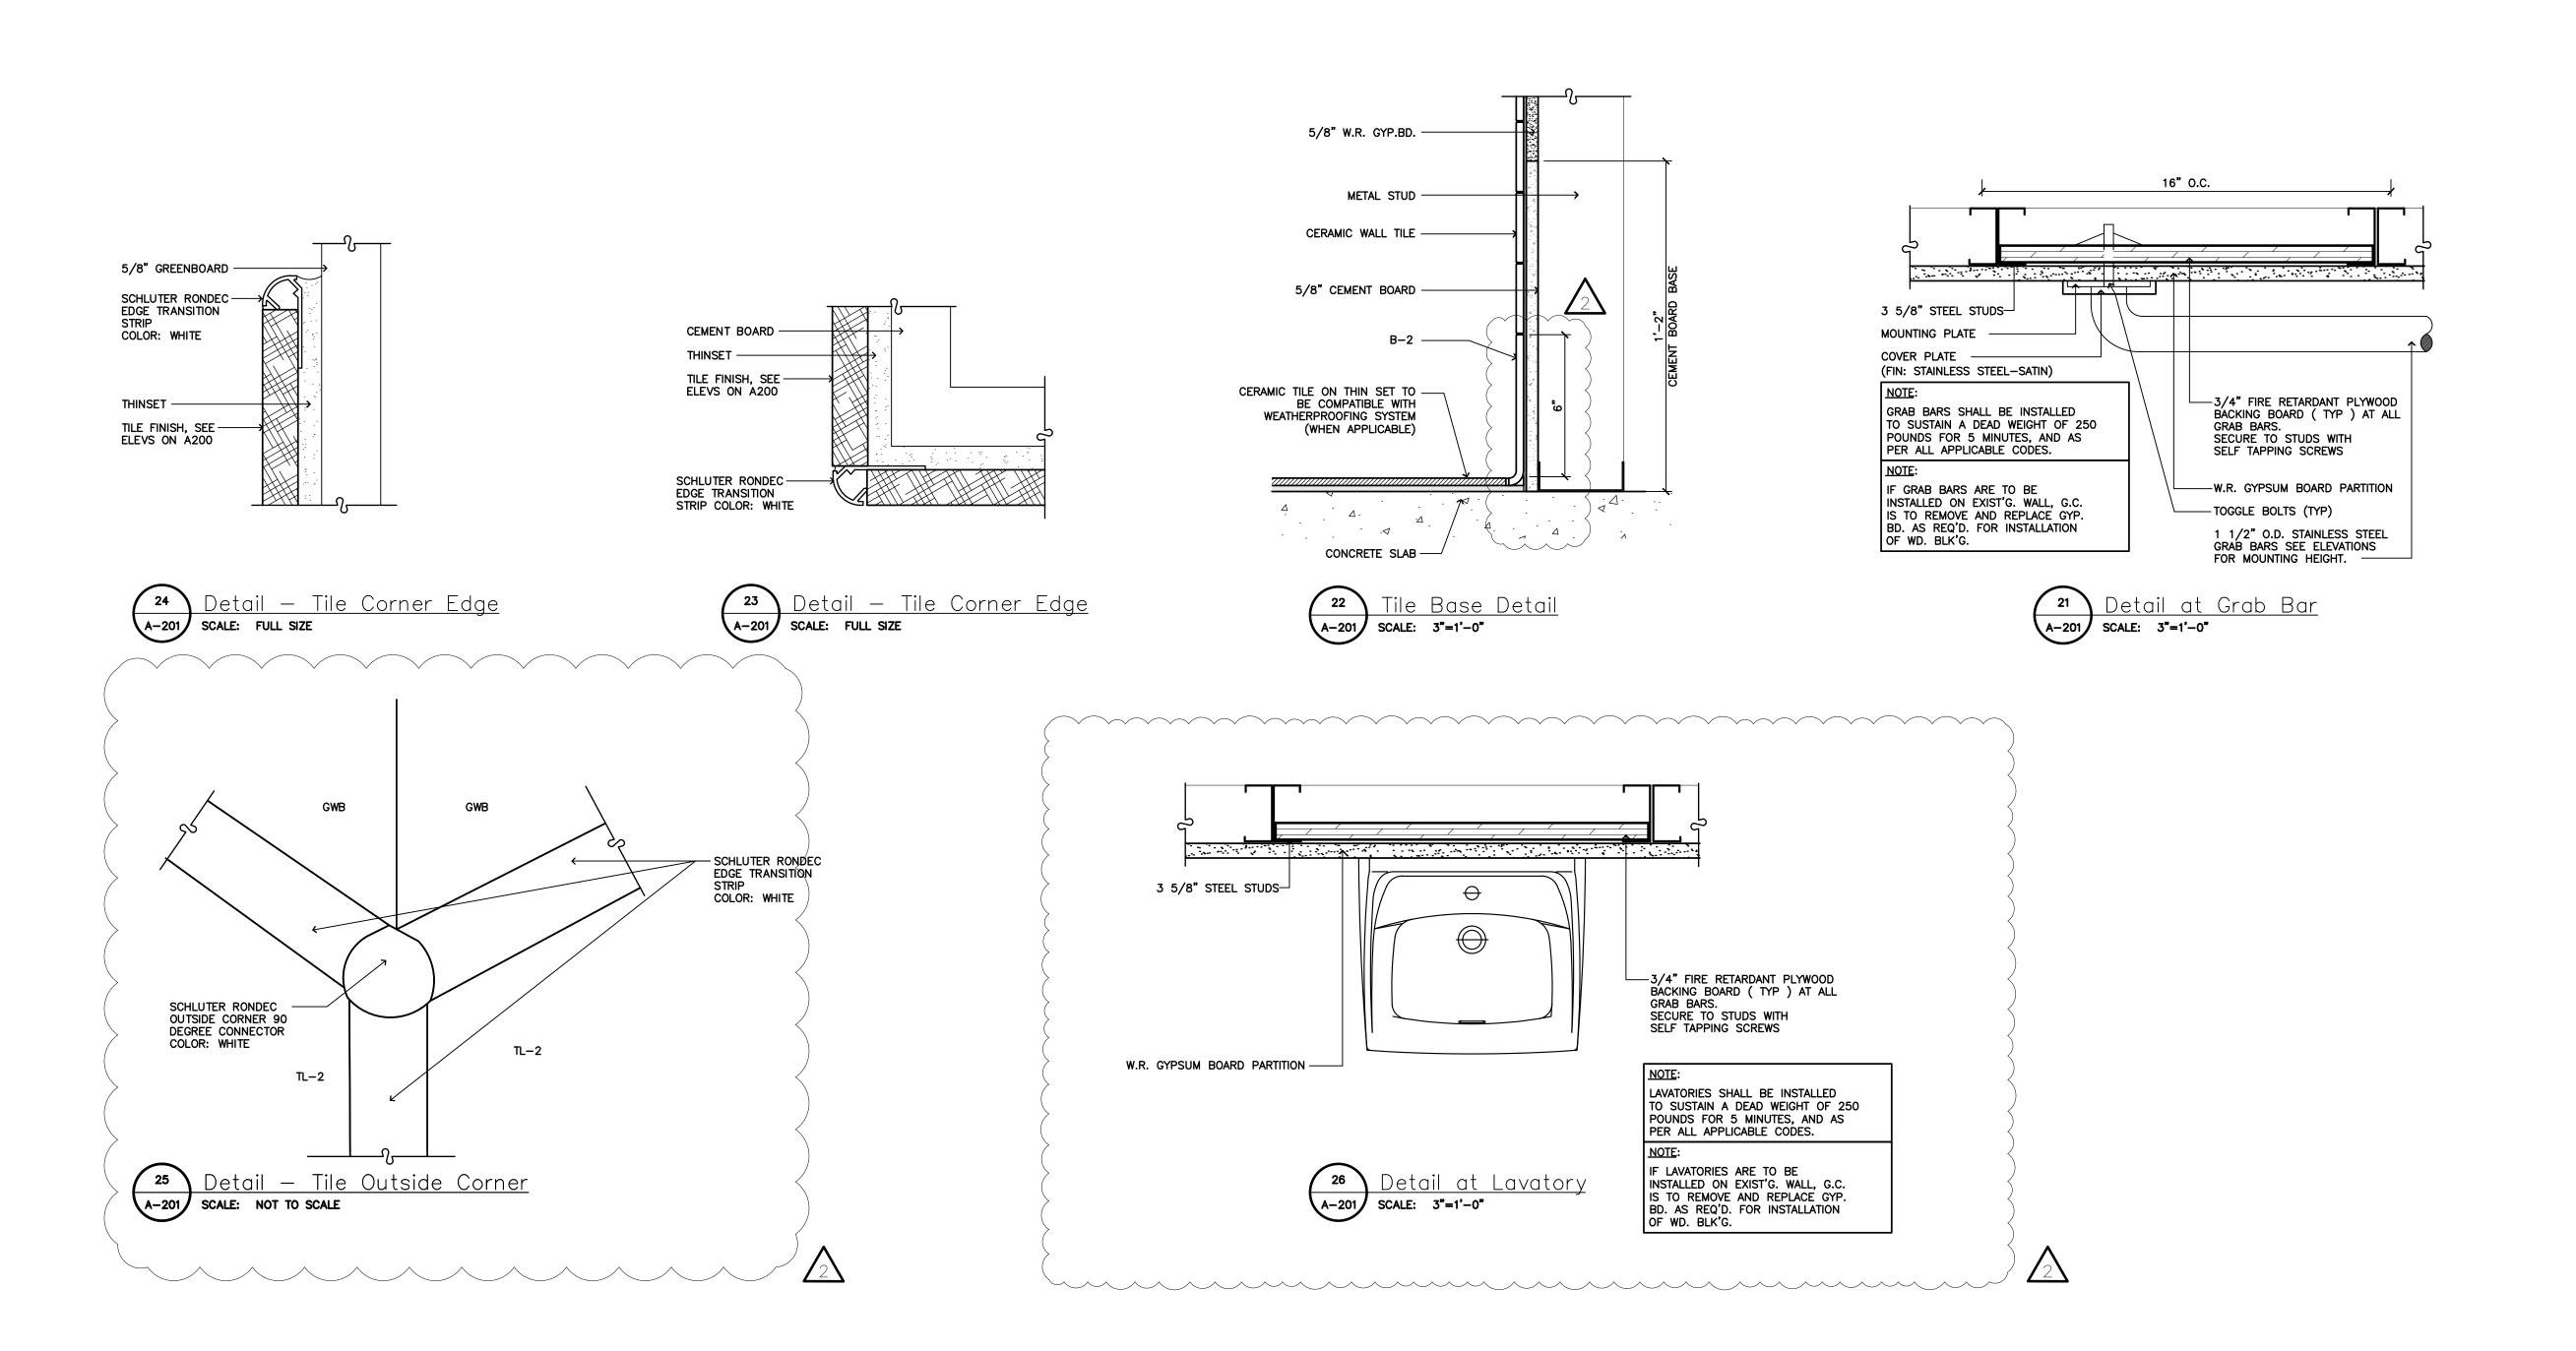



LIC.# : 22005563 EXP. DATE : 10/02/25

Drawing Description:

Drawing Number: A-200

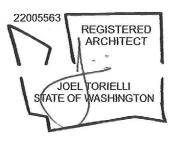



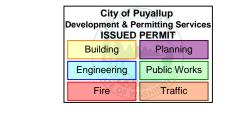

PRCTI20250011

PROJECT DESIGNER:



ARCHITECT:

JOEL TORIELLI

422 BOGERT AVE

RIDGEWOOD, NJ 07450

SOUTH HILL MALL 3500 S. MERIDIAN

UNIT #800 PUYALLUP, WA 98373 Project Number 33247 Store Number 3507

Revision Log:


Date	Description	No.
12-19-24	ISSUED FOR PERMIT, BID, LANDLORD & CLIENT REVIEW	$\triangle$
02-20-25	BUILDING DEPARTMENT AND LANDLORD COMMENTS	$\Lambda$
05-19-25	ISSUED FOR CONSTRUCTION	$\sqrt{2}$
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prosecuted.

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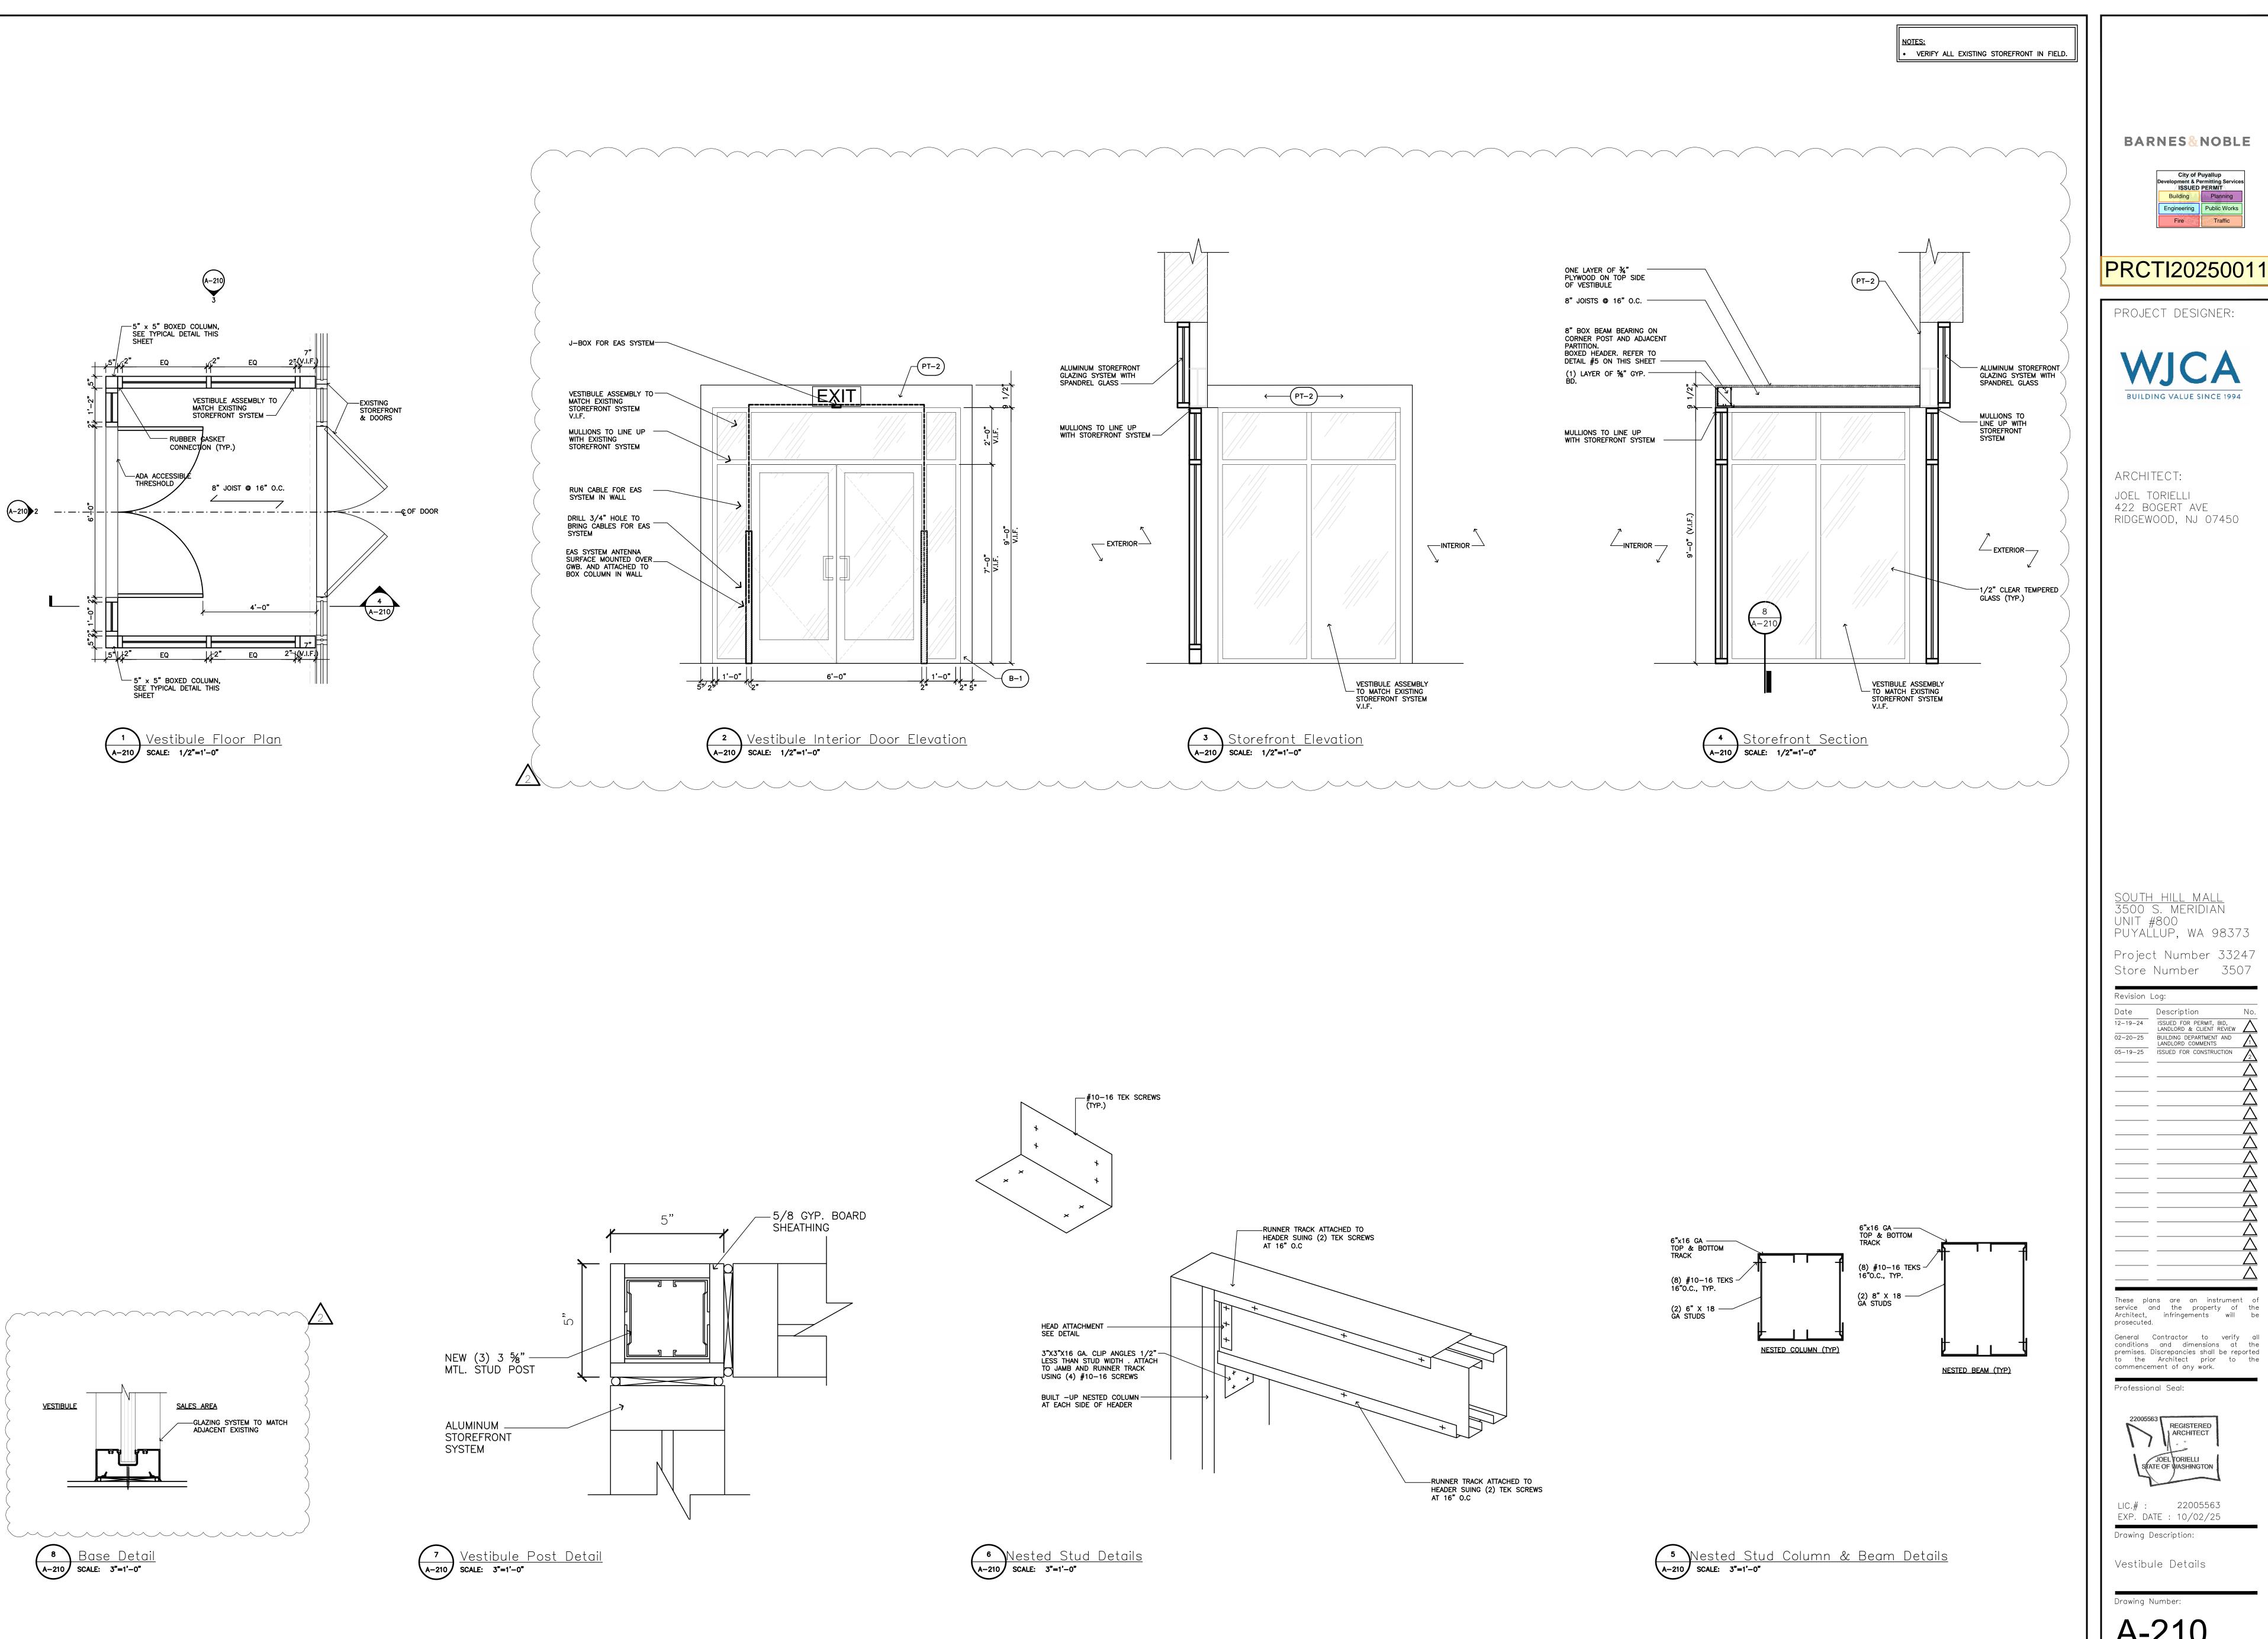
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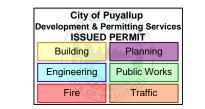


LIC.#: 22005563
EXP. DATE: 10/02/25
Drawing Description:

Toilet Room Details

Drawing Number:
A-201

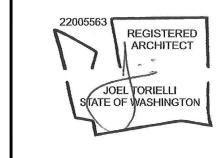





ARCHITECT: JOEL TORIELLI 422 BOGERT AVE

PUYAĽLUP, WA 98373 Project Number 33247 Store Number 3507

Description 12-19-24

02-20-25

05-19-25

Description

ISSUED FOR PERMIT, BID, LANDLORD & CLIENT REVIEW

LANDLORD & CLIENT REVIEW


LANDLORD COMMENTS

1SSUED FOR CONSTRUCTION

2


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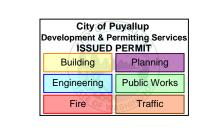
Professional Seal:

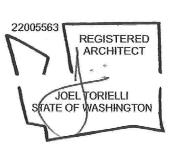

LIC.# : 22005563 EXP. DATE : 10/02/25

Vestibule Details



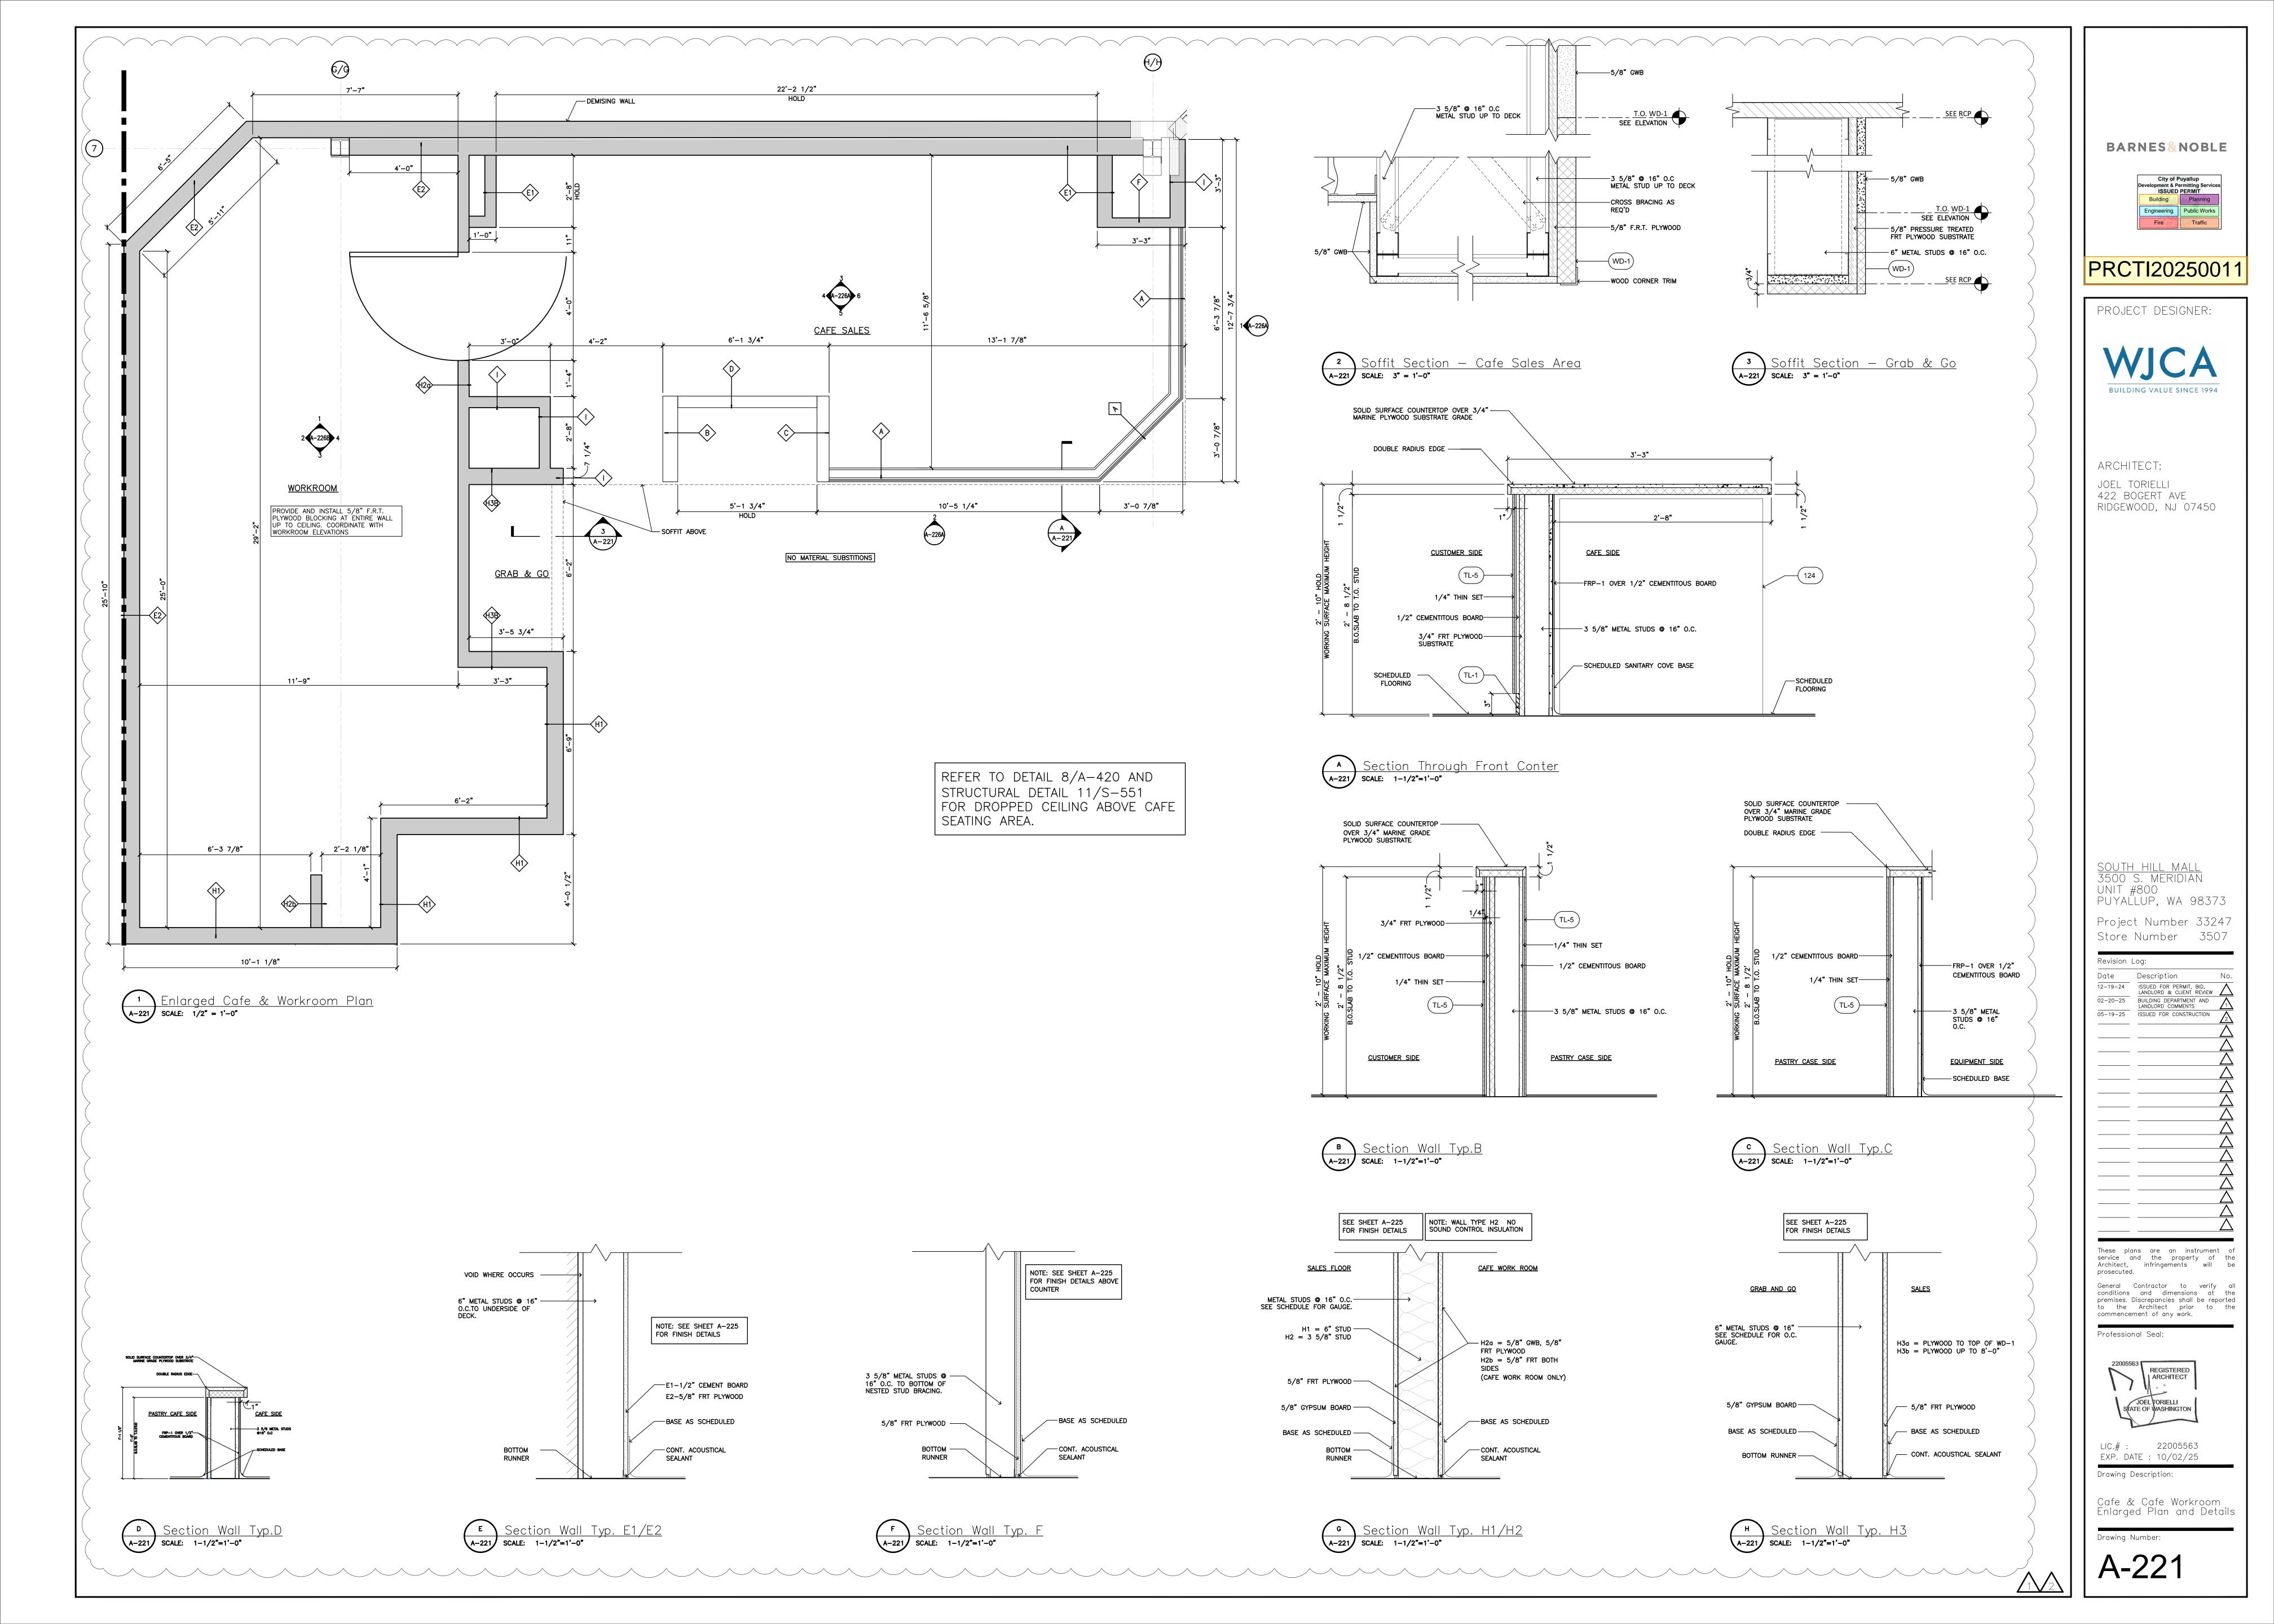

PRCTI20250011

PROJECT DESIGNER:



ARCHITECT:

JOEL TORIELLI

422 BOGERT AVE

RIDGEWOOD, NJ 07450

SOUTH HILL MALL 3500 S. MERIDIAN UNIT #800

PUYALLUP, WA 98373

Project Number 33247

Store Number 3507

Revision Log:

Date

Description

12-19-24

02-20-25

05-19-25

Description

No.

ISSUED FOR PERMIT, BID, LANDLORD & CLIENT REVIEW

LANDLORD COMMENTS


ISSUED FOR CONSTRUCTION

2

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commencement of any w Professional Seal:




LIC.# : 22005563 EXP. DATE : 10/02/25 Drawing Description:

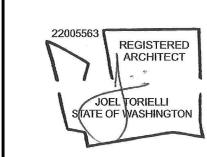
Cafe & Cafe Workroom Plumbing Plan


Drawing Number:

A-222A

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PRCTI20250011

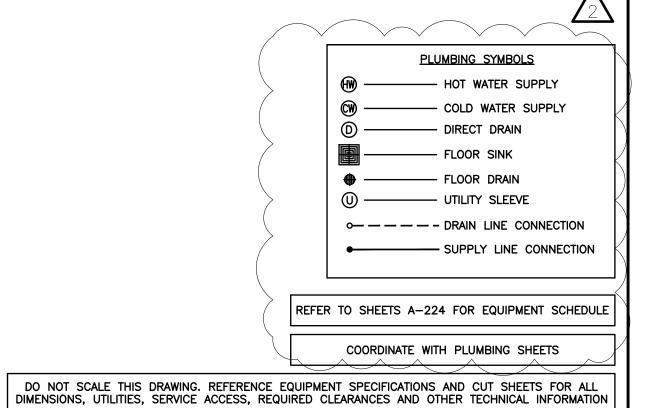PROJECT DESIGNER:

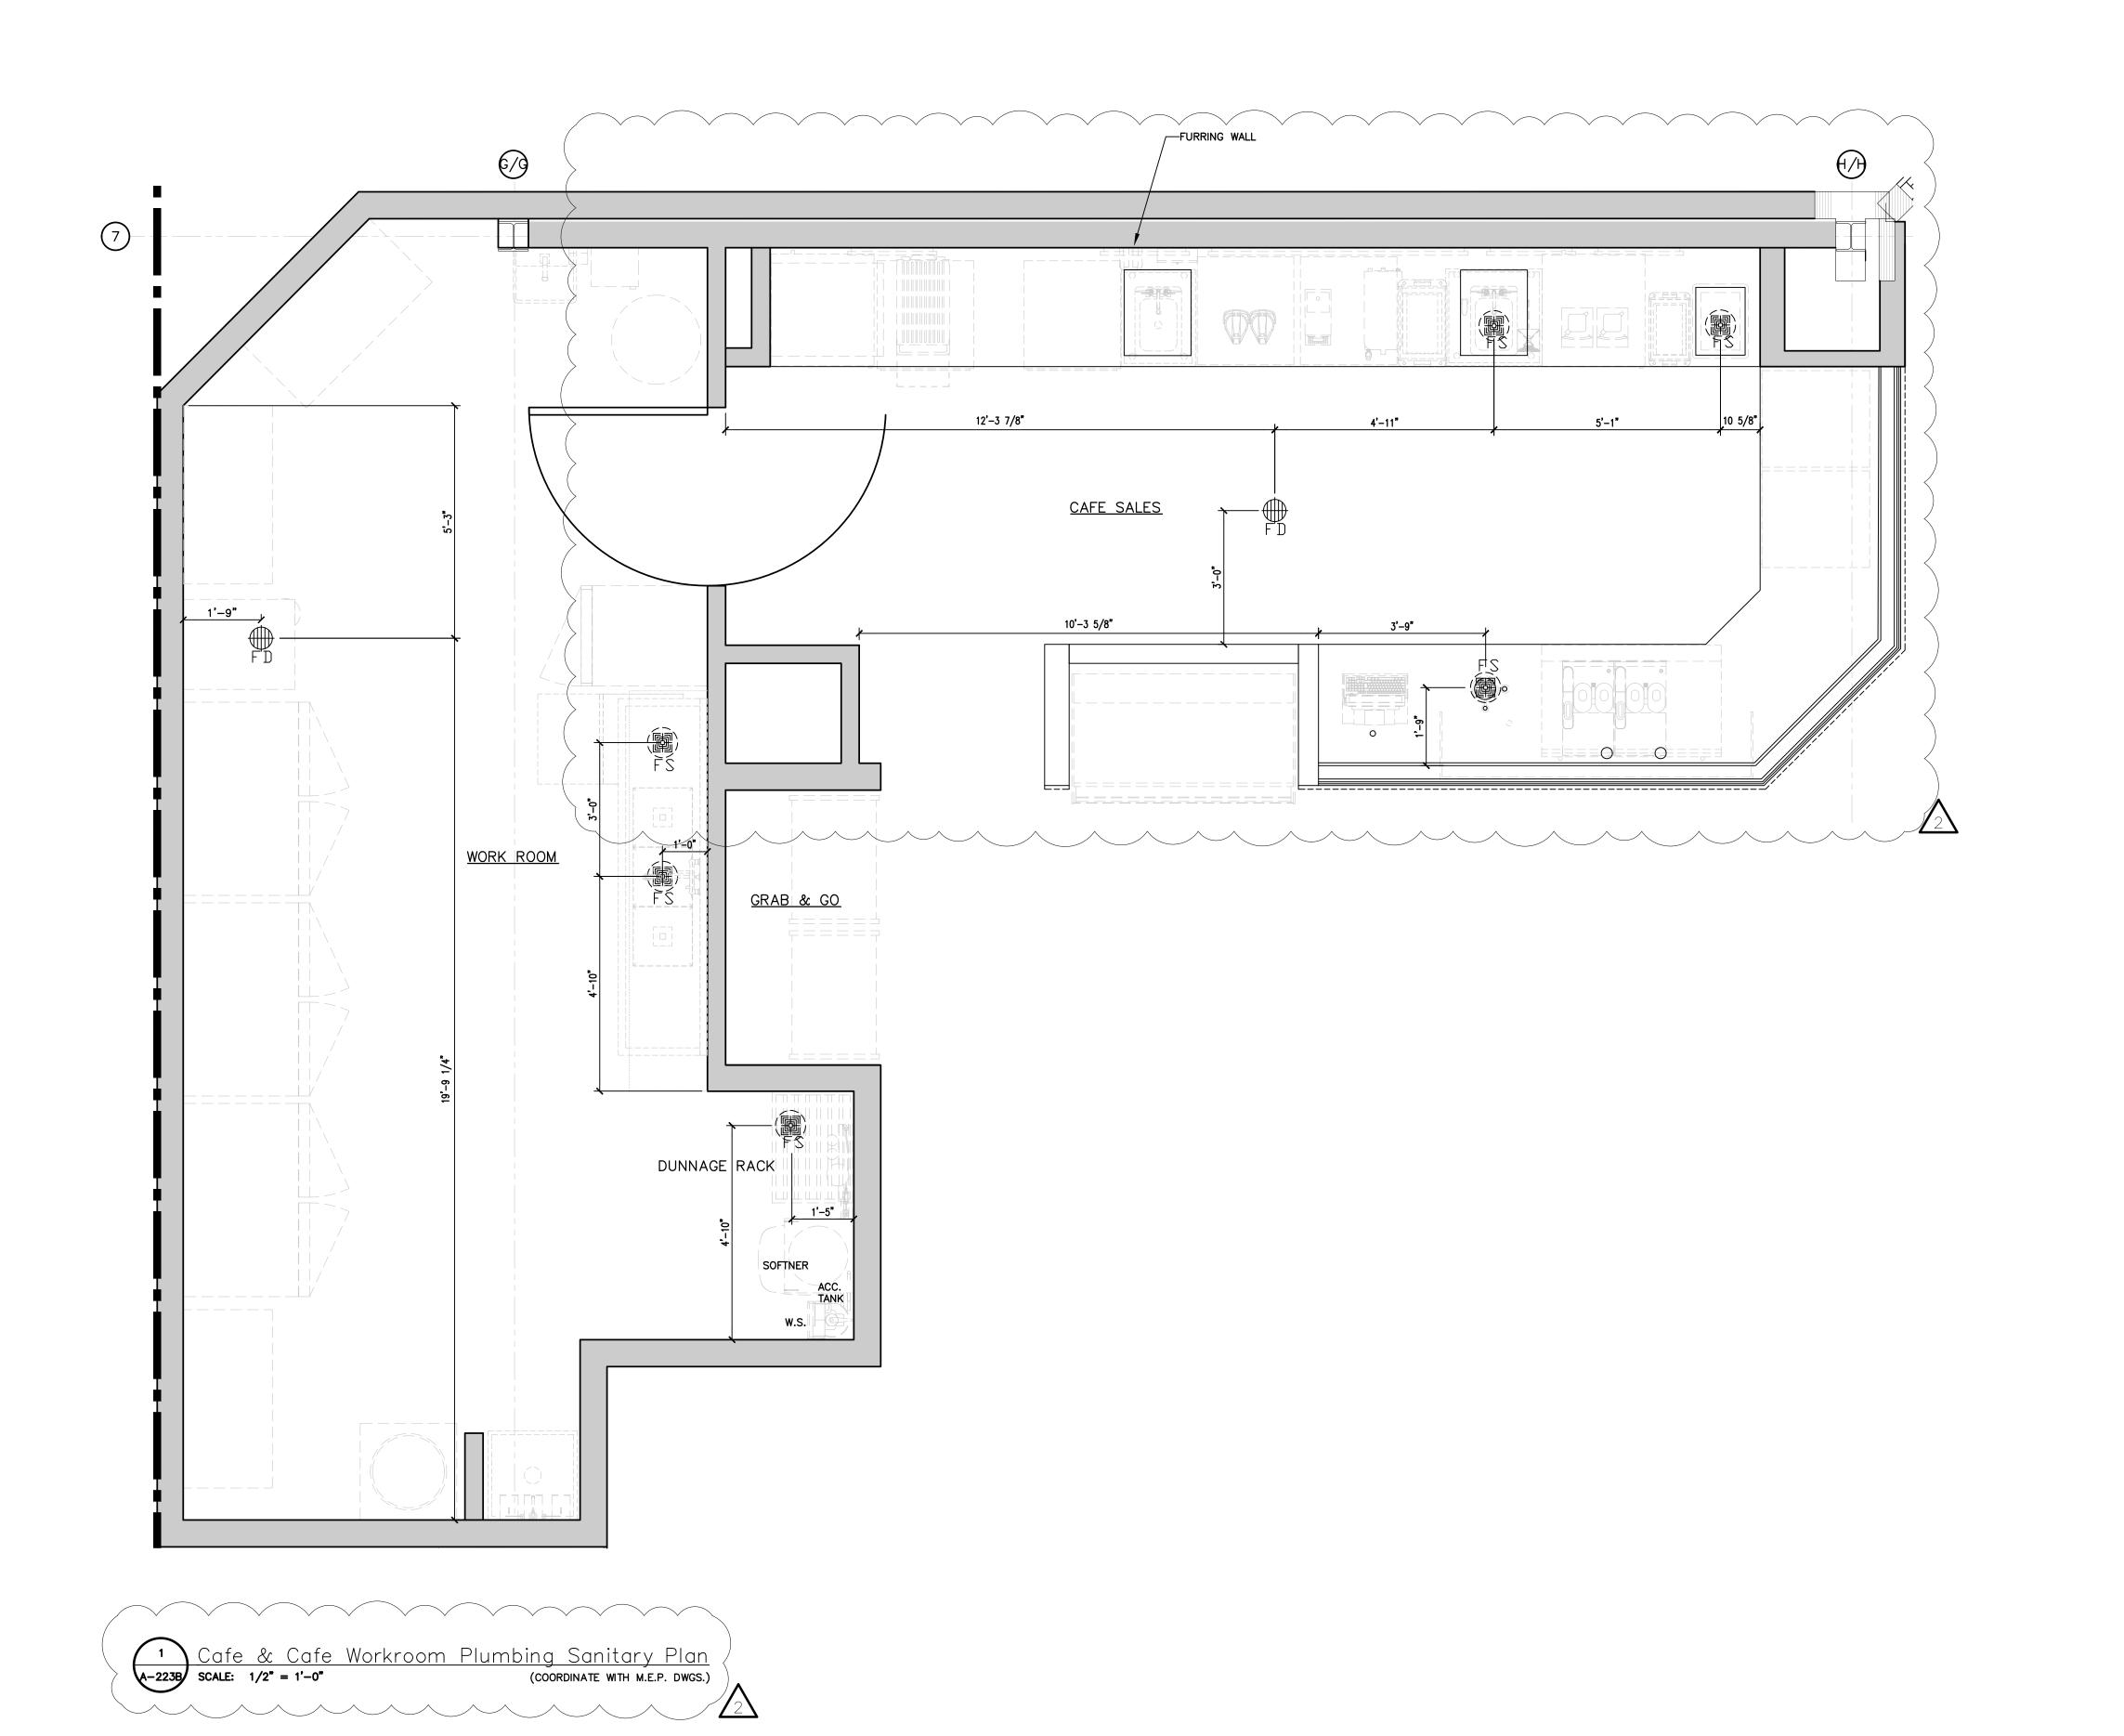

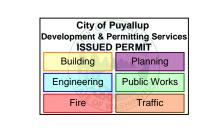ARCHITECT:

JOEL TORIELLI

422 BOGERT AVE

RIDGEWOOD, NJ 07450

SOUTH HILL MALL 3500 S. MERIDIAN UNIT #800 PUYALLUP, WA 98373

Project Number 33247
Store Number 3507

Revision Log:

Date
Description
No.


ISSUED FOR PERMIT, BID,
LANDLORD & CLIENT REVIEW
DESCRIPTION
DESC

These plans are an instrument of service and the property of the Architect, infringements will be prosecuted.

General Contractor to verify all

General Contractor to verify all conditions and dimensions at the premises. Discrepancies shall be reported to the Architect prior to the commencement of any work.

Professional Seal:

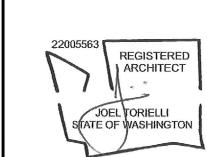


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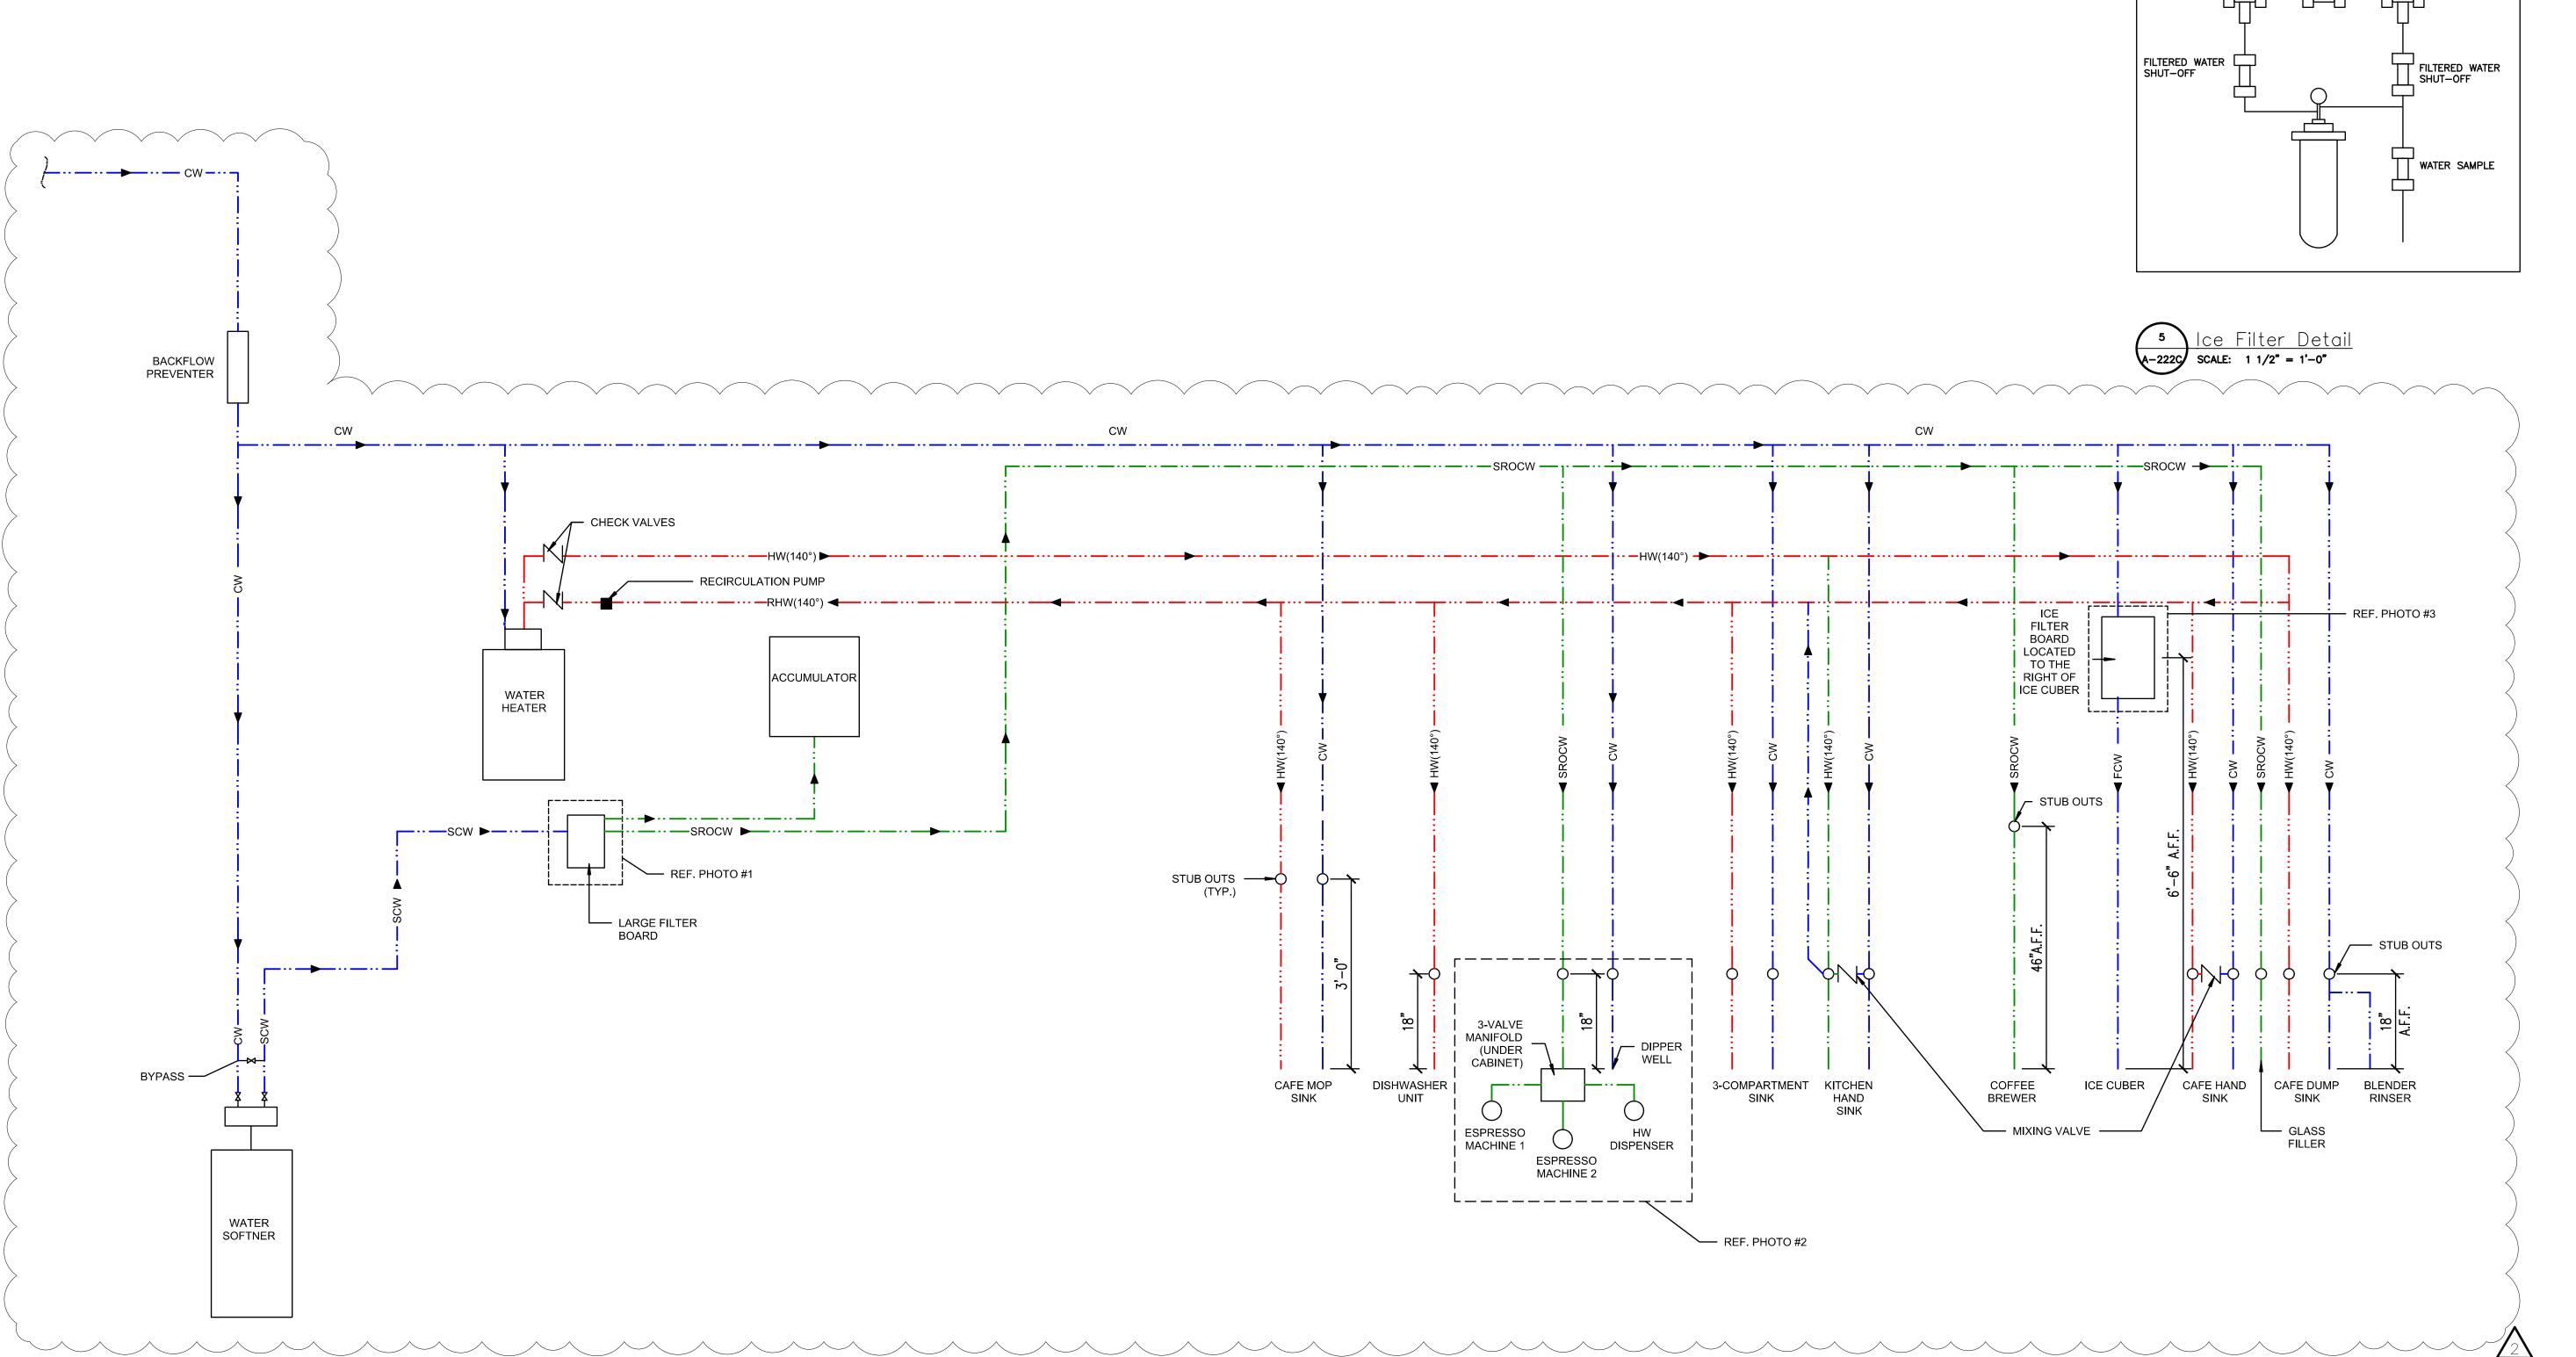
Cafe & Cafe Workroom Floor Penetration Plan

Drawing Number:

A-222B


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Reference Photo #4

A-222C SCALE: NTS

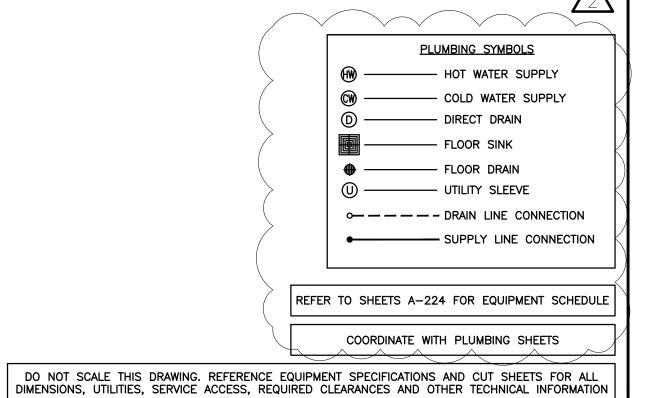ACCUMULATOR TANK IN WORKROOM

REFER TO PLUMBING ISOMETRIC FOR SIZING

THIS SCHEMATIC IS DIAGRAMMATIC AND INTENDED FOR PIPE ROUTING REFERENCE ONLY. INSTALLATION OF EQUIPMENT SHALL BE PER MANUFACTURERS GUIDELINES AND RECOMMENDATIONS

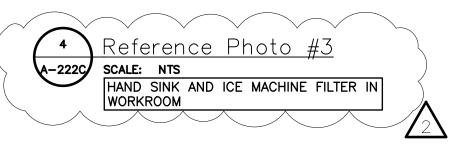FURNISH AND INSTALL AN APPROVED BACKFLOW PREVENTING DEVICE IN LINE WITH THE DOMESTIC WATER SUPPLY TO ALL APPLIANCES REQUIRING SAME (COFFEE

INCOMING WATER PRESSURE MUST BE BETWEEN 50 - 55 P.S.I. CONTRACTOR TO PROVIDE A BID ALTERNATE FOR BOOSTER PUMP DESIGNED FOR APPROXIMATE FLOW OF 60 GPM, AND APPROXIMATE PRESSURE BOOST OF 30 PSI TO SERVE THE CAFE. PUMP SHALL HAVE A VFD DRIVE FOR VARIABLE FLOW AND BID ALTERNATE SHOULD INCLUDE COST FOR ALL REQUIRED ACCESSORIES AND CONTROLS. THRUSH BRAND MODEL PB-VS--60-30 OR EQUAL. ENGINEER TO SIZE PUMP BASED ON FLOW TEST DATA IF PRESSURE IS DEEMED IN ADEQUATE.

PROJECT DESIGNER:

PRCTI20250011

**BARNES**%NOBLE

City of Puyallup
Development & Permitting Services
ISSUED PERMIT
Building Planning
Engineering Public Works
Fire Traffic

SOUTH HILL MALL 3500 S. MERIDIAN

Project Number 33247 Store Number 3507

Revision Log:

Date Description 12-19-24

12-19-24

13SUED FOR PERMIT, BID, LANDLORD & CLIENT REVIEW

DULANDLORD & CLIENT REVIEW

LANDLORD COMMENTS

DESCRIPTION

15SUED FOR PERMIT, BID, LANDLORD COMMENTS

DESCRIPTION


15SUED FOR CONSTRUCTION

25SUED FOR CONSTRUCTION

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Professional Seal:



EXP. DATE : 10/02/25

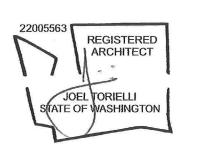Drawing Description: Cafe & Cafe Workroom Plumbing Schematic

Drawing Number:



Cafe & Cafe Workroom Plumbing Riser Schematic

Coordinate with M.E.P. DWGS.)

Reference Photo #1


SCALE: 3/4" = 1'-0"


WATER FILTRATION BOARD IN WORK ROOM

MAKER, ETC.)

BLUE = CW or SCW GREEN = SROCW

> ARCHITECT: JOEL TORIELLI 422 BOGERT AVE RIDGEWOOD, NJ 07450

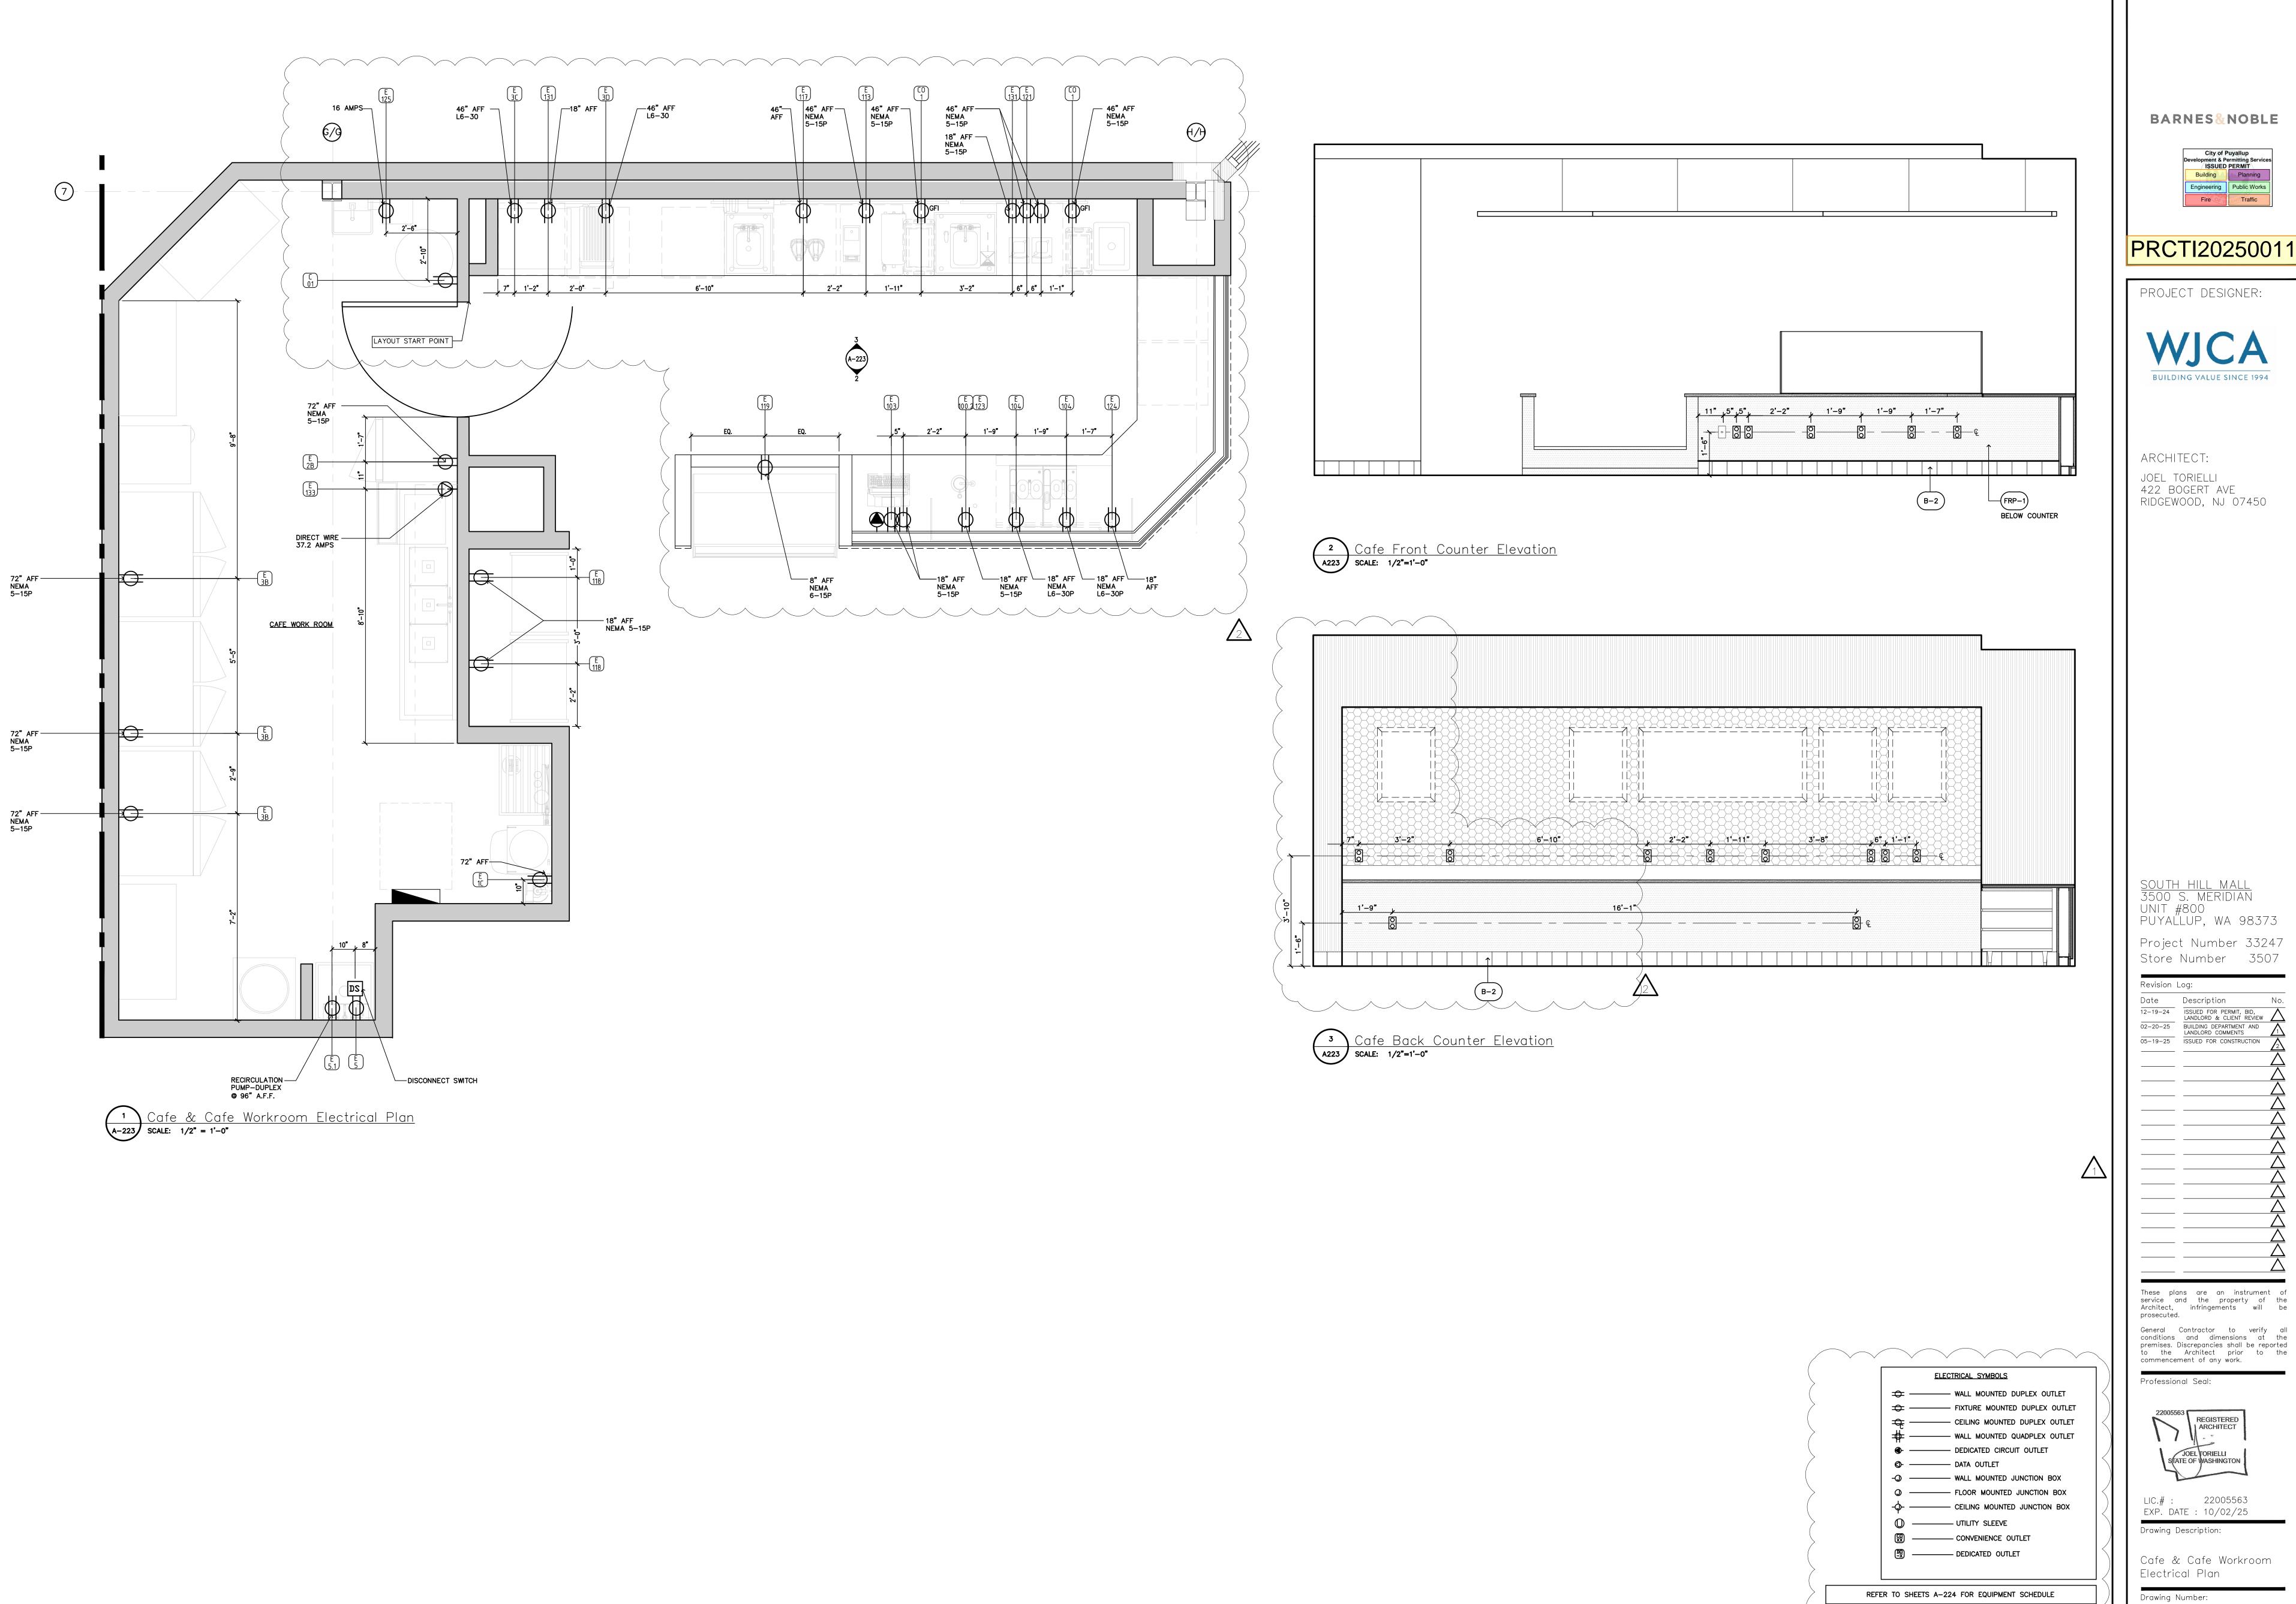

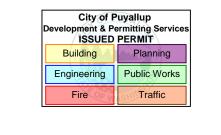

ARCHITECT: JOEL TORIELLI 422 BOGERT AVE RIDGEWOOD, NJ 07450

<u>South Hill Mall</u> 3500 S. Meridian Unit #800

PUYAĽLUP, WA 98373 Project Number 33247 Store Number 3507

Date Description

12-19-24

02-20-25

05-19-25

ISSUED FOR PERMIT, BID, LANDLORD & CLIENT REVIEW

LANDLORD COMMENTS

ISSUED FOR CONSTRUCTION

2

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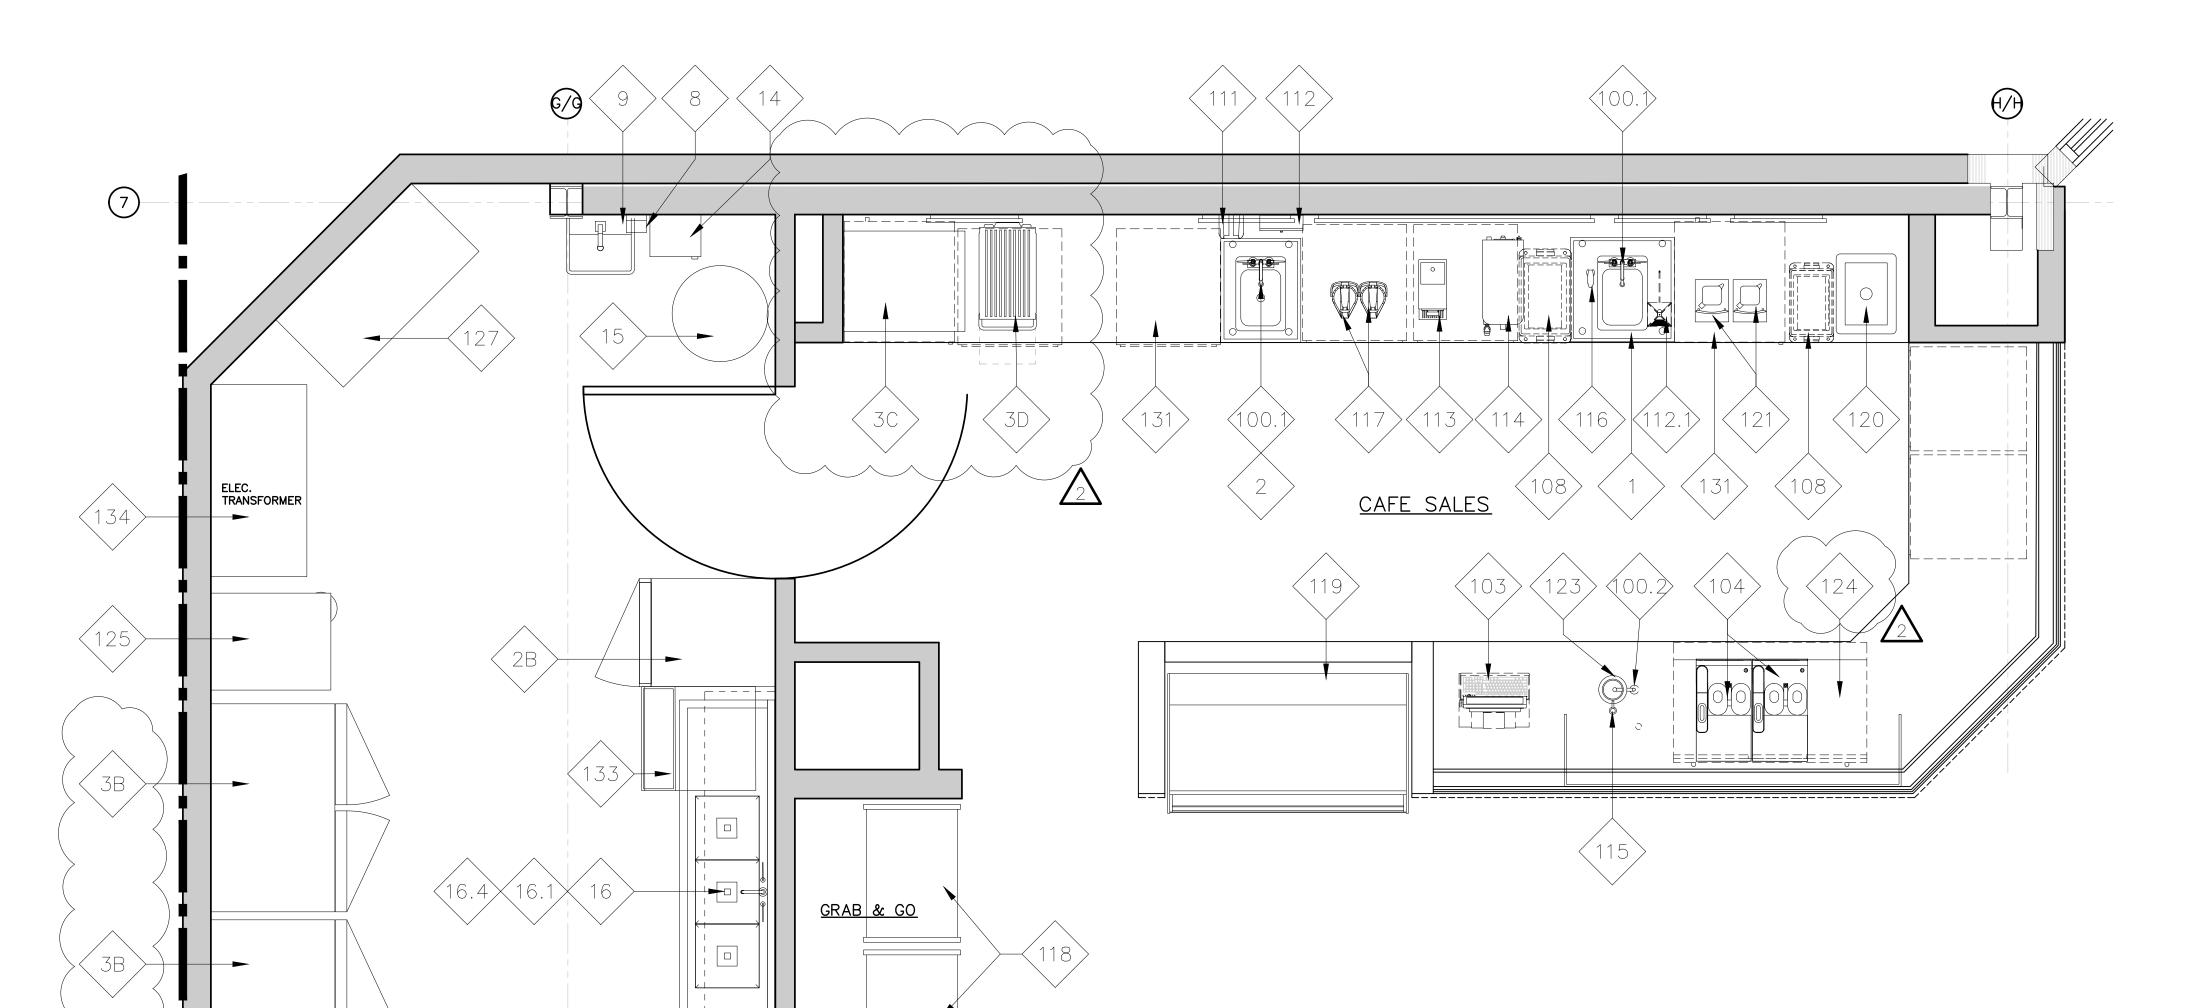
Professional Seal:

REGISTERED ARCHITECT JOEL TORIELLI STATE OF WASHINGTON

LIC.# : 22005563 EXP. DATE : 10/02/25

Cafe & Cafe Workroom Electrical Plan

DO NOT SCALE THIS DRAWING. REFERENCE EQUIPMENT SPECIFICATIONS AND CUT SHEETS FOR ALL DIMENSIONS, UTILITIES, SERVICE ACCESS, REQUIRED CLEARANCES AND OTHER TECHNICAL INFORMATION



	WORKROOM EQUIPMENT / UTILITIES SCHEDULE								
ITEM#	DESCRIPTION	MODEL#	QTY						
1A	R.O.WATER FILTRATION SYSTEM MANIFOLD BOARD	-	-	1					
1B	R.O.WATER FILTRATION SYSTEM - ACCUMULATOR TANK	-	-	1					
1C	R.O.WATER FILTRATION SYSTEM - WATER SOFTNER	-	-	1					
1D	R.O.WATER FILTRATION SYSTEM - BRINE	-	-	1					
2B	REFRIGERATOR, REACH-IN, SINGLE DOOR	TRUE MGF.	STG1R-1S-HC	1					
3B	FREEZER, REACH-IN, DOUBLE DOOR	TRUE MGF.	STG2F-2S-HC	2					
4	WATER HEATER	-	-	1					
5	MOP SINK	FIAT	MSB2424	1					
5.1	SERVICE FAUCET	CHICAGO FAUCET	897-RCF	1					
6	WALL SHELF	SUPPLIED BY BN	-	1					
8	SOAP DISPENSER	BN SUPPLIED PURELL	TFX	1					
9	HAND SINK - WALL MOUNTED	HAND SINK PARTS & ACCESSORIES	DH-17-NO FAU	1					
14	C-FOLD PAPER TOWEL DISPENSER	BN SUPPLIED C-FOLD	-	1					
15	WASTE CONTAINER	-	-	1					
16	THREE COMPARTMENT SINK	AMTEKCO INDUSTRIES LTD.	C-3-1620-24D	1					
16.1	PRE-RINSE FAUCET & ADD ON FAUCET			1					
16.4	LEVER WASTE	T&S BRASS	B-3950	3					
125	ICE MAKER, CUBE-STYLE	ITV ICE MAKER	SPIKA MS 500	1					
127	WIRE SHELVING	1880 HOSPITALITY	FF2472C	4					
129	REFRIGERATOR, REACH-IN, DOUBLE DOOR	TRUE MGF.	STG2DT-2S	1					
133	DISHWASHER, UNDERCOUNTER	JACKSON WWS	DISHSTAR HT	1					

# 1 Cafe & Cafe Workroom Equipment Plan A-224 SCALE: 1/2" = 1'-0"


CAFE WORK ROOM

LINE OF -SHELF ABOVE

ITEM#	DESCRIPTION	MANUFACTURER	MODEL#	QTY.
· ι <b>–</b> ινι <i>π</i>	DESCRIPTION	MANOLAGICALIA	INODEL#	411
1	SINK BOWL, WELD-IN, DUMP SINK	N. WASSERSTROM & SONS	F4480234	1
2	SINK BOWL, WELD-IN, HAND SINK	N. WASSERSTROM & SONS	F4480234	1
3C	BLODGETT OVEN	BLODGETT	CTB SGL	1
3D	RAPID COOK OVEN	MERRYCHEF USA	E2S HIGH CLASSIC	1
100.1	PANTRY FAUCET	T&S BRASS	KL45-4000-WH	2
100.2	HOT WATER DISPENSER	IN SINK ERATOR	C1300	1
103	POS SYSTEM	-	-	1
104	ESPRESSO MACHINE	MELITTA	CT8	2
108	GARBAGE CAN	RUBBERMAID COMMERCIAL PRODUCTS	FG354060BLA	2
111	TOUCH-FREE SOAP DISPENSER	GOJO INDUSTRIES, INC.	PURELL CS6	1
112	SURFACE-MOUNTED PAPER TOWEL DISPENSER	BOBRICK	B-2621	1
112.1	BLENDER RINSER	BLENDTEC	JRE-610	1
113	COFFEE GRINDER	GRINDMASTER-UNIC-CRATHCO	890BS	1
114	COFFEE BREWER	BUNN	53100.0100	1
115	MANIFOLD	-		1
116	GLASS FILLER	T&S BRASS	B-1210	1
117	AIRPOT	SERVICE IDEAS	ECALS22SS	2
118	SELF-SERVICE REFRIGERATED CASE	STRUCTURAL CONCEPTS	B3424	2
119	PASTRY CASE, CURVED GLASS	FEDERAL INDUSTRIES	SSRPF-5052	1
120	DROP-IN ICE BIN	KROWNE	D278	1
121	BLENDER	VITAMIX	36019-ABAB	2
123	DIPPER WELL	T&S BRASS	B-2282-01-F05	1
124	DOUBLE UNDER COUNTER REFRIGERATOR	TRUE MGF.	TUC-48-HC	1
131	SINGLE UNDER COUNTER REFRIGERATOR	TRUE MGF.	TUC-27-HC	2

CAFE EQUIPMENT POWER SCHEDULE												
QUIPMENT NO.	DESCRIPTION	QUANTITY	VOLTAGE AND PHASE	AMPS	НР	KVA	PANEL	CIRCUIT(S)	BREAKER SIZE	WIRE SIZE	CONDUIT	NEMA
2B	FREEZER, REACH-IN, SINGLE DOOR/	1	115V/1Ø	9.4	1-1/4	1.081	К	28	20A-1P	(2)#12 THWN & (1)#12 GND	3/4"	5-15P
3B	REFRIGERATOR, REACH-IN, DOUBLE DOOR/	2	115V/1Ø	9.4	1-1/4	1.081	K K	6 14	20A-1P	(2)#12 THWN & (1)#12 GND	3/4"	5-15P
3C	BLODGETT OVEN/	1	208V/3Ø	24.0		5.6	K	36,38,40	20A-3P	(3)#12 THWN & (1)#12 GND	3/4"	6-30P
3D	RAPID COOK OVEN/	1	208V/1Ø	30.0		6.0	K	39,41	30A-2P	(3)#12 THWN & (1)#12 GND	3/4"	6-30P
100.2	HOT WATER DISPENSER/	1	115V/1Ø	11.3	-	1.300	K	22	20A-1P	(2)#12 THWN & (1)#12 GND	3/4"	5-15P
103	POS SYSTEM/	1	115V/1Ø	-	VERIFY	VERIFY	K K	37 35	20A-1P	(2)#12 THWN & (1)#12 GND & (1)#12 ISO.GNO	3/4"	5-15P
104	ESPRESSO MACHINE/	2	208V-220V/1 Ø	30.0	-	6.240	K K	5,7 9,11	30A-2P	(2)#10 THWN & (1)#10 GND	3/4"	L6-30P
121	BLENDER	2	120V/1Ø	15.0	3.0	1.800	K K	18 20	20A-1P	(2)#12 THWN & (1)#12 GND	3/4"	5-15P
113	COFFEE GRINDER/	1	120V/1Ø	8.0	1/2	0.920	K	15	20A-1P	(2)#12 THWN & (1)#12 GND	3/4"	5-15P
114	COFFEE BREWER/	1	208V/1Ø	14.0	-	2.9	К	10,12	20A-2P	(2)#12 THWN & (1)#12 GND	3/4"	VERIFY WITH MANUFA TURER
118	SELF-SERVICE REFRIGERATED CASE/	2	120V/1Ø	15.6	_	1.198	K K	2 4	20A-1P	(2)#12 THWN & (1)#12 GND	3/4"	5-20P
119	PASTRY CASE, CURVED GLASS/	1	208V/1Ø	10.0	1/2	2.08	K	32,34	20A-2P	(2)#12 THWN & (1)#12 GND	3/4"	6-20P
124	DOUBLE UNDER COUNTER REFRIGERATOR/	1	TBD	-	-	-	К	30	20A-1P	(2)#12 THWN & (1)#12 GND	3/4"	
125	ICE MAKER, CUBE-STYLE/	1	115V/1Ø	16.2	-	1.289	K	1	20A-1P	(2)#12 THWN & (1)#12 GND	3/4"	
129	REFRIGERATOR/FREEZER REACH-IN, DOUBLE DOOR/	1	115V/1Ø	5.9	1/2	0.679	К	19	20A-1P	(2)#12 THWN & (1)#12 GND	3/4"	5-15P
131	SINGLE UNDER COUNTER REFRIGERATOR/	2	115V/1Ø	2.0	1/6	0.24	K K	8 13	20A-1P	(2)#12 THWN & (1)#12 GND	3/4"	5-15P
C01	CONVENIENCE RECEPTACLE/	1	120V/1Ø	1.5	-	0.180	SEE PLANS	SEE PLANS	20A-1P	(2)#12 THWN & (1)#12 GND	3/4"	5-15P

**BARNES**%NOBLE

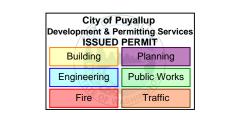

# PRCTI20250011

PROJECT DESIGNER:



ARCHITECT:

JOEL TORIELLI

422 BOGERT AVE

RIDGEWOOD, NJ 07450

SOUTH HILL MALL 3500 S. MERIDIAN UNIT #800

PUYALLUP, WA 98373
Project Number 33247
Store Number 3507

Revision Log:


Date Description

Date	Description	110
12-19-24	ISSUED FOR PERMIT, BID, LANDLORD & CLIENT REVIEW	$\triangle$
02-20-25	BUILDING DEPARTMENT AND LANDLORD COMMENTS	$\Lambda$
05-19-25	ISSUED FOR CONSTRUCTION	$\sqrt{2}$
		$\triangle$
		$\triangle$
		$\overline{\Lambda}$

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General Contractor to verify all conditions and dimensions at the premises. Discrepancies shall be reported to the Architect prior to the commencement of any work.


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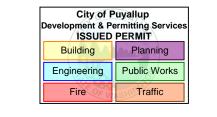


LIC.#: 22005563 EXP. DATE: 10/02/25 Drawing Description:

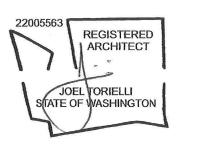Cafe & Cafe Workroom Equipment Plan and Schedule

Drawing Number:



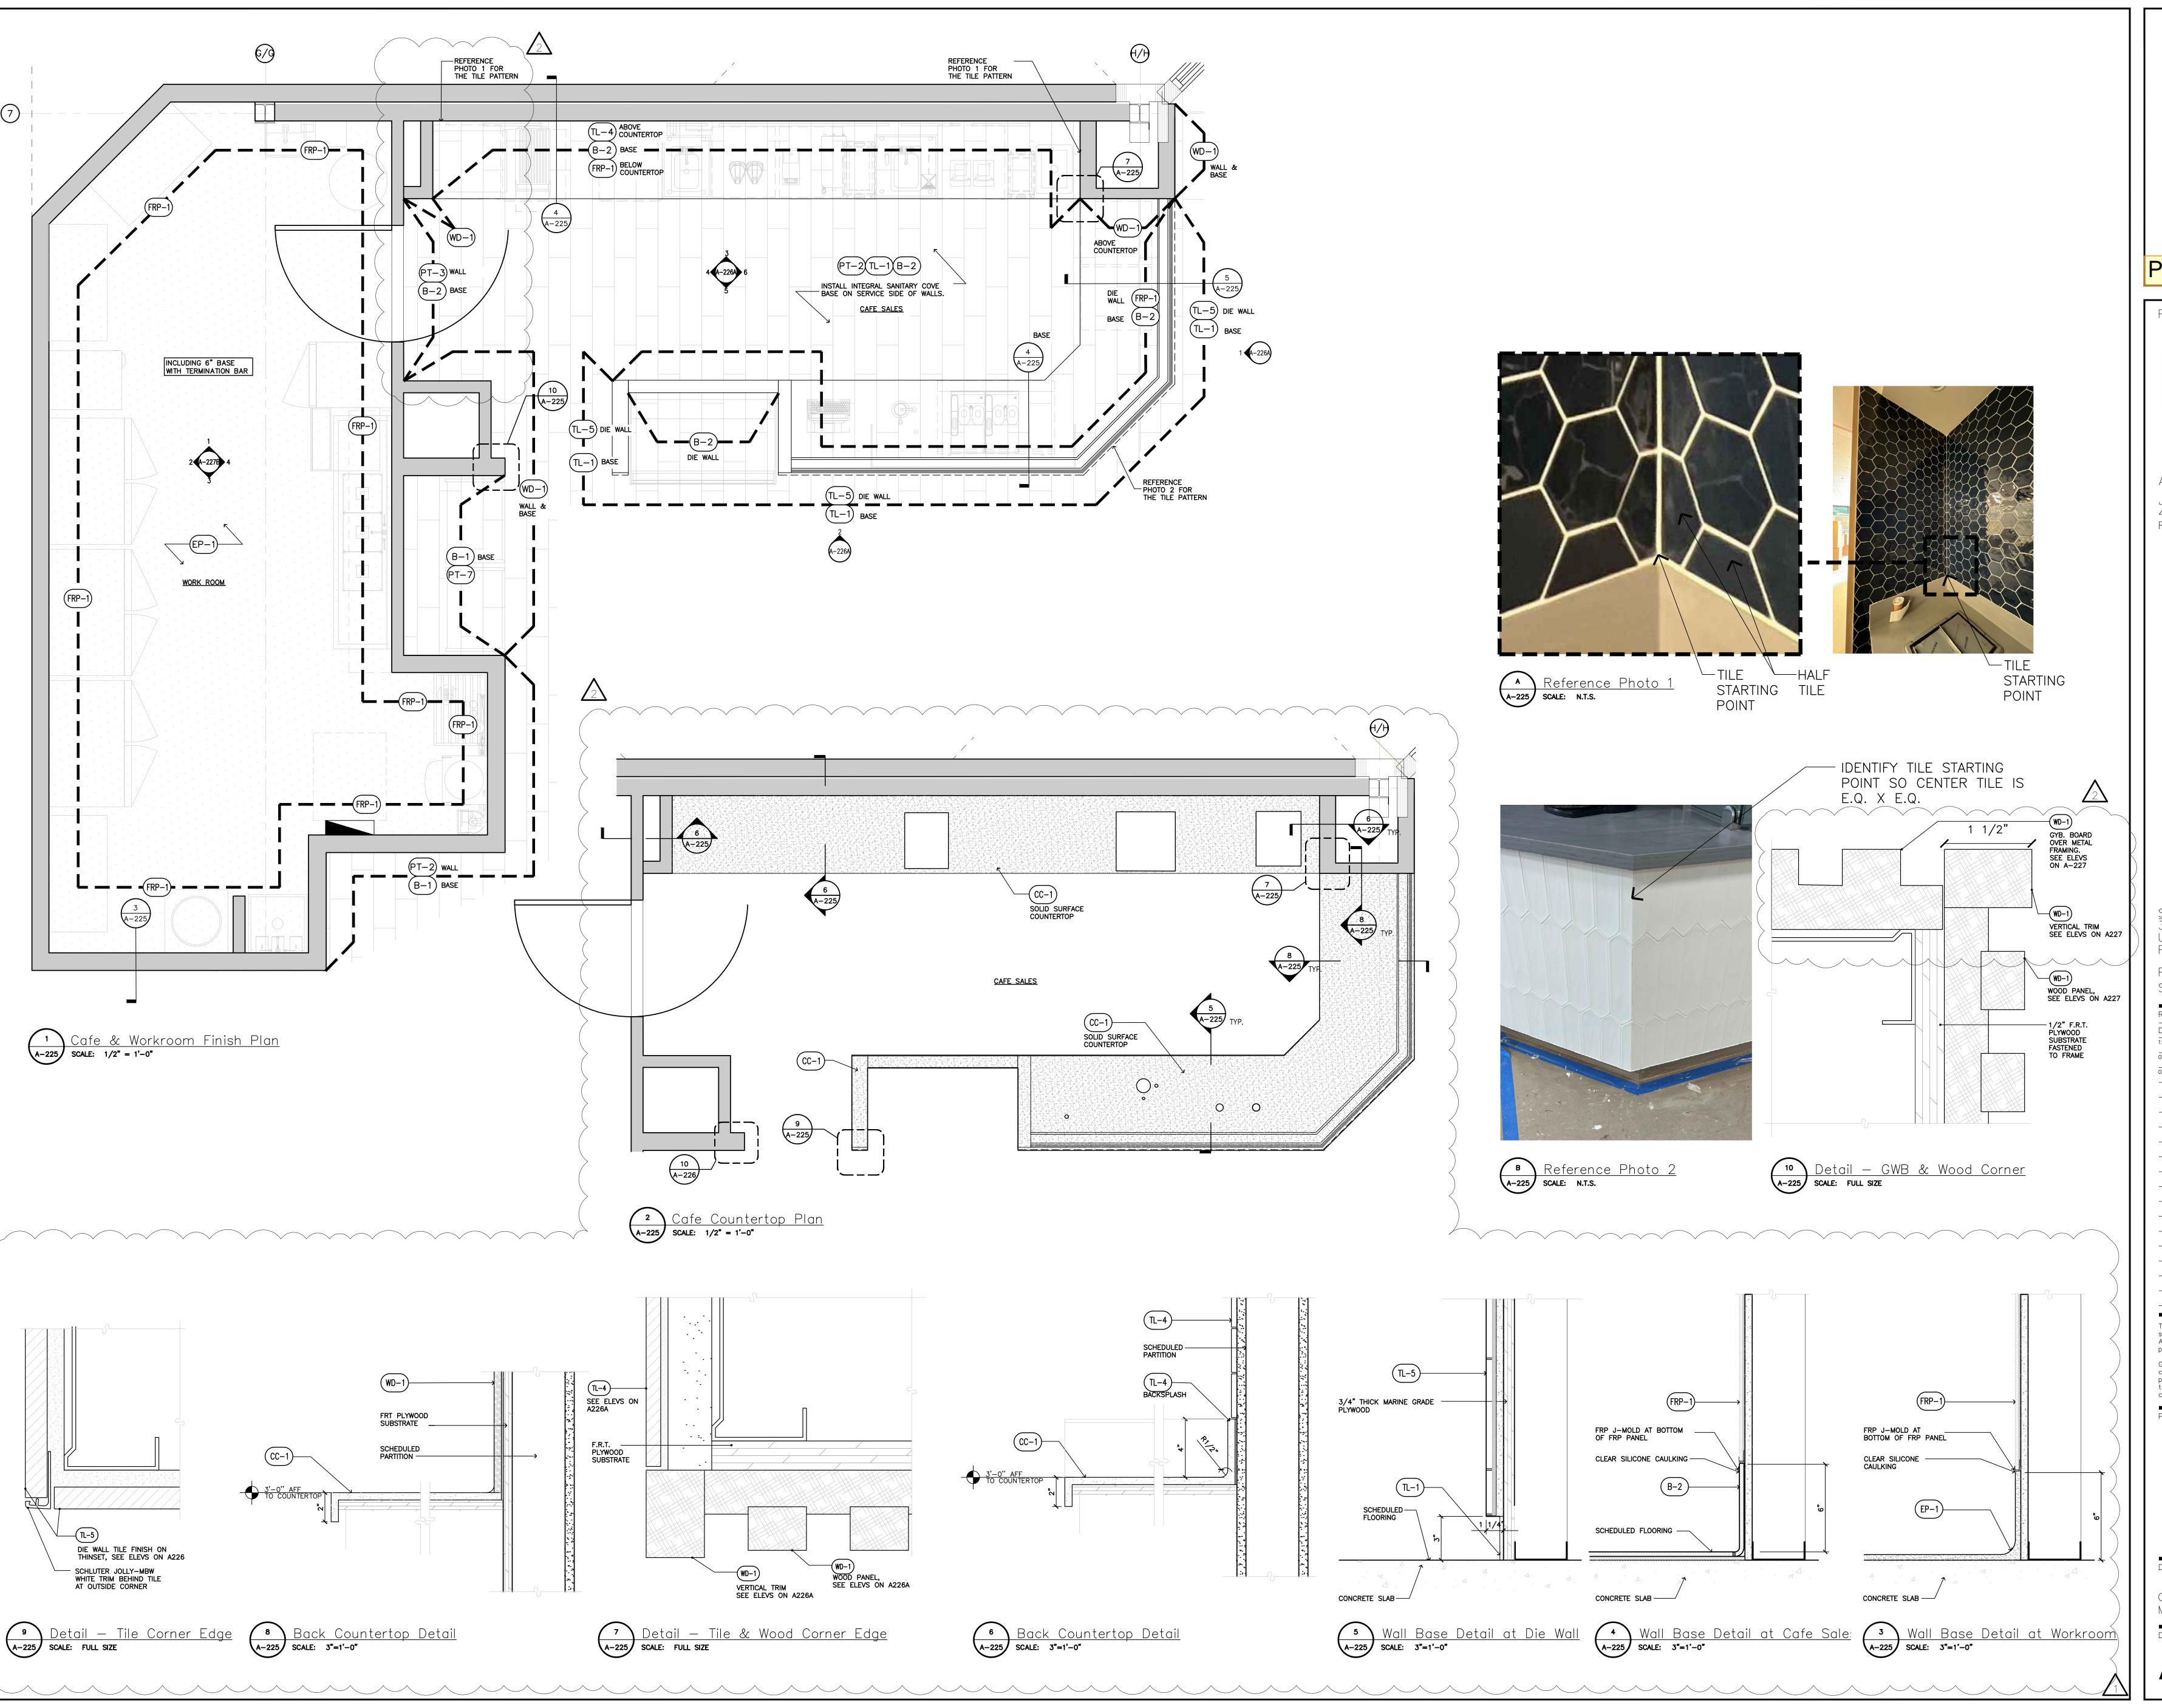

PRCTI20250011

PROJECT DESIGNER:



ARCHITECT: JOEL TORIELLI 422 BOGERT AVE RIDGEWOOD, NJ 07450

SOUTH HILL MALL 3500 S. MERIDIAN UNIT #800 PUYALLUP, WA 98373

Project Number 33247 Store Number 3507

Revision Log: Date Description

Description

12-19-24

ISSUED FOR PERMIT, BID, LANDLORD & CLIENT REVIEW

DESCRIPTION

ISSUED FOR PERMIT, BID, LANDLORD & CLIENT REVIEW

LANDLORD COMMENTS

ISSUED FOR CONSTRUCTION

2

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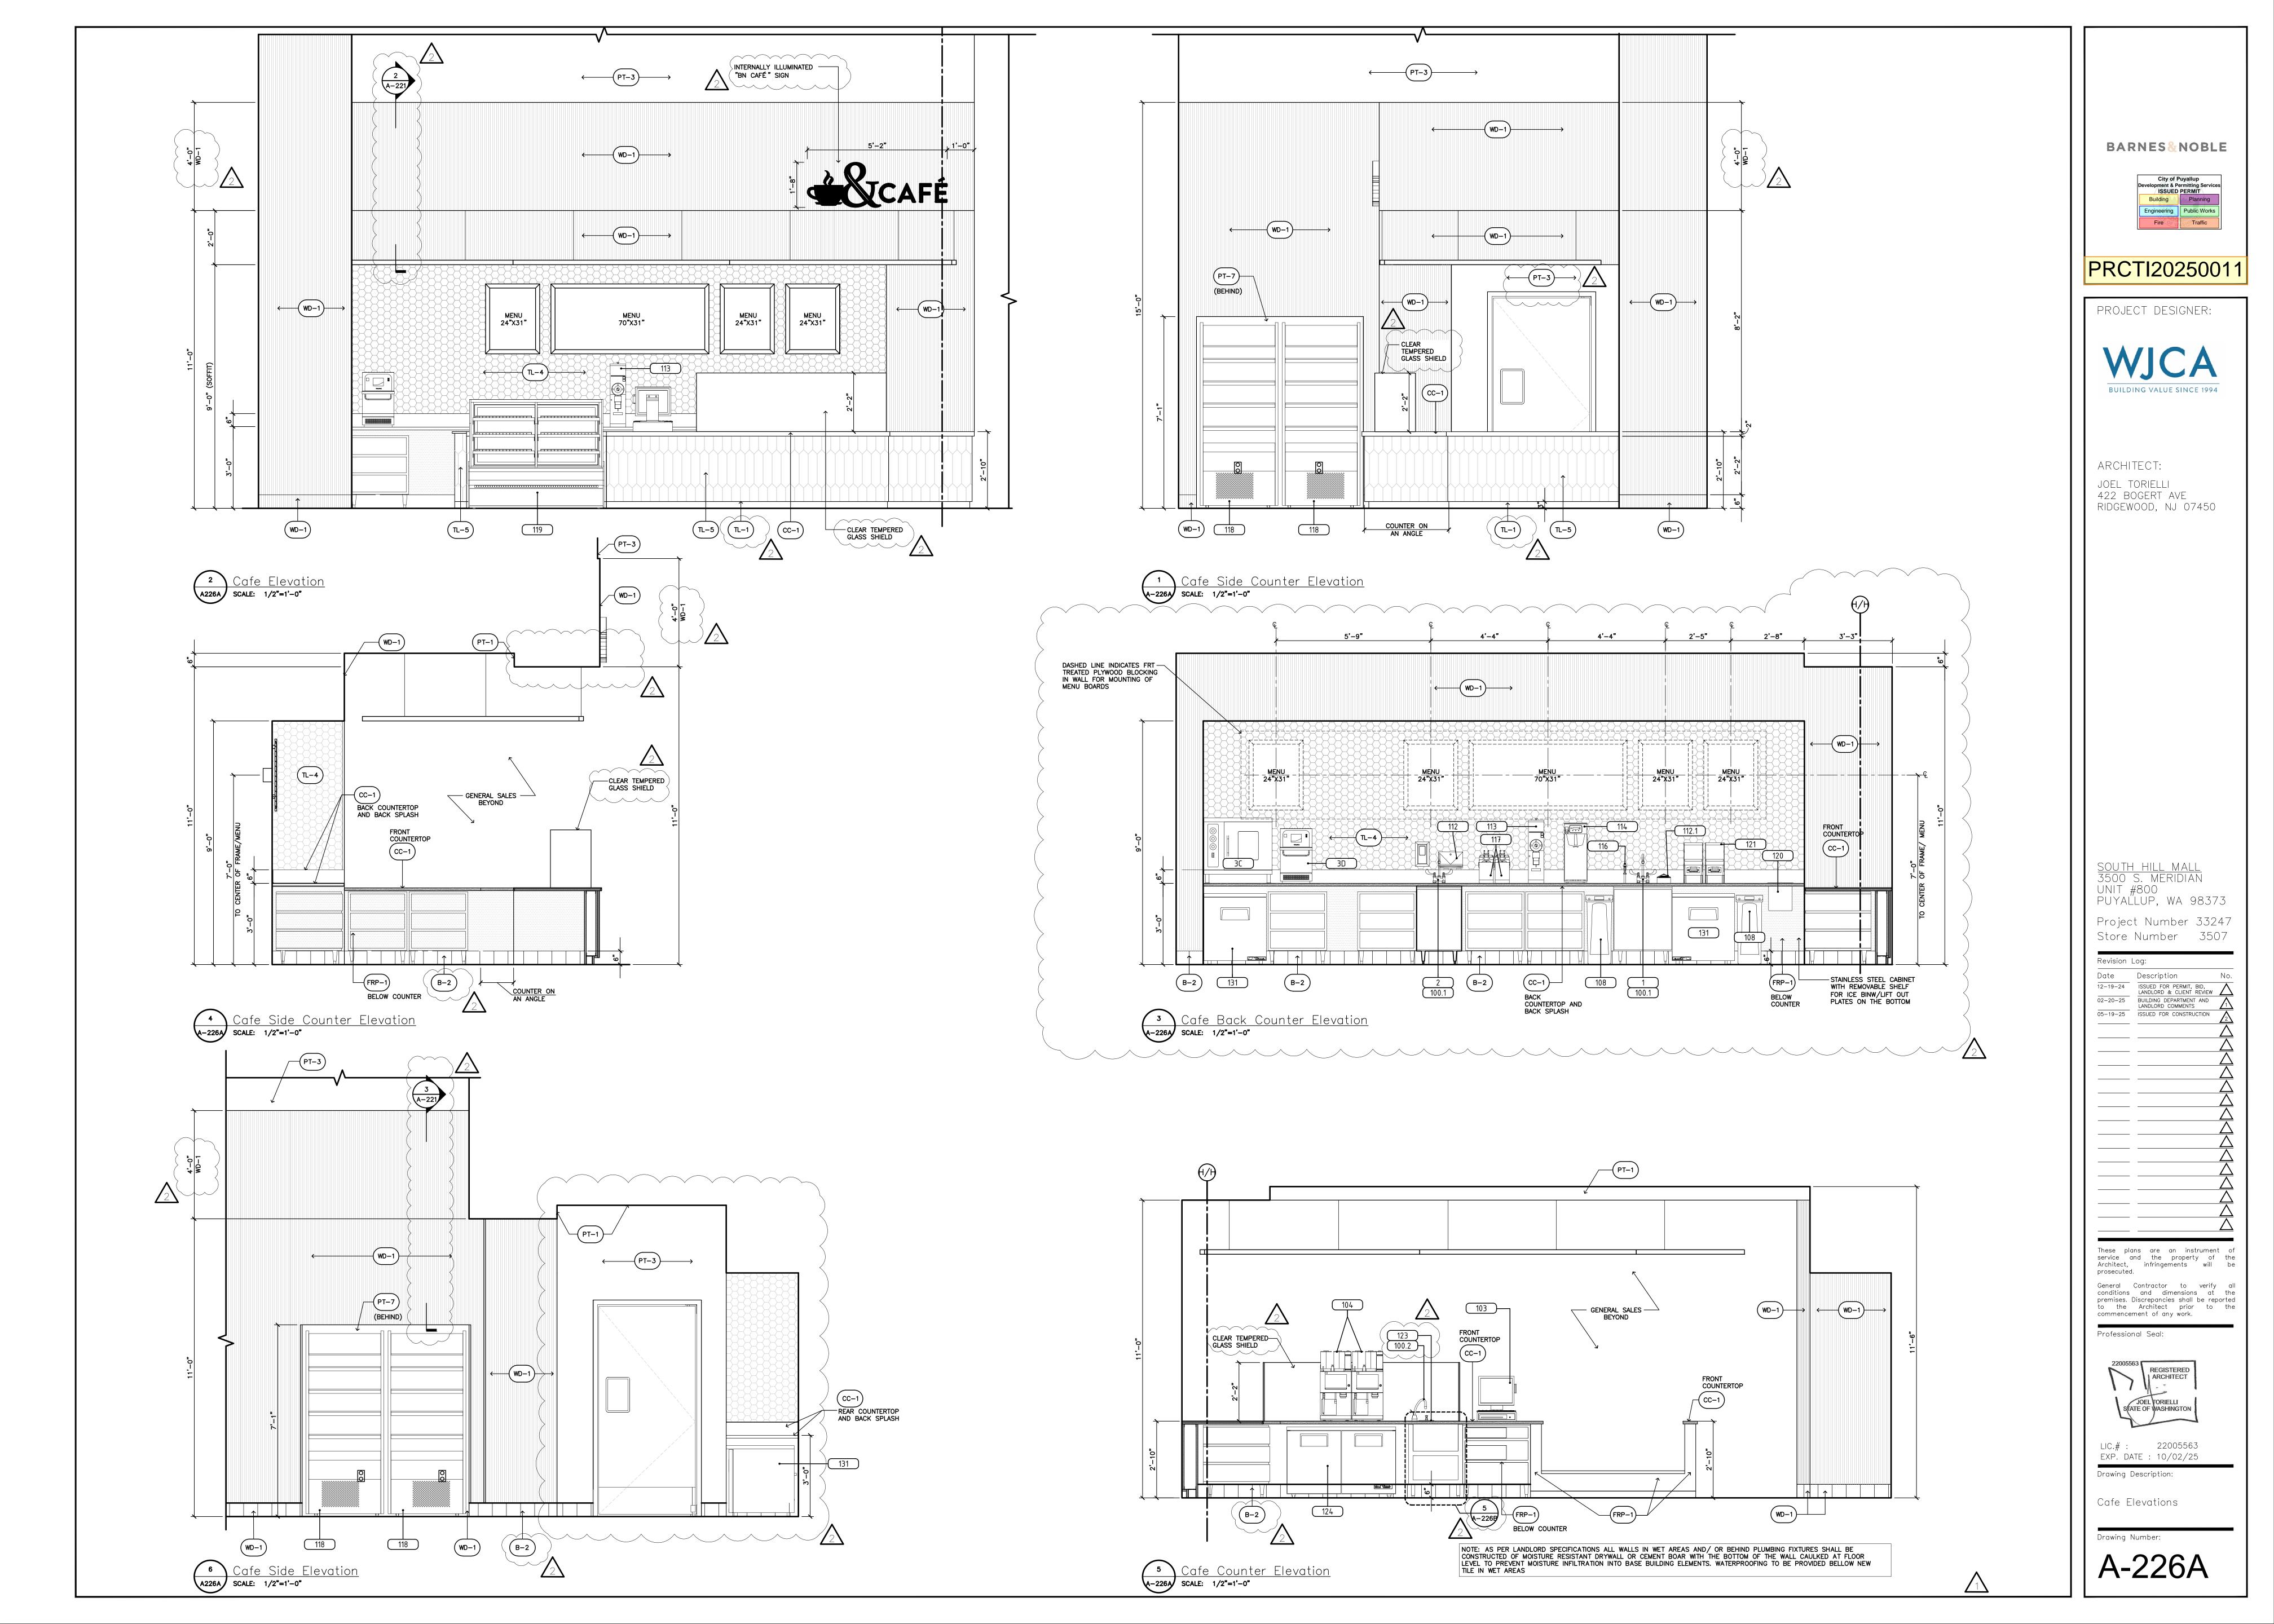
> REGISTERED ARCHITECT JOEL TORIELLI STATE OF WASHINGTON


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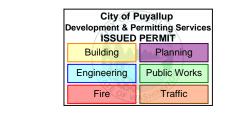
Drawing Description:

Cafe & Cafe Workroom Millwork Details

Drawing Number:





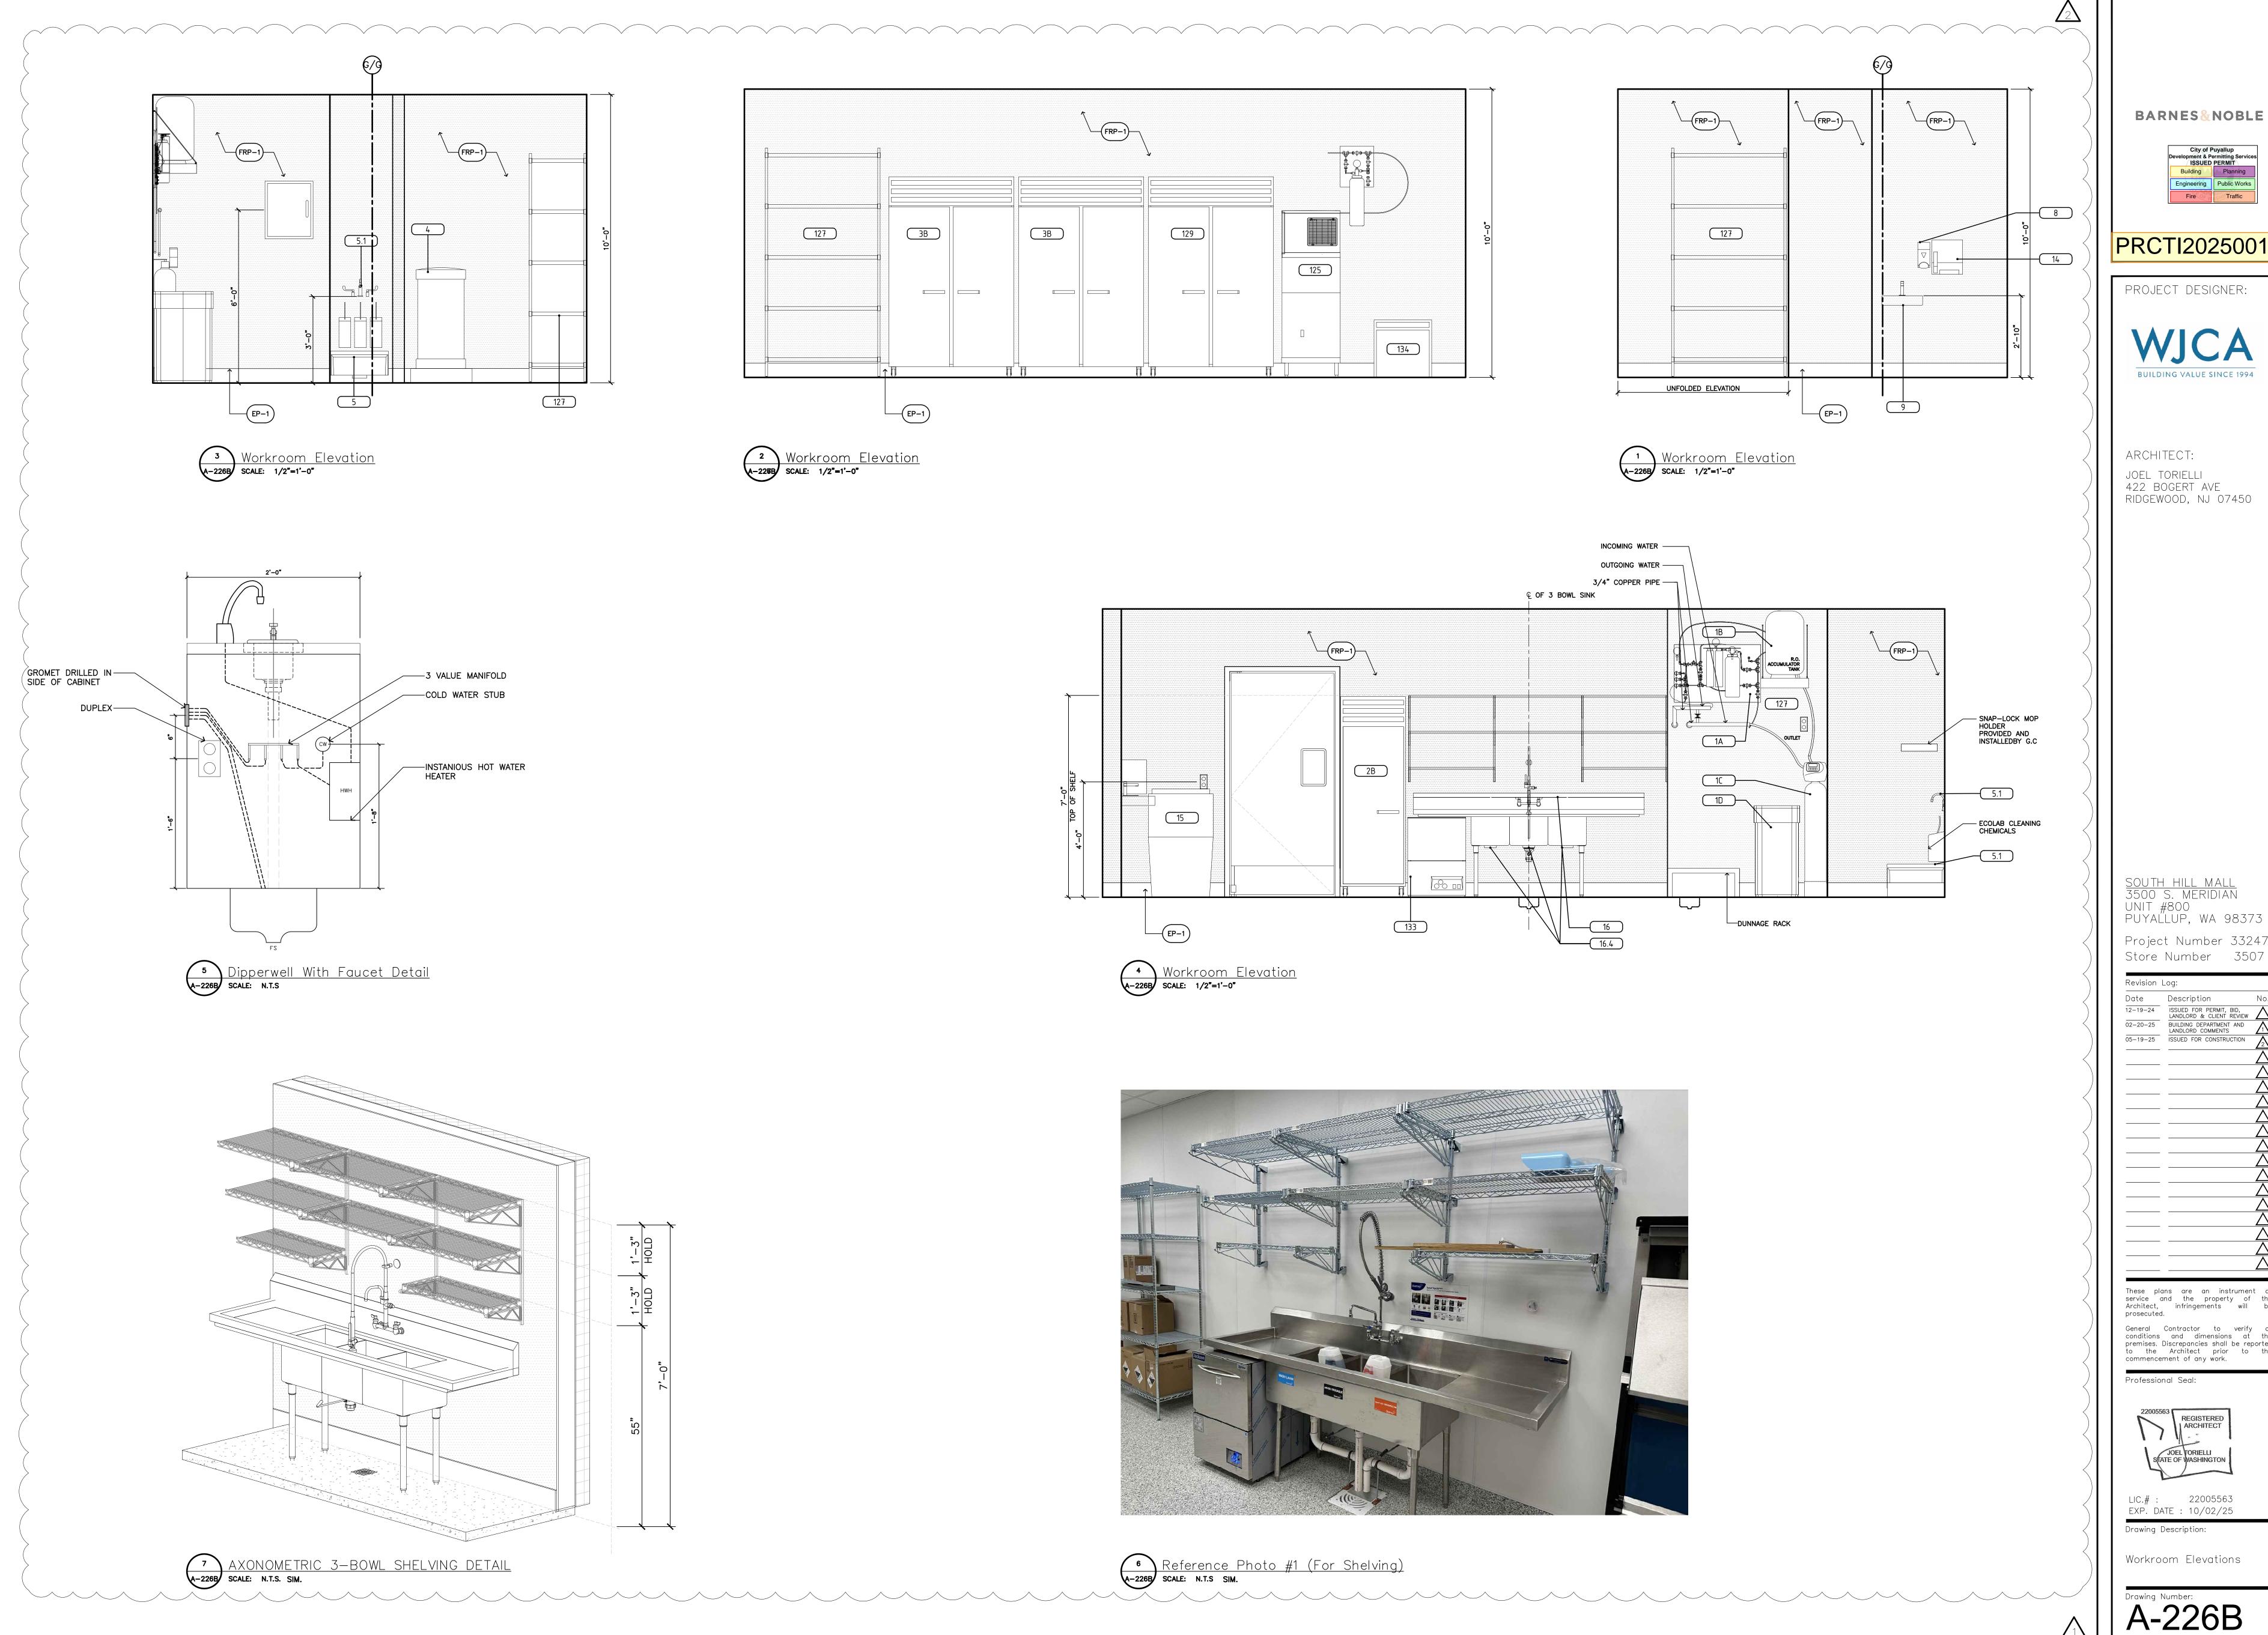

PRCTI20250011

PROJECT DESIGNER:



ARCHITECT: JOEL TORIELLI 422 BOGERT AVE RIDGEWOOD, NJ 07450

UNIT #800

Project Number 33247 Store Number 3507

Revision Log:

Date Description 12-19-24

02-20-25

05-19-25

Description

ISSUED FOR PERMIT, BID, LANDLORD & CLIENT REVIEW

LANDLORD & CLIENT REVIEW

LANDLORD COMMENTS


ISSUED FOR CONSTRUCTION

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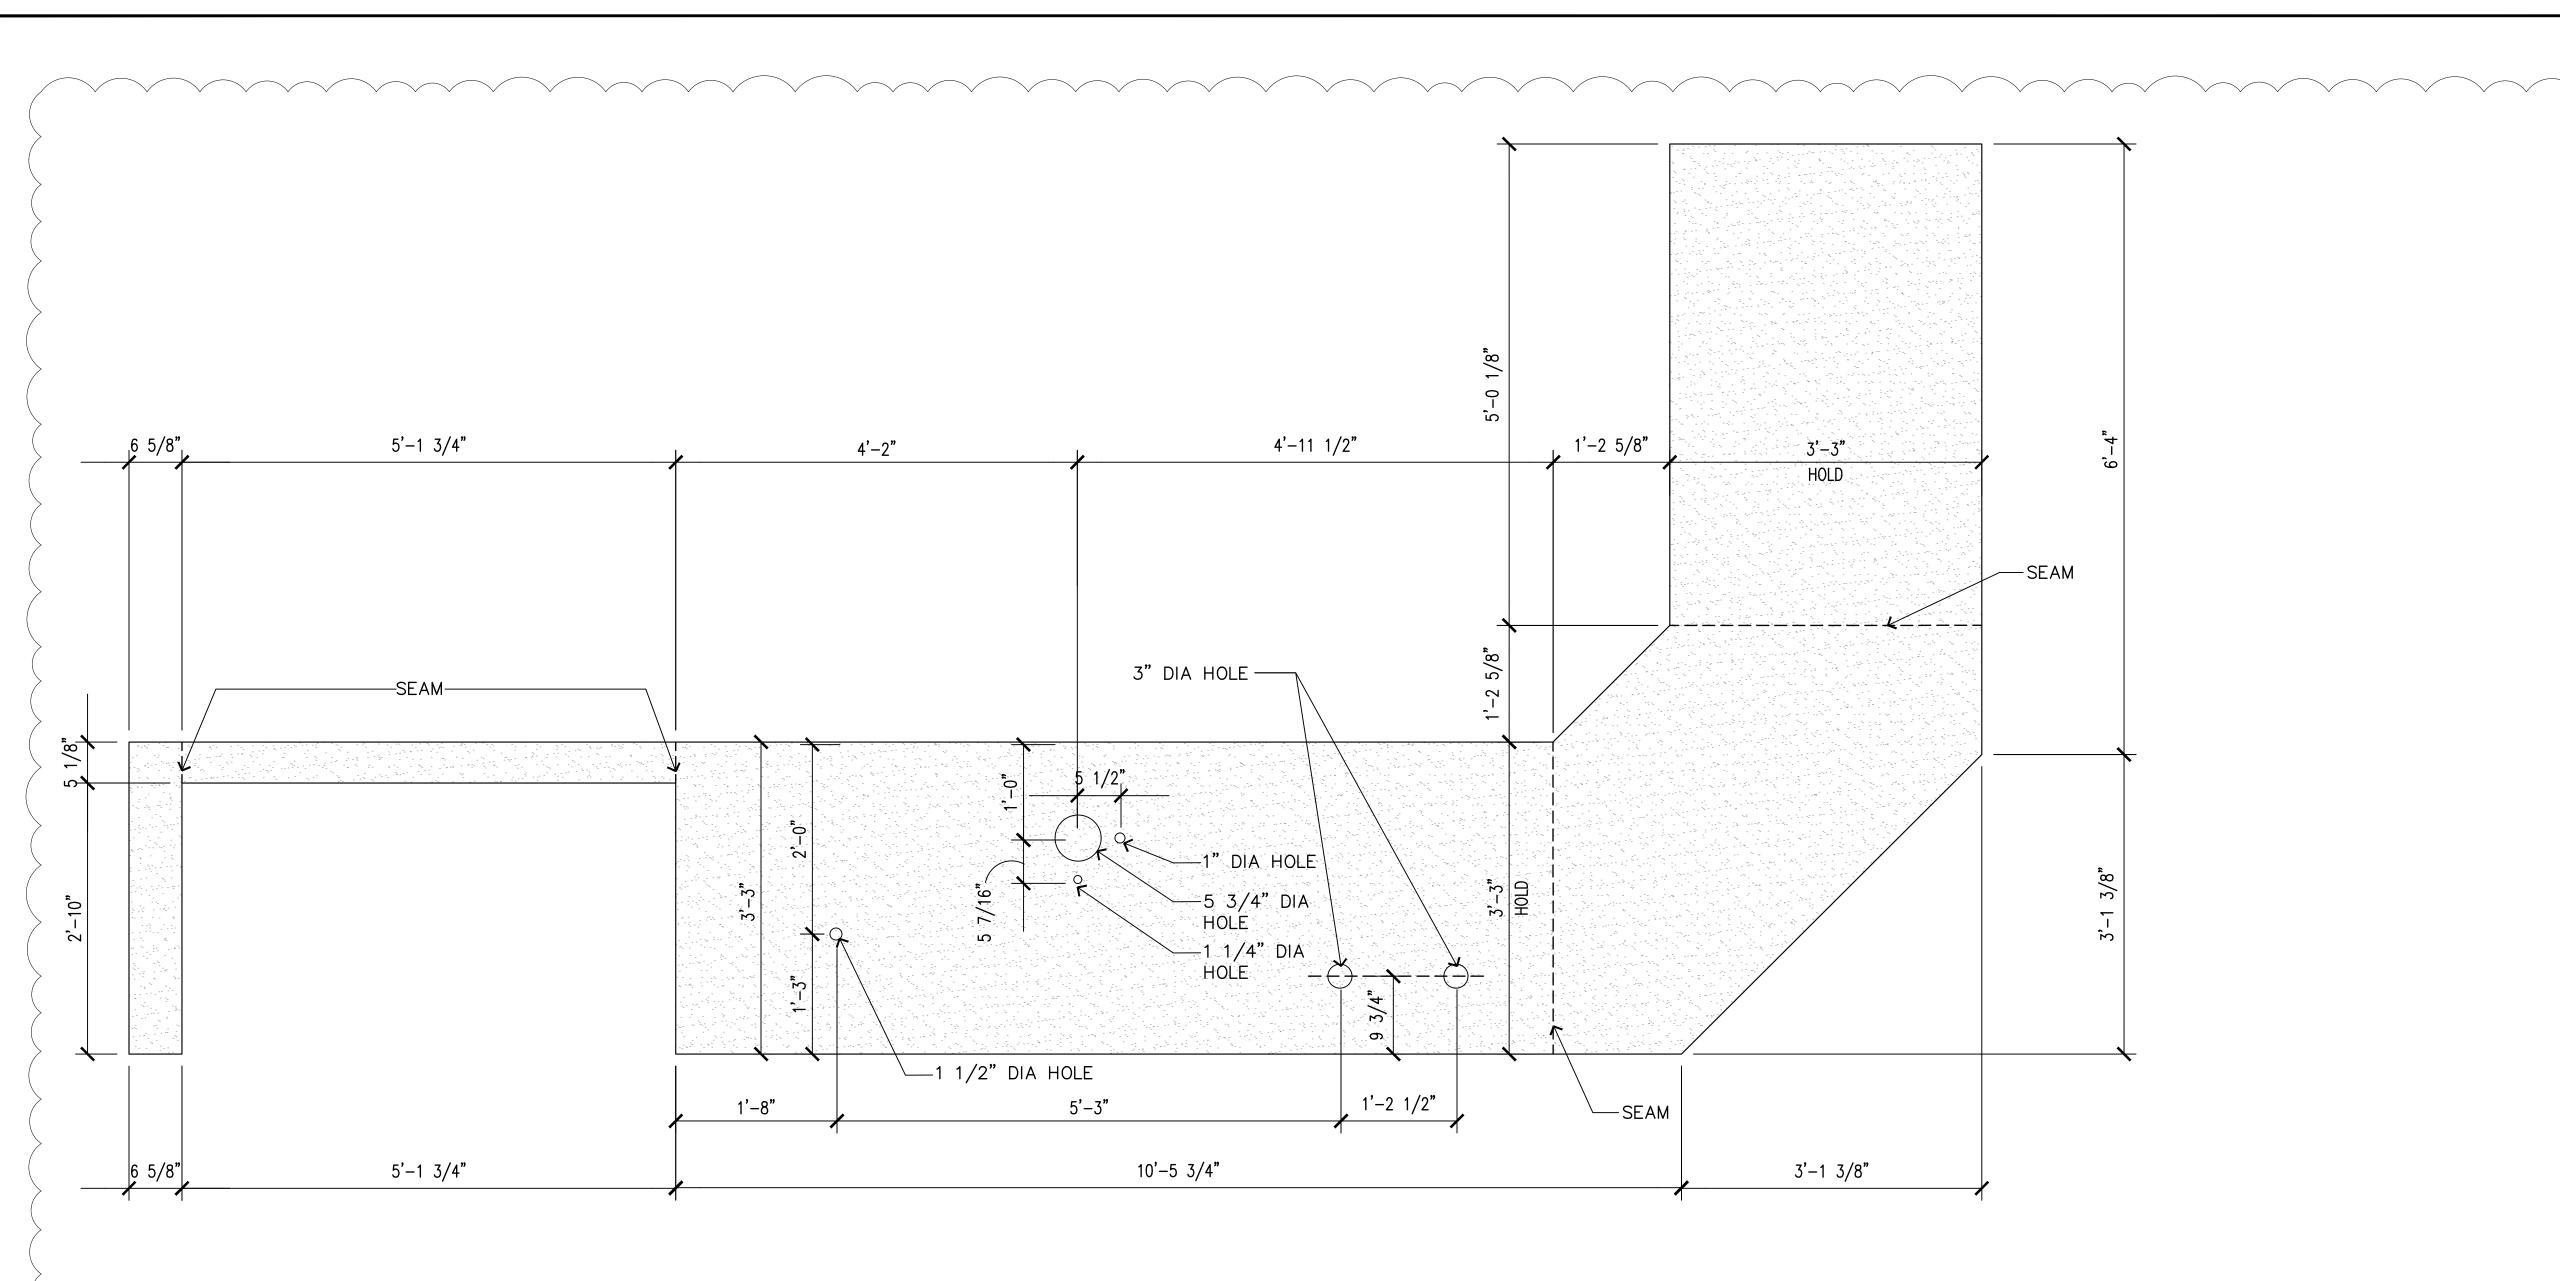
prosecuted. General Contractor to verify all conditions and dimensions at the premises. Discrepancies shall be reported to the Architect prior to the commencement of any work.

Professional Seal:




LIC.# : 22005563 EXP. DATE : 10/02/25 Drawing Description:

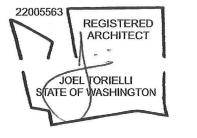Workroom Elevations




Enlarged Cafe Sales Countertop Plan
SCALE: 1" = 1'-0"

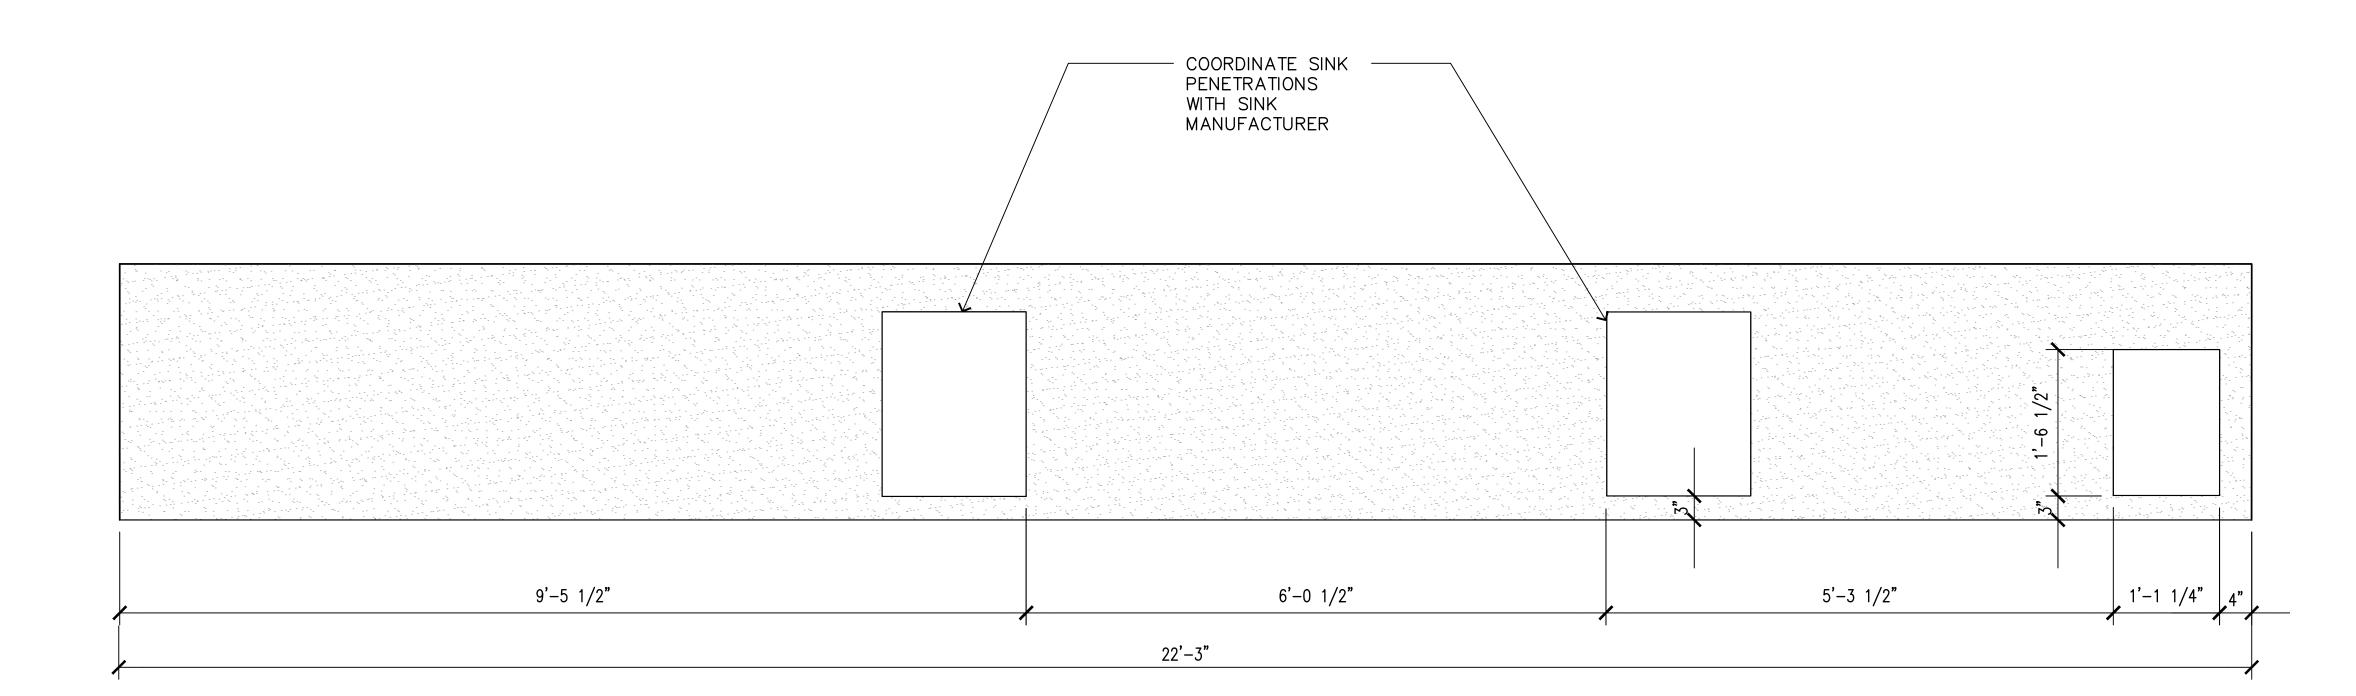

Enlarged Cafe Sales Countertop Plan
SCALE: 1" = 1'-0"

**BARNES&NOBLE** 

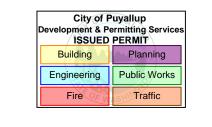

PRCTI20250011

PROJECT DESIGNER:



ARCHITECT:

JOEL TORIELLI

422 BOGERT AVE

RIDGEWOOD, NJ 07450

<u>SOUTH HILL MALL</u> 3500 S. MERIDIAN UNIT #800

PUYALLUP, WA 98373

Project Number 33247

Store Number 3507

Revision Log:

Date

Description

No.

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BUILDING DEPARTMENT AND
LANDLORD COMMENTS

ISSUED FOR CONSTRUCTION


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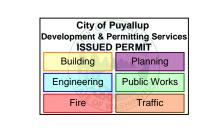


EXP. DATE : 10/02/25

Drawing Description:

Enlarged Countertop Penetration Plan

Drawing Number:

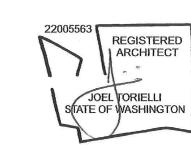

PRCTI20250011

PROJECT DESIGNER:



ARCHITECT: JOEL TORIELLI 422 BOGERT AVE RIDGEWOOD, NJ 07450

UNIT #800 PUYAL'LUP, WA 98373 Project Number 33247

Store Number 3507

Revision Log: Date Description 12-19-24

02-20-25

05-19-25

Description

ISSUED FOR PERMIT, BID, LANDLORD & CLIENT REVIEW

LANDLORD COMMENTS


15SUED FOR CONSTRUCTION

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Professional Seal:





EXP. DATE : 10/02/25

Drawing Description:

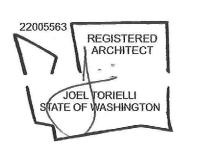Interior Storefront Elevations

Drawing Number:

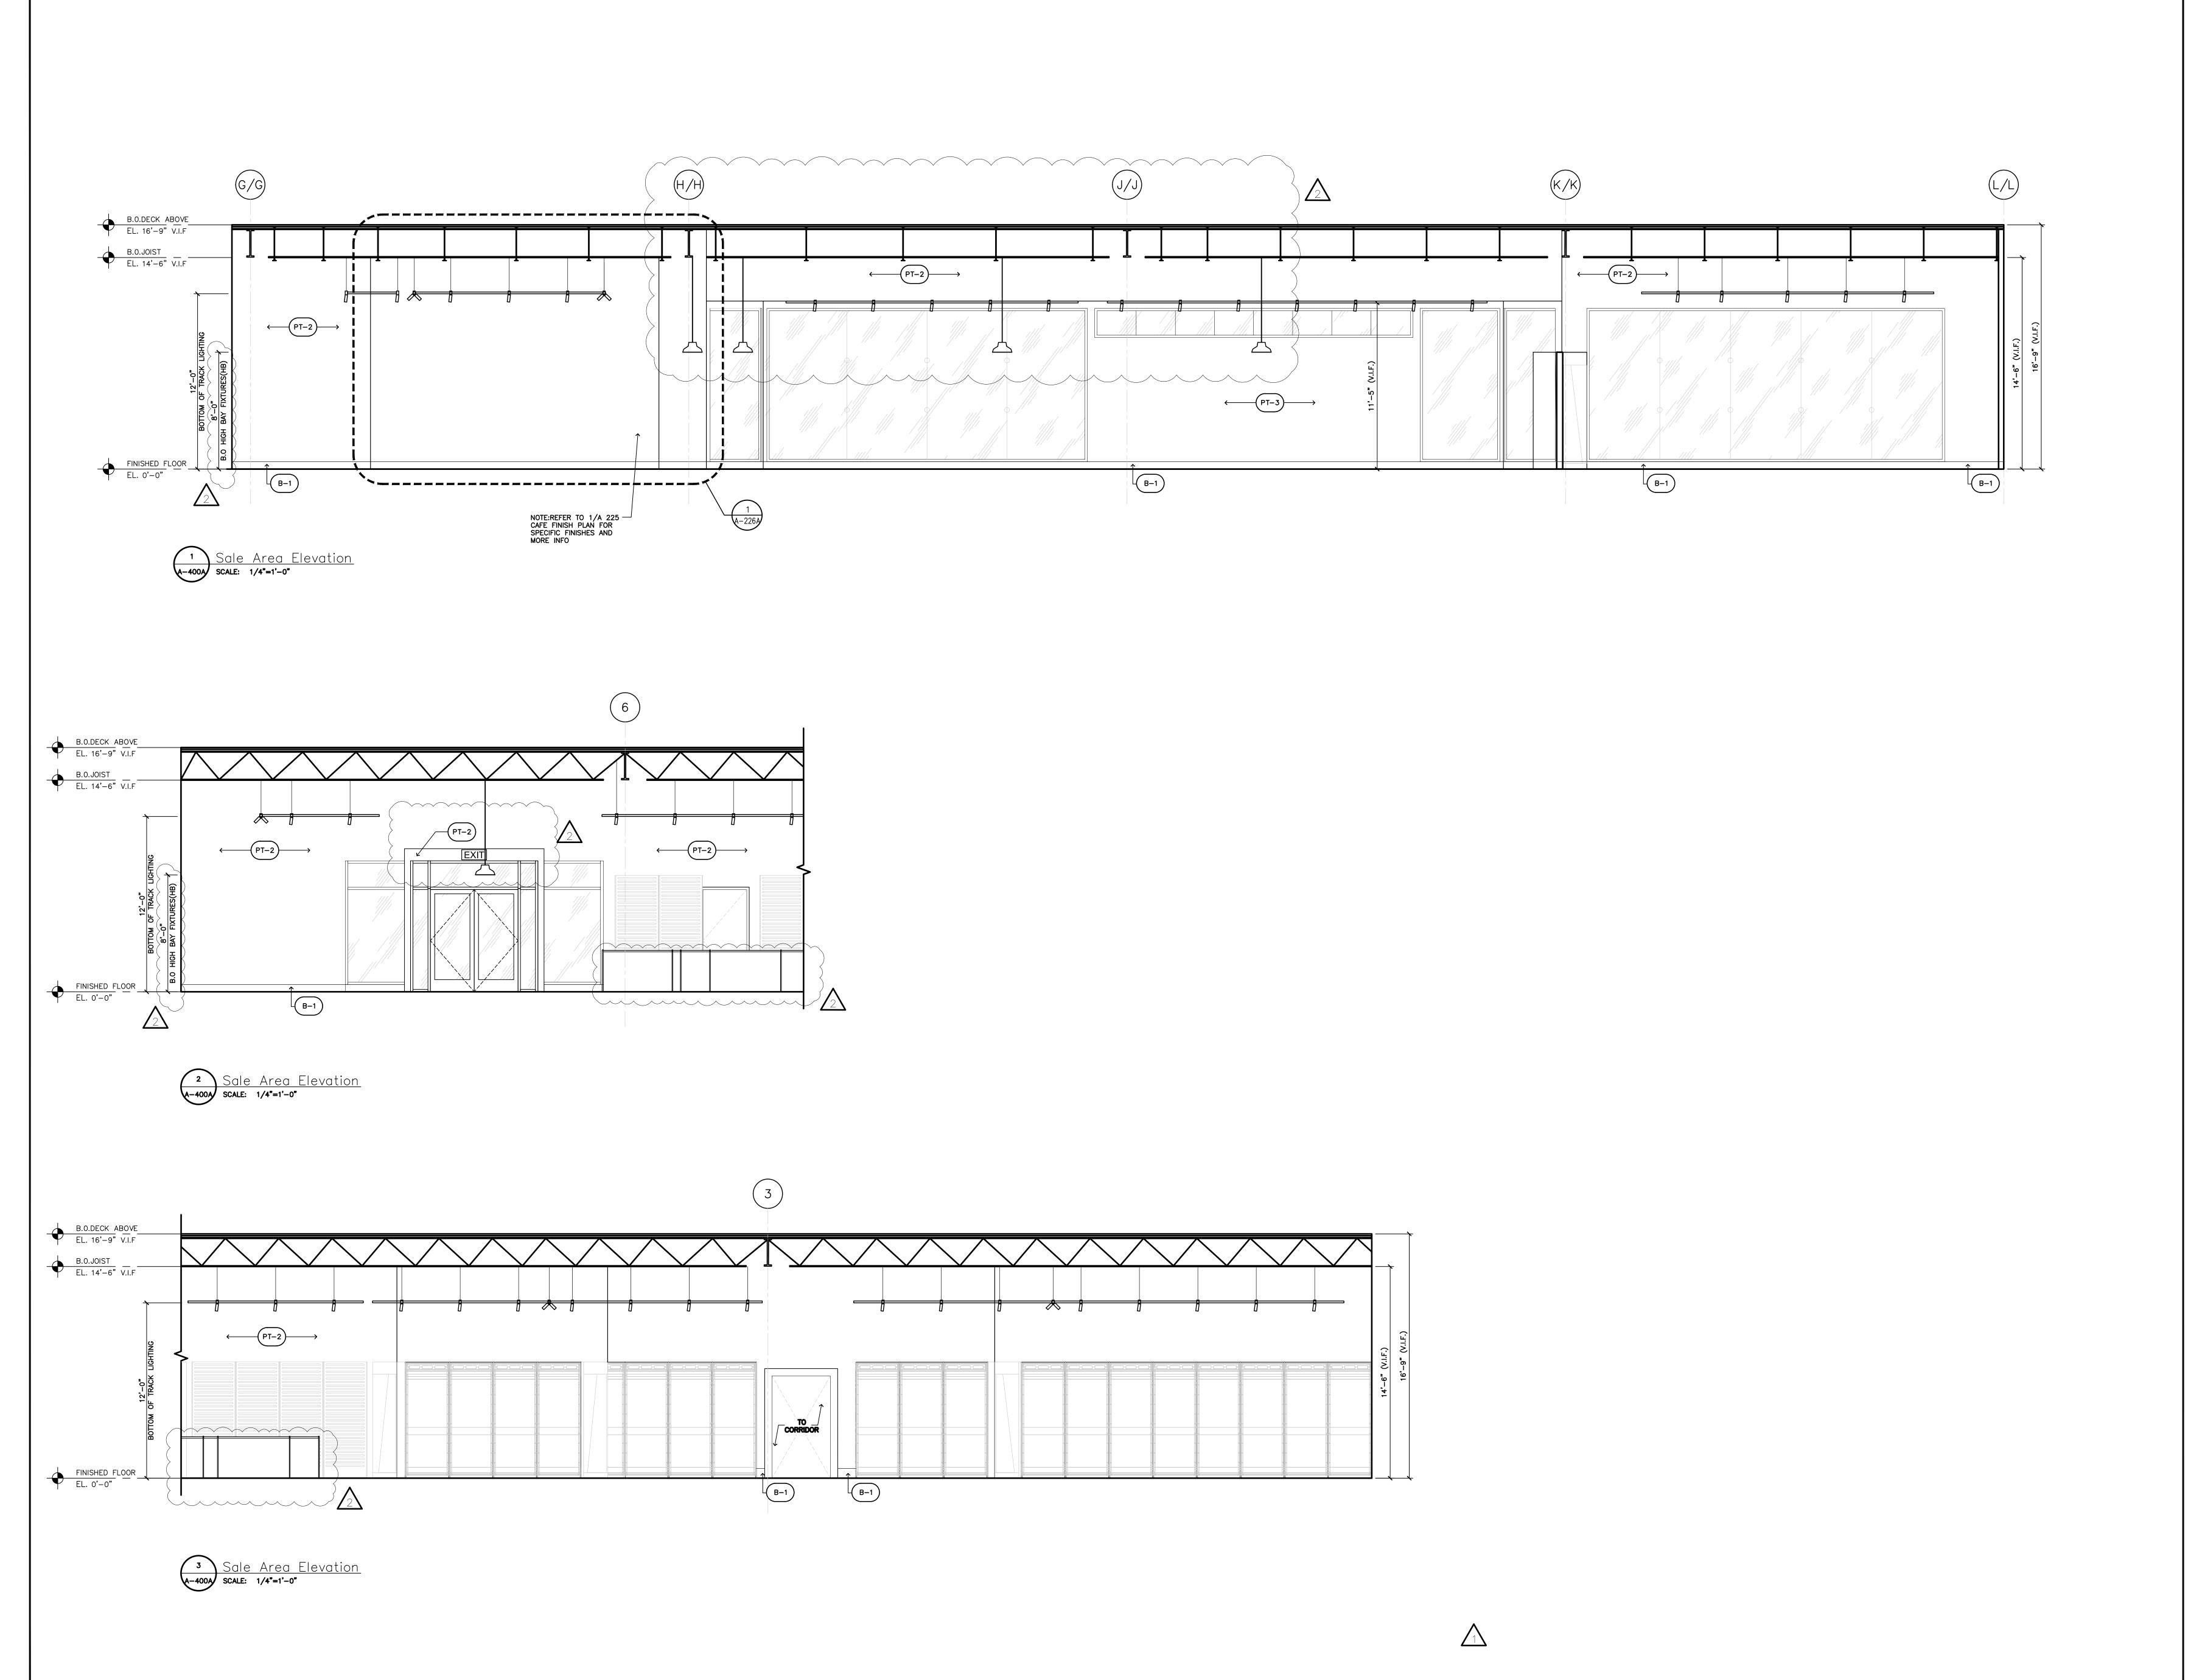

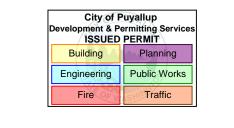

PRCTI20250011

PROJECT DESIGNER:



ARCHITECT:

JOEL TORIELLI

422 BOGERT AVE

RIDGEWOOD, NJ 07450

SOUTH HILL MALL 3500 S. MERIDIAN UNIT #800 PUYALLUP, WA 98373

PUYALLUP, WA 98373

Project Number 33247

Store Number 3507

Revision Log:

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Description

12-19-24
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02-20-25
BUILDING DEPARTMENT AND LANDLORD COMMENTS

05-19-25
ISSUED FOR CONSTRUCTION

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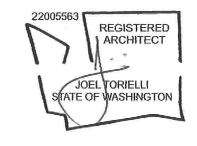
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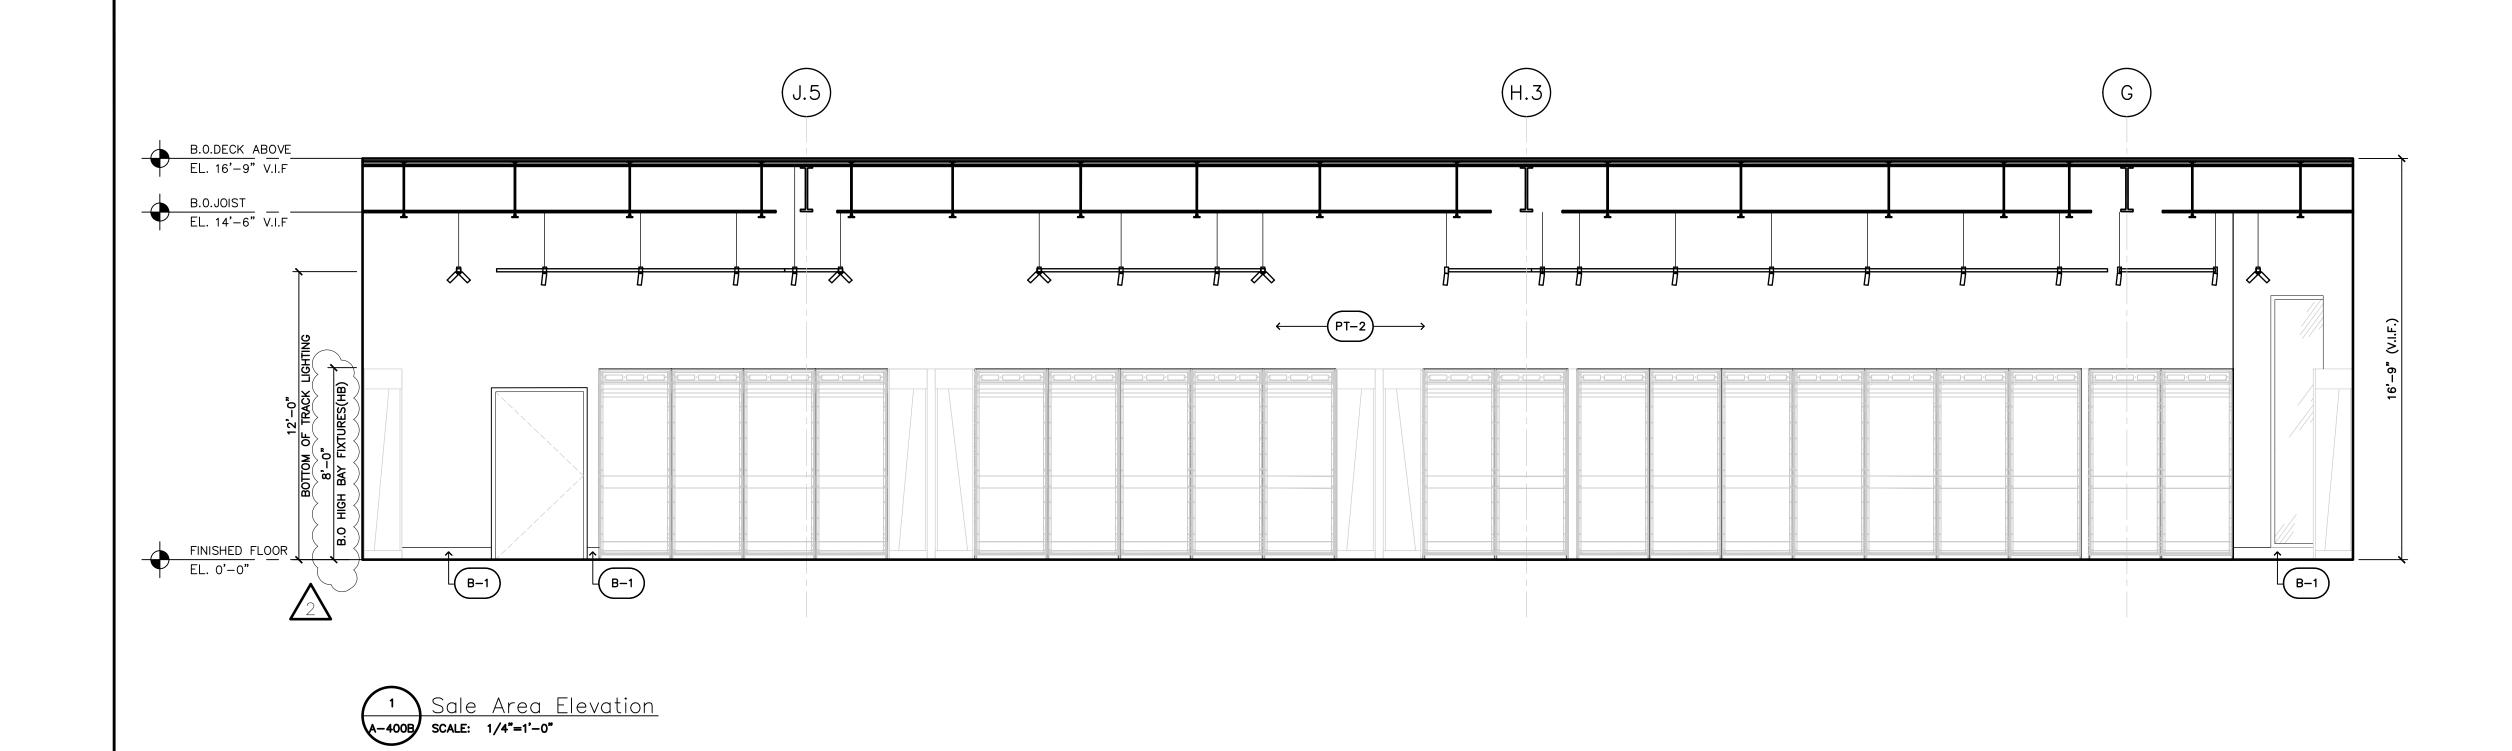
Professional Seal:




LIC.# : 22005563 EXP. DATE : 10/02/25 Drawing Description:

Sales Area Elevations


Drawing Number:
A-400A



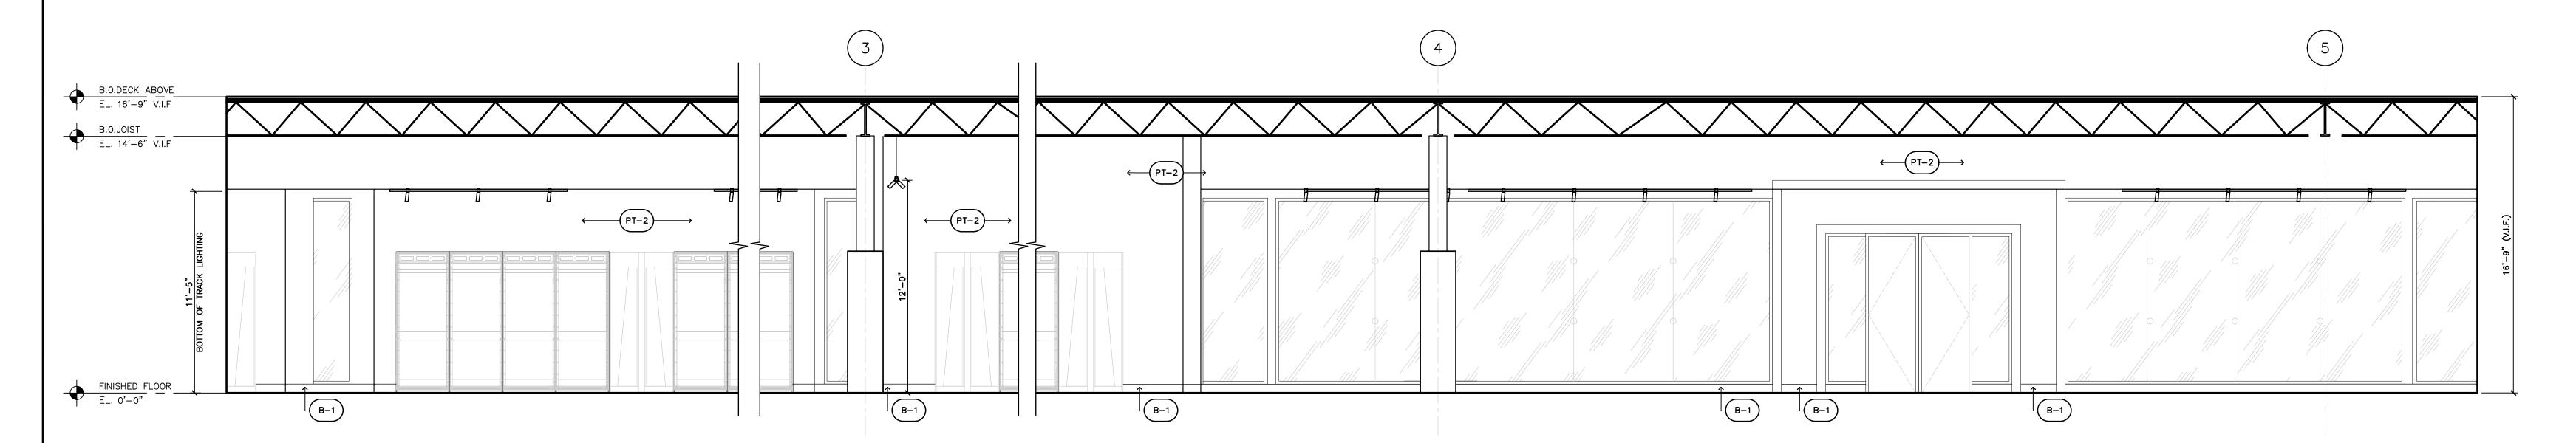

Sale Area Elevation
SCALE: 1/4"=1'-0"

**BARNES**&NOBLE

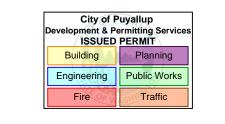

PRCTI20250011

PROJECT DESIGNER:



ARCHITECT:

JOEL TORIELLI

422 BOGERT AVE

RIDGEWOOD, NJ 07450

SOUTH HILL MALL 3500 S. MERIDIAN UNIT #800

PUYALLUP, WA 98373

Project Number 33247

Store Number 3507

Revision Log:

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Description

No.

ISSUED FOR PERMIT, BID, LANDLORD & CLIENT REVIEW

Description

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Description

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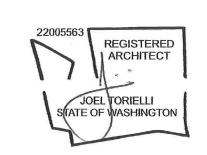
Desc

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General Contractor to verify all conditions and dimensions at the

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Professional Seal:




LIC.# : 22005563 EXP. DATE : 10/02/25


Drawing Description:

Sales Area Elevations

Drawing Number:
A-400B

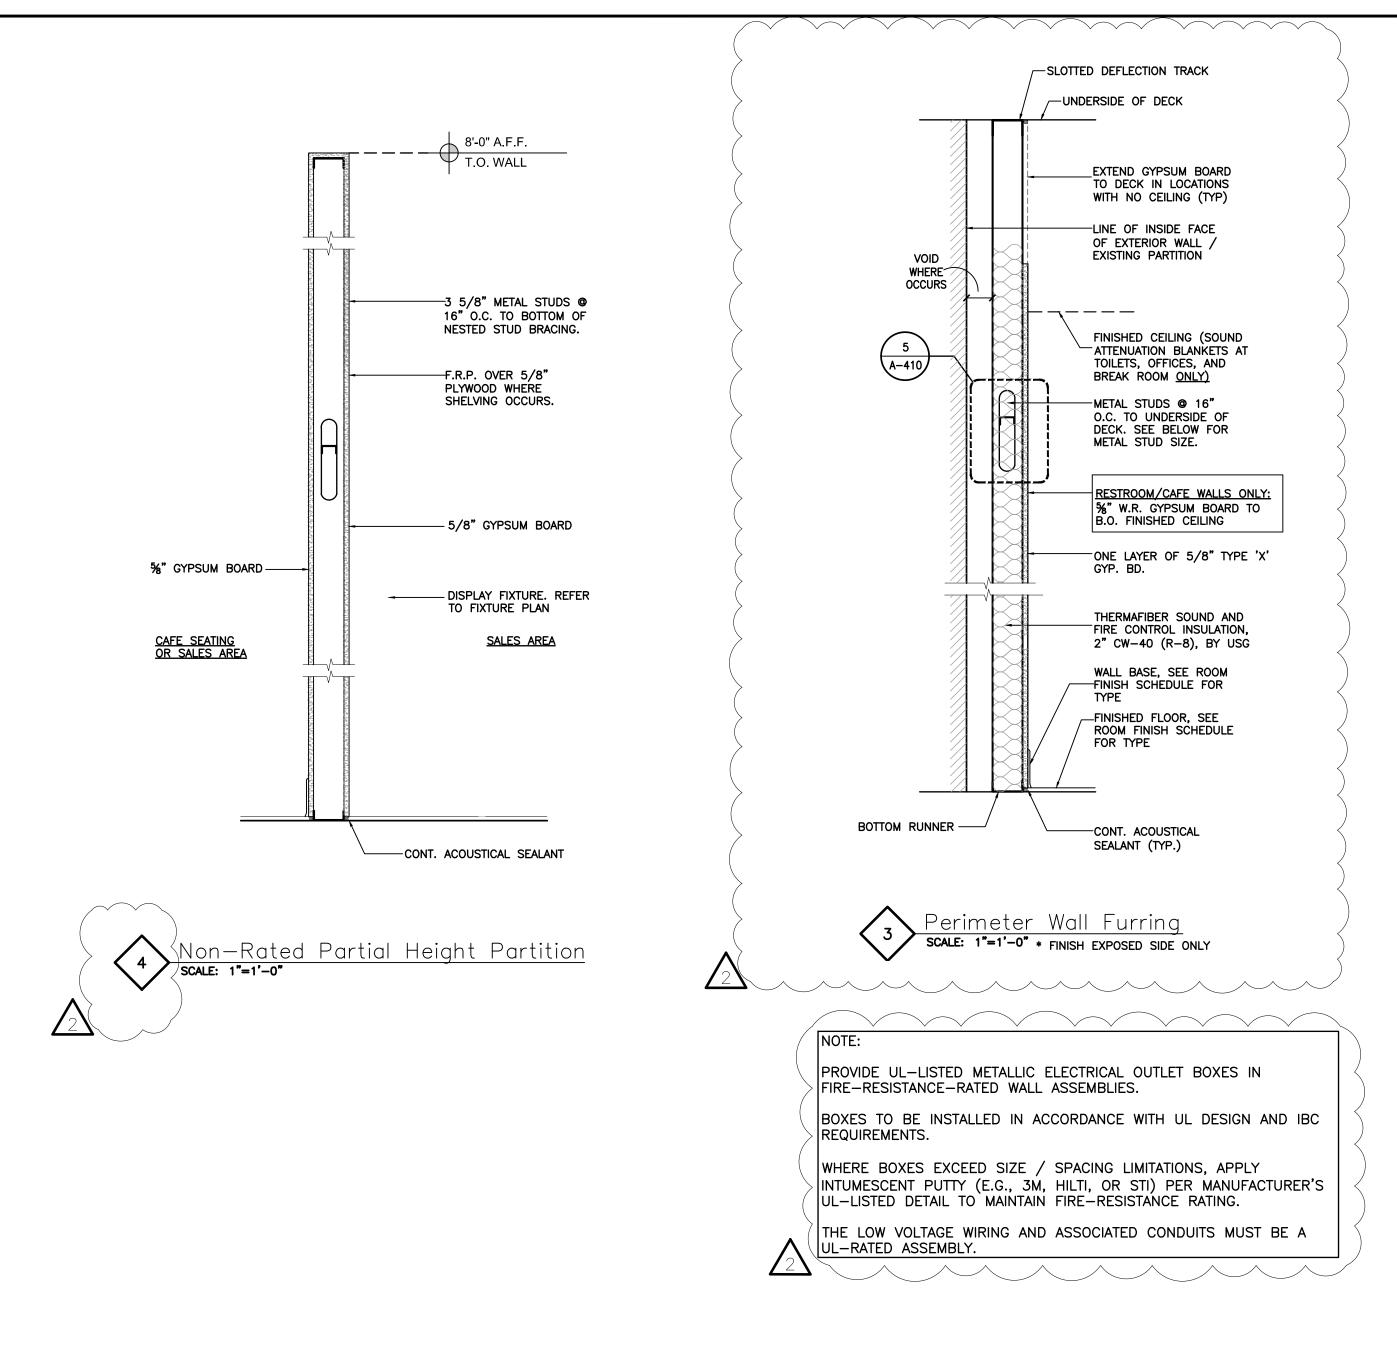

NOTE SEE STRUCTURAL DRAWINGS FOR FRAMING DETAILS AND SIZING

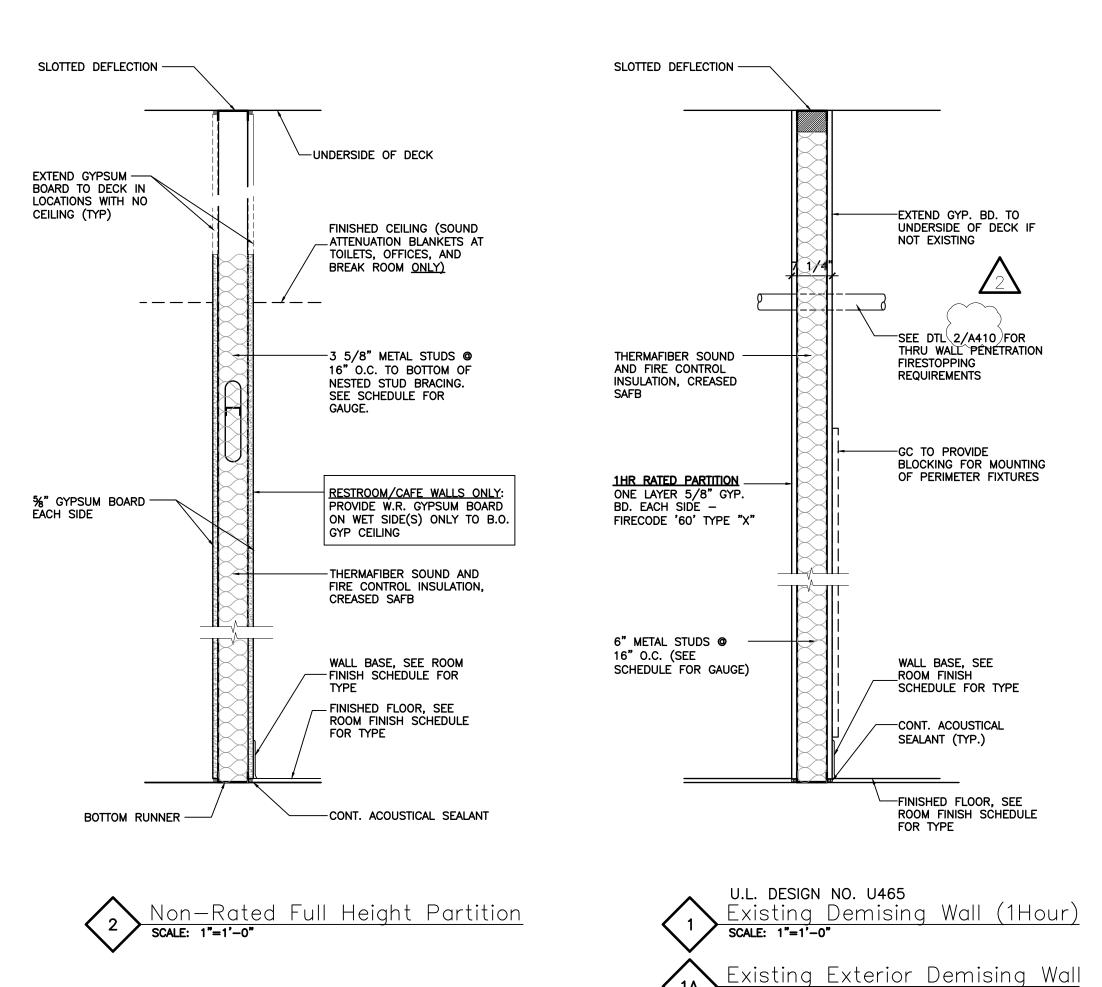

- PROVIDE %" WATER RESISTANT GYP. BD AT JANITOR'S CLOSET, DRINKING FOUNTAIN, KITCHEN AND ALL TOILET
- \*\* SEE ELEVATIONS FOR ALL FINISHES. COLOR AND TEXTURE TBD. SEE SCHEDULE FOR MORE INFORMATION.
- \*\*\* FINISH EXPOSED SIDE ONLY

PARTITION NOTES

ALL RATED PARTITIONS SHALL BE CONSTRUCTED TO THE UNDERSIDE OF THE STRUCTURAL FLOOR OR ROOF ABOVE WITH FIRESTOPPING AS PER CODE

. PROVIDE WATER RESISTANT GYPSUM BOARD IN ALL BATHROOMS AND JANITOR'S CLOSET FOR WALL AND CEILING CONSTRUCTION. . ALL RATED ASSEMBLIES MUST COMPLY WITH U.L. SPECIFICATIONS FOR 4. FOLLOW MANUFACTURER'S

REQUIREMENTS.

RECOMMENDATIONS AND ALL APPLICABLE CODES FOR LIMITING HEIGHT CRITERIA OF

DRYWALL PARTITIONS. 5. SIZE, STYLE, AND GAUGE OF ALL STUDS SHALL BE COORDINATED AND VERIFIED WITH MANUFACTURER'S RECOMMENDATIONS FOR LOADS AND LIMITING HEIGHTS (ALL

METAL STUDS TO BE MIN. 20 GAUGE). 6. BRACE PARTITIONS TO UNDERSIDE OF STRUCTURE ABOVE. PROVIDE FIRESTOPPING FOR RATED PARTITION TYPES (SEE CONSTRUCTION LEGEND FOR PARTITION TYPES).

STUD NOTES 7. PROVIDE DEFLECTION TRACK AS REQUIRED,

AT ALL FULL HEIGHT PARTITIONS.

8. ALL CELLULOSE LOOSE FILL INSULATION

SHALL HAVE A SMOKE-DEVELOPED INDEX

NOT TO EXCEED 450 (AND A FLAME SPREAD RATING NOT TO EXCEED 25 IF

- "e" WEB STIFFENERS REQUIRED AT ENDS.
- STUD GAUGE MAY VARY PER WALL TYPE DEPENDING ON THE ACTUAL HEIGHT AND SHEATHING TYPE REQUIRED.
- WEB-HEIGHT TO THICKNESS RATIO EXCEEDS 200. WEB STIFFENERS ARE REQUIRED AT ALL SUPPORT POINTS AND CONCENTRATED LOADS.
- 3. 5 PSF (POUNDS PER SQUARE FOOT), 7.5 PSF AND 10 PSF LOADS HAVE NOT BEEN REDUCED FOR STRENGTH DEFLECTION CHECKS, FULL LATERAL LOADS ARE
- LIMITING HEIGHTS ARE BASED ON PROPERLY FASTENED SHEATHING ON BOTH FLANGES OVER THE FULL HEIGHT OF THE STUD.
- 5. LIMITING HEIGHTS ARE BASED ON STEEL PROPERTIES ONLY (NON-COMPOSITE).
- 6. WEB CRIPPLING CHECK BASED ON 1 INCH END BEARING. WHERE LIMITING HEIGHTS ARE FOLLOWED BY "e", WEB STIFFENERS ARE REQUIRED.
- 7. ALLOWABLE MOMENT IS THE LESSER OF Mal AND Mad. STUD DISTORTIONAL
- BUCKLING BASED ON AN ASSUMED  $K\emptyset = 0$ .
- 8. REFER TO SPECIFICATIONS FOR DEFLECTION LIMIT.


## PARTITION NOTES

- 1. ALL METAL STUDS TO CONFORM TO LOCAL BUILDING CODES.
- 2. ALL STUD WALLS AND PARTITIONS REQUIRE GYP. BOARD ON BOTH SIDES FOR THE FULL HEIGHT OF THE STUDS UNLESS SPECIFICALLY DETAILED OTHERWISE.
- 3. ALL SUSPENDED WALLS SHALL HAVE GYP. BOARD WHICH EXTENDS 6" ABOVE THE SUSPENDED CEILING UNLESS SHOWN AND/OR NOTED OTHERWISE BY THE ARCHITECT.
- 4. ALL STUD WALLS AND PARTITIONS SHALL HAVE CONTINUOUS LINES OF BRIDGING SPACED AT 4'-0" MAXIMUM ON CENTER. THE BRIDGING SHALL BE SECURELY FASTENED TO THE STUDS WITH EITHER SCREWS OR WELDS.
- 5. ALL STUDS SHALL BE "CEE" STUDS WITH FLANGE STIFFENERS.
- 6. THE MATERIALS AND DETAILS SHOWN ARE FOR TYP. INSTALLATIONS, WHERE THE STUD MANUFACTURER'S RECOMMENDATIONS OR LOCAL ORDINANCES ARE MORE RESTRICTIVE, THEY SHALL APPLY.
- 7. G.C. TO INSTALL GREENBOARD (OR EQUAL MOLD—RESISTANT GYP. BD) ON ALL TOILET ROOM, JANITORS CLOSET, OR SIMILAR TYPE OF WETROOM AREAS.
- 8. TYPICAL FASTENER:

PER CONNECTION

AS TRACKS, U.O.N.

- A. STEEL STUDS TO STEEL STUDS OR TRACKS: • 25/20 GAUGE - #8 - 18 X 1/2" TEKS WITH PHILIPS PAN HEAD - MIN. 2 PER CONNECTION • 18/16 GAUGE - #10 - 16 X 3/4" TEKS WITH PHILIPS PAN HEAD - MIN. 3
- B. STEEL STUDS OR TRACKS TO WOOD PURLINS, GIRDERS AND BEAMS: • #14 - 10 X 1-1/2" H.W.H. TYPE "S" METAL-TO-WOOD TEKS AT 12" O.C., 2" FROM EACH END
- C. STEEL STUDS OR TRACKS TO STRUCTURAL STEEL (TUBE/WIDE FLANGE COL'S, BM'S, GIRDERS, ETC.): • 0.145" DIA. HILTI X-EDNI FASTENERS, 5/8" MIN, LENGTH AND MIN. OF 2 PER CONNECTION, OR 2 ROWS AT 16" O.C. FOR CONTINUOUS APPLICATIONS SUCH
- D. PLYWOOD TO STEEL STUDS: •  $\#10 - 24 \times 1 - 1/4$ " TEKS/3 (PLYMETALTEKS) WITH THIN WAFER HEAD - 24"
- O.C. FILED, 12" O.C. PERIMETER E. GYPSUM BOARD TO STEEL STUDS: #7 X 1-1/4" HI-LOW TYPE "S" BUGLE HEAD SCREWS FOR 3/8" TO 5/8"
- GYPSUM BOARD TO 25 GAUGE OR 20 GAUGE STUDS • #6 X 1-1/4" TYPE S-12 BUGLE HEAD SCREWS FOR 3/8" TO 5/8" TO 18 GAUGE OR 16 GAUGE STUDS OR TRACKS
- FIELD 12" O.C. CEILINGS, 24" O.C. WALLS BUTT JOINTS 12" O.C.
- F. STEEL STUDS OR TRACKS TO CONCRETE: • 0.145" DIA. HILTI X-DNI FASTENER, 1" MIN. LENGTH, 2 ROWS AT 16" O.C.

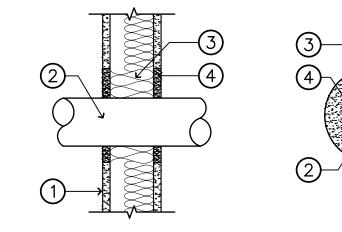

SECTION A-A 1 WALL ASSEMBLY - 1 HOUR FIRE RESISTANT GYPSUM PANEL WALL ASSEMBLY. (UL ĎEŠIGŇ NŎ. Ŭ465)

A-410 SCALE: N.T.S.

- NOMINAL 4"Ø OR SMALLER SCHEDULE 10 OR HEAVIER STEEL PIPE. A MIN. 1/4" TO MAX. 1-1/4" - NOMINAL 4"Ø OR SMALLER CAST OR DUCTILE IRON PIPE. A MIN. 1/4" TO MAX 1-1/4" ANNULAR SPACE BETWEEN PIPE AND PERIPHERY OF OPENING IS REQUIRED - O HOUR T RATING. - NOMINAL 4"Ø OR SMALLER ELECTRICAL METALLIC TUBING OR STEEL CONDUIT. A MIN. 1/4" TO MAX 1-1/4" ANNULAR SPACE BETWEEN PIPE AND PERIPHERY OF OPENING IS REQUIRED. A 1/2" OR SMALLER ELECTRICAL METALLIC TUBING OR STEEL CONDUIT HAS 1 HOUR RATING; LARGER THAN 1/2" HAS 0 HOUR T RATING.

- NOMINAL 3/4"Ø OR SMALLER TYPE L OR HEAVIER COPPER TUBING. A MIN. 1/4" TO MAX 1-13/16" ANNULAR SPACE BETWEEN PIPE AND PERIPHERY OF OPENING IS REQUIRED - 0 HOUR T RATING. - NOMINAL 4"Ø OR SMALLER TYPE L OR HEAVIER COPPER PIPE. A MIN. 3/8" TO MAX 1-1/4" ANNULAR SPACE BETWEEN PIPE AND PERIPHERY OF OPENING IS REQUIRED - O HOUR T RATING.  $\bigcirc$  FORMING MATERIAL - MINIMUM 2-1/2" SAFING THERMAFIBER SAFING INSULATION WITH MINIMUM DENSITY OF 3.5 PCF - U.L. R-10905 LABEL. FILL, VOID OR CAVITY MATERIAL - MINIMUM 1/2" DEPTH OF FIRECODE COMPOUND INSTALLED ON EACH SIDE OF THE WALL.

> Thru Penetration Firestopping Detail and Notes U.L. Design No. WL-1039

> > Typ. Rated Thru Wall Penetration Detail



Rated Thru Wall Penetration Detail A-410 SCALE: N.T.S.

 $\bigcirc \longrightarrow A$ 

WALL ASSEMBLY - 2 HOUR FIRE RESISTANT GYPSUM PANEL WALL

METALLIC PIPE - NOMINAL 3-1/2" Ø SCHEDULE 10 OR HEAVIER STEEL

FORMING MATERIAL - MINIMUM 1/2" SAFING THERMAFIBER SAFING INSULATION RECESSED FROM BOTH SURFACES TO ACCOMMODATE THE

FILL, VOID OR CAVITY MATERIAL — CAULK— MINIMUM 1/2" DEPTH OF FIRECODE COMPOUND INSTALLED ON EACH SIDE OF THE WALL.

Thru Penetration Firestopping Detail and Notes

U.L. Design No. WL-1064

PIPE. PIPE SHOULD BE CENTERED WITHIN OPENING. A MIN. 3/8" TO MAX

5/8" ANNULAR SPACE BETWEEN PIPE AND PERIPHERY OF OPENING IS

ASSEMBLY, DESIGN NO. U491

**BARNES** & NOBLE



PRCTI20250011

PROJECT DESIGNER:



ARCHITECT: JOEL TORIELLI 422 BOGERT AVE RIDGEWOOD, NJ 07450

SOUTH HILL MALL 3500 S. MERIDIAN


PUYALLUP, WA 98373 Project Number 33247 Store Number 3507

UNIT #800

Revision Log: Description Date 12-19-24 ISSUED FOR PERMIT, BID, LANDLORD & CLIENT REVIEW 02-20-25 BUILDING DEPARTMENT AND LANDLORD COMMENTS 05-19-25 ISSUED FOR CONSTRUCTION

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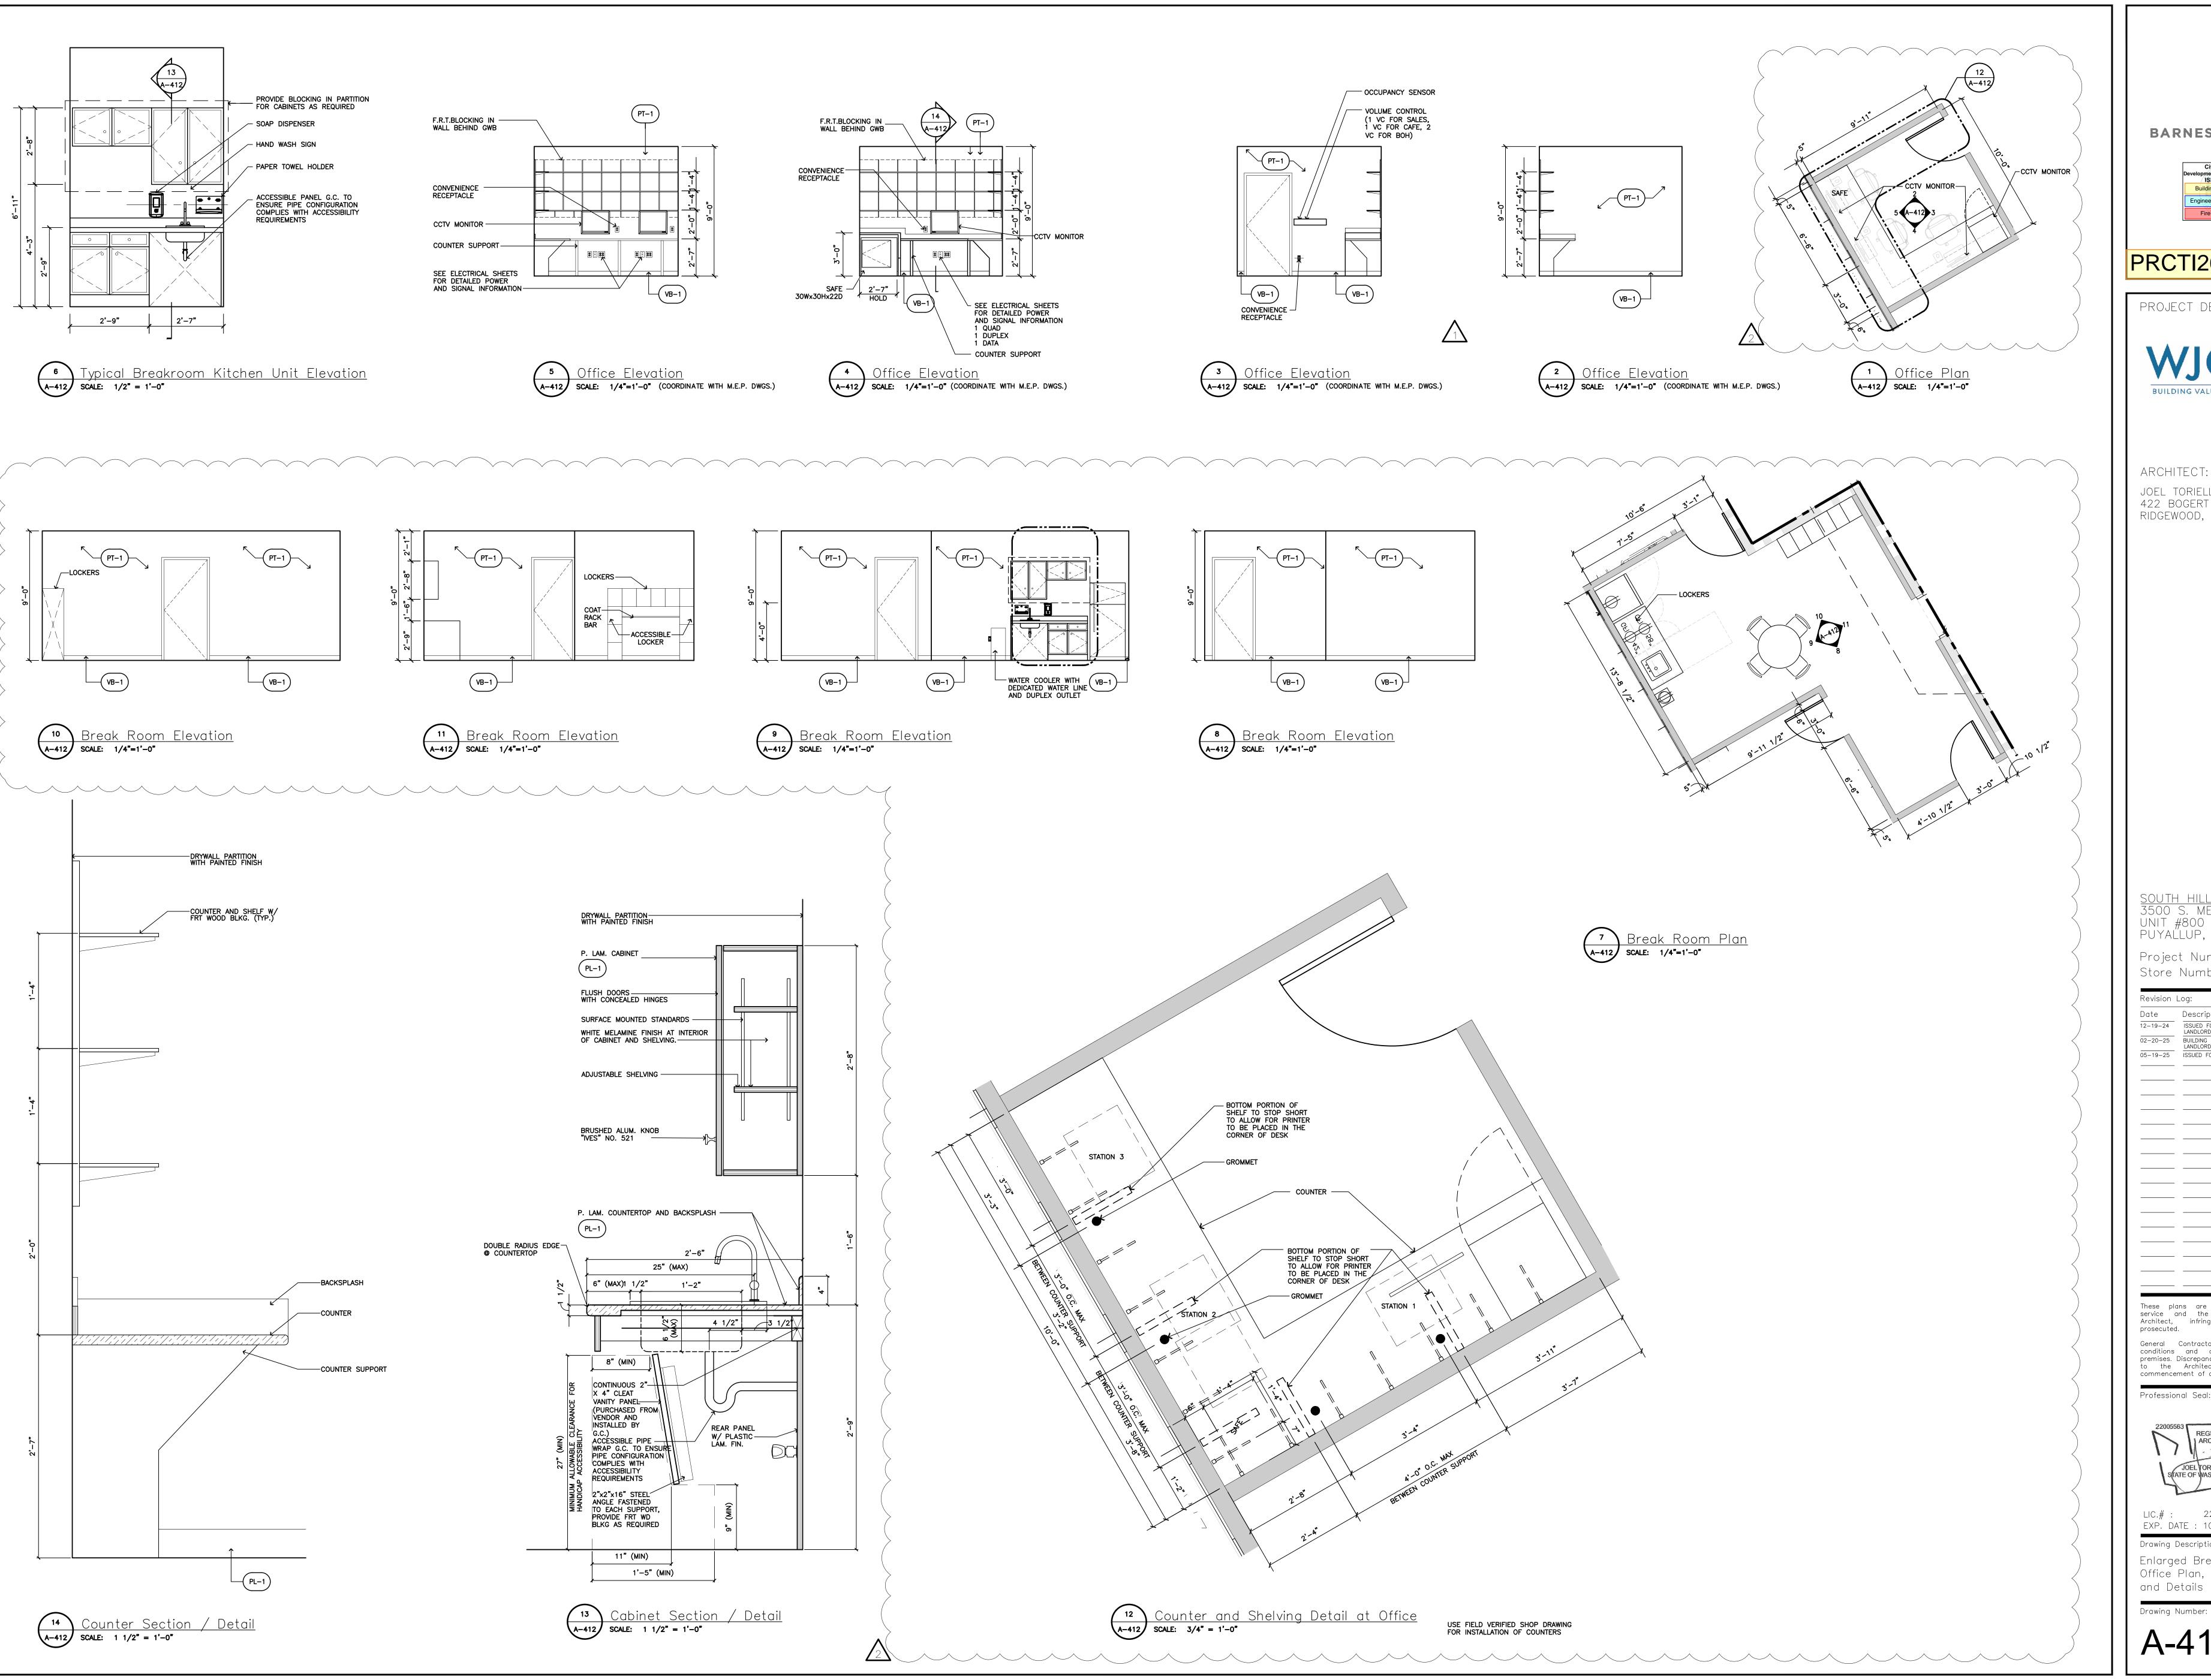
commencement of any work. Professional Seal:

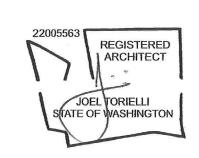


EXP. DATE : 10/02/25

Drawing Description: Partition Types

Drawing Number: A-410



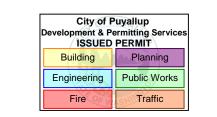

PRCTI20250011

PROJECT DESIGNER:



ARCHITECT: JOEL TORIELLI 422 BOGERT AVE RIDGEWOOD, NJ 07450

PUYALLUP, WA 98373 Project Number 33247 Store Number 3507

Revision Log:

Date Description 12-19-24

02-20-25

05-19-25

Description

ISSUED FOR PERMIT, BID, LANDLORD & CLIENT REVIEW

LANDLORD & CLIENT REVIEW

LANDLORD COMMENTS


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2

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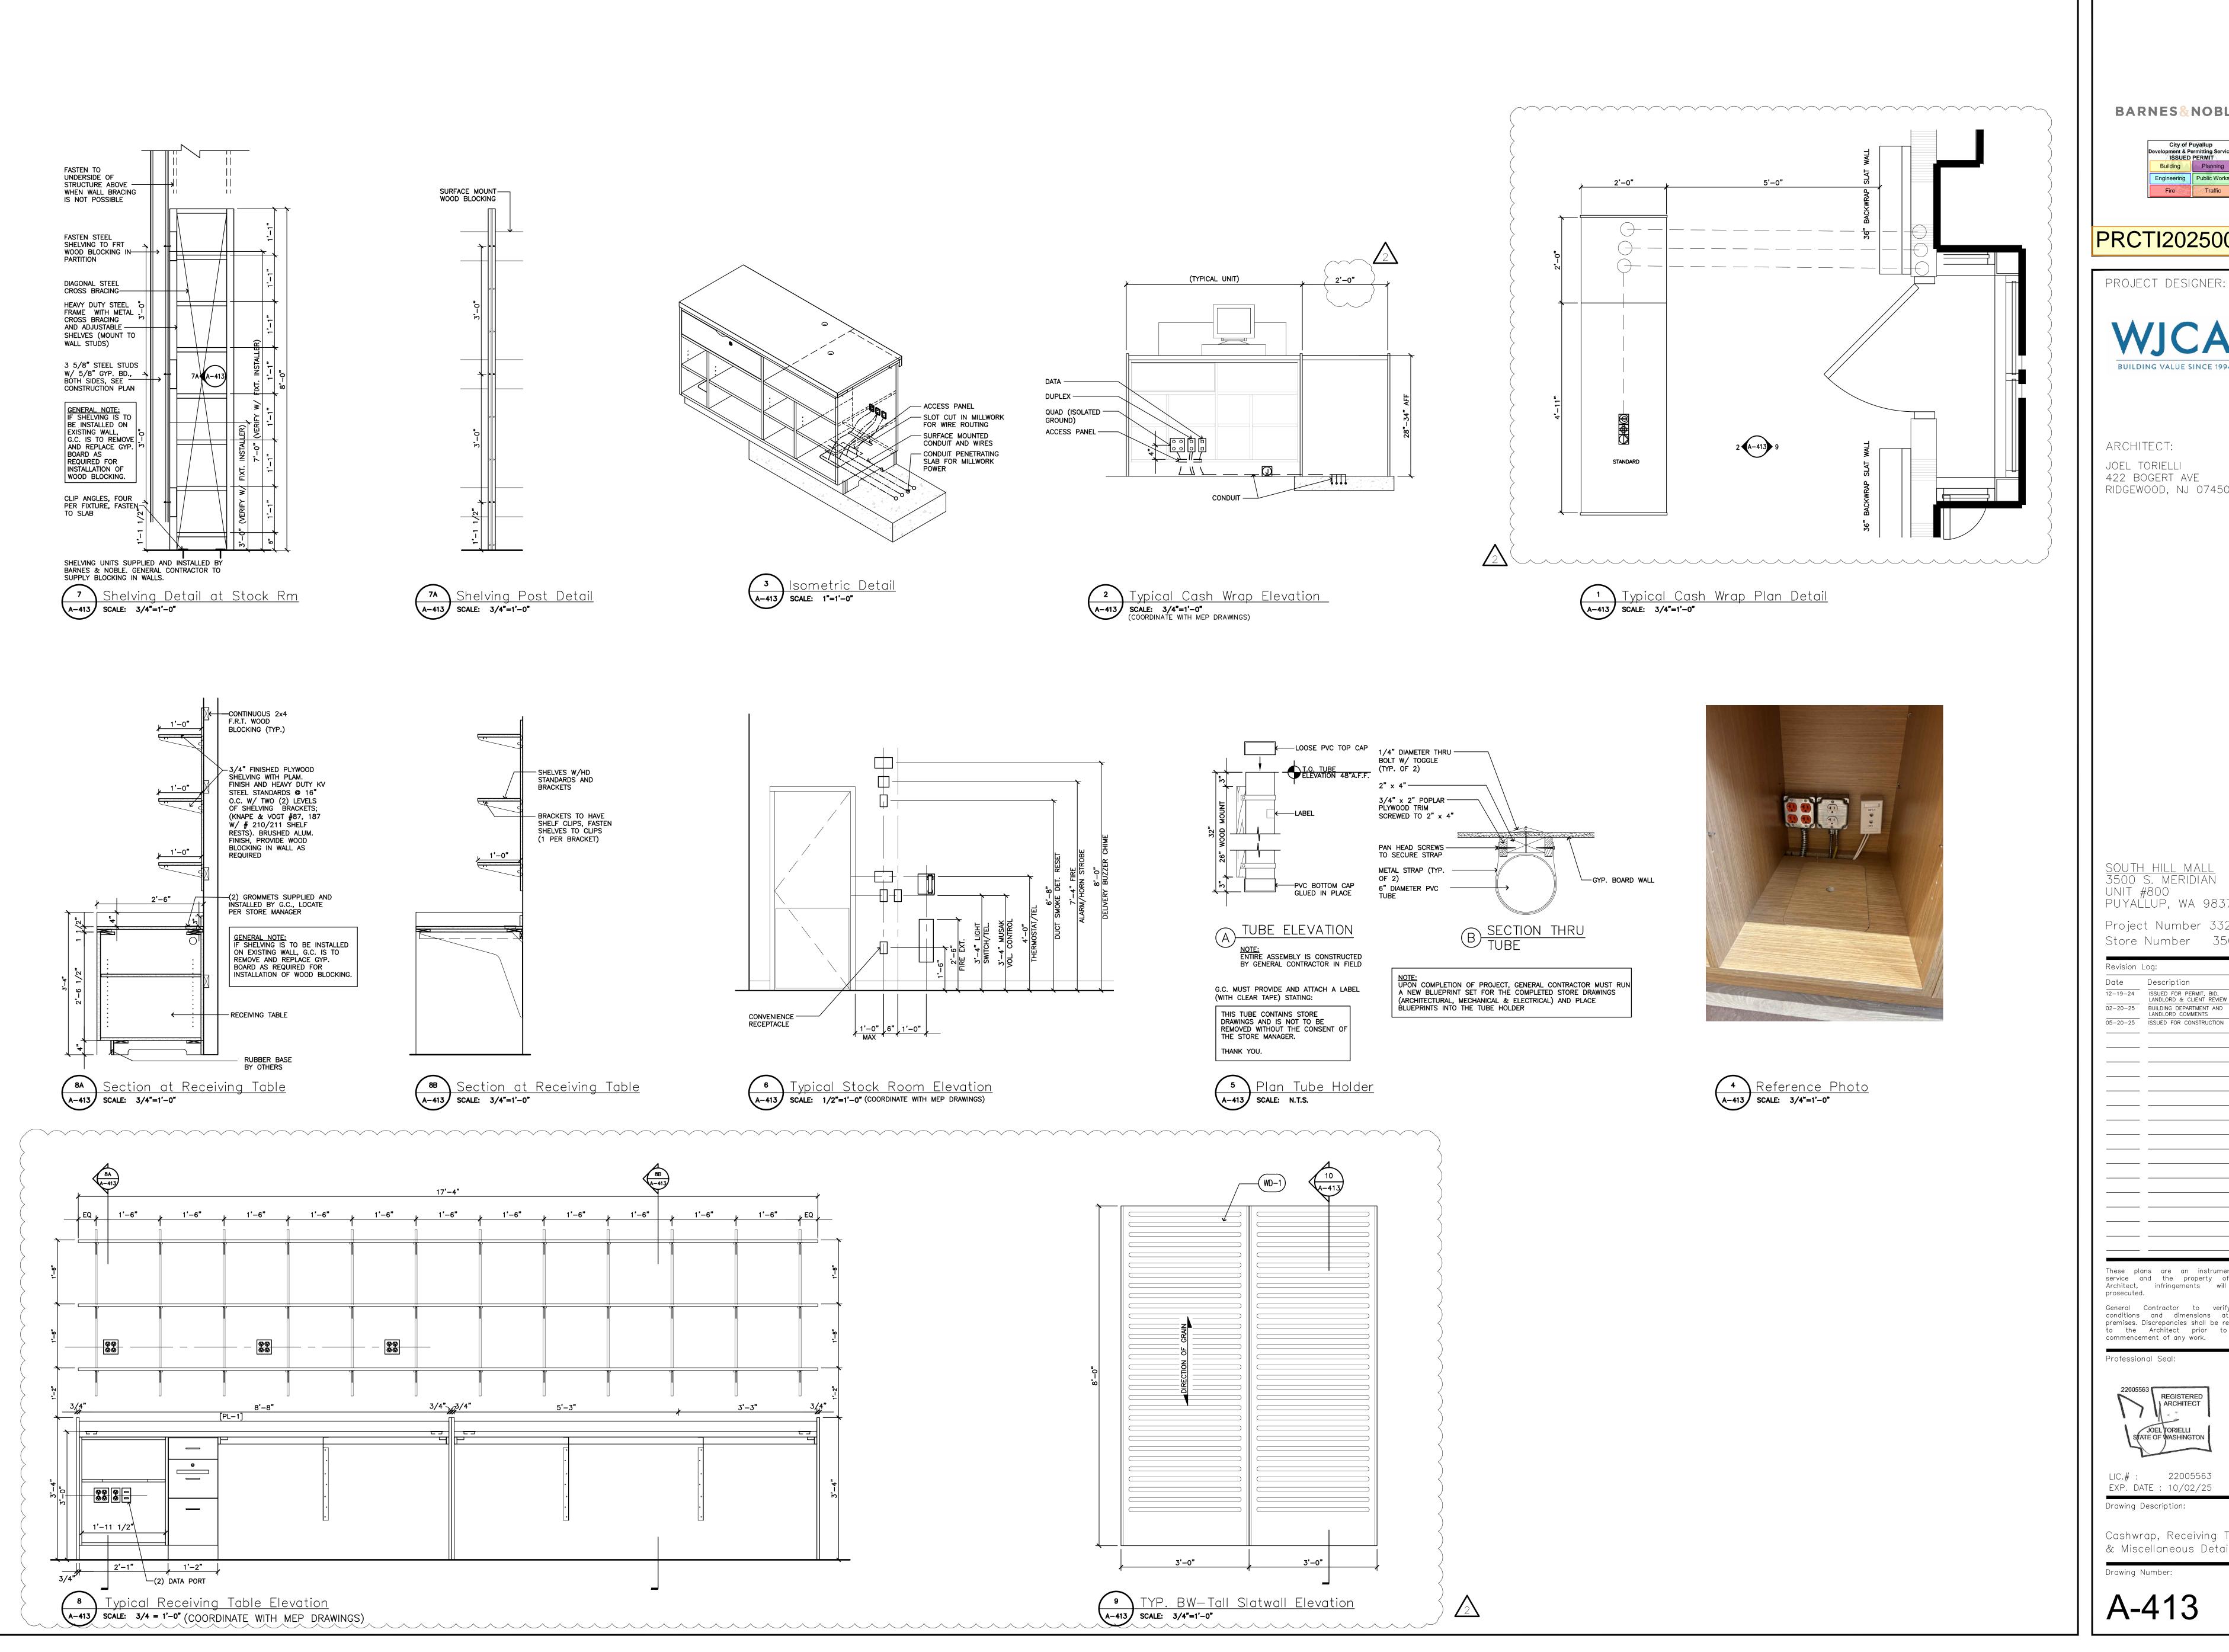
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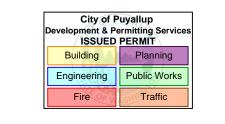


EXP. DATE : 10/02/25

Drawing Description: Enlarged Break Room and Office Plan, Elevations and Details

Drawing Number:

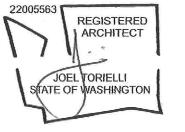



PRCTI20250011



ARCHITECT: JOEL TORIELLI 422 BOGERT AVE RIDGEWOOD, NJ 07450

SOUTH HILL MALL 3500 S. MERIDIAN UNIT #800

PUYAĽLUP, WA 98373 Project Number 33247 Store Number 3507


Revision Log: Date Description

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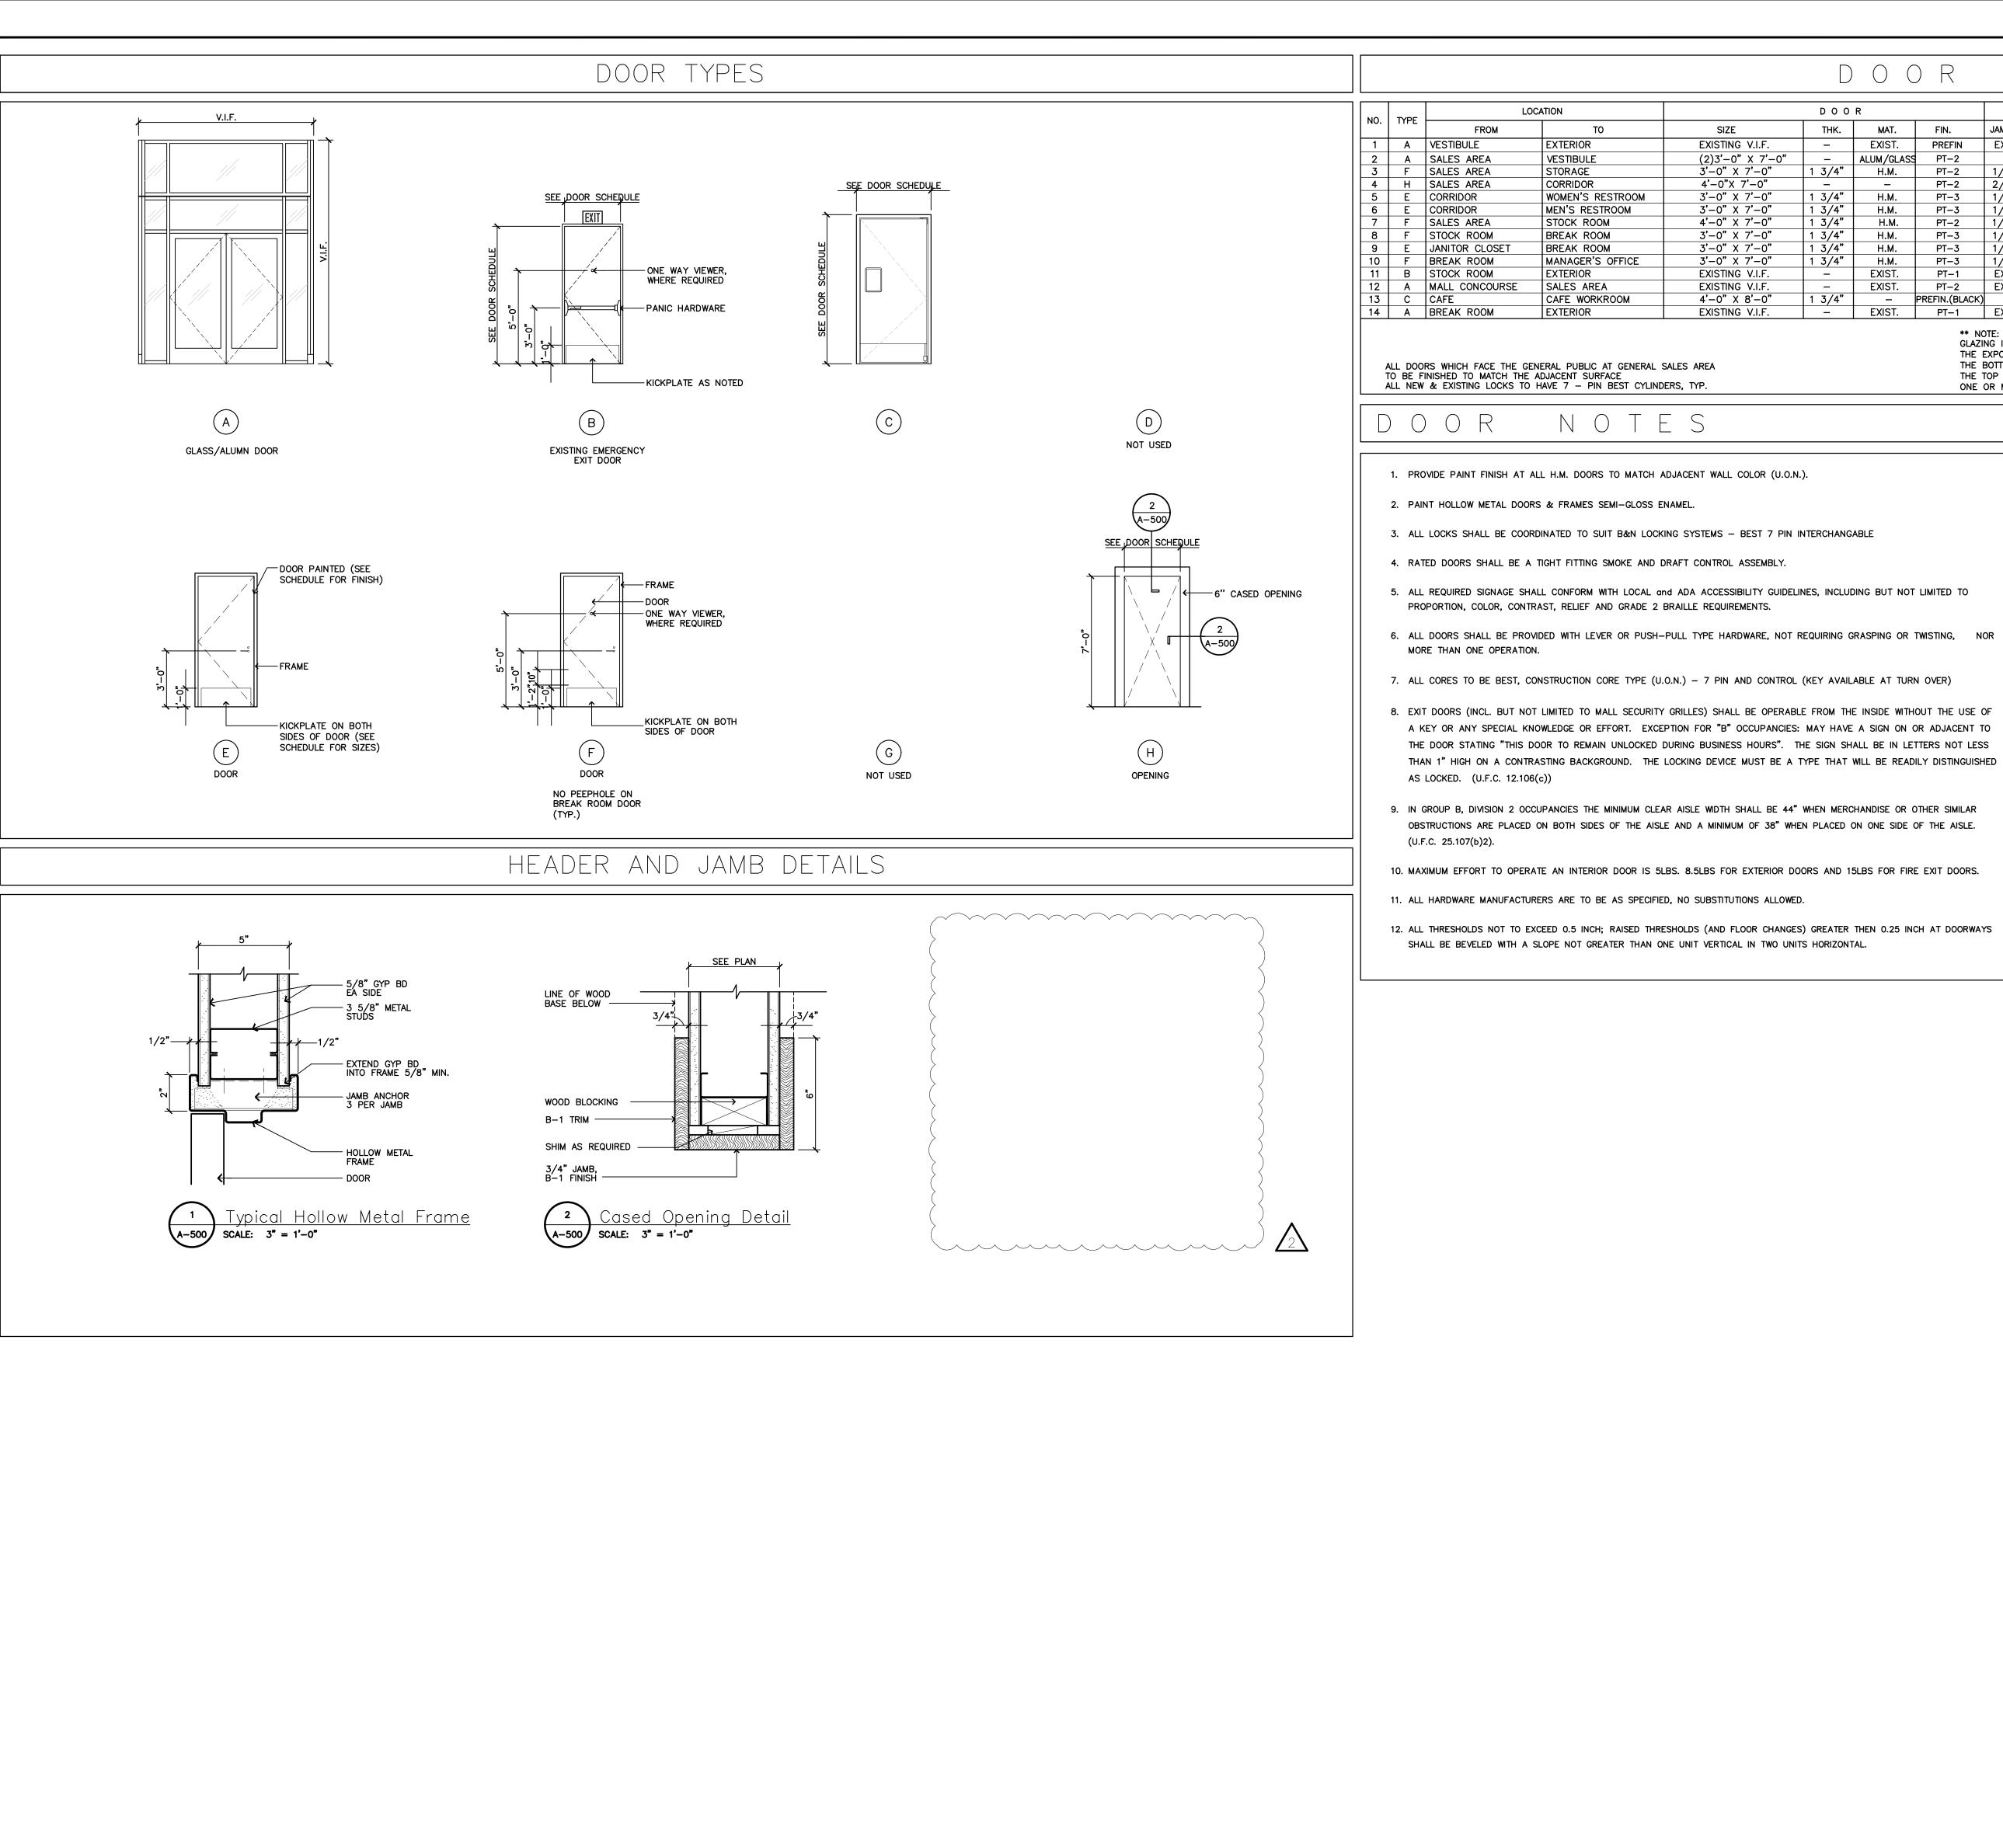
Professional Seal:



EXP. DATE : 10/02/25

Drawing Description:

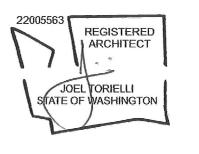Cashwrap, Receiving Table & Miscellaneous Details Drawing Number:



DOORFRAMEHARDWARE GROUP FIRE RATING JAMB/HEAD MAT. MAT. EXISTING V.I.F. PREFIN EXIST. EX. DOOR TO REMAIN REPAIR/REPLACE HARDWARE AS REQUIRED ALUM/GLASS STORAGE H.M. /A-500 CORRIDOR 4'-0"X 7'-0" 2/A-500 CASED OPENING WOMEN'S RESTROOM H.M. 1/A-500 MEN'S RESTROOM 1/A-500 H.M. PT-2 PT-3 PT-3 PT-3 PT-1 STOCK ROOM H.M. 1/A-500 1/A-500 BREAK ROOM H.M. 3'-0" X 7'-0" BREAK ROOM 1/A-500 H.M. 3'-0" X 7'-0" 1/A-500 EXIST. MANAGER'S OFFICE H.M. EXIST. EXTERIOR EXISTING V.I.F. EXIST. PT-2 SALES AREA EXISTING V.I.F. EXIST. EXIST. EX. DOOR TO REMAIN REPAIR/REPLACE HARDWARE AS REQUIRED ELIASON ENG-1 DOOR WITH 9"X14" WINDOW AND FRAME 4'-0" X 8'-0" CAFE WORKROOM – PREFIN.(BLACK) EXIST. PT-1 EXTERIOR EXISTING V.I.F.

1A VESTIBULE

MANAGER'S OFFICE,

\*EXISTING - VERIFY HARDWARE IN FIELD,

PROVIDE IF NOT EXISTING

BREAK ROOM,

10 WORK ROOM,

STOCK ROOM, STORAGE

/11/SALES CLOSET

DOOR SCHEDULE

GLAZING IN AN INDIVIDUAL FIXED OR OPERABLE PANEL THAT MEETS ALL OF THE FOLLOWING CONDITIONS SHALL BE CONSIDERED A HAZARDOUS LOCATION: THE EXPOSED AREA OF AN INDIVIDUAL PANEL IS GREATER THAN 9 SQUARE FEET (0.84 M2). THE BOTTOM EDGE OF THE GLAZING IS LESS THAN 18 INCHES (457 MM) ABOVE THE FLOOR THE TOP EDGE OF THE GLAZING IS GREATER THAN 36 INCHES (914 MM) ABOVE THE FLOOR.

1 HINGE

1 FLOOR STOP

(W/CONST. CORE)

3 SLENCERS HINGES

CLOSER

PLATE

3 SILENCERS 1 DOOR VIEWER

3 HINGES

CLOSER

2 PROTECTION

PLATE
1 FLOOR STOP 3 SILENCERS

/ POSHBUTZON LOCK (w/ const core)

2 PROTECTION
 PLATE
 1 FLØOR/STØP

3 SILENCERS

(Door swing in)

(w/ const. core)

3 HINGES HAGER
1 CLOSER LEN
(Door swing in)
1 PUSHBUTTON LOCK ALARM CLOCK

PROTECTION

FLOOR STOP

HARDWARE GROUPS

ONE OR MORE WALKING SURFACE(S) ARE WITHIN 36 INCHES (914 MM), MEASURED HORIZONTALLY AND IN A STRAIGHT LINE, OF THE PLANE OF THE GLAZING.

NO.	NOTE: DOOR HARDWARE AND SCHEDULE TO BE VERIFIED AND APPROVED BY TENANT PRIOR TO INITIAL PURCHASE ORDER AND CONSTRUCTION										
NO.	FROM	то	QTY	DESCRIPTION	MANUFACTURER	ITEM NO.	FINISH				
1	ENTRY DOOR		1	THRESHOLD	ZERO	4": 672A X W/ (2) 268A 6": 674A X W/ (2) 268A	ALUMINUM				
			2	CLOSER	DORMA	7300					
			1	CYLINDER	BEST (7-PIN CORE)	1EO4 X A5979 C181/1E7A4C413 626 BLANK AT EXTERIOR, THUMB TURN AT INTERIOR	ALUMINUM				
			2	PULL HANDLE							
			4	PUSHBAR (TWO BARS PER DOOR – UPPER AND LOWER BAR)							
			1	HINGE	KAWNEER	38–560	US32D				

KAWNEER

TOP OFFSET PIVOT

		2	HINGE	KAWNEER	STANDARD INTERMEDIATE PIVOT	
		1	HINGE	KAWNEER	BOTTOM OFFSET PIVOT	
		2	CLOSER	DORMA	7300	
		2	PULL HANDLE	BID	MATCH EX.	MATCH EX.
		4	PUSHBAR (TWO BARS PER DOOR – UPPER AND LOWER BAR)			
		1	BOTTOM RAIL WEATHER STRIPPING	KAWNEER	38–560	
		1	THRESHOLD	ZERO	4": 672A X W/ (2) 268A 6": 674A X W/ (2) 268A	ALUMINUM
	EMEDOENOV EVIT DOOD	3	HINGES	STANLEY	FBB191NRP-5x4.5	US32D
2	EMERGENCY EXIT DOOR	1	CLOSER	LCN	4110-NON-CUSTOMER SIDE OF DOOR US26D	
	*EXISTING - VERIFY	1	PANIC ALARM	VON DURPIN	33E0	SP-28
	HARDWARE IN FIELD,	1	THRESHOLD	ZERO	673 A W/268A	ALUMINUM
	PROVIDE IF NOT EXISTING	1	PERIMETER SEAL	NATIONAL GUARD PRODUCTS	160 V-WITH VINYL SEAL	ALUMINUM
		1	EXIT ALARM	DETEX	EA500	
		1	CORE	BEST 7-PIN	CONSTRUCTION CORE	
		1	THRESHOLD	HAGER	626S	AL
		1	WEATHERSTRIP	HAGER	891SV	AL
7	LANUTOR OF OCCU		HINGES	HAGER	BB1279 4-1/2 X 4-1/2	26D
3	JANITOR CLOSET	_	CLOSER	LCN	4030 H	AL
		1	CLASSROOM LOCKSET (W/ CONST. CORE)	SCHLAGE	ND70HD RHO	26D
		1	PROTECTION PLATE	HAGER	190S 12 X 34	32D

HAGER

HAGER

PUSHBUTTON LOCK | ALARM CLOCK

242F

DL 2700 IC

1756

190S 12" X 34"

BB1279 4-1/2 X 4-1/2

			DOOK VIEWER	TITTOLIT	1700	200
3	STOCK OUT SWING DOUBLE	2/	CONTINUOUS HINGES	HAGER	780-112 HD	AL////
/	póors / / / / /	2	CLOSER///	LCN / /	4111 H CUSH (110 DEG. OPEN)	AL////
/	*EXISTING - VERIFY	/1/	EXIT DEVICE///	VON DUPRIN//	22EØ X/16Ø9 STRIKE////////	AL////
	HARDWARÉ IN FJELD, / /	1/1/	ALARM / / /	DETEX///	EAX500///////////////////////////////////	AL / / /
//	PROVIDE IF NOT EXISTING	1	CYLINDER / /	SCHLAGE	/BØ-102////////////////////////////////////	26D / / /
/		2	PROTECTION PLATE	HAGER	19ØS 12" X 34" (INT. ONLY)	320
		1	COORDINATOR /	HAGER/	/ 2,97D/ / / / / / / / /	BLK / /
/		2	MOUNTING BRACKET	HAGER	/297M	BLK ///
		/2/	FLUSHBOLT /	HAGER/	282D///////////////////////////////////	26D///
//		1	ASTRAGAL /	HAGER /	/ 8 <i>3</i> 7\$/X <i>9</i> 6"////////////////////////////////////	AL ///
/ ,		1	DOOR VIEWER	HAGER /	17,56	26D / /
/		1	THRESHOLD /	HAGER /	6265	AL///
/		/1/	WEATHERSTRIP /	HAGER	B913V / / / / / / / /	AL / / /
		1	DOOR PULL	HAGER/	34G (INT. OF ACTIVE LEAF)	26D///
/ /	<i>\////////////////////////////////////</i>	1	RAIN DRIP GAURDS	MGP/INC.	/16A / / / / / / / / /	AL///
3	ELECTRIC ROOM	3/	HINGES / /	HANGAR//	BB127,9 4-1/2 × 4-1/2	26D / /
/		1/	STORE ROOM /	SØHLAGE//	ND 10 RHO ///////////////////////////////////	26D///
/			LOCKSET(w/const. core)			
/ ,	<i>\////////////////////////////////////</i>	1	¢Losér//	Len///	40,30 ør 4031////////////////////////////////////	MTLPC///
/		/1/	PROTECTION PLATE	HAGER /	/ 1/90/8 12" X/34" / / / / / / /	<i>3</i> 2D////
/		1/	FLØOR/STØP//	HAGER///	/ <b>24</b> 2F/ / / / / / / / /	26D////
		3	SILENCERS/	HAGER /	/397D///////////////////////////////////	GR //
/ ,	<i>{////////////////////////////////////</i>					
/						
7	NOT USED					
3	RESTROOMS	3	HINGES	HANGAR	BB1279 4-1/2 X 4-1/2	26D
	(STORE WITH CAFE)	1	CLOSER	LCN	4030 or 4031	MTLPC
		1	CLASSROOM SET	SCHLAGE	ND 70HD RHO (BEST 7-PIN CYLINDER)	S6D
		1	DEAD BOLT	SCHLAGE	B560B 626 OS-OCC(BEST 7-PIN CYLINDER)	
		1	PROTECTION PLATE	HAGER	190S 12 X 34	32D
		1	FLOOR STOP	HAGER	242F	26D
		3	SILENCERS	HAGER	307D	GR
		1	FLOOR STOP	HAGER	242F	26D
<b>A</b> /	RESTROOMS / / / / /	3	HINGES / /	HANGAR/	/BB/279/4-/1/2/X/4-/1/2/////////////////////////////////	26D / /
/	(STØRE/WITHOUT CAFE)	<u>/ 1/</u>	¢Losér///	Len///	#030 or 4031 / / / / / /	MTLPC///
	/////////////	1	TRILOGY LEVER SET	ALARM LOCK/	DŁ 2700/IC (BĘŚT 7-PIN ĆYLINDĘŔ)//	<b>2</b> 6D///
/	1//////////////////////////////////////	1	DEAD BOLT	SCHLAGE /	/B560B/626 ØS-ØCC(BEST 7-PM ØYLINDER)	
	<i>【////////////////////////////////////</i>	1/	PROTECTION PLATE	HAGER /	/190\$ 12 X/34///////////////////////////////////	320 / / /
/ /	<i>\////////////////////////////////////</i>	<u>/</u>	FLOOR STOP	HÁGER /	<b>242F</b>	260///
/	<i>\////////////////////////////////////</i>	/3/	SKENCERS /	HAGER /	3670////////////////////////////////////	GR///
_		/1/	FLOOR STOP//	HAGER//	2#2F///////////////////////////////////	26D////
	1				· · · · · · · · · · · · · · · · · · ·	

HAGER

1 PUSHBUTTON LOCK ALARM CLOCK DL 2700 IC

HAGER

HAGER /

BB1279 4-1/2 X 4-1/2 4030 H CUSH

BB1279 4-1/2 X/4-1/2 4030 H/CUSH (mount on J.C. side) DJ. 2700 /C

(mount on J.C. side)

190S 12"x 38"

307D

BARNES&NOBLE



PRCTI20250011

PROJECT DESIGNER:



ARCHITECT: JOEL TORIELLI 422 BOGERT AVE RIDGEWOOD, NJ 07450

MATCH STOREFRONT


UNIT #800 PUYAÜLUP, WA 98373

Project Number 33247 Store Number 3507

Revision Log: Date Description 12-19-24 ISSUED FOR PERMIT, BID, LANDLORD & CLIENT REVIEW 02-20-25 BUILDING DEPARTMENT AND LANDLORD COMMENTS 05-19-25 ISSUED FOR CONSTRUCTION

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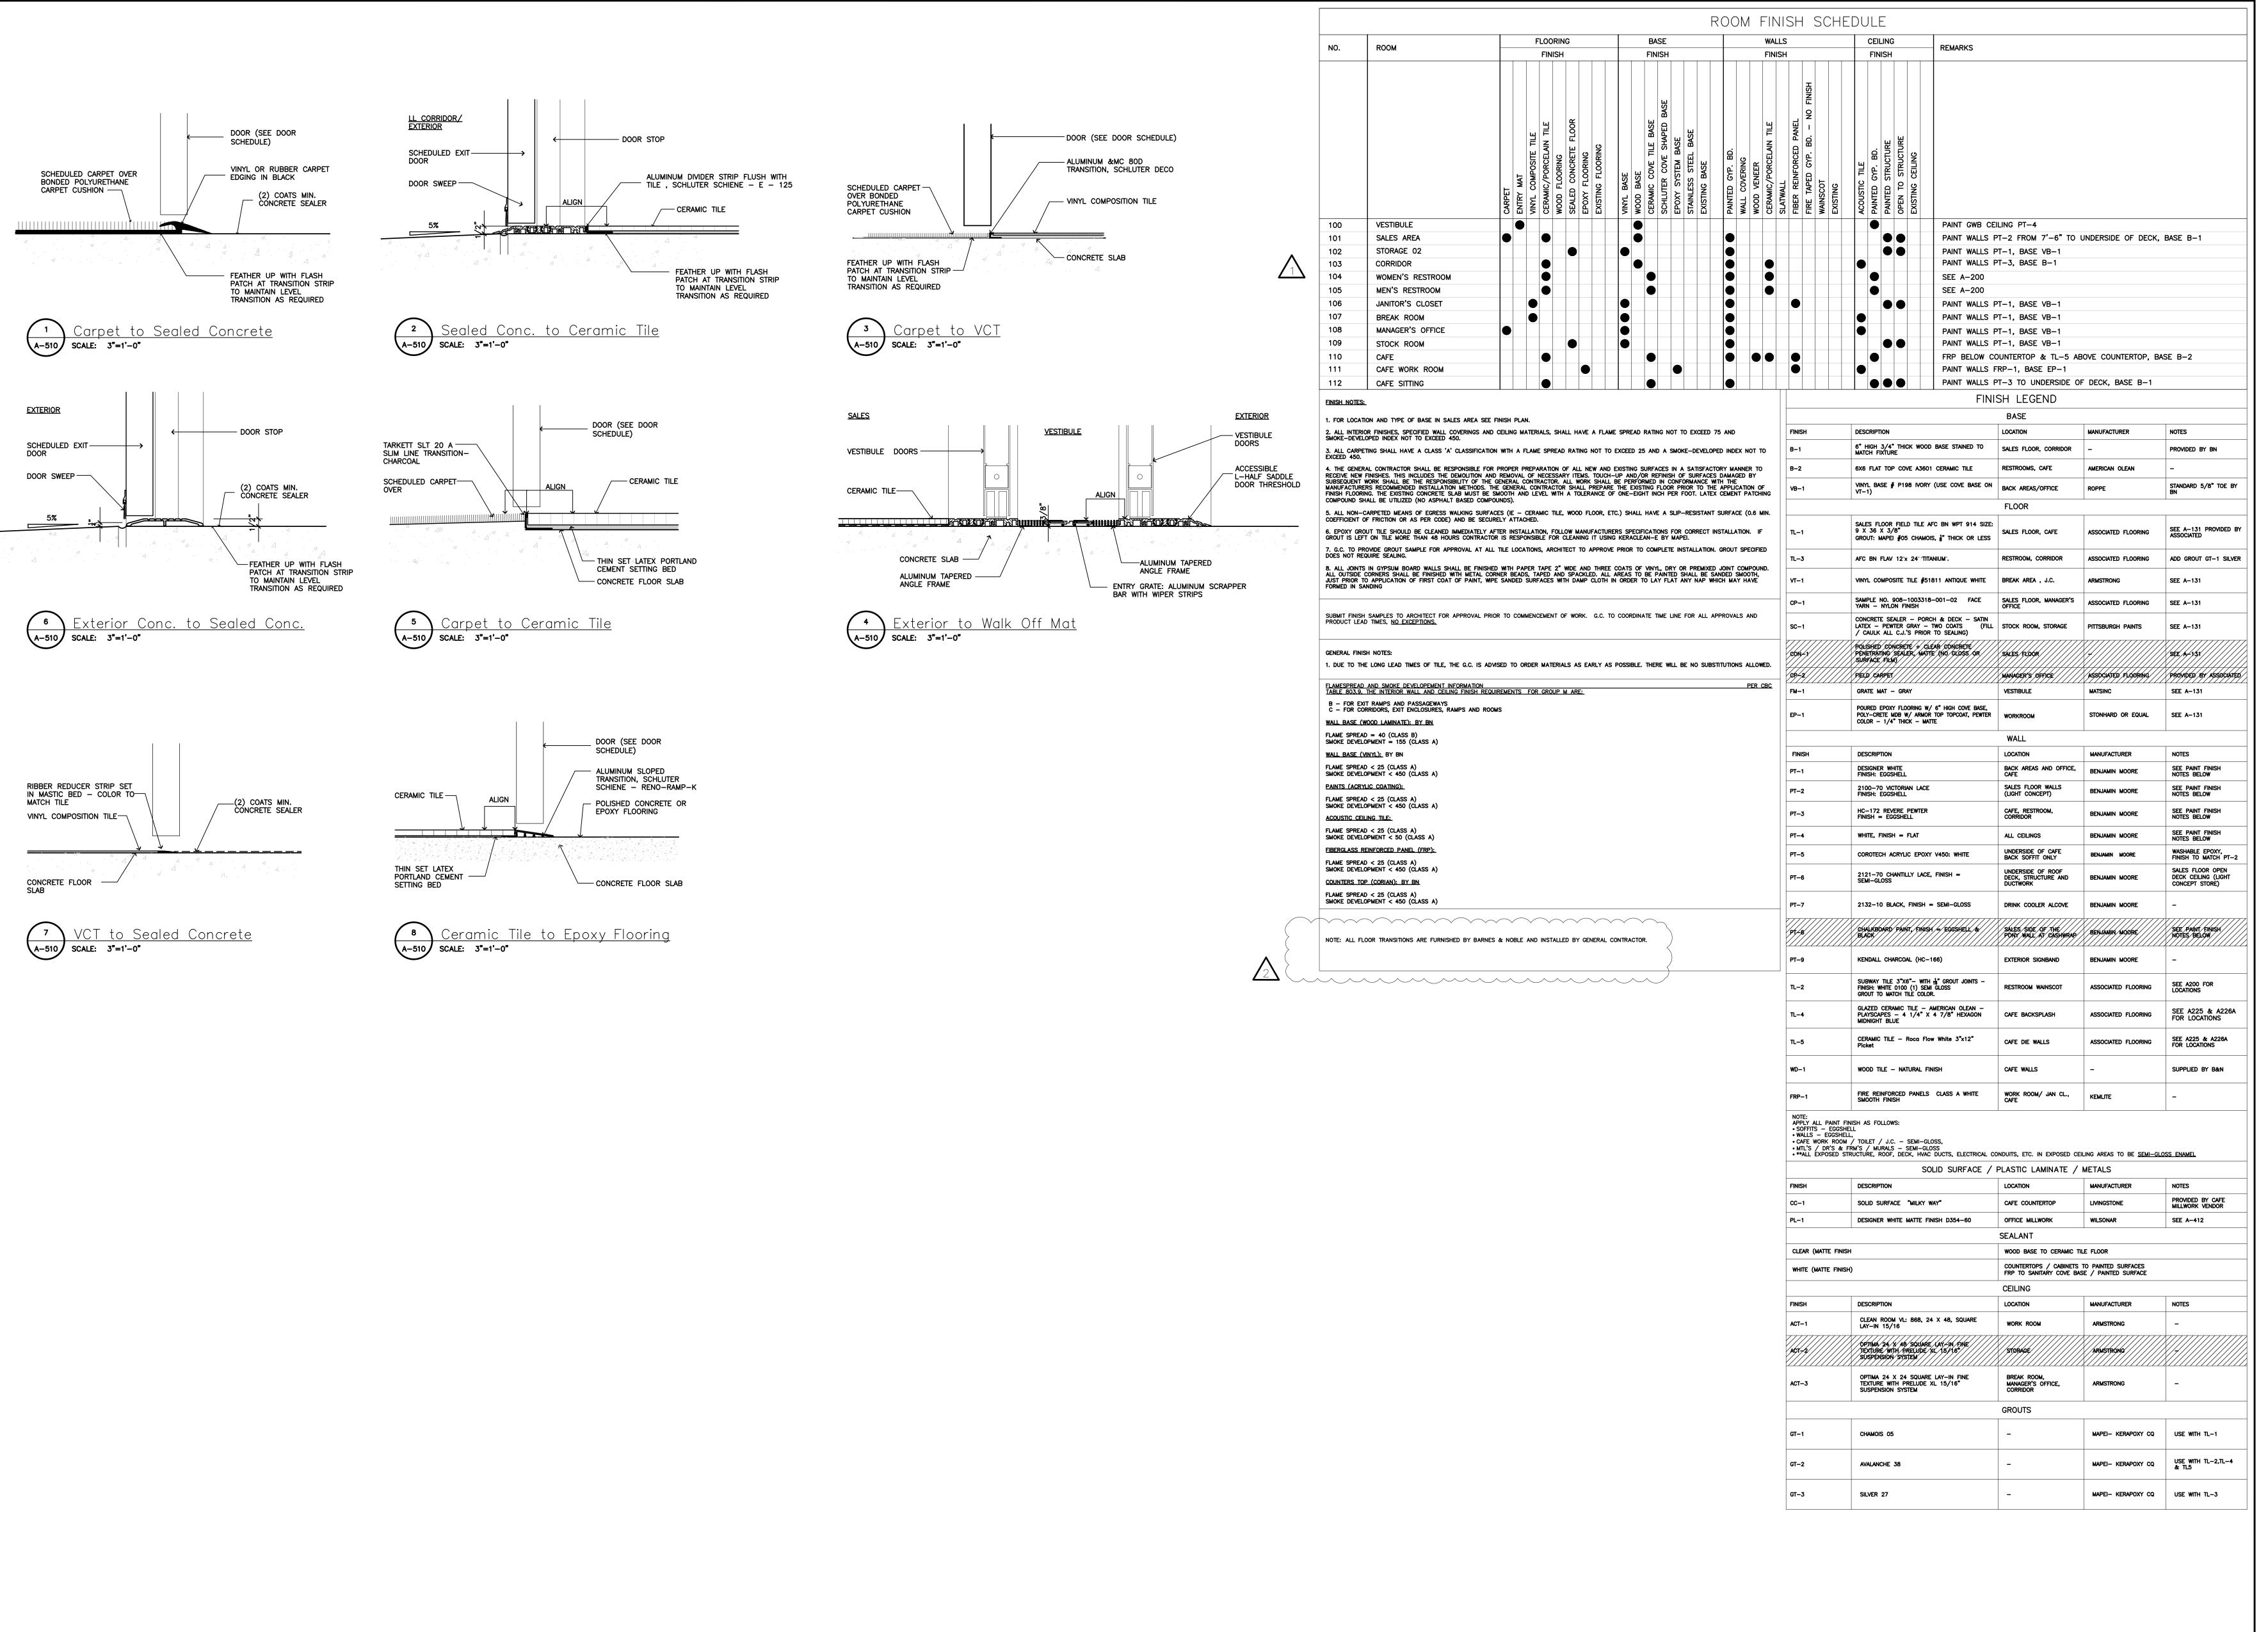
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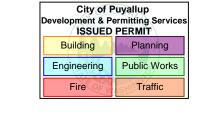


EXP. DATE : 10/02/25

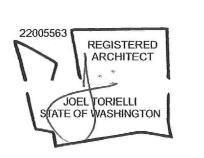Drawing Description: Door Types, Schedules, Notes, and Details

Drawing Number:





## PRCTI2025001

PROJECT DESIGNER:



ARCHITECT:

JOEL TORIELLI
422 BOGERT AVE
RIDGEWOOD, NJ 07450

SOUTH HILL MALL 3500 S. MERIDIAN

UNIT #800

PUYAĽLUP, WA 98373 Project Number 33247 Store Number 3507

Revision Log:

Date
Description

ISSUED FOR PERMIT, BID, LANDLORD & CLIENT REVIEW

Description

ISSUED FOR PERMIT, BID, LANDLORD COMMENTS


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ISSUED FOR CONSTRUCTION

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These plans are an instrument of service and the property of the Architect, infringements will be prosecuted.

General Contractor to verify all conditions and dimensions at the premises. Discrepancies shall be reported to the Architect prior to the commencement of any work.




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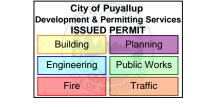
LIC.# : 22005563 EXP. DATE : 10/02/25

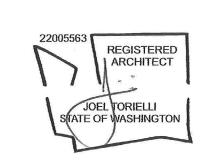Drawing Description:

Finish Schedule and Floor Transition Details

Drawing Number:



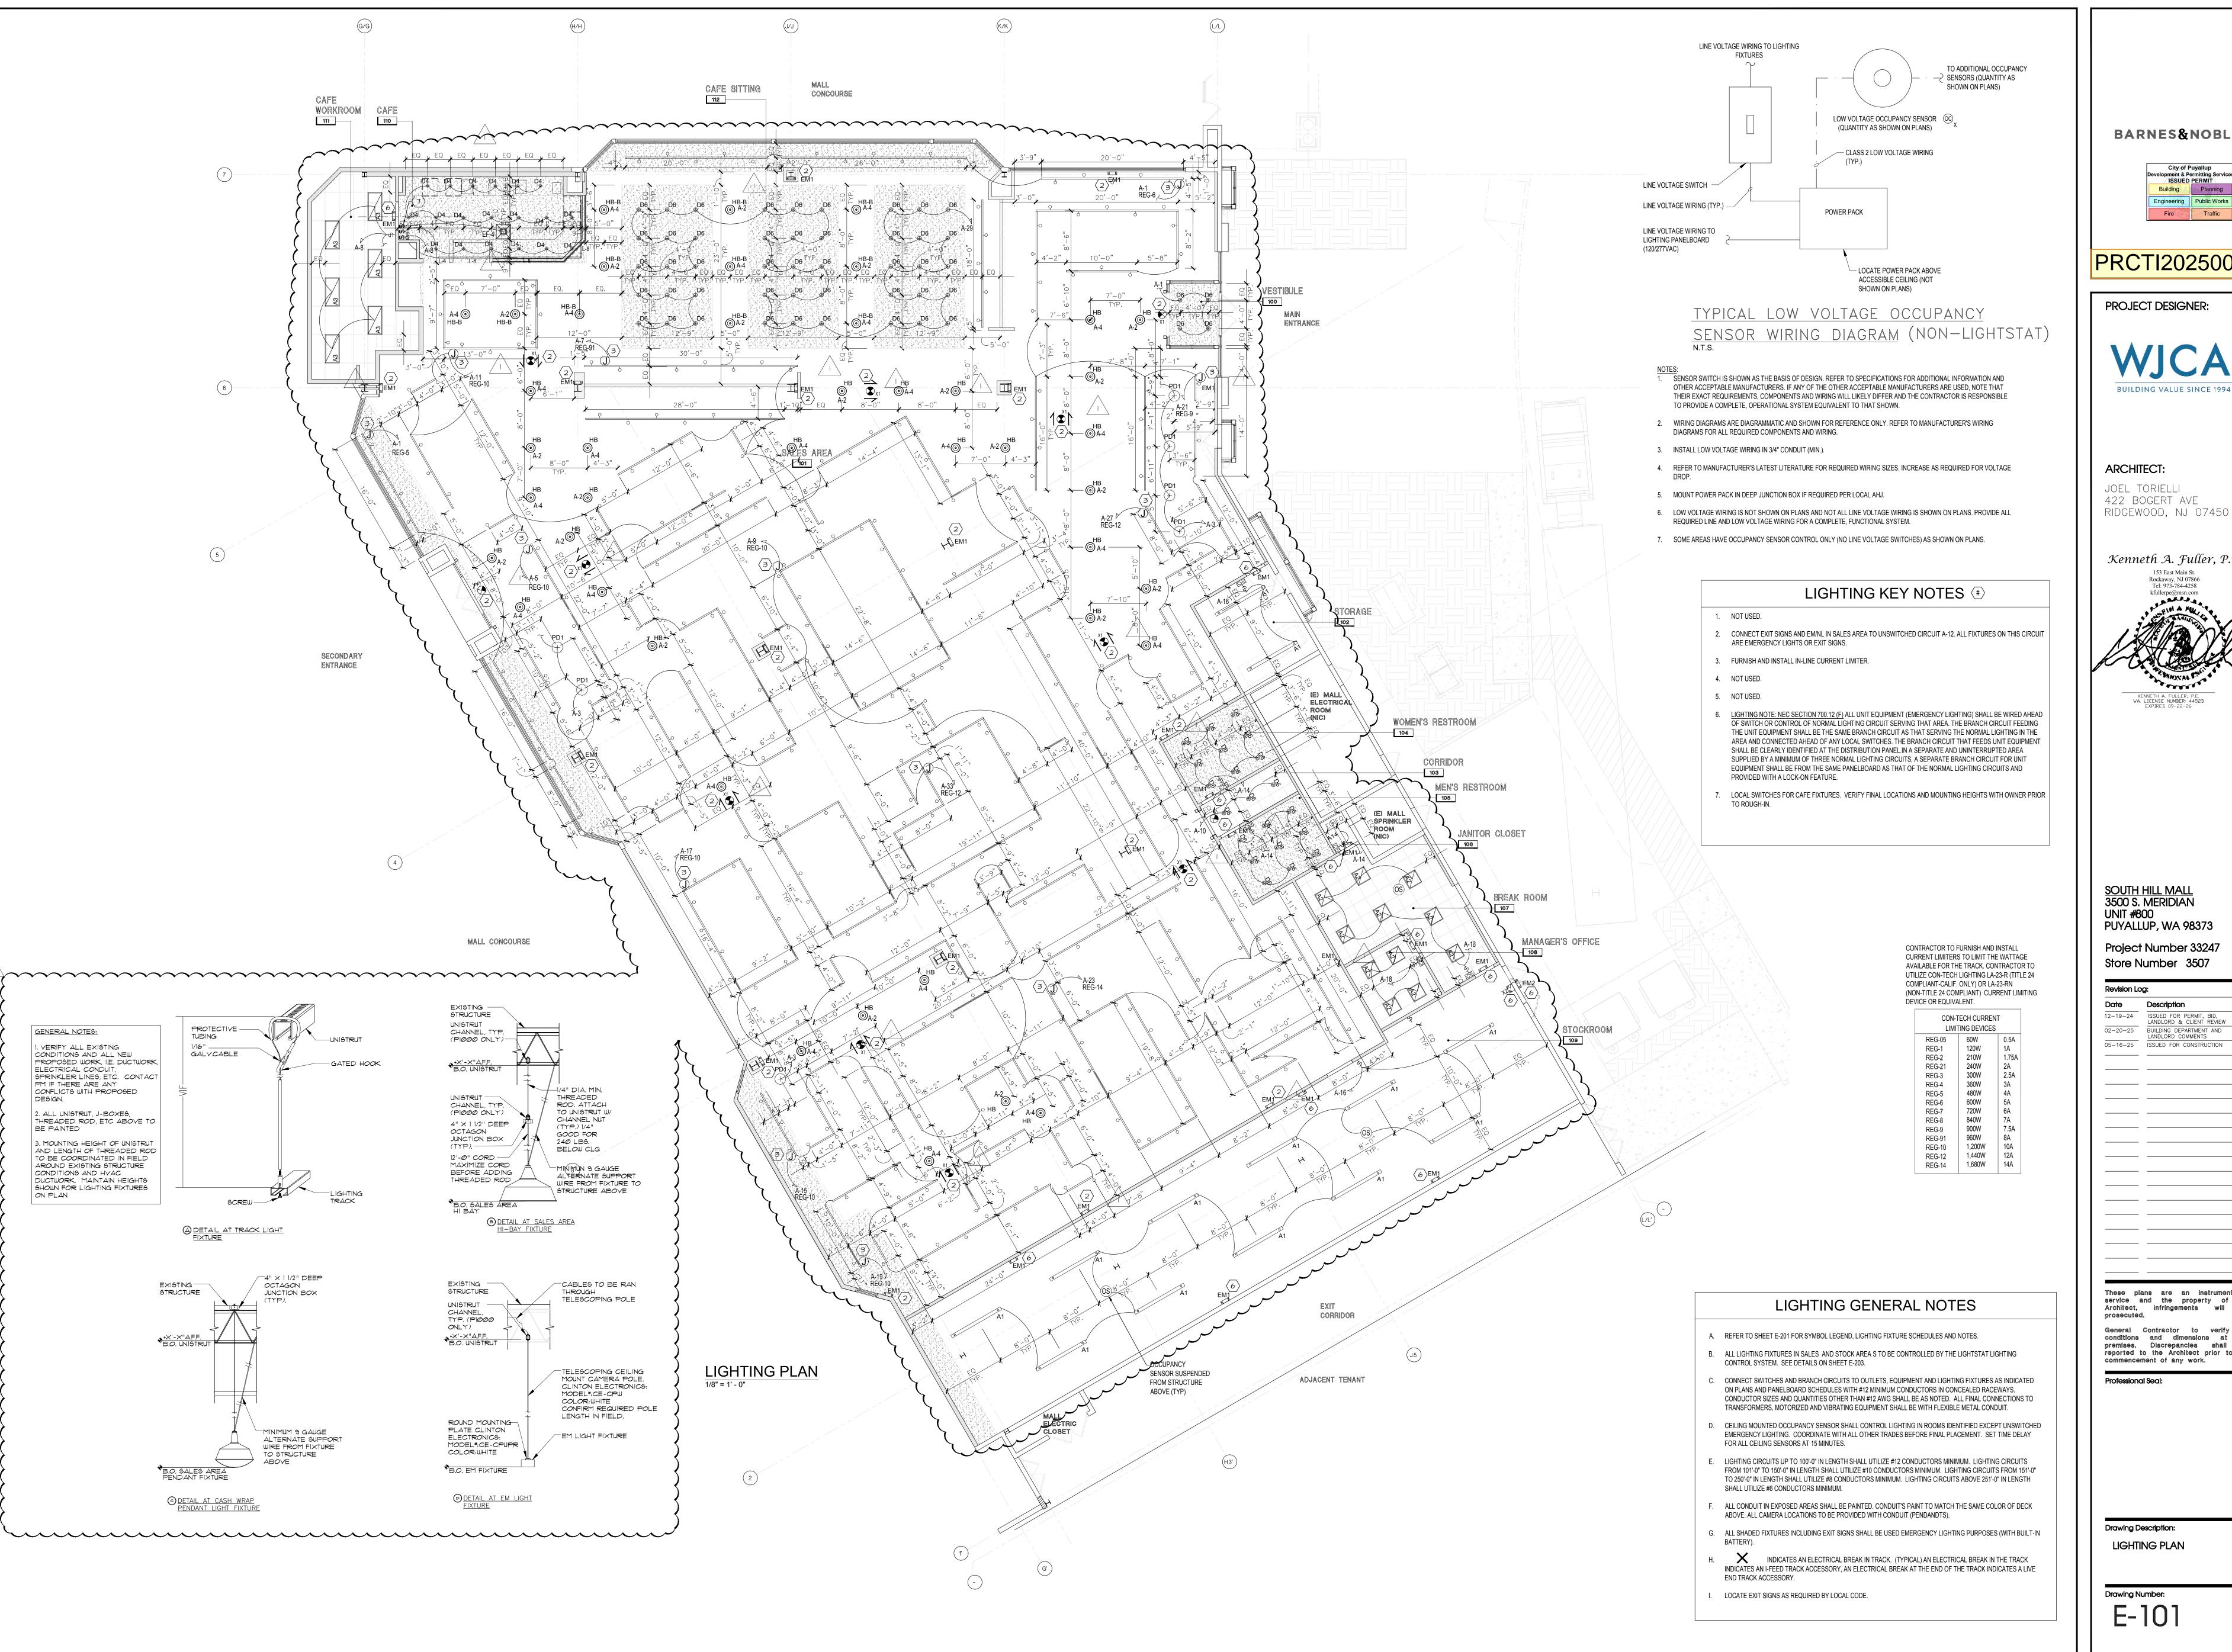

## PRCTI20250011

PROJECT DESIGNER:



JOEL TORIELLI 422 BOGERT AVE

Kenneth A. Fuller, P.E.

SOUTH HILL MALL 3500 S. MERIDIAN UNIT #800 PUYALLUP, WA 98373

Store Number 3507

Revision L	og:	
Date	Description	No.
12-19-24	ISSUED FOR PERMIT, BID, LANDLORD & CLIENT REVIEW	Δ
02-20-25	BUILDING DEPARTMENT AND LANDLORD COMMENTS	$\overline{\Lambda}$
05-16-25	ISSUED FOR CONSTRUCTION	2
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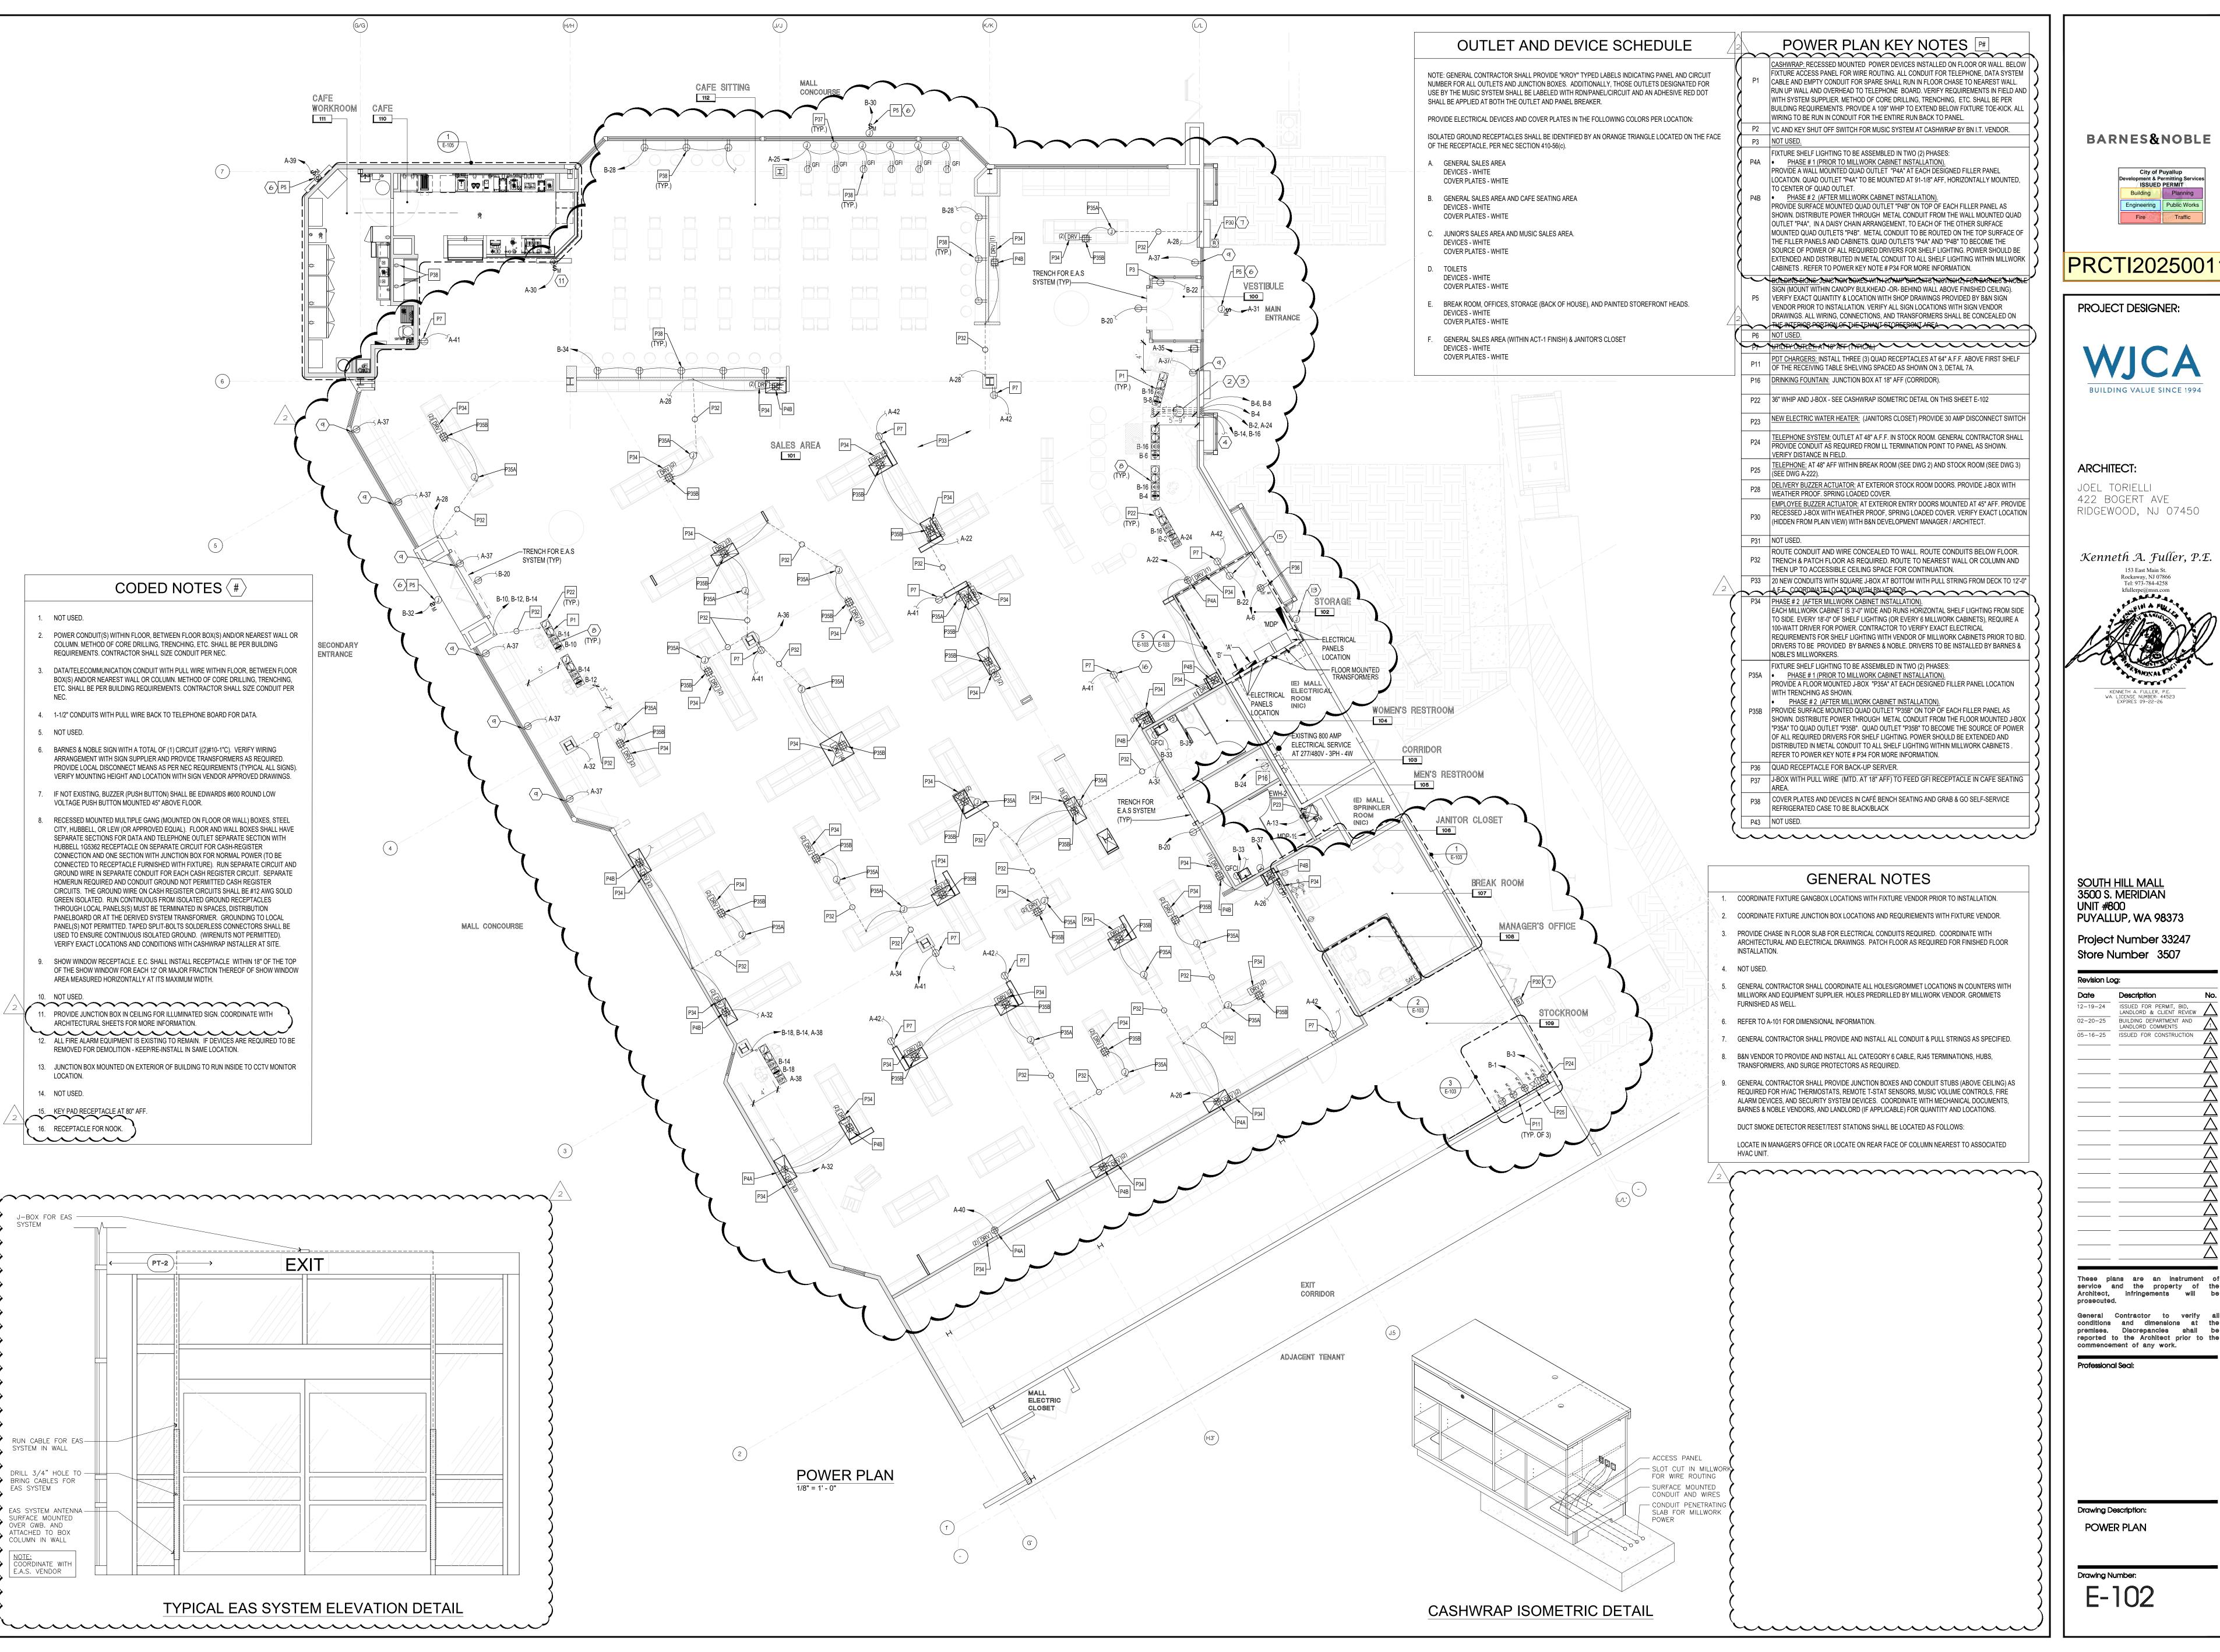
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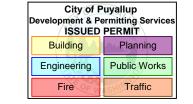
General Contractor to verify all conditions and dimensions at the premises. Discrepancies shall be reported to the Architect prior to the

commencement of any work. Professional Seal:

Drawing Description: LIGHTING PLAN

Drawing Number:





PROJECT DESIGNER:



JOEL TORIELLI

RIDGEWOOD, NJ 07450

Kenneth A. Fuller, P.E. Tel: 973-784-4258

SOUTH HILL MALL 3500 S. MERIDIAN

Store Number 3507

02-20-25 BUILDING DEPARTMENT AND 05-16-25 ISSUED FOR CONSTRUCTION


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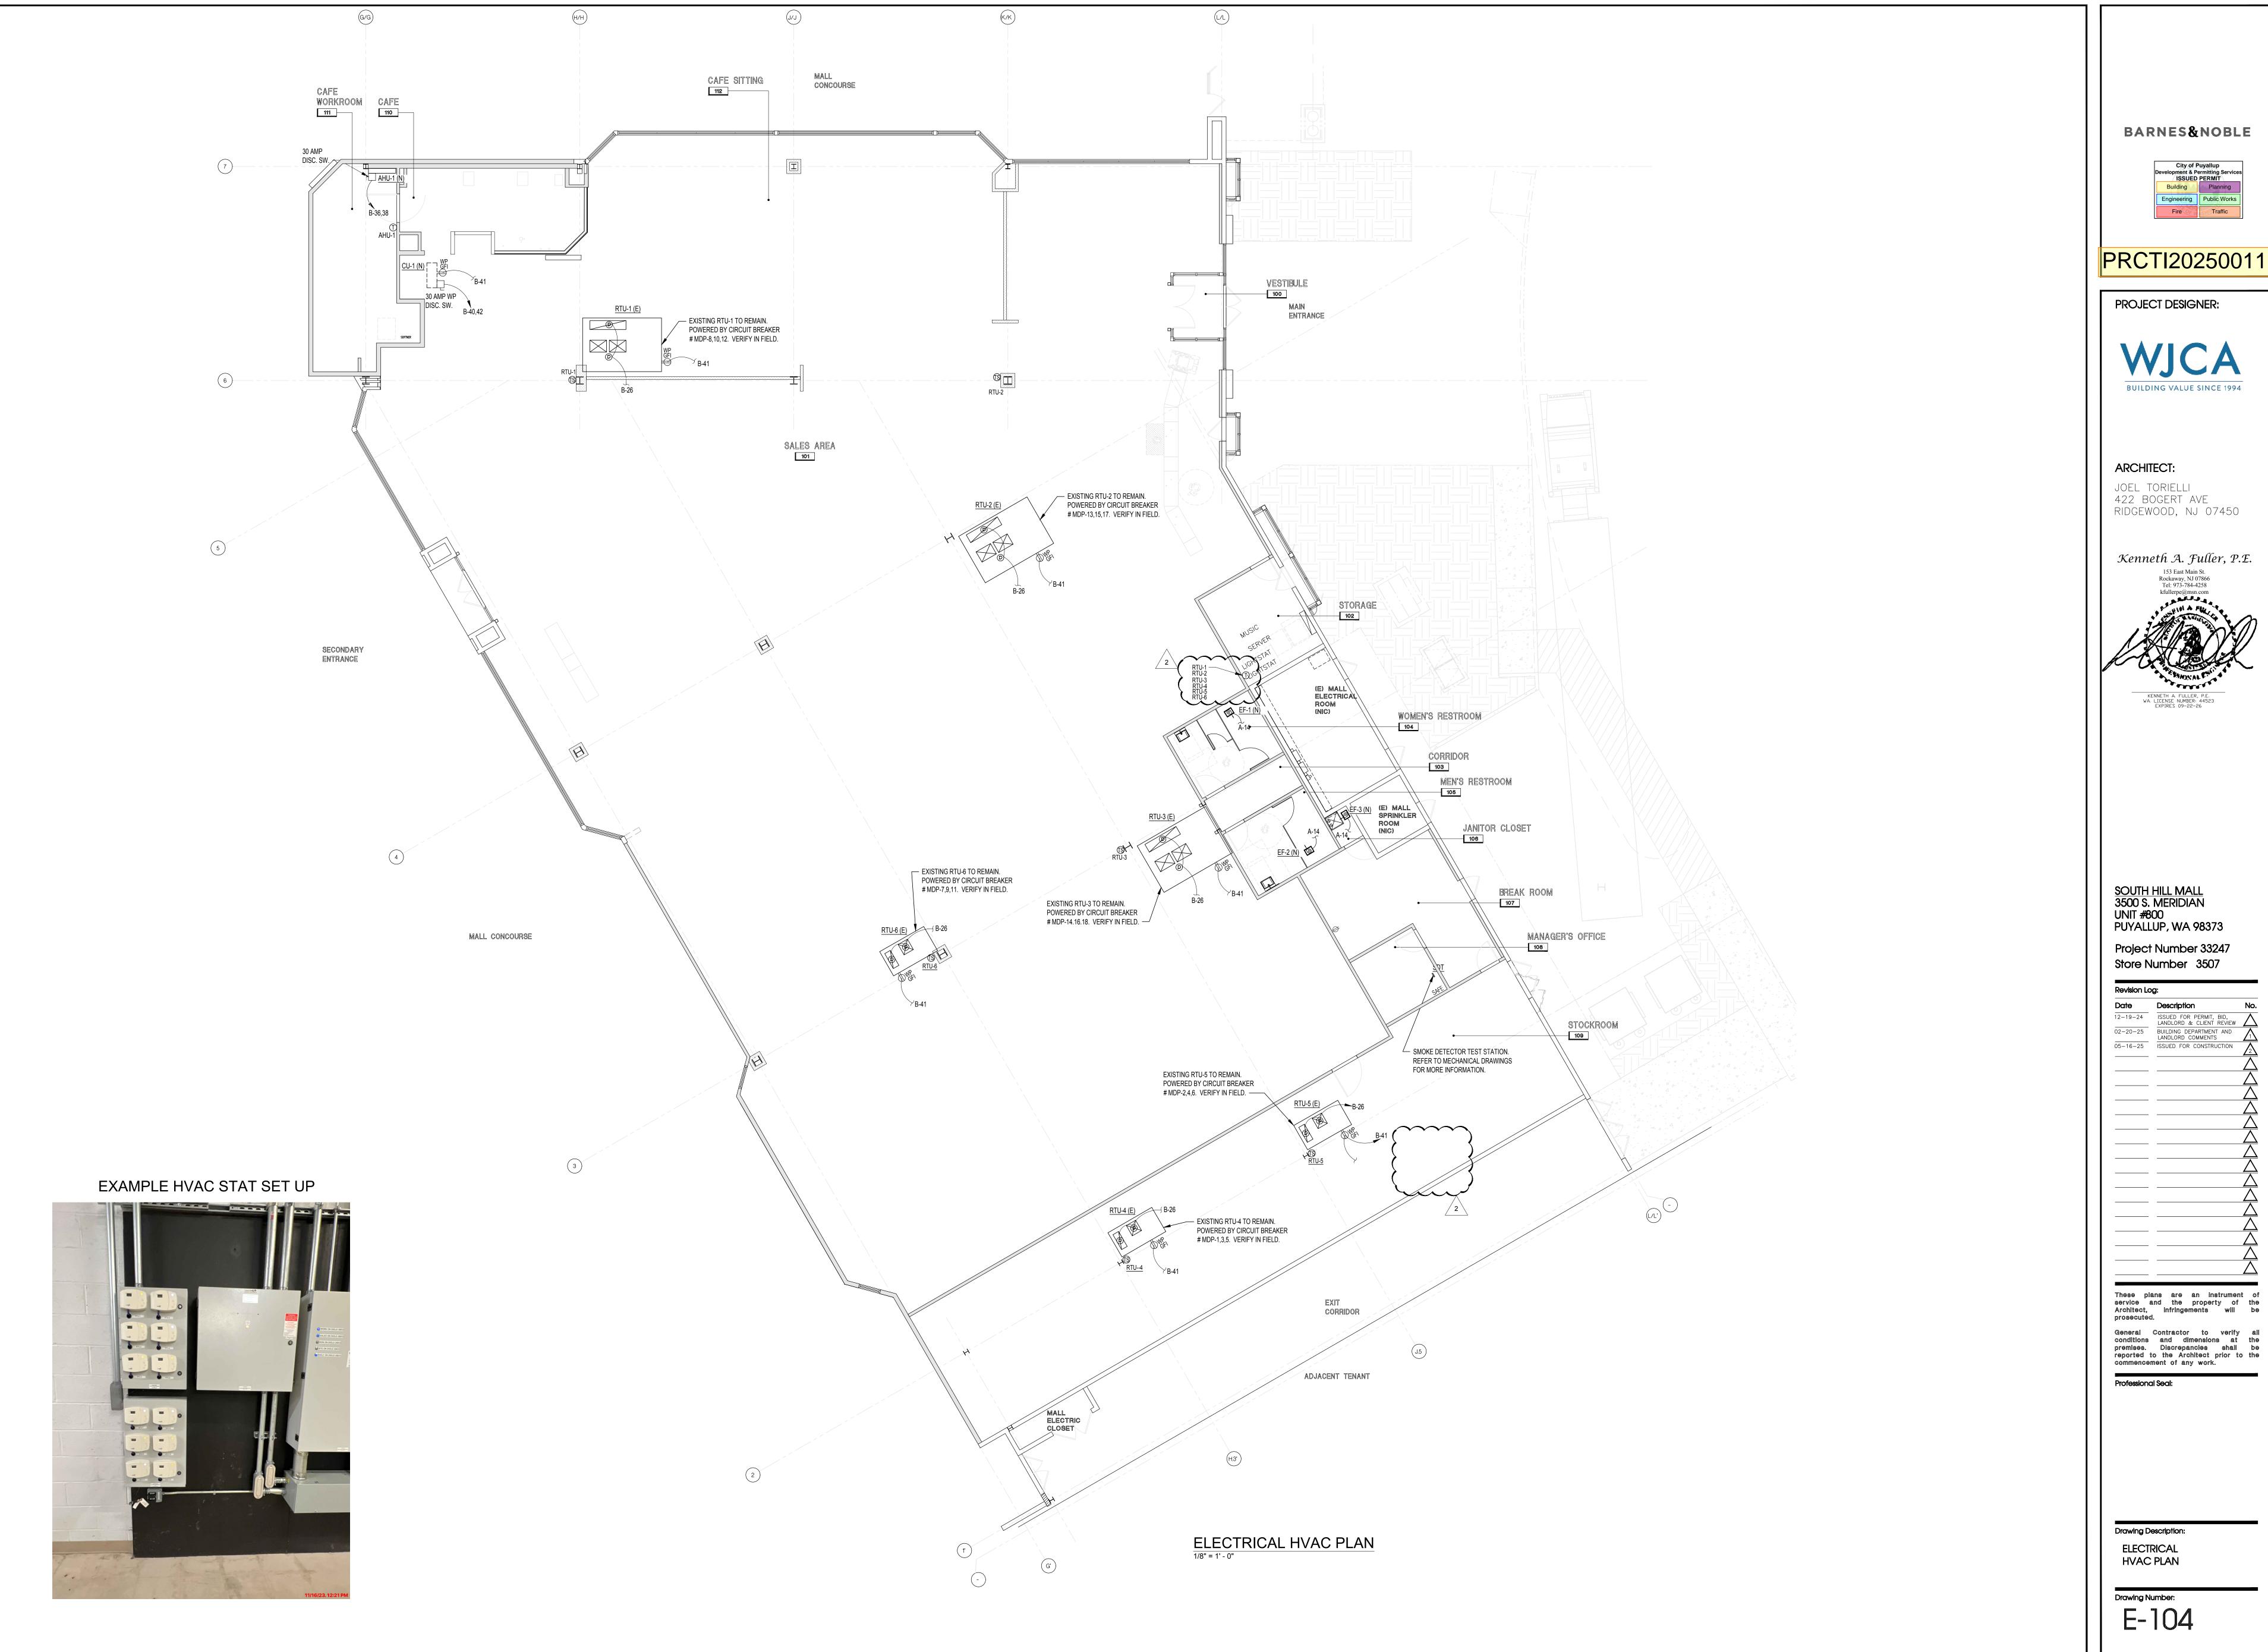
premises. Discrepancies shall be reported to the Architect prior to the commencement of any work.


Professional Seal:

**Drawing Description:** 

Drawing Number:



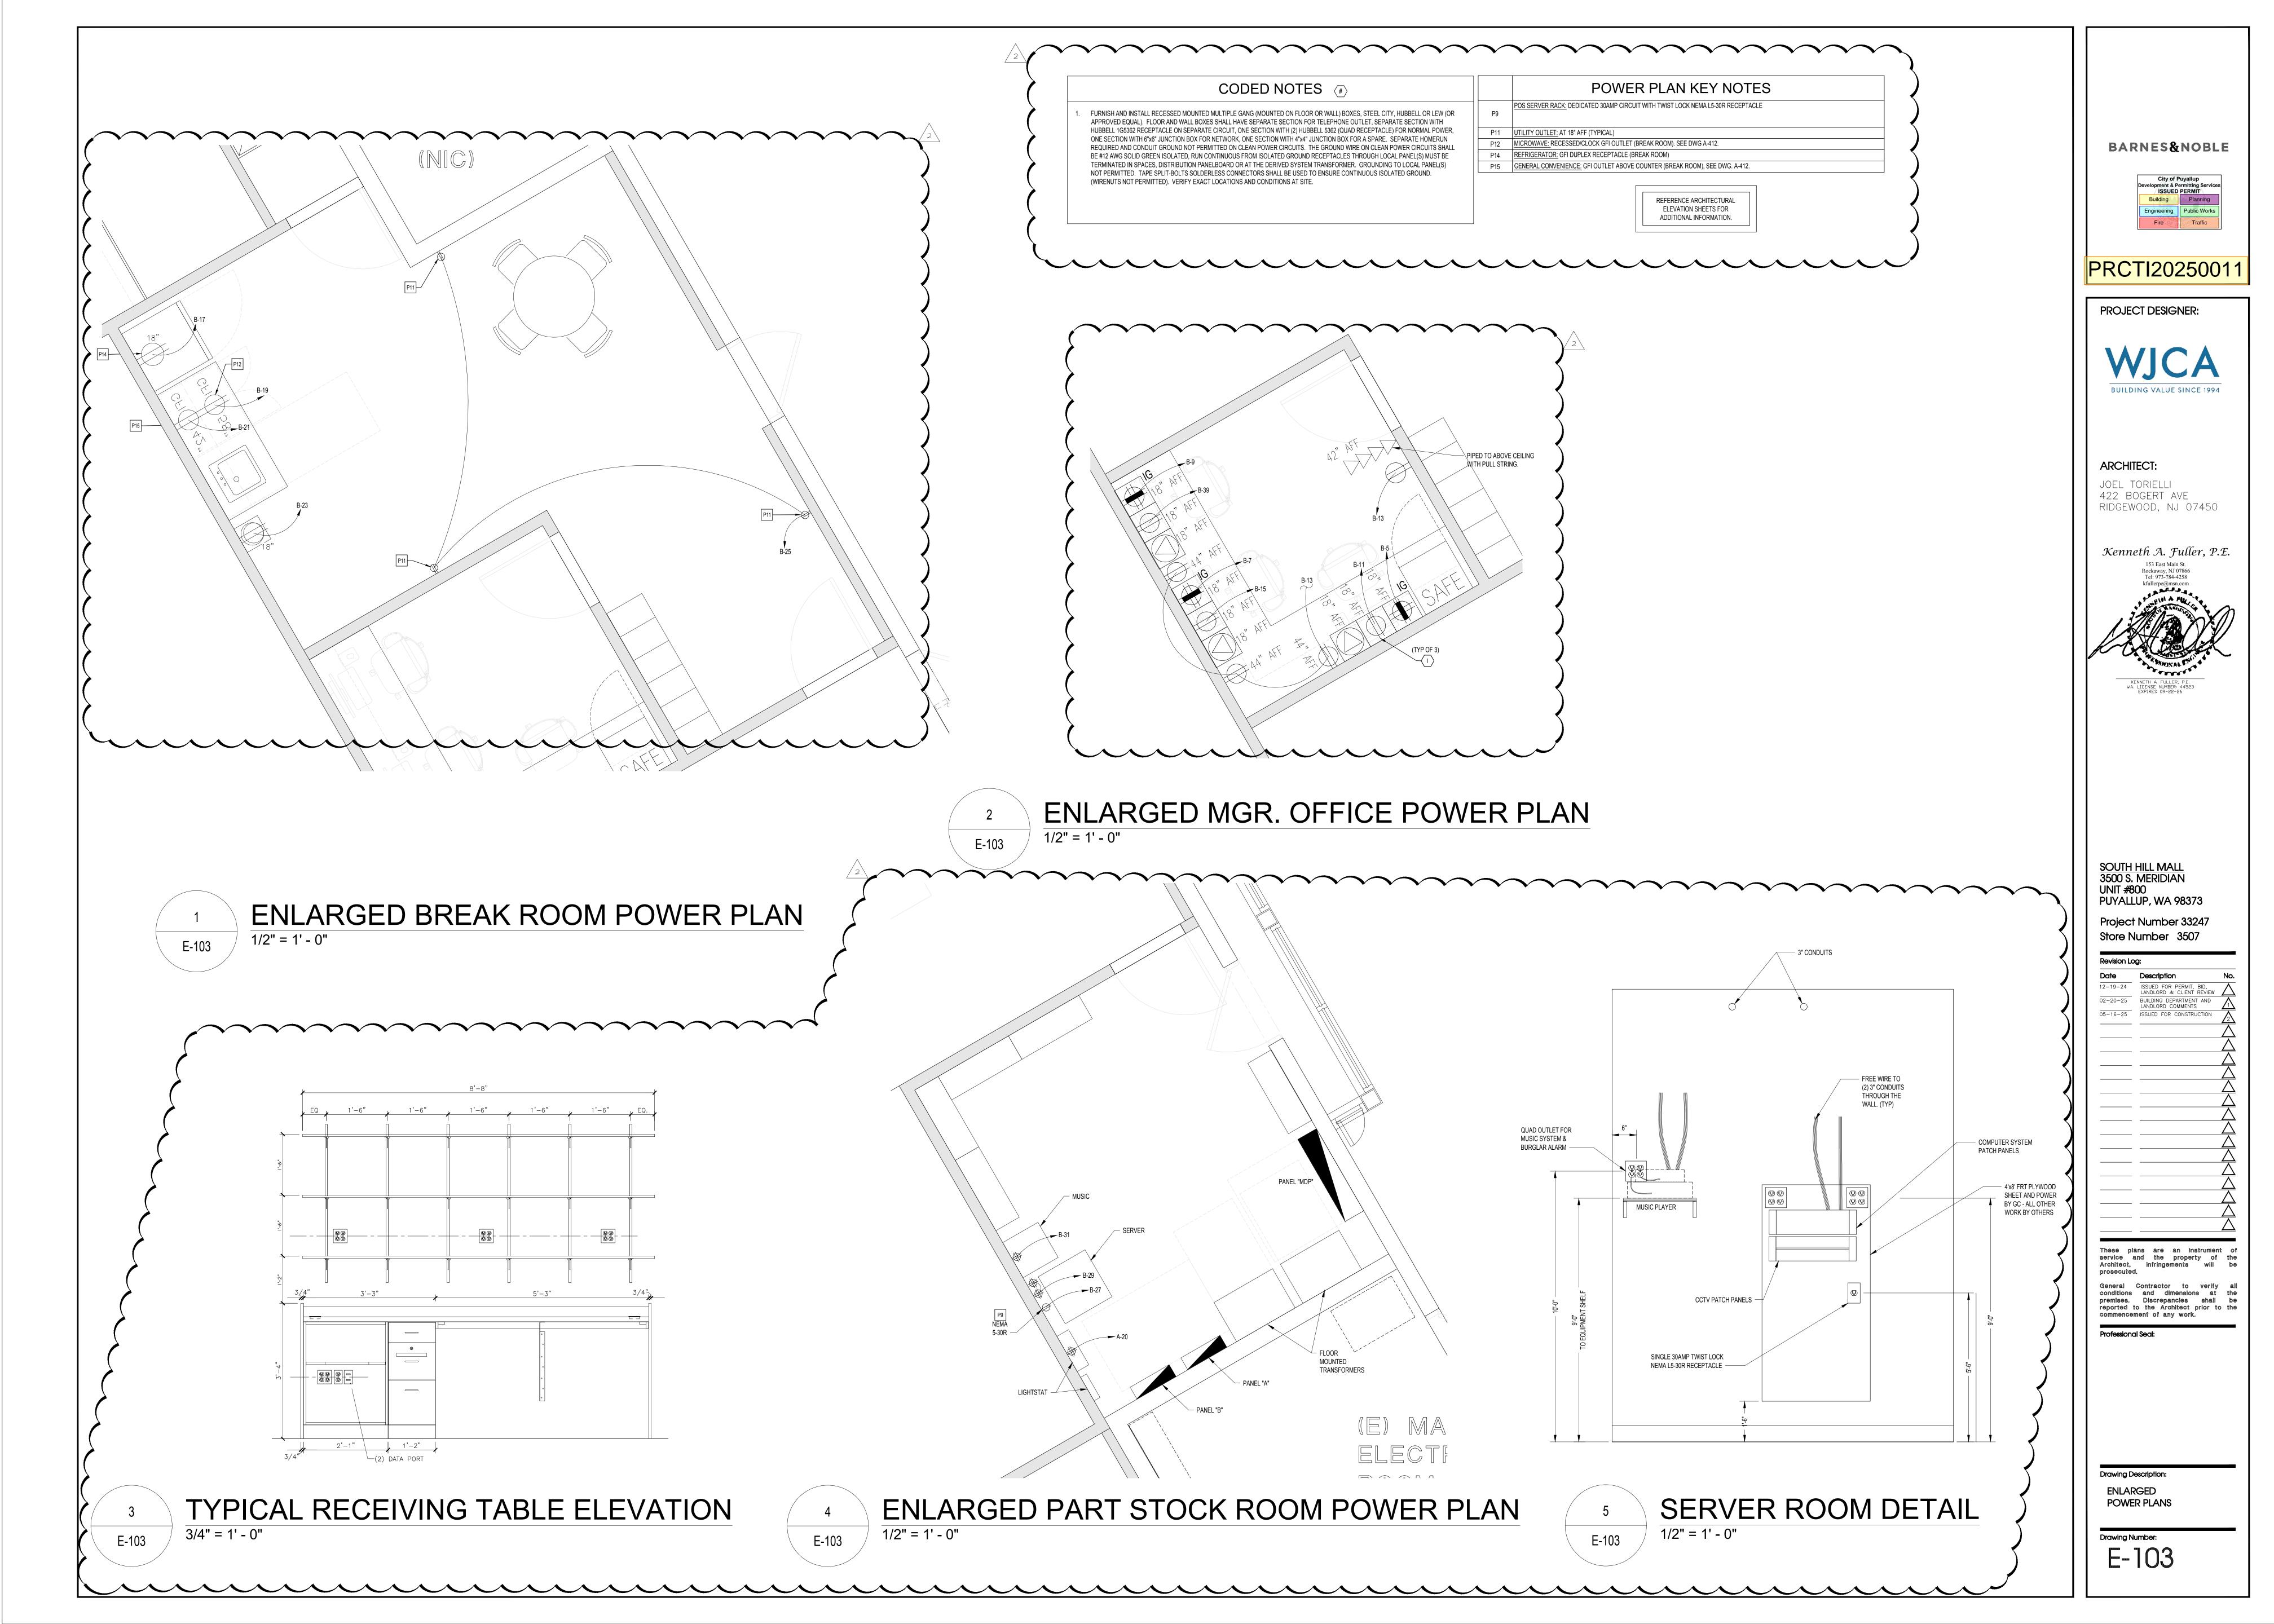

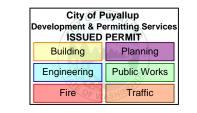

PRCTI20250011





12-19-24

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02-20-25

BUILDING DEPARTMENT AND
LANDLORD COMMENTS

1SSUED FOR CONSTRUCTION


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GENERAL NOTE:

VERIFY FINAL LOCATIONS WITH KITCHEN DRAWINGS PRIOR TO ROUGH-IN.

GENERAL NOTE: VERIFY ALL KITCHEN EQUIPMENT, SPECIFICATIONS, REQUIREMENTS, ETC. WITH KITCHEN VENDOR DRAWINGS & OWNER PRIOR TO BID.

ELEC	CTRICAL KITCHEN SYMBOL LEGEND
SYMBOL	DESCRIPTION
<b>⊕</b>	WALL/FIXTURE MOUNTED DUPLEX OUTLET  SPECIAL OUTLET. SEE CAFE EQUIPMENT POWER SCHEDULE FOR PLUG TYPE.
<b>①</b>	WALL MOUNTED JUNCTION BOX

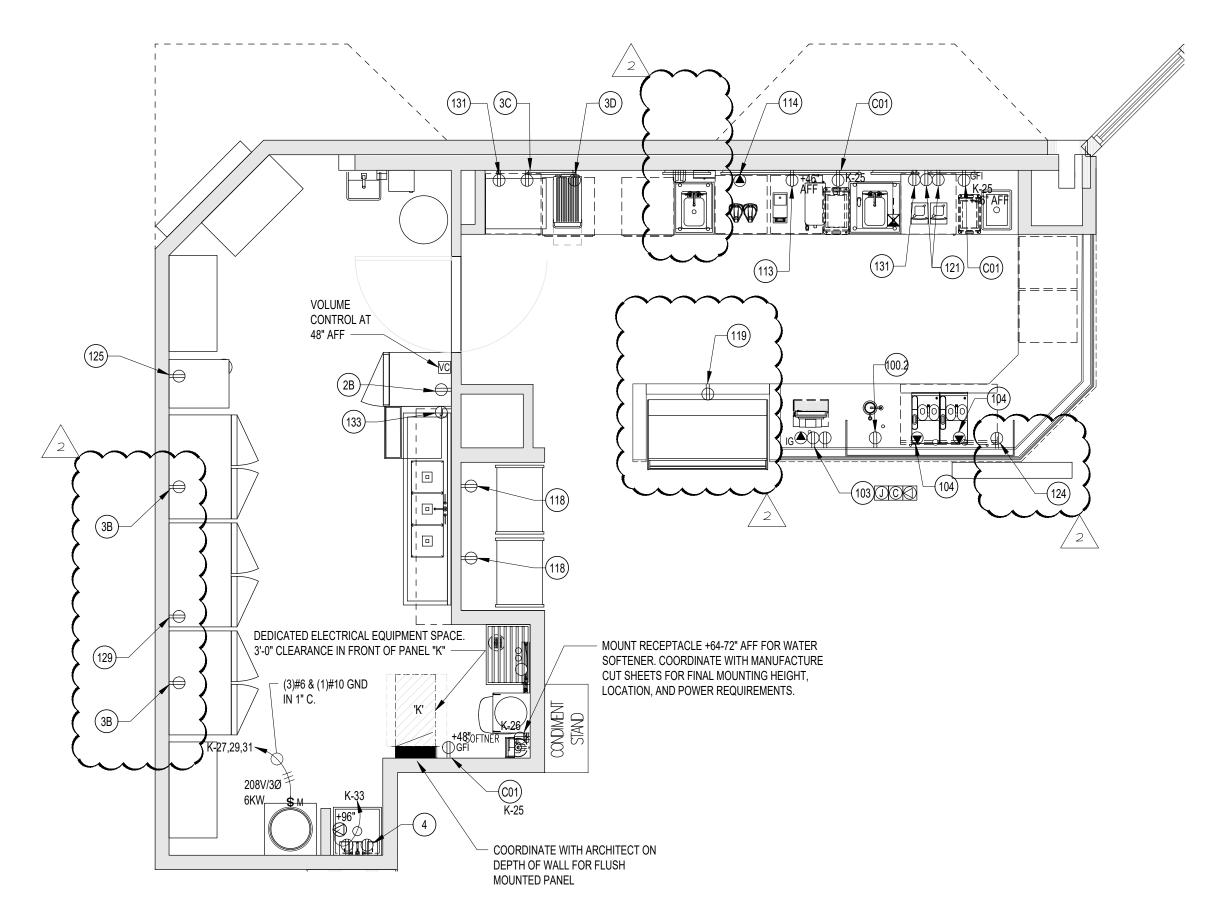

#### **ENLARGED KITCHEN POWER PLAN** E-105

#### GENERAL NOTES:

- ALL DEVICES IN FOOD PREP AREA SHALL BE GFI.
- 2. FOR LOCATION OF ELECTRICAL DEVICES, REFER TO ARCHITECTURAL EQUIPMENT/CABINET PLANS (A-227 & A-227a). ALL DEVICES TO ALIGN WITH DESIGNATED EQUIPMENT AND CABINET LOCATIONS AS SHOWN. NO EXCEPTIONS SHALL BE TAKEN.
- 3. GENERAL CONTRACTOR SHALL COORDINATE ELECTRICAL INSTALLATION WITH PLUMBING FOR INSTALLATION OF CARLON. SCHEDULE 40 CONDUIT CHASE FOR FILTER TUBING

SERVICE COUNTER MILLWORK NOTE: EACH ELECTRICAL DEVICE WITHIN REAR COUNTER OF SERVICE AREA SHALL BE STUBBED-OUT WITH M.C. CONDUIT. GENERAL 

#### KITCHEN ELECTRICAL NOTES

- 1. ALL COVERPLATES AND DISCONNECT SWITCHES IN KITCHEN AREA SHALL BE STAINLESS STEEL.
- 2. ALL ELECTRICAL WORK FOR FOOD SERVICE EQUIPMENT SHALL BE COMPLETELY INTERWIRED BY ELECTRICAL CONTRACTOR. FINAL CONNECTIONS TO EQUIPMENT JUNCTION BOX OR PULL BOX, AND ALL ELECTRICAL WORK FROM PANEL BOARDS, TO BE BY THE ELECTRICAL CONTRACTOR.
- 3. THE ELECTRICAL CONTRACTOR SHALL PROVIDE ALL ROUGH-IN AND FINAL CONNECTION TO THE FOOD SERVICE EQUIPMENT. ALL WORK TO BE IN COMPLIANCE WITH ALL NATIONAL, STATE AND LOCAL CODES
- 4. VERIFY OUTLET RATING AND CONFIGURATION WITH EQUIPMENT SUPPLIER PRIOR TO ROUGH-IN.
- 5. VERIFY EXACT LOCATION AND MOUNTING HEIGHTS OF ALL OUTLETS WITH EQUIPMENT SUPPLIER PRIOR TO
- 6. ELECTRICAL CONTRACTOR TO FURNISH AND INSTALL ALL PLUGS AND CORDS REQUIRED. ALL CORDS SHALL
- 7. ELECTRICAL CONTRACTOR TO FURNISH AND INSTALL ALL JUNCTION BOXES, PVC OR METAL CONDUIT, CONVENIENCE OUTLETS WITH COVERS, SWITCHES CONNECTORS, CONTROLS, AND OTHER ACCESSORIES THAT ARE NOT AN INTEGRAL PART OF THE FOOD SERVICE EQUIPMENT AS REQUIRED TO MAKE FINAL CONNECTIONS TO THE FOOD SERVICE EQUIPMENT FOR A COMPLETE AND FUNCTIONAL OPERATION

BE NEMA RATED AND UL APPROVED FOR MANUFACTURER AND EQUIPMENT.

8. ELECTRICAL CONTRACTOR TO FURNISH AND INSTALL ALL DISCONNECTS OR CIRCUIT BREAKERS AS REQUIRED BY CODES FOR EACH CONNECTION. COORDINATE LOCATION WITH THE KITCHEN EQUIPMENT

MEETING ALL APPLICABLE NATIONAL, STATE, AND LOCAL CODES AND ORDINANCES.

- 9. ELECTRICAL CONTRACTOR TO FURNISH AND INSTALL WALL SWITCH FOR FACTORY INSTALLED LIGHTING FIXTURES IN EXHAUST VENTILATOR HOODS PER APPLICABLE STATE AND LOCAL CODES APPLICABLE. ELECTRICAL CONTRACTOR SHALL PROVIDE WIRE AND CONNECTION TO EACH LIGHT FIXTURE. THE ELECTRICAL CONTRACTOR SHALL FULLY CONCEAL ALL WIRING BETWEEN POWER SOURCE, WALL SWITCH, AND JUNCTION BOX ON HOOD. THE ELECTRICAL CONTRACTOR SHALL BE RESPONSIBLE FOR PROVIDING ANY INNER WIRING OF LIGHT FIXTURES BETWEEN VENTILATOR HOOD SECTIONS AS REQUIRED. ALL WIRING WITHIN HOOD AND POWER SOURCE TO BE IN STRICT ACCORDANCE WITH MANUFACTURER'S RECOMMENDATIONS, NFPA #96 AND ALL OTHER APPLICABLE CODES.
- 10. IN ACCORDANCE WITH NFPA #96 AND MANUFACTURER'S RECOMMENDATIONS, THE ELECTRICAL CONTRACTOR SHALL FURNISH AND INSTALL A PUSH BUTTON STATION WITH PILOT LIGHT FOR VENTILATOR FAN MOTOR(S). THE ELECTRICAL CONTRACTOR IS TO BE RESPONSIBLE FOR, AND TO PROVIDE ALL REQUIRED WIRING FROM POWER SUPPLY THROUGH FAN SWITCH TO FAN MOTOR(S) AND PROVIDE MAGNETIC STARTERS AND FULLY INTERWIRE SYSTEM WITH ALL POWER INTERRUPTION DEVICE(S) BUILT INTO HOOD AND FIRE PROTECTION SYSTEM AS REQUIRED BY NFPA #96, NATIONAL, STATE AND/OR LOCAL CODES APPLICABLE. ELECTRICAL CONTRACTOR TO PROVIDE LOCK-OUT DEVICES ON CONTROL BOXES FOR EXHAUST HOOD FANS, SYSTEM AND FIRE PROTECTION SYSTEM.
- 11. ELECTRICAL CONTRACTOR TO PROVIDE, INSTALL AND FULLY WIRE SHUNT-TRIP BREAKERS FOR SHUT DOWN OF FUEL AND POWER TO COOKING EQUIPMENT AS REQUIRED BY NFPA #96 AND ALL OTHER NATIONAL, STATE, OR LOCAL CODES APPLICABLE. THE HOLDING COILS FOR SHUNT-TRIP BREAKERS SHALL BE WIRED TO A 120 VOLT/SINGLE PHASE CONTROL CIRCUIT BY THE ELECTRICAL CONTRACTOR AND EXTENDED THROUGH A CONTACTOR AND MAINTAINED BY A PRESSURE SWITCH LOCATED AT THE MOUNTING BRACKET OF THE CHEMICAL CYLINDER FOR HOOD PROTECTION. THE ELECTRICAL CONTRACTOR SHALL ALSO PROVIDE, INSTALL, AND FULLY INTERWIRE WITH POWER SHUTDOWN RELAY SWITCH, AND ADDITIONAL RELAY OR SWITCHES REQUIRED TO INTERFACE FIRE PROTECTION SYSTEM WITH FAN VENTILATOR MOTORS AND BUILDING ALARM SYSTEMS AS REQUIRED BY NFPA #96, NATIONAL, STATE. AND LOCAL CODES APPLICABLE. COORDINATE WITH FIRE SUPPRESSION CONTRACTOR FOR LOCATION OF FIRE SUPPRESSION SYSTEM, AND GAS SHUT-OFF VALVE AS PART OF THE COMPLETE SYSTEM AS APPLICABLE.
- 12. AT THE REMOTE FIRE CABLE PULL. ELECTRICAL TRADES TO PROVIDE EMPTY JUNCTION BOX AT 54" AFF AND CONDUIT CONCEALED IN WALL TO 6" ABOVE FINISHED CEILING. COORDINATE EXACT REQUIREMENTS WITH FOOD SERVICE EQUIPMENT TRADE AND FIRE SUPPRESSION CONTRACTOR.
- 13. ELECTRICAL CONTRACTOR SHALL INTERWIRE DISPOSER CONTROL SWITCH AND TO TIME DELAY/RELAY, MAGNETIC STARTER, DISPOSER MOTOR, AND SOLENOID VALVE WITH WATER TIGHT CONDUIT AS REQUIRED PER LOCAL CODES.
- 14. ELECTRICAL CONTRACTOR SHALL INTERWIRE THROUGH TIME CLOCK FOR LOW TEMPERATURE COMPRESSOR AND WALK-IN COMPARTMENT BLOWER COIL FAN MOTORS AND DEFROST ELEMENT POWER SOURCE AS PART OF MAIN POWER SOURCE. PROVIDE ALL WIRING AND CONDUIT WITH DISCONNECT. (VERIFY REQUIREMENTS WITH EQUIPMENT SUPPLIER)
- 15. ELECTRICAL CONTRACTOR SHALL PROVIDE FINAL CONNECTION TO A JUNCTION BOX MOUNTED ON TOP OF A PREFABRICATED REFRIGERATOR AND/OR FREEZER WALL AT APPROXIMATELY 8'-6" AFF. INTERWIRE THE LIGHT ADJACENT TO THE DOOR WITH THE FACTORY MOUNTED LIGHT SWITCH. ALL CONDUIT SHALL BE RUN EXPOSED ON TOP OF WALK-IN, NO EXPOSED CONDUIT WILL BE ALLOWED ON INSIDE OF WALK-IN. ELECTRICAL SERVICE REQUIRED FOR WALK-IN SHALL BE AS SHOWN FOR LIGHTS, DOOR AND DOOR FRAME HEATER. THRESHOLD PLATE HEATERS (WHERE SPECIFIED). HEATED PRESSURE RELIEF PORT (ON FREEZERS) AND ALARM SYSTEMS (WHERE SPECIFIED). (VERIFY REQUIREMENTS WITH EQUIPMENT
- 16. ELECTRICAL CONTRACTOR TO PROVIDE THE REQUIRED POWER SUPPLY AND FINAL CONNECTIONS TO THE TERMINAL BLOCK AT THE CONDENSING UNIT AND TO FULLY INTERWIRE TO ANY ADDITIONAL COMPONENTS, INCLUDE THE PROPER SIZE DISCONNECTS OR CIRCUIT BREAKERS. ALL WIRING FOR LOW AND MEDIUM TEMPERATURE CONDENSING UNIT TO BE ROUTED THROUGH DEFROST TIME CLOCK AND THEN WIRED TO EVAPORATOR COIL FOR PROPER POWER SUPPLY WITH THE REQUIRED QUANTITY OF WIRES. THE EVAPORATOR COIL DEFROST HEATER AND FAN MOTOR VOLTAGES AND LOADS ARE AS NOTED ON PLAN. VERIFY LOCATION OF COMPRESSORS AND COORDINATE WITH REFRIGERATION CONTRACTOR FOR FINAL CONNECTIONS. (VERIFY REQUIREMENTS WITH EQUIPMENT SUPPLIER)
- 17. ALL 50AMP OR LESS SINGLE PHASE AND 100AMP OR LESS THREE PHASE, RECEPTACLES IN KITCHEN AREAS SHALL BE GFCI PROTECTION PER N.E.C. 210-8(B).

				CAF	E EQU	IPMENT	POWER SCH	IEDULE				
QUIPMENT NO.		QUANTITY	VOLTAGE AND PHASE	AMPS	НР	KVA	PANEL	CIRCUIT(S)	BREAKER SIZE	WIRE SIZE	CONDUIT	NEMA
129	REFRIGERATOR/FREEZER, REACH-IN, DOUBLE DOOR	1	115V/1Ø	11.6	1/2	1.334	K	19	20A-1P	(2)#12 THWN & (1)#12 GND	3/4"	5-20P
2B	REFRIGERATOR, REACH-IN, SINGLE DOOR	1	115V/1Ø	3.8	1/4	0.437	K	28	15A-1P	(2)#12 THWN & (1)#12 GND	3/4"	5-15P
3B	FREEZER, REACH-IN, DOUBLE DOOR	2	115V/1Ø	9.4	1-1/4	1.081	K K	6 14	15A-1P	(2)#12 THWN & (1)#12 GND	3/4"	5-15P
3C	BLODGETT OVEN	1	208V/3Ø	24.0	1/4	5.6	K	36,38,40	30A-3P	(3)#10 THWN & (1)#10 GND	3/4"	VERIFY WITH MANUFACTURER
3D	RAPID COOK OVEN	1	208V/1Ø	30.0	-	6.0	K	39,41	30A-2P	(2)#10 THWN & (1)#10 GND	3/4"	6-30P
133	DISHWASHER, UNDERCOUNTER	1	208V/1Ø	37.2	-	7.74	K	21,23	40A-2P	(2)#8 THWN & (1)#10 GND	3/4"	DIRECT
125	ICE MAKER, CUBE STYLE	1	115V/1Ø	16.0	-	1.289	K	1	20A-1P	(2)#12 THWN & (1)#12 GND	3/4"	VERIFY WITH MANUFACTURER
100.2	HOT WATER DISPENSER	1	115V/1Ø	11.3	-	1.300	K	22	15A-1P	(2)#12 THWN & (1)#12 GND	3/4"	5-15P
103	POS SYSTEM	1	115V/1Ø	-	VERIFY	VERIFY	K K	35 18	20A-1P	(2)#12 THWN & (1)#12 GND & (1)#12 ISO. GND	3/4"	5-20P
104	ESPRESSO MACHINE	2	208V-220V/1Ø	30.0	-	6.240	K K	5,7 9,11	30A-2P	(2)#10 THWN & (1)#10 GND	3/4"	L6-30P
131	REFRIGERATOR, UNDERCOUNTER	2	115V/1Ø	2.0	1/6	0.24	K K	12 15	15A-1P	(2)#12 THWN & (1)#12 GND	3/4"	5-15P
121	BLENDER	2	120V/1Ø	15.0	3.0	1.800	K K	13 20	20A-1P	(2)#12 THWN & (1)#12 GND	3/4"	5-20P
113	COFFEE GRINDER	1	120V/1Ø	8.0	1/2	0.920	K	37	15A-1P	(2)#12 THWN & (1)#12 GND	3/4"	5-15P
114	COFFEE BREWER	1	208V/1Ø	14.0	-	2.9	K	8,10	20A-2P	(2)#12 THWN & (1)#12 GND	3/4"	VERIFY WITH MANUFACTURER
118	SELF-SERVICE REFRIGERATED CASE	2	120V/1Ø	15.6	-	1.198	K K	2 4	20A-1P	(2)#12 THWN & (1)#12 GND	3/4"	5-20P
119	DISPLAY CASE, REFRIGERATED, SELF SERVE	1	208V/1Ø	10.0	1/2	2.08	K	32,34	15A-2P	(2)#12 THWN & (1)#12 GND	3/4"	6-15P
124	DOUBLE UNDER COUNTER REFRIGERATOR	1	115V/1Ø	3.0	1/5	0.345	K	30	15A-1P	(2)#12 THWN & (1)#12 GND	3/4"	5-15P
CO1	CONVENIENCE RECEPTACLE	-	120V/1Ø	1.5	-	0.180	SEE PLANS	SEE PLANS	20A-1P	(2)#12 THWN & (1)#12 GND	3/4"	5-20P

## REFERENCE NOTES:

- 1. OWNER/VENDOR PROVIDED ITEM. VERIFY ALL UTILITY REQUIREMENTS AND LOCATIONS PRIOR TO ROUGH-IN
- 2. POS SYSTEM. PROVIDE ISOLATED, DEDICATED, GROUNDED CIRCUIT. PROVIDE 3/4" CONDUIT WITH PULL WIRE. GENERAL CONTRACTOR TO COORDINATE WITH SYSTEM INSTALLER.
- 3. THE ELECTRICAL CONTRACTOR SHALL BE REQUIRED TO FURNISH AND INSTALL A CODE-COMPLIANT DISCONNECTING MEANS FOR EACH PIECE OF EQUIPMENT IDENTIFIED IN THE ELECTRICAL CONNECTION SCHEDULE AS REQUIRING A DIRECT CONNECTION OR PROVIDE A LOCK-OFF TYPE BREAKER AS SHOWN IN THE PANEL SCHEDULE ON SHEET E202. ALL DISCONNECTS SHALL BE NEMA 4X. DISCONNECTS SHALL BE FUSED WHERE REQUIRED BY N.E.C. (TYPICAL).

#### BARNES&NOBLE



PROJECT DESIGNER:



#### ARCHITECT:

JOEL TORIELLI 422 BOGERT AVE RIDGEWOOD, NJ 07450

Kenneth A. Fuller, P.E. Rockaway, NJ 07866 Tel: 973-784-4258 KENNETH A. FULLER, P.E. WA. LICENSE NUMBER: 44523 EXPIRES 09-22-26

SOUTH HILL MALL 3500 S. MERIDIAN UNIT #800 PUYALLUP, WA 98373 Project Number 33247


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12-19-24	ISSUED FOR PERMIT, BID, LANDLORD & CLIENT REVIEW	
02-20-25	BUILDING DEPARTMENT AND LANDLORD COMMENTS	<u>-</u>
05-16-25	ISSUED FOR CONSTRUCTION	Z
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These plans are an instrument of service and the property of the Architect, infringements will be General Contractor to verify all conditions and dimensions at the premises. Discrepancies shall be

reported to the Architect prior to the commencement of any work. Professional Seal:

Drawing Description: ENLARGED KITCHEN POWER PLANS

Drawing Number:

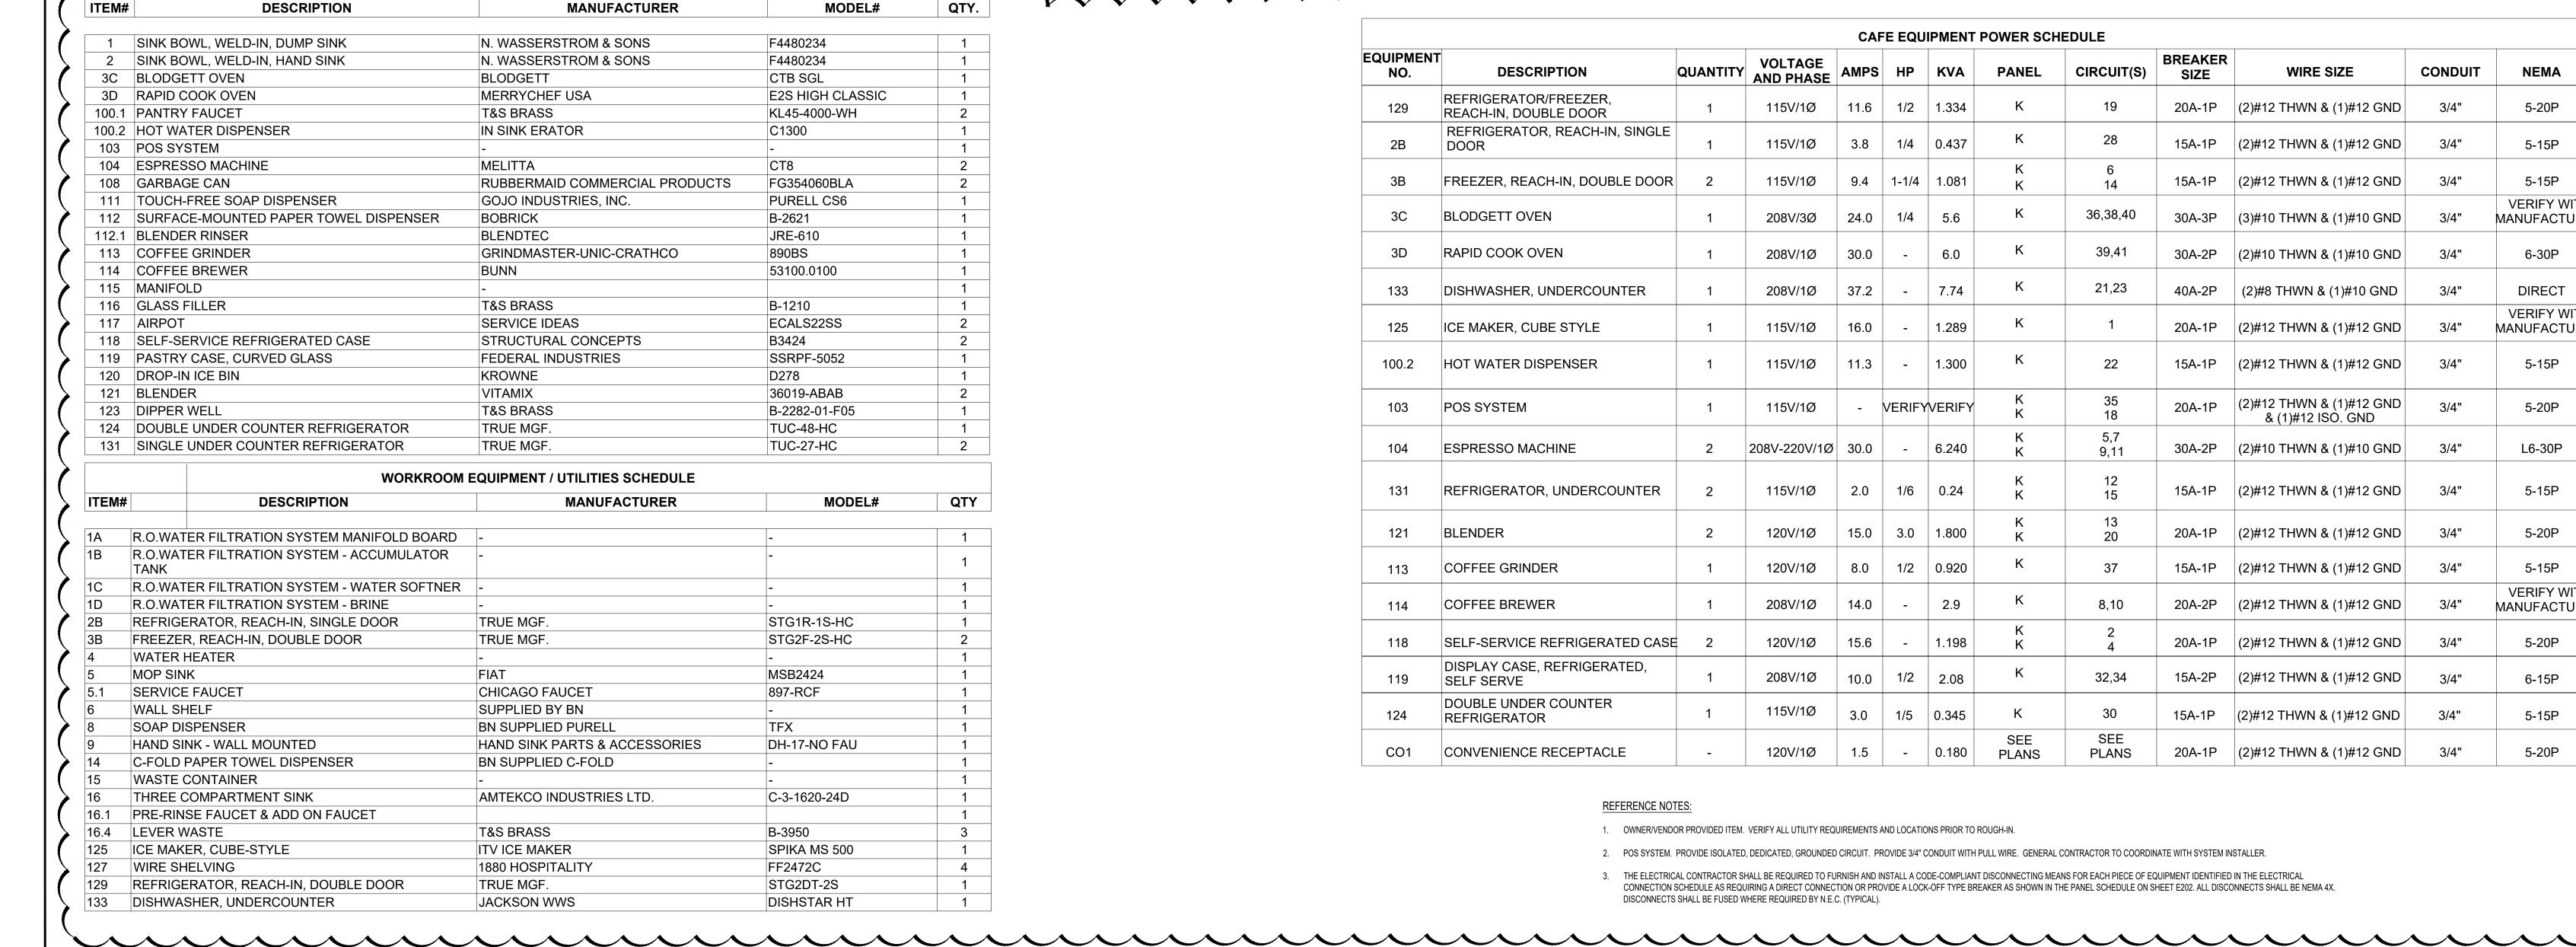

FOOD SERVICE EQUIPMENT / UTILITIES SCHEDULE

MANUFACTURER

**DESCRIPTION** 

SYMBOL	TAG	LOAD	DESCRIPTION	AREA
(i)	НВ	(VAE) 15	HIGH BAY HALOGEN LIGHTINGS NUVO SF76-283, L16A19N153OK FINISH: WHITE	SUSPENDED IN SALES FLOOR AT 8'-0" A.F.F.
	HB-B	15	HIGH BAY HALOGEN LIGHTINGS NUVO SF76-283, L16A19N1530K FINISH : BLACK	SUSPENDED ABOVE CAFE SEATING AREA AT 8'-0" A.F.F.
	LW-01	22	NEW TRACK HEADS  MANUFACTURER: ATTAIN LED  TRACK HEAD HP  MODEL: AT-25-35-95-24-WH-J	TRACK MOUNTED IN SALES AREA
	LWT-01 TRACK	-	NEW PENDANT MOUNTED  MANUFACTURER: CONTECH  SINGLE CIRCUIT LINE VOLTAGE  TRACK VARIOUS LENGTHS-  WHITE  UNISTRUT AND HANGING  HARDWARE	SUSPENDED IN SALES FLOOR AT 12'-0" A.F.F.
0 0	A1	68	BOH LIGHTING  MANUFACTURER: LITHONIA  LIGHTING  MODEL:  TZL1N LED L96 10000LM FST  MVOLT 30K 80CRI PLR E7W WH	SUSPENDED AT 12'-0" A.F.F. IN STOCK ROOM
A2	A2	-	OFFICE AND BREAK ROOM LIGHTING MANUFACTURER: DT BY TCP MODEL:DTF2UZD3835K	LAY-IN CEILING
A3	A3	46	ATTAIN 2 FT. X 4 FT. INTEGRATED LED 4000 LUMENS 4000K 120V COMMERCIAL GRADE RECESSED TROFFER W/ PRISMATIC LENSES	LAY-IN CEILING
0 0	A14	34	MANUFACTURER: LITHONIA LIGHTING MODELS: ZL1N LED STRIPLIGHT L48 5000LM FST MVOLT 30K 80CRI PLR E7W WH	SURFACE MOUNTED TO CEILING OR SUSPENDED AT 12FT A.F.F.
X1	X1	3.8	THERMOPLASTIC LED EXIT SIGN MANUFACTURER: BEST LIGHTING MODEL: EZXTEU-2RW-EM	SUSPENDED OR WALL MOUNTED AT 8'-0" A.F.F. MIN. B.O. SIGN
X2	X2	5	LED EXIT SIGN AND EMERGENCY LIGHT, THERMOPLASTIC COMBO MANUFACTURER: BEST LIGHTING MODEL: LEDCXTEU-2-R-W-RC	SUSPENDED OR WALL MOUNTED AT 8'-0" A.F.F. MIN. B.O. FIXTURE
EM1	EM1	5	EMERGENCY LIGHT MANUFACTURER: ASTRALITE MODEL: EU-5-LED	SUSPENDED OR WA MOUNTED AT 10'-0" A.F.F. MIN. B.O. FIXTURE (SALES AREA) OR AS HIGH AS POSSIBLE (NON-SALES)
EM2	EM2	2	EXTERIOR EMERGENCY LIGHT MANUFACTURER: BEST LIGHTING MODEL: LED HIGH LUMEN THERMOPLASTIC HPEM	WALL MOUNTED AT 8'-0" A.F.F. MIN. B.O. FIXTURE
<b>\( \phi\)</b>	D4	12	4" DIAMETER LED DOWNLIGHT MANUFACTURER: ATTAIN LED MODEL: AT-DL4-12-35-WH	RECESSED IN CAFE CEILING
	D6	32	6" DIAMETER LED DOWNLIGHT MANUFACTURER: MAXI LUME MODEL: H6-LED-2000L-DIM10-120- MD-35K-90/ L607 SHZ WH	RECESSED IN RESTROOM CEILING
	PD1	60	22" DIAMETER LED PENDANT MANUFACTURER: WAYFAIR MODEL: METAIRIE 1 LIGHT SINGLE DOME PENDANT LED TUBE PENDANT ADJUSTABLE MANUFACTURER: CORONET LED MODEL:	SUSPENDED ABOVE CASHWRAP AT 7'-6" AFF FROM J-BOX AT DECK  SUSPENDED ABOVE COUNTER AT 9'-0" AFF
	L-8	80	8ft: CRD3-8-30-HIGH-UNV-DB-BLK -AC-SD	
	L-6	60	6ft: CRD3-6-30-HIGH-UNV-DB-BLK	
	L-4	40	-AC-SD 4ft: CRD3-4-30-HIGH-UNV-DB-BLK	
	L-2	20	-AC-SD 2ft:	
OC) LS	OCCUPANCY SENSOR (LIGHTSTAT)		CRD3-2-30-HIGH-UNV-DB-BLK -AC-SD	DECK MOUNTED J-BOX WITH 3/4" CONDUIT DROP

## LIGHTING FIXTURE SCHEDULE NOTES:

- 1. PROVIDE WITH INTEGRAL EMERGENCY BATTERY PACK. EMERGENCY BATTERY PACKS SHALL PROVIDE A MINIMUM OF NINETY (90) MINUTES OF CODE REQUIRED EMERGENCY LIGHTING. EACH BATTERY PACK PROVIDED SHALL PRODUCE THE MAXIMUM LUMEN OUTPUT AVAILABLE WITH THE MAXIMUM NUMBER OF LAMPS. BODINE OR APPROVED EQUAL. CIRCUIT BATTERY PACK AHEAD OF ALL LIGHTING CONTROLS.
- 2. REFER TO ARCHITECTURAL REFLECTED CEILING PLAN AND/OR ROOM FINISH SCHEDULE TO DETERMINE PROPER TYPE OF LIGHT FIXTURE REQUIRED FOR THE CEILING CONSTRUCTION PRIOR TO ORDERING THE FIXTURES & PROVIDE FIXTURES THAT ARE COMPATIBLE WITH THE CEILING SYSTEM.
- NOT USED
- NOT USED
- NOT USED
- 8. VERIFY ALL INFORMATION MARKED AS "TBD" WITH BARNES & NOBLE PROJECT MANAGER AND THE ARCHITECT PRIOR TO PURCHASE.
- 9. VERIFY ALL MOUNTING HEIGHTS AND METHODS WITH ARCHITECT PRIOR TO INSTALLATION / ROUGH-IN.

SYMBOL	TAG	DESCRIPTION	MOUNTING HEIGHT
OC <sub>LS</sub>	OCCUPANCY SENSOR (LIGHTSTAT)	DECK MOUNTED J-BOX WITH 3/4" CONDUIT DROP	10'-6" AFF
<b>(S1)</b>	SPEAKER	В	LAY -IN CEILING
(S2)	SPEAKER	PROVIDE J-BOX MOUNTED TO DEC	MATCH HEIGHT BOTTOM OF LIGHT GRID
(CC)	CCTV	PROVIDE SURFACE MOUNTED J-BOX WITH 3/4" CONDUIT AND SWIVEL MOUNTED J-BOX	MATCH HEIGHT BOTTOM OF LIGHT GRID
©C <sub>c</sub>	CCTV	PROVIDE 3/4" CONDUIT THROUGH CEILING TO ABOVE VESTIBULE	CEILING MOUNTED
(CC) <sub>W</sub>	CCTV	PROVIDE 3/4" CONDUIT SLEEVE THRU WALL 12"-15" ABOVE CENTRE OF DOOR FRAME	WALL MOUNTED
M	MOTION DETECTOR	DECK MOUNTED J-BOX WITH 3/4" CONDUIT DROP	10'-6" AFF
KP	KEYPAD	PROVIDE 3/4" CONDUIT FLUSH AND CENTERED 48" AFF TO ABOVE VESTIBULE WITH PULL STRING. SEE ELECTRICAL DRAWINGS FOR OUTLET	48" AFF
(CBA)	CELL BOOST ANTENA	DUPLEX OUTLET MOUNTED IN THE CEILING. SEE ELECTRICAL DRAWINGS FOR OUTLET.	MATCH HEIGHT BOTTOM OF LIGHT GRID
(AP)	ACCESS POINT	PROVIDE SURFACE MOUNTED J-BOX WITH 3/4" CONDUIT AND SWIVEL MOUNTED J-BOX	MATCH HEIGHT BOTTOM OF LIGHT GRID
(DECT)	ANTENNA	PROVIDE SURFACE MOUNTED J-BOX WITH 3/4" CONDUIT AND SWIVEL MOUNTED J-BOX, FOR BN INTERNAL PHONE SYSTEM, 2-TOTAL, 1-FRONT, 1-BACK SALES ONLY	MATCH HEIGHT BOTTOM OF LIGHT GRID
EAS-WM	SECURITY PADDLE	PROVIDE 3/4" CONDUIT FLUSH AND CENTERED ON WOOD FRAME FROM 48" AFF TO ABOVE CEILING IN CORRIDOR. SEE ELECTRICAL DRAWINGS FOR OUTLET	WALL MOUNTED 48" AFF
EAS-FM	SECURITY PADDLE	PROVIDE 1" CONDUIT FROM SLAB TO ABOVE VESTIBULE CEILING. BOTH OUTLETS ON SAME CIRCUIT. SEE ELECTRICAL DRAWINGS FOR OUTLET	FLOOR MOUNTE 24" FROM VESTIBULE TO CENTRELINE
(GB)	-		WALL MOUNTED

1. GENERAL CONTRACTOR SHALL COORDINATE FINAL LOCATIONS FOR

2. CAMERAS SHOULD NOT BE PLACED WHERE NOT OBSTRUCTED BY

LOW VOLTAGE DEVICES WITH INDIVIDUAL LV VENDORS.

AWNING, STOREFRONT ETC.

<ol> <li>3.</li> <li>4.</li> <li>6.</li> <li>7.</li> <li>8.</li> </ol>	REFER TO ARCHITECTURAL REFLECTED CEILING PLANS FOR EXACT LOCATION OF LIGHT FIXTURES. CONTRACTORS TO COORDINATE LOCATIONS OF LIGHTING, SPEAKERS, AIR DIFFUSERS, GRILLES, SPRINKLER HEADS & THE LIKE, WITH REFLECTED CEILING LAY-OUTS AS REQUIRED & DIRECTED BY THE ARCHITECT.  ALL DEVICES, EQUIPMENT, FIXTURES, & THE LIKE, MUST BE GROUNDED BY USE OF A PROPERLY SIZED GROUNDING CONDUCTOR. MECHANICAL ELECTRICAL BONDS OF THE METALLIC RACEWAY SYSTEM SHALL ALSO BE MAINTAINED.  REFER TO MECHANICAL, PLUMBING, AND FIRE PROTECTION PLANS FOR EXACT LOCATION OF MECHANICAL AND PLUMBING EQUIPMENT. COORDINATE LOCATION OF DISCONNECT SWITCH ASSOCIATED WITH EACH PIECE OF EQUIPMENT WITH RESPECTIVE CONTRACTOR AND INSTALL IN ACCORDANCE WITH THE NEC.  REFER TO DIVISION 15 (21, 22 & 23) SPECIFICATIONS, HVAC, PLUMBING AND FIRE PROTECTION PLANS FOR ADDITIONAL ELECTRICAL WORK REQUIREMENTS & COORDINATION.  ALL RECEPTACLES SHOWN BACK-TO-BACK IN WALLS SHALL BE SEPARATED HORIZONTALLY BY 8" MINIMUM.  WHERE OPEN WIRING METHODS FOR LOW VOLTAGE SYSTEMS ARE PERMITTED BY THE CONTRACT DOCUMENTS AND LOCAL AUTHORITY, THE CONDUCTOR INSULATION MUST BE PLENUM RATED.  BRANCH CIRCUIT CONDUCTOR SIZES (& CONDUITS) SHALL BE INCREASED FROM THOSE INDICATED ON THE PLANS TO PREVENT EXCESSIVE VOLTAGE DROP, BRANCH CIRCUITS SHALL BE INSTALLED WITH WIRES OF SUFFICIENT SIZES OTHAT VOLTAGE DROP BETWEEN THE PANEL & THE LOADS DO NOT EXCEED A LIMIT OF 3%.  REGARDLESS OF THE TEMPERATURE RATING OF THE CONDUCTOR INSULATION, ALL CONDUCTOR AMPACITY RATINGS FOR THIS PROJECT SHALL BE DETERMINED FROM THE 75"C CONDUCTOR SHALL BE LIMITED TO ITS ASSOCIATED 60"C RATING AS INDICATED IN THE NEC TABLES. WHERE EQUIPMENT OR DEVICES ARE PROVIDED WITH TERMINALS/LUGS RATED FOR 60"C, THE AMPACITY RATING OF THE 75"C CONDUCTOR SHALL BE LECTRICAL CONTRACTOR SHALL BE RESPONSIBLE TO INCREASE THE CONDUCTORS AND CONDUIT SIZE AS REQUIRED.  ALL 120V AND 277V BRANCH CIRCUITS SHALL BE PROVIDED WITH SEPARATE NEUTRAL CONDUCTORS. SHARED NEUTRALS WILL NOT BE PERMITTED FOR MULTI-CIRCUIT INSTALLATIONS. WHERE MULTIPLE	A AC AFC AFF AFG AHU AIC  ARCH. ATS AWG BKR BLDG. C CATV CCTV CH CONTR CT CU CUH DE DN DS DWG. (E) or EXIST. EBB E.C. EF EH ELEC. EM EMT EQ. ETR EUH EWC EWH F FA FACP FC FLUOR FPB F.P.C.	
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<ol> <li>3.</li> <li>4.</li> <li>6.</li> <li>7.</li> <li>8.</li> </ol>	LAY-OUTS AS REQUIRED & DIRECTED BY THE ARCHITECT.  ALL DEVICES, EQUIPMENT, FIXTURES, & THE LIKE, MUST BE GROUNDED BY USE OF A PROPERLY SIZED GROUNDING CONDUCTOR. MECHANICAL/ ELECTRICAL BONDS OF THE METALLIC RACEWAY SYSTEM SHALL ALSO BE MAINTAINED.  REFER TO MECHANICAL, PLUMBING, AND FIRE PROTECTION PLANS FOR EXACT LOCATION OF MECHANICAL AND PLUMBING EQUIPMENT. COORDINATE LOCATION OF DISCONNECT SWITCH ASSOCIATED WITH EACH PIECE OF EQUIPMENT WITH RESPECTIVE CONTRACTOR AND INSTALL IN ACCORDANCE WITH THE NEC.  REFER TO DIVISION 15 (21, 22 & 23) SPECIFICATIONS, HVAC, PLUMBING AND FIRE PROTECTION PLANS FOR ADDITIONAL ELECTRICAL WORK REQUIREMENTS & COORDINATION.  ALL RECEPTACLES SHOWN BACK-TO-BACK IN WALLS SHALL BE SEPARATED HORIZONTALLY BY 8" MINIMUM.  WHERE OPEN WIRING METHODS FOR LOW VOLTAGE SYSTEMS ARE PERMITTED BY THE CONTRACT DOCUMENTS AND LOCAL AUTHORITY, THE CONDUCTOR INSULATION MUST BE PLENUM RATED.  BRANCH CIRCUIT CONDUCTOR SIZES (& CONDUITS) SHALL BE INCREASED FROM THOSE INDICATED ON THE PLANS TO PREVENT EXCESSIVE VOLTAGE DROP. BRANCH CIRCUITS SHALL BE INSTALLED WITH WIRES OF SUFFICIENT SIZE SO THAT VOLTAGE DROP BETWEEN THE PANEL & THE LOADS DO NOT EXCEED A LIMIT OF 3%.  REGARDLESS OF THE TEMPERATURE RATING OF THE CONDUCTOR INSULATION, ALL CONDUCTOR AMPACITY RATINGS FOR THIS PROJECT SHALL BE DETERMINED FROM THE 75°C CONDUCTOR SHALL BE DETERMINED FROM THE 75°C CONDUCTOR SHALL BE LIMITED TO ITS ASSOCIATED 60°C RATING AS INDICATED IN THE NEC TABLES. WHERE EQUIPMENT OR DEVICES ARE PROVIDED WITH TERMINALS/LUGS RATED FOR 60°C, THE AMPACITY RATING OF THE 75°C CONDUCTOR SHALL BE LIMITED TO ITS ASSOCIATED 60°C RATING AS INDICATED IN THE NEC TABLES. THE ELECTRICAL CONTRACTOR SHALL BE RESPONSIBLE TO INCREASE THE CONDUCTORS AND CONDUIT SIZE AS REQUIRED.  ALL 120V AND 277V BRANCH CIRCUITS SHALL BE PROVIDED WITH SEPARATE NEUTRAL CONDUCTORS. SHARED NEUTRALS WILL NOT BE PERMITTED FOR MULTI-CIRCUIT INSTALLATIONS. WHERE MULTIPLE CIRCUITS ARE RUN IN A COMMON RACEWAY, THE	AIC  ARCH.  ATS  AWG  BKR  BLDG.  C  CATV  CCTV  CH  CONTR  CT  CU  CUH  DE  DN  DS  DWG.  (E) or EXIST.  EBB  E.C.  EF  EH  ELEC.  EM  EMT  EQ.  ETR  EUH  EWC  EWH  F  FA  FACP  FC  FLUOR  FPB	ASYMMETRICAL INTERRUPTING CURRENT ARCHITECTURAL AUTOMATIC TRANSFER SWITCH AMERICAN WIRE GAGE BREAKER BUILDING CONDUIT CABLE TELEVISION CLOSED CIRCUIT TELEVISION CHILLER CONTRACTOR COPPER CABINET UNIT HEATER DUAL ELEMENT DOWN DISCONNECT SWITCH DRAWING EXISTING ELECTRICAL CONTRACTOR ELECTRICAL CONTRACTOR ELECTRICAL EMERGENCY ELECTRICAL EMERGENCY ELECTRICAL METALLIC TUBING EQUAL EXISTING TO REMAIN ELECTRIC WATER COOLER ELECTRIC WATER COOLER ELECTRIC WATER COOLER ELECTRIC WATER HEATER FUSE FIRE ALARM
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<ol> <li>4.</li> <li>6.</li> <li>8.</li> </ol>	METALLIC RACEWAY SYSTEM SHALL ALSO BE MAINTAINED.  REFER TO MECHANICAL, PLUMBING, AND FIRE PROTECTION PLANS FOR EXACT LOCATION OF MECHANICAL AND PLUMBING EQUIPMENT. COORDINATE LOCATION OF DISCONNECT SWITCH ASSOCIATED WITH EACH PIECE OF EQUIPMENT WITH RESPECTIVE CONTRACTOR AND INSTALL IN ACCORDANCE WITH THE NEC.  REFER TO DIVISION 15 (21, 22 & 23) SPECIFICATIONS, HVAC, PLUMBING AND FIRE PROTECTION PLANS FOR ADDITIONAL ELECTRICAL WORK REQUIREMENTS & COORDINATION.  ALL RECEPTACLES SHOWN BACK-TO-BACK IN WALLS SHALL BE SEPARATED HORIZONTALLY BY 8" MINIMUM.  WHERE OPEN WIRING METHODS FOR LOW VOLTAGE SYSTEMS ARE PERMITTED BY THE CONTRACT DOCUMENTS AND LOCAL AUTHORITY, THE CONDUCTOR INSULATION MUST BE PLENUM RATED.  BRANCH CIRCUIT CONDUCTOR SIZES (& CONDUITS) SHALL BE INCREASED FROM THOSE INDICATED ON THE PLANS TO PREVENT EXCESSIVE VOLTAGE DROP. BRANCH CIRCUITS SHALL BE INSTALLED WITH WIRES OF SUFFICIENT SIZE SO THAT VOLTAGE DROP BETWEEN THE PANEL & THE LOADS DO NOT EXCEED A LIMIT OF 3%.  REGARDLESS OF THE TEMPERATURE RATING OF THE CONDUCTOR INSULATION, ALL CONDUCTOR AMPACITY RATINGS FOR THIS PROJECT SHALL BE DETERMINED FROM THE 75°C CONDUCTOR TEMPERATURE RATINGS INDICATED IN THE NEC TABLES. WHERE EQUIPMENT OR DEVICES ARE PROVIDED WITH TERMINALS/LUGS RATED FOR 60°C, THE AMPACITY RATING OF THE 75°C CONDUCTOR SHALL BE LIMITED TO ITS ASSOCIATED 60°C RATING AS INDICATED IN THE NEC TABLES. THE ELECTRICAL CONTRACTOR SHALL BE RESPONSIBLE TO INCREASE THE CONDUCTORS AND CONDUIT SIZE AS REQUIRED.  ALL 120V AND 277V BRANCH CIRCUITS SHALL BE PROVIDED WITH SEPARATE NEUTRAL CONDUCTORS. SHARED NEUTRALS WILL NOT BE PERMITTED FOR MULTI-CIRCUIT INSTALLATIONS. WHERE MULTIPLE CIRCUITS ARE RUN IN A COMMON RACEWAY, THE	AWG BKR BLDG. C CATV CCTV CH CONTR CT CU CUH DE DN DS DWG. (E) or EXIST. EBB E.C. EF EH ELEC. EM EMT EQ. ETR EUH EWC EWH F FA FACP FC FLUOR FPB	
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<ul><li>4.</li><li>5.</li><li>6.</li><li>7.</li><li>8.</li></ul>	LOCATION OF MECHANICAL AND PLUMBING EQUIPMENT. COORDINATE LOCATION OF DISCONNECT SWITCH ASSOCIATED WITH EACH PIECE OF EQUIPMENT WITH RESPECTIVE CONTRACTOR AND INSTALL IN ACCORDANCE WITH THE NEC.  REFER TO DIVISION 15 (21, 22 & 23) SPECIFICATIONS, HVAC, PLUMBING AND FIRE PROTECTION PLANS FOR ADDITIONAL ELECTRICAL WORK REQUIREMENTS & COORDINATION.  ALL RECEPTACLES SHOWN BACK-TO-BACK IN WALLS SHALL BE SEPARATED HORIZONTALLY BY 8" MINIMUM.  WHERE OPEN WIRING METHODS FOR LOW VOLTAGE SYSTEMS ARE PERMITTED BY THE CONTRACT DOCUMENTS AND LOCAL AUTHORITY, THE CONDUCTOR INSULATION MUST BE PLENUM RATED.  BRANCH CIRCUIT CONDUCTOR SIZES (& CONDUITS) SHALL BE INCREASED FROM THOSE INDICATED ON THE PLANS TO PREVENT EXCESSIVE VOLTAGE DROP. BRANCH CIRCUITS SHALL BE INSTALLED WITH WIRES OF SUFFICIENT SIZE SO THAT VOLTAGE DROP BETWEEN THE PANEL & THE LOADS DO NOT EXCEED A LIMIT OF 3%.  REGARDLESS OF THE TEMPERATURE RATING OF THE CONDUCTOR INSULATION, ALL CONDUCTOR AMPACITY RATINGS FOR THIS PROJECT SHALL BE DETERMINED FROM THE 75°C CONDUCTOR TEMPERATURE RATINGS INDICATED IN THE NEC TABLES. WHERE EQUIPMENT OR DEVICES ARE PROVIDED WITH TERMINALS/LUGS RATED FOR 60°C, THE AMPACITY RATING OF THE 75°C CONDUCTOR SHALL BE LIMITED TO ITS ASSOCIATED 60°C RATING AS INDICATED IN THE NEC TABLES. THE ELECTRICAL CONTRACTOR SHALL BE RESPONSIBLE TO INCREASE THE CONDUCTORS AND CONDUIT SIZE AS REQUIRED.  ALL 120V AND 277V BRANCH CIRCUITS SHALL BE PROVIDED WITH SEPARATE NEUTRAL CONDUCTORS. SHARED NEUTRALS WILL NOT BE PERMITTED FOR MULTI-CIRCUIT INSTALLATIONS. WHERE MULTIPLE CIRCUITS ARE RUN IN A COMMON RACEWAY, THE	C CATV CCTV CH CONTR CT CU CUH DE DN DS DWG. (E) or EXIST. EBB E.C. EF EH ELEC. EM EMT EQ. ETR EUH EWC EWH F FA FACP FC FLUOR FPB	CONDUIT CABLE TELEVISION CLOSED CIRCUIT TELEVISION CHILLER CONTRACTOR COOLING TOWER COPPER CABINET UNIT HEATER DUAL ELEMENT DOWN DISCONNECT SWITCH DRAWING EXISTING ELECTRIC BASEBOARD ELECTRICAL CONTRACTOR EXHAUST FAN ELECTRICAL EMERGENCY ELECTRICAL EMERGENCY ELECTRICAL METALLIC TUBING EQUAL EXISTING TO REMAIN ELECTRIC WATER COOLER ELECTRIC WATER COOLER ELECTRIC WATER HEATER FUSE FIRE ALARM
<ul><li>4.</li><li>5.</li><li>6.</li><li>7.</li><li>8.</li></ul>	DISCONNECT SWITCH ASSOCIATED WITH EACH PIECE OF EQUIPMENT WITH RESPECTIVE CONTRACTOR AND INSTALL IN ACCORDANCE WITH THE NEC.  REFER TO DIVISION 15 (21, 22 & 23) SPECIFICATIONS, HVAC, PLUMBING AND FIRE PROTECTION PLANS FOR ADDITIONAL ELECTRICAL WORK REQUIREMENTS & COORDINATION.  ALL RECEPTACLES SHOWN BACK-TO-BACK IN WALLS SHALL BE SEPARATED HORIZONTALLY BY 8" MINIMUM.  WHERE OPEN WIRING METHODS FOR LOW VOLTAGE SYSTEMS ARE PERMITTED BY THE CONTRACT DOCUMENTS AND LOCAL AUTHORITY, THE CONDUCTOR INSULATION MUST BE PLENUM RATED.  BRANCH CIRCUIT CONDUCTOR SIZES (& CONDUITS) SHALL BE INCREASED FROM THOSE INDICATED ON THE PLANS TO PREVENT EXCESSIVE VOLTAGE DROP. BRANCH CIRCUITS SHALL BE INSTALLED WITH WIRES OF SUFFICIENT SIZE SO THAT VOLTAGE DROP BETWEEN THE PANEL & THE LOADS DO NOT EXCEED A LIMIT OF 3%.  REGARDLESS OF THE TEMPERATURE RATING OF THE CONDUCTOR INSULATION, ALL CONDUCTOR AMPACITY RATINGS FOR THIS PROJECT SHALL BE DETERMINED FROM THE 75°C CONDUCTOR TEMPERATURE RATINGS INDICATED IN THE NEC TABLES. WHERE EQUIPMENT OR DEVICES ARE PROVIDED WITH TERMINALS/LUGS RATED FOR 60°C, THE AMPACITY RATING OF THE 75°C CONDUCTOR SHALL BE LIMITED TO ITS ASSOCIATED 60°C RATING AS INDICATED IN THE NEC TABLES. THE ELECTRICAL CONTRACTOR SHALL BE RESPONSIBLE TO INCREASE THE CONDUCTORS AND CONDUIT SIZE AS REQUIRED.  ALL 120V AND 277V BRANCH CIRCUITS SHALL BE PROVIDED WITH SEPARATE NEUTRAL CONDUCTORS. SHARED NEUTRALS WILL NOT BE PERMITTED FOR MULTI-CIRCUIT INSTALLATIONS. WHERE MULTIPLE CIRCUITS ARE RUN IN A COMMON RACEWAY, THE	CCTV CH CONTR CT CU CUH DE DN DS DWG. (E) or EXIST. EBB E.C. EF EH ELEC. EM EMT EQ. ETR EUH EWC EWH F FA FACP FC FLUOR FPB	CLOSED CIRCUIT TELEVISION CHILLER CONTRACTOR COOLING TOWER COPPER CABINET UNIT HEATER DUAL ELEMENT DOWN DISCONNECT SWITCH EXISTING EXISTING ELECTRIC BASEBOARD ELECTRICAL CONTRACTOR EXHAUST FAN ELECTRICAL EMERGENCY ELECTRICAL EMERGENCY ELECTRICAL METALLIC TUBING EQUAL EXISTING TO REMAIN ELECTRIC WATER COOLER ELECTRIC WATER COOLER FIRE ALARM
<ul><li>4.</li><li>5.</li><li>6.</li><li>7.</li><li>8.</li></ul>	REFER TO DIVISION 15 (21, 22 & 23) SPECIFICATIONS, HVAC, PLUMBING AND FIRE PROTECTION PLANS FOR ADDITIONAL ELECTRICAL WORK REQUIREMENTS & COORDINATION.  ALL RECEPTACLES SHOWN BACK-TO-BACK IN WALLS SHALL BE SEPARATED HORIZONTALLY BY 8" MINIMUM.  WHERE OPEN WIRING METHODS FOR LOW VOLTAGE SYSTEMS ARE PERMITTED BY THE CONTRACT DOCUMENTS AND LOCAL AUTHORITY, THE CONDUCTOR INSULATION MUST BE PLENUM RATED.  BRANCH CIRCUIT CONDUCTOR SIZES (& CONDUITS) SHALL BE INCREASED FROM THOSE INDICATED ON THE PLANS TO PREVENT EXCESSIVE VOLTAGE DROP. BRANCH CIRCUITS SHALL BE INSTALLED WITH WIRES OF SUFFICIENT SIZE SO THAT VOLTAGE DROP BETWEEN THE PANEL & THE LOADS DO NOT EXCEED A LIMIT OF 3%.  REGARDLESS OF THE TEMPERATURE RATING OF THE CONDUCTOR INSULATION, ALL CONDUCTOR AMPACITY RATINGS FOR THIS PROJECT SHALL BE DETERMINED FROM THE 75°C CONDUCTOR TEMPERATURE RATINGS INDICATED IN THE NEC TABLES. WHERE EQUIPMENT OR DEVICES ARE PROVIDED WITH TERMINALS/LUGS RATED FOR 60°C, THE AMPACITY RATING OF THE 75°C CONDUCTOR SHALL BE LIMITED TO ITS ASSOCIATED 60°C RATING AS INDICATED IN THE NEC TABLES. THE ELECTRICAL CONTRACTOR SHALL BE RESPONSIBLE TO INCREASE THE CONDUCTORS AND CONDUIT SIZE AS REQUIRED.  ALL 120V AND 277V BRANCH CIRCUITS SHALL BE PROVIDED WITH SEPARATE NEUTRAL CONDUCTORS. SHARED NEUTRALS WILL NOT BE PERMITTED FOR MULTI-CIRCUIT INSTALLATIONS. WHERE MULTIPLE CIRCUITS ARE RUN IN A COMMON RACEWAY, THE	CH CONTR CT CU CUH DE DN DS DWG. (E) OF EXIST. EBB E.C. EF EH ELEC. EM EMT EQ. ETR EUH EWC EWH F FA FACP FC FLUOR FPB	CHILLER CONTRACTOR COOLING TOWER COPPER CABINET UNIT HEATER DUAL ELEMENT DOWN DISCONNECT SWITCH DRAWING EXISTING ELECTRIC BASEBOARD ELECTRICAL CONTRACTOR EXHAUST FAN ELECTRICAL EMERGENCY ELECTRICAL EMERGENCY ELECTRICAL METALLIC TUBING EQUAL EXISTING TO REMAIN ELECTRIC WATER COOLER ELECTRIC WATER COOLER FIRE ALARM FIRE ALARM FIRE ALARM FIRE ALARM
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<ul><li>7.</li><li>8.</li><li>9.</li></ul>	CONTRACT DOCUMENTS AND LOCAL AUTHORITY, THE CONDUCTOR INSULATION MUST BE PLENUM RATED.  BRANCH CIRCUIT CONDUCTOR SIZES (& CONDUITS) SHALL BE INCREASED FROM THOSE INDICATED ON THE PLANS TO PREVENT EXCESSIVE VOLTAGE DROP. BRANCH CIRCUITS SHALL BE INSTALLED WITH WIRES OF SUFFICIENT SIZE SO THAT VOLTAGE DROP BETWEEN THE PANEL & THE LOADS DO NOT EXCEED A LIMIT OF 3%.  REGARDLESS OF THE TEMPERATURE RATING OF THE CONDUCTOR INSULATION, ALL CONDUCTOR AMPACITY RATINGS FOR THIS PROJECT SHALL BE DETERMINED FROM THE 75°C CONDUCTOR TEMPERATURE RATINGS INDICATED IN THE NEC TABLES. WHERE EQUIPMENT OR DEVICES ARE PROVIDED WITH TERMINALS/LUGS RATED FOR 60°C, THE AMPACITY RATING OF THE 75°C CONDUCTOR SHALL BE LIMITED TO ITS ASSOCIATED 60°C RATING AS INDICATED IN THE NEC TABLES. THE ELECTRICAL CONTRACTOR SHALL BE RESPONSIBLE TO INCREASE THE CONDUCTORS AND CONDUIT SIZE AS REQUIRED.  ALL 120V AND 277V BRANCH CIRCUITS SHALL BE PROVIDED WITH SEPARATE NEUTRAL CONDUCTORS. SHARED NEUTRALS WILL NOT BE PERMITTED FOR MULTI-CIRCUIT INSTALLATIONS. WHERE MULTIPLE CIRCUITS ARE RUN IN A COMMON RACEWAY, THE	EBB E.C. EF EH ELEC. EM EMT EQ. ETR EUH EWC EWH F FA FACP FC FLUOR FPB	ELECTRIC BASEBOARDELECTRICAL CONTRACTOR
<ul><li>7.</li><li>8.</li><li>9.</li></ul>	BRANCH CIRCUIT CONDUCTOR SIZES (& CONDUITS) SHALL BE INCREASED FROM THOSE INDICATED ON THE PLANS TO PREVENT EXCESSIVE VOLTAGE DROP. BRANCH CIRCUITS SHALL BE INSTALLED WITH WIRES OF SUFFICIENT SIZE SO THAT VOLTAGE DROP BETWEEN THE PANEL & THE LOADS DO NOT EXCEED A LIMIT OF 3%.  REGARDLESS OF THE TEMPERATURE RATING OF THE CONDUCTOR INSULATION, ALL CONDUCTOR AMPACITY RATINGS FOR THIS PROJECT SHALL BE DETERMINED FROM THE 75°C CONDUCTOR TEMPERATURE RATINGS INDICATED IN THE NEC TABLES. WHERE EQUIPMENT OR DEVICES ARE PROVIDED WITH TERMINALS/LUGS RATED FOR 60°C, THE AMPACITY RATING OF THE 75°C CONDUCTOR SHALL BE LIMITED TO ITS ASSOCIATED 60°C RATING AS INDICATED IN THE NEC TABLES. THE ELECTRICAL CONTRACTOR SHALL BE RESPONSIBLE TO INCREASE THE CONDUCTORS AND CONDUIT SIZE AS REQUIRED.  ALL 120V AND 277V BRANCH CIRCUITS SHALL BE PROVIDED WITH SEPARATE NEUTRAL CONDUCTORS. SHARED NEUTRALS WILL NOT BE PERMITTED FOR MULTI-CIRCUIT INSTALLATIONS. WHERE MULTIPLE CIRCUITS ARE RUN IN A COMMON RACEWAY, THE	EF EH ELEC. EM EMT EQ. ETR EUH EWC EWH F FA FACP FC FLUOR FPB	EXHAUST FAN
9.	INDICATED ON THE PLANS TO PREVENT EXCESSIVE VOLTAGE DROP, BRANCH CIRCUITS SHALL BE INSTALLED WITH WIRES OF SUFFICIENT SIZE SO THAT VOLTAGE DROP BETWEEN THE PANEL & THE LOADS DO NOT EXCEED A LIMIT OF 3%.  REGARDLESS OF THE TEMPERATURE RATING OF THE CONDUCTOR INSULATION, ALL CONDUCTOR AMPACITY RATINGS FOR THIS PROJECT SHALL BE DETERMINED FROM THE 75°C CONDUCTOR TEMPERATURE RATINGS INDICATED IN THE NEC TABLES. WHERE EQUIPMENT OR DEVICES ARE PROVIDED WITH TERMINALS/LUGS RATED FOR 60°C, THE AMPACITY RATING OF THE 75°C CONDUCTOR SHALL BE LIMITED TO ITS ASSOCIATED 60°C RATING AS INDICATED IN THE NEC TABLES. THE ELECTRICAL CONTRACTOR SHALL BE RESPONSIBLE TO INCREASE THE CONDUCTORS AND CONDUIT SIZE AS REQUIRED.  ALL 120V AND 277V BRANCH CIRCUITS SHALL BE PROVIDED WITH SEPARATE NEUTRAL CONDUCTORS. SHARED NEUTRALS WILL NOT BE PERMITTED FOR MULTI-CIRCUIT INSTALLATIONS. WHERE MULTIPLE CIRCUITS ARE RUN IN A COMMON RACEWAY, THE	EH ELEC. EM EMT EQ. ETR EUH EWC EWH F FA FACP FC FLUOR FPB	
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9.	REGARDLESS OF THE TEMPERATURE RATING OF THE CONDUCTOR INSULATION, ALL CONDUCTOR AMPACITY RATINGS FOR THIS PROJECT SHALL BE DETERMINED FROM THE 75°C CONDUCTOR TEMPERATURE RATINGS INDICATED IN THE NEC TABLES. WHERE EQUIPMENT OR DEVICES ARE PROVIDED WITH TERMINALS/LUGS RATED FOR 60°C, THE AMPACITY RATING OF THE 75°C CONDUCTOR SHALL BE LIMITED TO ITS ASSOCIATED 60°C RATING AS INDICATED IN THE NEC TABLES. THE ELECTRICAL CONTRACTOR SHALL BE RESPONSIBLE TO INCREASE THE CONDUCTORS AND CONDUIT SIZE AS REQUIRED.  ALL 120V AND 277V BRANCH CIRCUITS SHALL BE PROVIDED WITH SEPARATE NEUTRAL CONDUCTORS. SHARED NEUTRALS WILL NOT BE PERMITTED FOR MULTI-CIRCUIT INSTALLATIONS. WHERE MULTIPLE CIRCUITS ARE RUN IN A COMMON RACEWAY, THE	EMT EQ. ETR EUH EWC EWH F FA FACP FC FLUOR FPB	ELECTRICAL METALLIC TUBING EQUAL
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9.	CONDUCTOR AMPACITY RATINGS FOR THIS PROJECT SHALL BE DETERMINED FROM THE 75°C CONDUCTOR TEMPERATURE RATINGS INDICATED IN THE NEC TABLES. WHERE EQUIPMENT OR DEVICES ARE PROVIDED WITH TERMINALS/LUGS RATED FOR 60°C, THE AMPACITY RATING OF THE 75°C CONDUCTOR SHALL BE LIMITED TO ITS ASSOCIATED 60°C RATING AS INDICATED IN THE NEC TABLES. THE ELECTRICAL CONTRACTOR SHALL BE RESPONSIBLE TO INCREASE THE CONDUCTORS AND CONDUIT SIZE AS REQUIRED.  ALL 120V AND 277V BRANCH CIRCUITS SHALL BE PROVIDED WITH SEPARATE NEUTRAL CONDUCTORS. SHARED NEUTRALS WILL NOT BE PERMITTED FOR MULTI-CIRCUIT INSTALLATIONS. WHERE MULTIPLE CIRCUITS ARE RUN IN A COMMON RACEWAY, THE	ETR EUH EWC EWH F FA FACP FC FLUOR FPB	EXISTING TO REMAIN ELECTRIC UNIT HEATER ELECTRIC WATER COOLER FUSE FIRE ALARM FAN COIL UNIT
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9.	AMPACITY RATING OF THE 75°C CONDUCTOR SHALL BE LIMITED TO ITS ASSOCIATED 60°C RATING AS INDICATED IN THE NEC TABLES. THE ELECTRICAL CONTRACTOR SHALL BE RESPONSIBLE TO INCREASE THE CONDUCTORS AND CONDUIT SIZE AS REQUIRED.  ALL 120V AND 277V BRANCH CIRCUITS SHALL BE PROVIDED WITH SEPARATE NEUTRAL CONDUCTORS. SHARED NEUTRALS WILL NOT BE PERMITTED FOR MULTI-CIRCUIT INSTALLATIONS. WHERE MULTIPLE CIRCUITS ARE RUN IN A COMMON RACEWAY, THE	FA FACP FC FLUOR FPB	FUSE FIRE ALARM FIRE ALARM CONTROL PANEL FAN COIL UNIT
9.	60°C RATING AS INDICATED IN THE NEC TABLES. THE ELECTRICAL CONTRACTOR SHALL BE RESPONSIBLE TO INCREASE THE CONDUCTORS AND CONDUIT SIZE AS REQUIRED.  ALL 120V AND 277V BRANCH CIRCUITS SHALL BE PROVIDED WITH SEPARATE NEUTRAL CONDUCTORS. SHARED NEUTRALS WILL NOT BE PERMITTED FOR MULTI-CIRCUIT INSTALLATIONS. WHERE MULTIPLE CIRCUITS ARE RUN IN A COMMON RACEWAY, THE	FACP FC FLUOR FPB	FIRE ALARM CONTROL PANEL FAN COIL UNIT
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	CONDUCTORS. SHARED NEUTRALS WILL NOT BE PERMITTED FOR MULTI-CIRCUIT INSTALLATIONS. WHERE MULTIPLE CIRCUITS ARE RUN IN A COMMON RACEWAY, THE	FPB	FILIORESCENT
	INSTALLATIONS. WHERE MULTIPLE CIRCUITS ARE RUN IN A COMMON RACEWAY, THE		FLOORESCENT FAN POWER BOX (VAV)
	·	F.P.G.	FAN POWER BOX (VAV) FIRE PROTECTION CONTRACTOR
		FS	FLOW SWITCH
	SIZED PER CODE. UNDER NO CIRCUMSTANCES SHALL MORE THAN SIX (6) CURRENT	FT. G.C.	FOOT/FEET GENERAL CONTRACTOR
	CARRYING CONDUCTORS BE RUN IN A SINGLE CONDUIT. REFERENCE NEC ARTICLE AND	GFI	GROUND FAULT INTERRUPTING
	TABLE 310.15(B)(2)(a).	OND	PROTECTION
10.	ALL CONDUITS SHALL CONTAIN A GROUND CONDUCTOR SIZED PER NEC TABLE #250.122.	GND HID	GROUND HIGH INTENSITY DISCHARGE
	IN ADDITION, WHERE AN ISOLATED, INSULATED GROUND IS REQUIRED, A SEPARATE	HOA	HAND-OFF-AUTOMATIC
	GROUND CONDUCTOR WITH GREEN INSULATION SHALL BE RUN FROM THE PANEL	HP HPS	HORSEPOWER
	GROUND BUS TO THE ISOLATED GROUND CONNECTION OF THE DEVICE. IN NO CASE SHALL THE SYSTEM GROUND (CONDUCTOR & ASSOCIATED OUTLET BOXES, CONDUIT &	HVAC	HIGH PRESSURE SODIUM HEATING, VENTILATION, AIR
	BUILDING STEEL) BE ALLOWED TO CONTACT THE ISOLATED GROUND (CONDUCTOR &		CONDITIONING
	DEVICE). WHERE CIRCUIT CONDUCTORS ARE INCREASED IN SIZE FOR VOLTAGE DROP,	IG INCAND.	ISOLATED GROUND INCANDESCENT
	THE GROUND CONDUCTOR SIZE SHALL BE INCREASED PROPORTIONATELY (ACCORDING TO CIRCULAR MIL AREA) FROM THE SIZE REQUIRED BY NEC TABLE #250.122.	JB	INCANDESCENT
	TO CINCOLAR WILL AREA) I NOW THE SIZE REQUIRED BY NEC TABLE #250.122.	KCMIL	ONE THOUSAND CIRCULAR MILS
	ELECTRICAL INSTALLATION REQUIREMENTS FOR ALL HVAC, PLUMBING, FIRE	K.E.C. KVA	KITCHEN EQUIPMENT CONTRACTOR KILOVOLT AMPERE
	PROTECTION, SPECIAL SYSTEMS AND OWNER EQUIPMENT BEING FURNISHED BY OTHERS SHALL BE REVIEWED AND COORDINATED WITH OTHER TRADES PRIOR TO	KW	KILOWATT
	ROUGH-IN. OBTAIN EQUIPMENT SHOP DRAWINGS FROM	LTG MATV	LIGHTING MASTER ANTENNA TV
	INSTALLER/SUPPLIER/CONTRACTOR/OWNER FURNISHING EQUIPMENT, AS REQUIRED,	MAU	MAKE-UP AIR UNIT
	FOR REVIEW AND COORDINATION. CONTACT ARCHITECT/ENGINEER WITH ANY DISCREPANCIES FOUND BETWEEN CONSTRUCTION DRAWINGS AND EQUIPMENT BEING	MAX	MAXIMUM
	FURNISHED PRIOR TO ROUGH-IN.	MCB MCC	MAIN CIRCUIT BREAKER MOTOR CONTROL CENTER
40	THE ELECTRICAL CONTRACTOR CHAIL EURNICH ALL ACCESS RANGES AS REQUIRED	M.C.	MECHANICAL CONTRACTOR
	THE ELECTRICAL CONTRACTOR SHALL FURNISH ALL ACCESS PANELS, AS REQUIRED FOR SERVICING AND TESTING, FOR EQUIPMENT AND/OR DEVICES FURNISHED UNDER	MECH. MFR	MECHANICAL MANUFACTURER
	HIS CONTRACT. THE GENERAL CONTRACTOR SHALL INSTALL ACCESS PANELS. THE	MH	MANOPACTORER METAL HALIDE
	ELECTRICAL CONTRACTOR SHALL COORDINATE THE SIZE AND LOCATION OF EACH ACCESS PANEL WITH THE ARCHITECT AND GENERAL CONTRACTOR PRIOR TO	MIN	MINIMUM
	ROUGH-IN.	MLO MOD	MAIN LUGS ONLY MOTOR OPERATED DAMPER
		MSB	MAIN SWITCHBOARD
	ELECTRICAL CONTRACTOR SHALL INCLUDE IN HIS BID ALL CUTTING, TRENCHING AND PATCHING ASSOCIATED WITH THE ELECTRICAL INSTALLATION.	MTD NEC	MOUNTED NATIONAL ELECTRIC CODE
	THE STATE ACCOUNTED WITH THE ELECTRICAL INCIDENTIAL ATTOM.	NF	NON FUSED
	ALL PENETRATIONS THROUGH FIRE RATED WALLS ASSOCIATED WITH THE ELECTRICAL	NFPA	NATIONAL FIRE PROTECTION ASSOCIATION
	INSTALLATION SHALL BE SLEEVED AND FIRE-STOPPED USING A UL APPROVED METHOD. UL APPROVED METHOD SHALL MEET OR EXCEED FIRE RATING OF STRUCTURE BEING	NIC	ASSOCIATION NOT IN CONTRACT
	PENETRATED. REFERENCE ARCHITECTURAL PLANS FOR FIRE RATED STRUCTURES.	NL	NIGHTLIGHT
		NTS Ø or PH	NOT TO SCALE PHASE
	NO CONDUIT, BOXES, WIRING, OR CABLES SHALL BE INSTALLED WITHIN 1 1/2" OF THE LOWEST POINT OF THE UNDERSIDE OF THE ROOF DECKING, NOR SHALL THEY BE	P	POLE
	INSTALLED CONCEALED WITHIN METAL-CORRUGATED ROOF DECKING. FOR EXISTING	PB P.C.	PULL BOX PLUMBING CONTRACTOR
	INSTALLATIONS, THE ELECTRICAL CONTRACTOR SHALL BE RESPONSIBLE TO REPLACE	P.C. PNL	PLUMBING CONTRACTOR
	AND/OR REWORK EXISTING CONDUIT, BOXES, WIRING, AND CABLING THAT IS NOT IN COMPLIANCE WITH THIS REQUIREMENT.	PRE	POWER ROOF EXHAUSTER
	SS IN THE TREMOREMENT.	PVC RTU	POLYVINYL CHLORIDE ROOF TOP UNIT
	ALL ELECTRICAL EQUIPMENT AND DEVICES FOR THIS PROJECT MUST BE UL LISTED.	SPKR	SPEAKER
	DEVICES, EQUIPMENT, SYSTEMS SHALL BE INSTALLED PER N.E.C. REQUIREMENTS AND MANUFACTURER'S INSTRUCTIONS.	SPST TIE	SINGLE POLE SINGLE THROW
		IIE	MULTIPLE OUTLETS WIRED ON SAME BRANCH CICRUIT
	ALL CONDUIT AND CABLING SHALL BE PROPERLY SUPPORTED AS REQUIRED BY THE	TS	TAMPER SWITCH
	NATIONAL ELECTRICAL CODE. FOR EXISTING INSTALLATIONS, THE ELECTRICAL CONTRACTOR SHALL BE RESPONSIBLE TO REPLACE AND/OR REWORK EXISTING	TTB TV	TELEPHONE TERMINAL BOARD TELEVISION
	CONDUIT AND/OR CABLING THAT IS NOT IN COMPLIANCE WITH THIS REQUIREMENT.	TYP.	TYPICAL
10	CONTRACTOR QUALITIES IN VERSEY OF AR ON CRARE STOOR CONSTRUCTION TYPE	UH	GAS FIRED UNIT HEATER
	CONTRACTOR SHALL FIELD VERIFY SLAB ON GRADE FLOOR CONSTRUCTION TYPE PRIOR TO CUTTING. UNDER NO CIRCUMSTANCES SHALL THE CONTRACTOR CUT A	UL UNO	UNDERWRITER'S LABORATORY UNLESS NOTED OTHERWISE
	STRUCTURAL FLOOR SLAB THICKER THAN FOUR (4") INCHES WITHOUT PRIOR WRITTEN	UV	UNIT VENTILATOR
	APPROVAL FROM ENGINEER OF RECORD. NOTIFY ENGINEER OF RECORD OF ANY SLAB	V W	VOLTS WATTS
	THICKNESS GREATER THAN FOUR (4") INCHES PRIOR TO PROCEEDING WITH ANY SAW CUTTING.	WP	WEATHER-PROOF
		WR	WEATHER-RESISTANT TYPE DEVICE (NEMA 3R RATED)
		X'FMR	(NEMA 3R RATED) TRANSFORMER


	A	 	[	ELEC
	AC AFC	 AIR CONDITIONING UNIT ABOVE FINISH COUNTER	SYMBOL	
OF LIGHT S, AIR	AFF AFG AHU AIC	 ABOVE FINISH FLOOR ABOVE FINISH GRADE AIR HANDLING UNIT ASYMMETRICAL INTERRUPTING		CONDUI IN UNFIN
OF A OF THE	ARCH. ATS AWG	 CURRENT ARCHITECTURAL AUTOMATIC TRANSFER SWITCH AMERICAN WIRE GAGE		MINIMUI CONDUI CONDUI
N OF	BKR BLDG. C CATV	 BREAKER BUILDING CONDUIT CABLE TELEVISION	<b>/</b> -•#-\	CONDUI NUMBEF ALL CON
PECTIVE	CCTV CH	 CLOSED CIRCUIT TELEVISION CHILLER		CODE-S
	CONTR CT CU CUH	 CONTRACTOR COOLING TOWER COPPER CABINET UNIT HEATER		PANELB ONE-LIN
	DE DN DS			DISCON
BY THE I MUST	DWG. (E) or EXIST. EBB E.C.	 DISCONNECT SWITCH DRAWING EXISTINGELECTRIC BASEBOARD	<b>\$</b> <sub>X</sub>	20A - 12 NOTED ( BEING C
1 THOSE	EF EH	 ELECTRICAL CONTRACTOR EXHAUST FAN ELECTRIC HEATER		LINE VO
RCUITS	ELEC. EM EMT EQ.	 ELECTRICAL EMERGENCY ELECTRICAL METALLIC TUBING FOLIAL	\$ <sub>OC</sub>	TOP OF WATTS1
, ALL ROM THE	ETR EUH	 EXISTING TO REMAIN ELECTRIC UNIT HEATER		LOW VC
ERE C, THE	EWC EWH	 ELECTRIC WATER COOLER ELECTRIC WATER HEATER	©S) TYPE	BY MAN DIAGRA
ATED R SHALL	FA FACP	FUSE FIRE ALARM FIRE ALARM CONTROL PANEL		TECHNO HALLWA SENSOR
JIRED. UTRAL	FC FLUOR	 FAN COIL UNIT FLUORESCENT		SLINSOI
IT , THE	FPB F.P.C. FS	 FAN POWER BOX (VAV) FIRE PROTECTION CONTRACTOR FLOW SWITCH	Φ	20A - 12 AFF TO
IALL BE ENT CLE AND	FT. G.C. GFI	 FOOT/FEET GENERAL CONTRACTOR GROUND FAULT INTERRUPTING PROTECTION	Φ	20A - 12 NOTED
#250.122. ATE	GND HID HOA	 GROUND HIGH INTENSITY DISCHARGE HAND-OFF-AUTOMATIC	<b>+</b>	20A - 12 UNLESS
EL CASE NDUIT & TOR &	HP HPS HVAC	 HORSEPOWER HIGH PRESSURE SODIUM HEATING, VENTILATION, AIR CONDITIONING	<b>⊕</b> lg	20A - 12 UNLESS
DROP, CORDING	IG INCAND.	 ISOLATED GROUND INCANDESCENT	⊕GFI	20A - 12
	JB KCMIL K.E.C. KVA	 JUNCTION BOX ONE THOUSAND CIRCULAR MILS KITCHEN EQUIPMENT CONTRACTOR KILOVOLT AMPERE	⊕ <sup>GFI</sup> WP	RESISTA AFF TO
Y TO	KW LTG	 KILOVOLT AWIFERE KILOWATT LIGHTING	⊕ <sup>GFI</sup>	20A - 12
IIRED,	MATV MAU MAX	 MASTER ANTENNA TV MAKE-UP AIR UNIT MAXIMUM	GUSB	
BEING	MCB MCC M.C.	 MAIN CIRCUIT BREAKER MOTOR CONTROL CENTER MECHANICAL CONTRACTOR	⊕ <sup>usB</sup>	20A - 129 AFF TO
IRED NDER THE	MECH. MFR	 MECHANICAL MANUFACTURER	₩USB	20A - 12 UNLESS
CH	MH MIN MLO	 METAL HALIDE MINIMUM MAIN LUGS ONLY	Φ	FURNISI
	MOD MSB	 MOTOR OPERATED DAMPER MAIN SWITCHBOARD		TO THE
G AND	MTD NEC	 MOUNTED NATIONAL ELECTRIC CODE		CARPET SO THA
TRICAL METHOD.	NF NFPA	NON FUSED NATIONAL FIRE PROTECTION ASSOCIATION		ARCHITI FURNISI
BEING RES.	NIC NL	NOT IN CONTRACT NIGHTLIGHT		#818TC <i>F</i>
THE	NTS Ø or PH	 NOT TO SCALE PHASE	$\bigcirc \hspace{0.1cm} \blacktriangledown$	FURNISI LIMITED
E STING	P PB	PULL BOX		FLOOR E
PLACE OT IN	P.C. PNL PRE	 PLUMBING CONTRACTOR PANEL POWER ROOF EXHAUSTER		COVERS THE QU
	PVC RTU	 POLYVINYL CHLORIDE ROOF TOP UNIT		FLOOR I BOX IS F
TED. TS AND	SPKR SPST	 SPEAKER SINGLE POLE SINGLE THROW		INSTALL TECHNO
	TIE	MULTIPLE OUTLETS WIRED ON SAME BRANCH CICRUIT		ACCEPT INSTRUC
THE	TS TTB	 TAMPER SWITCH TELEPHONE TERMINAL BOARD		
S NT.	TV TYP.	 TELEVISION TYPICAL		STANDA
PE	UH UL	 GAS FIRED UNIT HEATER UNDERWRITER'S LABORATORY		(
ΓA RITTEN	UNO	 UNLESS NOTED OTHERWISE UNIT VENTILATOR		(
NY SLAB Y SAW	W WP			(
	WR WR X'FMR	 WEATHER-PROOF WEATHER-RESISTANT TYPE DEVICE (NEMA 3R RATED) TRANSFORMER		L
	AT IVIIX	 UNIVERSITY	B	DOOR B CONNEC
			СН	CHIME A
			B	PUSH-BI BEING S

	SYMBOL	ELECTRICAL SYMBOL LEGEND  DESCRIPTION
	STWIDGE	
	•	CONDUIT WITH WIRING RUN CONCEALED IN OR ABOVE CEILING OR WALL, OR RUN EXPOSED IN UNFINISHED AREAS. CROSS HATCHING INDICATES NUMBER OF CONDUCTORS (#12 AWG - MINIMUM). PROVIDE A CODE-SIZED GROUND WIRE IN ALL CONDUITS IN ADDITION TO THE CONDUCTORS SHOWN. SHADED DOT INDICATES CODE-SIZED ISOLATED GROUND WIRE IN CONDUIT.
	<b>/-</b> ₩	CONDUIT WITH WIRING RUN CONCEALED BELOW FLOOR. CROSS HATCHING INDICATES NUMBER OF CONDUCTORS (#12 AWG - MINUMUM). PROVIDE A CODE-SIZED GROUND WIRE IN ALL CONDUITS IN ADDITION TO THE CONDUCTORS SHOWN. SHADED DOT INDICATES CODE-SIZED ISOLATED GROUND WIRE IN CONDUIT.
		PANELBOARD MOUNTED 6'-6" TO TOP. SEE PANEL SCHEDULES & ELECTRICAL ONE-LINE DIAGRAM.
		DISCONNECT SWITCH - TYPE & RATING AS SHOWN ON PLANS
	<b>\$</b> <sub>X</sub>	20A - 120V/277V SINGLE POLE TOGGLE SWITCH MOUNTED 48" AFF TO TOP OF BOX, UNLESS NOTED OTHERWISE. IF APPLICABLE, LOWER CASE SUBSCRIPT "x" - KEYS SWITCH TO FIXTURES BEING CONTROLLED (TYPICAL OF ALL SWITCH SYMBOLS)
	<b>\$</b> oc	LINE VOLTAGE PASSIVE INFRARED WALL SWITCH OCCUPANCY SENSOR MOUNTED 48"AFF TO TOP OF BOX, UNLESS NOTED OTHERWISE (OC2 = DUAL RELAY). MANUFACTURER SHALL BE WATTSTOPPER, HUBBELL, SENSOR SWITCH, COOPER CONTROLS, OR LUTRON)
	©S) <sub>TYPE</sub>	LOW VOLTAGE CEILING MOUNTED OCCUPANCY SENSOR. LOCATE AS DIRECTED PER MANUFACTURER AND PROVIDE STANDARD VS. EXTENDED COVERAGE RANGE AS DIRECTED BY MANUFACTURER. REFER TO TYPICAL LOW VOLTAGE OCCUPANCY SENSOR WIRING DIAGRAM ON SHEET E101. (1 = DUAL TECHNOLOGY 360° COVERAGE PATTERN, 2 = DUAL TECHNOLOGY CORNER MOUNTED WITH WIDE VIEW COVERAGE PATTERN, 3 = PIR NARROW HALLWAY COVERAGE PATTERN). MANUFACTURER SHALL BE WATTSTOPPER, HUBBELL, SENSOR SWITCH, COOPER CONTROLS, OR LUTRON,)
	φ	20A - 125V GROUNDING TYPE SIMPLEX RECEPTACLE MOUNTED 18" AFF TO TOP OF BOX, UNLESS NOTED OTHERWISE
	Φ	20A - 125V GROUNDING TYPE DUPLEX RECEPTACLE MOUNTED 18" AFF, UNLESS NOTED OTHERWISE
	<b>+</b>	20A - 125V GROUNDING TYPE QUADRAPLEX RECEPTACLE MOUNTED 18" AFF, UNLESS NOTED OTHERWISE
	$\Phi^{IG}$	20A - 125V ISOLATED GROUND TYPE DUPLEX RECEPTACLE MOUNTED 18" AFF, UNLESS NOTED OTHERWISE
8	- ⊕ <sup>GFI</sup> WP	20A - 125V GROUND FAULT INTERRUPTING TYPE DUPLEX RECEPTACLE, WEATHER RESISTANT LISTED WITH DIE-CAST ALUMINUM "WHILE IN-USE COVER" AND MOUNTED 18" AFF TO TOP OF BOX, UNLESS NOTED OTHERWISE
`	⊕ <sup>GFI</sup>	20A - 125V GROUND FAULT INTERRUPTING TYPE DUPLEX RECEPTACLE MOUNTED 18" AFF TO TOP OF BOX, UNLESS NOTED OTHERWISE
	⊕ <sup>USB</sup>	20A - 125V GROUNDING TYPE DUPLEX RECEPTACLE WITH (2) USB PORTS MOUNTED 18" AFF TO TOP OF BOX, UNLESS NOTED OTHERWISE
	USB	20A - 125V GROUNDING TYPE DUPLEX RECEPTACLE WITH (4) USB PORTS MOUNTED 18" AFF, UNLESS NOTED OTHERWISE
	<b>(</b>	FURNISH AND INSTALL A COMPLETE FLOOR BOX SYSTEM WHICH INCLUDES, BUT IS NOT LIMITED TO THE FOLLOWING: SINGLE GANG, CAST IRON, FULLY ADJUSTABLE FLOOR BOX RECESSED IN CONCRETE FLOOR SLAB WITH (1) 20A DUPLEX RECEPTACLE, FLUSH ALUMINUM FINISHED CARPET FLANGE AND COVER. FOR TILE FLOOR INSTALLATION, PROVIDE APPROPRIATE FLANGE SO THAT TOP COVER OF FLOOR BOX IS FLUSH WITH TILE. COORDINATE EXACT LOCATION WITH ARCHITECT PRIOR TO INSTALLATION. FLOOR BOX IS CAPABLE OF ACCEPTING (4) 1" CONDUITS. FURNISH AND INSTALL SYSTEM PER MANUFACTURER'S INSTRUCTIONS. WIREMOLD #880CS1-1, #818TCAL, #828R-TCAL
		FURNISH AND INSTALL A COMPLETE FLOOR BOX SYSTEM WHICH INCLUDES, BUT IS NOT LIMITED TO THE FOLLOWING: 2-GANG, CAST IRON, FULLY ADJUSTABLE MULTI-SERVICE FLOOR BOX RECESSED IN CONCRETE FLOOR SLAB WITH (1) 20A DUPLEX RECEPTACLE, (1) 6-PORT TELE/DATA MOUNTING BEZEL, FLUSH ALUMINUM FINISHED CARPET FLANGE AND COVERS, AND VOLTAGE DIVIDER. THE FURNISHED FLOOR BOX SHALL BE SIZED TO ACCEPT THE QUANTITY AND SIZE OF CONDUITS REQUIRED FOR THE TELE/DATA CABLING. FOR TILE FLOOR INSTALLATION, PROVIDE APPROPRIATE FLANGE SO THAT TOP COVER OF FLOOR BOX IS FLUSH WITH TILE. COORDINATE EXACT LOCATION WITH ARCHITECT PRIOR TO INSTALLATION. COORDINATE BRACKET AND TELE/DATA DEVICE REQUIREMENTS WITH TECHNOLOGY INSTALLER PRIOR TO ORDERING MATERIALS. FLOOR BOX IS CAPABLE OF ACCEPTING (6) 1"CONDUITS. FURNISH AND INSTALL SYSTEM PER MANUFACTURER'S INSTRUCTIONS. WIREMOLD #880CS2-1, #828TCAL, #828R-TCAL, #828COMTCAL
		STANDARD GANG BOX REFER TO TERMINAL LIST BELOW FOR INDIVIDUAL DEVICES:  TELEPHONE S SPARE CONDUIT (RAN UP TO CEILING)  DATA J J-BOX WITH GENERAL POWER  DUPLEX DEDICATED DUPLEX WITH ISOLATED GROUND  QUAD
	(B)	DOOR BELL ASSEMBLY. MOUNTING, TYPE, RATINGS AS INDICATED ON PLANS. MAKE CONNECTIONS PER MANUFACTURER'S INSTRUCTIONS.
	CH	CHIME ASSEMBLY. MOUNTING, TYPE, RATINGS AS INDICATED ON PLANS. MAKE CONNECTIONS PER MANUFACTURER'S INSTRUCTIONS.
	_	PUSH-BUTTON ASSEMBLY MOUNTED AT 48" AFF TO TOP OF BOX. TYPE AND RATINGS PER LOAD
	<b>B</b>	BEING SERVED. MAKE CONNECTIONS TO EQUIPMENT PER MANUFACTURER'S INSTRUCTIONS.  JUNCTION BOX - SIZE AS REQUIRED BY NEC
	<b>₩</b>	TELEPHONE OUTLET MOUNTED 18" AFF UNLESS NOTED OTHERWISE. PROVIDE 1"C
	$egin{array}{cccccccccccccccccccccccccccccccccccc$	WITH PULLWIRE TO ACCESSIBLE CEILING SPACE. PROVIDE CONDUIT BUSHING.  DATA OUTLET MOUNTED 18" AFF, UNLESS NOTED OTHERWISE, PROVIDE 1"C WITH
	<b>A</b>	PULLWIRE TO ACCESSIBLE CEILING SPACE. PROVIDE CONDUIT BUSHING.  COMBINATION TELEPHONE/DATA OUTLET MOUNTED 18" AFF, UNLESS NOTED
	<b>V</b>	OTHERWISE. 1"C WITH PULLWIRE TO ACCESSIBLE CEILING SPACE. PROVIDE CONDUIT BUSHING. PLUG MOLD MNTD. ABOVE COUNTERTOP.
	(#)	
<b>\</b>	DRV] <sup>(#)</sup>	DRIVER FOR SHELF LIGHTING. (#) QUANTITY OF UNITS.

Store Number 3507

<u>note:</u> as per landlord specifications all mechanical, plumbing, and electrical equipments be properly supported from steel structure, not roof deck.

**BARNES&NOBLE** 

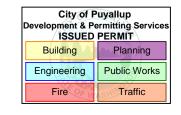


PROJECT DESIGNER:



ARCHITECT:

JOEL TORIELLI 422 BOGERT AVE RIDGEWOOD, NJ 07450

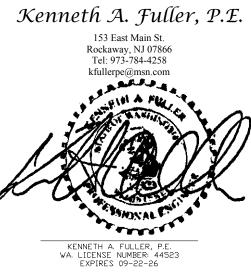

SOUTH HILL MALL 3500 S. MERIDIAN UNIT #800 PUYALLUP, WA 98373

Project Number 33247

Revision Log: Date Description

12-19-24
ISSUED FOR PERMIT, BID, LANDLORD & CLIENT REVIEW

02-20-25
BUILDING DEPARTMENT AND LANDLORD COMMENTS

05-16-25
ISSUED FOR CONSTRUCTION

2 These plans are an instrument of service and the property of the Architect, infringements will be

prosecuted. General Contractor to verify all conditions and dimensions at the premises. Discrepancies shall be reported to the Architect prior to the

commencement of any work.

Professional Seal:

Drawing Description: ELECTRICAL **SCHEDULES** & DETAILS

Drawing Number: E-201

PANEL TO THE NEMA TO THE NO.				MDP	VOLTA	GE	277	/ 480 V	PHASE		;	3	WIRE	4		
CKT.	ГҮРЕ	•		EXIST.	MAINS			MLO	BUS RAT	ING	80	00	AIC RA	TING 30,000		
NO.		ENCLO	SURE	EXIST.	MOUNT	ΓING	SURF	ACE	OPTIONS	8			NOTE			
			DESCRIPTION		POLE	WIRE	BKR.	TOTAL	PHASE	TOTAL	BKR.	WIRE	POLE	DESCRIPTION		СК
1						SIZE	SIZE	WATTS		WATTS	SIZE	SIZE				NO
· 1								6366	Α	6,920						2
3	E		RTU-4		3	10	25	6366	В	6,920	25	10	3	RTU-5	E	4
5								6366	С	6,920						6
7								9965	Α	23,805						8
9	E		RTU-6		3	8	40	9965	В	23,805	90	2	3	RTU-1	E	10
11								9965	С	23,805						12
13								23805	Α	23805						14
15	E		RTU-2		3	2	90	23805	В	23805	90	2	3	RTU-3	E	16
17								23805	С	23805						18
19	N	LO	WATER HEATER		1	12	20	4000	Α	23,711				751.744 TDANOFORMED		20
21			SPARE		1		20		В	24,410	100	1	3	75kVA TRANSFORMER (PANEL 'A' & 'B')	N	22
23			SPARE		1		20		С	25,538				(		24
25									A	21,457				7512/A TDANSEODMED		26
27			200 AMP SPACE						В	21,855	100	1	3 1	75kVA TRANSFORMER (PANEL 'K')	N	28
29									c	23,411				,		30

488 AMPS

405835 WATTS

TOTAL DEMAND LOAD


DANI				^	VOLTA	CE	120	/ 200 \/	DUASE			3	WIDE	4		
	ELBOAR	ט		A				/ 208 V	PHASE	FINO			WIRE	·		
	EL TYPE		OUDE	NQ	MAINS		150	\ <u>\</u>	BUS RAT				AIC RA	ATING 25,000		
	A TYPE I	ENCLO		NEMA 1	MOUNT		SURFA		OPTIONS		DICE		NOTE	PEOCRIPTION		014
CKT.	•		DESCRIPTION		POLE		BKR. SIZE	TOTAL	PHASE	TOTAL	BKR.		POLE	DESCRIPTION		CK.
1		LCP	S/W TRACK / VES	T LIGHTS	1	12	20	WATTS 1208	A	WATTS 285	SIZE 20	12	1	SALES HIGH BAY LTS	LCP	NC 2
<u> </u>			SALES PENDANT			12	20	960	В	345	20	12_	1	SALES HIGH BAY LTS	LCP	_4
5			SALES TRACK LIC		1	12	20	1200	C	360	20	12	1	BACK-UP SERVER RECEPT.	LO/IG	6
7			SALES TRACK LIC		1	12	20	960	A	800	20	12	·	CAFÉ/WORKRM LÌGHTS	20,10	8
9			SALES TRACK LIC		1	12	20	1200	В	125	20	12	1	CORRIDOR LIGHTS	LCP	10
11			SALES TRACK LIC		1	12	20	1200	С	1000	20	12	1	EM LIGHTS/EXIT SIGNS	LO	12
13			RE-CIRCULATION	PUMP	1	12	20	300	A	1,560	20	12	1	JAN CL. / RESTRM LTS / EF-1,2,3		14
15		LCP	SALES TRACK LIC	GHTING	1	12	20	1200	В	1,100	20	12	1	STOCK / STORAGE LTG		16
17		LCP	SALES TRACK LIC	GHTING	1	12	20	1200	С	700	20	12	1	OFFICE / BREAK RM LTS		18
19		LCP	SALES TRACK LIC	GHTING	1	12	20	1200	Α	500	20_	12	_1	LCP		20
21		LCP	SALES TRACK LIC	GHTING	1	12	20	900	В (	1200	20	12	1	SALES SHELF RECEPT.	LCP	22
23		LCP	CAFE SEATING TR	ACK	1	12	20	1680	c (	300	20	12	1	INFO RECEPTACLE		24
25			CAFÉ SEATING J-E	вох	1	12	20	1080	$\land$	1100	20	12	1	SALES SHELF RECEPT.	LCP	26
27		LCP	SALES TRACK LIC	GHTING	1	12	20	1440	2 <b>B</b>	900	20	12	1	SALES SHELF RECEPT.	LCP	28
29		LCP	SALES RECESSED	LIGHTS	1	12	20	1440	) c >	1200	20	12	1	CAFÉ SIGN	LCP	30
31		LCP	SIGN		1	12	20	1200	A \	1300	20	12	1	SALES SHELF RECEPT.	LCP	32
33		LCP	SALES TRACK LIC	GHTING	1	12	20	1440	В	1200	20	12	1	SALES SHELF RECEPT.	LCP	34
35		LCP	STOREFRONT CAF	ÉSIGN	1	12	20	1000	c	1100	20	12	1	SALES SHELF RECEPT.	LCP	36
37		LCP	S/W OUTLETS		1	12	20	1440	Α (	300	20	12	1	INFO RECEPTACLE		38
39		LCP	SIGN		1	12	20	1200	В	1000	20	12	1	SALES SHELF RECEPT.	LCP	40
41			FIXTURE UTILITY	OUTLETS	1	12	20	900	) c	1080	20	12	1	FIXTURE UTILITY OUTLETS		42
ALL	PHASES	то в	BALANCED TO WI	THIN 7%	· · ·				<u> </u>				· ·			
A=	13,233			WATTS				2		LO	CIRC	JITS W	ITH HA	NDLE LOCK-OFF DEVICE		
B=	13,610			WATTS						IG	CIRCI	JITS W	TH ISC	DLATED GROUND		
C=	14,360			WATTS						LCP	CIRCI	JITS O	N LIGH	TING CONTROL PANEL		
TOTA	AL CONN	IECTE	LOAD	41203	WATTS	S		115	AMPS							

	P	ANEL	BOAR	D		В	VOLTA	GE	120	/ 208 V	PHASE		3 WIRE 4		4			
	P	ANEL	TYPE			NQ	MAINS		125		BUS RAT	TING	22	25	AIC RA	TING 25,000	1	
	N	IEMA	TYPE E	ENCLOSU	IRE	NEMA 1	Тиоии	ΓING	SURFA	CE	OPTIONS	3			NOTE		]	
		СКТ.			DESCRIPTION		POLE	WIRE	BKR.	TOTAL	PHASE	TOTAL	BKR.	WIRE	POLE	DESCRIPTION		СКТ.
		NO.						SIZE	SIZE	WATTS		WATTS	SIZE	SIZE				NO.
h		1			PDT CHARGERS		1	12	20	1080	Α	400	20	12	1	CASHWRAP RECEPTACLE	IG	2
2		3			RECEIVING TABLE		1	12	20	900	В	400	20	12	1	CASHWRAP RECEPTACLE	IG	4
		5		IG	OFFICE RECEPTAGE	CLE	1	12	20	180	С	400	20	12	1	CASHWRAP RECEPTACLE	IG	6
		7		IG	OFFICE RECEPTAGE	CLE	1	12	20	180	Α	400	20	12	1	CASHWRAP RECEPTACLE	IG	8
		9		IG	OFFICE RECEPTAGE	CLE	1	12	20	180	В	400	20	12	1	CASHWRAP RECEPTACLE	IG	10
		11			OFFICE RECEPTAGE	CLE	1	12	20	360	С	400	20	12	1	CASHWRAP RECEPTACLE	IG	12
		13			OFFICE RECEPTAGE	CLE	1	12	20	540	Α	540	20	12	1	CASHWRAP OUTLET		14
		15			OFFICE RECEPTAGE	CLE	1	12	20	360	В	720	20	12	1	CASHWRAP OUTLET		16
	$\mathbb{L}$	17			BREAKRM REFRIG	ERATOR	1	12	20	1000	С	400	20	12	1	CASHWRAP RECEPTACLE	IG	18
1 2	4	<b>∆19</b>			BREAKRM MICRO	WAVE	1	12	20	1500	Α	1000	20	12	1	E.A.S RECEPTS	LO	20
		21			BREAKRM COUNT	ER REC	1	12	20	180	В	360	20	12	1	KEYPAD OUTLET		22
		23			WATER COOLER		1	12	20 ្	500	С	500	20	12	1	DRINKING FOUNTAIN		24
		25	$\triangle$		BREAK RM OUTLE	TS	1	12	20	540	Α	1080	20	12	1	DUCT DETECTORS	LO	26
)		27 🗸	$\frac{2}{2}$	<b>`_rô</b>	IT RACK		1	10	30	2000	В	1080	20	12	1	CAFÉ SEATING OUTLETS		28
		29		LO/IG	POS SERVER REC	EPT	1	12	20	720	<i>}</i> c	1200	20	12	1	SIGN	LCP	30
)		31			MUSIC SYSTEM		1	12	20	360	A	1200	20	12	1_	SIGN	LGR	32
		33			TOILET OUTLETS		1	12	20	360	В	900	20	12	1	CAFÉ COUNTER OUTLETS		34
		35			HAND DRYER		1	12	20	1450	С	208	15	12	2	AHU-1	HACR	36
		37			HAND DRYER		1	12	20	1450	Α	208			_			38
		39			OFFICE RECEPTAGE	CLE	1	12	20	360	В	2600	30	10	2	  CU-1	HACR	40
		41			ROOFTOP OUTLE	TS	1	12	20	1260	С	2600		10				42
	A	LL PF	IASES	TO BE B	ALANCED TO WITH	IIN 7%												
	A	<b>=</b> 1	0,478			WATTS						LO	CIRCL	JITS W	ITH HA	NDLE LOCK-OFF DEVICE		
	В		0,800			WATTS						IG	CIRCL	JITS W	ITH ISC	DLATED GROUND		
	C	= 1	1,178			WATTS												
	$\  \cdot \ _{T}$	ΌΤΔΙ	CONN	IECTED L	OAD	32456	WATTS	3		91	AMPS							
				ND LOAD		27286	WATTS			76	AMPS							

1	LBOAR	D		K	VOLTA	GE	120	/ 208 V	PHASE		[ ;	3	WIRE	4			
PANEL	L TYPE			NQ	MAINS		200		BUS RAT	ING	2	25	AIC RA	TING 25,000	-		
NEMA	TYPE	ENCLO	SURE	NEMA 1	MOUNT	ING	SURF	ACE	OPTIONS	6			NOTE	·	1		
СКТ.		ITEM	DESCRIPTION		POLE	WIRE	BKR.	TOTAL	PHASE	TOTAL	BKR.	WIRE	POLE	DESCRIPTION	ITEM		СКТ
NO.		#				SIZE	SIZE	WATTS		WATTS	SIZE	SIZE			#		NO.
1		125	ICE MAKER, CUBE	STYLE	1	12	20	1289	Α	1198	20	12	1	SELF-SERVICE REF. CASE	118	GFCI	2
3			SPARE		1		20		В	1198	20	12	<b>1</b>	SELF-SERVICE REF. CASE	118	GFCI	4
5	GFCI	104	ESPRESSO MACH	INE	2	10	30	3120	c	1081	15	12	1	REACH-IN FREEZER	3B	GFCI	6
7	G1 G1	104	EST KESSO MACTI			10	30	3120	<b>A</b> >	1450	20	12	2	COFFEE BREWER	114		8
9	GFCI	104	ESPRESSO MACH	INE	2	10	30	3120	В	1450	20	12		OOI I LE BILLWEIX	114		10
11	Ø1 Ø1		ZOT RECOO MACT		~~		~	3120	c (	240	15	12	1	REFRIGERATOR U/C	131	GFCI	12
13	GFCI	121	BLENDER		1	12	20	1800	A (	1081	15	12	1	REACH-IN FREEZER	3B	GFCI	14
15	GFCI	131	REFRIGERATOR U	/C	1	12	15	240	) в		20		1	SPARE			16
17		$\sim$	SPARE		1		20		] c {	600	20	12	1	CAFÉ POS CASHWRAP	103		18
19		129	REACH-IN FRIDGE		1	12	20	679	<b>A</b>	1800	20	12	$\searrow_1$	BLENDER	121	GFCI	20
21		133	DISHWASHER, U/O	· · · · · · · · · · · · · · · · · · ·	2	8	407	3870	<b> </b>	1300	20	12	1	HOT WATER DISPENSER	100.2	GFCI	22
23		100	DIOTIVACTIEN, O/C				\ <u></u>	3870			20		1	SPARE			24
25			KITCHEN CONVEN	. REC.	1	12		540	<b>/</b> A	1000	20	12	1_	WATER SOFTENER			<b>-26</b>
27						>		4100	В (	437	15	12	1	REACH-IN REFRIGERATOR	2B		28
29	LO	4	WATER HEATER		3	6 >	50	4100	c	1000	15	12	1	U/C REFRIGERATOR	124		30
31								4100	A	1040	15	12	2	DISPLAY CASE, REFRIG.	119		32
33		LO	RE-CIRCULATING	PUMP	1	12	20	300	) в					DISPERT CASE, REI RIG.	113		34
35	IG	103	CAFÉ POS CASHV	/RAP	1	12	20	<b>100</b>		2880							36
37	GFCI	113	COFFEE GRINFER		1	12	20	920	\ A	1440	30	10	3	BLODGETT OVEN	3C		38
39		3D	RAPID COOK OVE	N	2	10	30	3000	⟨ в ⟩	1800							40
41		30	IVALID COOK OVE	\		'0	30	3000	c		20		1	SPARE			42

DESCRIPTIO	V		NEC CONNECTED kW	VOLT	PHASE	NEC DEMAND FACTOR	<b>NEC DEMAND kW</b>
LIGHTING- 1	20V		7.7	120	1	1.25	9.6
INTERIOR SIG	3N		2.2	120	1	1.25	2.8
TRACK LIGHT	rs		14.8	120	1	TRACK LENGTH=	14.8
RECEPTACLE	S		36.0	120	1	>10kW=10+[0.5*(kW-10)]	23.0
STOREFRON	T SIGN		4.8	120	1	1.25	6.0
S/W OUTLET	rs .		1.4	120	1	1.25	1.8
HAND DRYE	R		2.9	120	1	1.00	2.9
AHU-1 / CU-1			5.6	208	1	1.00	5.6
WATER HEA	TER "EWH-1"		12.3	208	3	1.25	15.4
CAFÉ EQUIPI	MENT (208V,3PI	<del>1</del> )	6.1	208	3	1.00	6.1
EXISTING RT	U-1,2,3,4,5 AND	RTU-6	284.0	480	3	1.00	284.0
WATER HEATER "EWH-2"			4.0	277	1	1.25	5.0
CAFÉ EQUIPI	MENT (208V,1PI	<del>1</del> )	31.2	208	1	1.00	31.2
CAFÉ EQUIPI	MENT		15.3	120	1	1.00	15.3
ADD'L TO M	EET NEC 220.12 *	***	39.22	120	1	1.00	39.2
TOTALS			467.6				462.7
	* ** *** **** E.C. DEMAND k	125% OF TH N.E.C. ARTIC MINUS ACT N.E.C. 2014 /A x 1,000	ER VALUE OF THE TWO CA E LARGEST MOTOR OR CO CLE 220-12 REQUIREMENT UAL SHOW WINDOW LIG ARTICLE 220.43(B) EXCEPT	OMPRESSO (200 VA F HTING KV TION (CUF	OR IN SYS PER FOOT 'A. RRENT LIN	·	UNIT.
SY	STEM VOLTAGE	x 1.732					
<u>462.7</u>	<u>x 1000 =</u>	<u>462,716</u>	556.6	5 AMPS	USE (EXI	ST) 800 AMP SERVICE	
480	x 1.732 =	831					

**BARNES&NOBLE** 

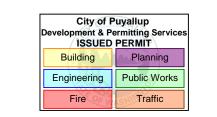


PROJECT DESIGNER:



ARCHITECT:

JOEL TORIELLI 422 BOGERT AVE RIDGEWOOD, NJ 07450

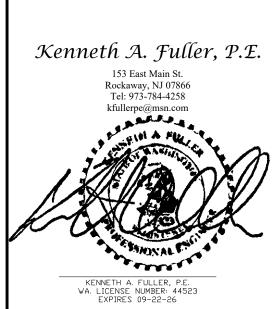

SOUTH HILL MALL 3500 S. MERIDIAN UNIT #800 PUYALLUP, WA 98373 Project Number 33247

Store Number 3507

Revision Log:

Date	Description	No
12-19-24	ISSUED FOR PERMIT, BID, LANDLORD & CLIENT REVIEW	Δ
02-20-25	BUILDING DEPARTMENT AND LANDLORD COMMENTS	$\Lambda$
05-13-25	ISSUED FOR CONSTRUCTION	2
		$\triangle$
		$\triangle$
		$\overline{\triangle}$
		$\overline{\wedge}$
	· · ·	


General Contractor to verify all conditions and dimensions at the premises. Discrepancies shall be reported to the commencement of any work.

Professional Seal:

Drawing Description: ELECTRICAL PANEL SCHEDULES


Drawing Number:

E-202.1

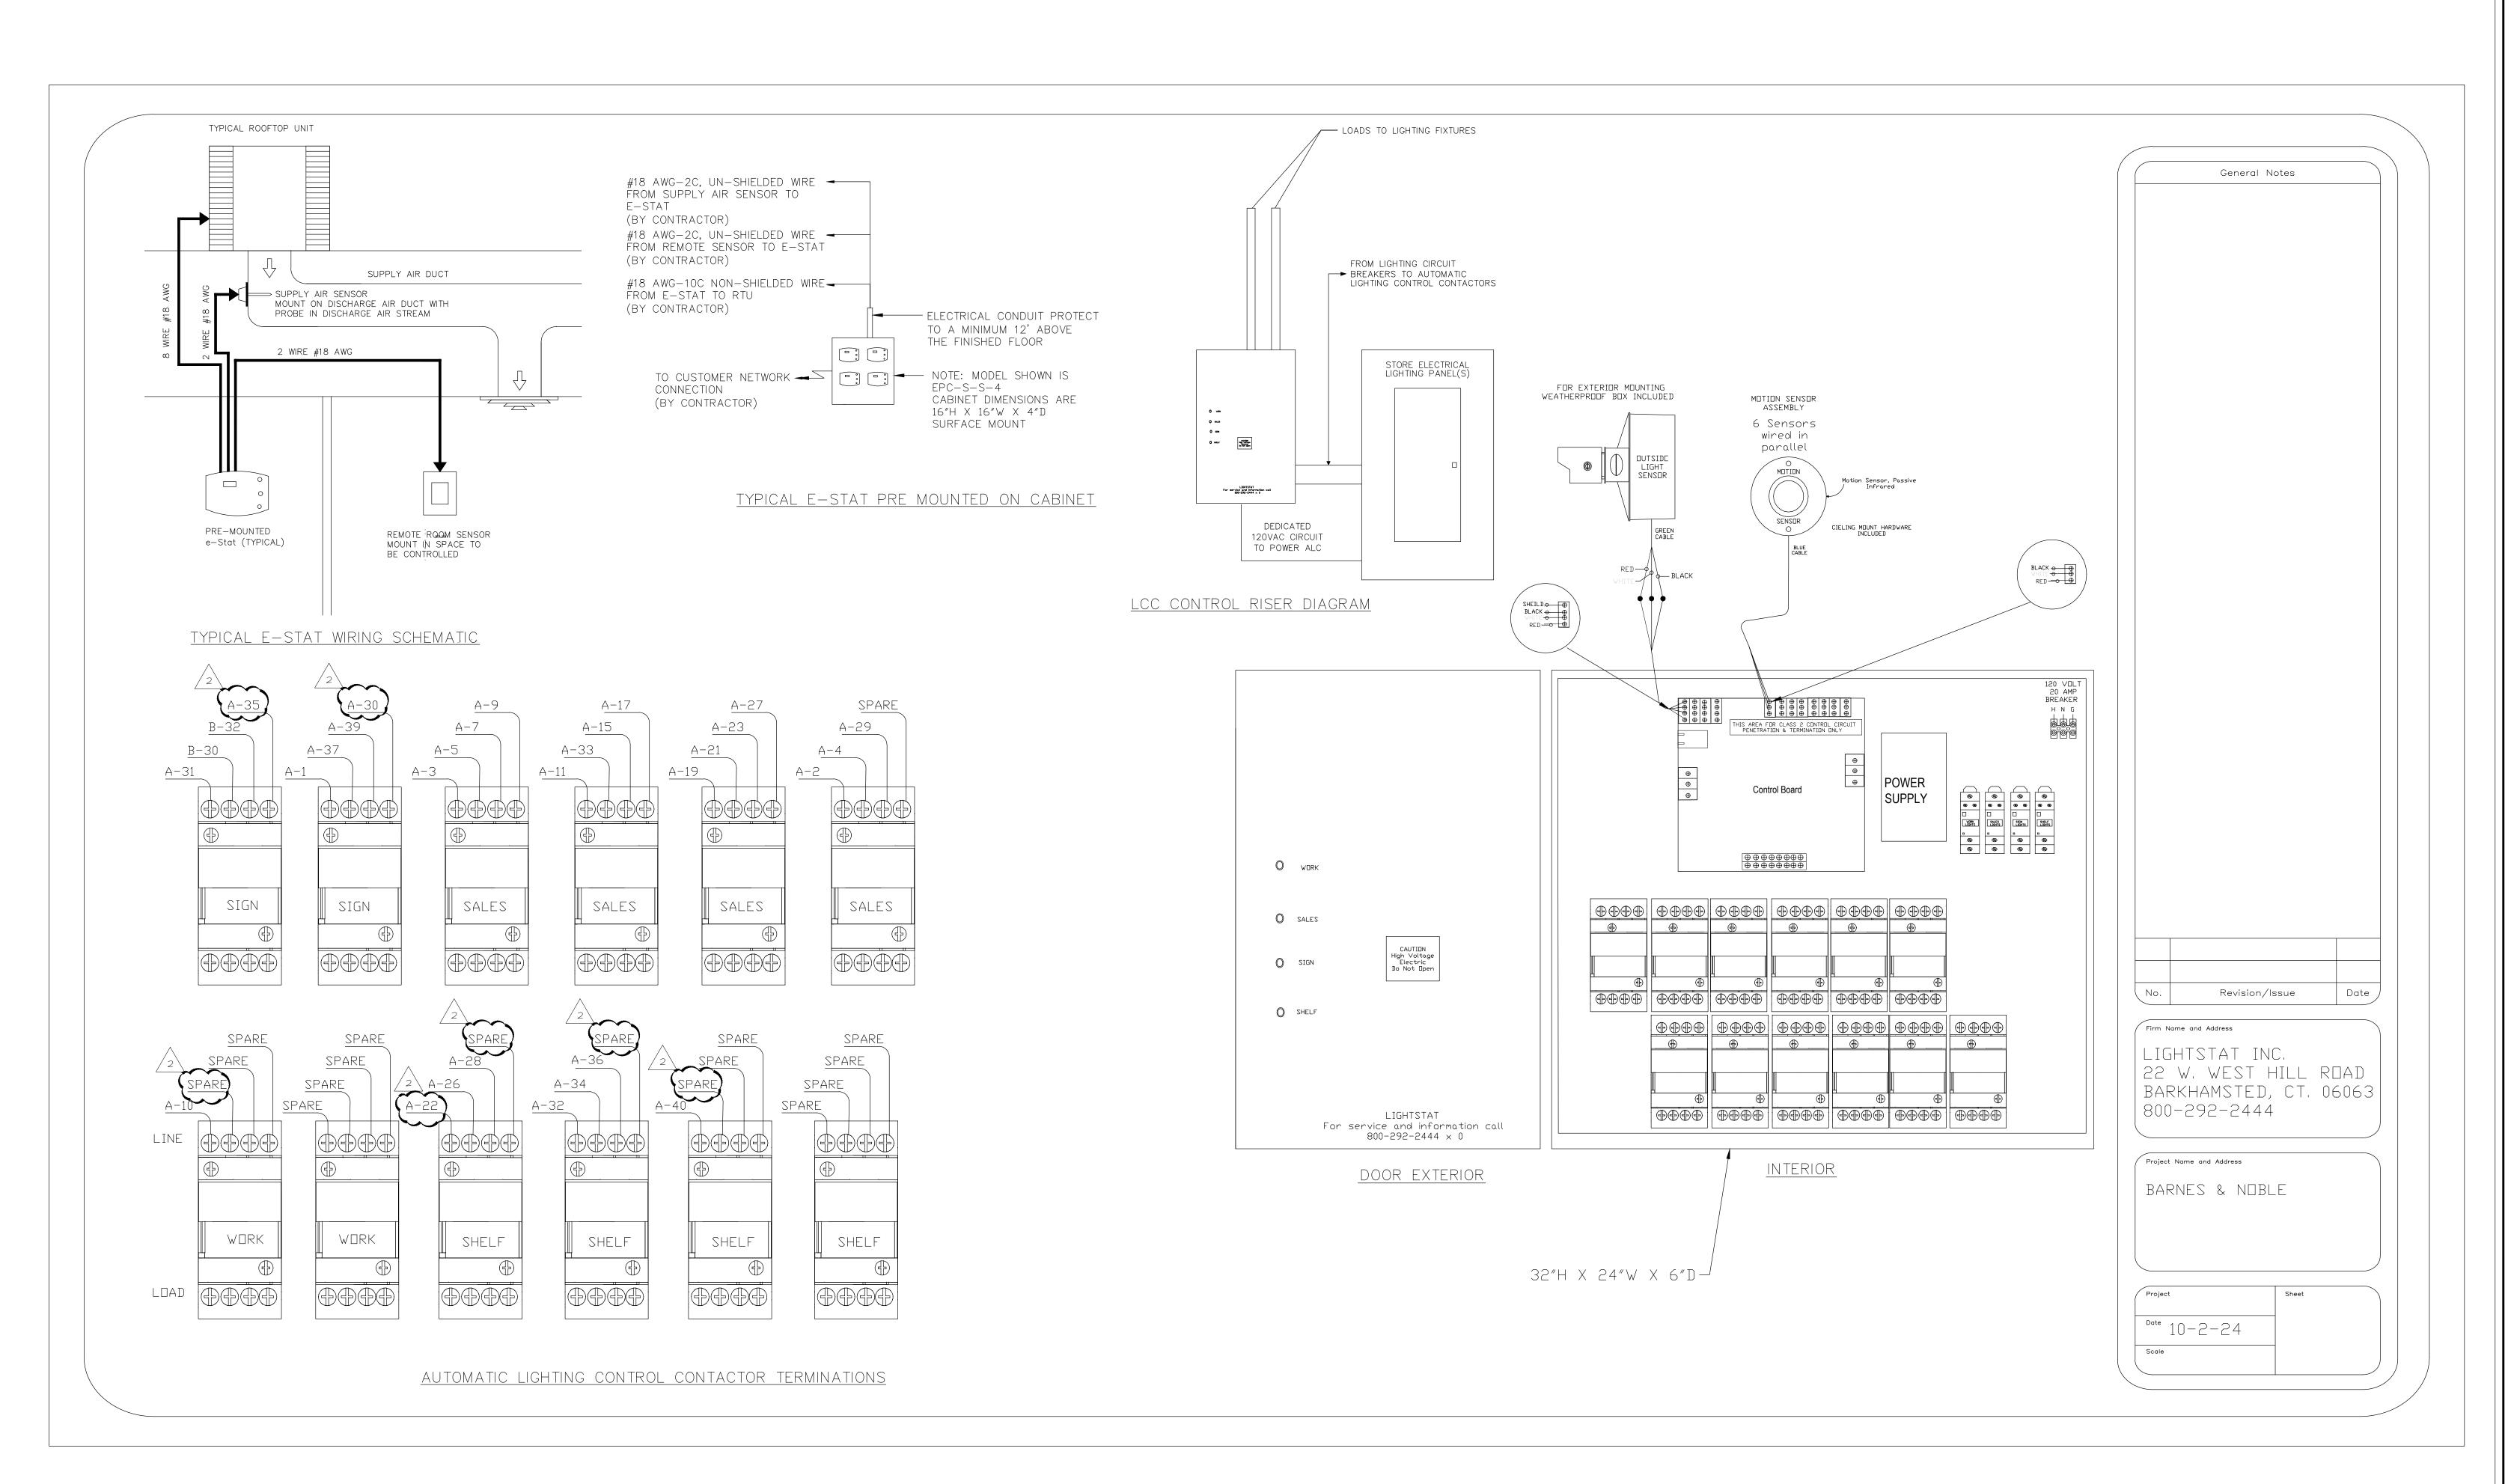

DRAWINGS FOR INFORMATION ONLY - BN VENDOR TO VERIFY ALL INFORMATION PRIOR TO WORK



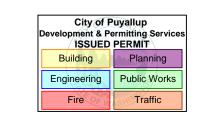


PROJECT DESIGNER:



## ARCHITECT:

JOEL TORIELLI 422 BOGERT AVE RIDGEWOOD, NJ 07450

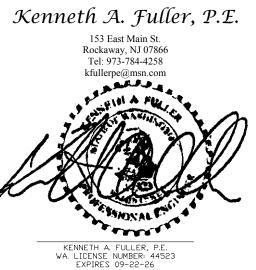

SOUTH HILL MALL 3500 S. MERIDIAN UNIT #800 PUYALLUP, WA 98373

Project Number 33247

Store Number 3507

12-19-24 ISSUED FOR PERMIT, BID, LANDLORD & CLIENT REVIEW


02-20-25 BUILDING DEPARTMENT AND LANDLORD COMMENTS 05-16-25 ISSUED FOR CONSTRUCTION


service and the property of the Architect, infringements will be

General Contractor to verify all conditions and dimensions at the premises. Discrepancies shall be reported to the Architect prior to the commencement of any work.

Professional Seal:

E-203

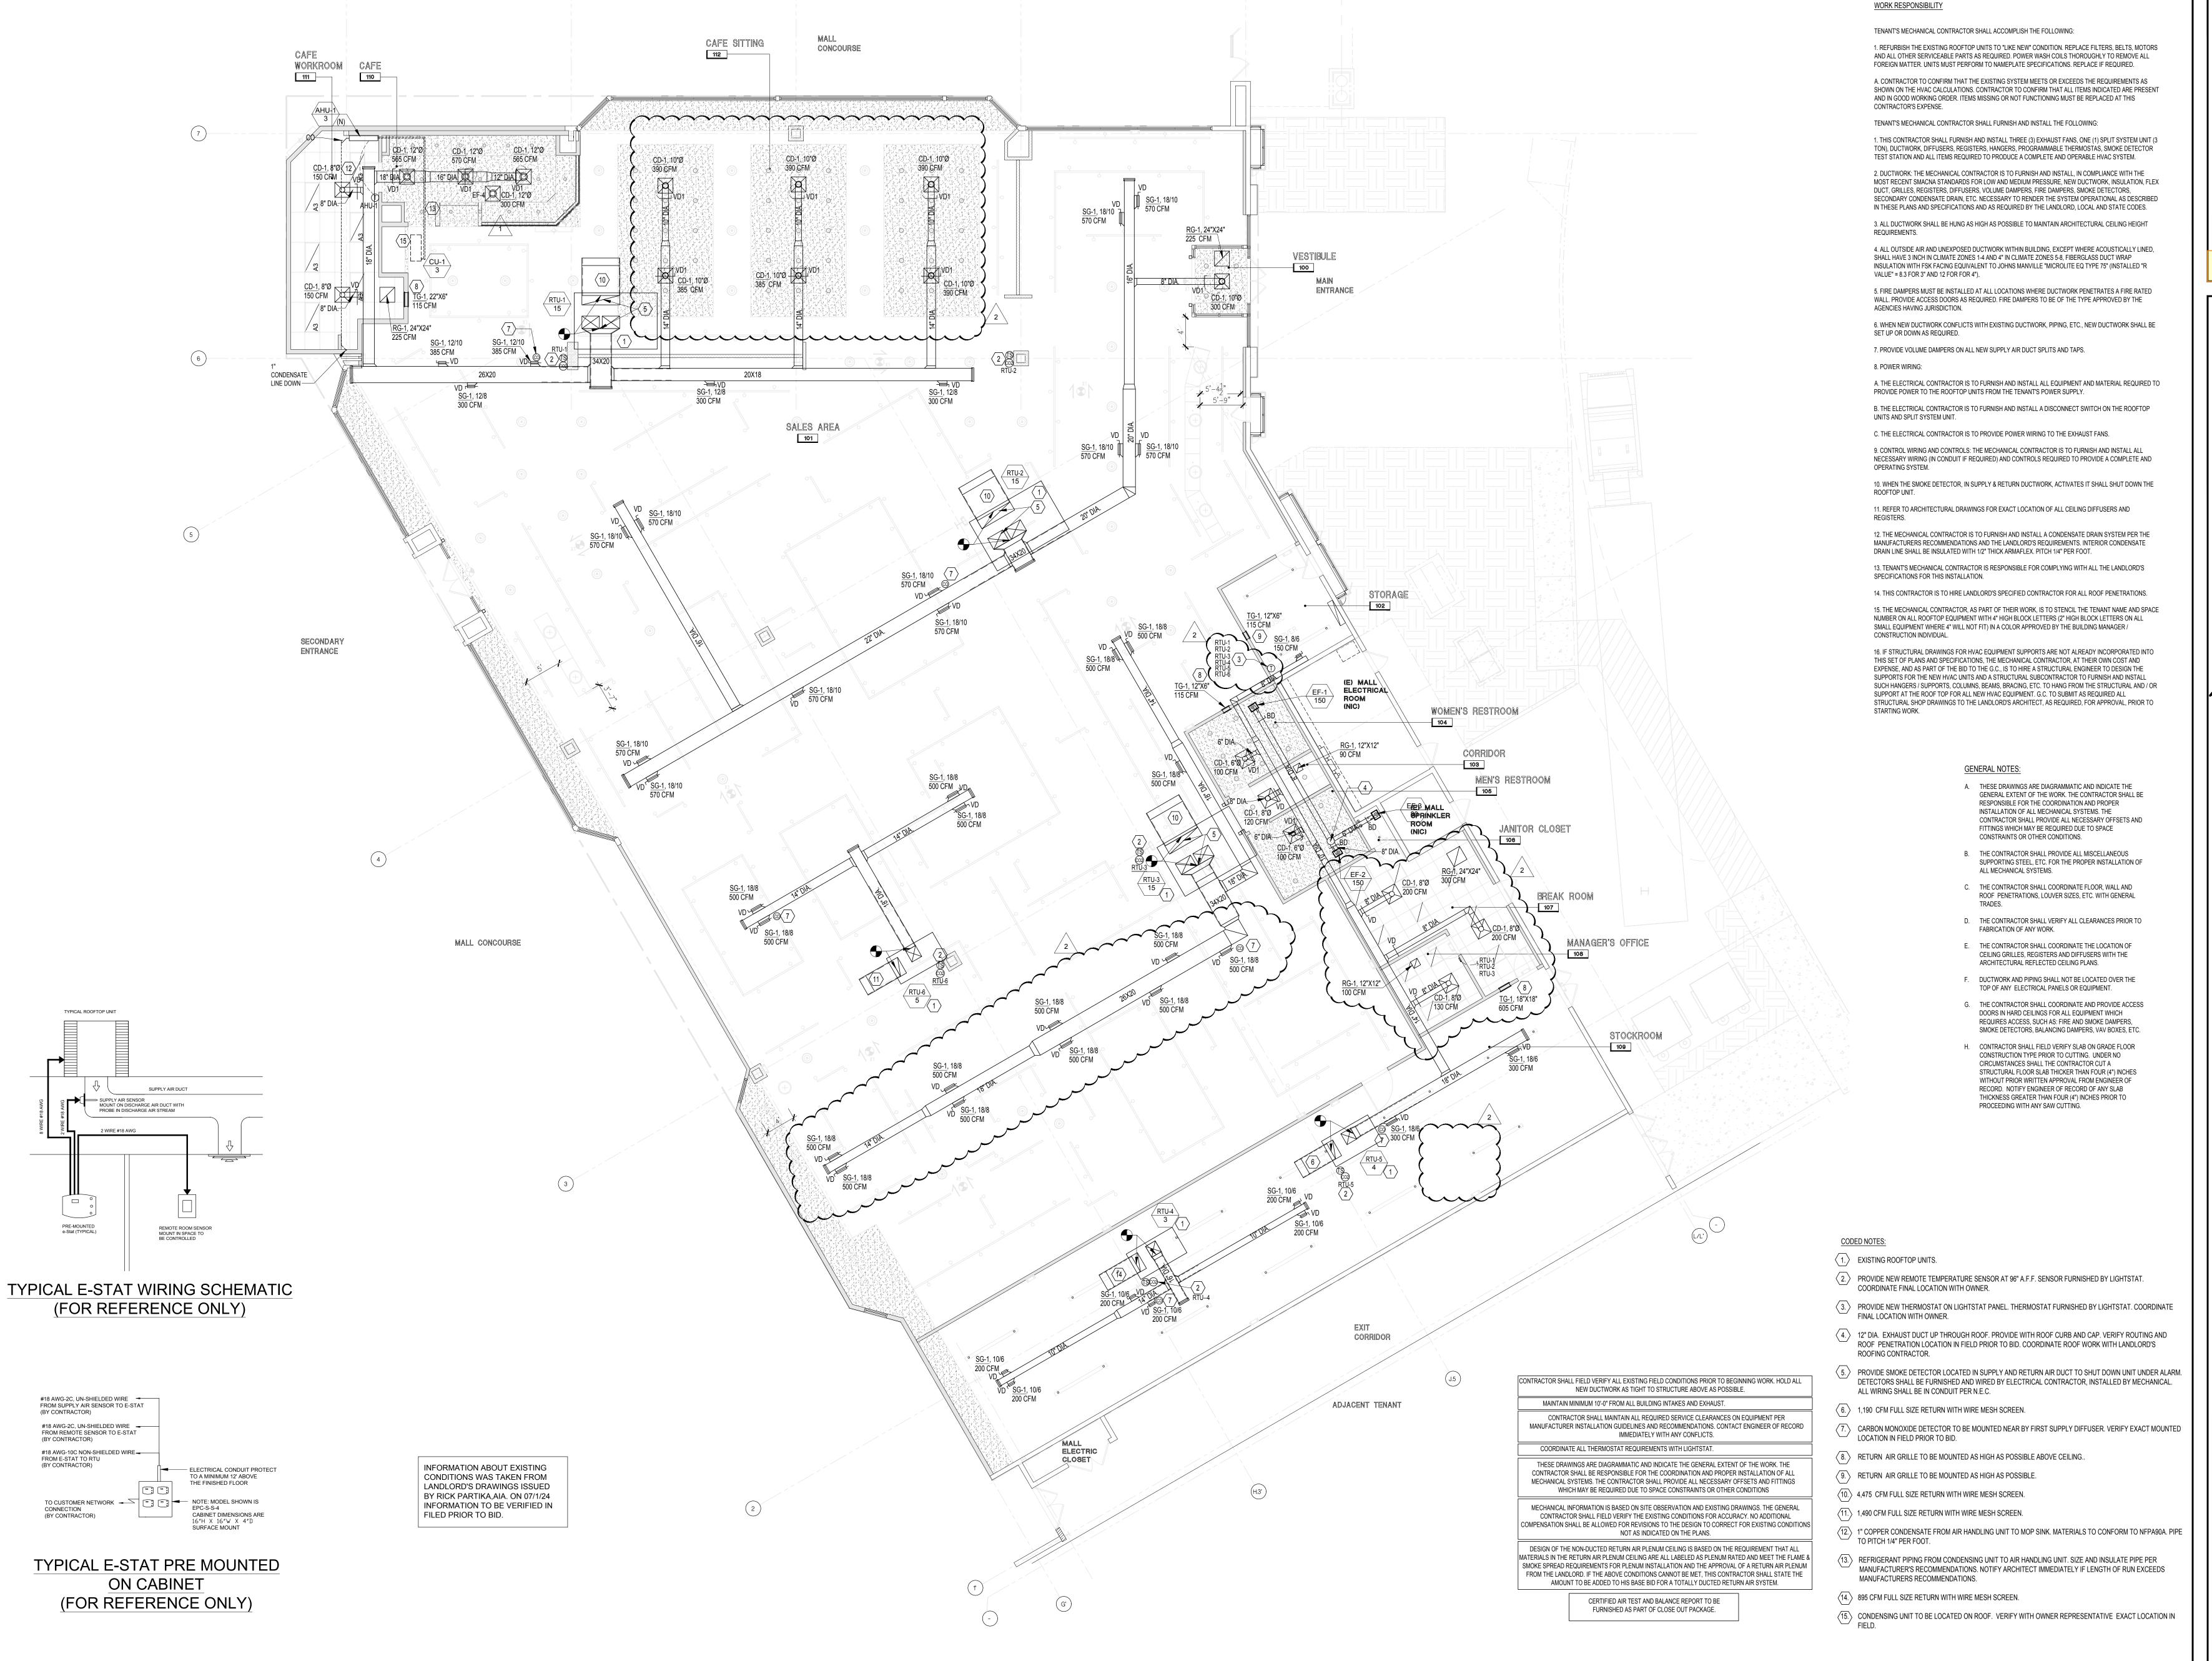

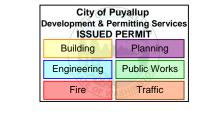

PROJECT DESIGNER:



ARCHITECT:

JOEL TORIELLI 422 BOGERT AVE RIDGEWOOD, NJ 07450

Kenneth A. Fuller, P.E. Rockaway, NJ 07866 Tel: 973-784-4258 KENNETH A. FULLER, P.E. WA. LICENSE NUMBER: 44523 EXPIRES 09-22-26

SOUTH HILL MALL 3500 S. MERIDIAN UNIT #800 PUYALLUP, WA 98373

Project Number 33247 Store Number 3507

Revision Log: 12-19-24 02-20-25 BUILDING DEPARTMENT AND 05-16-25 ISSUED FOR CONSTRUCTION

These plans are an instrument of

service and the property of the Architect, infringements will be General Contractor to verify all

conditions and dimensions at the premises. Discrepancies shall be reported to the Architect prior to the commencement of any work.


Professional Seal:

Drawing Description: HVAC PLAN


Drawing Number:

	FOOD SERVICE	E EQUIPMENT / UTILITIES SCHEDULE		
ITEM#	DESCRIPTION	MANUFACTURER	MODEL#	QTY
1	SINK BOWL, WELD-IN, DUMP SINK	N. WASSERSTROM & SONS	F4480234	1
2	SINK BOWL, WELD-IN, HAND SINK	N. WASSERSTROM & SONS	F4480234	1
3C	BLODGETT OVEN	BLODGETT	CTB SGL	1
3D	RAPID COOK OVEN	MERRYCHEF USA	E2S HIGH CLASSIC	1
100.1	PANTRY FAUCET	T&S BRASS	KL45-4000-WH	2
100.2	HOT WATER DISPENSER	IN SINK ERATOR	C1300	1
103	POS SYSTEM	-	-	1
104	ESPRESSO MACHINE	MELITTA	CT8	2
108	GARBAGE CAN	RUBBERMAID COMMERCIAL PRODUCTS	FG354060BLA	2
111	TOUCH-FREE SOAP DISPENSER	GOJO INDUSTRIES, INC.	PURELL CS6	1
112	SURFACE-MOUNTED PAPER TOWEL DISPENSER	BOBRICK	B-2621	1
112.1	BLENDER RINSER	BLENDTEC	JRE-610	1
113	COFFEE GRINDER	GRINDMASTER-UNIC-CRATHCO	890BS	1
114	COFFEE BREWER	BUNN	53100.0100	1
115	MANIFOLD	-		1
116	GLASS FILLER	T&S BRASS	B-1210	1
117	AIRPOT	SERVICE IDEAS	ECALS22SS	2
118	SELF-SERVICE REFRIGERATED CASE	STRUCTURAL CONCEPTS	B3424	2
119	PASTRY CASE, CURVED GLASS	FEDERAL INDUSTRIES	SSRPF-5052	1
120	DROP-IN ICE BIN	KROWNE	D278	1
121	BLENDER	VITAMIX	36019-ABAB	2
123	DIPPER WELL	T&S BRASS	B-2282-01-F05	1
124	DOUBLE UNDER COUNTER REFRIGERATOR	TRUE MGF.	TUC-48-HC	1
131	SINGLE UNDER COUNTER REFRIGERATOR	TRUE MGF.	TUC-27-HC	2


	WORKROOM	EQUIPMENT / UTILITIES SCHEDULE		
ITEM#	DESCRIPTION	MANUFACTURER	MODEL#	QTY
1A	R.O.WATER FILTRATION SYSTEM MANIFOLD BOARD			1
1B	R.O.WATER FILTRATION SYSTEM MANIFOLD BOARD  R.O.WATER FILTRATION SYSTEM ACCUMULATOR  TANK	-	-	1
1C	R.O.WATER FILTRATION SYSTEM - WATER SOFTNER	-	-	1
1D	R.O.WATER FILTRATION SYSTEM - BRINE	-	-	1
2B	REFRIGERATOR, REACH-IN, SINGLE DOOR	TRUE MGF.	STG1R-1S-HC	1
3B	FREEZER, REACH-IN, DOUBLE DOOR	TRUE MGF.	STG2F-2S-HC	2
4	WATER HEATER	-	-	1
5	MOP SINK	FIAT	MSB2424	1
5.1	SERVICE FAUCET	CHICAGO FAUCET	897-RCF	1
6	WALL SHELF	SUPPLIED BY BN	-	1
8	SOAP DISPENSER	BN SUPPLIED PURELL	TFX	1
9	HAND SINK - WALL MOUNTED	HAND SINK PARTS & ACCESSORIES	DH-17-NO FAU	1
14	C-FOLD PAPER TOWEL DISPENSER	BN SUPPLIED C-FOLD	-	1
15	WASTE CONTAINER	-	-	1
16	THREE COMPARTMENT SINK	AMTEKCO INDUSTRIES LTD.	C-3-1620-24D	1
16.1	PRE-RINSE FAUCET & ADD ON FAUCET			1
16.4	LEVER WASTE	T&S BRASS	B-3950	3
125	ICE MAKER, CUBE-STYLE	ITV ICE MAKER	SPIKA MS 500	1
127	WIRE SHELVING	1880 HOSPITALITY	FF2472C	4
129	REFRIGERATOR, REACH-IN, DOUBLE DOOR	TRUE MGF.	STG2DT-2S	1
133	DISHWASHER, UNDERCOUNTER	JACKSON WWS	DISHSTAR HT	1

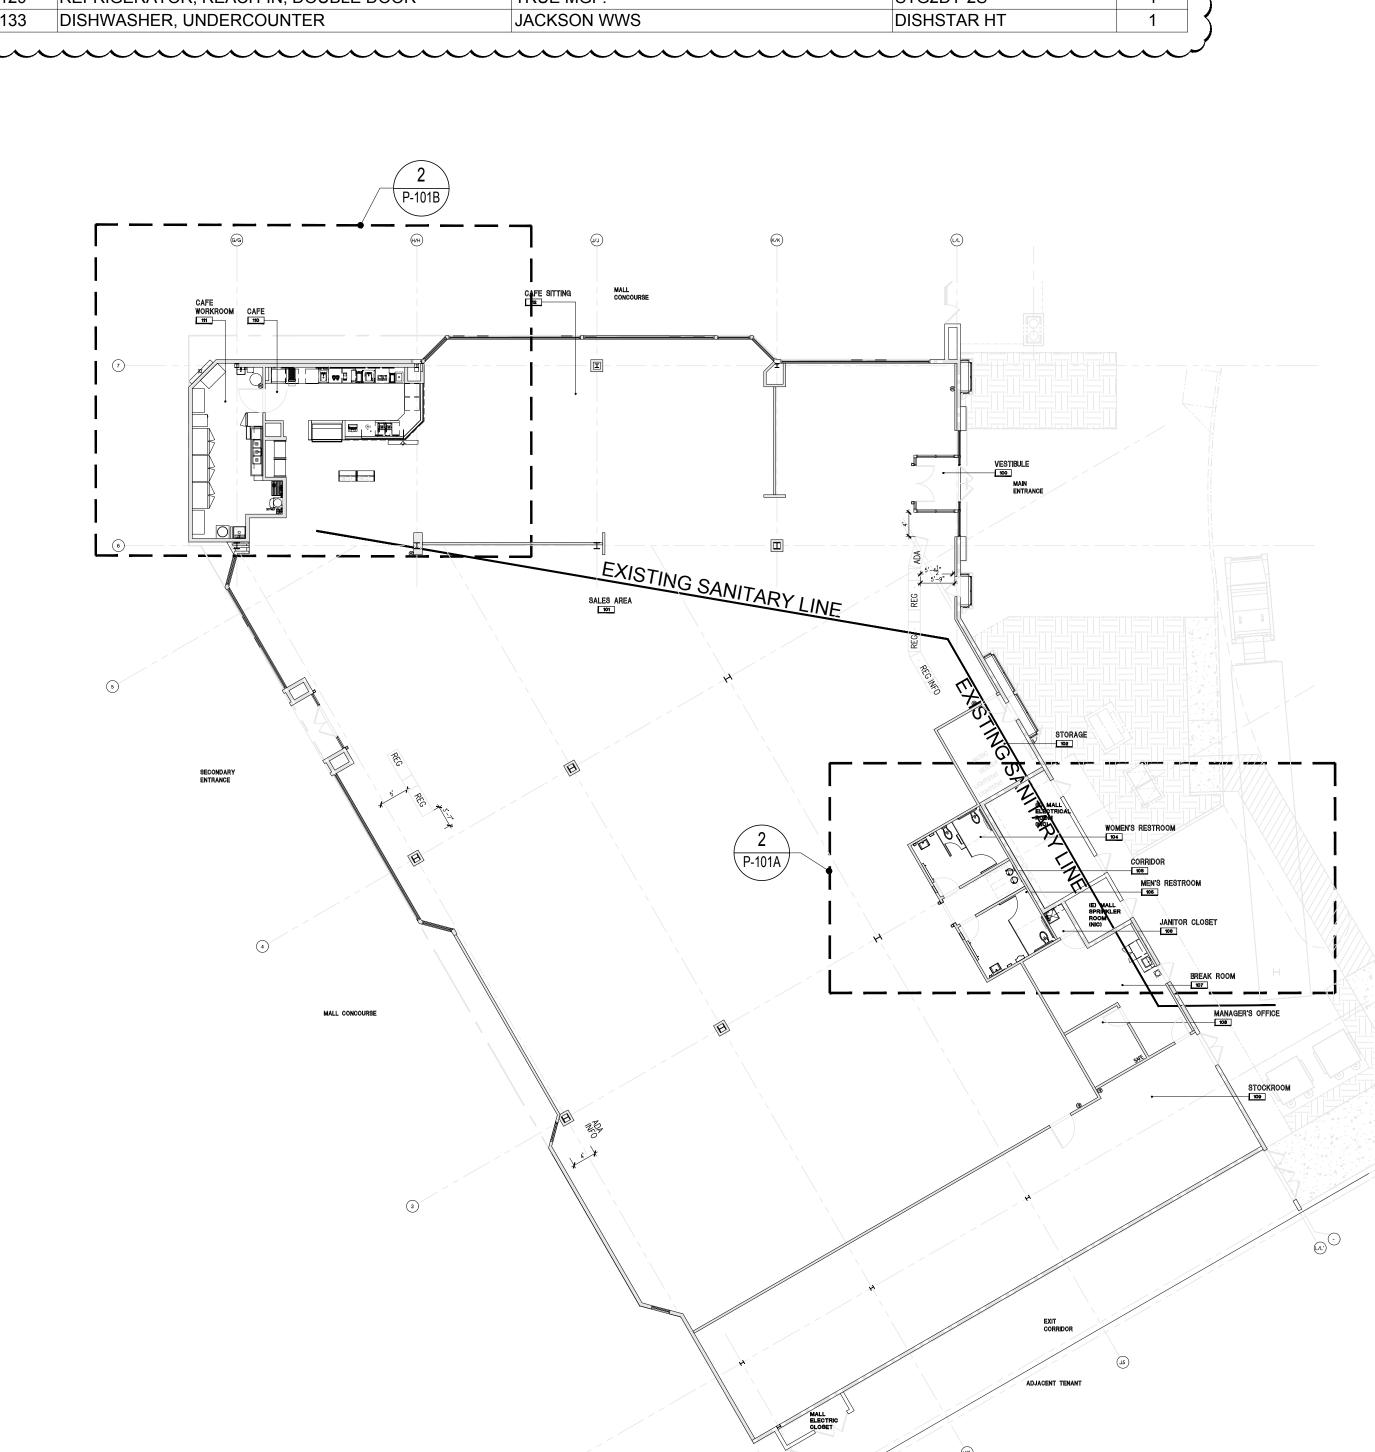


Sanitary Waste & Vent Overall Plan
SCALE: 1/16" = 1'-0"

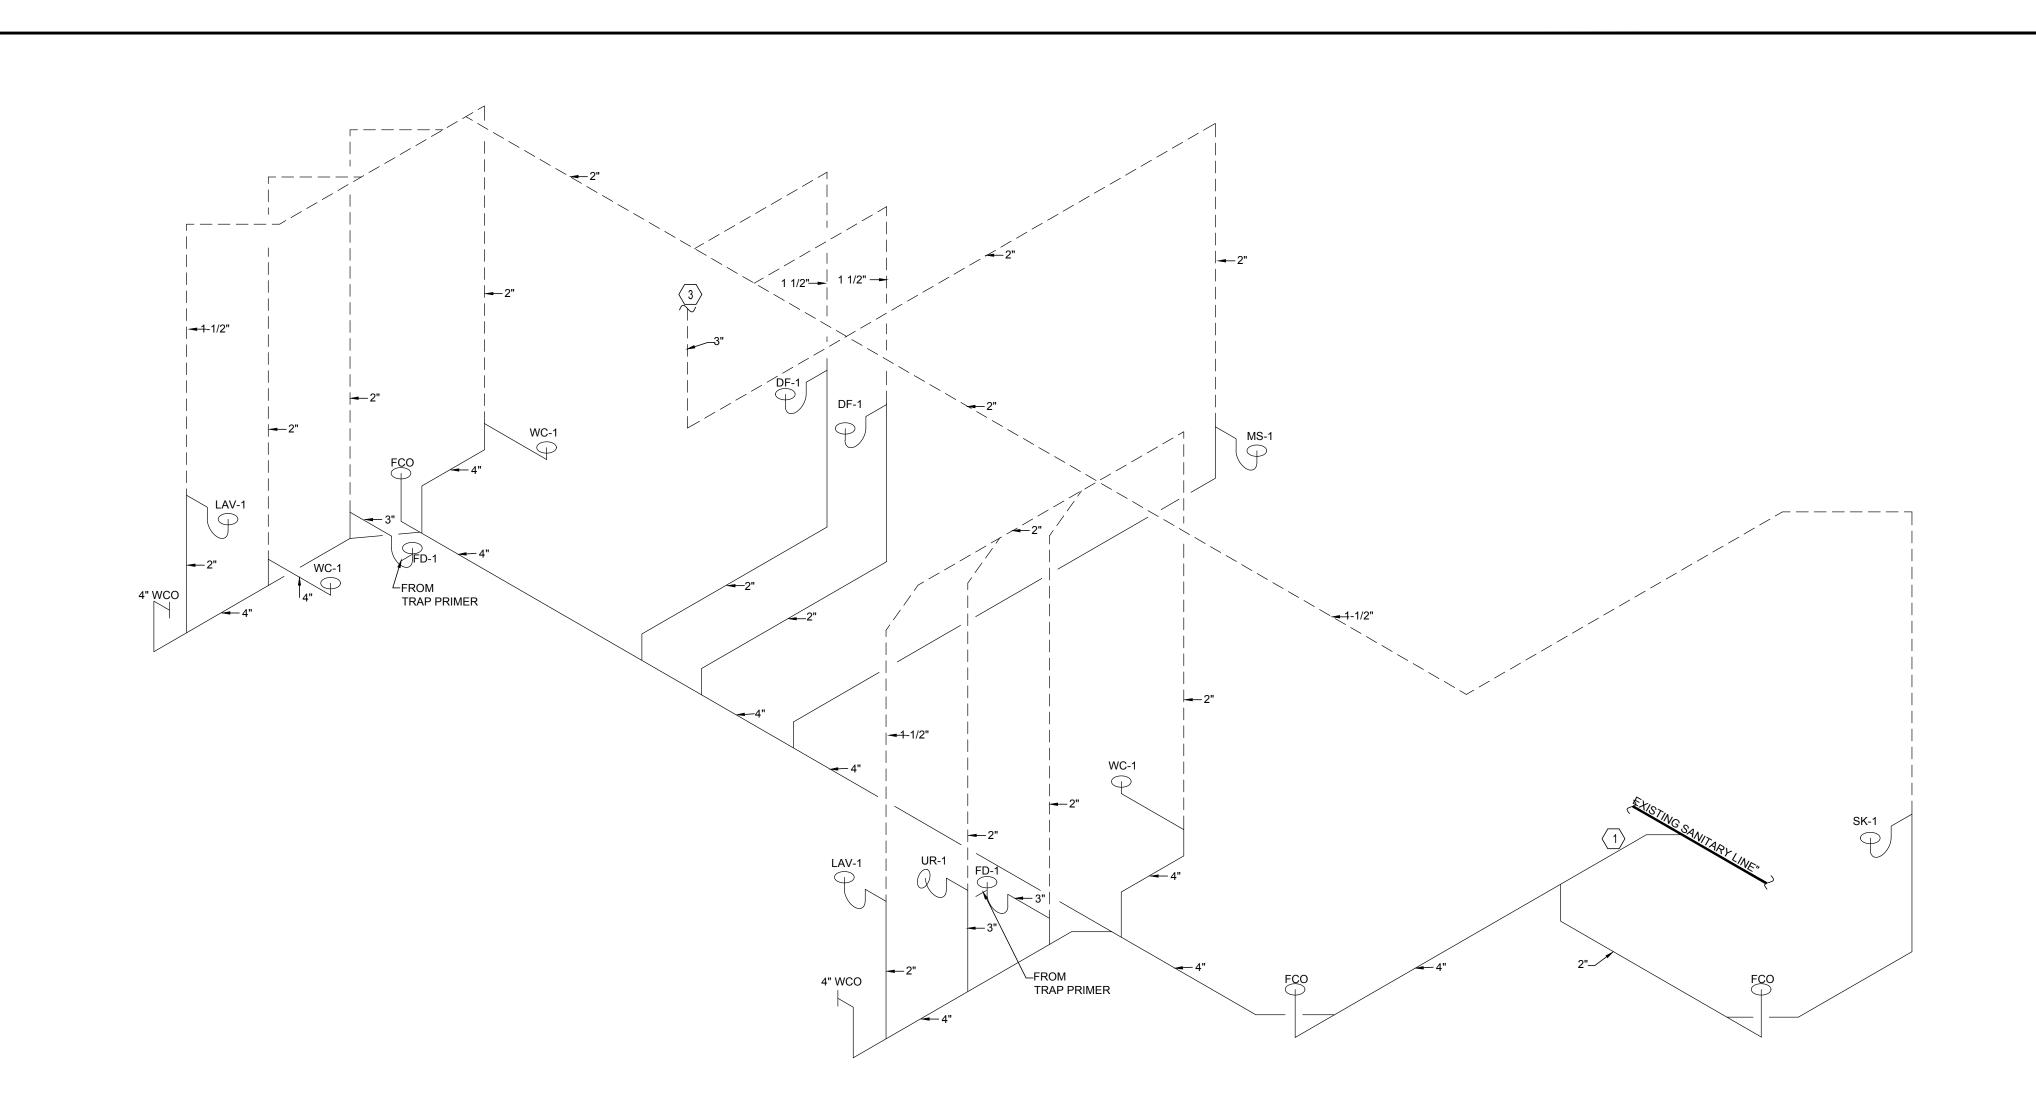

| Scale: N.T.S. | Scale: N.T.S.

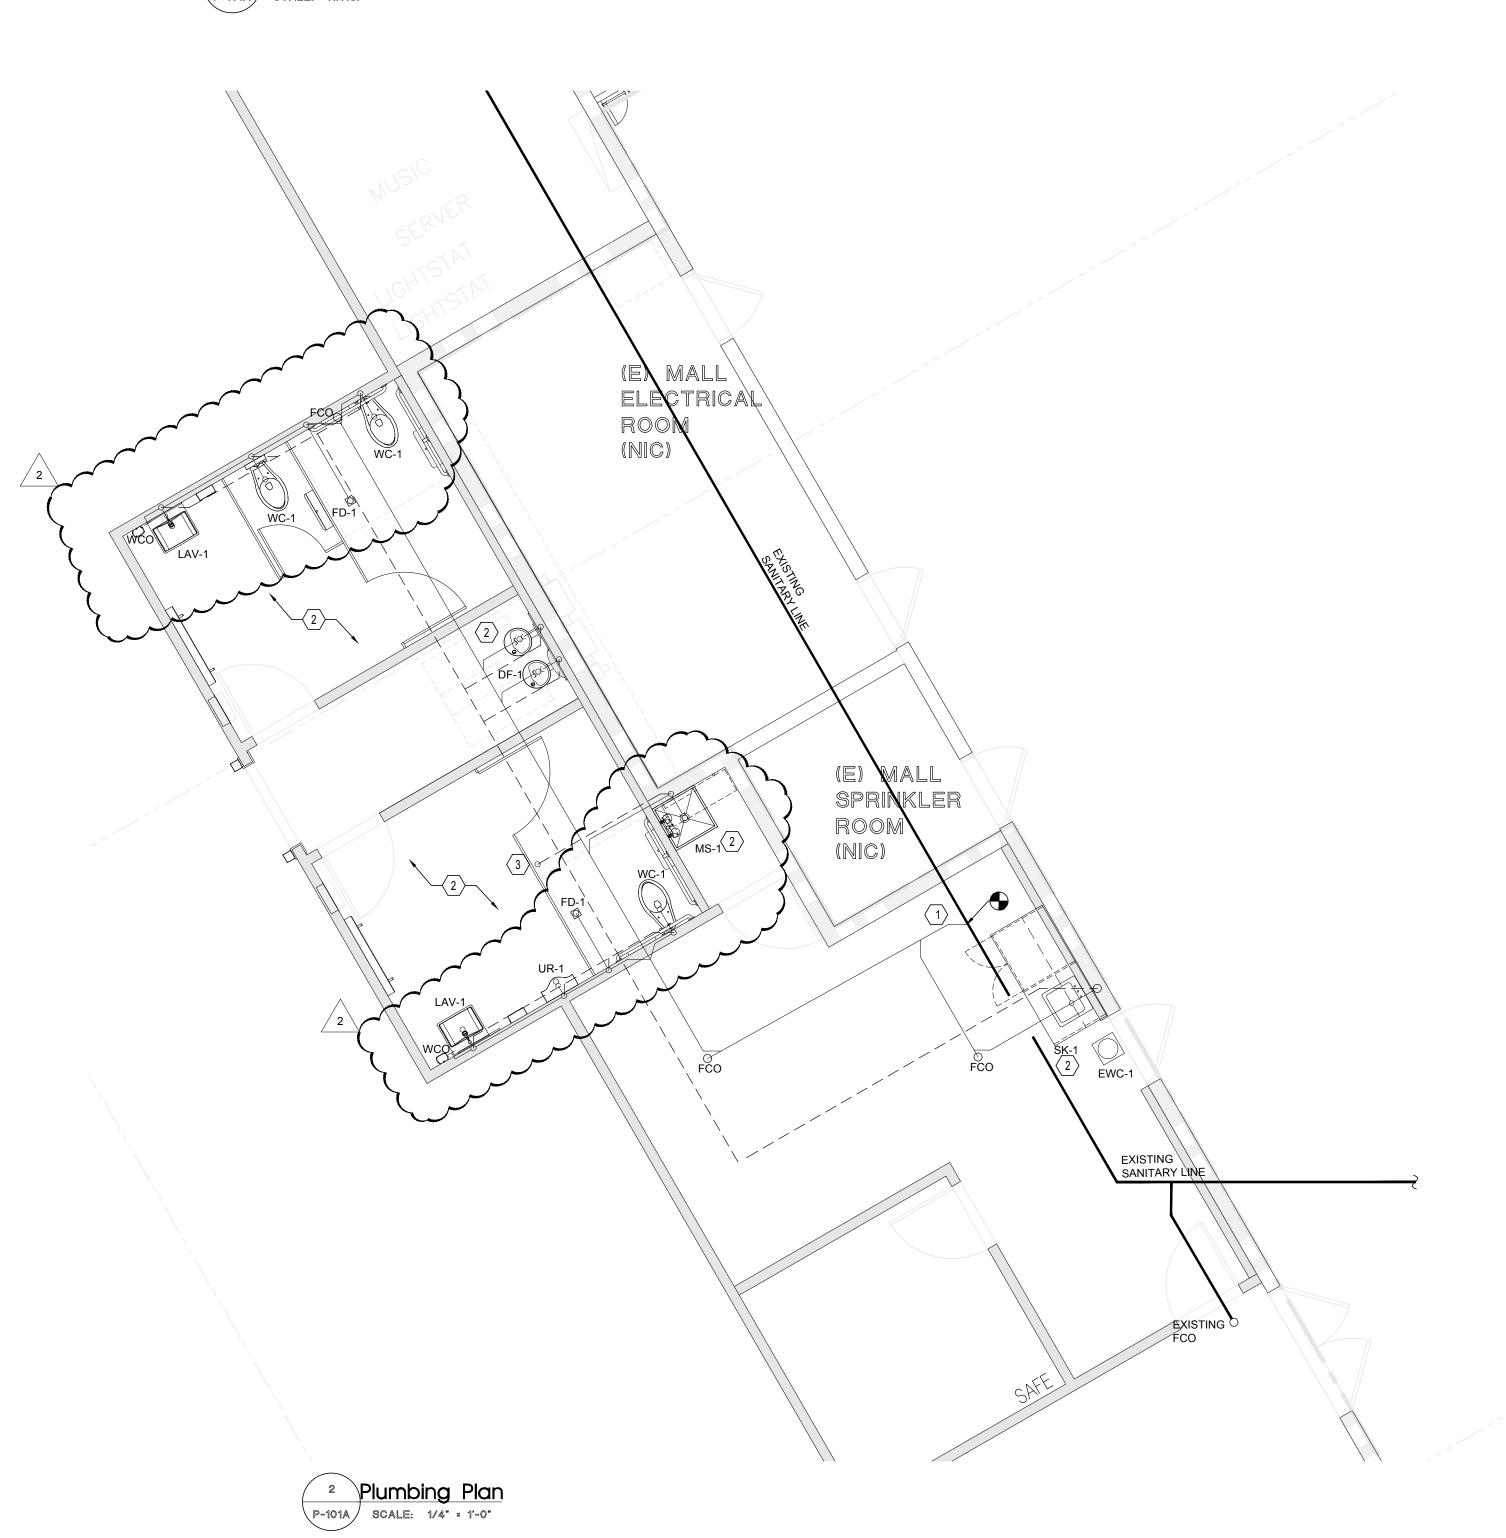

**BARNES&NOBLE** 

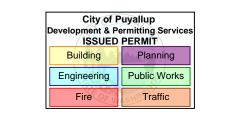

PRCTI20250011

PROJECT DESIGNER:



ARCHITECT:

JOEL TORIELLI 422 BOGERT AVE RIDGEWOOD, NJ 07450

Kenneth A. Fuller, P.E.

SOUTH HILL MALL 3500 S. MERIDIAN UNIT #800 PUYALLUP, WA 98373 Project Number 33247

Store Number 3507

te	Description	No
19-24	ISSUED FOR PERMIT, BID, LANDLORD & CLIENT REVIEW	$\triangle$
20-25	BUILDING DEPARTMENT AND LANDLORD COMMENTS	$\Lambda$
16-25	ISSUED FOR CONSTRUCTION	2
		$\triangle$

These plans are an instrument of service and the property of the Architect, infringements will be

conditions and dimensions at the premises. Discrepancies shall be reported to the Architect prior to the

commencement of any work. Professional Seal:

2. CONTRACTOR PROVIDE PLUMBING FIXTURES AS SPECIFIED ON SHEET #P-201. RECONNECT TO EXISTING SANITARY LINE AND EXISTING VENT LINE LINE AS

3. NEW 3" VENT LINE UP THROUGH ROOF. VERIFY LOCATION PRIOR TO BID.

4. 1-1/2" VENT LINE TO CONNECT TO EXISTING VENT LINE. VERIFY EXACT LOCATION AND POINT OF CONNECTION IN FIELD.

GENERAL NOTES: (PLUMBING)

LOCATIONS AND HEIGHTS.

CODED NOTES: #

A. THESE DRAWINGS ARE DIAGRAMMATIC AND INDICATE THE GENERAL EXTENT OF WORK. THE CONTRACTOR SHALL BE RESPONSIBLE FOR THE COORDINATION AND PROPER INSTALLATION OF ALL PLUMBING SYSTEMS. REFERENCE FOOD SERVICE DRAWINGS WHEN INSTALLING FOR EXACT

B. THE CONTRACTOR SHALL PROVIDE ALL MISCELLANEOUS SUPPORTING STEEL ETC. FOR THE PROPER INSTALLATION OF ALL PLUMBING SYSTEMS.

PIPING SHALL NOT BE LOCATED IN ELECTRICAL ROOMS OR OVER THE TOP OF ANY ELECTRICAL PANELS OR EQUIPMENT.

E. CONTRACTOR SHALL FIELD VERIFY SLAB ON GRADE FLOOR CONSTRUCTION

TYPE PRIOR TO CUTTING. UNDER NO CIRCUMSTANCES SHALL THE CONTRACTOR CUT A STRUCTURAL FLOOR SLAB THICKER THAN FOUR (4") INCHES WITHOUT PRIOR WRITTEN APPROVAL FROM ENGINEER OF RECORD. NOTIFY ENGINEER OF RECORD OF ANY SLAB THICKNESS GREATER THAN FOUR

1. EXTEND AND CONNECT NEW 4 "SANITARY LINE TO EXISTING SANITARY LINE. FIELD VERIFY EXACT SIZE, LOCATION, INVERT ELEVATION, DIRECTION OF

(4") INCHES PRIOR TO PROCEEDING WITH ANY SAW CUTTING.

FLOW, AND POINT OF CONNECTION PRIOR TO ANY WORK.

C. THE CONTRACTOR SHALL COORDINATE FLOOR, WALL AND ROOF PENETRATIONS WITH THE GENERAL CONTRACTOR.

5. 2" VENT LINE TO CONNECT TO EXISTING VENT LINE. VERIFY EXACT LOCATION AND POINT OF CONNECTION IN FIELD.


6. 3" SANITARY LINE TO CONNECT TO EXISTING SANITARY LINE. FIELD VERIFY EXACT SIZE, LOCATION, INVERT ELEVATION, DIRECTION OF FLOW, AND POINT OF CONNECTION PRIOR TO ANY WORK.


THESE DRAWINGS ARE DIAGRAMMATIC AND INDICATE THE GENERAL EXTENT OF THE WORK. THE CONTRACTOR SHALL BE RESPONSIBLE FOR THE COORDINATION AND PROPER INSTALLATION OF ALL PLUMBING SYSTEMS. THE CONTRACTOR SHALL PROVIDE ALL NECESSARY OFFSETS AND FITTINGS WHICH MAY BE REQUIRED DUE TO SPACE CONSTRAINTS OR OTHER CONDITIONS

CONTRACTOR SHALL FIELD VERIFY ALL EXISTING FIELD CONDITIONS PRIOR TO BEGINNING WORK.

Drawing Description: SANITARY WASTE & VENT PLAN

Drawing Number:

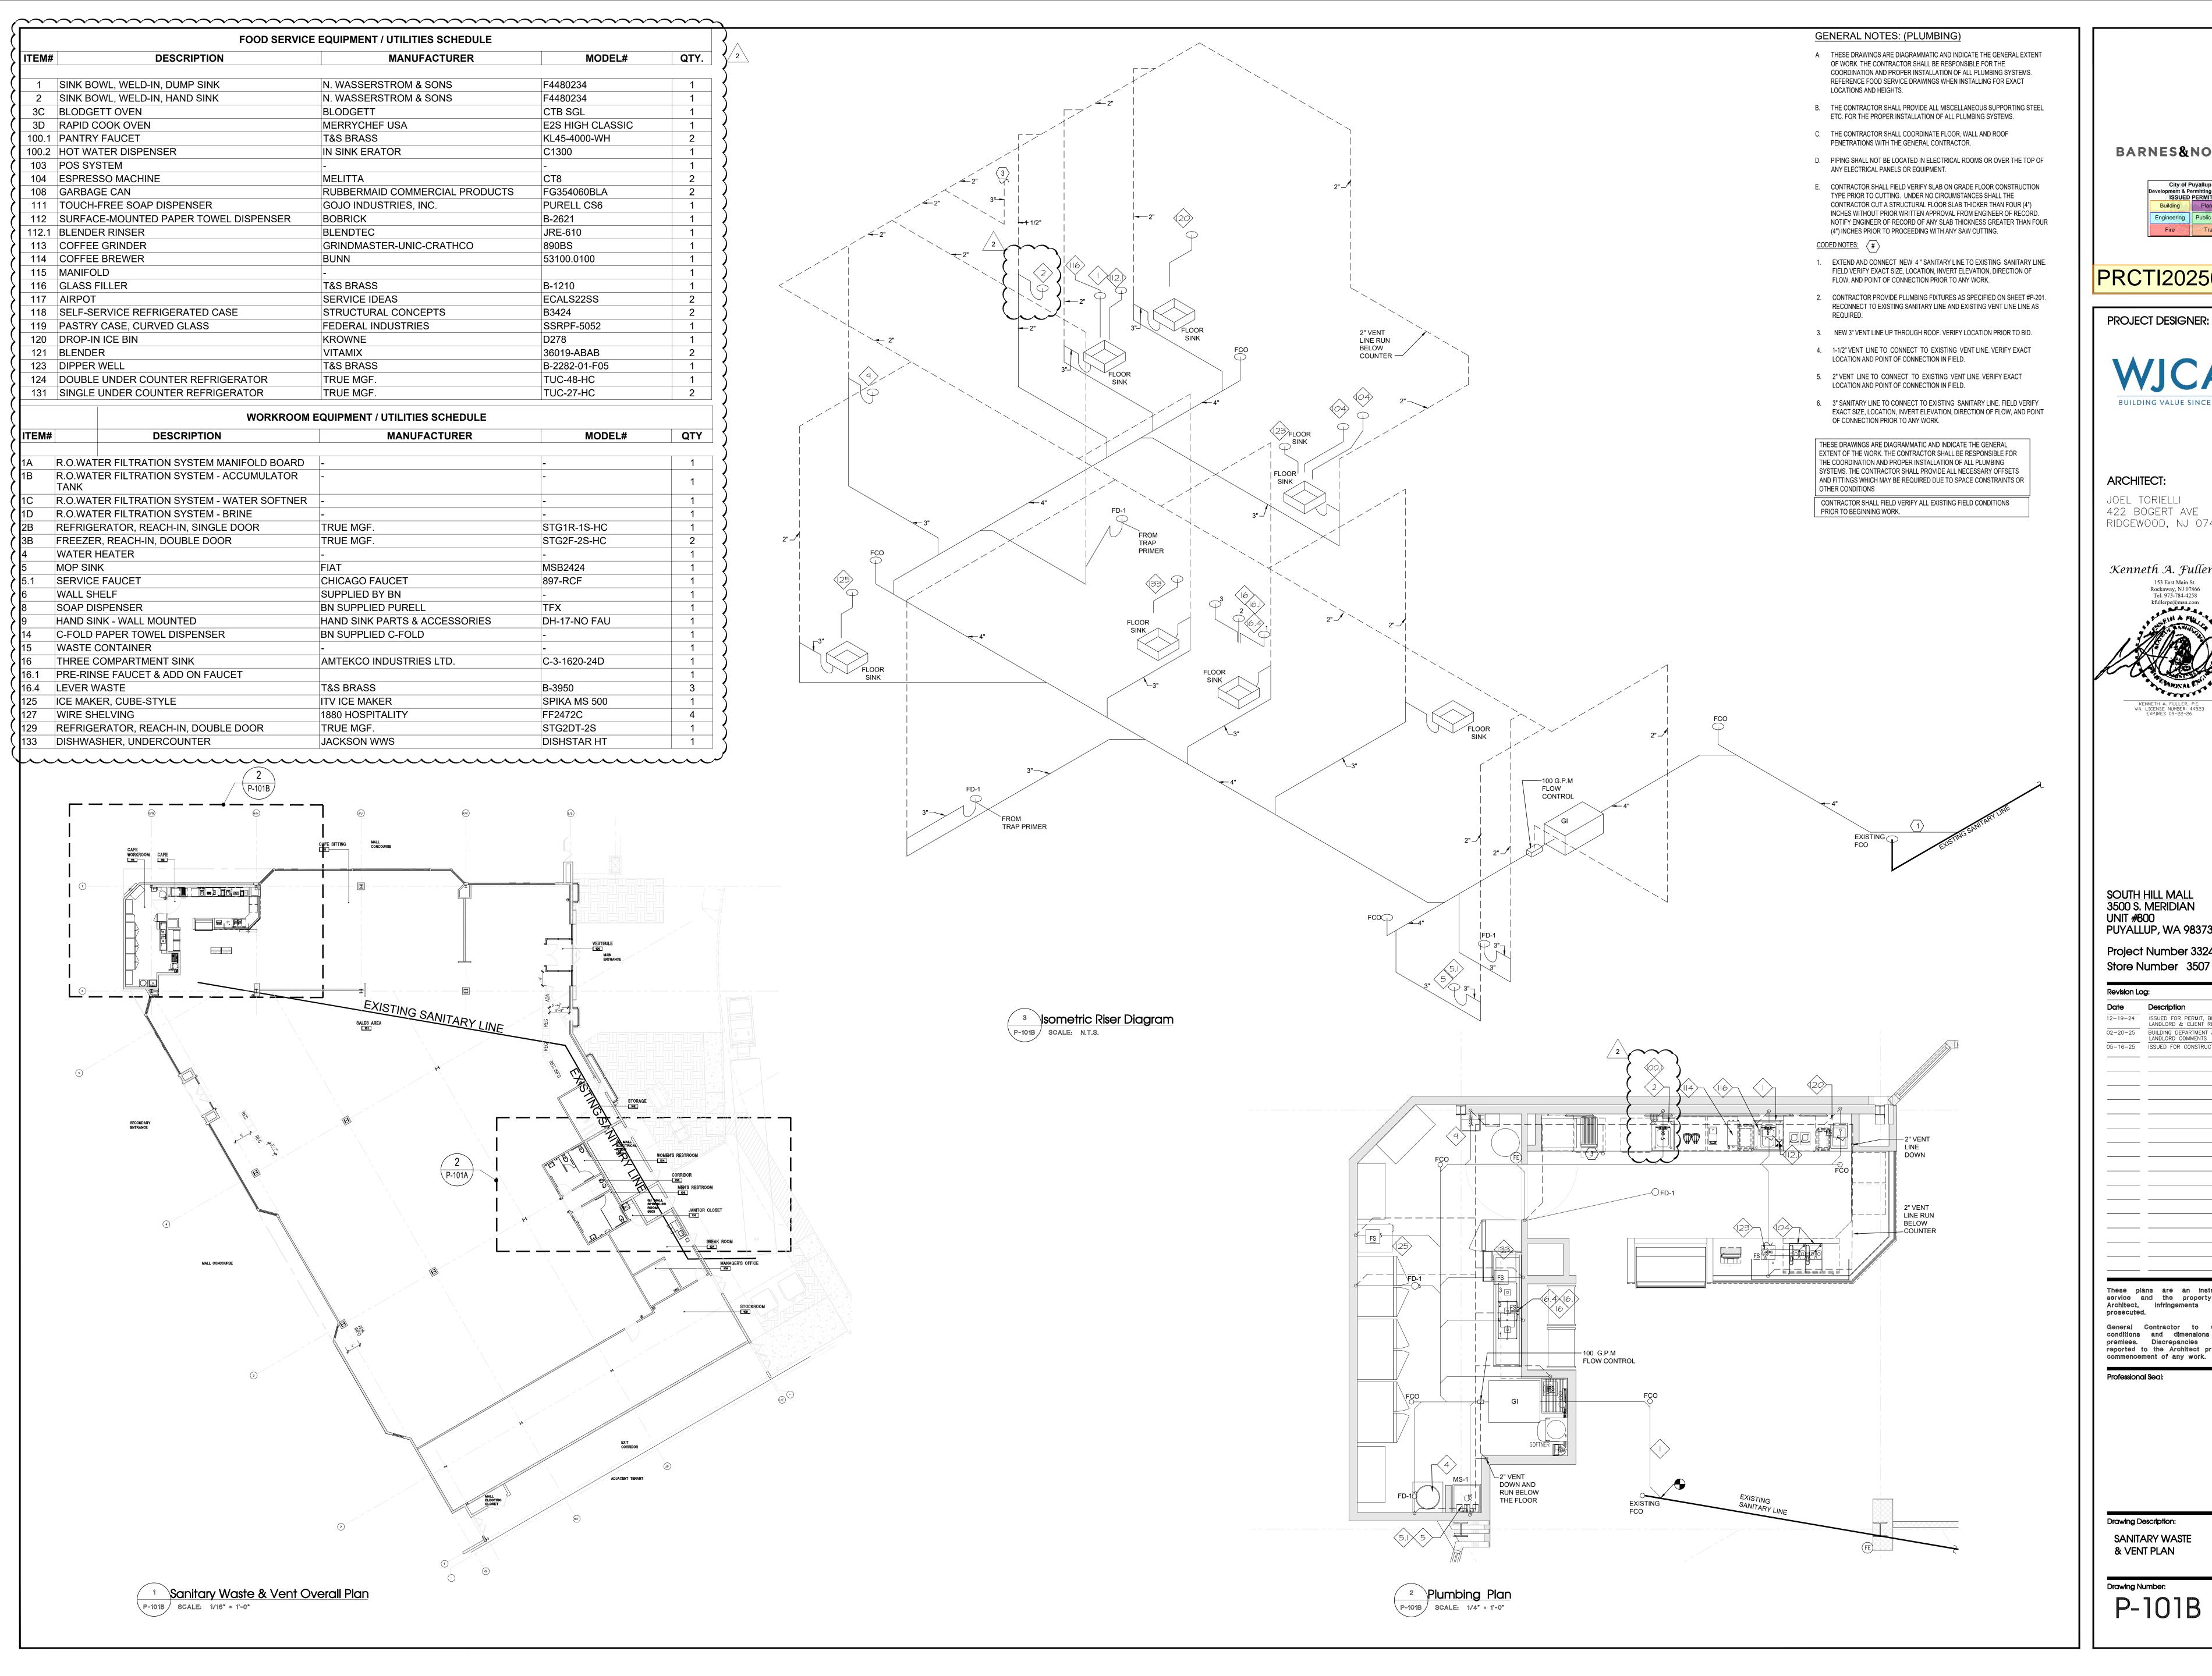

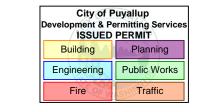

PRCTI2025001

PROJECT DESIGNER:



ARCHITECT:

JOEL TORIELLI 422 BOGERT AVE RIDGEWOOD, NJ 07450

Kenneth A. Fuller, P.E. KENNETH A. FULLER, P.E. WA. LICENSE NUMBER: 44523 EXPIRES 09-22-26

SOUTH HILL MALL 3500 S. MERIDIAN UNIT #800 PUYALLUP, WA 98373 Project Number 33247

Revision Log:

ate	Description	No.
-19-24	ISSUED FOR PERMIT, BID, LANDLORD & CLIENT REVIEW	$\triangle$
-20-25	BUILDING DEPARTMENT AND LANDLORD COMMENTS	$\overline{\Lambda}$
-16-25	ISSUED FOR CONSTRUCTION	2
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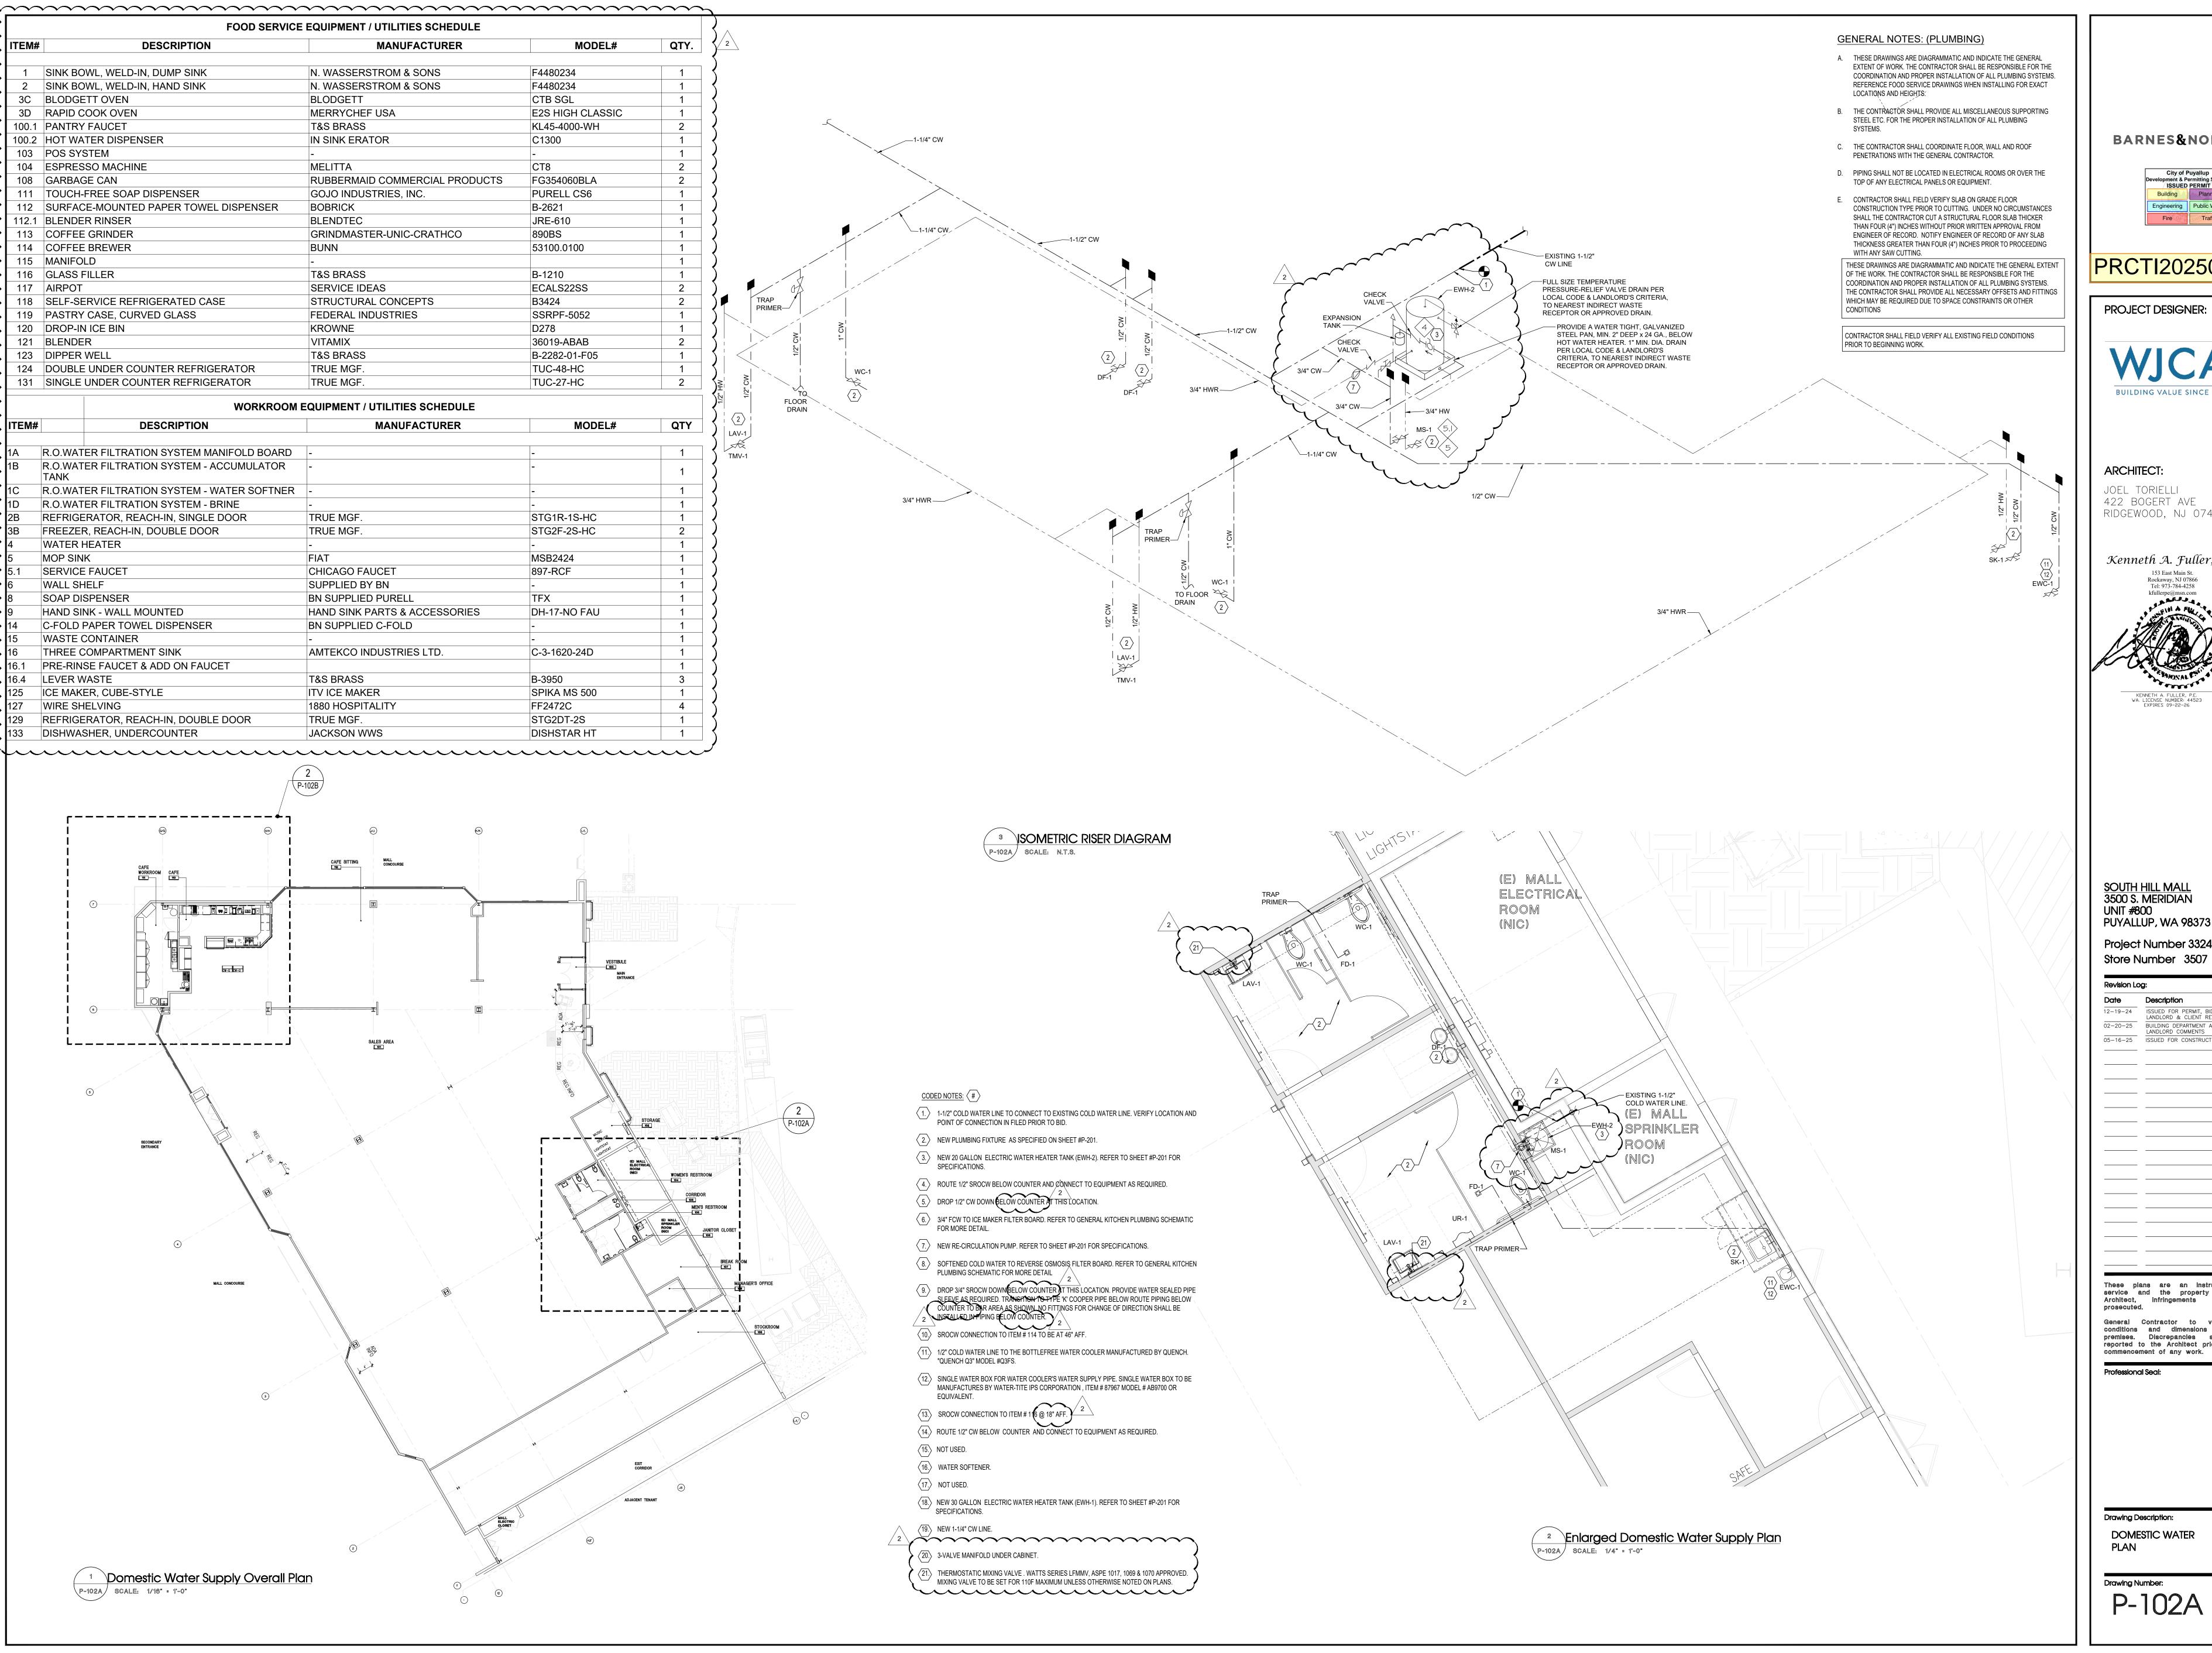
service and the property of the Architect, infringements will be


premises. Discrepancies shall be reported to the Architect prior to the commencement of any work.

Professional Seal:

Drawing Description: SANITARY WASTE & VENT PLAN

Drawing Number: P-101B



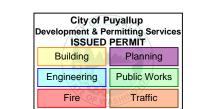



**ARCHITECT:** 

JOEL TORIELLI 422 BOGERT AVE RIDGEWOOD, NJ 07450



SOUTH HILL MALL 3500 S. MERIDIAN UNIT #800 PUYALLUP, WA 98373 Project Number 33247

te	Description	No.
19-24	ISSUED FOR PERMIT, BID, LANDLORD & CLIENT REVIEW	Δ
20-25	BUILDING DEPARTMENT AND LANDLORD COMMENTS	$\Lambda$
16-25	ISSUED FOR CONSTRUCTION	2
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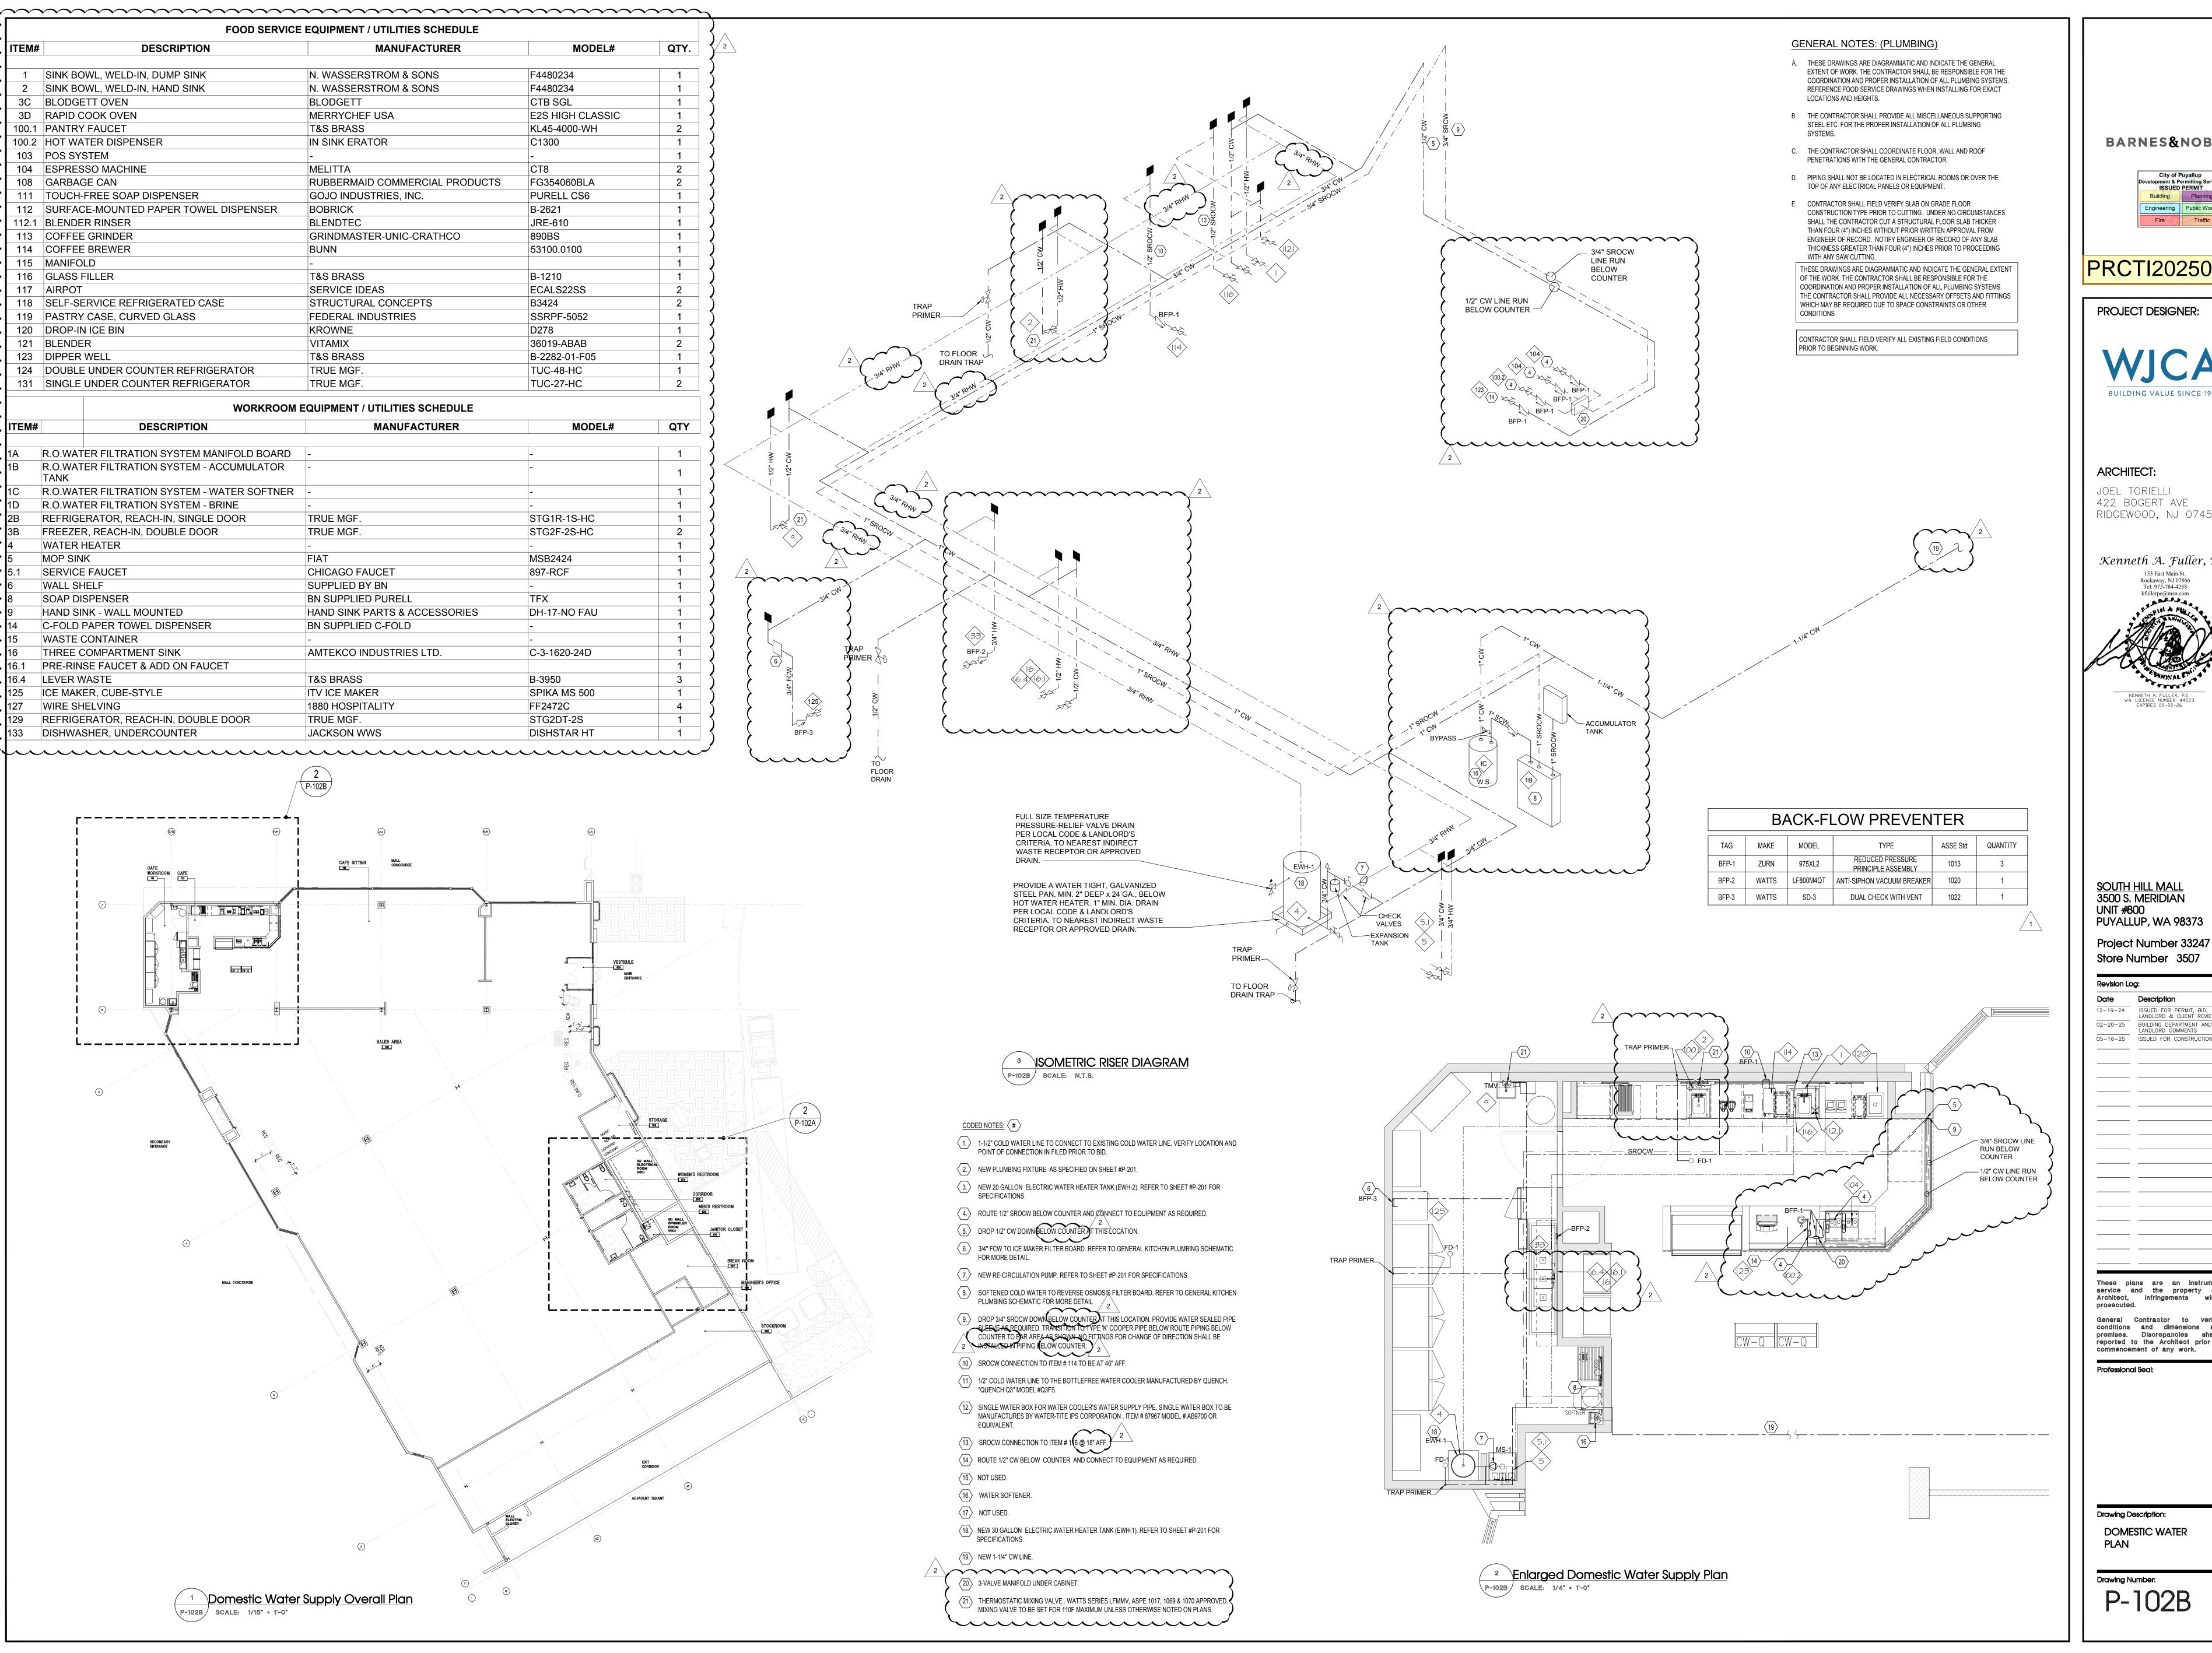
These plans are an instrument of service and the property of the Architect, infringements will be


premises. Discrepancies shall be reported to the Architect prior to the commencement of any work.

Professional Seal:

Drawing Description: DOMESTIC WATER

Drawing Number: P-102A



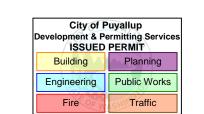


PROJECT DESIGNER:



**ARCHITECT:** 

JOEL TORIELLI 422 BOGERT AVE RIDGEWOOD, NJ 07450

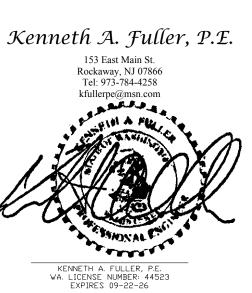

SOUTH HILL MALL 3500 S. MERIDIAN UNIT #800 PUYALLUP, WA 98373

te	Description	No.
19-24	ISSUED FOR PERMIT, BID, LANDLORD & CLIENT REVIEW	Δ
20-25	BUILDING DEPARTMENT AND LANDLORD COMMENTS	1
16-25	ISSUED FOR CONSTRUCTION	2
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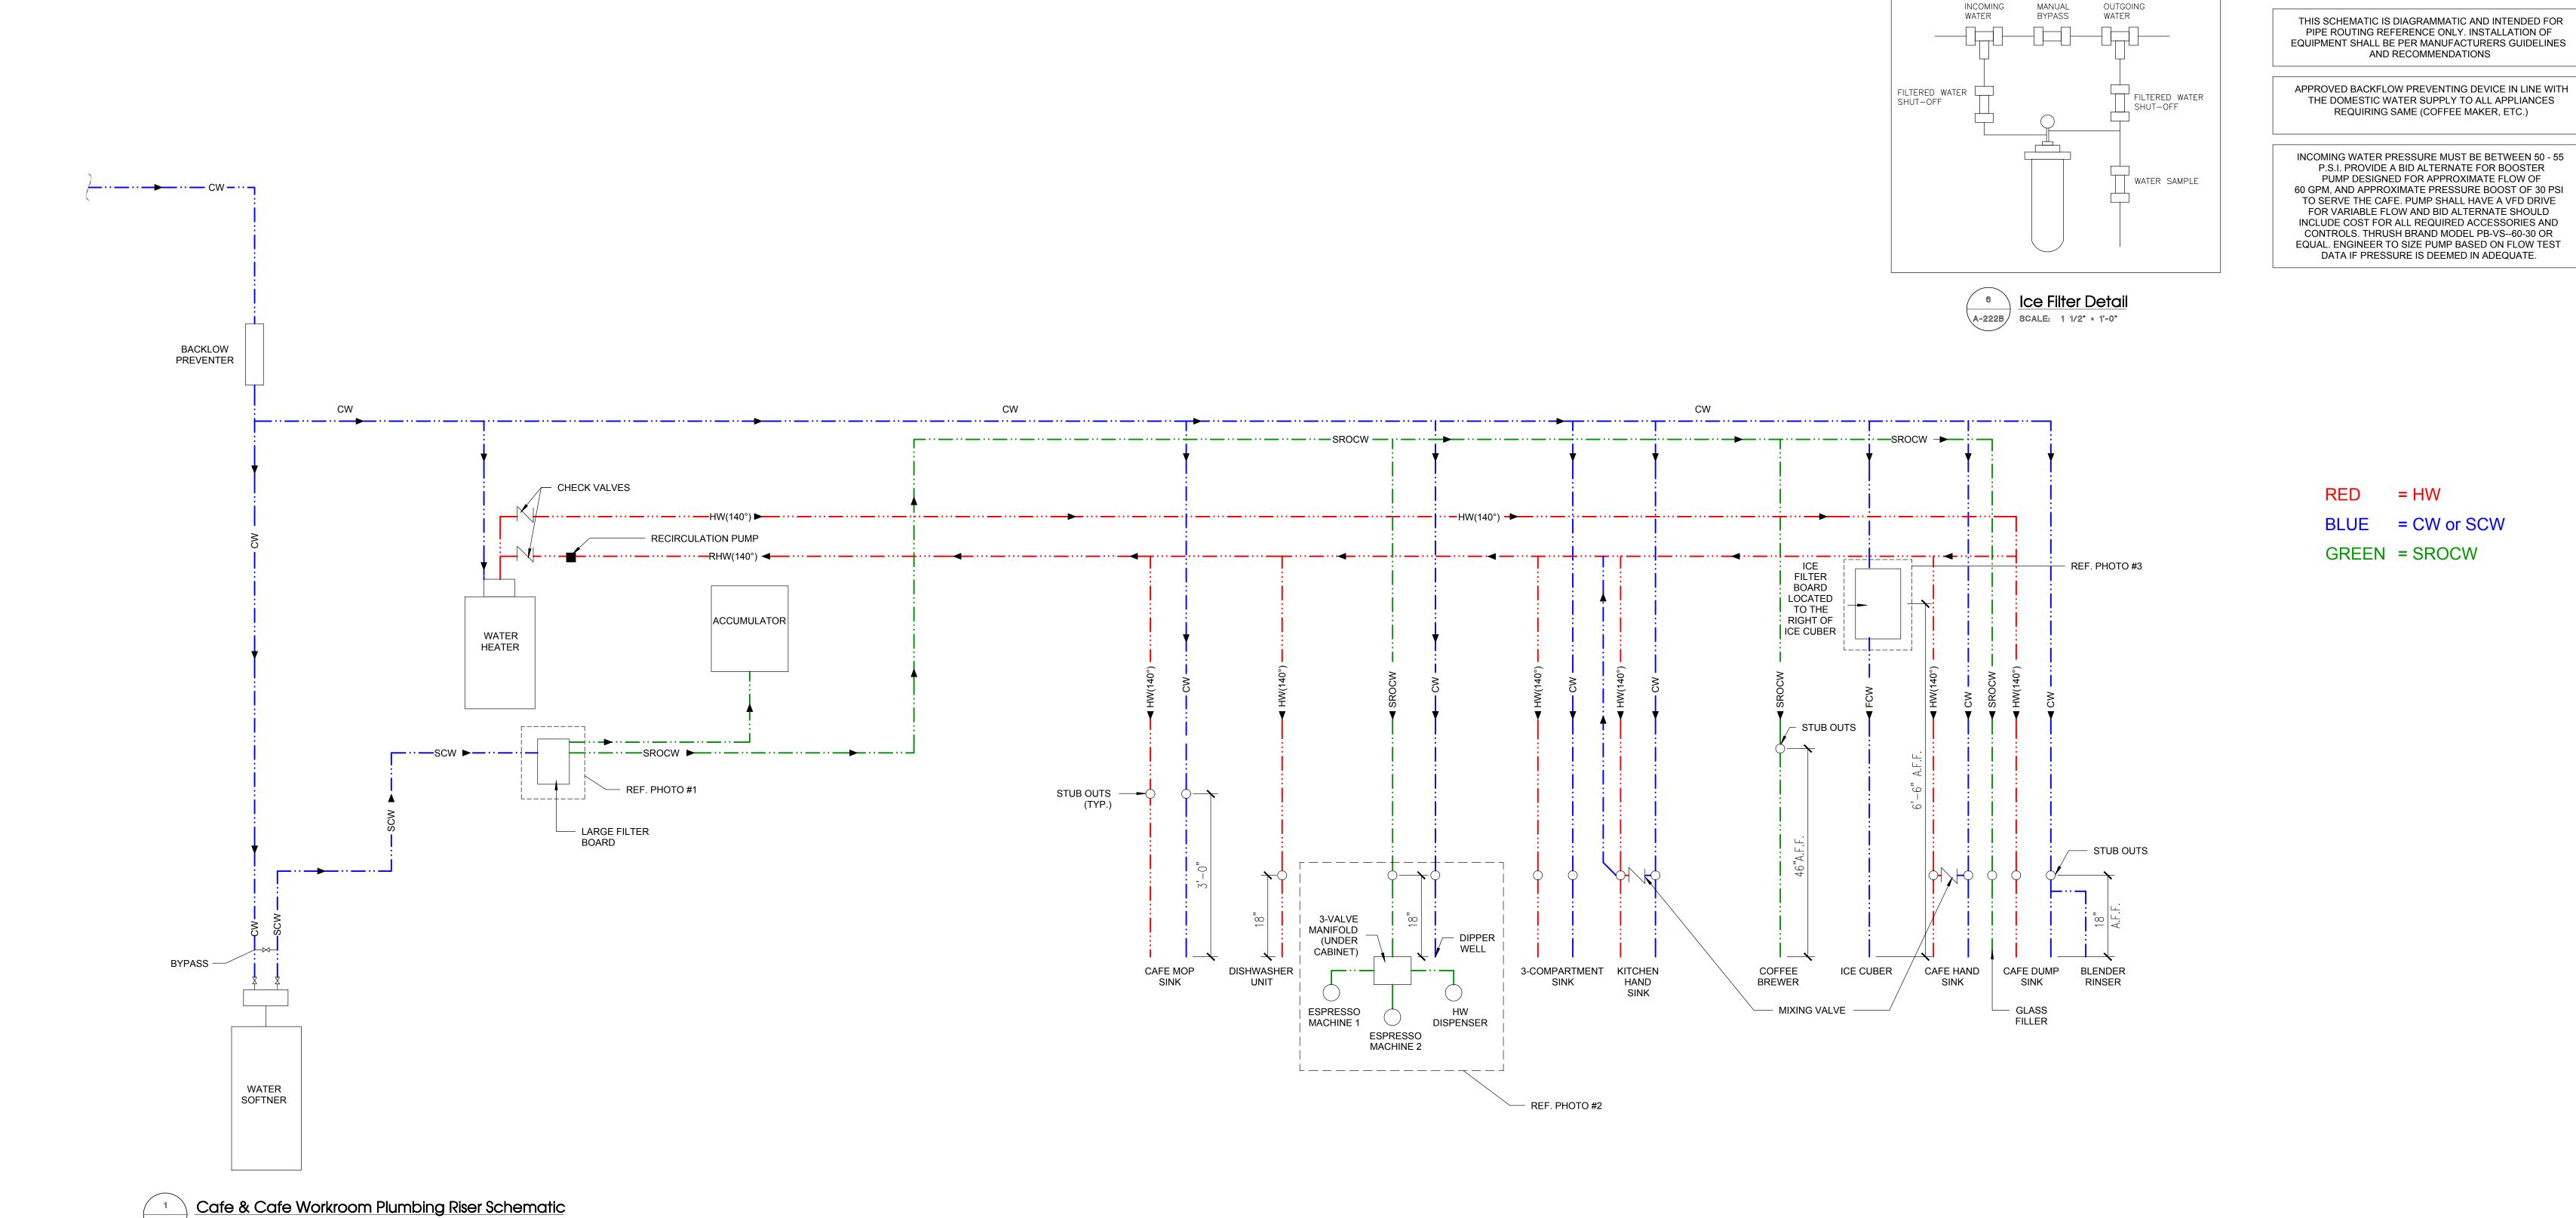
These plans are an instrument of service and the property of the Architect, infringements will be

conditions and dimensions at the premises. Discrepancies shall be reported to the Architect prior to the commencement of any work.

Professional Seal:

DOMESTIC WATER

Drawing Number: P-102B






A-222B SCALE: 3/4" : 1'-0" (COORDINATE WITH M.E.P. DWGS.)

Reference Photo #1

SCALE: 3/4" = 1'-0"

WATER FILTRATION BOARD IN WORK ROOM



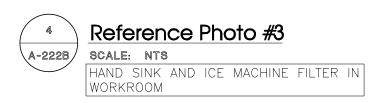



Reference Photo #4

scale: NTS

ACCUMULATOR TANK IN WORKROOM

THIS SCHEMATIC IS DIAGRAMMATIC AND INTENDED FOR PIPE ROUTING REFERENCE ONLY. INSTALLATION OF EQUIPMENT SHALL BE PER MANUFACTURERS GUIDELINES

REFER TO PLUMBING ISOMETRIC FOR SIZING


AND RECOMMENDATIONS

REQUIRING SAME (COFFEE MAKER, ETC.)

P.S.I. PROVIDE A BID ALTERNATE FOR BOOSTER PUMP DESIGNED FOR APPROXIMATE FLOW OF

DATA IF PRESSURE IS DEEMED IN ADEQUATE.

GREEN = SROCW

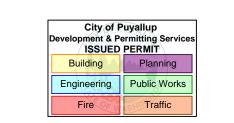


**BARNES&NOBLE** 

PROJECT DESIGNER:



ARCHITECT:

JOEL TORIELLI 422 BOGERT AVE RIDGEWOOD, NJ 07450

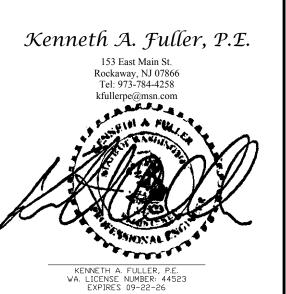

SOUTH HILL MALL 3500 S. MERIDIAN UNIT #800 PUYALLUP, WA 98373 Project Number 33247

Store Number 3507

Date	Description	No
2-19-24	ISSUED FOR PERMIT, BID, LANDLORD & CLIENT REVIEW	$\triangle$
02-20-25	BUILDING DEPARTMENT AND LANDLORD COMMENTS	$\Lambda$
05-16-25	ISSUED FOR CONSTRUCTION	2
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premises. Discrepancies shall be reported to the Architect prior to the

commencement of any work.


Drawing Description: DOMESTIC WATER


Drawing Number:

Cafe & Cafe Workroom Plumbing Riser Schematic

SCALE: N.T.S. (FOR ADDITIONAL INFORMATION REFER TO WITH SHEET #A-222B)

THIS PLUMBING RISER SCHEMATIC IS FOR REFERENCE ONLY. REFER TO PLUMBING DESIGN IN SHEET #P-102B, FOR WATER DISTRIBUTION, PIPE SIZES, AND CODE COMPLIANCE COMPONENTS.

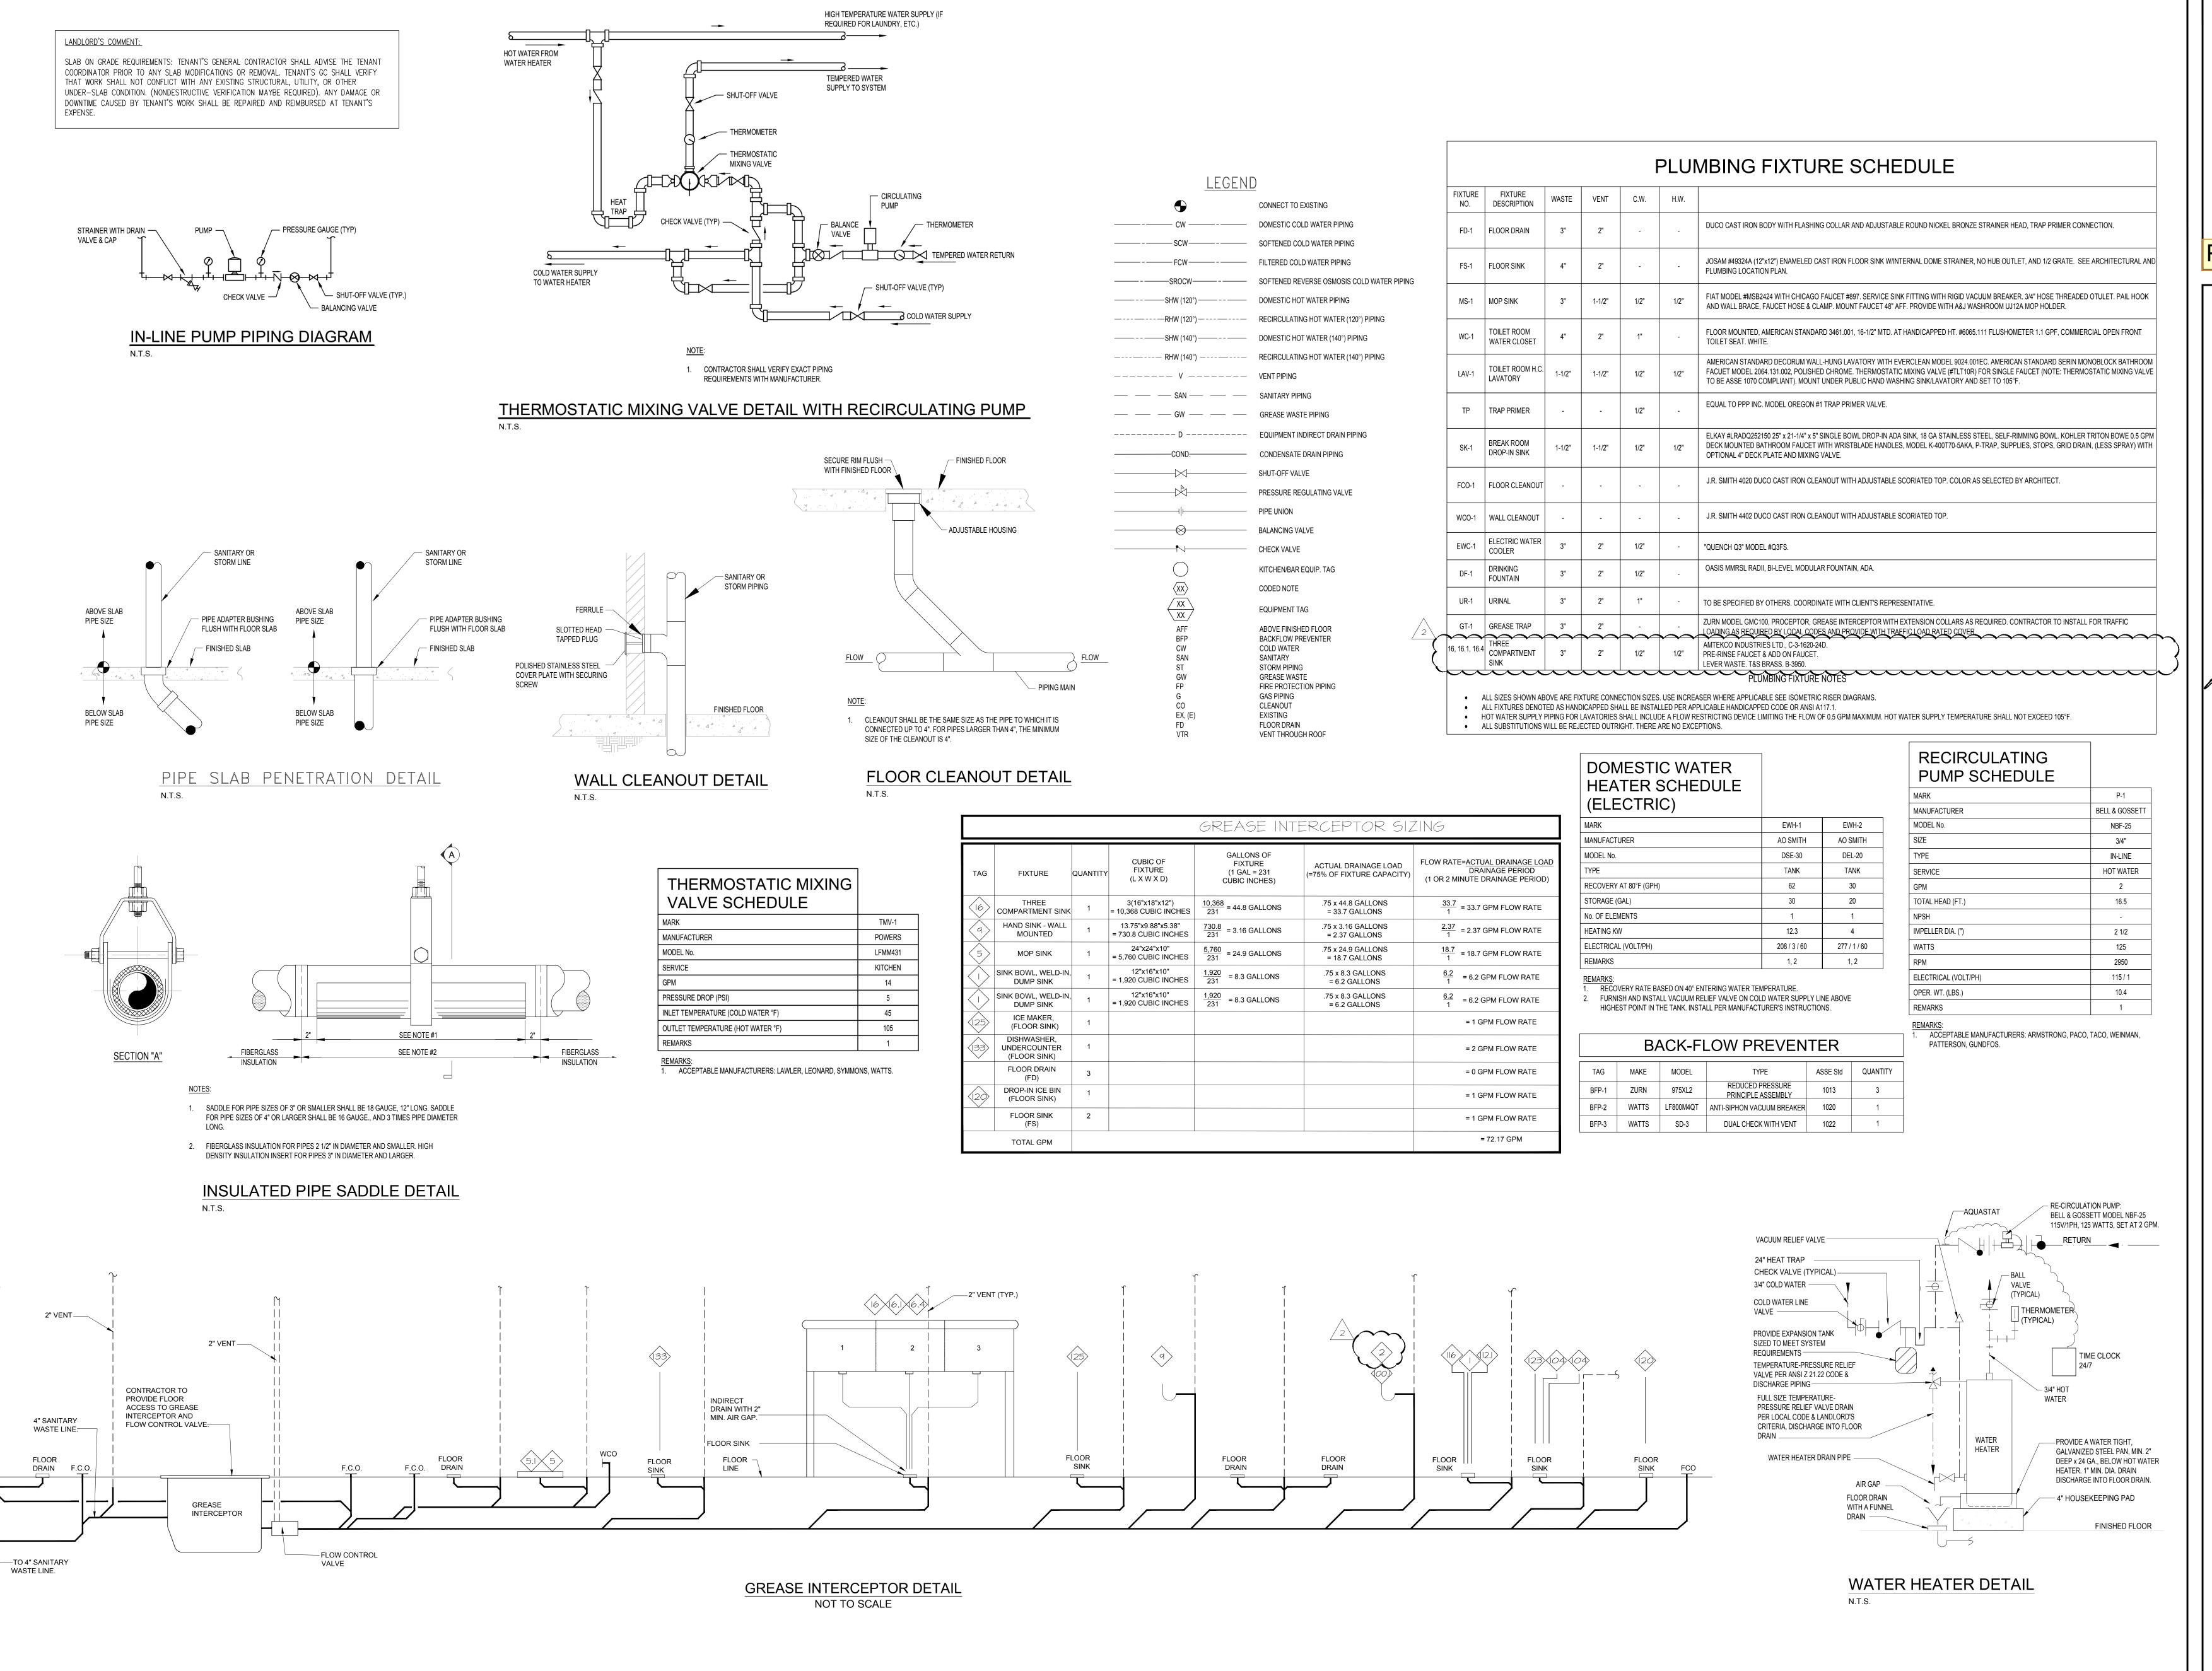

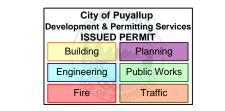

PROJECT DESIGNER:



**ARCHITECT:** 

JOEL TORIELLI 422 BOGERT AVE RIDGEWOOD, NJ 07450



SOUTH HILL MALL 3500 S. MERIDIAN UNIT #800 PUYALLUP, WA 98373

Project Number 33247

Store Number 3507

Description  ISSUED FOR PERMIT, BID, LANDLORD & CLIENT REVIEW  BUILDING DEPARTMENT AND LANDLORD COMMENTS  ISSUED FOR CONSTRUCTION	No.
LANDLORD & CLIENT REVIEW BUILDING DEPARTMENT AND LANDLORD COMMENTS	$\frac{\triangle}{\triangle}$
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service and the property of the Architect, infringements will be conditions and dimensions at the premises. Discrepancies shall be reported to the Architect prior to the commencement of any work.

These plans are an instrument of

Professional Seal:

Drawing Description: PLUBMING SCHEDULES, LEGEND & DETAILS

Drawing Number: P-201