Abbreviations MAS MASONRY ANCHOR BOLT MAT'L MATERIAL ACOUSTICAL ACOUSTICAL CEILING TILE MAXIMUM METAL BASE ADJUSTABLE MECH MECHANICAL ARCHITECT OR ENGINEER ABOVE FINISH FLOOR MEMB MEMBRANE AUTHORITY HAVING JURISDICTION MFR MANUFACTURER ALUM ALUMINUM MIN MINIMUM ANOD ANODIZED MISC MISCELLANEOUS APC ACOUSTIC PANEL CEILING MASONRY OPENING ARCH ARCHITECT, ARCHITECTURAL METAL MW MICROWAVE ASF ALUMINUM STOREFRONT NORTH BAR REINFORCING BAR BFF BELOW FINISH FLOOR NOT IN CONTRACT BLDG BUILDING NOM NOMINAL BLKG BLOCKING NTS NOT TO SCALE BLW BELOW BRICK MASONRY UNIT OCC ON CENTER BOTTOM OF OCCUPANTS, OCCUPANCY BS BOTH SIDES OD OUTSIDE DIAMETER BTWN BETWEEN OFF OFFICE ОН BUR BUILT-UP ROOF OVERHAND OPNG OPENING CG CORNER GUARD OPP OPPOSITE VIEW OTS OPEN TO STRUCTURE CEILING HEIGHT CIP CAST-IN-PLACE PAINT CONTROL JOINT PLUMBING FIXTURE CENTERLINE CLG POLYMER CEMENT CEILING CLR CLEAR PERF PERFORATED CMU CONCRETE MASONRY UNIT PANIC HARDWARE COL COLUMN PLATE CONC CONCRETE PLAM PLASTIC LAMINATE CONST CONSTRUCTION PLAS PLASTIC CONT CONTINUOUS PLYWD PLYWOOD CONTR CONTRACTOR PNL PANEL CORR CORRIDOR PAINT, PAINTED CPT CARPET PREFAB PREFABRICATED COLD ROLLED CR PREFIN PREFINISHED CERAMIC TILE PRESSURE TREATED PAPER TOWEL HOLDER CTR CENTER DEPT DEPARTMENT RADIUS DRINKING FOUNTAIN RUBBER BASE DIAMETER RCP REFLECTED CEILING PLAN DIMENSION DIM ROOF DRAIN DEADLOAD REFER, REFERENCE REFR REFRIGERATOR DOWN REINF REINFORCE, REINFORCED DIMENSION POINT DOOR REQD REQUIRED DOWNSPOU^{*} REV REVISION DW DISHWASHER ROOM DWG DRAWING ROUGH OPENING RESIN PANEL **EXISTING** EAST SCHED SCHEDULE EACH SMOKE DETECTOR SQUARE FEET EXPANSION BOLT **EXPANSION JOINT** SHT SHEET SHTG SHEATHING **ELEVATION** ELEC ELECTRICAL SIM SIMILAR ELEV ELEVATOR SMC SUSPENDED METAL CEILING EMER EMERGENCY SOG SLAB ON GRADE EQ EQUAL SPLASH PAN SPEC SPECIFICATION, SPECIFIED EQUIP EQUIPMENT EW EACH WAY SQUARE SOLID SURFACING EXH EXHAUST SSF SSTL STAINLESS STEEL EXPANSION EXT EXTERIOR STL STEEL STOR STORAGE STN STAIN FLAT BAR STRUCT STRUCTURAL FBO FURNISHED BY OWNER SUSP SUSPENDED FLOOR DRAIN FIRE EXTINGUISHER THERMOSTAT FIRE EXTINGUISHER CABINET TONGUE & GROOVE FINISH FLOOR TEL TELEPHONE FINISH GRADE TEMP TEMPORARY FIN FINISH TEMP TEMPERED FIXT FIXTURE THK THICK FLSHG FLASHING TOP OF FND FOUNDATION TOP OF STRUCTURE FO FACE OF TOW TOP OF WALL FOIC FURNISHED BY OWNER TS TUBE STEEL TYP TYPICAL INSTALLED BY CONTRACTOR FOIO FURNISHED AND INSTALLED BY OWNER FOOT, FEET UNO UNLESS NOTED OTHERWISE FTG FOOTING FV FIELD VERIFY VAPOR BARRIER GA GAUGE VINYL COMPOSITION TILE GB GRAB BAR VERT VERTICAL G&S GLUE & SCREW VEST VESTIBULE GALV GALVANIZED VERIFY IN FIELD VENEER PLASTER GENERAL CONTRACTOR GEN GENERAL GL GLASS GRID LINE WIDE GMT GLASS MOSAIC TILE WINDOW GWB GYPSUM BOARD WITH GS GYPSUM SHEATHING WATER CLOSET WOOD HIGH WASHER/DRYER HI HIGH WATER HEATER HDWR HARDWARE WITHOUT HM HOLLOW METAL WATERPROOF HORIZ HORIZONTAL WEIGHT WWF WELDED WIRE FABRIC HR HOUR HT HEIGHT WWM WELDED WIRE MESH HVAC HEATING, VENTILATION, AIR CONDITIONING HWD HARDWOOD HWH HOT WATER HEATER SYMBOLS INSIDE DIAMETER ANGLE IN INCH ΑT INCL INCLUDE, INCLUDING CHANNEL INSUL INSULATE, INSULATION NUMBER INT INTERIOR JT JOINT KO KNOCK OUT

LOCK LONG LOW

LAV LAVATORY

LOW LIGHT LIGHT VALENCE

LN LO LT

LAM LAMINATE, LAMINATED

LIVE LOAD

LINOLEUM

Drawing Symbols

NORTH ARROW

GRID LINE MARKER

INTERIOR ELEVATIONS

FLOOR FINISH (FINISH COLOR)

ROOM NAME

ROOM NUMBER

WINDOW TYPE

DOOR NUMBER

RELITE TYPE

CEILING TYPE

CEILING HEIGHT

PARTITION TYPE

MATERIAL TAG

EXISTING TOPOGRAPHY

NEW TOPOGRAPHY

1-HOUR FIRE RATED

2-HOUR FIRE RATED

BUILDING SEPARATION

ENCLOSURE

CONC **←**→ CPT FLOOR FINISH TRANSITION

- **EXTERIOR ELEVATION**

ROOM NAME

101A

10'-0" AFF

-----410-----

- IN THE PERMITTING JURISDICTION AT THE DETAIL TIME OF PERMITTING. 5. REPETITIVE FEATURES DRAWN OR NOTED ONLY ONCE SHALL BE COMPLETELY PROVIDED AS IF DRAWN OR NOTED IN FULL
 - 6. THESE DRAWINGS ARE SPECIFIC TO THIS PROJECT. THESE DRAWINGS OR PORTIONS THEREOF SHALL NOT BE USED FOR OTHER

General Notes

1. CONTRACTOR TO VERIFY ALL DIMENSIONS

WORK. CONTRACTOR SHALL REPORT

DIMENSIONS ARE SHOWN FACE OF STUD,

ARE SHOWN TO FACE OF FINISH FOR

3. ALL APPLICABLE CODES AND ORDINANCES

4. ALL WORK IS TO CONFORM TO THE CURRENT

VERSION OF THE INTERNATIONAL BUILDING

CODE (IBC) AND ALL AMENDMENTS IN EFFECT

NOTES AND SPECIFICATIONS.

TAKE PRECEDENCE OVER ALL DRAWINGS,

FACE OF CONCRETE OR MASONRY, AND TO

CENTERLINE OF GRID LINES, UNLESS NOTED OTHERWISE ON THE DRAWINGS. DIMENSIONS

THE ARCHITECT IMMEDIATELY.

EXISTING WORK.

AND CONDITIONS BEFORE PROCEEDING WITH

ERRORS, OMISSIONS AND DISCREPANCIES TO

- STOP WORK AND NOTIFY OWNER IF ASBESTOS OR HAZARDOUS MATERIALS ARE DISCOVERED.
- 8. DO NOT SCALE THE DRAWINGS. THE CONTRACTOR SHALL REFER TO DIMENSIONS SHOWN ON DRAWINGS AND INFORM ARCHITECT OF ANY DISCREPANCIES.

Materials & Symbols

COMPACTED EARTH SAND, GRAVEL, OR

CRUSHED ROCK CONCRETE

MASONRY (IN PLAN)

WOOD - CONTINUOUS

WOOD FINISH


RIGID INSULATION MINERAL WOOL BATT INSULATION

MINERAL WOOL BOARD INSULATION

GYPSUM BOARD

REVISION TAG

TEACHING STATION TAG

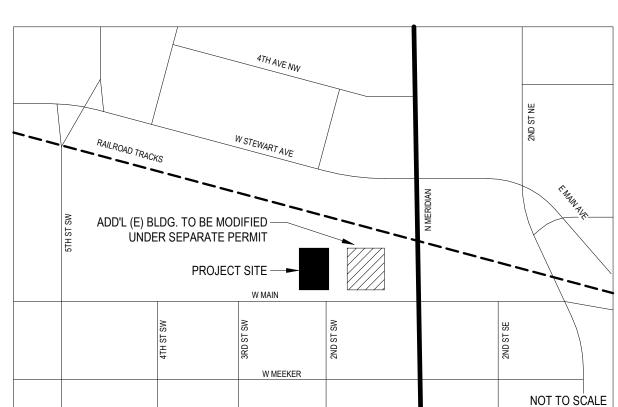

Project Information

Owner

COMMUNITY HEALTH CARE 1148 BROADWAY, SUITE 100 TACOMA, WA 98042 CONTACT: DEBBIE JACOBSON

Owner Project Manager

ROCK PROJECT MANAGEMENT SERVICES 1601 E VALLEY RD, SUITE 110 RENTON, WA 98057 CONTACT: ANNE REESE

Project Description

ADDRESS 201 W MAIN

PUYALLUP, WA 98371 TAX PARCEL NUMBER 7940100244

PROJECT DESCRIPTION
PROJECT SCOPE RECAP ONLY. REFER TO DRAWINGS AND SPECIFICATIONS FOR DESCRIPTION AND REQUIREMENTS.

REROOFING THE EXISTING SILO ON ROOF OF BUILDING.

Section 28 Township 20 Range 04 Quarter 14 STEWARTS J P 1ST ADD PARCEL "A" OF DBLR 2006-04-14-5003 DESC AS FOLL COM AT 1/4 SEC COR COM TO SEC 28 & 27 TH N 89 DEG 11 MIN 44 SEC W 457.20 FT ALG C/L OF MAIN ST TH N 00 DEG 48 MIN 16 SEC E 30 FT TO S LI OF B 4 & POB TH N 01 DEG 07 MIN 04 SEC E 76.45 FT TH S 89 DEG 11 MIN 44 SEC E 5 FT TH N 01 DEG 07 MIN 04 SEC E 30 FT TH S 89 DEG 11 MIN 44 SEC E 6.50 FT TH N 01 DEG 07 MIN 04 SEC E 63.85 FT TO NLY LI OF SD B 4 TH S 74 DEG 19 MIN 59 SEC E 69.21 FT TH S 89 DEG 11 MIN 44 SEC E 44.65 FT TH N 00 DEG 41 MIN 04 SEC E 3.39 FT TH S 89 DEG 11 MIN 44 SEC 20.19 FT TO BEG OF NON TANG C TO L RAD OF 101 FT RAD CTR S 27 DEG 01 MIN 36 SEC TH ALG SD CURVE 14.97 THRU CENT ANGLE OF 08 DEG 29 MIN 30 SEC TH S 00 DEG 48 MIN 16 SEC W 161.91 FT TO NLY MAR OF SD ST TH N 89 DEG 11 MIN 44 SEC W 157.87 FT TO POB OUT OF 024-3 SEG 2006-1084 04/26/06CL

Project Team

Architect

MILLER HAYASHI ARCHITECTS PLLC 118 N 35TH STREET, SUITE 200 SEATTLE, WA 98103 206 634 0177 CONTACT: ELLEN HAGEN

Structural Engineer

Site Plan

PCS STRUCTURAL SOLUTIONS 1250 PACIFIC AVE, SUITE 701 TACOMA, WA 98402

CHC Puyallup - Cannery Silo Reroof



CHC Puyallup -Cannery Silo Reroof

201 W. Main Puyallup, WA 98371

Miller HayashiArchitects

118 North 35th St. Suite 200 Seattle, Washington 98103 Tel: 206 634 0177 Fax: 206 634 0167

ARCHITECT'S STAMP



CONSULTANT

Sheet Index

AA1.00 TITLE SHEET, SHEET INDEX & GENERAL NOTES

A2.00 **ROOF PLAN**

A2.20 ENLARGED ROOF PLAN, DETAILS & EXISTING PHOTOS

& Industries.

1-800-647-0982

Separate Electrical Permit is required with

the Washington State Department of Labor

https://lni.wa.gov/licensing-permits/electrical/

EXISTING BUILDING

27,593 GROSS SF

electrical-permits-fees-and-inspections

or call for Licensing Information:

Approval of submitted plans is not an approval of omissions or oversights by this office or non compliance with any applicable regulations of local government. The contractor is responsible for making sure that the building complies with all applicable codes and regulations of the local government.

The approved construction plans, documents, and all engineering must be posted on the job at all inspections in a visible and readily accessible location.

Full sized legible color plans are required to be provided by the permitee on site for inspection.


City of Puyallup Building **REVIEWED FOR** COMPLIANCE

SKinnear 06/24/2025 1:27:29 PM




PRRF20250705

CONSULTANT'S STAMP

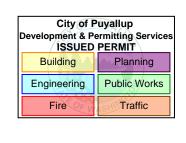

BUILDING DEPARTMENT'S STAMP

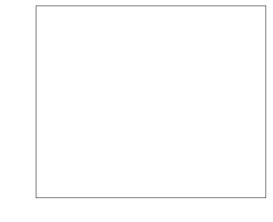

PHASE

Silo Re-Roof **Permit Set**


DATE


05/22/25

REVISIONS

SHEET TITLE

TITLE SHEET **SHEET INDEX & GENERAL NOTES**

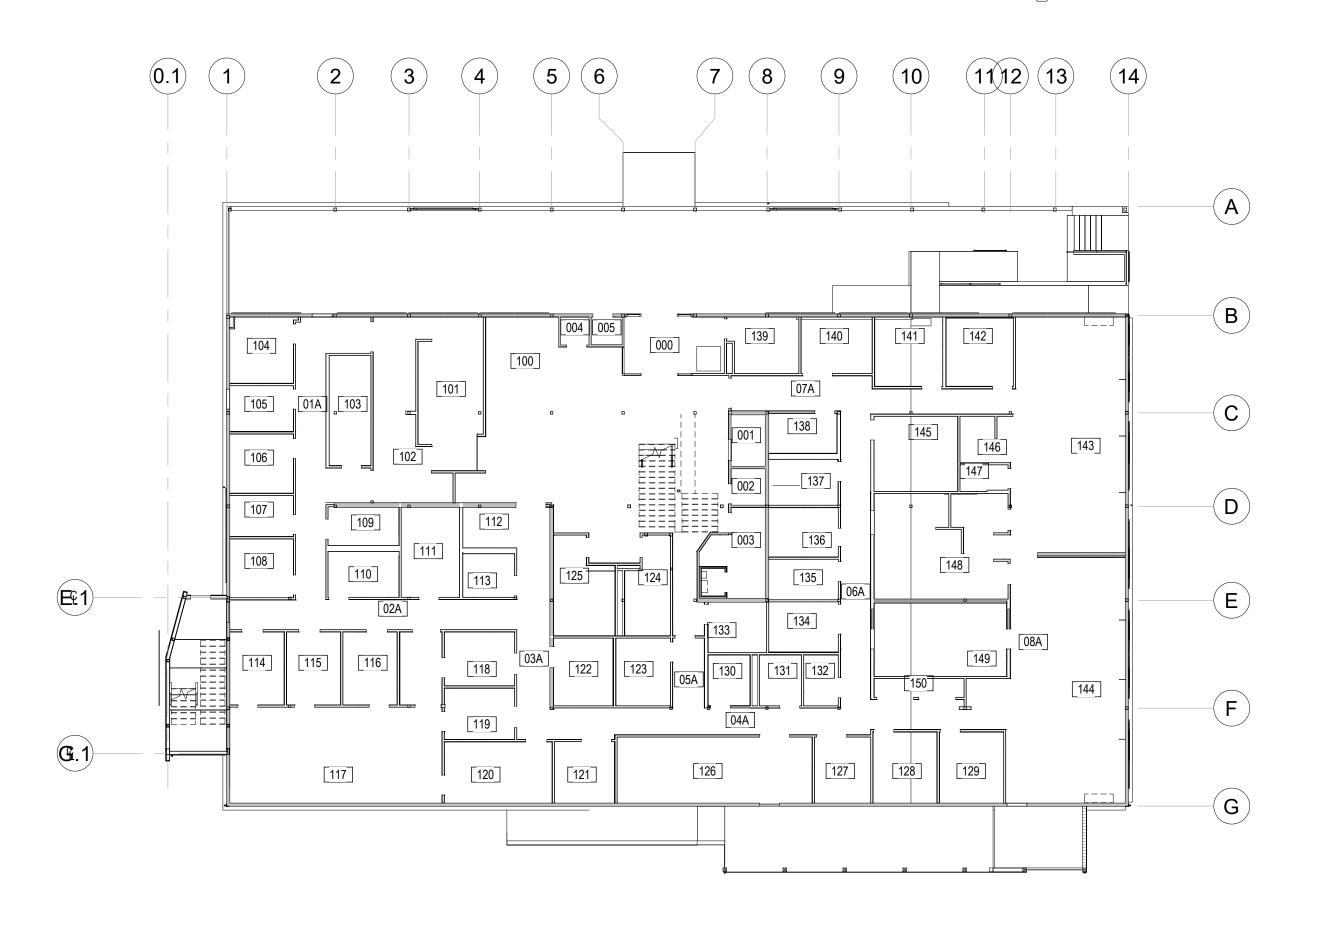

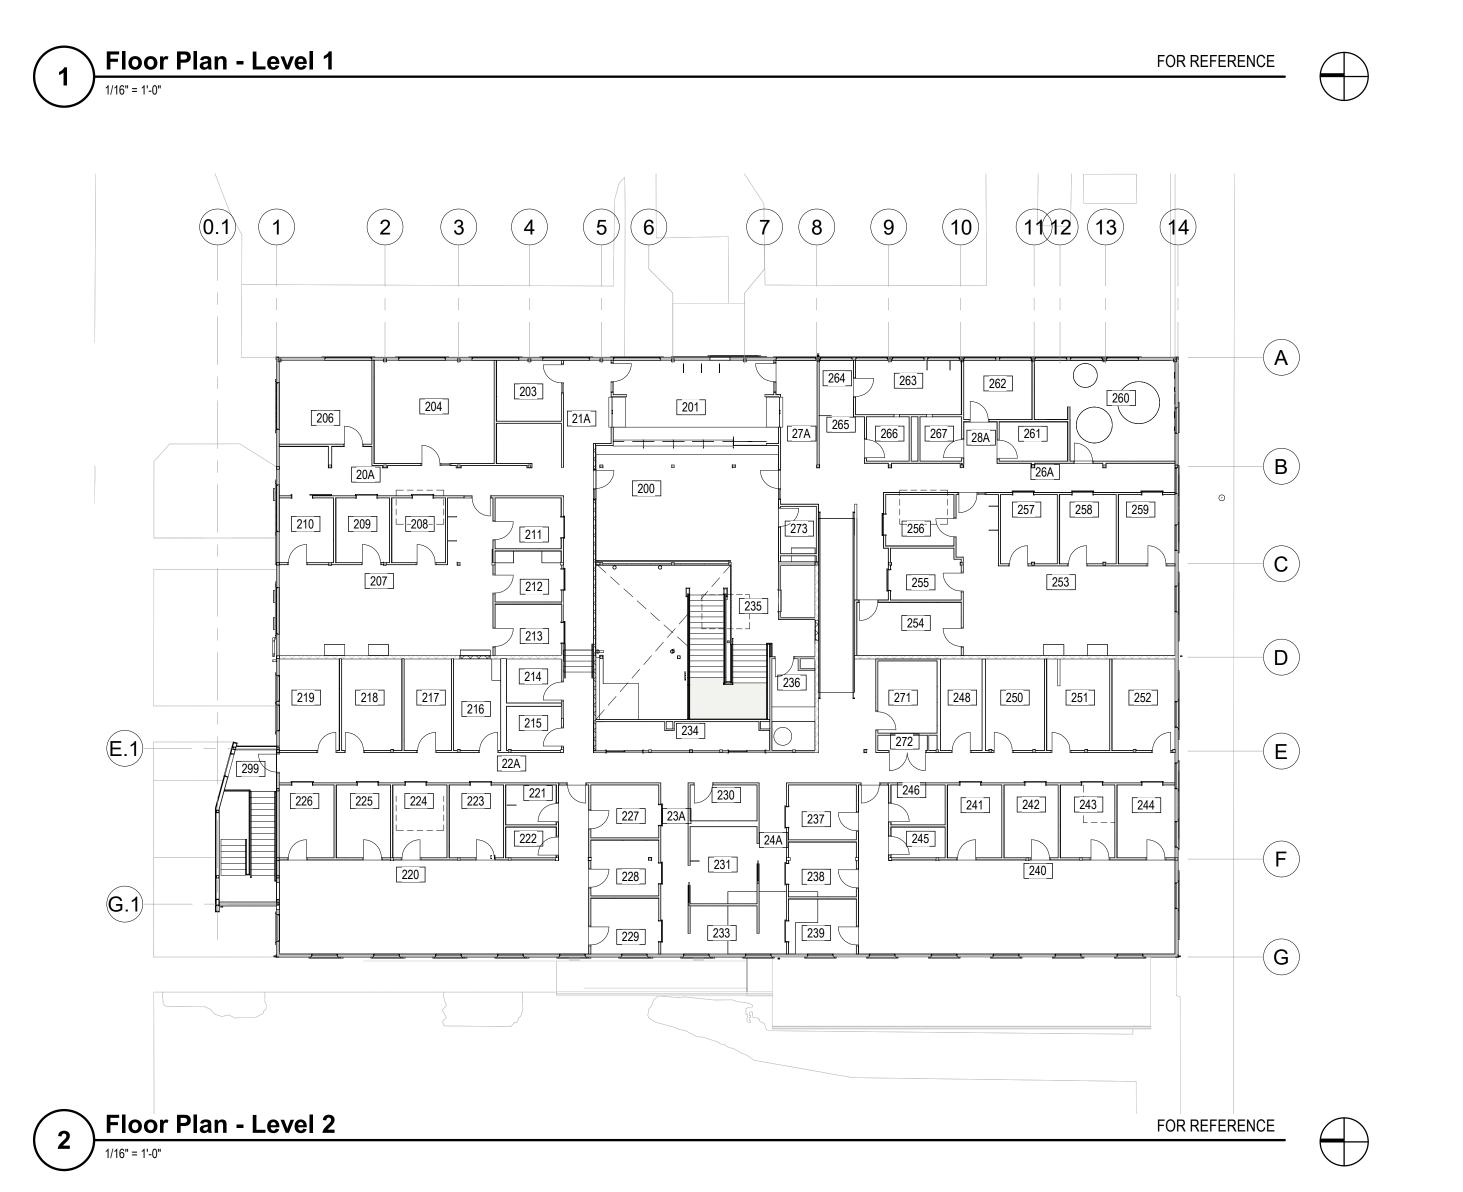

Floor Plan General Notes

- REFER TO GENERAL NOTES ON SHEET <u>AA1.00</u>.
 ALL DIMENSIONS TO NEW PARTITIONS ARE TO FACE OF FRAMING LINO
- UNO.
 3. DIMENSIONS TO EXISTING WALLS ARE EITHER TO FINISHED FACE
 OR TO GRID LINE
- OR TO GRID LINE.

 4. INFILL WITHIN EXISTING CONSTRUCTION AND NEW PARTITIONS IMMEDIATELY ADJACENT TO EXISTING CONSTRUCTION SHALL MATCH EXISTING CONSTRUCTION. PATCHES, INFILL, AND NEW PARTITIONS IMMEDIATELY ADJACENT TO OR WITHIN EXISTING PARTITIONS SHALL BE FINISHED TO BLEND SEAMLESSLY WITH EXISTING MATERIALS AND FINISH AND SHALL ALIGN WITH EXISTING

Floor Plan Legend

EXISTING PARTITION TO REMAIN, TYP

FRAMED WALL PARTITION, TYP



201 W. Main Puyallup, WA 98371


Miller HayashiArchitects

118 North 35th St. Suite 200 Seattle, Washington 98103 Tel: 206 634 0177 Fax: 206 634 0167


ARCHITECT'S STAMP



CONSULTANT

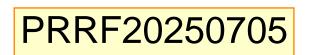

CONSULTANT'S STAMP

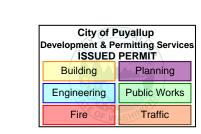

BUILDING DEPARTMENT'S STAMP

PHASE

Silo Re-Roof Permit Set

05/22/25

REVISIONS


lo. Description

SHEET TITLE

FLOOR PLANS

SHEET NO.

A2.00

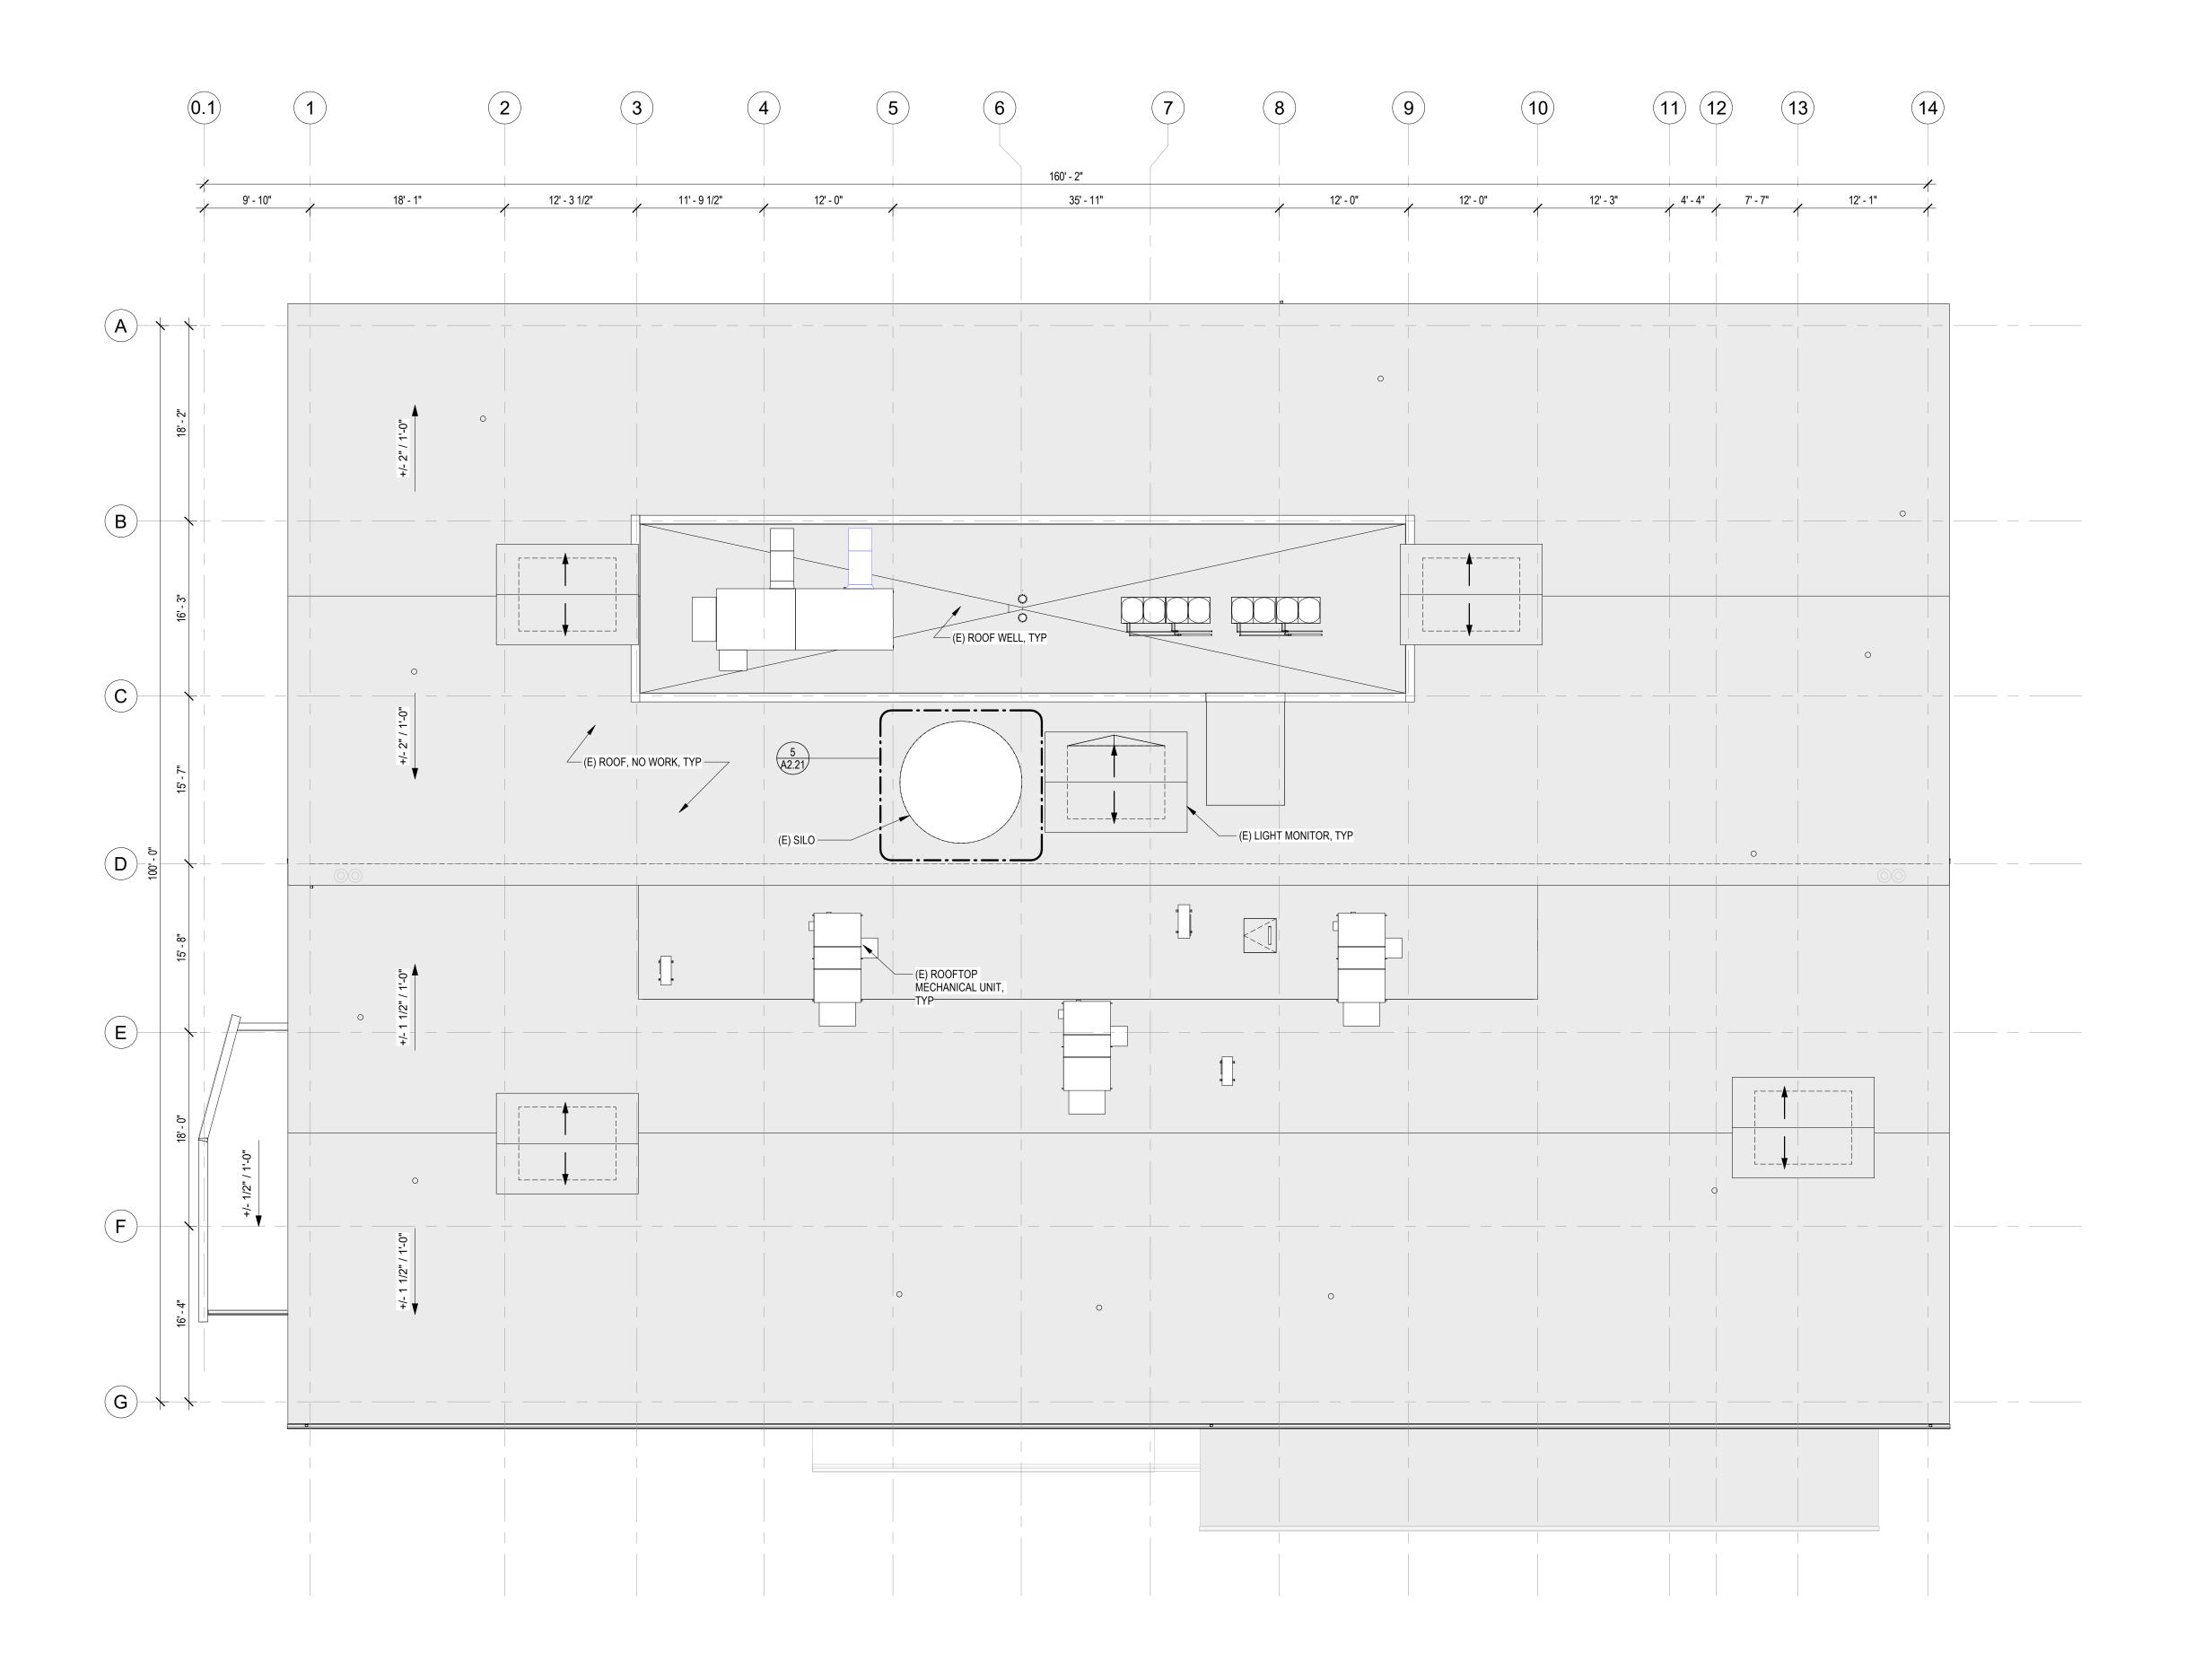

Roof Plan



Roof Plan General Notes

- REFER TO GENERAL NOTES ON <u>AA1.00</u>.
 REFER TO A4 AND A6 SERIES SHEETS FOR ROOF DECK EDGE DIMENSIONS FROM GRIDLINE.
- 3. REFER TO A6 SERIES SHEETS FOR ROOF DETAILS. 4. PROTECT EXISTING ROOF TO REMAIN DURING CONSTRUCTION.
- MAINTAIN EXISTING WARRANTIES. 5. ALL ROOF CONSTRUCTION SHALL PROVIDE POSITIVE SLOPE TO DRAIN IN CONFORMANCE WITH NRCA PUBLISHED RECOMMENDATIONS, MINIMUM OF 1/4" PER FOOT SLOPE, TYPICAL. PROVIDE FIBERGLASS-FACED POLYISOCYANURATE RIGID INSULATION AND TAPERED POLYISOCYANURATE PANELS AT CRICKETS AS INDICATED.
- 6. REFER TO STRUCTURAL, MECHANICAL, ELECTRICAL AND
- HAZARDOUS MATERIALS SHEETS AND COORDINATE THE WORK . 7. ALL ROOF PENETRATIONS SHALL BE LOCATED AWAY FROM ROOF VALLEYS AND OTHER APPURTENANCES AS RECOMMENDED BY NRCA IN THEIR 4TH EDITION ROOFING AND WATERPROOFING MANUAL, AND AS NOTED IN NRCA'S CONSTRUCTION DETAILS SECTION OF MANUAL.
- 8. ALL ROOFS AND PENETRATIONS SHALL BE ROOFED AND FLASHED SO WEATHERPROOF AND WATERTIGHT, OVER MECHANIICALLY-ATTACHED THERMAL BARRIER BOARD, WITH PLIES FULLY ADHERED AND COURSES SEQUENCED IN A WATERSHEDDING MANNER TO DIRECT WATER TO DRAINS, GUTTERS, AND SCUPPERS AND PREVENT LEAKAGE.
- 9. CONTRACTOR SHALL SUBMIT SHOP DRAWINGS FOR REVIEW. SHOP DRAWINGS SHALL INCLUDE ROOF SYSTEM COMPONENTS AND ACCESSORIES INCLUDING ITEMS REQUIRED BUT NOT SPECIFICALLY DETAILED.
- 10. THE ROOF PLAN DRAWINGS ARE DIAGRAMMATIC, AND NOT ALL REQUIRED ROOF PENETRATIONS ARE ILLUSTRATED. REFER TO MECHANICAL AND ELECTRICAL DRAWINGS FOR ADDITIONAL EQUIPMENT AND PIPING PENETRATIONS. PROVIDE CURBS, FLASHINGS, CRICKETS, COLLARS, ETC PER ARCHITECTURAL DETAILS FOR ALL PENETRATIONS AND EQUIPMENT WHETHER SHOWN ON THE ROOF PLAN OR NOT.
- 11. EXTEND EXISTING PLUMBING VENT PIPING TO MINIMUM HEIGHT 8"
- ABOVE FINISHED ROOF. 12. ALL ROOF PATCH AREAS TO BE INSTALLED WEATHERPROOF AND
- WATERTIGHT, AND TO ENSURE PROPER DRAINAGE.

 13. PRIOR TO PERFORMING ANY ROOFING WORK, CONTRACTOR SHALL PROPERTY OF THE PROPERT TEST ALL DRAIN LINES AND NOTIFY OWNER OF ANY LINES THAT ARE PLUGGED OR PARTIALLY PLUGGED. ANY DRAIN LINES THAT ARE SLOW DRAINING OR PLUGGED FOLLOWING THE WORK SHALL BE CORRECTED AT THE CONTRACTOR'S EXPENSE.
- 14. REFER TO WALLS SECTIONS FOR TYPICAL ASSEMBLIES AND MINIMUM INSULATION REQUIREMENTS.

CHC Puyallup -Cannery Silo Reroof

201 W. Main Puyallup, WA 98371

Miller HayashiArchitects


118 North 35th St. Suite 200 Seattle, Washington 98103 Tel: 206 634 0177 Fax: 206 634 0167

ARCHITECT'S STAMP



CONSULTANT

CONSULTANT'S STAMP

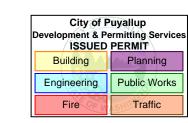

Roof Plan Legend

SINGLE PLY ROOF MEMBRANE ASSEMBLY OVER EXISTING SILO ROOF, TYP, REF A2.21

(E) TPO ROOF ASSEMBLY OVER EXISTING STRUCTURE, TYP

ROOF DRAIN AND OVERFLOW DRAIN IN SUMP, REF MECH PER DETAIL, TYP



GUTTER DROP TO DOWNSPOUT, TYP REF DETAIL




SKYLIGHT, TYP



WELDED SSTL FABRICATION AT PARAPET TRANSITIONS AT LOCATIONS INDICATED, REF DIAGRAMATTIC DETAIL AND FIELD VERIFY EACH CONDITION

BUILDING DEPARTMENT'S STAMP

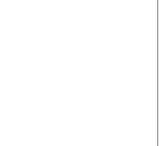

Silo Re-Roof Permit Set


05/22/25

REVISIONS


SHEET TITLE

ROOF PLAN

SHEET NO.

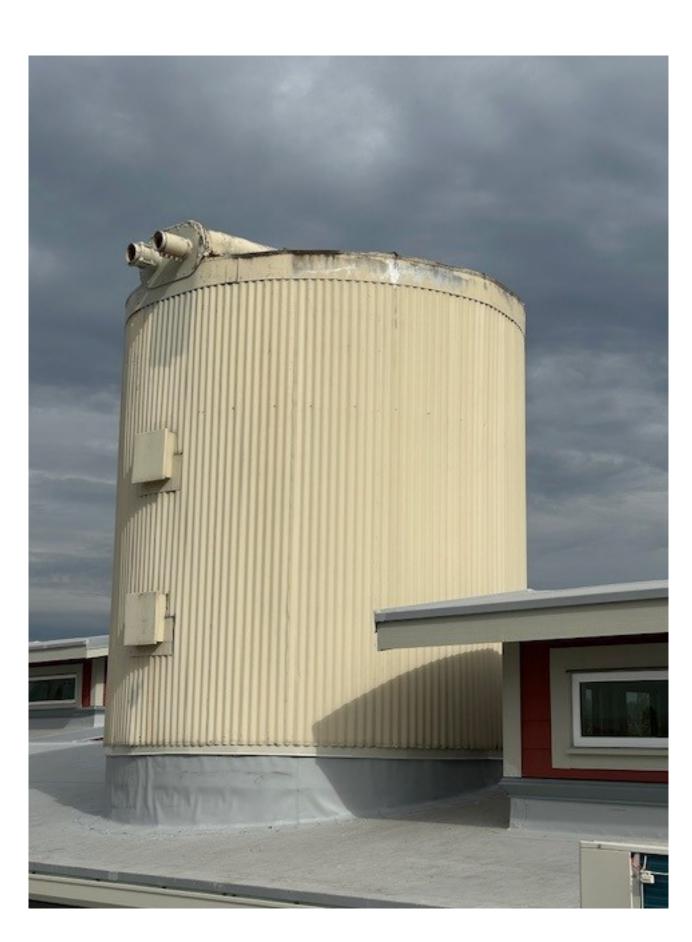


(E) SILO PICTURE - VIEW FROM SOUTHWEST

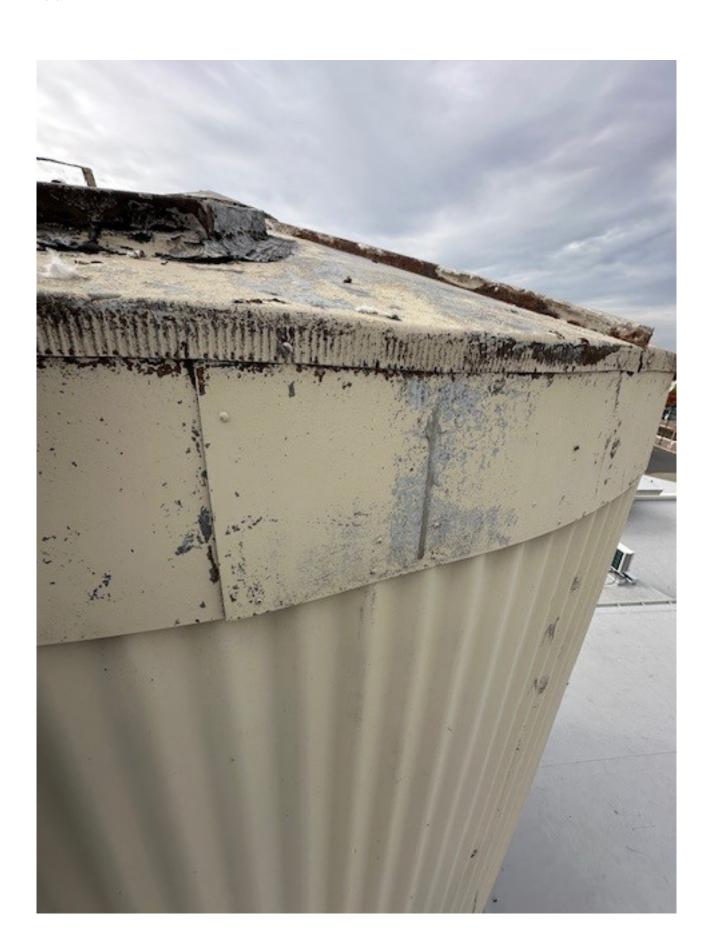

(E) SILO PICTURE - VIEW OF ROOF EDGE



(E) SILO PICTURE - VIEW OF CAP AND ROOF

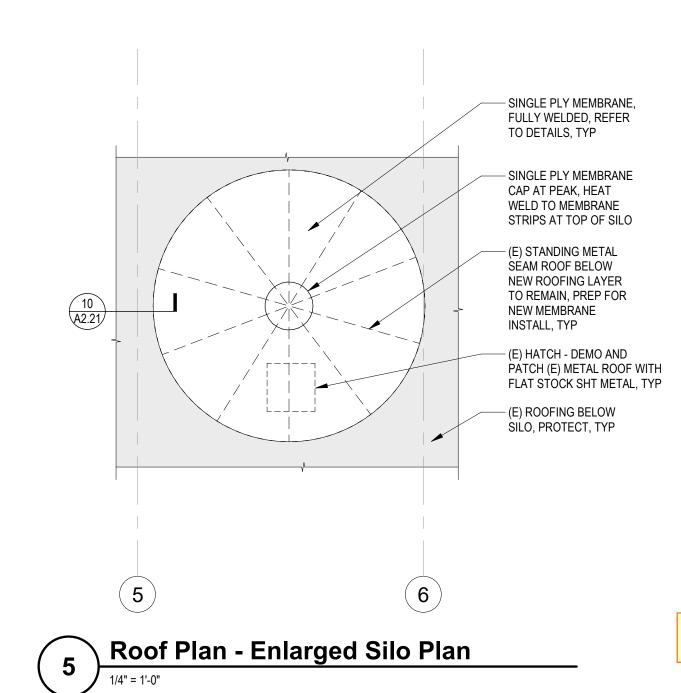


Miller HayashiArchitects

CHC Puyallup -Cannery Silo Reroof


118 North 35th St. Suite 200 Seattle, Washington 98103 Tel: 206 634 0177 Fax: 206 634 0167

201 W. Main Puyallup, WA 98371


ARCHITECT'S STAMP

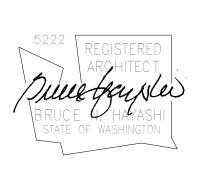


CONSULTANT

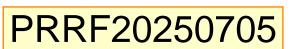

CONSULTANT'S STAMP

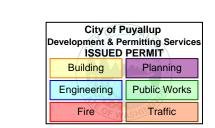

BUILDING DEPARTMENT'S STAMP

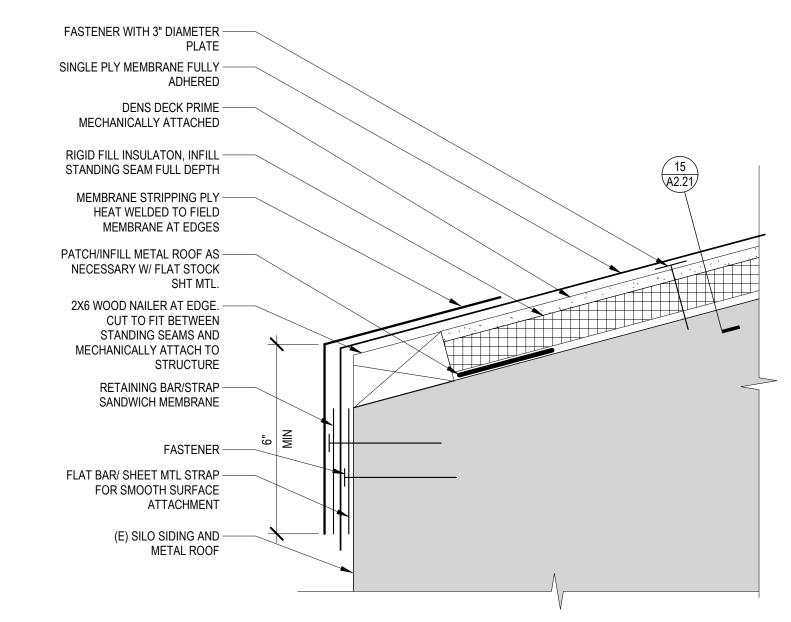


PHASE Silo Re-Roof

DATE 05/22/25

Permit Set

REVISIONS

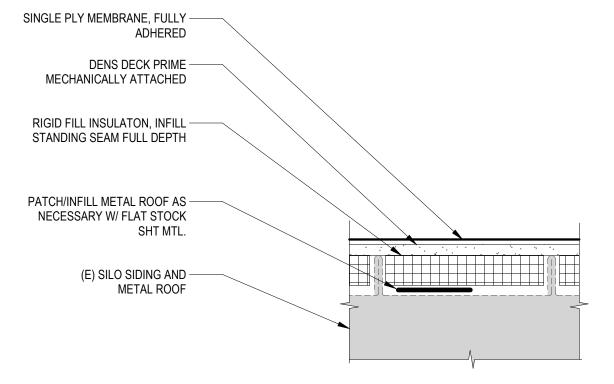

Silo Roof Detail - Roof Edge

Silo Roof Detail - Standing Seam Section

15
1" = 1'-0"

SHEET TITLE **ENLARGED ROOF PLAN, DETAILS & EXISTING PHOTOS**

SHEET NO.