Reviewed for Compliance Approved for Construction By Janelle Montgomery B-21-0583

Date of Review

PROJECT INFORMATION

TENANT IMPROVEMENT TO COMBINE TWO SUITES IN AN EXISTING SINGLE STORY BUILDING INTO

ZONING INFORMATION

APPROVED PLAN

CITY OF PUYALLUP PLANNING DIVISION

APPROVED BY: NComstock

DATE: 09/20/2021

CONDITIONS: N/A

CASE NO.: B-21-0583

BUILDING AREA

FIRST FLOOR

PROJECT DESCRIPTION

GENERAL DRAWINGS

GOVERNING CODE

PARCEL NUMBER

CHAPTER 20.28

ZONING

A750

A751

COVER SHEET

ARCHITECTURAL DRAWINGS

FLOOR PLAN

ONE HOME LENDING BUSINESS OFFICE.

SHEET INDEX

SCHEDULES, ENLARGED PLAN

INTERIOR ELEVATIONS

STANDARD CASEWORK AND FIXTURES

INTERIOR METAL FRAMING DETAILS

INTERIOR METAL FRAMING DETAILS

INTERIOR METAL FRAMING DETAILS

COLORS AND MATERIALS SCHEDULE, STANDARD ABBREVIATIONS, CODE PLAN

9/20/2021

4,330 SQ FT

DEMOLITION DRAWINGS

MECHANICAL DRAWINGS

CITY OF PUYALLUP MUNICIPAL CODE

TITLE 20 - ZONING CODE

OP - PROFESSIONAL OFFICE

0419044082

DEMOLITION PLAN

MECHANICAL PLAN

PLUMBING PLAN





AMERICAN INSTITUTE OF ARCHITECTS



HELIX DESIGN GROUP, INC

OWNER

PLAZA 512 LLC 2505 E. MAIN PUYALLUP, WA 98372

CONTACT: JESS QUNELL PHONE: (206) 909-7539 EMAIL: JQUNELL@HOTMAIL.COM

ARCHITECT

HELIX DESIGN GROUP, INC. 6021 12th STREET EAST SUITE 201 TACOMA, WASHINGTON 98424

CONTACTS: DIANE BARRINGER, PROJECT MGR LOWELL CATE, PRINCIPAL PHONE: (253) 922-9037 DIANEB@HELIXDESIGNGROUP.NET

GENERAL CONTRACTOR SUPERIOR BUILDERS, INC. P.O. BOX 1849

MILTON, WA 98354

EMAIL: JEFFS@SBITACOMA.BIZ

CONTACT: JEFF SCHWEITZER PHONE: (253) 922-7160

COVER SHEET

STEWART TITLE PLAZA 512 BUILDING TENANT

IMPROVEMENT

PUYALLUP, WASHINGTON

REVISION I CITY COMMENTS

JOB NO.

07.27.21 PERMIT SET

i21-031

DRAWING NO.

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TENANTIMPROVEMENT

507 31ST AVE SW PUYALLUP, WA 98373

INTERIORS


HELIX DESIGN GROUP, INC. 6021 12th STREET EAST SUITE 201 TACOMA, WASHINGTON 98424 CONTACT: DIANE BARRINGER PHONE: (253) 922-9037 EMAIL: DIANEB@HELIXDESIGNGROUP.NET

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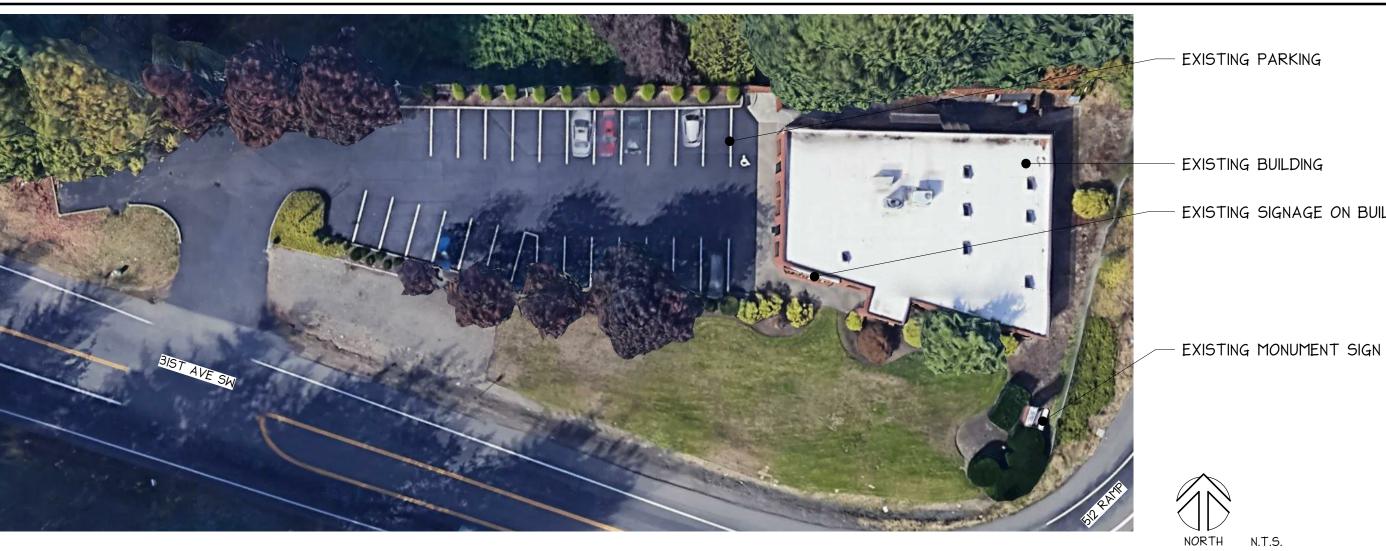
TENANT


STEWART TITLE 1360 POST OAK BLVD, SUITE 100 HOUSTON, TX 77056 CONTACT: STEVE LINDSTROM PHONE: (713) 985-1199 EMAIL: SLINDSTROM@STEWART.COM

AREA MAP

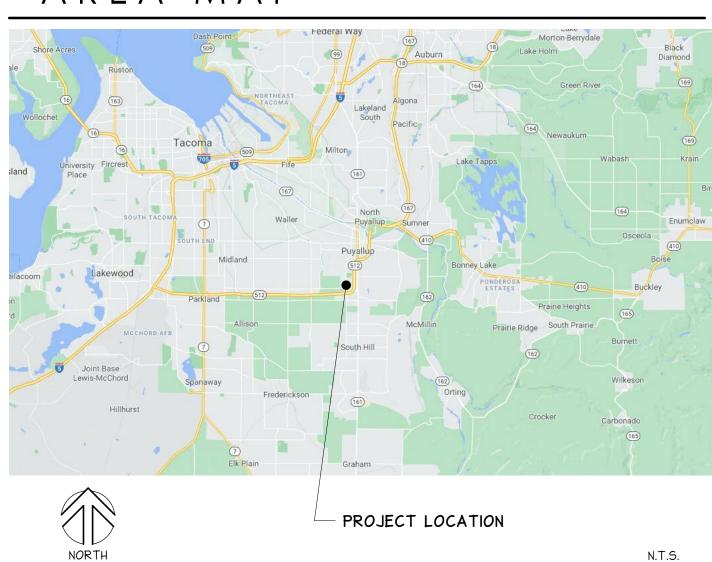

SITE PLAN



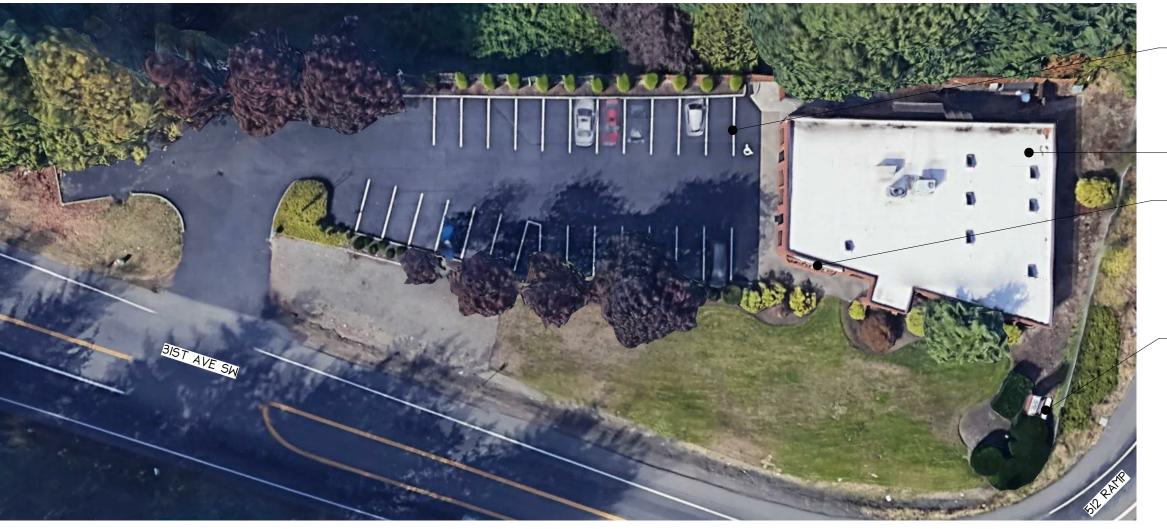

GENERAL NOTES

ALL WORK SHALL CONFORM TO APPLICABLE BUILDING CODES AND ORDINANCES. WHERE MORE THAN ONE CODE OR ORDINANCE CONFLICT WITH EACH OTHER, THE MORE RESTRICTIVE CODE SHALL GOVERN.

2. THE CONTRACTOR SHALL VERIFY ALL EXISTING CONDITIONS AT THE SITE AND SHALL NOTIFY THE ARCHITECT

- IMMEDIATELY OF ANY UNCERTAINTIES OR DISCREPANCIES WITH DRAWINGS.
- 3. THE CONTRACTOR SHALL VERIFY THE LOCATIONS OF ALL UTILITIES AT THE SITE, PROTECT THEM FROM DAMAGE AND REPORT ANY DISCREPANCIES WITH DRAWINGS.
- 4. THE CONTRACTOR SHALL INSURE THE HEALTH AND SAFETY OF THE PUBLIC AND ALL WHO ENTER THE BUILDING
- 5. THE CONTRACTOR SHALL VERIFY AND COORDINATE THE WORK OF SUBCONTRACTORS AND ALL DRAWINGS PRIOR TO PROCEEDING WITH ANY WORK OR FABRICATION.
- 6. DRAWINGS SHALL NOT BE SCALED. NOTIFY THE ARCHITECT IMMEDIATELY OF ANY CONFLICTS.
- 7. ALL CONSTRUCTION SHALL MEET OR EXCEED LOCAL INDUSTRY STANDARDS. DETAILS ARE PROVIDED TO INDICATE MINIMUM QUALITY AND TO GIVE STANDARDS OF CONSTRUCTION. IF A CONDITION IS NOT SPECIFICALLY DETAILED, SUBMIT A SUGGESTED DETAIL FOR GUIDANCE AND APPROVAL.
- 8. THE CONTRACTOR SHALL BE RESPONSIBLE FOR DESIGN, PERMITTING AND CONSTRUCTION OF MECHANICAL AND ELECTRICAL WORK AS REQUIRED TO ACCOMMODATE CONSTRUCTION AND SHALL PROVIDE ALL NECESSARY SHAFTS, OPENINGS, BASES AND STRUCTURAL SUPPORT FOR DUCTS, PIPES, CONDUITS AND EQUIPMENT.
- 9. DIMENSIONS ON PLANS ARE TO FACE OF STUD, CENTER OF COLUMN, CENTER OF MULLION, FACE OF CONCRETE, FACE OF MASONRY, FACE OF FRAME OR FACE OF ROUGH OPENING, UNLESS OTHERWISE NOTED.
- 10. LABORATORY TESTING AND SPECIAL INSPECTION REQUIRED IN ACCORDANCE WITH IBC CHAPTER 17 FOR ALL EARTHWORK COMPACTION, FIELD WELDING, HIGH STRENGTH BOLTING AND ALL STRUCTURAL CONCRETE. OWNER TO HIRE AN INDEPENDENT SPECIAL INSPECTOR AND TESTING LAB FOR ALL CODE REQUIRED TESTING
- II. REPAIR / REPLACE EXISTING WALL FLOOR AND CEILING FINISHES TO MATCH EXISTING ADJACENT FINISHES WHEN DAMAGED DURING COURSE OF CONSTRUCTION.
- 12. DEMOLISH ALL EXISTING BUILDING COMPONENTS NECESSARY TO CONSTRUCT WORK CAP ALL EXISTING UTILITIES (PLUMBING, ELECTRICAL AND MECHANICAL) BEHIND WALLS FLOORS, ETC.
- 13. SUSPENDED CEILINGS TO BE DESIGNED FOR SEISMIC DESIGN CATEGORY D, E, OR F.
- 14. REFER TO SHEET A600 FOR STANDARD CASEWORK DETAILS AND PLUMBING FIXTURE AND TOILET ACCESSORIES

THE APPROVED CONSTRUCTION PLANS, DOCUMENTS AND ALL ENGINEERING MUST BE POSTED ON THE JOB AT ALL INSPECTIONS IN A VISIBLE AND READILY ACCESSIBLE LOCATION.

FULL SIZED LEDGIBLE COLOR PLANS ARE REQUIRED TO BE PROVIDED BY THE PERMITEE ON SITE FOR INSPECTION

CODE INFORMATION

GOVERNING CODE

2018 INTERNATIONAL BUILDING CODE (IBC) WASHINGTON STATE AMENDMENTS WASHINGTON STATE AMENDMENTS 2018 WASHINGTON STATE ENERGY CODE (WSEC)

NORTH N.T.S.

EXISTING PARKING

EXISTING BUILDING

EXISTING SIGNAGE ON BUILDING

OCCUPANCY CLASSIFICATION

(NON-FIRE RATED) V-B

BUSINESS

AUTOMATIC FIRE SPRINKLER SYSTEM IBC CHAPTER 9

BUILDING IS NOT EQUIPPED WITH AN AUTOMATIC FIRE SPRINKLER SYSTEM.

FIRE ALARM AND DETECTION SYSTEM IBC CHAPTER 9

BUILDING IS NOT EQUIPPED WITH AN AUTOMATIC FIRE ALARM AND DETECTION SYSTEM

OCCUPANT LOAD IBC TABLE 1004.5

3,952 SQ FT / 150 = 27 OCCUPANTS (1 OCCUPANT / 150 GROSS SQ FT)

omissions or oversight by this office or making sure that the building complies with all

2018 INTERNATIONAL EXISTING BUILDING CODE (IEBC) 2018 UNIFORM PLUMBING CODE (UPC)

IBC CHAPTER 3

CONSTRUCTION TYPE IBC SECTION 602

(COMBUSTIBLE CONSTRUCTION)

52 OCCUPANTS *

BUSINESS AREAS: ENTRY, SIGN ROOMS, OFFICES, WORK AREAS * ASSEMBLY AREAS: TRAINING ROOM

372 SQ FT / I5 = 25 OCCUPANTS (I OCCUPANT / I5 NET SQ FT)

Approval of submitted plans is not an approval of noncompliance with any applicable regulations of local government. The contractor is responsible for applicable building codes and regulations of the local government.

GRID LINE DESIGNATION = center of structure = face of structure = existing

INTERIOR ELEVATION ELEVATION NUMBER SHEET NUMBER

SYMBOLS

EXTERIOR ELEVATION ELEVATION NUMBER SHEET NUMBER

BUILDING SECTION SECTION NUMBER SHEET NUMBER

WALL SECTION SECTION LETTER SHEET NUMBER

DETAIL NUMBER

SHEET NUMBER REVISION

REVISION

MATCHLINE

DETAIL

NORTH ARROW


NORTH

MATCHLINE

F.O.S. (1)

- $\frac{}{|}$ $\frac{|}{|}$ $\frac{|}{|}$ $\frac{|}{|}$ $\frac{|}{|}$

B-21-0583 CITY OF PUYALLUP

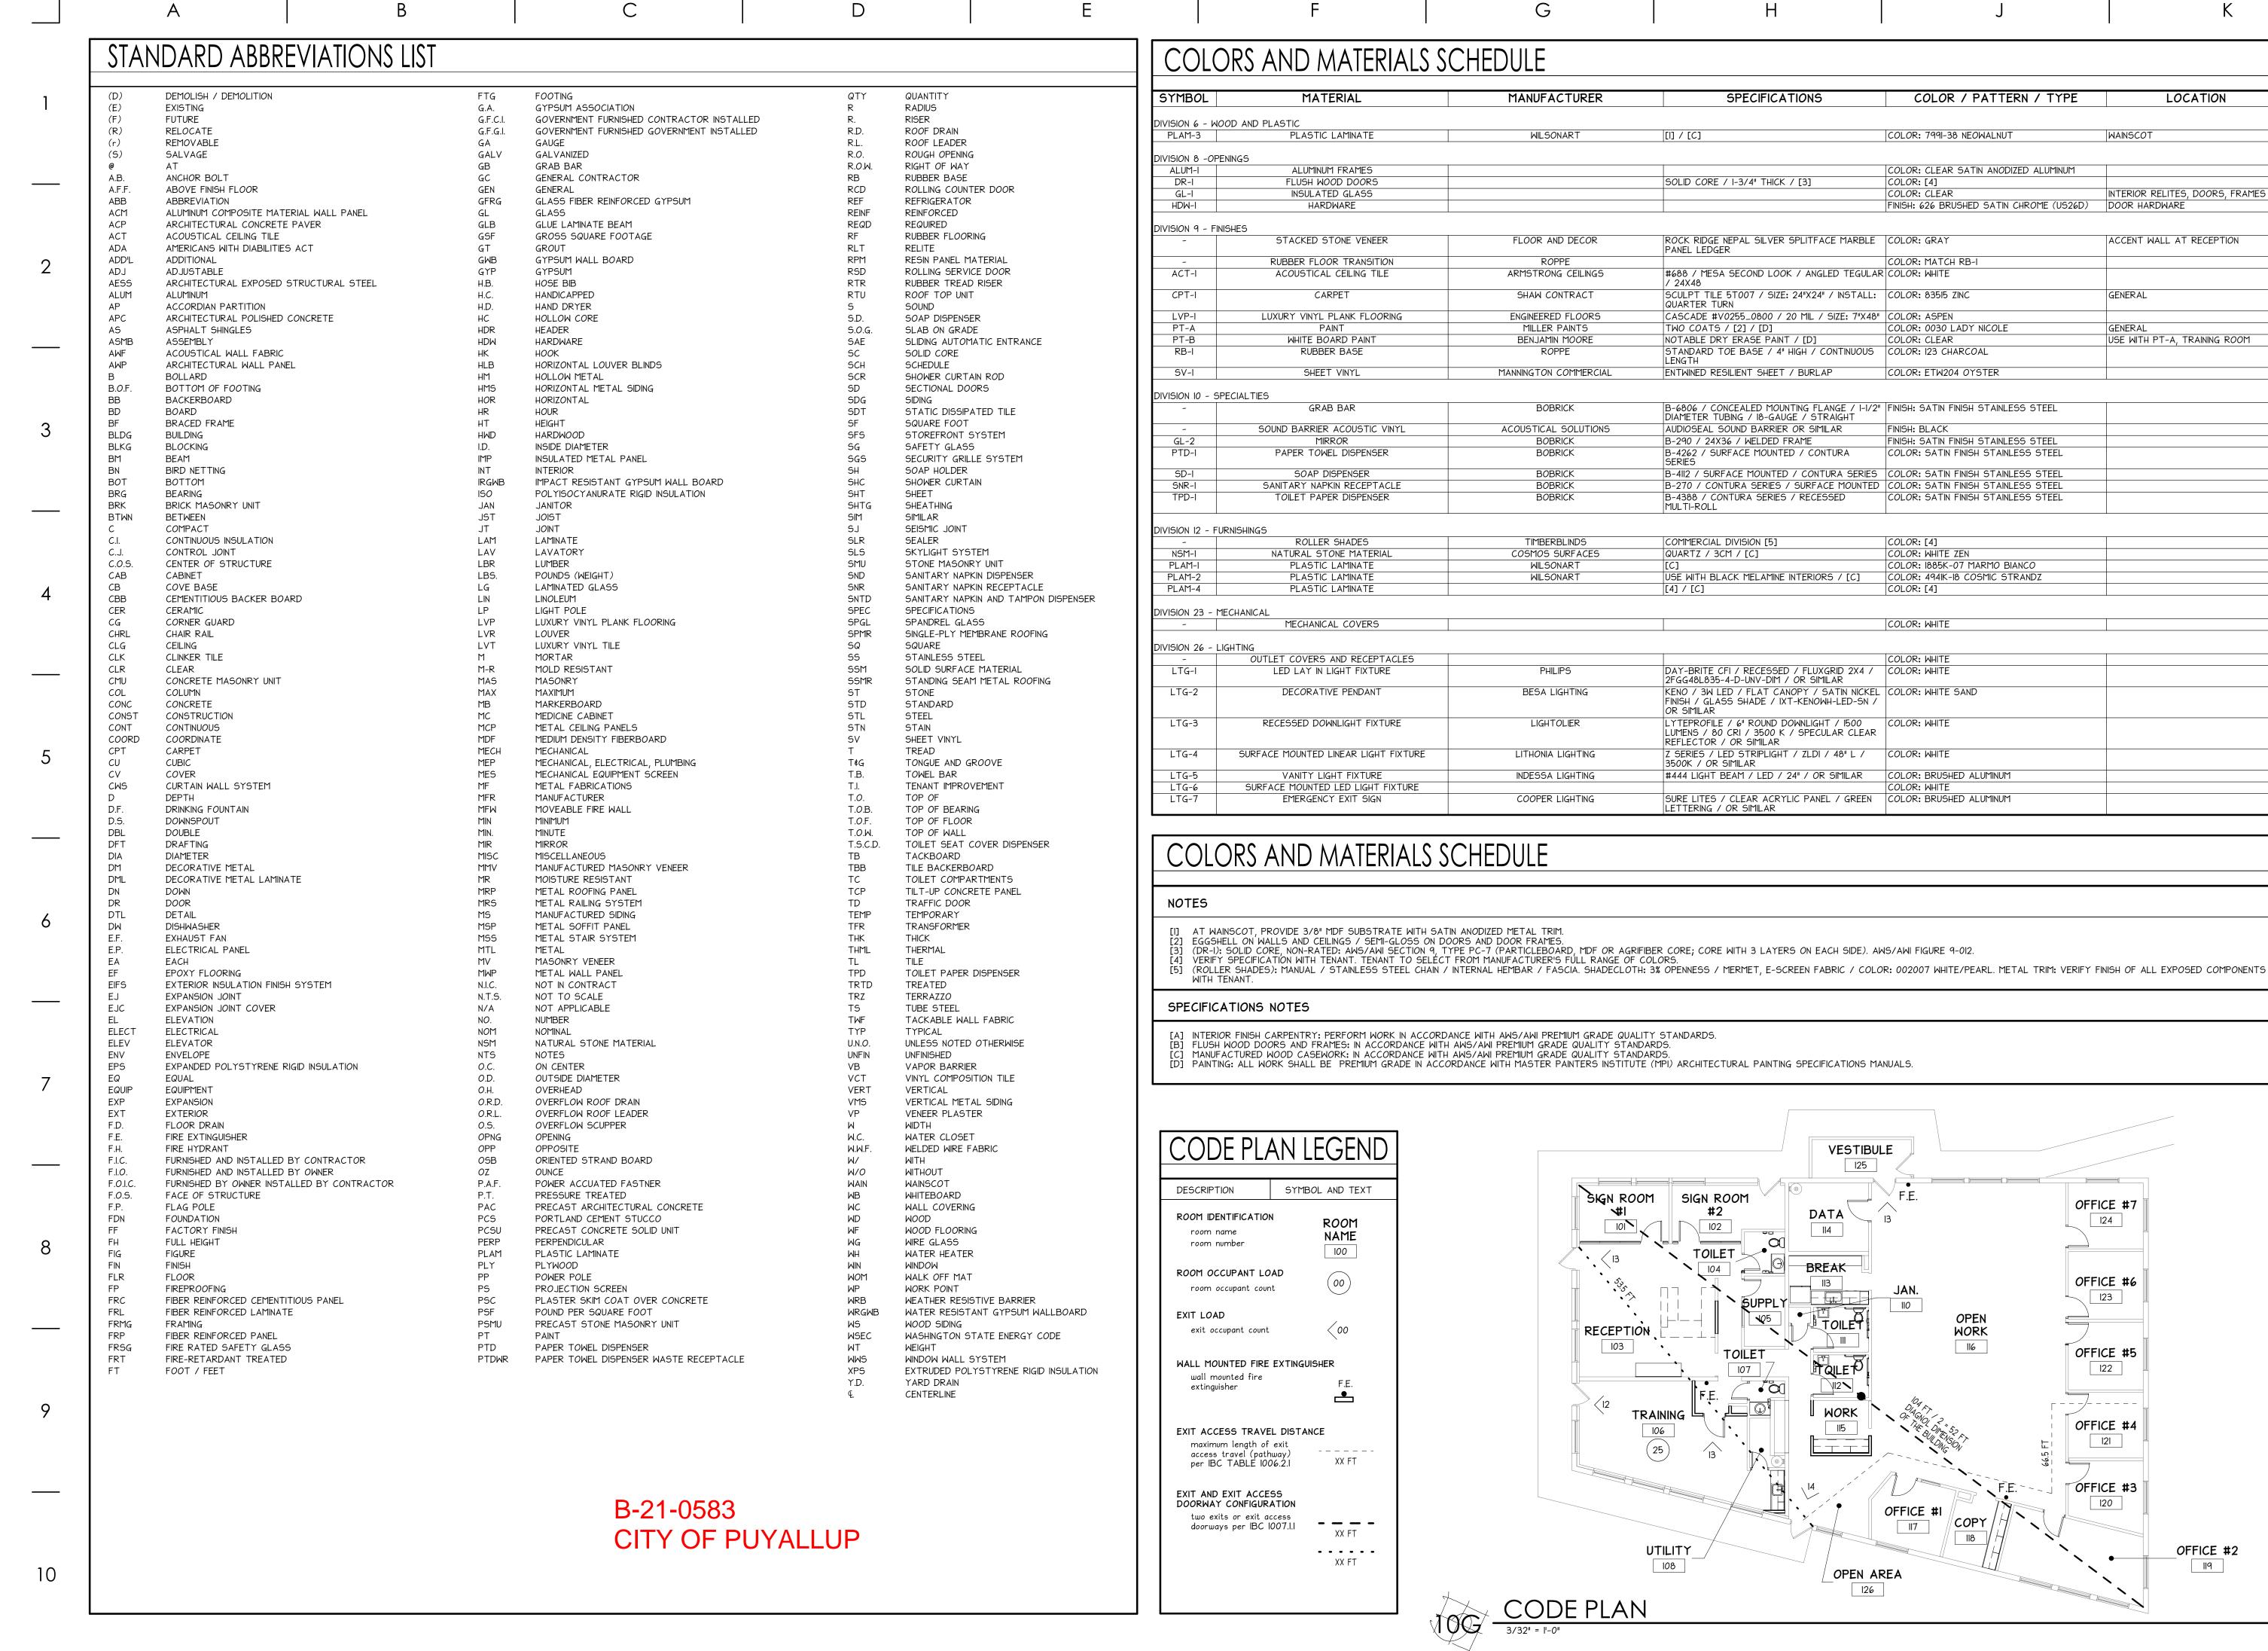

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SPECIFICATIONS LOCATION COLOR / PATTERN / TYPE WAINSCOT COLOR: 7991-38 NEOWALNUT COLOR: CLEAR SATIN ANODIZED ALUMINUM SOLID CORE / I-3/4" THICK / [3 COLOR: [4] NTERIOR RELITES, DOORS, FRAMES COLOR: CLEAR FINISH: 626 BRUSHED SATIN CHROME (US26D) DOOR HARDWARE ROCK RIDGE NEPAL SILVER SPLITFACE MARBLE | COLOR: GRAY ACCENT WALL AT RECEPTION PANEL LEDGER COLOR: MATCH RB-#688 / MESA SECOND LOOK / ANGLED TEGULAR COLOR: WHITE SCULPT TILE 5T007 / SIZE: 24"X24" / INSTALL: COLOR: 83515 ZINC GENERAL QUARTER TURN CASCADE #V0255_0800 / 20 MIL / SIZE: 7"X48" | COLOR: ASPEN TWO COATS / [2] / [D] COLOR: 0030 LADY NICOLE USE WITH PT-A, TRAINING ROOM NOTABLE DRY ERASE PAINT / [D] COLOR: CLEAR STANDARD TOE BASE / 4" HIGH / CONTINUOUS | COLOR: 123 CHARCOAL ENTWINED RESILIENT SHEET / BURLAP COLOR: ETW204 OYSTER B-6806 / CONCEALED MOUNTING FLANGE / I-I/2" FINISH: SATIN FINISH STAINLESS STEEL DIAMETER TUBING / 18-GAUGE / STRAIGHT AUDIOSEAL SOUND BARRIER OR SIMILAR FINISH: BLACK B-290 / 24X36 / WELDED FRAME FINISH: SATIN FINISH STAINLESS STEEL B-4262 / SURFACE MOUNTED / CONTURA COLOR: SATIN FINISH STAINLESS STEEL B-4112 / SURFACE MOUNTED / CONTURA SERIES | COLOR: SATIN FINISH STAINLESS STEEL B-270 / CONTURA SERIES / SURFACE MOUNTED COLOR: SATIN FINISH STAINLESS STEEL B-4388 / CONTURA SERIES / RECESSED COLOR: SATIN FINISH STAINLESS STEEL MULTI-ROLL COMMERCIAL DIVISION [5 COLOR: WHITE ZEN QUARTZ / 3CM / [C] COLOR: 1885K-07 MARMO BIANCO USE WITH BLACK MELAMINE INTERIORS / [C] COLOR: 494IK-18 COSMIC STRANDZ COLOR: [4] [4] / [C] COLOR: WHIT COLOR: WHITE DAY-BRITE CFI / RECESSED / FLUXGRID 2X4 / 2FGG48L835-4-D-UNV-DIM / OR SIMILAR COLOR: WHITE KENO / 3W LED / FLAT CANOPY / SATIN NICKEL COLOR: WHITE SAND |FINISH / GLASS SHADE / IXT-KENOWH-LED-SN / OR SIMILAR LYTEPROFILE / 6" ROUND DOWNLIGHT / 1500 COLOR: WHITE LUMENS / 80 CRI / 3500 K / SPECULAR CLEAR REFLECTOR / OR SIMILAR Z SERIES / LED STRIPLIGHT / ZLDI / 48" L / COLOR: WHITE 3500K / OR SIMILAR #444 LIGHT BEAM / LED / 24" / OR SIMILAR COLOR: BRUSHED ALUMINUN OLOR: WHITE SURE LITES / CLEAR ACRYLIC PANEL / GREEN COLOR: BRUSHED ALUMINUN

VESTIBULE

125

DATA

114

TOILET

107

G

WORK

OFFICE #1

117

OPEN AREA

OFFICE #7

124

OFFICE #6

123

OFFICE #5

122

OFFICE #4

121

OFFICE #3

OFFICE #2

119

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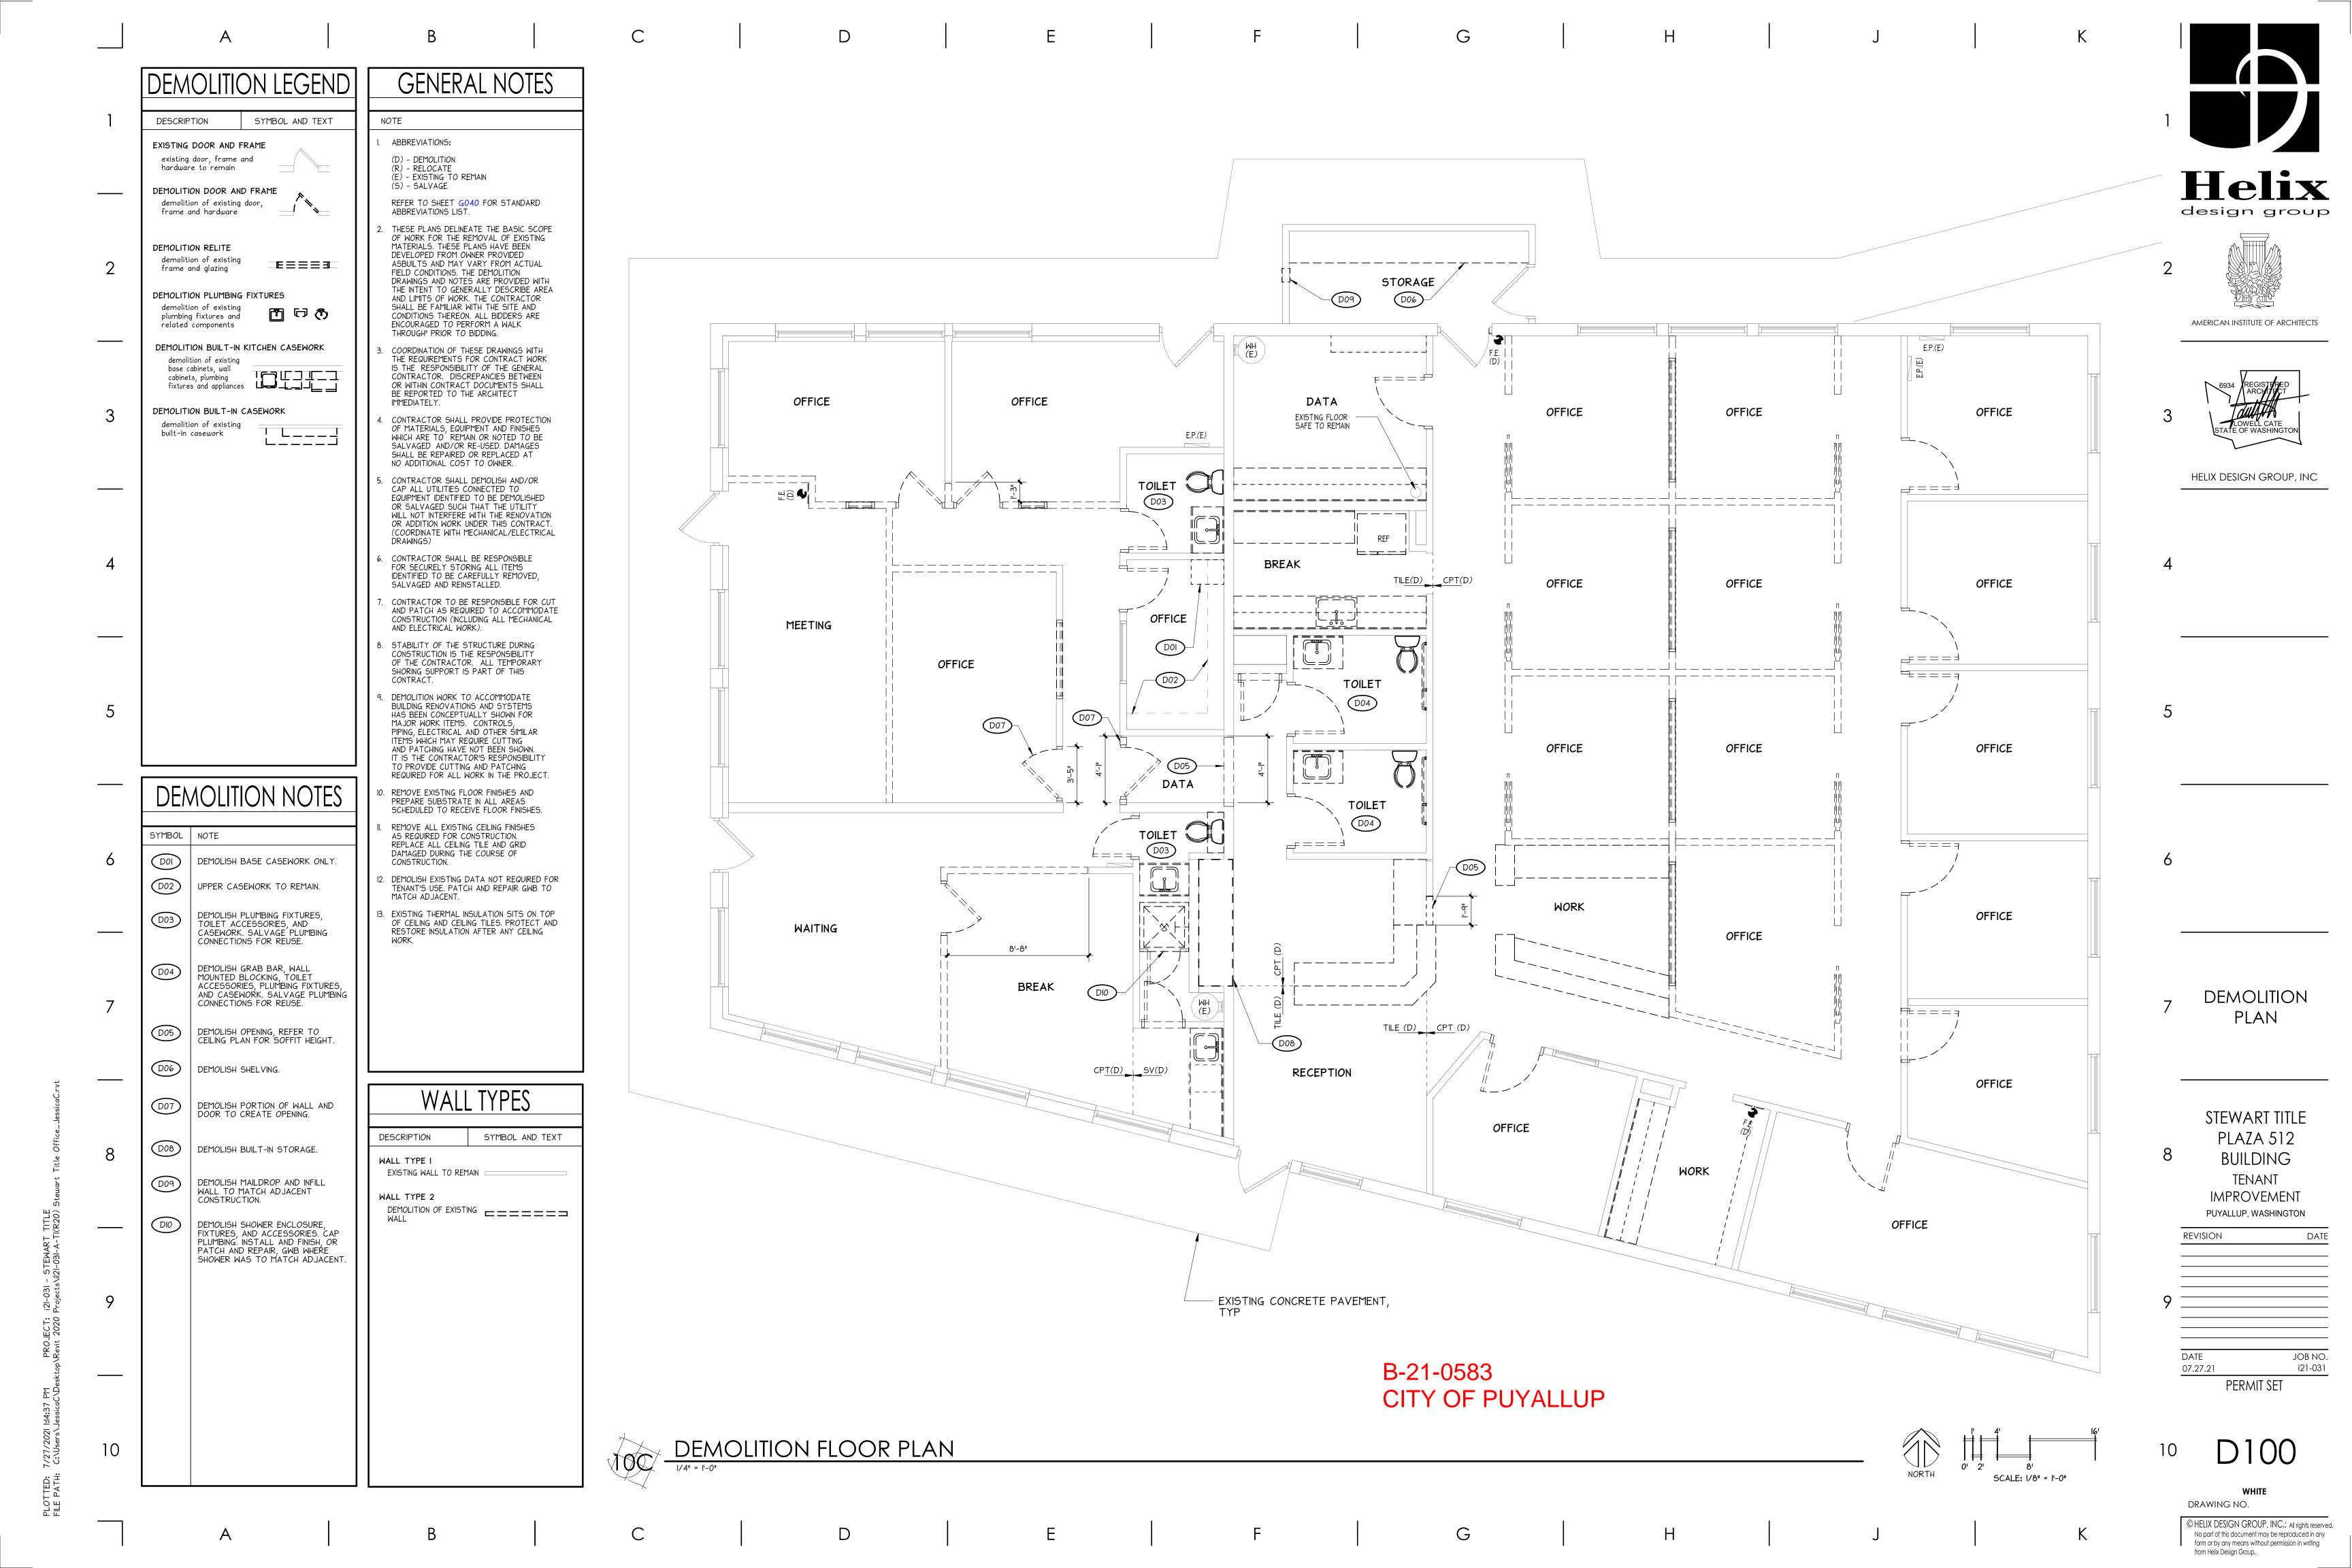
> COLORS AND MATERIALS **SCHEDULE** STANDARD **ABBREVIATIONS** CODE PLAN


STEWART TITLE PLAZA 512 BUILDING **TENANT IMPROVEMENT** PUYALLUP, WASHINGTON


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REFLECTED 7 CEILING PLAN, ENLARGED PLAN

STEWART TITLE
PLAZA 512
BUILDING
TENANT
IMPROVEMENT
PUYALLUP, WASHINGTON


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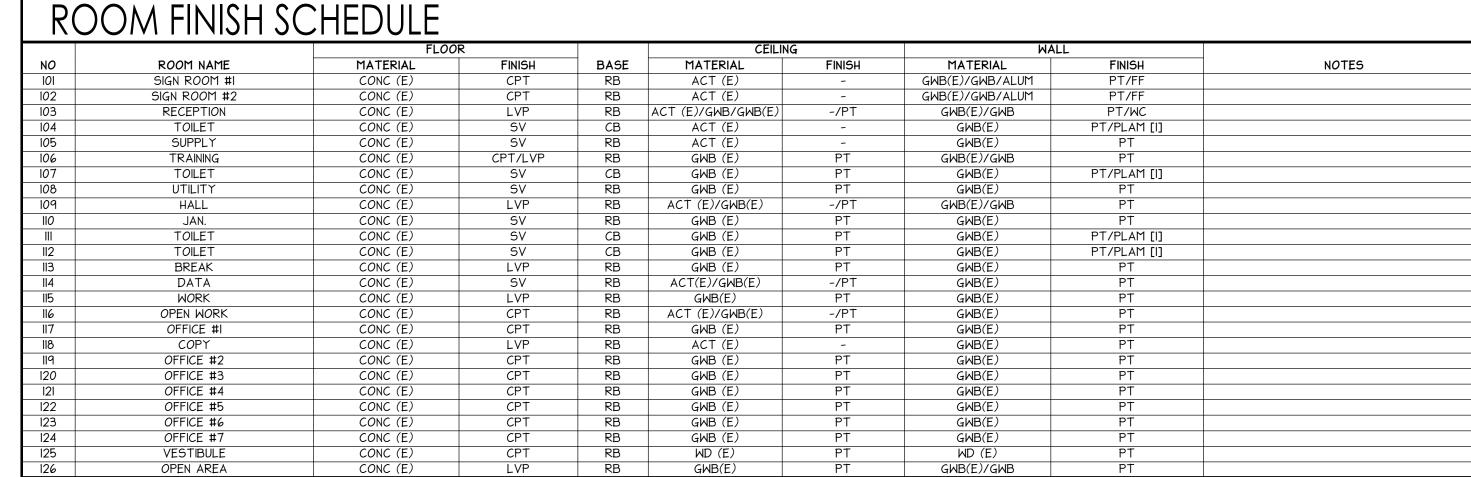
10 A120

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GENERAL NOTES

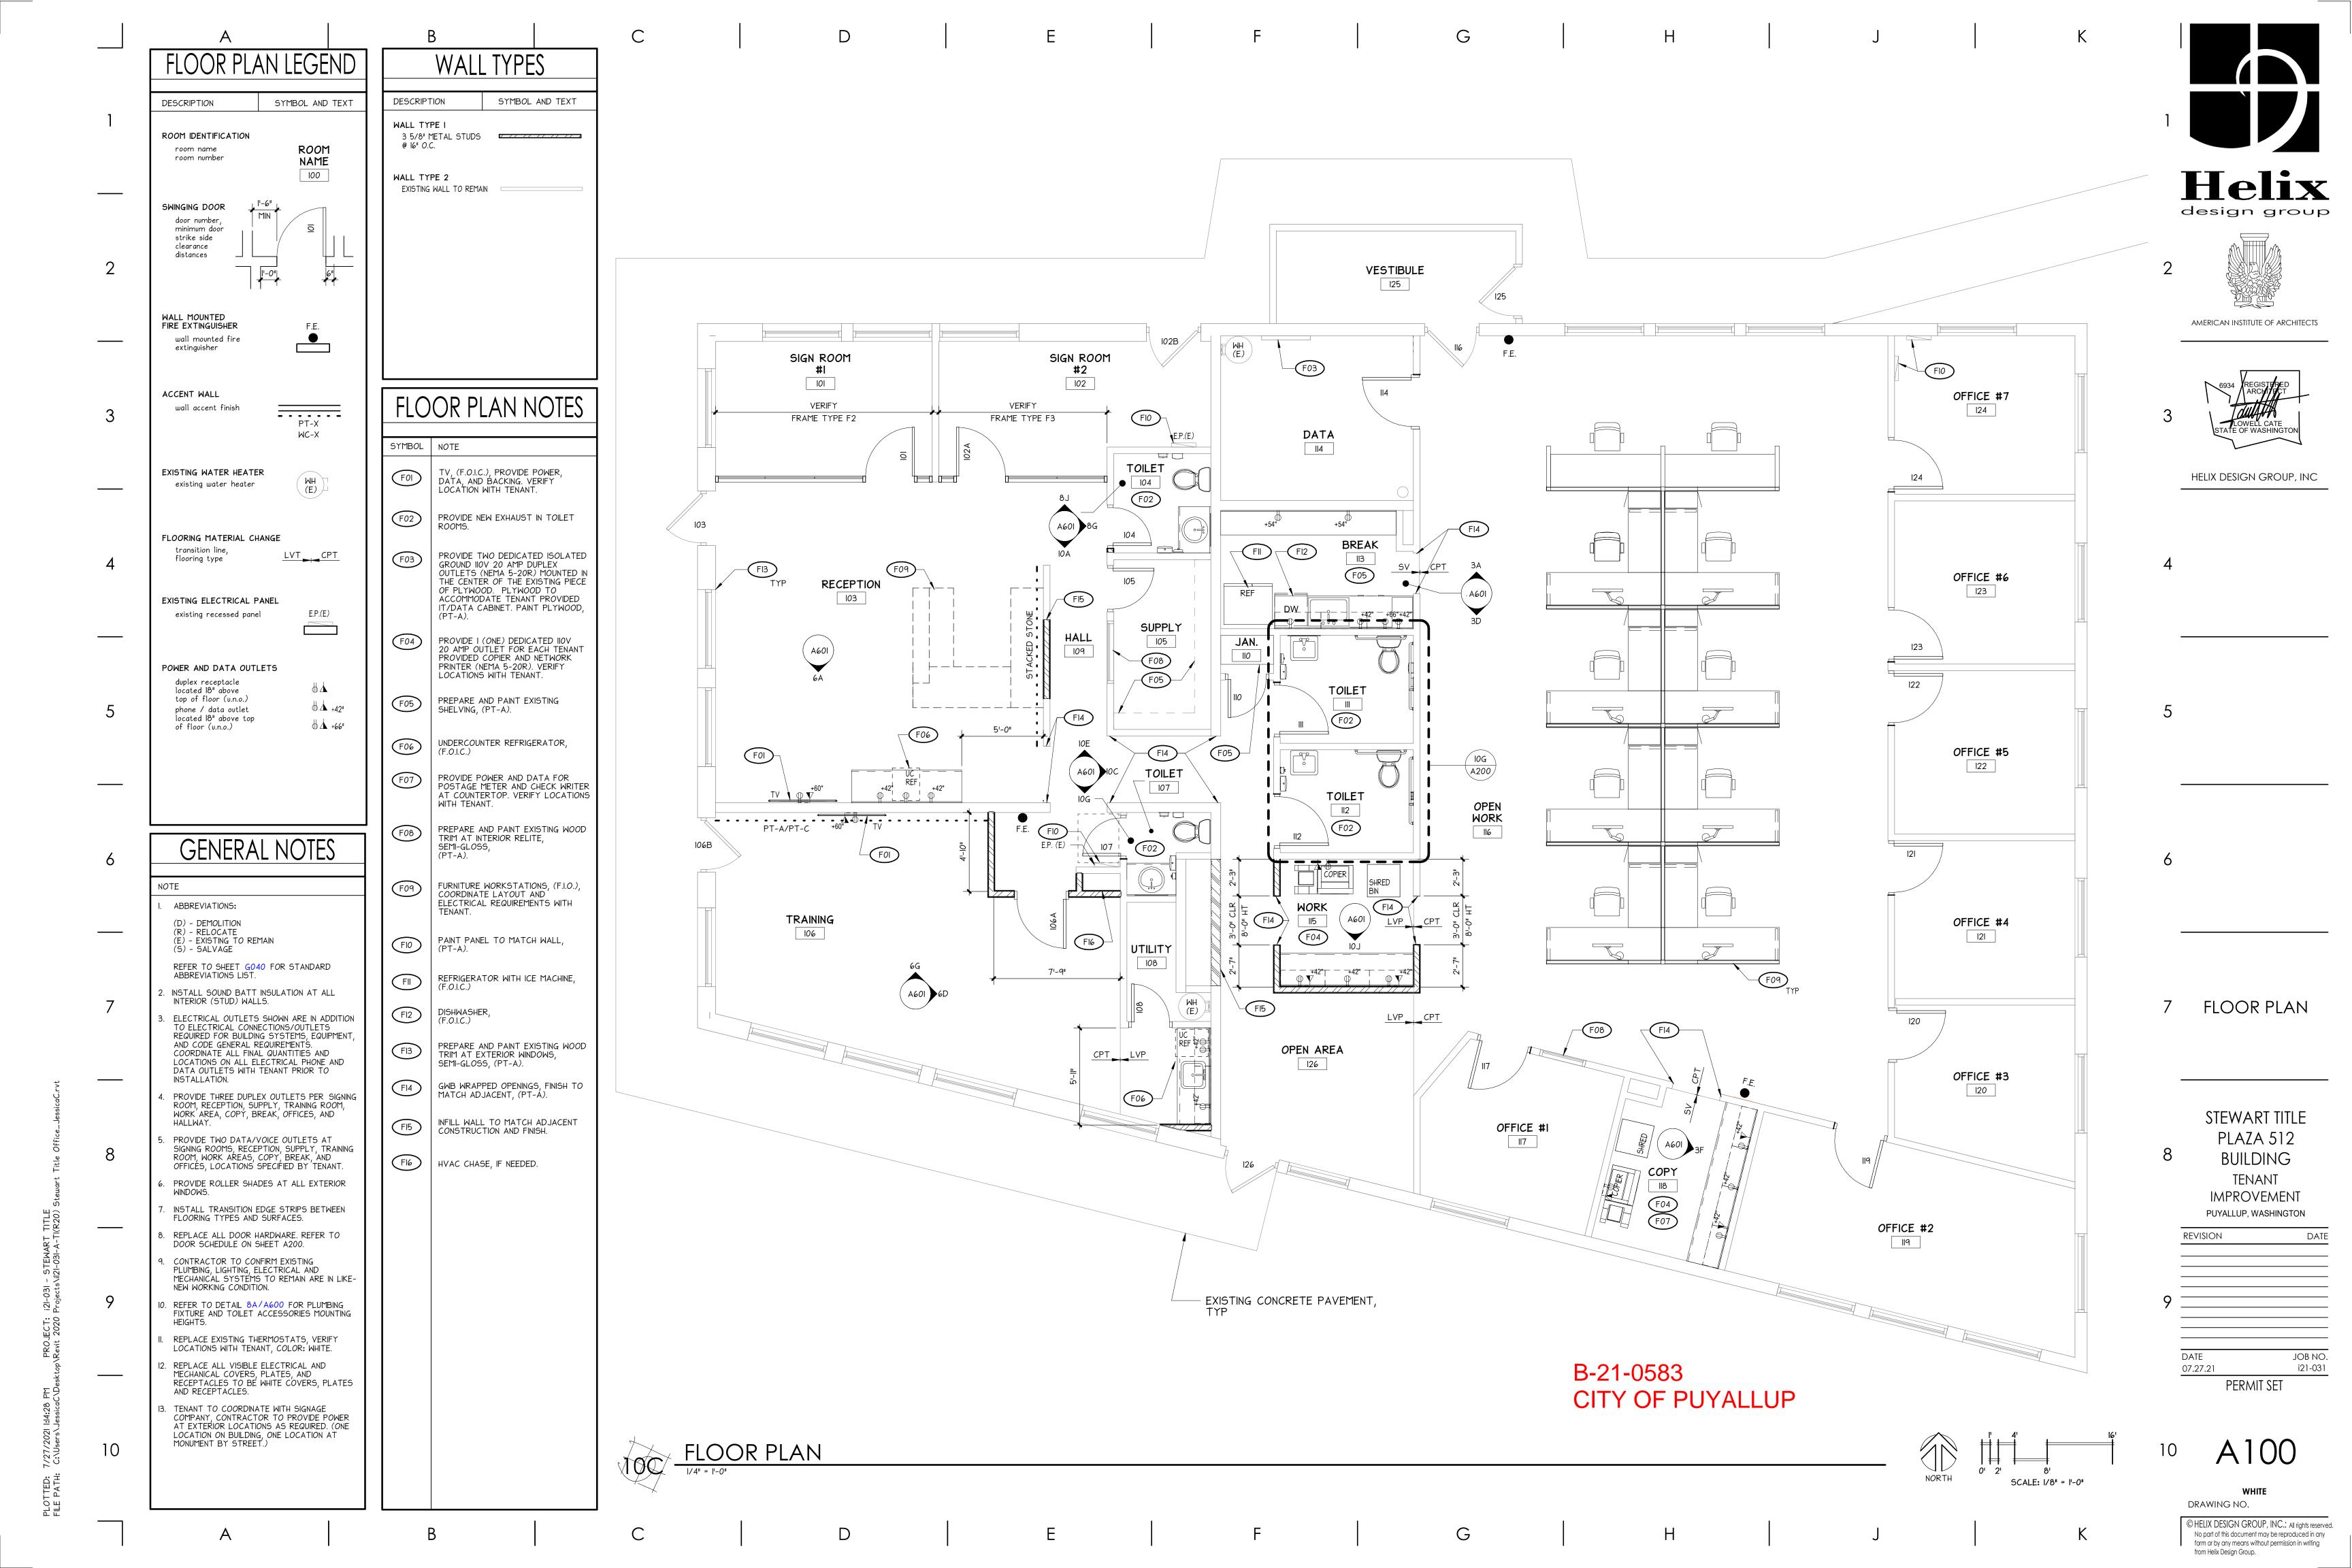
I. REFER TO COLORS AND MATERIALS SCHEDULE FOR COLORS AND FINISHES.

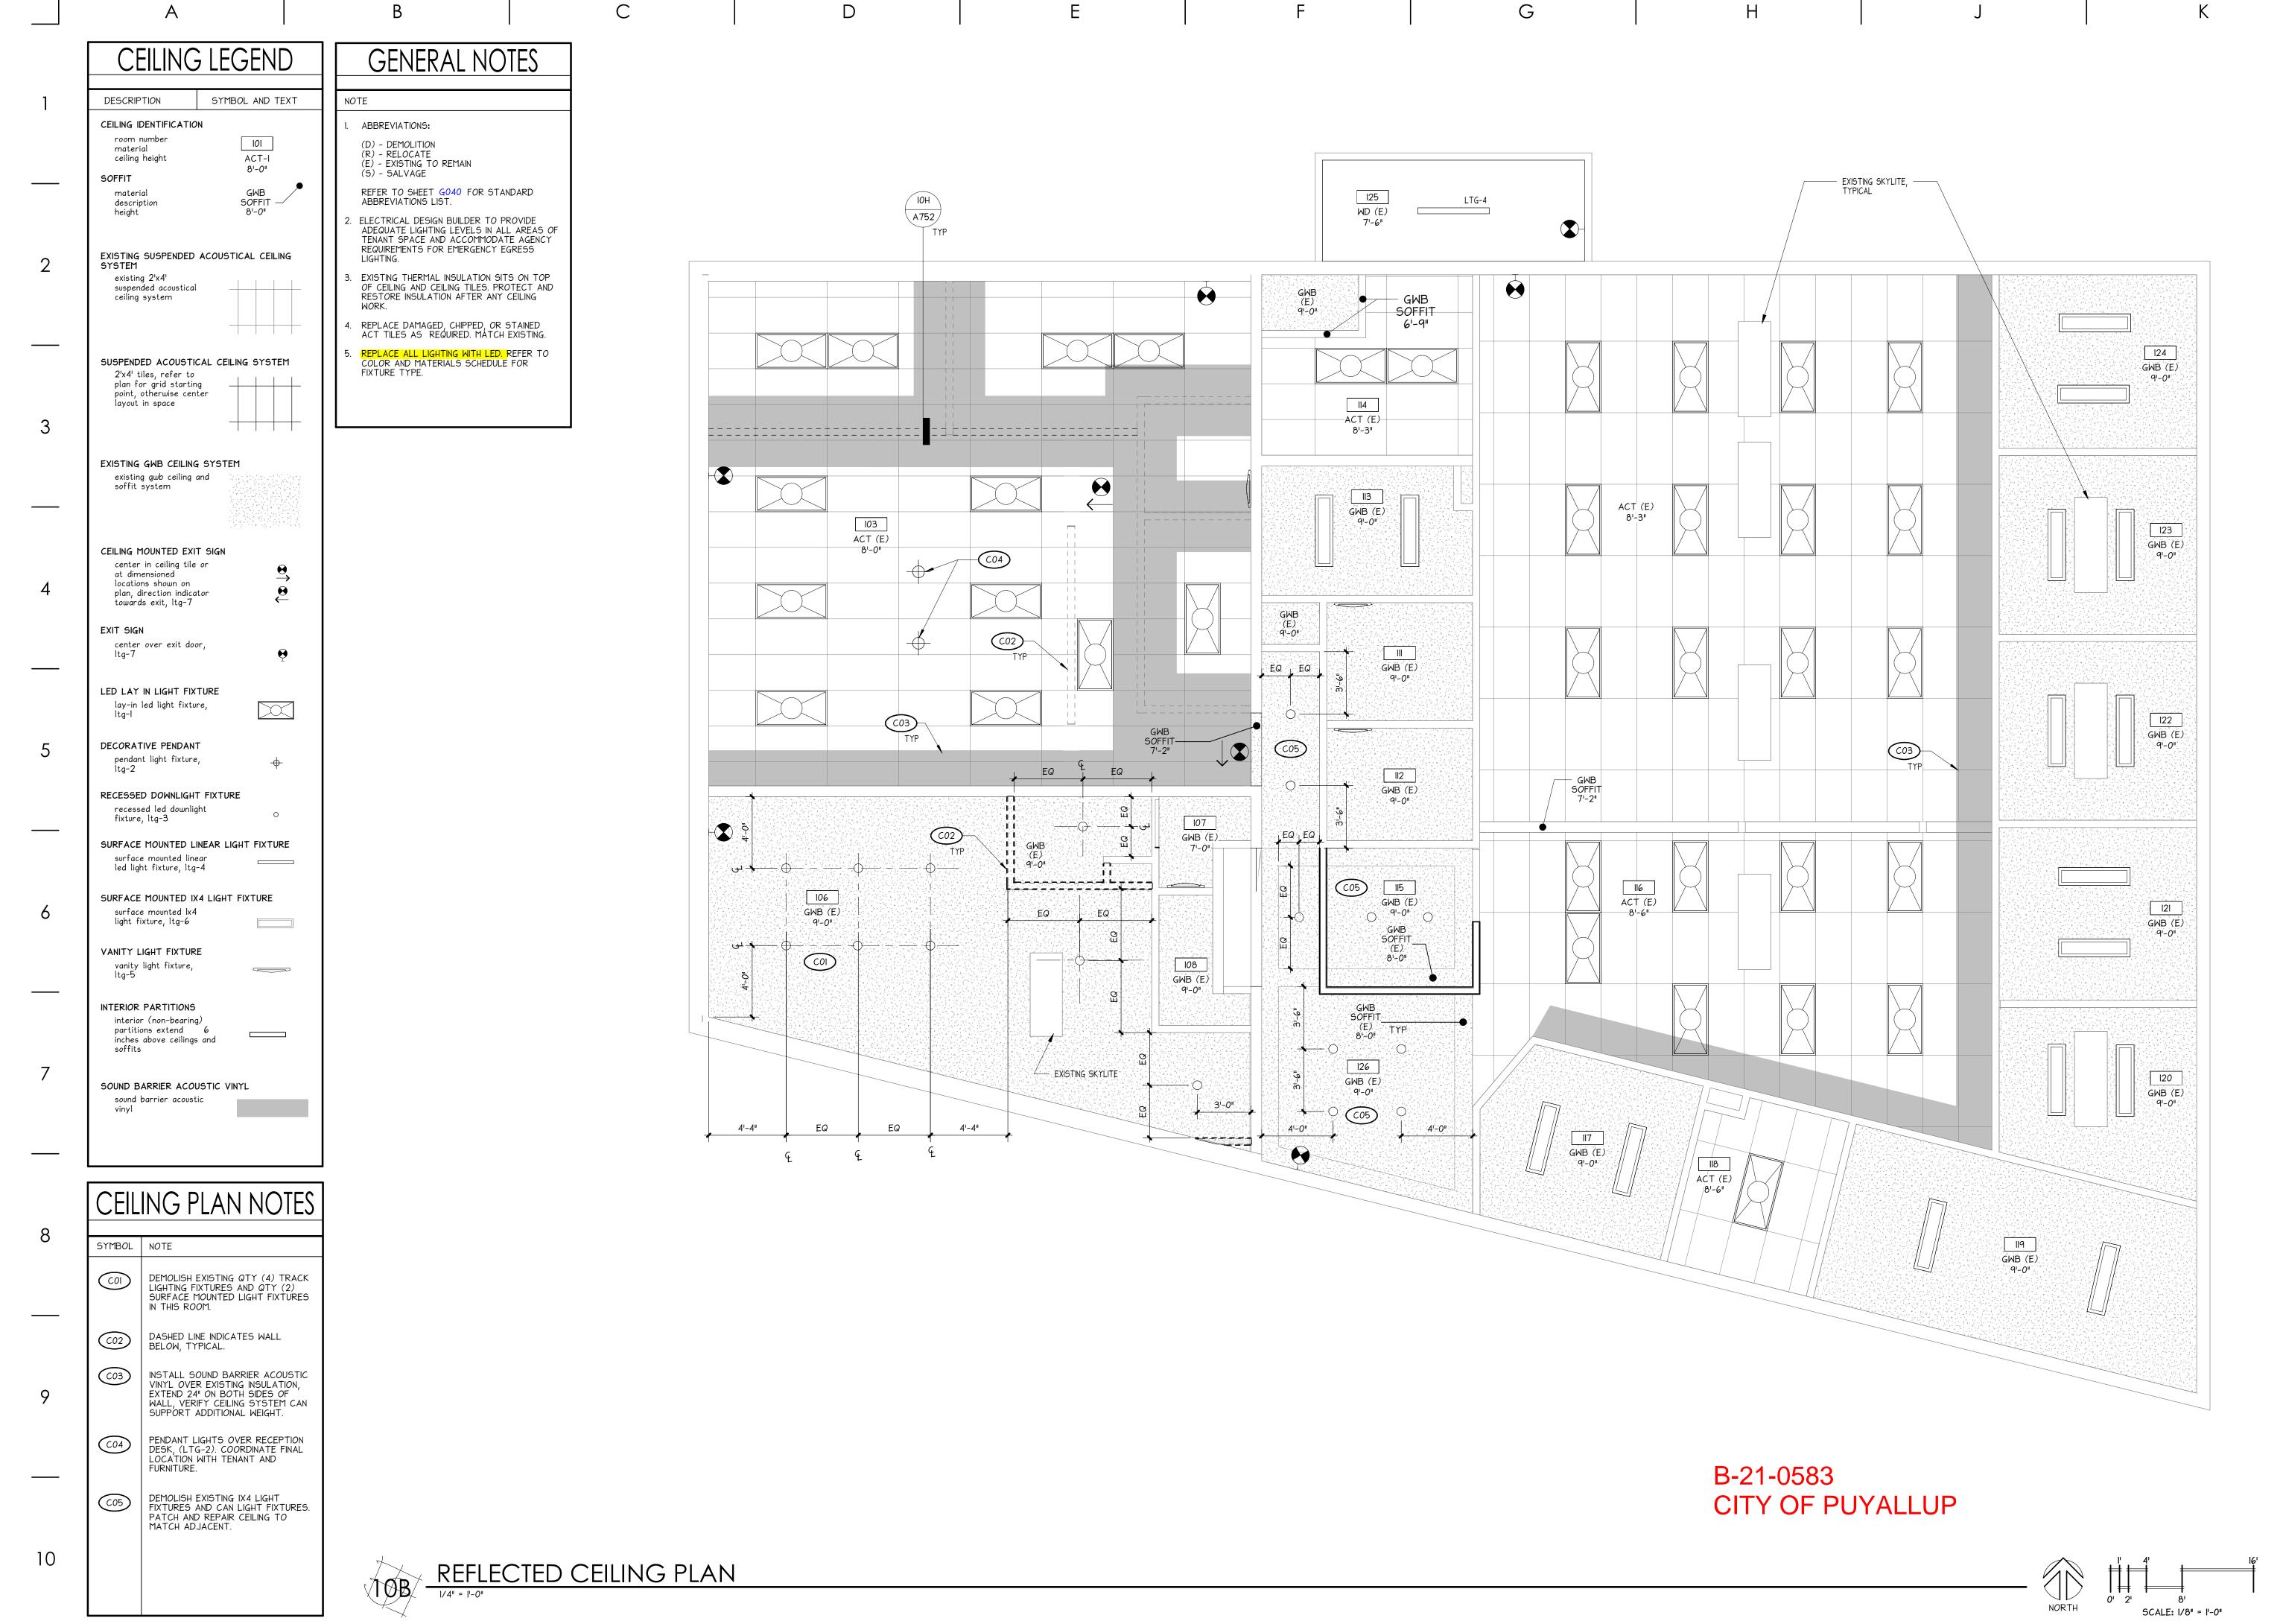3. PAINT ALL EXPOSED CONDUITS AND PIPES; MATCH COLOR OF ADJACENT MATERIAL.

2. "PAINT" (PT) IS A GENERIC TERM USED IN DOCUMENTS. REFER TO COLORS AND MATERIALS SCHEDULE FOR SPECIFIC TYPE OF APPLIED FINISH. THE TERM "PAINT" REFERS TO PAINTS, STAINS, SEALERS AND OTHER

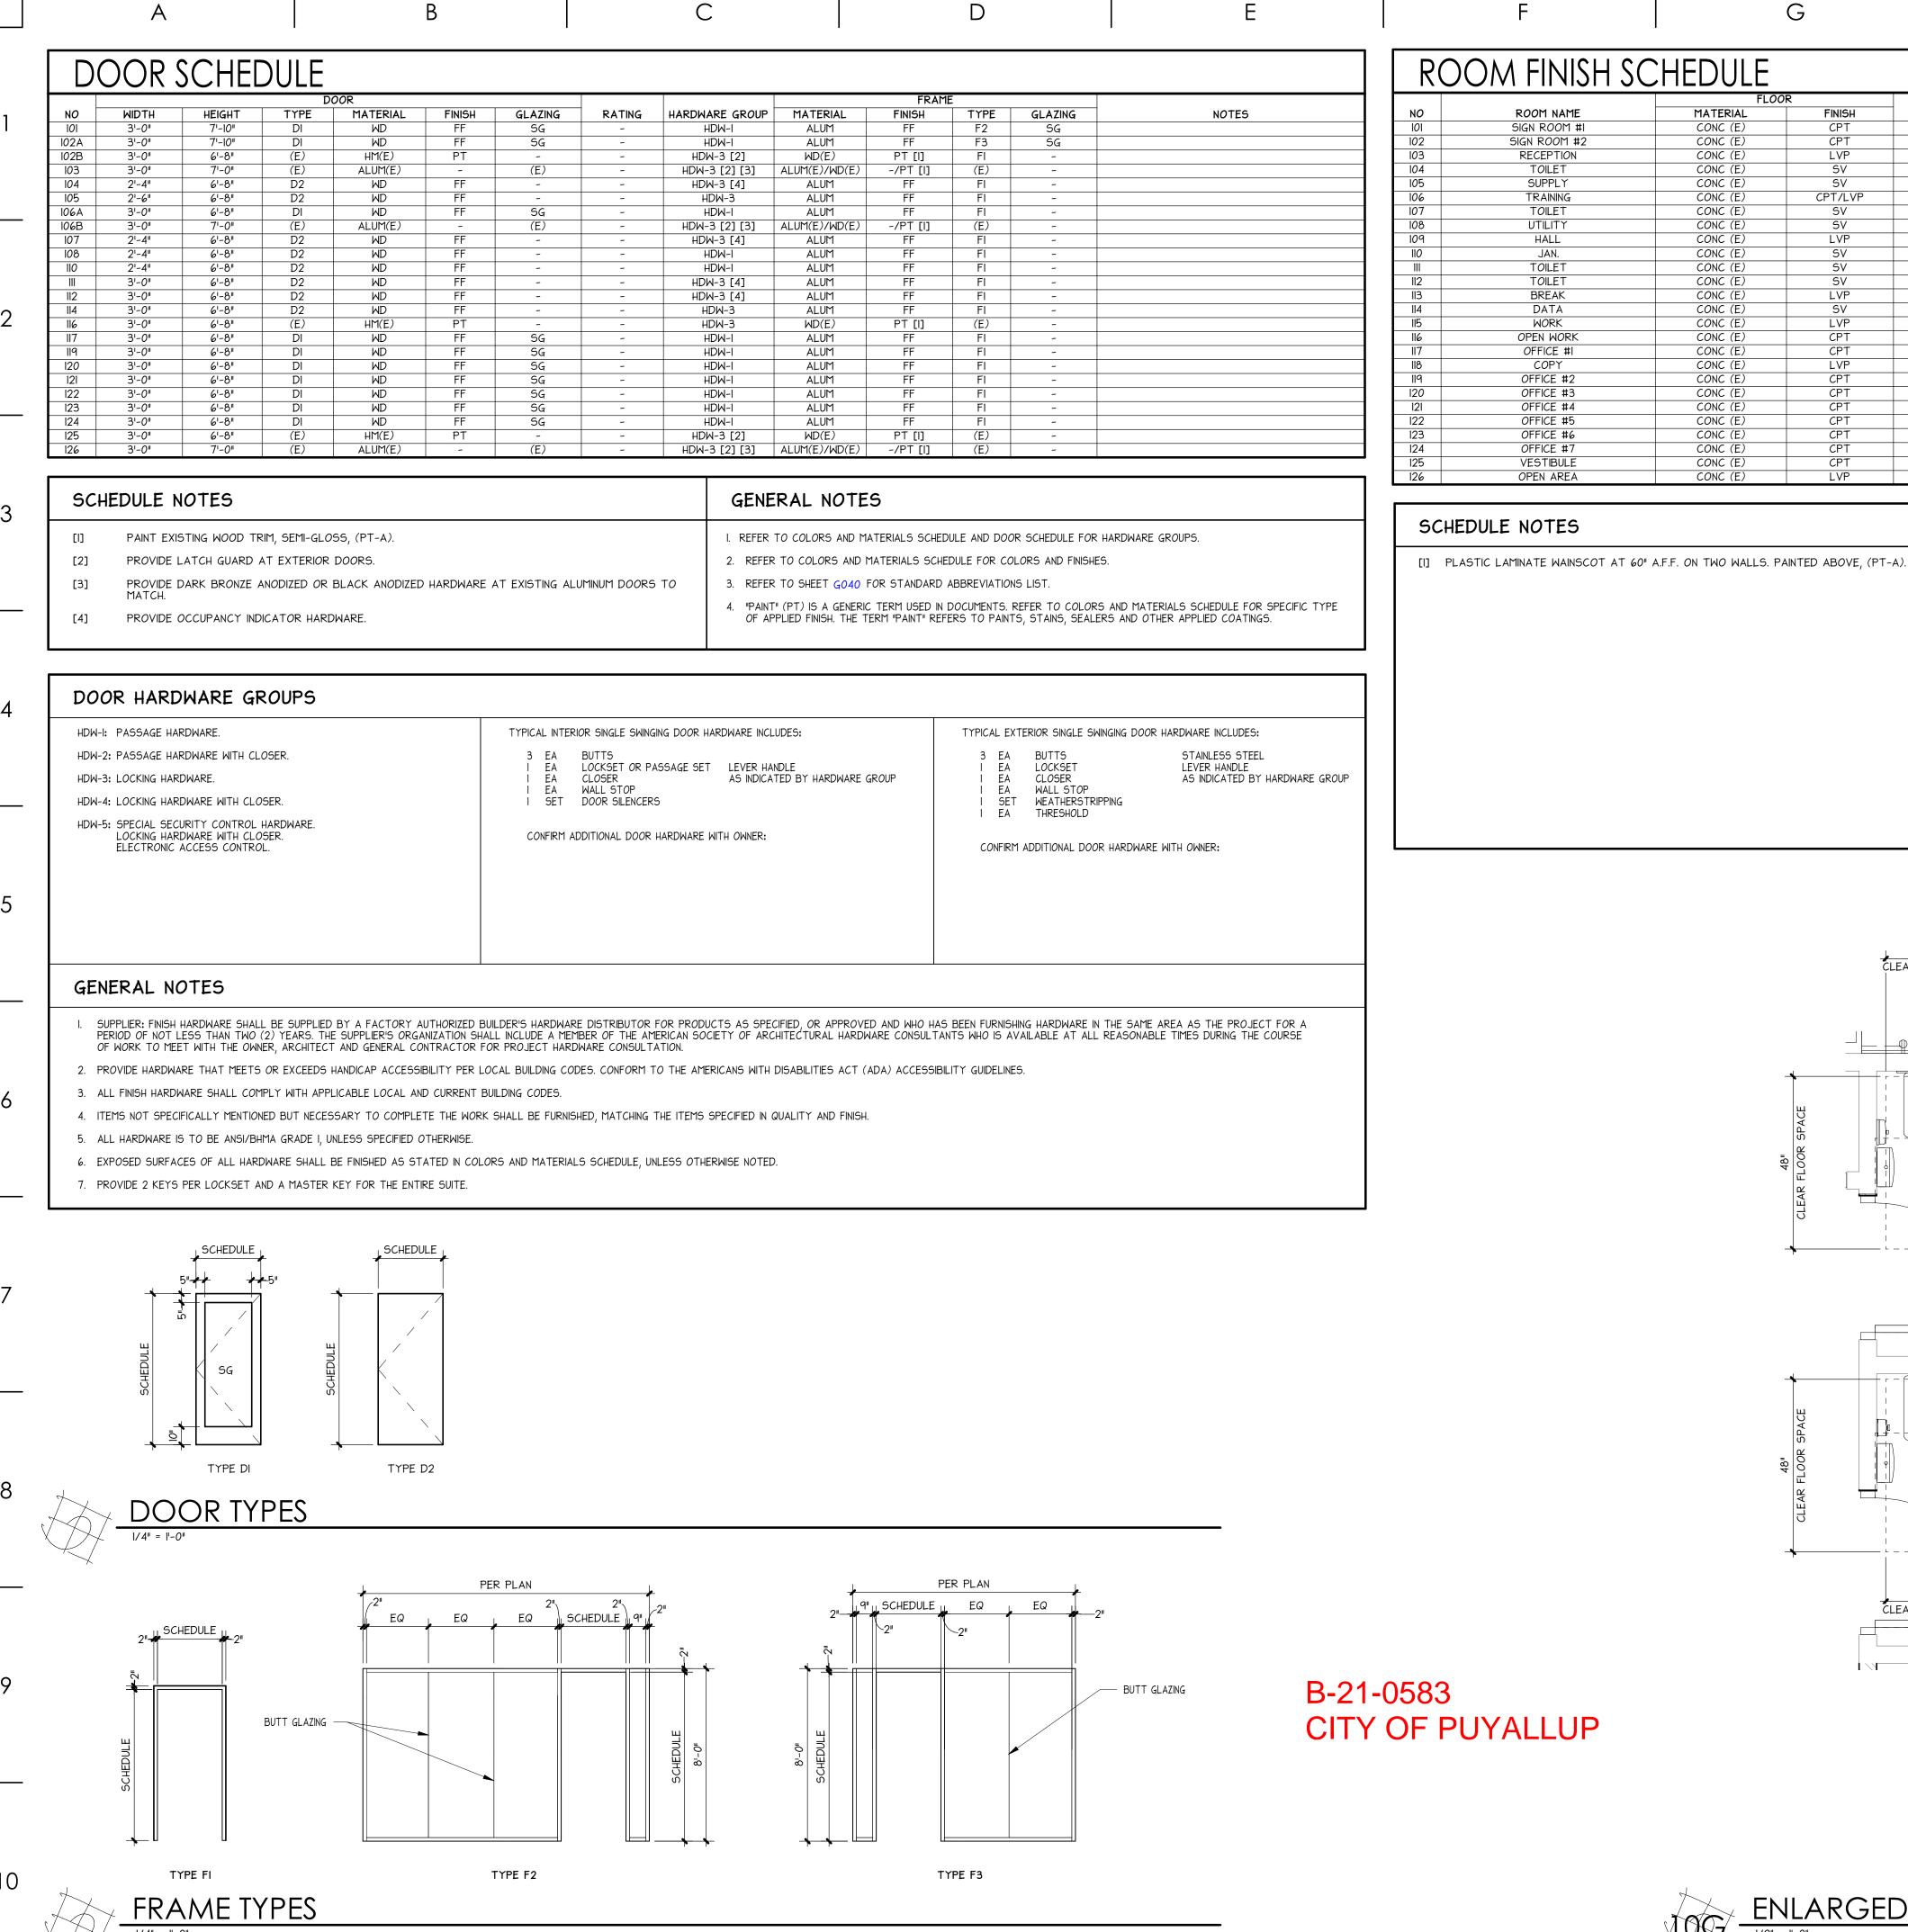4. PAINT ALL EXPOSED SHEET METAL (GALVANIZED STEEL) HVAC DUCTS. CONFIRM COLOR WITH TENANT.

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SCALE: 1/2" = 1'-0"
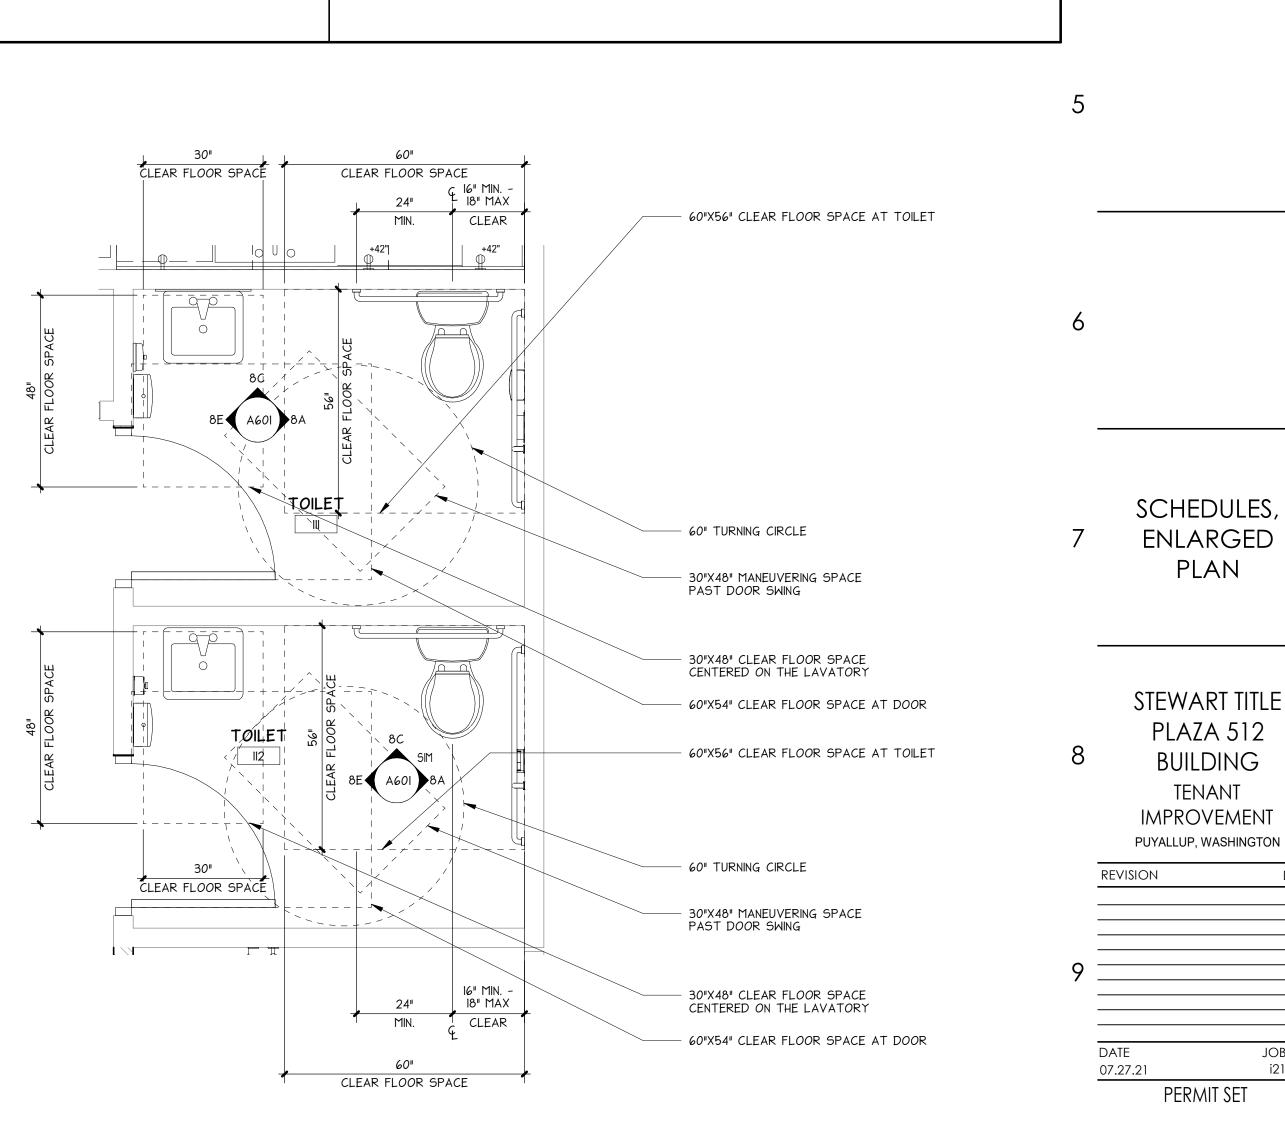
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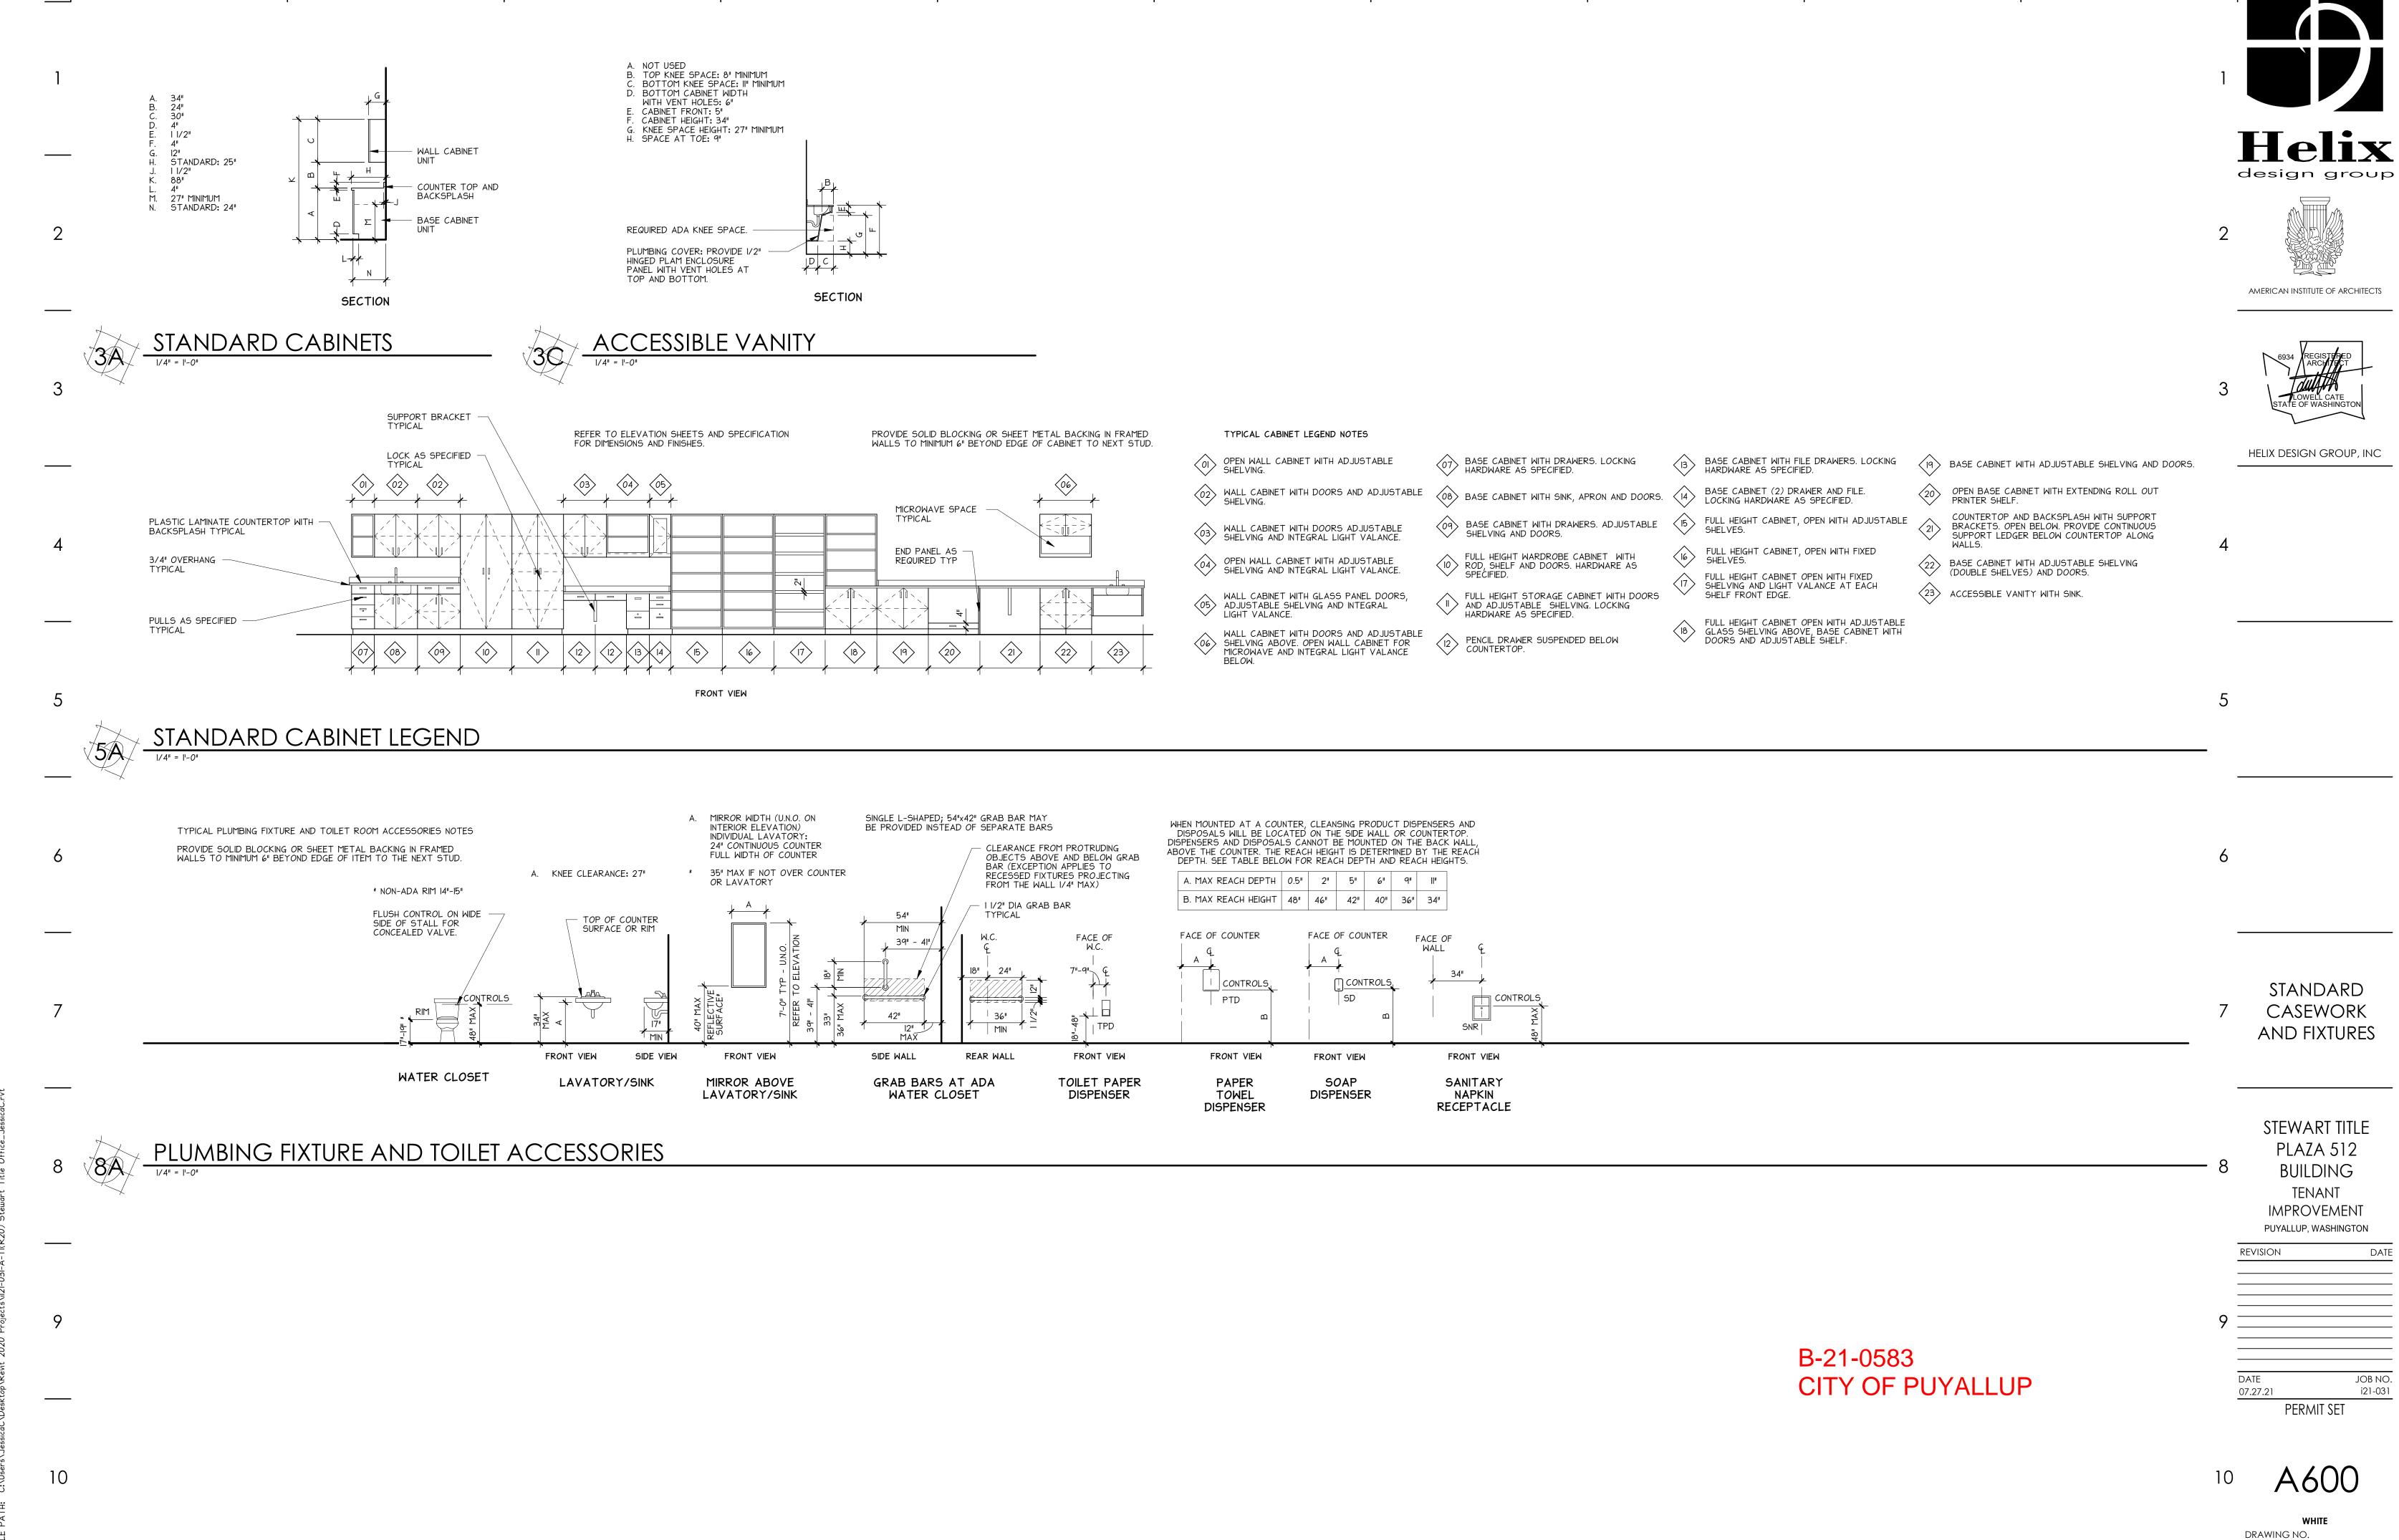
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ENLARGED PLAN - TOILET 111 AND TOILET 112

from Helix Design Group.




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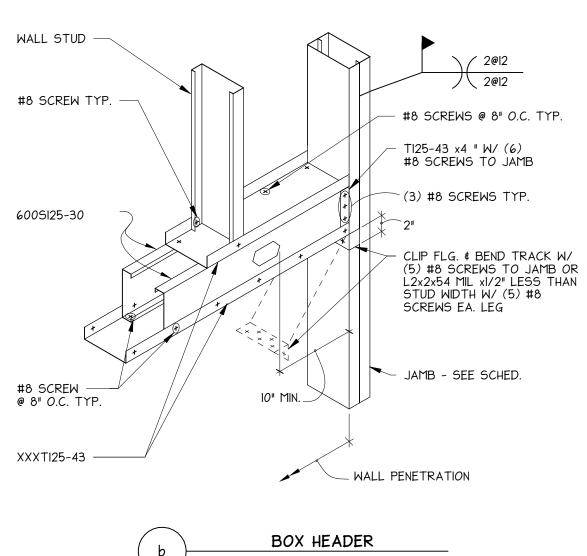
THE INSTALLATION AND CONSTRUCTION OF COLD-FORMED NON-STRUCTURAL STEEL FRAMING, SHALL BE IN ACCORDANCE WITH THE STANDARD FOR COLD-FORMED STEEL FRAMING, GENERAL PROVISIONS, AMERICAN IRON AND STEEL INSTITUTE (AISI-GENERAL) AND AISI-NASPEC AND SHALL BE MANUFACTURED BY A MEMBER OF THE STEEL STUD MANUFACTURER'S ASSOCIATION (SSMA), OR PRE-APPROVED EQUAL, IN ACCORDANCE WITH SSMA ICC ER-4943P. ALL 54 MIL AND HEAVIER GALVANIZED MEMBERS SHALL BE FORMED FROM STEEL THAT MEETS THE REQUIREMENTS OF ASTM A-653, QUALITY SQ, GRADE 33, FY=33 KSI. COLD-FORMED STEEL FRAMING MEMBERS SHALL MEET THE TYPE, SIZE, AND THICKNESS AS INDICATED IN THE ARCHITECTURAL DRAWINGS AND SPECIFICATIONS, AND SHALL CONFORM TO THE MINIMUM PROCEDURE OF THE GYPSUM CONSTRUCTION HANDROOK BY COC. INC. PRESCRIPTIVE REQUIREMENTS OF THE GYPSUM CONSTRUCTION HANDBOOK BY CGC, INC.

GENERAL NOTES


Р	ENETI	1AL NOITAS	NON-BEAR 1B SCHEDUL SF LIVE LOA	.E	5
		MIN. NUMBER STUD(S) AT JAMB			
	E (FT)	(1)	(2)	(3)	(4)
GA.		HORIZ. DEFLECTION LIMIT OF WALL HT			
STUD SIZE ¢ GA.	MAX. OPN'G SIZE (FT.)	1 / 240	1 / 240	1 / 240	1 / 240
		MAX. JAMB HT (FT)			
	3	12	16	-	-
_	4	12	15	16	-
3625125-33	6	10	13	15	16
62512	8	9	12	14	16
n	10	-	12	13	15
	12	-	11	13	14
	3	12	16	-	-
<u>س</u>	4	10	16	-	-
6005125-33	6	-	15	16	-
0051	8	-	13	16	-
0	10	-	11	15	16
	12	-	9	14	16
	3	-	-	-	-
<u>س</u>	4	-	-	-	-
8005125-33	6	16	-	-	-
1500	8	15	16	-	-
80	10	14	16	-	-
	12	13	16	-	-

- I. BOXED JAMB STUDS SHOWN. BACK-TO-BACK JAMB STUDS PERMITTED AT
- CONTRACTOR OPTION. FOR DETAIL SEE 10D/A751 2. FOR CONNECTION TO STRUCTURE ABOVE SEE -/---
- 3. FOR CONNECTION TO STRUCTURE BELOW SEE 10A/A751
- 4. HEADER AND STUDS SHALL BE CONTINUOUS NO SPLICES ALLOWED.

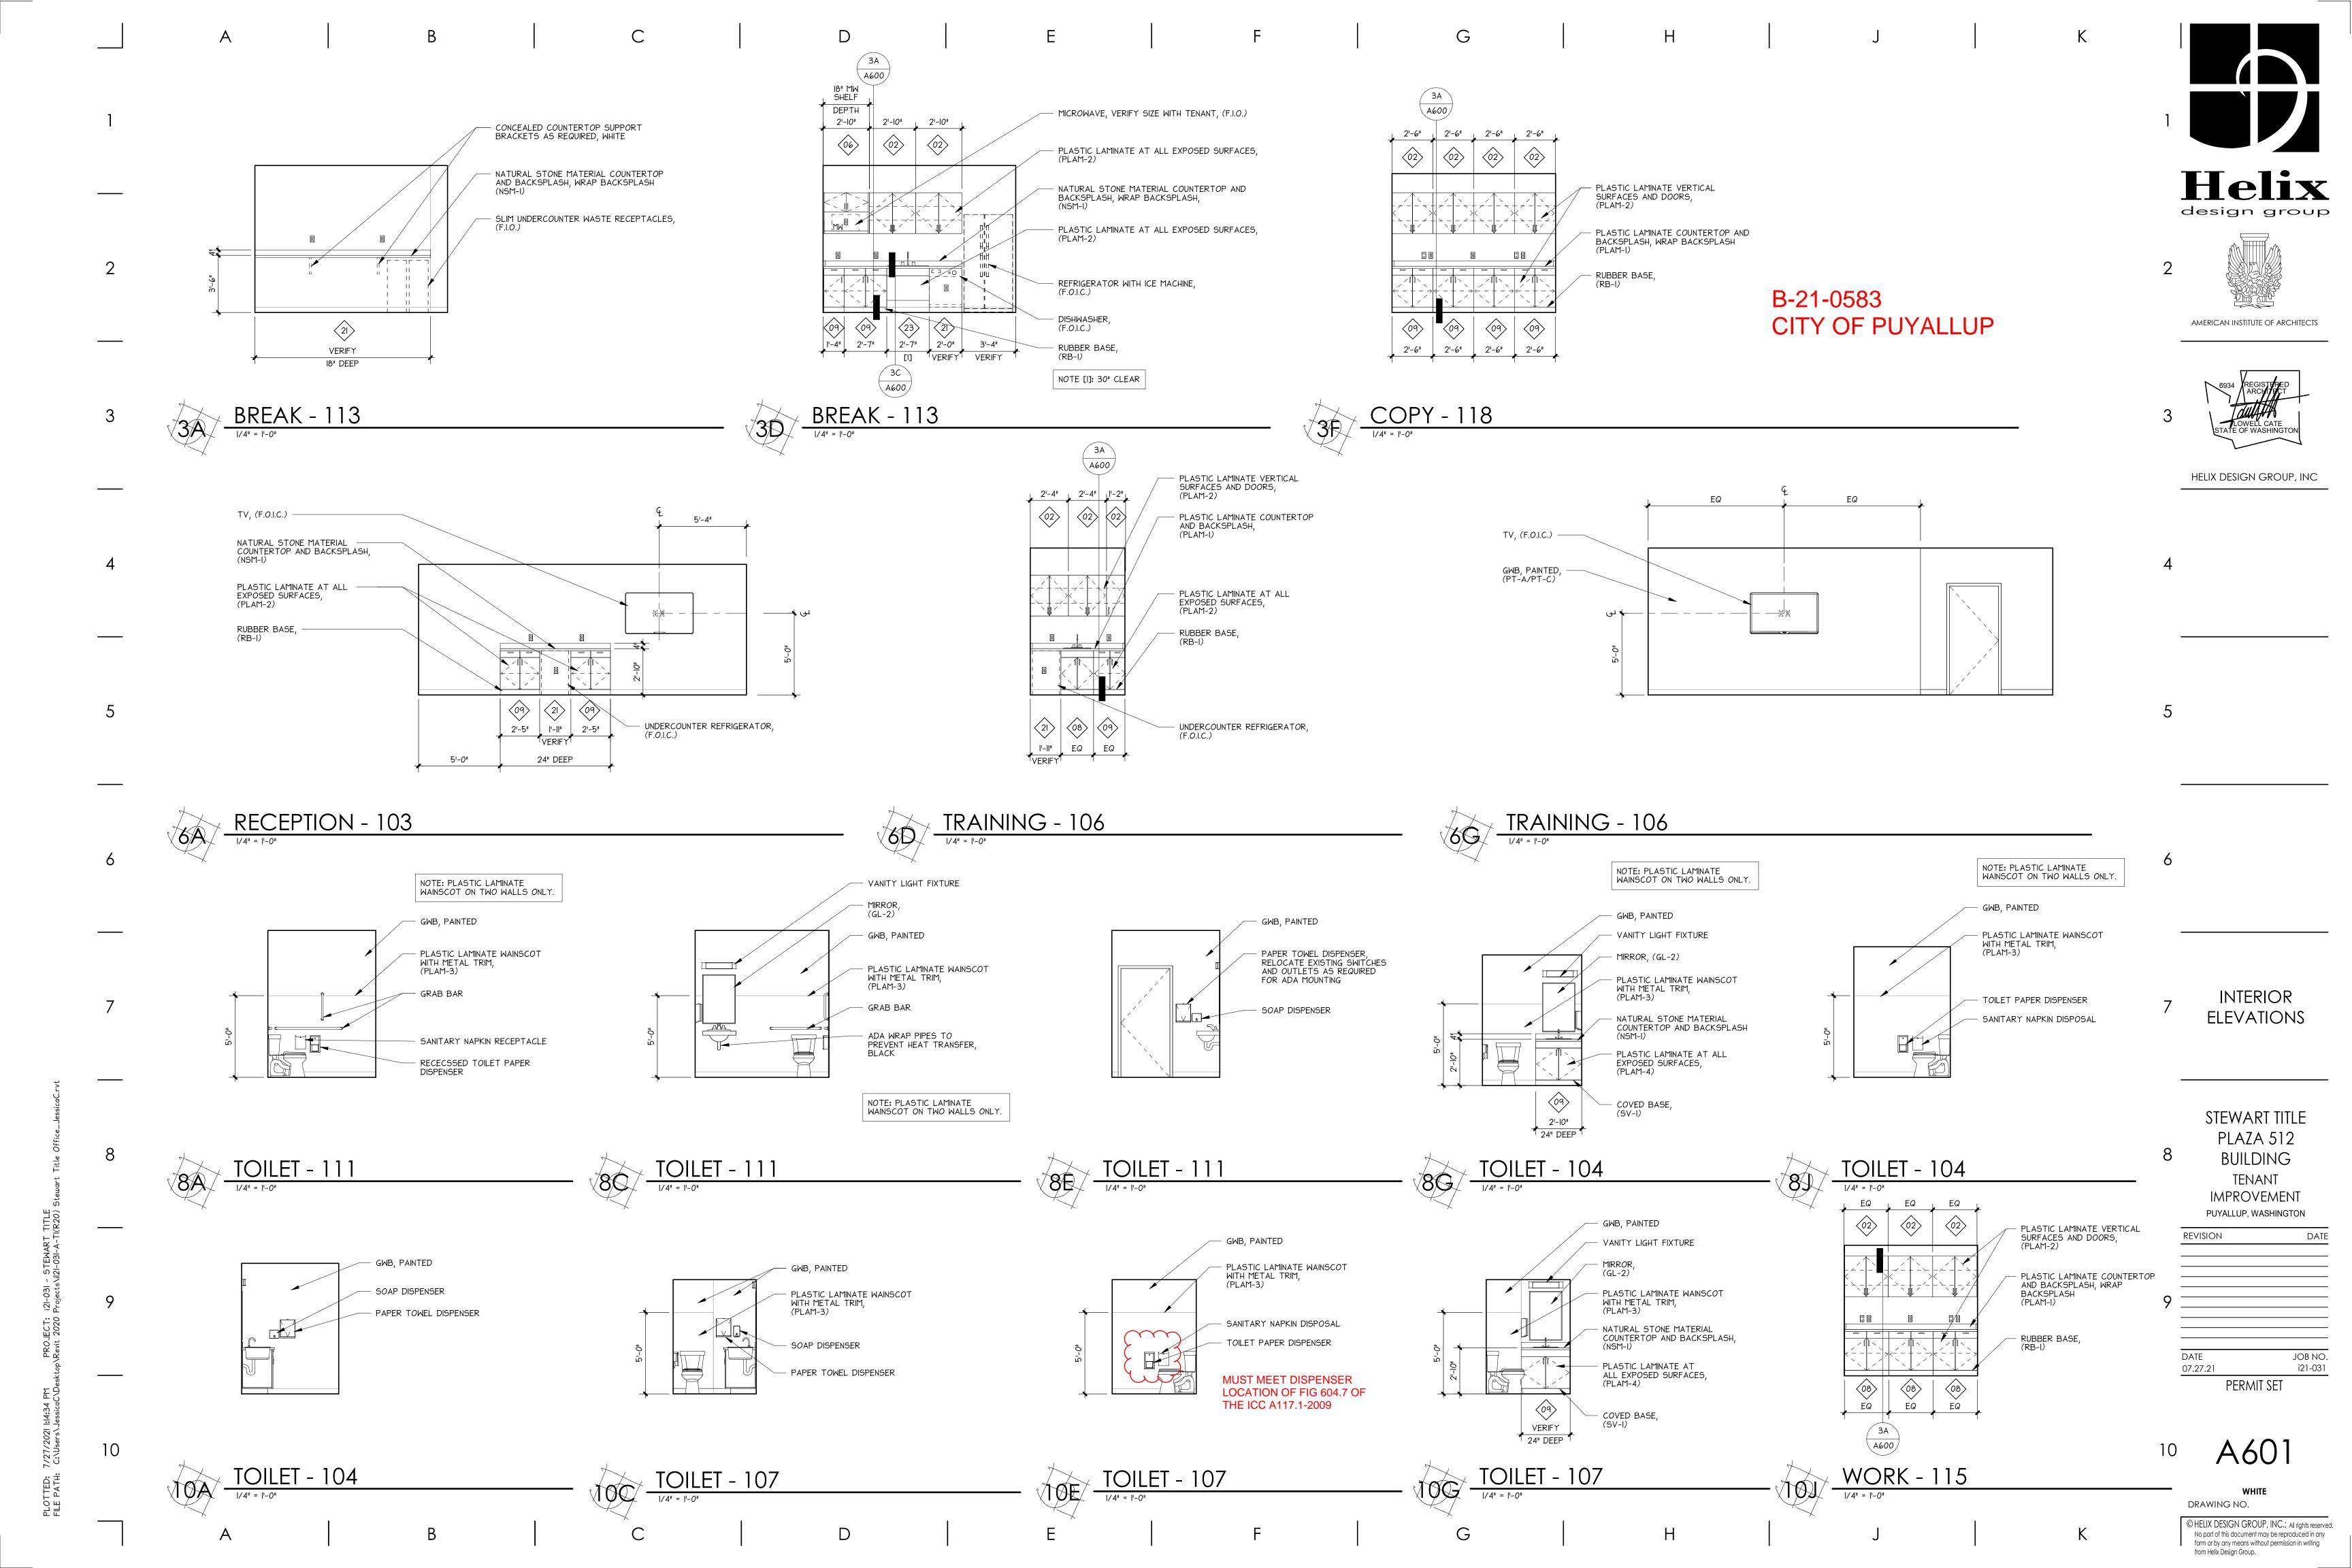		WALL STUD —
		#8 SCREW TYP.
WALL STUD #8 SCREW TYP.	2@12	(00CIDE 20
NESTED	CLIP FLG & BEND TRACK W/ (5) #8 SCREWS TO JAMB OF L2x2x54 MIL xI/2" LESS THAN STUD WIDTH W/ (5) #8	6005 25-30
XXXT250-54	SCREWS EA. LEG JAMB - SEE SCHED.	#8 SCREW @ 8" O.C. TYP.
#8 SCREW @	WALL PENETRATION	XXXTI25-43 ————
(a) NE	STED HEADER	b



12'-0" MAX. PENETRATION SIZE

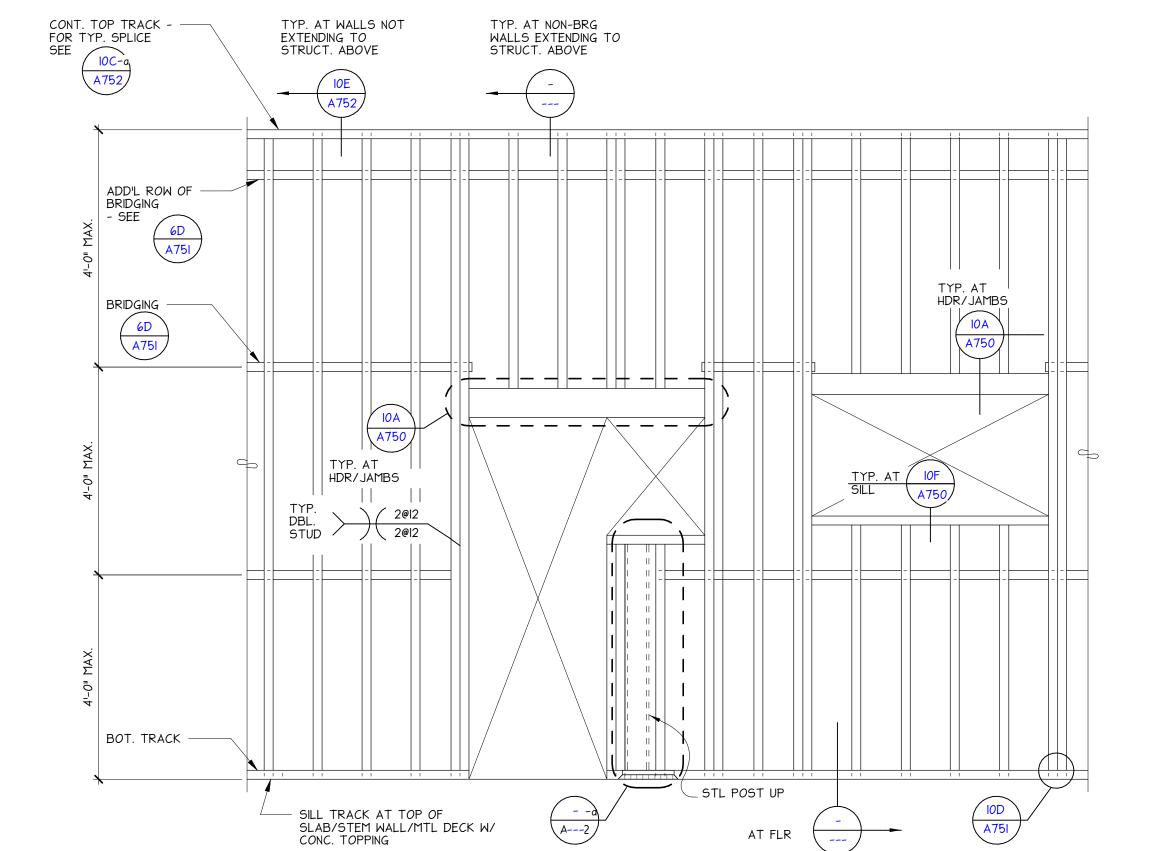

COLD-FORMED STUD WALL FRAMING NOTES:


- I. ALL NON-BEARING WALL STUDS SHALL BE PER 1/A751 UNLESS NOTED OTHERWISE. FOR WALL TYPE AND PROPER LOCATION SEE ARCHITECTURAL DRAWINGS.
- 2. PROVIDE BRIDGING AT ALL NON-BEARING WALLS WITHOUT FULL HEIGHT QUALIFIED SHEATHING EITHER SIDE OF STUD PER 6D/A75I NOTE #I.

G

- 3. FOR TYPICAL CEILING FRAMING SCHEDULE AND DETAIL SEE 6A/A751 4. ALL WELDS SHALL BE 1/8" FILLET MAXIMUM. FOR MATERIALS THINNER THAN 0.15", EFFECTIVE THROAT SHALL NOT BE LESS THAN THINNEST MATERIAL. WELD IN ACCORDANCE WITH "STRUCTURAL WELDING CODE -- SHEET METAL"
- 5. STUD PUNCH-OUTS SHALL NOT BE SPACED LESS THAN 24" O.C. NOR WITHIN 10" CLEAR OF MEMBER END AT STUDS, HEADERS, BEAMS, JOISTS, ETC.
- 6. SCREWS SHALL BE THREAD-FORMING OR THREAD-CUTTING, WITH OR WITHOUT A SELF DRILLING POINT. SCREWS SHALL BE INSTALLED AND TIGHTENED IN ACCORDANCE WITH THE MANUFACTURER'S RECOMMENDATION. MINIMUM SPACING IS THREE SCREW DIAMETERS. A MINIMUM OF (3) THREADS SHALL BE ENGAGED.
- 7. FOR TYPICAL WALL CORNER REQUIREMENTS SEE 10C/A752

MILS/GAUGE SCHEDULE			
MIL5	MIN. THICKNESS	GAUGE	
30	.0312	20	
33	.0346	20	
43	.0451	18	
54	.0566	16	
68	.0713	14	
97	.1017	12	

ELEVATION

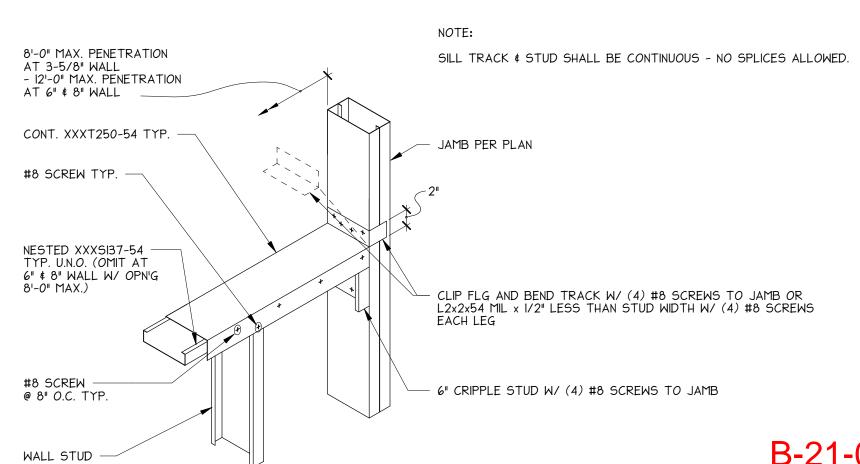

B-21-0583 CITY OF PUYALLUP

07.27.21

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INTERIOR METAL

FRAMING

DETAILS

STEWART TITLE

PLAZA 512

BUILDING

TENANT

IMPROVEMENT

PUYALLUP, WASHINGTON


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NOT TO SCALE

4'-0" MAX. PENETRATION SIZE (NOT ALLOWED AT DOORS)

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CLIP FLG. & BEND - INSTALL CLIP FLG. & BEND - INSTALL 96" O.C. MAX. - ALL STRAPS SHALL BE = 3x SCREW DIA. 96" O.C. MAX. - ALL STRAPS SHALL BE CONNECTED TO AT LEAST (I) BLOCK CONNECTED TO AT LEAST (I) BLOCK
- PROVIDE ADD'L BLOCK EA. SIDE AT
DISCONTINUOUS STRAP - PROVIDE ADD'L BLOCK EA. SIDE AT (2) #8 SCREWS DISCONTINUOUS STRAP TO CHANNEL & STUD FULL HT SHT'G -FRAMED WALL SEE NOTE #1 · lq"xlq"x(d)- " CLIP ANGLE - PROVIDE BRIDGING - (I) THICKNESS HEAVIER THAN STUD @ 48" O.C. VERT. MAX. - TYP. U.N.O. OR 54 MIL. MIN., - SEE ALSO SCREWED ANGLE SCREW ATTACHMENT -(4) #8 MIN. EA. SIDE PROVIDE BRIDGING - SCREW ATTACHMENT - FRAMED WALL @ 48" O.C. VERT. MAX. - TYP. U.N.O. - (4) #8 MIN. EA. SIDE - SEE ALSO TAUT 33 MIL. x lq." - <u>TAUT 33 MIL. x Iq."</u> CONT. STRAP EA. SIDE CONT. STRAP — (1) #8 EA. FLG, EA. STUD - PROVIDE BRIDGING @ 48" O.C. VERTICAL MAX. - TYP. U.N.O. REFER TO 150U50-54 COLD-ROLLED OPTION I - BRIDGING CONSISTS OF CHANNEL - OPTIONAL SPLICE AT DBL. FLAT STRAP W/ BLK'G CLIP ANGLE - PROVIDE DBL. CLIP ANGLE ((1) EA. SIDE) AT OPTION 3: BRIDGING ONE FACE CONSISTS OF B.U. STUDS SINGLE FLAT STRAP WITH BLOCK AND FULL HEIGHT SHEATHING OPPOSITE FACE FULL HT SHT'G -SEE NOTE #1 OPTION 2: BRIDGING CONSISTS OF COLD-ROLLED CHANNEL WITH CLIP ANGLE (6" MAX. STUD SIZE) I. QUALIFIED SHEATHING SHALL BE GWB, GYPSUM SHEATHING, PLYWOOD SHEATHING, OR O.S.B. ONLY AND SHALL OCCUR FULL HEIGHT. OF WALL. - FASTEN W/ #6 SCREW MIN. @ 12" O.C. MAX TYP.

G

G

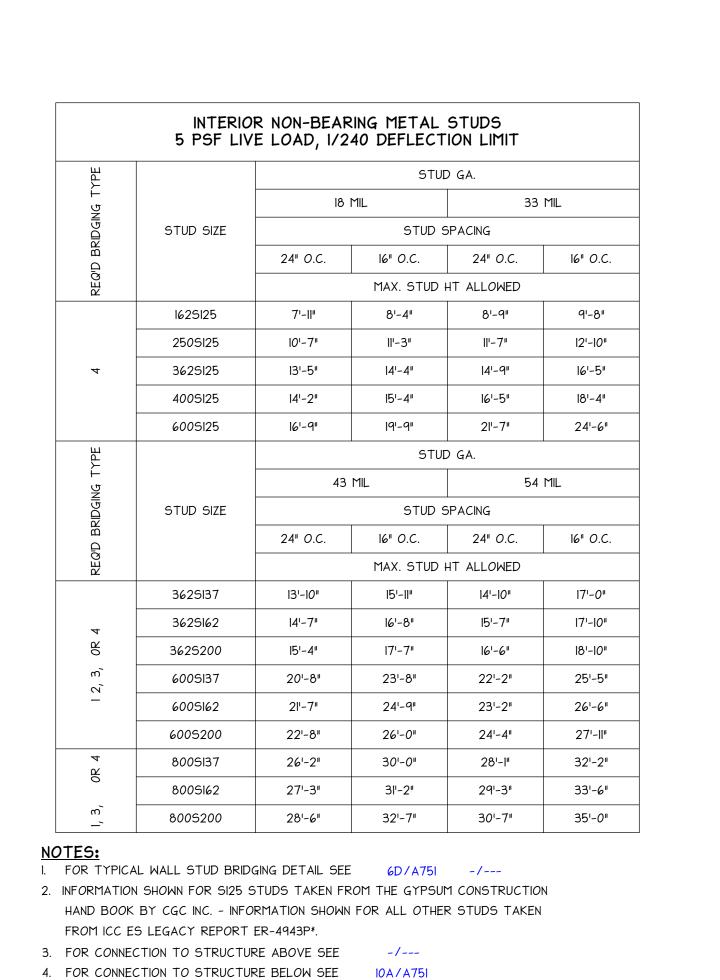TYP. MIN. EDGE

DISTANCE


TRACK BLOCK PIECE TO MATCH WALL STUD -


SCHEDULE

DETAIL

| | = | -0|

TRACK BLOCK PIECE TO MATCH WALL STUD -

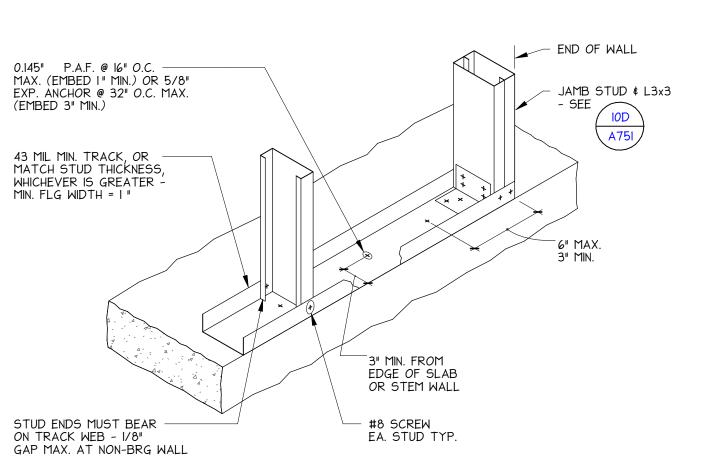

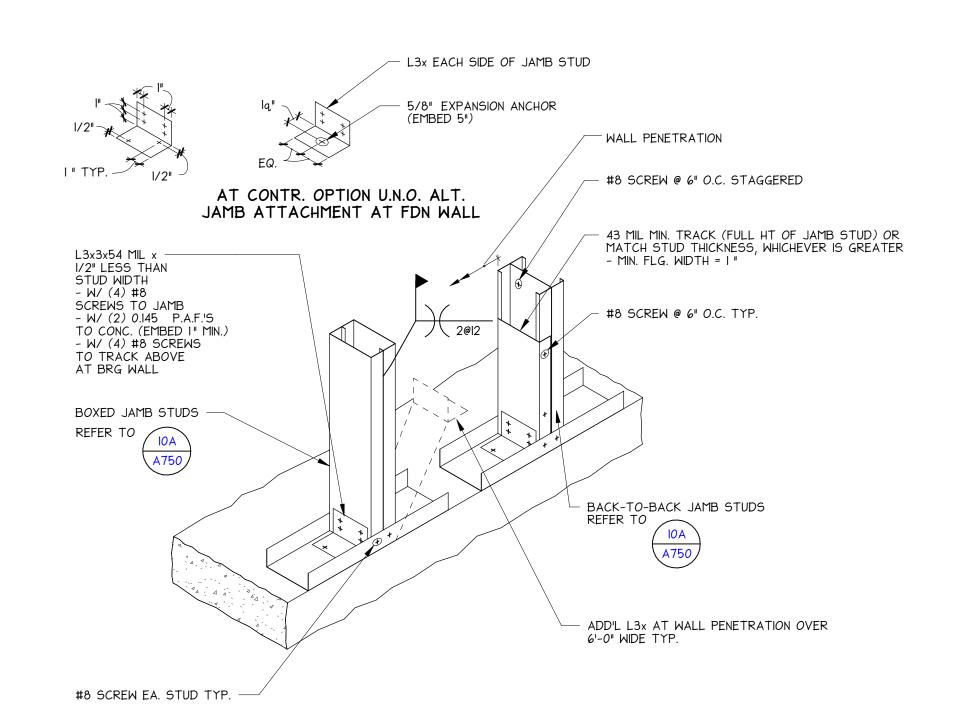

OPTION 4: FULL HT SHEATHING EACH FACE

B-21-0583 CITY OF PUYALLUP

A751

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HELIX DESIGN GROUP, INC

INTERIOR METAL

FRAMING

DETAILS

STEWART TITLE

PLAZA 512

BUILDING

TENANT


IMPROVEMENT


PUYALLUP, WASHINGTON


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JOB NO.

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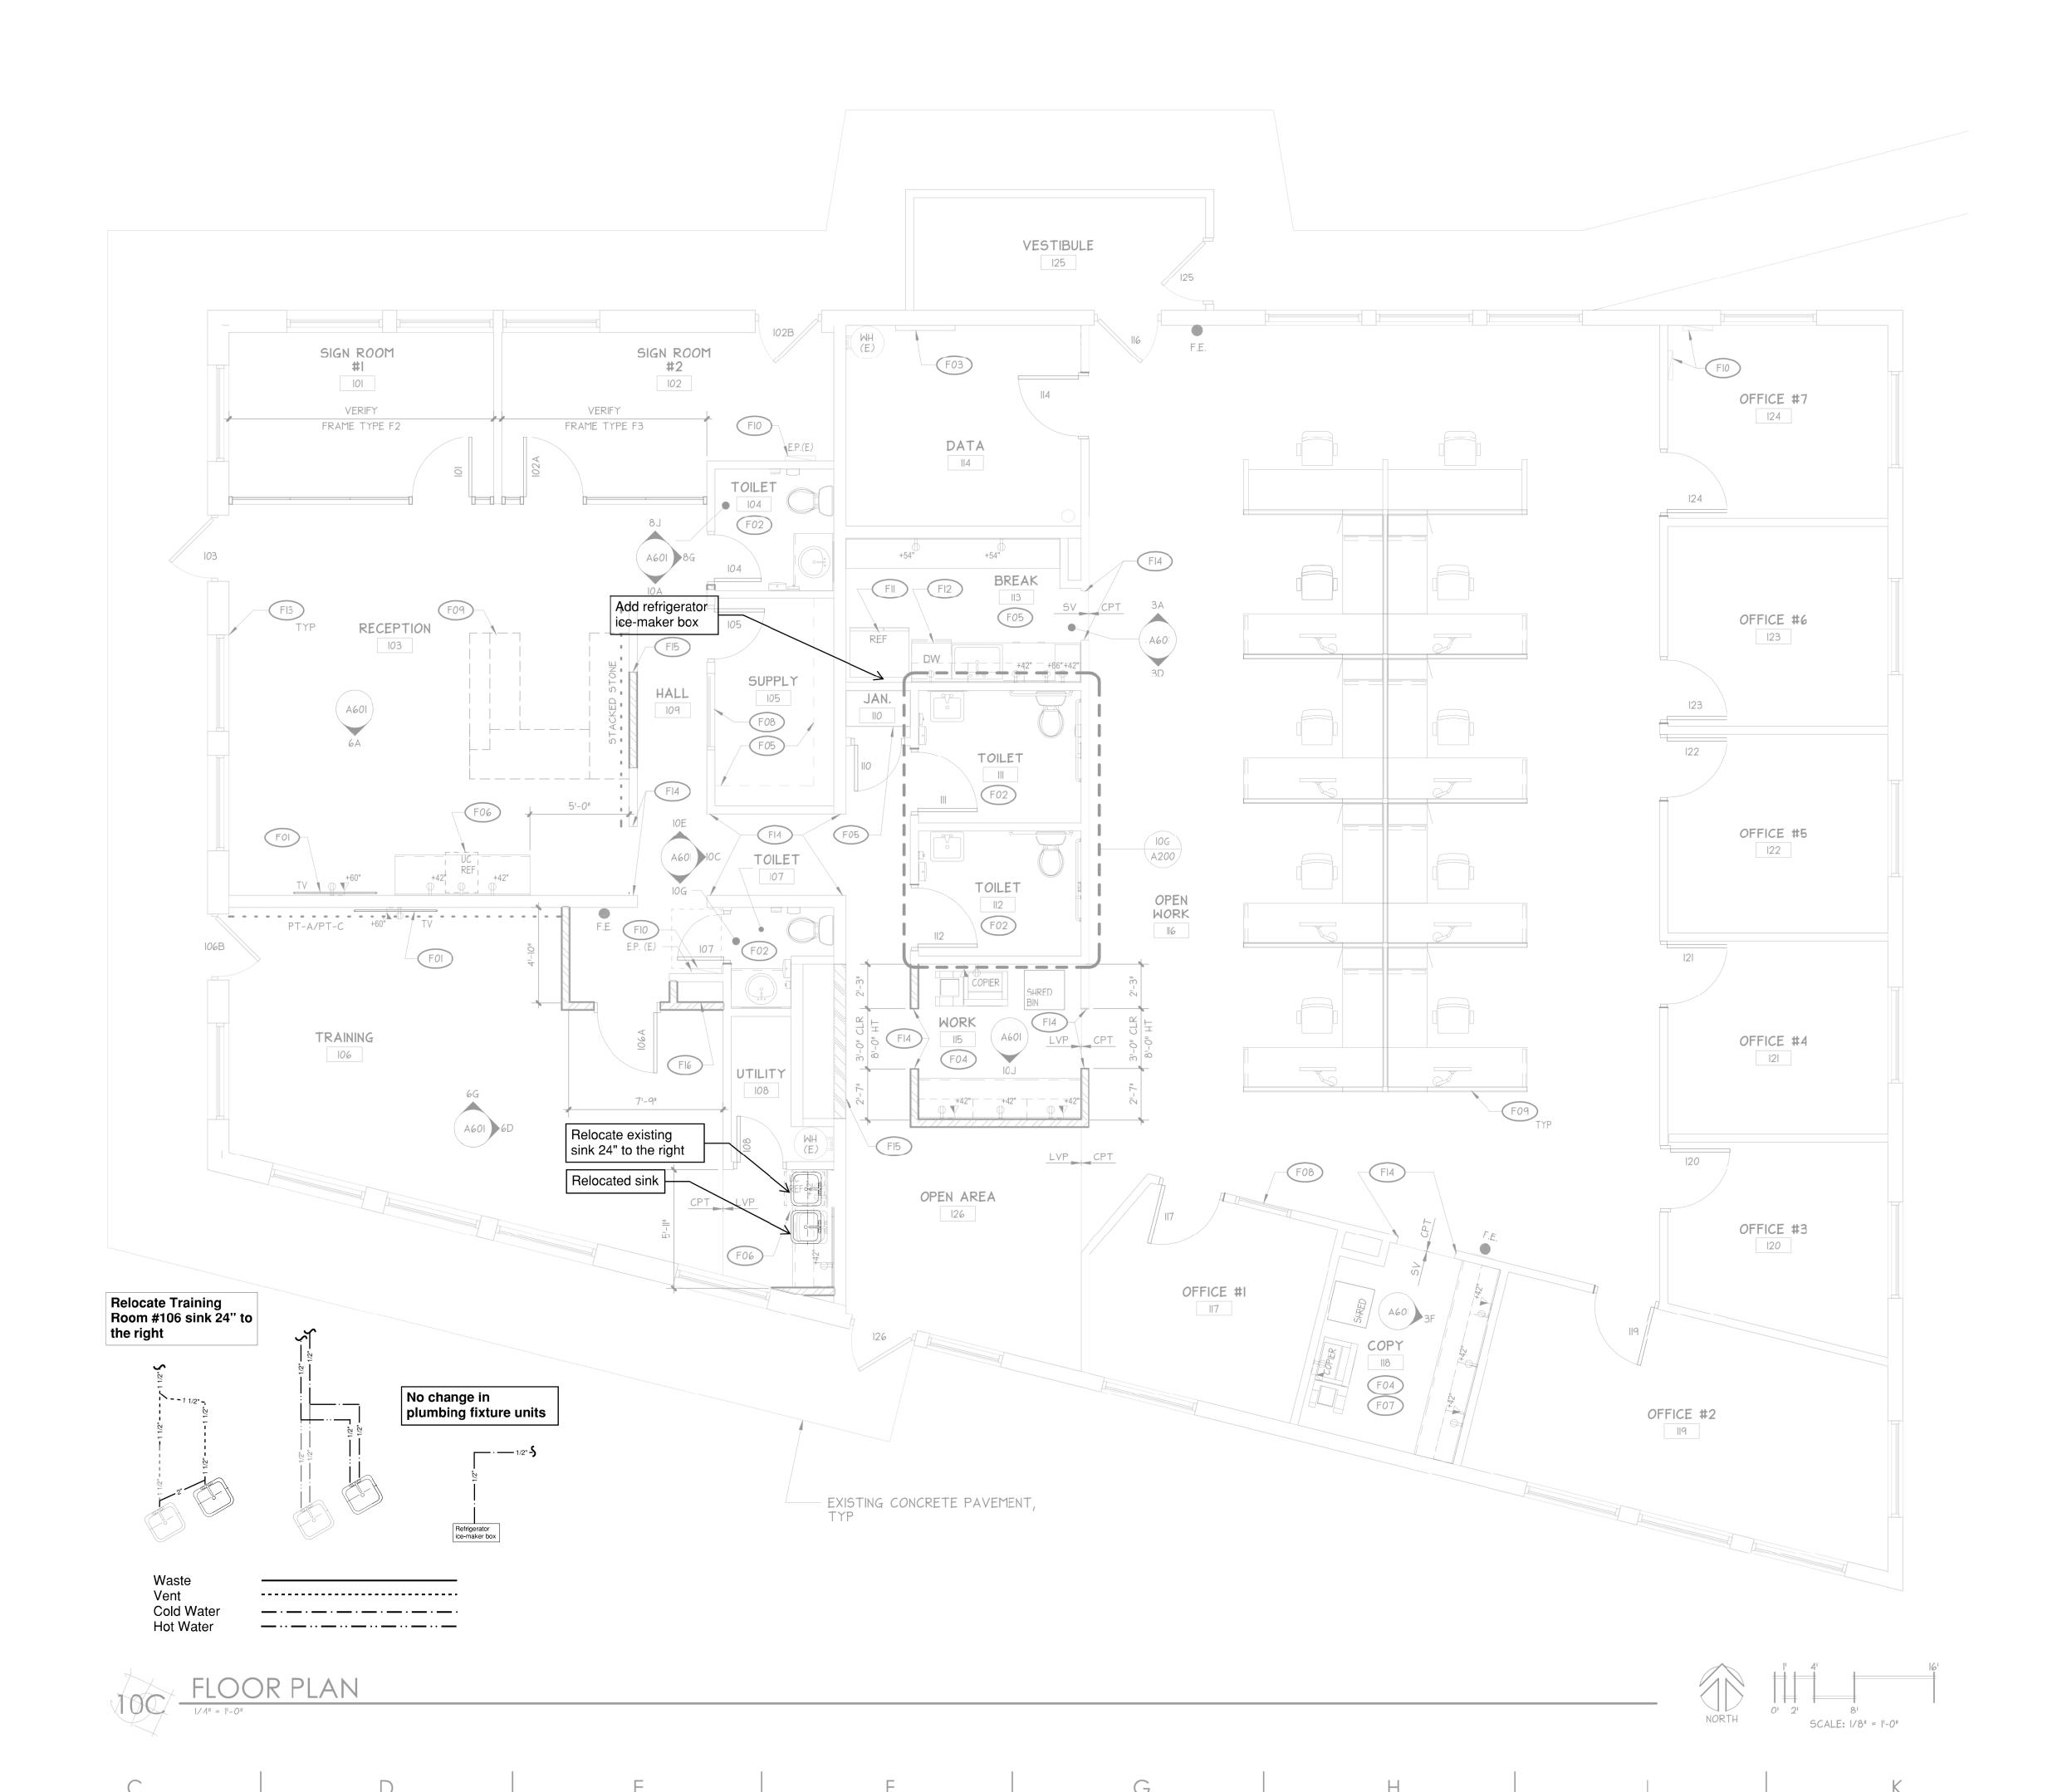


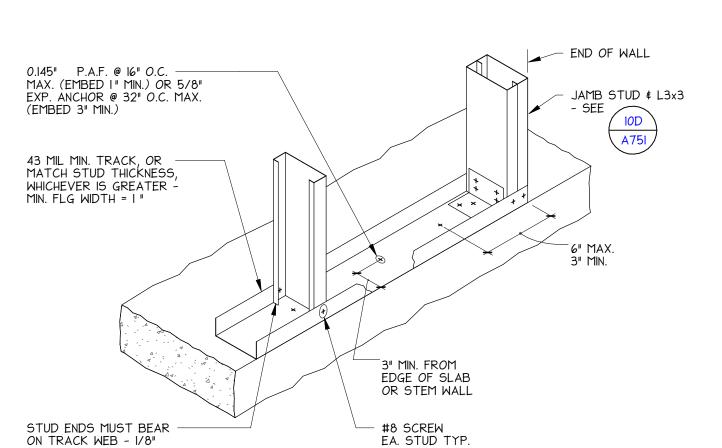

Date 7-14-21

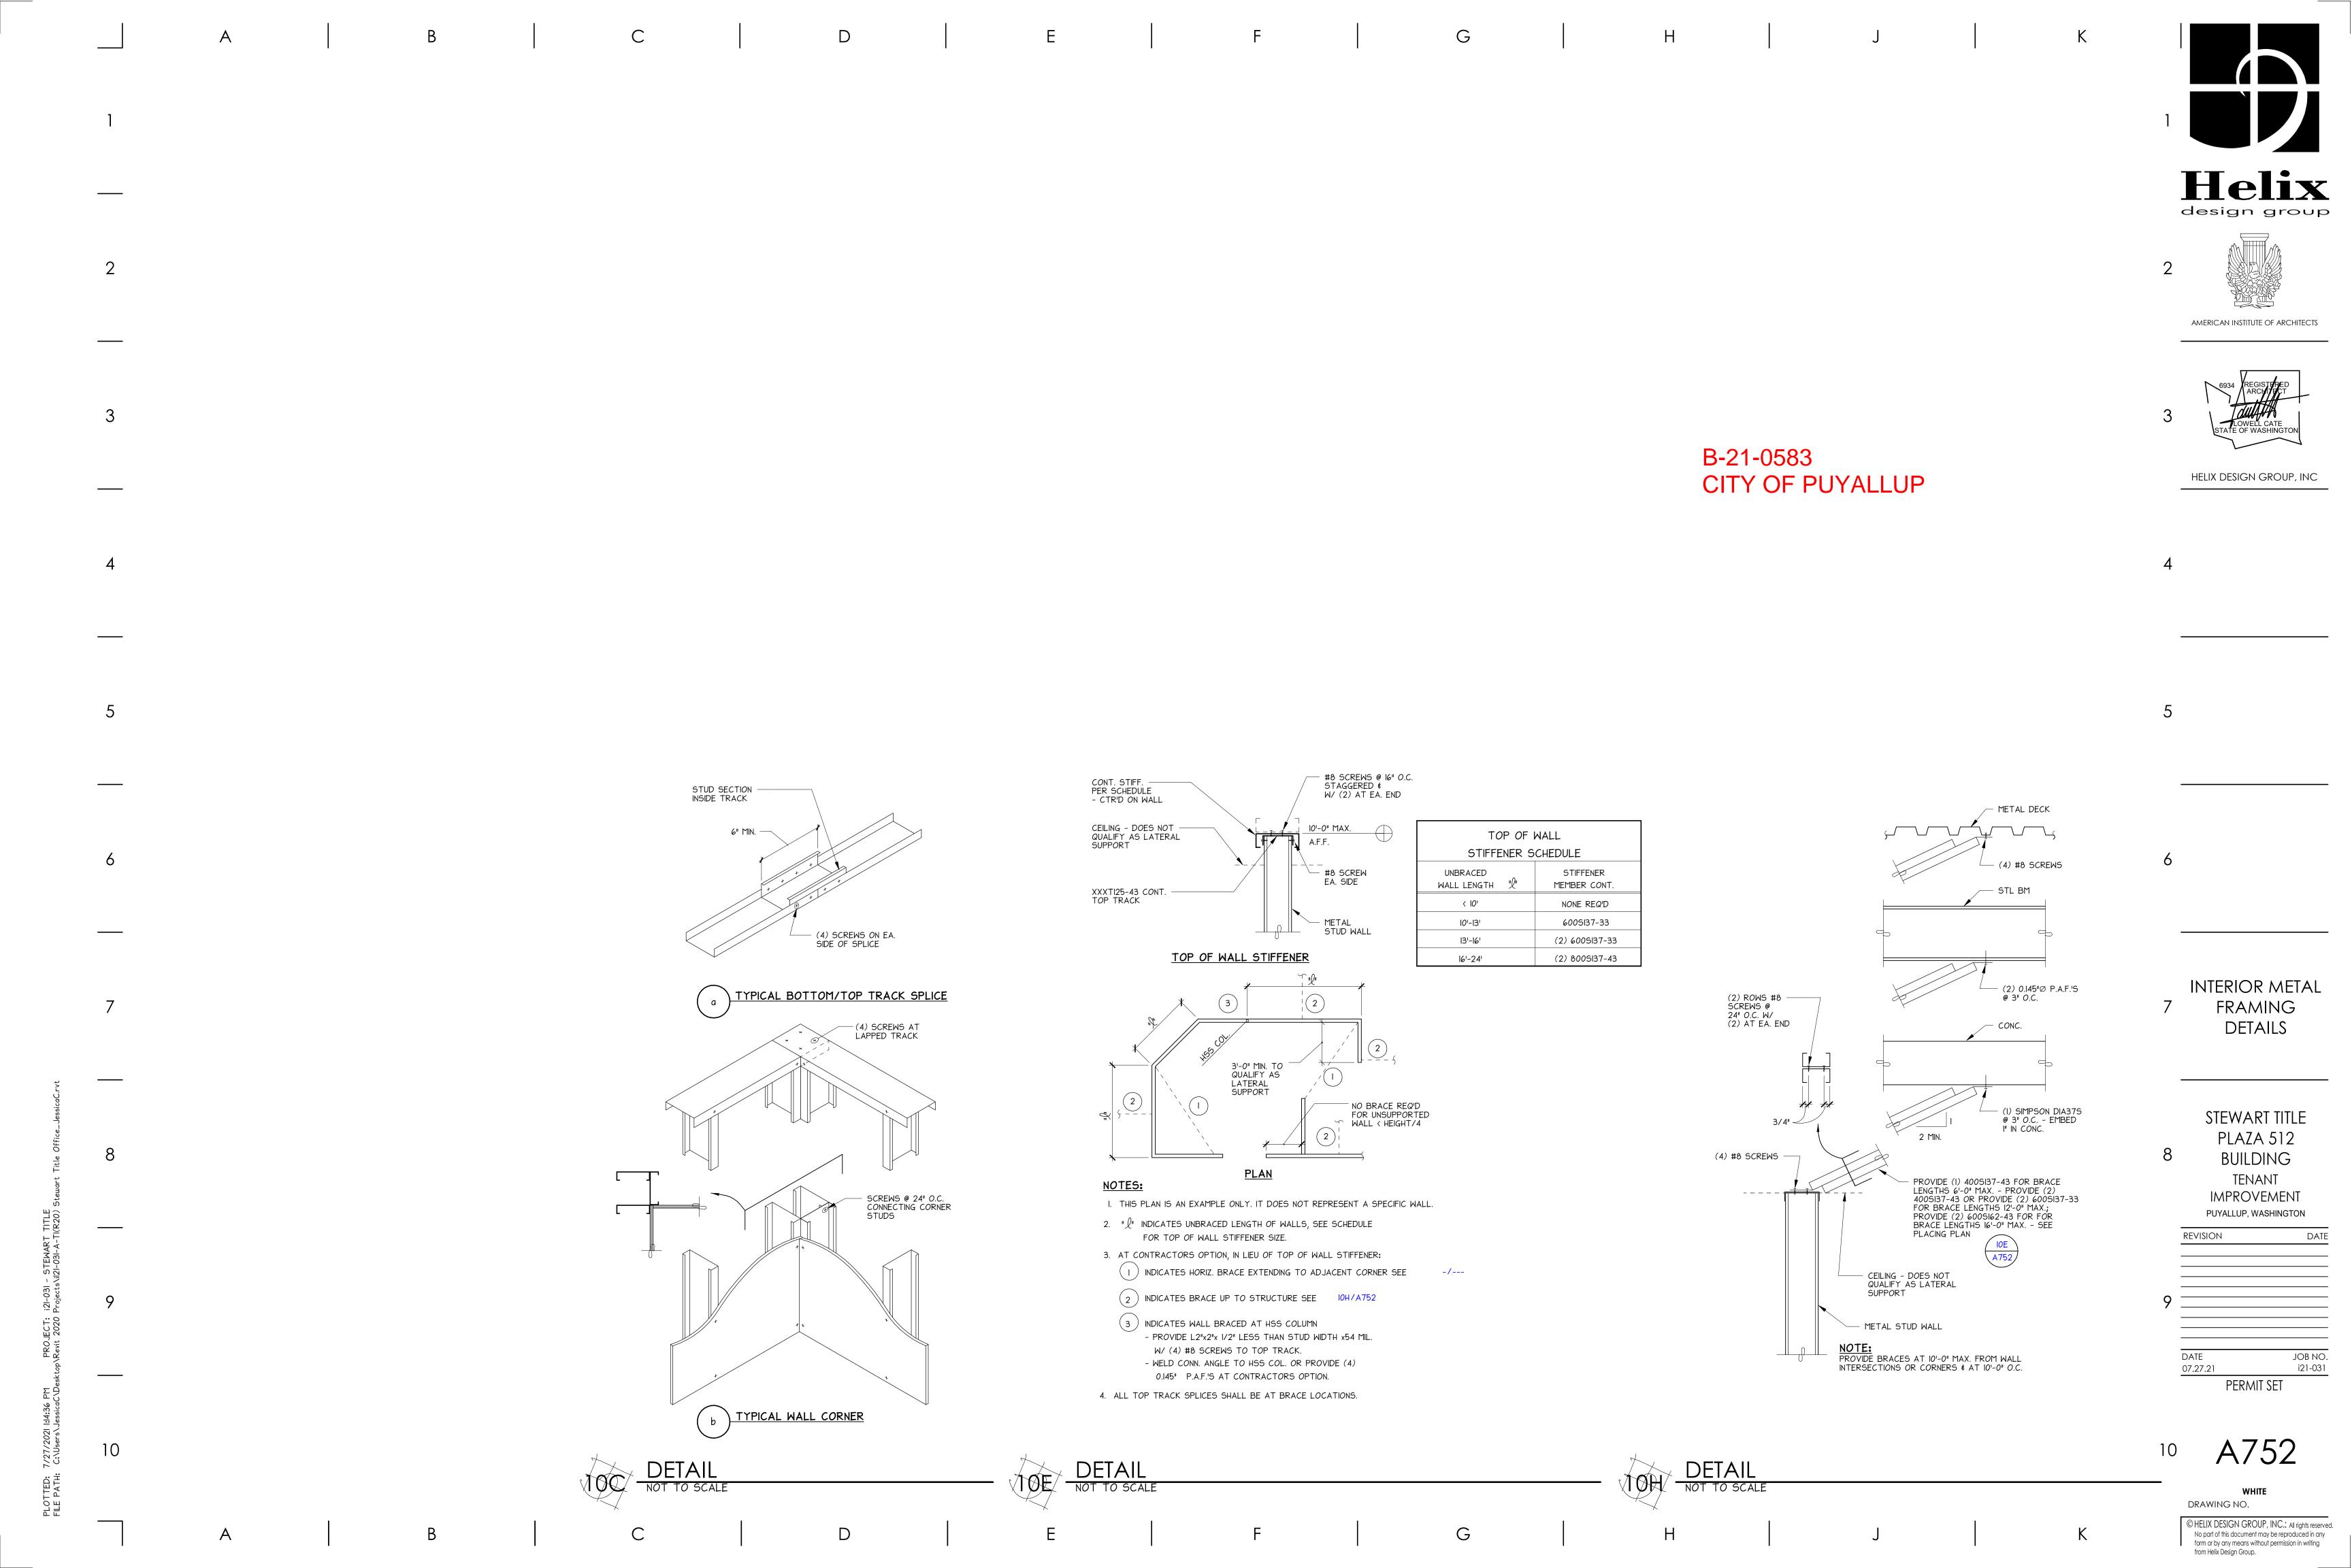Scale ۱/4"

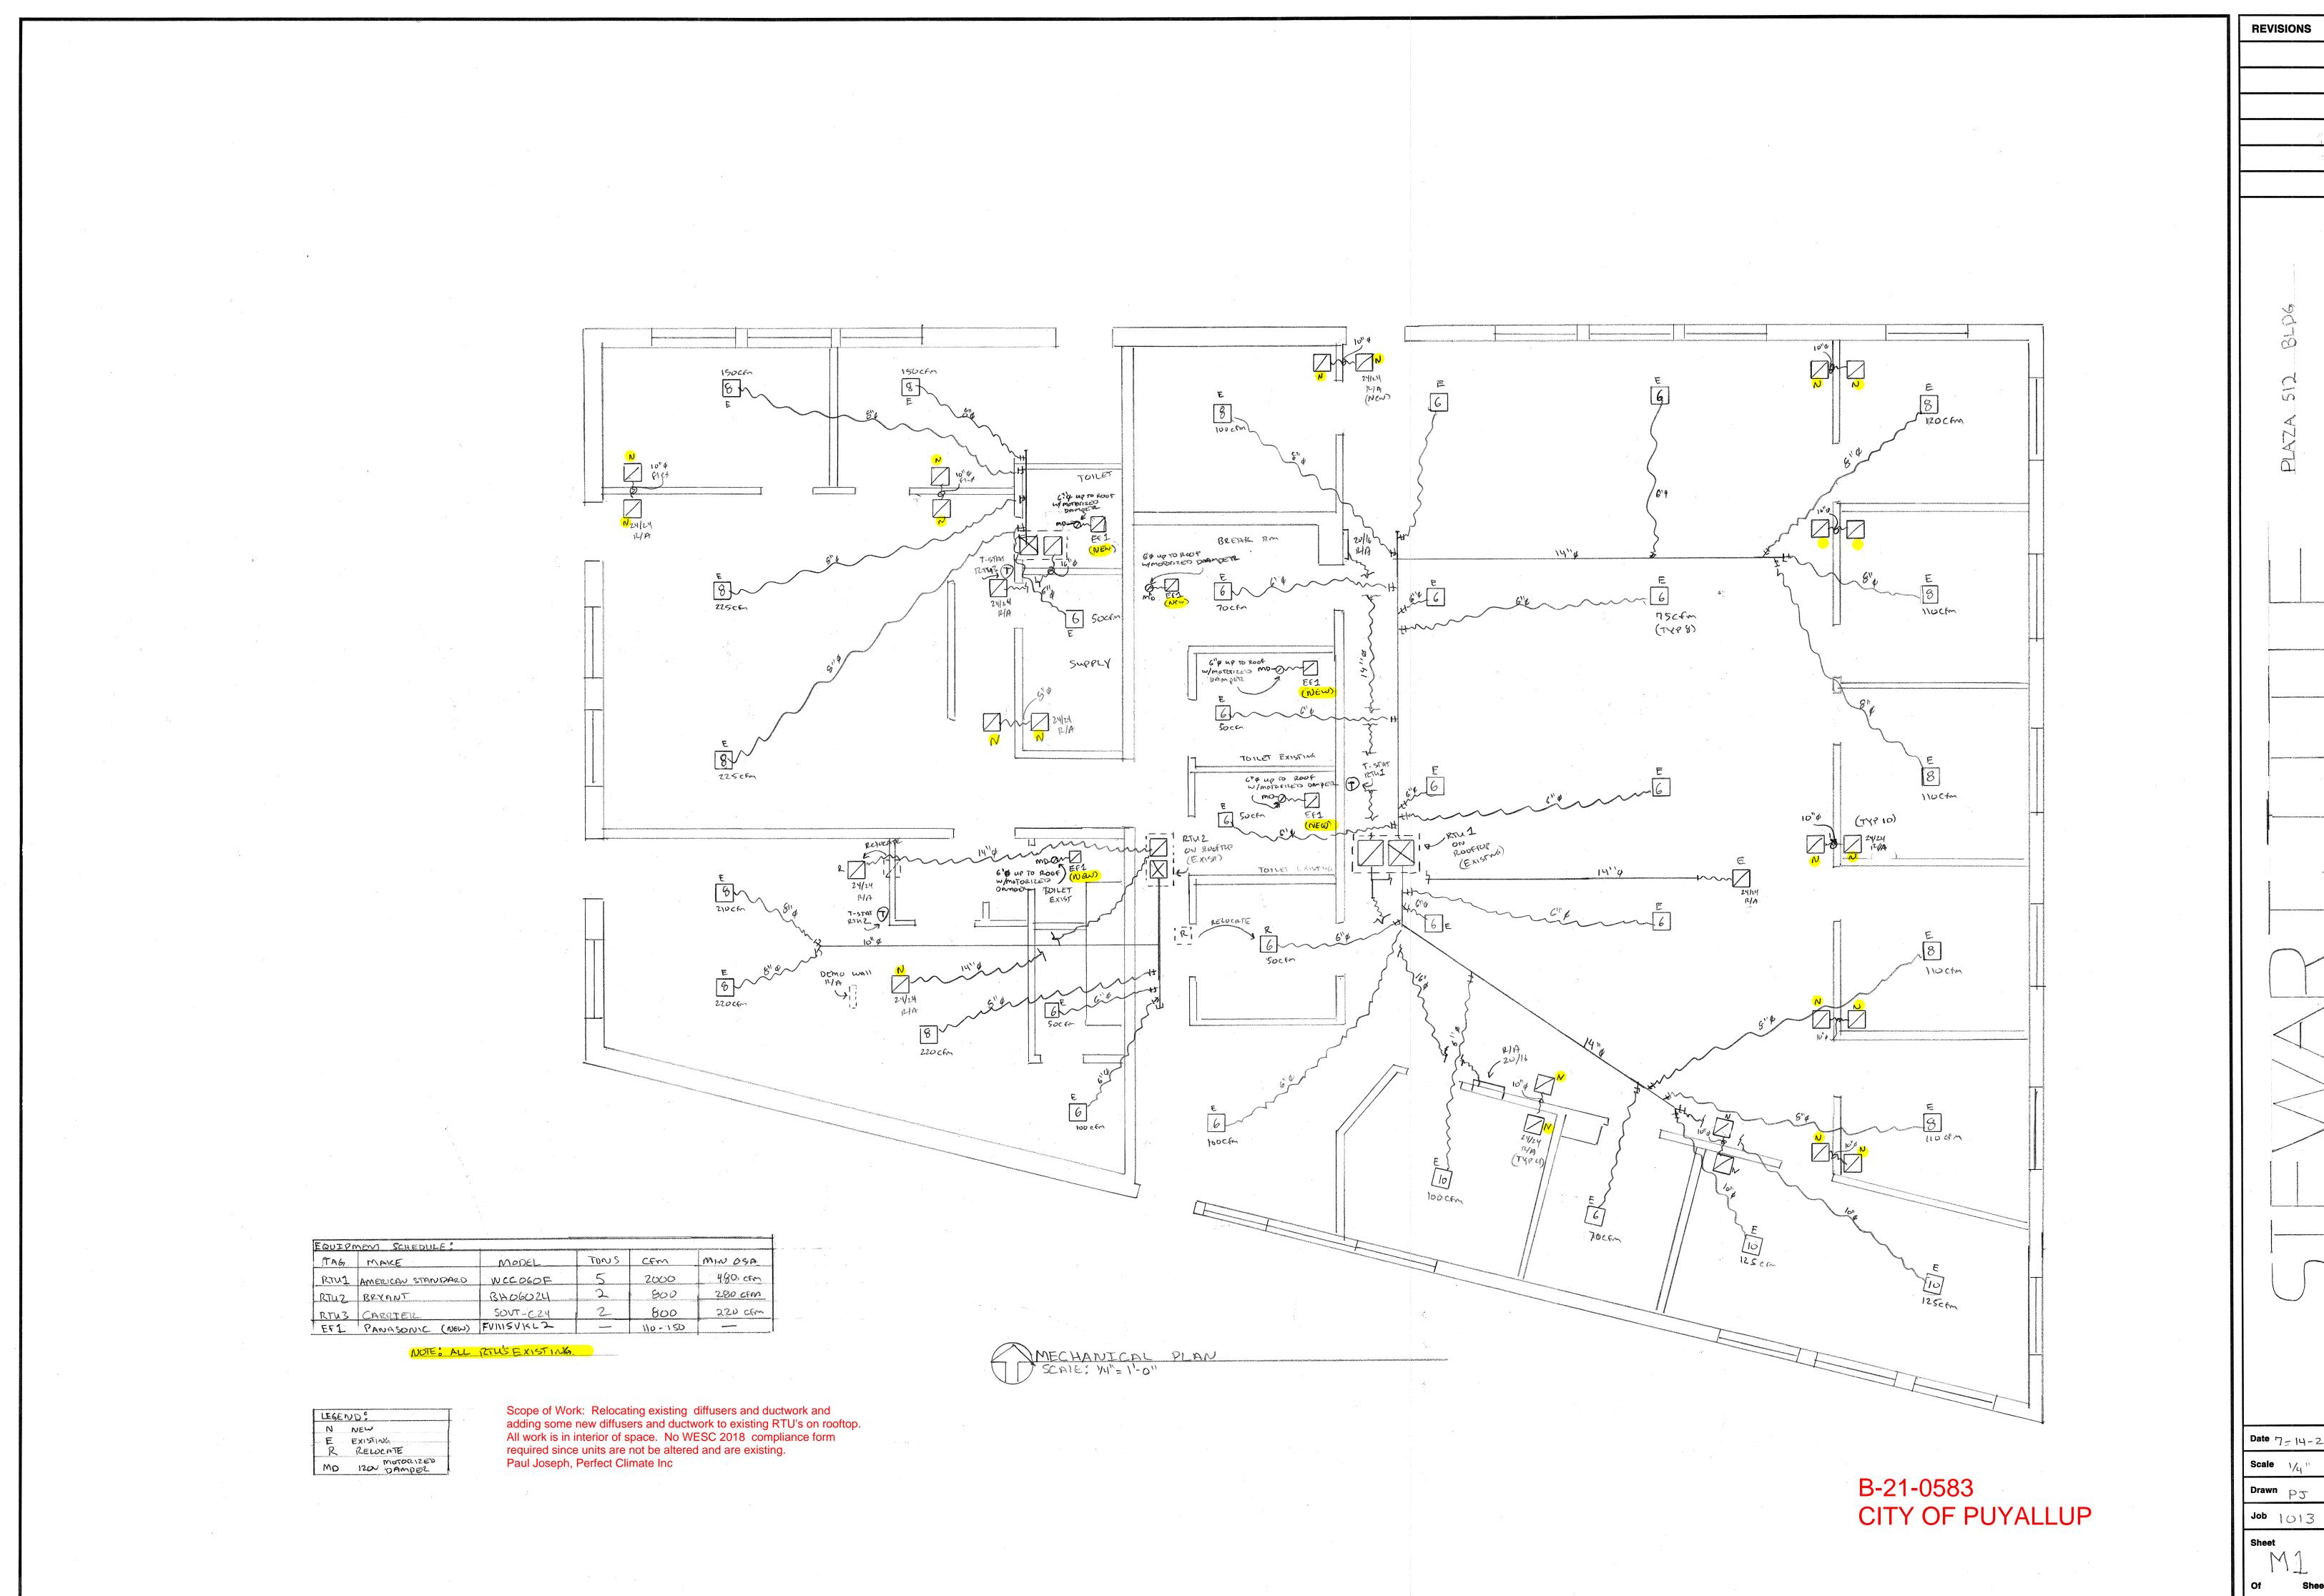Job 1013



PERMIT SET

STEWART TITLE 507 31ST AVE SW PUYALLUP, WA 9837.

RADIANT Plumbing & Heating, Inc

4516 S 8th St Tacoma, WA 98404 253-548-6723 License# RADIAPH874OF

Sheet

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Plumbing Plan

Permit Drawings Date: 6/22/2021