

Bradley Park Phase 2 - Brownstone East



WESLEY HOMES 707 39TH AVENUE SE, BLDG D PUYALLUP, WA 98374



I hereby certify that this document was prepared by me or under my direct supervision and that I am a duly licensed architect under the laws of the State of Washington

SEE BELOW

Signature

Dawn Wieczorek
Typed or Printed Name

11192 6/02/23
License # Date

11192
REGISTERED ARCHITECT

DAWN MARIE WIECZOREK
STATE OF WASHINGTON

WESLEY BRADLEY PARK
PH2 EAST BROWNSTONE
707 39TH AVENUE SE, BLDG D
PUYALLUP, WA 98374

PRMU20230881 - Rev #1: Energy Code, EV Location at Garage, and DAS System Location.

BUILDING PERMIT: PRMU20230881

CONSTRUCTION SET
SEPT. 23, 2024

PARCEL ID: 0419037014

REVISIONS

No.	Description	Date
1	BLDG PERMIT REV 1	3/4/24
4	AS1 2 - CHV PCR	6/17/25

2108
PROJECT NUMBER

Author _____
DRAWN BY _____

Checker _____
FOR COMPLIANCE

WESLEY BRADLEY PARK
PH2 EAST BROWNSTONE

TITLE SHEET

T1.1

PROJECT TEAM

Owner: Wesley Homes Bradley Park, LLC
707 39th Ave. SE
Puyallup, WA 98374

Owner's Developer: Senior Housing Partners
2823 Hamline Ave. N.
Roseville, MN 55113

Architect: InSite Architects
1000 University Ave. West, Suite 130
St. Paul, MN 55104
Ph: 612-252-4822

Contractor: Walsh Construction
315 5th Ave. S, Suite 600
Seattle, WA 98104
Ph: 206-547-4008

Civil/ Landscape: Barghausen
18215 72nd Avenue South
Kent, WA 98032
Ph: 425-251-6222
Fx: 425-251-8782

Structural Engineer: AHBL
2215 N. 30th Street
Tacoma, WA 98403
Ph: 253-383-2422

Mechanical, Electrical, Plumbing Engineers: Steen Engineering
5430 Douglas Drive North
Minneapolis, MN 55429-3106
Ph: 763-585-6742

Low Voltage Engineers/Designers: Collins Electrical Construction Co.
278 State Street
St. Paul, MN 55107
Ph: 651-224-2833

Parking Information

PROVIDED PARKING: - ALSO SEE SHEET A0.1 FOR PARKING CALCULATIONS

PROVIDED PARKING SCHEDULE		
Description	Count	Comments
ADA STALL	3	
COMPACT PARKING STALL	17	
ELECTRIC CAR STALL	4	
ELECTRIC CAR STALL - ADA	1	
ELECTRIC CAR STALL - COMPACT	1	
STANDARD STALL	45	
Total	71	
REQUIRED PARKING:		
67 UNITS @ 1 STALLS/UNIT = 67 STALLS		

UNIT MIX & SQUARE FOOTAGES

UNIT SCHEDULE - BROWNSTONE...		
UNIT TYPE	Unit Name	COUNT

LEVEL 1 - EAST		
DECATUR TYPE A	1 BD+	1
HERRON TYPE A	1 BD	1
LOPEZ	2 BD+	1
ORCAS	1 BD+LIB	1
VANCOUVER	2 BD++	2
VASHON	1 BD+	7
WHIDBEY	2 BD+	9
		22

LEVEL 2 - EAST		
CAMANO	1 BD+	1
DECATUR	1 BD+	1
FOX	1 BD+	1
LOPEZ	2 BD+	1
ORCAS	1 BD+LIB	1
VANCOUVER	2 BD++	2
VASHON	1 BD+	7
WHIDBEY	2 BD+	9
		23

LEVEL 3 - EAST		
DECATUR	1 BD+	1
FIDALGO TYPE A	2 BD	1
FOX	1 BD+	1
LOPEZ	2 BD+	1
LUMMI	1 BD+	1
ORCAS	1 BD+LIB	1
VANCOUVER	2 BD++	2
VASHON	1 BD+	7
WHIDBEY	2 BD+	7
		22
Grand total		67

Energy Code Compliance Summary

2018 WASHINGTON STATE ENERGY CODE RESIDENTIAL PROVISION per Chapter 51-11R WAC

TABLE 402.4.1 INSULATION & FENESTRATION VALUES:

Roof: R49 (ADVANCED FRAMING REQUIRED PER OPTION 1.7) - A

Exterior Walls: R21 int

Headers: R10

Floor (Underside of PT Deck): R30

Slab on Grade: R19 - 2" horizontally @ perimeter

Glazing U factor: .28 max (per option 1.7)

Multifamily R2 Dwelling unit: 4.5 credits required per Table 406.2:

• Heating option:

1. Heat Pump 1 credit

• Energy Options:

1. 1.7 Efficient Building Envelope .5 credit

2. 2.2 Air Leakage Control and Efficient Ventilation 1.5 credit

3. 4.1 High Efficiency HVAC Distribution .5 credit

4. 5.1 Efficient Water Heating .5 credit

5. 5.2 Efficient Water Heating .5 credit

SHEET INDEX

SHEET NUMBER	SHEET NAME	PERMIT 06/02/23	PERMIT RESPONSE 1	CONSTRUCTION SET 9.23.24
GENERAL INFORMATION				
T1.1	TITLE SHEET	•	•	•
CODE				
AC1.1	ARCHITECTURAL CODE SUMMARY AND CODE PLANS	•	•	•
AC1.2	ARCHITECTURAL CODE PLANS	•	•	•
AC1.3	ARCHITECTURAL CODE PLANS	•	•	•

CIVIL - FOR REFERENCE ONLY*				
C1	CIVIL COVER SHEET	•	•	•
C2	EXISTING SITE AND TESC PLAN NORTH	•	•	•
C3	EXISTING SITE AND TESC PLAN SOUTH	•	•	•
C4	CONSTRUCTION NOTES	•	•	•
C5	GRADING PLAN NORTH	•	•	•
C6	GRADING PLAN SOUTH	•	•	•
C7	GRADING PLAN - CARE CENTER SOUTH PARKING LOT	•	•	•
C8	GRADING PLAN - CARE CENTER ENTRANCE PAVING	•	•	•
C9	GRADING PLAN - BROWNSTONE NORTHEAST SIDEWALK	•	•	•
C10	DRAINAGE PLAN NORTH	•	•	•
C11	DRAINAGE PLAN SOUTH	•	•	•
C12	WATER AND SEWER PLAN NORTH	•	•	•
C13	WATER AND SEWER PLAN SOUTH	•	•	•
C14	CONSTRUCTION NOTES	•	•	•
C15	CONSTRUCTION NOTES AND DETAILS	•	•	•
C16	CONSTRUCTION NOTES AND DETAILS	•	•	•
C17	WATER DETAILS	•	•	•
C18	WATER DETAILS	•	•	•
C19	SEWER DETAILS	•	•	•

ARCHITECTURAL				
A0.1	ARCHITECTURAL SITE PLAN	•	•	•
A1.0	GARAGE LEVEL OVERALL PLANS	•	•	•
A1.0N	GARAGE LEVEL BROWNSTONE B - NORTH	•	•	•
A1.0S	GARAGE LEVEL BROWNSTONE B - SOUTH	•	•	•
A1.1	FIRST LEVEL OVERALL PLAN - BROWNSTONE B	•	•	•
A1.1N	FIRST LEVEL BROWNSTONE B PLAN - NORTH	•	•	•
A1.1S	FIRST LEVEL BROWNSTONE B PLAN - SOUTH	•	•	•
A1.2	SECOND LEVEL OVERALL FLOOR PLANS	•	•	•
A1.2N	SECOND LEVEL BROWNSTONE B PLAN - NORTH	•	•	•
A1.2S	SECOND LEVEL BROWNSTONE B PLAN - SOUTH	•	•	•
A1.3	THIRD LEVEL OVERALL FLOOR PLANS	•	•	•
A1.3N	THIRD LEVEL BROWNSTONE B PLAN - NORTH	•	•	•
A1.3S	THIRD LEVEL BROWNSTONE B PLAN - SOUTH	•	•	•
A1.4	ROOF PLANS & DETAILS	•	•	•
A2.1	ENLARGED UNIT PLANS	•	•	•
A2.2	ENLARGED UNIT PLANS	•	•	•
A2.3	ENLARGED UNIT PLANS	•	•	•
A2.4	ENLARGED UNIT PLANS - 3RD FLOOR	•	•	•
A2.5	PAVILION PLANS, ELEVATIONS & DETAILS	•	•	•
A3.1	EXTERIOR ELEVATIONS - BROWNSTONE EAST	•	•	•
A3.2	EXTERIOR ELEVATIONS - BROWNSTONE EAST	•	•	•
A3.3	EXTERIOR ELEVATIONS BROWNSTONE EAST	•	•	•
A4.1	BUILDING SECTIONS	•	•	•
A5.1	WALL SECTIONS	•	•	•
A5.2	WALL SECTIONS	•	•	•
A5.3	WALL SECTIONS	•	•	•
A5.4	WALL SECTIONS	•	•	•
A5.5	WALL SECTIONS	•	•	•
A5.6	WALL SECTIONS	•	•	•
A6.1	EXTERIOR DETAILS	•	•	•
A6.2	EXTERIOR DETAILS	•	•	•
A6.3	EXTERIOR DETAILS	•	•	•
A6.4	EXTERIOR DETAILS	•	•	•
A6.5	EXTERIOR DETAILS	•	•	•
A6.6	EXTERIOR DETAILS	•	•	•
A6.7	EXTERIOR DETAILS	•	•	•
A6.8	EXTERIOR DETAILS	•	•	•
A7.1	ELEVATOR PLANS & SECTIONS & TYP DETAILS	•	•	•
A7.2	LOBBY STAIR PLANS & SECTIONS & TYP DETAILS	•	•	•
A7.3	STAIR A PLANS & SECTIONS	•	•	•
A7.4	SOUTH STAIR PLANS & SECTIONS	•	•	•
A7.5	STAIR B PLANS & SECTIONS	•	•	•
A8.1	REFLECTED CEILING PLANS - LEVELS 0 & 1	•	•	•
A8.2	REFLECTED CEILING PLANS - LEVEL 2	•	•	•
A8.3	REFLECTED CEILING PLANS - LEVEL 3	•	•	•
A8.4	REFLECTED CEILING PLANS - UNITS	•	•	•
A8.5	REFLECTED CEILING PLANS - UNITS	•	•	•
A8.6	REFLECTED CEILING PLANS - UNITS	•	•	•
A8.7	REFLECTED CEILING PLANS - GAME ROOM & CLUB ROOM	•	•	•
A8.1	INTERIOR ELEVATIONS - MOUNTING HEIGHTS & UNITS	•	•	•
A8.2	INTERIOR ELEVATIONS - UNITS	•	•	•
A9.3	INTERIOR ELEVATIONS - COMMON AREAS	•	•	•
A9.4	INTERIOR ELEVATIONS - COMMON AREAS	•	•	•
A10.1	WALL TYPES	•	•	•
A10.2	INTERIOR DETAILS	•	•	•

*FULL CIVIL DRAWINGS TO BE ISSUED UNDER SEPARATE COVER

SHEET NUMBER	SHEET NAME	PERMIT 06/02/23	PERMIT RESPONSE 1	CONSTRUCTION SET 9.23.24
INTERIOR DETAILS				
A10.3	INTERIOR DETAILS	•	•	•
A10.4	INTERIOR DETAILS	•	•	•
A10.5	PENETRATION FIRESTOPPING DETAILS	•	•	•
A11.1	DOOR & WINDOW & ROOM FINISH SCHEDULES AND TYPES	•	•	•

INTERIORS				
ID0.1	SCHEDULES AND MATERIALS	•	•	•
ID1.0N	FINISH FLOOR PLAN	•	•	•
ID1.0S	FINISH FLOOR PLAN	•	•	•
ID1.1N	FINISH FLOOR PLAN	•	•	•
ID1.1S	FINISH FLOOR PLAN	•	•	•
ID1.2N	FINISH FLOOR PLAN	•	•	•
ID1.2S	FINISH FLOOR PLAN	•	•	•
ID1.3N	FINISH FLOOR PLAN	•	•	•
ID1.3S	FINISH FLOOR PLAN	•	•	•
ID2.1	INTERIOR ELEVATIONS	•	•	•

STRUCTURAL				
S0.1-B	STRUCTURAL NOTES	•	•	•
S0.2-B	STRUCTURAL NOTES	•	•	•
S0.3-B	QUALITY ASSURANCE NOTES	•	•	•
S0.4-B	QUALITY ASSURANCE NOTES	•	•	•
S0.5-B	CONCRETE SCHEDULES	•	•	•
S0.6-B	WOOD SCHEDULES	•	•	•
S0.7-B	WOOD SCHEDULES	•	•	•
S0.8-B	TYPICAL DETAILS	•	•	•
S0.9-B	FRAMING NOTES	•	•	•
S1.0-BN	LEVEL 0 FOUNDATION PLAN - NORTH	•	•	•
S1.0-BS	LEVEL 0 FOUNDATION PLAN - SOUTH	•	•	•
S1.1-BN	LEVEL 1 FRAMING PLAN - NORTH	•	•	•
S1.1-BNM	LEVEL 1 MILD STEEL PLAN - NORTH	•	•	•
S1.1-BNP	LEVEL 1 POST-TENSIONING PLAN - NORTH	•	•	•
S1.1-BS	LEVEL 1 FRAMING PLAN - SOUTH	•	•	•
S1.1-BSM	LEVEL 1 MILD STEEL PLAN - SOUTH	•	•	•
S1.1-BSP	LEVEL 1 POST-TENSIONING PLAN - SOUTH	•	•	•
S1.2-BN	LEVEL 2 FRAMING PLAN - NORTH	•	•	•
S1.2-BS	LEVEL 2 FRAMING PLAN - SOUTH	•	•	•
S1.3-BN	LEVEL 3 FRAMING PLAN - NORTH	•	•	•
S1.3-BS	LEVEL 3 FRAMING PLAN - SOUTH	•	•	•
S1.4-BN	ROOF FRAMING PLAN - NORTH	•	•	•
S1.4-BS	ROOF FRAMING PLAN - SOUTH	•	•	•
S1.5-B	LEVEL 2 DIAPHRAGM PLAN	•	•	•
S1.6-B	LEVEL 3 DIAPHRAGM PLAN	•	•	•
S1.7-B	ROOF DIAPHRAGM PLAN	•	•	•
S2.1-B	FOUNDATION DETAILS	•	•	•
S2.2-B	FOUNDATION DETAILS	•	•	•
S2.3-B	FOUNDATION DETAILS	•	•	•
S2.4-B	FOUNDATION DETAILS	•	•	•
S2.5-B	FOUNDATION DETAILS	•	•	•
S2.6-B	FOUNDATION DETAILS	•	•	•
S3.1-B	CONCRETE FLOOR DETAILS	•	•	•
S3.2-B	CONCRETE FLOOR DETAILS	•	•	•
S4.1-B	POST-TENSIONED SLAB DETAILS	•	•	•
S4.2-B	POST-TENSIONED SLAB DETAILS	•	•	•
S5.1-B	CMU WALL DETAILS	•	•	•
S6.1-B	FLOOR FRAMING DETAILS	•	•	•
S6.2-B	FLOOR FRAMING DETAILS	•	•	•
S6.3-B	FLOOR FRAMING DETAILS	•	•	•
S6.4-B	FLOOR FRAMING DETAILS	•	•	•
S6.5-B	FLOOR FRAMING DETAILS	•	•	•
S7.1-B	ROOF FRAMING DETAILS	•	•	•
S7.2-B	ROOF FRAMING DETAILS	•	•	•
S7.3-B	ROOF FRAMING DETAILS	•	•	•
S7.4-B	ROOF FRAMING DETAILS	•	•	•
S7.5-B	ROOF FRAMING DETAILS	•	•	•
S7.6-B	ROOF FRAMING DETAILS	•	•	•

2018 WSEC Energy Credit 1.7:

Advanced framing and raised heel trusses or rafters.

Vertical Glazing U-0.28


R-49 Advanced (U-0.020) as listed in Section A102.2.1, Ceilings below a vented attic AND R-49 vaulted ceilings with full height of uncompressed insulation extending over the wall top plates at the eaves.

2018 WSEC Energy Credit 2.2:
Compliance based on Section R402.4.1.2: Reduce the tested air leakage to 2.0 air changes per hour maximum at 50 Pascals OR
For R-2 Occupancies, optional compliance based on Section R402.4.1.2: Reduce the tested air leakage to 0.25 cfm/sf maximum at 50 Pascals AND
All whole house ventilation requirements as determined by Section M1507.3 of the International Residential Code or Section 403.8 of the International Mechanical Code shall be met with a heat recovery ventilation system with minimum sensible heat recovery efficiency of 0.65.


The approved construction plans, documents, and all engineering must be posted on the job at all inspections in a visible and readily accessible location.

Full sized legible color plans are required to be provided by the permittee on site for inspection.

Approval of submitted plans is not an approval of omissions or oversights by this office or non compliance with any applicable regulations of local government. The contractor is responsible for making sure that the building complies with all applicable codes and regulations of the local government.

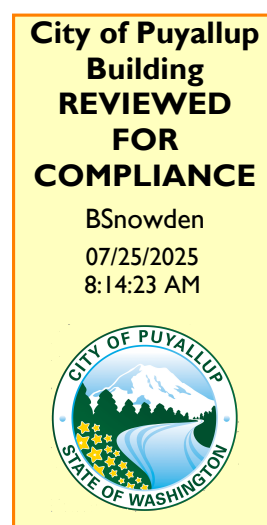

7/23/2025 3:11:25 PM

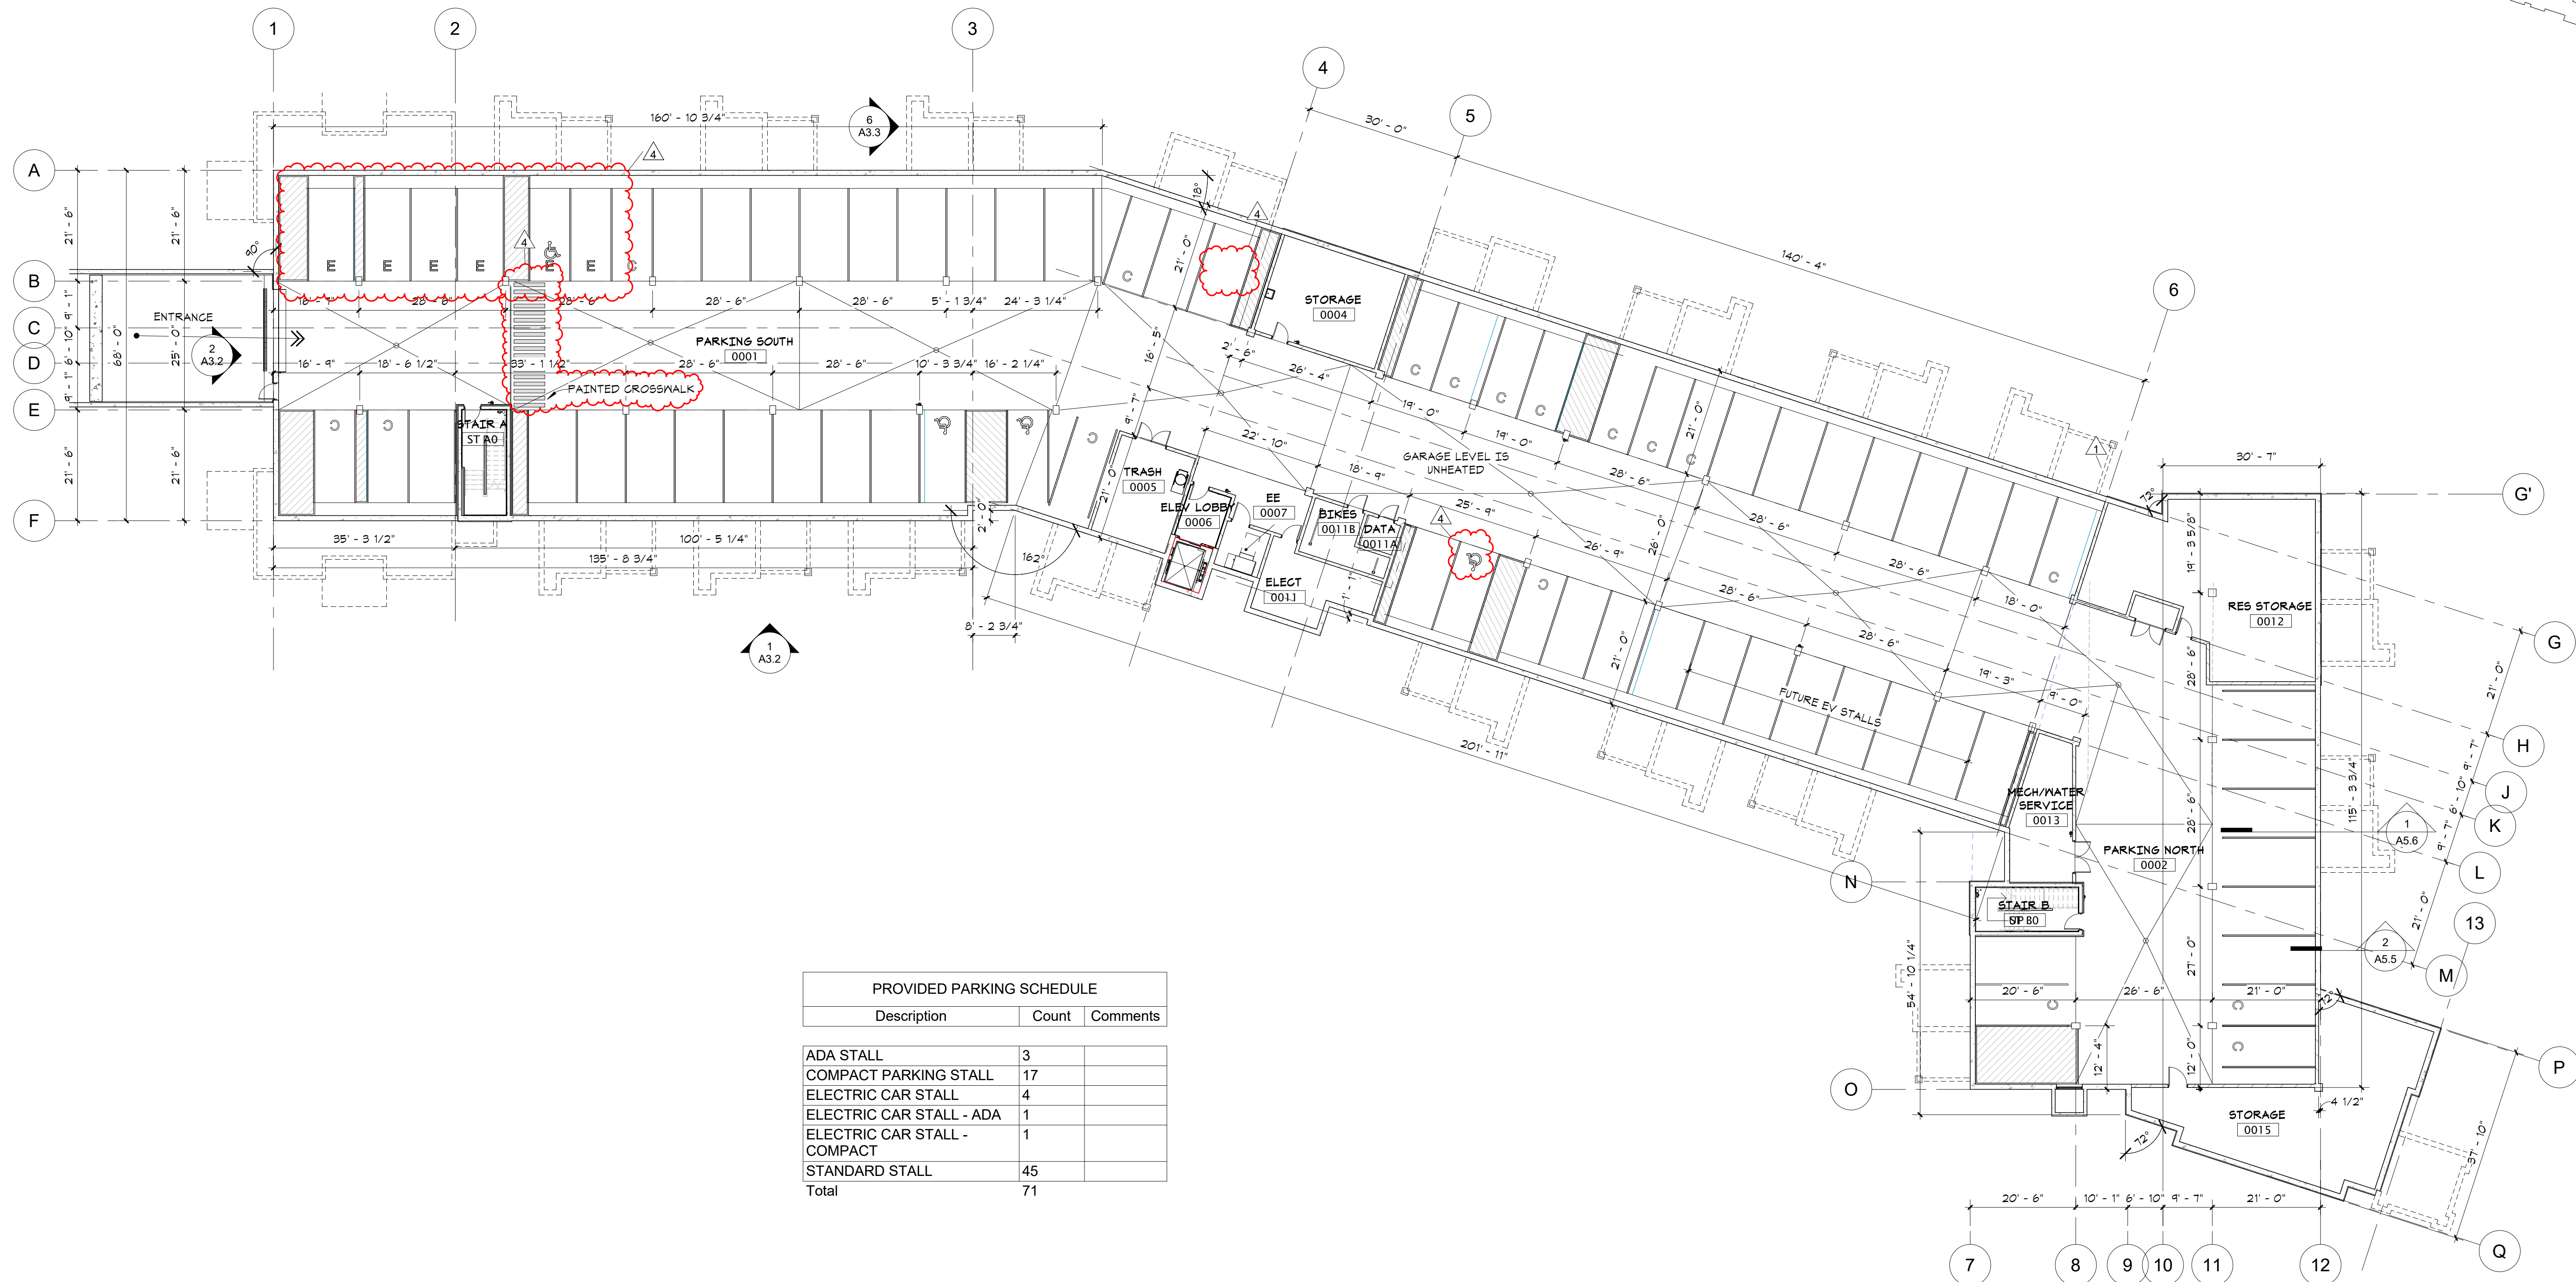

PROVIDED PARKING SCHEDULE		
Description	Count	Comments
ADA STALL	3	
COMPACT PARKING STALL	17	
ELECTRIC CAR STALL	4	
ELECTRIC CAR STALL - ADA	1	
ELECTRIC CAR STALL - COMPACT	1	
STANDARD STALL	45	
Total	71	

1 LEVEL 0 - OVERALL BSTONE EAST
A1.0 1/16" = 1'-0"

GENERAL PLAN NOTES

1. TYPICAL INTERIOR DIMENSIONS FOR SINGLE STUD WALLS ARE TO FACE OF STUD. FOR MULTIPLE STUD WALLS DIMENSIONS ARE TO FACE OF STUD ON SHEAR SIDE. FURRING DIMENSIONS ARE TO FACE OF STUD, AND MASONRY DIMENSIONS ARE TO FACE OF WALL.
2. EXTERIOR DIMENSIONS ARE TO OUTSIDE FACE OF CMU FOUNDATION & SHEATHING AND TO CENTERLINE OF WINDOWS.
3. PROVIDE ACCESS PANELS WHEREVER REQUIRED FOR ACCESS TO MECHANICAL AND/OR ELECTRICAL ITEMS. VERIFY WITH MECHANICAL AND ELECTRICAL. AND COORDINATE EXACT LOCATION WITH ARCHITECT IF LOCATED IN FINISHED SPACES.
4. PRIME AND PAINT ALL EXPOSED EXTERIOR METALS, ETC. WHICH ARE NOT PREFINISHED. SUCH AS, BUT NOT LIMITED TO: STEEL LINTELS, BOLLARDS, ETC.
5. ALL STRUCTURAL STEEL TO BE (1) HOUR FIRE RATED. SEE STRUCTURAL PLANS FOR LOCATIONS AND QUANTITY OF STEEL BEAMS AND COLUMNS.
6. SEE SHEET A10.1 FOR WALL TYPES.
7. SEE A10 SERIES SHEETS FOR TYPICAL INTERIOR DETAILS.
8. PAINT ALL ITEMS PENETRATING THE SLOPED ROOF TO MATCH ROOFING SUCH AS BUT NOT LIMITED TO VENT PIPES, FAN COVERS, ETC.
9. PROVIDE AN AUTOMATIC DRY SPRINKLER SYSTEM IN THE ATTIC INSTEAD OF DRAFTSTOPPING SEE AC1.1 CODE REVIEW.
10. SEE SHEETS A2 SERIES SHEETS FOR ENLARGED UNIT PLANS AND FLOOR PLANS.
11. AT RESIDENTIAL FLOORS, PROVIDE HANDRAIL ON ONE SIDE OF CORRIDOR. PROVIDE BLOCKING FOR FUTURE RAILING AT OPPOSITE SIDE.
12. SEE INTERIOR DESIGNER'S FINISH SCHEDULE FOR LOCATION OF PICTURE & CHAIR RAILS AND ALL INTERIOR FINISHES.
13. FOR TYPICAL AIR BARRIER INSTALLATION SEE 1 / A6.2
14. SEE SHEET A10.5 FOR TYPICAL FIRESTOPPING PENETRATION DETAILS.
15. ALL QUARTZ OR SOLID SURFACE COUNTERS SHALL HAVE UNDERMOUNT SINKS.



in.site
architects

1000 university ave. w. # suite 130
st. paul, minnesota 55104
612-552-4820

I hereby certify that this document was prepared by me or under my direct supervision and that I am a duly licensed architect under the laws of the State of Washington

SEE BELOW

Signature

Dawn Wieczorek

Typed or Printed Name

11192

License #

6/02/23

Date

11182

REGISTERED

ARCHITECT

Dawn Marie Wieczorek

STATE OF WASHINGTON

WESLEY BRADLEY PARK
PH2 EAST BROWNSTONE
707 39TH AVENUE SE, BLDG D
PUYALLUP, WA 98374

PRMU20230881 - Rev #1: Energy Code, EV Location at Garage, and DAS System Location.


BUILDING PERMIT: PRMU20230881

CONSTRUCTION
SET
SEPT. 23, 2024

PARCEL ID: 0419037014

REVISIONS

No.	Description	Date
1	BLDG PERMIT REV 1	3/4/24
4	ASI 2 - CHV PCR	6/17/25

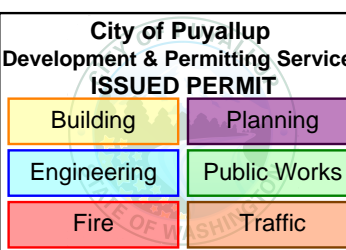

2108

PROJECT NUMBER

Author

DRAWN BY

Checker

CHECKED BY

WESLEY BRADLEY PARK
PH2 EAST BROWNSTONE




GARAGE LEVEL OVERALL
PLANS

A1.0

0-DOOR SCHEDULE - GARAGE LEVEL																			
REV	Door Number	To Room Name	DOOR						FRAME			HDW R	GLASS		Auto-OP	Card Rdr	Mag Hold	Comments	
			Width	HT	THK	TYPE	MATL	FIN	Type	MATL	FIN		Door	Sidelite					
LEVEL 0																			
	0001	PARKING SOUTH	3'-0"	7'-0"	1 3/4"	F	HM	PT	F1A	HM	PT	634X							WEATHERSTRIPPING; WELDED FLANGE
	0001A		16'-0"	8'-2"	0"														COILING SECURITY GATE
1	0004	STORAGE	3'-0"	7'-0"	1 3/4"	F	HM	PT	F1A	HM	PT	034X03							WEATHERSTRIPPING
	0005	TRASH	6'-0"	7'-0"	1 3/4"	F	HM	PT	F1A	HM	PT	044B05 90							
	0006	ELEV LOBBY	3'-0"	7'-0"	1 3/4"	NL	HM	PT	F1A	HM	PT	634X02 S	IT						
1	0007	EE	3'-6"	7'-0"	1 3/4"	F	HM	PT	F1A	HM	PT	034B 90							
	0011	ELECT	3'-0"	7'-0"	1 3/4"	F	HM	PT	F1A	HM	PT	054A 60							
	0011A	DATA	3'-0"	7'-0"	1 3/4"	F	HM	PT	F1A	HM	PT	034							
1	0011B	BIKES	3'-0"	7'-0"	1 3/4"	F	HM	PT	F1A	HM	PT	030D							
	0012	RES STORAGE	3'-0"	7'-0"	1 3/4"	F	HM	PT	F1A	HM	PT	030D							
	0014	MED/WATER SERVICE	6'-0"	7'-0"	1 3/4"	F	HM	PT	F1A	HM	PT	044B05							
ASI-2	0013A	DAS	6'-0"	7'-0"	1 3/4"	F	HM	PT	F1A	HM	PT	044B05 90							
	0015	STORAGE	3'-6"	7'-0"	1 3/4"	F	HM	PT	F1A	HM	PT	030D							
	ST-A0	STAIR A	3'-0"	7'-0"	1 3/4"	F	HM	PT	F1A	HM	PT	030A01 180							WEATHERSTRIPPING
	ST-B0	STAIR B	3'-0"	7'-0"	1 3/4"	F	HM	PT	F1A	HM	PT	030A01 180							WEATHERSTRIPPING

DOOR AND WINDOW NOTES															
1. FIRE RATING LABELS ARE SHOWN IN MINUTES UNO.															
2. UNDERCUT AT ALL INTERIOR DOORS UNO.															
3. DOOR HARDWARE TO BE CENTERED ON RAIL OF PANEL DOORS.															
4. SEE A11.1 FOR DOOR TYPES															
5. REFER TO ELEVATIONS AND PLANS FOR WINDOWS LOCATIONS REQUIRING SAFETY GLAZING TO MEET IBC 2406. WINDOWS WITH 'T' INCLUDED IN TAG INDICATES SAFETY GLAZING IS REQ'D.															
6. ALL DRYWALL "DW" FRAMED OPENINGS ARE TIMELY FRAMES WITH WD TRIM. VERIFY FINISH OF FRAME AND TRIM WITH ID.															
GLAZING TYPES															
IN 1" INSULATED NON-TEMPERED															
IT 1" INSULATED TEMPERED															
P 1/4" PLATE GLASS															
T 1/4" TEMPERED															
F 1/4" FROSTED GLASS															
W 1/4" WIRED GLASS															
DOOR AND WINDOW ABBREVIATIONS															
ALUM	ALUMINUM	NL	NARROW LITE	OC	OVERHEAD COILING	PLAM	PLASTIC LAMINATE	PREFIN	PRE-FINISHED	RAISED	RAISED PANEL	SCHB	SOLID CORE HARDBOARD	SCR	SCREEN
AP	FLUSH W/ APPLIED MLDG	OH	OVERHEAD SEGMENTAL	CA	CASEMENT WINDOW	PLAM	PLASTIC LAMINATE	PT	PAINT	SCW	SOLID CORE WOOD	SH	SINGLE HUNG WINDOW	SL	SLIDING/GLIDING WINDOW
CL	CHAIN LINK	RP	RAISED PANEL	DW	DRYWALL (SEE NOTES ABOVE)	SCW	SOLID CORE WOOD	ST	STAIN	STL	STEEL	TR	TRAFFIC DOOR (SOLID CORE)	WD	WOOD
F	FLUSH	RP	RAISED PANEL	FG	FULL GLASS	SCR	SOLID CORE WOOD	ST	STAIN	STL	STEEL	TR	TRAFFIC DOOR (SOLID CORE)	WD	WOOD
FRP	FIBERGLASS REINFORCED PLASTIC	SCHB	SOLID CORE HARDBOARD	FX	FIXED WINDOW	SCR	SOLID CORE WOOD	SH	SINGLE HUNG WINDOW	SL	SLIDING/GLIDING WINDOW	ST	STEEL	TR	TRAFFIC DOOR (SOLID CORE)
HCHB	HOLLOW CORE HARDBOARD	SCW	SOLID CORE WOOD	HCHW	HOLLOW CORE WOOD	SH	SINGLE HUNG WINDOW	SL	SLIDING/GLIDING WINDOW	ST	STEEL	TR	TRAFFIC DOOR (SOLID CORE)	WD	WOOD
HM	HOLLOW METAL	ST	STAIN	HMD	HOLLOW METAL KNOCKED DOWN	STL	STEEL	TR	TRAFFIC DOOR (SOLID CORE)	WD	WOOD				
IF	INSULATED FIBERGLASS	CLWD	CLAD WOOD	IM	INSULATED METAL	WD	WOOD								
MCWV	MINERAL CORE WD VENEER														

GENERAL PLAN NOTES															
1. TYPICAL INTERIOR DIMENSIONS FOR SINGLE STUD WALLS ARE TO FACE OF STUD. FOR MULTIPLE STUD WALLS DIMENSIONS ARE TO FACE OF STUD ON SHEAR SIDE. FURRING DIMENSIONS ARE TO FACE OF STUD, AND MASONRY DIMENSIONS ARE TO FACE OF WALL.															
2. EXTERIOR DIMENSIONS ARE TO OUTSIDE FACE OF CMU FOUNDATION & SHEATHING AND TO CENTERLINE OF WINDOWS.															
3. PROVIDE ACCESS PANELS WHEREVER REQUIRED FOR ACCESS TO MECHANICAL AND/OR ELECTRICAL ITEMS. VERIFY WITH MECHANICAL AND ELECTRICAL, AND COORDINATE EXACT LOCATION WITH ARCHITECT IF LOCATED IN FINISHED SPACES.															
4. PRIME AND PAINT ALL EXPOSED EXTERIOR METALS, ETC. WHICH ARE NOT PREFINISHED, SUCH AS, BUT NOT LIMITED TO: STEEL LINTELS, BOLLARDS, ETC.															
5. ALL STRUCTURAL STEEL TO BE (1) HOUR FIRE RATED. SEE STRUCTURAL PLANS FOR LOCATIONS AND QUANTITY OF STEEL BEAMS AND COLUMNS.															
6. SEE SHEET A10.1 FOR WALL TYPES.															
7. SEE A10 SERIES SHEETS FOR TYPICAL INTERIOR DETAILS.															
8. PAINT ALL ITEMS PENETRATING THE SLOPED ROOF TO MATCH ROOFING SUCH AS BUT NOT LIMITED TO VENT PIPES, FAN COVERS, ETC.															
9. PROVIDE AN AUTOMATIC DRY SPRINKLER SYSTEM IN THE ATTIC INSTEAD OF DRAFTSTOPPING SEE AC1.1 CODE REVIEW.															
10. SEE SHEETS A2 SERIES SHEETS FOR ENLARGED UNIT PLANS AND FLOOR PLANS.															
11. AT RESIDENTIAL FLOORS, PROVIDE HANDRAIL ON ONE SIDE OF CORRIDOR. PROVIDE BLOCKING FOR FUTURE RAILING AT OPPOSITE SIDE.															
12. SEE INTERIOR DESIGNER'S FINISH SCHEDULE FOR LOCATION OF PICTURE & CHAIR RAILS AND ALL INTERIOR FINISHES.															
13. FOR TYPICAL AIR BARRIER INSTALLATION SEE 1 / A8.2															
14. SEE SHEET A10.5 FOR TYPICAL FIRESTOPPING PENETRATION DETAILS.															
15. ALL QUARTZ OR SOLID SURFACE COUNTERS SHALL HAVE UNDERMOUNT SINKS.															

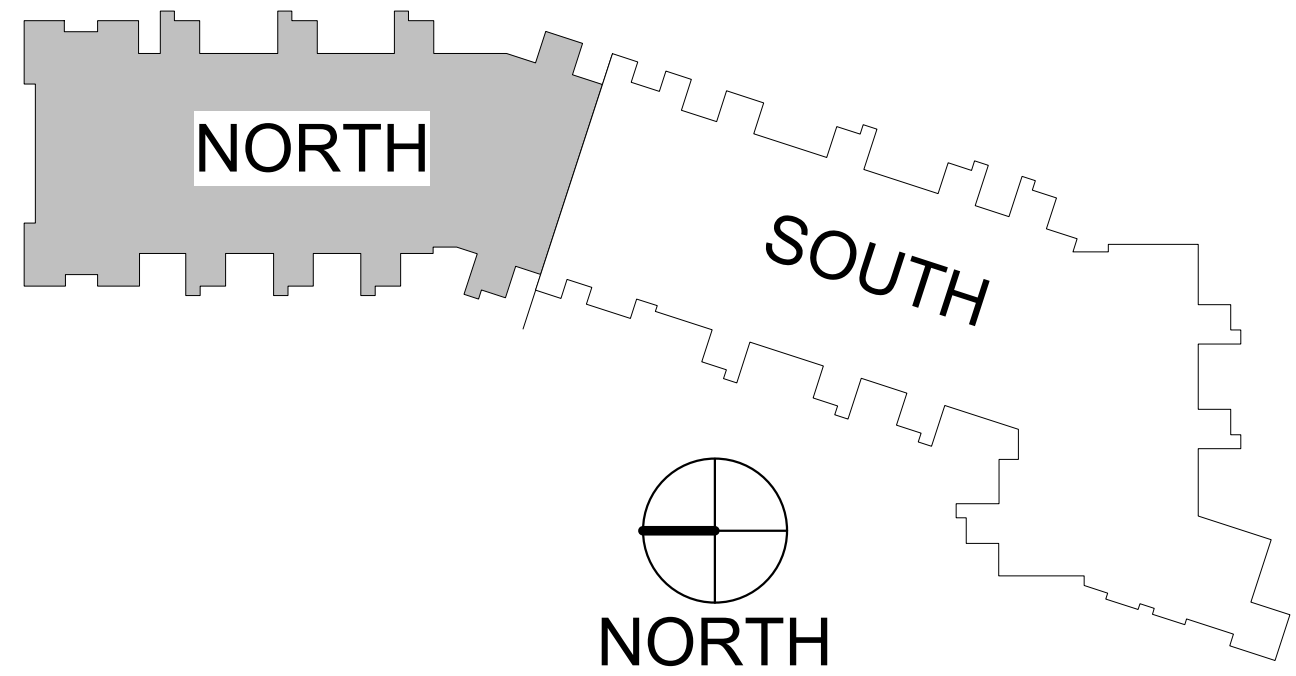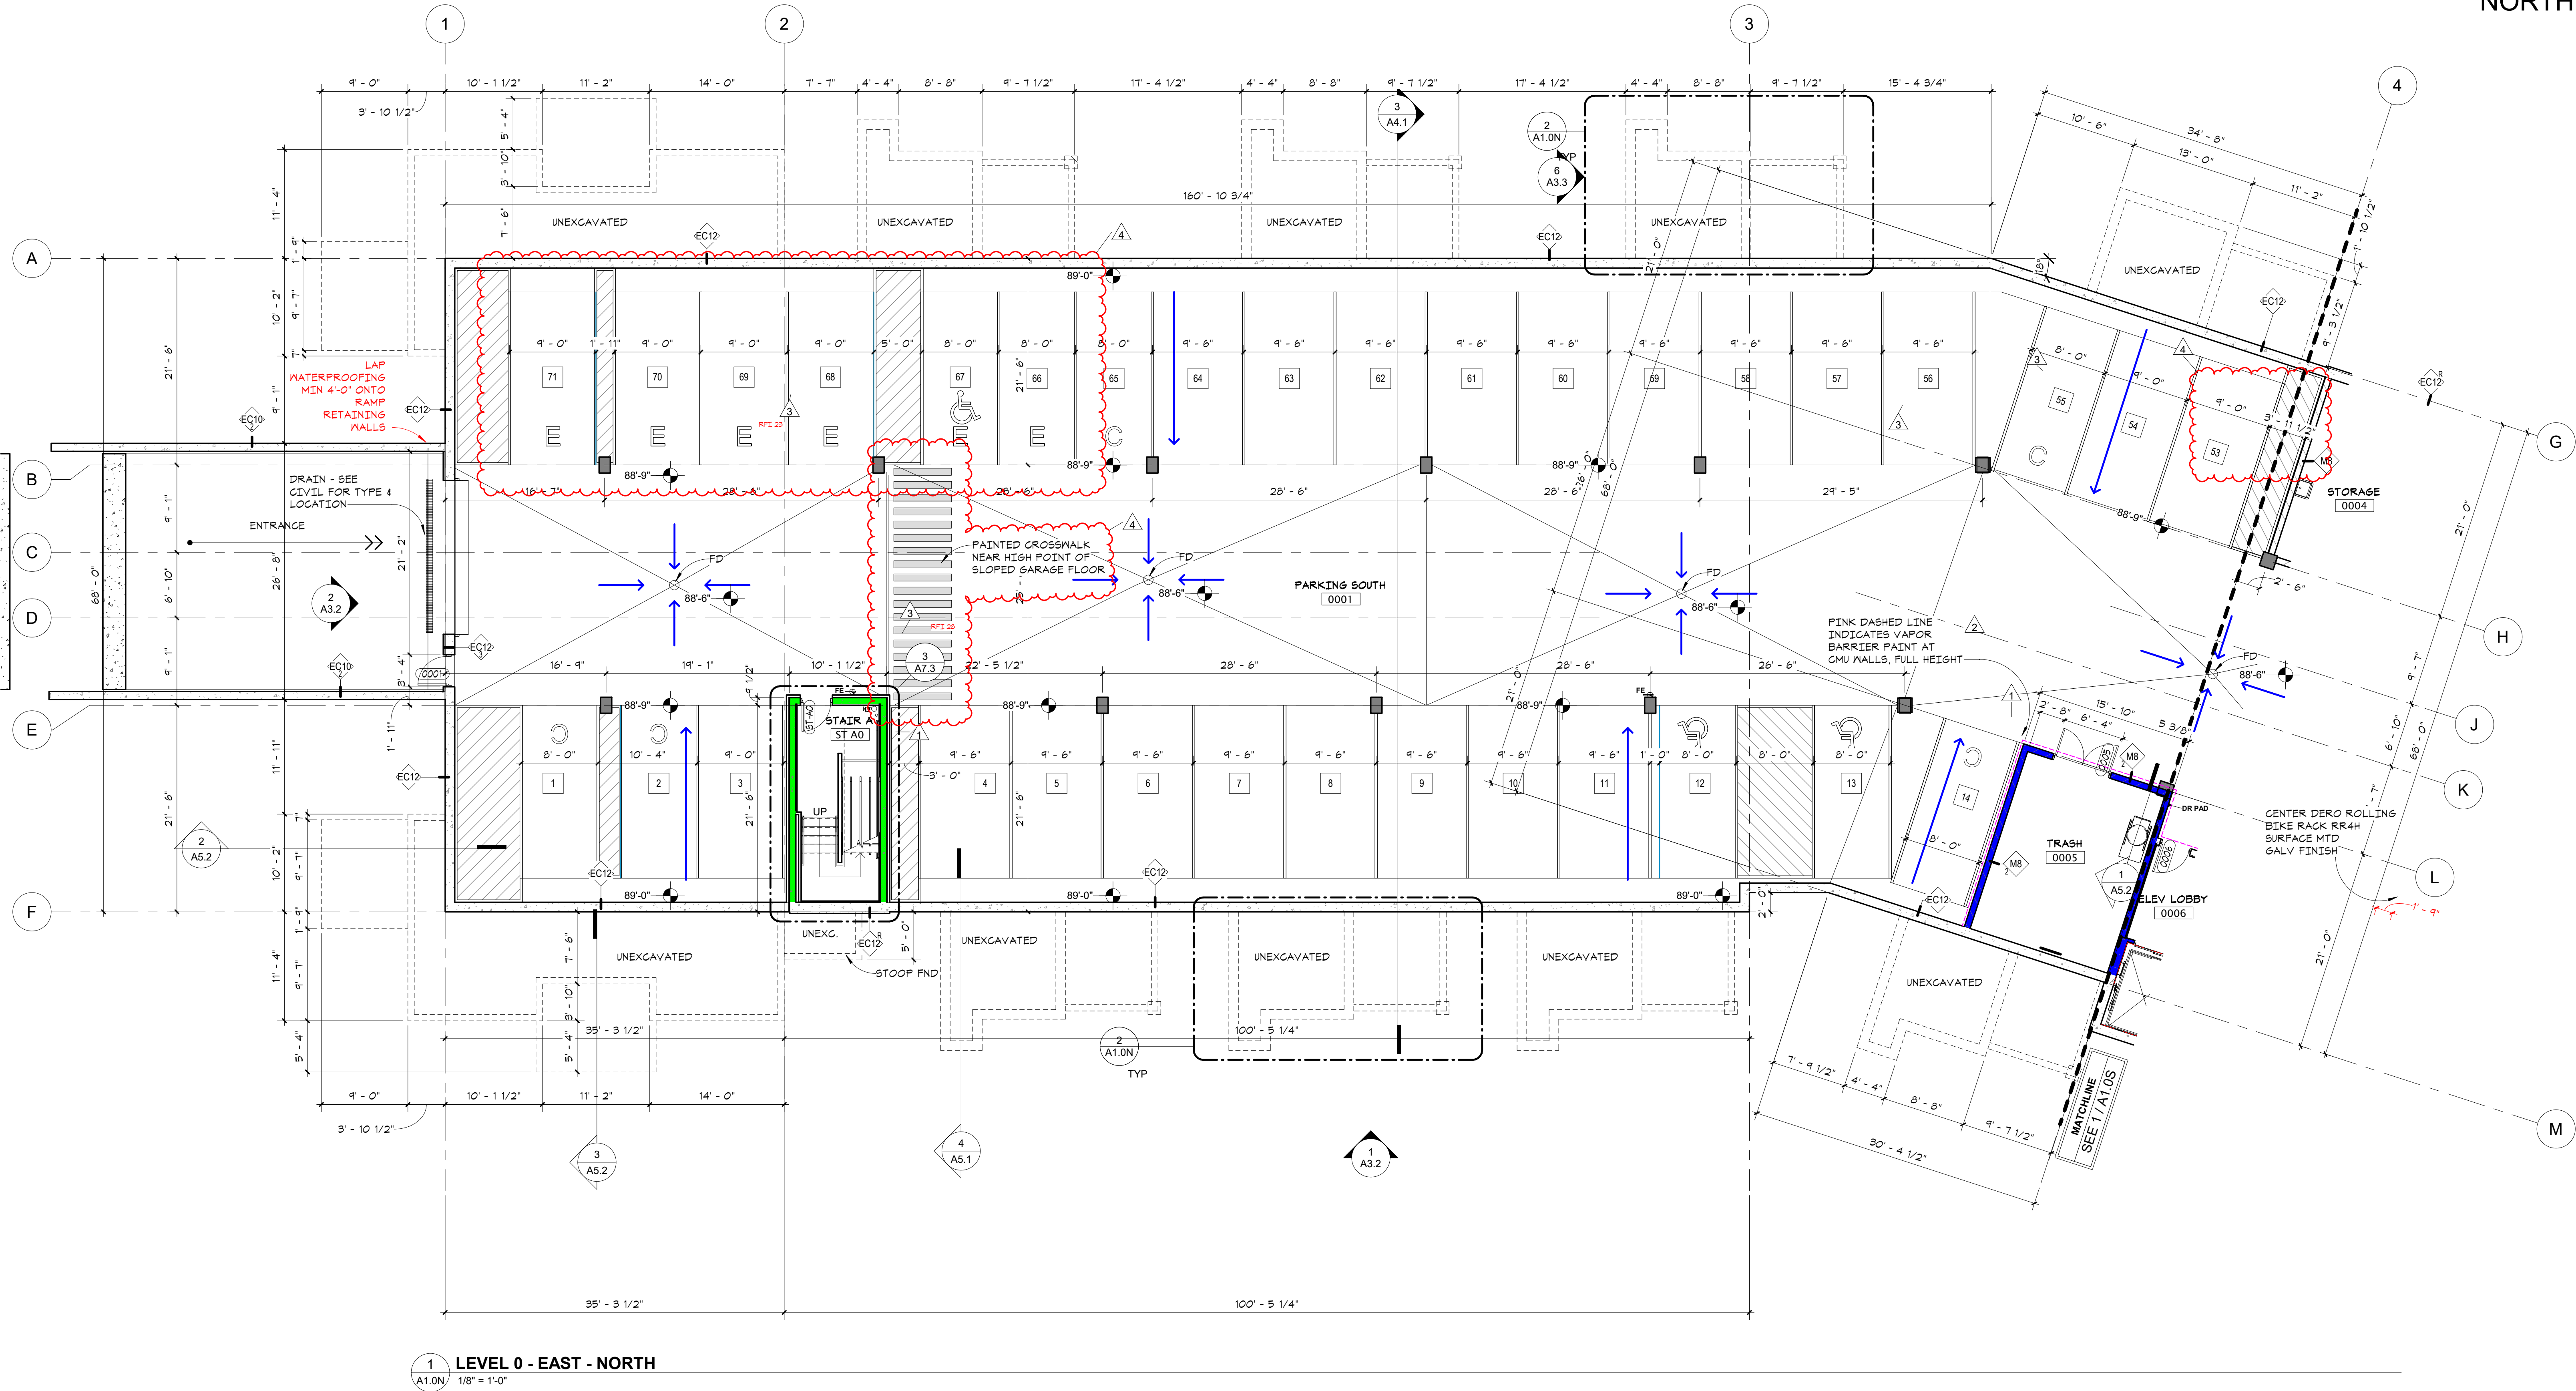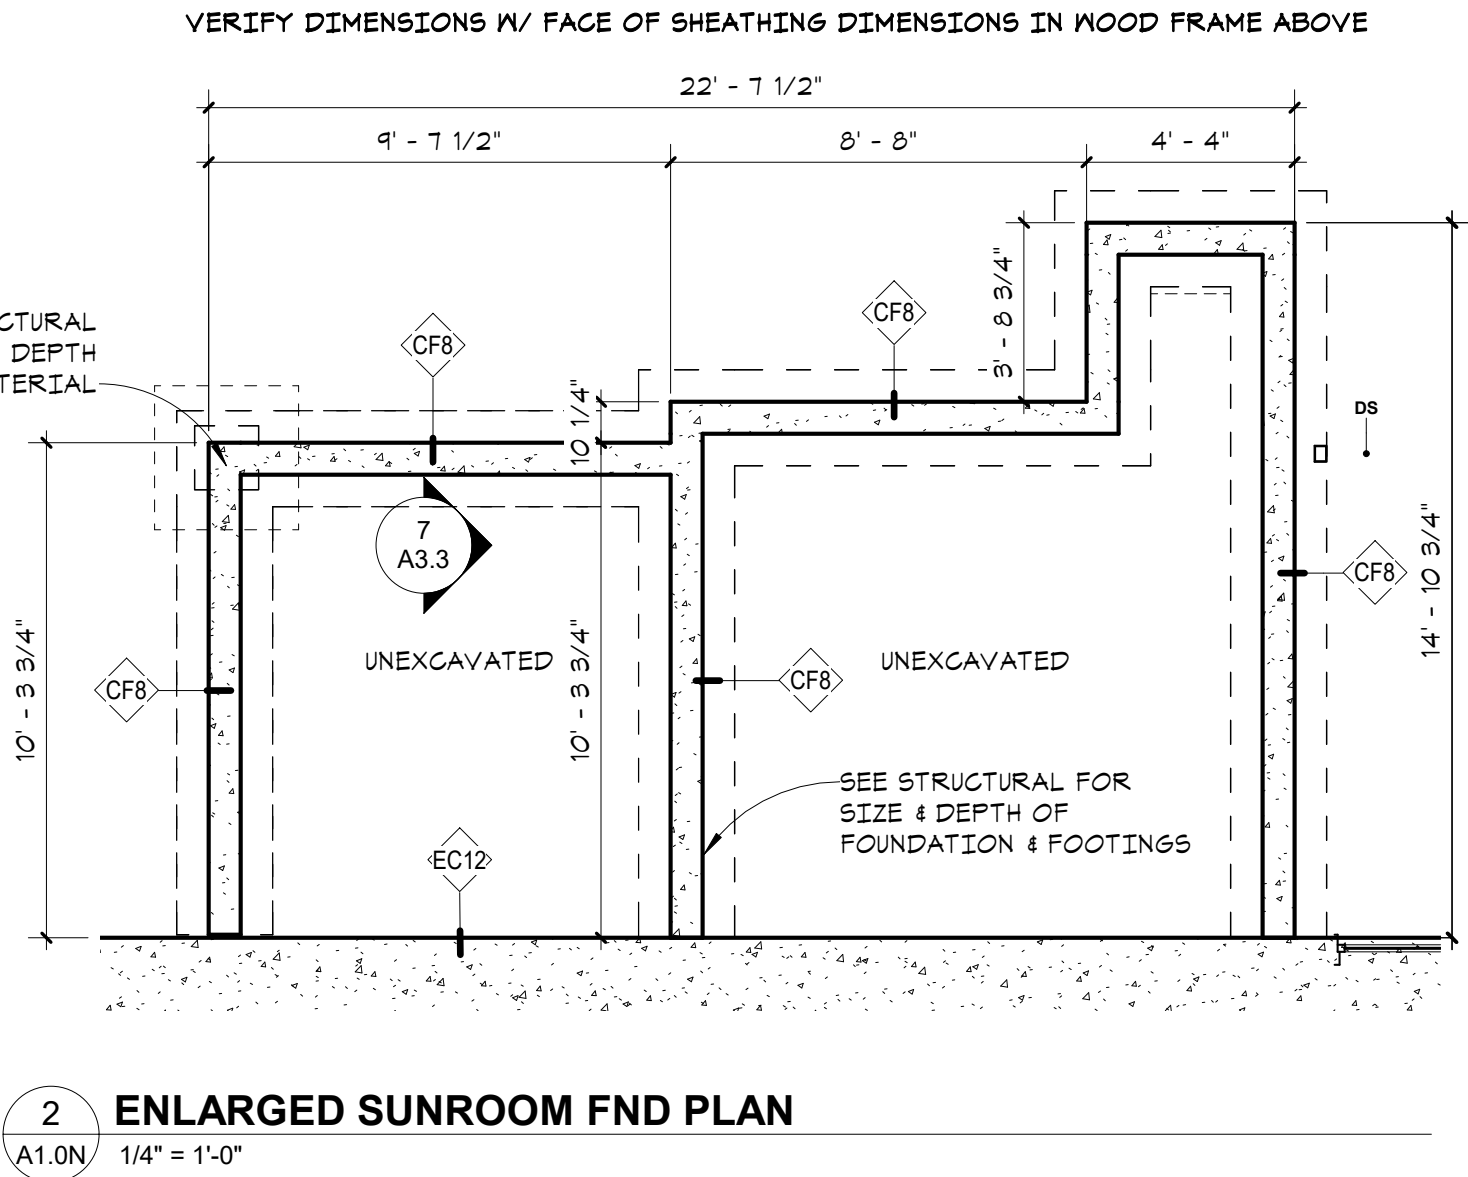

in site architects
1000 university ave. w. # suite 130
st. paul, minnesota 55104
612-252-4820

I hereby certify that this document was prepared by me or under my direct supervision and that I am a duly licensed architect under the laws of the State of Washington

SEE BELOW

Signature
Dawn Wiecezorek
Typed or Printed Name
11192 6/02/23
License # Date
11192
REGISTERED ARCHITECT
DAWN MARIE WIECZOREK
STATE OF WASHINGTON

WESLEY BRADLEY PARK
PH2 EAST BROWNSTONE
707 39TH AVENUE SE, BLDG D
PUYALLUP, WA 98374

PRMU20230881 - Rev #1: Energy Code, EV Location at Garage, and DAS System Location.


BUILDING PERMIT: PRMU20230881

CONSTRUCTION SET
SEPT. 23, 2024

PARCEL ID: 0419037014

REVISIONS

No.	Description	Date
1	BLDG PERMIT REV 1	3/4/24
2	CONSTRUCTION SET	9/23/24
3	ASI 1	3/25/24
4	ASI 2 - City PCR	6/17/25

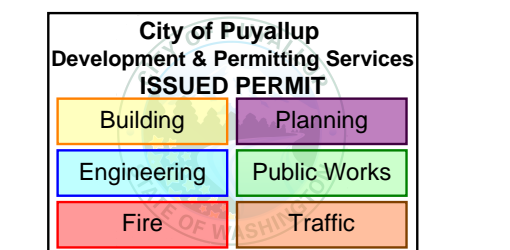


2108
PROJECT NUMBER

Author _____ Checker _____
DRAWN BY _____ CHECKED BY _____

WESLEY BRADLEY PARK
PH2 EAST BROWNSTONE

GARAGE LEVEL
BROWNSTONE B - NORTH

A1.0N

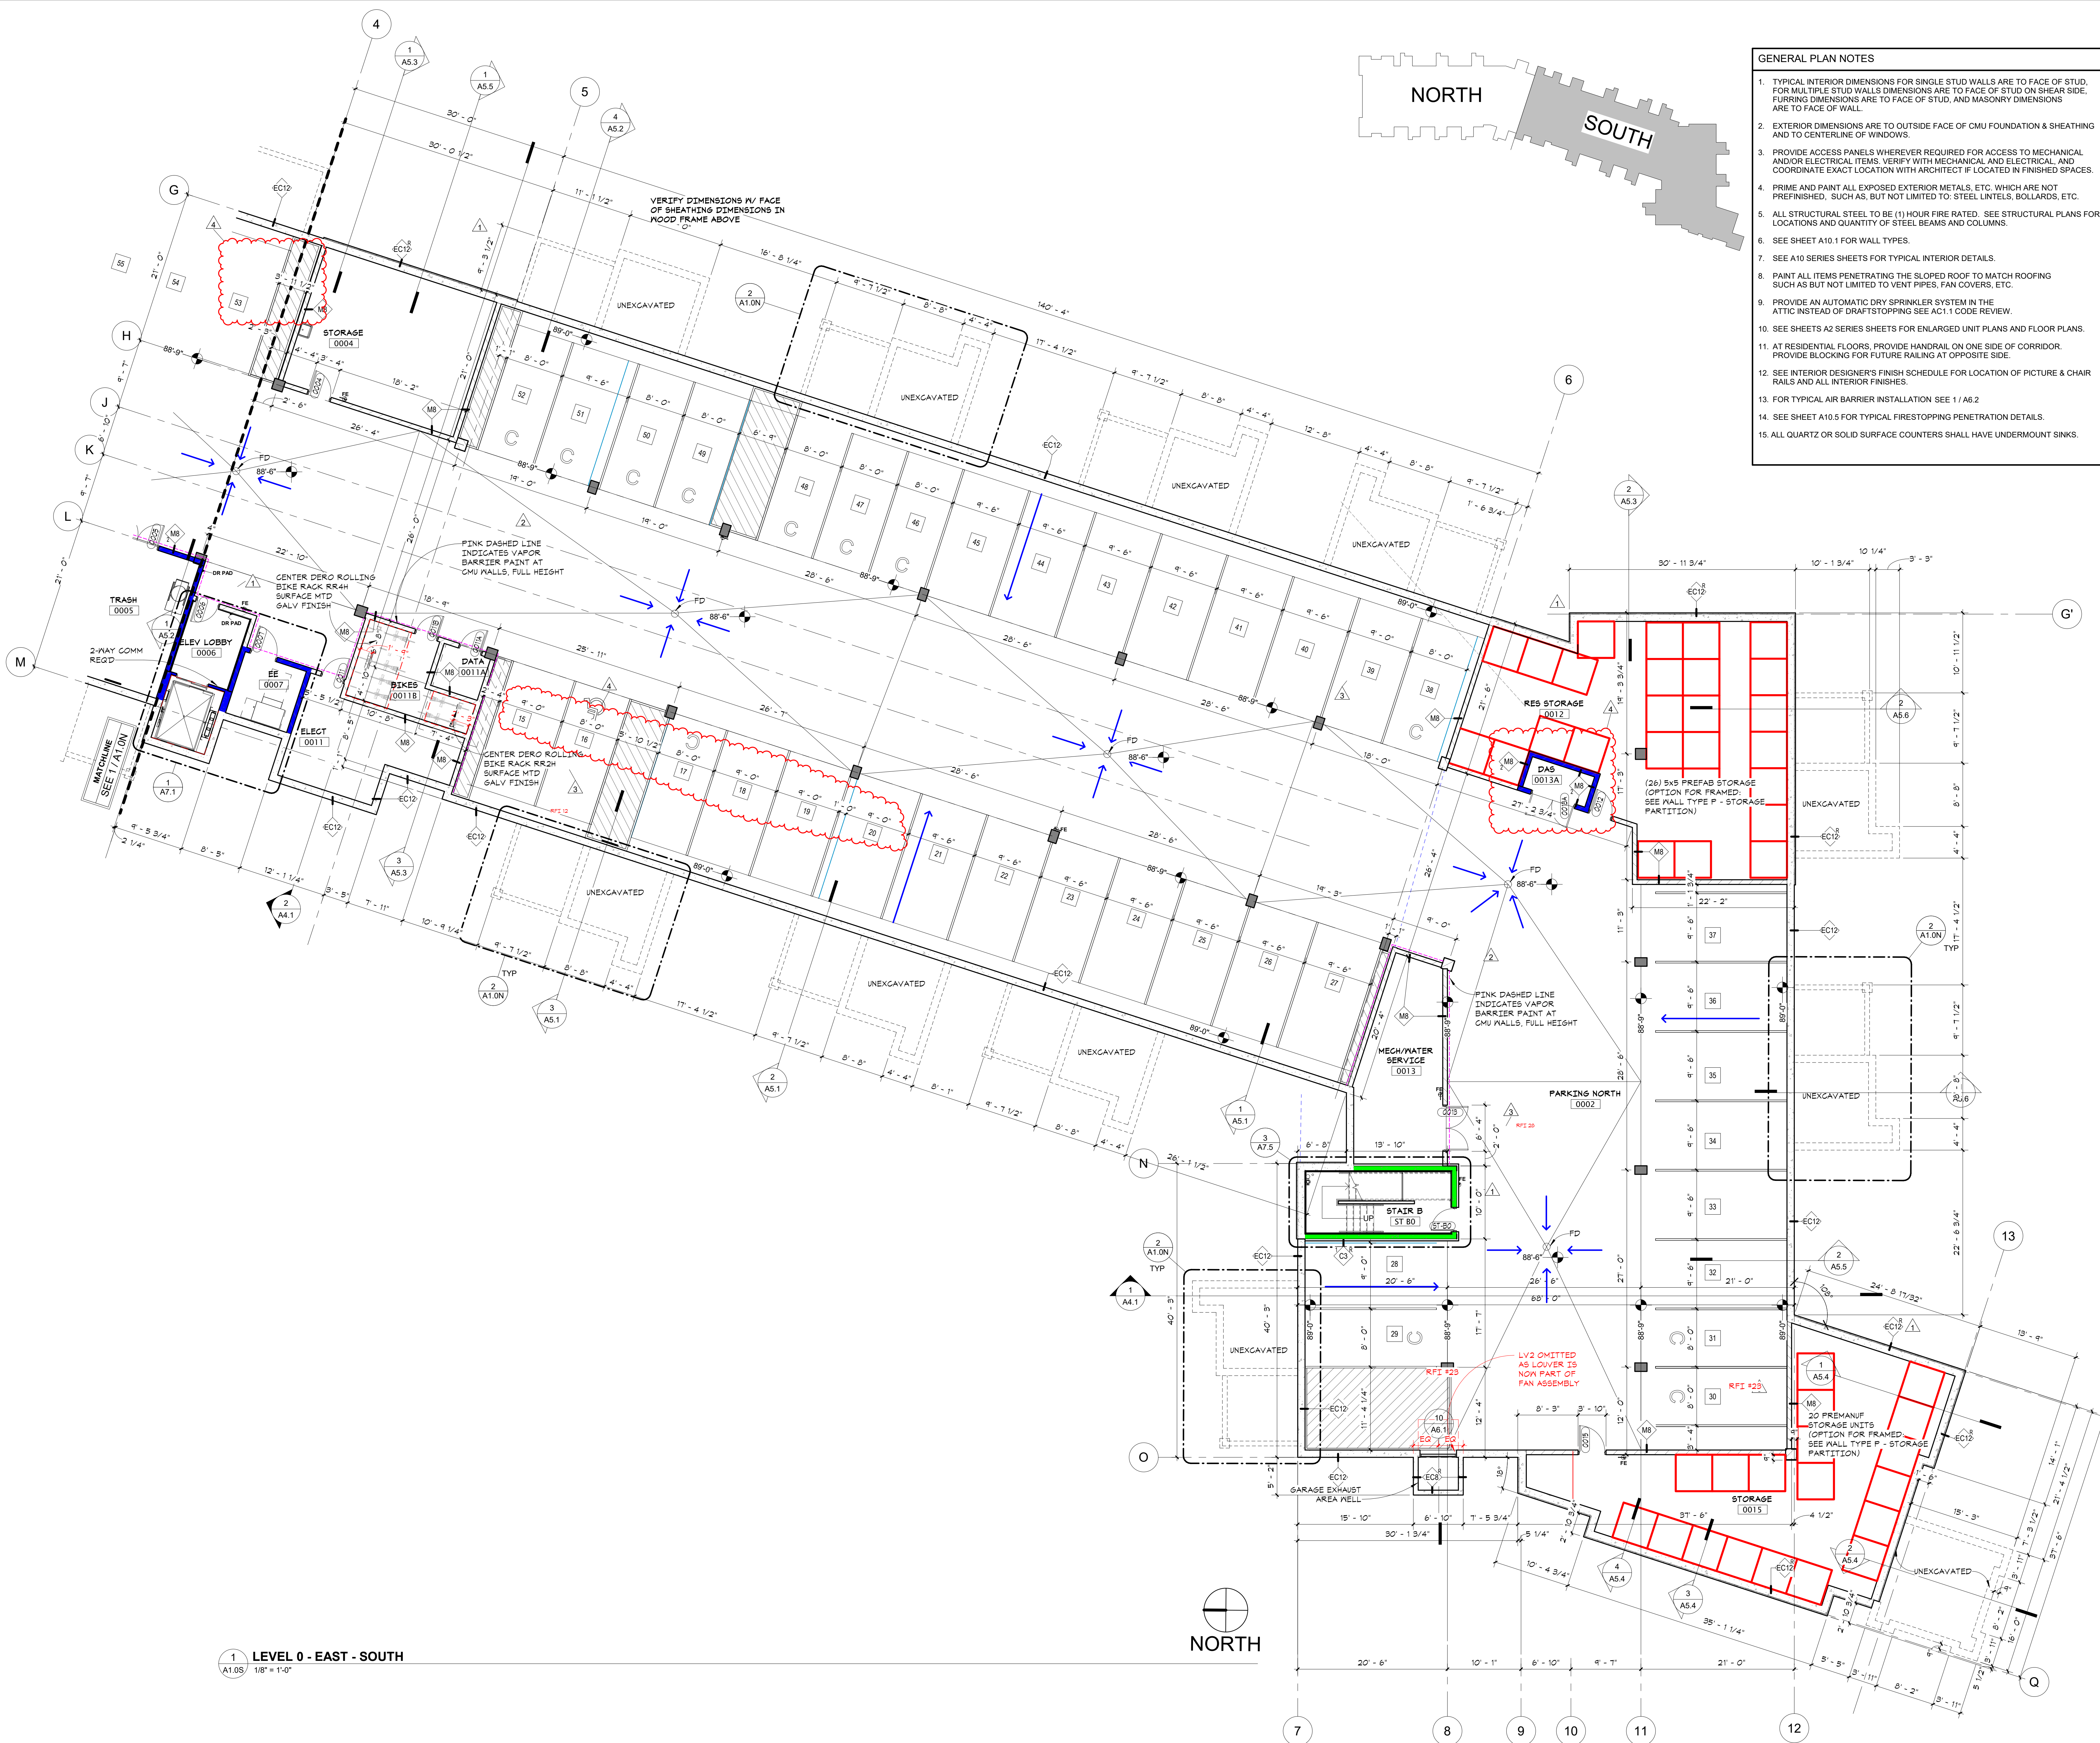

GENERAL PLAN NOTES

1. TYPICAL INTERIOR DIMENSIONS FOR SINGLE STUD WALLS ARE TO FACE OF STUD. FOR MULTIPLE STUD WALLS DIMENSIONS ARE TO FACE OF STUD ON SHEAR SIDE. FURRING DIMENSIONS ARE TO FACE OF STUD, AND MASONRY DIMENSIONS ARE TO FACE OF WALL.
2. EXTERIOR DIMENSIONS ARE TO OUTSIDE FACE OF CMU FOUNDATION & SHEATHING AND TO CENTERLINE OF WINDOWS.
3. PROVIDE ACCESS PANELS WHEREVER REQUIRED FOR ACCESS TO MECHANICAL AND/OR ELECTRICAL ITEMS. VERIFY WITH MECHANICAL AND ELECTRICAL, AND COORDINATE EXACT LOCATION WITH ARCHITECT IF LOCATED IN FINISHED SPACES.
4. PRIME AND PAINT ALL EXPOSED EXTERIOR METALS, ETC. WHICH ARE NOT PREFINISHED, SUCH AS, BUT NOT LIMITED TO: STEEL LINTELS, BOLLARDS, ETC.
5. ALL STRUCTURAL STEEL TO BE (1) HOUR FIRE RATED. SEE STRUCTURAL PLANS FOR LOCATIONS AND QUANTITY OF STEEL BEAMS AND COLUMNS.
6. SEE SHEET A10.1 FOR WALL TYPES.
7. SEE A10 SERIES SHEETS FOR TYPICAL INTERIOR DETAILS.
8. PAINT ALL ITEMS PENETRATING THE SLOPED ROOF TO MATCH ROOFING SUCH AS BUT NOT LIMITED TO VENT PIPES, FAN COVERS, ETC.
9. PROVIDE AN AUTOMATIC DRY SPRINKLER SYSTEM IN THE ATTIC INSTEAD OF DRAFTSTOPPING SEE AC1.1 CODE REVIEW.
10. SEE SHEETS A2 SERIES SHEETS FOR ENLARGED UNIT PLANS AND FLOOR PLANS.
11. AT RESIDENTIAL FLOORS, PROVIDE HANDRAIL ON ONE SIDE OF CORRIDOR. PROVIDE BLOCKING FOR FUTURE RAILING AT OPPOSITE SIDE.
12. SEE INTERIOR DESIGNER'S FINISH SCHEDULE FOR LOCATION OF PICTURE & CHAIR RAILS AND ALL INTERIOR FINISHES.
13. FOR TYPICAL AIR BARRIER INSTALLATION SEE 1 / A6.2
14. SEE SHEET A10.5 FOR TYPICAL FIRESTOPPING PENETRATION DETAILS.
15. ALL QUARTZ OR SOLID SURFACE COUNTERS SHALL HAVE UNDERMOUNT SINKS.

in + site architects
1000 university ave. w. # suite 130
st. paul, minnesota 55104
612-952-4820

I hereby certify that this document was prepared by me or under my direct supervision and that I am a duly licensed architect under the laws of the State of Washington

SEE BELOW

Signature
Dawn Wiecezorek
Typed or Printed Name
11192 6/02/23
License # Date
11186
REGISTERED ARCHITECT
DAWN MARIE WIECZOREK
STATE OF WASHINGTON


**WESLEY BRADLEY PARK
PH2 EAST BROWNSTONE**
707 39TH AVENUE SE, BLDG D
PUYALLUP, WA 98374

PRMU20230881 - Rev #1: Energy Code, EV Location at Garage, and DAS System Location.
BUILDING PERMIT: PRMU20230881
CONSTRUCTION SET
SEPT. 23, 2024

PARCEL ID: 0419037014

REVISIONS

No.	Description	Date
1	BLDG PERMIT REV 1	3/4/24
2	CONSTRUCTION SET	9/23/24
3	AS1	3/25/25
4	AS1.2 - City PCR	6/17/25

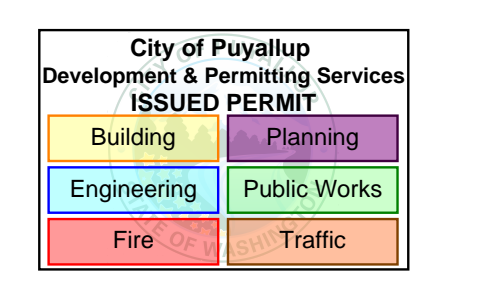

2108
PROJECT NUMBER

Author _____ Checker _____
DRAWN BY _____ CHECKED BY _____

**WESLEY BRADLEY PARK
PH2 EAST BROWNSTONE**

GARAGE LEVEL
BROWSTONE B - SOUTH
A1.0S



- GENERAL PLAN NOTES
1. TYPICAL INTERIOR DIMENSIONS FOR SINGLE STUD WALLS ARE TO FACE OF STUD. FOR MULTIPLE STUD WALLS DIMENSIONS ARE TO FACE OF STUD ON SHEAR SIDE. FURRING DIMENSIONS ARE TO FACE OF STUD, AND MASONRY DIMENSIONS ARE TO FACE OF WALL.
 2. EXTERIOR DIMENSIONS ARE TO OUTSIDE FACE OF CMU FOUNDATION & SHEATHING AND TO CENTERLINE OF WINDOWS.
 3. PROVIDE ACCESS PANELS WHEREVER REQUIRED FOR ACCESS TO MECHANICAL AND/OR ELECTRICAL ITEMS. VERIFY WITH MECHANICAL AND ELECTRICAL AND COORDINATE EXACT LOCATION WITH ARCHITECT IF LOCATED IN FINISHED SPACES.
 4. PRIME AND PAINT ALL EXPOSED EXTERIOR METALS, ETC. WHICH ARE NOT PREFINISHED, SUCH AS, BUT NOT LIMITED TO: STEEL LINTELS, BOLLARDS, ETC.
 5. ALL STRUCTURAL STEEL TO BE (1) HOUR FIRE RATED. SEE STRUCTURAL PLANS FOR LOCATIONS AND QUANTITY OF STEEL BEAMS AND COLUMNS.
 6. SEE SHEET A10.1 FOR WALL TYPES.
 7. SEE A10 SERIES SHEETS FOR TYPICAL INTERIOR DETAILS.
 8. PAINT ALL ITEMS PENETRATING THE SLOPED ROOF TO MATCH ROOFING SUCH AS BUT NOT LIMITED TO VENT PIPES, FAN COVERS, ETC.
 9. PROVIDE AN AUTOMATIC DRY SPRINKLER SYSTEM IN THE ATTIC INSTEAD OF DRAFTSTOPPING SEE AC1.1 CODE REVIEW.
 10. SEE SHEETS A2 SERIES SHEETS FOR ENLARGED UNIT PLANS AND FLOOR PLANS.
 11. AT RESIDENTIAL FLOORS, PROVIDE HANDRAIL ON ONE SIDE OF CORRIDOR. PROVIDE BLOCKING FOR FUTURE RAILING AT OPPOSITE SIDE.
 12. SEE INTERIOR DESIGNER'S FINISH SCHEDULE FOR LOCATION OF PICTURE & CHAIR RAILS AND ALL INTERIOR FINISHES.
 13. FOR TYPICAL AIR BARRIER INSTALLATION SEE 1 / A6.2
 14. SEE SHEET A10.5 FOR TYPICAL FIRESTOPPING PENETRATION DETAILS.
 15. ALL QUARTZ OR SOLID SURFACE COUNTERS SHALL HAVE UNDERMOUNT SINKS.

in site architects
1000 university ave. w. suite 130
st. paul, minnesota 55104
612-952-4820

I hereby certify that this document was prepared by me or under my direct supervision and that I am a duly licensed architect under the laws of the State of Washington

SEE BELOW

Signature
Dawn Wiecezorek
Typed or Printed Name
11192 6/02/23
License # Date
11192
REGISTERED ARCHITECT
DAWN MARIE WIECZOREK
STATE OF WASHINGTON

WESLEY BRADLEY PARK
PH2 EAST BROWNSTONE
707 39TH AVENUE SE, BLDG D
PUYALLUP, WA 98374

PRMU20230881 - Rev #1: Energy Code, EV Location at Garage, and DAS System Location.


BUILDING PERMIT: PRMU20230881

CONSTRUCTION SET
SEPT. 23, 2024

PARCEL ID: 0419037014

REVISIONS

No.	Description	Date
1	BLDG PERMIT REV 1	3/4/24
2	CONSTRUCTION SET	9/23/24
3	AS1.1	3/25/25
4	AS1.2 - City PCR	6/17/25

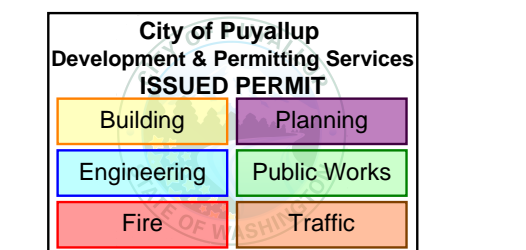

2108
PROJECT NUMBER

jdk Checker
DRAWN BY CHECKED BY

WESLEY BRADLEY PARK
PH2 EAST BROWNSTONE

FIRST LEVEL BROWNSTONE
B PLAN - SOUTH

A1.1S

1 LEVEL 1 - EAST - SOUTH
A1.1S 1/8" = 1'-0"



GENERAL PLAN NOTES

1. TYPICAL INTERIOR DIMENSIONS FOR SINGLE STUD WALLS ARE TO FACE OF STUD. FOR MULTIPLE STUD WALLS DIMENSIONS ARE TO FACE OF STUD ON SHEAR SIDE. FURRING DIMENSIONS ARE TO FACE OF STUD, AND MASONRY DIMENSIONS ARE TO FACE OF WALL.

2. EXTERIOR DIMENSIONS ARE TO OUTSIDE FACE OF CMU FOUNDATION & SHEATHING AND TO CENTERLINE OF WINDOWS.

3. PROVIDE ACCESS PANELS WHEREVER REQUIRED FOR ACCESS TO MECHANICAL AND/OR ELECTRICAL ITEMS. VERIFY WITH MECHANICAL AND ELECTRICAL, AND COORDINATE EXACT LOCATION WITH ARCHITECT IF LOCATED IN FINISHED SPACES.

4. PRIME AND PAINT ALL EXPOSED EXTERIOR METALS, ETC. WHICH ARE NOT PREFINISHED, SUCH AS, BUT NOT LIMITED TO: STEEL LINTELS, BOLLARDS, ETC.

5. ALL STRUCTURAL STEEL TO BE (1) HOUR FIRE RATED. SEE STRUCTURAL PLANS FOR LOCATIONS AND QUANTITY OF STEEL BEAMS AND COLUMNS.

6. SEE SHEET A10.1 FOR WALL TYPES.

7. SEE A10 SERIES SHEETS FOR TYPICAL INTERIOR DETAILS.

8. PAINT ALL ITEMS PENETRATING THE SLOPED ROOF TO MATCH ROOFING SUCH AS BUT NOT LIMITED TO VENT PIPES, FAN COVERS, ETC.

9. PROVIDE AN AUTOMATIC DRY SPRINKLER SYSTEM IN THE ATTIC INSTEAD OF DRAFTSTOPPING SEE AC1.1 CODE REVIEW.

10. SEE SHEETS A2 SERIES SHEETS FOR ENLARGED UNIT PLANS AND FLOOR PLANS.

11. AT RESIDENTIAL FLOORS, PROVIDE HANDRAIL ON ONE SIDE OF CORRIDOR. PROVIDE BLOCKING FOR FUTURE RAILING AT OPPOSITE SIDE.

12. SEE INTERIOR DESIGNER'S FINISH SCHEDULE FOR LOCATION OF PICTURE & CHAIR RAILS AND ALL INTERIOR FINISHES.

13. FOR TYPICAL AIR BARRIER INSTALLATION SEE 1 / A6.2

14. SEE SHEET A10.5 FOR TYPICAL FIRESTOPPING PENETRATION DETAILS.

15. ALL QUARTZ OR SOLID SURFACE COUNTERS SHALL HAVE UNDERMOUNT SINKS.

in + site
architects

1000 university ave. w. suite 130
st. paul, minnesota 55104
612-952-4820

I hereby certify that this document was prepared by me or under my direct supervision and that I am a duly licensed architect under the laws of the State of Washington

Signature
Dawn Wiecezorek
Typed or Printed Name
11192 6/02/23
License # Date
11192
REGISTERED ARCHITECT
DAWN MARIE WIECZOREK
STATE OF WASHINGTON

WESLEY BRADLEY PARK
PH2 EAST BROWNSTONE
707 39TH AVENUE SE, BLDG D
PUYALLUP, WA 98374


PRMU20230881 - Rev #1: Energy Code, EV Location at Garage, and DAS System Location.

BUILDING PERMIT: PRMU20230881

CONSTRUCTION SET
SEPT. 23, 2024

PARCEL ID: 0419037014

REVISIONS		
No.	Description	Date
1	BLDG PERMIT REV 1	3/4/24
3	ASI 1	3/25/25
4	ASI 2 - City PCR	6/17/25

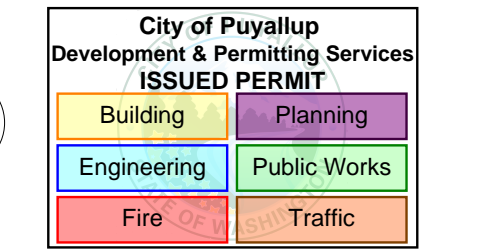

2108
PROJECT NUMBER

Author _____ Checker _____
DRAWN BY _____ CHECKED BY _____
WESLEY BRADLEY PARK
PH2 EAST BROWNSTONE

THIRD LEVEL BROWSTONE
B PLAN - SOUTH

A1.3S



in site
architects

1000 university ave. w. suite 130
st. paul, minnesota 55104
612-552-4820

I hereby certify that this document was
prepared by me or under my direct supervision
and that I am a duly licensed architect
under the laws of the State of Washington

SEE BELOW

Signature

Dawn Wiecezorek
Typed or Printed Name

11192 6/02/23
License # Date



WESLEY BRADLEY PARK
PH2 EAST BROWNSTONE
707 39TH AVENUE SE, BLDG D
PUYALUP, WA 98374

PRMU20230881 - Rev #1: Energy
Code, EV Location at Garage, and
DAS System Location.


BUILDING PERMIT: PRMU20230881

CONSTRUCTION
SET
SEPT. 23, 2024

PARCEL ID: 0419037014

REVISIONS

No.	Description	Date
1	BLDG PERMIT REV 1	3/4/24
2	CONSTRUCTION SET	9/23/24
4	ASI 2 - City PCR	6/17/25

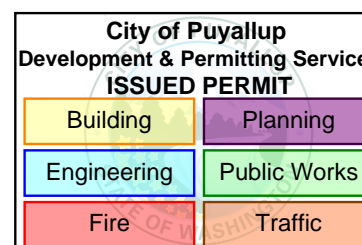

2108

PROJECT NUMBER

Author _____ Checker
DRAWN BY _____ CHECKED BY _____

WESLEY BRADLEY PARK
PH2 EAST BROWNSTONE


DOOR & WINDOW &
ROOM FINISH SCHEDULES
AND TYPES

A11.1

DOOR AND WINDOW NOTES														
1. FIRE RATING LABELS ARE SHOWN IN MINUTES UNO.														
2. UNDERCUT AT ALL INTERIOR DOORS UNO.														
3. DOOR HARDWARE TO BE CENTERED ON RAIL OF PANEL DOORS.														
4. SEE A11.1 FOR DOOR TYPES														
5. REFER TO ELEVATIONS AND PLANS FOR WINDOWS LOCATIONS REQUIRING SAFETY GLAZING TO MEET IBC 2408. WINDOWS WITH 'T' INDICATES SAFETY GLAZING IS REQ'D.														
6. ALL DRYWALL "DW" FRAMED OPENINGS ARE TIMELY FRAMES WITH WD TRIM. VERIFY FINISH OF FRAME AND TRIM WITH ID.														
GLAZING TYPES														
IN 1" INSULATED NON-TEMPERED IT 1" INSULATED TEMPERED P 1/4" PLATE GLASS T 1/4" TEMPERED F 1/4" FROSTED GLASS W 1/4" WIRED GLASS														
DOOR AND WINDOW ABBREVIATIONS														
ALUM	ALUMINUM	NL	NARROW LITE	AP	FLUSH W/ APPLIED MLDG	OC	OVERHEAD COILING	CL	CASEMENT WINDOW	OH	OVERHEAD SEGMENTAL	PLAM	PLASTIC LAMINATE	
DW	FLUSH	PT	PAINT	RP	RAISED PANEL	PREFIN	PRE-FINISHED	FRP	FIBERGLASS REINFORCED	SCR	SCREEN	SCW	SOLID CORE WOOD	
FX	HCHB	SH	SINGLE HUNG WINDOW	HCW	HOLLOW CORE WOOD	SL	SLIDING/GLIDING WINDOW	HM	HOLLOW METAL	ST	STAIN	STL	STEEL	
HMKD	HOLLOW METAL KNOCKED	TR	TRAFFIC DOOR (SOLID CORE)	IF	INSULATED FIBERGLASS	CLWD	CLAD WOOD	IM	INSULATED METAL	WD	WOOD			
MCWV	MINERAL CORE WD VENEER													

TYPICAL UNIT DOOR SCHEDULE														
DOOR NO.	NAME	WIDTH	HT	THK	DOOR TYPE	MAT	FIN	FRAME TYPE	MAT	FIN	HDWR	FIRE RATING	COMMENTS	
A	ENTRY	3'-0"	6'-8"	1 3/4"	AP	SCHB	PT	F1	DW	PT	039U99	20 MIN-S	CONCEALED DROP BOTTOM	
A1	ENTRY	3'-0"	6'-8"	1 3/4"	RP-1	IF	PT	F5	DW	PREFIN	039U97		EXTERIORWD TRIM INTERIOR/FG STORM DR.	
B	BED/BATH	3'-0"	6'-8"	1 3/4"	RP	SCHB	PREFIN	PREHUNG	WD	PREFIN	011U			
B1	BATH	3'-0"	6'-8"	1 3/4"	RP	SCHB	PREFIN	PREHUNG	WD	PREFIN	011U			
BP	BED/BATH POCKET	3'-0"	6'-8"	1 3/4"	RP	SCHB	PREFIN	PREHUNG	WD	PREFIN	006C		POCKET W/PULL BOTH SIDES	
C2.5	CLOSET	2'-6"	6'-8"	1 3/4"	RP	SCHB	PREFIN	PREHUNG	WD	PREFIN	010U			
C3	CLOSET	3'-0"	6'-8"	1 3/4"	RP	SCHB	PREFIN	PREHUNG	WD	PREFIN	010U			
CF2.5	CLOSET	2'-6"	6'-8"	1 3/4"	RP	HCHB	PREFIN	PREHUNG	WD	PREFIN	005		BIFOLD - FULL JAMB	
CF3	CLOSET	3'-0"	6'-8"	1 3/4"	RP	HCHB	PREFIN	PREHUNG	WD	PREFIN	005		SINGLE BIFOLD - FULL JAMB	
CF4	CLOSET	4'-0"	6'-8"	1 3/4"	RP	HCHB	PREFIN	PREHUNG	WD	PREFIN	005A		BIFOLD PAIR - FULL JAMB	
CF5	CLOSET	5'-0"	6'-8"	1 3/4"	RP	HCHB	PREFIN	PREHUNG	WD	PREFIN	005A		BIFOLD PAIR - FULL JAMB	
CF6	CLOSET	6'-0"	6'-8"	1 3/4"	RP	HCHB	PREFIN	PREHUNG	WD	PREFIN	005A		BIFOLD PAIR - FULL JAMB	
CP3	POCKET/CLOSET	3'-0"	6'-8"	1 3/4"	RP	HCHB	PREFIN	PREHUNG	WD	PREFIN	006B		POCKET W/PULL BOTH SIDES	
D3	SUNROOM	3'-0"	6'-8"	1 3/4"	FG-MUNTINS	SOWD	PREFIN	PREHUNG	WD	PREFIN	025U		PAIR	
D4	SUNROOM	4'-0"	6'-8"	1 3/4"	FG-MUNTINS	SOWD	PREFIN	PREHUNG	WD	PREFIN	025U		PAIR	
D5	CLOSET	5'-0"	6'-8"	1 3/4"	BP	HCHB	PREFIN	PREHUNG	WD	PREFIN	010U			
DP5	DEN	5'-0"	6'-8"	1 3/4"	FG-MUNTINS	SOWD	PREFIN	PREHUNG	WD	PREFIN	006A		PAIR/MUNTINS/POCKET/PULL BOTH SIDES	
M	MECHANICAL	2'-10"	7'-0"	1 3/4"	RP	SCHB	PREFIN	PREHUNG	WD	PREFIN	015U		SMOKE SEAL & SILL	
O	OPENING	5'-0"	7'-0"	1 3/4"					WD	ST			CASED OPENING	

NOTE: ALSO SEE
MECHANICAL PLANS FOR
LOUVER TYPES & SIZES

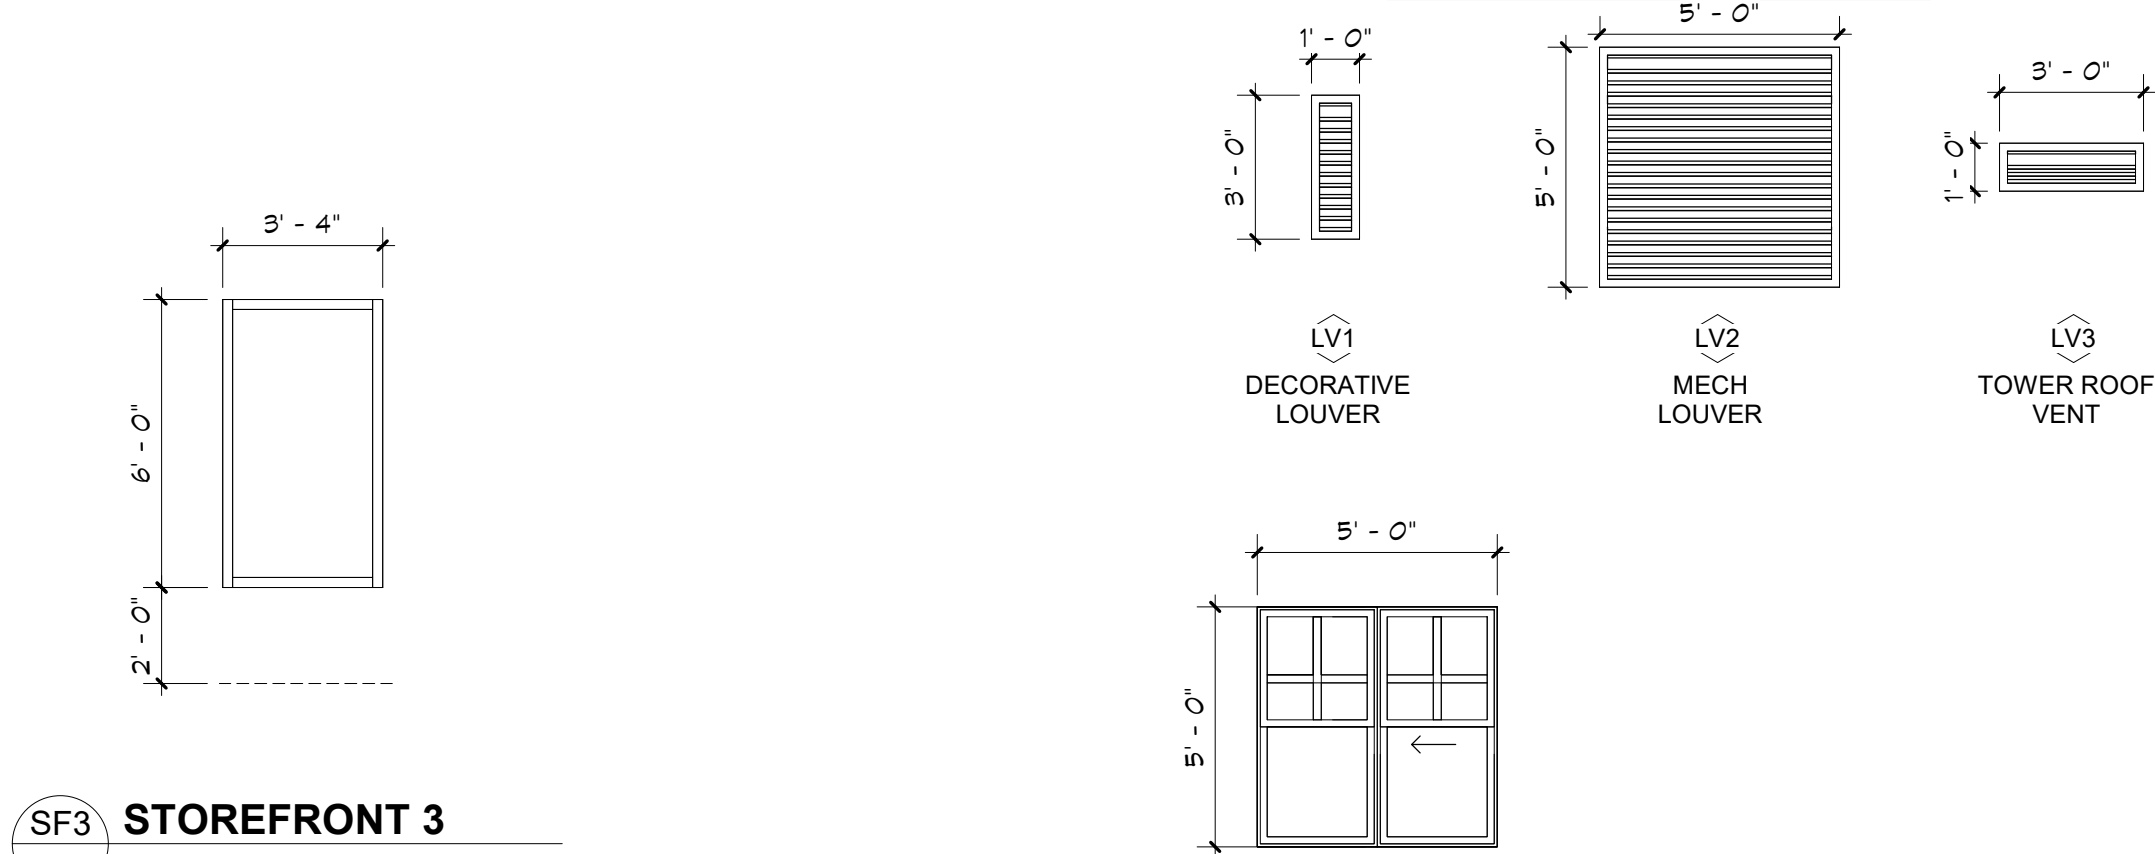

TEMPERED GLASS SHALL BE PROVIDED AT
PANELS MORE THAN 9 SF AND WITHIN 18"
AFF. (IBC 2406.3.1)
TEMPERED GLASS SHALL BE PROVIDED AT
PANELS WITHIN 24" OF THE ARC OF A
DOOR SWING. (IBC 2406.3.6)

GENERAL NOTES - SAFETY GLAZING

1/4" = 1'-0"

DOOR TYPES

1/4" = 1'-0"

FRAME TYPES

1/4" = 1'-0"

WINDOW AND LOUVER LEGEND

1/4" = 1'-0"