

Design Area #: 1 HAZARD: **OH-1** Zone: **1** System Type: **WET** Location: KITCHEN 105 Flowing Outlets: 12 Density: 0.15 Remote Area: 900 Flow: **452.3** gpm @ **35** psi Calculation Safety: 7.1 psi Includes **250** gpm Hose allowance NOTE: AREA REDUCED BY 40% TO 900SF PER 19.3.3.2.3

GENERAL NOTES

- 1. INTERNATIONAL BUILDING CODE (2021) w/ WASHINGTON STATE AMENDMENTS

BUILDING AREA = 3,854 SF CONCEALED SPACE = 3,854SF

- 1.2. TYPE OF CONSTRUCTION: V-B 1.3. SPRINKLERED AREAS (APPROXIMATE - SEE ARCHITECTURAL PLANS FOR ACTUAL)
- 1.4. INSTALLATION STANDARDS: SPRINKLER SYSTEM DESIGNED AND INSTALLED PER NFPA-13 (2019)
- 2.1. 1" BRANCHLINES TO BE BLK SCHEDULE 40 PIPING WITH THREADED FITTINGS 2.2. 1½" THROUGH 2½" MAIN & BRANCHLINES TO BE BLK SCHEDULE 10 PIPING WITH GROOVED FITTINGS
- 3. DESIGN CRITERIA
- 3.1. LIGHT HAZARD AREAS DESIGNED TO DELIVER 0.10 GPM/S.F. OVER THE MOST DEMANDING 1500 S.F. 3.2. ORDINARY HAZARD GROUP 1 AREAS DESIGNED TO DELIVER 0.15 GPM/S.F. OVER THE MOST DEMANDING 1500 S.F. 3.3. REMOTE AREA REDUCTIONS HAVE BEEN TAKEN WHERE APPLICABLE PER NFPA 13 11.2.3.2.3
- 4.1. ALL MATERIAL TO BE NEW AND MEET U.L. STANDARDS 4.2. HANGERS TO BE INSTALLED IN ACCORDANCE WITH NFPA 13. SEE PLAN FOR HANGING REQUIREMENTS
- SYMBOLS USED ON DRAWINGS:
- +9'6" PIPE ELEVATION A.F.F

OH1 ROOM HAZARD CLASSIFICATION (ALL ROOMS ARE CONSIDERED LIGHT HAZARD UNLESS NOTED)

01 01 HYDRAULIC CALCULATION JUNCTION POINT

10'-6" CEILING HEIGHT

SEISMIC BRACING

6.1. INSTALL A COMPLETE WET FIRE SPRINKLER SYSTEM THAT WILL COVER ALL AREAS OF THE BUILDING PER NFPA 13 IN ITS ENTIRETY. FDC TO BE INSTALLED AT A REMOTE LOCATION AS SHOWN ON THE SITE PLAN.



Two-screw ceiling flange with two 18 gauge (0.294") x 11/2"

HANGER DETAILS

*REFER TO REDBUILT SPRINKLER SYSTEM INSTALLATION GUIDE FOR MORE DETAILS

City of Puyallup Fire **REVIEWED** FOR COMPLIANCE 11/14/2025 2:08:39 PM

THE APPROVED CONSTRUCTION PLANS AND ALL ENGINEERING MUST BE POSTED ON THE JOB AT ALL INSPECTIONS IN A VISIBLE AND READILY ACCESSIBLE LOCATION.


Approval of submitted plans is not an approval of omissions or oversight by this office or noncompliance with any applicable regulations of local government. The contractor is responsible for making sure that the building complies with all applicable building codes and regulations of the local government.

City of Puyallup Development & Permitting Services ISSUED PERMIT					
Building	Planning				
Engineering	Public Works				
Fire OF W	Traffic				

RISER LEGEND

- 1. 6" UNDERGROUND WATER SERVICE (BY OTHERS) (FLUSHING & TESTING OF THE UNDERGROUND SHALL BE COMPLETED PRIOR TO THE SPRINKLER SYSTEM
- HOOKUP. UNDERGROUND PAPERS ARE TO BE SUPPLIED TO THE "FP" CONTRACTOR BY THE G.C.) . 6" FLANGED X GROOVED ADAPTER 6"x2½" GROOVED CONC. REDUCER 2½" GROOVED BUTTERFLY VALVE w/ TAMPER
- 2½" GROOVED COMMERCIAL RISER MANIFOLD w/ FLOW SWITCH, PRESSURE GAUGE, & TEST AND
- 6. 2½" GROOVED TO SYSTEM

7. MAIN DRAIN PIPED TO OUTSIDE

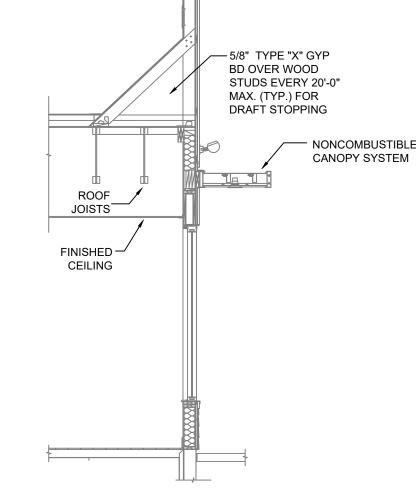

PEN-WEB	TRUSS	SPRINKLER	DETAILS

FIRE SPRINKLER PLAN


SCALE: 1/8" = 1'-0"

Two-screw ceiling flange with two 18 gauge (0.294") x 1½" wood screws into ½" lead holes. Hanger per NFPA 13	
Red-L;™ Red-LT™ or Red-W™ truss	

1 All RedBuilt™ Open-Web Trusses

- For Red-L,™ Red-LT™ and Red-W™ trusses, screws must line up along the
 This detail may be used on top or bottom chord. center of the chord ± ½" tolerance. . If installing through a gypsum board ceiling, increase the fastener length by the gypsum board thickness.
- For all double chord trusses, one screw must be positioned in the center of each chord ± 1/4" tolerance. Pipe size at maximum hanger spacing: 2"

5 All RedBuilt™ Open-Web Trusses

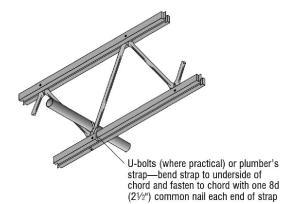

, , , ,
Pipe size at maximum hanger spacing: 3"


NFPA 13 STEEL PIPE HANGER SPACING (EXCEPT LIGHT WALL THRD PIPING)				
NOMINAL SIZE inches	MAX SPACING feet			
1"	12'-0"			
1-1/4"	12'-0"			
1-1/2"	15'-0"			
2"	15'-0"			
2-1/2"	15'-0"			
3"	15'-0"			
4"& LARGER	15'-0"			


SYM	CNT	POSITION	FINISH	TEMP	K	NPT	SIN	MFG.	MODEL#	ESCUTCHEON
0	34	SPRIG	BRASS	200	5.60	1/2"	TY313	Тусо	TY-FRB	N/A
\odot	47	PENDENT	WHITE	200	5.60	1/2"	TY323	Тусо	TY-FRB	SEMI-RECESSED
	3	DRY PENDENT	CHROME	200	5.60	1"	TY3255	Тусо	DS-1	STANDARD
	84	TOTAL								<u> </u>

RISER DETAIL


SPRINKLER HEAD LEGEND


WALL SECTION - FRONT ENTRANCE SCALE: 1/4" = 1'-0"

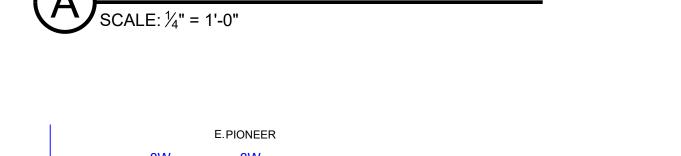


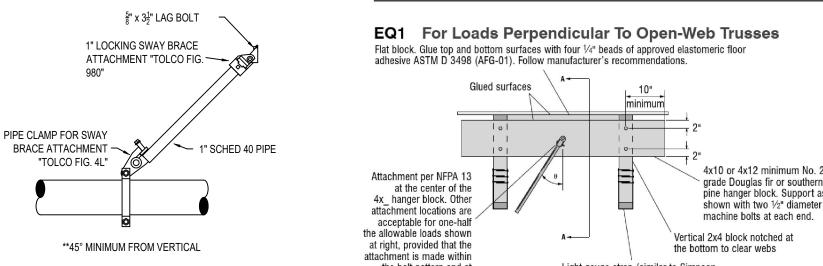


4x10 or 4x12 minimum No. 2 grade Douglas fir or southern pine hanger block. Support as Light gauge strap (similar to Simpson Strong-Tie" LSTA24 strap). Install with three 8d (21/2") common or 10d (3") common nails at the ends of the straps.

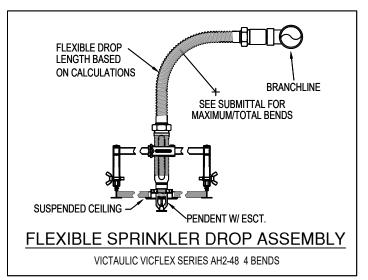


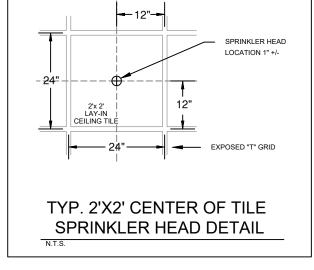

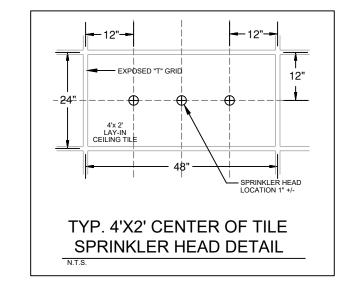

INSTALLATION DETAILS

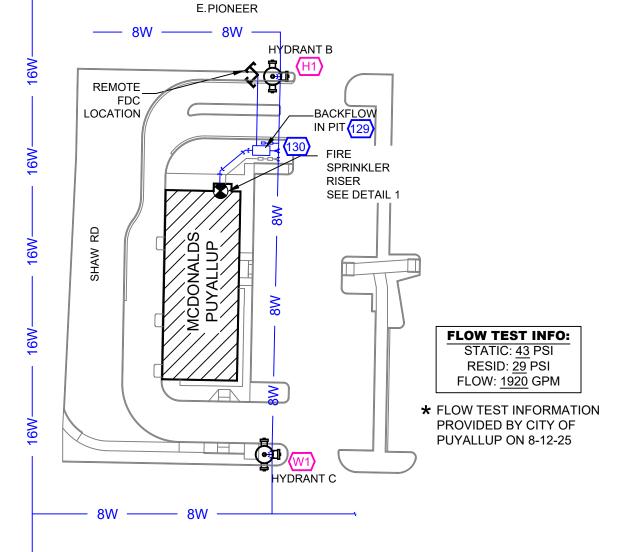

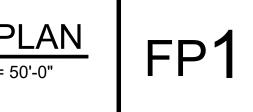

McDONALDS

DEC 31, 25
WASHINGTON STATE
CERTIFICATE OF COMPETENCY
FIRE SPRINKLER SYSTEMS

REVISIONS

10/8/25 UPDATED NFPA CODE TO 2

Drawing Title

Project No. 25-1559

Drawn By AMM

FIRE PROTECTION PLAN

1/8" = 1'

09/17/25


DWG Type SUBMITTAL DWG

Parcel Number. 0420264021

9/5/2025

Brimstone Fire Safety Management, LLC

BRIMSFS918KO

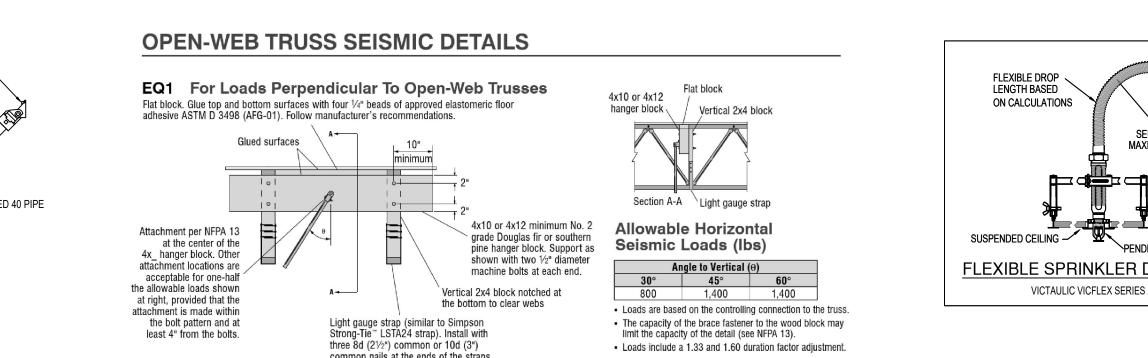

EARTHQUAKE BRACING DETAILS *REFER TO REDBUILT SPRINKLER SYSTEM

Glued surfaces must be clean and dust free.

INSTALLATION GUIDE FOR MORE DETAILS