

PEX GENERAL NOTES

UPONOR AQUAPEX UV RESISTANCE RATINGS

Product	Marking	UV Resistance
Uponor AquaPEX White	5106	1 month
Uponor AquaPEX Blue	5206	3 month
Uponor AquaPEX Red	5206	3 month

NOTE: UPONOR AQUAPEX PURPLE RECLAIMED WATER PIPE HAS NOT BEEN TESTED FOR UV RESISTANCE AND THEREFORE RETAINS A 5006 RATING.

HYDROSTATIC TEMPERATURE AND PRESSURE RATING FOR UPONOR AQUAPEX PIPING.

ASTM F876 Temperature and Pressure Ratings for SDR9 PEX		
Rated Temperature	Hydrostatic Design Stress (HDS) psi	Pressure Rating for Water psi
73.4°F/23°C	630	160
180°F/82°C	400	100
200°F/93°C	315	80

THESE LISTINGS ARE PUBLISHED IN PPI TR-4, A CULMINATION REPORT OF THE LISTINGS THAT ARE MAINTAINED WITH PPI.

STANDARDS, CODES, AND LISTINGS

STANDARDS:

UPONOR AQUAPEX PIPING, PROPEX EP FITTINGS, PROPEX LF BRASS FITTINGS, EP MULTIPOURT PRODUCTS, EP VALVES AND COPPER VALVED MANIFOLDS ARE MANUFACTURED AND TESTED TO MEET THE FOLLOWING REQUIREMENTS:

Standard	Specification
ASTM F876	Standard Specification for Cross-linked Polyethylene (PEX) Piping
ASTM F877	Standard Specification for Cross-linked Polyethylene (PEX) Plastic Hot and Cold Water Distribution Systems
ASTM F1960	Standard Specification for Cold Expansive Fittings with PEX Reinforcing Rings for Use with Cross-linked Polyethylene (PEX) Piping
ASTM F2023	Standard Test Method for Evaluating the Oxidative Resistance of Cross-linked Polyethylene (PEX) Piping and Systems to Hot Chlorinated Water
ASTM F2657	Standard Test Method for Outdoor Weathering Exposure of Cross-linked Polyethylene (PEX) Piping
ASTM E84	Standard Test Method for Surface Burning Characteristics of Building Materials
ASTM E119	Standard Test Method for Materials fire Test of Building Construction and Materials
ASTM E814	Standard Test Method for Materials fire Test of Through penetration Firestop Systems
CAN/CSA B137.5	Cross-linked Polyethylene (PEX) Piping System for Pressure Application
CAN/CSA B214	Installation Code of Hydronic Heating System
CANULC-S102.2	Standard Test Method for Surface Burning Characteristics of Flooring, Floor Covering and Miscellaneous Materials and Assemblies
CANULC-S101	Standard Method of Fire Endurance Test of Building, construction and Materials
CANULC-S115	Standard Method of Fire Tests of firestop Systems
CANULC/ORD-C199P	Combustible Piping for Sprinkler Systems
ANSI/NSF Standard 14	Plaster Piping System Components and Related Materials
ANSI/NSF Standard 61	Drinking Water System Components - Health Effects
ANSI/NSF Standard 359	Valves for Cross-linked Polyethylene (PEX) Water Distribution Systems
AWWA C904	Cross-linked Polyethylene (PEX) Pressure Pipe, 1/2" (12mm) through 3" (76mm) for Water Service
ANSI/UL 263	Standard for Safety for Fire Test of Building Construction and Materials
UL 1821	Standard for Safety for Thermoplastic Sprinkler Pipe and Fitting for Fire Protection Service (NFPA 13D applications only)
UL 2846	Standard for Safety for Fire Test of Plastic Water Distribution Plumbing Pipe for Visible Flame and Smoke Characteristics
ASME B16.5	Pipe Flanges and Flanged Fittings NPS through NPS 24 Metric/Inch Standard

CODES

ICC, IPC, IMC, IRC, UPC, UMC, NSPC, HUD, UFGS, NPC OF CANADA, NBC OF CANADA

LISTINGS

CNSFUS-FS, CNSFUS-RFH, CNSFUS-PW, CQAIUS, UL, CSA, WH, ETL, PPI-TR-4, ICC-ES-PMG, IAPMO, BMEC, CCMC

UPONOR PROPEX FITTINGS

UPONOR PROPEX FITTINGS ARE AVAILABLE IN BOTH ENGINEERED POLYMER (EP) AND LEAD-FREE (LF) BRASS AND ARE TESTED AND LISTED TO ASTM F1960 AND CAN/CSA B137.5

UPONOR PROPEX LEAD-FREE (LF) BRASS FITTINGS

ALL UPONOR LF BRASS PRODUCTS COMPLY WITH NSF/ANSI 61 ANNEX G, NSF/ANSI 372 AND CONFORM TO THE LEAD-CONTENT REQUIREMENTS FOR "LEAD-FREE" PLUMBING AS DEFINED BY CALIFORNIA, VERMONT, MARYLAND AND LOUISIANA STATE LAWS AS WELL AS THE U.S. SAFE DRINKING WATER ACT, EFFECTIVE JANUARY 2014.

ALL UPONOR LF BRASS FITTINGS MARKED AS NSFUS-PW-G COMPLY WITH THE DEZINIFICATION RESISTANCE (DZR) AND STRESS CORROSION CRACKING (SCC) REQUIREMENTS OF SECTIONS 5.8.1 AND 5.8.2 PER THE CURRENT NSF 14 STANDARD.

UPONOR'S LF BRASS IS APPROVED FOR DIRECT BURIAL IN SOIL PER NSF/ANSI STANDARD 14 TESTING WHICH ESTABLISHED MINIMUM PERFORMANCE CRITERIA FOR DZR/SCC RESISTANCE FOR PEX FITTINGS INTENDED FOR POTABLE WATER.

NOTE: UPONOR DOES NOT PERMIT A PRESS-TYPE FITTING TO BE USED WITH PROPEX SWEAT OR FITTING SWEAT ADAPTERS. BRASS MATERIAL IS NOT NEARLY AS MALLEABLE AS COPPER MATERIAL, CAUSING UNDO STRESS AND AFFECTING THE INTEGRITY OF THE CONNECTION

MINIMUM DISTANCE BETWEEN PROPEX FITTINGS

TO ENSURE A PROPER PROPEX CONNECTION, FOLLOW THE REQUIRED MINIMUM DISTANCE BETWEEN FITTINGS CHART.

Nominal Fitting Size	Cut Length of Pipe
1/2"	2"
3/4"	3"
1"	3 1/2"
1 1/4"	4 1/2"
1 1/2"	4 3/4"
2"	6"
2 1/2"	7 1/2"
3"	9"

RECOMMENDED NUMBER OF EXPANSIONS FOR 3/8" TO 3" PIPING AT 73.4° F (23° C)

Piping Size	Milwaukee ProPEX Tool M12	M12	FORCELOK	MANUAL	Uponor ProPEX Tool 100/150	201
3/8"	8	9	-	-	5	7
1/2"	5	6	-	-	4	4
3/4"	9	8	-	-	9	9H
1"	12	5	-	-	14	7H
1 1/4"	-	7	-	-	-	7H
1 1/2"	-	6	-	-	-	8H
2"	-	-	4	-	-	5H
2 1/2"	-	-	5	-	-	-
2 1/2"	-	-	7	-	-	-

NOTE: "H" IN THE TABLE REFERS TO UPONOR H-SERIES EXPANDER HEADS. FIRE STOPPING SOLUTIONS

THERE IS A WIDE RANGE OF FIRE STOPPING SOLUTIONS THAT HAVE BEEN TESTED AND LISTED WITH PEX PIPE; INCLUDING INTUMESCENT CAULKS, WRAP STRIPS, PASS-THROUGH DEVICES, COLLARS AND CAST-IN-PLACE SLEEVES. SOME FIRE STOP MANUFACTURERS INCLUDE, BUT ARE NOT LIMITED TO, 3M™, HLT®, RECTORESEAL®, PASSIVE FIRE PROTECTION PARTNERS, SPECIFIED TECHNOLOGIES INC., HOLDRITE® AND PROSET SYSTEMS®.

FIRE ASSEMBLY DOCUMENTATION AND LISTINGS SHALL BE OBTAINED FROM THE SELECTED FIRE STOP SOLUTION MANUFACTURER. MOST OF THE FIRES STOP MANUFACTURERS HAVE SYSTEM SELECTOR TOOLS OR NAVIGATORS ON THEIR WEBSITES TO EASILY RESEARCH AND FIND A LISTING THAT MATCHES THE SPECIFIED CONSTRUCTION.

ASTM E84 - SURFACE BURNING CHARACTERISTICS

(RETURN-AIR PLENUMS ASTM E84)
UPONOR PEX-A PIPING SYSTEMS COMPRISED OF UPONOR PEX-A PIPE, UPONOR PROPEX RINGS, UPONOR EP FITTINGS, UPONOR LF BRASS FITTINGS AND UPONOR PEX-A PIPE SUPPORT PRODUCTS ARE LISTED FOR INSTALLATION IN RETURN-AIR PLENUMS AS TESTED IN ACCORDANCE WITH ASTM E84.


Classified as to Surface Burning Characteristics			
ASTM E84	Flame Spread	Smoke Developed	Limitations
Nominal 1/2" to 3/4" size	25 or less	50 or less	Adjacent pipe runs shall be located at least 18" apart.
3" maximum nominal size Uponor PEX-a Supported with Uponor PEX-a Pipe Support	25 or less	50 or less	Pipe or fitting sections without PEX-a Pipe Support must be covered with a rated insulation per Table 3-5. There is no minimum length of PEX-a Pipe Support segments...
3" maximum nominal size Uponor PEX-a with 1/2" insulation	25 or less	50 or less	1/2" minimum thickness insulation as specified in Table 3-5.

UPONOR AQUAPEX ASTM E84 REQUIREMENTS

Plumbing		Hydronic	Radiant
Provide the following criteria and then click calculate below.			
Enter Your Domestic Water Supply Parameters:			
B1	Pressure Available at Building	-	Calculation
B2	Min. Flow Working Pressure	-	71.00 PSI
B3	Static Head - System Height (ft.)	60.00 ± 0.00	28.00 PSI
B4	Additional Component Loss	-	0.00 PSI
Available Pressure For Friction Loss			27.00 PSI
Enter Your Piping Supply Information:			
C1	Longest Run to Fixture (ft.)	-	Calculation
C2	Fitting Allowance (% of number above)	-	0.00 FT
Total Developed Length			60.00 FT
Friction Loss Rate Per Foot (Friction Loss / 100') = Velocity (FPM)			
Friction Loss Rate per 100 Feet (Friction Loss / 100' x 100) = Velocity (FPM)			
Enter Your System Parameters for Each Valve:			
D1	Water Flow Rate Temperature (°F)	-	Calculation
D2	Max. Velocity Per Water Temp. (ft/sec.)	-	71.00 PSI
D3	WSPU Predominant Future Curve	-	0.00 PSI
Choose the code that you state or local AHJ has adopted. WSPU Predominant Future Curve			
BEC			


QAI P321-1

GUIDELINES: 1/2" THROUGH 3/4" (UNINSULATED)
LIMITATIONS: ADJACENT RUNS SHALL BE LOCATED AT LEAST 18" APART

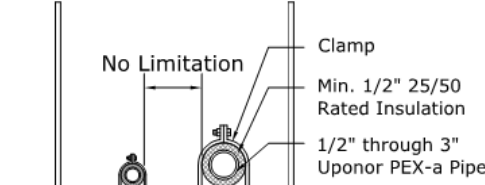

QAI P321-1

GUIDELINES: 1/2" THROUGH 3" (INSULATED)
LIMITATIONS: 1/2" MINIMUM THICKNESS INSULATION AS SPECIFIED

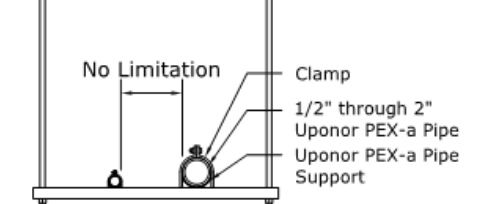

QAI P321-2

GUIDELINES: 1/2" THROUGH 3" (PEX-A PIPE SUPPORT)
PIPE OR FITTING SECTIONS WITHOUT PEX-A PIPE SUPPORT MUST BE COVERED WITH A RATED INSULATION. THERE IS NO MINIMUM LENGTH OF PEX-A PIPE SUPPORT SEGMENTS.

UPONOR AQUAPEX DESIGN PARAMETERS

- DOMESTIC COLD-WATER PIPING
 - MAXIMUM VELOCITY OF 12 FT/SEC. THROUGH PIPE
 - RECOMMENDED VELOCITY OF 10 FT/SEC. THROUGH PIPE
- DOMESTIC HOT-WATER PIPING
 - MAXIMUM VELOCITY OF 12 FT/SEC. THROUGH PIPE
 - RECOMMENDED VELOCITY OF 8 FT/SEC. THROUGH PIPE
 - MAXIMUM OPERATING TEMPERATURE OF 200 DEG F (93.3 DEG C)
- DOMESTIC HOT-WATER RETURN PIPING
 - MAXIMUM VELOCITY OF 2 FT/SEC. THROUGH PIPE
 - MAXIMUM OPERATING TEMPERATURE OF 140 DEG F (60 DEG C)

NOTES:
UPONOR ALLOWS THE DEDICATED FIXTURE SUPPLY PIPE TO BE OF THE SAMENOMINAL SIZE AS THE FIXTURE BEING SUPPLIED, PROVIDED THE DEDICATED PIPE IS NO LONGER THAN 25 LINEAR FEET FROM A UNIFORM-FRICTION-LOSS-SIZED PIPE.

Uponor Allows The Use Of 12" Pipe For Domestic Hot-Water Return Piping Provided A Flow-Control Device Is In Place To Maintain Velocities At Or Below 2 Ft/Sec.

RECIRCULATED HOT-WATER SYSTEM DESIGN

UPONOR AQUAPEX PIPING IS TESTED AND LISTED TO PEX 5106 NSF-PW (CL5). PER ASTM F876, THE CL5 CHLORINE RESISTANCE RATING IS INTENDED FOR AN END-USE CONDITION OF 100% AT 140°F/60°C. UPONOR REQUIRES THAT THE VELOCITY OF THE RECIRCULATION PIPING SHALL NOT EXCEED 2 FT/SEC AND THE SYSTEM MUST BE BALANCED PROPERLY. SEE UPONOR'S PLUMBING DESIGN ASSISTANCE MANUAL OR ASPE PLUMBING ENGINEERING DESIGN HANDBOOK VOLUME 2 FOR MORE INFORMATION.

Nominal Pipe Size	Velocity (ft/sec)	Flow Rate (gpm)	Friction Loss per Foot at 120°F/48.9°C
1/2"	2	1.1	0.0195
3/4"	2	2.2	0.0126
1"	2	3.6	0.0092
1 1/4"	2	5.4	0.0072
1 1/2"	2	7.5	0.0059
2"	2	12.9	0.0042
2 1/2"	2	19.8	0.0033
3"	2	28.1	0.0026

REVERSE OSMOSIS AND DE-IONIZED WATER SYSTEMS

REVERSE-OSMOSIS SYSTEMS AND SYSTEMS USING DE-IONIZED WATER WITH A PH BETWEEN 5 AND 8 AND A MAXIMUM TEMPERATURE OF 104 DEG F(40 DEG C) ARE APPROVED FOR USE WITH UPONOR AQUAPEX PIPING UPONOR REQUIRES THE USE OF ENGINEERED POLYMER (EP) OR STAINLESS-STEEL FITTINGS WITH THESE SYSTEMS.

BUNDLING

PARALLEL RUNS OF UPONOR PEX MAY BE BUNDLED TOGETHER GIVEN THE FOLLOWING GUIDELINES:

- ENTIRE BUNDLE MUST BE SUPPORTED AT THE REQUIRED O.C. DISTANCES.
- CABLE TIES MAY BE USED TO MAINTAIN A TIGHT BUNDLE OF PEX.
- CABLE TIES MAY NOT BE USED AS THE SOLE MEANS OF SUPPORTING THE BUNDLE.
- KEEP HOT AND COLD BUNDLES 6" APART IF UNINSULATED.

THERMAL EXPANSION AND CONTRACTION

HORIZONTAL TUBING RUNS

THERMAL EXPANSION FORCES ON SUSPENDED HORIZONTAL RUNS OF PEX-A TUBING THAT CAN EXPERIENCE A 22° C (40°F) OR GREATER RISE IN TEMPERATURE SHALL BE CONTROLLED BY A MEANS OF MITIGATING TEMPERATURE-INDUCED STRESSES TO OTHER PARTS OF THE WATER DISTRIBUTION SYSTEM. MEANS FOR CONTROLLING THERMAL EXPANSION INCLUDE:

- SUPPORTING THE TUBING WITH CONTINUOUS RUNS OF UPONOR PEX-A PIPE SUPPORT
- RIGID ANCHOR POINTS INSTALLED EVERY 20 M (65 FT.)
- PROPER STRAPPING (E.G. 27 KG (60 LB.) STRAPS OR EQUIVALENT) SPACED 1 M (3 FT.) AND RATED FOR THE MAXIMUM TEMPERATURE AND UV EXPOSURE OF THE PEX-A TUBING APPLICATION.
- LOOPS
- OFFSETS
- ARMS WITH RIGID ANCHOR POINTS

VERTICAL TUBING RUNS

THERMAL EXPANSION FORCES ON VERTICAL RUNS OF PEX-A TUBING THAT PASSES THROUGH MORE THAN ONE FLOOR AND CAN EXPERIENCE A 22° C (40°F) OR GREATER RISE IN TEMPERATURE SHALL BE CONTROLLED BY INSTALLING:

- A RISER CLAMP AT THE TOP OF EVERY OTHER FLOOR; AND
- MID-STORY GUIDES TO MAINTAIN THE ALIGNMENT OF THE VERTICAL TUBING.

NOTE: INSTALLING RISER CLAMPS ISOLATES EXPANSION TO TWO-FLOOR INTERVALS ALLOWING THE PEX-A TUBING TO NATURALLY COMPENSATE FOR THE EXPANSION.

ABOVE-GROUND AND SUSPENDED APPLICATIONS

SMALLER DIAMETER (3/8" TO 1") PIPE RUNS REQUIRE AN EXTRA 1/8" TO 3/16" OF LONGITUDINAL CLEARANCE PER FOOT OF RUN. DO NOT ALLOW PIPING TO DIP EXCESSIVELY BETWEEN SUPPORTS AND DO NOT PULL PIPING TIGHT DURING INSTALLATION.


LARGER SUSPENDED COMMERCIAL SYSTEMS ARE OFTEN DESIGNED TO INCLUDE A NUMBER OF CHANGES IN DIRECTION. THESE DIRECTIONAL CHANGES CAN BE A BENEFICIAL ASPECT IN THE PIPING SYSTEM BY CREATING A SPRING-LIKE EFFECT, WHICH SAFELY ABSORBS AND CONTROLS THERMAL EXPANSION AND CONTRACTION.

CONTROLLING EXPANSION IN HOT-WATER SYSTEMS

BEST PRACTICE FOR CONTROLLING EXPANSION FORCES IS TO CONTINUOUSLY RESTRAIN THE PIPE BY INSTALLING UPONOR PEX-A PIPE SUPPORT. DOMESTIC COLD WATER SYSTEMS DO NOT TYPICALLY EXPERIENCE THE TEMPERATURE DIFFERENTIALS SEEN IN DOMESTIC HOT WATER SYSTEMS, THEREFORE REQUIRING FEWER FIXED ANCHOR POINTS. PEX-A PIPE SUPPORT SHALL BE INSTALLED IN ACCORDANCE WITH THE INSTALLATION GUIDELINES IN THE PDAM.

STRAPPING SHALL BE:

- NYLON COATED STAINLESS-STEEL WITH A MINIMUM TENSILE RATING OF 300-LBS.
- RATED FOR OPERATING TEMPERATURE RANGES, INCLUDING HIGH TEMPERATURES.
- UV-RESISTANT TO WITHSTAND EXPECTED LIFE OF THE PIPING SYSTEM.
- TO ACCOUNT FOR EXPANSION, FIXED ANCHOR POINTS SHALL BE USED TO RESTRICT PIPING MOVEMENT. FIXED ANCHOR POINTS SHALL BE:
- INSTALLED EVERY 65 FT.
- CONSTRUCTED WITH MATERIALS THAT PROVIDE RIGIDITY.
- UTILIZE A PIPE CLAMP THAT WILL RESTRAIN PIPING MATERIAL.
- INSTALLED WITHIN 18" OF A FIRE-RATED WALL PENETRATION.

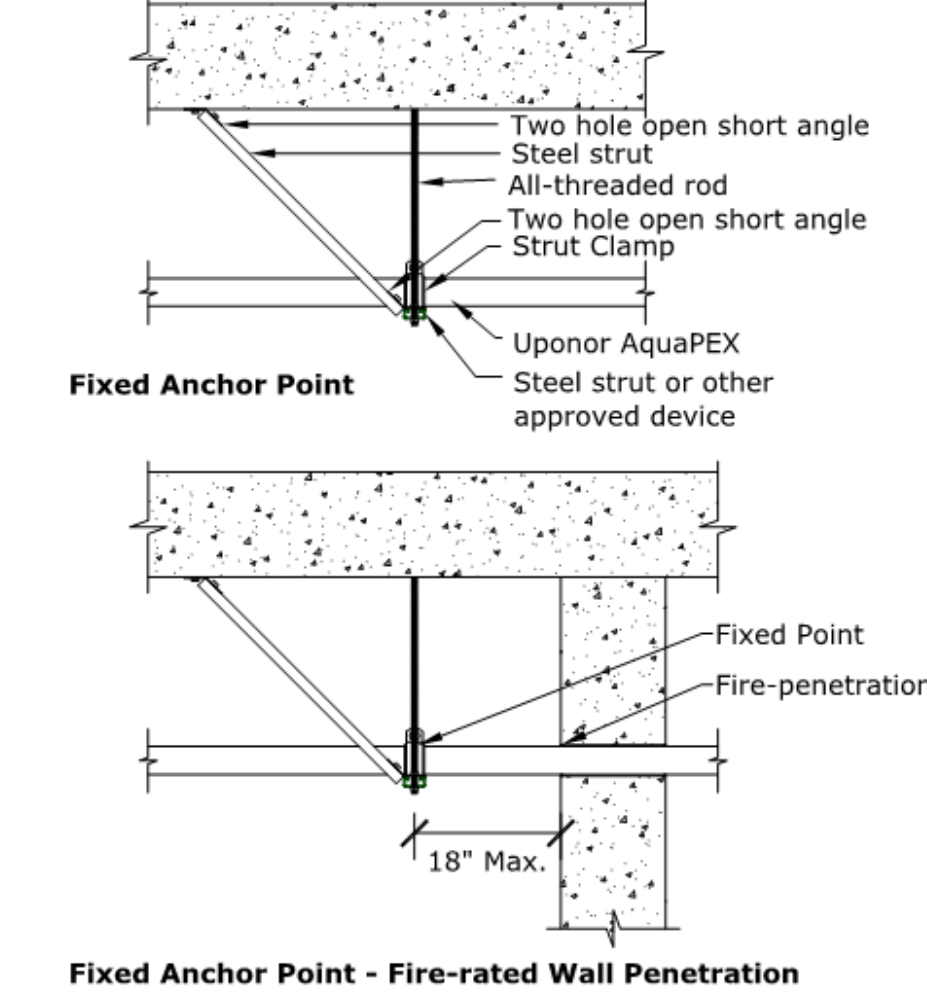

EXPANSION AND CONTRACTION: RISERS

VERTICAL PIPING RUNS MUST COMPLY WITH SUPPORT SPACING AS DEFINED BY CODE. BEST PRACTICE IS THE UTILIZE THE FLOOR ASSEMBLY AS AN ANCHOR POINT FOR CONTROLLING CONTRACTION BY MEANS OF RISER CLAMPS. DO THIS BY UTILIZING AN ADDITIONAL RISER CLAMP AT THE TOP OF THE FLOOR ASSEMBLY AS LISTED BELOW:

- DOMESTIC HOT WATER: TOP OF EVERY-OTHER FLOOR.
- DOMESTIC COLD WATER: TOP OF EVERY FOURTH FLOOR


THERMAL EXPANSION IN UNDERGROUND APPLICATIONS

FOR DIRECT-BURIAL APPLICATIONS, MITIGATE THE EFFECTS OF THERMAL EXPANSION BY INCORPORATING PROPER INSTALLATION TECHNIQUES THAT PROVIDE ADEQUATE RESISTANCE TO AXIAL STRESS PER PPI TR-21 THERMAL EXPANSION AND CONTRACTION IN PLASTIC PIPING SYSTEMS. A BURIED OR CONCRETE-ENCASED PIPE IS EFFECTIVELY RESTRAINED AGAINST BOTH LATERAL AND AXIAL MOVEMENT BY SURROUNDING EMBEDMENT MATERIAL. THE MAGNITUDE OF THE FRICTIONAL RESTRAINING FORCE IS DEPENDENT ON THE NATURE OF THE SOIL AND ON INSTALLATION AND OPERATING CONDITIONS. FOR EXAMPLE, THE EXTENT OF COMPACTION NEAR THE PIPE CAN AFFECT THE QUALITY OF CONTRACT BETWEEN THE PIPE AND SURROUNDING SOIL. THE ANCHORING OR RESTRAINING EFFECT OF SURROUNDING SOIL ON PIPE MOVEMENT CAN BE SIGNIFICANTLY AUGMENTED BY EXTERNAL PIPE GEOMETRY, TEES, LATERAL CONNECTIONS AND CHANGES IN DIRECTION ALL HELP TO ANCHOR A PIPE IN THE SURROUNDING SOIL BECAUSE THE FRICTION BETWEEN THE PIPE AND SURROUNDING MATERIAL IS GENERALLY SUFFICIENT TO ARREST AXIAL PIPE MOVEMENT. A BURIED PIPE THAT IS SUBJECT TO TYPICAL FLUCTUATION IN THE TEMPERATURE OF THE FLUID IT CONVEYS OR OF THE SOIL THAT SURROUNDS IT IS ONLY SUBJECT TO MODEST AXIAL THERMAL STRESSES THAT ARE WELL WITHIN THE STRENGTH CAPABILITIES OF THE PIPE.

BENDING PEX

THE MINIMUM BEND RADIUS OF UPONOR AQUAPEX PIPING IS SIX (6) TIMES THE OUTSIDE DIAMETER. BEND SUPPORTS ARE AVAILABLE FOR 3/8", 1/2", 3/4" AND 1" PIPING AND MAY BE USED TO FACILITATE 90 DEGREE RIGID BENDS. LARGE DIAMETER PVC CONDUIT CAN BE USED TO FACILITATE 90 DEGREE BENDS IN LARGER DIAMETER UPONOR AQUAPEX PIPING. TO ALLEVIATE STRESS ON PROPEX CONNECTIONS AND FITTINGS, DO NOT CHANGE DIRECTION IMMEDIATELY AFTER A PROPEX CONNECTION. UPONOR RECOMMENDS A MINIMUM OF TWO TIMES THE OUTSIDE DIAMETER (O.D.) OF THE PIPE AS THE MINIMUM DISTANCE BEFORE CHANGING DIRECTION.

Pipe Size (in)	Pipe O.D. (in)	Min. Bend radius (in)	2 x O.D. (in)
1/2"	0.625"	3 3/4"	1 1/4"
3/4"	0.875"	5 1/4"	1 3/4"
1"	1.125"	6 3/4"	2 1/4"

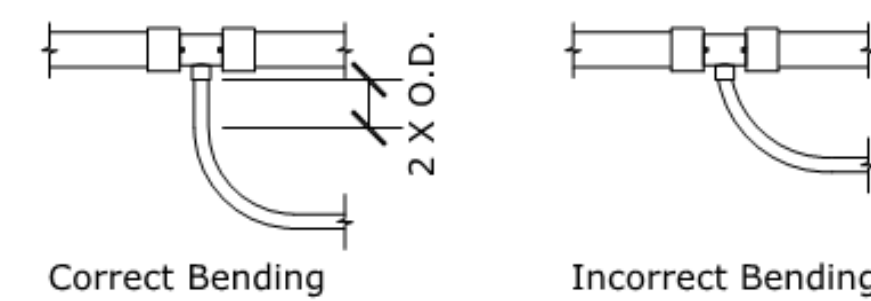



SUPPORTING UPONOR PEX PIPE, FITTINGS, AND VALVES

SUSPENDED RUNS OF UPONOR PEX PIPE CAN BE SUPPORTED BY THE SAME CONVENTIONAL MEANS AS METALLIC PIPE, USING COPPER TUBE SIZE (CTS) HANGERS AND SUPPORTS. HOWEVER, SUPPORT SPACING WILL VARY DEPENDING ON LOCAL CODE REQUIREMENTS.


NOTE: UPONOR RECOMMENDS USING HANGERS AND SUPPORTS DESIGNED FOR USE WITH PLASTIC PIPING.

Spacing for Bare PEX (Dimension A)			Spacing w/PEX-a Pipe Support (Dimension B)		
Nominal Pipe Size	International Plumbing Code (IPC)	Uniform Plumbing Code (UPC)	National Plumbing Code of Canada (NPCC)	International Plumbing Code (IPC)	Uniform Plumbing Code (UPC)
1/2"	32"	32"	32"	6'-0"	6'-0"
3/4"	32"	32"	32"	6'-0"	6'-0"
1"	32"	32"	32"	8'-0"	8'-0"
1 1/4"	32"	48"	32"	8'-0"	8'-0"
1 1/2"	32"	48"	32"	8'-0"	8'-0"
2"	32"	48"	32"	8'-0"	8'-0"
2 1/2"	32"	48"	32"	8'-0"	8'-0"
3"	32"	48"	32"	8'-0"	8'-0"

UPONOR SPACING REQUIREMENTS

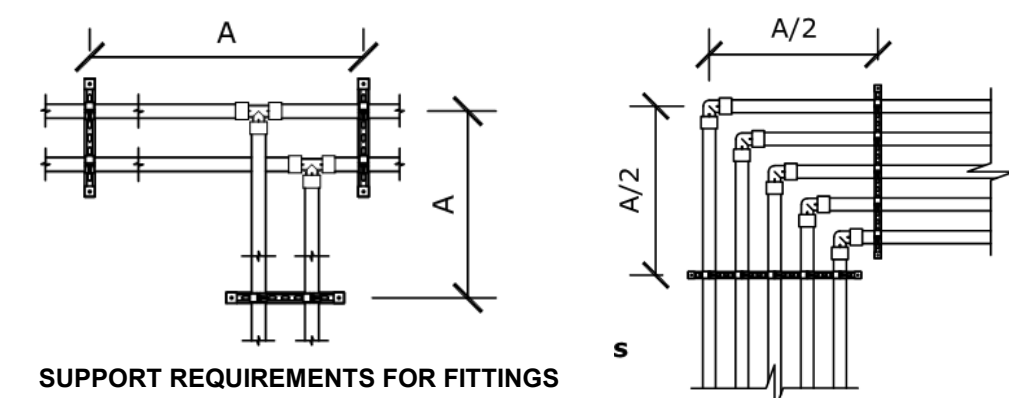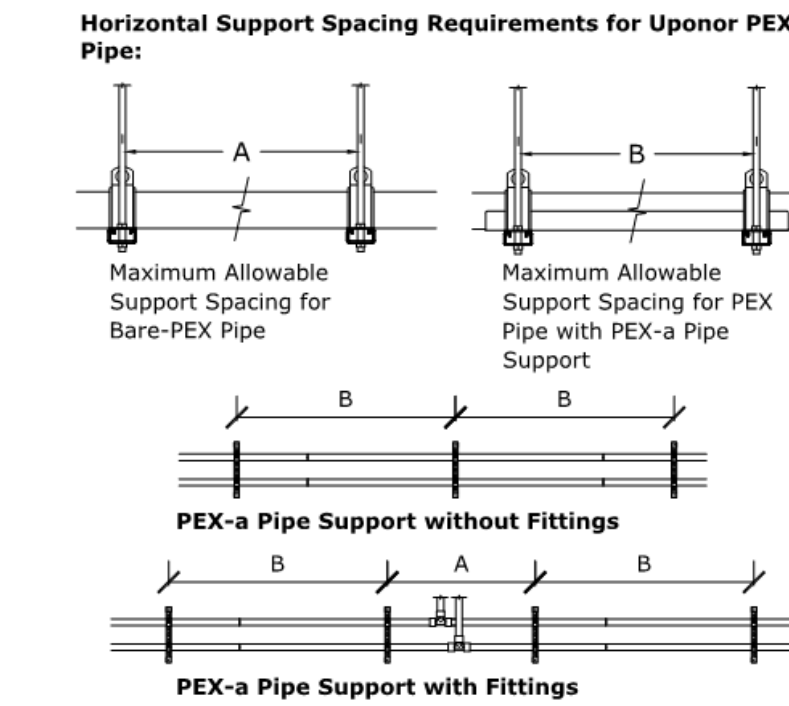


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ADDITIONAL SUPPORT REQUIREMENTS FOR FITTINGS AT CORNERS

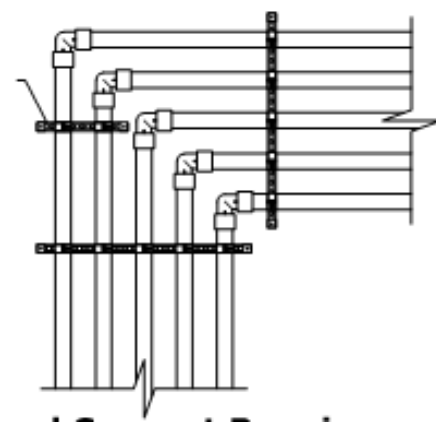CORNER SUPPORT EXAMPLE

DISTANCE G = 16"
TOTAL DISTANCE FOR G = 32"
(16" x 2)
DISTANCE H = 16"
TOTAL DISTANCE FOR H = 32"



Nominal Pipe Size	Dimension "C"
1/2"	-
3/4"	-
1"	-
1 1/4"	18"1
1 1/2"	18"1
2"	18"1
2 1/2"	7"2
3"	7"2

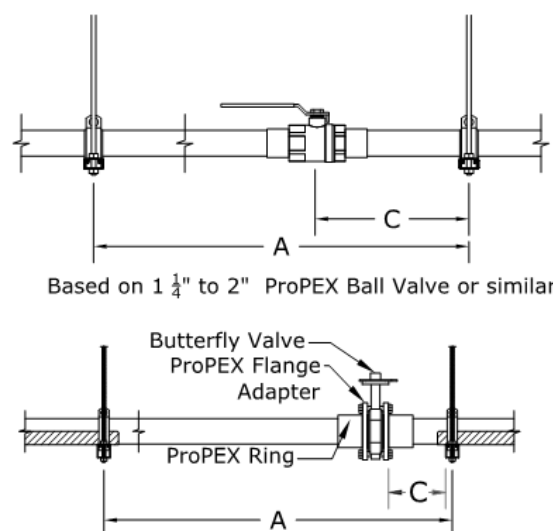BASED ON 2 1/2" TO 3" DUCTILE-IRON BUTTERFLY VALVES OR SIMILAR


NOTE: IF DIMENSION C CANNOT BE MET ADDITIONAL SUPPORT SHALL BE ADDED.

UPONOR PEX-A PIPE SUPPORT

PEX-A PIPE SUPPORT IS A SELF-GRIPPING, GALVANIZED-STEEL CHANNEL FOR PEX PIPING. IT PROVIDES CONTINUOUS, UNINTERRUPTED SUPPORT OF PEX-A PIPING, ALLOWING PLACEMENT OF HANGERS SIMILAR TO THAT OF METALLIC PIPING. PEX-A PIPE SUPPORT MAY BE INSULATED WITH TYPICAL CTS (COPPER TUBE SIZE) PIPE INSULATION AND IS AVAILABLE IN 9-FOOT (3M) LENGTHS IN 1/2"-3" SIZES.


Uponor PEX-a Pipe support Installation Guidelines

Nominal Pipe Size	Max. Support Spacing (A)	Max. Cantilever (B)	Min. Overlap (C)	Min. Distance to Fitting (D)	Min. Overhang (E)
1/2"	6'-0"	18"	6"	1 3/4"	1"
3/4"				1 3/4"	
1"				2 1/4"	
1 1/4"	8'-0"	18"	6"	2 3/4"	1"
1 1/2"				3"	
2"				4"	
2 1/2"	8'-0"	18"	6"	5"	1"
3"				6"	

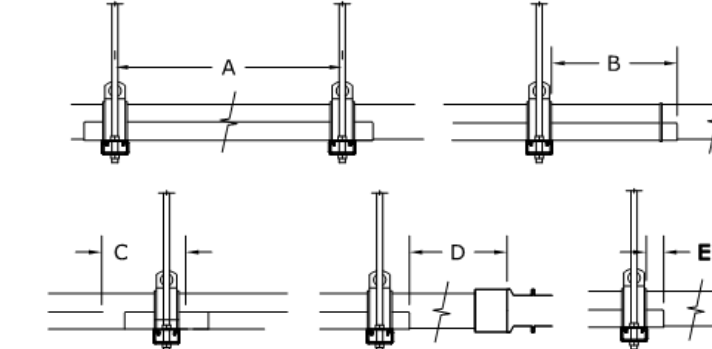

PEX GENERAL NOTES

STRAPPING FOR SYSTEMS USING CLEVIS-TYPE HANGERS OR EQUIVALENT

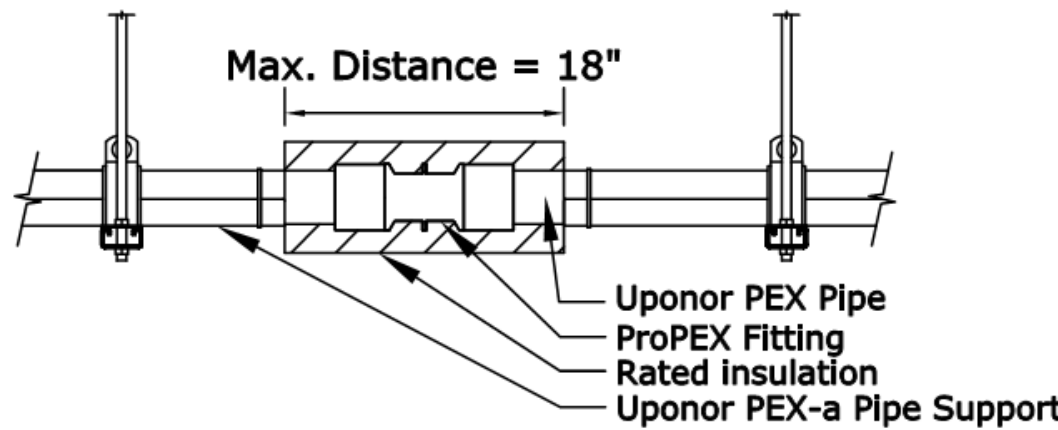

PEX-A PIPE SUPPORT INSTALLIONS IN ASTM E84 APPLICATIONS

- ASTM E84 REQUIREMENTS FOR PEX-A PIPE SUPPORT**
- UPONOR PEX-A PIPE SUPPORT HAS BEEN TESTED AND APPROVED FOR USE IN ASTM E84 APPLICATIONS. TO MEET THE REQUIREMENTS, PEX-A PIPE SUPPORT MUST BE INSTALLED PER THE FOLLOWING REQUIREMENTS:
- PIPE OR FITTINGS WITHOUT PEX-A PIPE SUPPORT SHALL BE COVERED WITH A MINIMUM 1 2" THICK INSULATION.
 - THERE IS NO MINIMUM SEGMENT LENGTH OF PEX-A PIPE SUPPORT

WHEN INSTALLED PER THE ABOVE REQUIREMENTS, THERE ARE NO SPACING LIMITATIONS BETWEEN PARALLEL PIPING RUNS.

NOTES:

THE ABOVE REQUIREMENTS ALSO APPLY TO PEX-A PIPE SUPPORT INSTALLED IN A VERTICAL POSITION FOR ASTM E84 APPLICATIONS. EXPOSED SECTIONS OF 1/2" AND 3/4" UPONOR PEX PIPE CAN BE INSTALLED UN-INSULATED IF THE PIPE RUNS ARE SEPARATED BY A MINIMUM OF 18"




EXPANSION AND CONTRACTION CONTROL WITH PEX-A PIPE SUPPORT

- WHEN PROPERLY INSTALLED, UPONOR PEX-A PIPE SUPPORT CAN REDUCE LINEAR EXPANSION AND CONTRACTION BY UP TO 93% WHEN COMPARED TO BARE-PEX PIPE. REFER TO THE FOLLOWING REQUIREMENTS:
- 300-LB. TENSILE-RATED, STAINLESS-STEEL STRAPS
 - FIXED ANCHOR POINTS INSTALLED EVERY 65 FT. FOR DOMESTIC HOT WATER APPLICATIONS.
 - FIXED ANCHOR POINTS INSTALLED EVERY 150 FT. FOR DOMESTIC COLD-WATER APPLICATIONS.

PIPING SUPPORTS: GENERAL GUIDELINES

- UPONOR RECOMMENDS USING PLASTIC OR METAL PIPING SUPPORTS DESIGNED FOR USE WITH PLASTIC PIPING.
- ALLOW FOR THE LINEAR EXPANSION RATE OF UPONOR AQUAPEX PIPING APPROXIMATELY 1.1" (28 MM) PER 10°F (5.6°C) TEMPERATURE CHANGE FOR EVERY 100' OF PIPING.
- WHEN INSTALLING PIPING RUNS, THERMAL EXPANSION CALLS FOR AN EXTRA 1/8" TO 3/16" OF LONGITUDINAL CLEARANCE PER FOOT OF RUN. DO NOT ALLOW PIPING TO DIP EXCESSIVELY BETWEEN SUPPORTS. DO NOT PULL PIPING TIGHT DURING INSTALLATION.
- ALLOW ADEQUATE CLEARANCE BETWEEN PEX PIPING AND THE STRUCTURE (BORED HOLES OR SLEEVES) TO ALLOW PIPING TO MOVE FREELY DUE TO THERMAL EXPANSION AND CONTRACTION.
- TO ENSURE LIMITED MOVEMENT OF MULTI-PORT TEES DUE TO FLOWING WATER, INSTALL A PIPE SUPPORT WITHIN 6 INCHES OF THE MULTI-PORT TEE ON THE SUPPLY PIPE RUN.

SUPPORTING UPONOR MULTI-PORT TEES

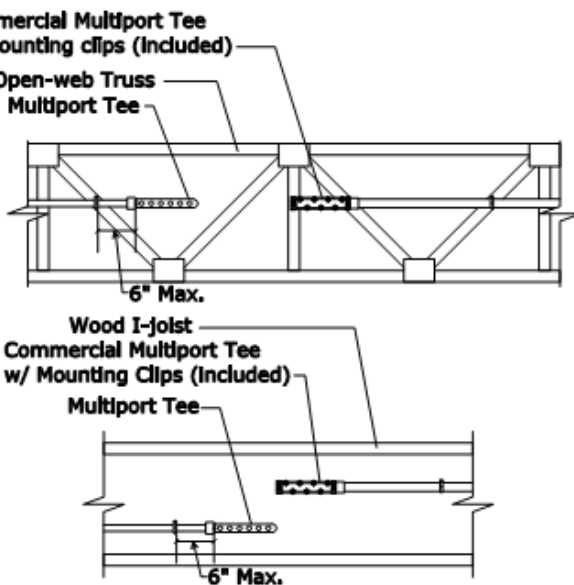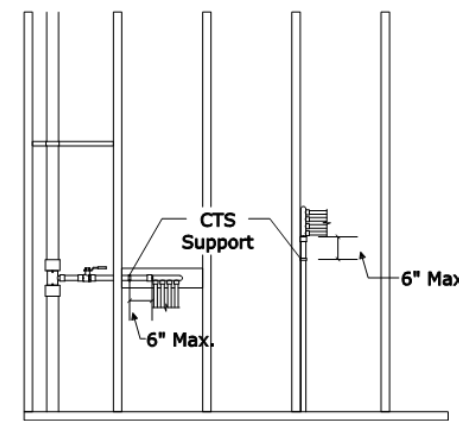
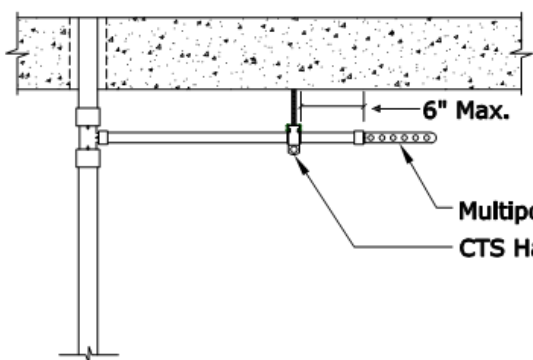


SUPPORT MULTI-PORT TEES WITHIN 6" FOR ALL INSTALLATION APPLICATIONS.

VERTICAL SUPPORT REQUIREMENTS

		Nominal Pipe Size	International Plumbing Code (IPC)	Uniform Plumbing Code (UPC)	National Plumbing Code of Canada
Vertical	In wall	All Pipe Sizes	5'-0" (1.5m)	5'-0" (1.5m)	5'-0" (1.5m)
	Risers	All Pipe Sizes	Base of each floor; provide mid-story guide	Base of each floor; provide mid-story guide	Supported at the base and floor levels of alternate stories

VERTICAL SUPPORT REQUIREMENTS CONT...

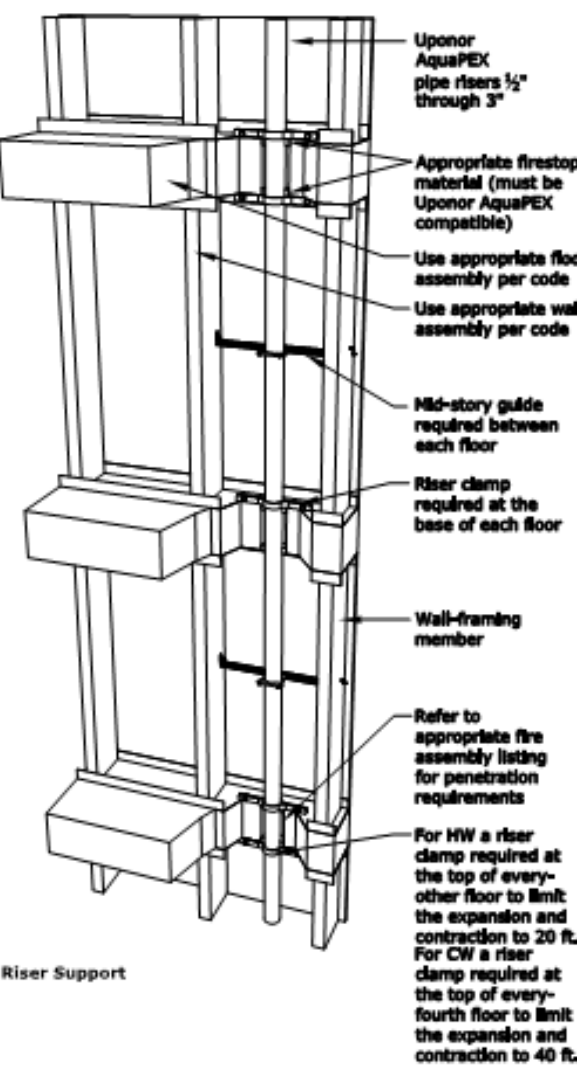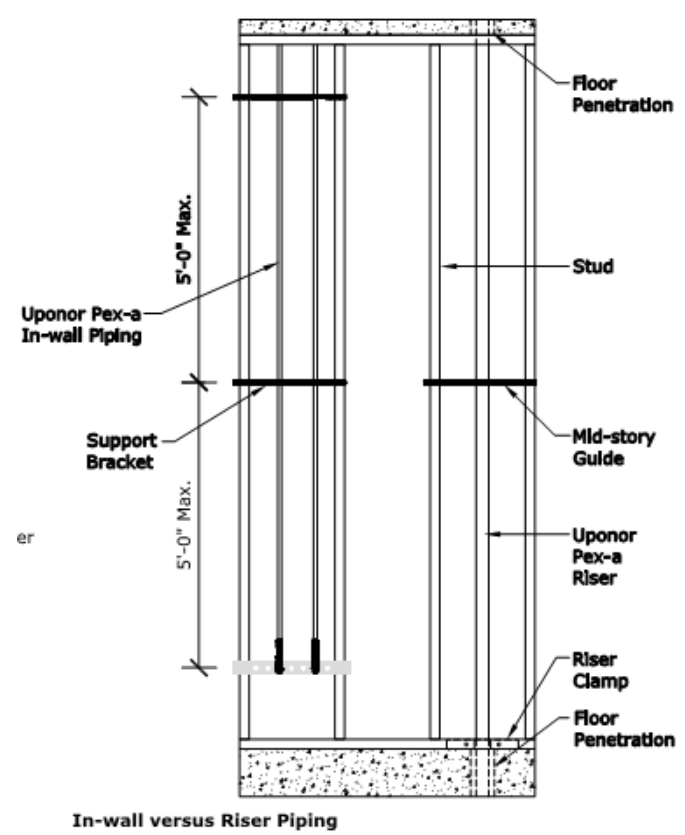

STORING AND HANDLING PEX

ALTHOUGH NOT COMPREHENSIVE, THE FOLLOWING HIGHLIGHTS THE MOST COMMON GUIDELINES WHEN STORING AND HANDLING UPONOR AQUAPEX:

- DO NOT STORE PEX PIPING OUTDOORS.
- KEEP PEX PIPING IN THE ORIGINAL PACKAGING UNTIL TIME OF INSTALLATION.
- INSTALL UPONOR SYSTEMS ACCORDING TO THE INSTALLATION INSTRUCTIONS.
- FAILURE TO FOLLOW THE INSTRUCTIONS AND INSTALLATION GUIDELINES IN THIS MANUAL CAN RESULT IN THE FAILURE OF UPONOR SYSTEMS.
- DO NOT USE UPONOR AQUAPEX PIPING WHERE TEMPERATURES AND PRESSURES EXCEED RATINGS.
- DO NOT USE OR STORE UPONOR AQUAPEX WHITE PIPING WHERE IT WILL BE EXPOSED TO DIRECT SUNLIGHT FOR MORE THAN 30 DAYS.
- DO NOT USE OR STORE UPONOR AQUAPEX RED AND BLUE PIPING WHERE IT WILL BE EXPOSED TO DIRECT SUNLIGHT FOR MORE THAN 90 DAYS.
- DO NOT WELD, GLUE OR USE ADHESIVES OR ADHESIVE TAPE WITH UPONOR AQUAPEX PIPING.

NOTE: YOU MAY TEMPORARILY AFFIX ADHESIVE TAPE TO UPONOR AQUAPEX PIPING DURING INSTALLATION. HOWEVER, TO PROTECT THE INTEGRITY OF THE SYSTEM, THE TAPE SHOULD NOT BE PERMANENT. REMOVE THE TAPE AND RESIDUAL ADHESIVE AFTER COMPLETING THE INSTALLATION.

- DO NOT APPLY OPEN FLAME TO UPONOR AQUAPEX PIPING.
- DO NOT INSTALL UPONOR AQUAPEX PIPING WITHIN SIX INCHES OF ANY GAS APPLIANCE VENTS. ONE EXCEPTION IS DOUBLE-WALL B-VENTS, WHICH HAVE A MINIMUM CLEARANCE OF ONE INCH.
- DO NOT INSTALL UPONOR AQUAPEX PIPING WITHIN 12" OF ANY RECESSED LIGHT FIXTURE UNLESS THE PEX PIPING LINE IS PROTECTED WITH SUITABLE INSULATION OR THE CAN LIGHT IS INSULATION CONTACT (I.C.) RATED.
- DO NOT INSTALL UPONOR AQUAPEX PIPING WITHIN 5 FT. OF DIRECT VIEW FROM FLUORESCENT LIGHTING WITHOUT SLEEVING THE PIPE WITH A UV-BLOCKING MATERIAL.
- DO NOT USE UPONOR AQUAPEX PIPING TO CONVEY NATURAL GAS.
- DO NOT SOLDER, BRAZE, WELD OR FUSION-WELD WITHIN 18" OF ANY UPONOR AQUAPEX PIPING IN THE SAME WATER LINE. MAKE ANY HEAT-RELATED CONNECTIONS PRIOR TO MAKING THE PROPEX CONNECTION.
- DO NOT INSTALL UPONOR AQUAPEX PIPING BETWEEN THE TUB/SHOWER VALVE AND TUB SPOUT.
- DO NOT USE UPONOR AQUAPEX PIPING FOR AN ELECTRICAL GROUND.
- DO NOT SPRAY ON OR ALLOW ORGANIC CHEMICALS, STRONG ACIDS OR STRONG BASES TO COME INTO CONTACT WITH UPONOR AQUAPEX PIPING.
- DO NOT USE PETROLEUM OR SOLVENT BASED PAINTS, GREASES OR SEALANTS ON UPONOR AQUAPEX PIPING.
- USE ONLY APPROVED AND APPROPRIATE FIRESTOP MATERIALS WITHIN UPONOR AQUAPEX PIPING.
- DO NOT ALLOW RODENTS, INSECTS OR OTHER PESTS TO COME INTO CONTACT WITH UPONOR AQUAPEX PIPING.
- DO NOT SUBJECT UPONOR AQUAPEX PIPING TO BLUNT IMPACT.
- DO NOT INSTALL UPONOR AQUAPEX PIPING IN SOIL ENVIRONMENTS CONTAMINATED WITH SOLVENTS, FUELS, ORGANIC COMPOUNDS, PESTICIDES OR OTHER DETRIMENTAL MATERIALS THAT MAY CAUSE PERMEATION, CORROSION, DEGRADATION OR STRUCTURAL FAILURE OF THE PIPING. WHERE SUCH CONDITIONS ARE SUSPECTED, PERFORM A CHEMICAL ANALYSIS OF THE SOIL OR GROUNDWATER TO ASCERTAIN THE ACCEPTABILITY OF UPONOR AQUAPEX PIPING FOR THE SPECIFIC INSTALLATION. CHECK LOCAL CODES FOR ADDITIONAL REQUIREMENTS.
- DO NOT PRESS PROPEX BRASS FITTINGS (I.E. COPPER PRESS).
- AQUAPEX PIPING PASSING THROUGH DRILLED OR NOTCHED METAL STUDS OR JOISTS OR HOLLOW SHELL MASONRY WALLS SHALL BE PROTECTED FROM ABRASION BY ELASTOMERIC OR PLASTIC SLEEVES OR GROMMETS.

NOTE: WHEN TRANSITIONING FROM PEX TO OTHER PIPING MATERIALS, FOLLOW THE APPROPRIATE INSTALLATION INSTRUCTIONS FOR THAT PRODUCT.

STRAPPING REQUIREMENTS FOR UPONOR AQUAPEX PIPE RUNS

- STEEL STRAPS MUST BE COATED OR HAVE NO SHARP EDGES.
- CABLE TIES SHALL NOT BE USED FOR SUSPENSION ALONE.
- PIPING SHALL BE ISOLATED FROM OTHER MEP SYSTEMS BY MEANS OF INSULATION OR STAND-OFF BRACKETS.
- FOR HOT-WATER APPLICATIONS, UPONOR RECOMMENDS A STRAPPING MATERIAL SUITABLE FOR THE APPLICATION (I.E. UV, HIGH TEMPERATURE)
- APPROVED STRAPPING MATERIALS INCLUDE:
- PIPE TALONS
- CLAMPS
- STAND-OFF BRACKETS
- NYLON BANDING AND CABLE TIES (50 LB. MIN.) SUITED FOR THE APPLICATION

PEX PIPE CALCULATIONS

CALCULATION & SIZING TABLE-120° HW & HWR

Enter Your Domestic Water Supply Parameters:

75	Pressure Available at Building	Calculation:	+ 75.00 PSI
30	Min. Fixture Working Pressure	-	30.00 PSI
60	Static Loss - System Height (ft.)	60.00 x 0.433	- 25.98 PSI
0	Additional Component Loss	-	0.00 PSI

Available Pressure For Friction Loss = 19.02 PSI

Enter Your Piping Supply Information:

400	Longest Run to Fixture (ft.)	Calculation:	+ 400.00 FT
25	Fitting Allowance (% of number above)	+ 100.00 FT	

Total Developed Length = 500.00 FT

Friction Loss Rate Per Foot (Friction Loss / TDL) = 0.038 PSI/FT

Friction Loss Rate per 100 Feet (Friction Loss / TDL * 100) = 3.804 PSI/100FT

Enter Your System Parameters for Each Table:

A	B	C	Water Size Table Temperature (°F)
60	120	110	
10	8	2	Max. Velocity Per Water Temp (ft./sec.)
FT	FT	FT	WSFU Predominant Fixture Curve

Choose the code that your state or local AHJ has adopted. State specific codes are only listed if the fixture unit to gpm conversion differs from a model code.

Water Size Chart for Uponor AquaPEX:

Uponor AquaPEX Water Size Table UPC - Flush Tank 100% Water @ 60°F 3.804 PSI/100ft. Max. Velocity = 10 ft./sec.				Uponor AquaPEX Water Size Table UPC - Flush Tank 100% Water @ 120°F 3.804 PSI/100ft. Max. Velocity = 8 ft./sec.				Uponor AquaPEX Water Size Table UPC - Flush Tank 100% Water @ 110°F 3.804 PSI/100ft. Max. Velocity = 2 ft./sec.			
Pipe Size	WSFU Range	Velocity (ft./sec.)	GPM	Pipe Size	WSFU Range	Velocity (ft./sec.)	GPM	Pipe Size	WSFU Range	Velocity (ft./sec.)	GPM
3/8"	0-0	2.10	0.63	3/8"	0-0	2.30	0.69	3/8"	0-0	2.00	0.60
1/2"	0-0	2.60	1.44	1/2"	0-0	2.90	1.60	1/2"	0-0	2.00	1.10
3/4"	1-3	3.30	3.64	3/4"	1-4	3.70	4.08	3/4"	1-1	2.00	2.20
1"	4-8	4.00	7.28	1"	5-10	4.40	8.00	1"	2-3	2.00	3.64
1 1/4"	9-16	4.60	12.51	1 1/4"	11-19	5.10	13.87	1 1/4"	4-6	2.00	5.44
1 1/2"	17-29	5.20	19.70	1 1/2"	20-33	5.70	21.60	1 1/2"	7-9	2.00	7.58
2"	30-87	6.20	40.28	2"	34-103	6.80	44.18	2"	10-17	2.00	12.99
2 1/2"	88-232	7.20	71.29	2 1/2"	104-260	7.80	77.23	2 1/2"	18-29	2.00	19.80
3"	233-450	8.10	114.04	3"	261-443	8.00	112.63	3"	30-49	2.00	28.16

CALCULATION & SIZING TABLE-140° HW & HWR

Enter Your Domestic Water Supply Parameters:

75	Pressure Available at Building	Calculation:	+ 75.00 PSI
30	Min. Fixture Working Pressure	-	30.00 PSI
0	Static Loss - System Height (ft.)	0.00 x 0.433	- 0.00 PSI
0	Additional Component Loss	-	0.00 PSI

Available Pressure For Friction Loss = 45.00 PSI

Enter Your Piping Supply Information:

200	Longest Run to Fixture (ft.)	Calculation:	+ 200.00 FT
25	Fitting Allowance (% of number above)	+ 50.00 FT	

Total Developed Length = 250.00 FT

Friction Loss Rate Per Foot (Friction Loss / TDL) = 0.180 PSI/FT

Friction Loss Rate per 100 Feet (Friction Loss / TDL * 100) = 18.000 PSI/100FT


Enter Your System Parameters for Each Table:

A	B	C	Water Size Table Temperature (°F)
60	140	130	
10	8	2	Max. Velocity Per Water Temp (ft./sec.)
FT	FT	FT	WSFU Predominant Fixture Curve

Choose the code that your state or local AHJ has adopted. State specific codes are only listed if the fixture unit to gpm conversion differs from a model code.

Water Size Chart for Uponor AquaPEX:

Uponor AquaPEX Water Size Table UPC - Flush Tank 100% Water @ 140°F 18.000 PSI/100ft. Max. Velocity = 8 ft./sec.				Uponor AquaPEX Water Size Table UPC - Flush Tank 100% Water @ 130°F 18.000 PSI/100ft. Max. Velocity = 2 ft./sec.			
Pipe Size	WSFU Range	Velocity (ft./sec.)	GPM	Pipe Size	WSFU Range	Velocity (ft./sec.)	GPM
3/8"	0-0	5.80	1.74	3/8"	0-0	2.00	0.60
1/2"	1-3	7.20	3.98	1/2"	0-0	2.00	1.10
3/4"	4-11	8.00	8.82	3/4"	1-1	2.00	2.20
1"	12-20	8.00	14.55	1"	2-3	2.00	3.64
1 1/4"	21-33	8.00	21.76	1 1/4"	4-6	2.00	5.44
1 1/2"	34-54	8.00	30.31	1 1/2"	7-9	2.00	7.58
2"	55-134	8.00	51.97	2"	10-17	2.00	12.99
2 1/2"	135-270	8.00	79.21	2 1/2"	18-29	2.00	19.80
3"	271-443	8.00	112.63	3"	30-49	2.00	28.16

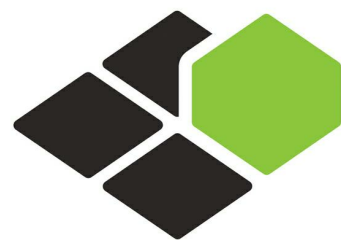


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Seal:



Owner:



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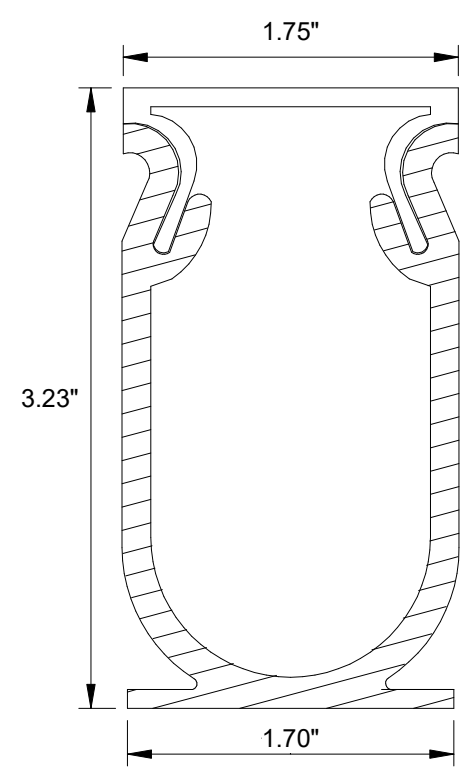
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B4-124-1803

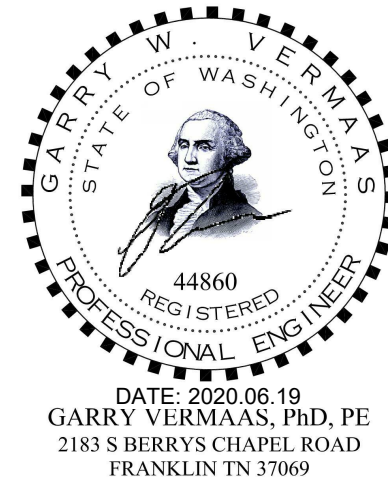SHEET NAME

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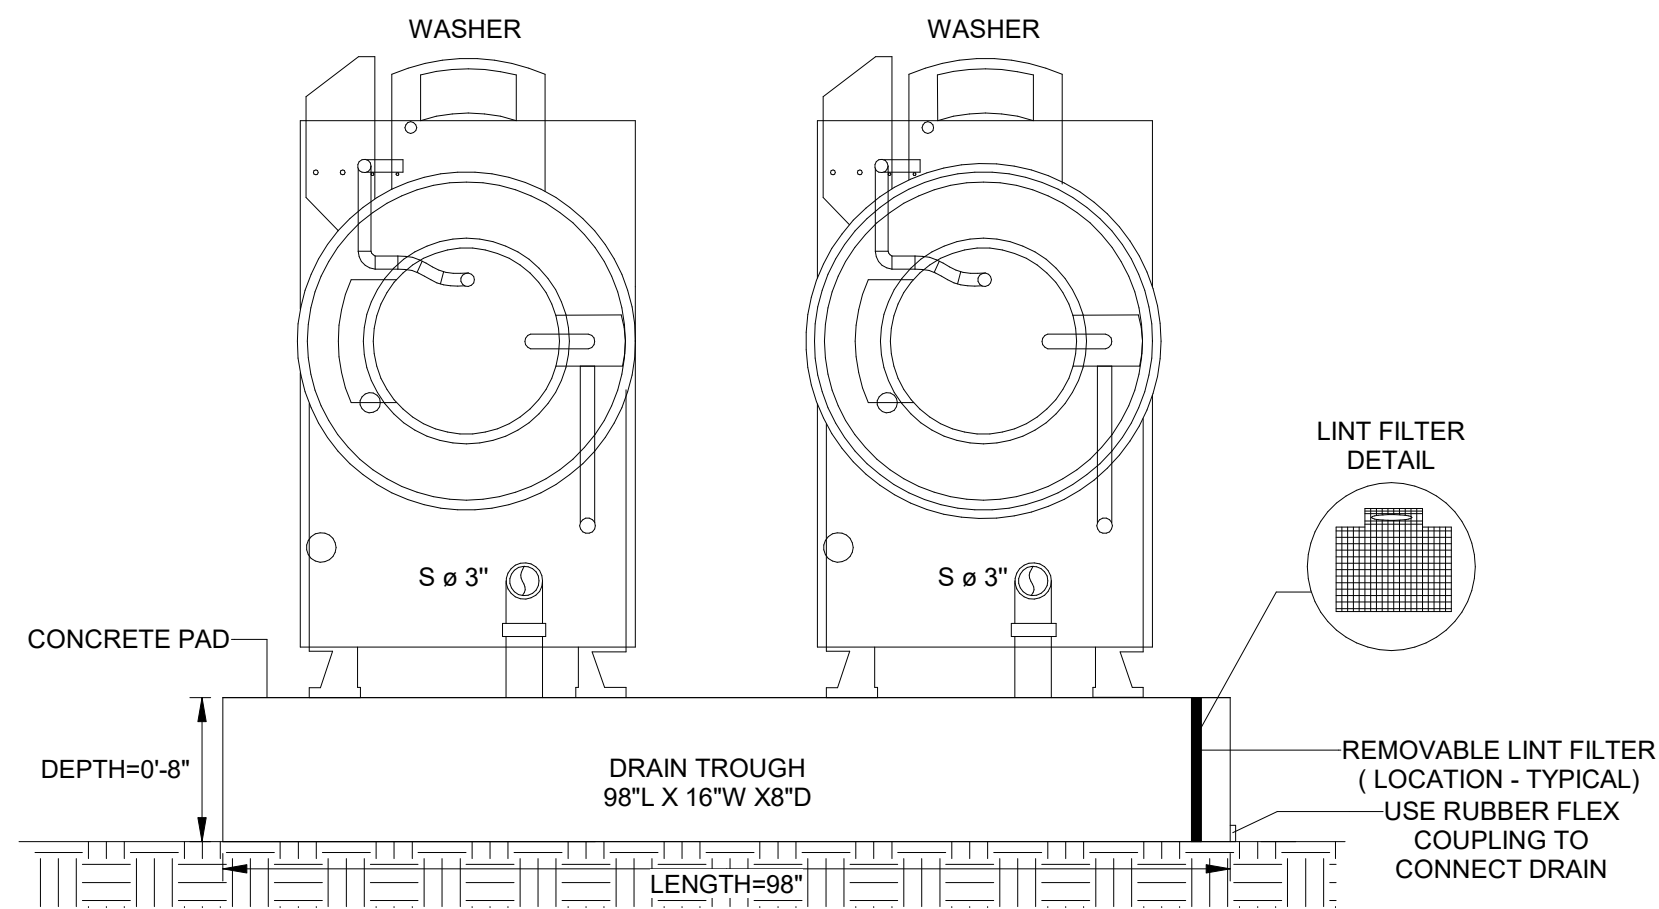
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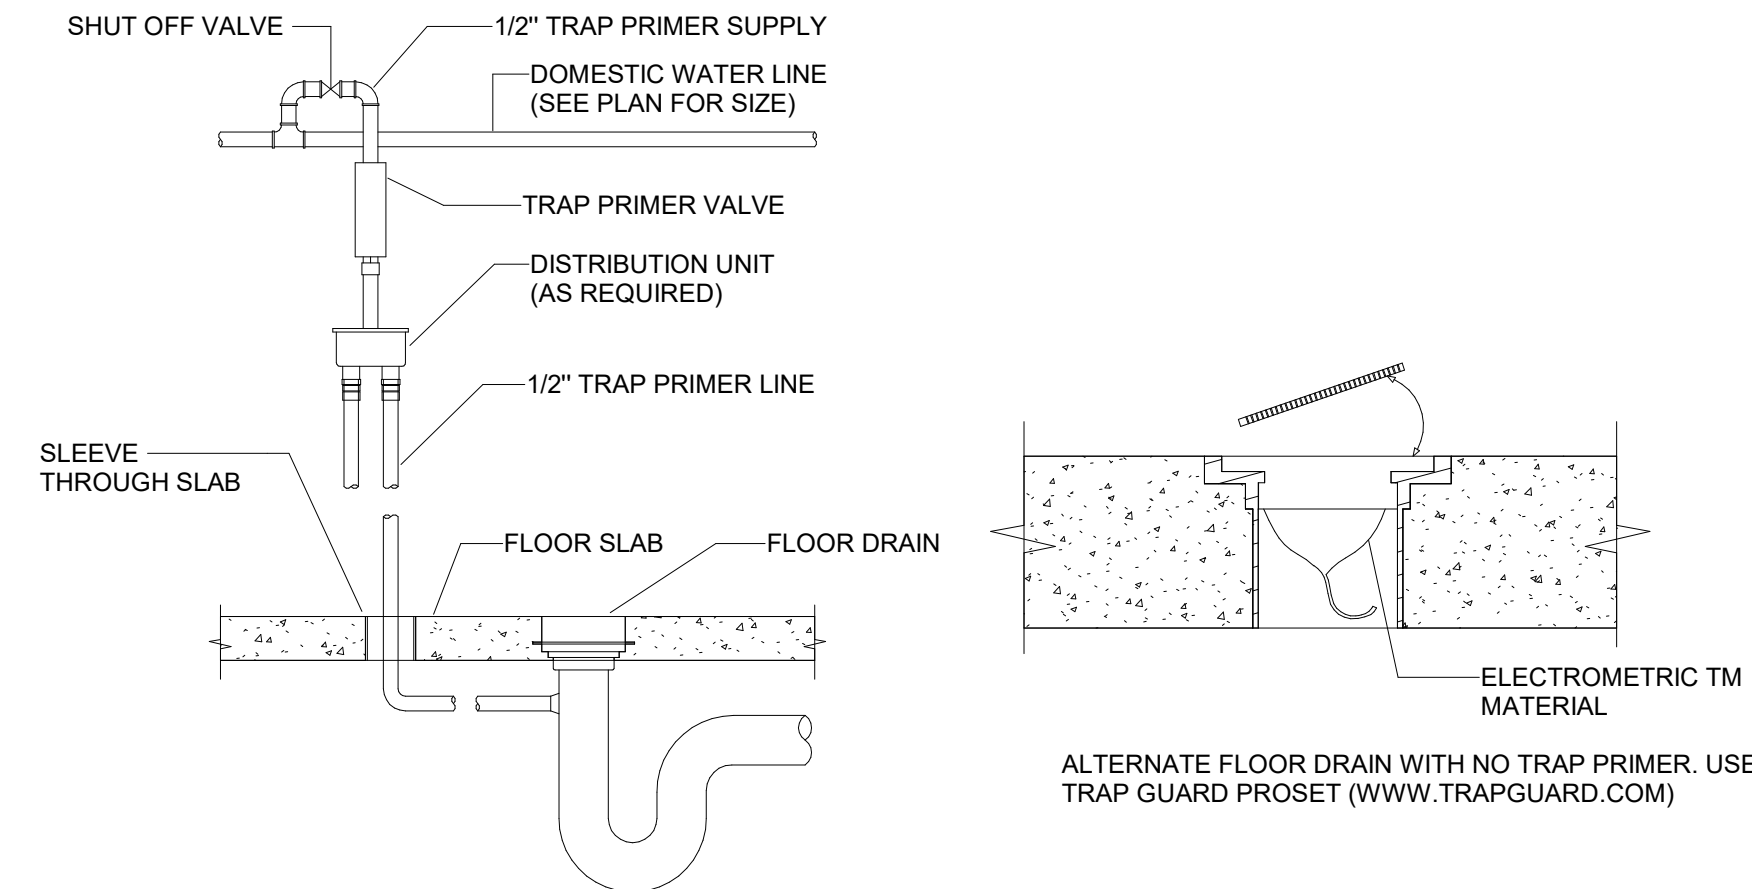
DECK DRAIN SPECIFICATIONS

1. THE FRONTIER DECK DRAIN IS A REMOVABLE TOP DRAIN THAT FEATURES A DOUBLE WALL BASE AND A SNAP IN TOP. WHEN INSTALLING THIS DRAIN, THE TOPS ARE STAGGERED PAST THE JOINTS MAKING THE JOINTS VERY RIGID. BECAUSE FRONTIER DECK DRAIN TOPS ARE REMOVABLE, THIS DRAIN IS EASY TO CLEAN AND THE TOPS CAN BE REPLACED IF EVER DAMAGED. IT IS RECOMMENDED THAT YOU DRILL AND PIN (3/8\"/>
2. MAXIMUM FLOW RATE OF 9.3 GPM PER FOOT.
3. FITTINGS CONSIST OF 45 AND 90 DEGREE ANGLES, TEES, CROSSES, END ADAPTERS, END PLUGS, DOWN ADAPTERS, AND SIDE ADAPTERS.
4. CARTON INCLUDES 80\"/>
5. INSTALLATION TO BE COMPLETED IN ACCORDANCE WITH MANUFACTURERS SPECIFICATIONS.
6. FINAL COLOR SELECTION BY OWNER.


6 DECK DRAIN DETAIL
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4 WASHERS AND DRAN TROUGH INSTALLATION DETAIL
NTS




1 TRAP PRIMER & TRAP GUARD DRAIN INSERT DETAIL
NTS



NOTES:

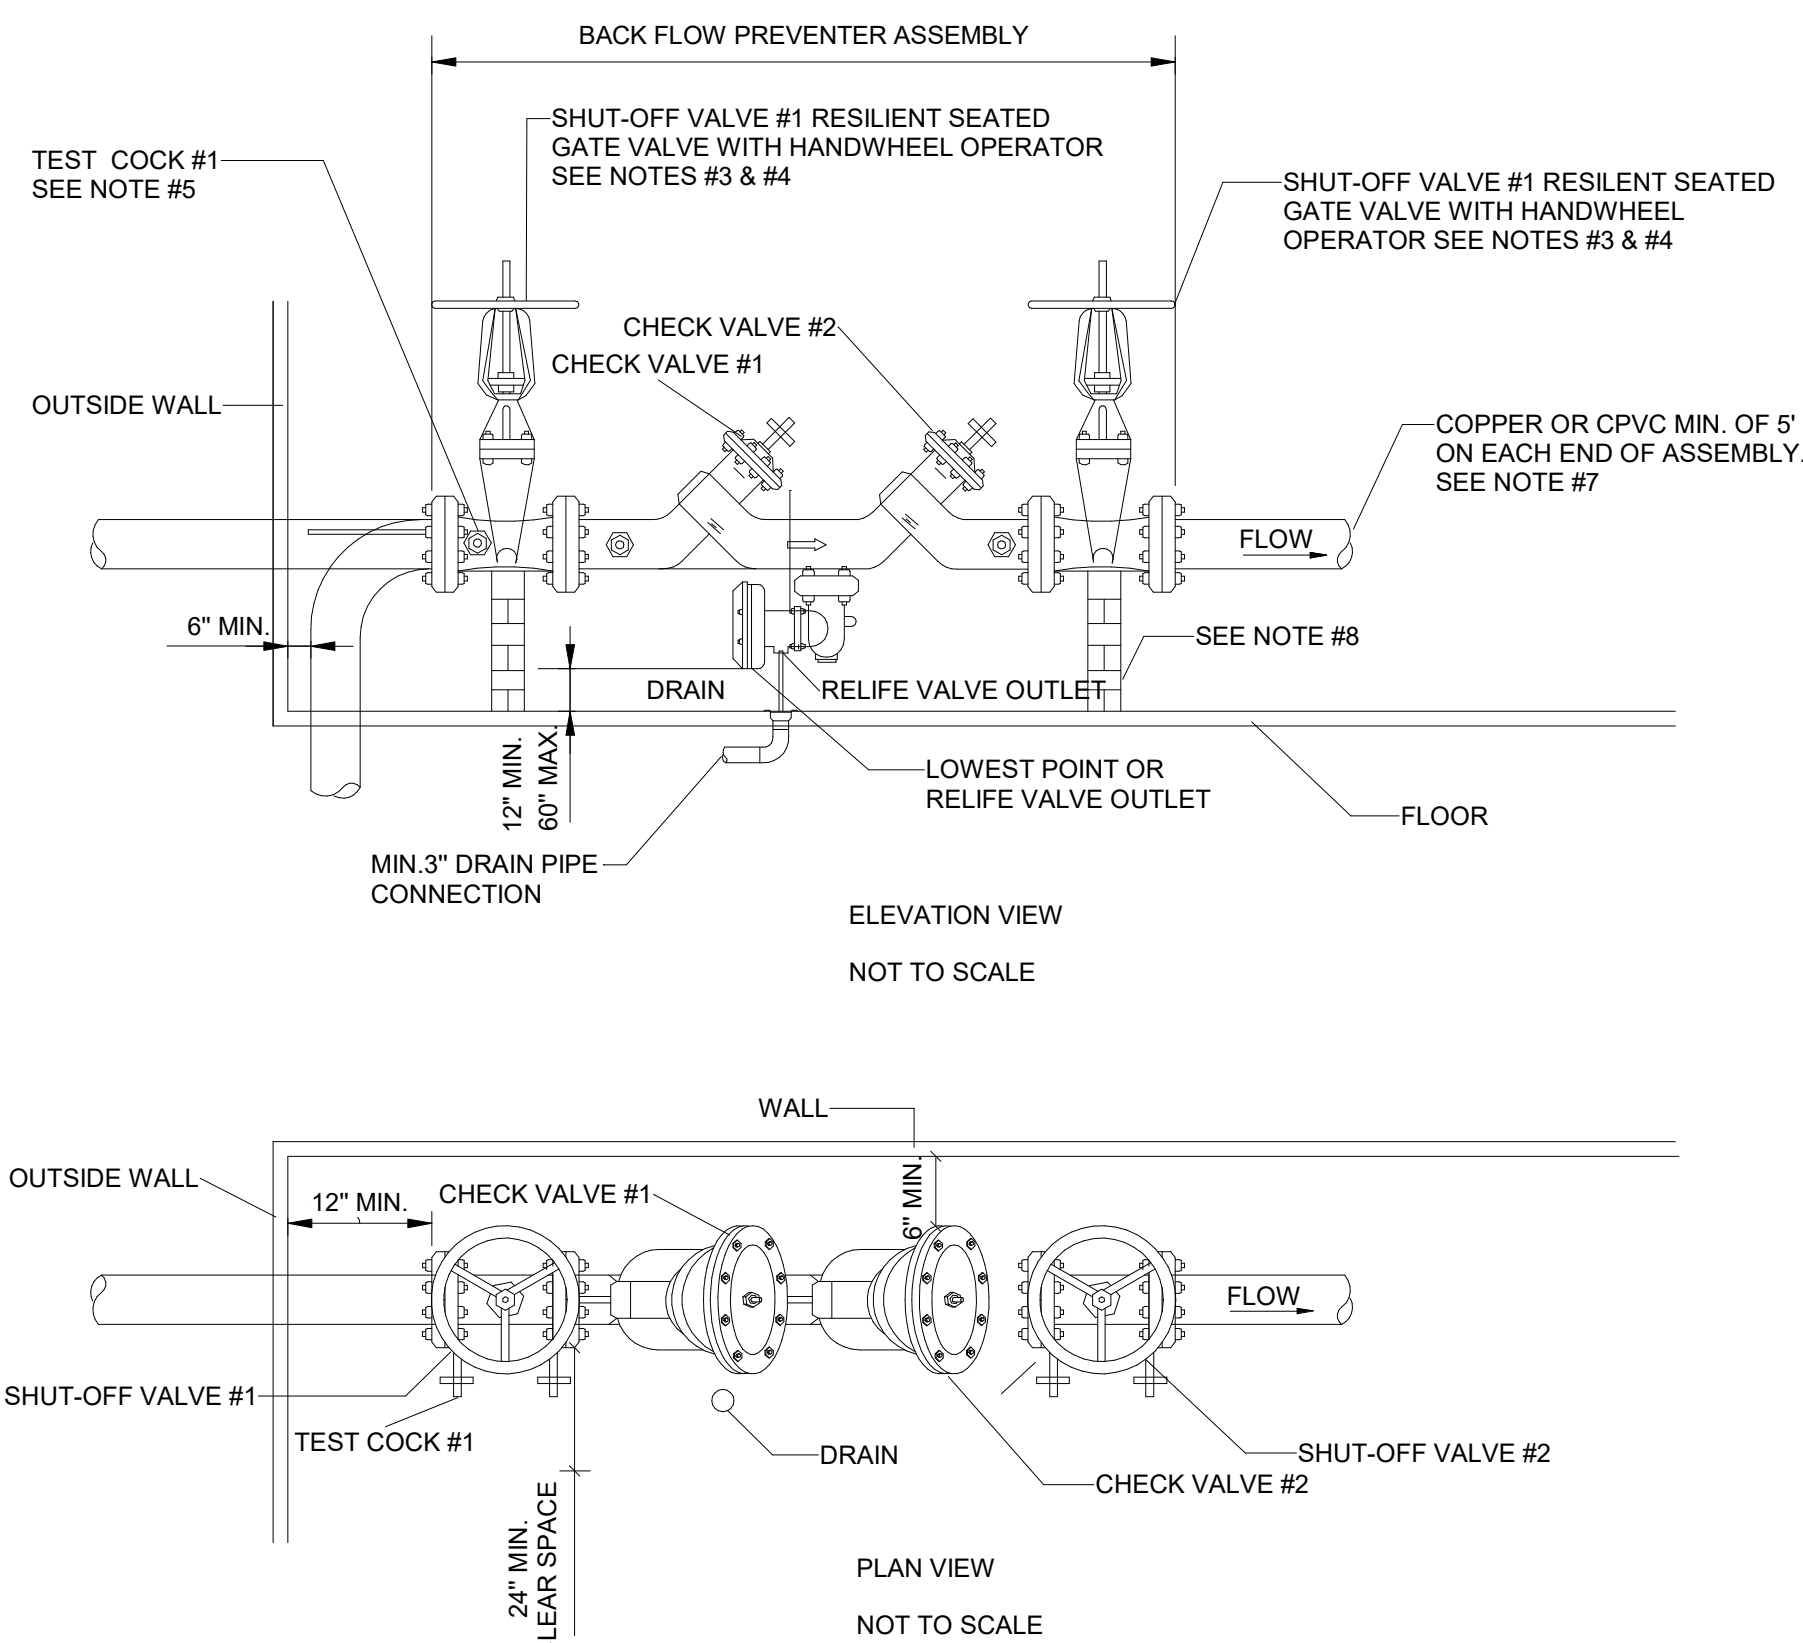
1. INDOOR INSTALLATION SHALL ONLY BE PERMITTED IN CASES WHERE ADEQUATE SPACE FOR THE BACKFLOW PREVENTION ASSEMBLY IS NOT AVAILABLE OUTSIDE.OWNER WILL REVIEW ON A CASE BY CASE BASIS.
2. BACK FLOW PREVENTER ASSEMBLY (BFPA).
3. APPROVED BFPA INCLUDES SHUT-OFF VALVE.
4. TEST COCK #1 SHALL BE UPSTREAM OF SHUT-OFF VALVE #1 AND IS PART OF THE APPROVED ASSEMBLY.
5. ASSEMBLIES SHALL BE INSTALLED AS UPRIGHT AND IN THE HORIZONTAL POSITION UNLESS OTHERWISE APPROVED.
6. PIPE MATERIAL AND FITTINGS SHALL BE AS SPECIFIED STANDARDS & SPECIFICATIONS.
7. SUPPORT FOR ASSEMBLY SHALL BE DESIGNED BY GENERAL CONTRACTOR. IT IS RECOMMENDED 8\"/>
8. AN AIR GAP DRAIN IS RECOMMENDED TO REDUCE SPLASHING OF MINOR DISCHARGES FROM THE RELIEF VALVE DRAIN PORT.
9. ALL LOCATIONS FOR BFPA'S REQUIRE OWNER APPROVAL.
10. NO TAPS, BRANCHES,FHS OR OTHER ACCESSORIES ARE PERMITTED ON THE PIPING BETWEEN THE BFPA & METER.

7 BACKFLOW PREVENTER DETAIL
NTS

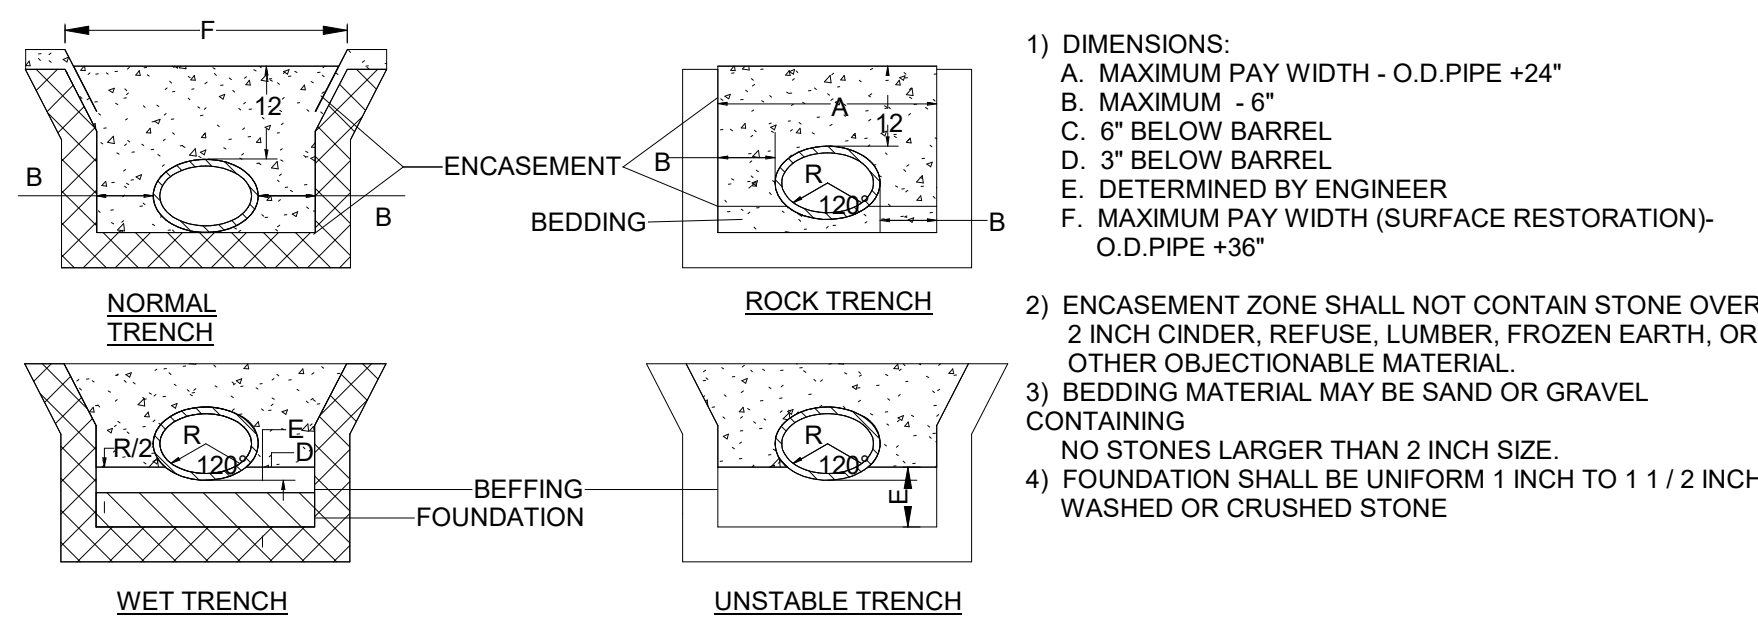

5 TRENCH SECTIONS FOR WATER MAINS
NTS

- 1) DIMENSIONS:
A. MAXIMUM PAY WIDTH - O.D.PIPE +24"
B. MAXIMUM - 6"
C. 6\"/>
- 2) ENCASEMENT ZONE SHALL NOT CONTAIN STONE OVER 2 INCH CINDER, REFUSE, LUMBER, FROZEN EARTH, OR OTHER OBJECTIONABLE MATERIAL.
- 3) BEDDING MATERIAL MAY BE SAND OR GRAVEL CONTAINING NO STONES LARGER THAN 2 INCH SIZE.
- 4) FOUNDATION SHALL BE UNIFORM 1 INCH TO 1 1/2 INCH WASHED OR CRUSHED STONE

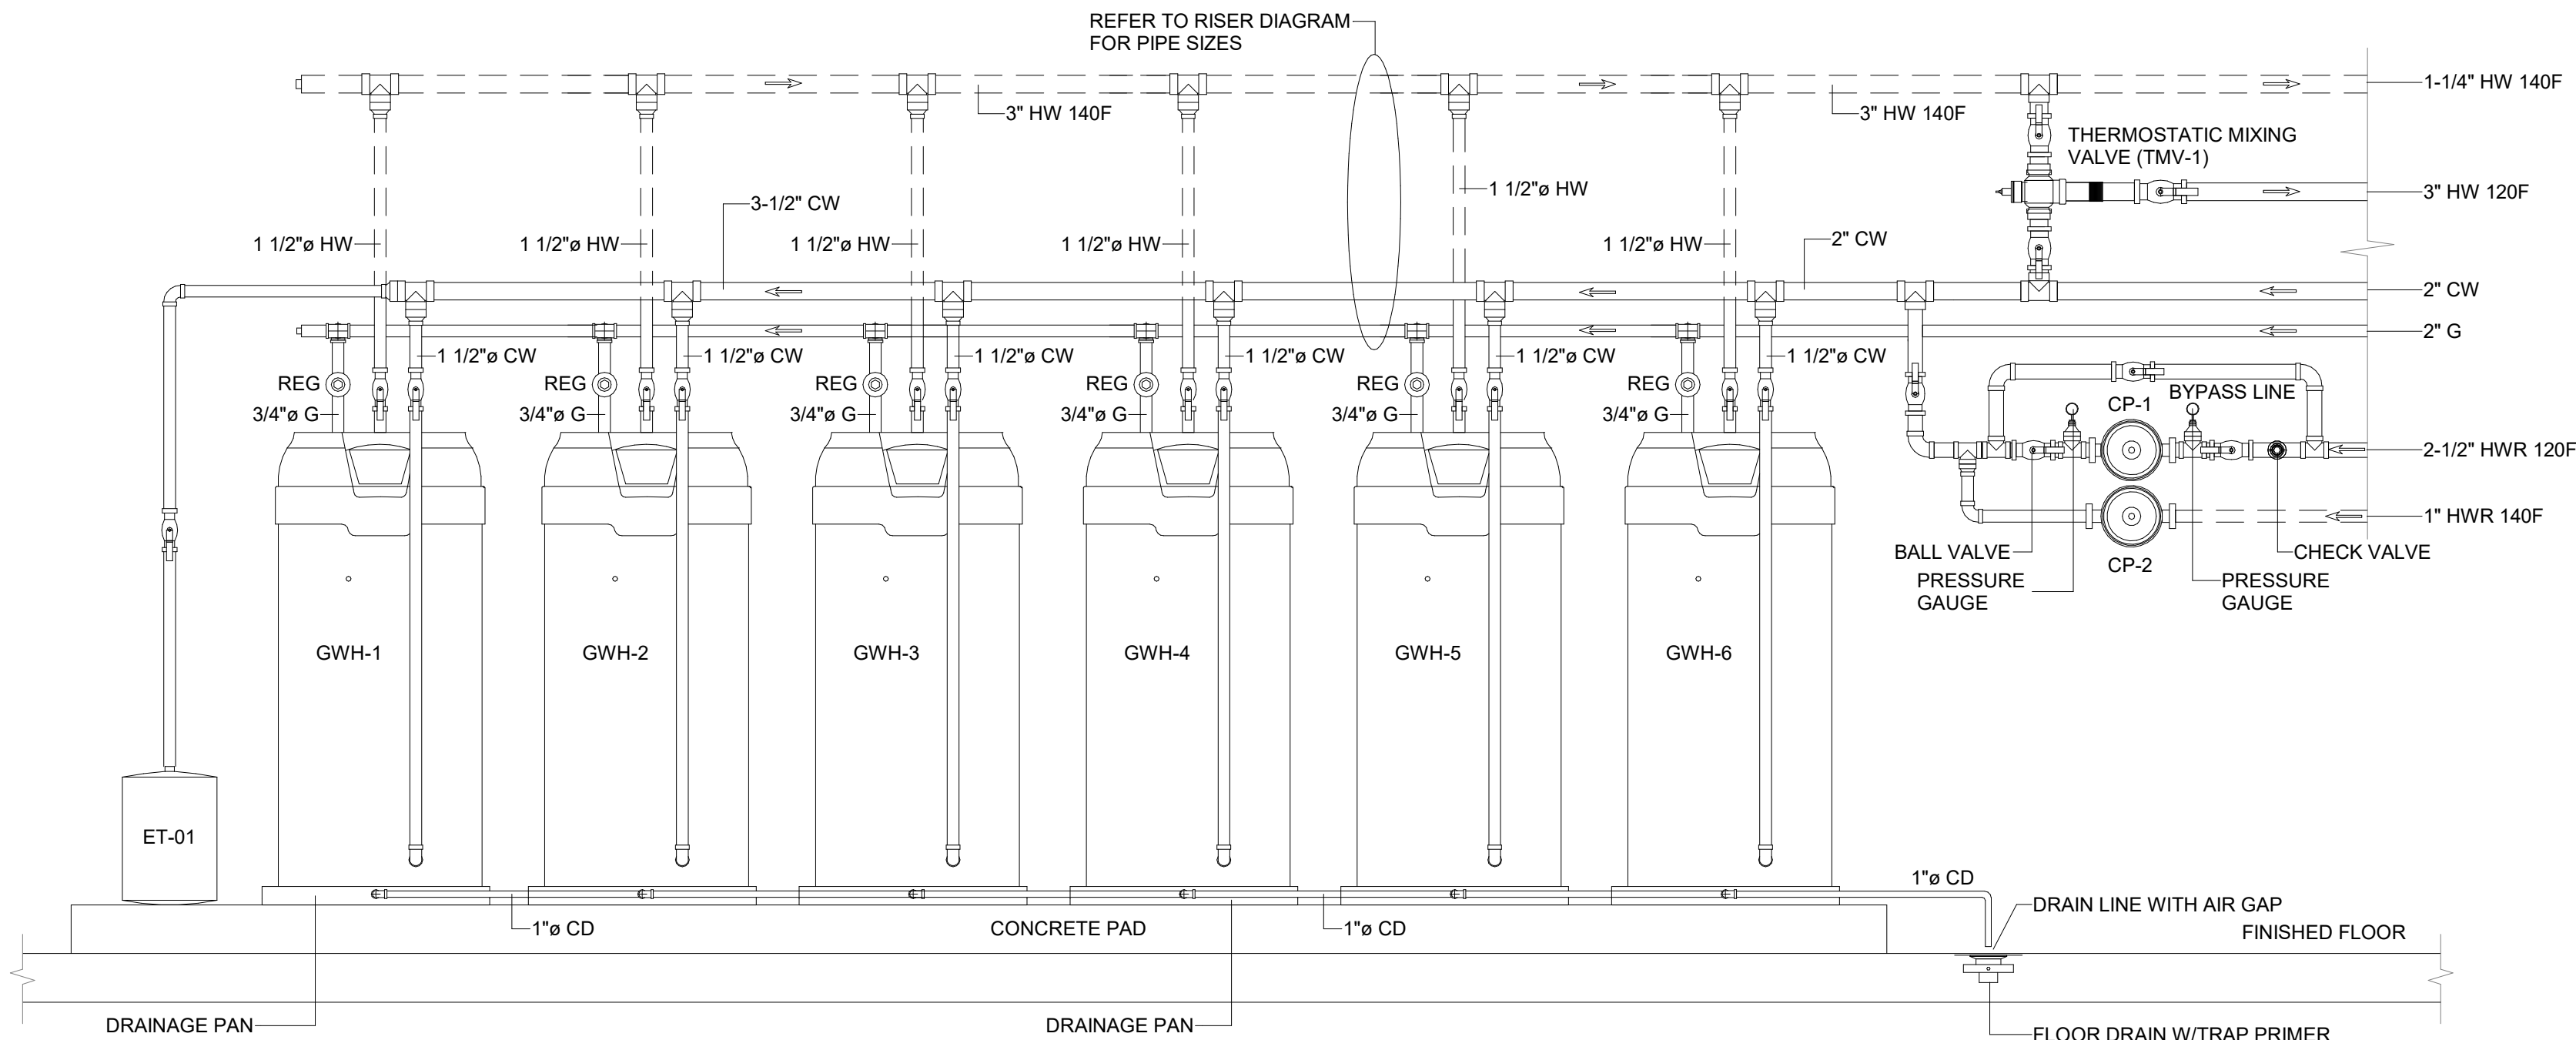

3 WATER HEATERS INSTALLATION DETAIL
NTS

- NOTE:
1. REFER TO MECHANICAL DWG'S FOR ROUTING OF GAS FIRED WATER HEATERS INTAKE & EXHAUST FLUES.
 2. VALVE BOTH SYSTEMS TOGETHER SUCH THAT EACH SYSTEM CAN BACK UP THE OTHER IN EMERGENCIES.
 3. USE AO SMITH CYCLONE WATER HEATERS WITH MANIFOLD SYSTEM PER MANUFACTURER'S REQUIREMENTS.
 4. CONTRACTOR SHOULD PROVIDE NON-PLASTIC DRAIN PAN FOR ALL GAS FUELED WATER HEATERS. AND DRAIN PAN SHALL CONNECT TO THE NEAREST FLOOR DRAIN.
 5. REFER TO PLUMBING SHEET P-401 FOR WATER HEATER SPECIFICATIONS.

B-20-0180
City of Puyallup




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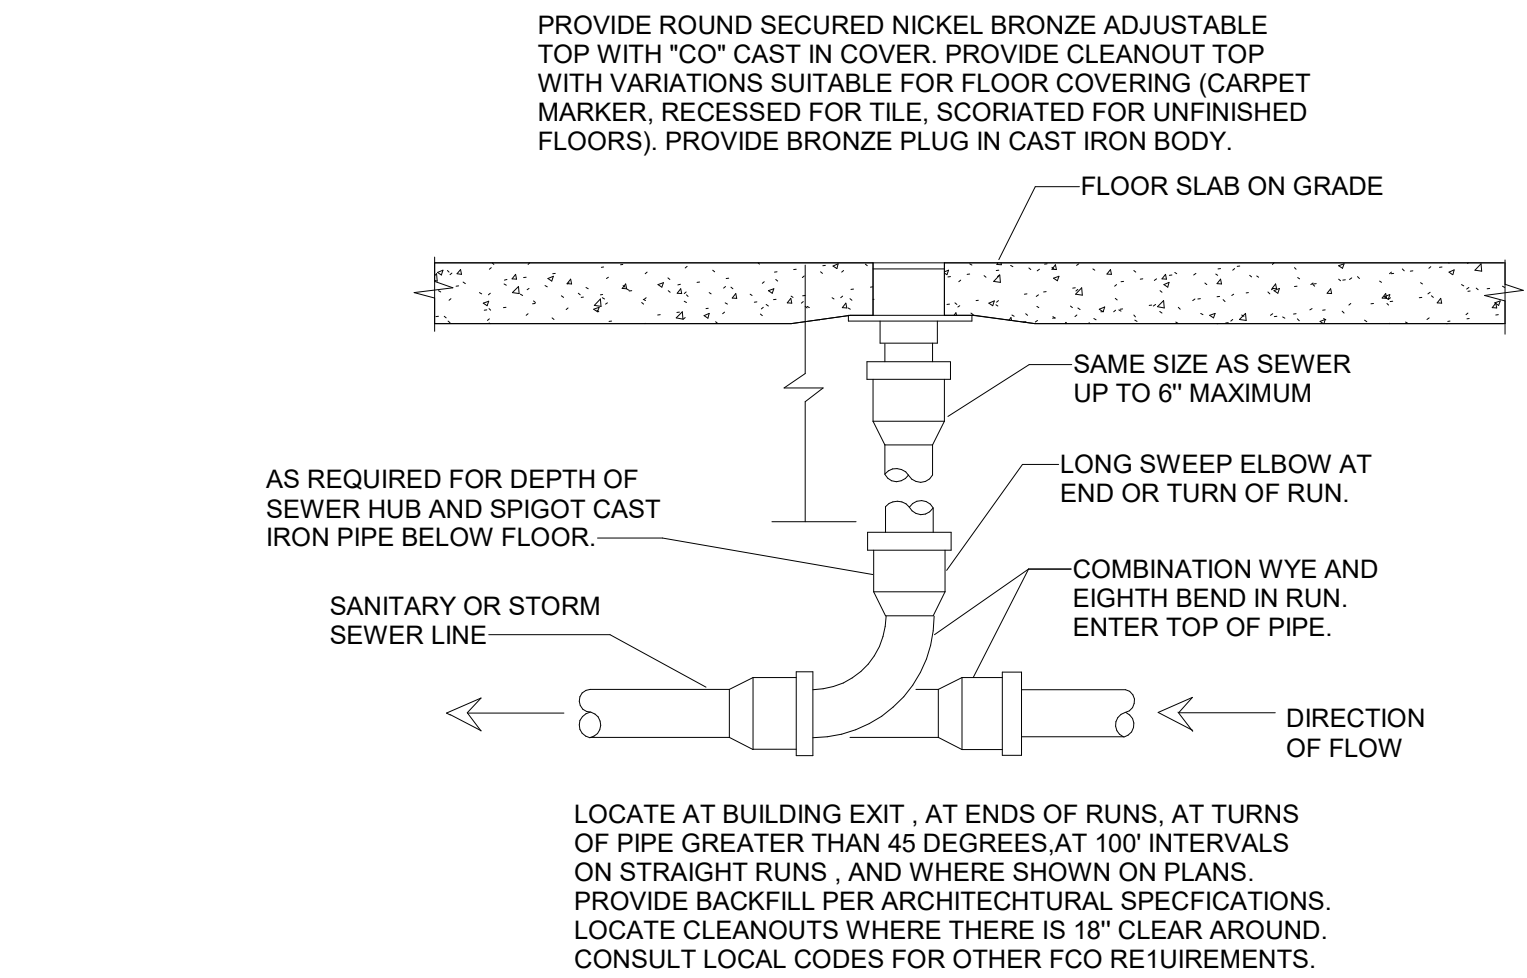
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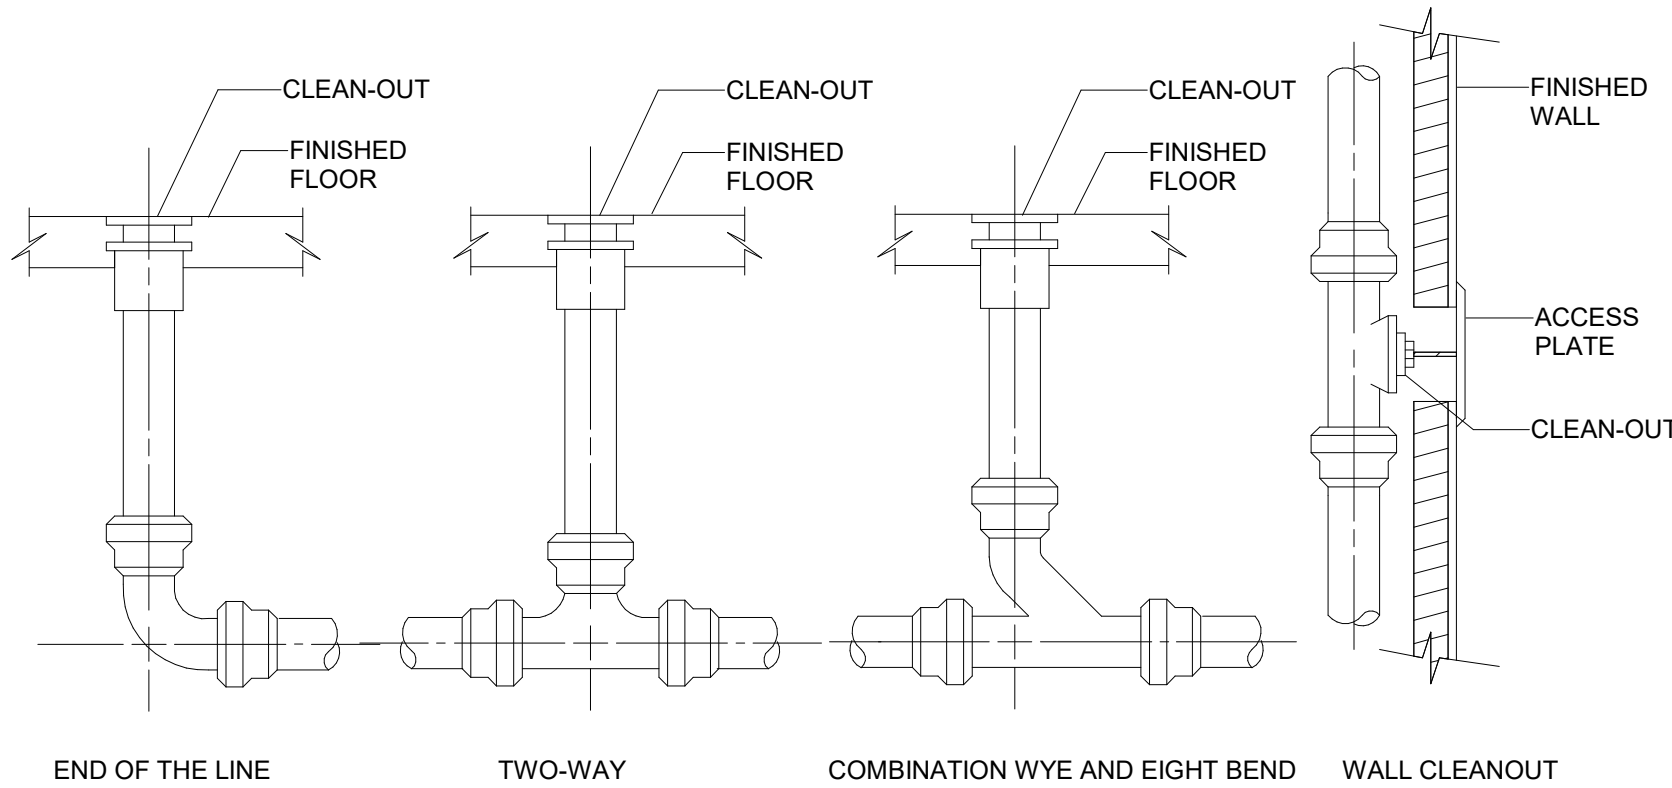
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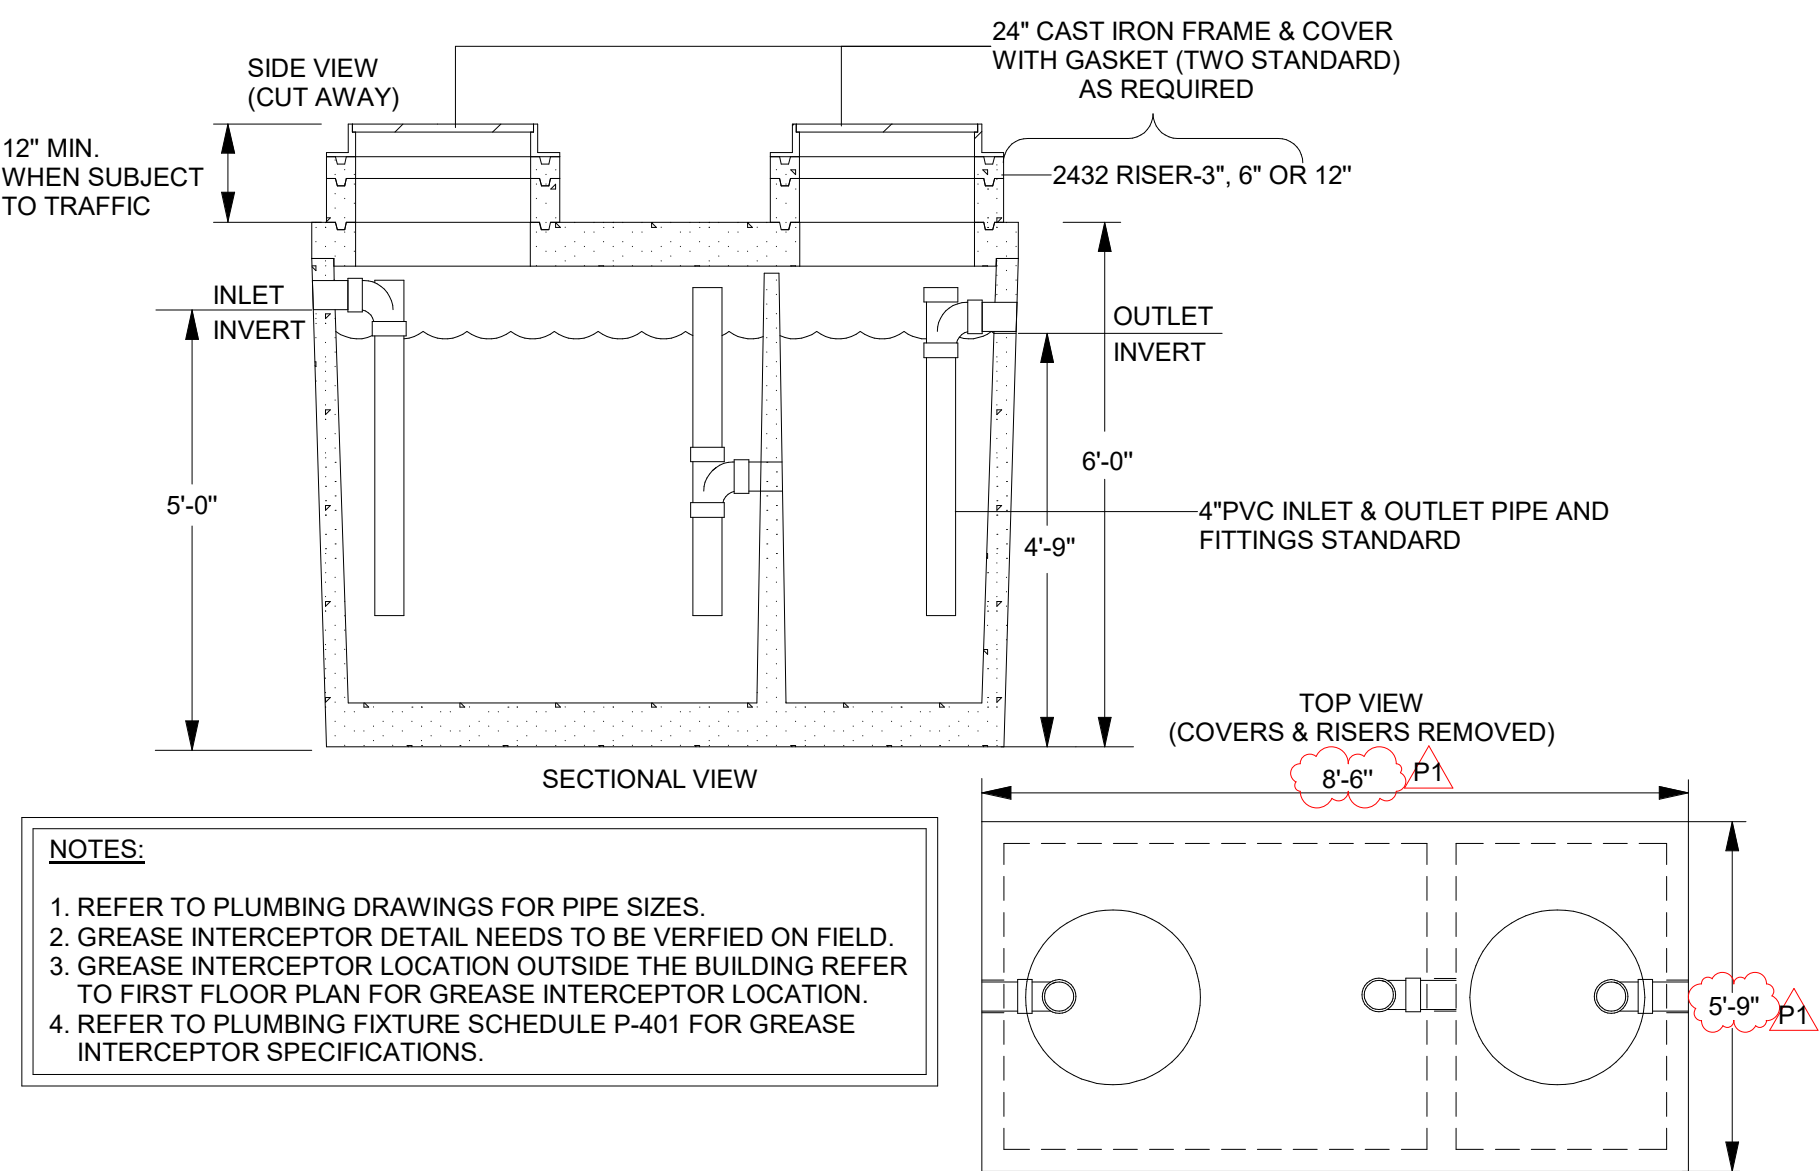
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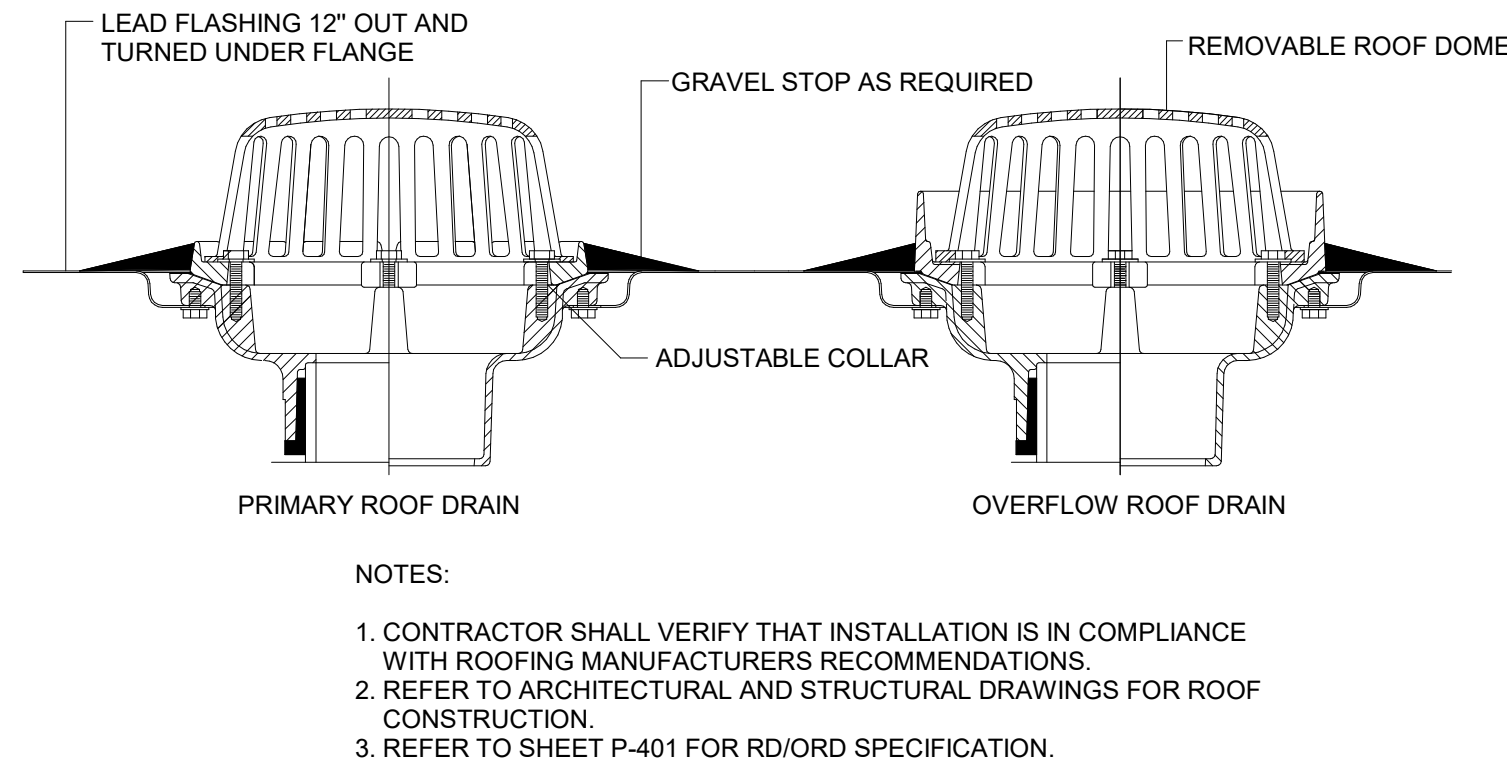
10 FLOOR CLEANOUT DETAIL
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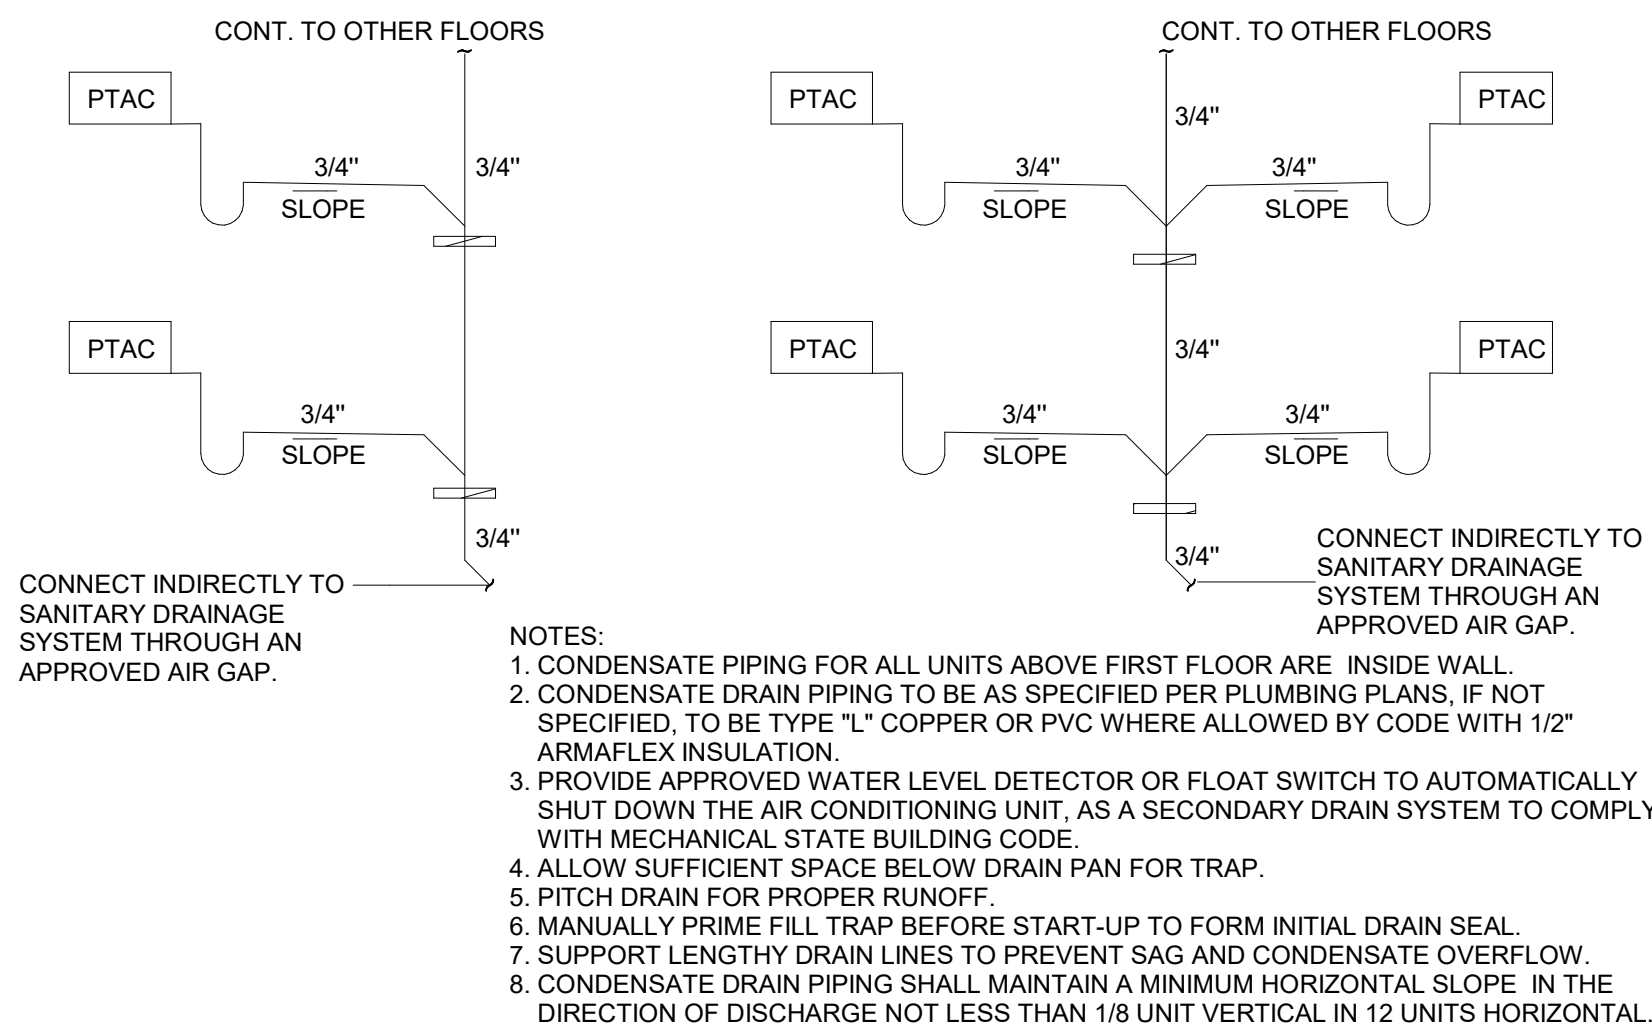
11 FLOOR & WALL CLEANOUTS
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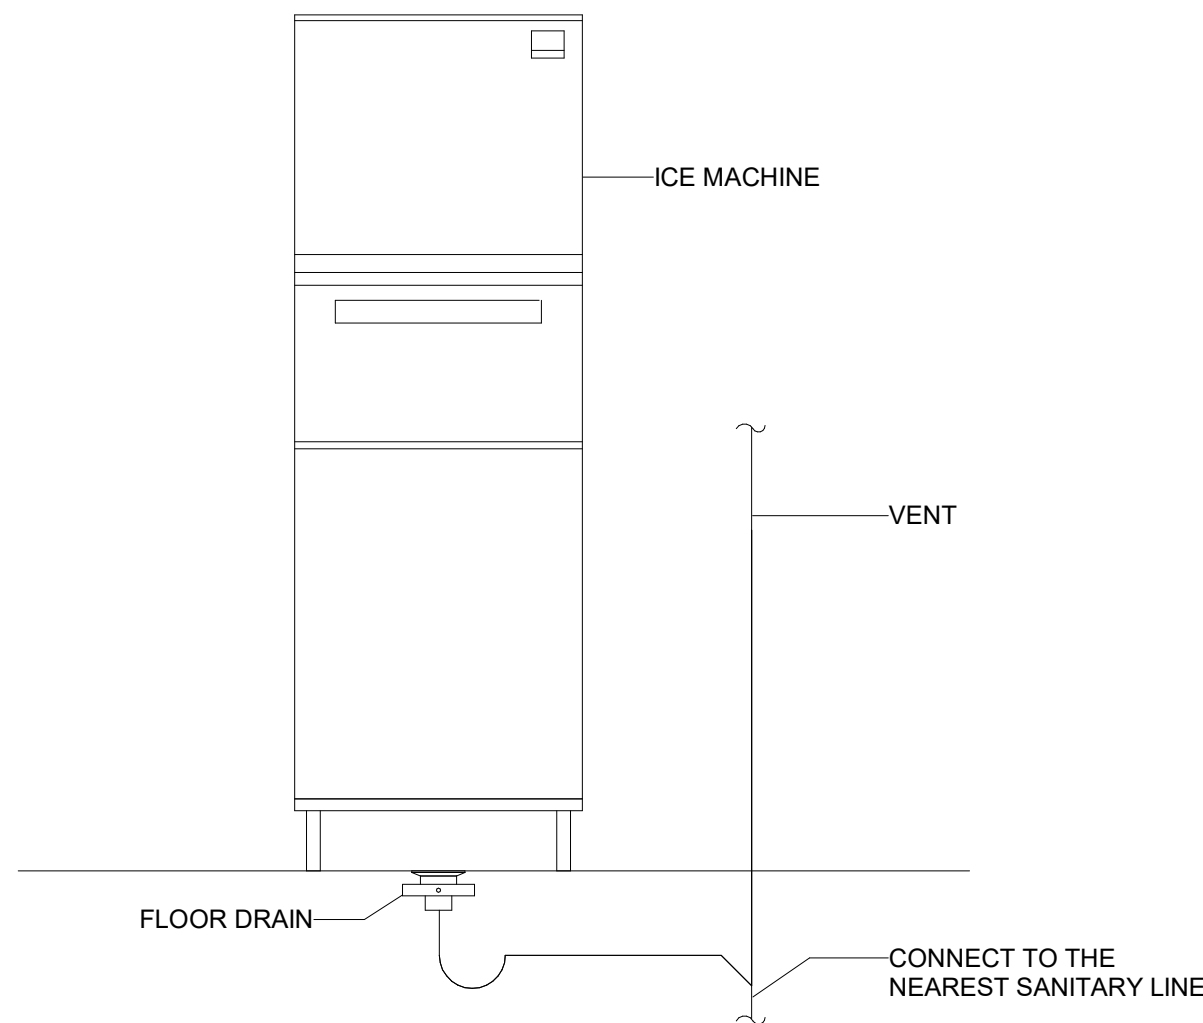
12 GREASE INTERCEPTOR DETAIL
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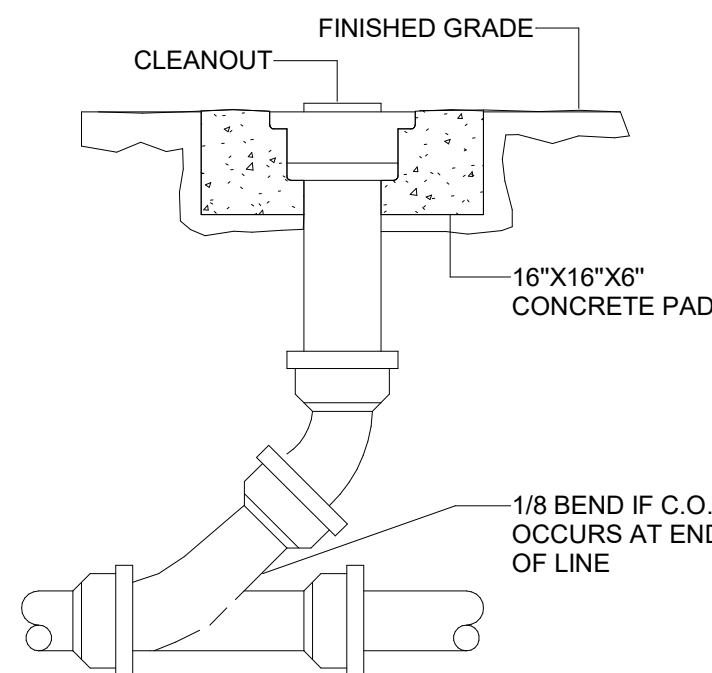
7 PRIMARY AND OVERFLOW ROOF DRAIN DETAIL
NTS




8 PTAC CONDENSATE DETAIL
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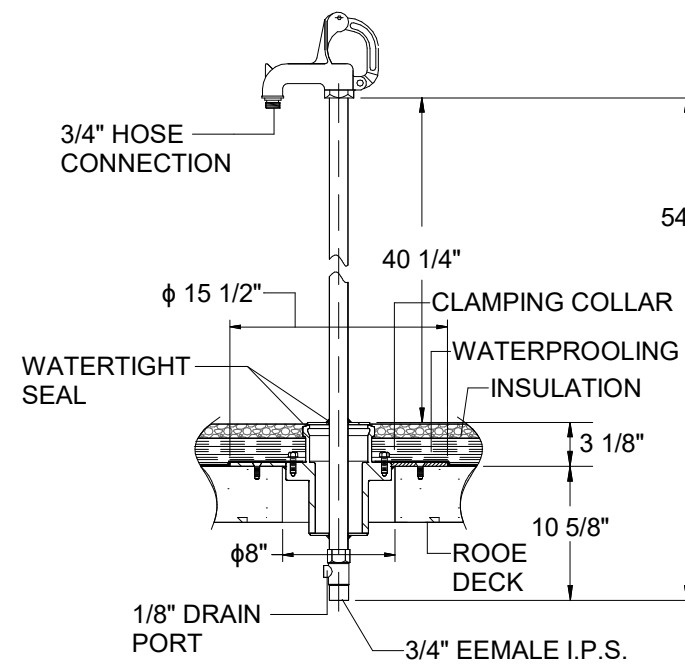
4 ICE MAKER DRAINAGE PIPING DETAIL
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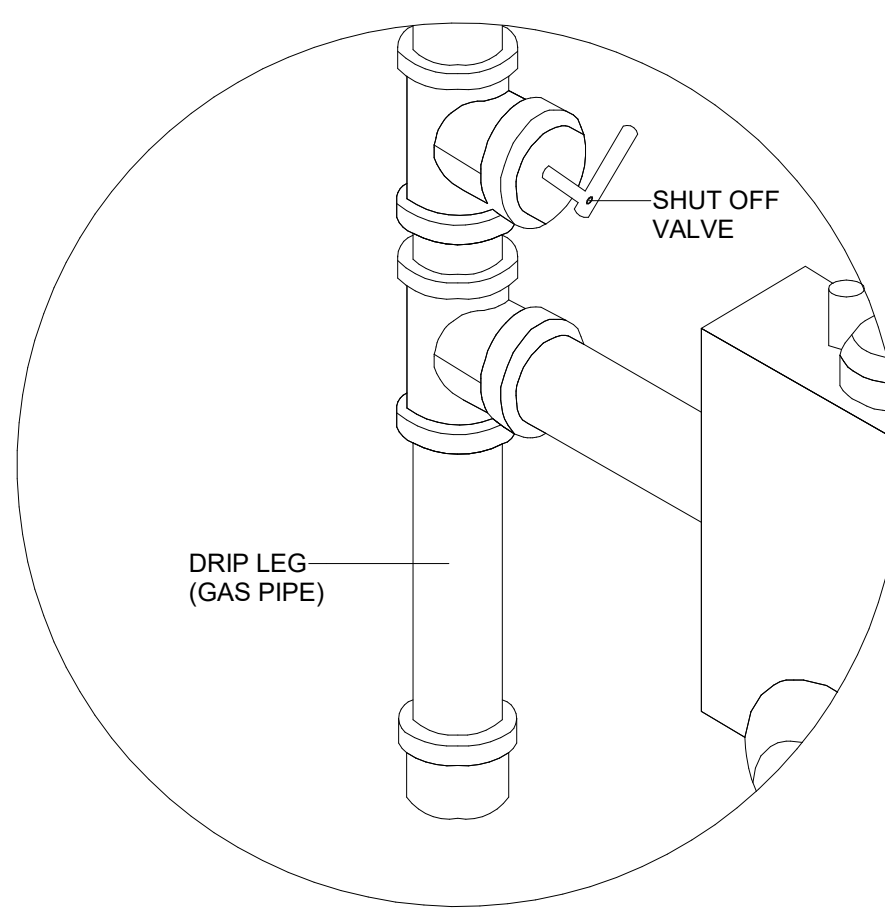
5 CLEANOUT TO GRADE
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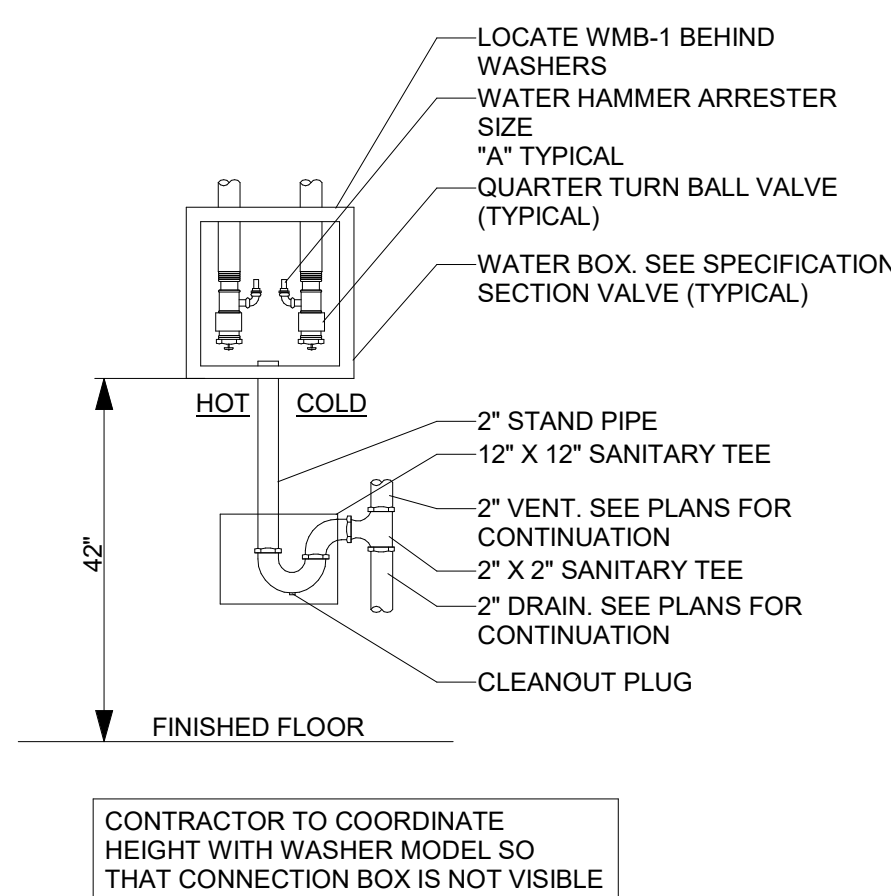
1 WATER PIPING HANGER DETAIL
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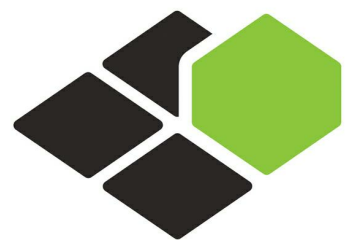
2 ROOF HYDRANT DETAIL
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6 GAS TEST PORT AND SHUT-OFF VALVE DETAIL
NTS



3 GREY BOX DETAIL
NTS

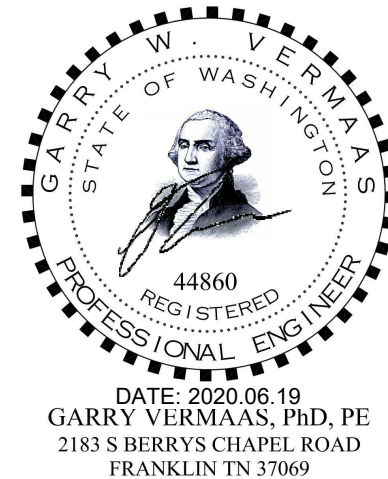


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Owner:

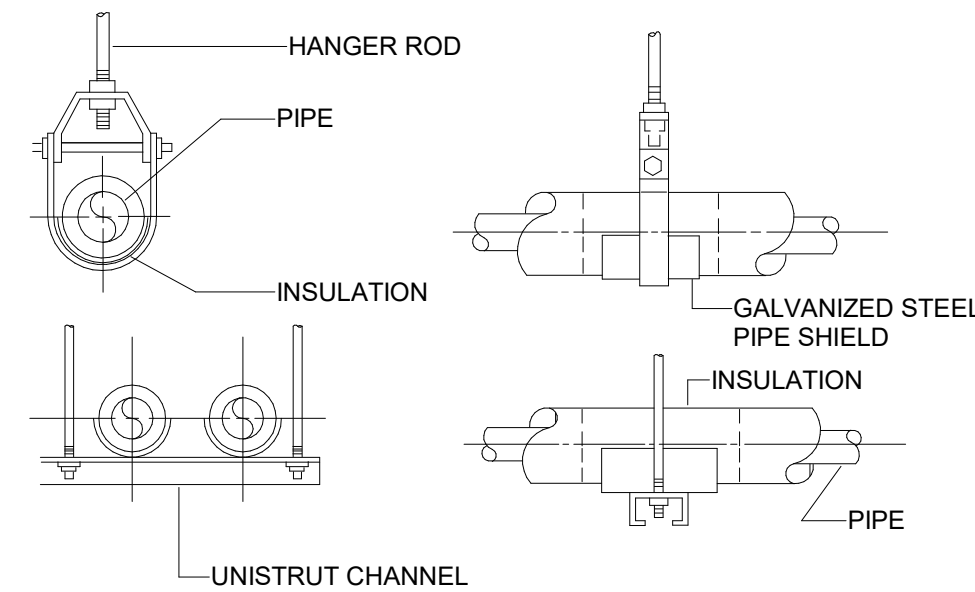

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PROTOTYPE VERSION: V9.2 2014 FEB

ISSUE NO.	DELTA	ISSUE DATE	DESCRIPTION
2	P1	2020.06.03	ADDENDUM #1
1	P0	2020.02.21	ISSUED FOR PERMIT

B-20-0180
City of Puyallup
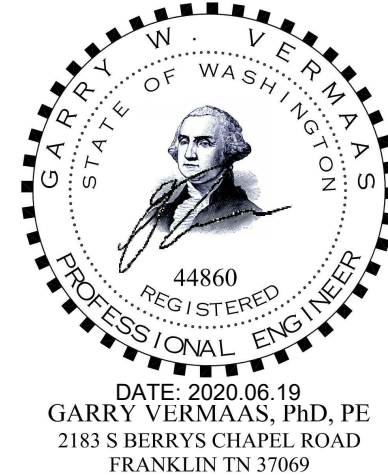
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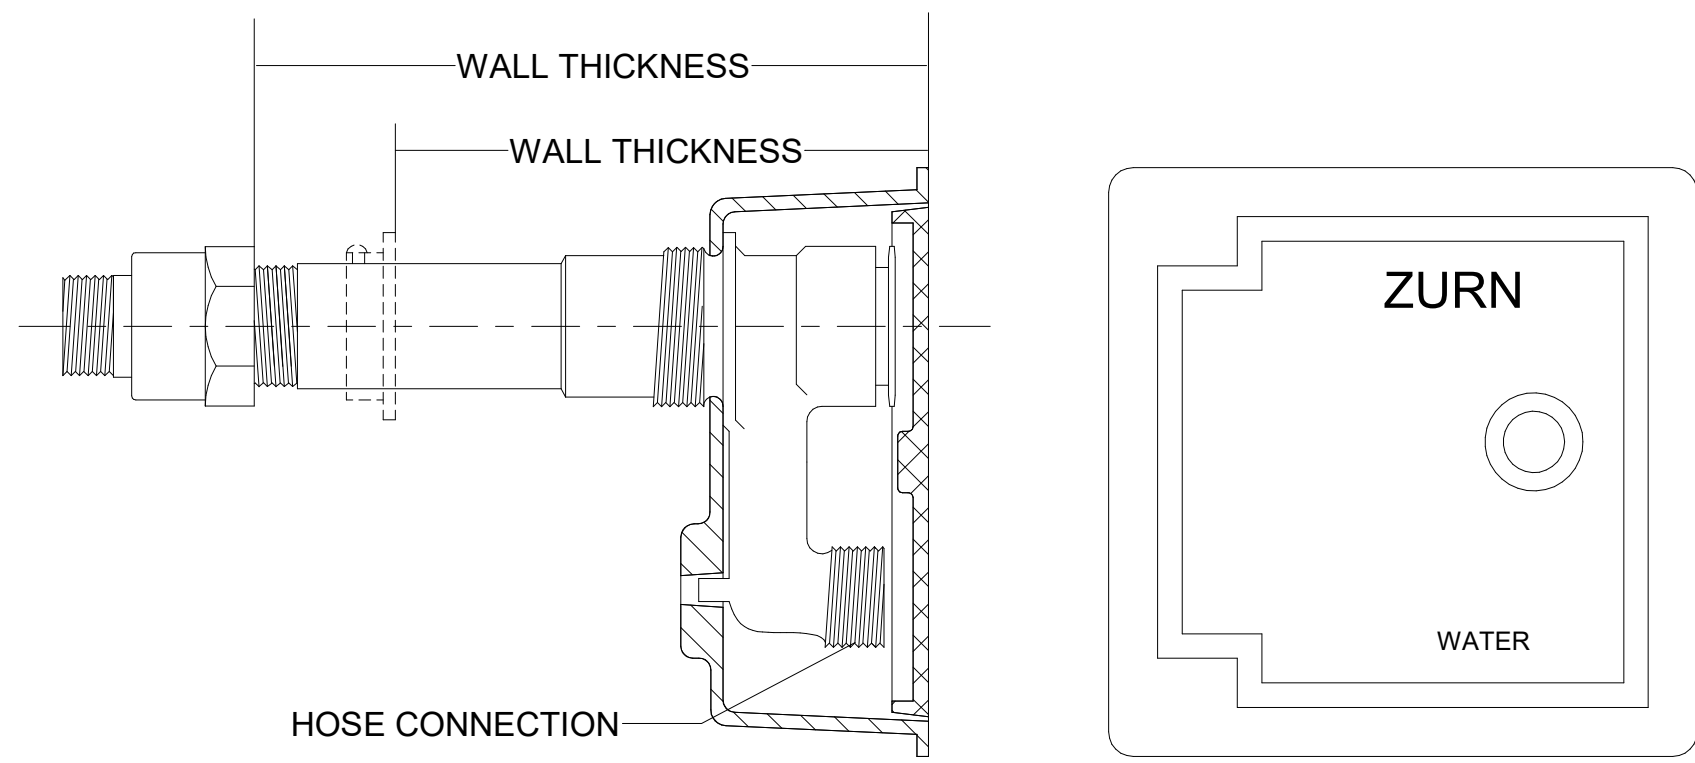
PROJECT NO.
B4-124-1803

SHEET NAME


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DRAWINGS NO.


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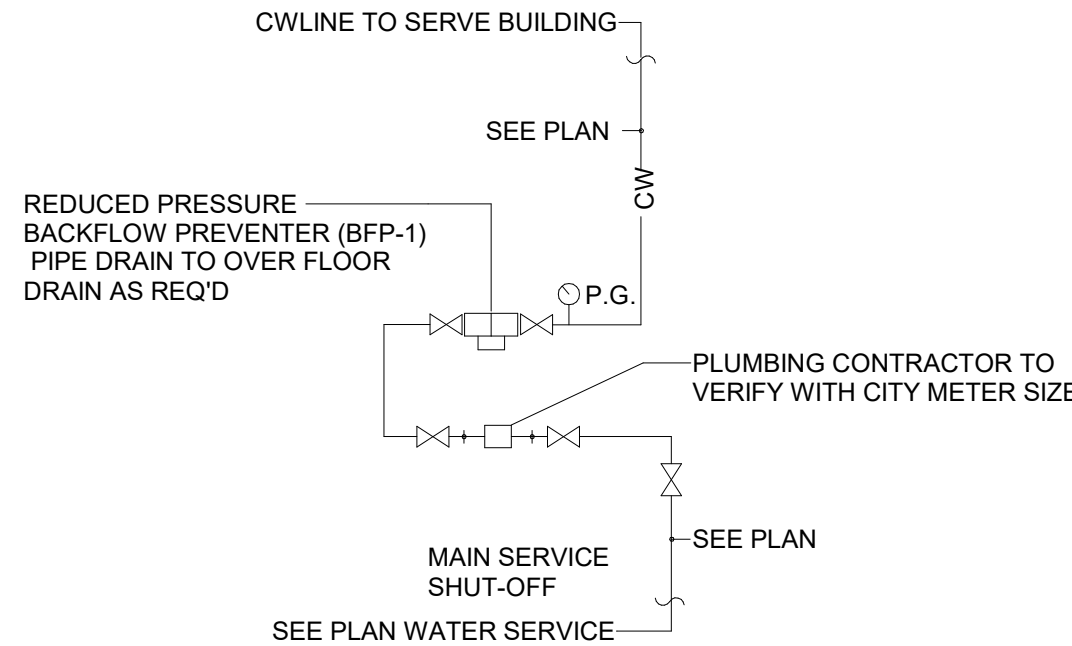
8 HOSE BIB DETAIL
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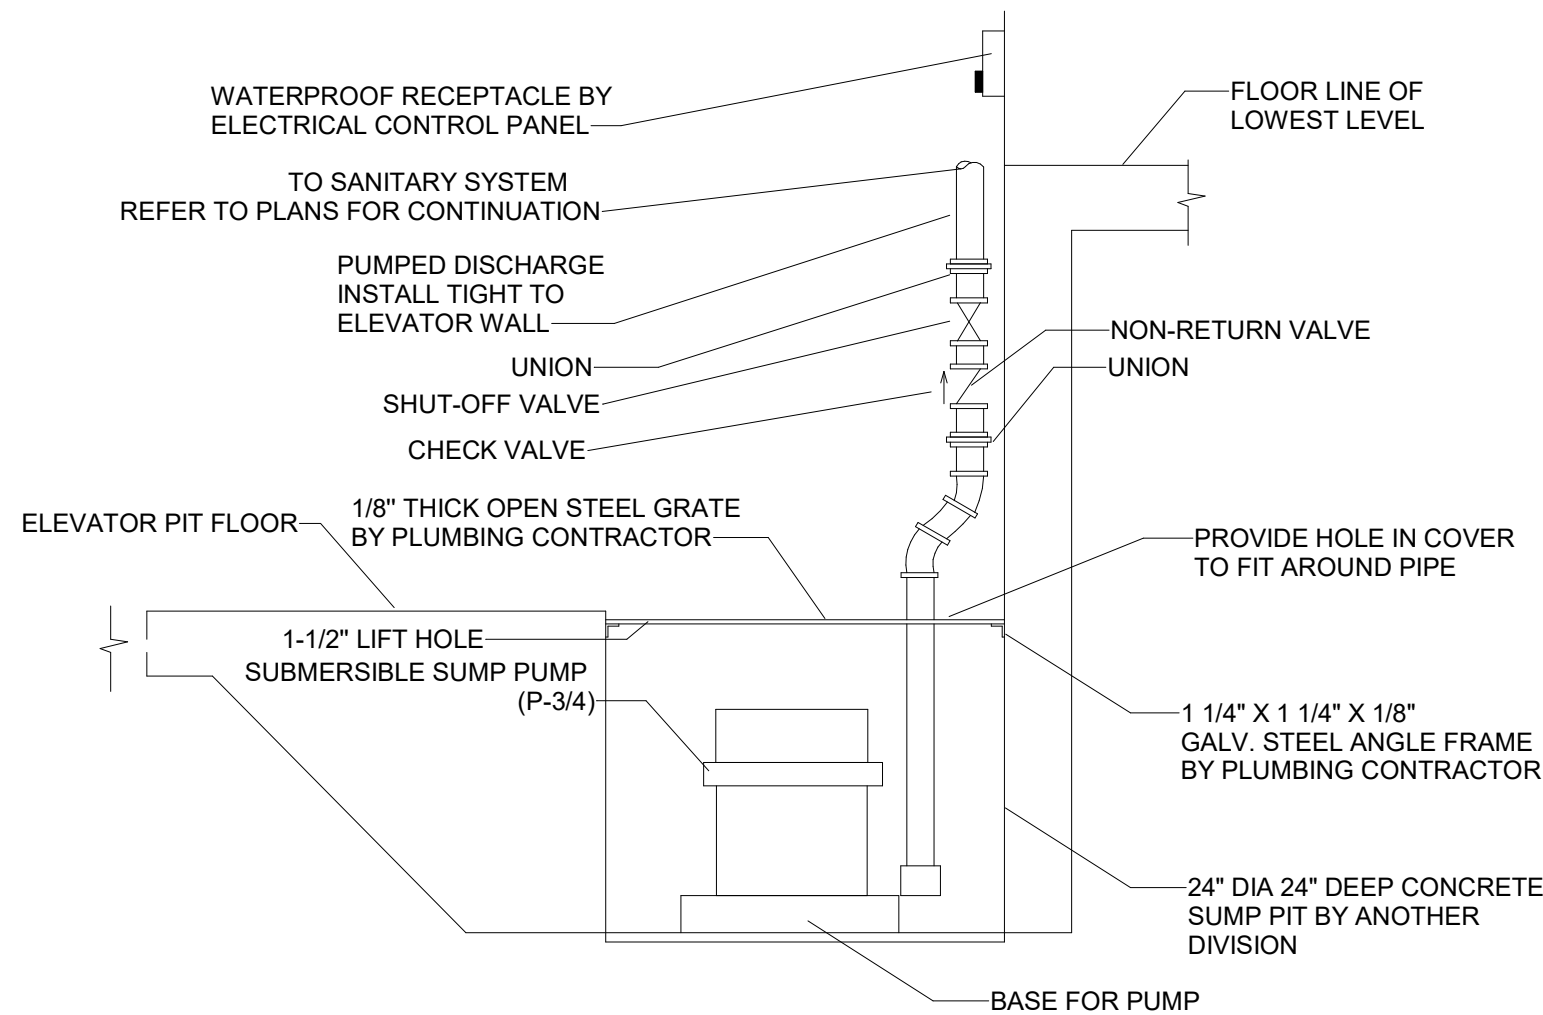
6 EYEWASH STATION DETAIL
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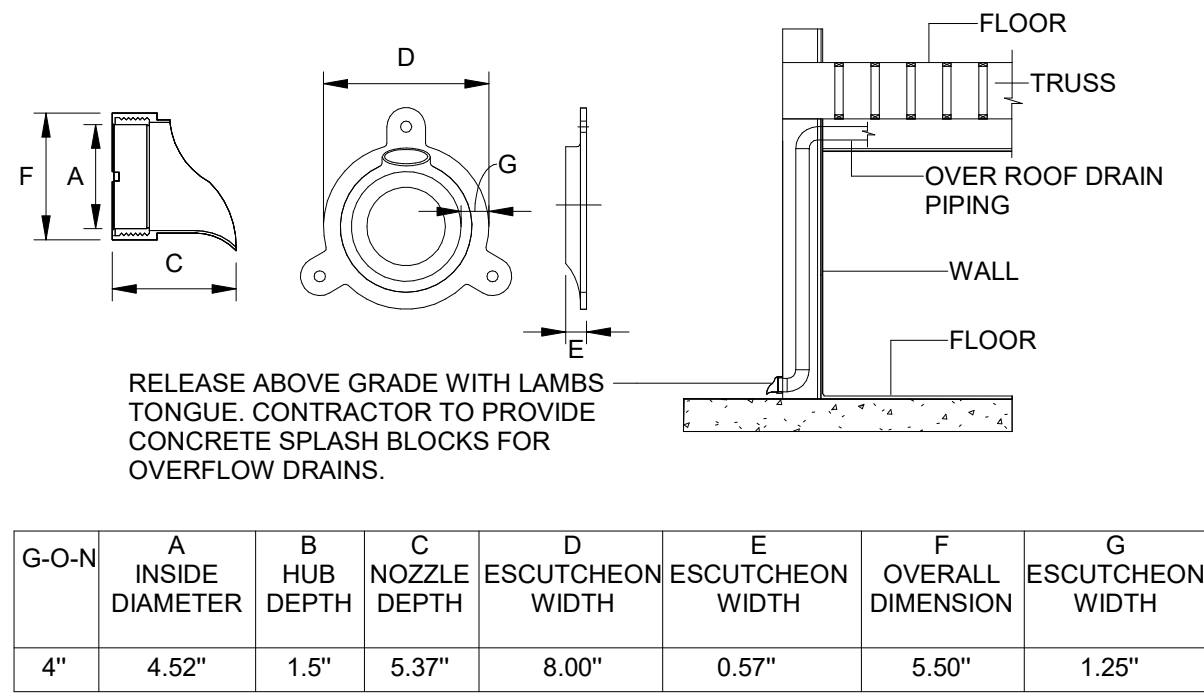
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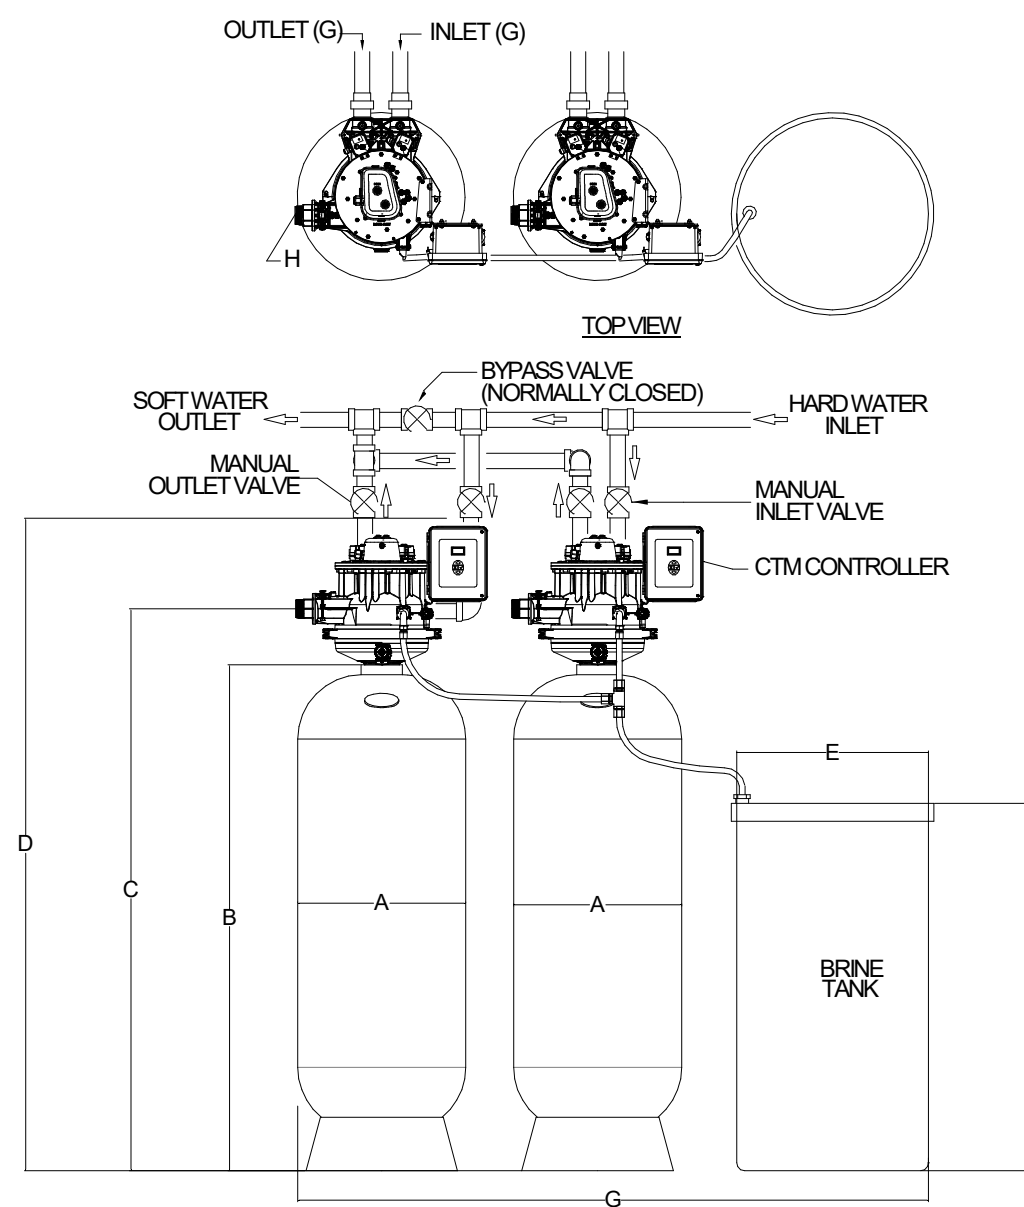
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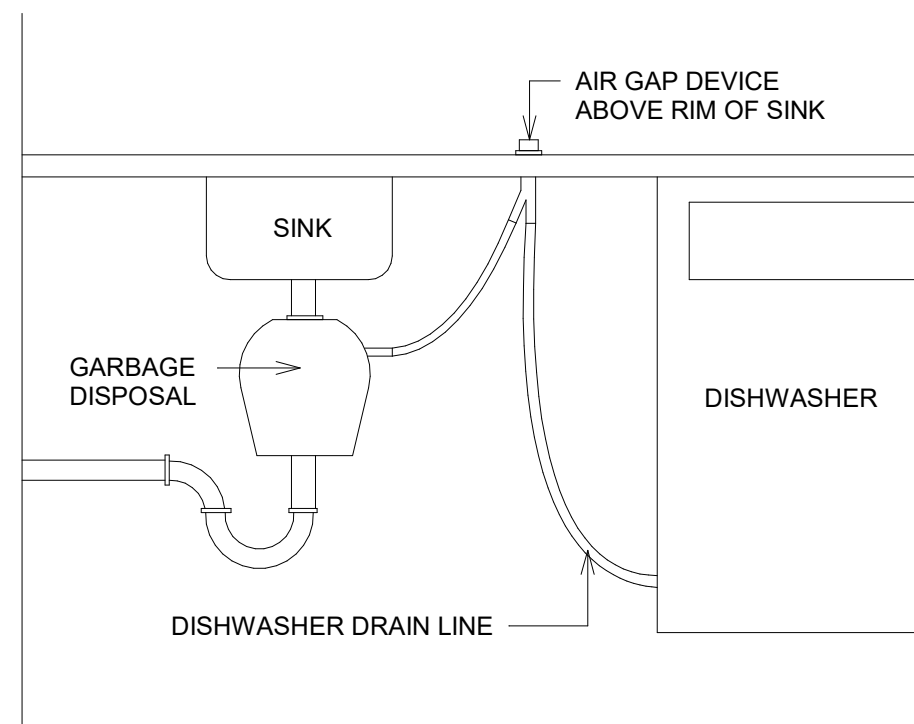
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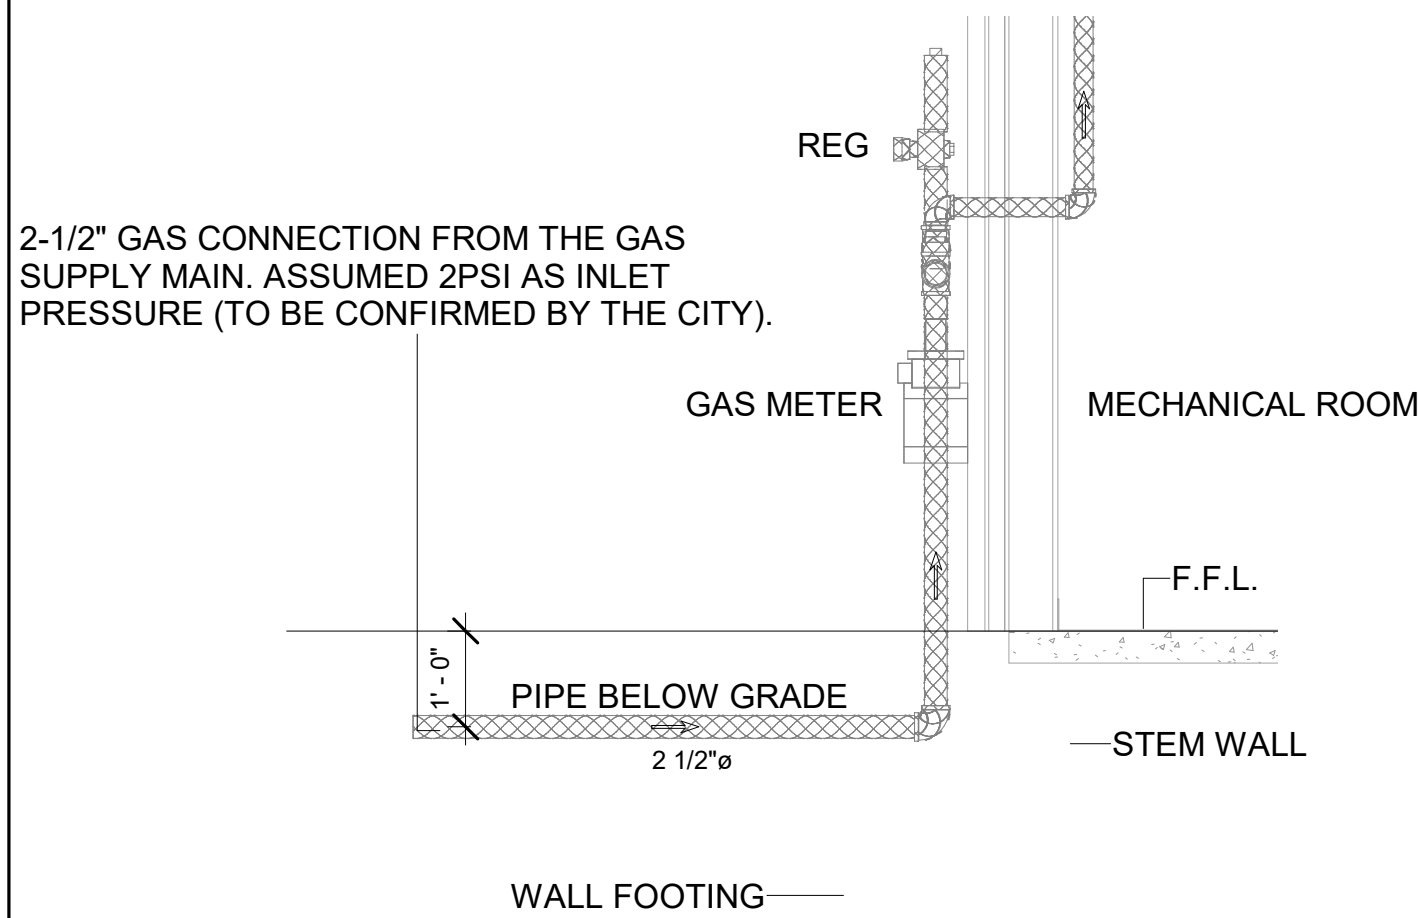
7 LAMBS TONGUE DETAIL
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5 WATER SOFTENER DETAIL
NTS



2 DISHWASHER DRAIN DETAIL
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10 GAS LINE ENTERING THE BUILDING
NTS

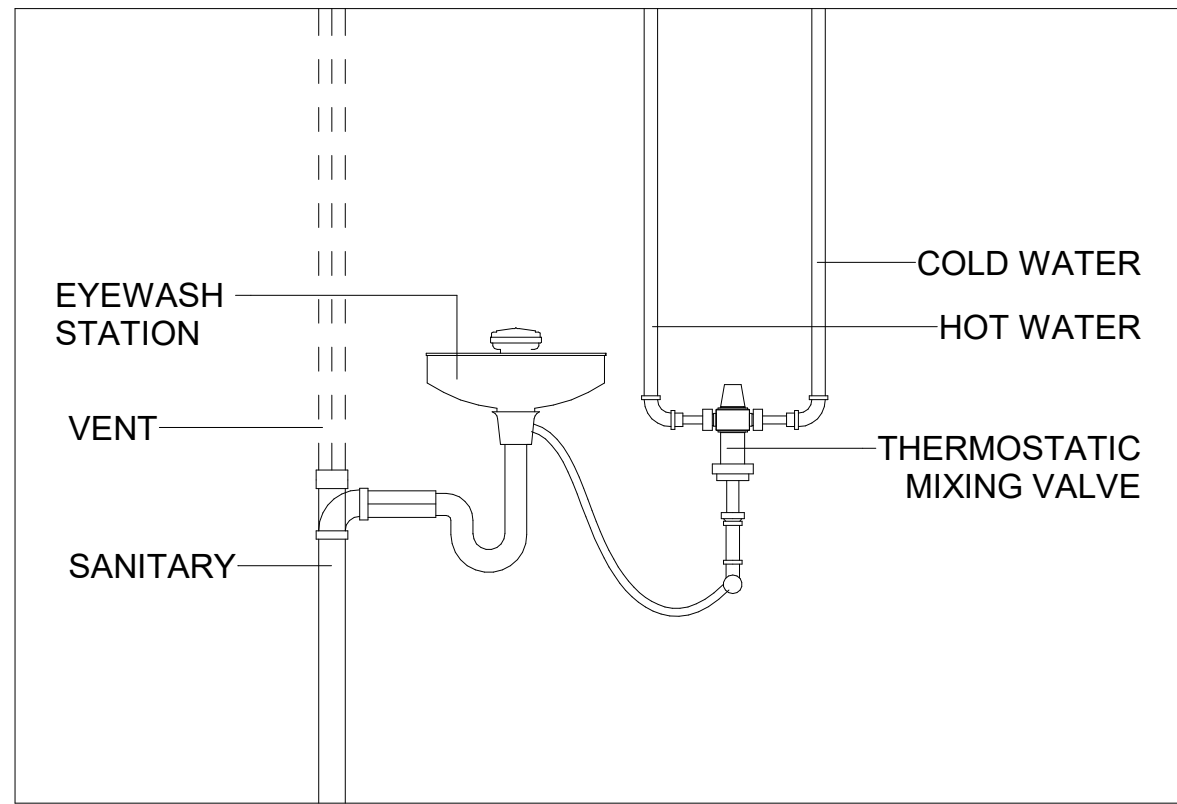

3 GAS LINE TO THE GAS GRILL
NTS
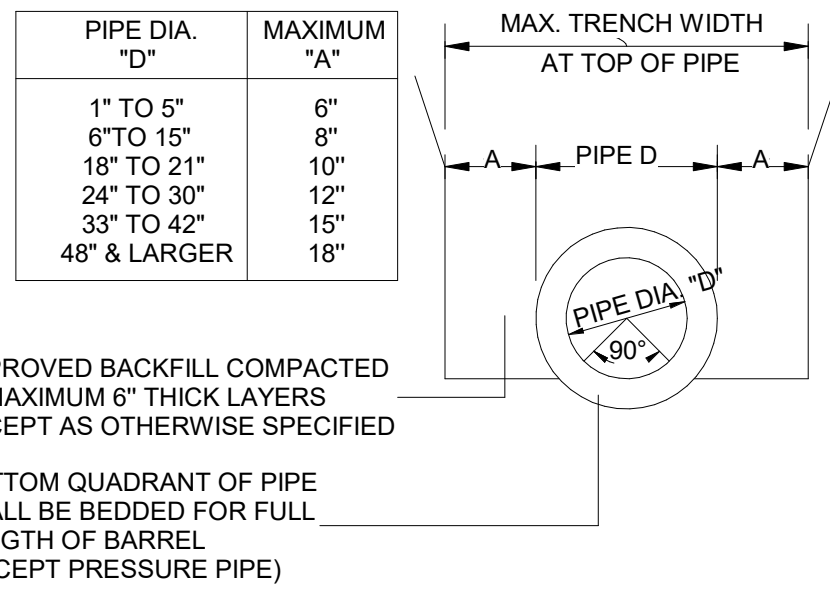
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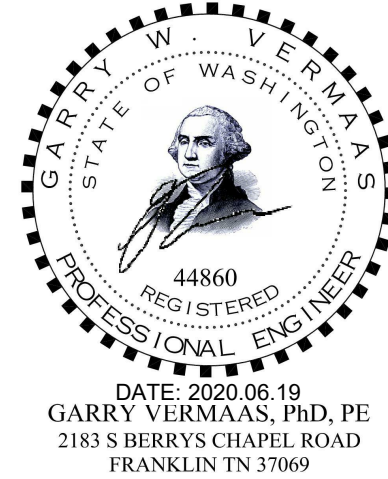
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RICARDO J. MUNIZ-GUILLET, AIA
5453 NW 106TH DR
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MEP ENGINEER
GARRY VERMAAS PhD, PE
2183 S BERRYS CHAPEL ROAD
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Seal:



Owner:



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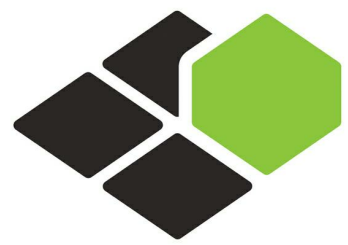
PROJECT NO.
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DETAILS-3

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Seal:



DATE: 2020.06.19
GARRY VERMAAS, PhD, PE
2183 S BERRYS CHAPEL ROAD
FRANKLIN, TN 37069

Owner:



Dakota Legacy Group

Hospitality Development:
4500 36TH AVE. S SUITE
200, FARGO, ND 58104
701.551.8000 (OFFICE)



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WATER SUPPLY KEYNOTE.


#	TEXT
①	PROVIDE AND INSTALL PRECISION PLUMBING PRODUCTS INC. #P1-500 TRAP PRIMER WITH 1/2" CW CONNECTION TO LINE INDICATED ON DRAWING. EXTEND OFF TOP OF LINE PER MANUFACTURER INSTRUCTIONS.(OR) PROVIDE AND INSTALL THE PROSET TRAP GUARD FLOOR DRAIN AS ALTERNATIVE.

GENERAL NOTES

- WATER HAMMER ARRESTORS SHALL BE PROVIDED AT ALL QUICK-CLOSING VALVES SUCH AS FLUSH VALVE, WASHING MACHINES, ICE MAKERS, REFRIGERATOR, DISHWASHERS, AND DRINKING FOUNTAINS AND SHALL CONFIRM WITH ASSE 1010.
- REFER TO THE UNIT PLANS FOR THE PIPING IN EACH UNIT.
- CONTRACTOR TO COORDINATE LOCATION OF PLUMBING RISER IN SHAFT WITH OTHER TRADES.
- REFER TO PLUMBING ISOMETRIC DRAWINGS FOR PIPE SIZES NOT LABELED IN PLANS.
- AS PER FLOW TEST REPORT STATIC PRESSURE IS 51 PSI HENCE BOOSTER PUMP IS REQUIRED, IF THESE PRESSURE CHANGES PLEASE CONTACT THE "EOR".
- PROVIDE INSULATION FOR ALL ICE MACHINE DRAIN TRAPS.
- ALL SHOWER AND SHOWER/TUBS SHALL HAVE PRESSURE BALANCING VALVES.
- BFP-2 TO BE PROVIDED FOR ALL ICE MACHINES AND COFFEE BREWERS NEAR COLD WATER SUPPLY.
- VIBRATION ISOLATOR TO BE GIVEN FOR BOOSTER PUMP & RECIRCULATION PUMPS.
- CONTRACTOR TO SELECT ALL VALVES AND SUBMIT SPECS TO BASE4 FOR REVIEW.
- POOL CONTRACTOR TO SUBMIT POOL DRAWINGS AND POOL HEATER SPECIFICATIONS TO BASE4 FOR REVIEW.
- POOL CONTRACTOR TO CONNECT POOL HEATING PIPES TO DHU BEFORE POOL HEATER.
- GC TO TEST THE BACKFLOW PREVENTER BEFORE PUT INTO SERVICE AND SHALL SUBMIT THE TEST REPORTS TO THE AHJ FOR APPROVAL.
- PROVIDE 1" ARMAFLEX INSULATION TO HOT WATER SUPPLY PIPES.
- CONTRACTOR SHALL PROVIDE EMERGENCY GAS SHUT-OFF VALVE WITH KEY AT GAS FIRE PIT AND GAS GRILLS.
- CONTRACTOR SHALL ENSURE TO PROVIDE THE BACKFLOW PREVENTER CONFORMING TO ASSE 1022 OR BY AN AIR GAP TO PREVENT THE BACKFLOW FOR THE WATER SUPPLY CONNECTION TO COFFEE MACHINES AND NON-CARBONATED BEVERAGE DISPENSERS.
- CONTRACTOR SHALL INSTALL WATER ARRESTOR AT PUBLIC TOILETS.
- CONTRACTOR SHALL ENSURE TO PROVIDE THE TEMPERATURE MIXING VALVE FOR PUBLIC HAND WASHING FACILITIES.
- GC SHALL INSTALL ALL THE EXTERIOR PIPING BASED ON FROST DEPTH.
- ALL DRAIN LINES, P-TRAP AND SUPPLY LINES EXPOSED TO VIEW BENEATH THE VANITY OR BEHIND THE WATER CLOSET MUST BE CHROME PLATED.

① 1ST FLOOR WATER & GAS SUPPLY PLAN PART-A
1/8" = 1'-0"

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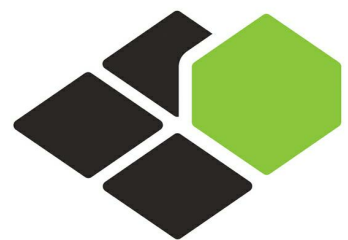


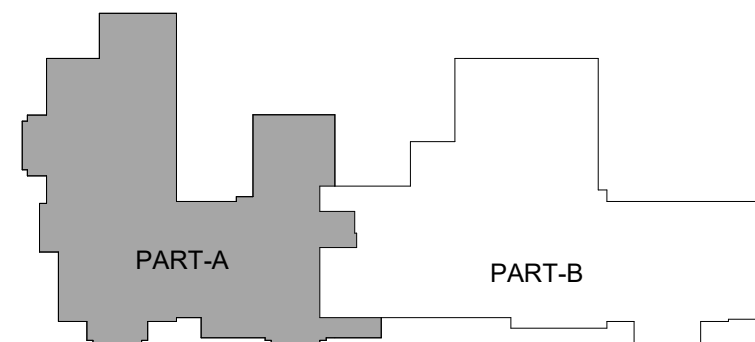KEY PLAN FOR 1ST FLOOR-A
1" = 80'-0"

1ST FLOOR WATER
& GAS SUPPLY
PLAN-A

DRAWINGS NO.

P-201A




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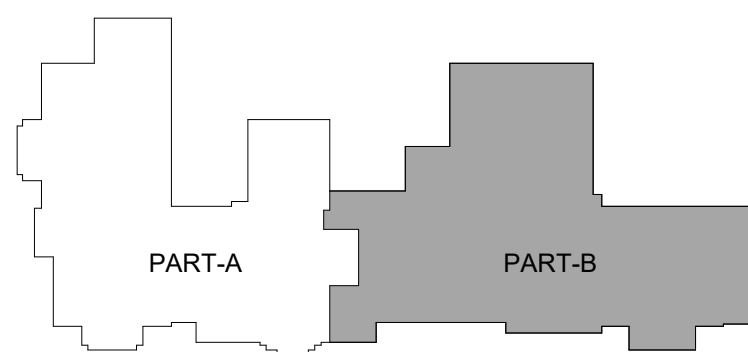
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WATER SUPPLY KEYNOTES

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②	CONTRACTOR SHALL PROVIDE AN APPROVED WATER-TEMPERATURE LIMITING DEVICE TO PROVIDE TEPID WATER FOR EYE WASH STATION. DEVICE MUST MEET MINIMUM FLOW RATES AND DURATION REQUIREMENTS.

GENERAL NOTES

- WATER HAMMER ARRESTORS SHALL BE PROVIDED AT ALL QUICK-CLOSING VALVES SUCH AS FLUSH VALVE, WASHING MACHINES, ICE MAKERS, REFRIGERATOR, DISHWASHERS, AND DRINKING FOUNTAINS AND SHALL CONFIRM WITH ASSE 1010.
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- ALL DRAIN LINES, P-TRAP AND SUPPLY LINES EXPOSED TO VIEW BENEATH THE VANITY OR BEHIND THE WATER CLOSET MUST BE CHROME PLATED.

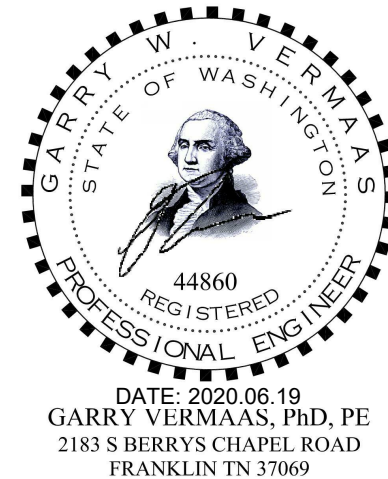

KEY PLAN FOR 1ST FLOOR-B
1" = 80'-0"


① 1ST FLOOR WATER & GAS SUPPLY PLAN PART-B
1/8" = 1'-0"

B-20-0180
City of Puyallup

1ST FLOOR WATER
& GAS SUPPLY
PLAN-B

DRAWINGS NO.

P-201B

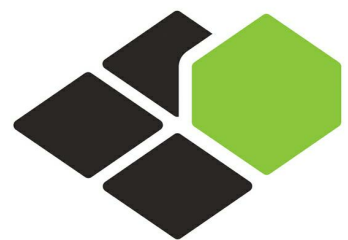


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SHEET NAME

1ST FLOOR
SANITARY & VENT
PLAN-A


DRAWINGS NO.

P-202A

#	TEXT
①	ALL PTAC'S & CEILING MOUNTED AHU/D'S UNITS CONDENSATE LINE SHALL CONNECT TO NEAREST SANITARY LINE. CONTRACTOR TO COORDINATE WITH THE CONNECTIONS & ENSURE SLOPE OF 1/8" PER FT IS MAINTAINED.
②	ALL FLOOR MOUNTED AHU SHALL INDIRECTLY CONNECT TO NEAREST FLOOR DRAIN & NEED TO CONNECT TO NEAREST SANITARY LINE. CONTRACTOR TO COORDINATE WITH THE CONNECTIONS & ENSURE SLOPE OF 1/8" PER FT IS MAINTAINED.

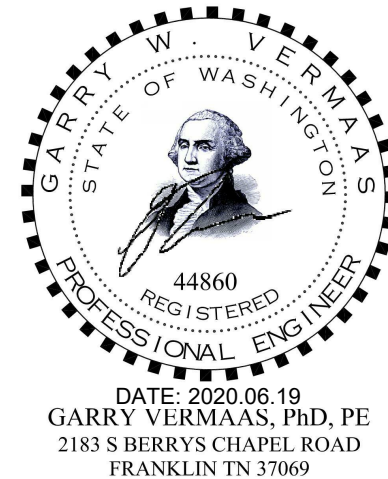
GENERAL NOTES

- REFER TO THE UNIT PLANS FOR THE PIPING IN EACH UNIT.
- REFER TO THE ARCHITECTURAL DRAWING FOR PANTRY/KITCHEN EQUIPMENT/CALLOUTS.
- CONTRACTOR TO COORDINATE LOCATION OF PLUMBING RISER IN SHAFT WITH OTHER TRADES.
- REFER TO PLUMBING ISOMETRIC DRAWINGS FOR PIPE SIZES NOT LABELED IN PLANS.
- CONTRACTOR SHALL PROVIDE INSULATION FOR FLOOR DRAIN PIPING.
- CONTRACTOR SHALL PROVIDE WALL CLEANOUTS AT THE BASE OF EACH VERTICAL WASTE STACK AND AS PER LATEST PLUMBING CODE.
- GC TO PROVIDE CLEANOUTS AT INTERVALS OF NOT MORE THAN 100FT AND AT CHANGE IN HORIZONTAL DIRECTION GREATER THAN 45DEG. CLEANOUTS SHALL BE THE SAME SIZE AS THE PIPE SERVING THE CLEANOUT.
- ALL PIPES TO BE INSULATED AGAINST FREEZING.
- CONTRACTOR TO PROVIDE INSULATION FOR WASTE AND WATER PIPING SERVING THE DUMPSTER AREA.
- GC TO ENSURE ALL RUNS OF SANITARY & STORM BELOW THE FOOTINGS ARE ENCASED IN CONCRETE WORK OR STEEL TO PREVENT RUPTURE. REFER TO SE DRAWINGS.
- CONTRACTOR TO ENSURE AIRGAP BETWEEN THE FLOOR SINK AND THE DRAIN LINE FROM S-COMPARTMENT SINK.
- CONTRACTOR SHALL ENSURE AIRGAP BETWEEN THE DRAIN LINE OF ELEVATOR SUMP PUMP AND THE HUB DRAIN.
- CONTRACTOR TO INSTALL ALL PRIMARY ROOF DRAIN PIPES OUTSIDE THE BUILDING BASED ON FROST DEPTH AND AS PER SITE ELEVATIONS.
- ELEVATOR PIT / SHAFT DIMENSIONS AND CAPACITY / SPEED ARE BASIS OF DESIGN SPECIFICATION ONLY. GC SHALL COORD. WITH OWNER AND SUBMIT ELEVATOR SHOP DRAWINGS / SPECIFICATIONS TO BASE4, AS SOON AS POSSIBLE BUT NO LATER THAN PRIOR TO INITIAL MUNICIPAL FILING COMMENTS RESUBMITTAL.
- CONTRACTOR SHALL PROVIDE AIR ADMITTANCE VALVE FOR ALL DISHWASHERS AT KITCHEN/NATE SINKS.
- ALL SANITARY & WATER PIPES WHICH ARE TO BE ROUTED THROUGH THE TRUSSES/TJIS, TRUSS/TJI MANUFACTURER TO COORDINATE WITH PLUMBING CONTRACTOR ON SITE FOR TRUSS/TJI TO BE SPACED ACCORDINGLY TO AVOID CLASH.
- CONTRACTOR TO INSTALL ALL THE PRIMARY ROOF DRAIN PIPES OUTSIDE THE BUILDING BASED ON FROST DEPTH AND AS PER SITE ELEVATIONS.

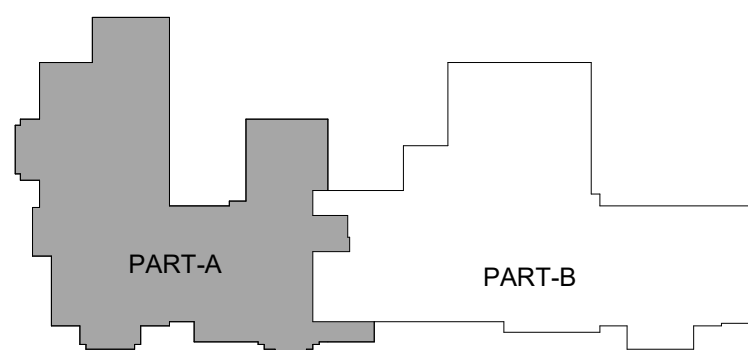


KEY PLAN FOR 1ST FLOOR-A
1" = 80'-0"

B-20-0180
City of Puyallup

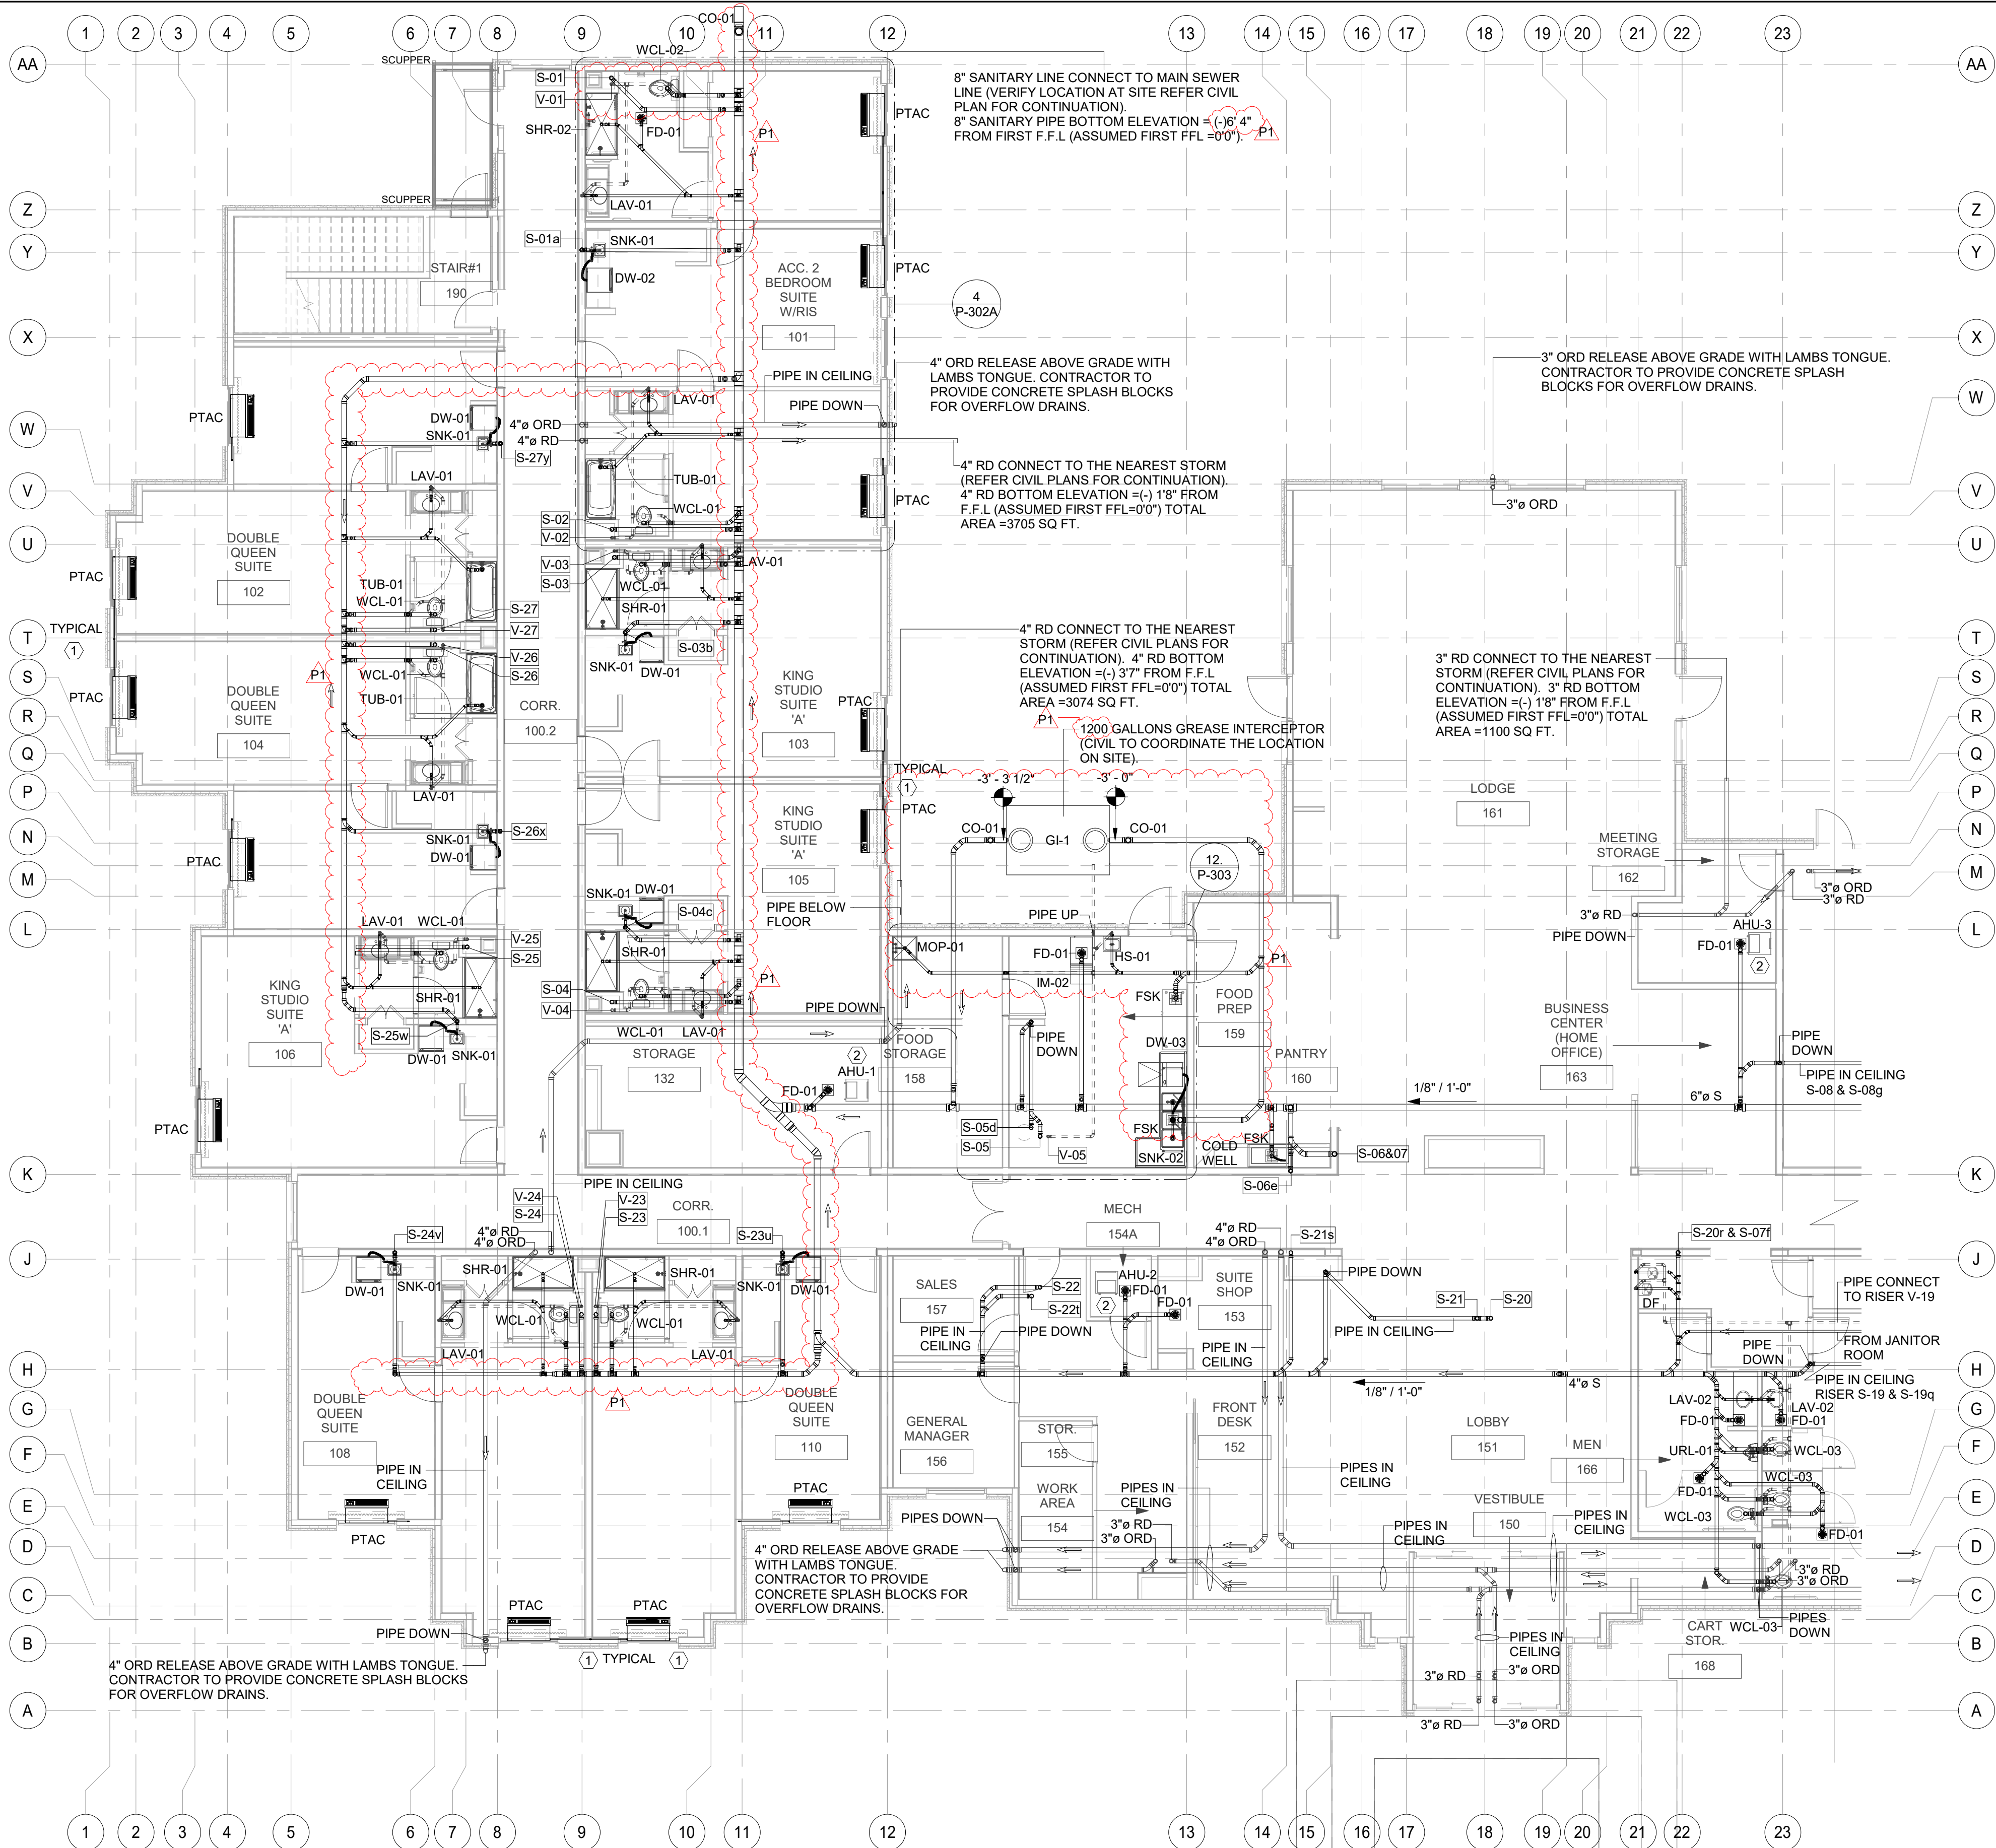

① 1ST FLOOR SANITARY & VENT PLAN PART-A
1/8" = 1'-0"

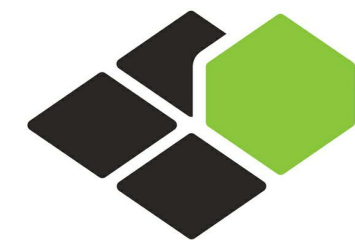


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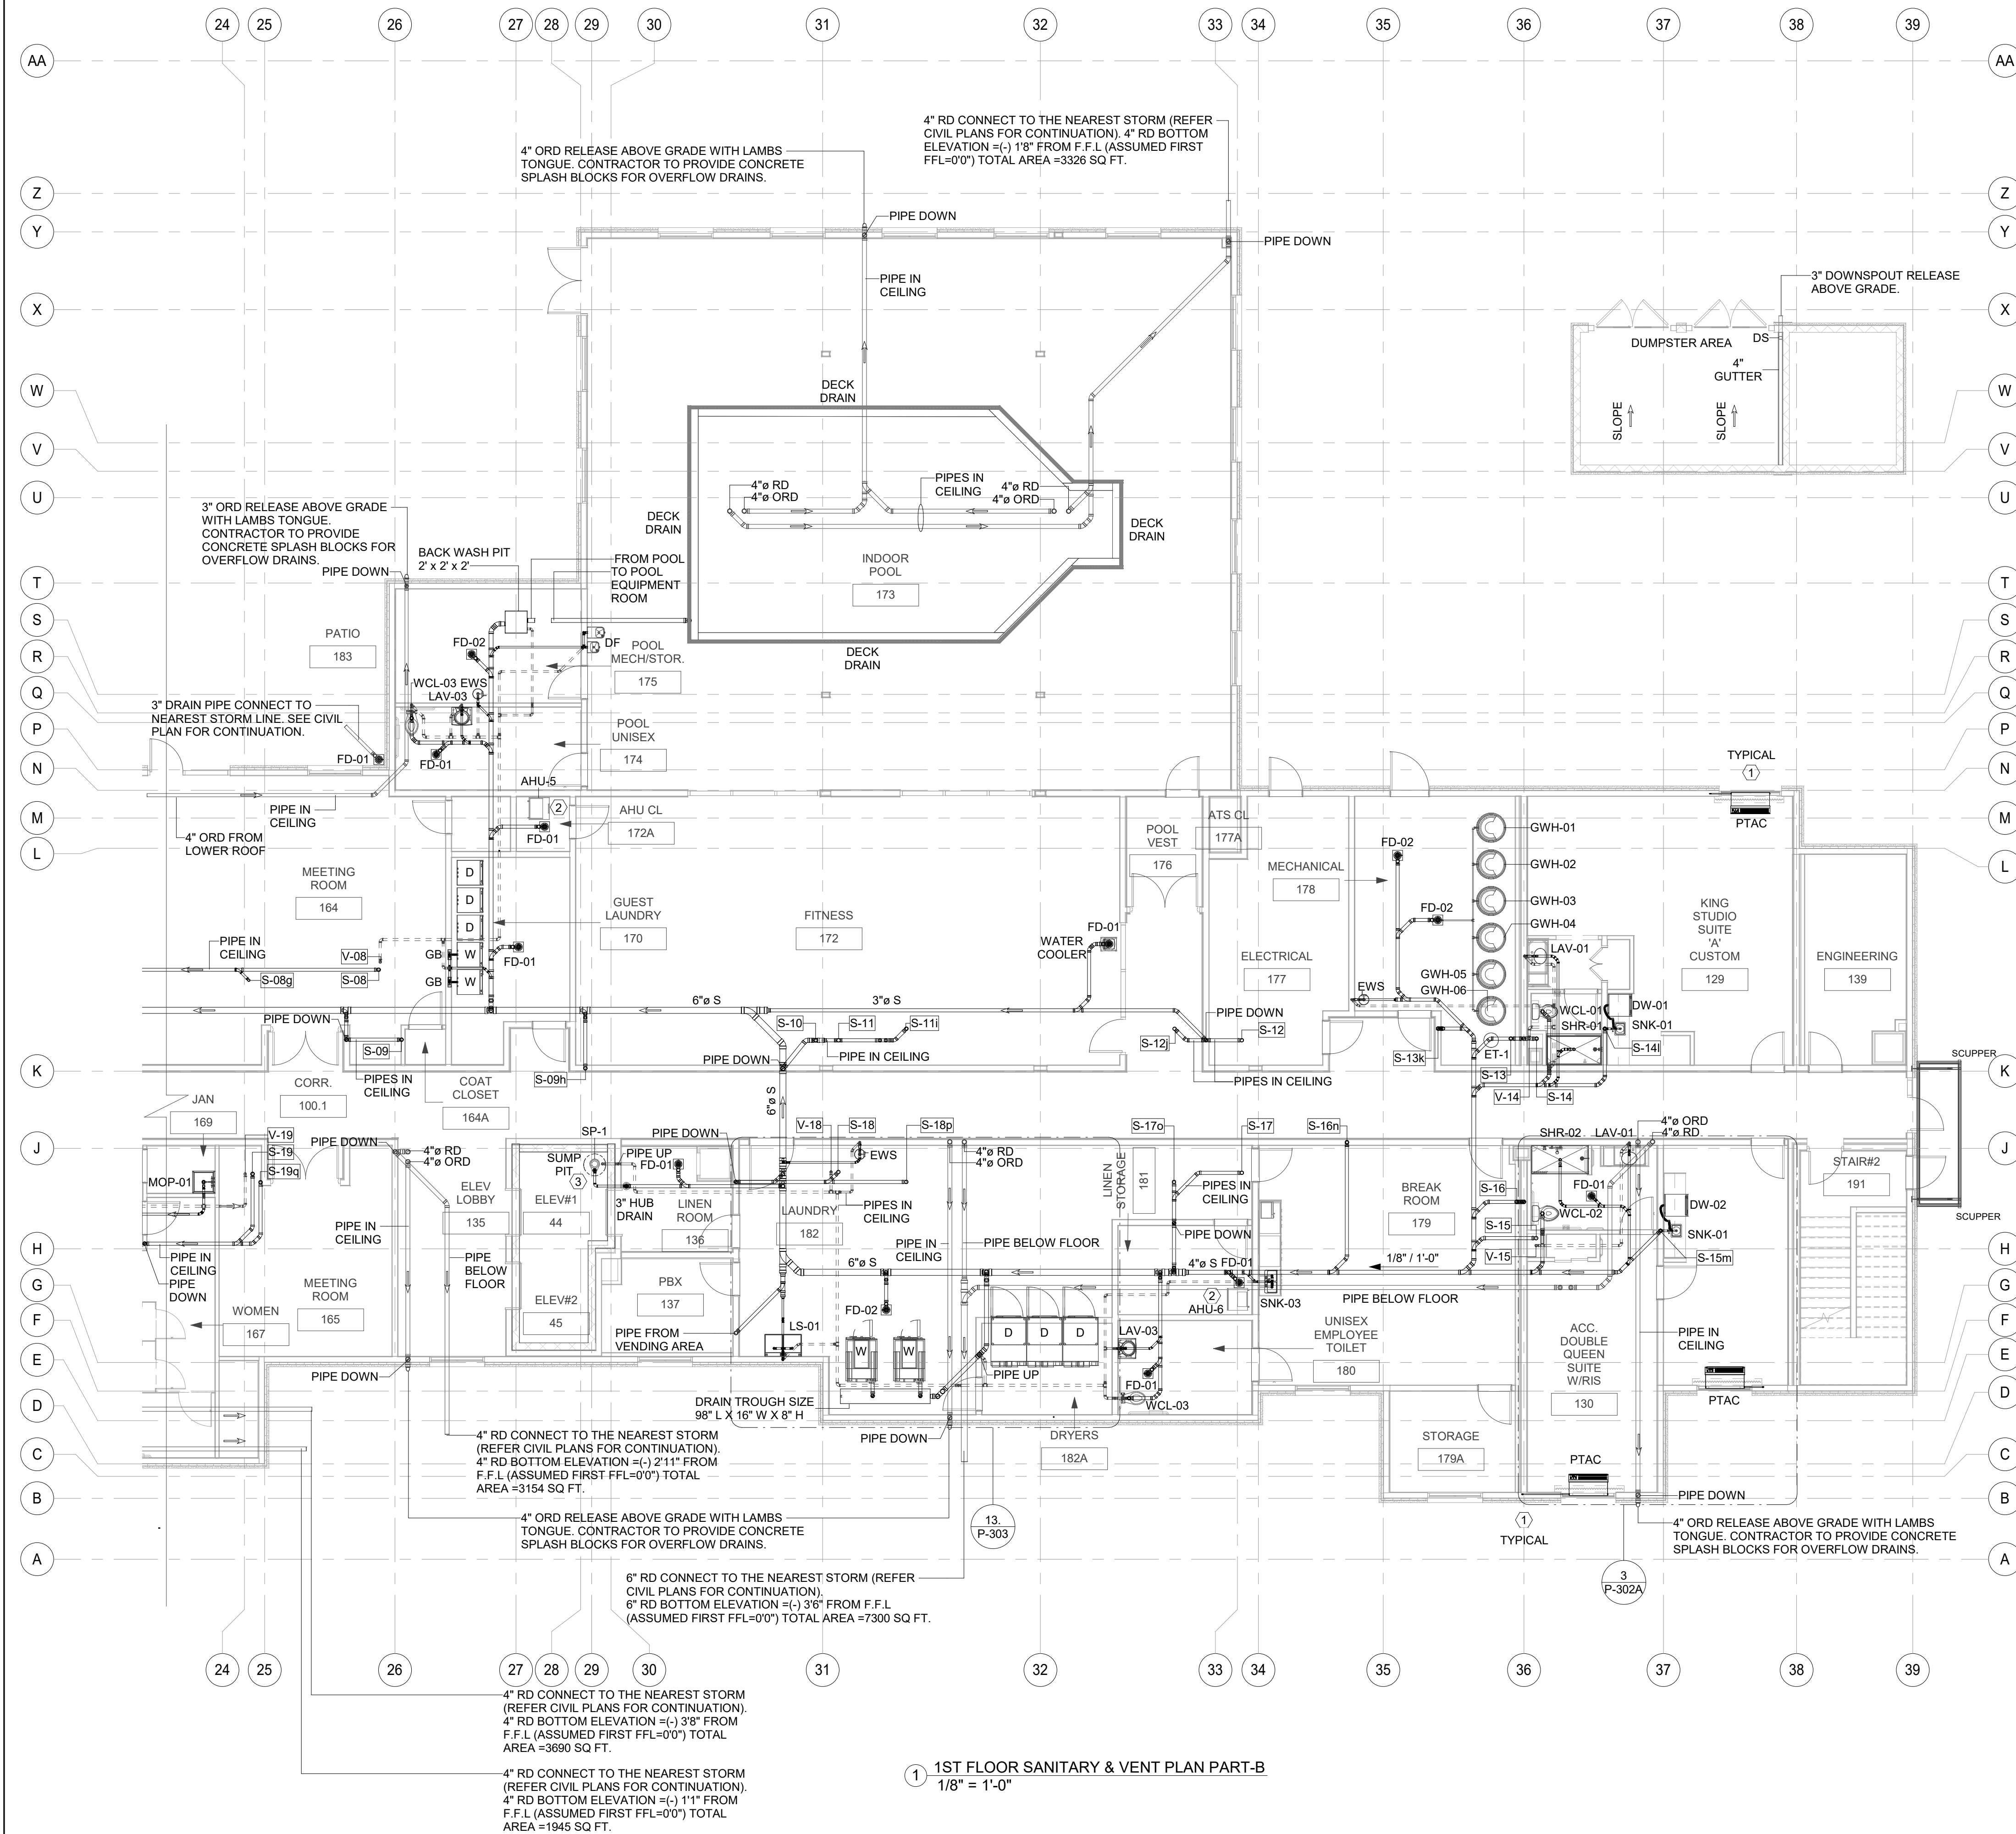
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SHEET NAME

1ST FLOOR
SANITARY & VENT
PLAN-B

DRAWINGS NO.

P-202B

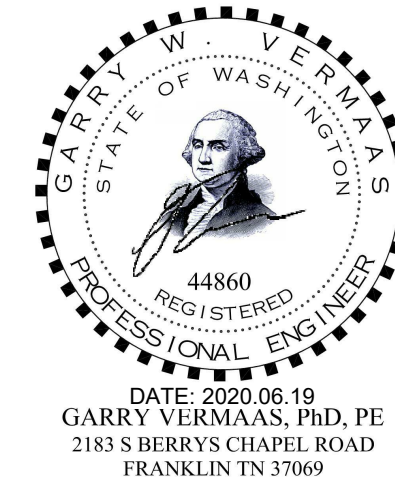


1-1ST FLOOR SANITARY & VENT PLAN PART-B
1/8" = 1'-0"

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1	ALL PTAC'S & CEILING MOUNTED AHU/DS UNITS CONDENSATE LINE SHALL CONNECT TO NEAREST SANITARY LINE. CONTRACTOR TO COORDINATE WITH THE CONNECTIONS & ENSURE SLOPE OF 1/8" PER FT IS MAINTAINED.
2	ALL FLOOR MOUNTED AHU SHALL INDIRECTLY CONNECT TO NEAREST FLOOR DRAIN & NEED TO CONNECT TO NEAREST SANITARY LINE. CONTRACTOR TO COORDINATE WITH THE CONNECTIONS & ENSURE SLOPE OF 1/8" PER FT IS MAINTAINED.
3	SUMP PIT DIAMETER OF 24" AND HEIGHT 24" WITH GAS TIGHT REMOVABLE COVER ON TOP OF PIT. REFER TO STRUCTURAL DRAWINGS FOR SUMP PIT DESIGN.


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- CONTRACTOR SHALL PROVIDE INSULATION FOR FLOOR DRAIN PIPING.
- CONTRACTOR SHALL PROVIDE WALL CLEANOUTS AT THE BASE OF EACH VERTICAL WASTE STACK AND AS PER LATEST PLUMBING CODE.
- GO TO PROVIDE CLEANOUTS AT INTERVALS OF NOT MORE THAN 100FT AND AT CHANGE IN HORIZONTAL DIRECTION GREATER THAN 45DEG. CLEANOUTS SHALL BE THE SAME SIZE AS THE PIPE SERVING THE CLEANOUT.
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- CONTRACTOR TO PROVIDE INSULATION FOR WASTE AND WATER PIPING SERVING THE DUMPSTER AREA.
- GO TO ENSURE ALL RUNS OF SANITARY & STORM BELOW THE FOOTINGS ARE ENCASED IN CONCRETE WORK OR STEEL TO PREVENT RUPTURE. REFER TO SE DRAWINGS.
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- COMMENTS RESUBMITTAL.
- CONTRACTOR SHALL PROVIDE AIR ADMITTANCE VALVE FOR ALL DISHWASHERS AT KITCHEN/NATE SINKS.
- ALL SANITARY & WATER PIPES WHICH ARE TO BE ROUTED THROUGH THE TRUSSES/TJS, TRUSSES/TJ MANUFACTURER TO COORDINATE WITH PLUMBING CONTRACTOR ON SITE FOR TRUSSES/TJ TO BE SPACED ACCORDINGLY TO AVOID CLASH.
- CONTRACTOR TO INSTALL ALL THE PRIMARY ROOF DRAIN PIPES OUTSIDE THE BUILDING BASED ON FROST DEPTH AND AS PER SITE ELEVATIONS.

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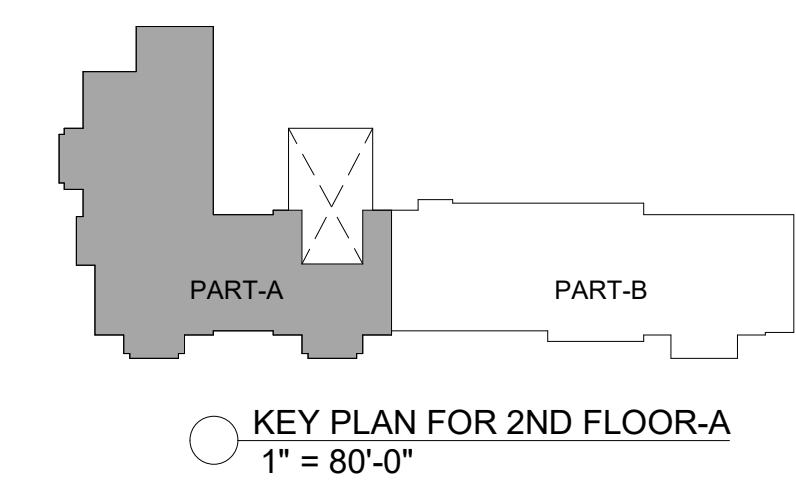
KEY PLAN FOR 1ST FLOOR-B
1" = 80'-0"

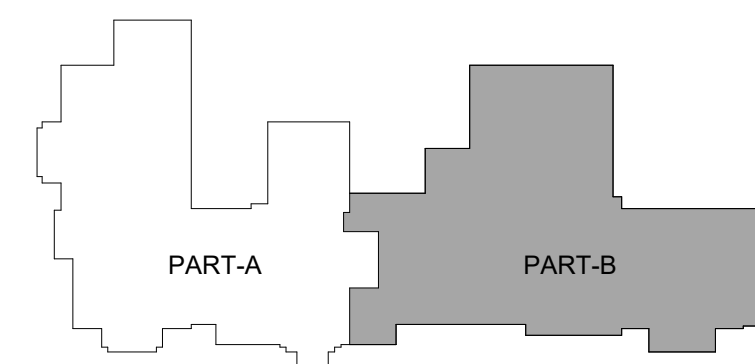


1 2ND FLOOR WATER & GAS SUPPLY PLAN PART-A
1/8" = 1'-0"

WATER SUPPLY KEYNOTE	
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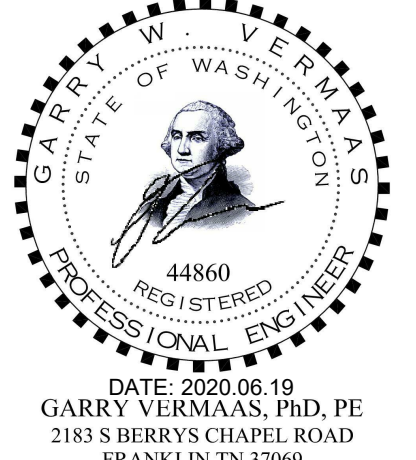
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
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2183 S BERRYS CHAPEL ROAD
FRANKLIN, TN 37069

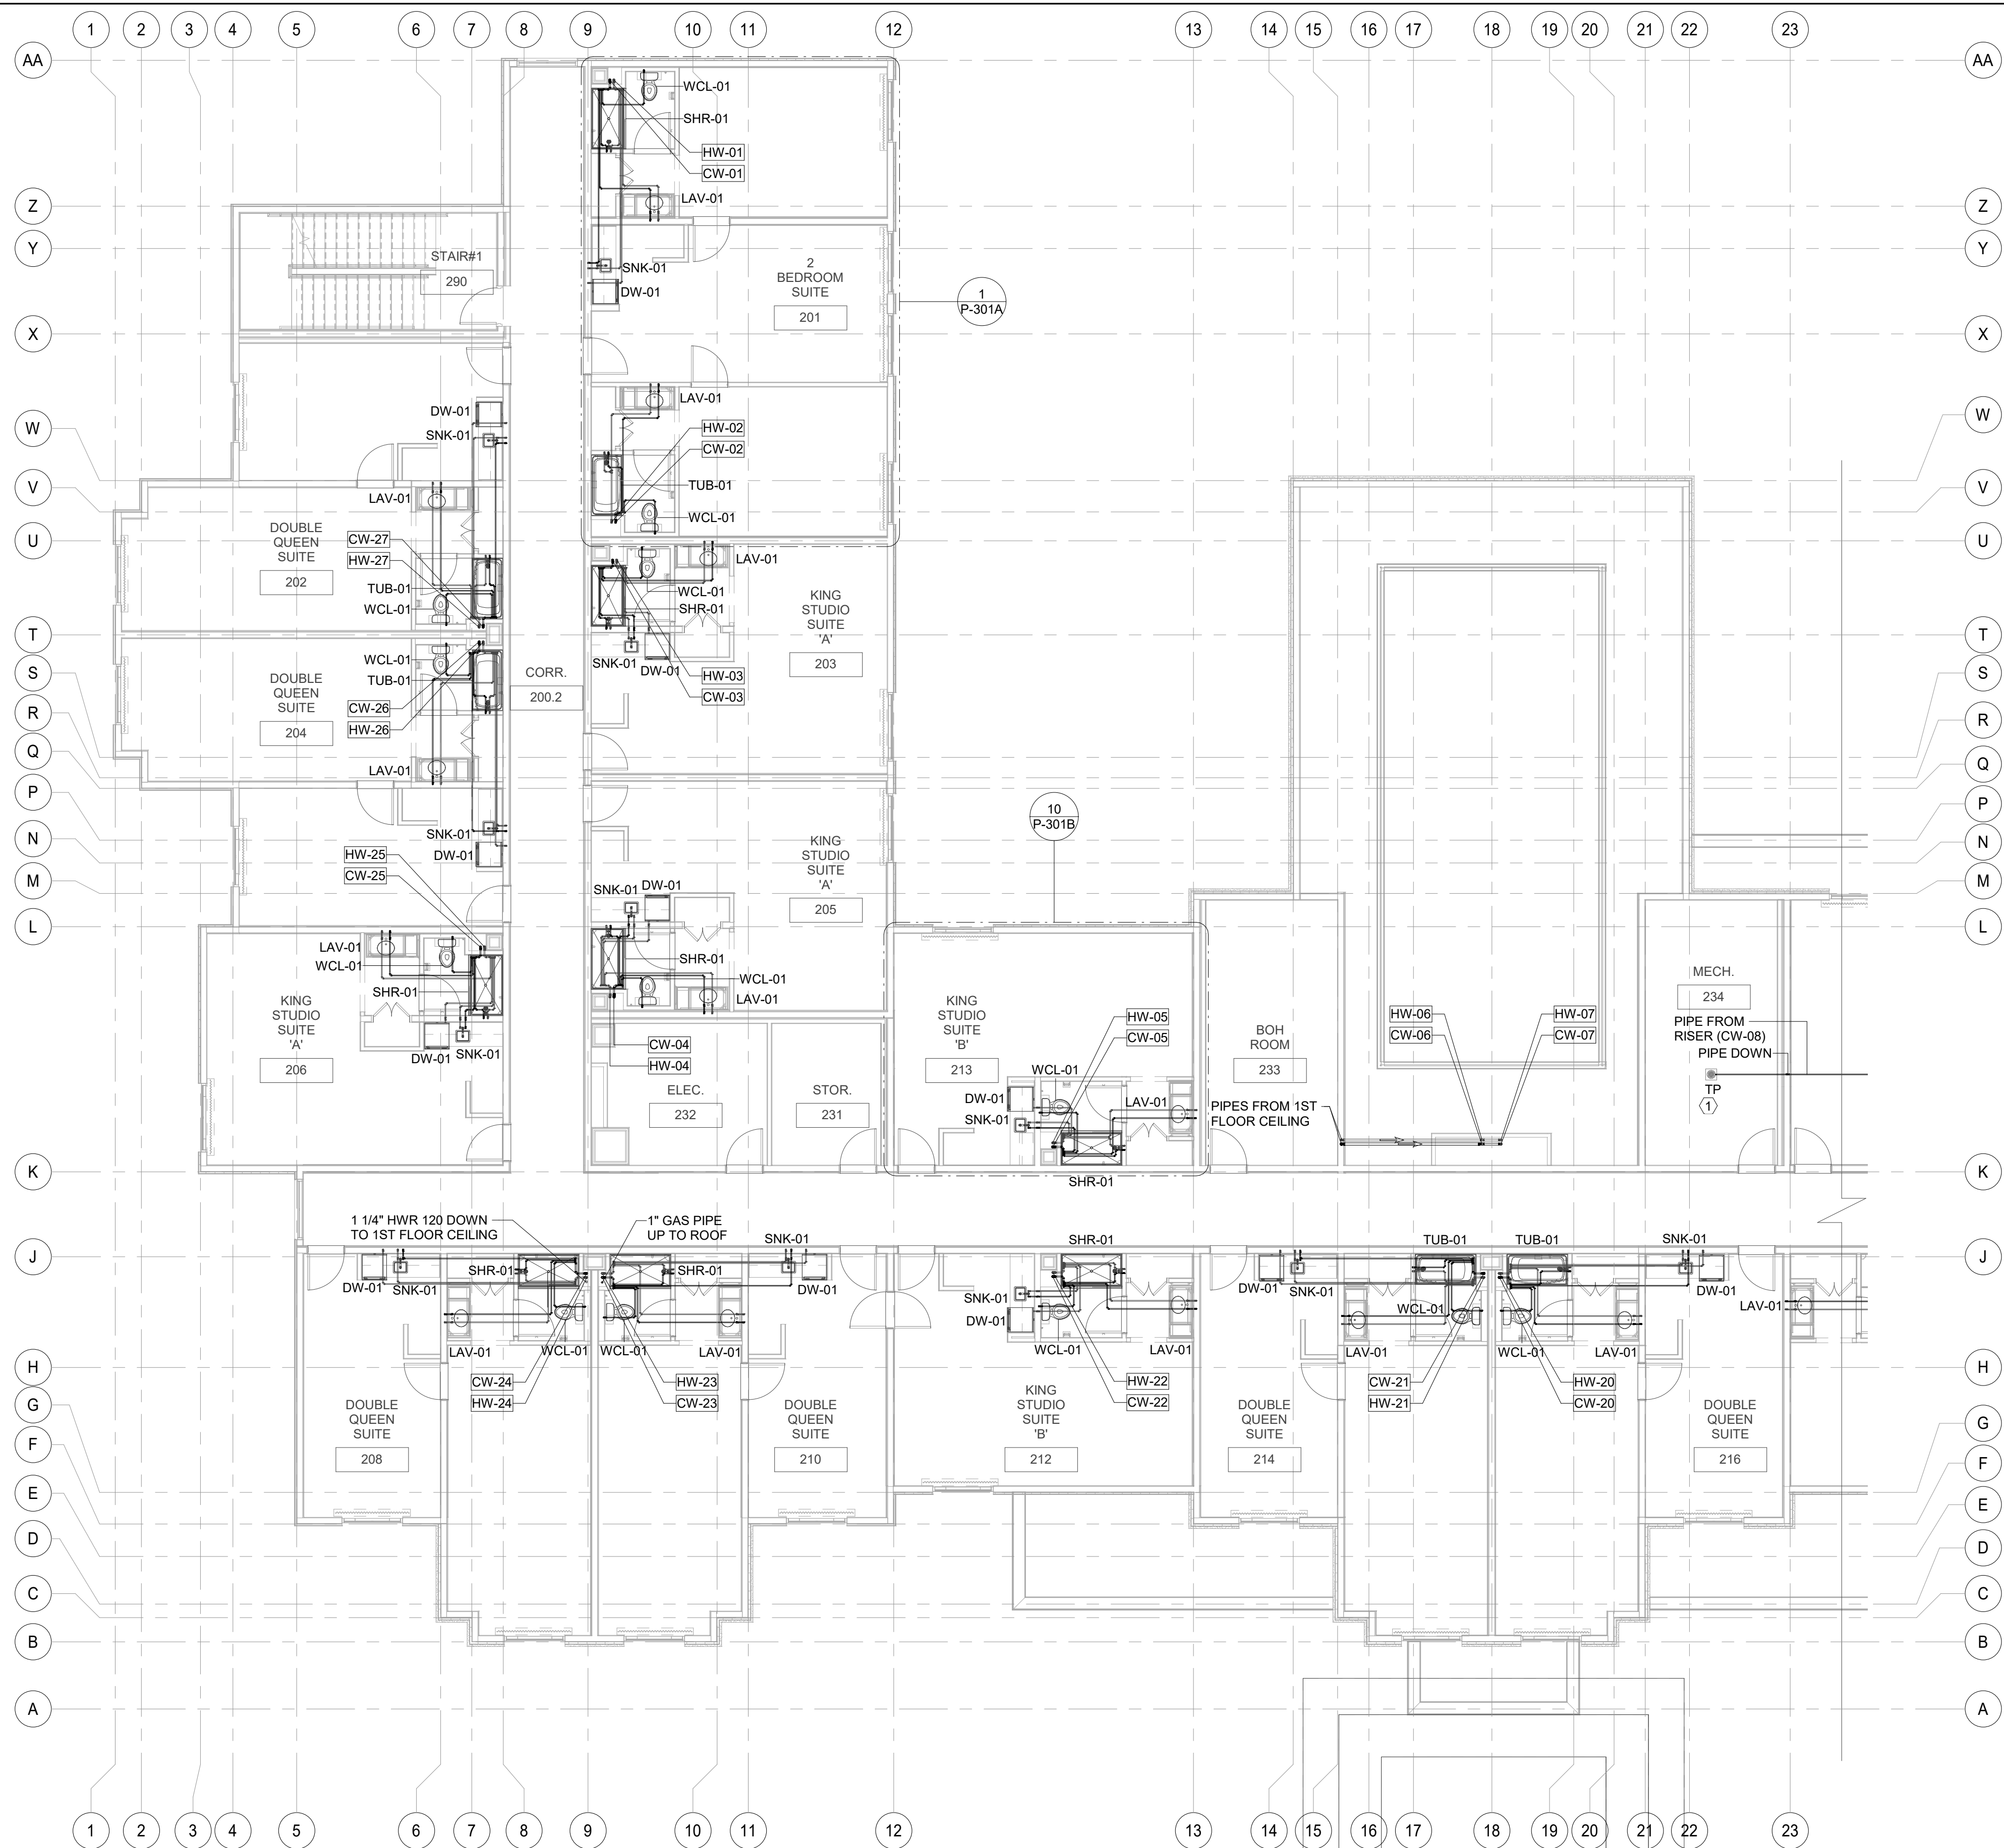Seal:

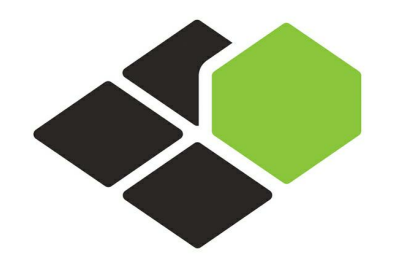

DATE: 2020.06.19
GARRY VERMAAS, PhD, PE
2183 S BERRYS CHAPEL ROAD
FRANKLIN, TN 37069

Owner:



dla
Dakota Legacy Group
Hospitality Development:
4500 36TH AVE. S SUITE
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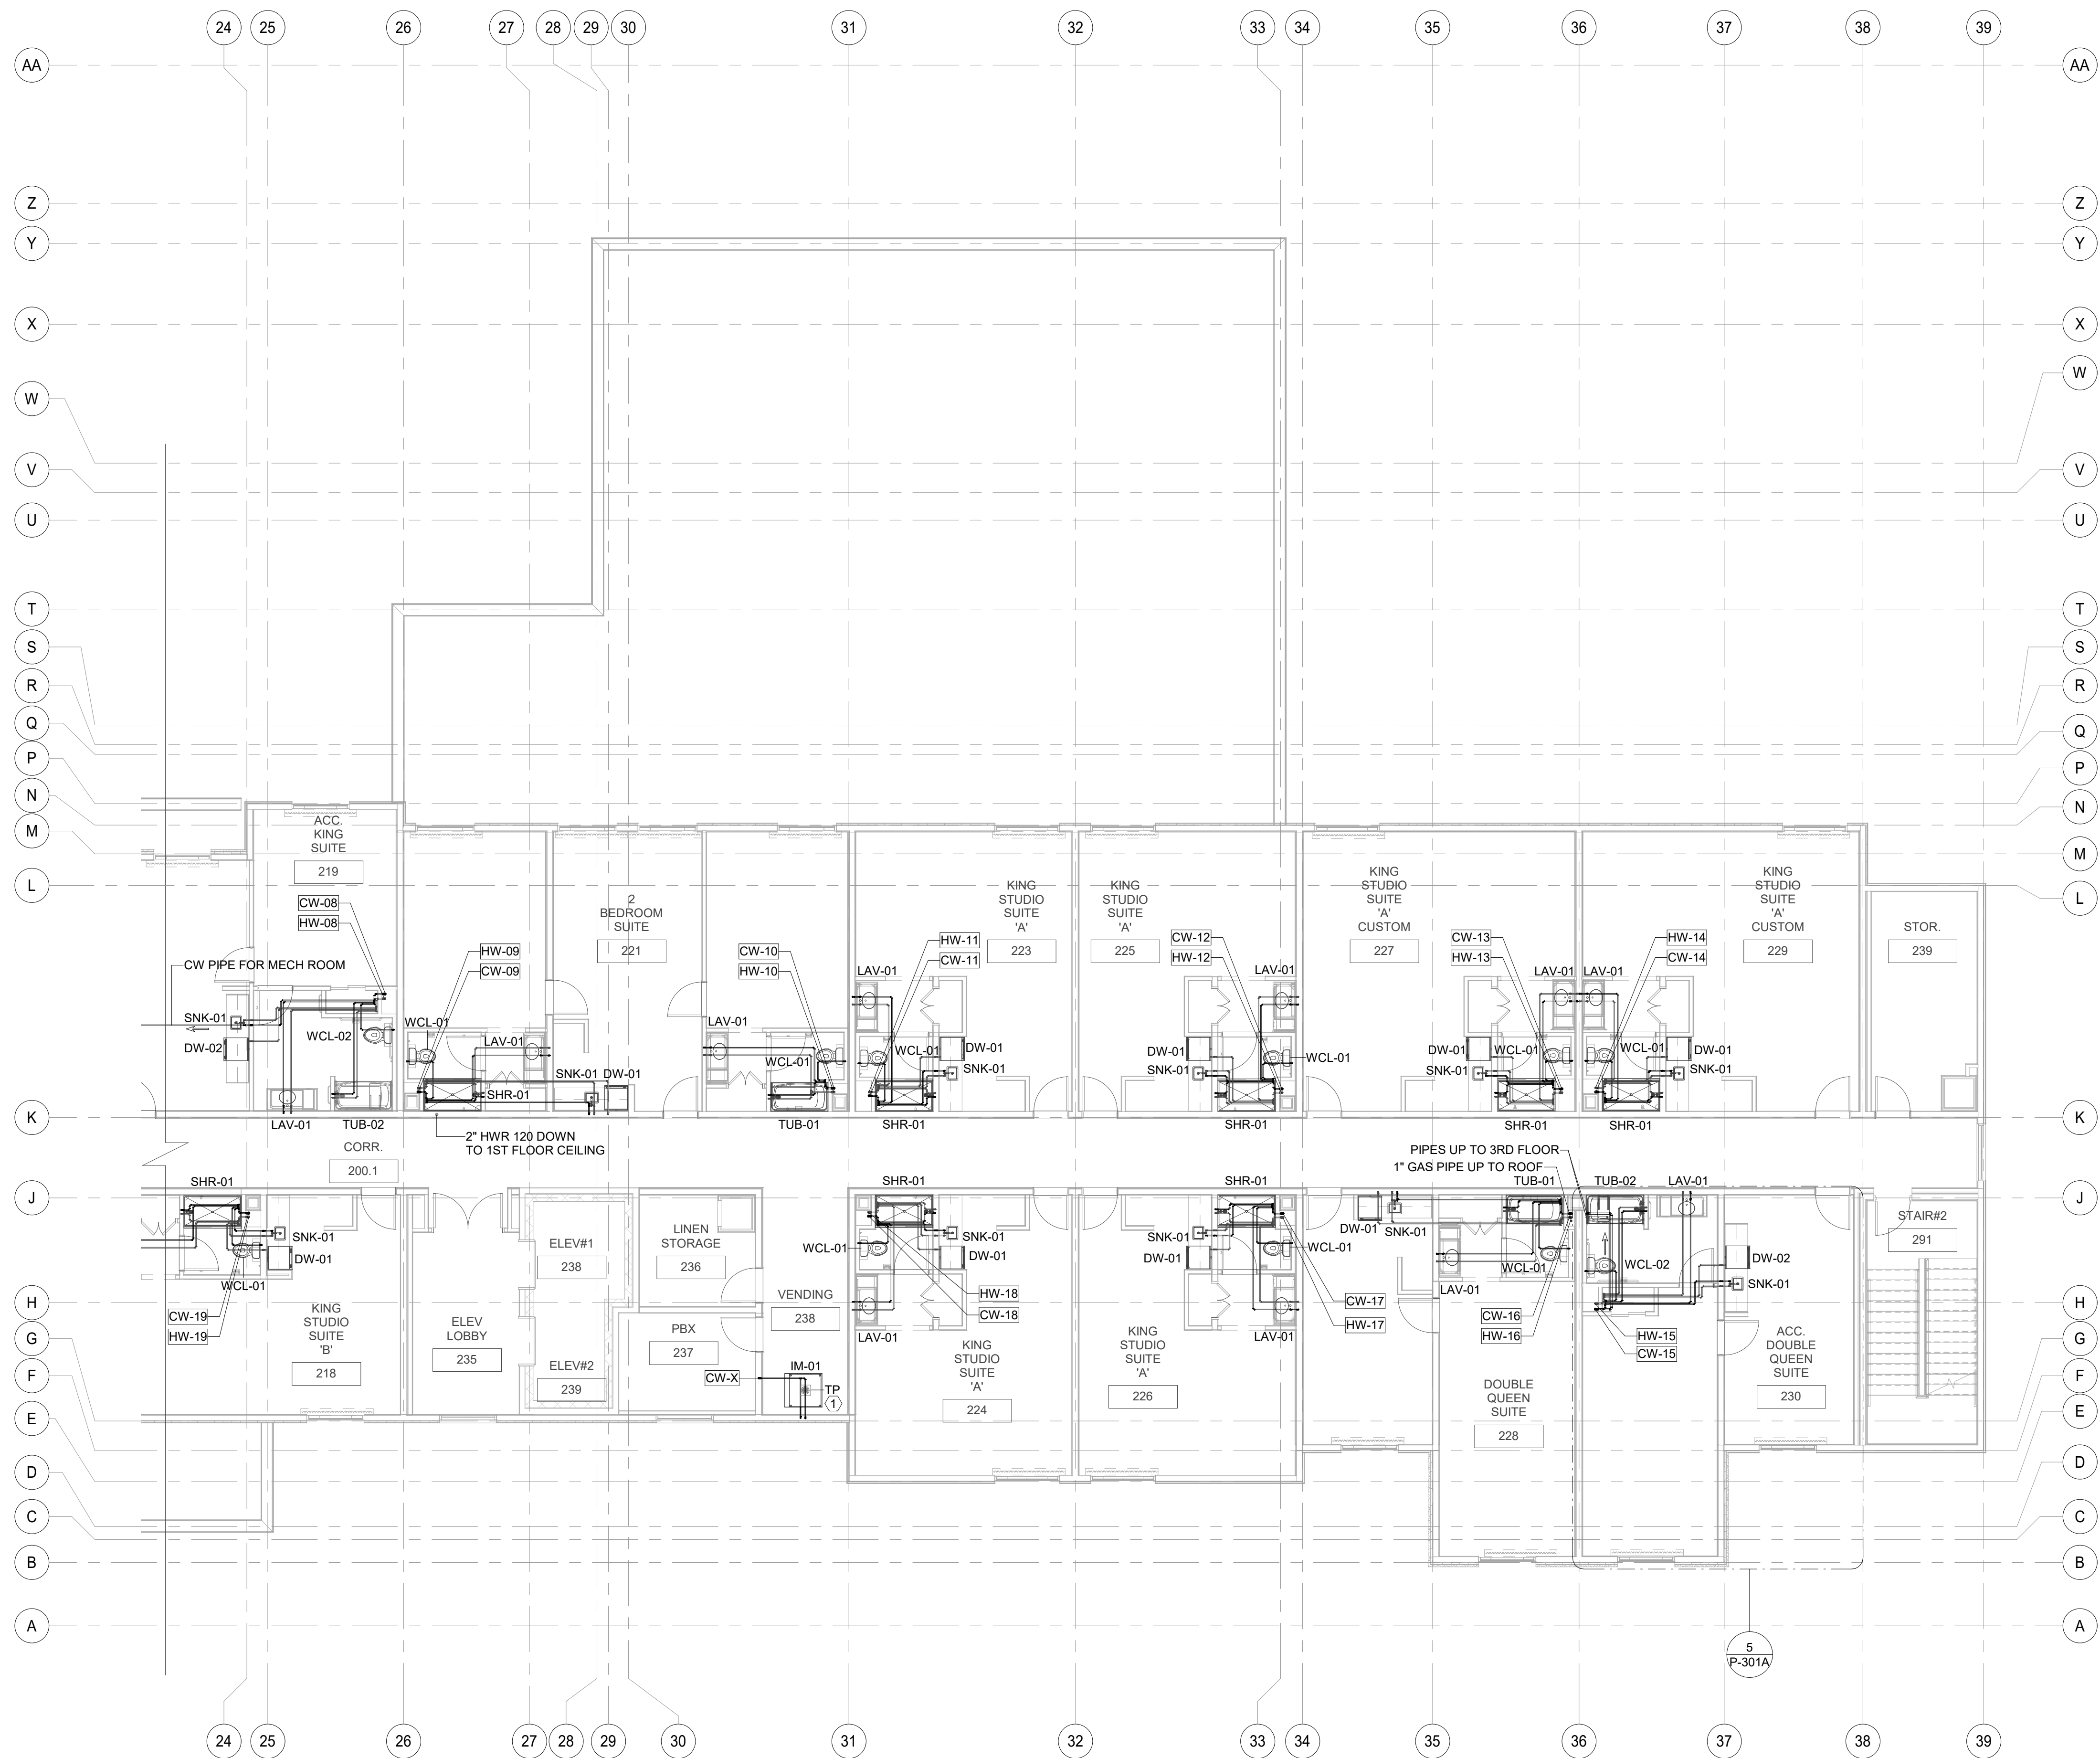
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PROJECT NO.
B4-124-1803

SHEET NAME

2ND FLOOR WATER & GAS SUPPLY PLAN-A



DRAWINGS NO.
P-203A



1 2ND FLOOR WATER & GAS SUPPLY PLAN PART-B
1/8" = 1'-0"

WATER SUPPLY KEYNOTE	
#	TEXT
1	PROVIDE AND INSTALL PRECISION PLUMBING PRODUCTS INC. #P1-500 TRAP PRIMER WITH 1/2" CW CONNECTION TO LINE. INDICATED ON DRAWING. EXTEND OFF TOP OF LINE PER MANUFACTURER INSTRUCTIONS.(OR) PROVIDE AND INSTALL THE PROSET TRAP GUARD FLOOR DRAIN AS ALTERNATIVE.

B-20-0180
City of Puyallup

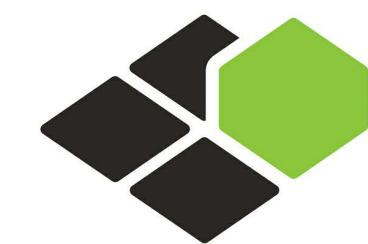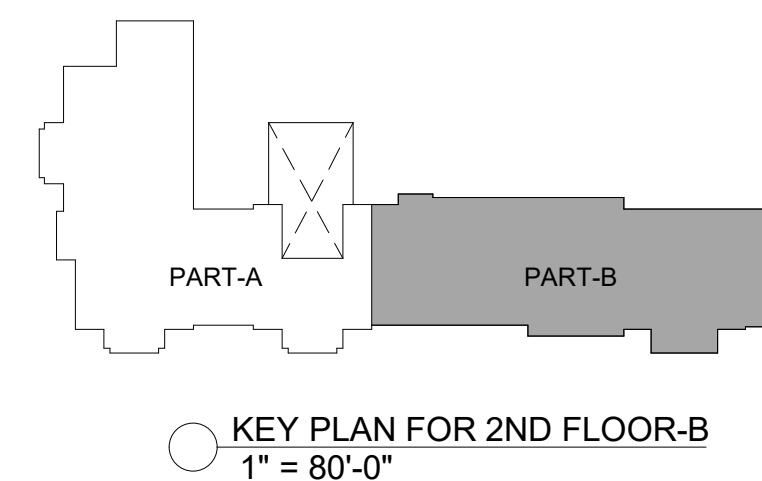

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CORAL SPRINGS, FL 33076

MEP ENGINEER
GARRY VERMAAS PhD, PE
2183 S BERRYS CHAPEL ROAD
FRANKLIN, TN 37069

Seal:



Owner:



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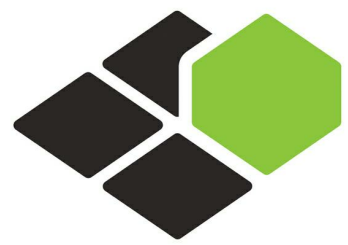
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B4-124-1803

SHEET NAME

2ND FLOOR WATER
& GAS SUPPLY
PLAN-B

DRAWINGS NO.

P-203B




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MEP ENGINEER
GARRY VERMAAS PhD, PE
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Seal:



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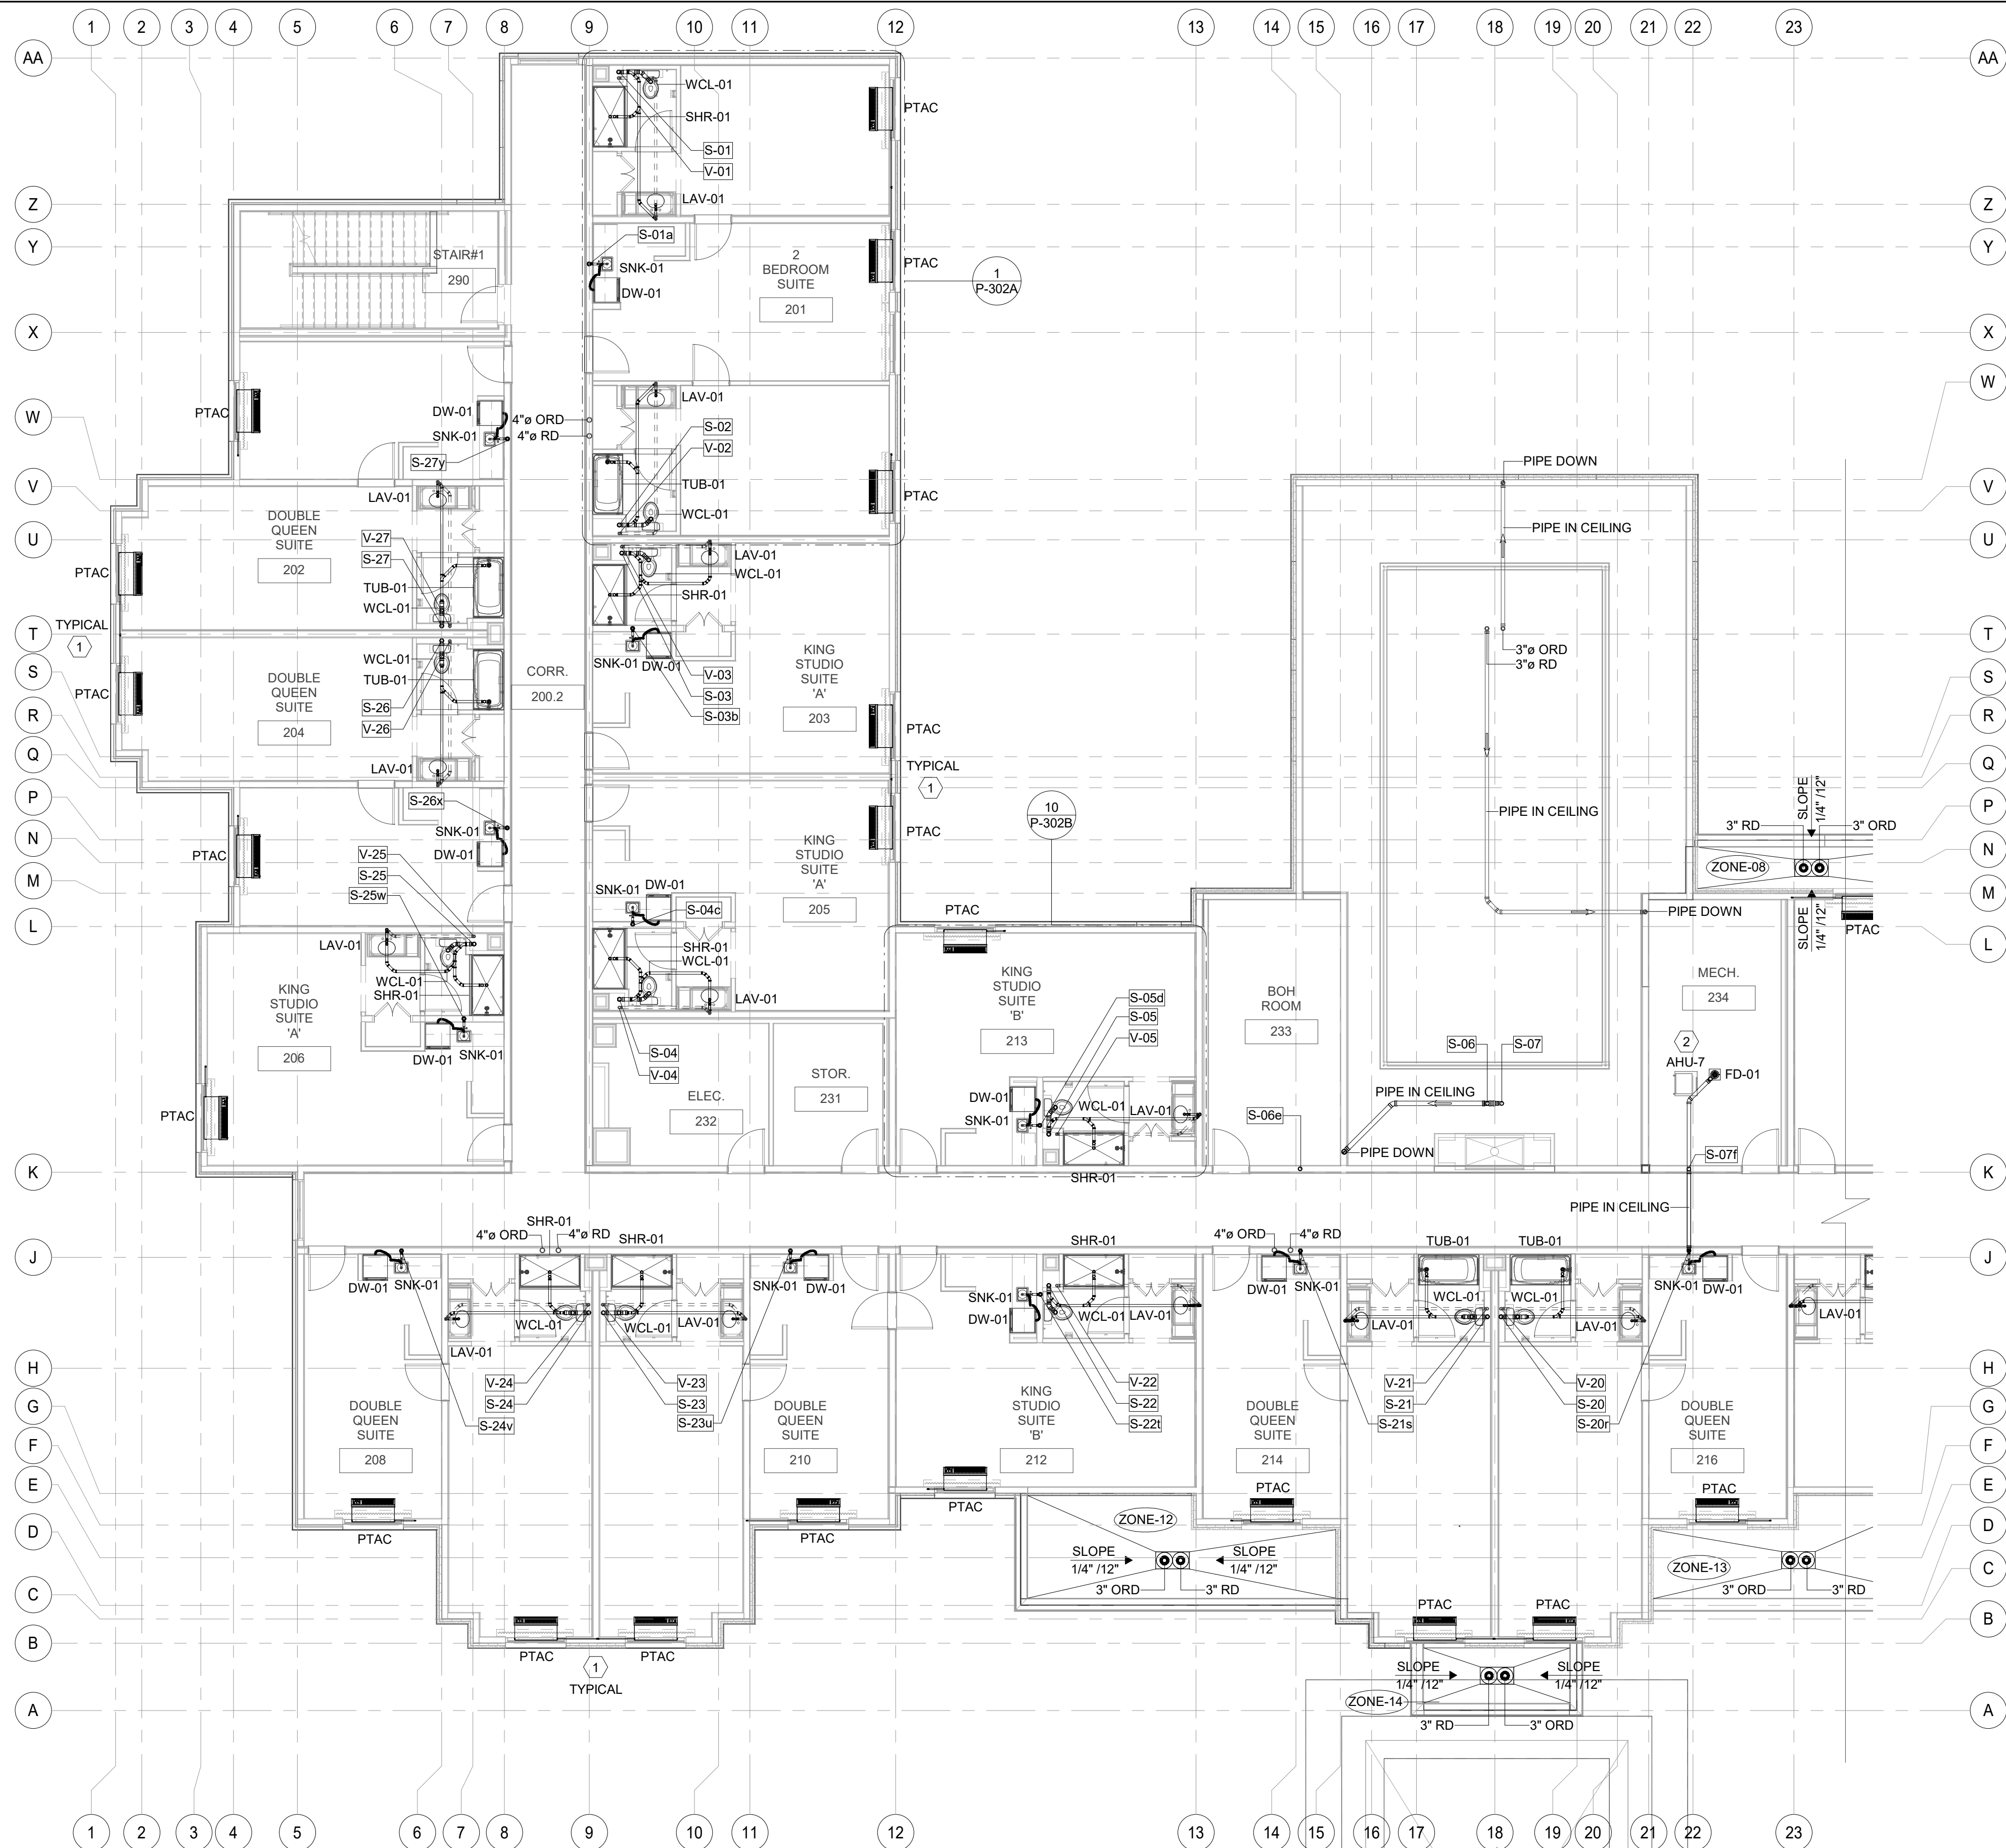
PROJECT NO.
B4-124-1803

SHEET NAME

**2ND FLOOR
SANITARY & VENT
PLAN-A**

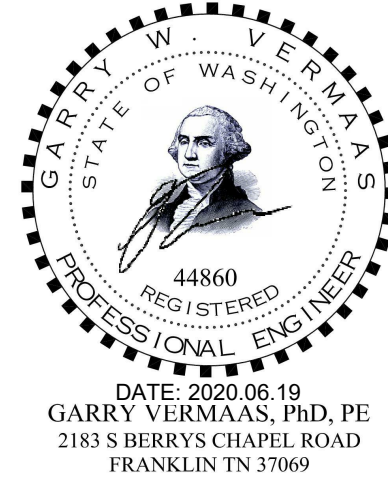DRAWINGS NO.

P-204A



1 2ND FLOOR SANITARY & VENT PLAN PART-A
1/8" = 1'-0"


GENERAL NOTE

1. ALL SANITARY & WATER PIPES WHICH ARE TO BE ROUTED THROUGH THE TRUSSES/TJ'S. TRUSS/TJI MANUFACTURER TO COORDINATE WITH PLUMBING CONTRACTOR ON SITE FOR TRUSS/TJI TO BE SPACED ACCORDINGLY TO AVOID CLASH.

SANITARY & VENT KEYNOTES.

#	TEXT
1	3/4" CONDENSATE RISER DOWN, SEE LOWER FLOOR PLANS FOR CONTINUATION. ROUTE EACH CONDENSATE VERTICAL RISER TO CONNECT TO NEAREST SANITARY LINE. GC TO COORDINATE CONNECTION & ENSURE SLOPE OF 1/8" FT. FOR THE HORIZONTAL RUN OF PIPE. TYPICAL FOR ALL PTAC'S UNITS CONDENSATE DRAINAGE UNLESS NOTED OTHERWISE.
2	ALL FLOOR MOUNTED AHU SHALL INDIRECTLY CONNECT TO NEAREST FLOOR DRAIN & NEED TO CONNECT TO NEAREST SANITARY LINE. CONTRACTOR TO COORDINATE WITH THE CONNECTIONS & ENSURE SLOPE OF 1/8" PER FT IS MAINTAINED.

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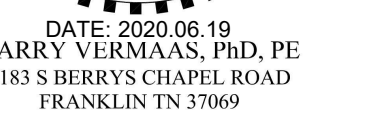


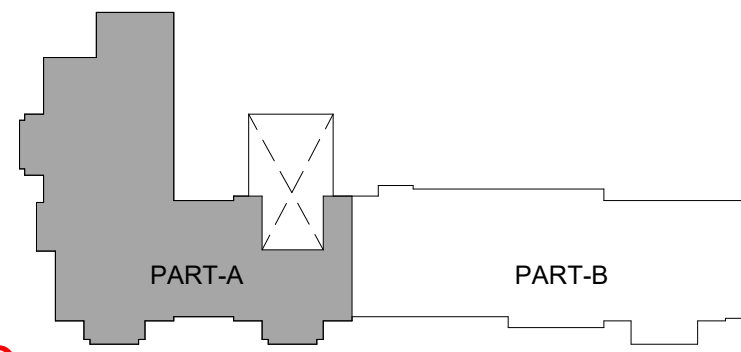KEY PLAN FOR 2ND FLOOR-A
1" = 80'-0"



RICARDO J. MUNIZ-GUILLET, AIA
5453 NW 106TH DR
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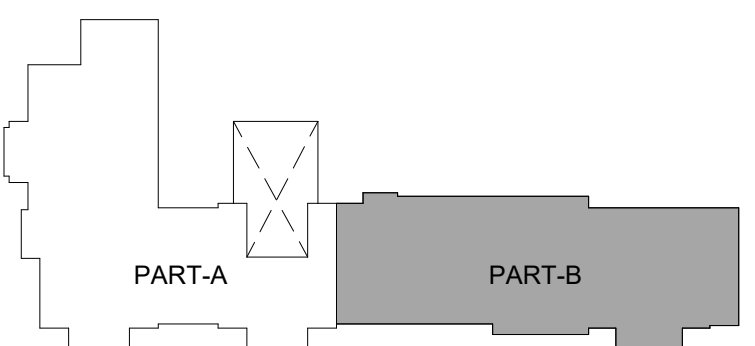
PROJECT NO. B4-124-1803

SHEET NAME

2ND FLOOR
SANITARY & VENT
PLAN-B

RAWINGS NO.

P-204B



○ KEY PLAN FOR 2ND FLOOR-B
1" = 80'-0"

SANITARY & VENT KEYNOTE


#	TEXT
①	3/4" CONDENSATE RISER DOWN, SEE LOWER FLOOR PLANS FOR CONTINUATION. ROUTE EACH CONDENSATE VERTICAL RISER TO CONNECT TO NEAREST SANITARY LINE. GC TO COORDINATE CONNECTION & ENSURE SLOPE OF 1/8"FT. FOR THE HORIZONTAL RUN OF PIPE. TYPICAL FOR ALL PTAC'S UNITS CONDENSATE DRAINAGE UNLESS NOTED OTHERWISE.

GENERAL NOTE

1. ALL SANITARY & WATER PIPES WHICH ARE TO BE ROUTED THROUGH THE TRUSSES/TJ'S. TRUSS/TJI MANUFACTURER TO COORDINATE WITH PLUMBING CONTRACTOR ON SITE FOR TRUSS/TJI TO BE SPACED ACCORDINGLY TO AVOID CLASH.


1 2ND FLOOR SANITARY & VENT PLAN PART-B
1/8" = 1'-0"

B-20-0180
City of Puyallup

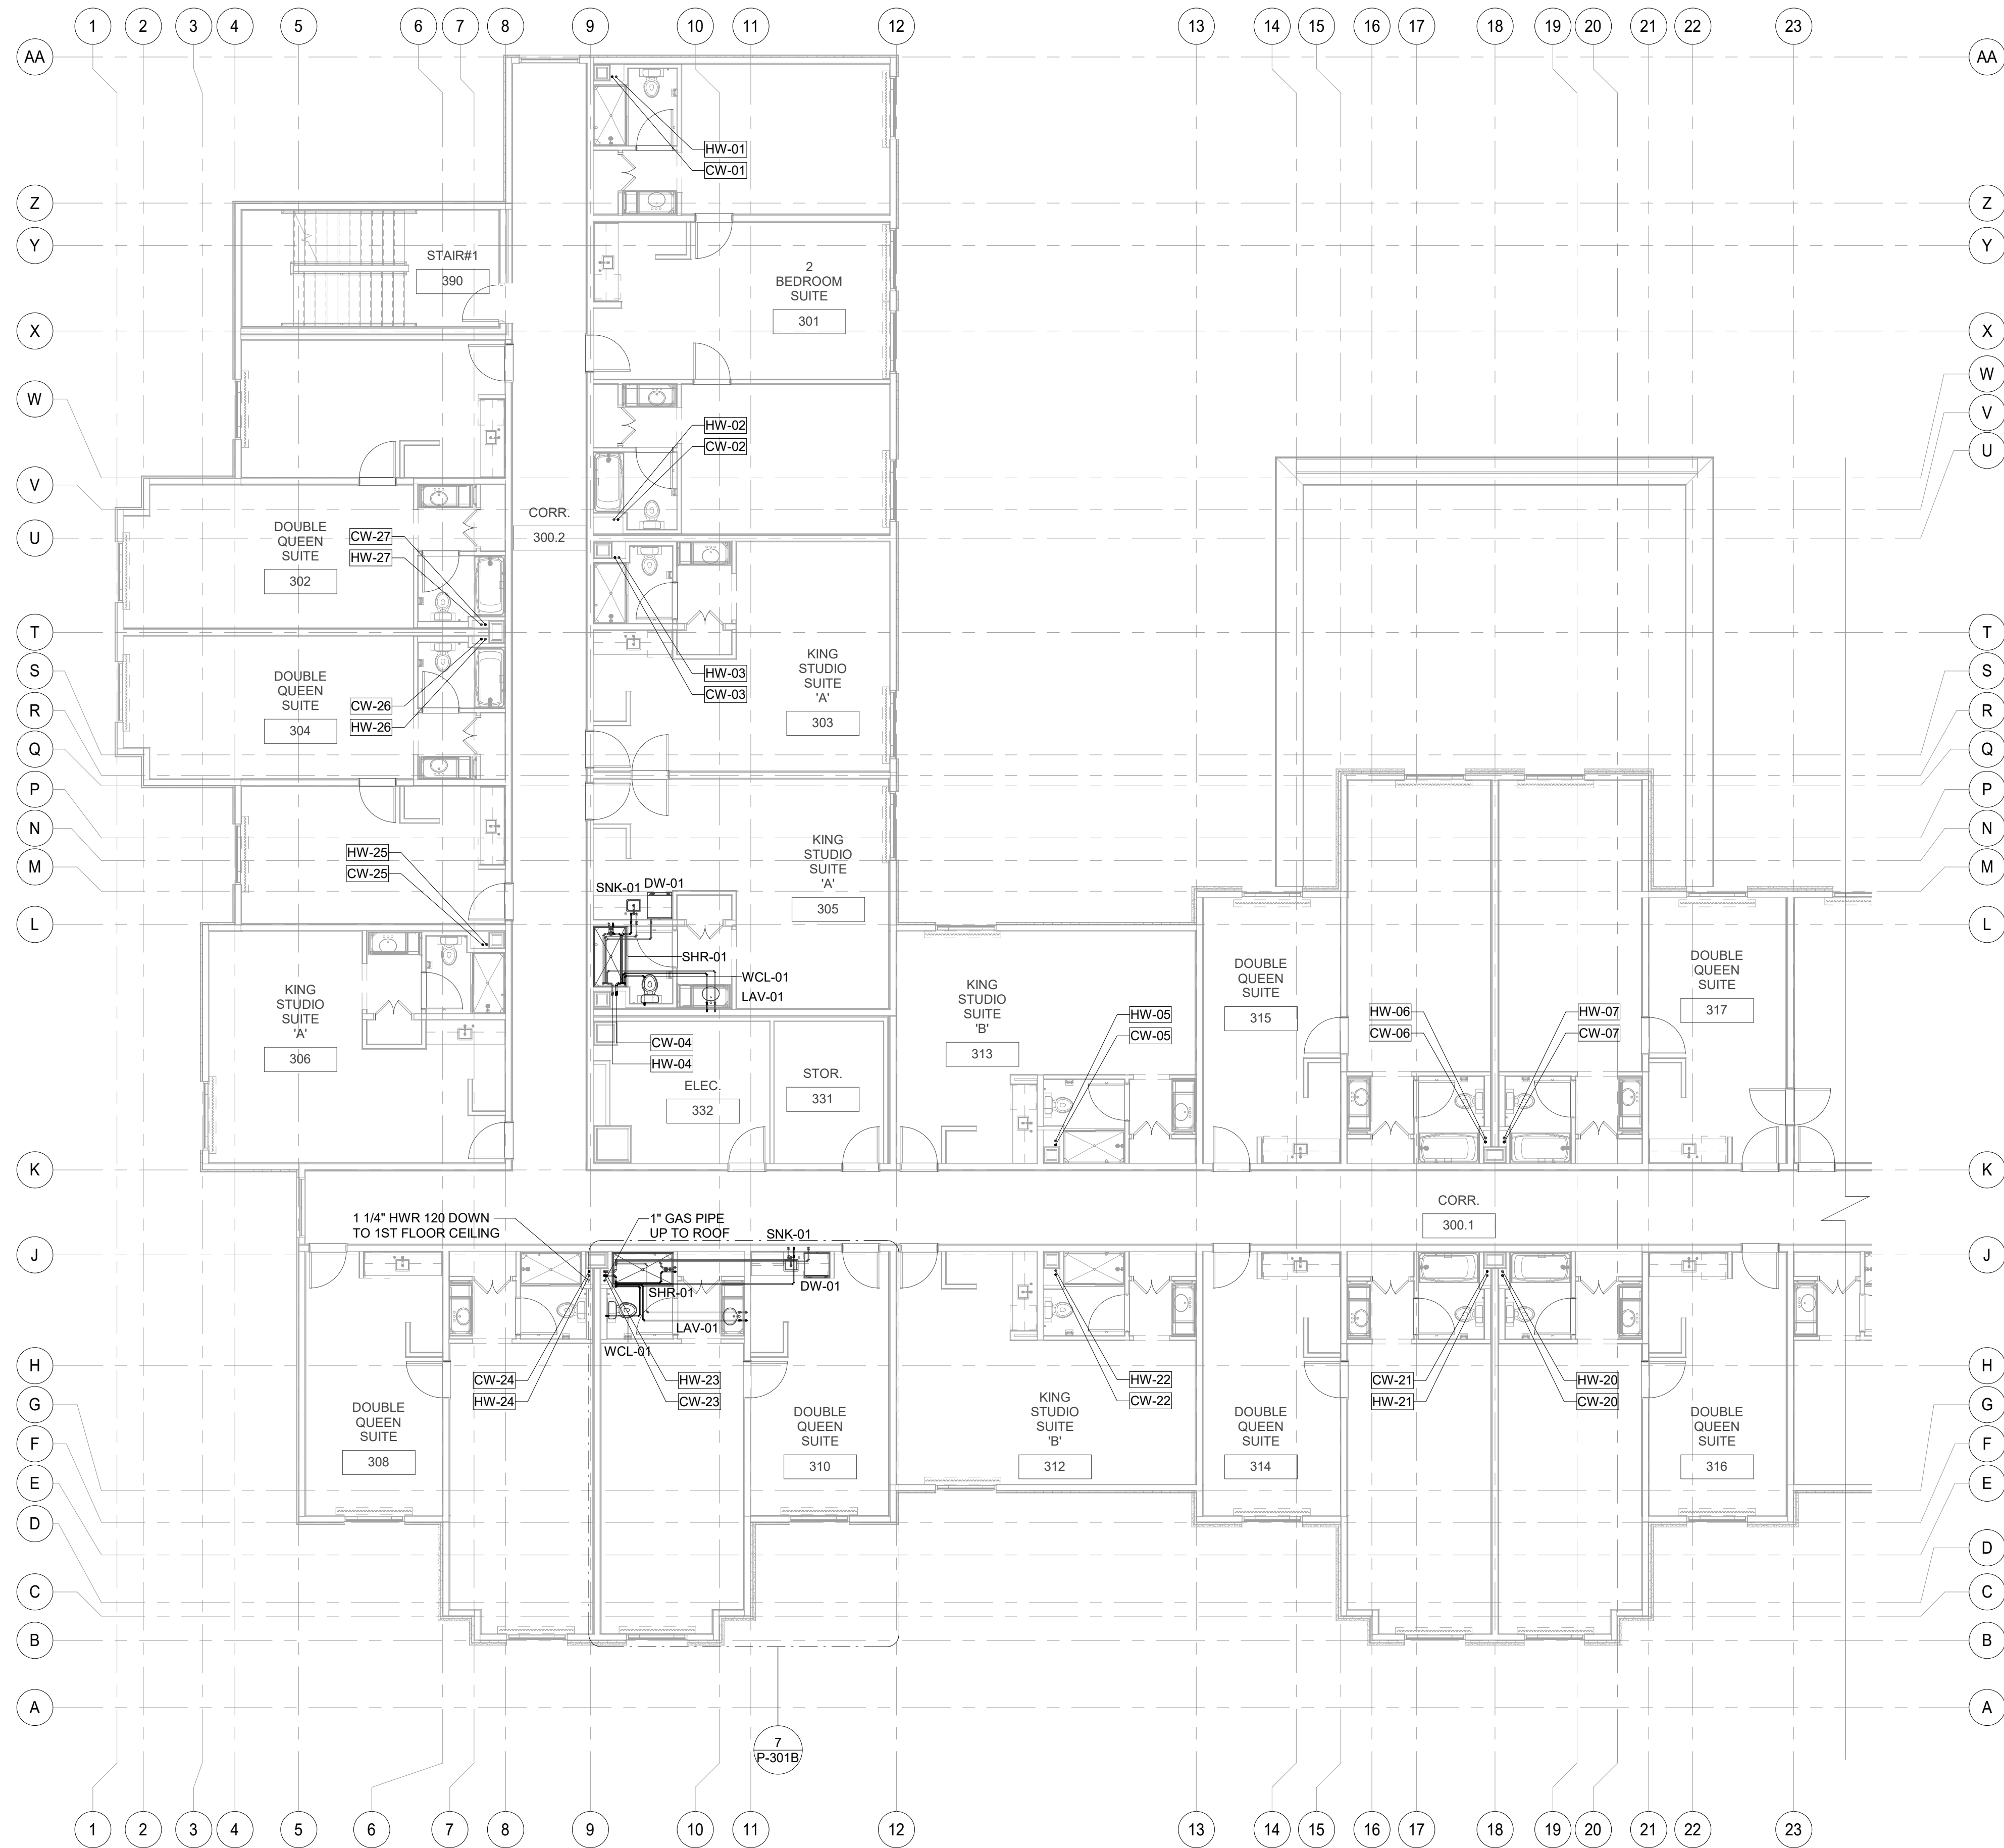


1 3RD FLOOR WATER & GAS SUPPLY PLAN PART-A
1/8" = 1'-0"

B-20-0180
City of Puyallup

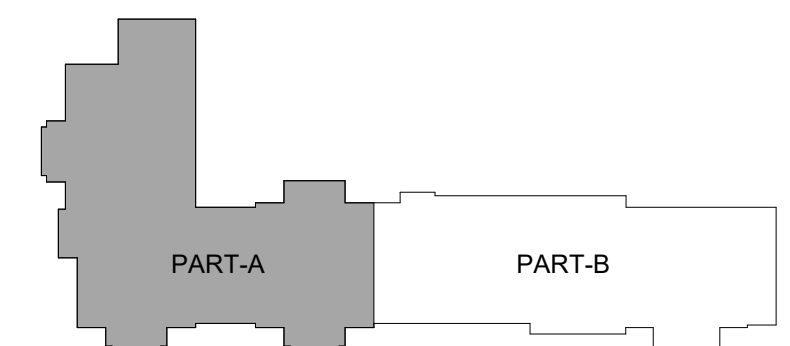

KEY PLAN FOR TYP. FLOOR-A
1" = 80'-0"

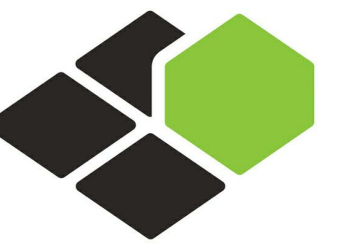

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CORAL SPRINGS, FL 33076

MEP ENGINEER
GARRY VERMAAS PhD, PE
2183 S BERRYS CHAPEL ROAD
FRANKLIN, TN 37069

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SHEET NAME

3RD FLOOR WATER
& GAS SUPPLY
PLAN-A

DRAWINGS NO.

P-205A



MEP ENGINEER
GARRY VERMAAS PhD, PE
2183 S BERRYS CHAPEL ROAD
FRANKLIN, TN 37069

DATE: 2020.06.19
 GARRY VERMAAS, PH.D, PE
 2183 S BERRYS CHAPEL ROAD
 FRANKLIN TN 37069




DLQ
Dakota Legacy Group
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3RD FLOOR WATER & GAS SUPPLY PLAN-B

P-205B




○ KEY PLAN FOR TYP. FLOOR-B
1" = 80'-0"

#	TEXT
①	PROVIDE AND INSTALL PRECISION PLUMBING PRODUCTS INC. #P1-500 TRAP PRIMER WITH 1/2" CW CONNECTION TO LINE INDICATED ON DRAWING. EXTEND OFF TOP OF LINE PER MANUFACTURER INSTRUCTIONS.(OR) PROVIDE AND INSTALL THE PROSET TRAP GUARD FLOOR DRAIN AS ALTERNATIVE.

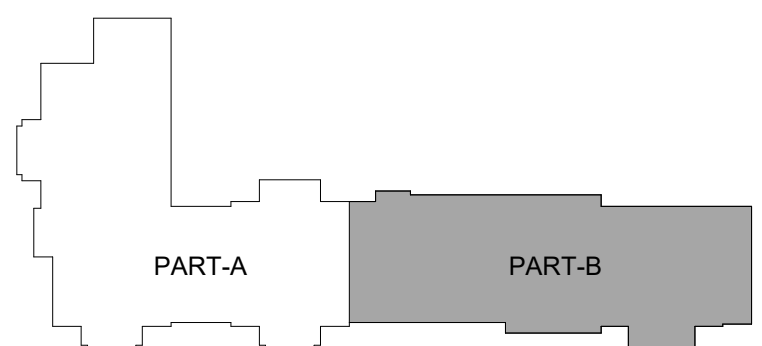1 3RD FLOOR WATER & GAS SUPPLY PLAN PART-B
1/8" = 1'-0"

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City of Puyallup

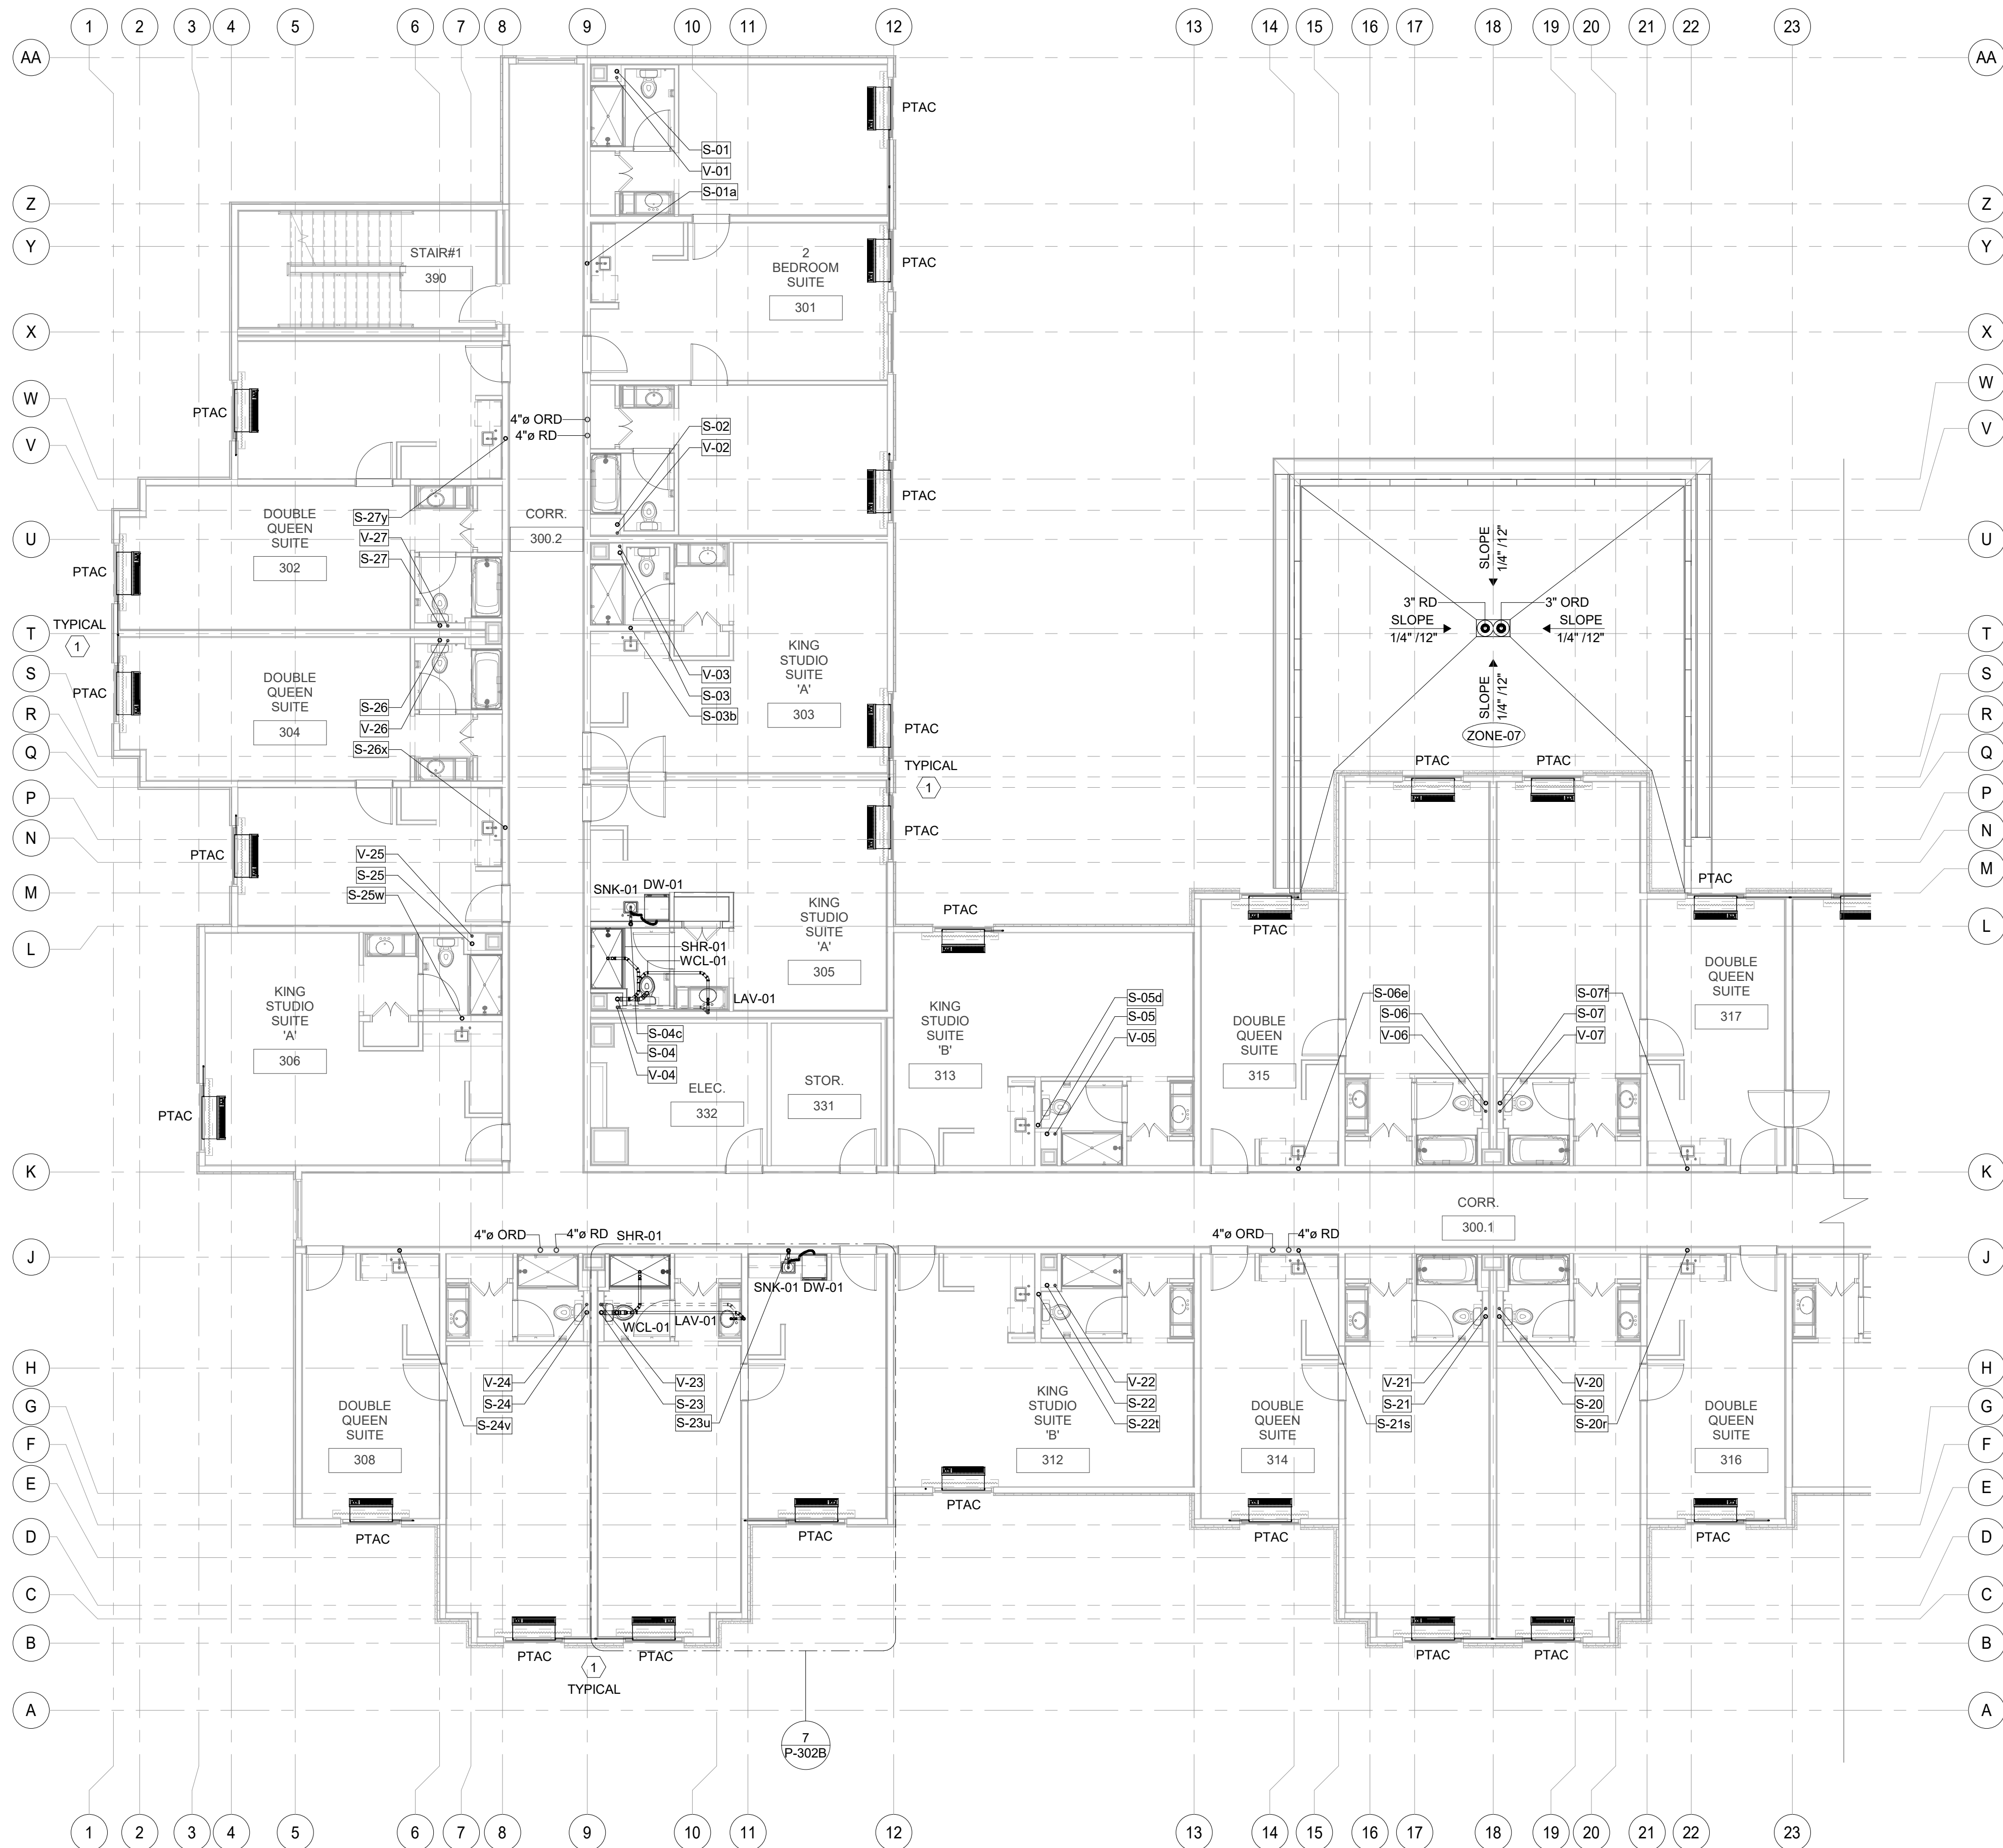


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1/8" = 1'-0"

GENERAL NOTE


1. ALL SANITARY & WATER PIPES WHICH ARE TO BE ROUTED THROUGH THE TRUSSES/TJ'S. TRUSSES/TJ'S MANUFACTURER TO COORDINATE WITH PLUMBING CONTRACTOR ON SITE FOR TRUSSES/TJ'S TO BE SPACED ACCORDINGLY TO AVOID CLASH.

SANITARY & VENT KEYNOTE	
#	TEXT
1	3/4" CONDENSATE RISER DOWN, SEE LOWER FLOOR PLANS FOR CONTINUATION. ROUTE EACH CONDENSATE VERTICAL RISER TO CONNECT TO NEAREST SANITARY LINE. GO TO COORDINATE CONNECTION & ENSURE SLOPE OF 1/8" FT FOR THE HORIZONTAL RUN OF PIPE. TYPICAL FOR ALL PTAC'S UNITS CONDENSATE DRAINAGE UNLESS NOTED OTHERWISE.

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KEY PLAN FOR TYP. FLOOR-A
1" = 80'-0"

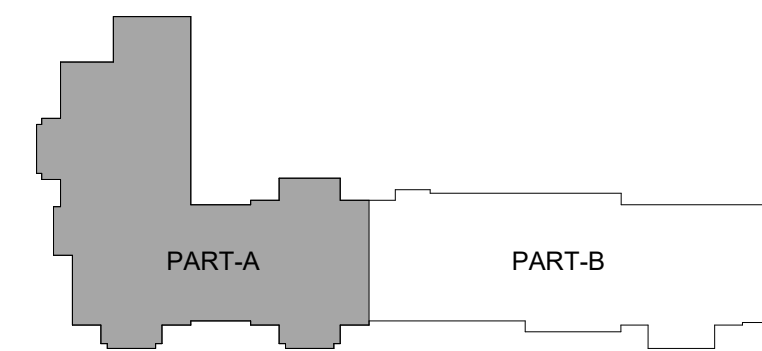

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5453 NW 106TH DR
CORAL SPRINGS, FL 33076

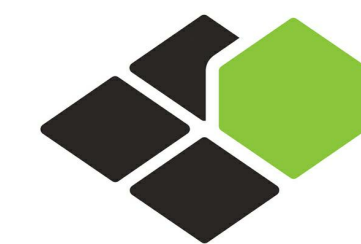MEP ENGINEER
GARRY VERMAAS PhD, PE
2183 S BERRYS CHAPEL ROAD
FRANKLIN, TN 37069

Seal:



Owner:



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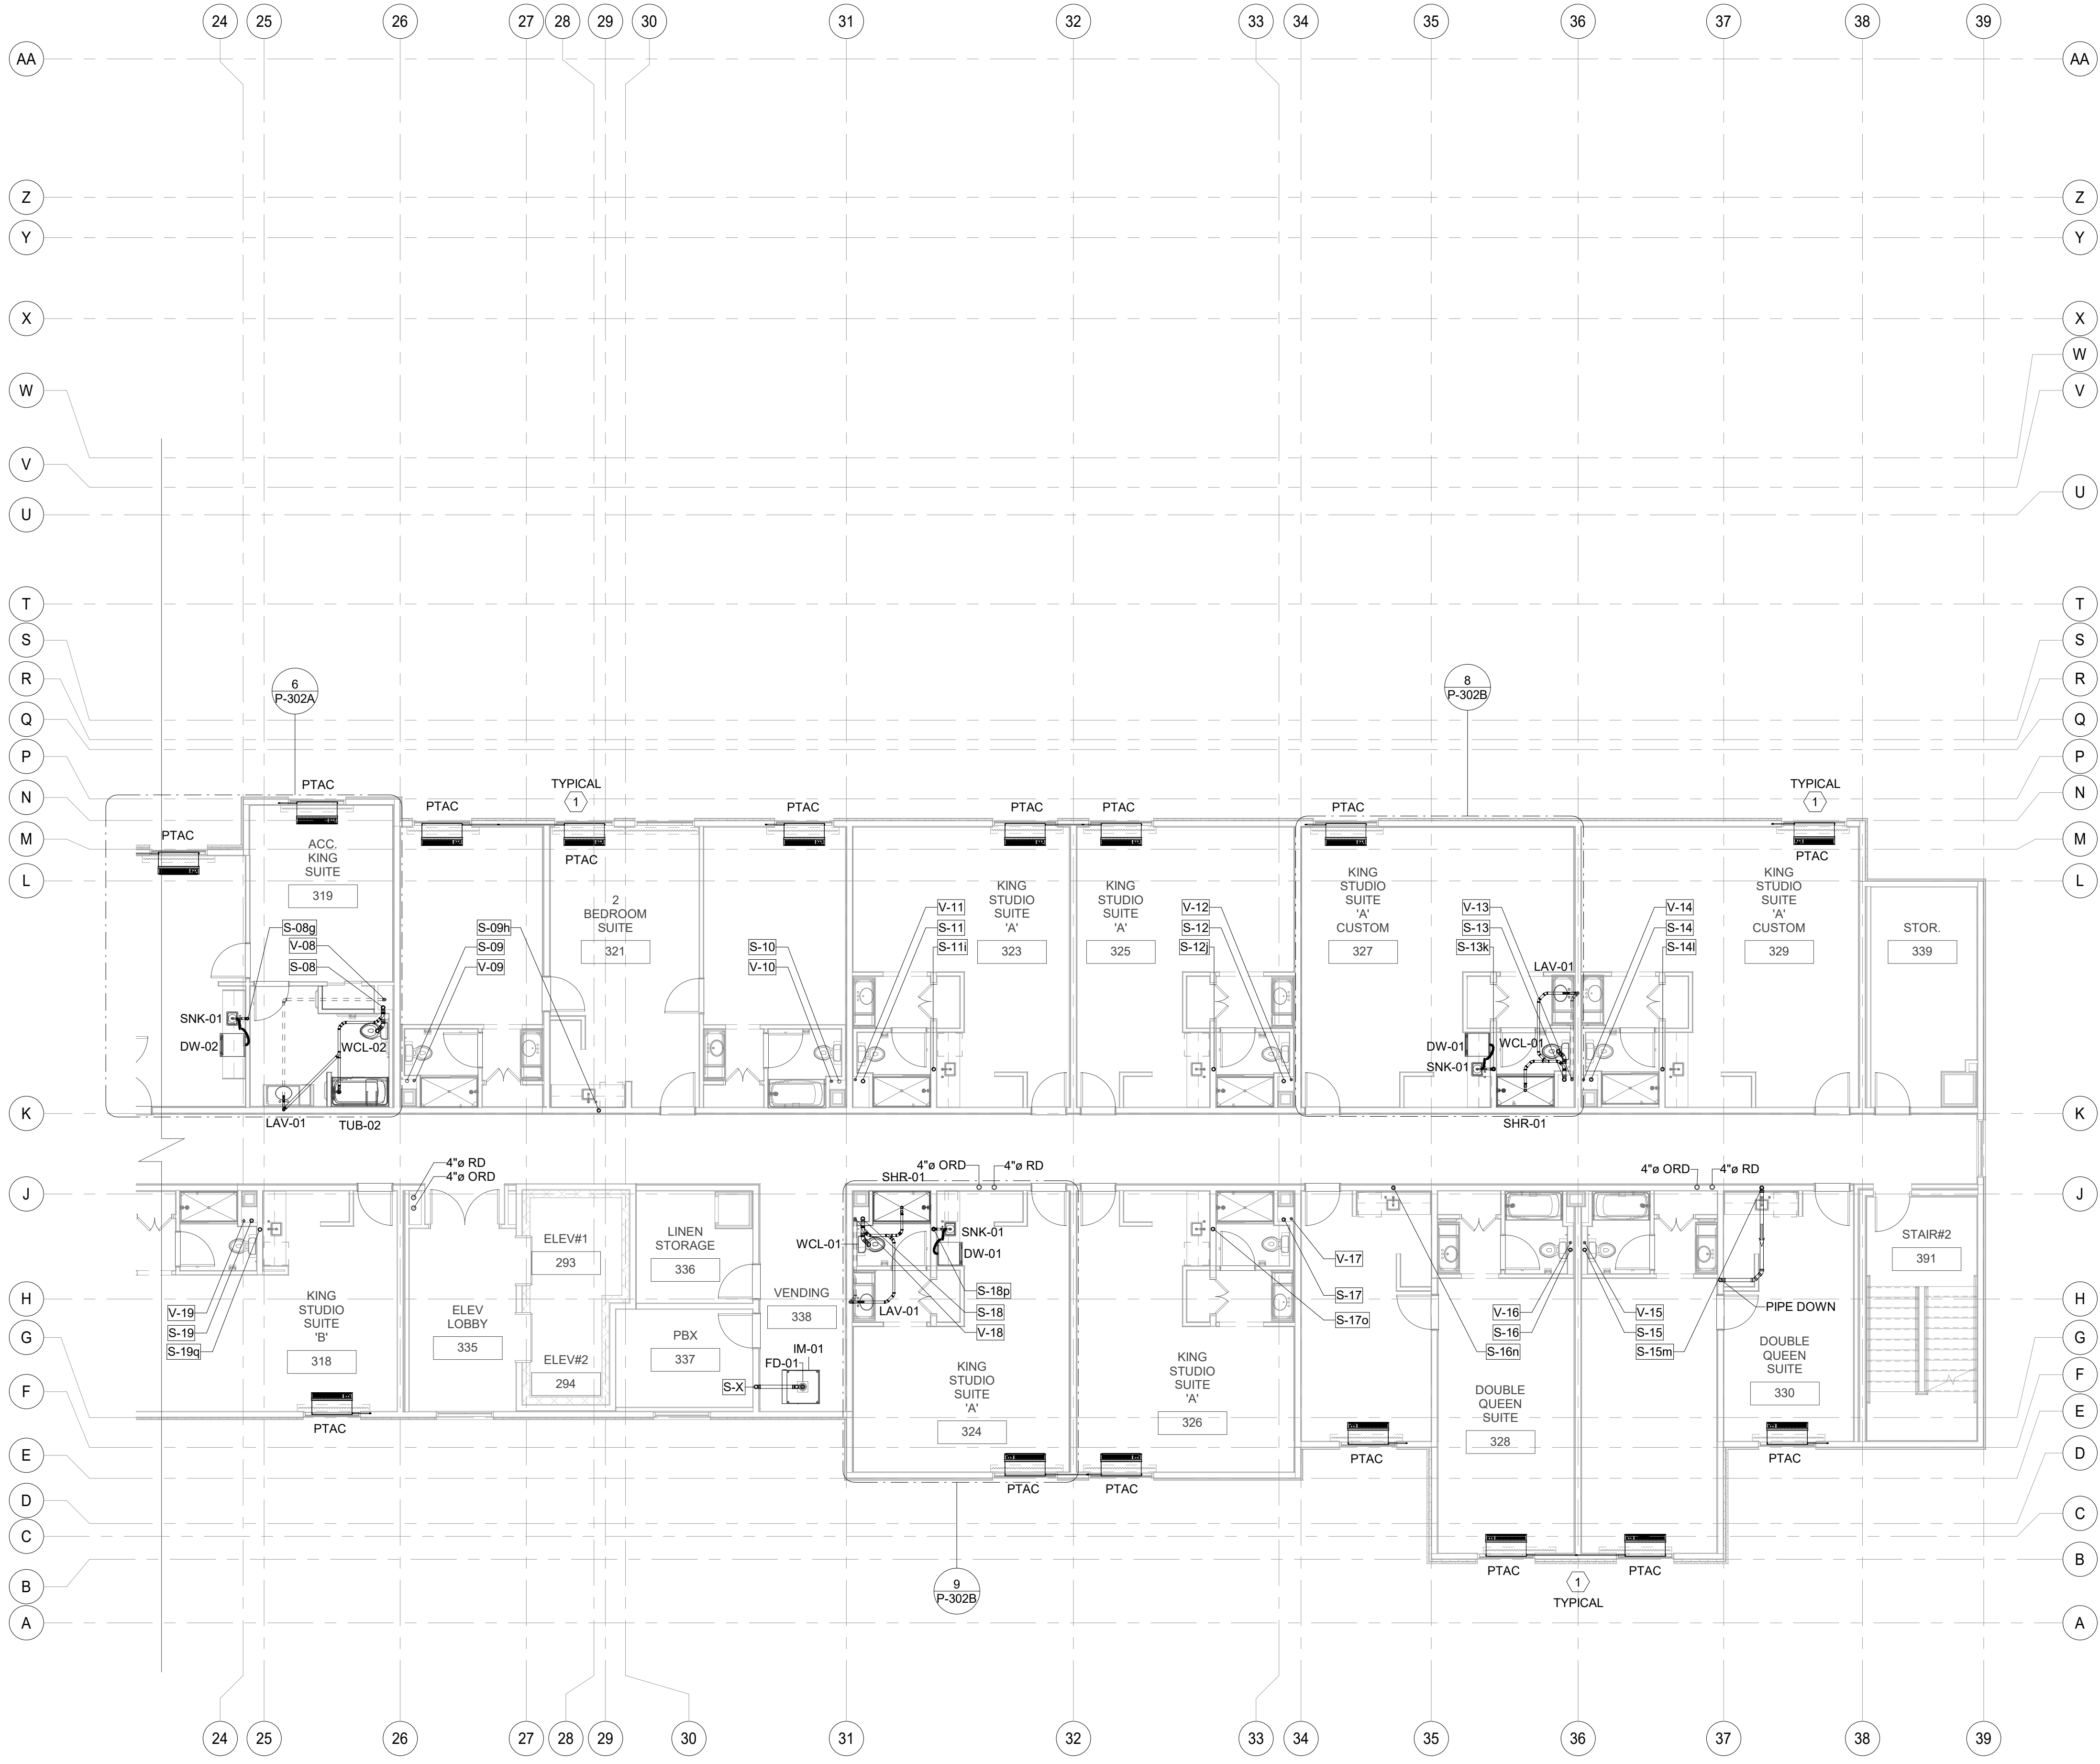
PROJECT NO.
B4-124-1803

SHEET NAME

**3RD FLOOR
SANITARY & VENT
PLAN-A**

DRAWINGS NO.

P-206A




GENERAL NOTE


1. ALL SANITARY & WATER PIPES WHICH ARE TO BE ROUTED THROUGH THE TRUSSES/TJ'S. TRUSSES/TJ MANUFACTURER TO COORDINATE WITH PLUMBING CONTRACTOR ON SITE FOR TRUSSES/TJ TO BE SPACED ACCORDINGLY TO AVOID CLASH.

#	TEXT
①	3/4" CONDENSATE RISER DOWN, SEE LOWER FLOOR PLANS FOR CONTINUATION. ROUTE EACH CONDENSATE VERTICAL RISER TO CONNECT TO NEAREST SANITARY LINE. GC TO COORDINATE CONNECTION & ENSURE SLOPE OF 1/8"FT. FOR THE HORIZONTAL RUN OF PIPE. TYPICAL FOR ALL PTAC'S UNITS CONDENSATE DRAINAGE UNLESS NOTED OTHERWISE.

① 3RD FLOOR SANITARY & VENT PLAN PART-B
1/8" = 1'-0"


B-20-0180
City of Puyallup

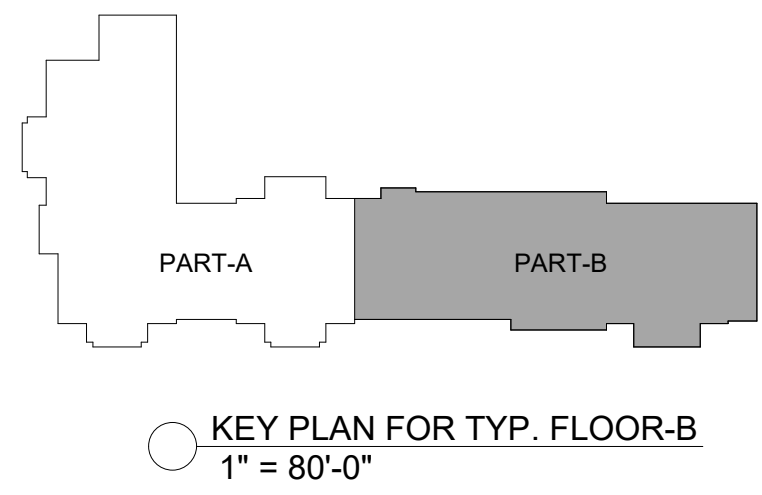

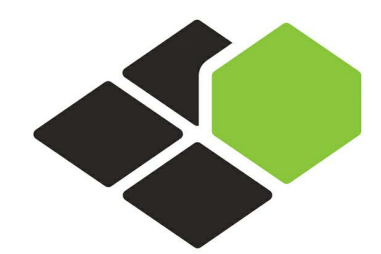


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MEP ENGINEER
GARRY VERMAAS PhD, PE
2183 S BERRYS CHAPEL ROAD
FRANKLIN, TN 37069

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

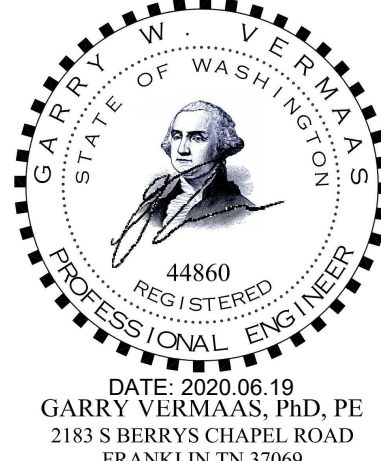
DATE: 2020.06.19
GARRY VERMAAS, PhD, PE
2183 S BERRYS CHAPEL ROAD
FRANKLIN, TN 37069

Owner:



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Hospitality Development
4500 36TH AVE. S SUITE
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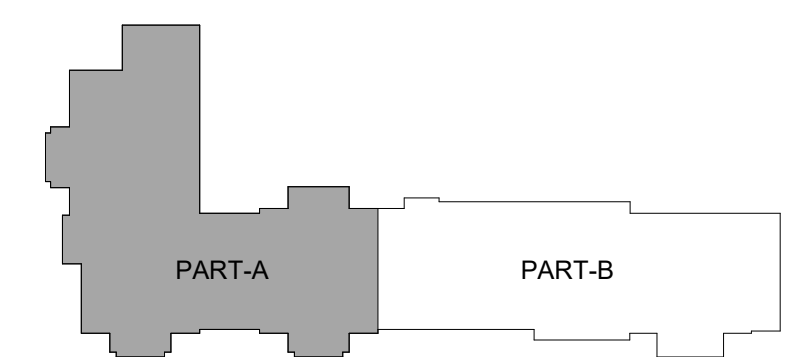
**3RD FLOOR
SANITARY & VENT
PLAN-B**

DRAWINGS NO.
P-206B



1 4TH FLOOR WATER & GAS SUPPLY PLAN PART-A
1/8" = 1'-0"

B-20-0180
City of Puyallup



KEY PLAN FOR TYP. FLOOR-A
1" = 80'-0"




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MEP ENGINEER
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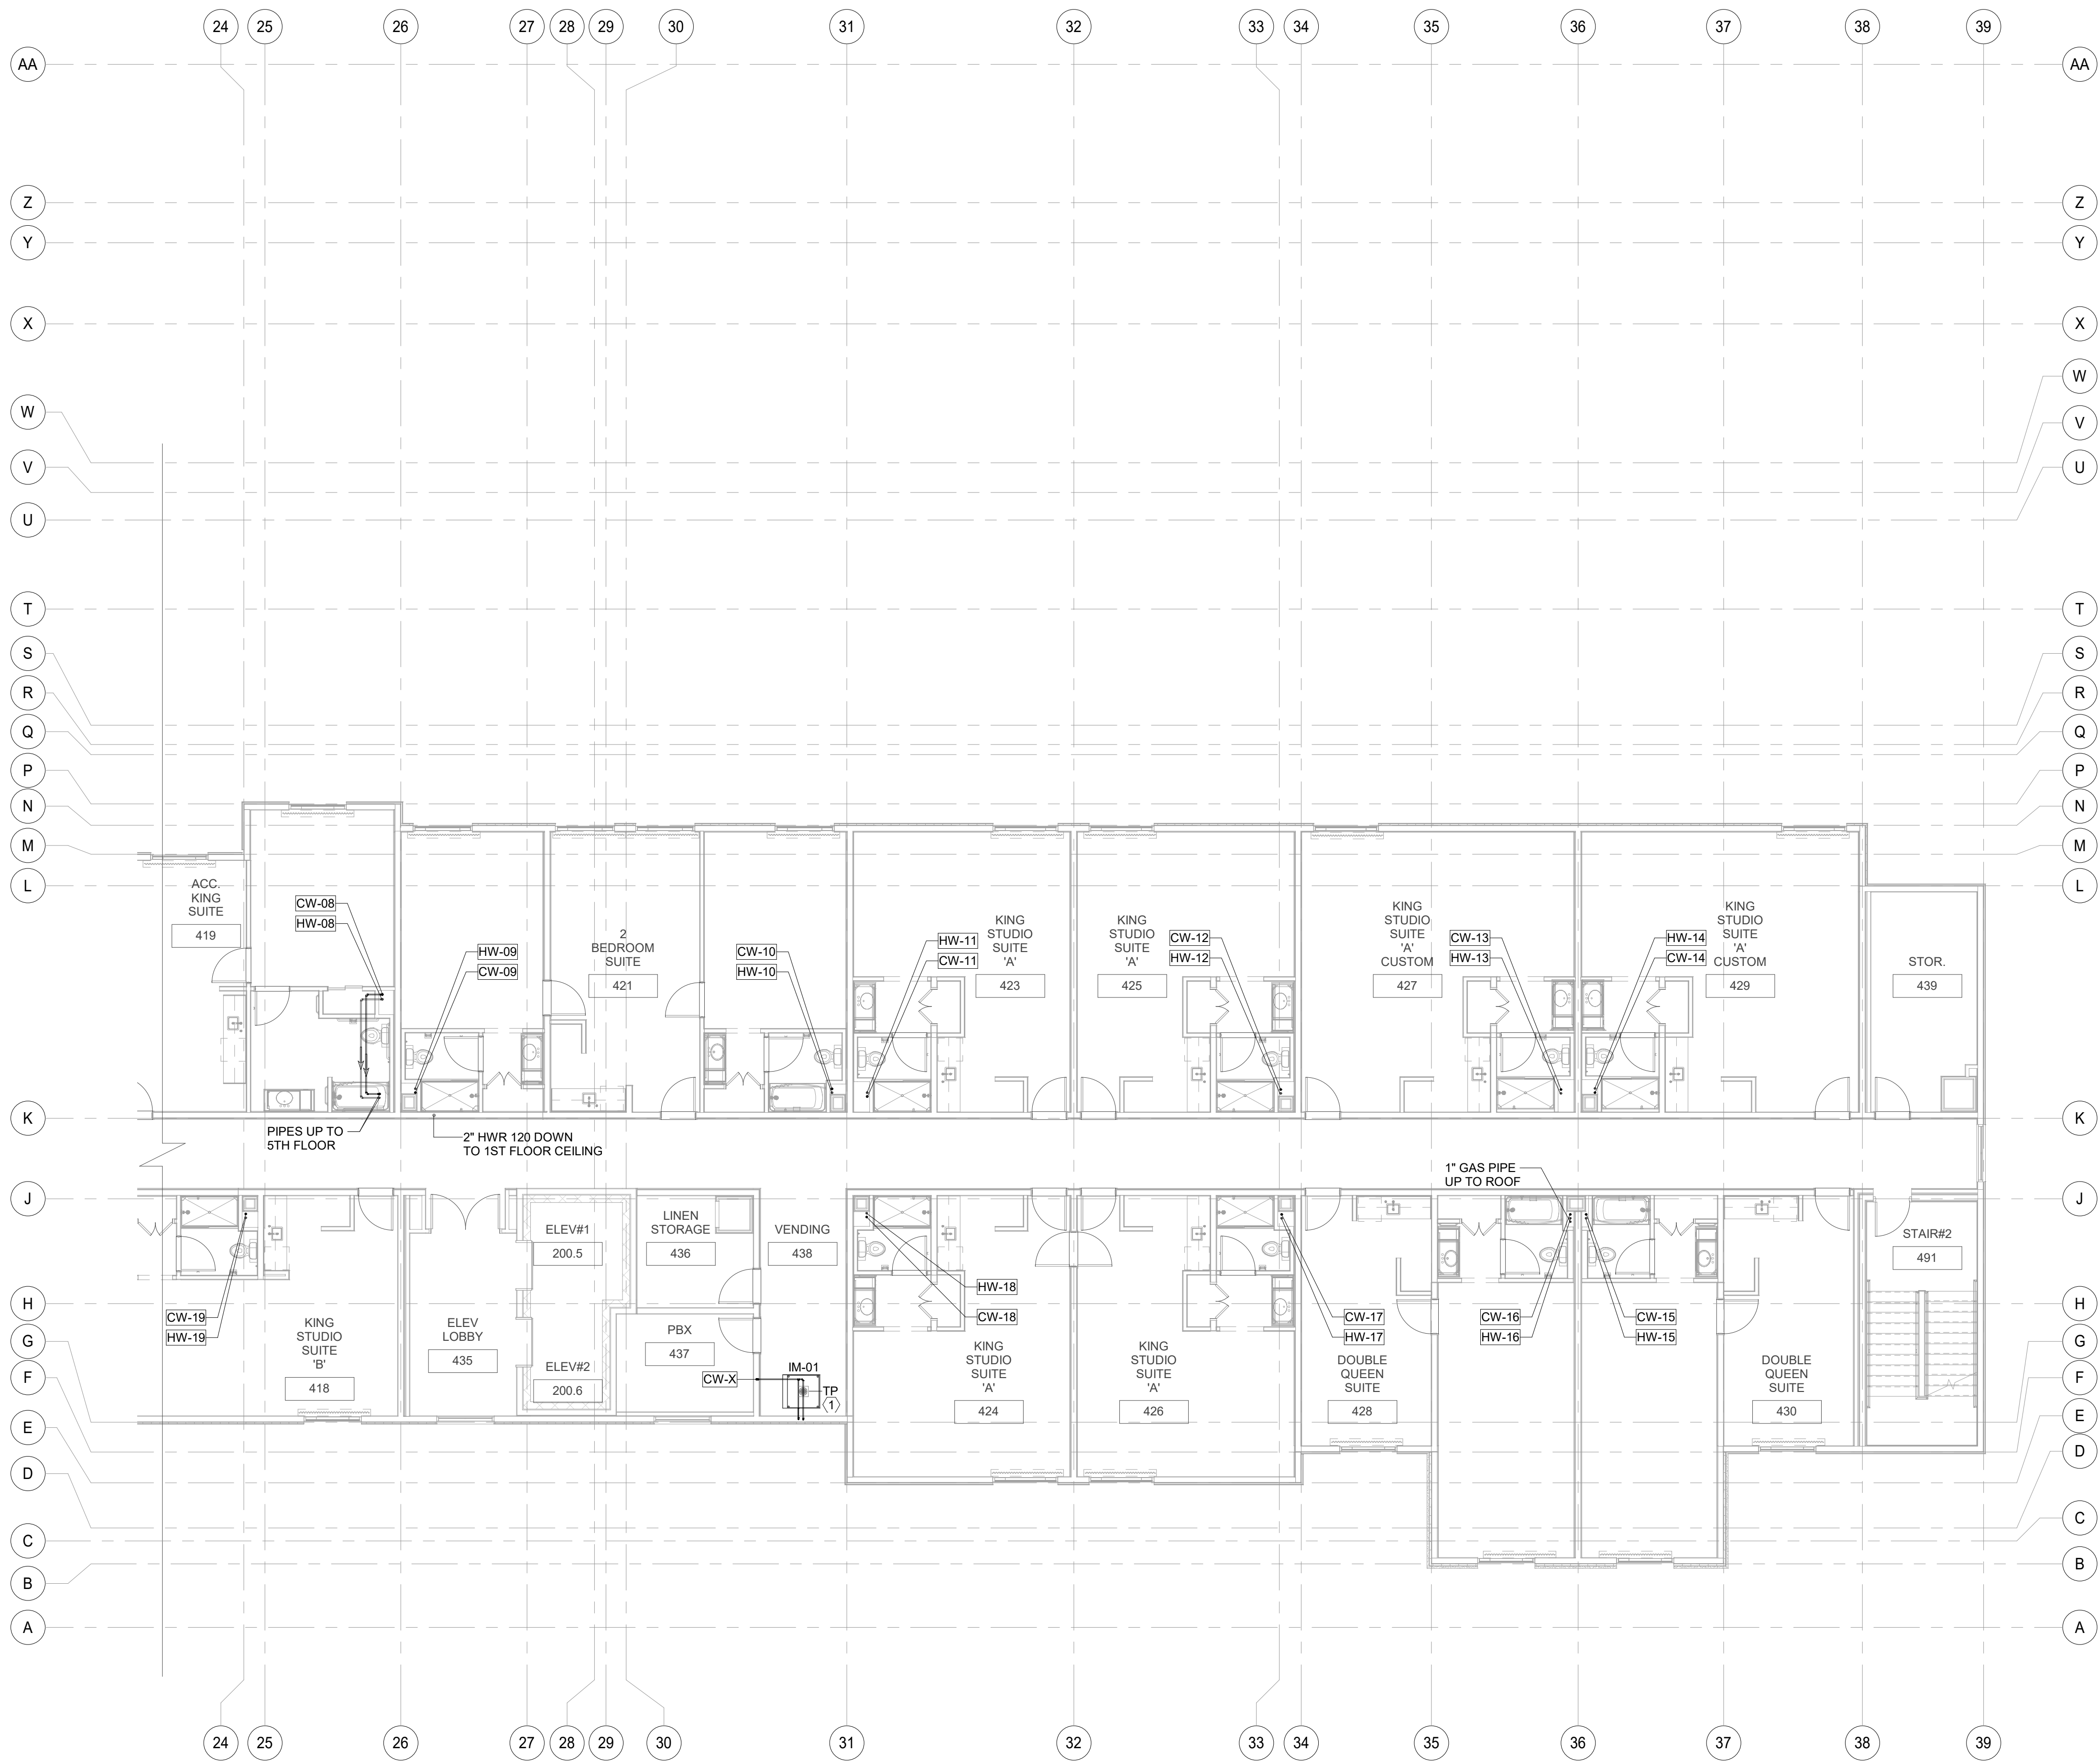
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B4-124-1803

SHEET NAME

4TH FLOOR WATER
& GAS SUPPLY
PLAN-A

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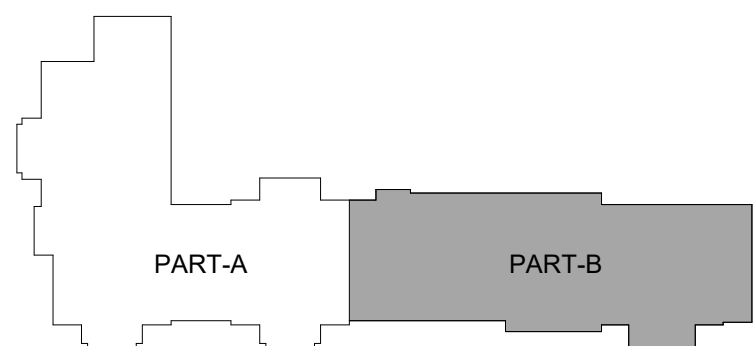
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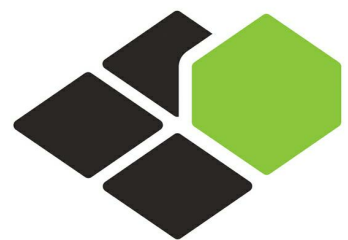
WATER SUPPLY KEYNOTE	
#	TEXT
①	PROVIDE AND INSTALL PRECISION PLUMBING PRODUCTS INC. #P1-500 TRAP PRIMER WITH 1/2" CW CONNECTION TO LINE. INDICATED ON DRAWING. EXTEND OFF TOP OF LINE PER MANUFACTURER INSTRUCTIONS.(OR) PROVIDE AND INSTALL THE PROSET TRAP GUARD FLOOR DRAIN AS ALTERNATIVE.

① 4TH FLOOR WATER & GAS SUPPLY PLAN PART-B
1/8" = 1'-0"

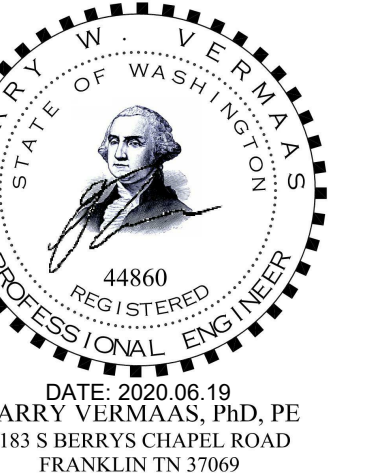B-20-0180
City of Puyallup



KEY PLAN FOR TYP. FLOOR-B
1" = 80'-0"




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MEP ENGINEER
GARRY VERMAAS PhD, PE
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FRANKLIN, TN 37069

Seal:



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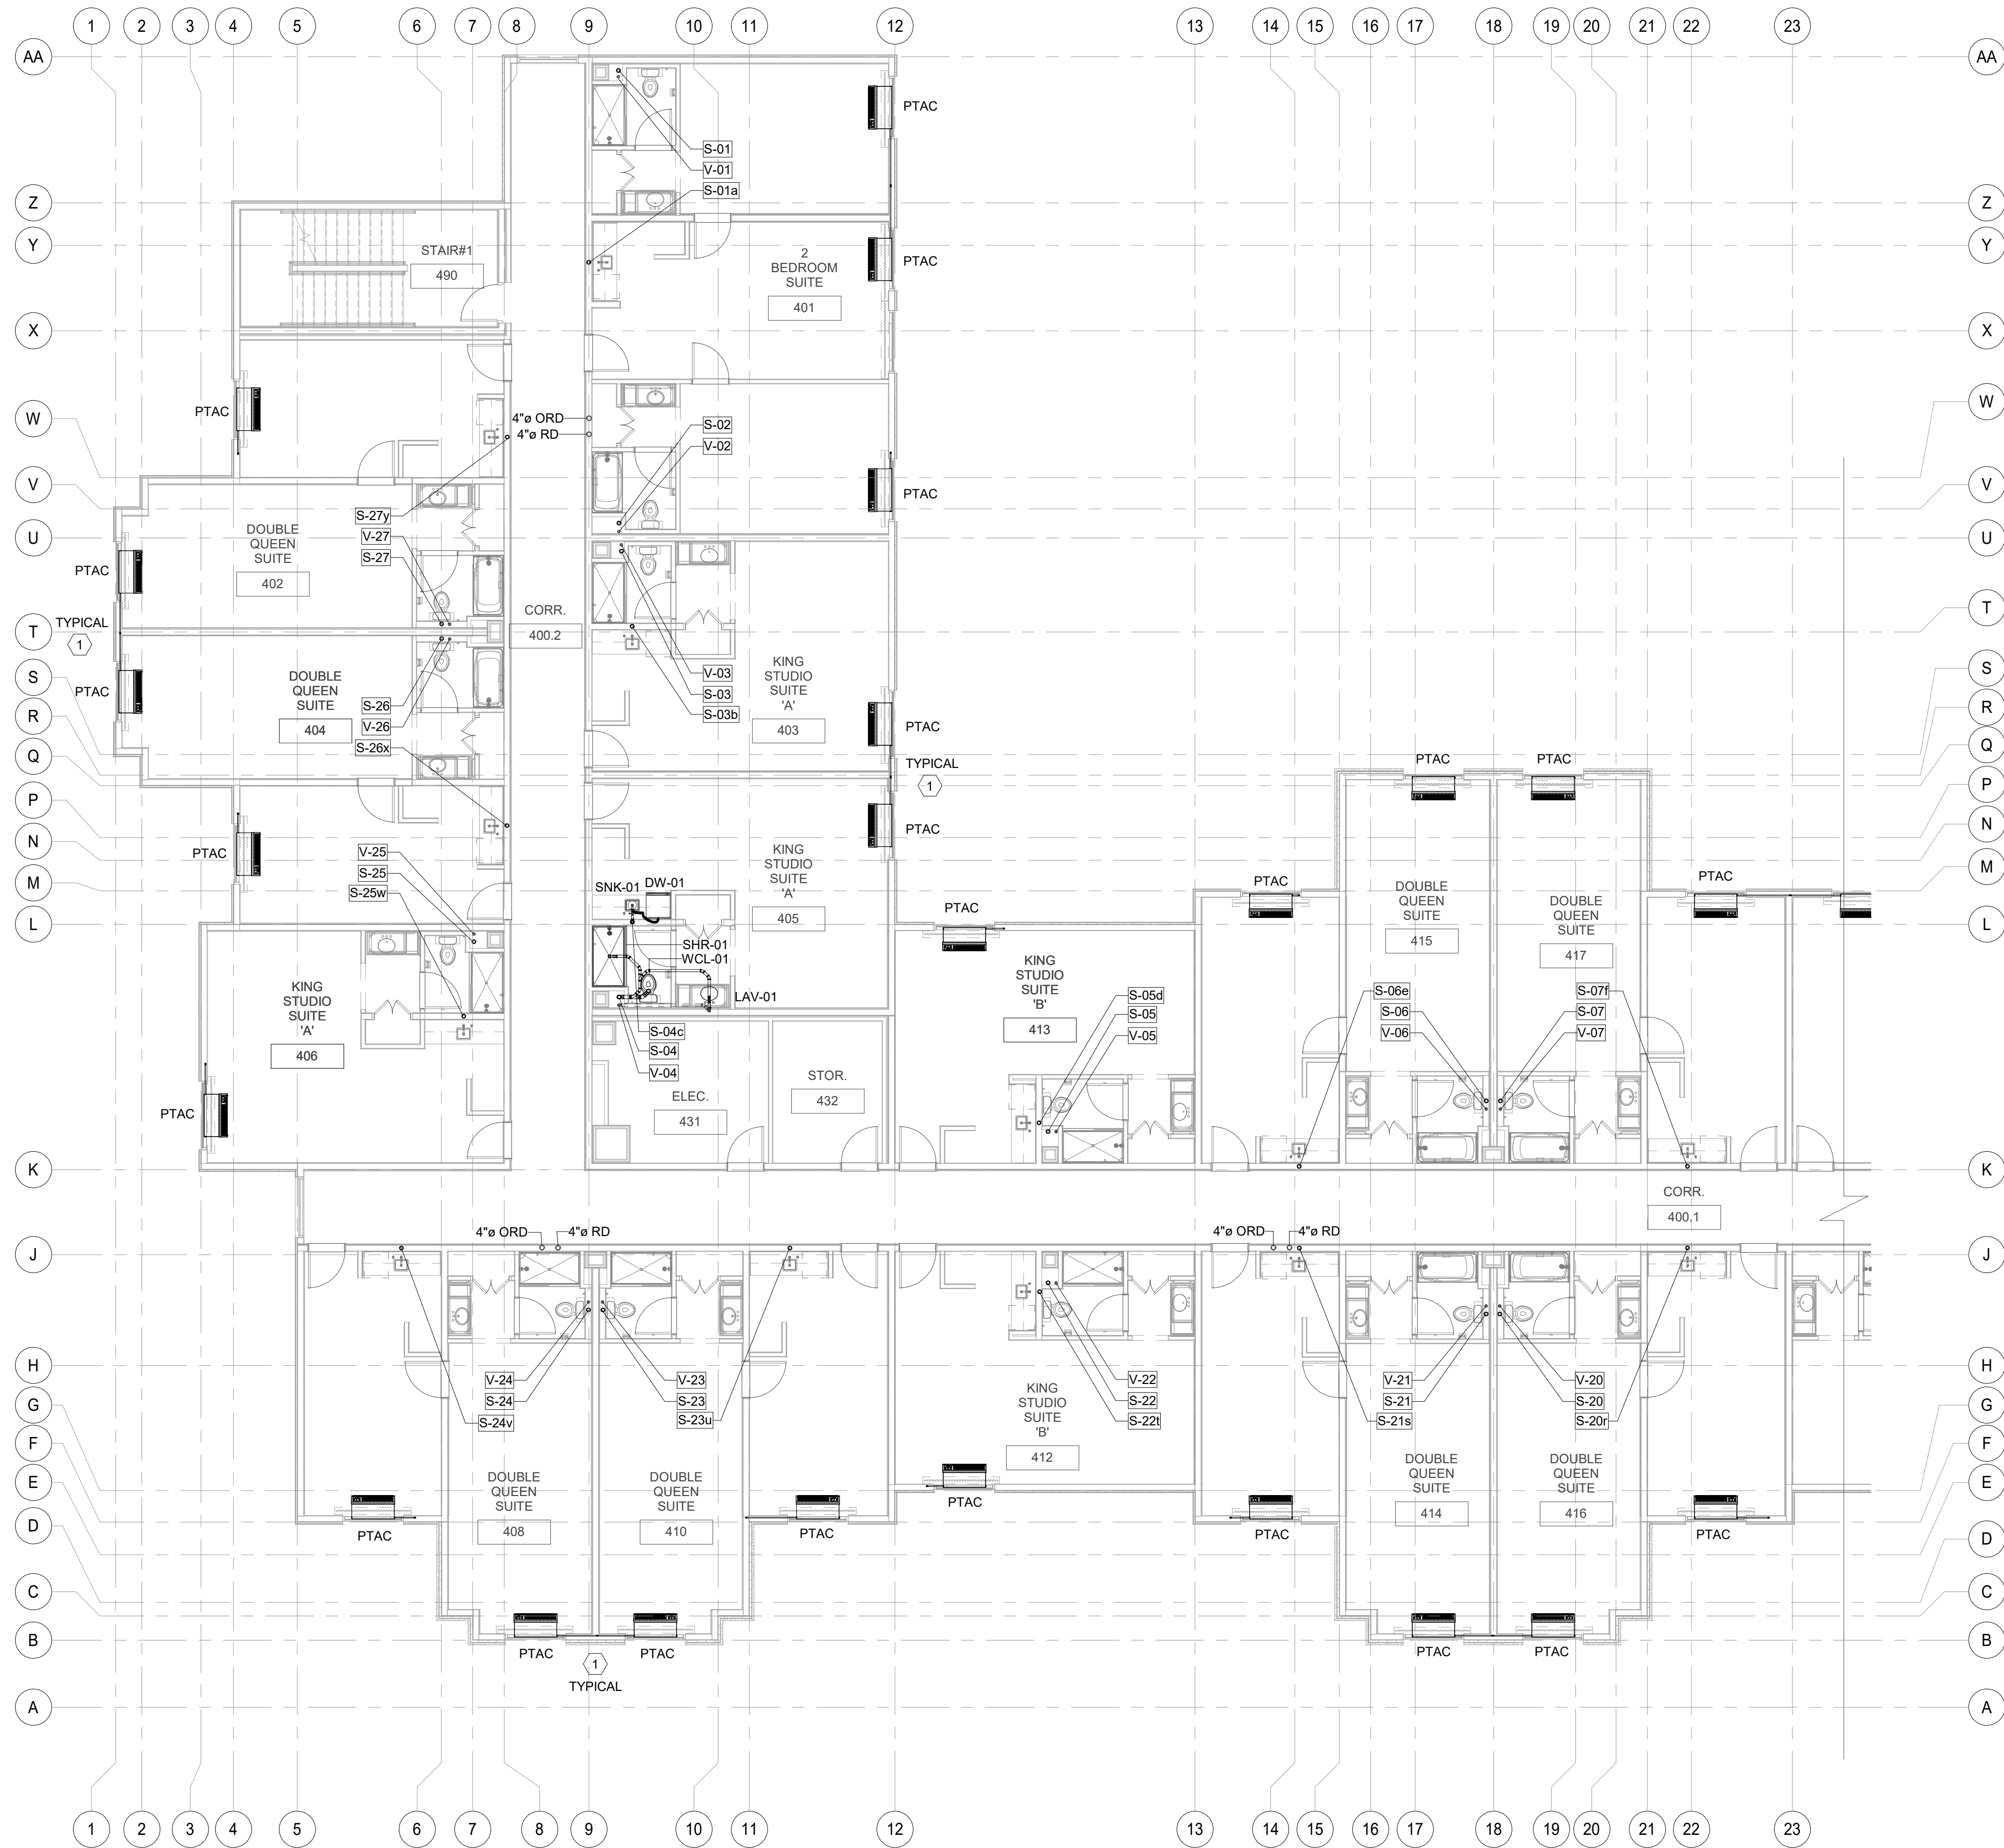
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4TH FLOOR WATER
& GAS SUPPLY
PLAN-B

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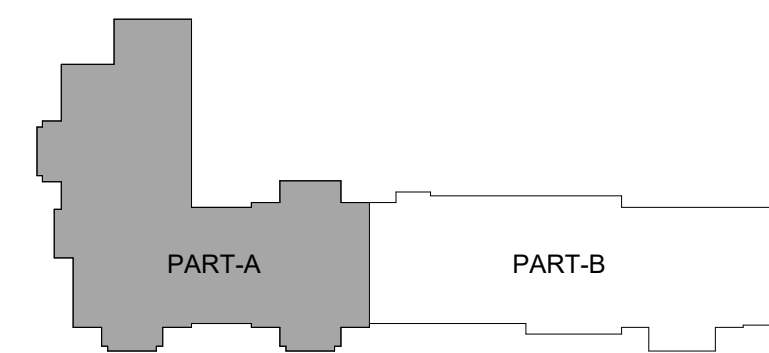
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1 4TH FLOOR SANITARY & VENT PLAN PART-A
1/8" = 1'-0"

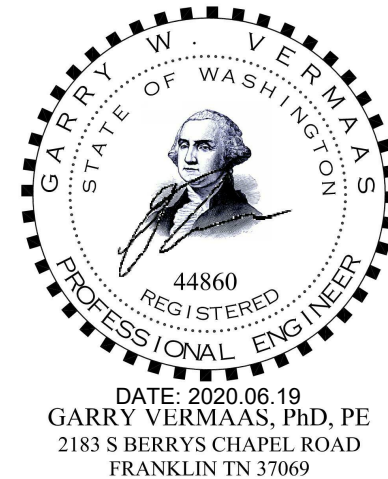
GENERAL NOTE
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#	TEXT
1	3/4" CONDENSATE RISER DOWN, SEE LOWER FLOOR PLANS FOR CONTINUATION. ROUTE EACH CONDENSATE VERTICAL RISER TO CONNECT TO NEAREST SANITARY LINE. GC TO COORDINATE CONNECTION & ENSURE SLOPE OF 1/8"1". FOR THE HORIZONTAL RUN OF PIPE, TYPICAL FOR ALL PTAC'S UNITS CONDENSATE DRAINAGE UNLESS NOTED OTHERWISE.



KEY PLAN FOR TYP. FLOOR-A
1" = 80'-0"

B-20-0180
City of Puyallup

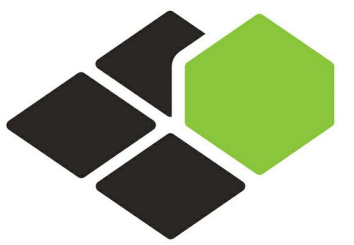


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MEP ENGINEER
GARRY VERMAAS PhD, PE
2183 S BERRYS CHAPEL ROAD
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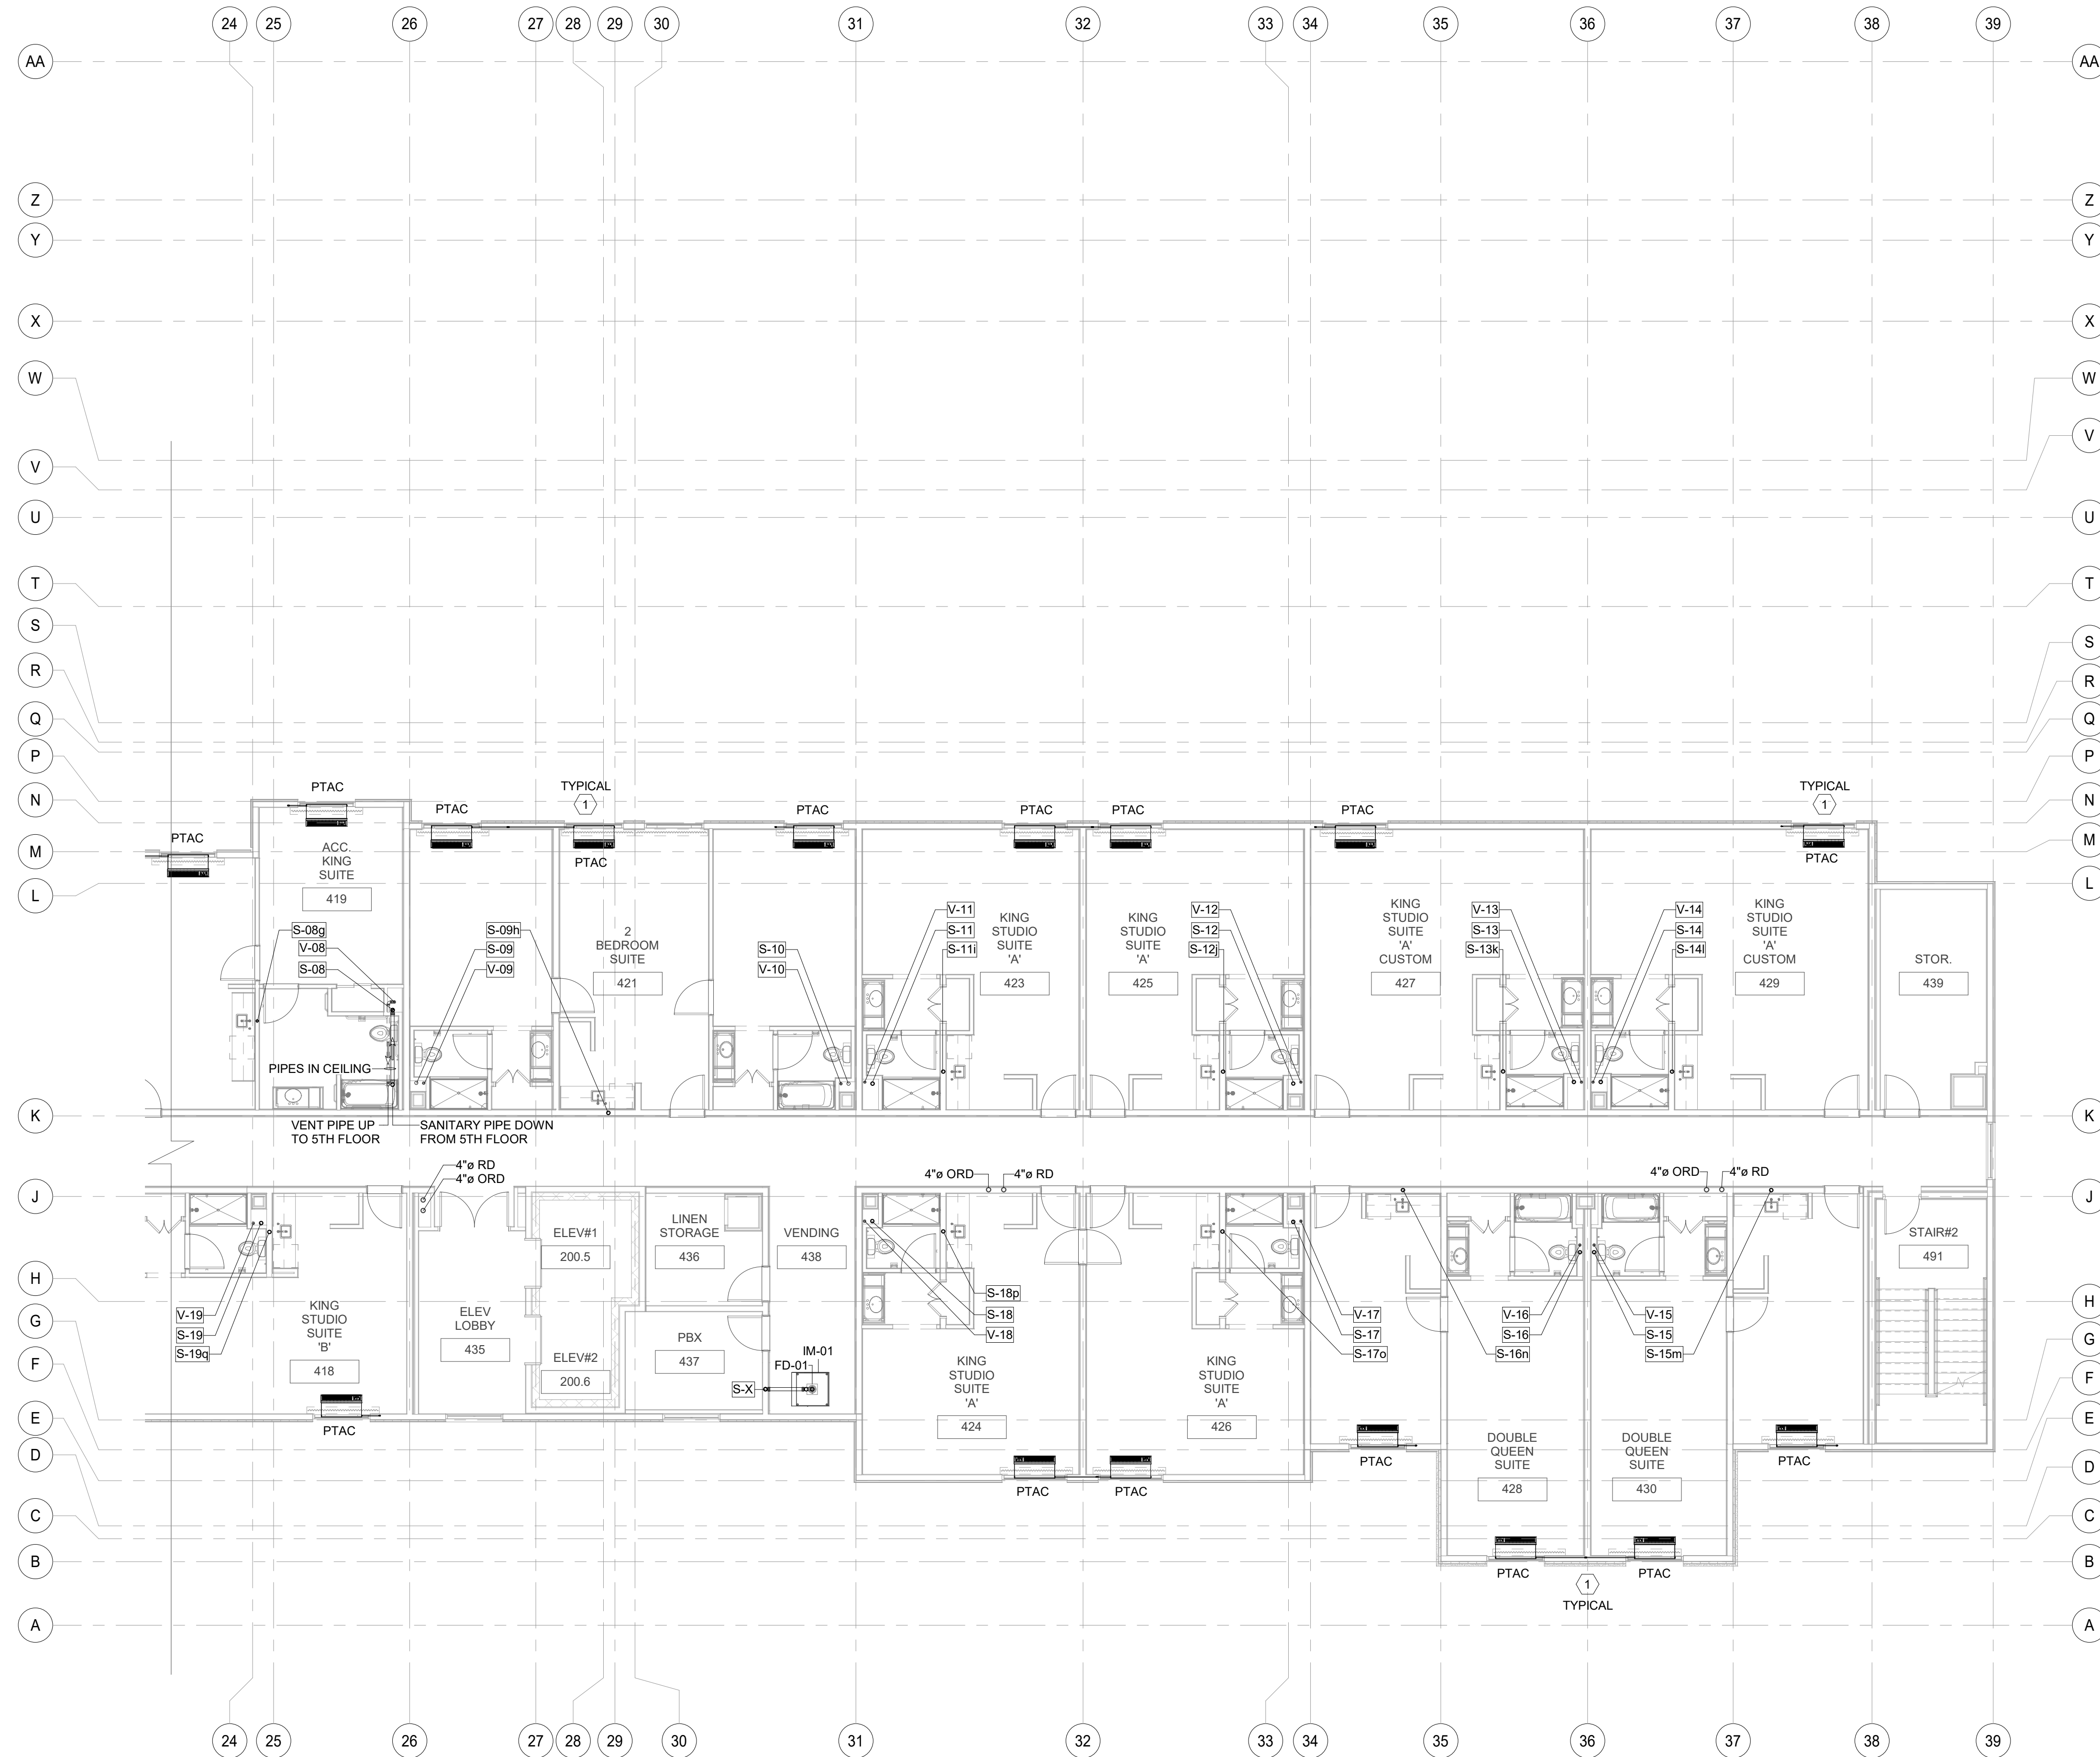
PROJECT NO.
B4-124-1803

SHEET NAME

4TH FLOOR
SANITARY & VENT
PLAN-A

DRAWINGS NO.

P-208A

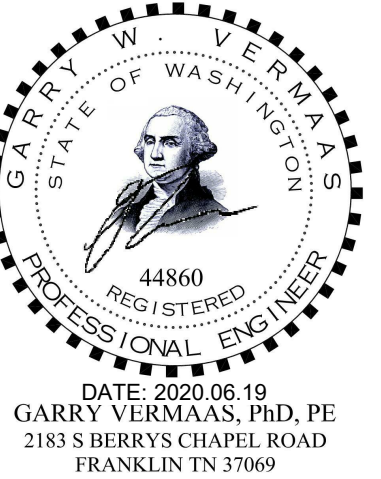



1 4TH FLOOR SANITARY & VENT PLAN PART-B
1/8" = 1'-0"

GENERAL NOTE

1. ALL SANITARY & WATER PIPES WHICH ARE TO BE ROUTED THROUGH THE TRUSSES/T/JS. TRUSSES/T/JS MANUFACTURER TO COORDINATE WITH PLUMBING CONTRACTOR ON SITE FOR TRUSSES/T/JS TO BE SPACED ACCORDINGLY TO AVOID CLASH.

#	TEXT
①	3/4" CONDENSATE RISER DOWN. SEE LOWER FLOOR PLANS FOR CONTINUATION. ROUTE EACH CONDENSATE VERTICAL RISER TO CONNECT TO NEAREST SANITARY LINE. GC TO COORDINATE CONNECTION & ENSURE SLOPE OF 1/8"FT FOR THE HORIZONTAL RUN OF PIPE. TYPICAL FOR ALL PTAC'S UNITS CONDENSATE DRAINAGE UNLESS NOTED OTHERWISE.

B-20-0180
City of Puyallup

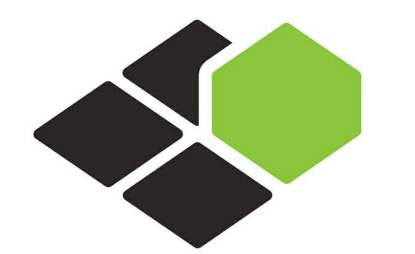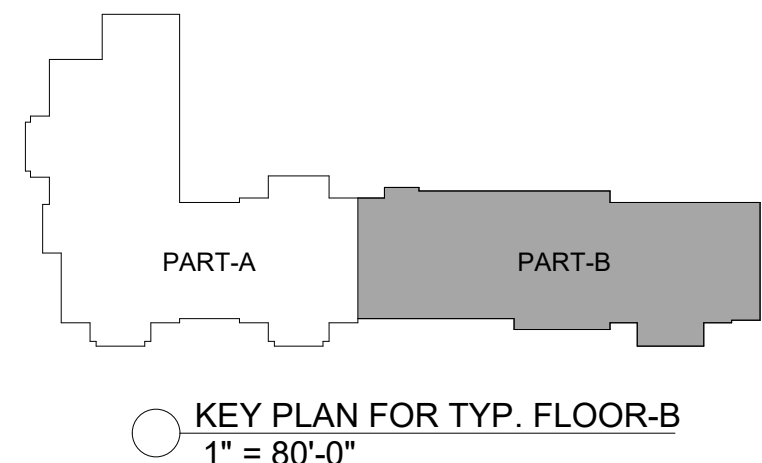


BASE4

2901 CLINT MOORE ROAD, #114
BOCA RATON, FLORIDA 33496
888.901.8008 www.base-4.com

RICARDO J. MUNIZ-GUILLET, AIA
5453 NW 106TH DR
CORAL SPRINGS, FL 33076

MEP ENGINEER
GARRY VERMAAS PhD, PE
2183 S BERRYS CHAPEL ROAD
FRANKLIN, TN 37069

Seal:

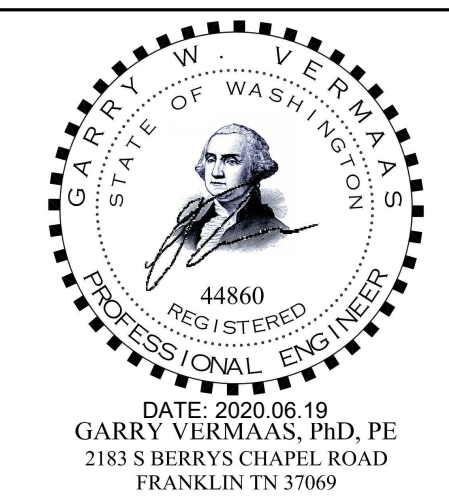

Owner:



3500 S MERIDIAN, PUYALLUP, WA 98373
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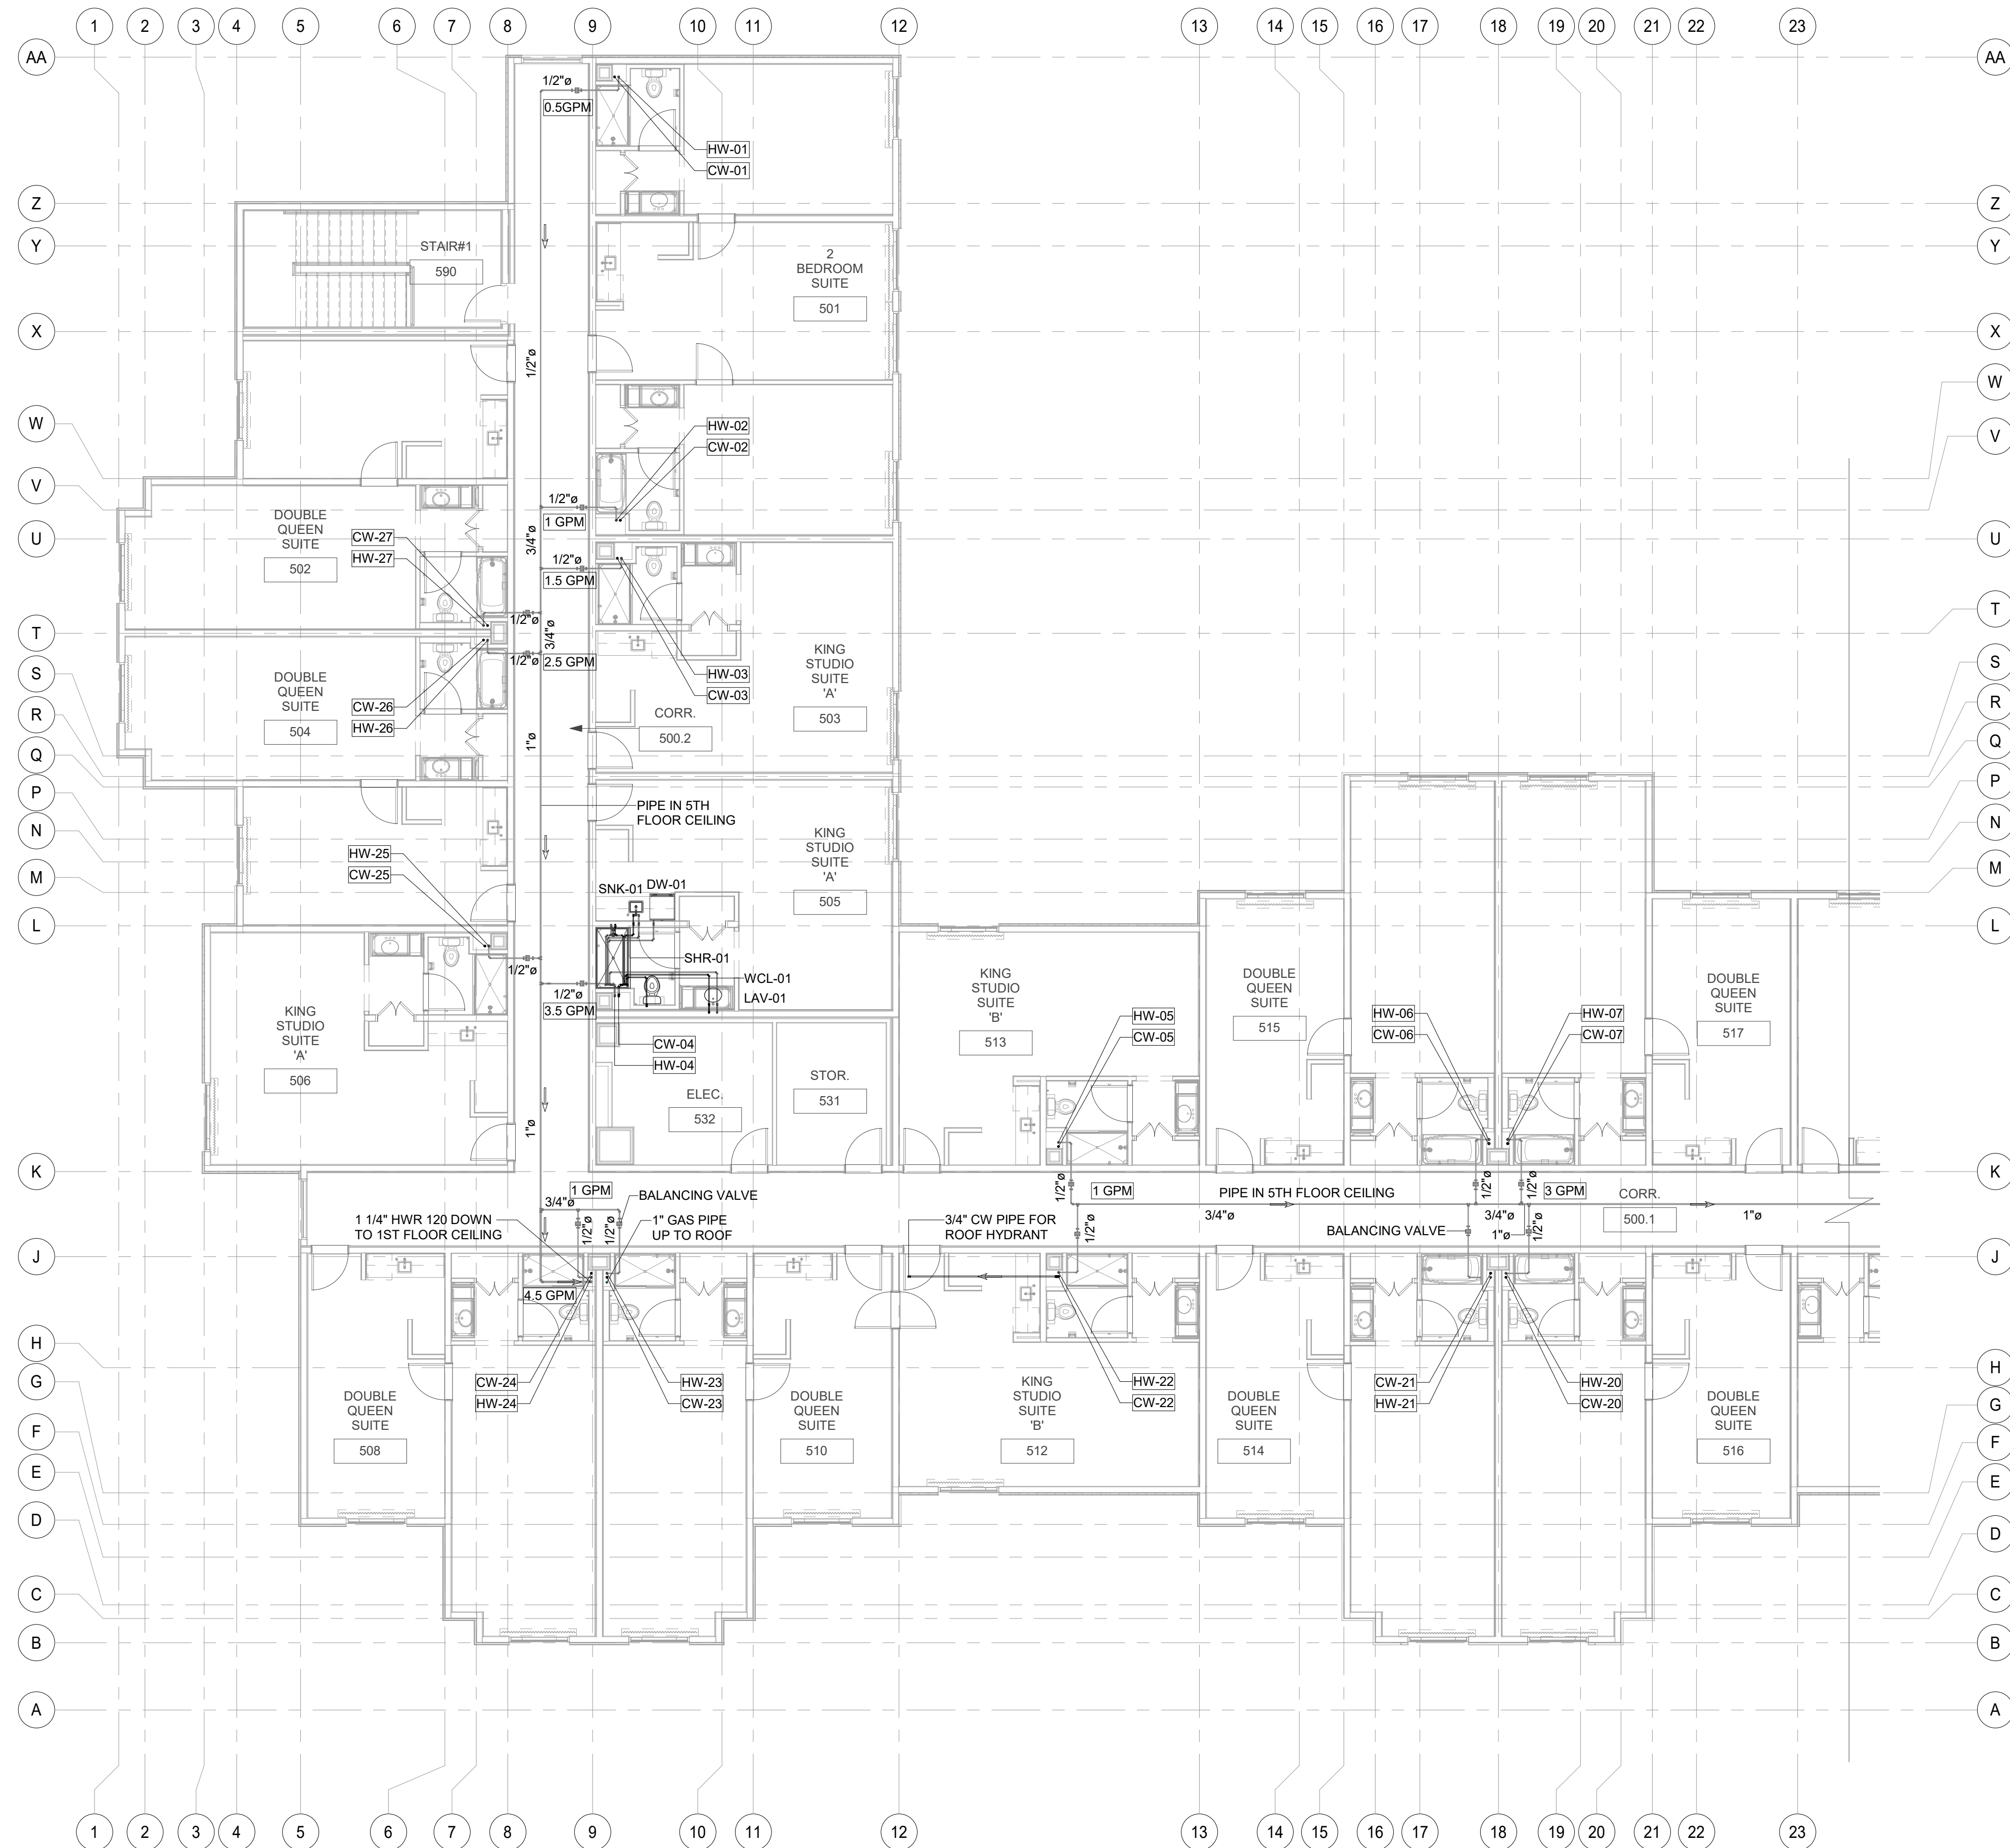
PROJECT NO.
B4-124-1803

SHEET NAME

4TH FLOOR
SANITARY & VENT
PLAN-B


DRAWINGS NO.

P-208B



1 5TH FLOOR WATER & GAS SUPPLY PLAN PART-A
1/8" = 1'-0"

B-20-0180
City of Puyallup

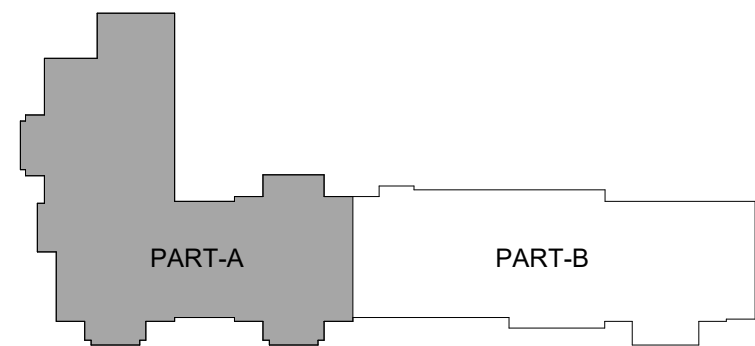

KEY PLAN FOR TYP. FLOOR-A
1" = 80'-0"




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2183 S BERRYS CHAPEL ROAD
FRANKLIN, TN 37069

Seal:



Owner:

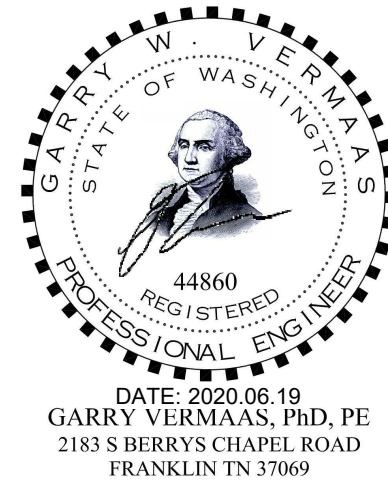

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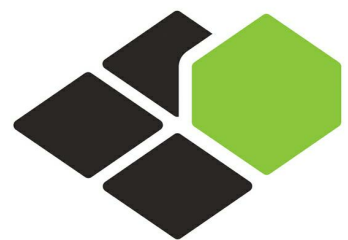
PROJECT NO.
B4-124-1803

SHEET NAME

5TH FLOOR WATER
& GAS SUPPLY
PLAN-A

DRAWINGS NO.

P-209A




BASE⁴

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2901 CLINT MOORE ROAD, #114
BOCA RATON, FLORIDA 33496
888.901.8008 www.base-4.com

RICARDO J. MUNIZ-GUILLET, AIA
5453 NW 106TH DR
CORAL SPRINGS, FL 33076

MEP ENGINEER
GARRY VERMAAS PhD, PE
2183 S BERRYS CHAPEL ROAD
FRANKLIN, TN 37069

Seal:

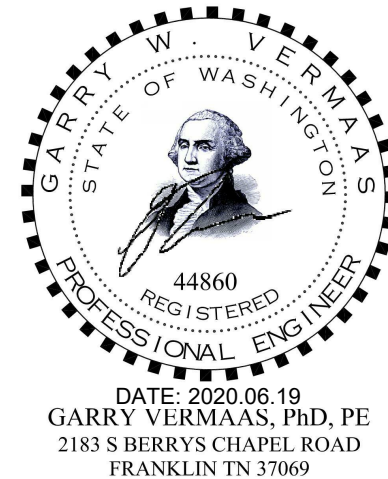

Owner:



Dakota Legacy Group
Hospitality Development
4500 36TH AVE. S SUITE
200, FARGO, ND 58104
701.551.8000 (OFFICE)



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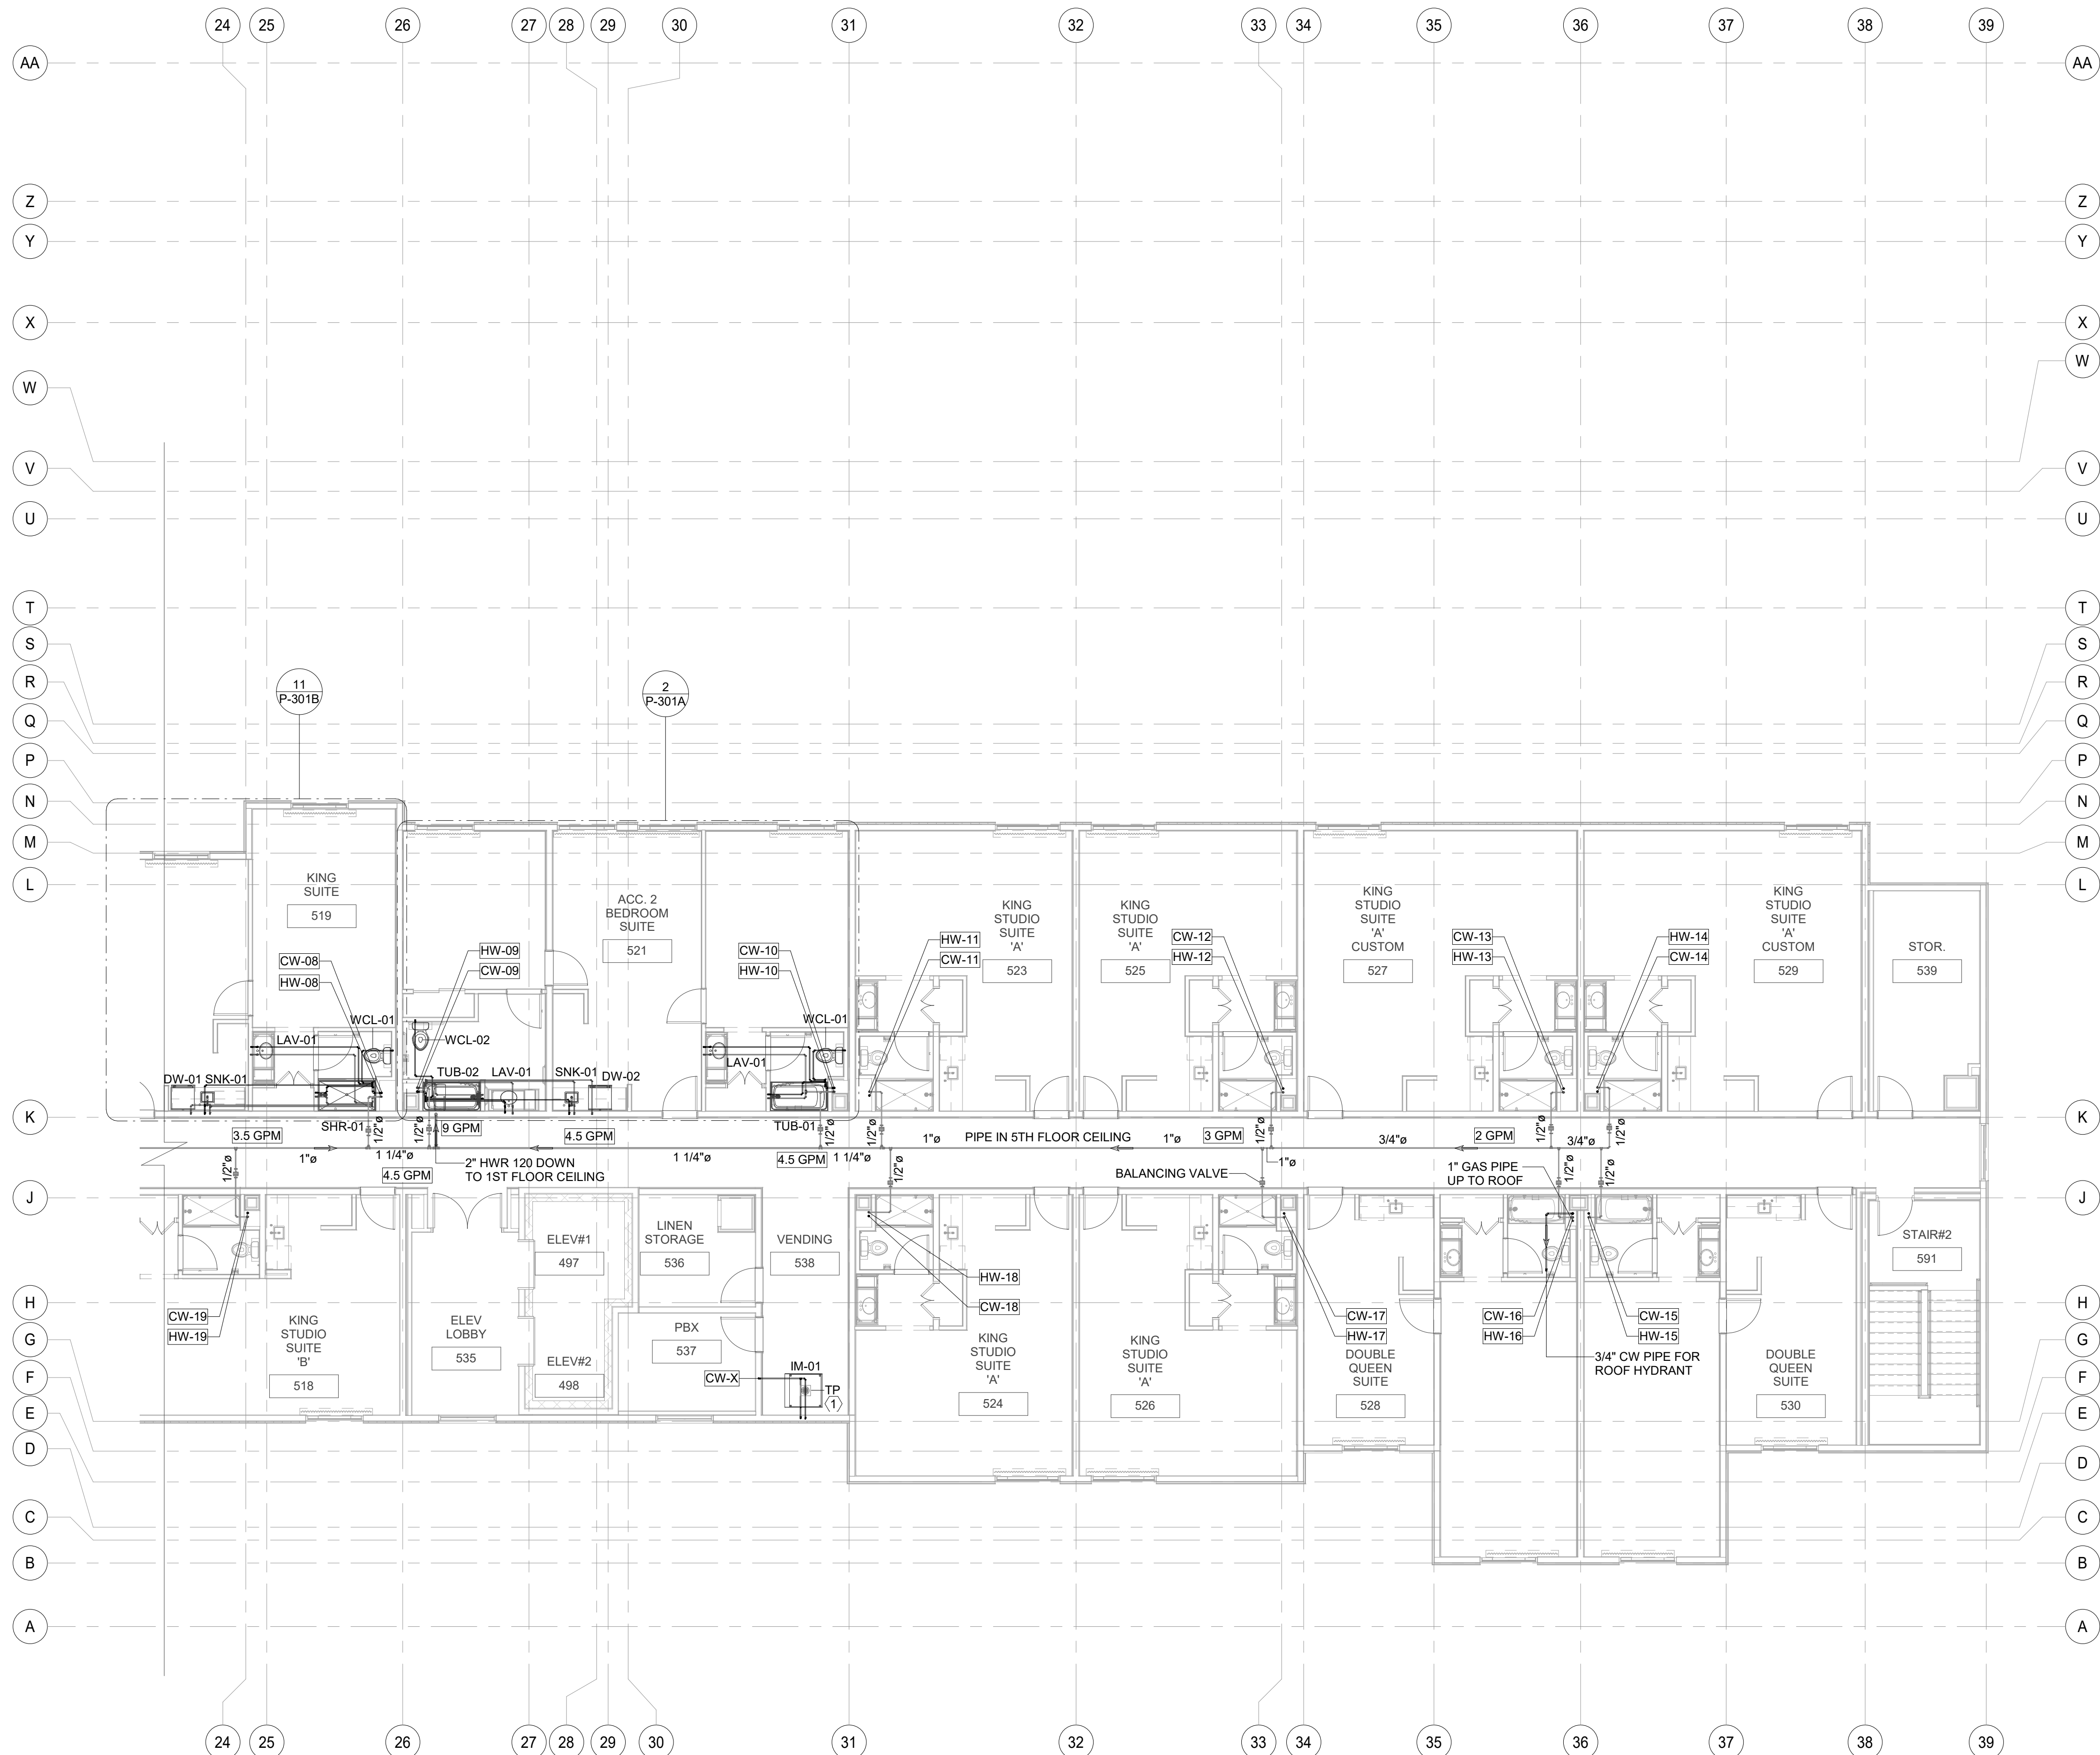
PROJECT NO.
B4-124-1803

SHEET NAME

**5TH FLOOR WATER
& GAS SUPPLY
PLAN-B**


DRAWINGS NO.

P-209B




① 5TH FLOOR WATER & GAS SUPPLY PLAN PART-B
1/8" = 1'-0"

B-20-0180
City of Puyallup

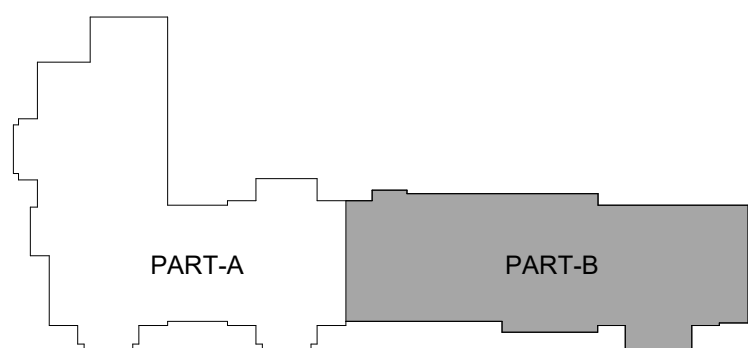

○ KEY PLAN FOR TYP. FLOOR-B
1" = 80'-0"

#	TEXT
①	PROVIDE AND INSTALL PRECISION PLUMBING PRODUCTS INC. #P1-500 TRAP PRIMER WITH 1/2" CW CONNECTION TO LINE. INDICATED ON DRAWING. EXTEND OFF TOP OF LINE PER MANUFACTURER INSTRUCTIONS (OR) PROVIDE AND INSTALL THE PROSET TRAP GUARD FLOOR DRAIN AS ALTERNATIVE.

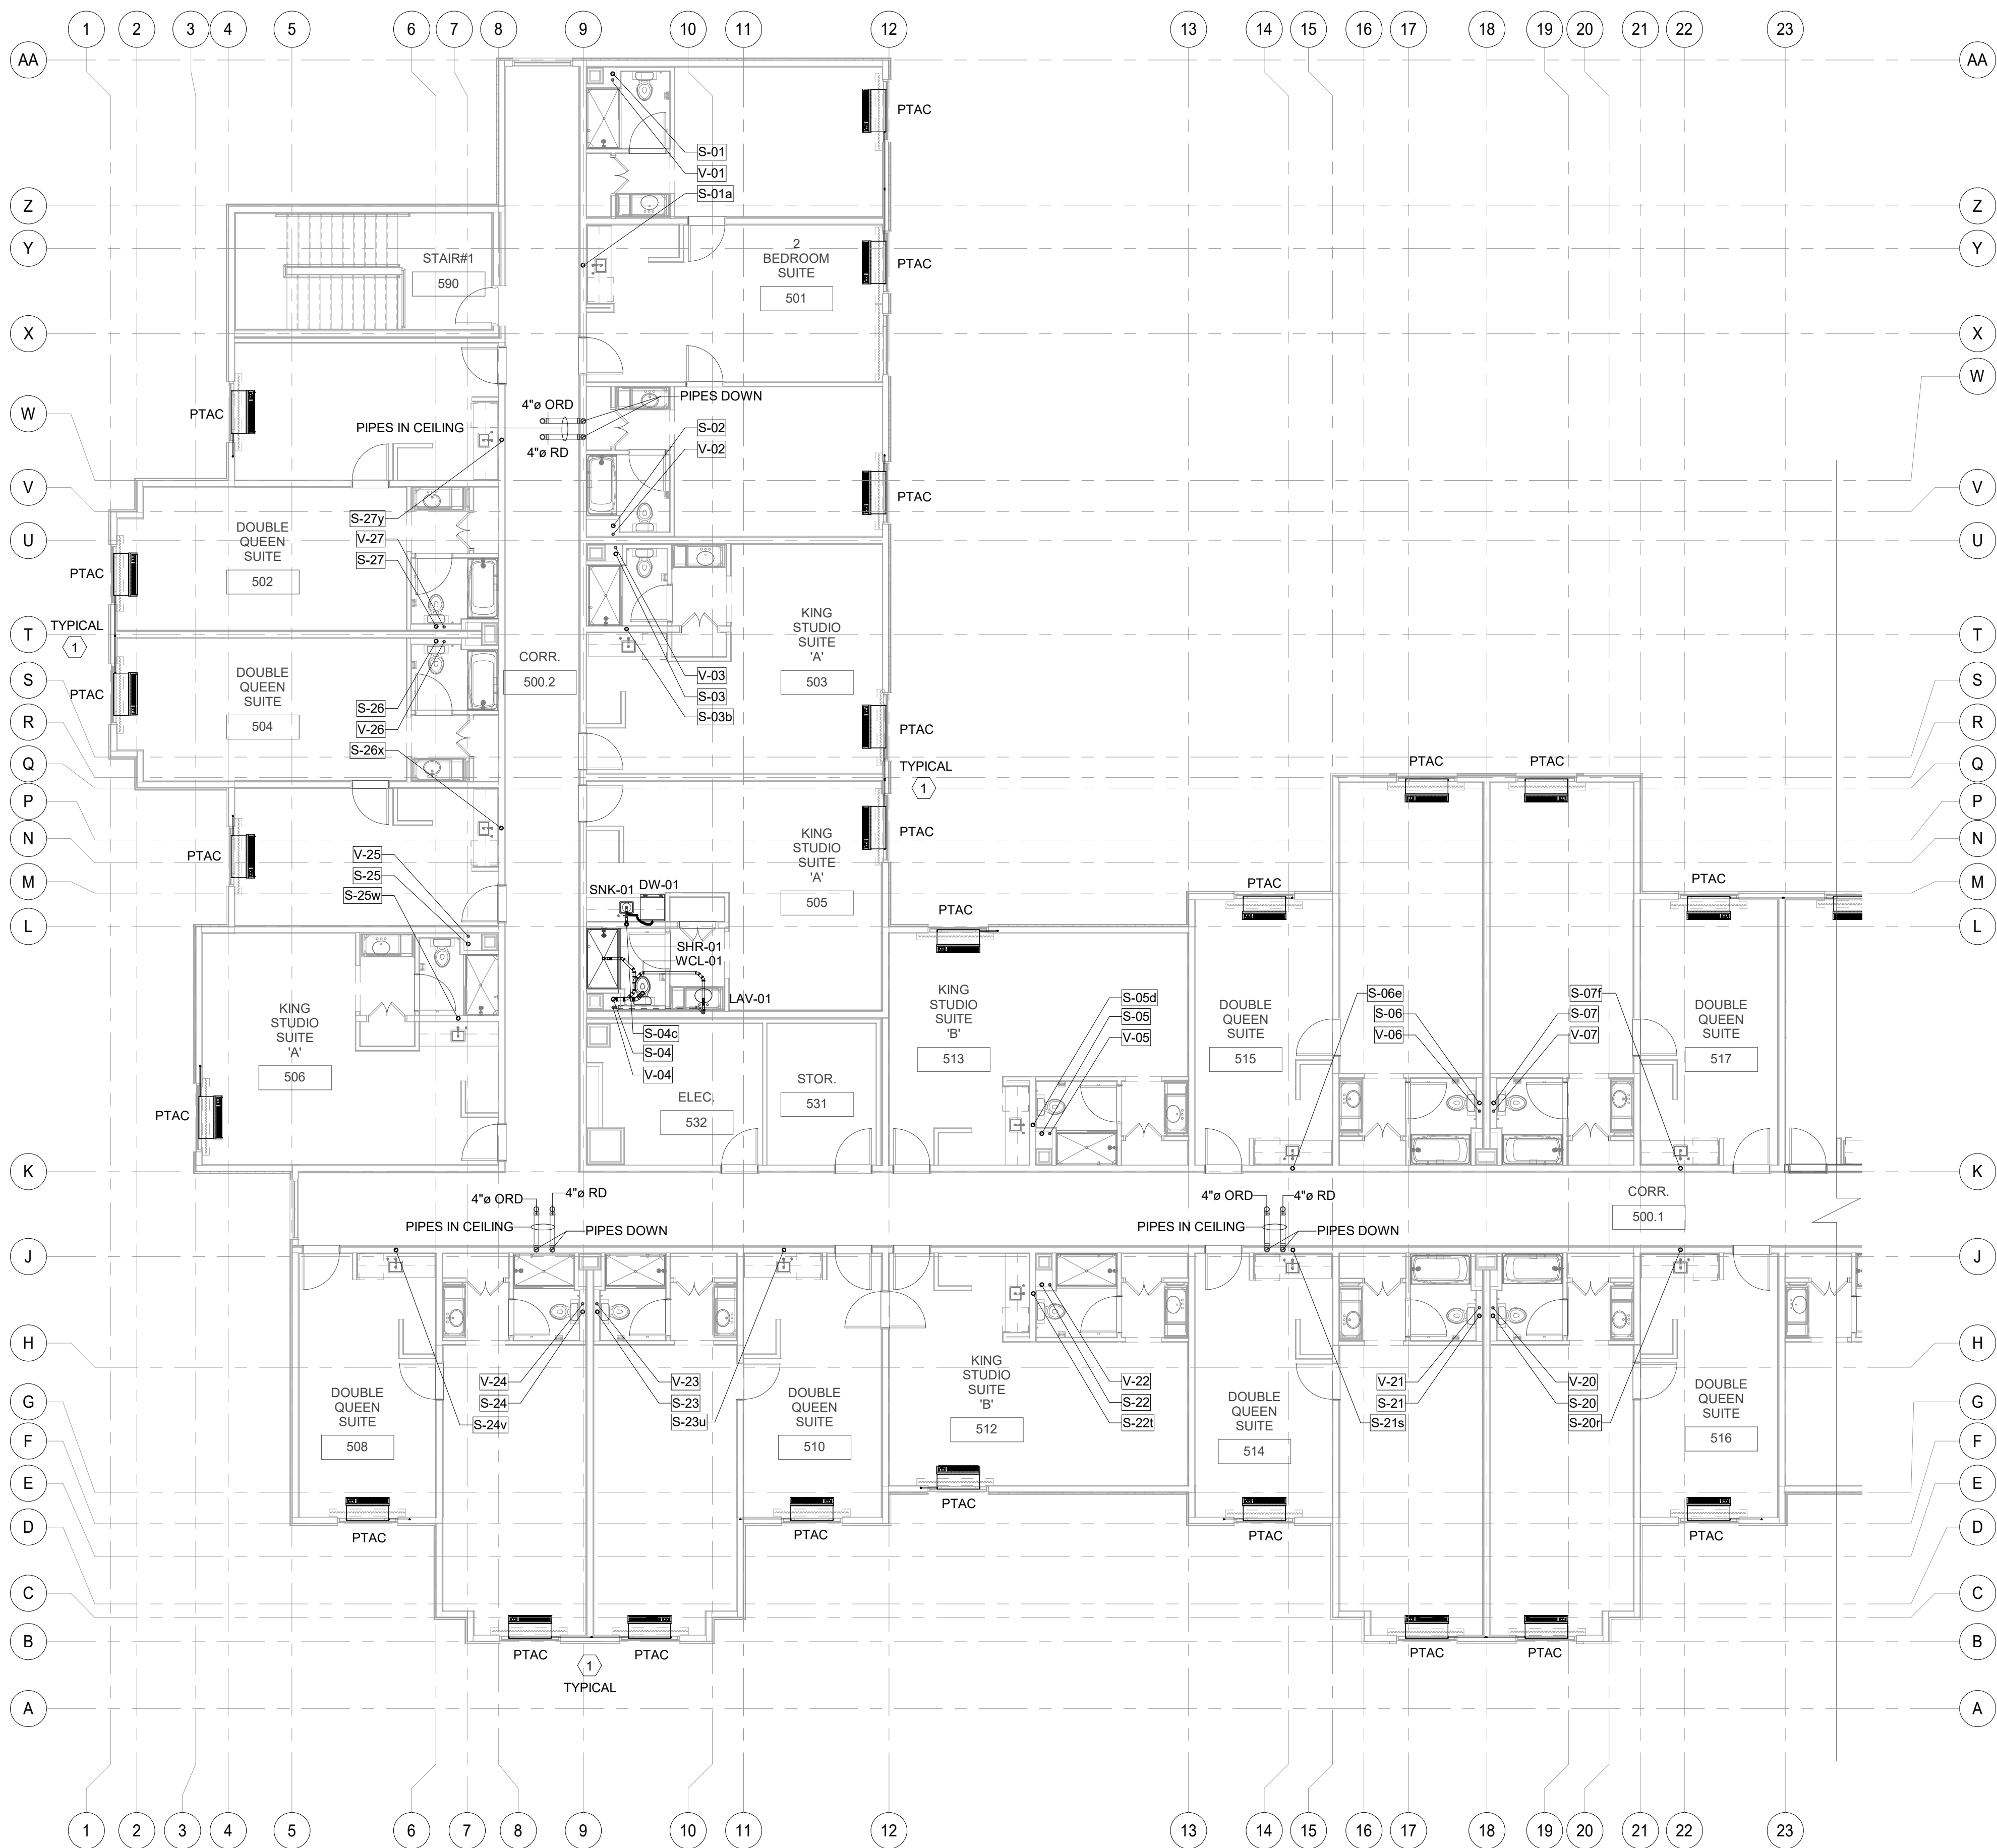


① 5TH FLOOR SANITARY & VENT PLAN PART-A
1/8" = 1'-0"

GENERAL NOTE

1. ALL SANITARY & WATER PIPES WHICH ARE TO BE ROUTED THROUGH THE TRUSSES/TJ'S. TRUSS/TJ MANUFACTURER TO COORDINATE WITH PLUMBING CONTRACTOR ON SITE FOR TRUSS/TJ TO BE SPACED ACCORDINGLY TO AVOID CLASH.

#	TEXT
①	3/4" CONDENSATE RISER DOWN, SEE LOWER FLOOR PLANS FOR CONTINUATION. ROUTE EACH CONDENSATE VERTICAL RISER TO CONNECT TO NEAREST SANITARY LINE. GC TO COORDINATE CONNECTION & ENSURE SLOPE OF 1/8"FT FOR THE HORIZONTAL RUN OF PIPE. TYPICAL FOR ALL PTAC'S UNITS CONDENSATE DRAINAGE UNLESS NOTED OTHERWISE.

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City of Puyallup

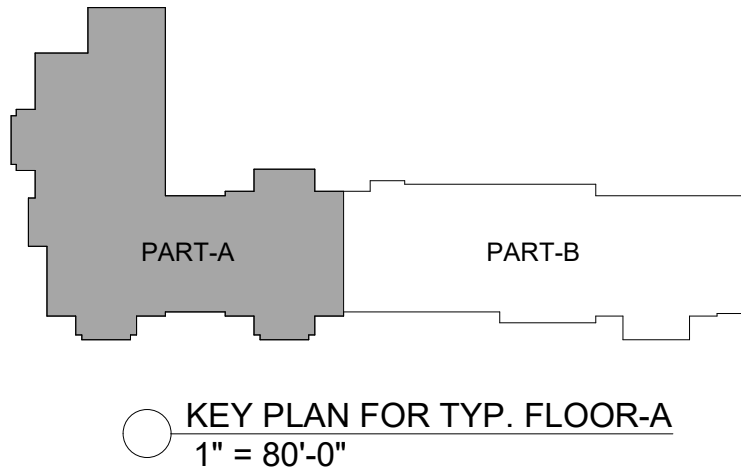


BASE4

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888.901.8008 www.base-4.com

RICARDO J. MUNIZ-GUILLET, AIA
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MEP ENGINEER
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2183 S BERRYS CHAPEL ROAD
FRANKLIN, TN 37069

Seal:

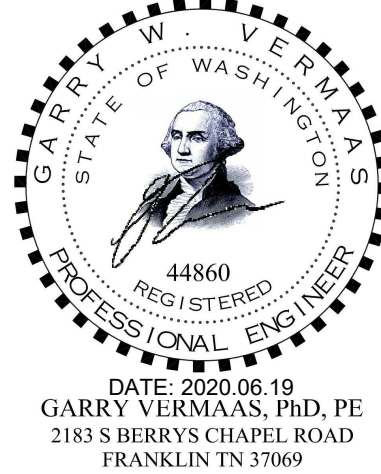

Owner:



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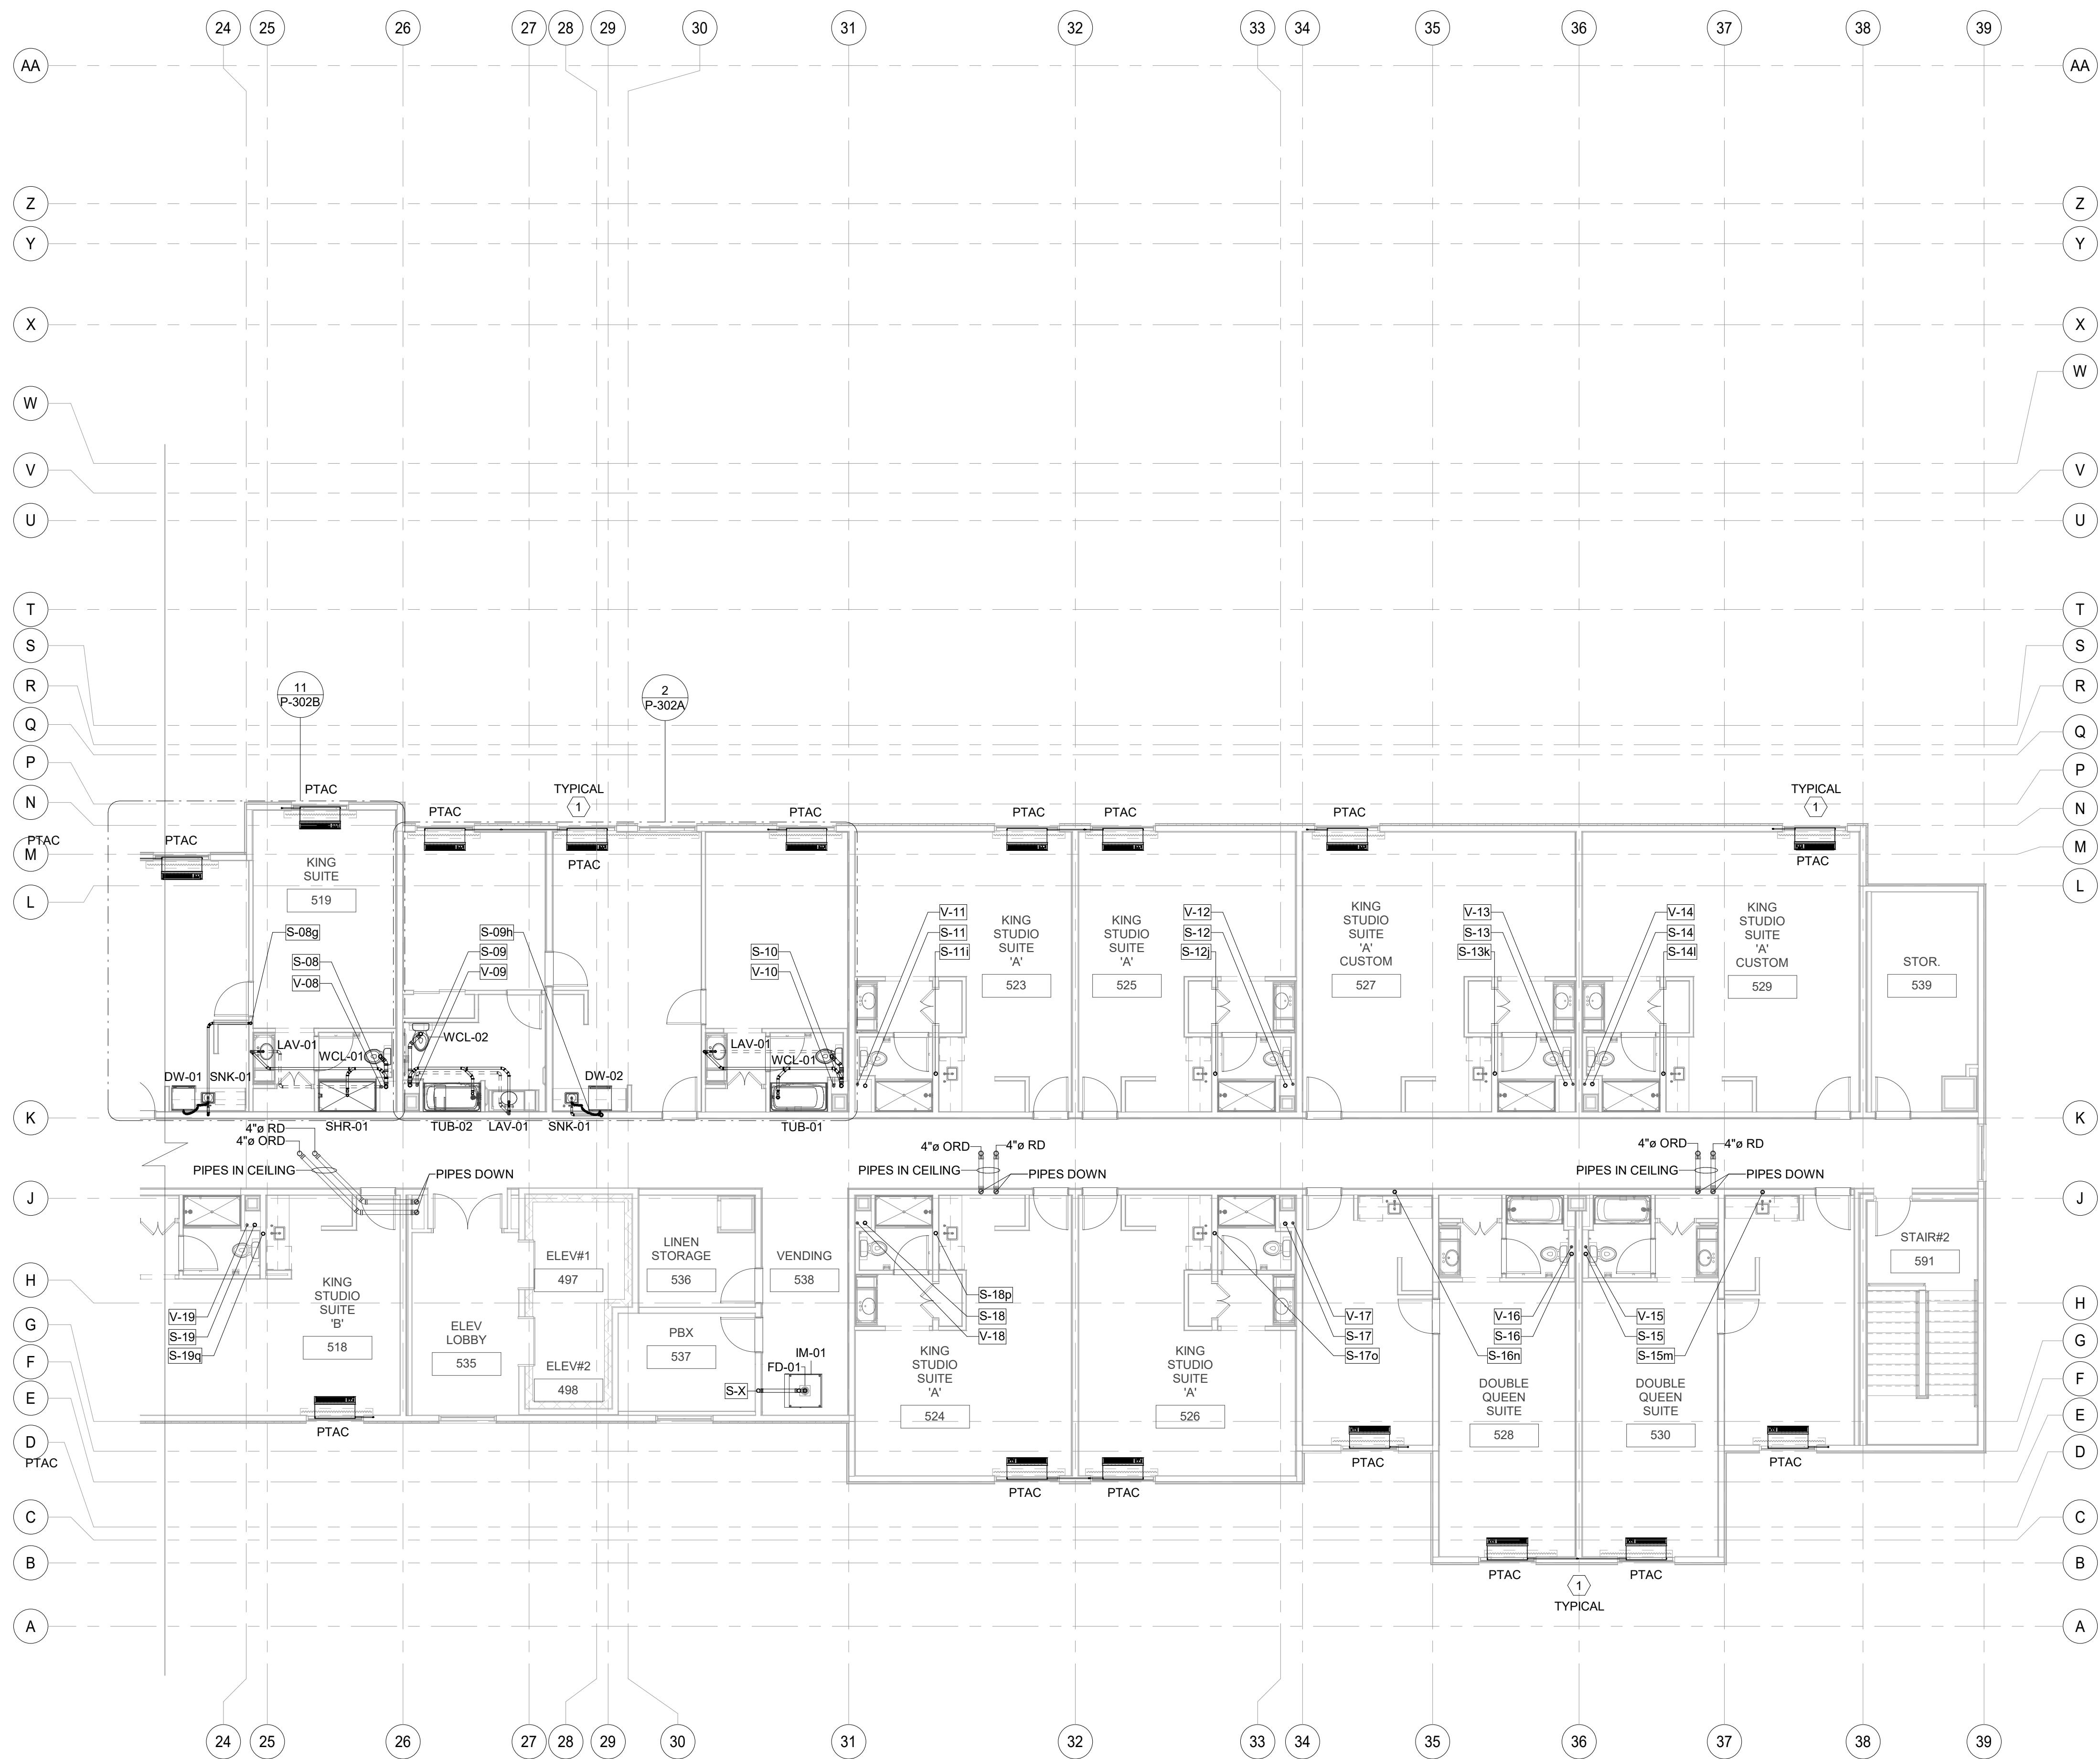
PROJECT NO.
B4-124-1803

SHEET NAME

5TH FLOOR
SANITARY & VENT
PLAN-A

DRAWINGS NO.

P-210A





1 5TH FLOOR SANITARY & VENT PLAN PART-B
1/8" = 1'-0"

GENERAL NOTE
1. ALL SANITARY & WATER PIPES WHICH ARE TO BE ROUTED THROUGH THE TRUSSES/TJ'S. TRUSSES/TJ'S MANUFACTURER TO COORDINATE WITH PLUMBING CONTRACTOR ON SITE FOR TRUSSES/TJ'S TO BE SPACED ACCORDINGLY TO AVOID CLASH.

#	TEXT
1	3/4" CONDENSATE RISER DOWN. SEE LOWER FLOOR PLANS FOR CONTINUATION. ROUTE EACH CONDENSATE VERTICAL RISER TO CONNECT TO NEAREST SANITARY LINE. GO TO COORDINATE CONNECTION & ENSURE SLOPE OF 1/8" FT FOR THE HORIZONTAL RUN OF PIPE. TYPICAL FOR ALL PTAC'S UNITS CONDENSATE DRAINAGE UNLESS NOTED OTHERWISE.


B-20-0180
City of Puyallup

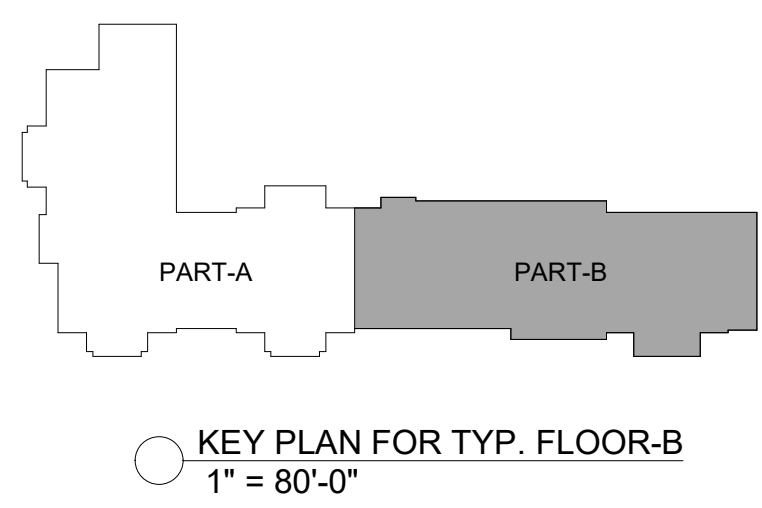

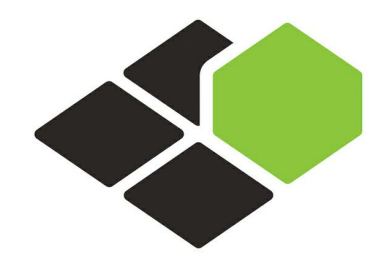


BASE⁴
2901 CLINT MOORE ROAD, #114
BOCA RATON, FLORIDA 33496
888.901.8008 www.base-4.com
RICARDO J. MUNIZ-GUILLET, AIA
5453 NW 106TH DR
CORAL SPRINGS, FL 33076
MEP ENGINEER
GARRY VERMAAS PhD, PE
2183 S BERRYS CHAPEL ROAD
FRANKLIN, TN 37069

Seal:




DATE: 2020.06.19
GARRY VERMAAS, PhD, PE
2183 S BERRYS CHAPEL ROAD
FRANKLIN, TN 37069

Owner:



Dakota Legacy Group
Hospitality Development
4500 36TH AVE. S SUITE
200, FARGO, ND 58104
701.551.8000 (OFFICE)



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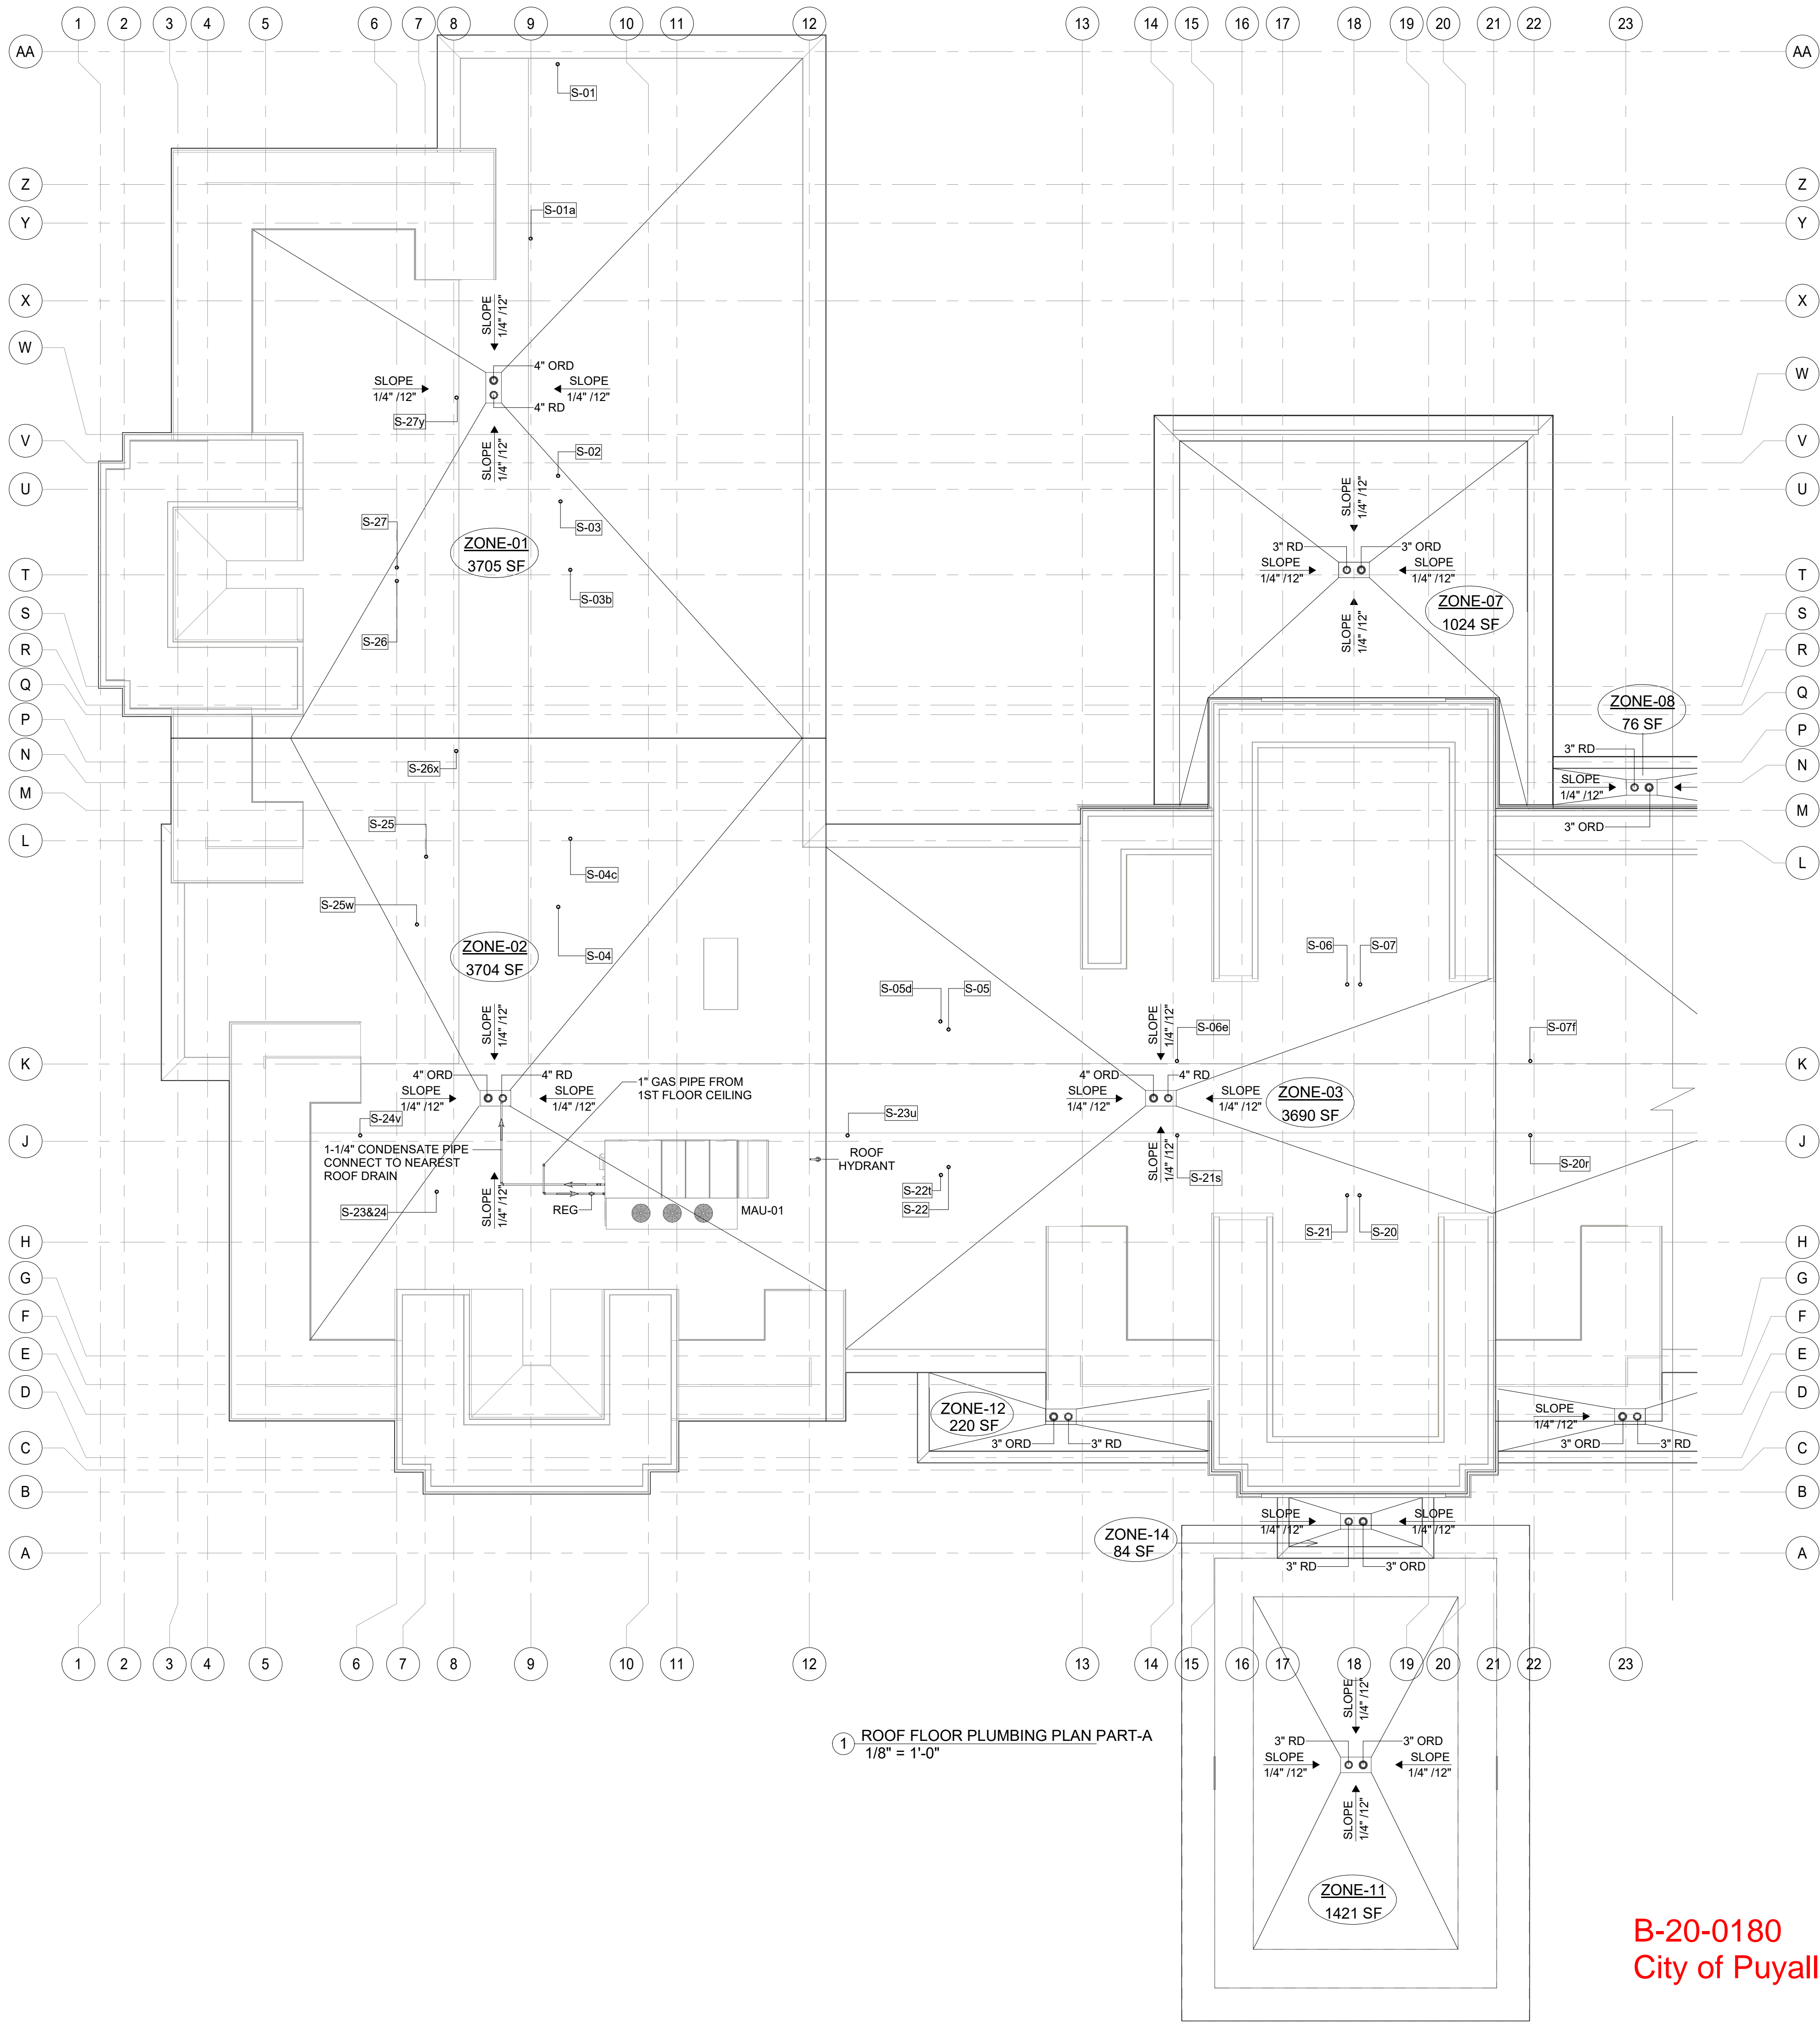
PROJECT NO.
B4-124-1803

SHEET NAME


**5TH FLOOR
SANITARY & VENT
PLAN-B**

DRAWINGS NO.
P-210B

ROOF DRAIN SCHEDULE					
LOCATION :		PUYALLUP, WA			
PRIMARY RAINFALL RATE :		2.0 IN/ HR			
SLOPE OF DRAIN PIPING :		1/8" PER FOOT			
ZONE NO.	ROOF AREA (SQ. FT.)	WALL AREA (SQ. FT.)	TOTAL AREA (SQ. FT.)	PRIMARY DRAIN SIZE	SECONDARY DRAIN ROOF DRAIN
01	3705	-	3705	4"	4"
02	3704	-	3704	4"	4"
03	3690	-	3690	4"	4"
04	3154	-	3154	4"	4"
05	3645	-	3645	4"	4"
06	3655	-	3655	4"	4"
07	1024	650	1674	3"	3"
08	76	380	456	3"	3"
09	1663	980	2643	4"	4"
10	1663	775	2438	4"	4"
11	1421	-	1421	3"	3"
12	220	580	800	3"	3"
13	220	580	800	3"	3"
14	85	300	385	3"	3"
ROOF DRAINAGE SYSTEMS WERE SIZED PER THE 2015 UNIFORM PLUMBING CODE, TABLE 1101.9					
MAXIMUM ALLOWABLE SQ.FT. INCLUSIVE OF PARAPET HEIGHTS, USING THE ABOVE STATED PARAMETERS LISTED AS FOLLOWS.					
ROOF RAIN PIPE SIZE	PRIMARY ROOF (SQ.FT.)	SECONDARY ROOF (SQ.FT.)			
3"	1,644	1,644			
4"	3,760	3,760			
6"	10,700	10,700			
8"	23,000	23,000			



B-20-0180
City of Puyallup

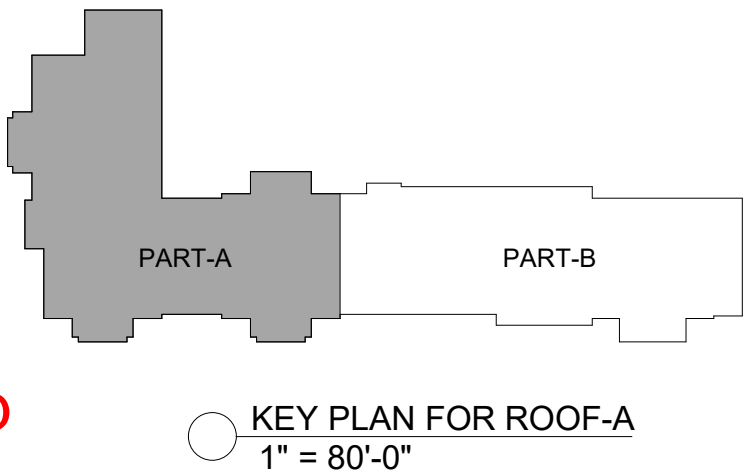


BASE⁴

BASE4
2901 CLINT MOORE ROAD, #114
BOCA RATON, FLORIDA 33496
888.901.8008 www.base-4.com

RICARDO J. MUNIZ-GUILLET, AIA
5453 NW 106TH DR
CORAL SPRINGS, FL 33076

MEP ENGINEER
GARRY VERMAAS PhD, PE
2183 S BERRYS CHAPEL ROAD
FRANKLIN, TN 37069

Seal:

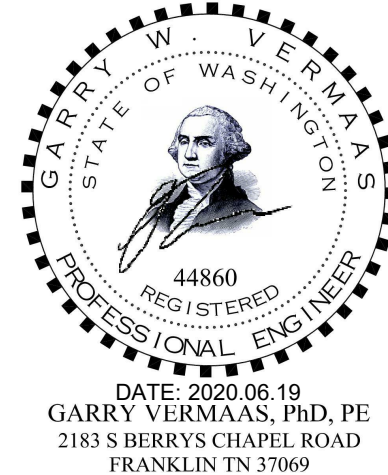

Owner:



3500 S MERIDIAN, PUYALLUP, WA 98373
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B4-124-1803

SHEET NAME

ROOF PLUMBING
PLAN-A

DRAWINGS NO.

P-211A


ROOF DRAIN SCHEDULE

LOCATION: PUYALLUP, WA					
PRIMARY RAINFALL RATE: 2.0 IN/HR					
SLOPE OF DRAIN PIPING: 1/8" PER FOOT					
ZONE NO.	ROOF AREA (SQ.FT.)	WALL AREA (SQ.FT.)	TOTAL AREA (SQ.FT.)	PRIMARY DRAIN SIZE	SECONDARY ROOF DRAIN SIZE
01	3705	-	3705	4"	4"
02	3704	-	3704	4"	4"
03	3690	-	3690	4"	4"
04	3154	-	3154	4"	4"
05	3645	-	3645	4"	4"
06	3655	-	3655	4"	4"
07	1024	650	1674	3"	3"
08	76	380	456	3"	3"
09	1663	980	2643	4"	4"
10	1663	775	2438	4"	4"
11	1421	-	1421	3"	3"
12	220	580	800	3"	3"
13	220	580	800	3"	3"
14	85	300	385	3"	3"

ROOF DRAINAGE SYSTEMS WERE SIZED PER THE 2015 UNIFORM PLUMBING CODE, TABLE 1101.6


MAXIMUM ALLOWABLE SQ.FT. INCLUSIVE OF PARAPET HEIGHTS, USING THE ABOVE STATED PARAMETERS, LISTED AS FOLLOWS:

ROOF RAIN PIPE SIZE	PRIMARY ROOF (SQ.FT.)	SECONDARY ROOF AREA (SQ.FT.)
3"	1,644	1,644
4"	3,760	3,760
6"	10,700	10,700
8"	23,000	23,000

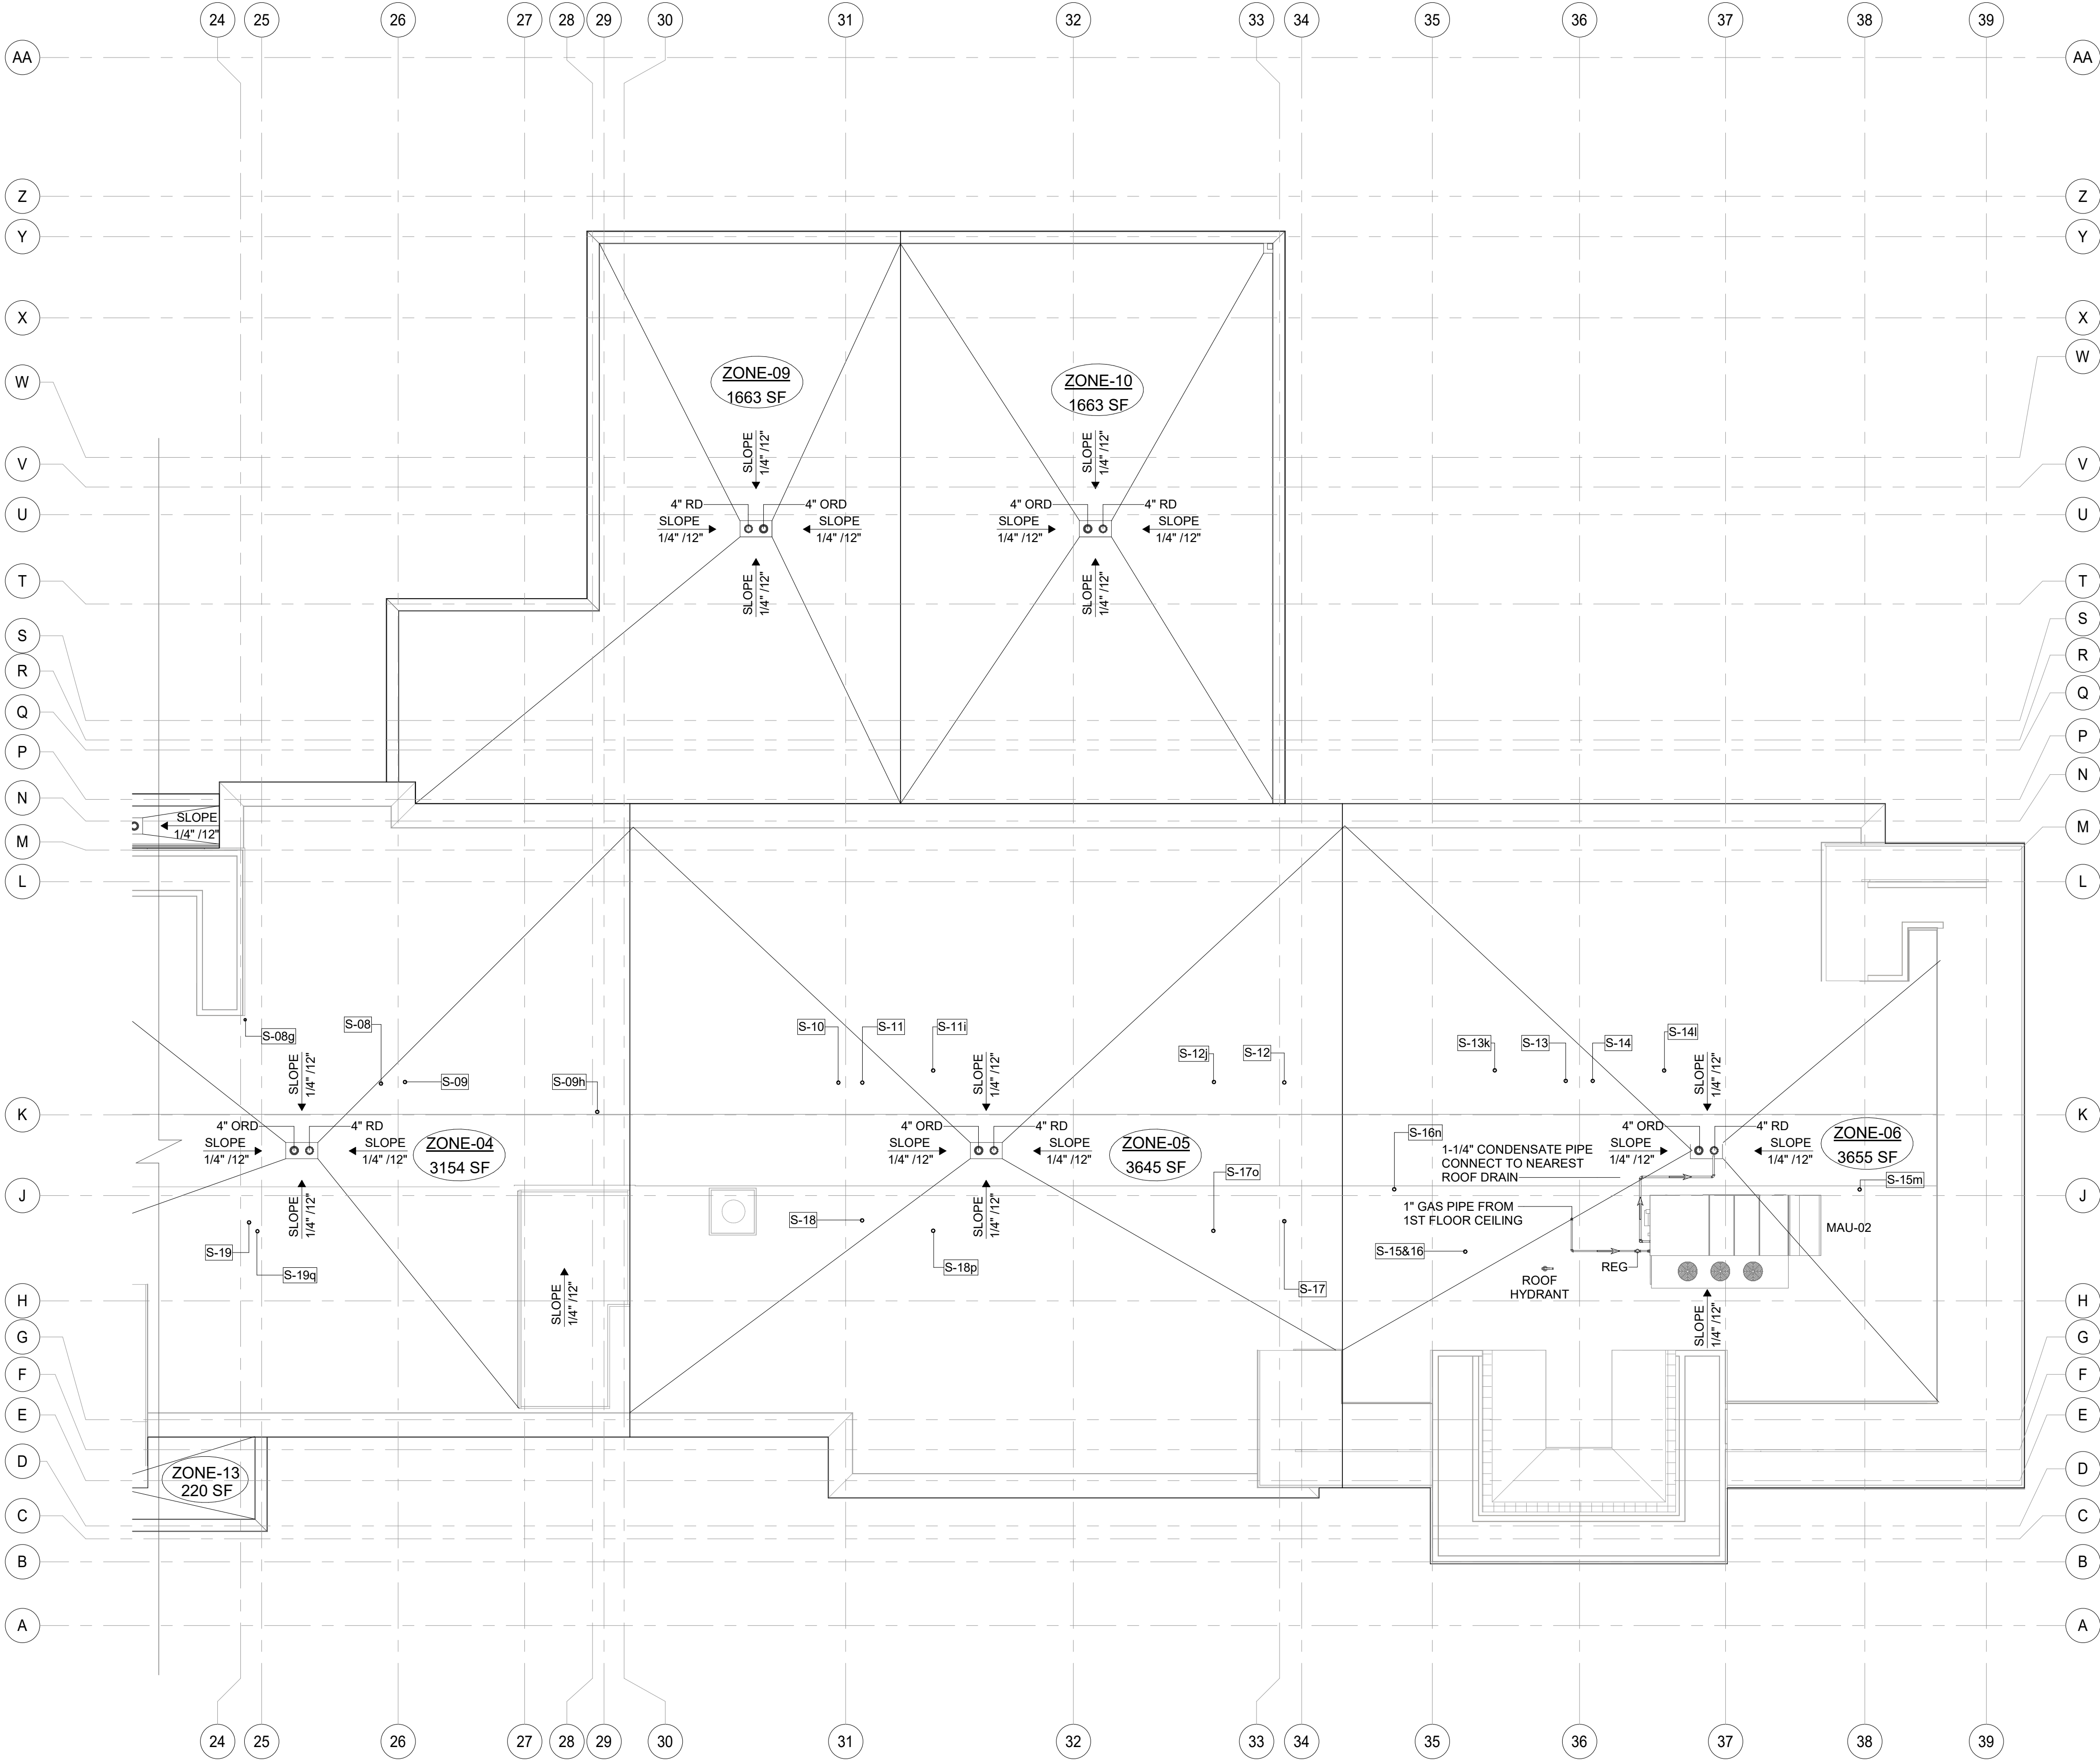

1 ROOF FLOOR PLUMBING PLAN PART-B
1/8" = 1'-0"

B-20-0180
City of Puyallup

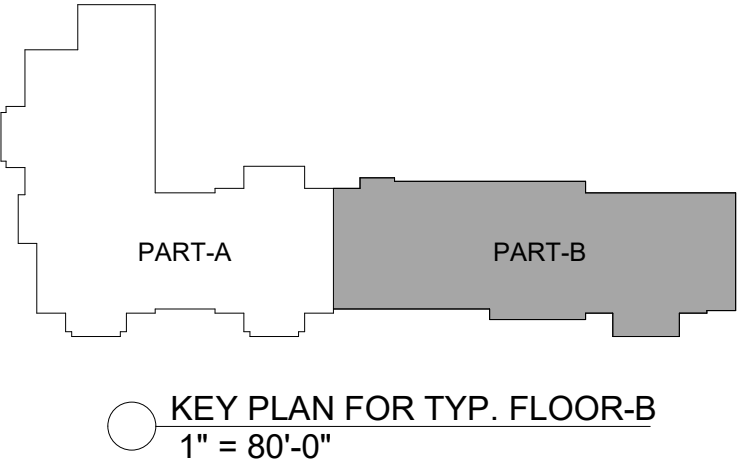


BASE⁴

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RICARDO J. MUNIZ-GUILLET, AIA
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MEP ENGINEER
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Seal:



Owner:

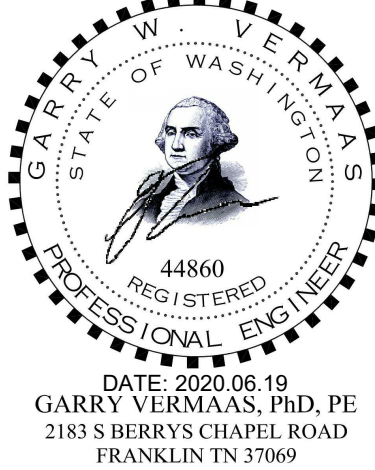

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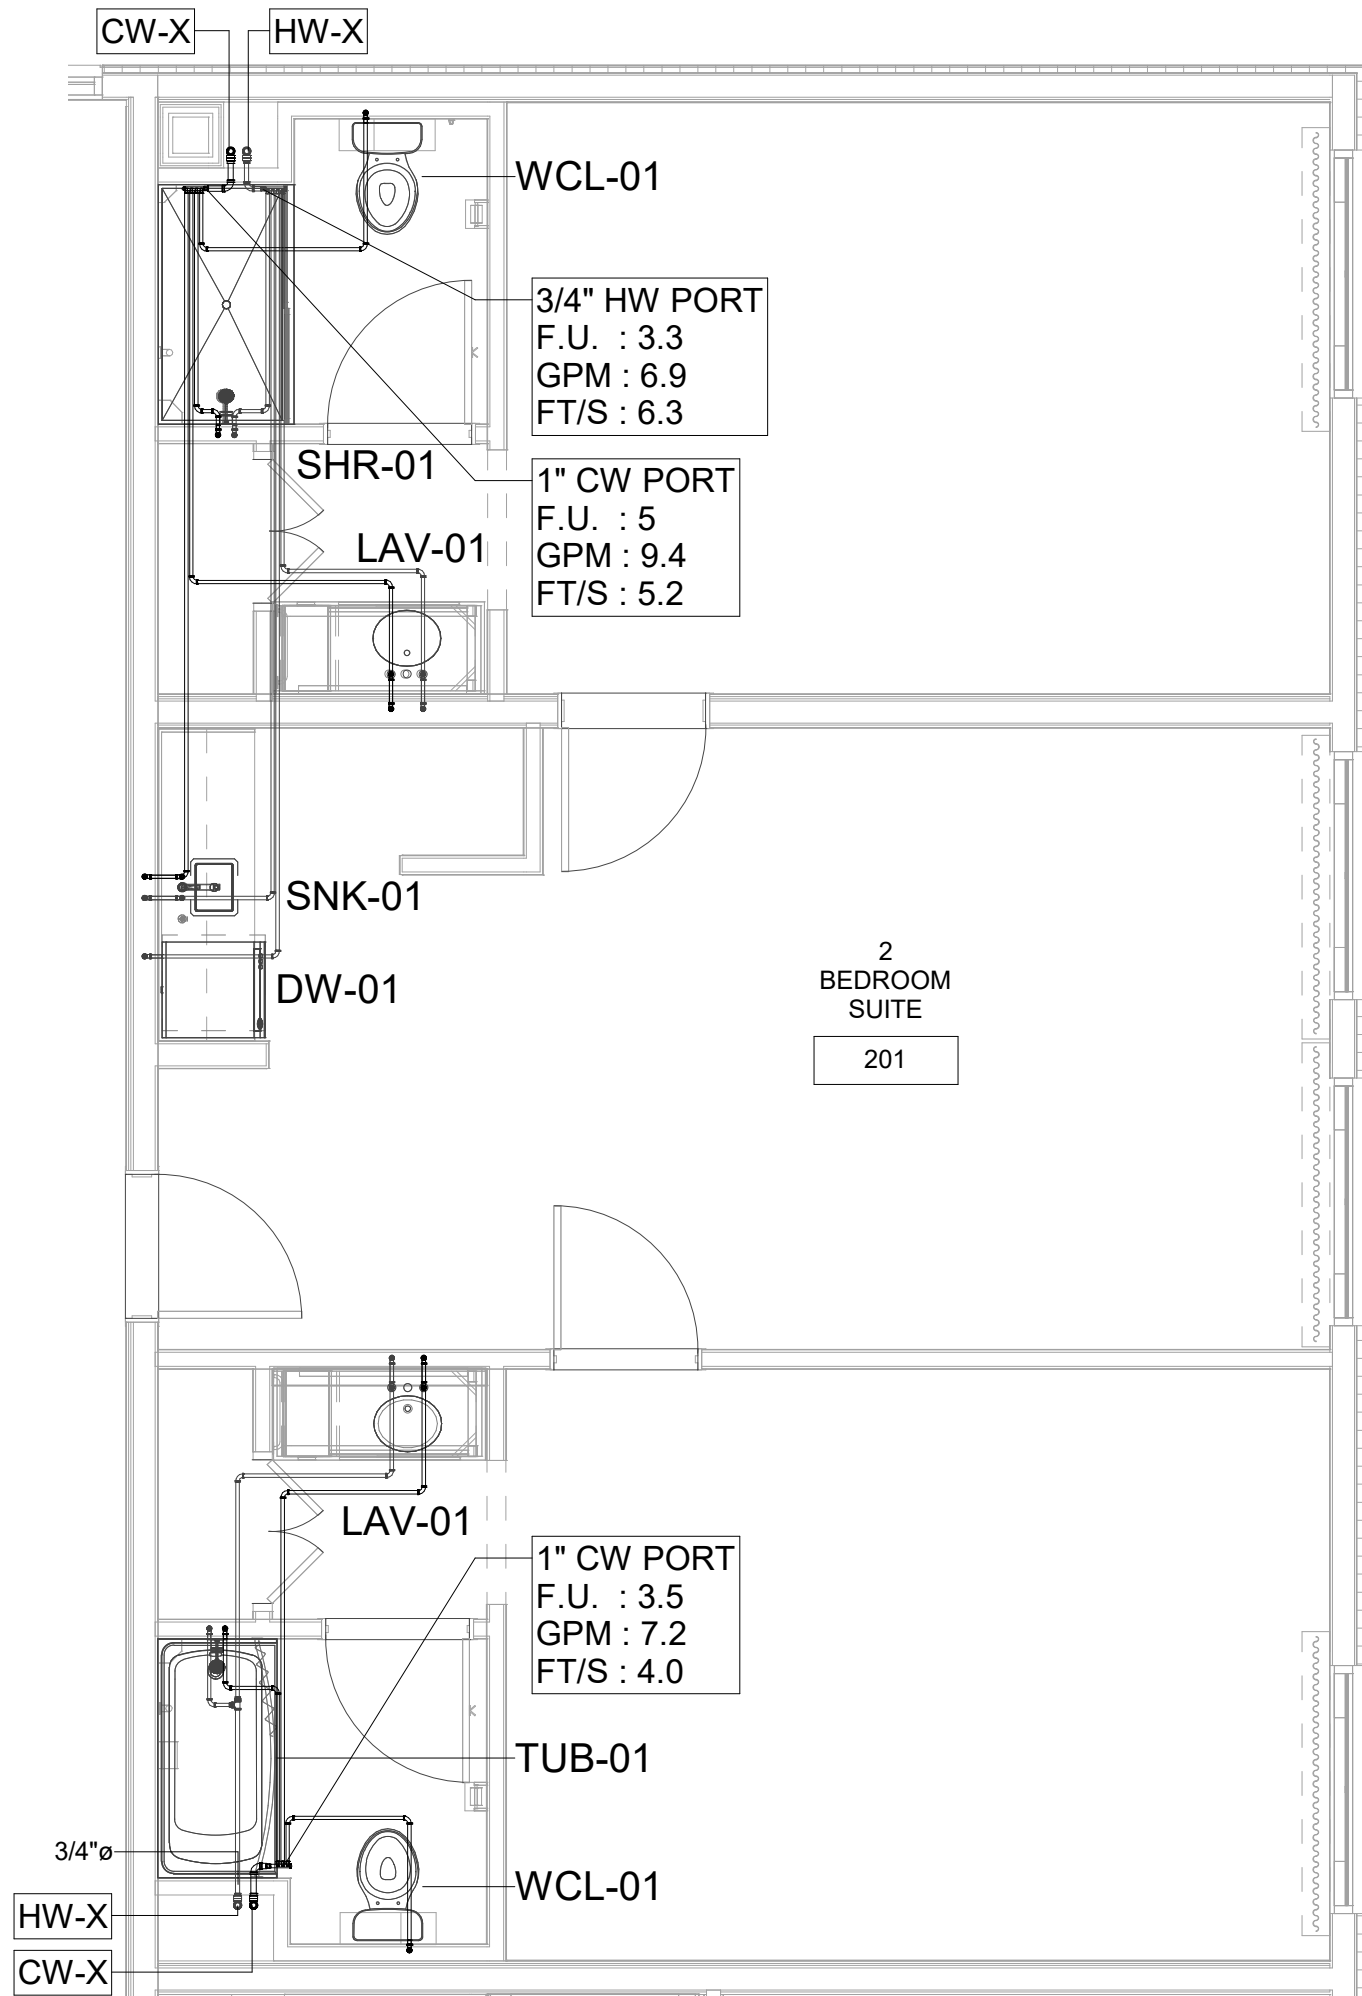
SHEET NAME

ROOF PLUMBING
PLAN-B


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P-211B


WATER SUPPLY DEMAND		
FIXTURE	CW/U	HW/U
BATHROOM GROUP	3.5	1.8
SNK AND DW	1.5	1.5




1 2 BEDROOM SUITE WATER SUPPLY PLAN
1/4" = 1'-0"

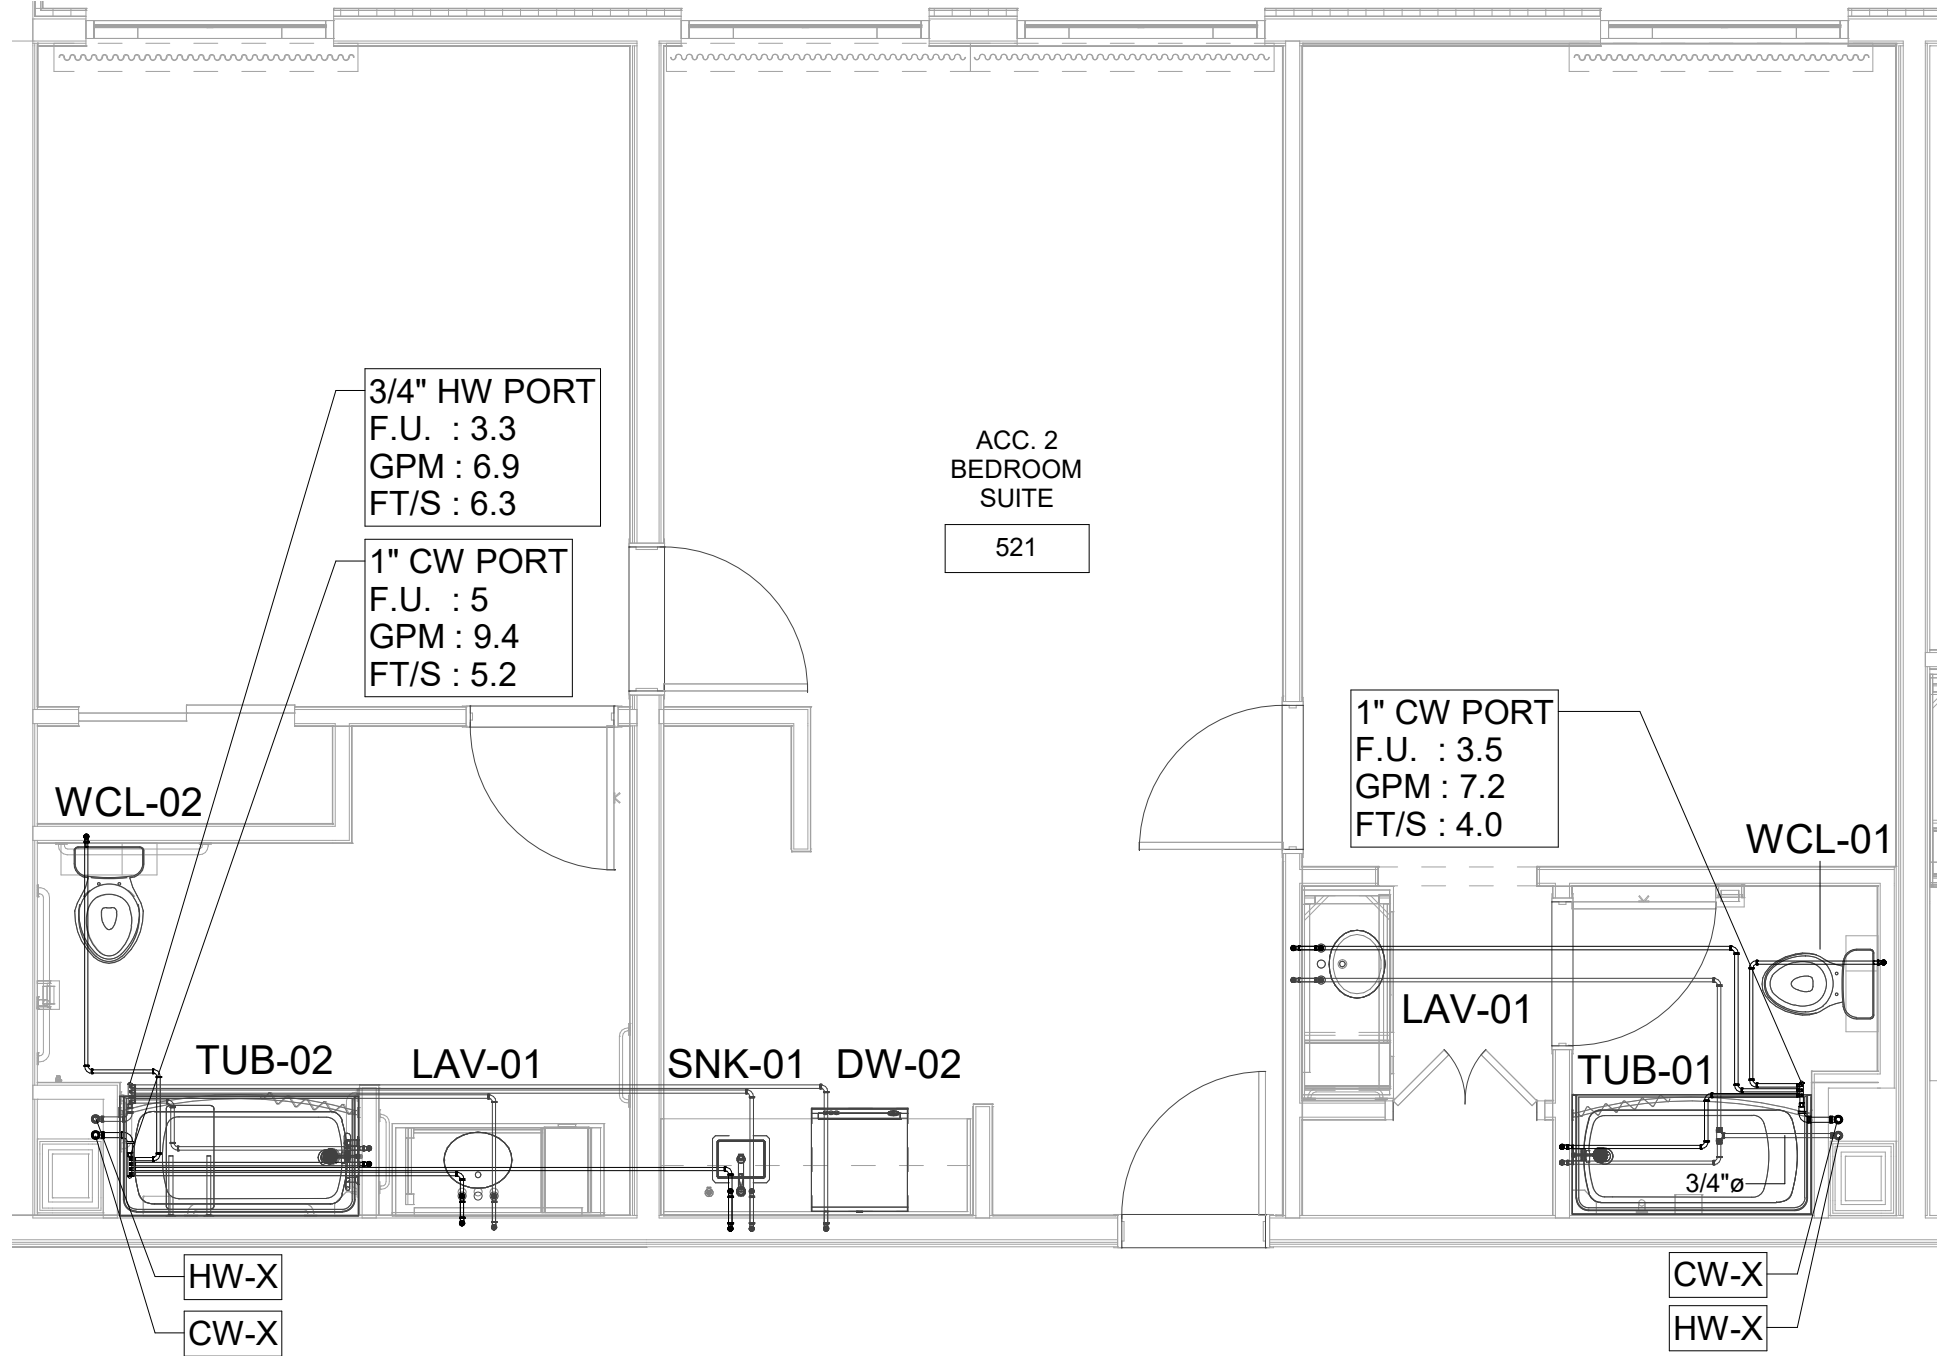


2 ACCESSIBLE 2 BEDROOM SUITE WATER SUPPLY PLAN
1/4" = 1'-0"

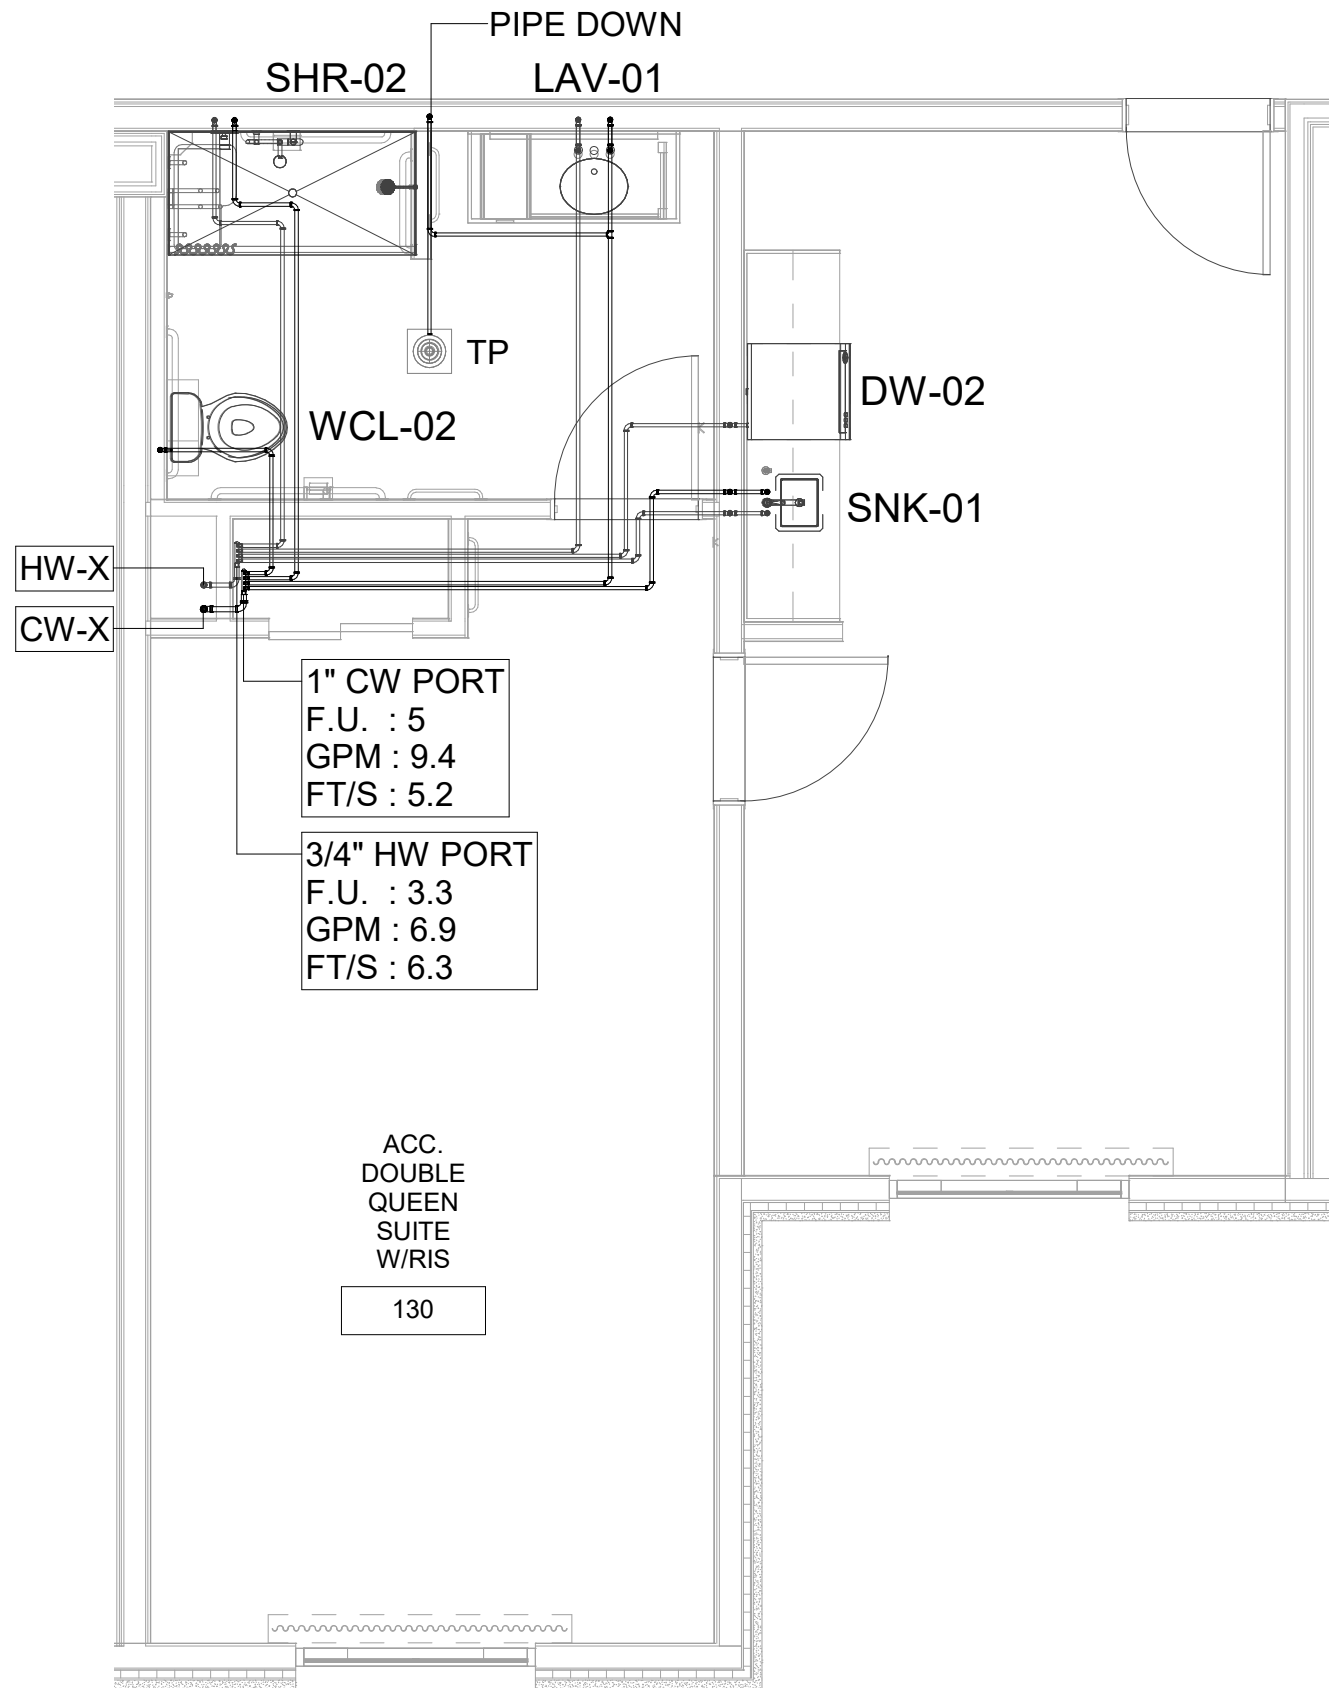


3 ACCESSIBLE DOUBLE QUEEN SUITE W/RI&S WATER SUPPLY PLAN
1/4" = 1'-0"

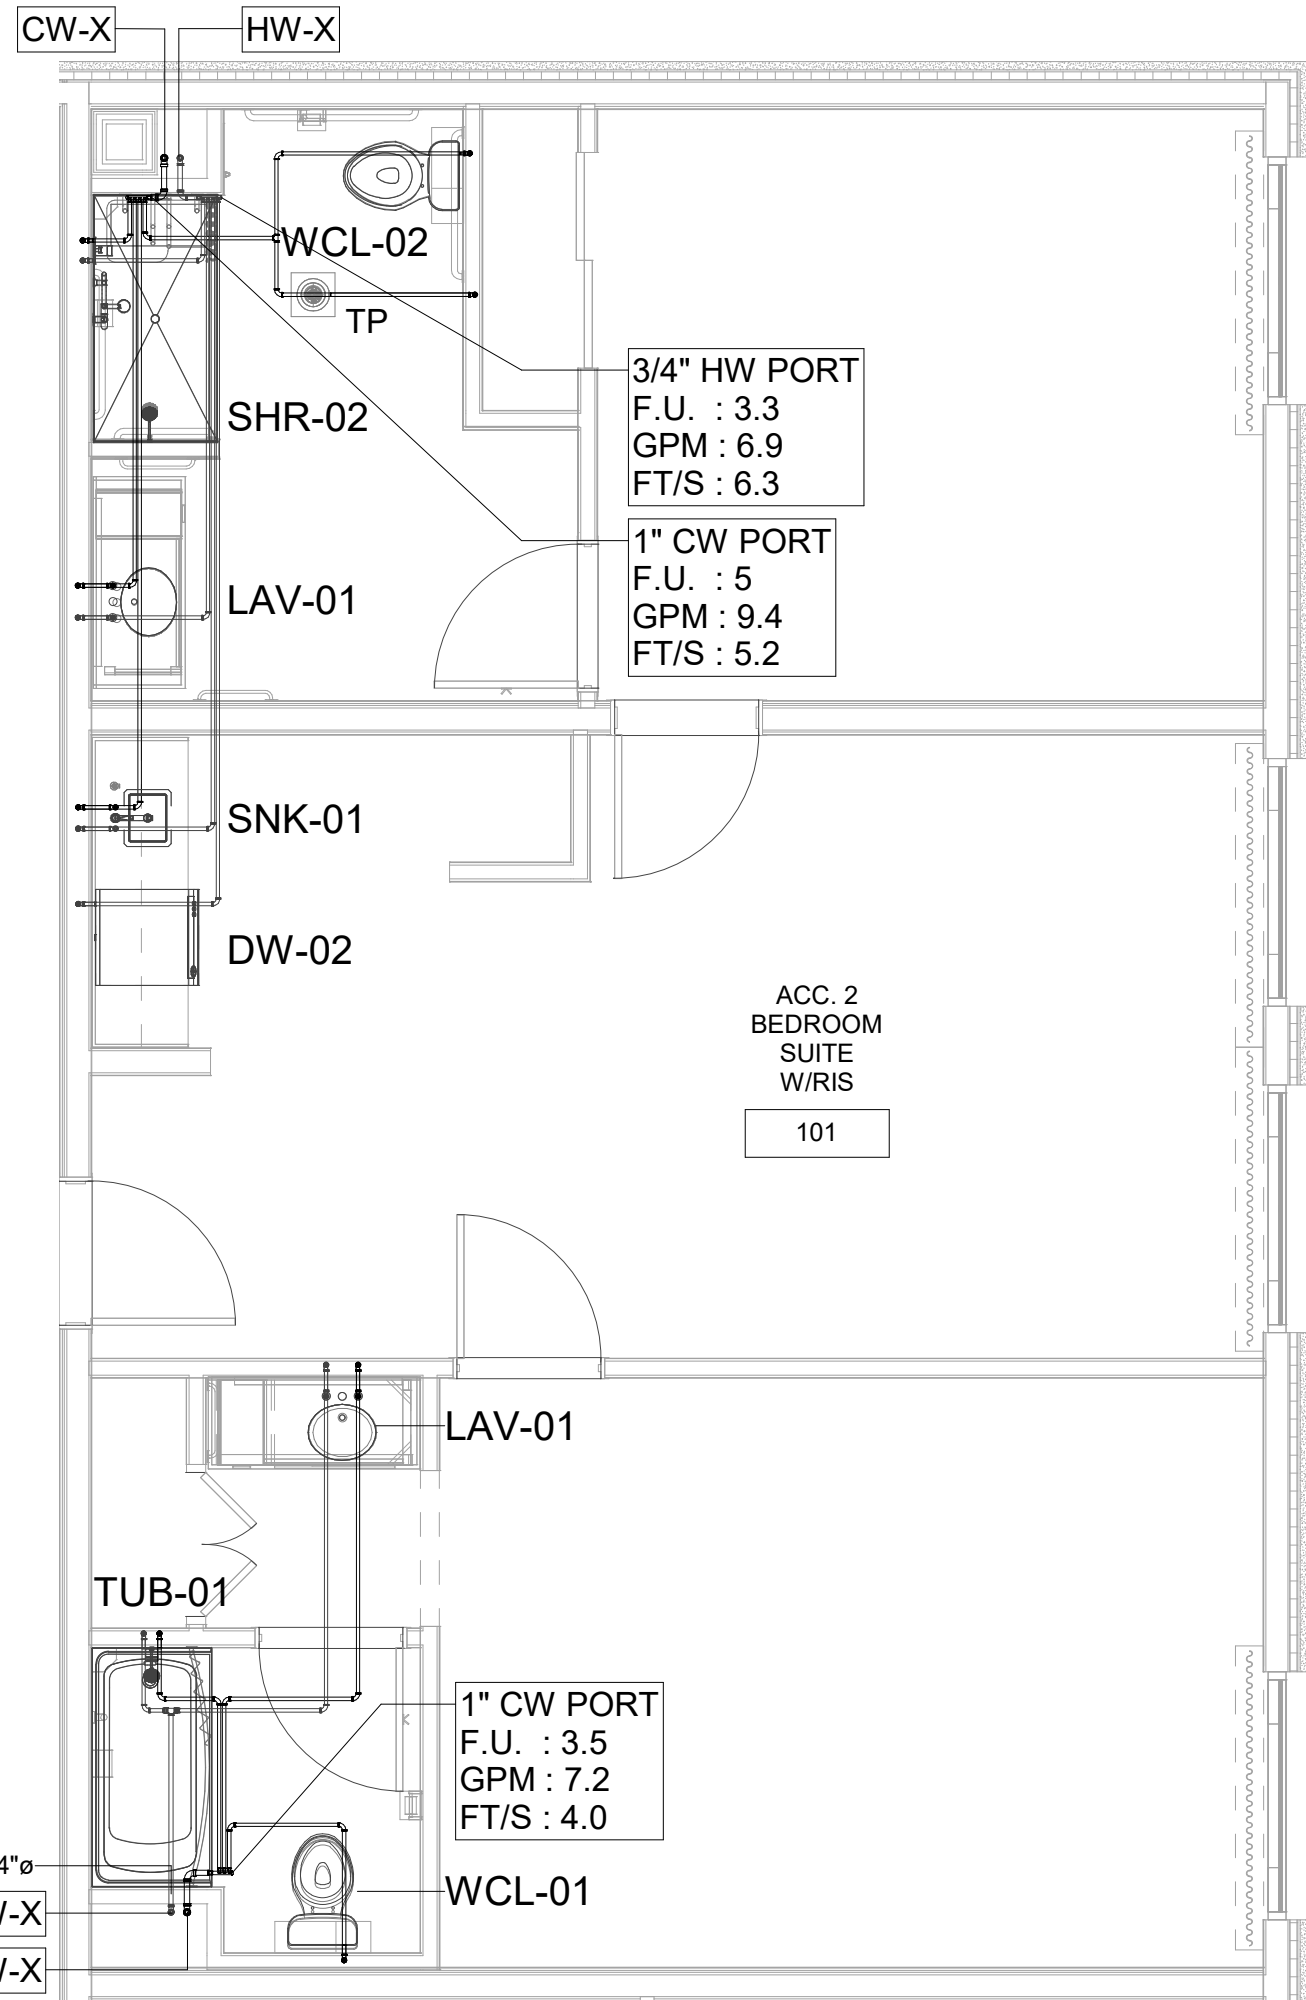


4 ACCESSIBLE 2 BEDROOM SUITE W/RI&S WATER SUPPLY PLAN
1/4" = 1'-0"

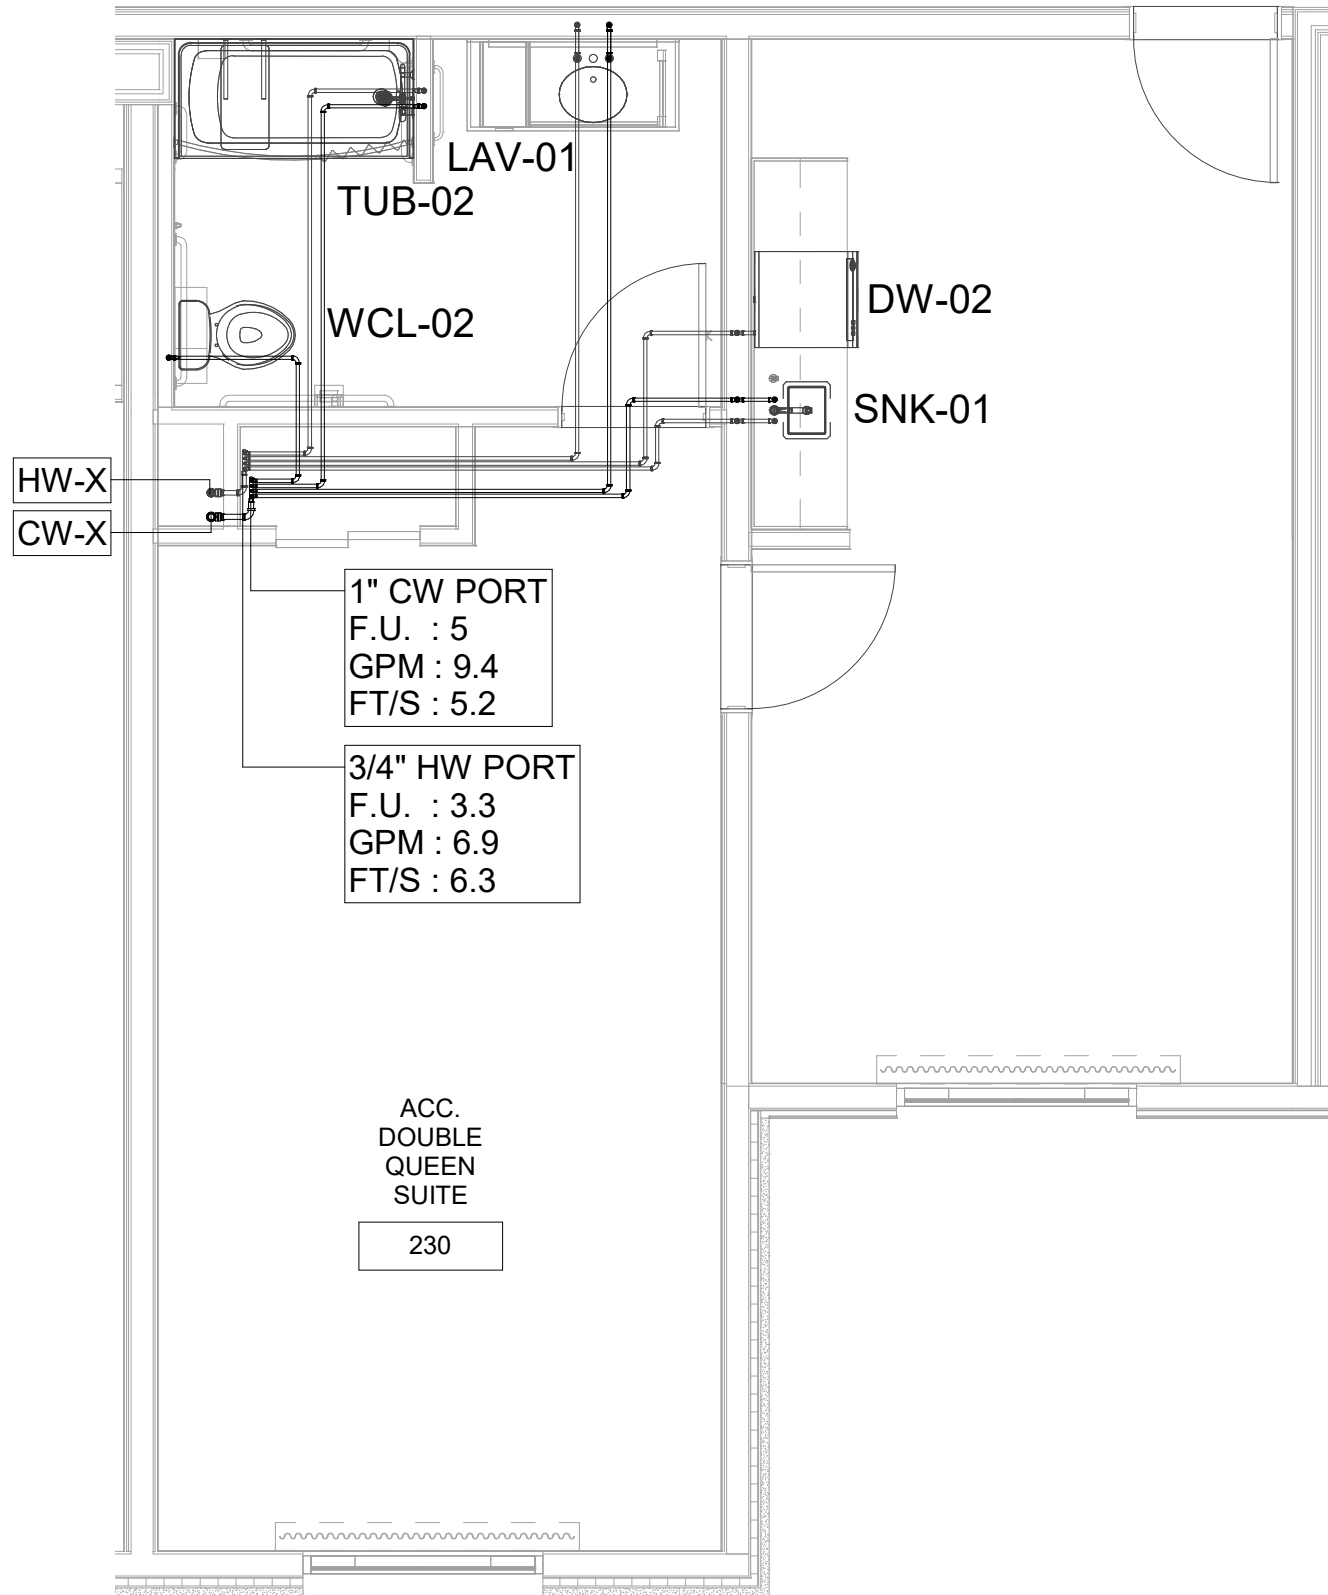

5 ACCESSIBLE DOUBLE QUEEN SUITE WATER SUPPLY PLAN
1/4" = 1'-0"

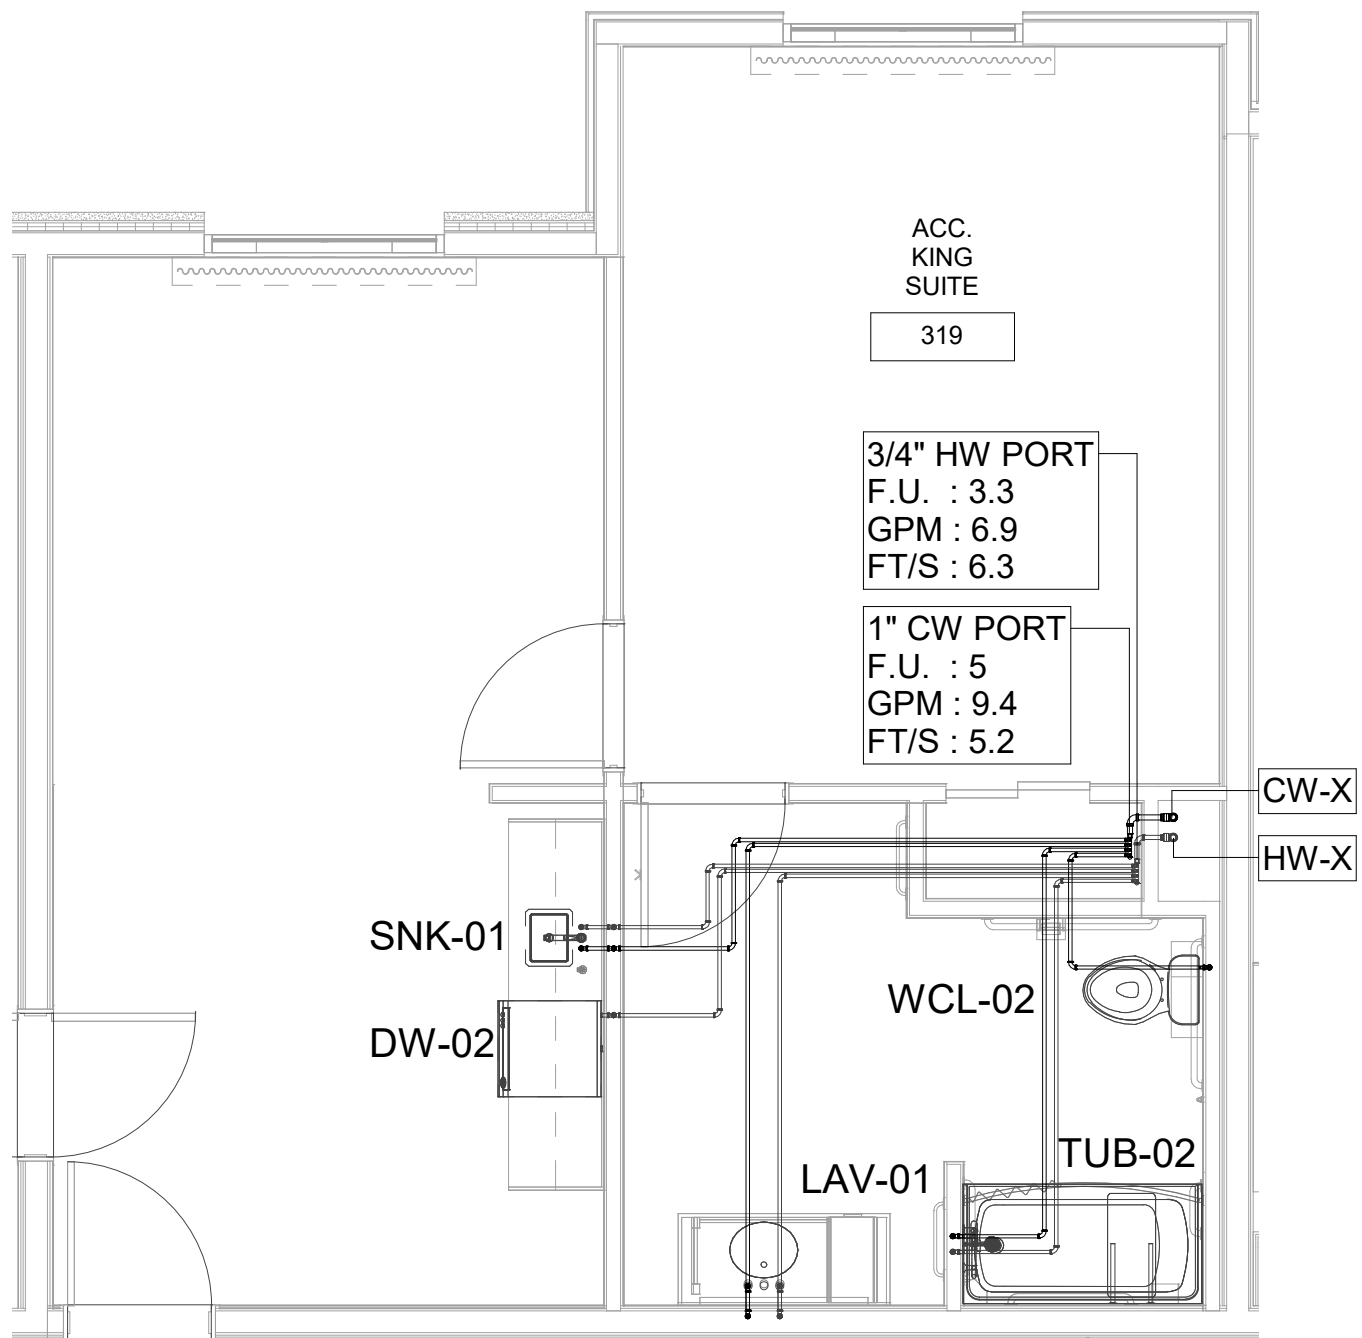

6 ACCESSIBLE KING SUITE WATER SUPPLY PLAN
1/4" = 1'-0"

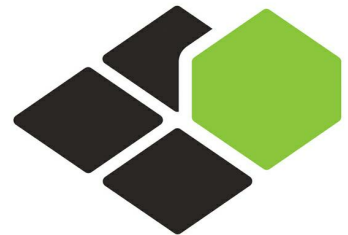


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MEP ENGINEER
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2183 S BERRYS CHAPEL ROAD
FRANKLIN, TN 37069

Seal:



Owner:

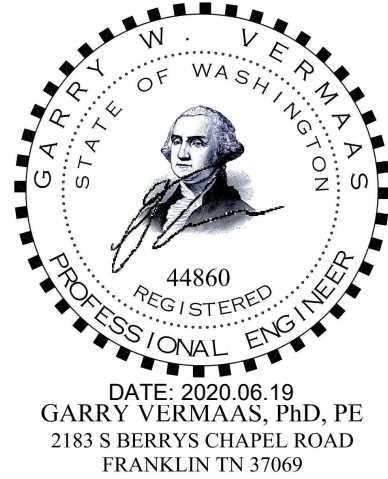

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B4-124-1803

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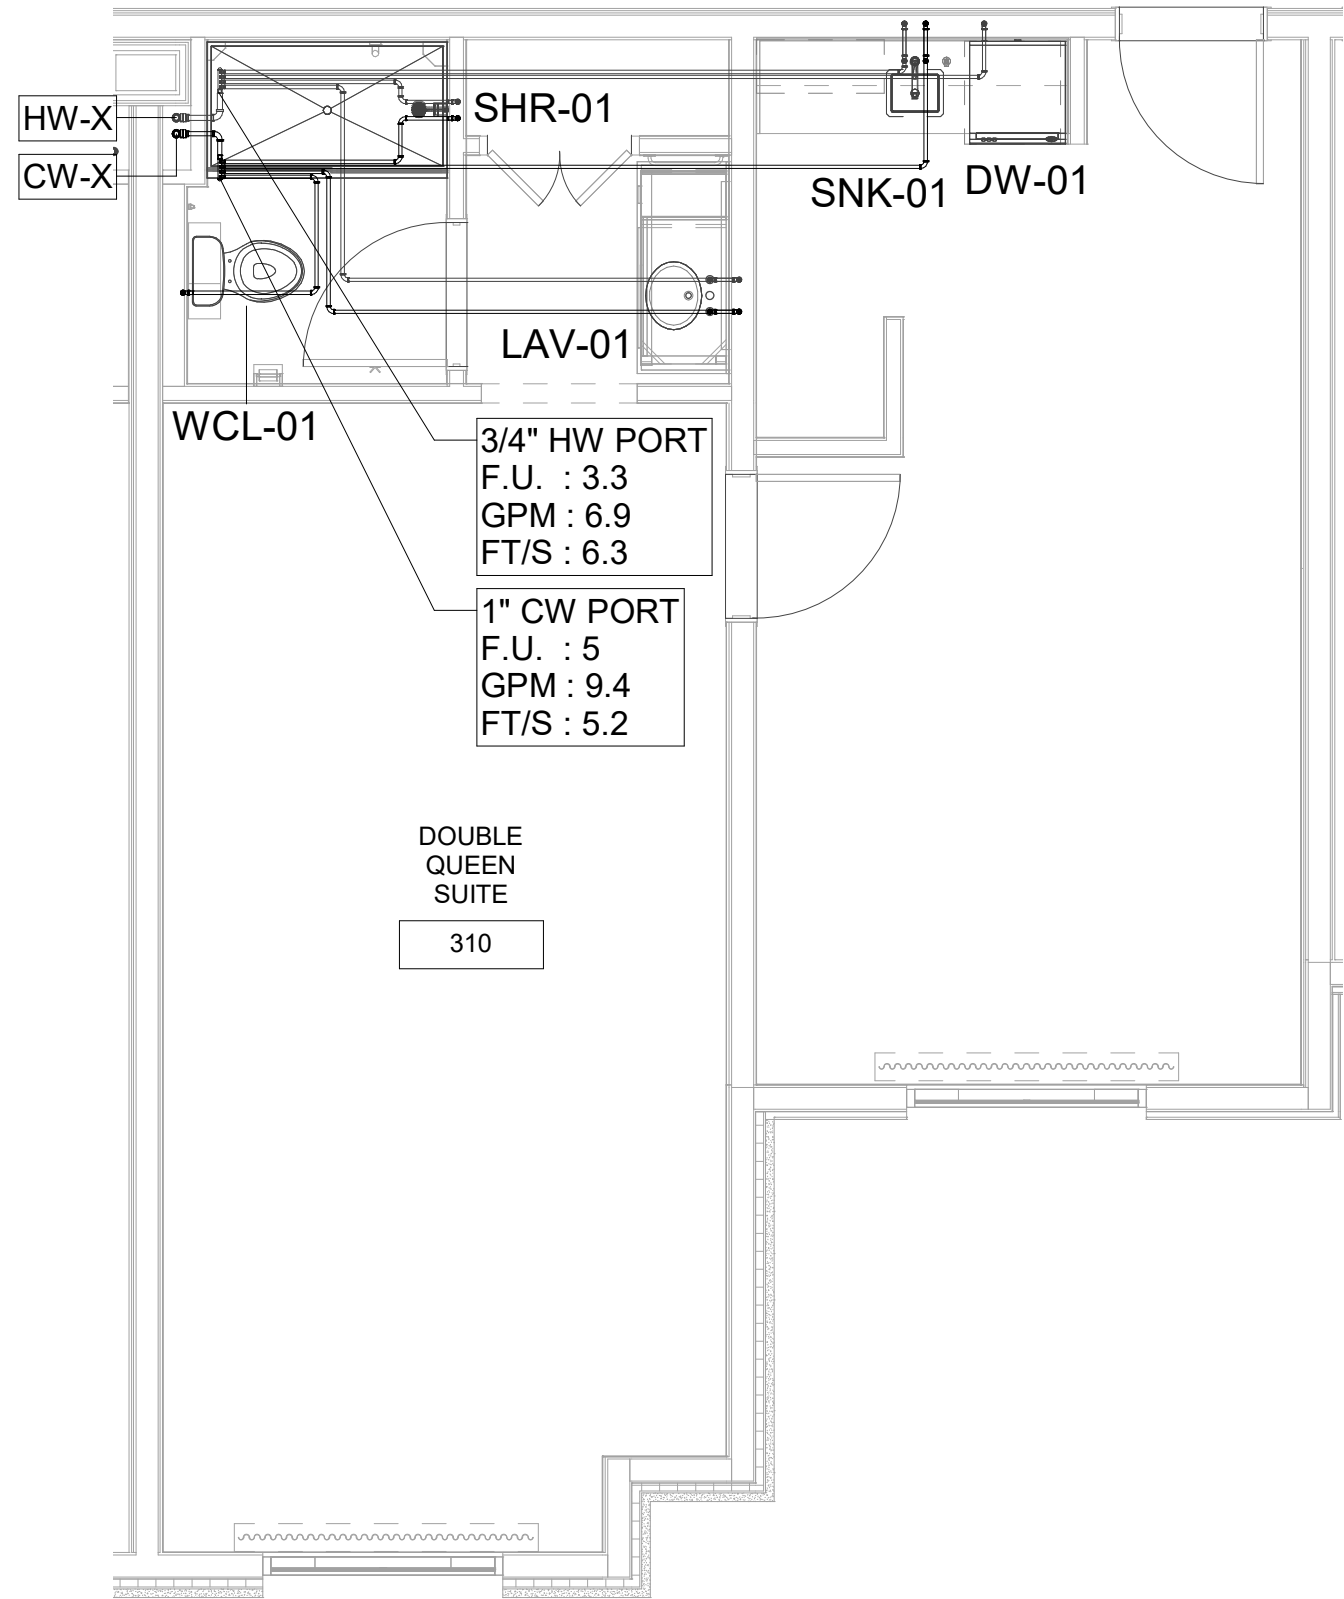
UNIT WATER
SUPPLY PLAN-A

DRAWINGS NO.


P-301A

B-20-0180
City of Puyallup


WATER SUPPLY DEMAND		
FIXTURE	CWFU	HWFU
BATHROOM GROUP	3.5	1.8
SNK AND DW	1.5	1.5




7 DOUBLE QUEEN SUITE WATER SUPPLY PLAN
1/4" = 1'-0"

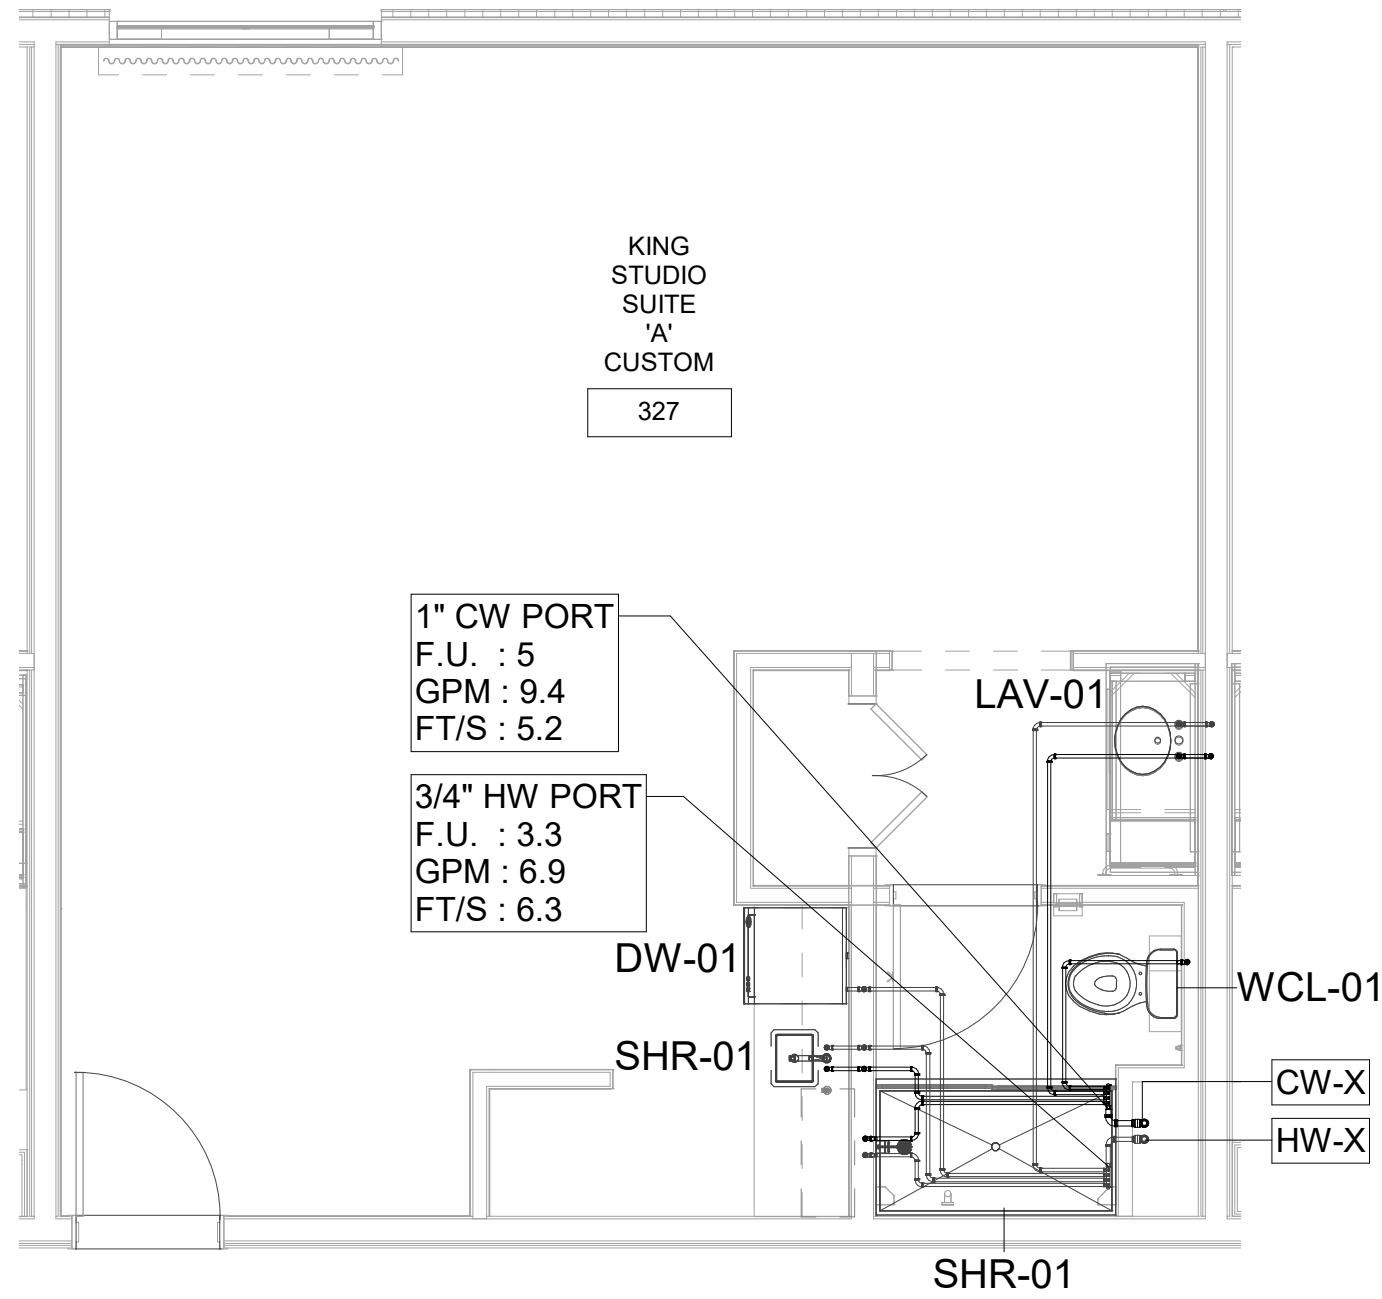


8 KING STUDIO 'A' CUSTOM WATER SUPPLY PLAN
1/4" = 1'-0"

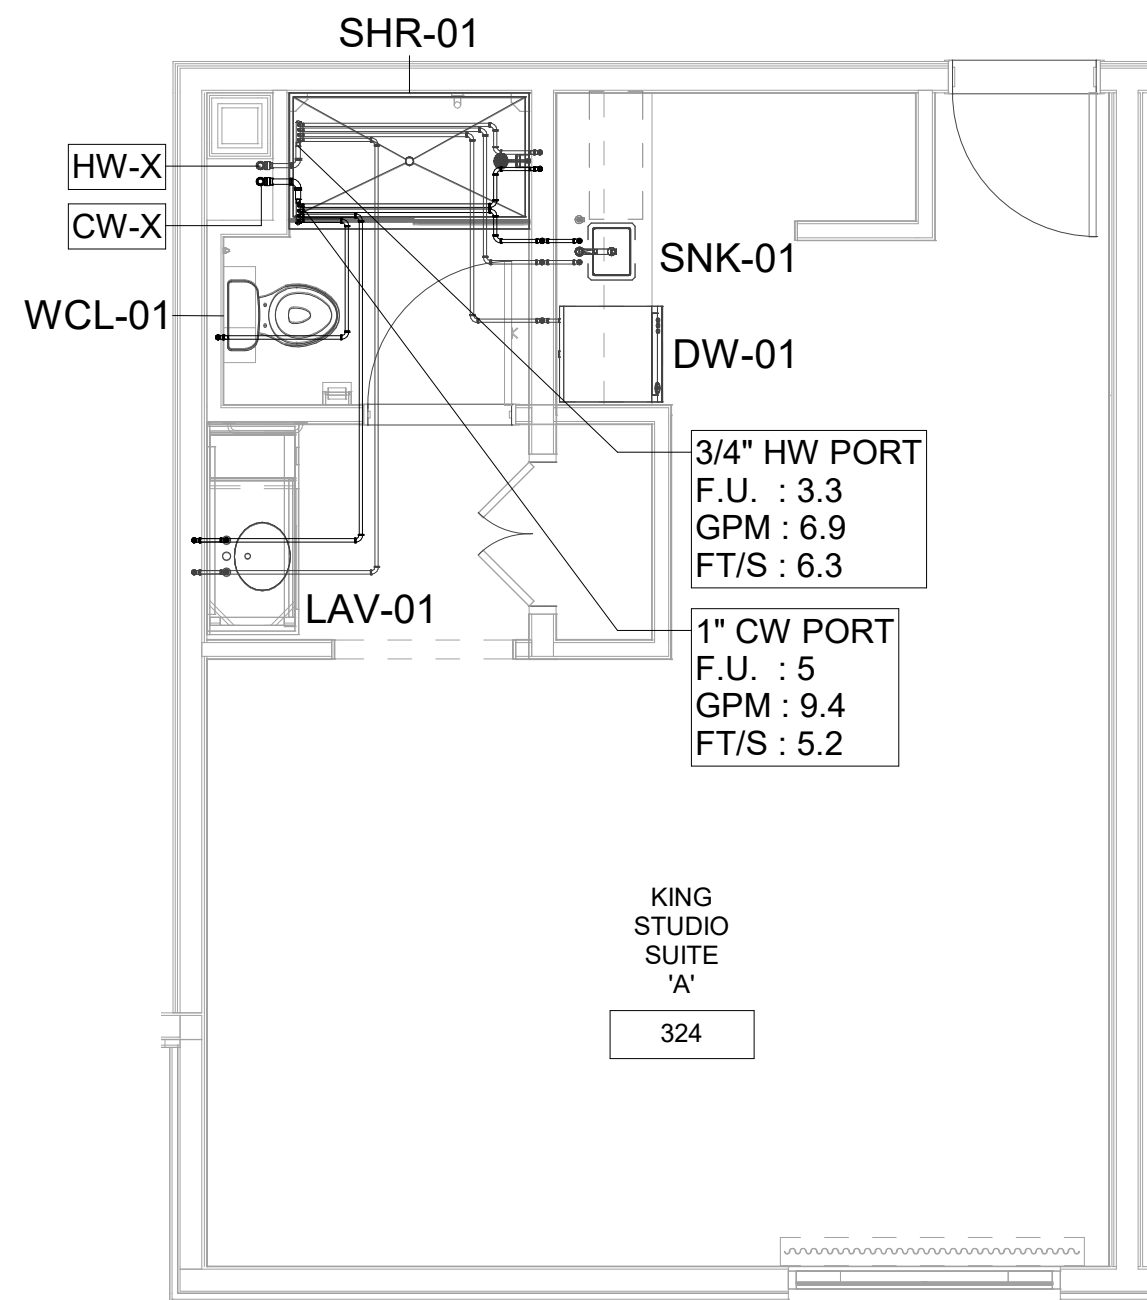

9 KING STUDIO 'A' WATER SUPPLY PLAN
1/4" = 1'-0"

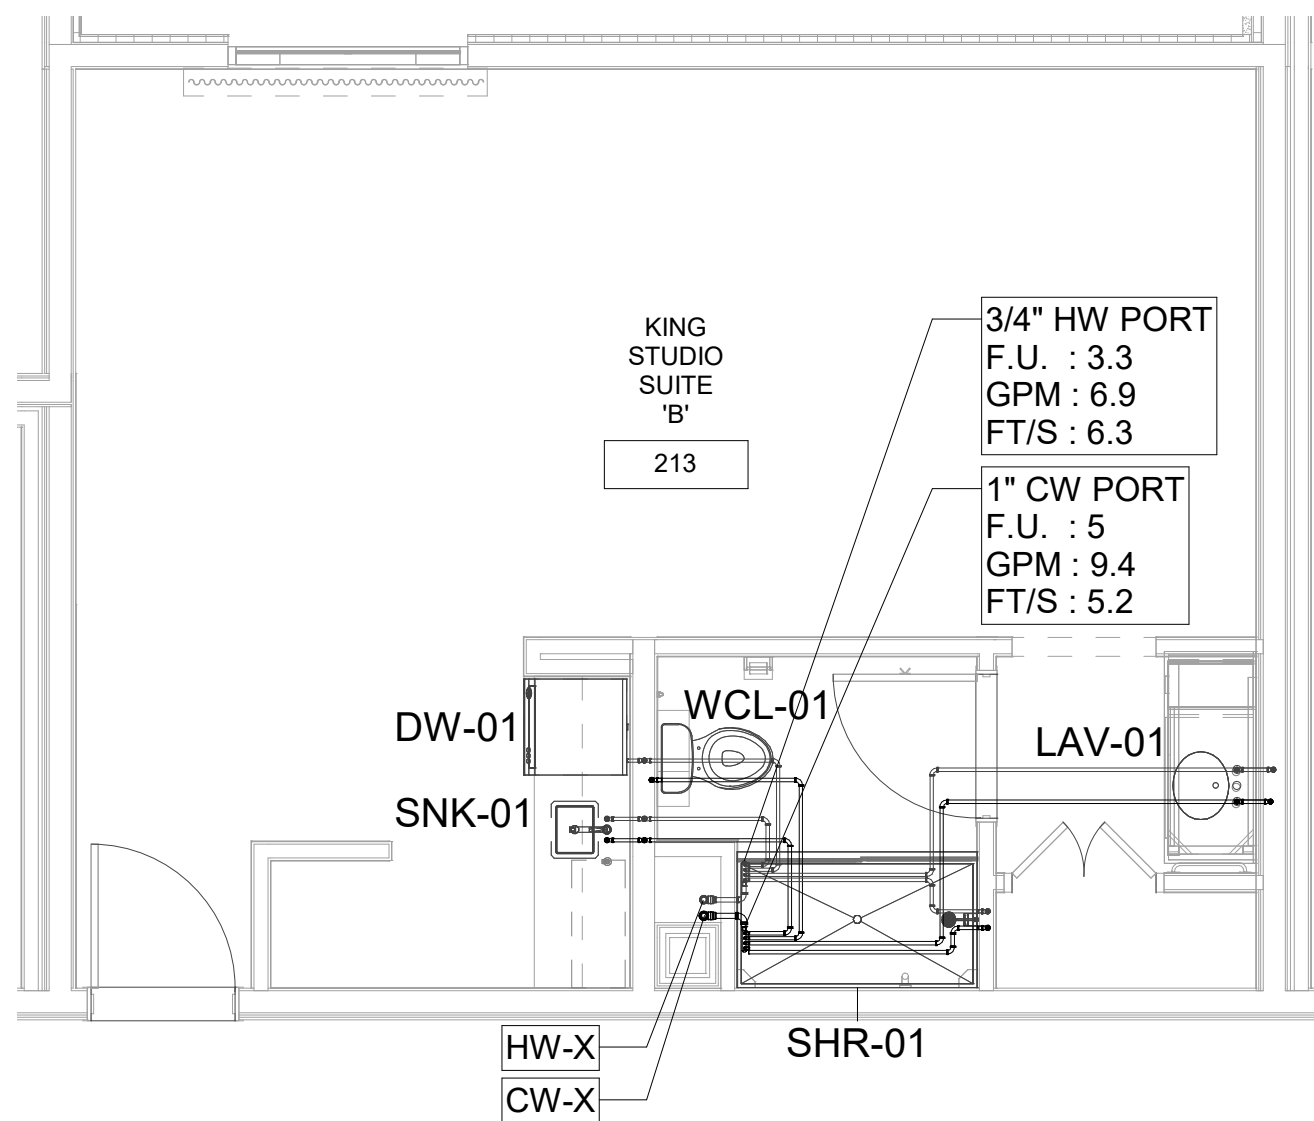


10 KING STUDIO 'B' WATER SUPPLY PLAN
1/4" = 1'-0"

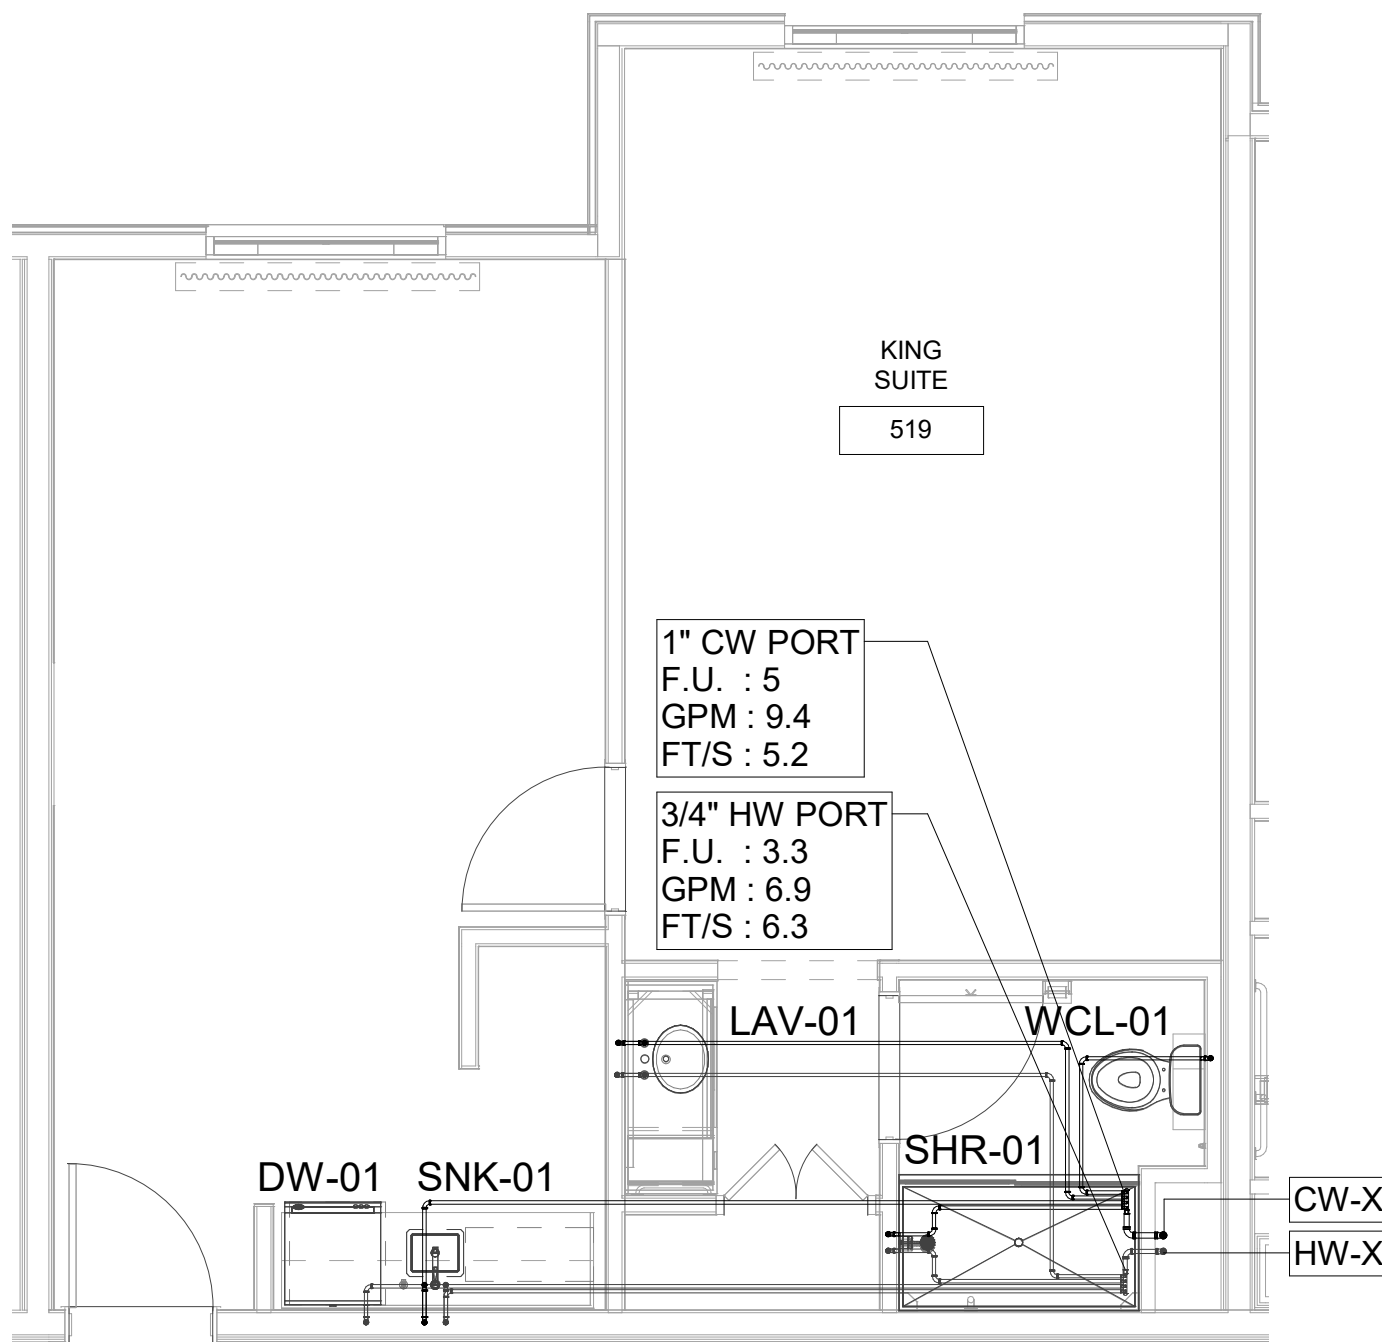

11 KING SUITE WATER SUPPLY PLAN
1/4" = 1'-0"

NOT IN USE

B-20-0180
City of Puyallup

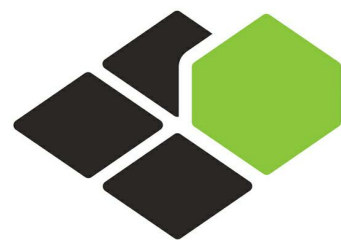


BASE⁴

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CORAL SPRINGS, FL 33076

MEP ENGINEER
GARRY VERMAAS PhD, PE
2183 S BERRYS CHAPEL ROAD
FRANKLIN, TN 37069

Seal:

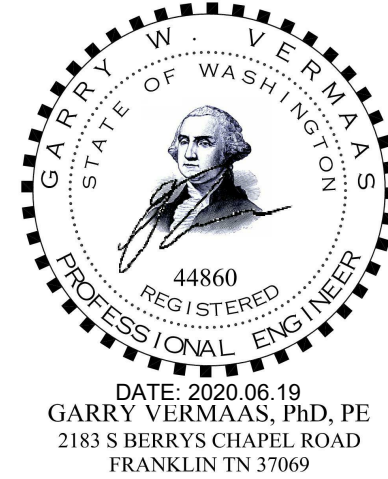

Owner:



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PROTOTYPE VERSION: V9.2 2014 FEB

ISSUE NO.	DELTA	ISSUE DATE	DESCRIPTION
1	P0	2020.02.21	ISSUED FOR PERMIT

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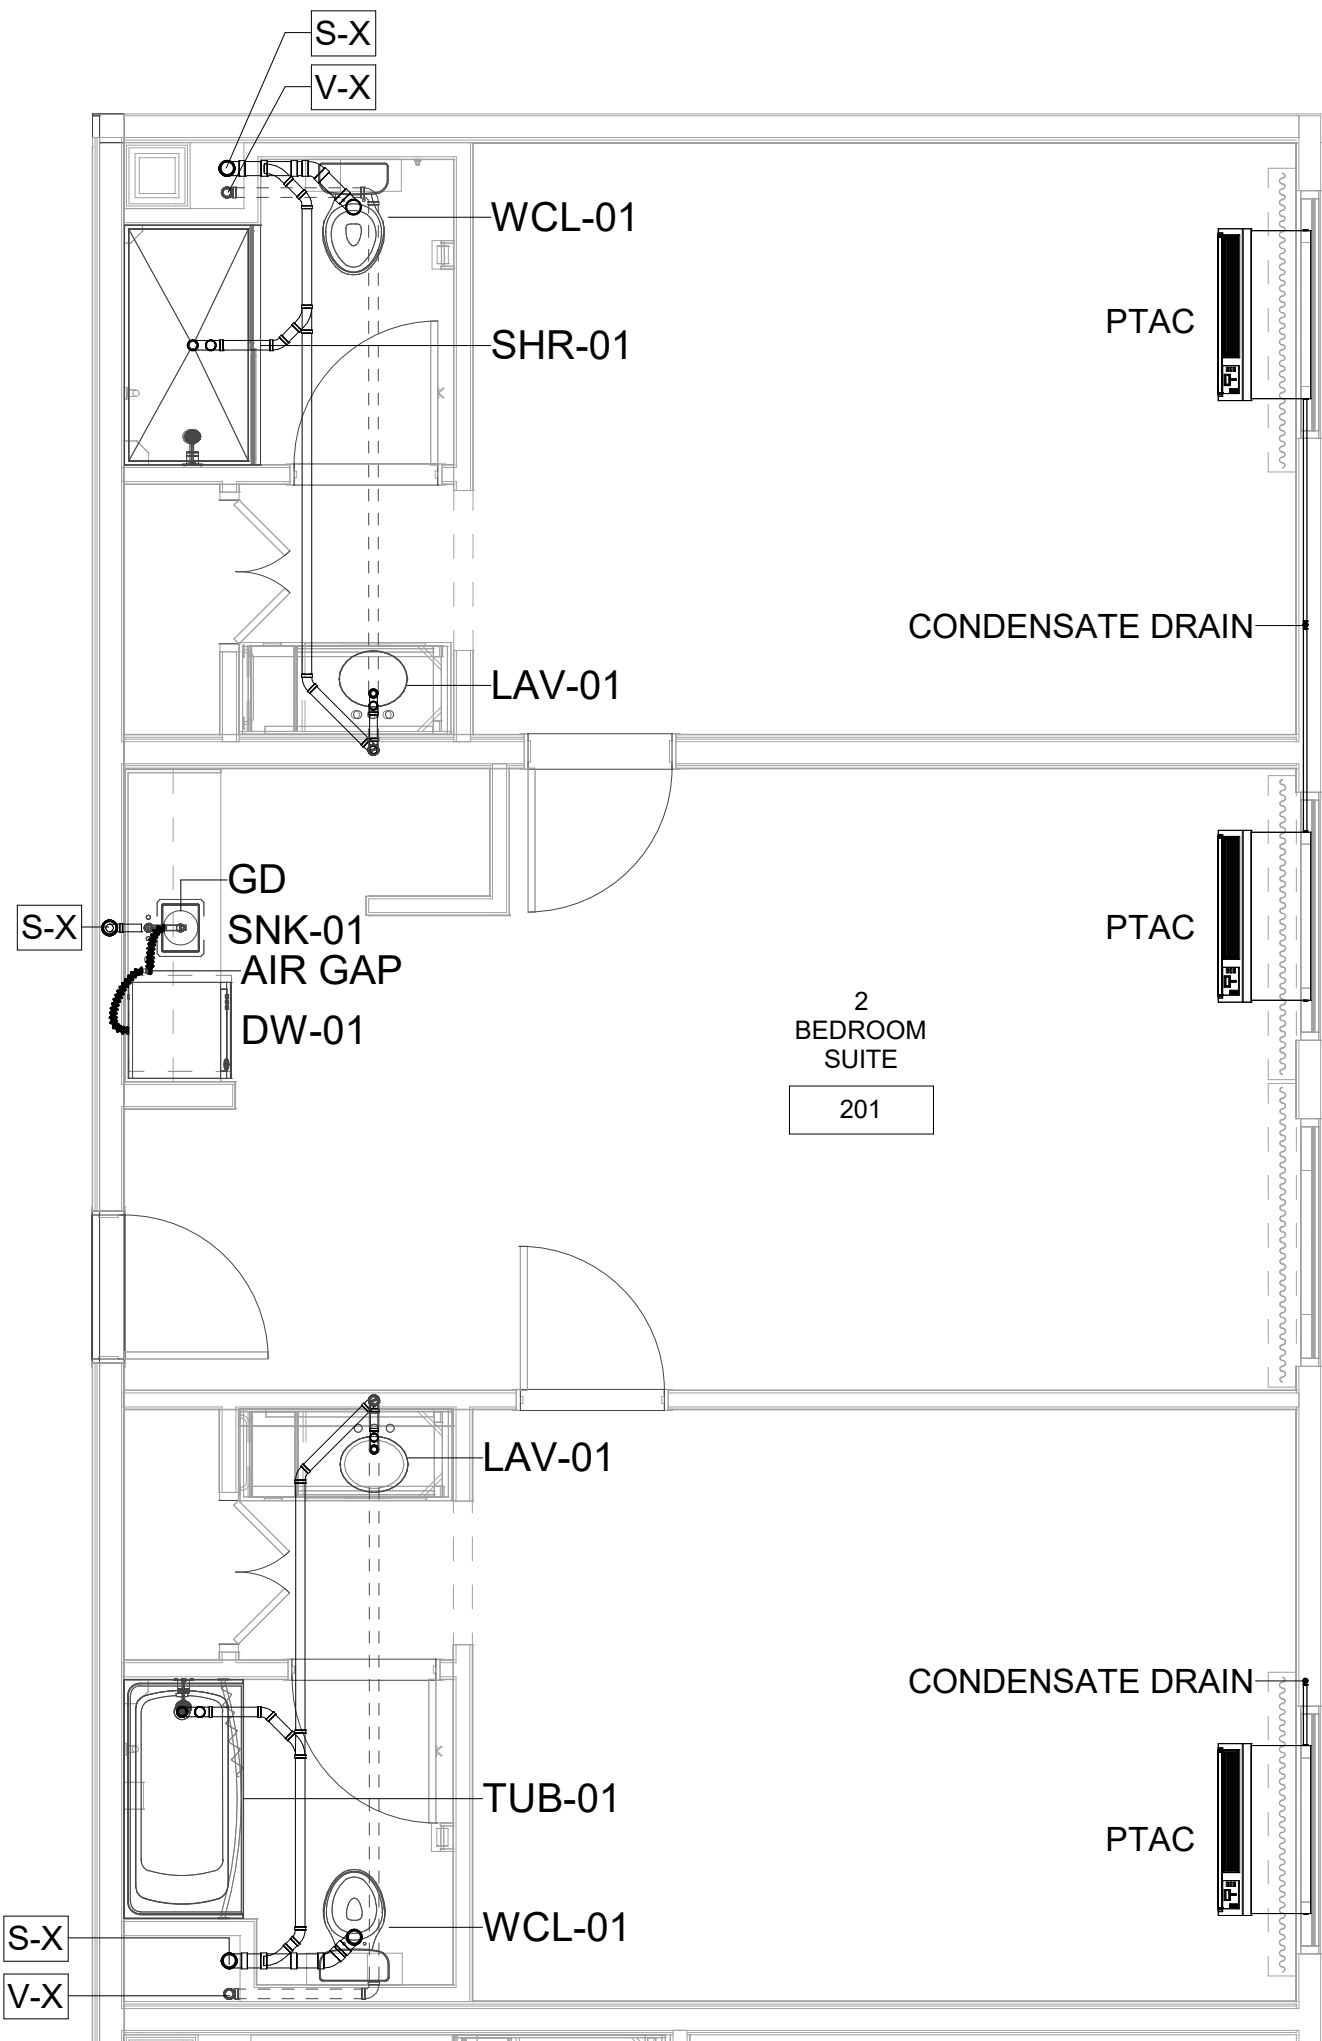
SHEET NAME

UNIT WATER
SUPPLY PLAN-B


DRAWINGS NO.

P-301B


SEWER LOAD DEMAND	
FIXTURE	DFU
BATHROOM GROUP	5.0
SNK / DW	2.0




① 2 BEDROOM SUITE SANITARY AND VENT PLAN
1/4" = 1'-0"

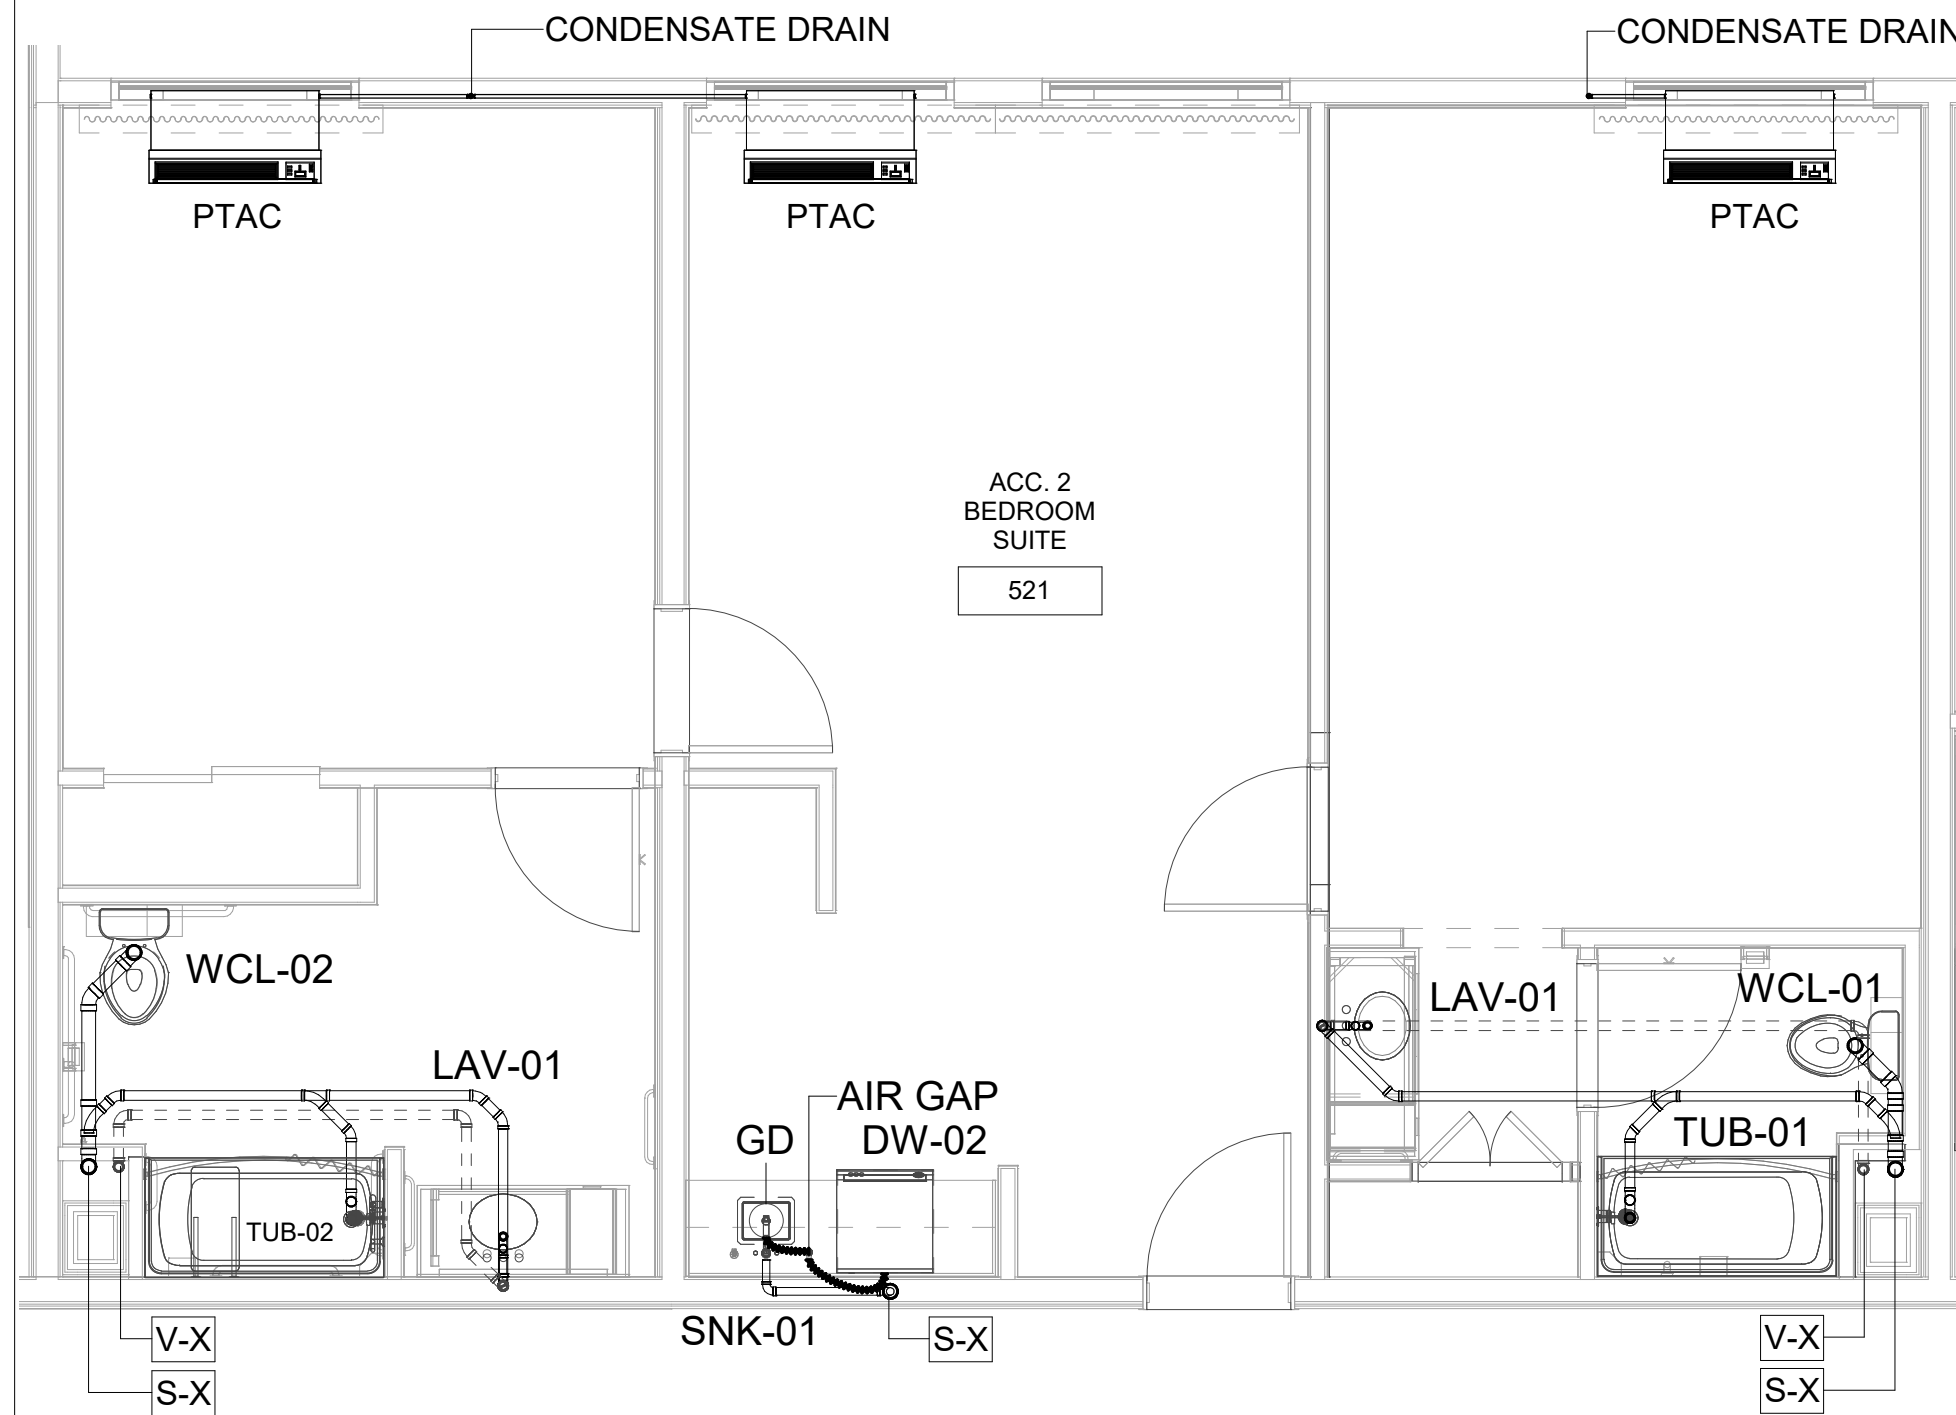


② ACCESSIBLE 2 BEDROOM SUITE SANITARY AND VENT PLAN
1/4" = 1'-0"

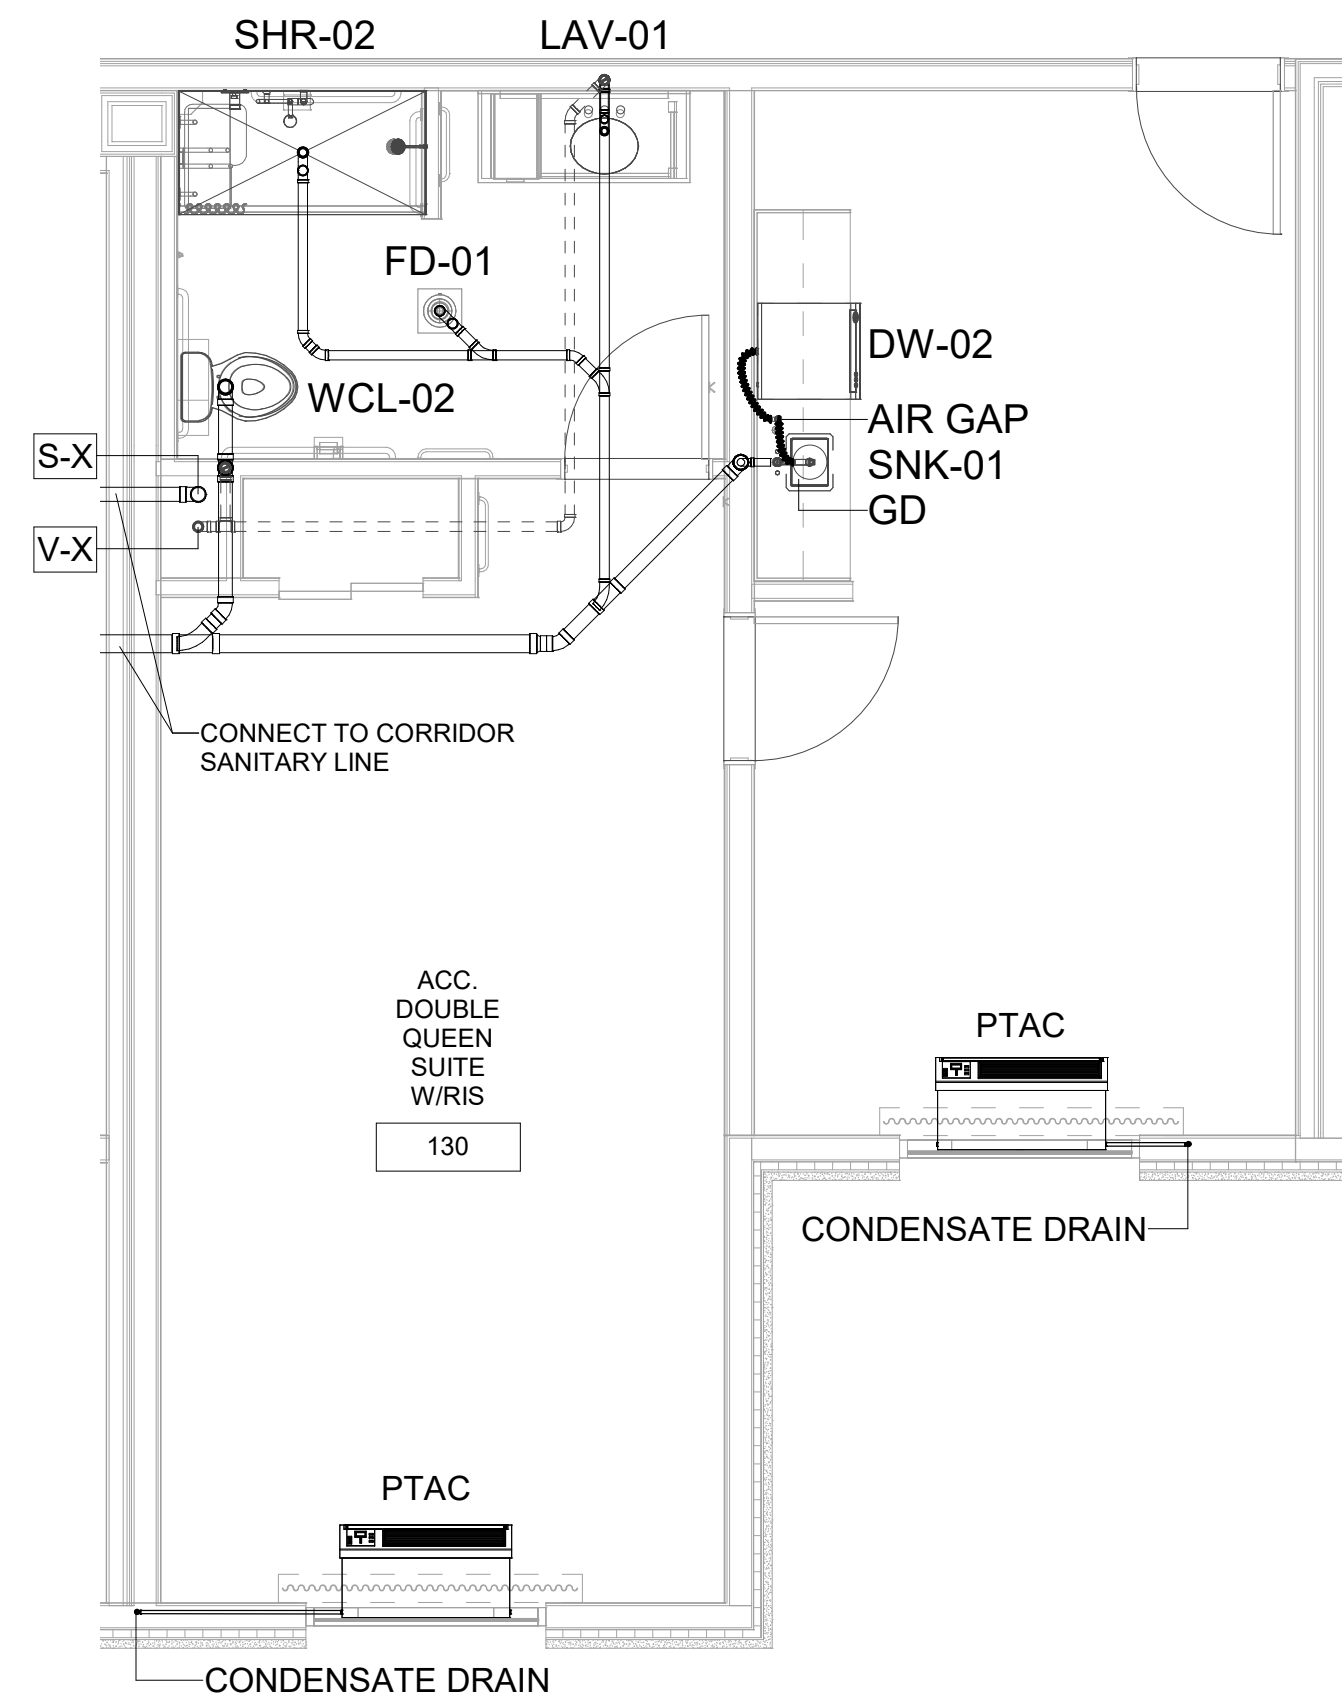


③ ACCESSIBLE DOUBLE QUEEN SUITE W/RIS SANITARY AND VENT PLAN
1/4" = 1'-0"

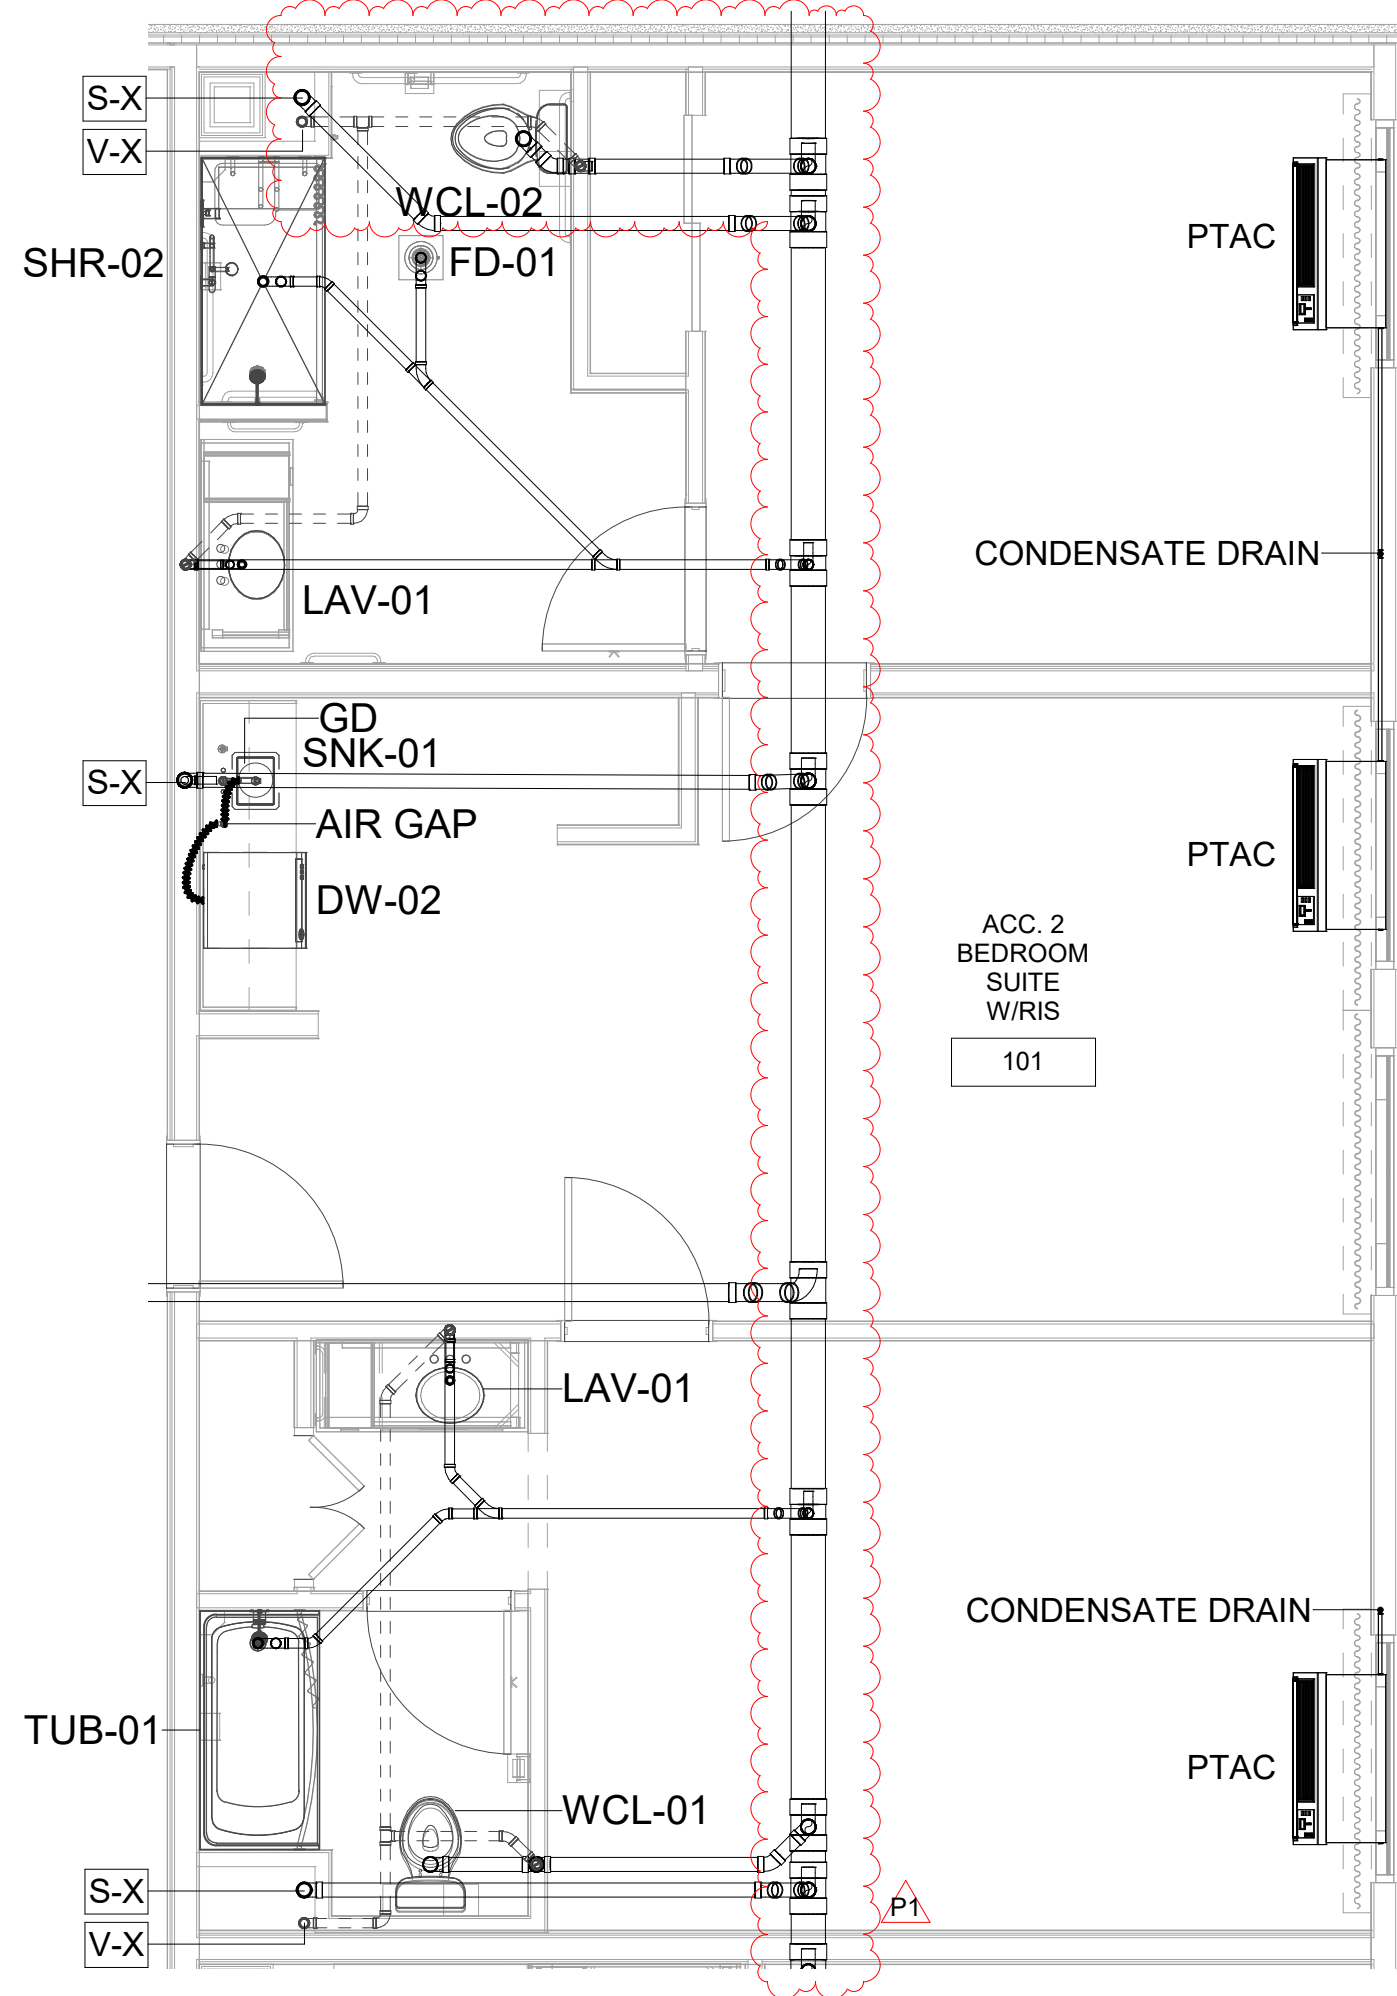


④ ACCESSIBLE 2 BEDROOM SUITE W/RIS SANITARY AND VENT PLAN
1/4" = 1'-0"

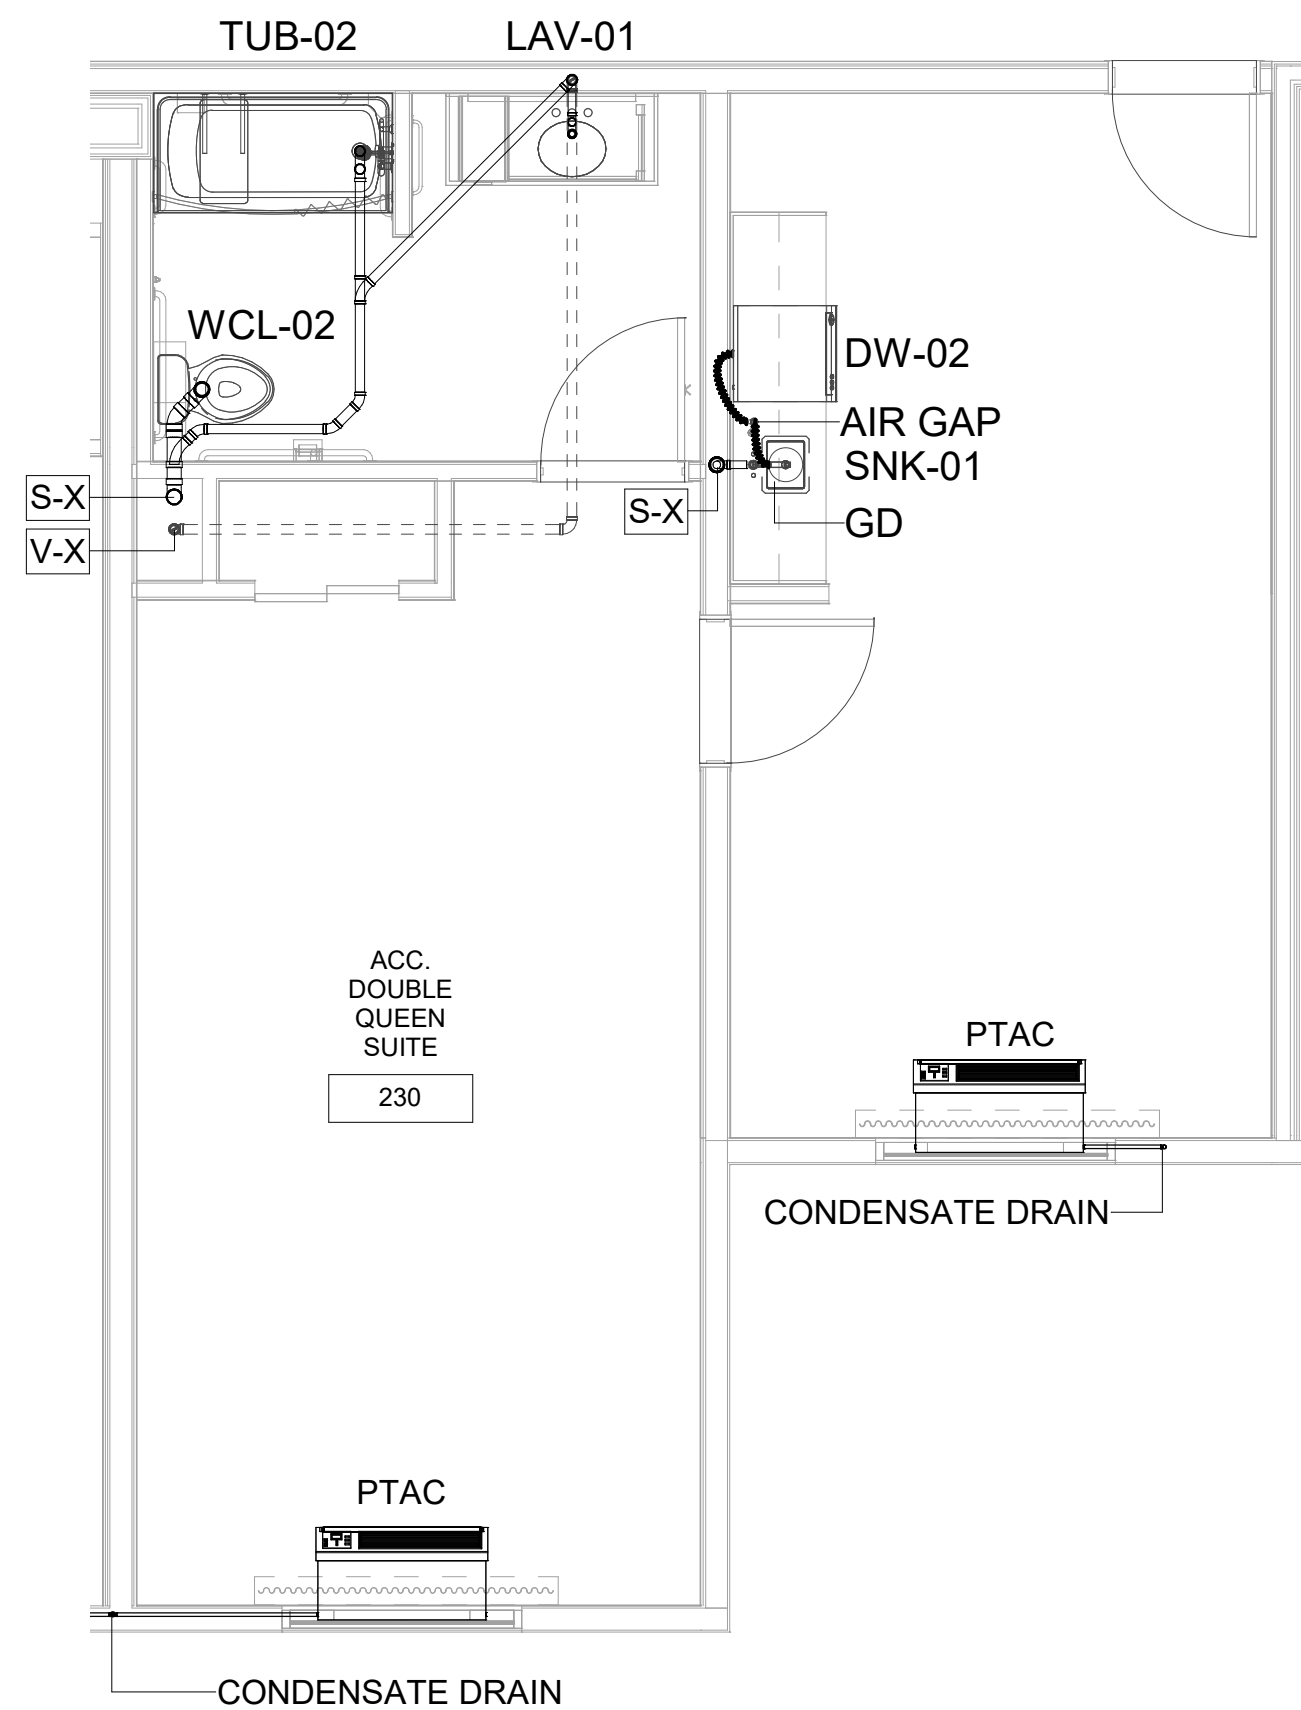

⑤ ACCESSIBLE DOUBLE QUEEN SUITE SANITARY AND VENT PLAN
1/4" = 1'-0"

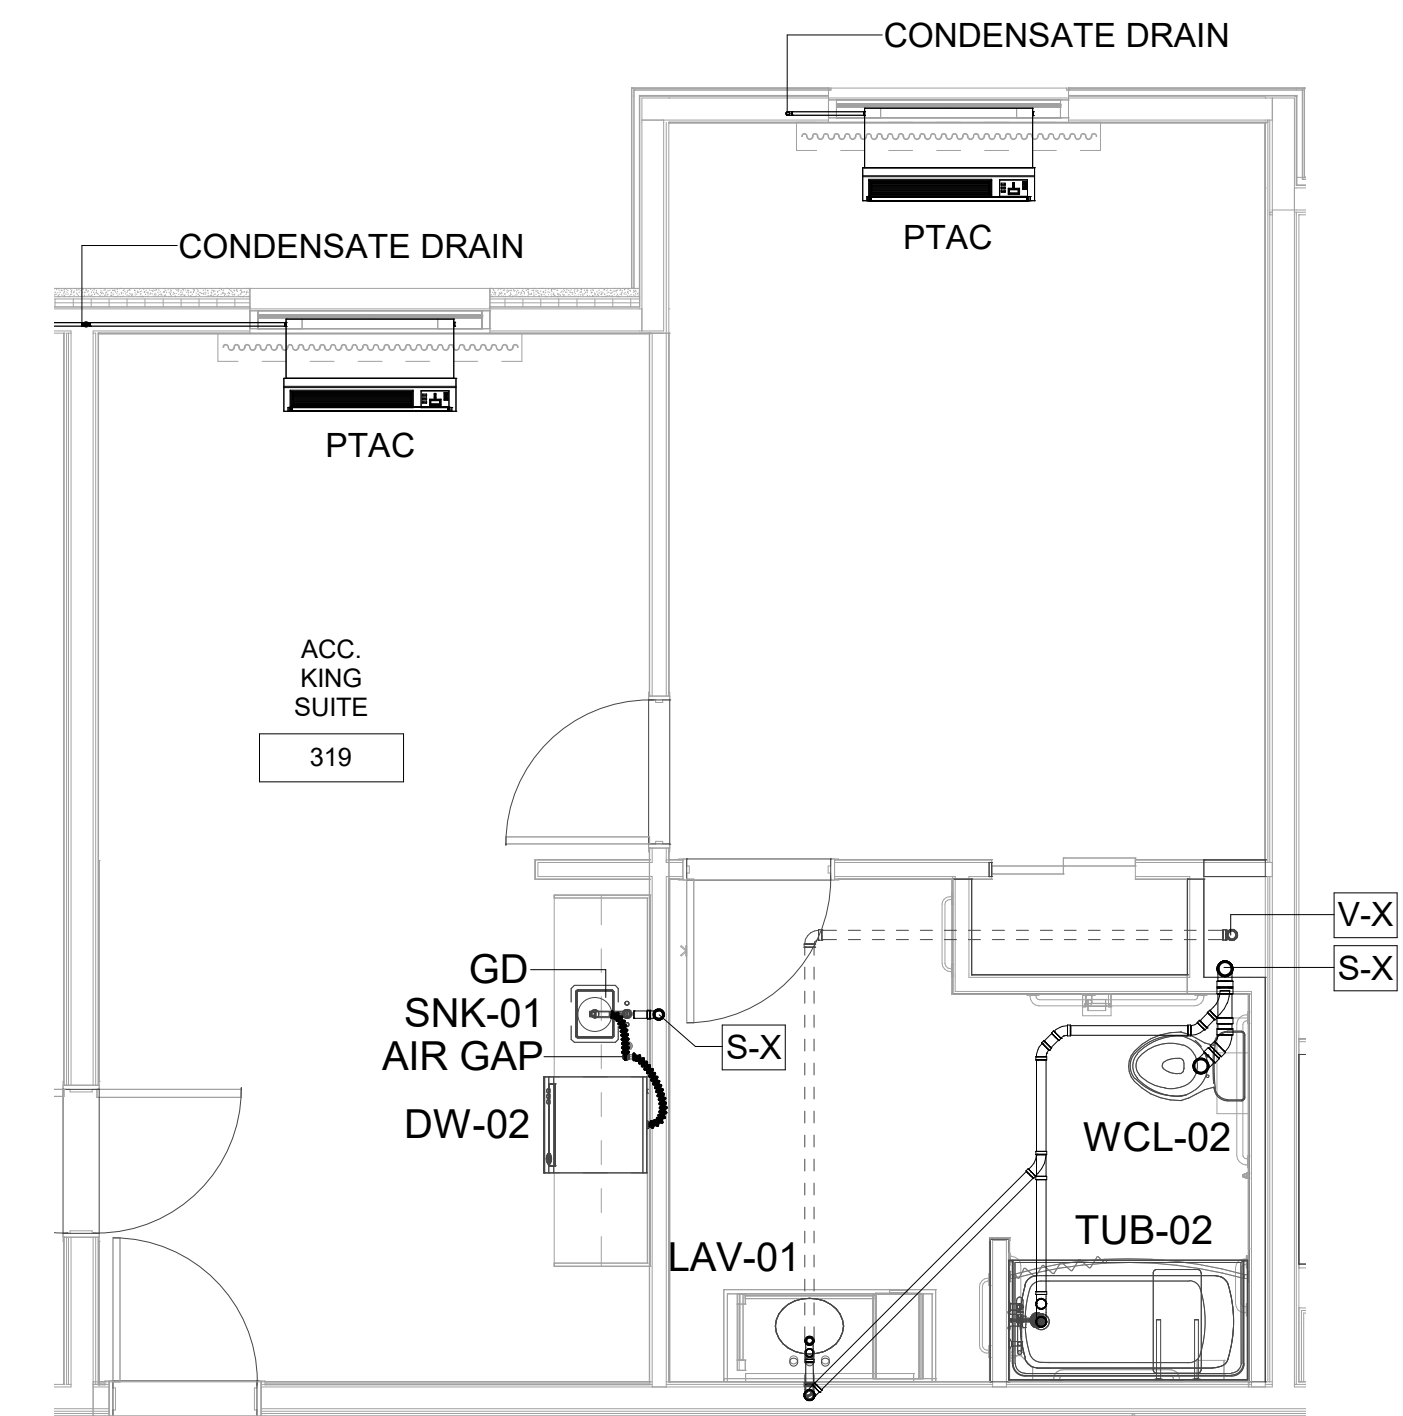

⑥ ACCESSIBLE KING SUITE SANITARY AND VENT PLAN
1/4" = 1'-0"

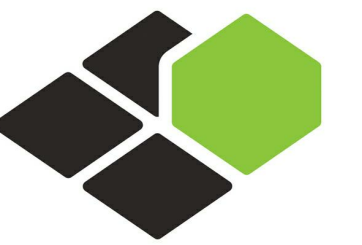


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SHEET NAME


UNIT SANITARY &
VENT PLAN-A

DRAWINGS NO.


P-302A

B-20-0180
City of Puyallup

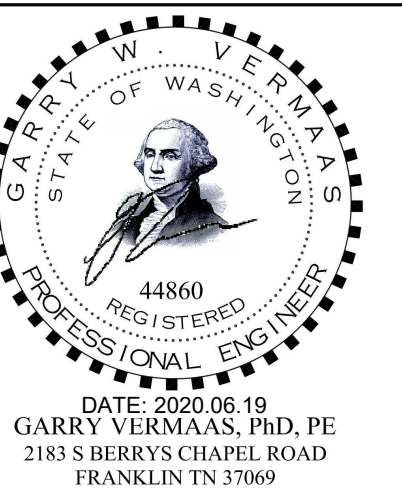
SEWER LOAD DEMAND		
FIXTURE	DFU	
BATHROOM GROUP	5.0	
SNK / DW	2.0	

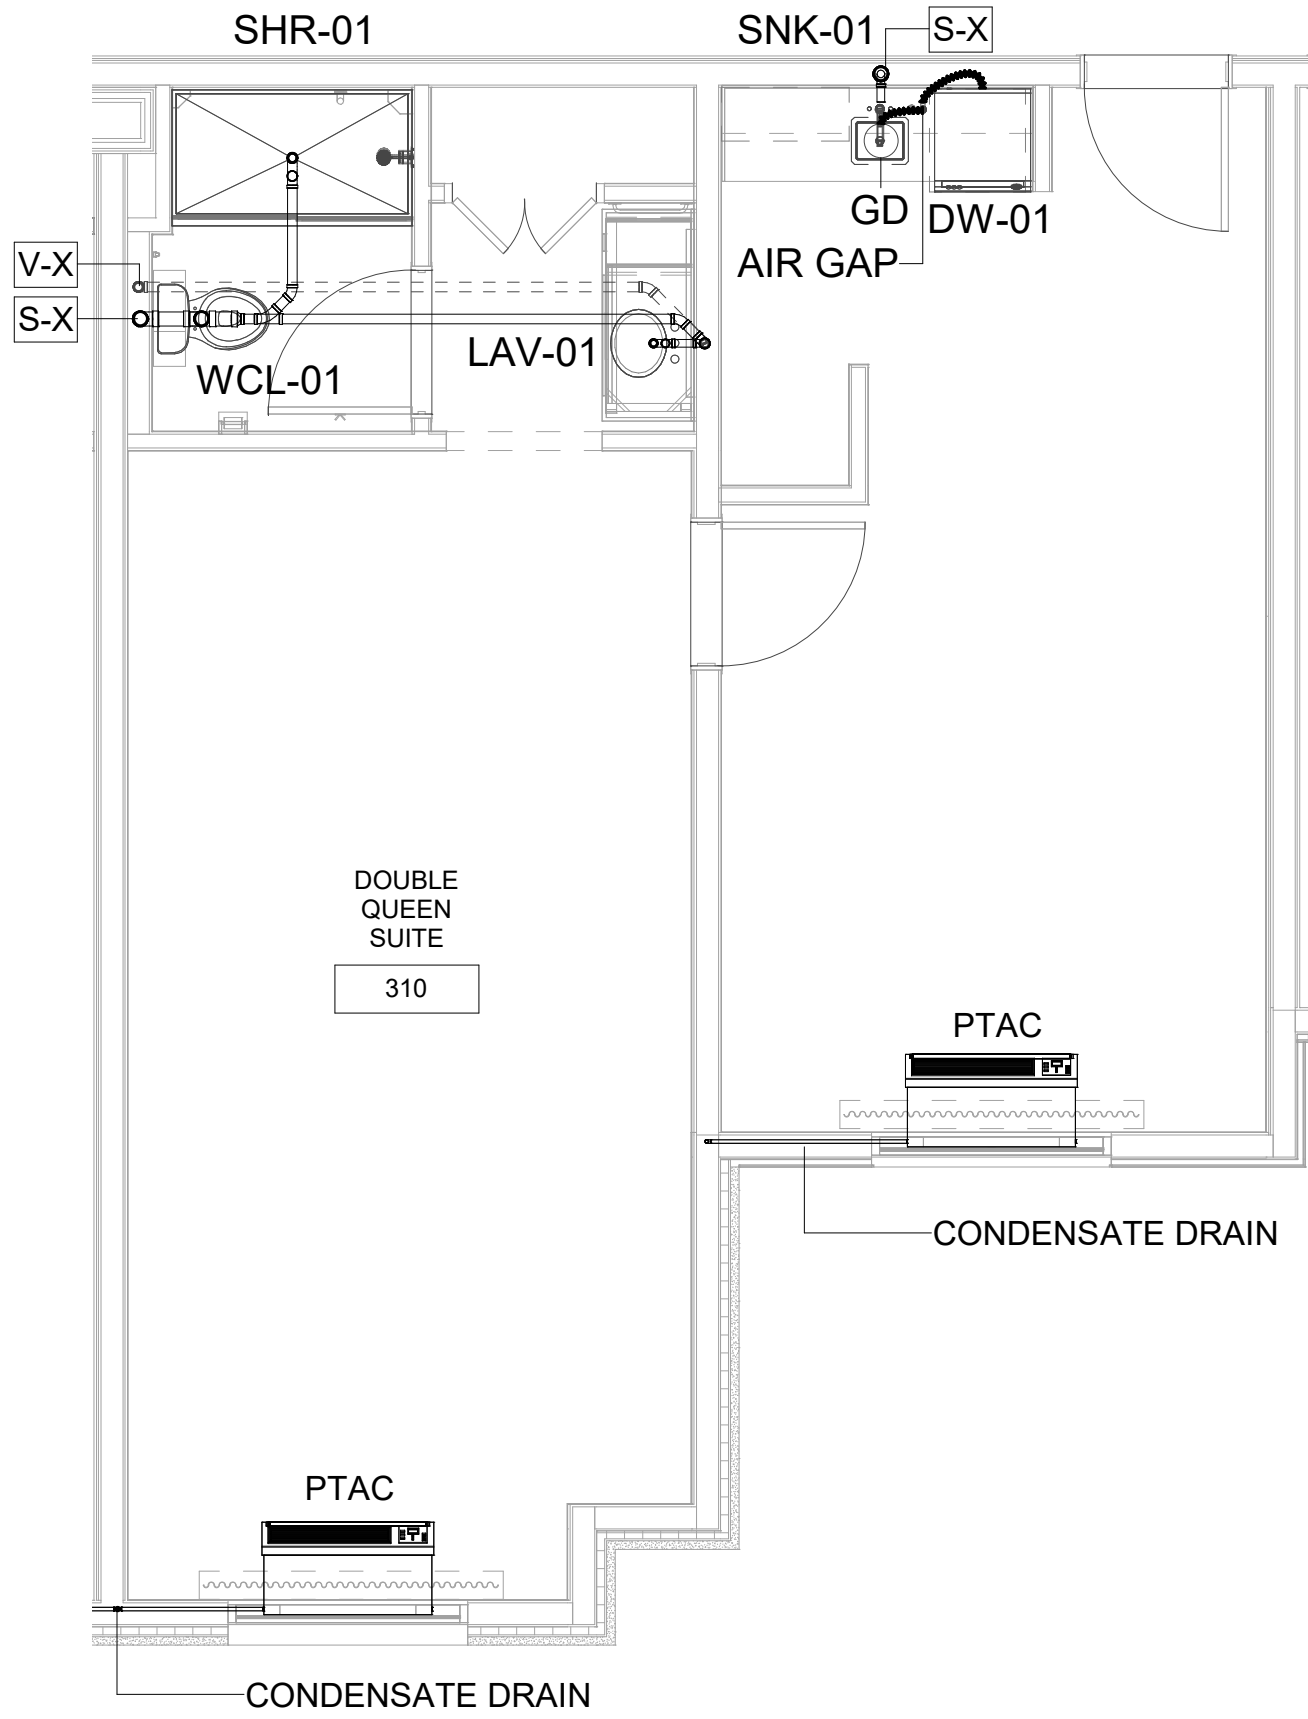


7 DOUBLE QUEEN SUITE SANITARY AND VENT PLAN
1/4" = 1'-0"

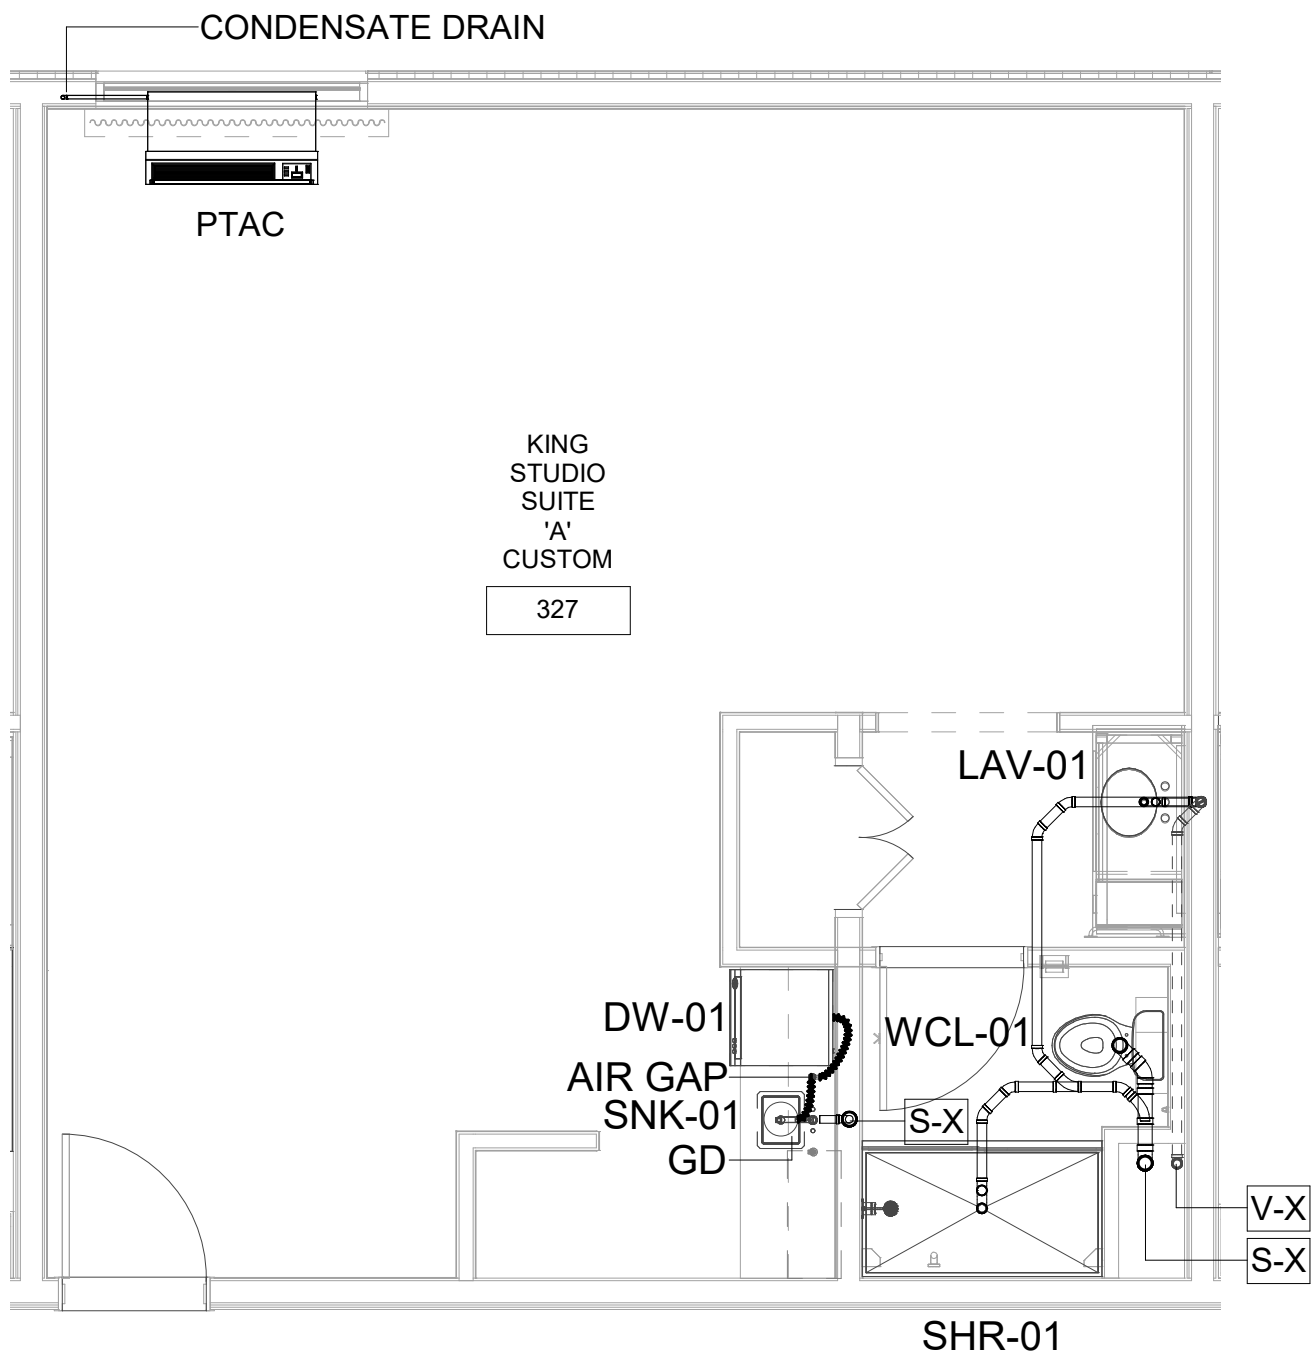


8 KING STUDIO 'A' CUSTOM SANITARY AND VENT PLAN
1/4" = 1'-0"

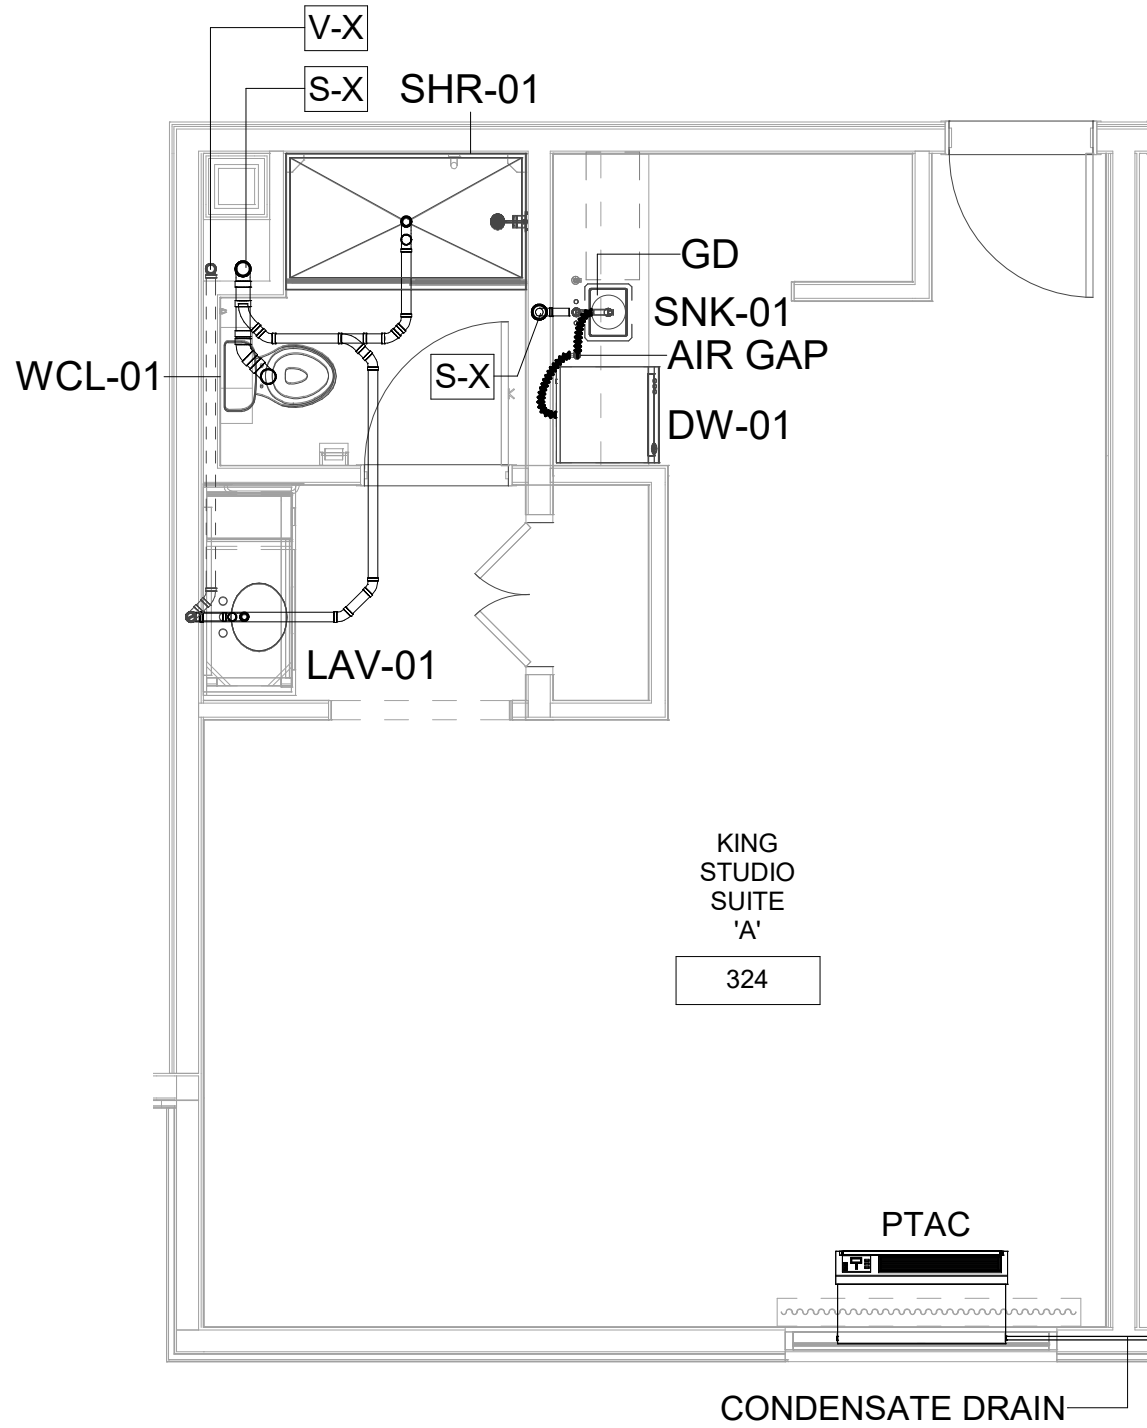

9 KING STUDIO 'A' SANITARY AND VENT PLAN
1/4" = 1'-0"

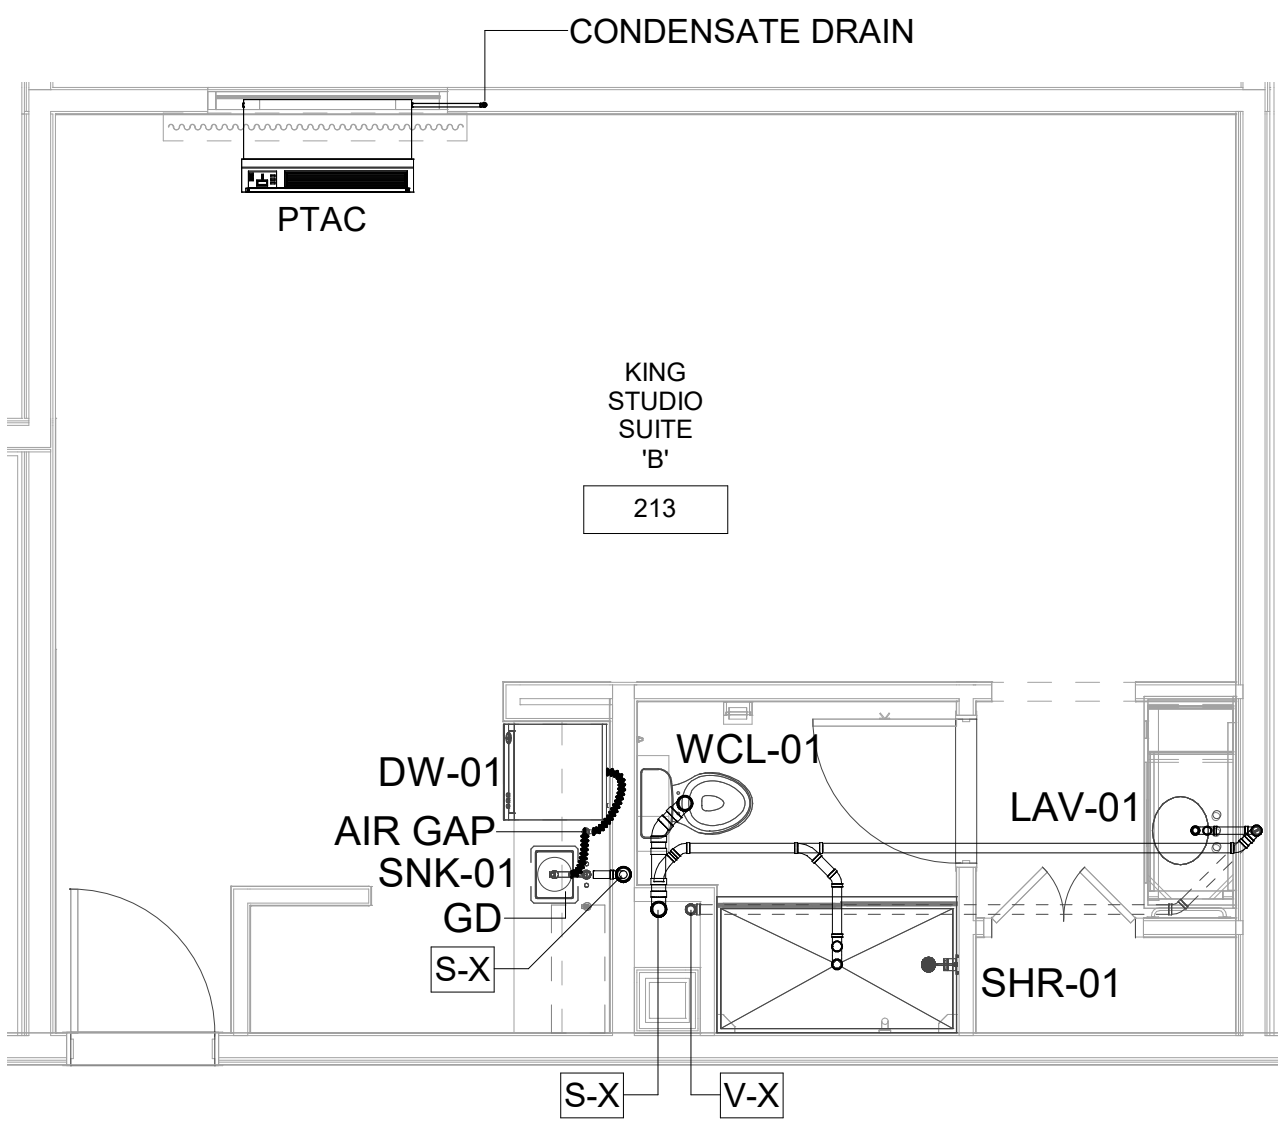


10 KING STUDIO 'B' SANITARY AND VENT PLAN
1/4" = 1'-0"

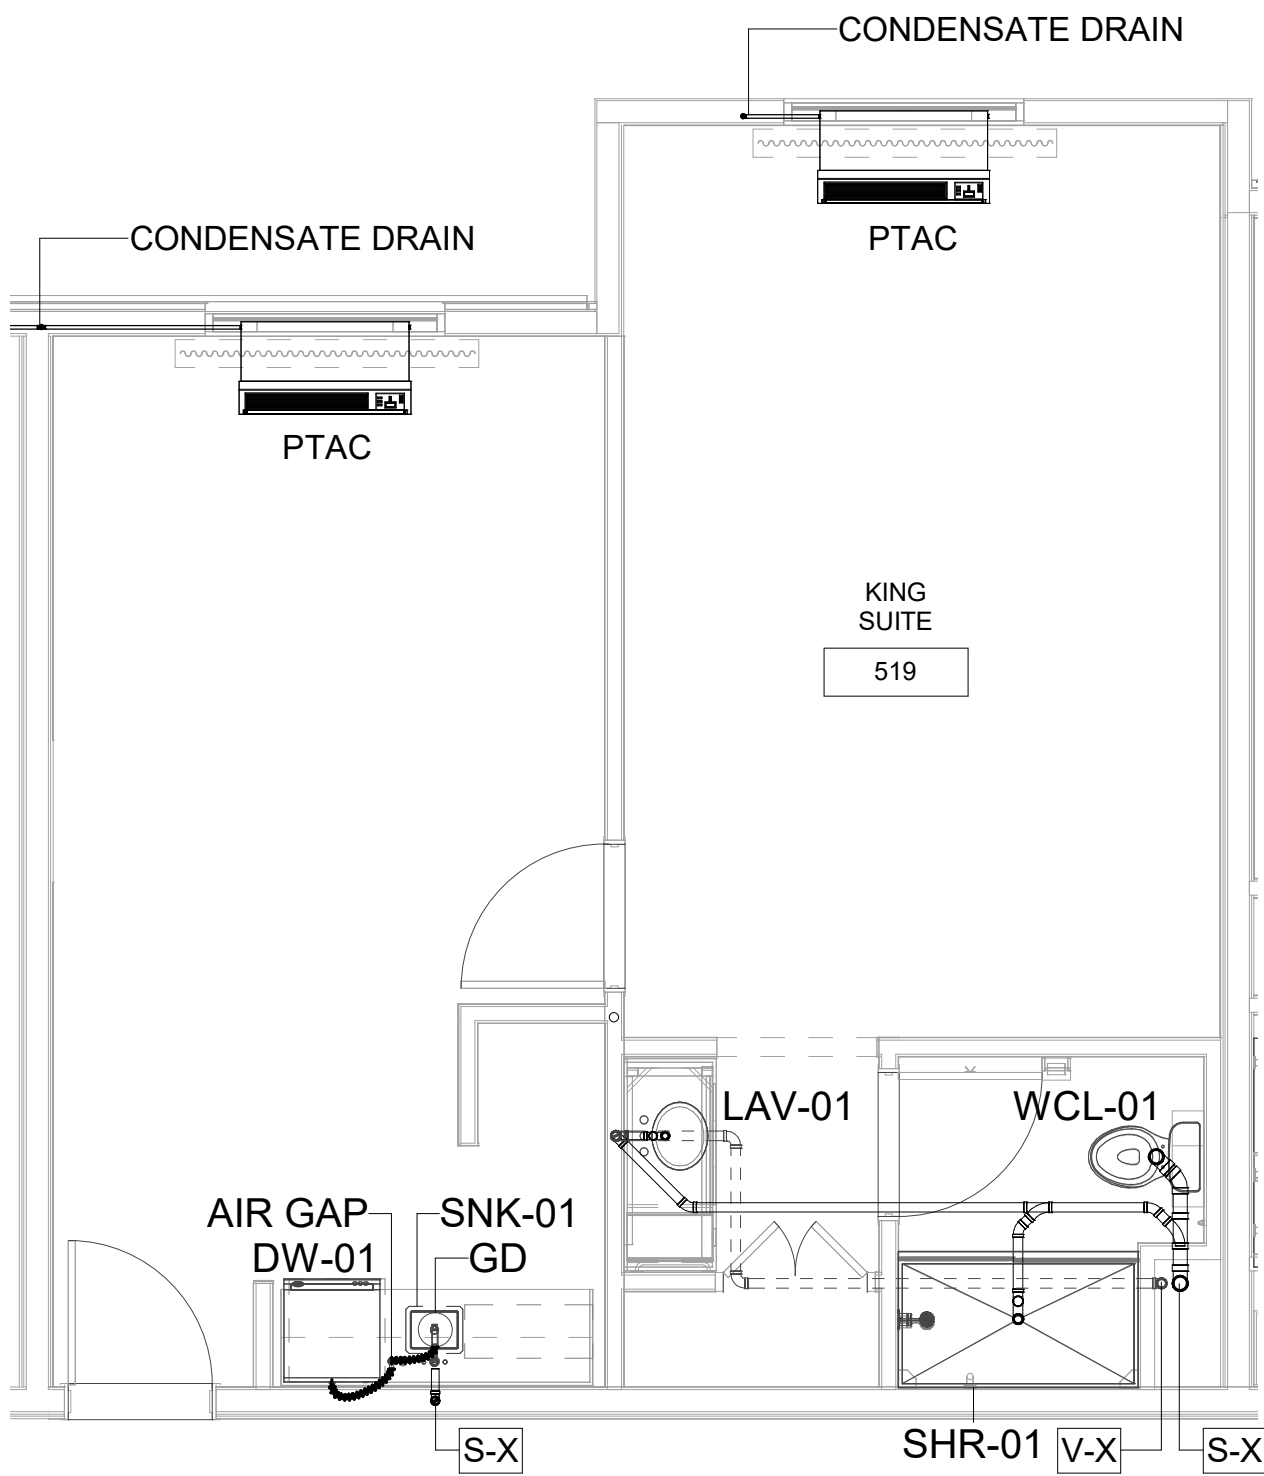

11 KING SUITE SANITARY AND VENT PLAN
1/4" = 1'-0"

NOT IN USE

B-20-0180
City of Puyallup

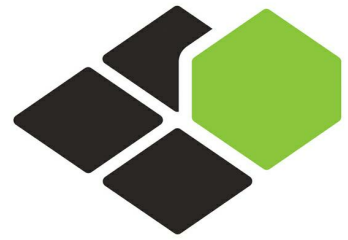


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Seal:



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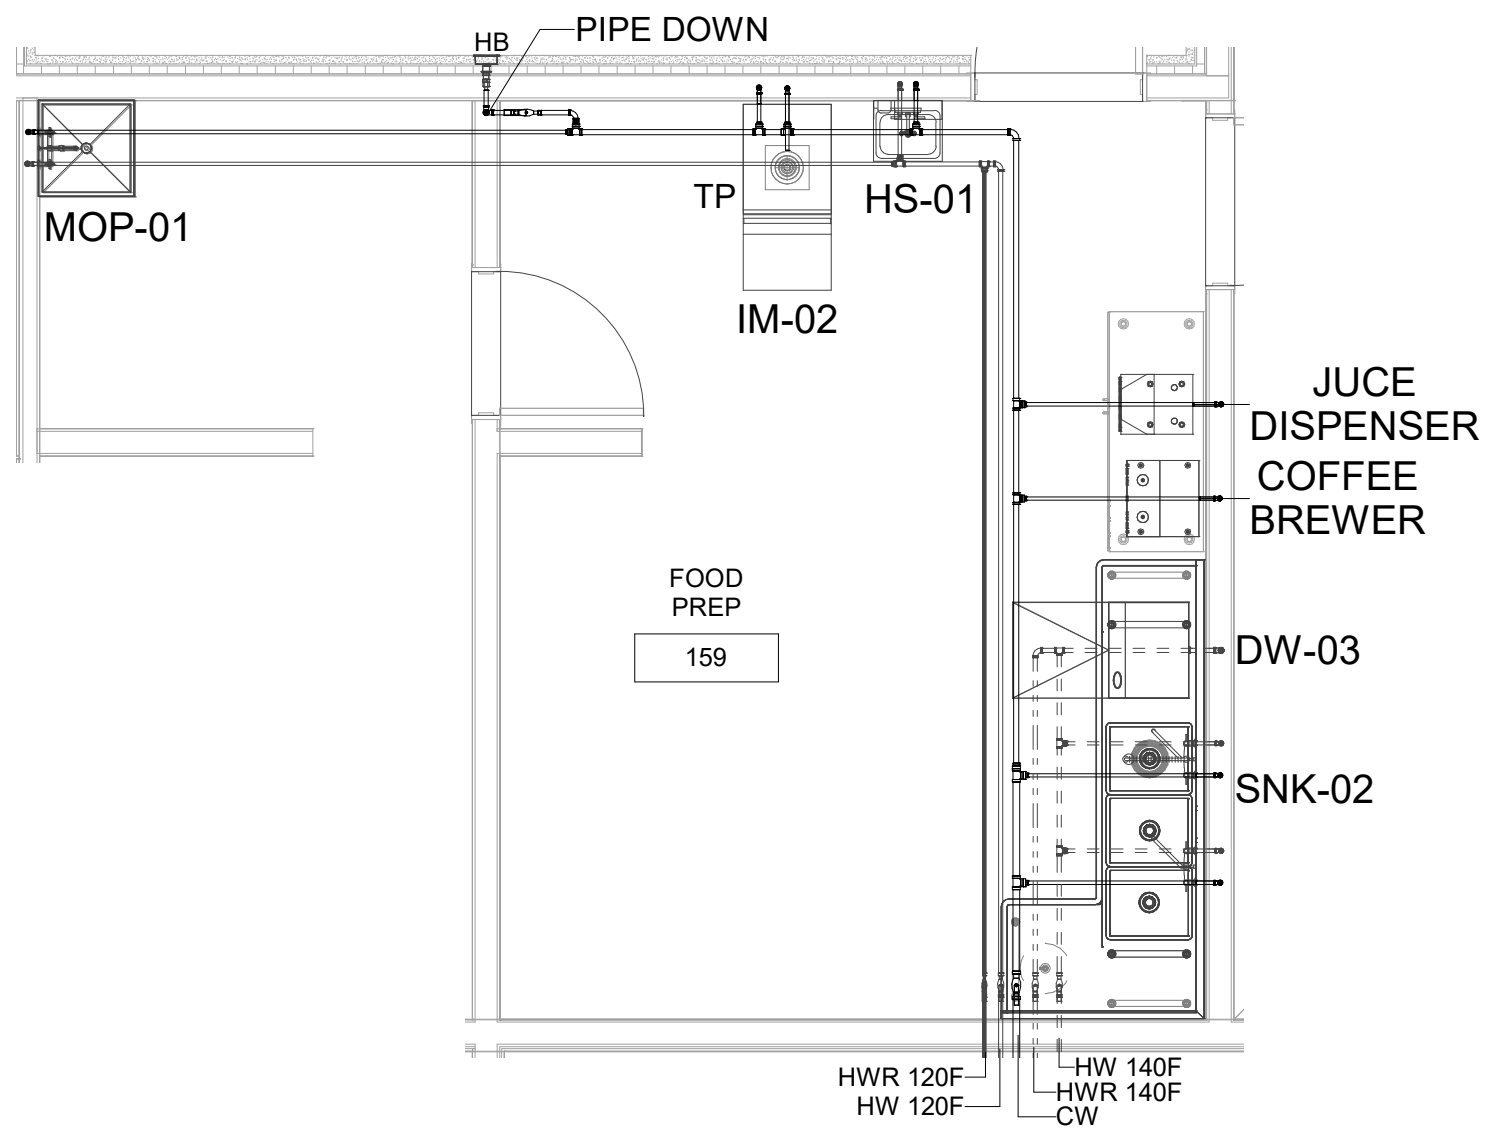
PROJECT NO.
B4-124-1803

SHEET NAME


UNIT SANITARY &
VENT PLAN-B

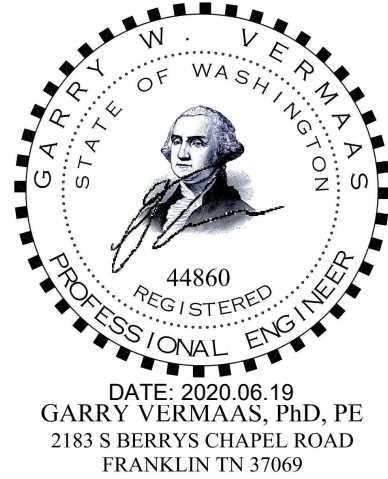DRAWINGS NO.


P-302B




12 FOOD PREP AREA WATER SUPPLY PLAN
1/4" = 1'-0"

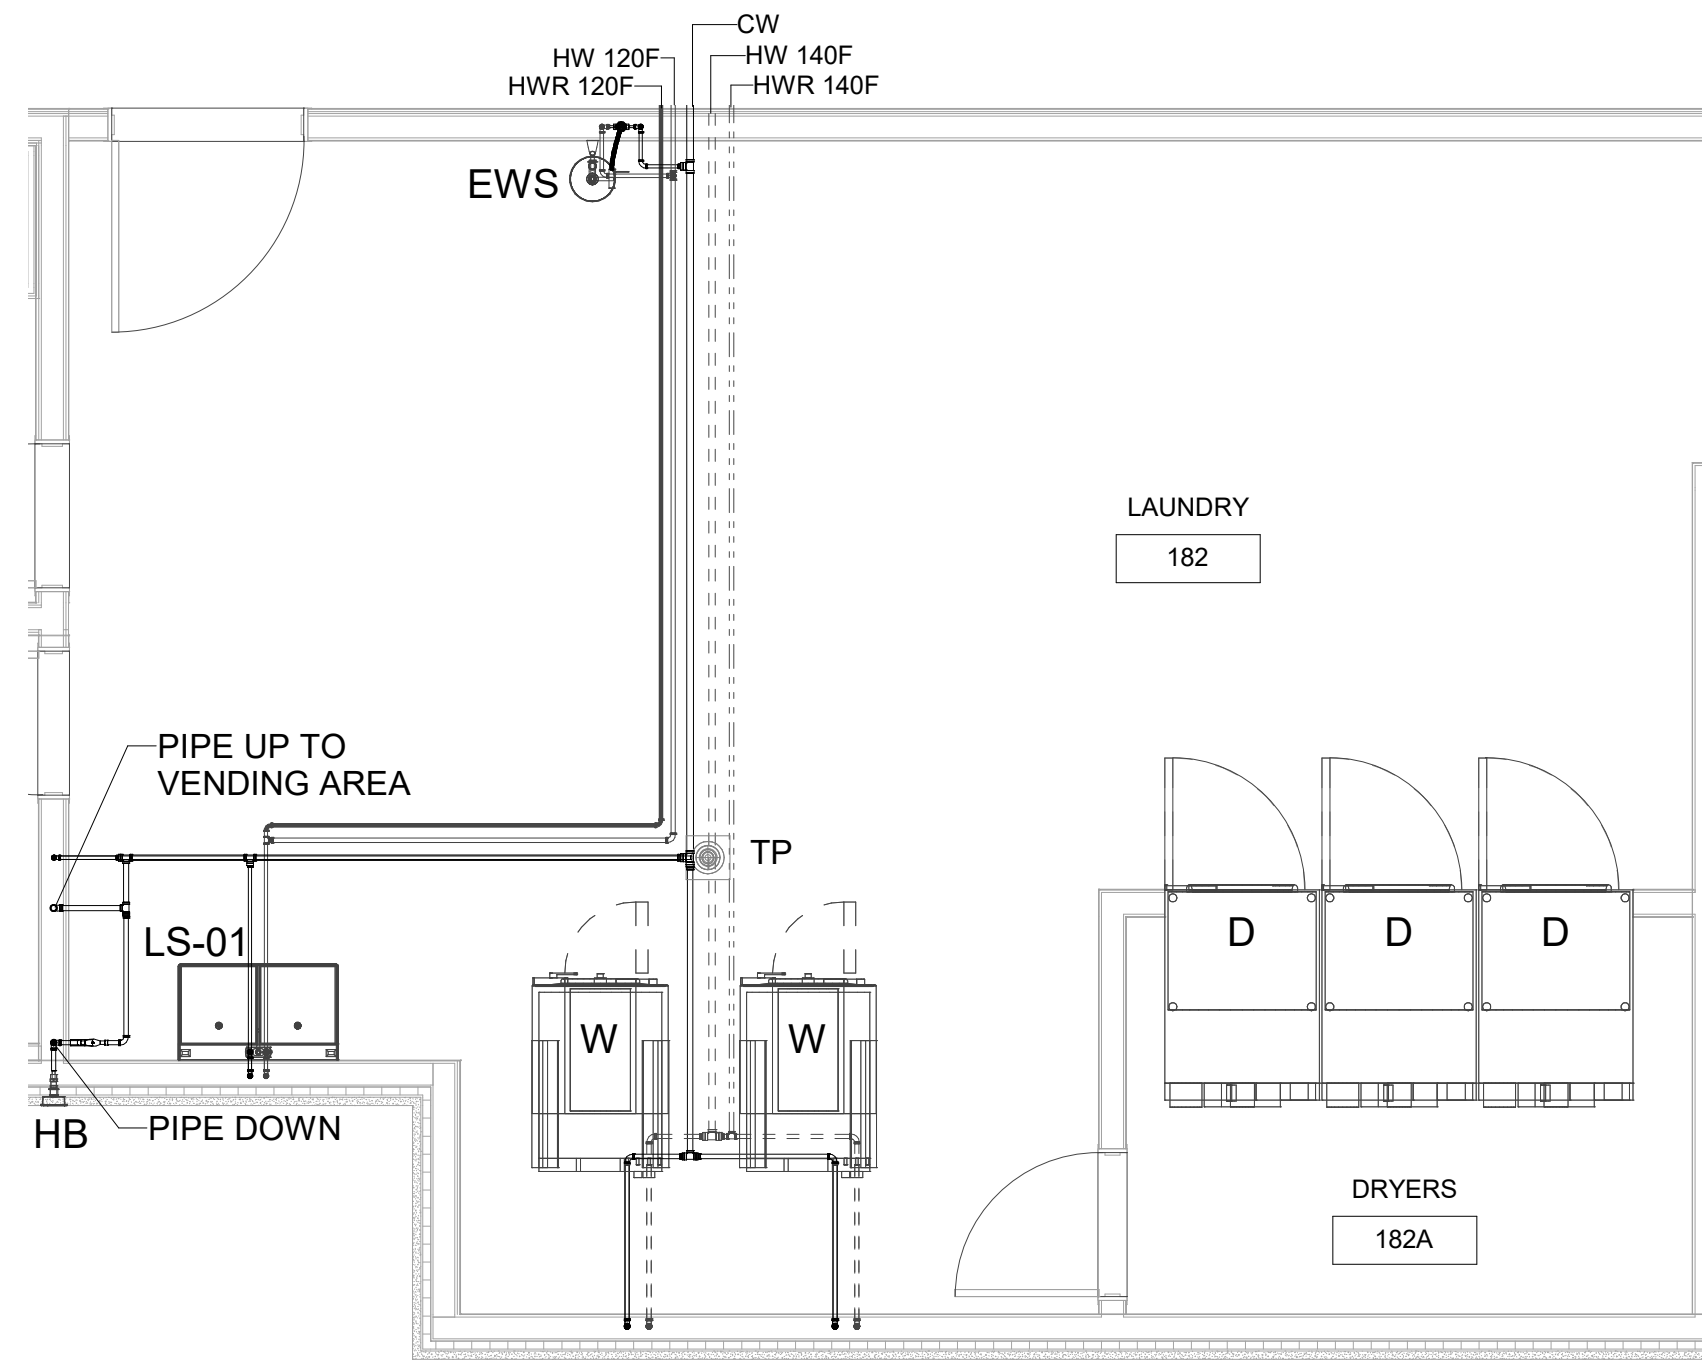


13 LAUNDRY AREA WATER SUPPLY PLAN
1/4" = 1'-0"

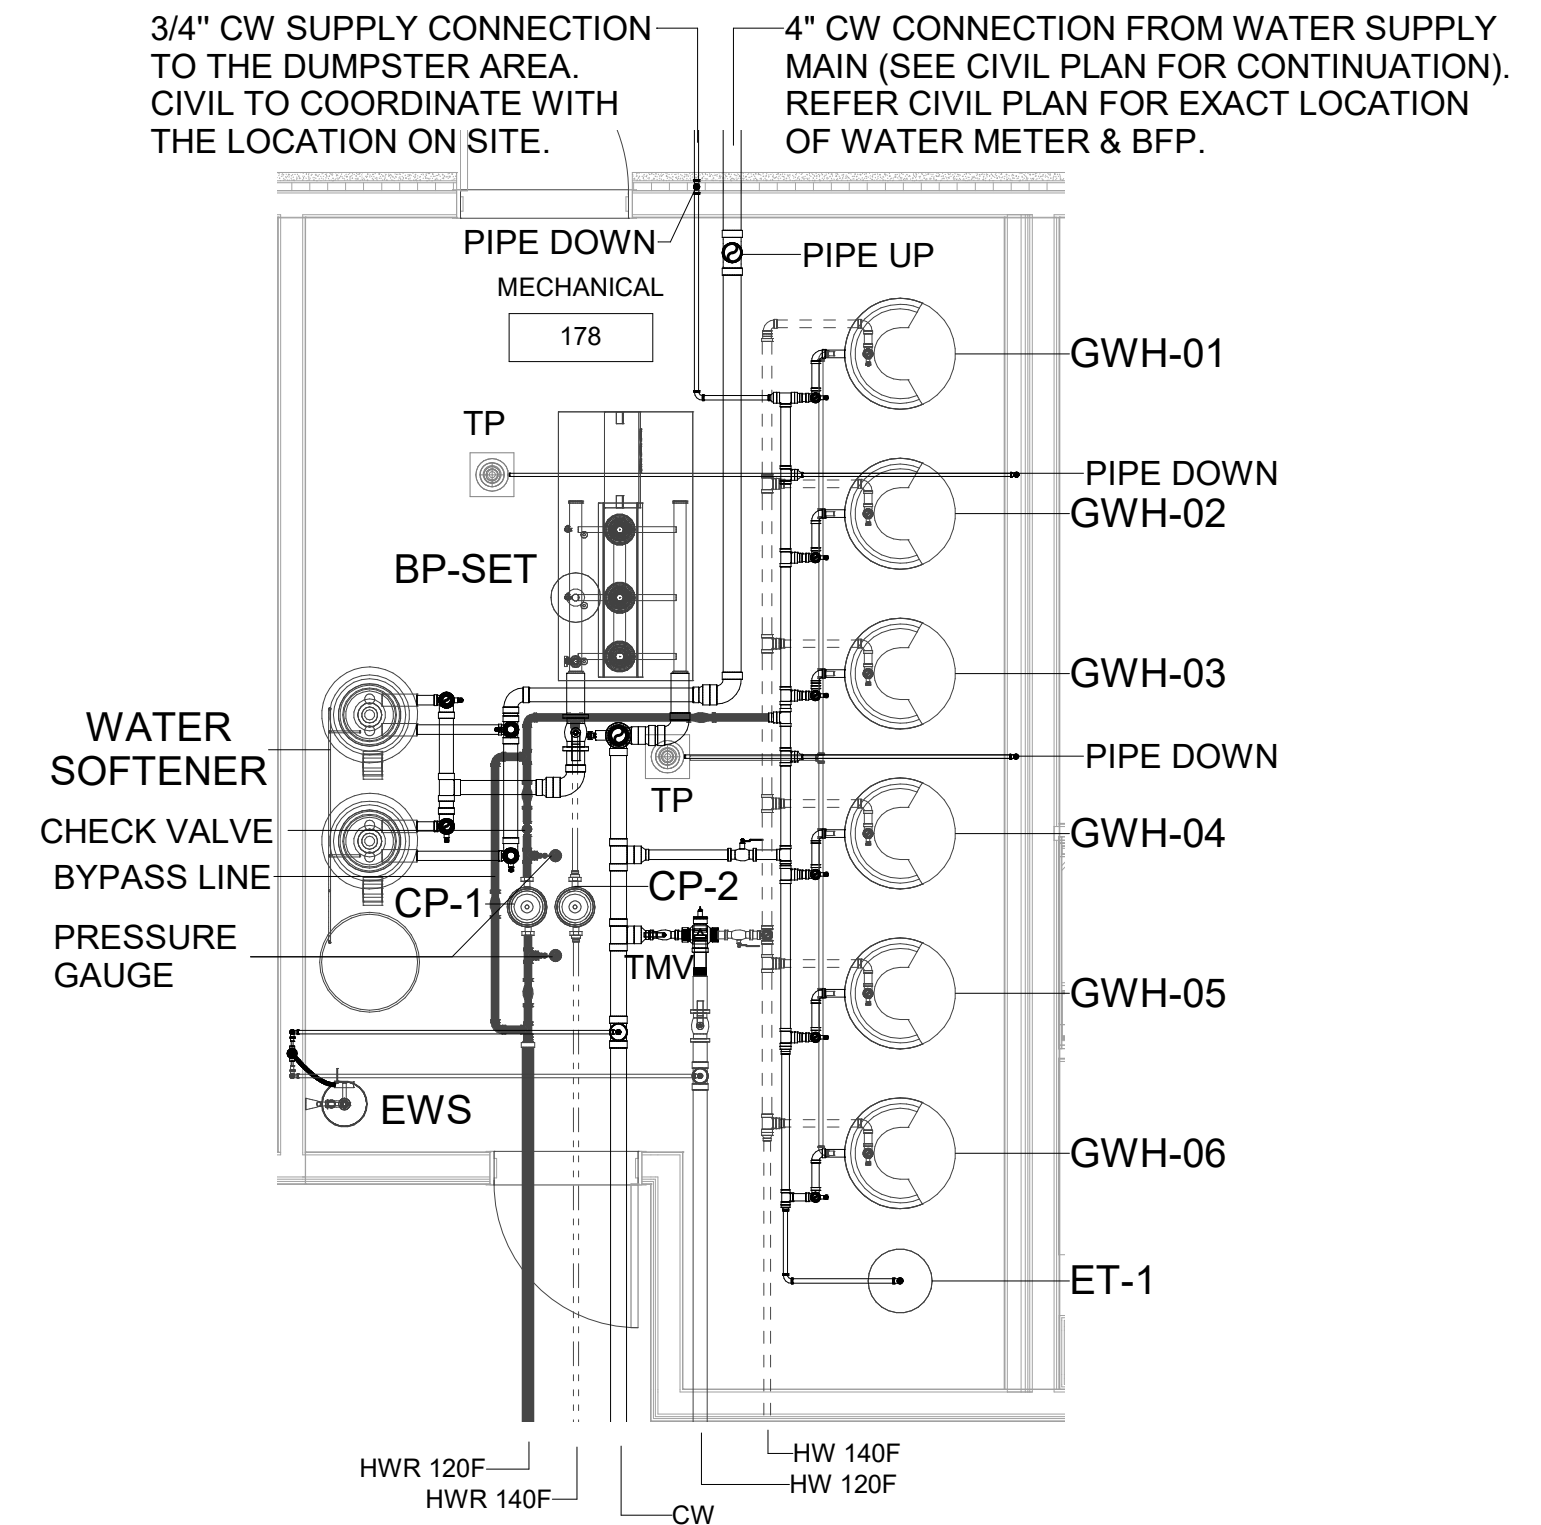

14 MECHANICAL ROOM WATER SUPPLY PLAN
1/4" = 1'-0"

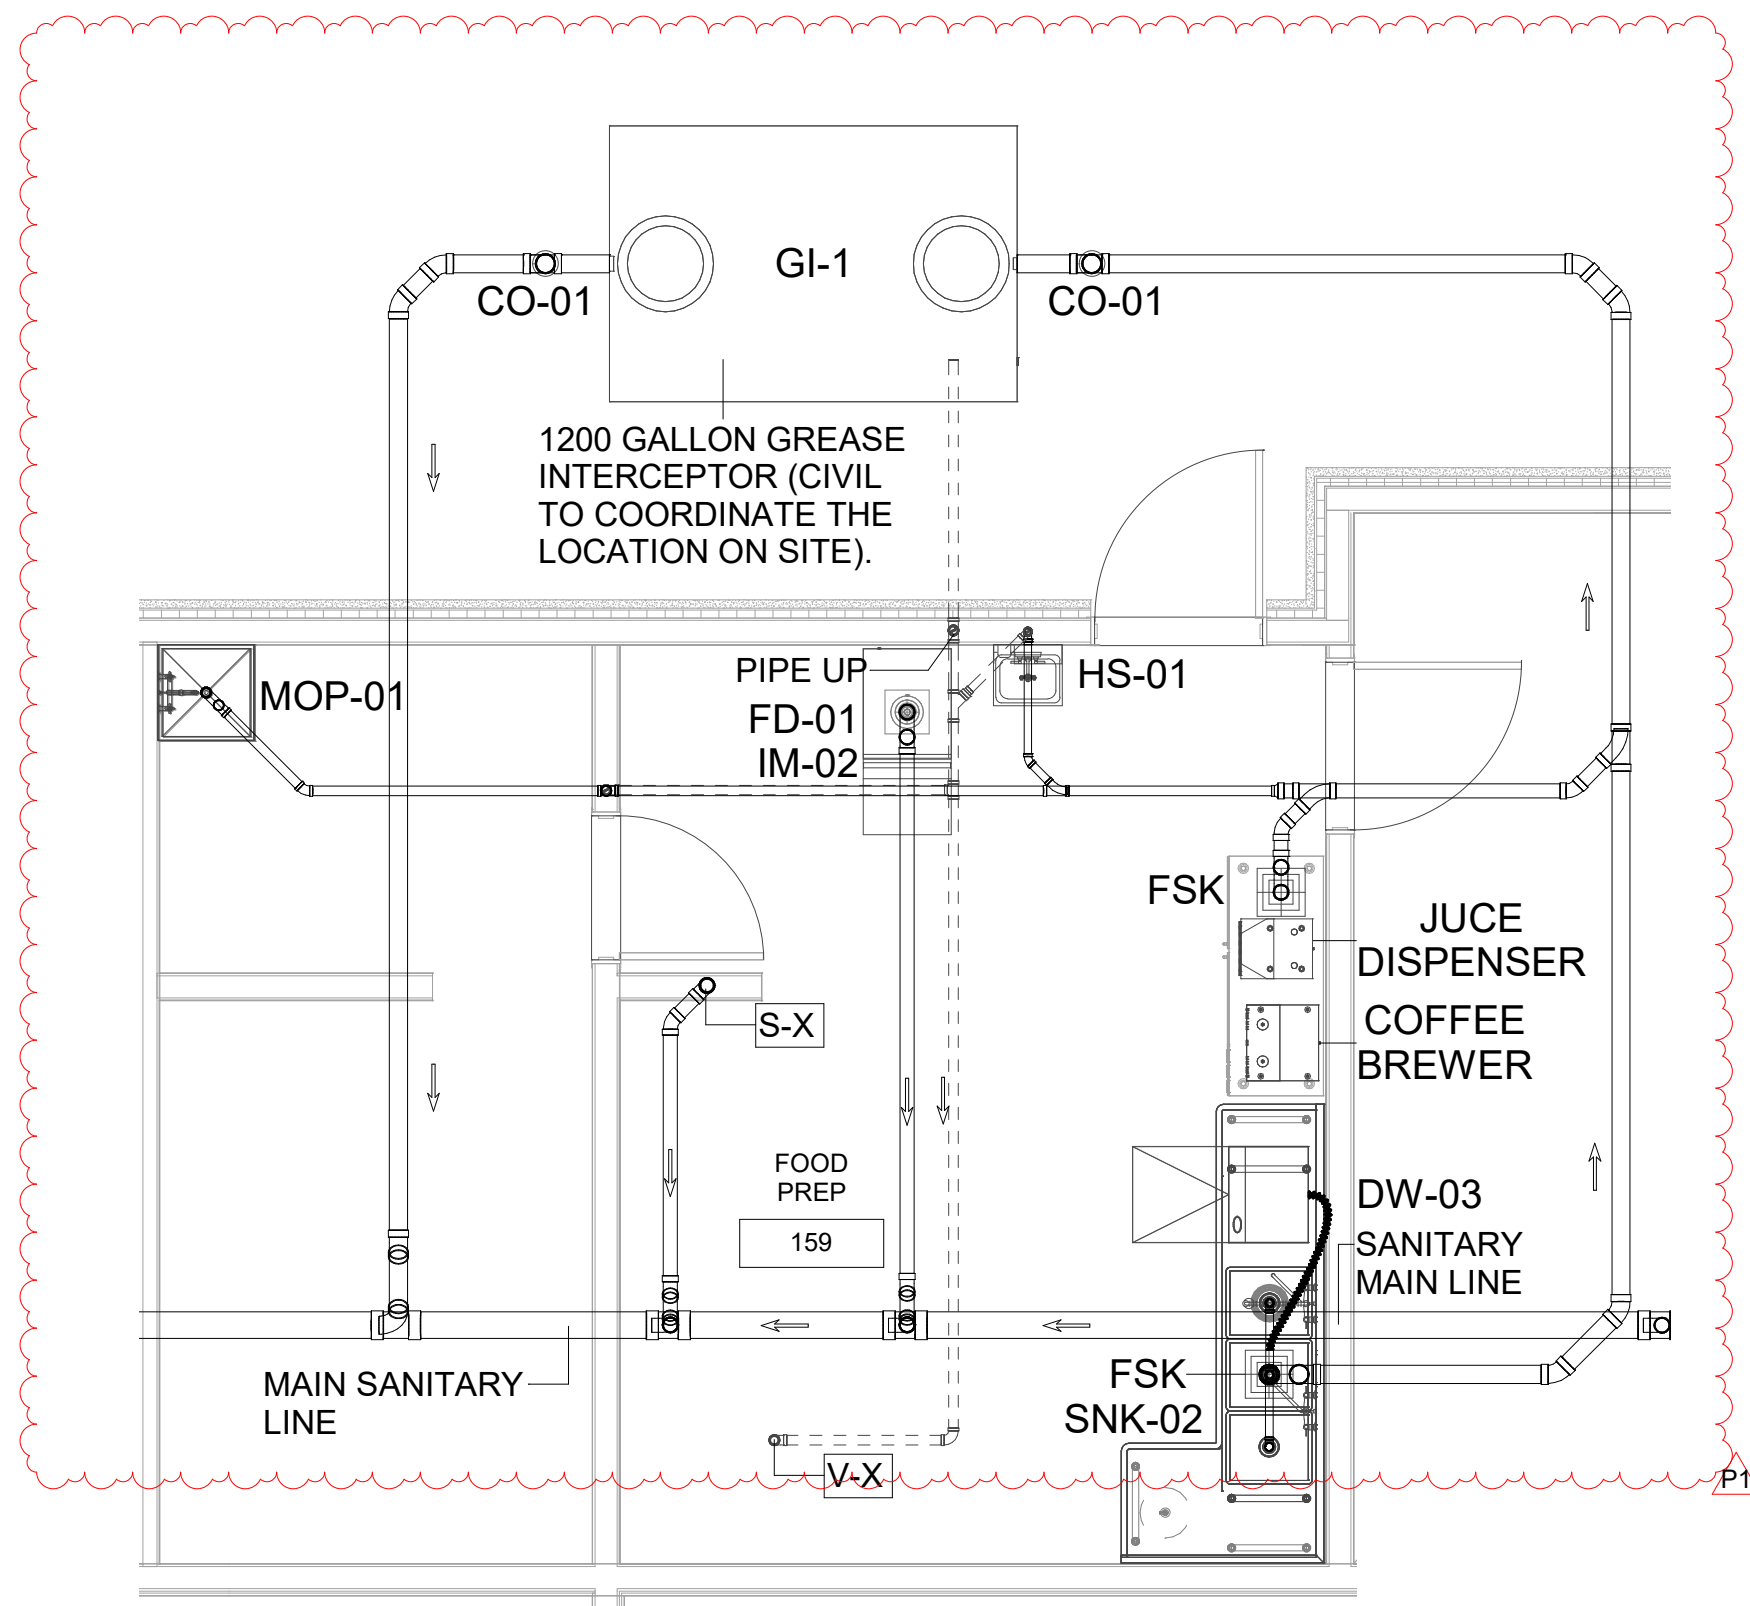


12 FOOD PREP AREA SANITARY & VENT PLAN
1/4" = 1'-0"

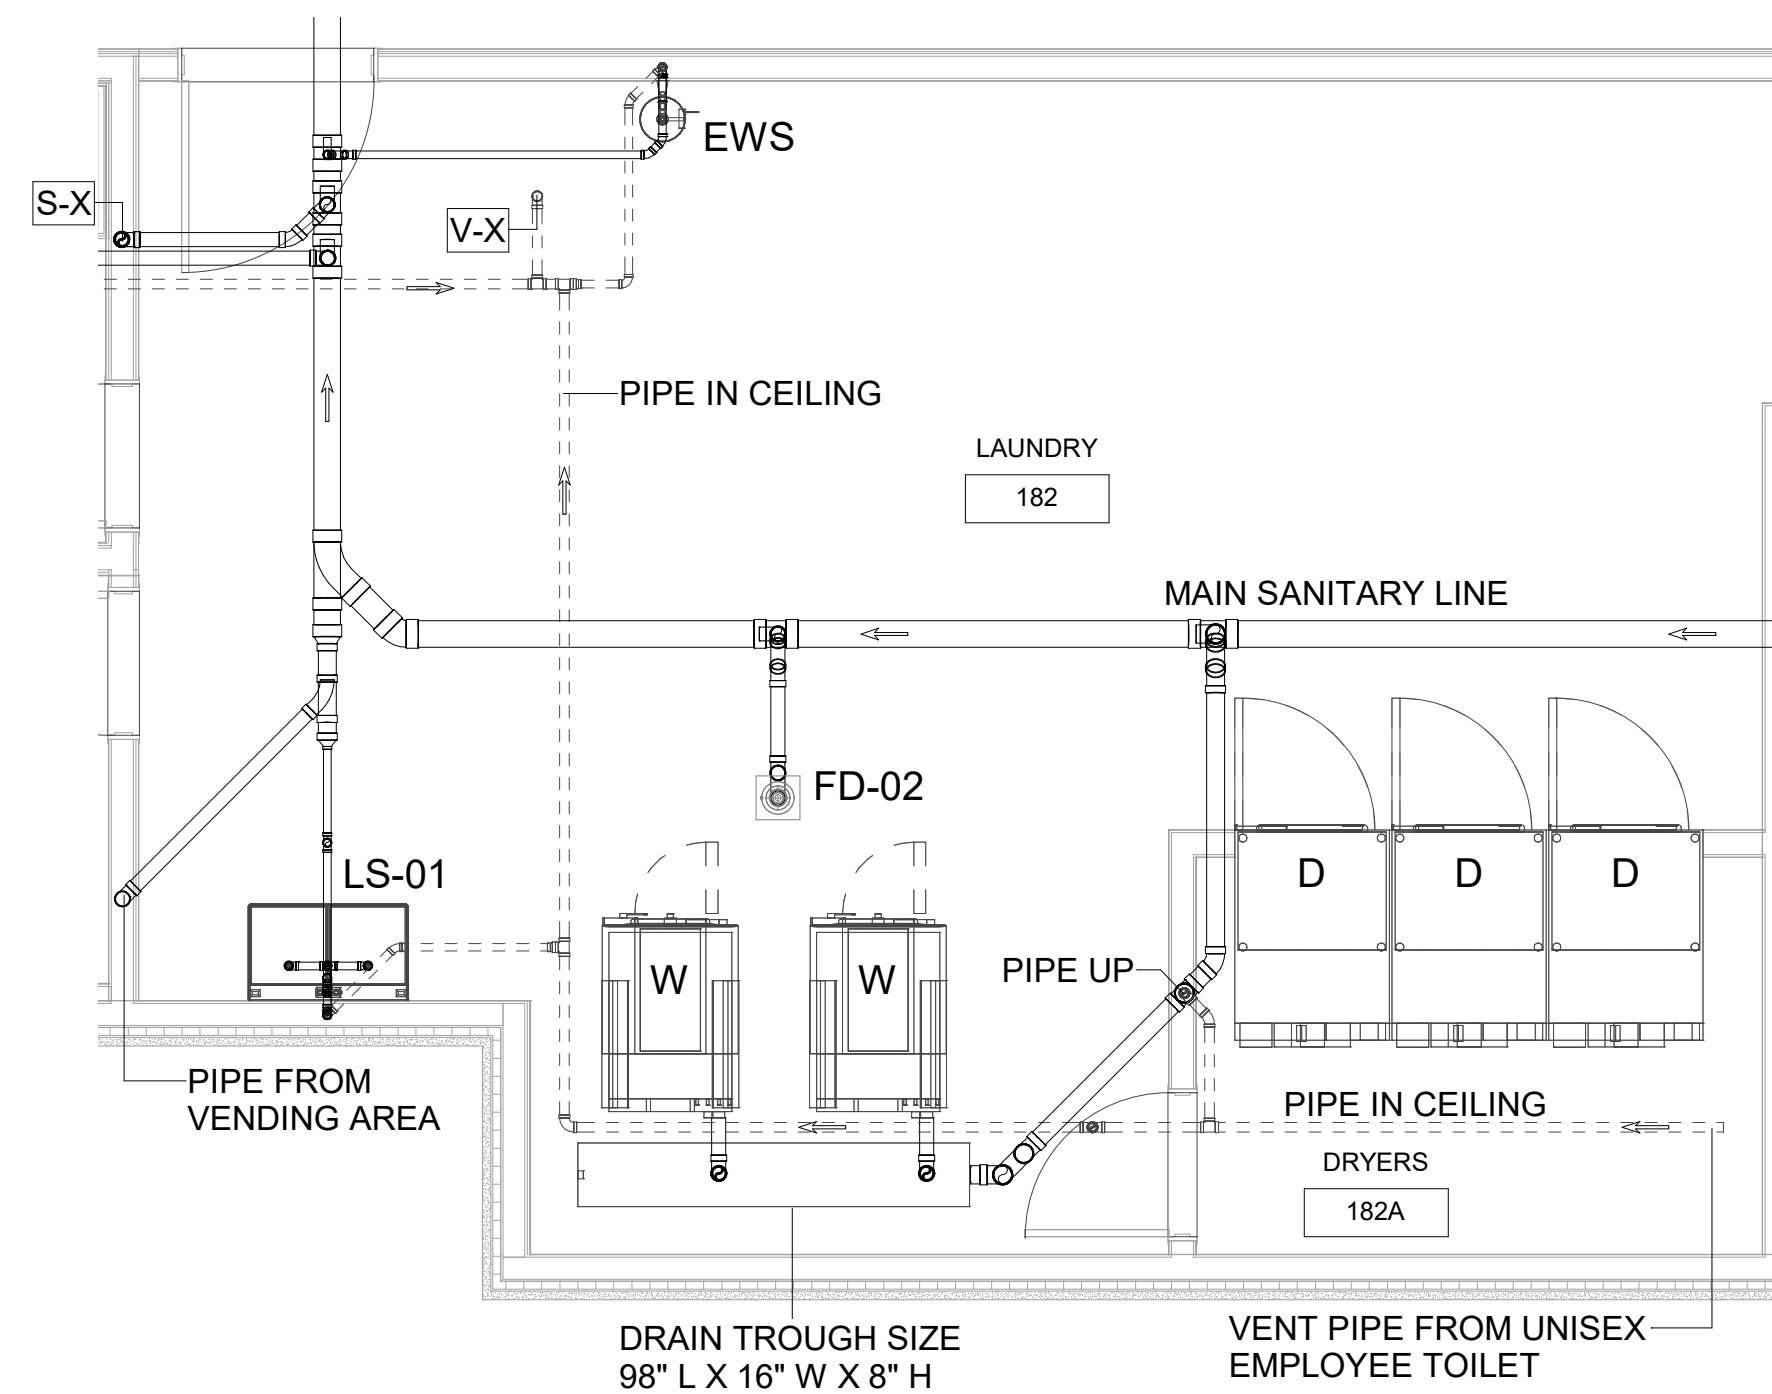

13 LAUNDRY AREA SANITARY & VENT PLAN
1/4" = 1'-0"

NOT IN USE

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Seal:

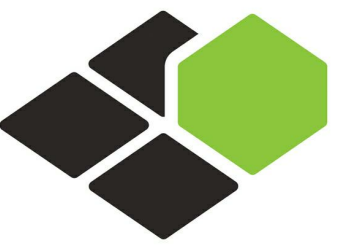

Owner:



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CURRENT ISSUE DATE
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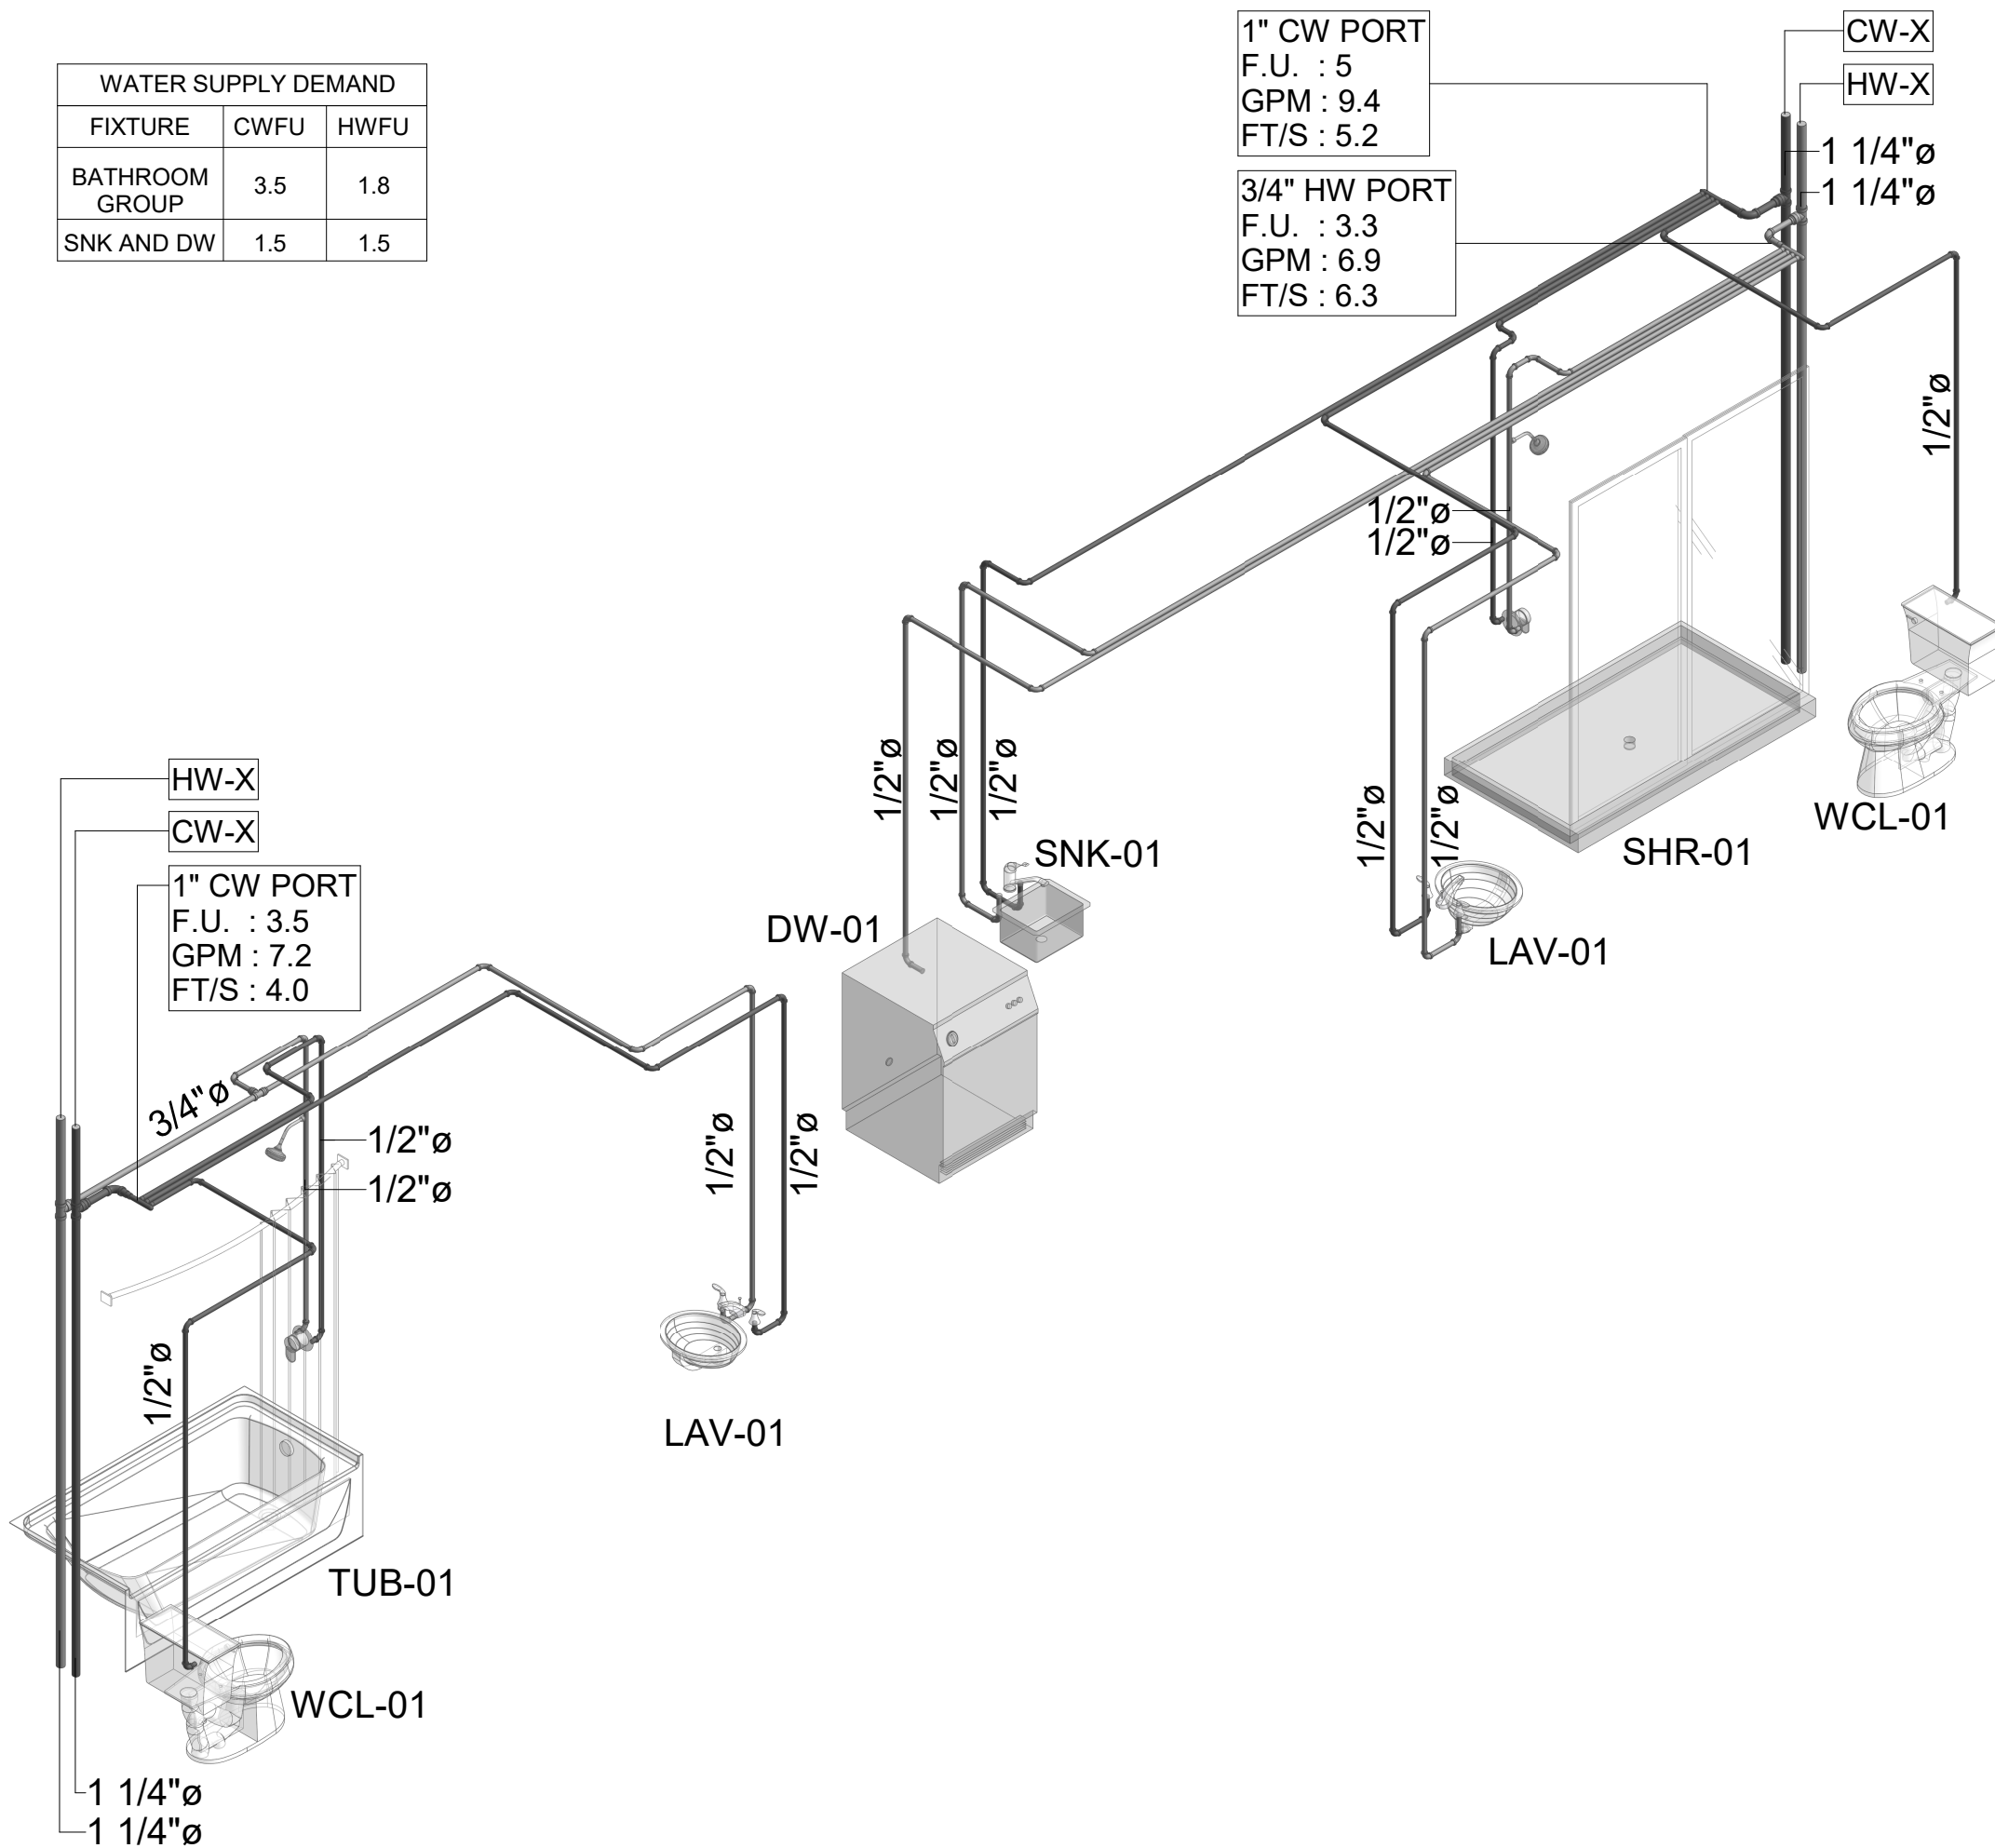
SHEET NAME

UNIT WATER
SUPPLY &
SANITARY PLAN


DRAWINGS NO.

P-303


WATER SUPPLY DEMAND		
FIXTURE	CW/FU	HW/FU
BATHROOM GROUP	3.5	1.8
SNK AND DW	1.5	1.5




1 2 BEDROOM SUITE WATER SUPPLY RISER DIAGRAM

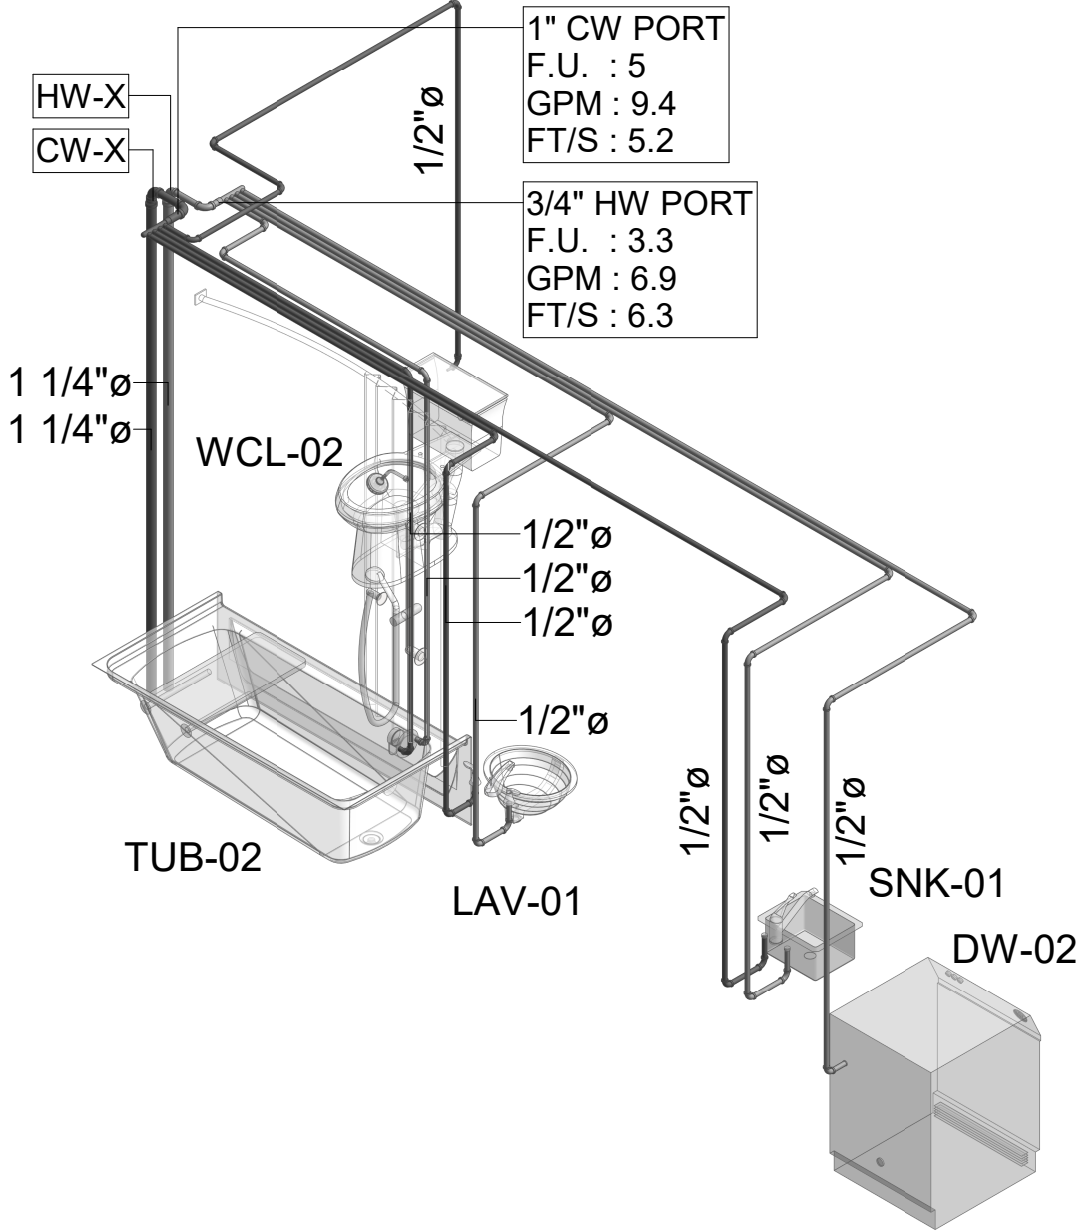


2 ACCESSIBLE 2 BEDROOM SUITE WATER SUPPLY RISER DIAGRAM

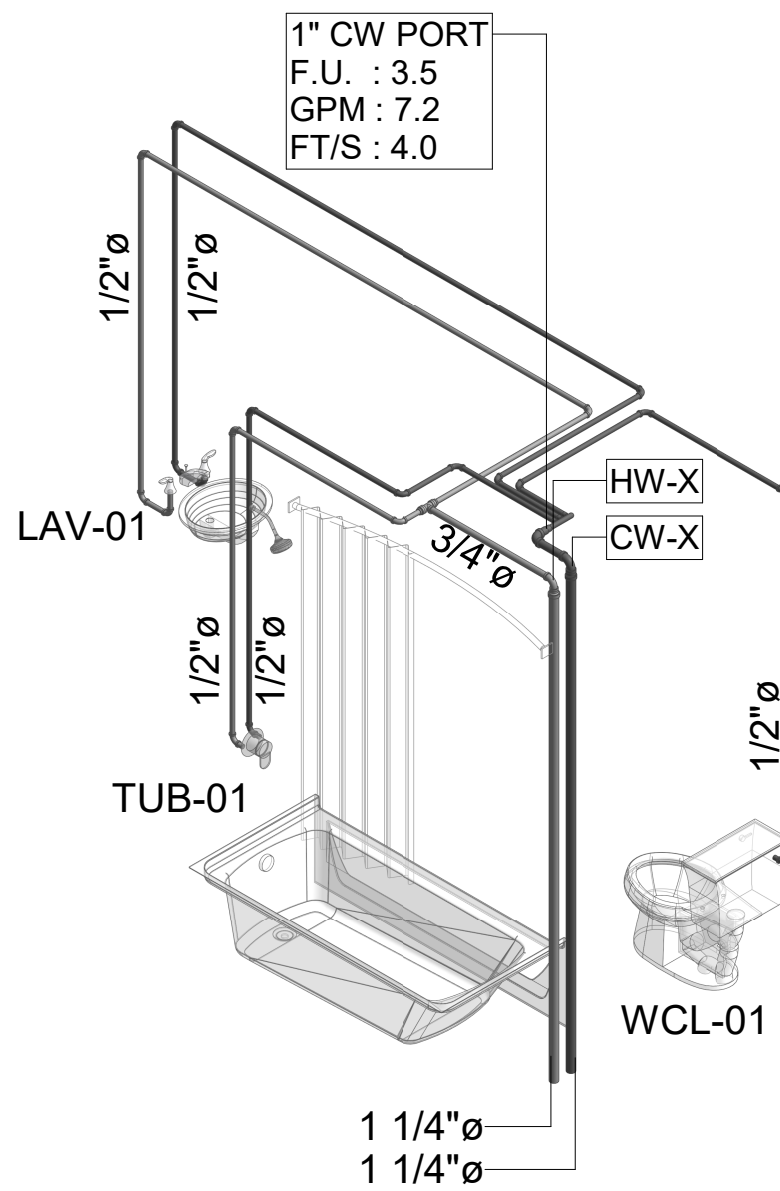


3 ACCESSIBLE DOUBLE QUEEN SUITE W/RIS WATER SUPPLY RISER DIAGRAM

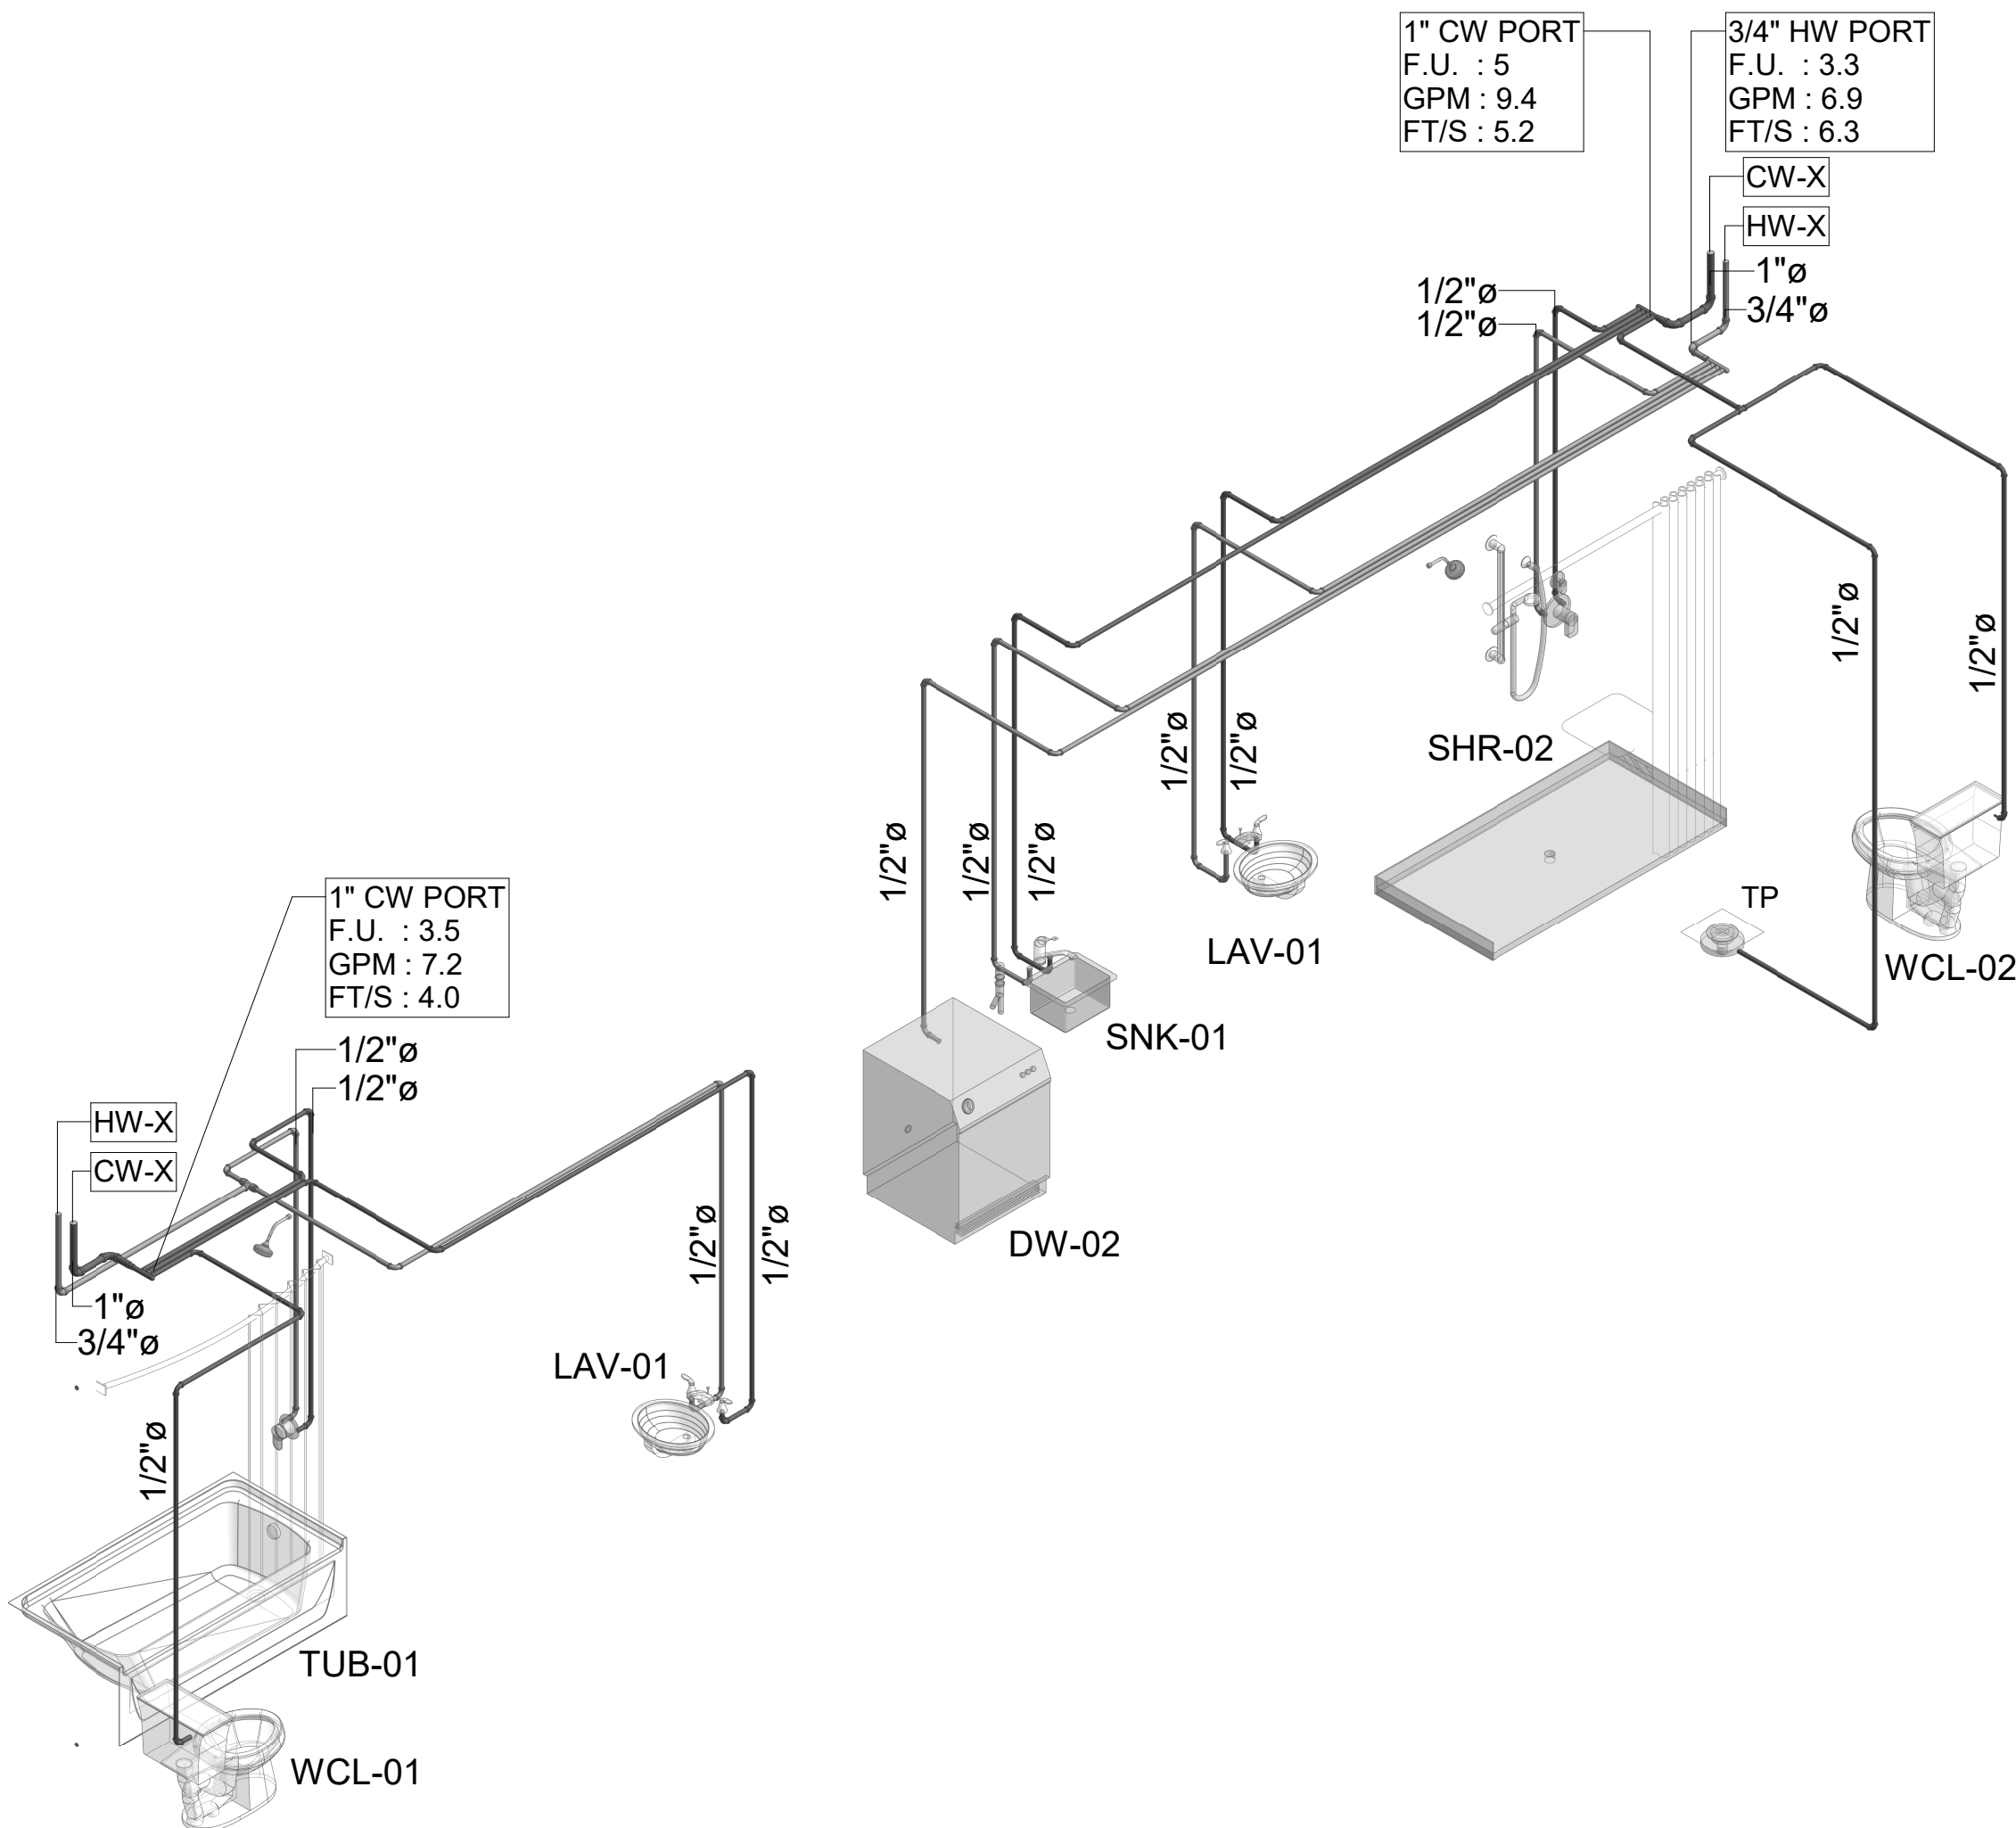

4 ACCESSIBLE 2 BEDROOM SUITE W/RIS WATER RISER DIAGRAM

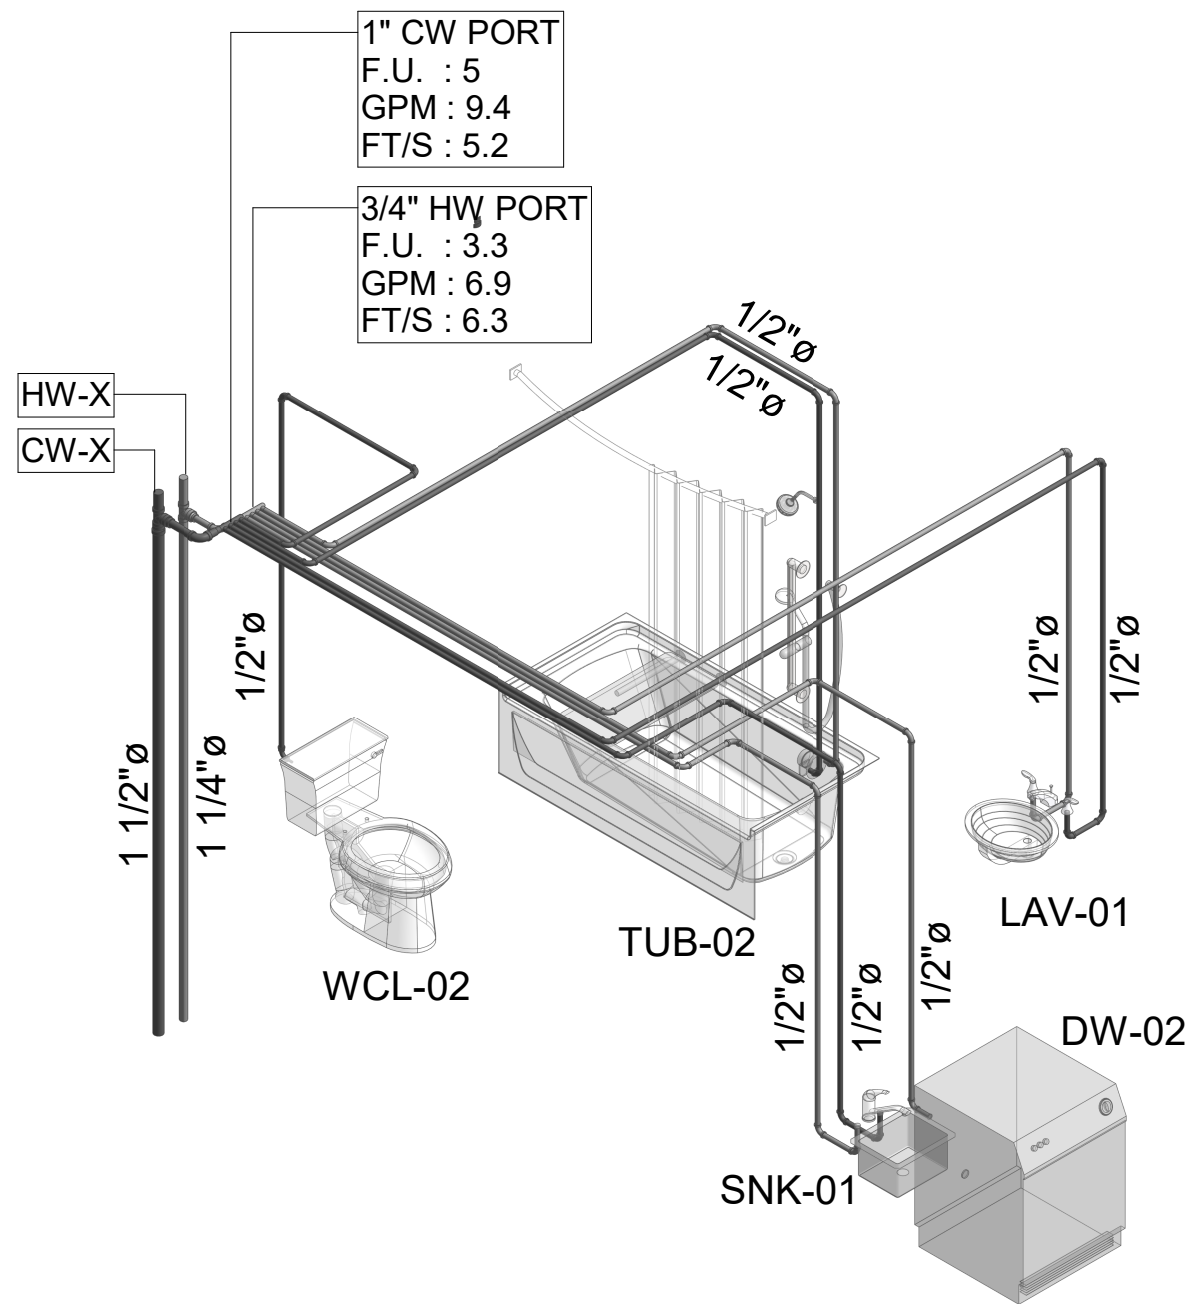


5 ACCESSIBLE DOUBLE QUEEN SUITE WATER SUPPLY RISER DIAGRAM

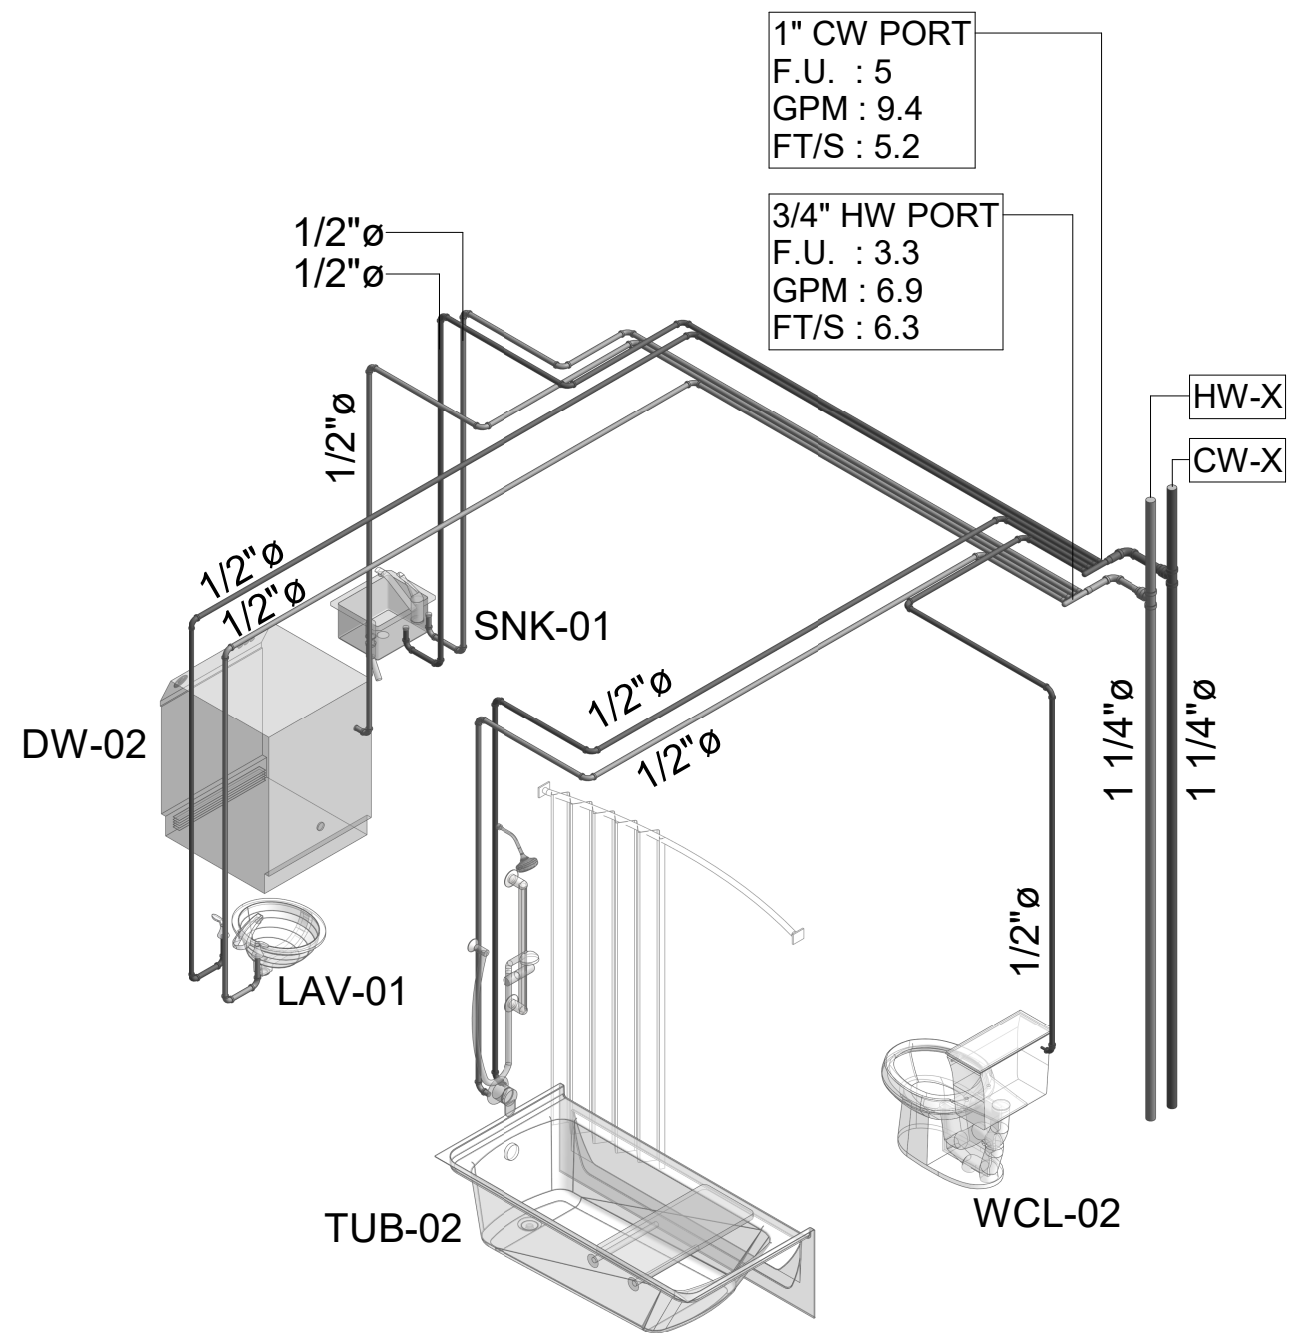

6 ACCESSIBLE KING SUITE WATER SUPPLY RISER DIAGRAM

B-20-0180
City of Puyallup

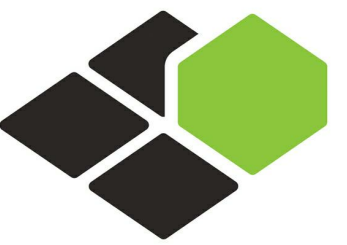


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2183 S BERRYS CHAPEL ROAD
FRANKLIN, TN 37069

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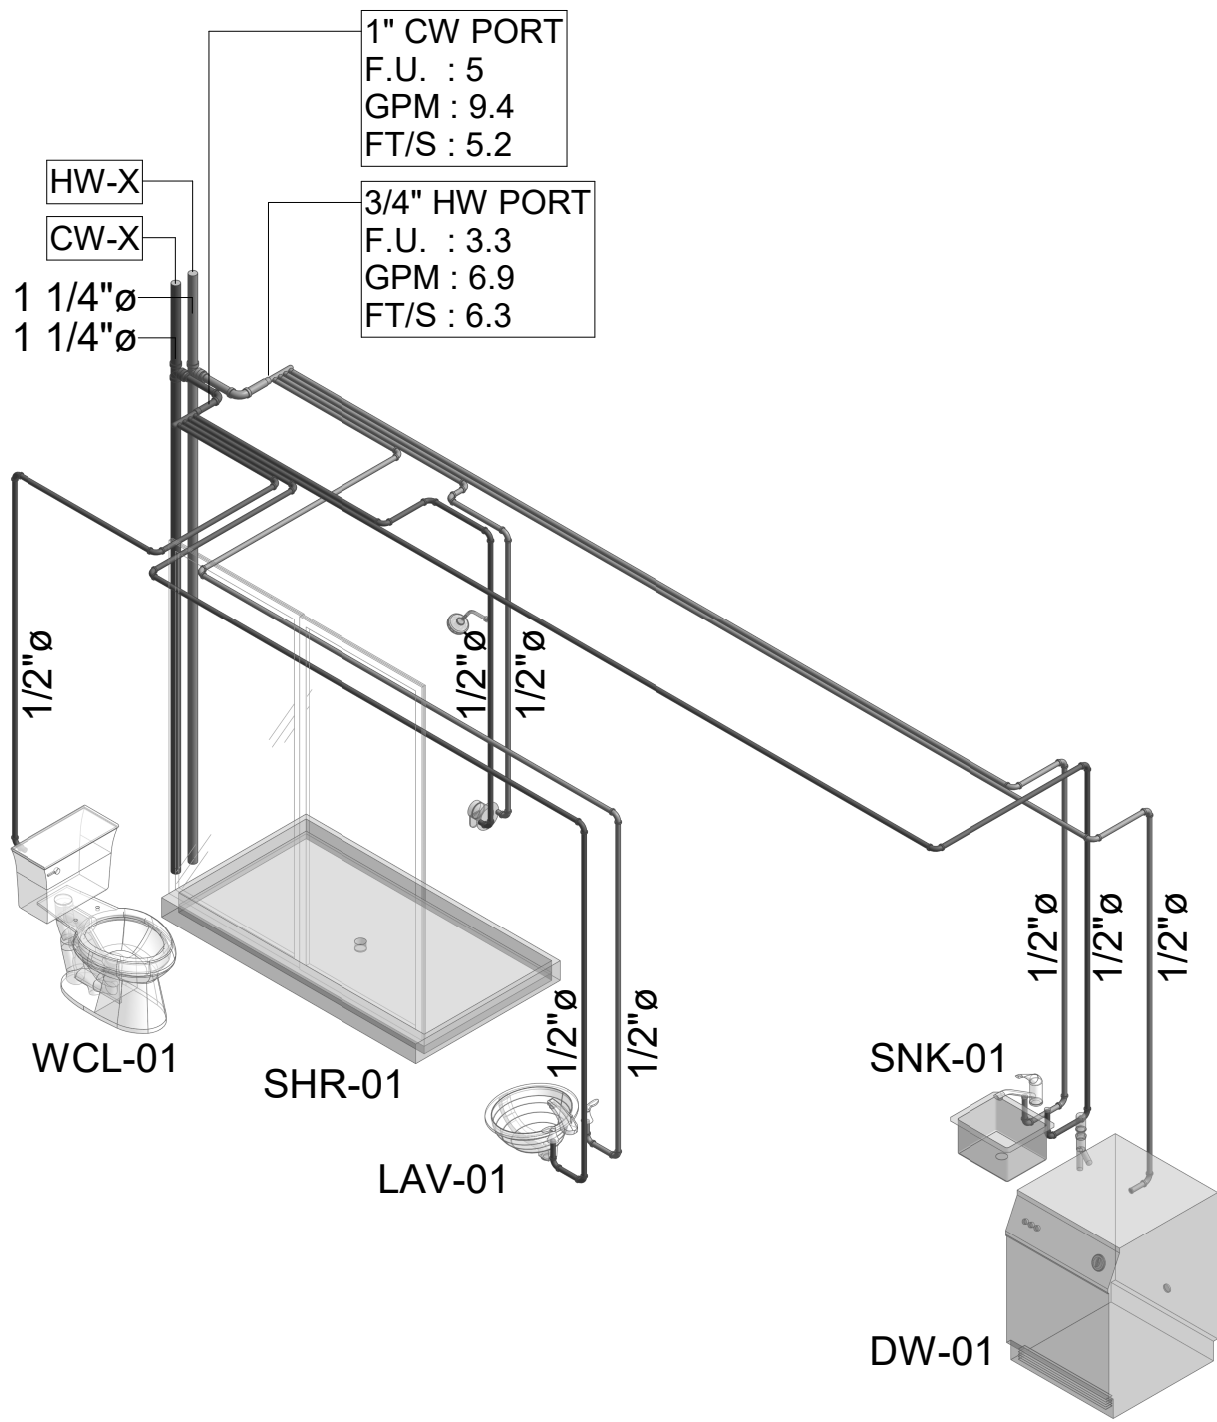
SHEET NAME

UNIT WATER
SUPPLY RISER
DIAGRAM-A


DRAWINGS NO.

P-304A

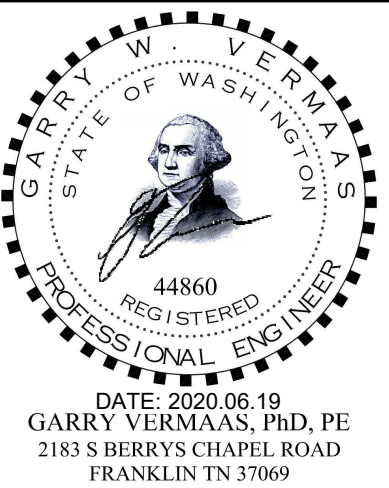
WATER SUPPLY DEMAND		
FIXTURE	CW FU	HW FU
BATHROOM GROUP	3.5	1.8
SNK AND DW	1.5	1.5




7 DOUBLE QUEEN SUITE WATER SUPPLY RISER DIAGRAM

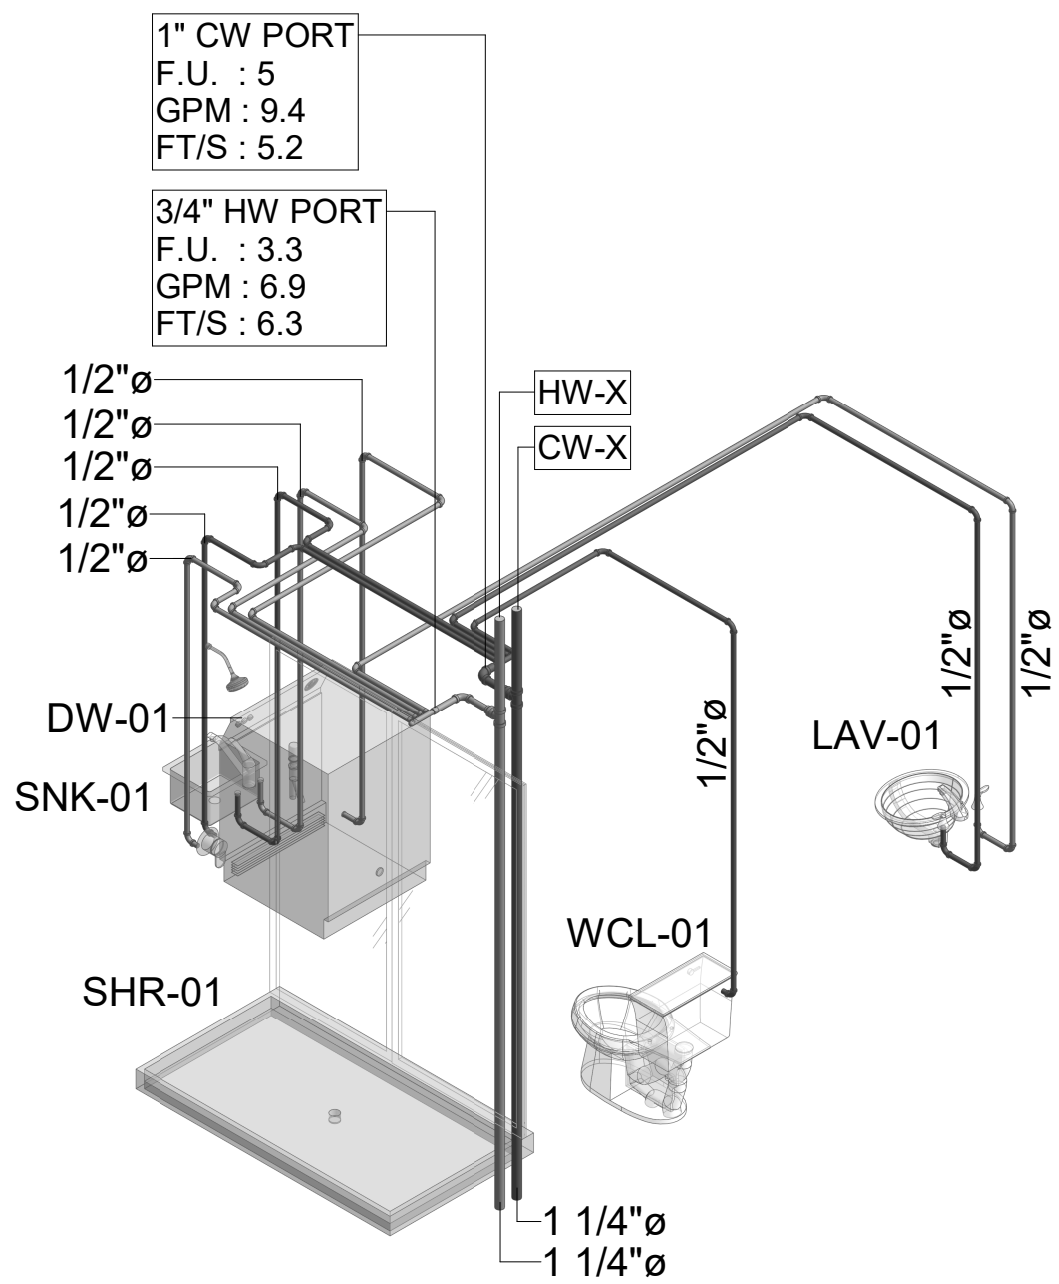


8 KING STUDIO 'A' CUSTOM WATER SUPPLY RISER DIAGRAM

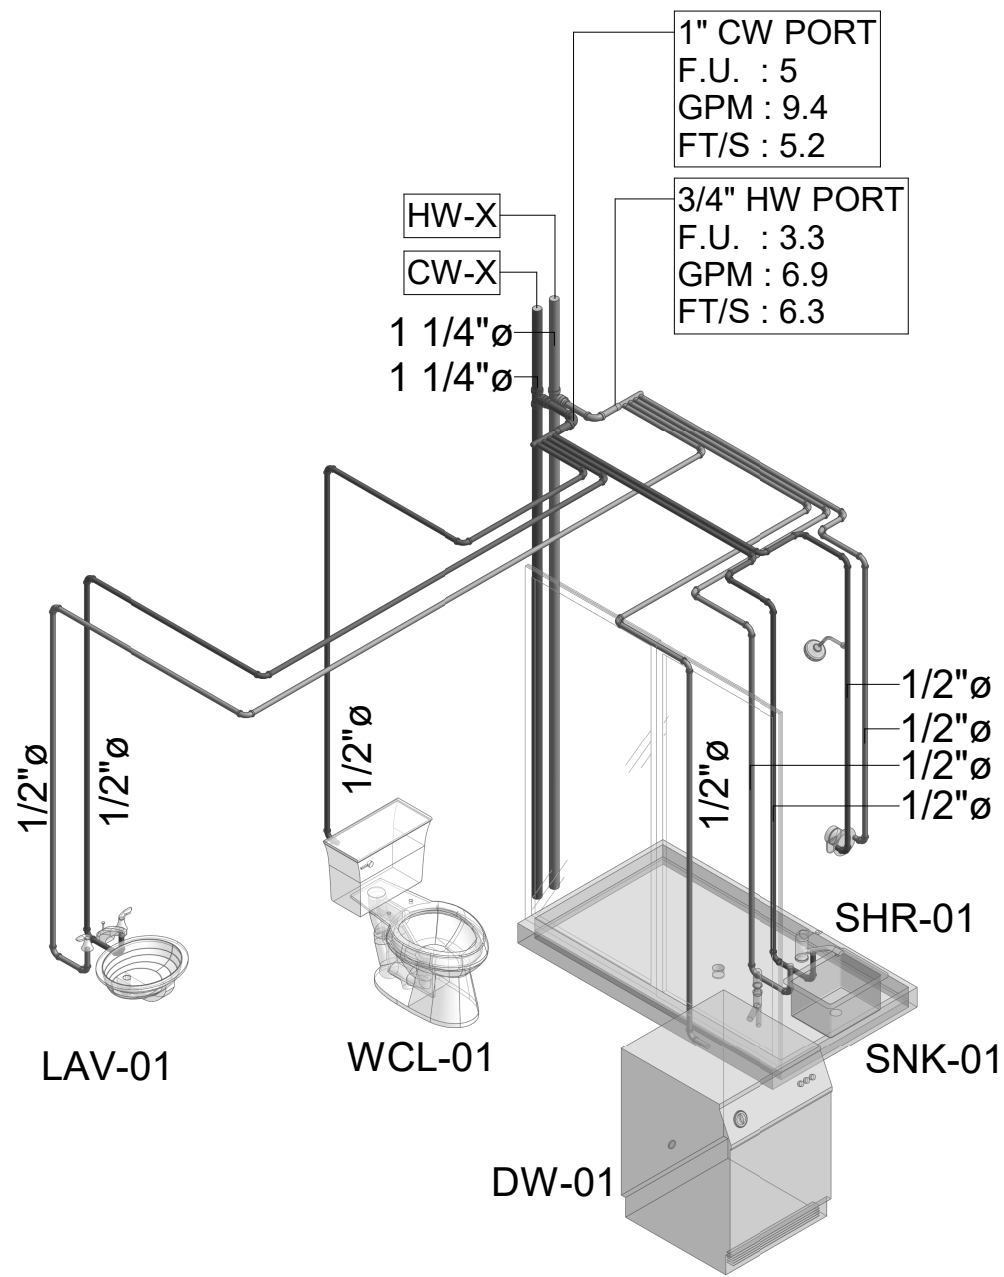

9 KING STUDIO 'A' WATER SUPPLY RISER DIAGRAM

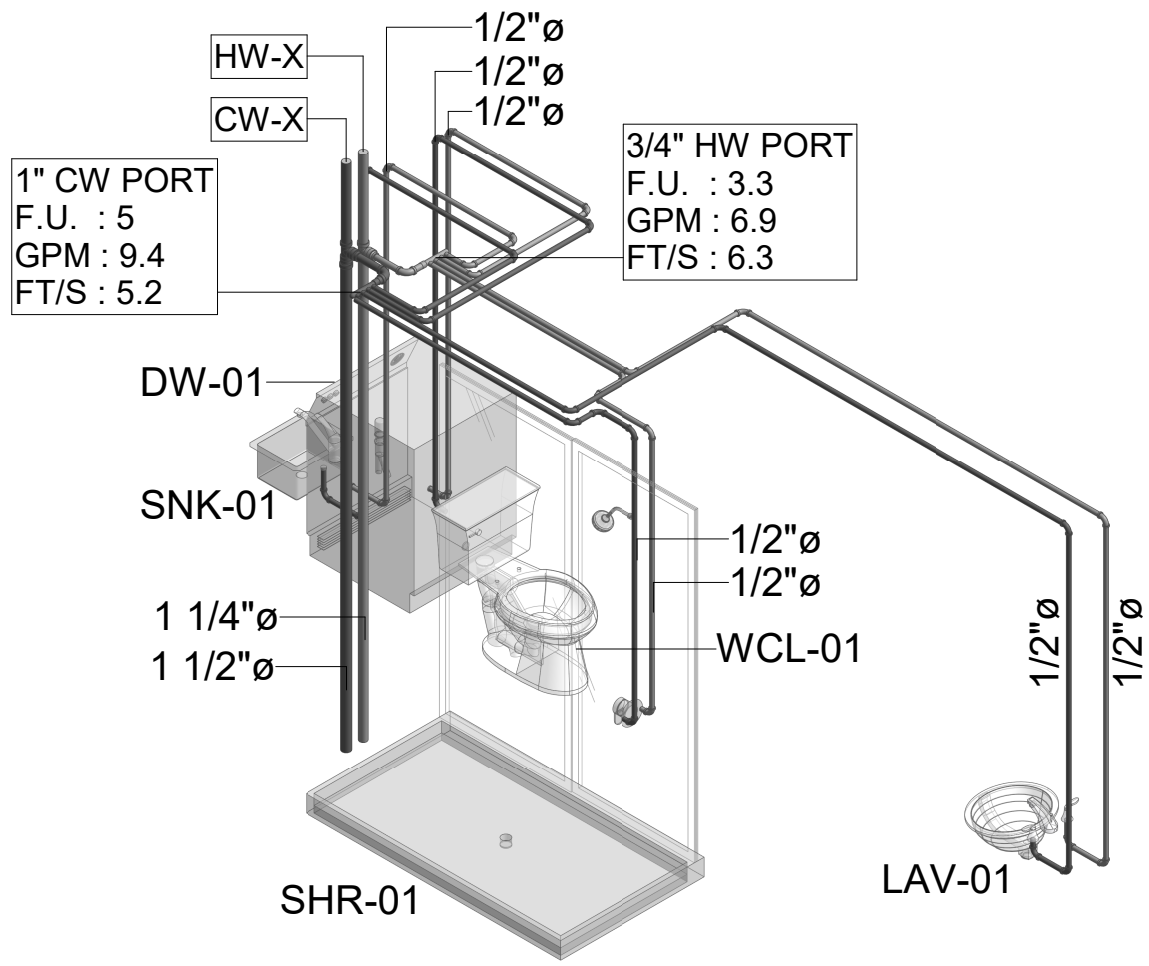


10 KING STUDIO 'B' WATER SUPPLY RISER DIAGRAM

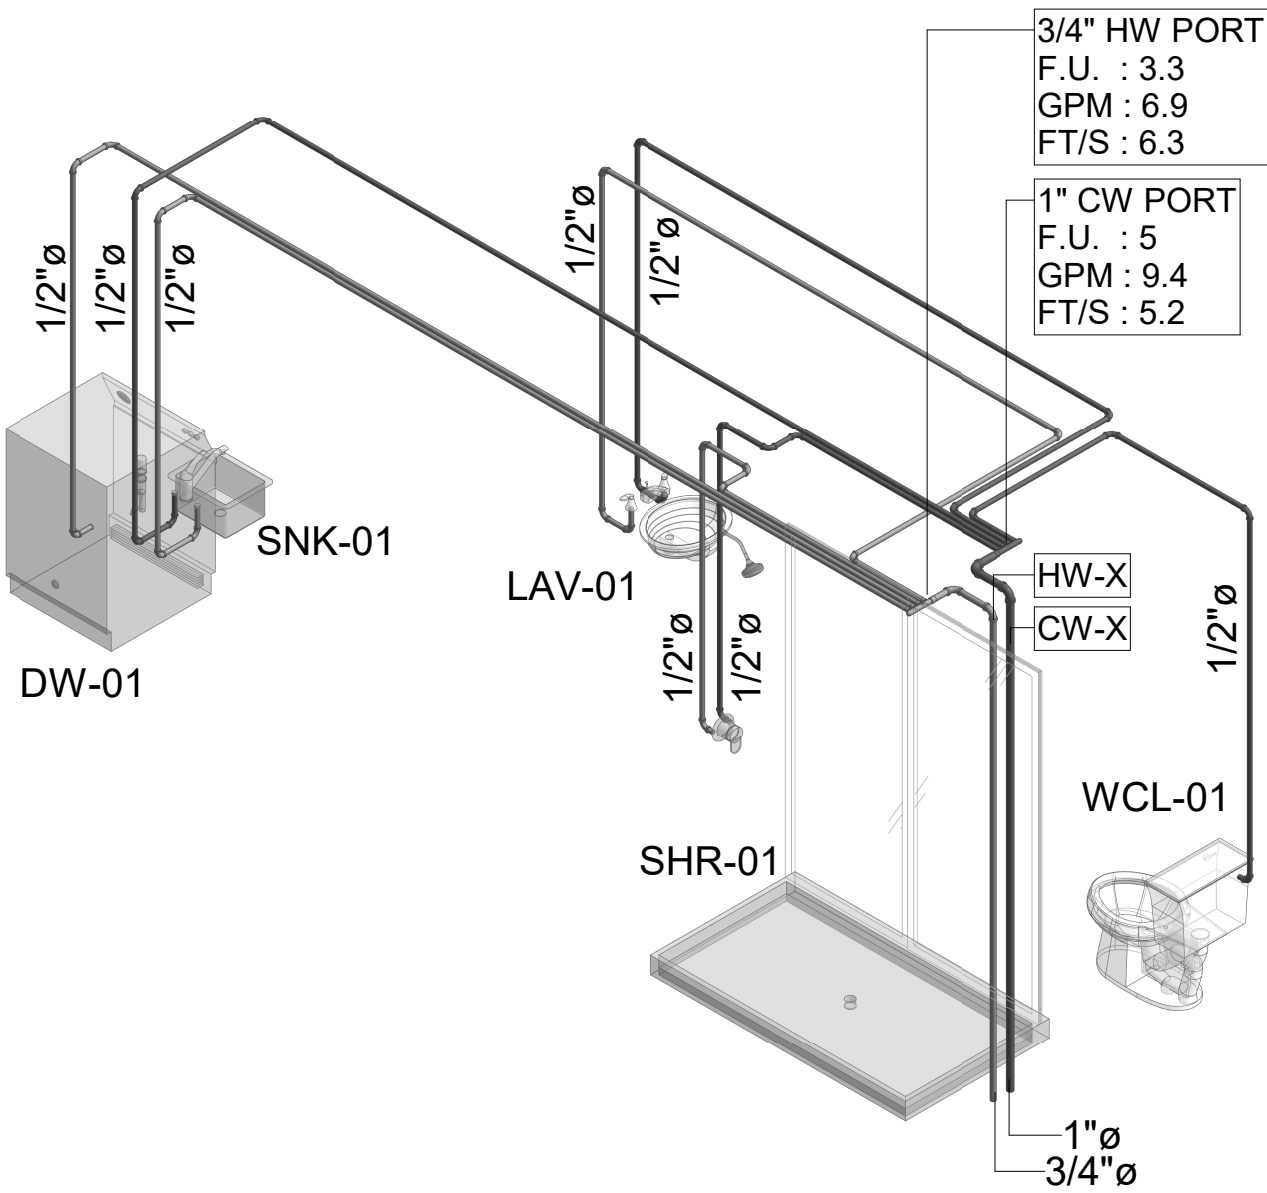

11 KING SUITE WATER SUPPLY RISER DIAGRAM

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B-20-0180
City of Puyallup

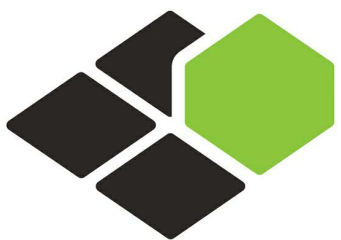


BASE⁴

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Seal:



Owner:

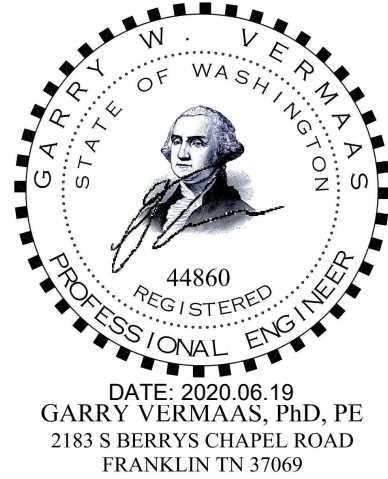

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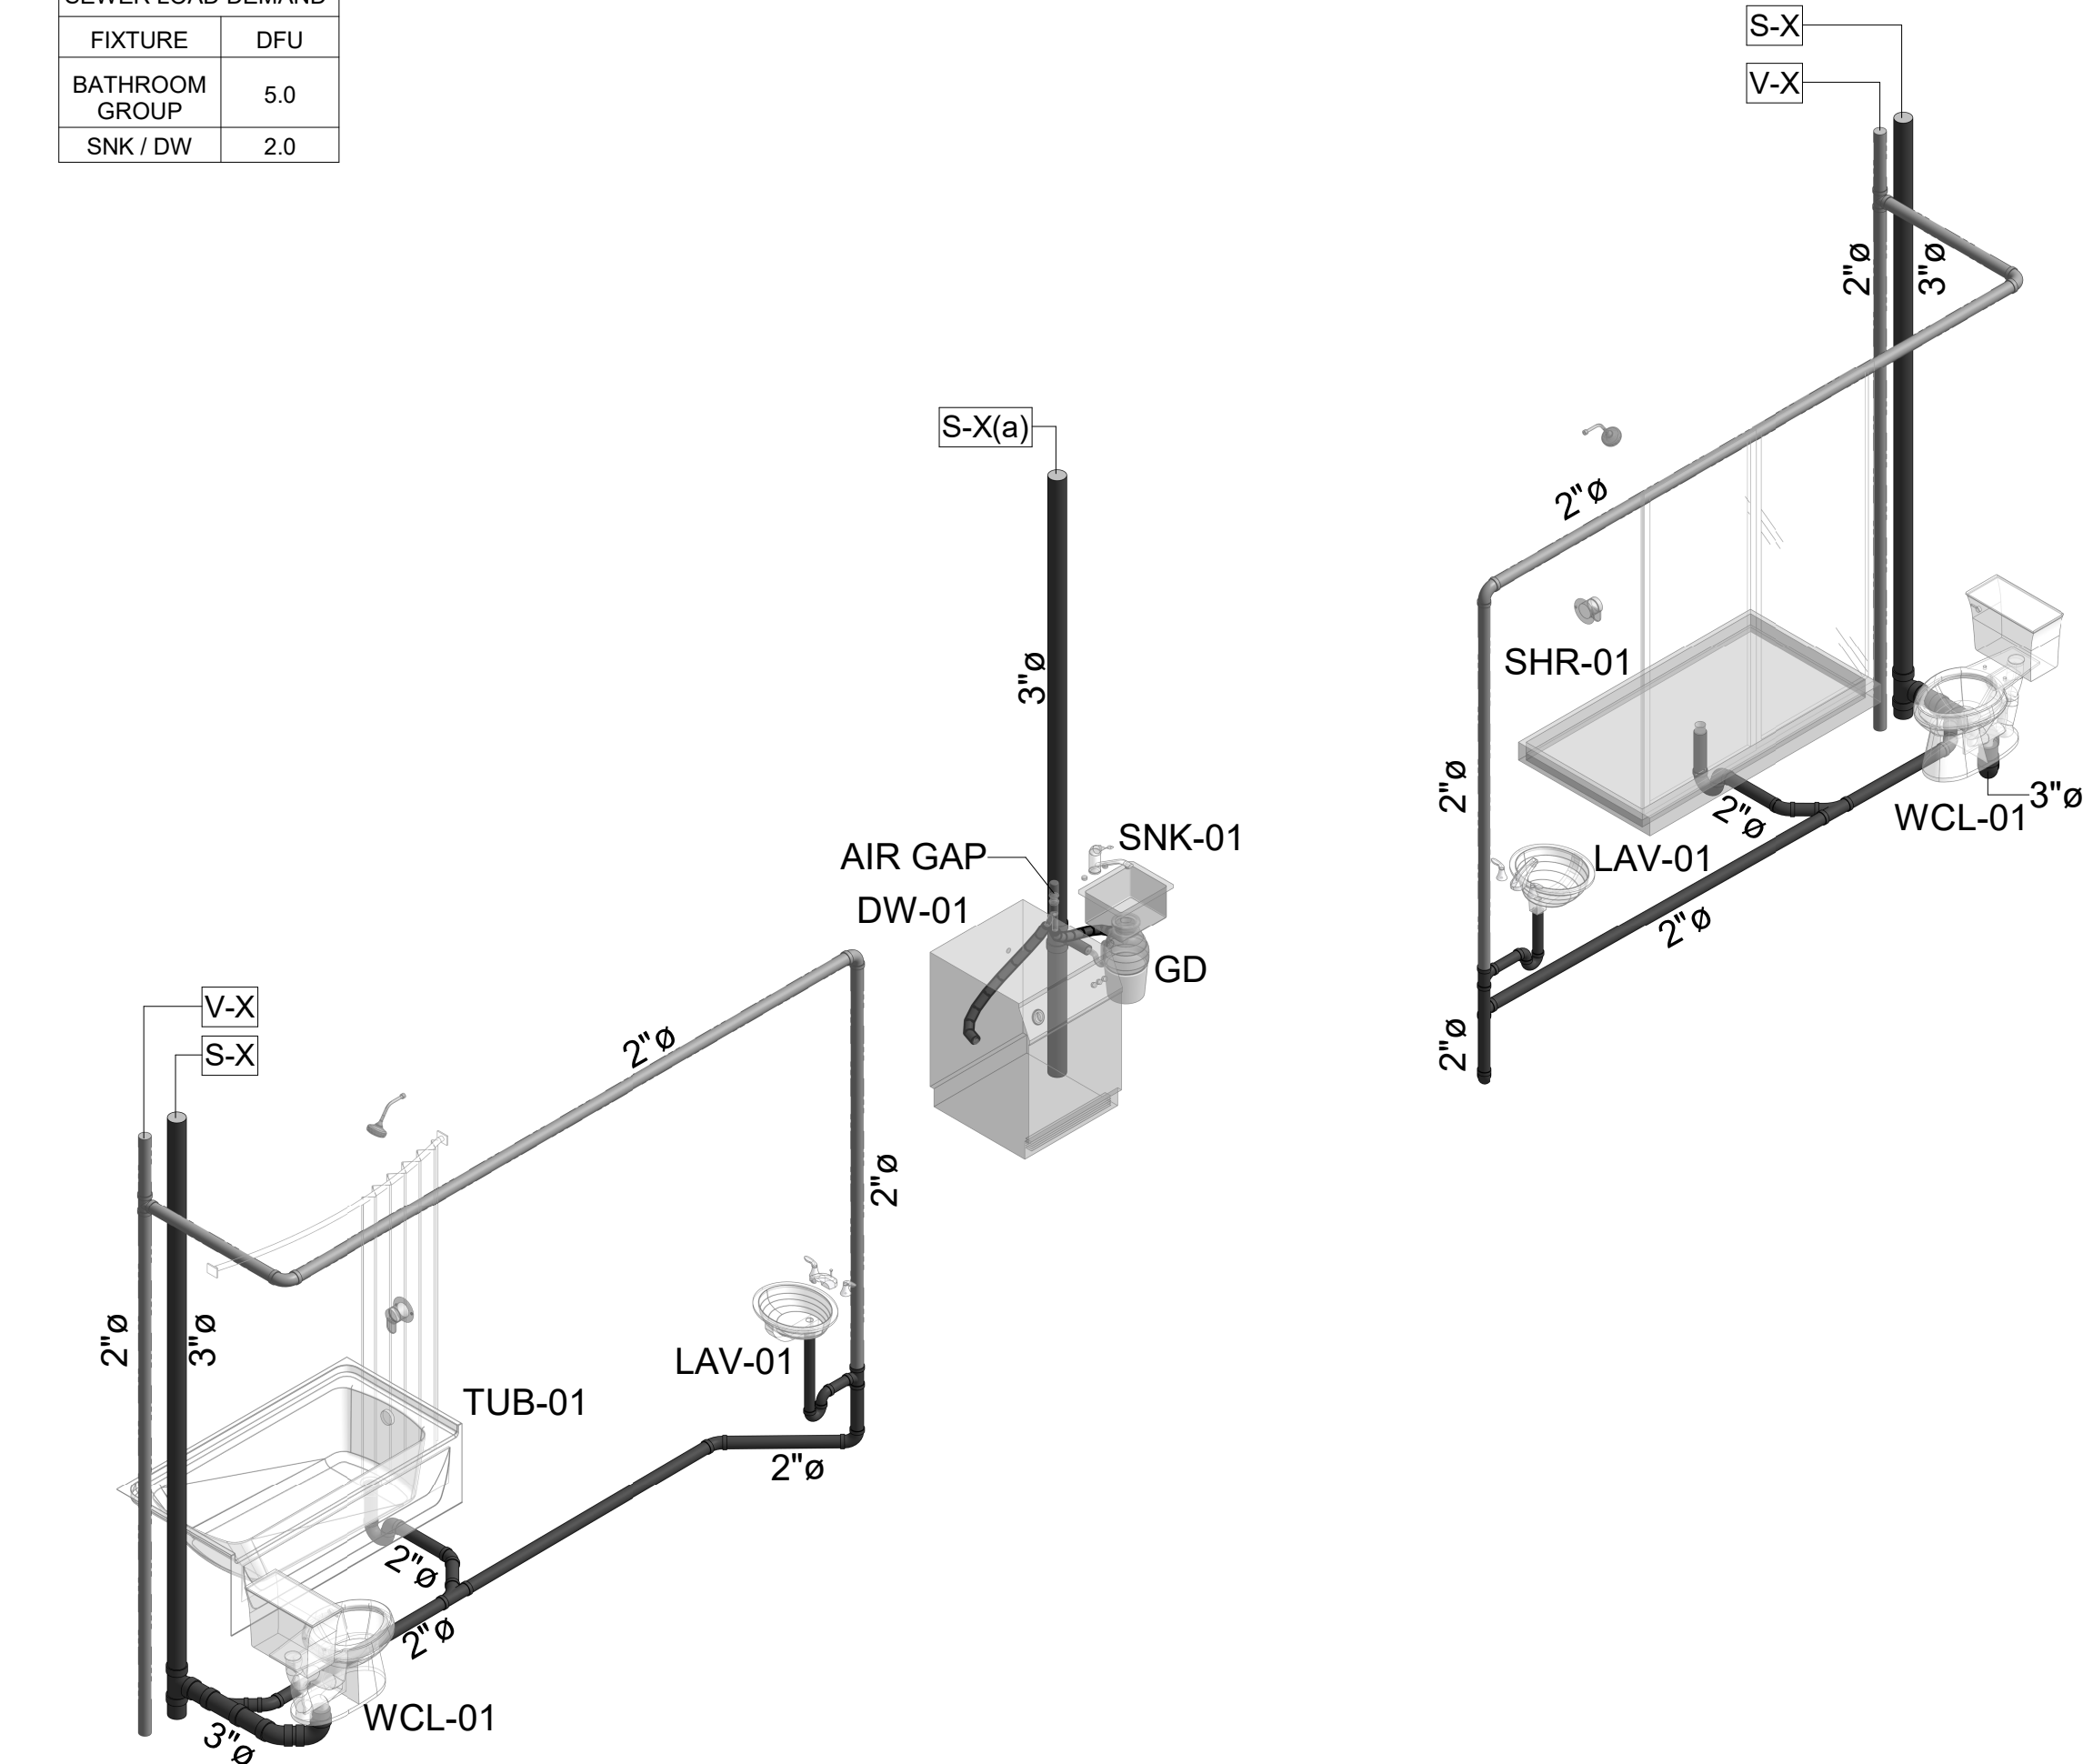
SHEET NAME

UNIT WATER
SUPPLY RISER
DIAGRAM-B


DRAWINGS NO.

P-304B


SEWER LOAD DEMAND		
FIXTURE	DFU	
BATHROOM GROUP	5.0	
SNK / DW	2.0	




1 2 BEDROOM SUITE SANITARY AND VENT RISER DIAGRAM

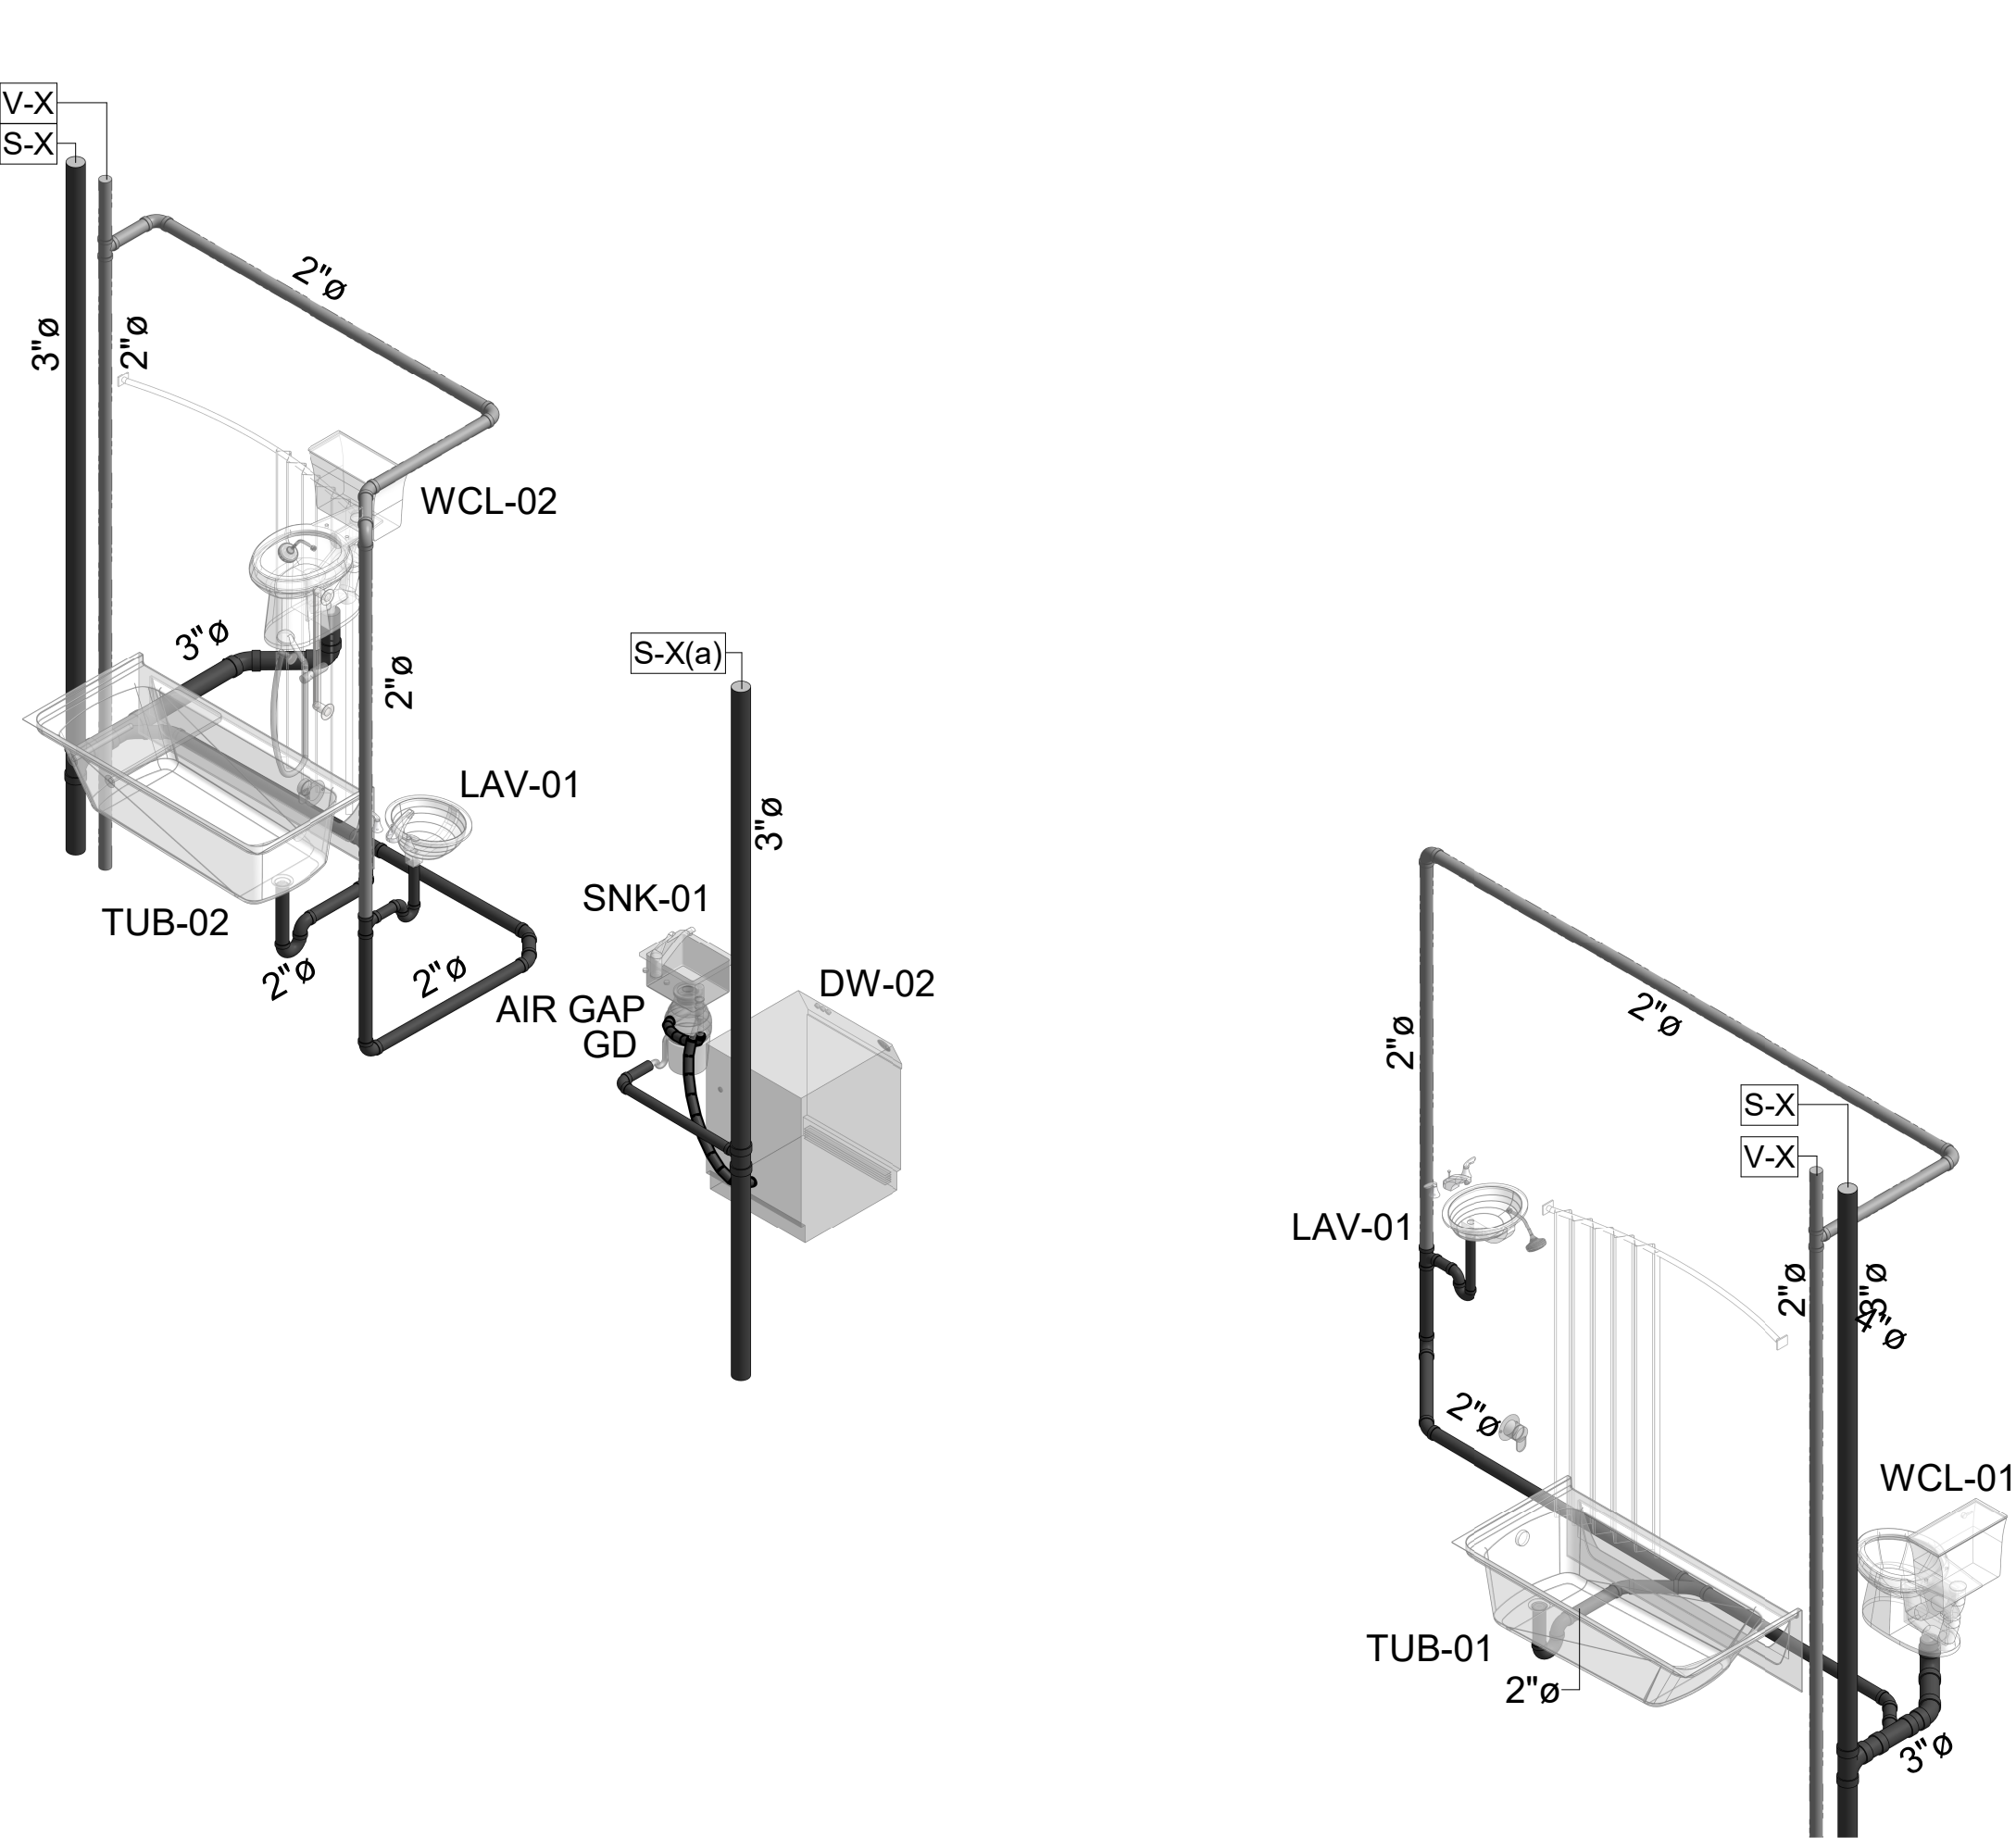


2 ACCESSIBLE 2 BEDROOM SUITE SANITARY AND VENT RISER DIAGRAM

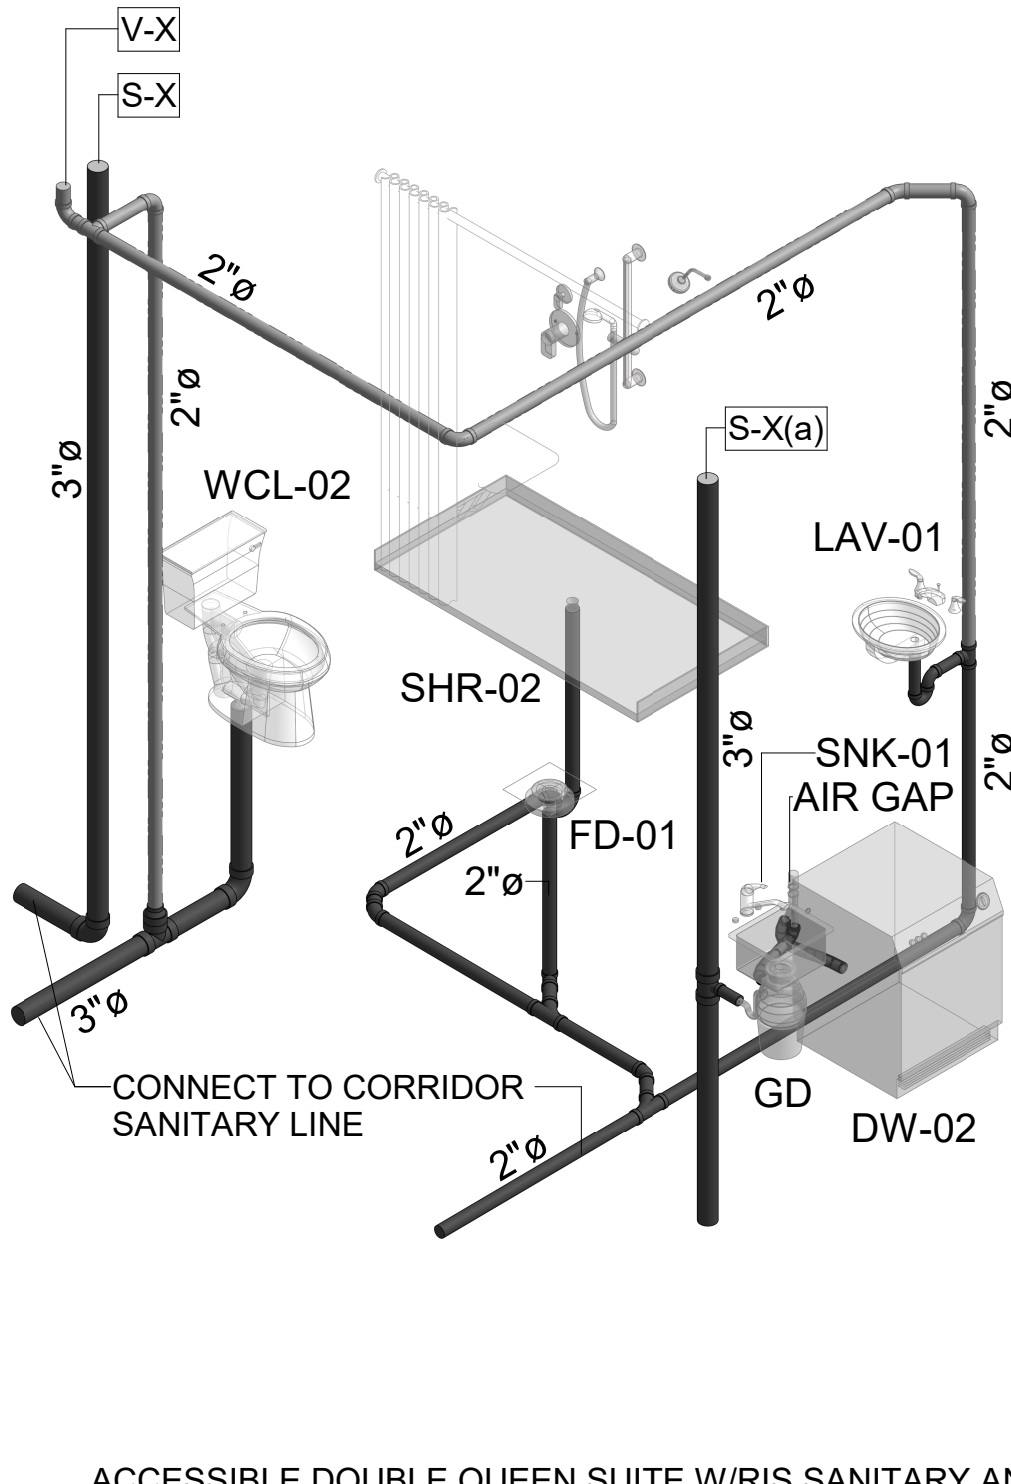


3 ACCESSIBLE DOUBLE QUEEN SUITE W/RIS SANITARY AND VENT RISER DIAGRAM

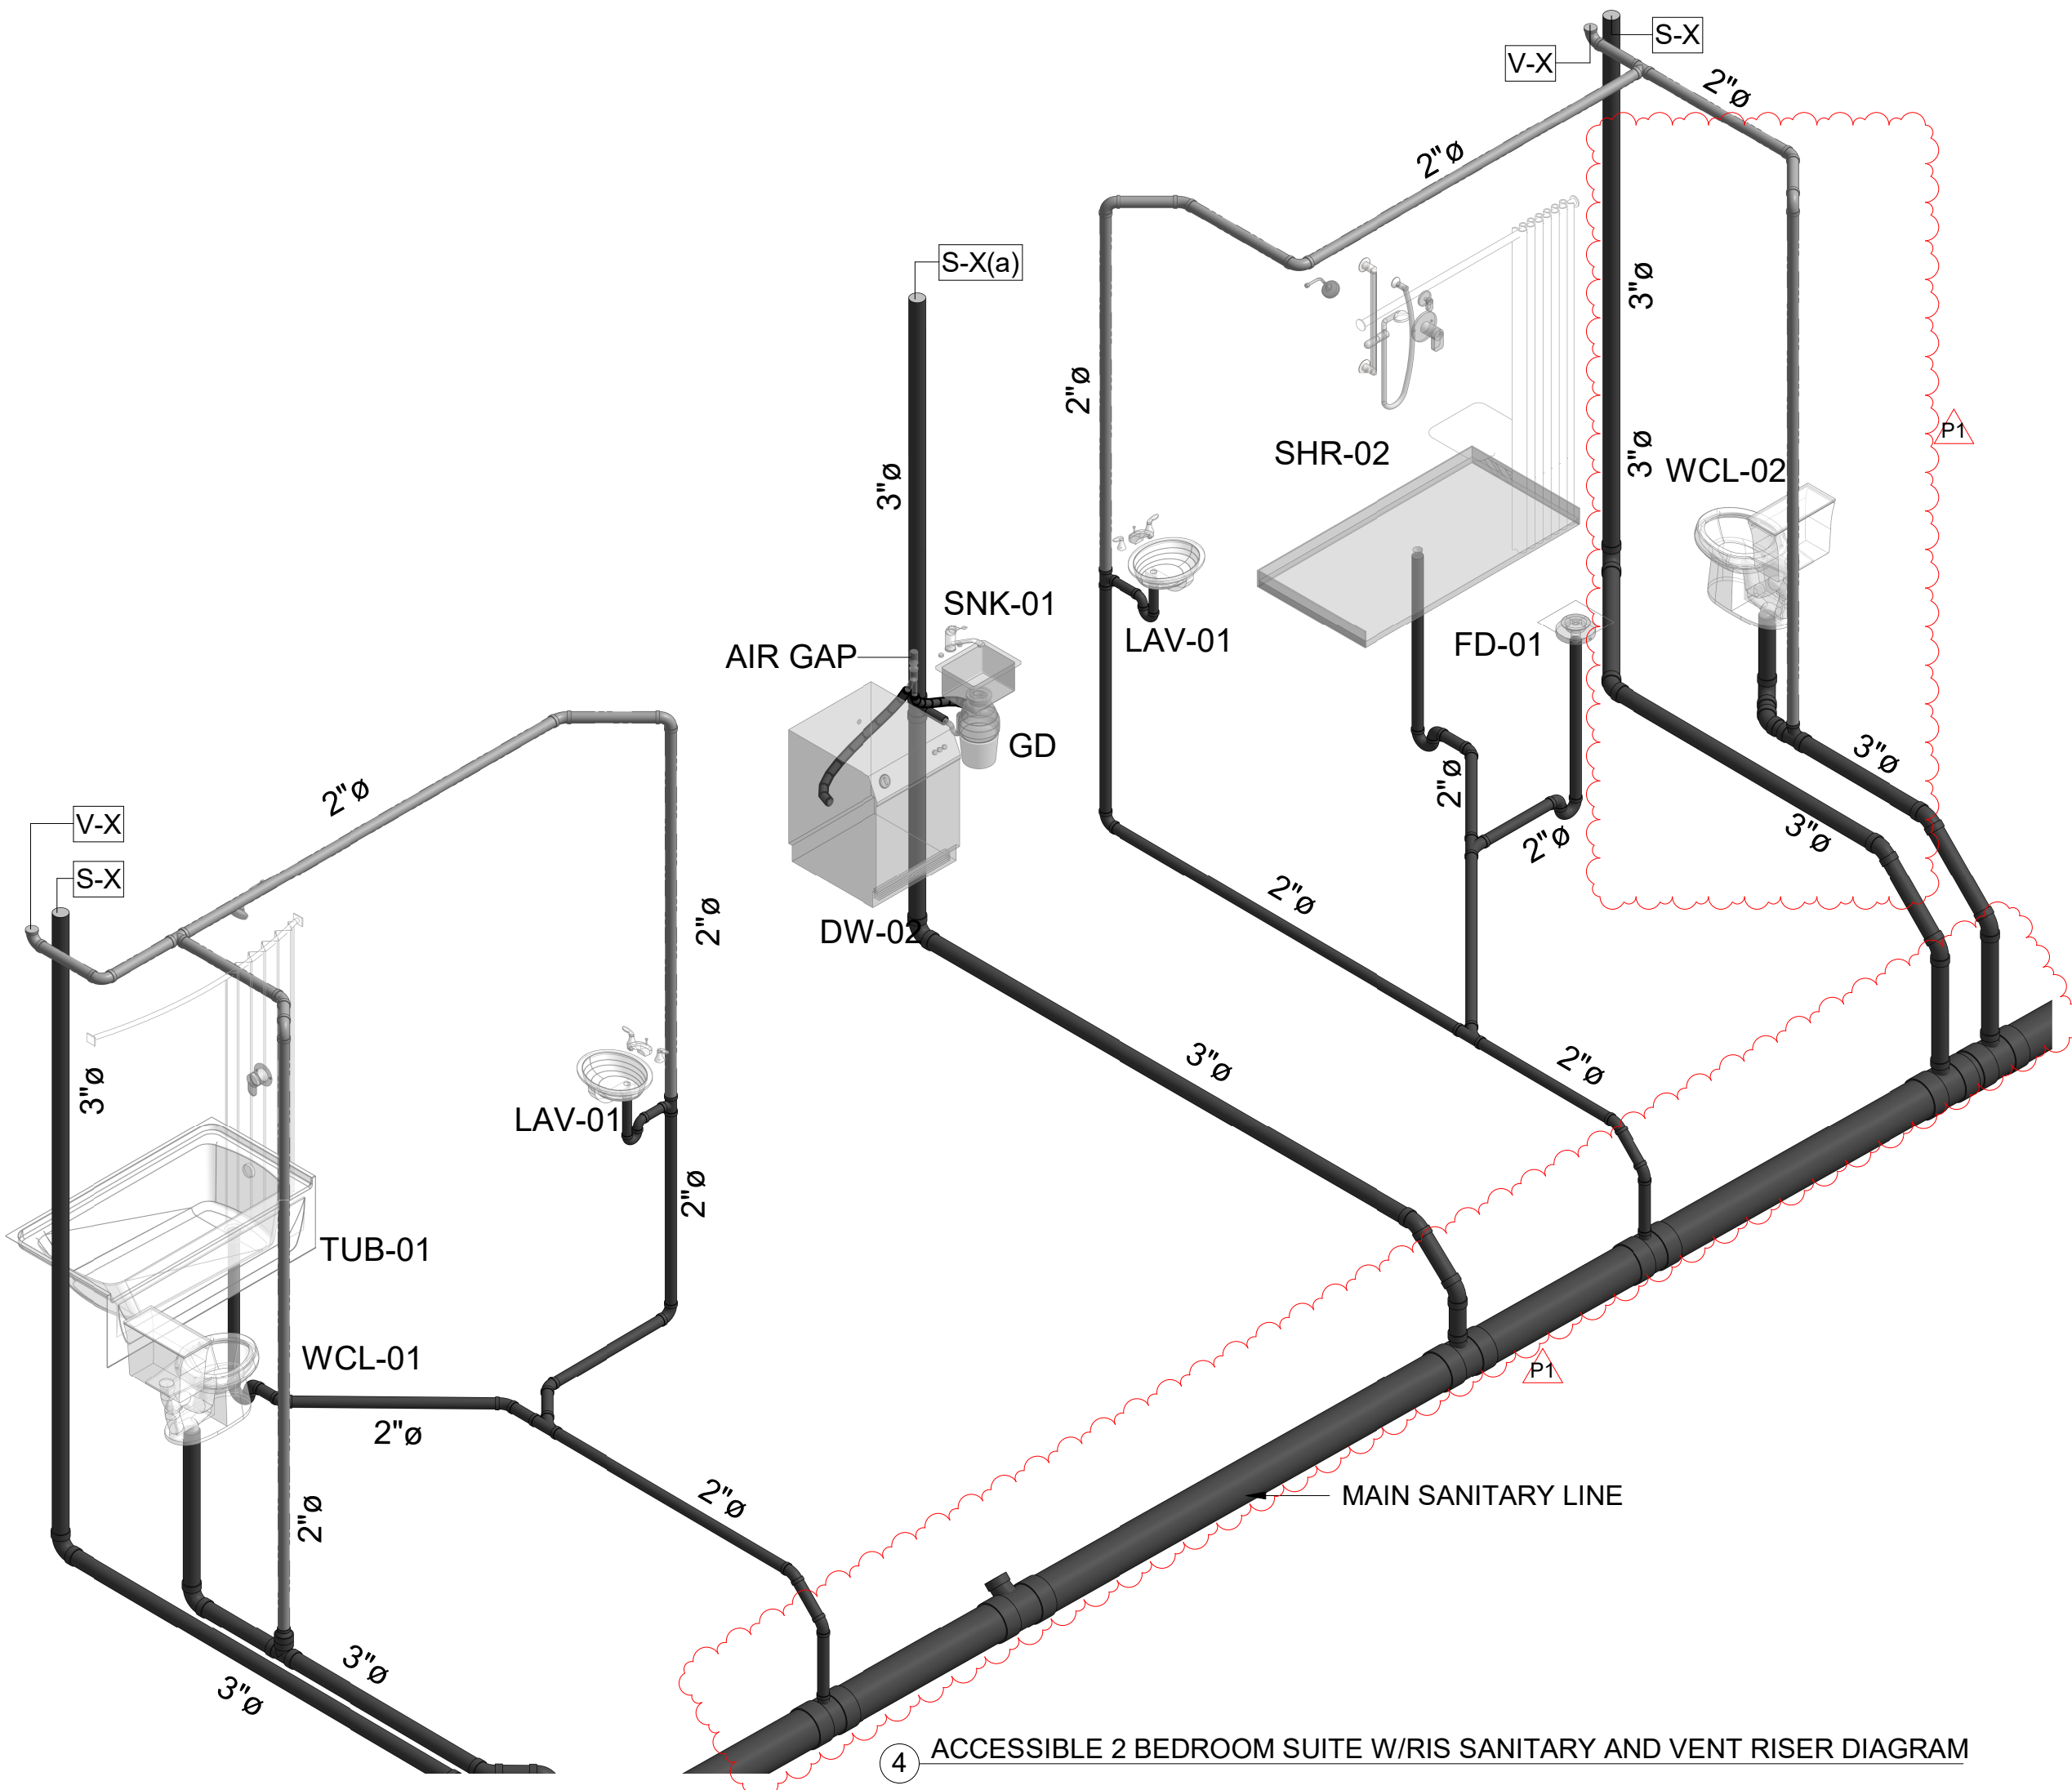


4 ACCESSIBLE 2 BEDROOM SUITE W/RIS SANITARY AND VENT RISER DIAGRAM

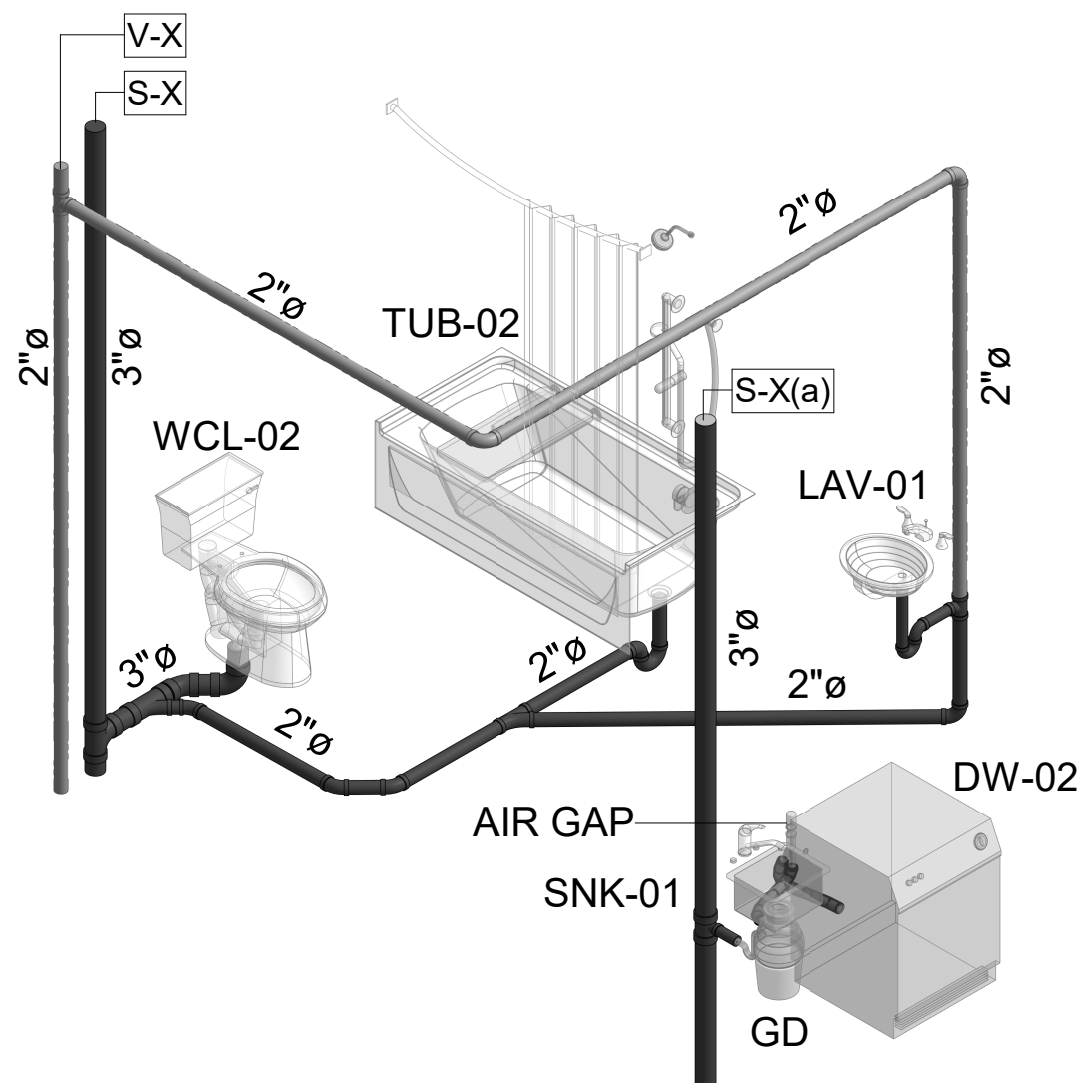

5 ACCESSIBLE DOUBLE QUEEN SUITE SANITARY AND VENT RISER DIAGRAM

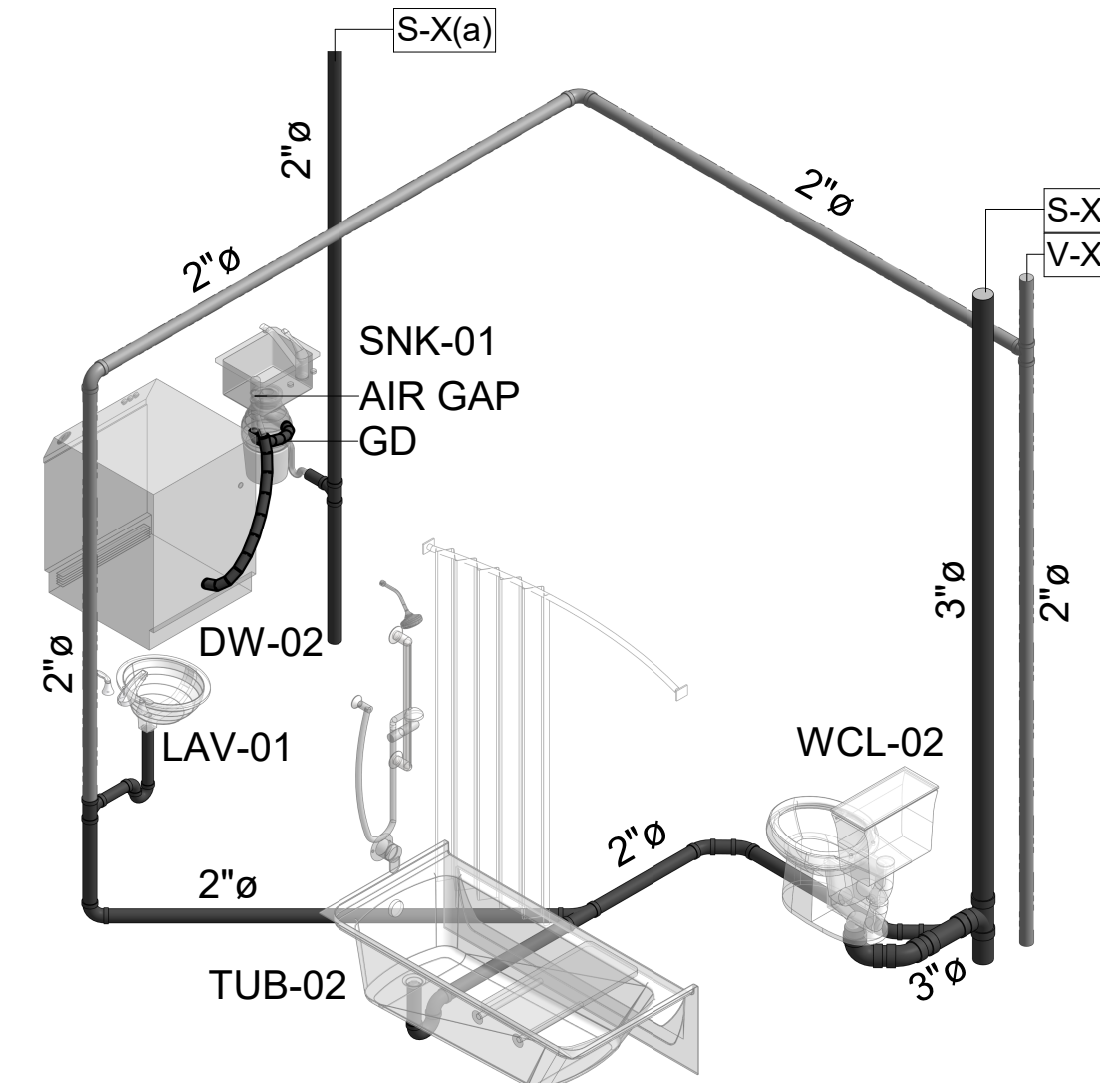

6 ACCESSIBLE KING SUITE SANITARY AND VENT RISER DIAGRAM

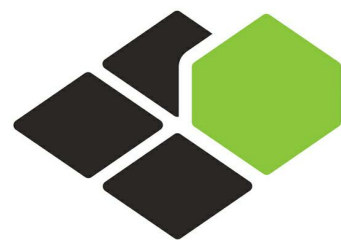


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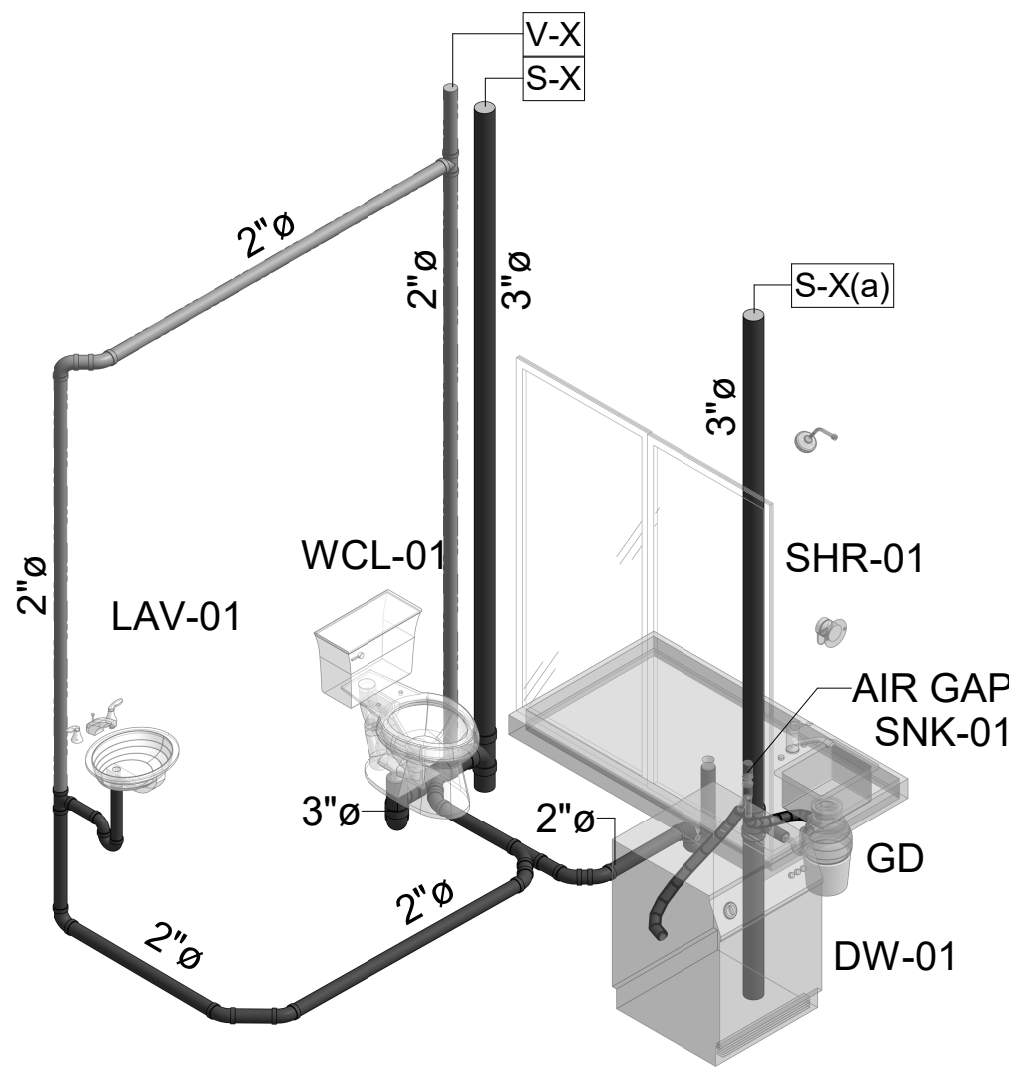
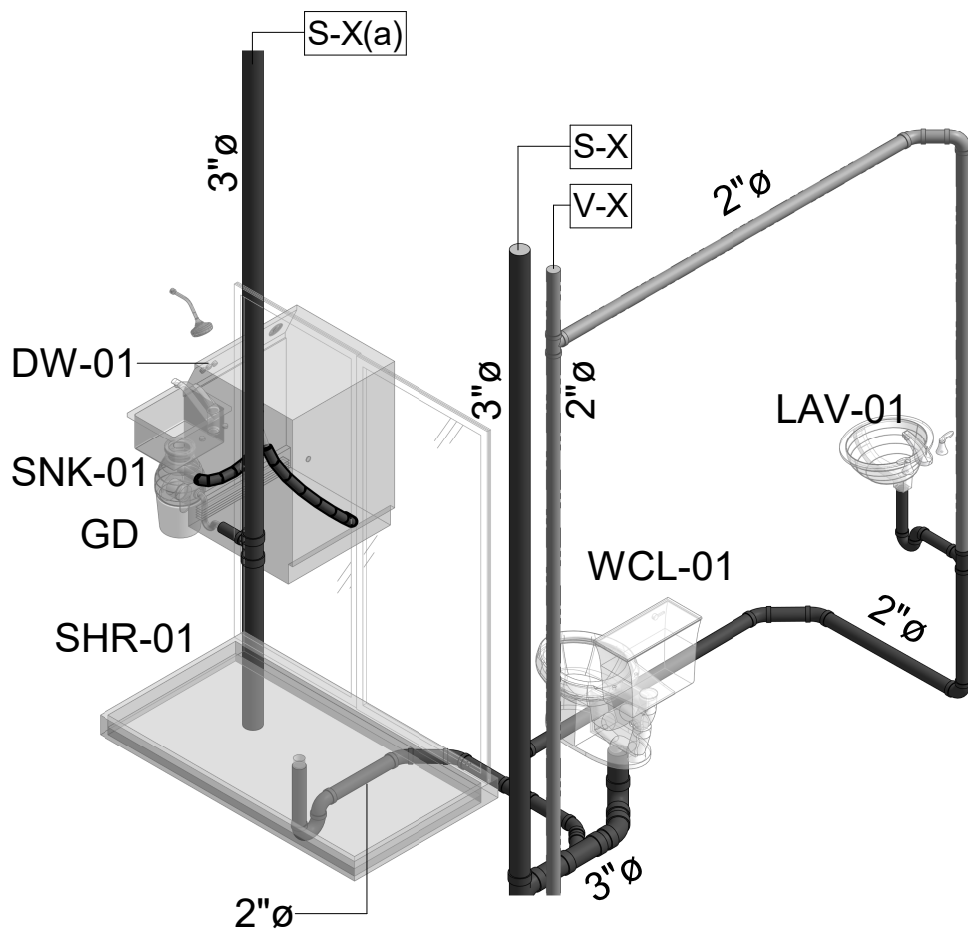
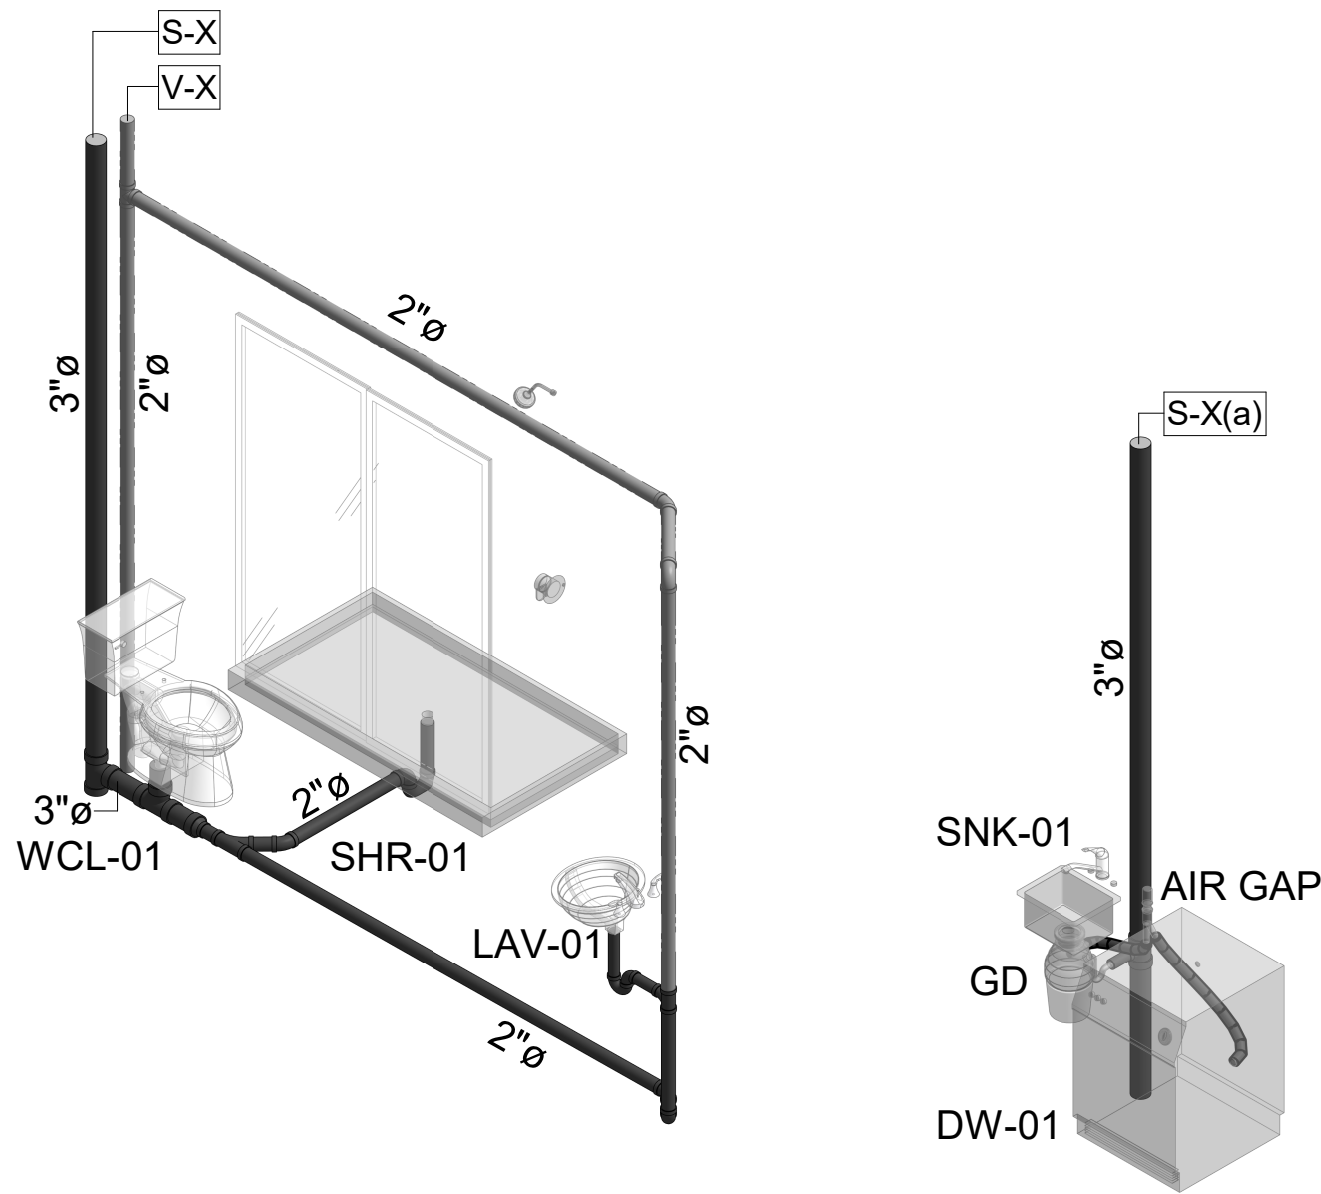
UNIT SANITARY &
VENT RISER
DIAGRAM-A

DRAWINGS NO.

P-305A

B-20-0180
City of Puyallup



SEWER LOAD DEMAND		
FIXTURE	DFU	
BATHROOM GROUP	5.0	
SNK / DW	2.0	

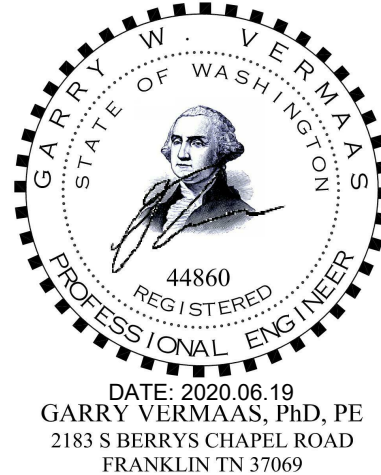

7 DOUBLE QUEEN SUITE SANITARY AND VENT RISER DIAGRAM

8 KING STUDIO 'A' CUSTOM SANITARY AND VENT RISER DIAGRAM

9 KING STUDIO 'A' SANITARY AND VENT RISER DIAGRAM

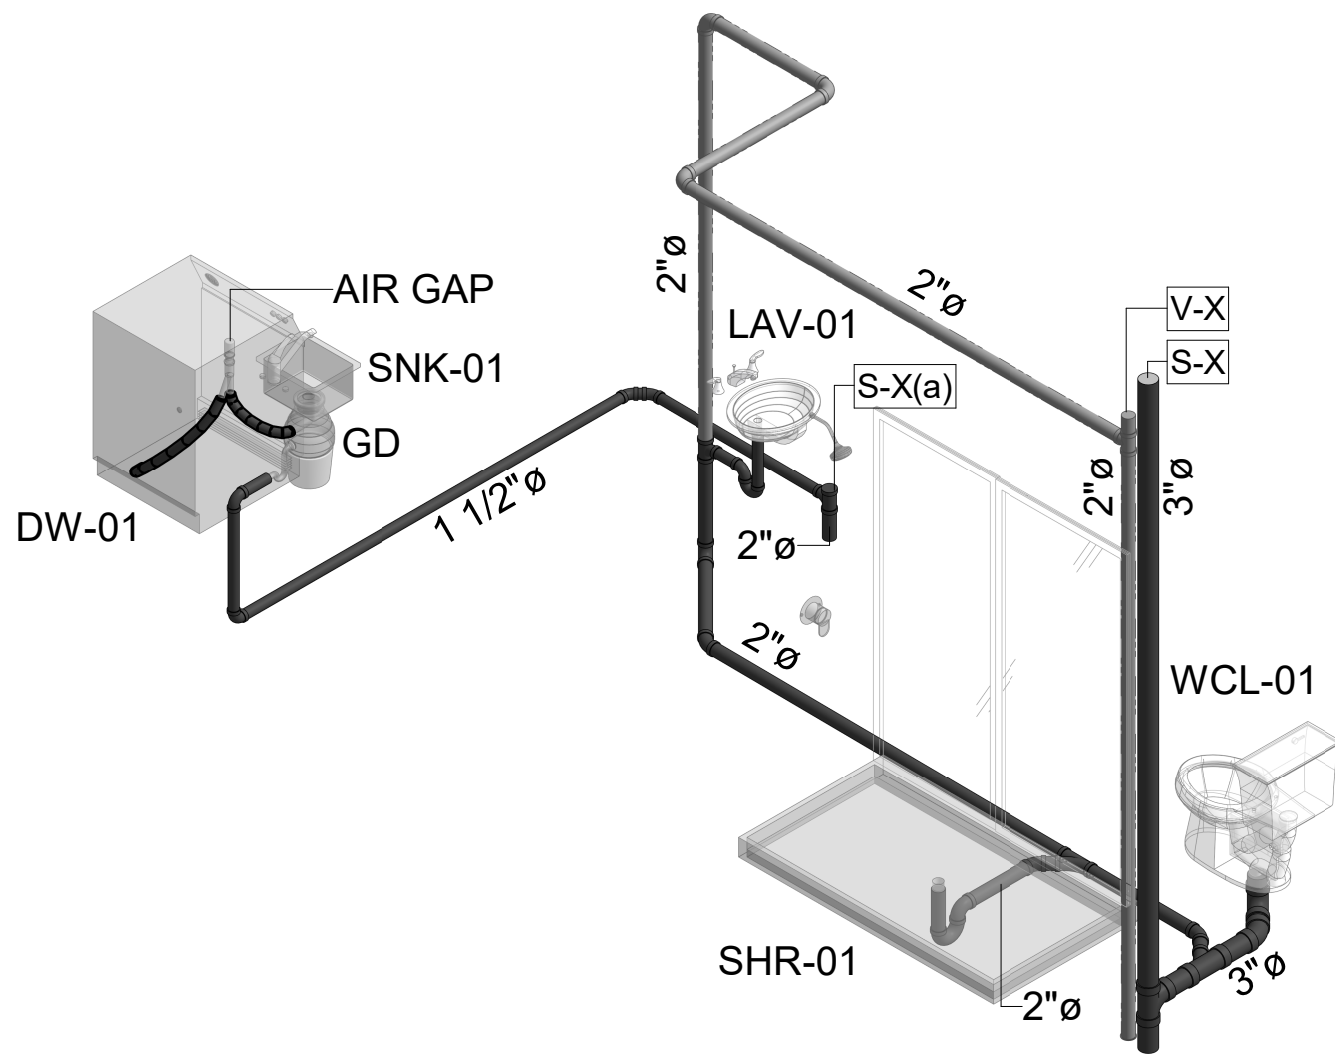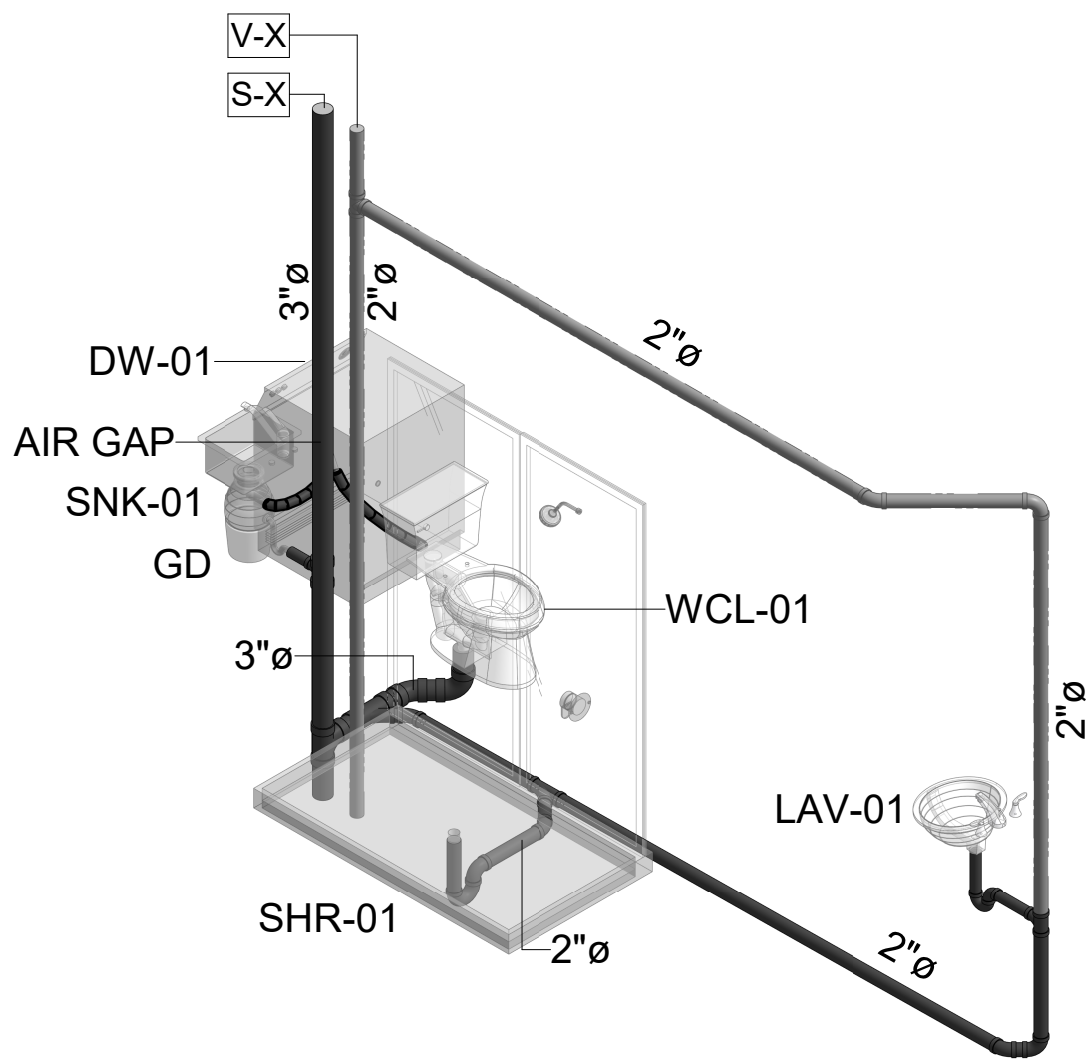


10 KING STUDIO 'B' SANITARY AND VENT RISER DIAGRAM

11 KING SUITE SANITARY AND VENT RISER DIAGRAM

NOT IN USE

B-20-0180
City of Puyallup

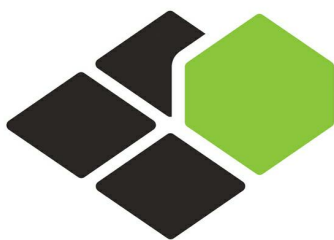


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CORAL SPRINGS, FL 33076

MEP ENGINEER
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2183 S BERRYS CHAPEL ROAD
FRANKLIN, TN 37069

Seal:



Owner:

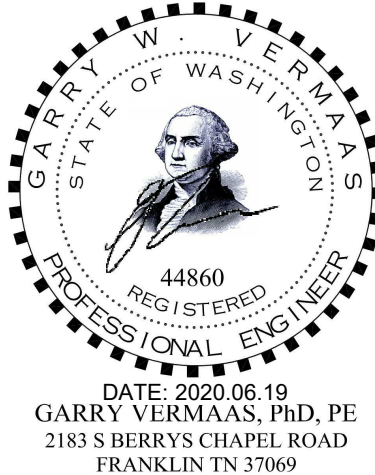

Dakota Legacy Group
Hospitality Development
4500 36TH AVE. S SUITE
200, FARGO, ND 58104
701.551.8000 (OFFICE)



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ISSUE NO.	DELTA	ISSUE DATE	DESCRIPTION
1	P0	2020.02.21	ISSUED FOR PERMIT

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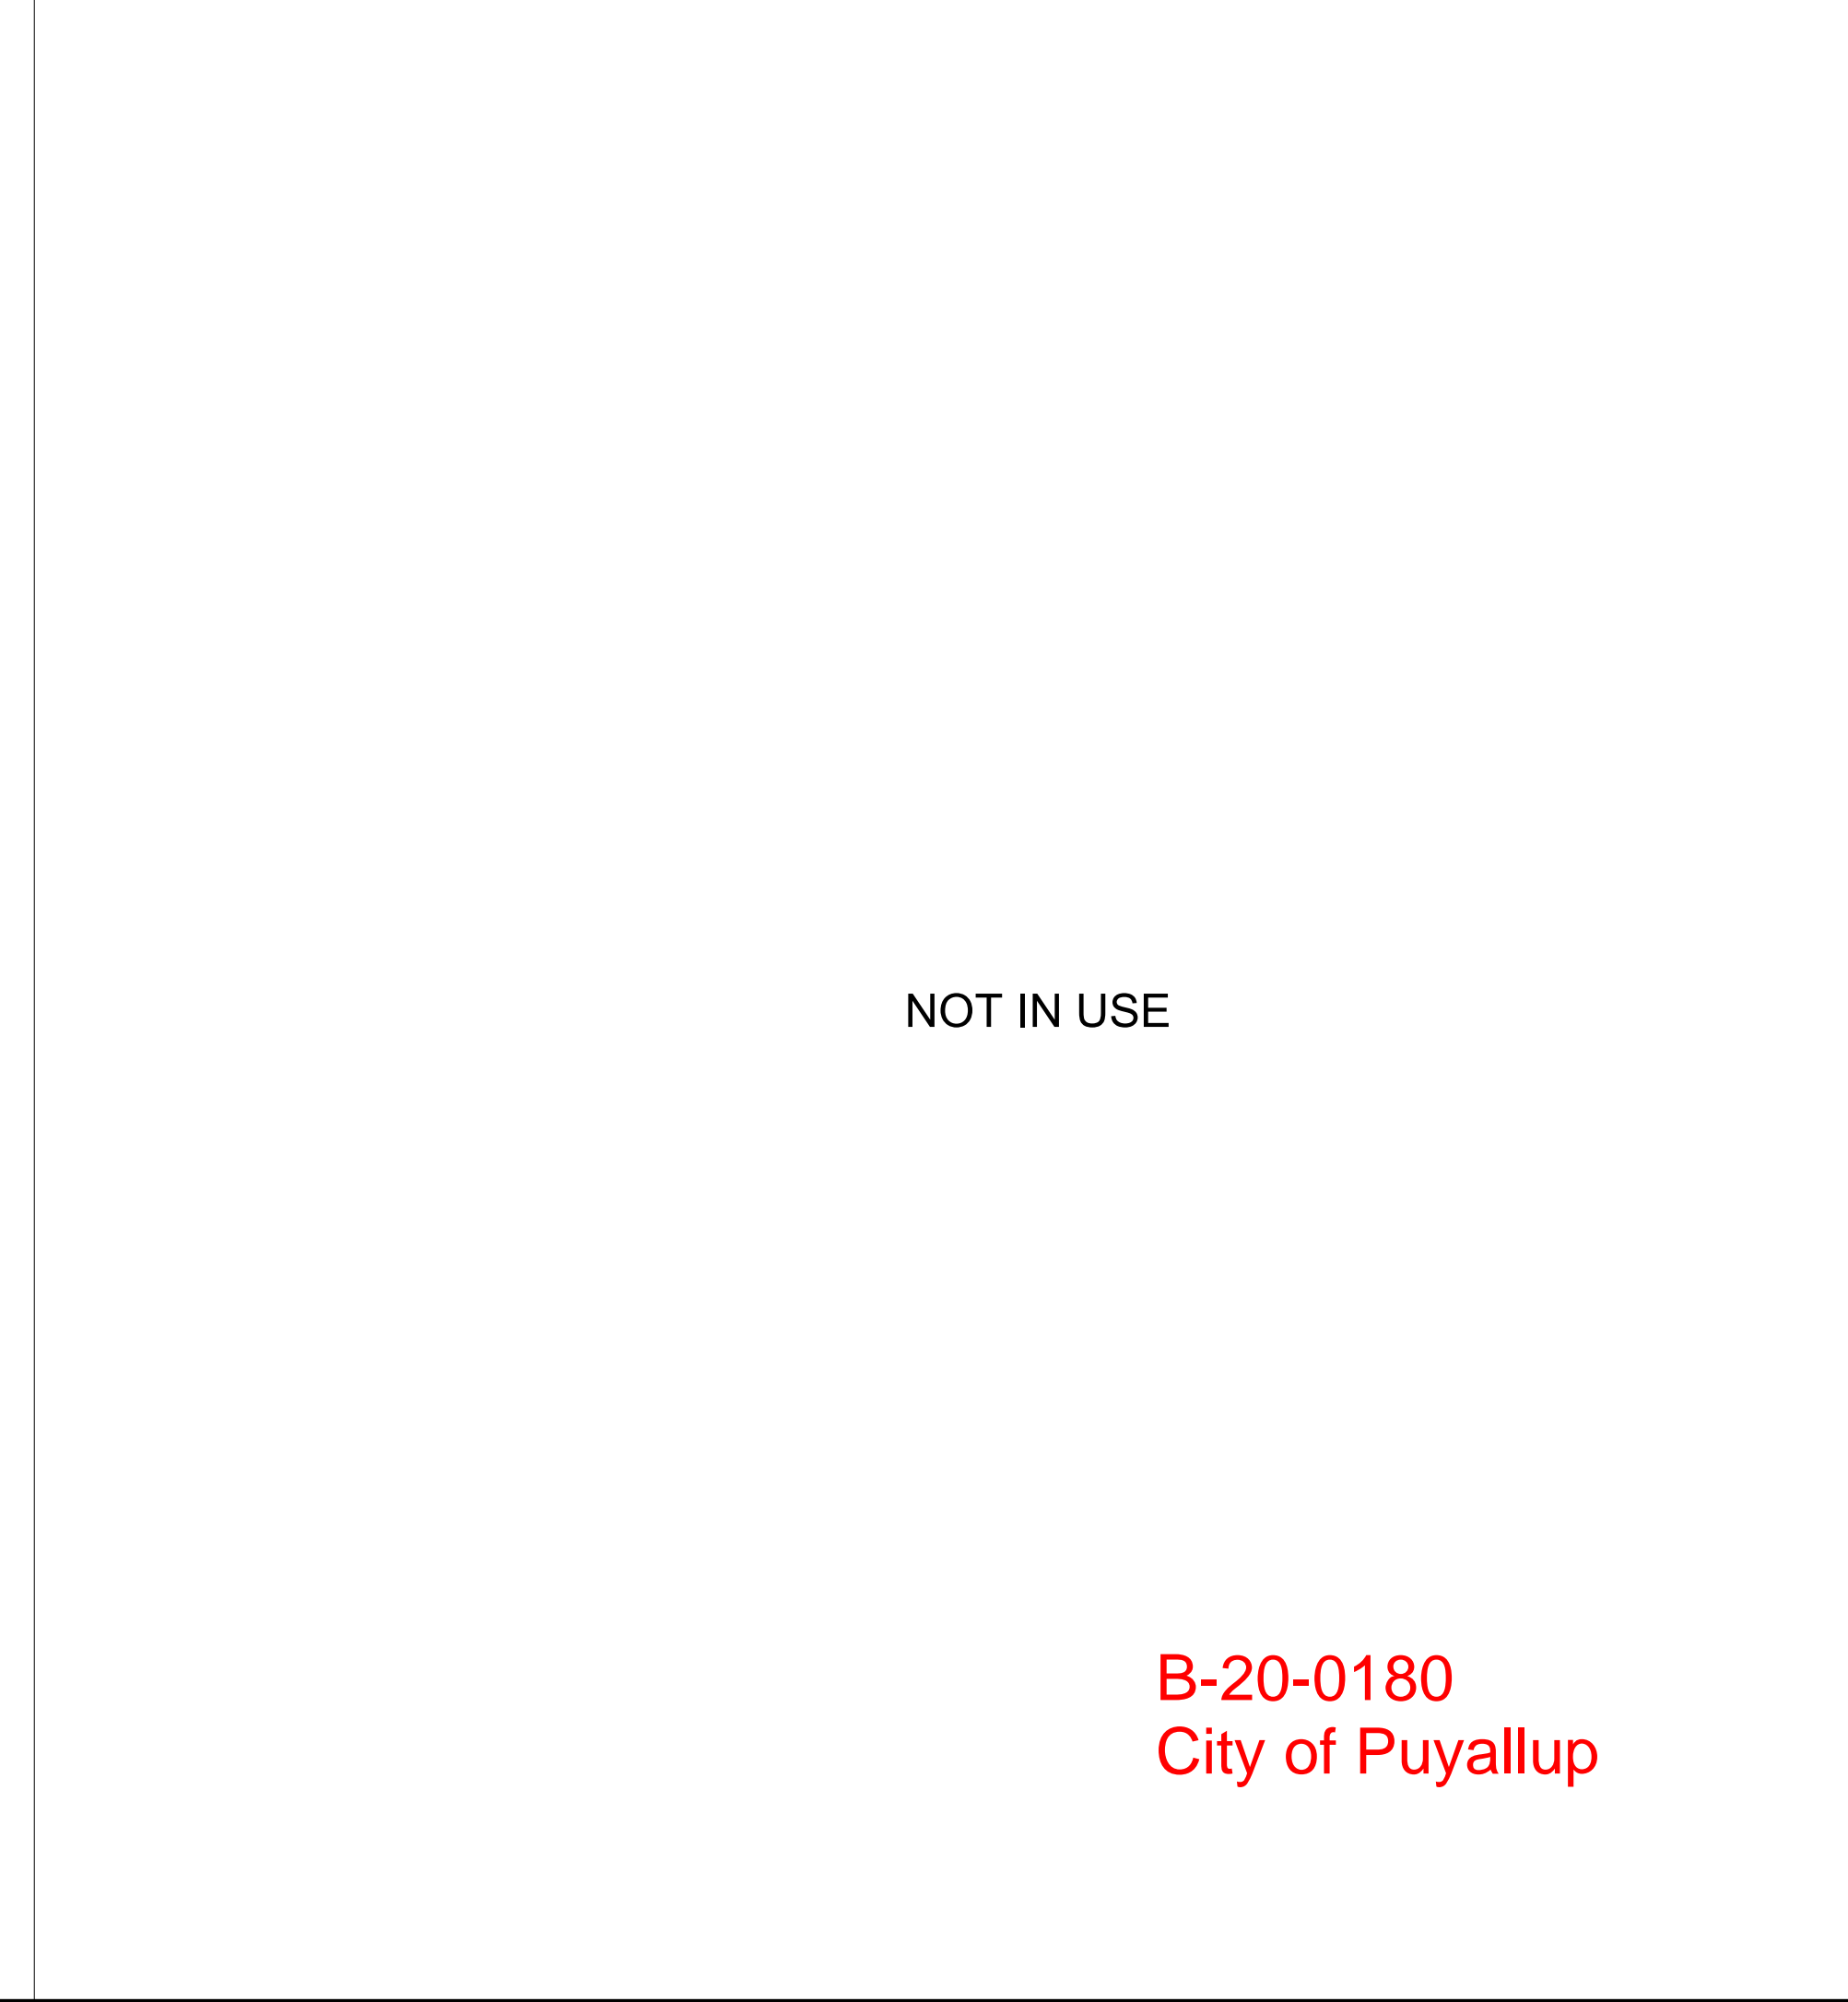
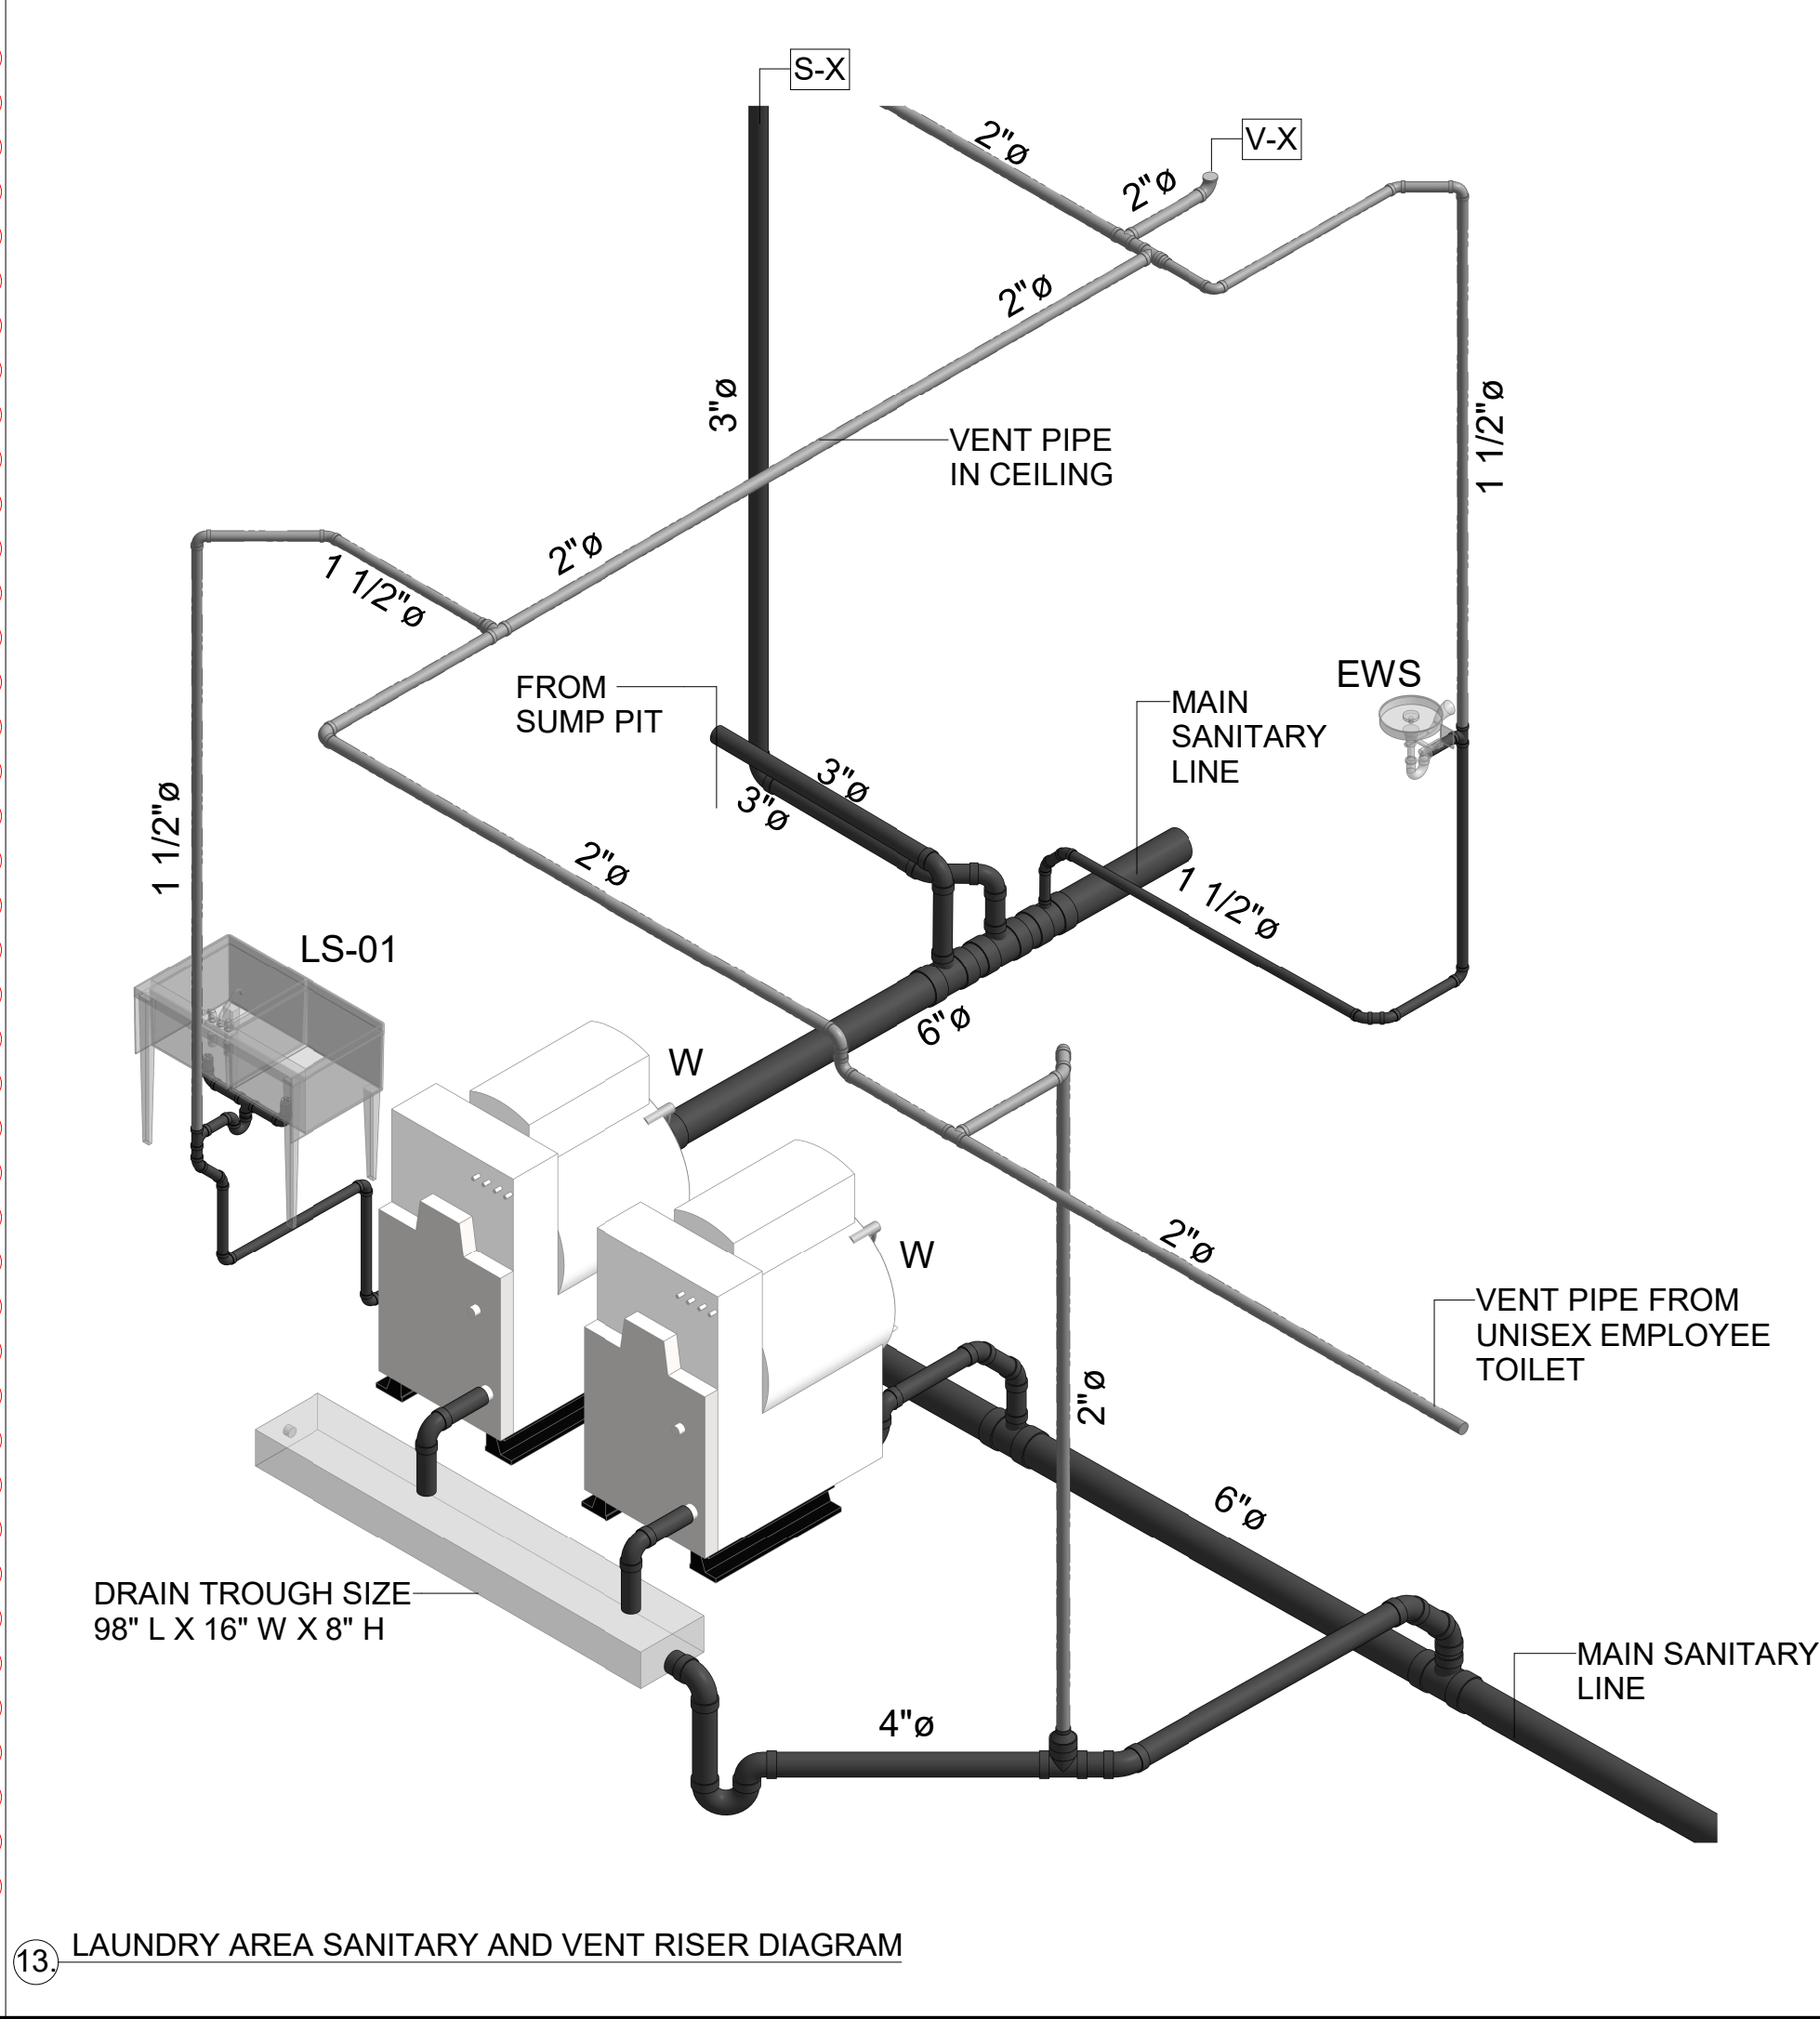
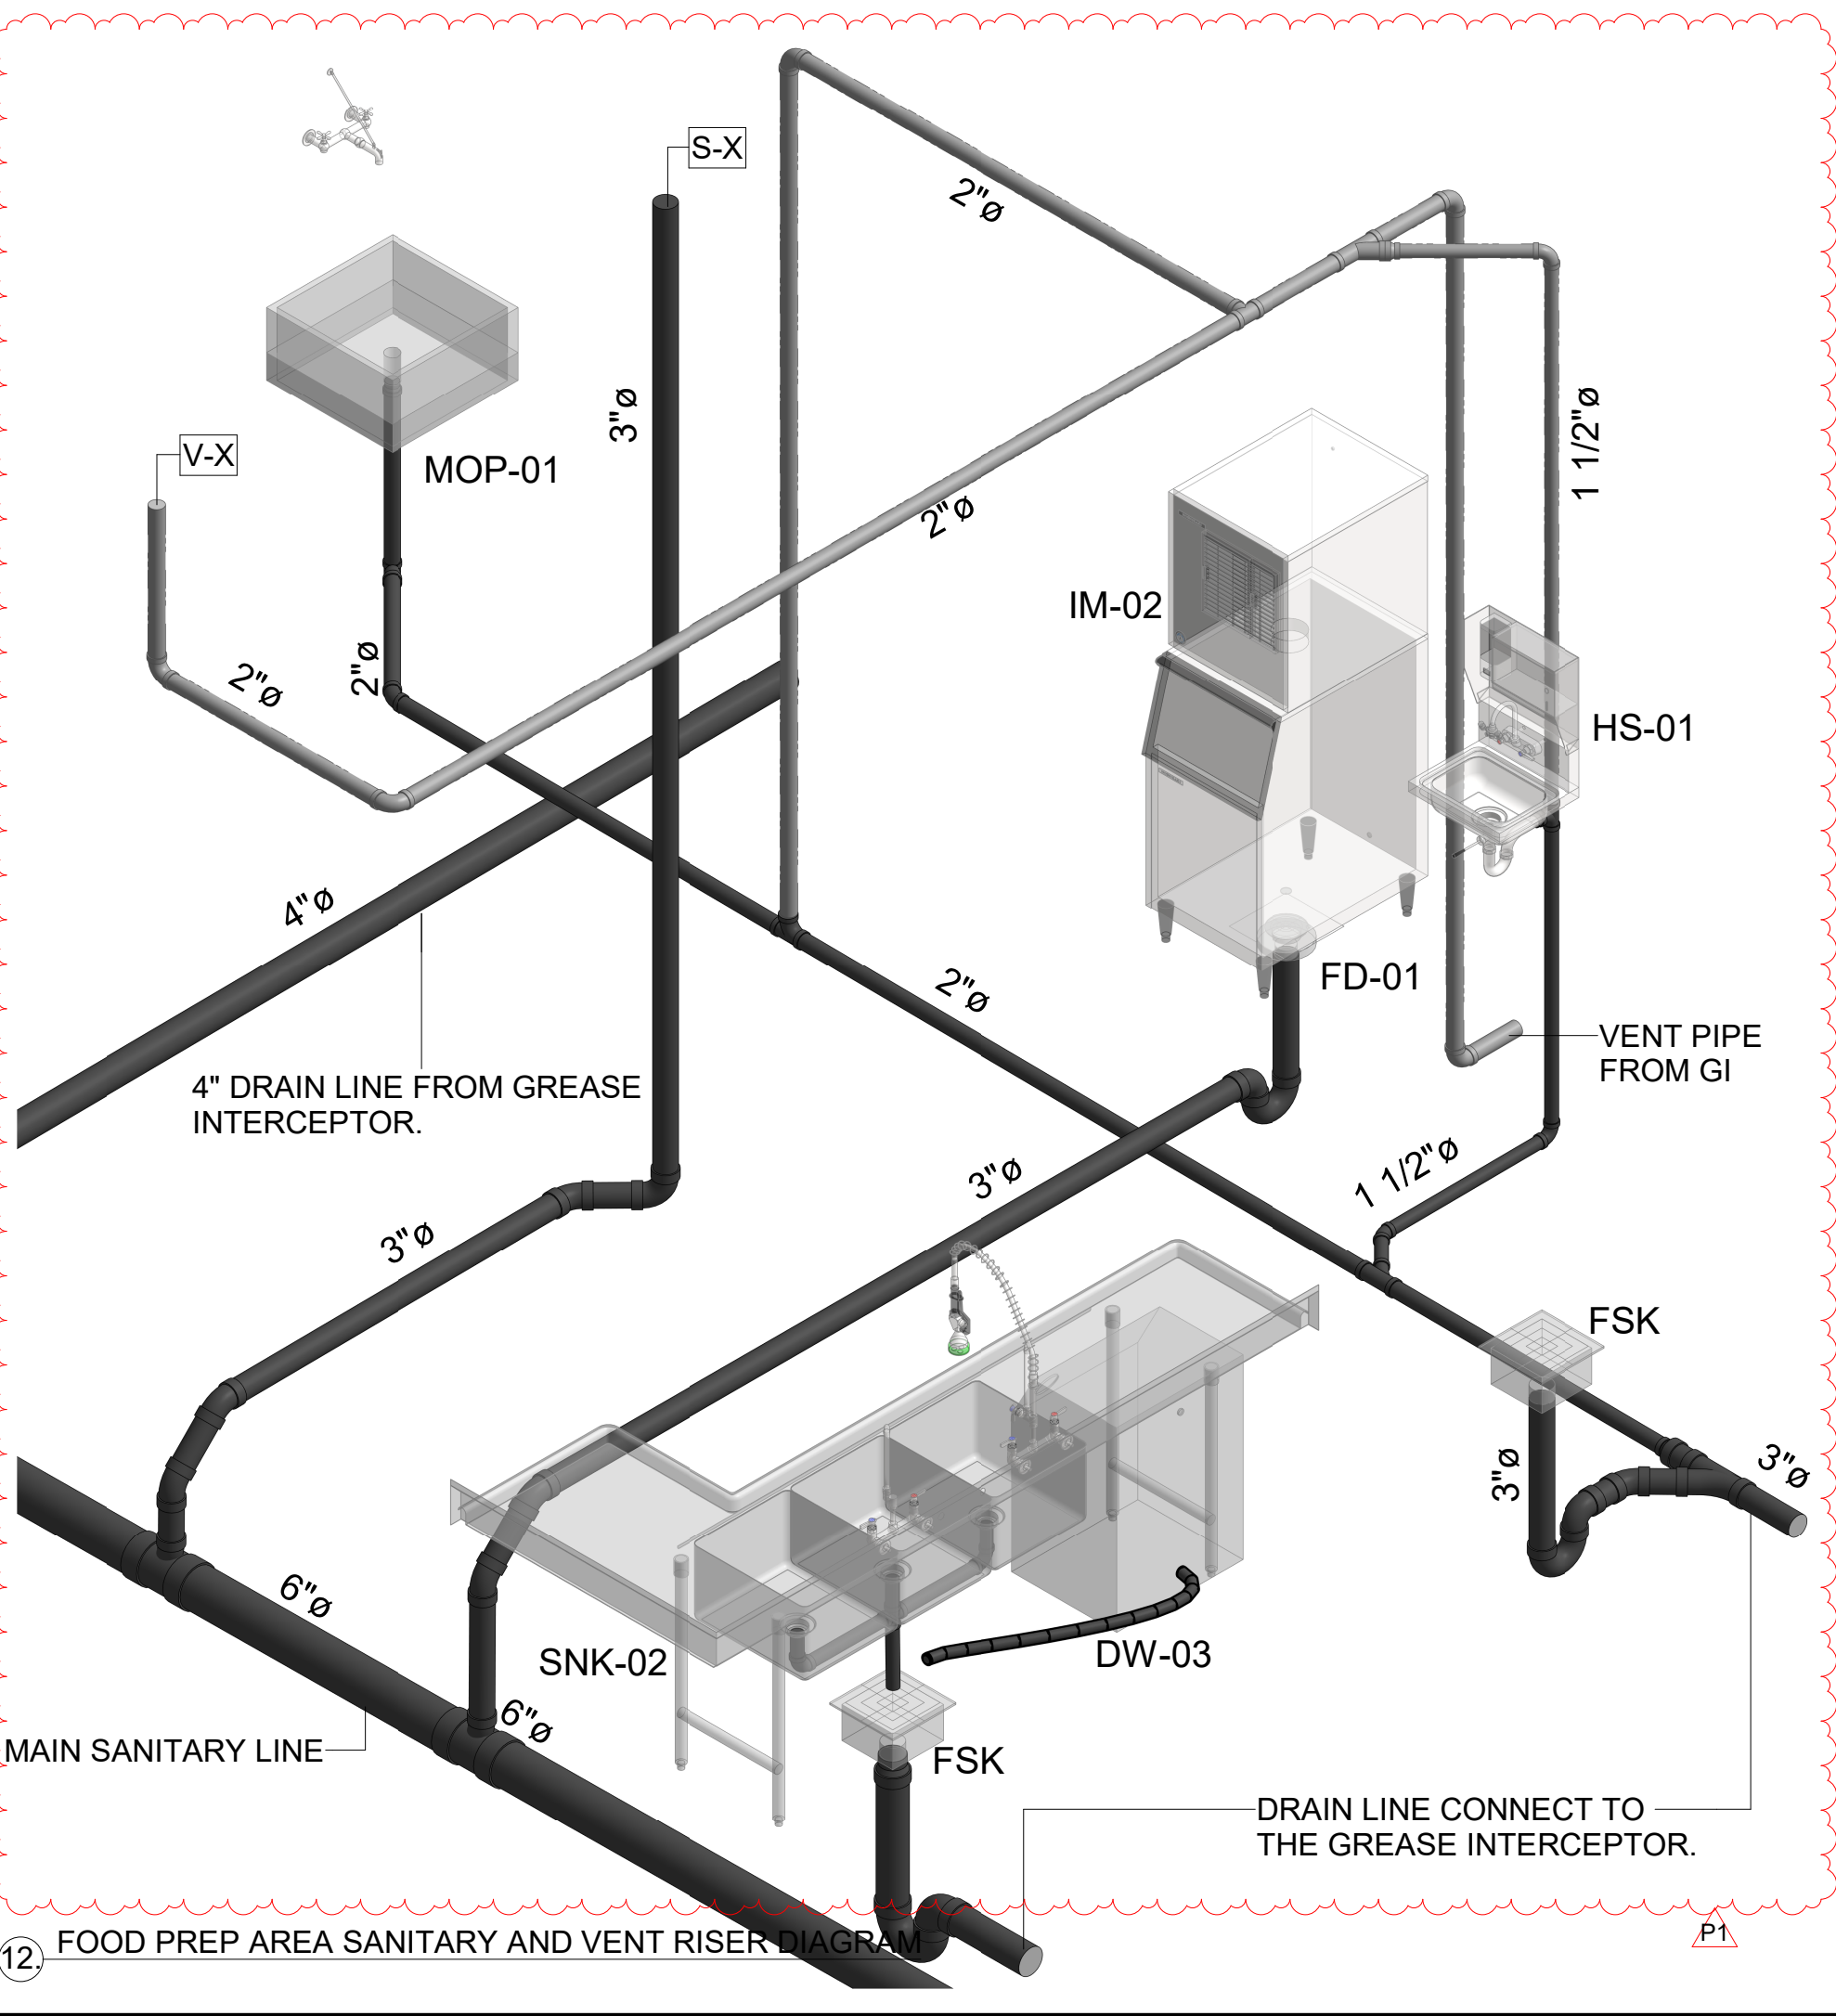
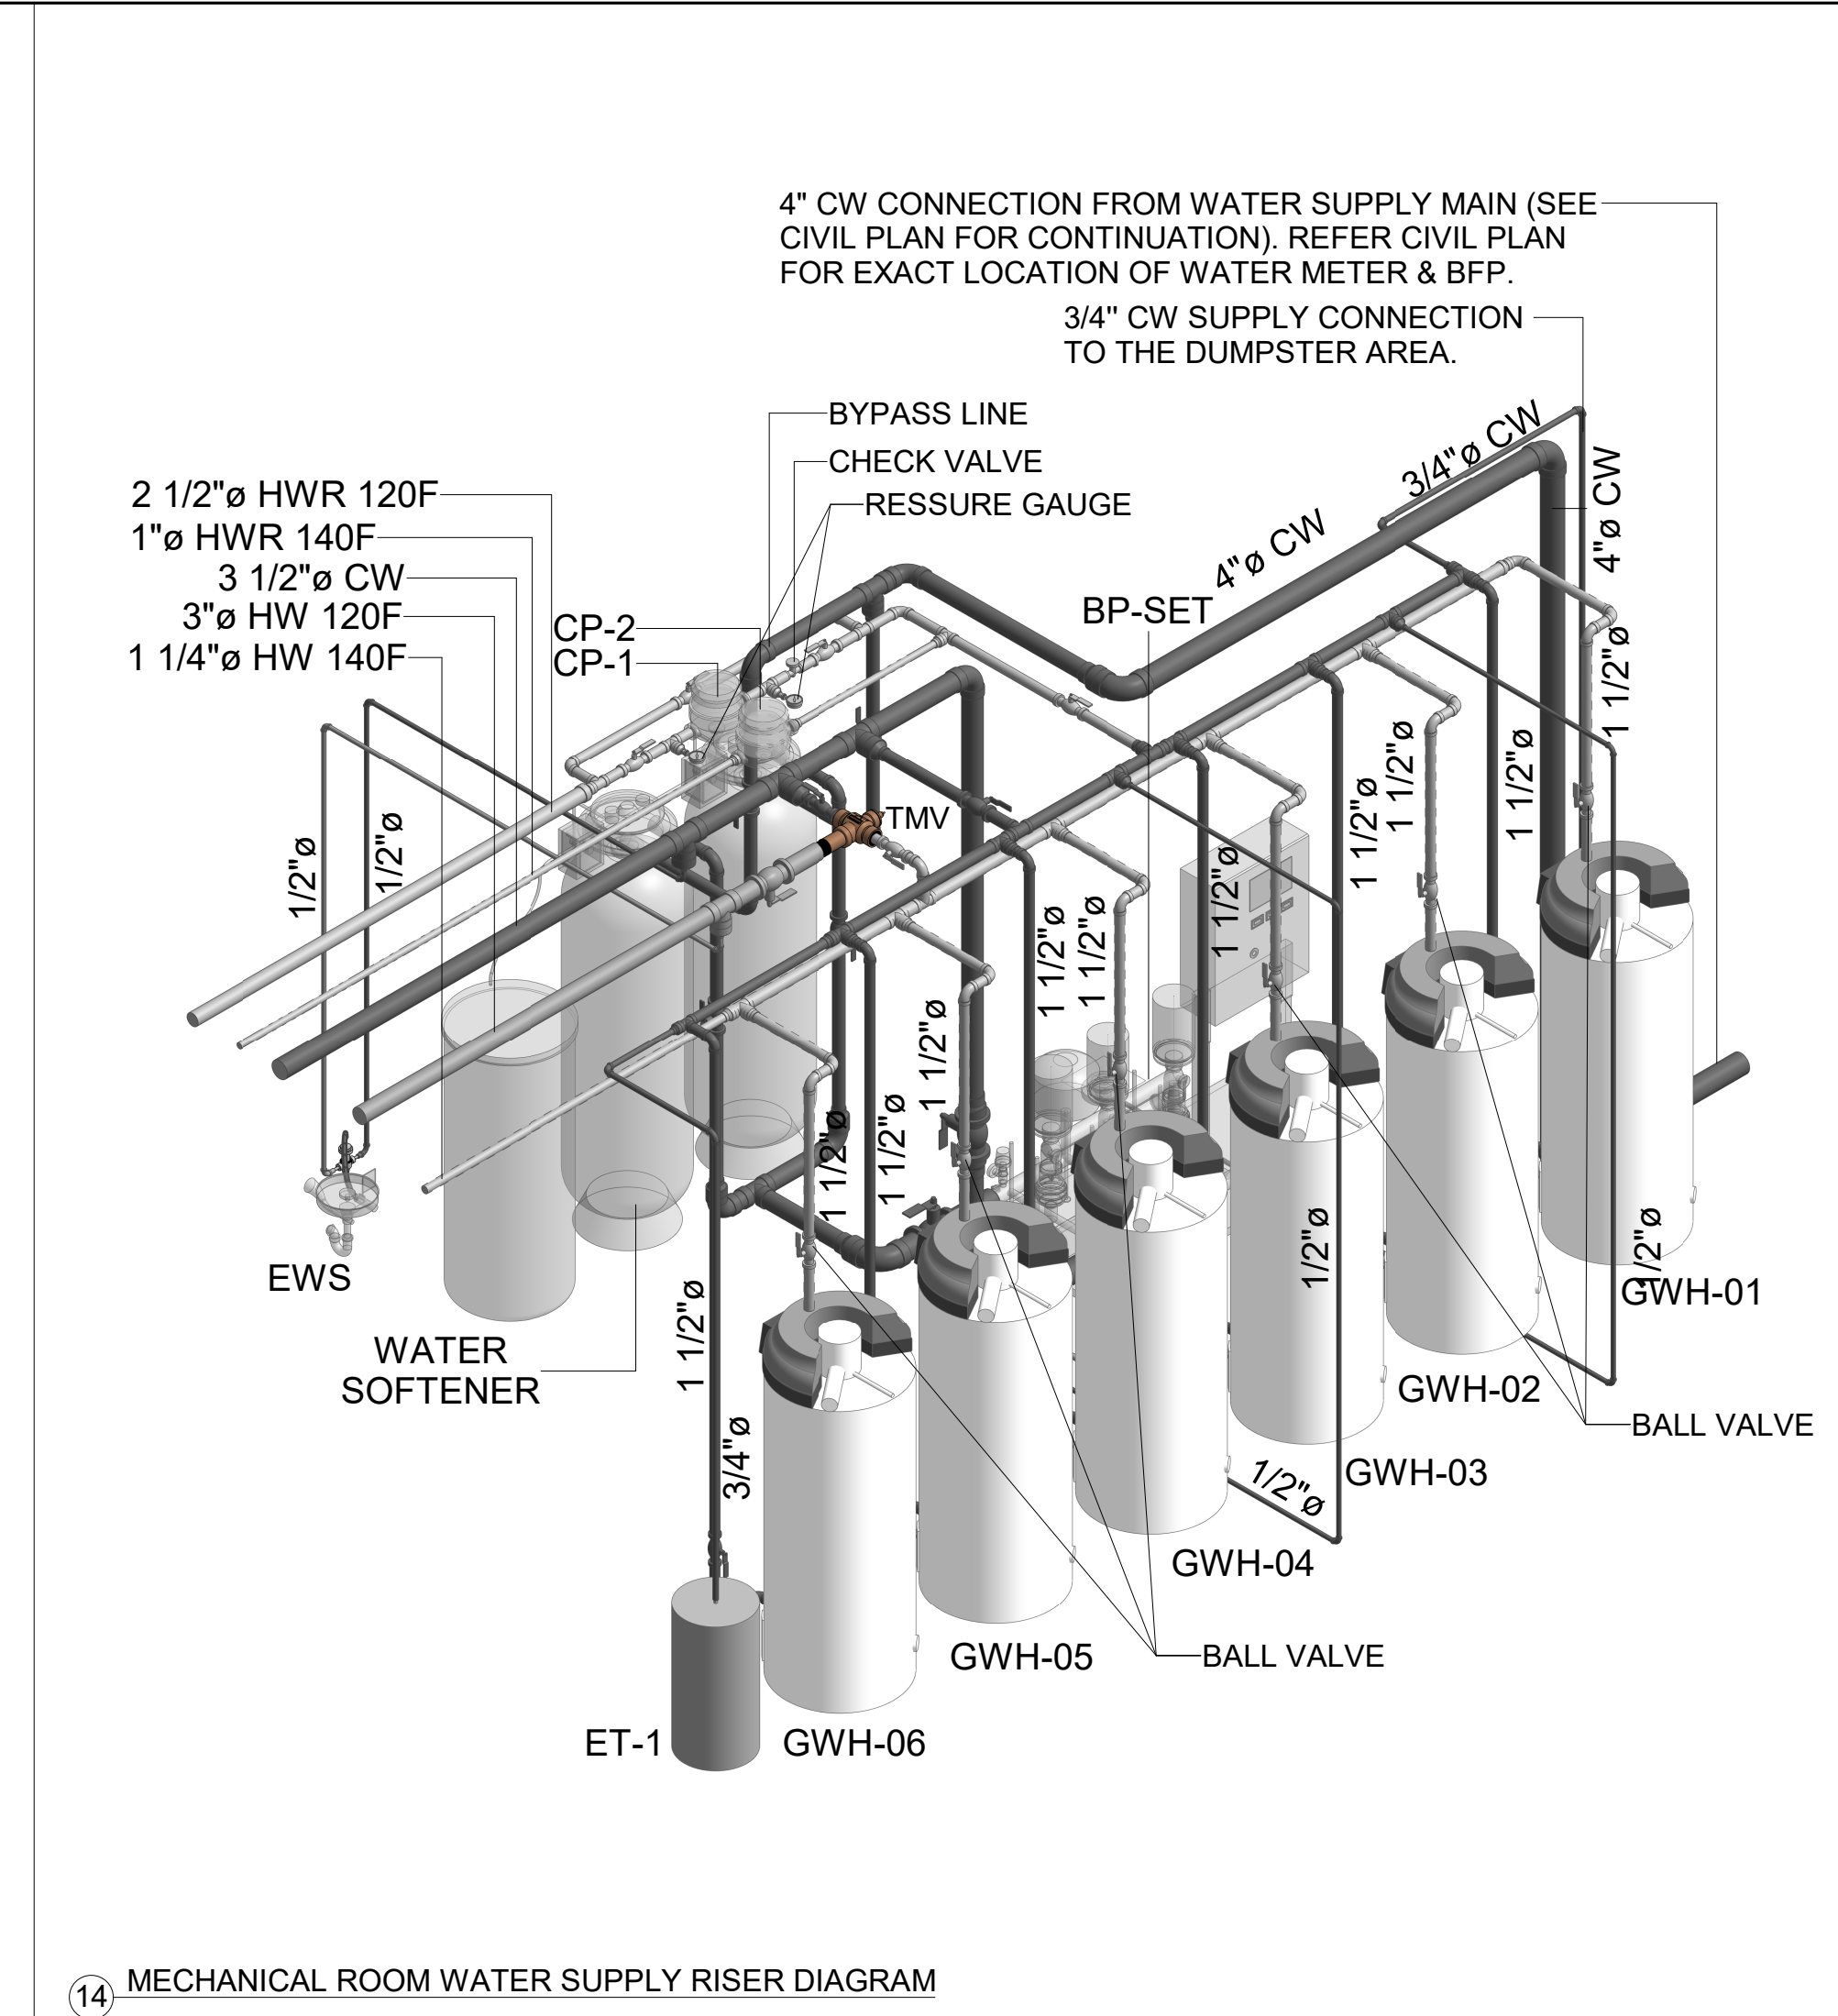
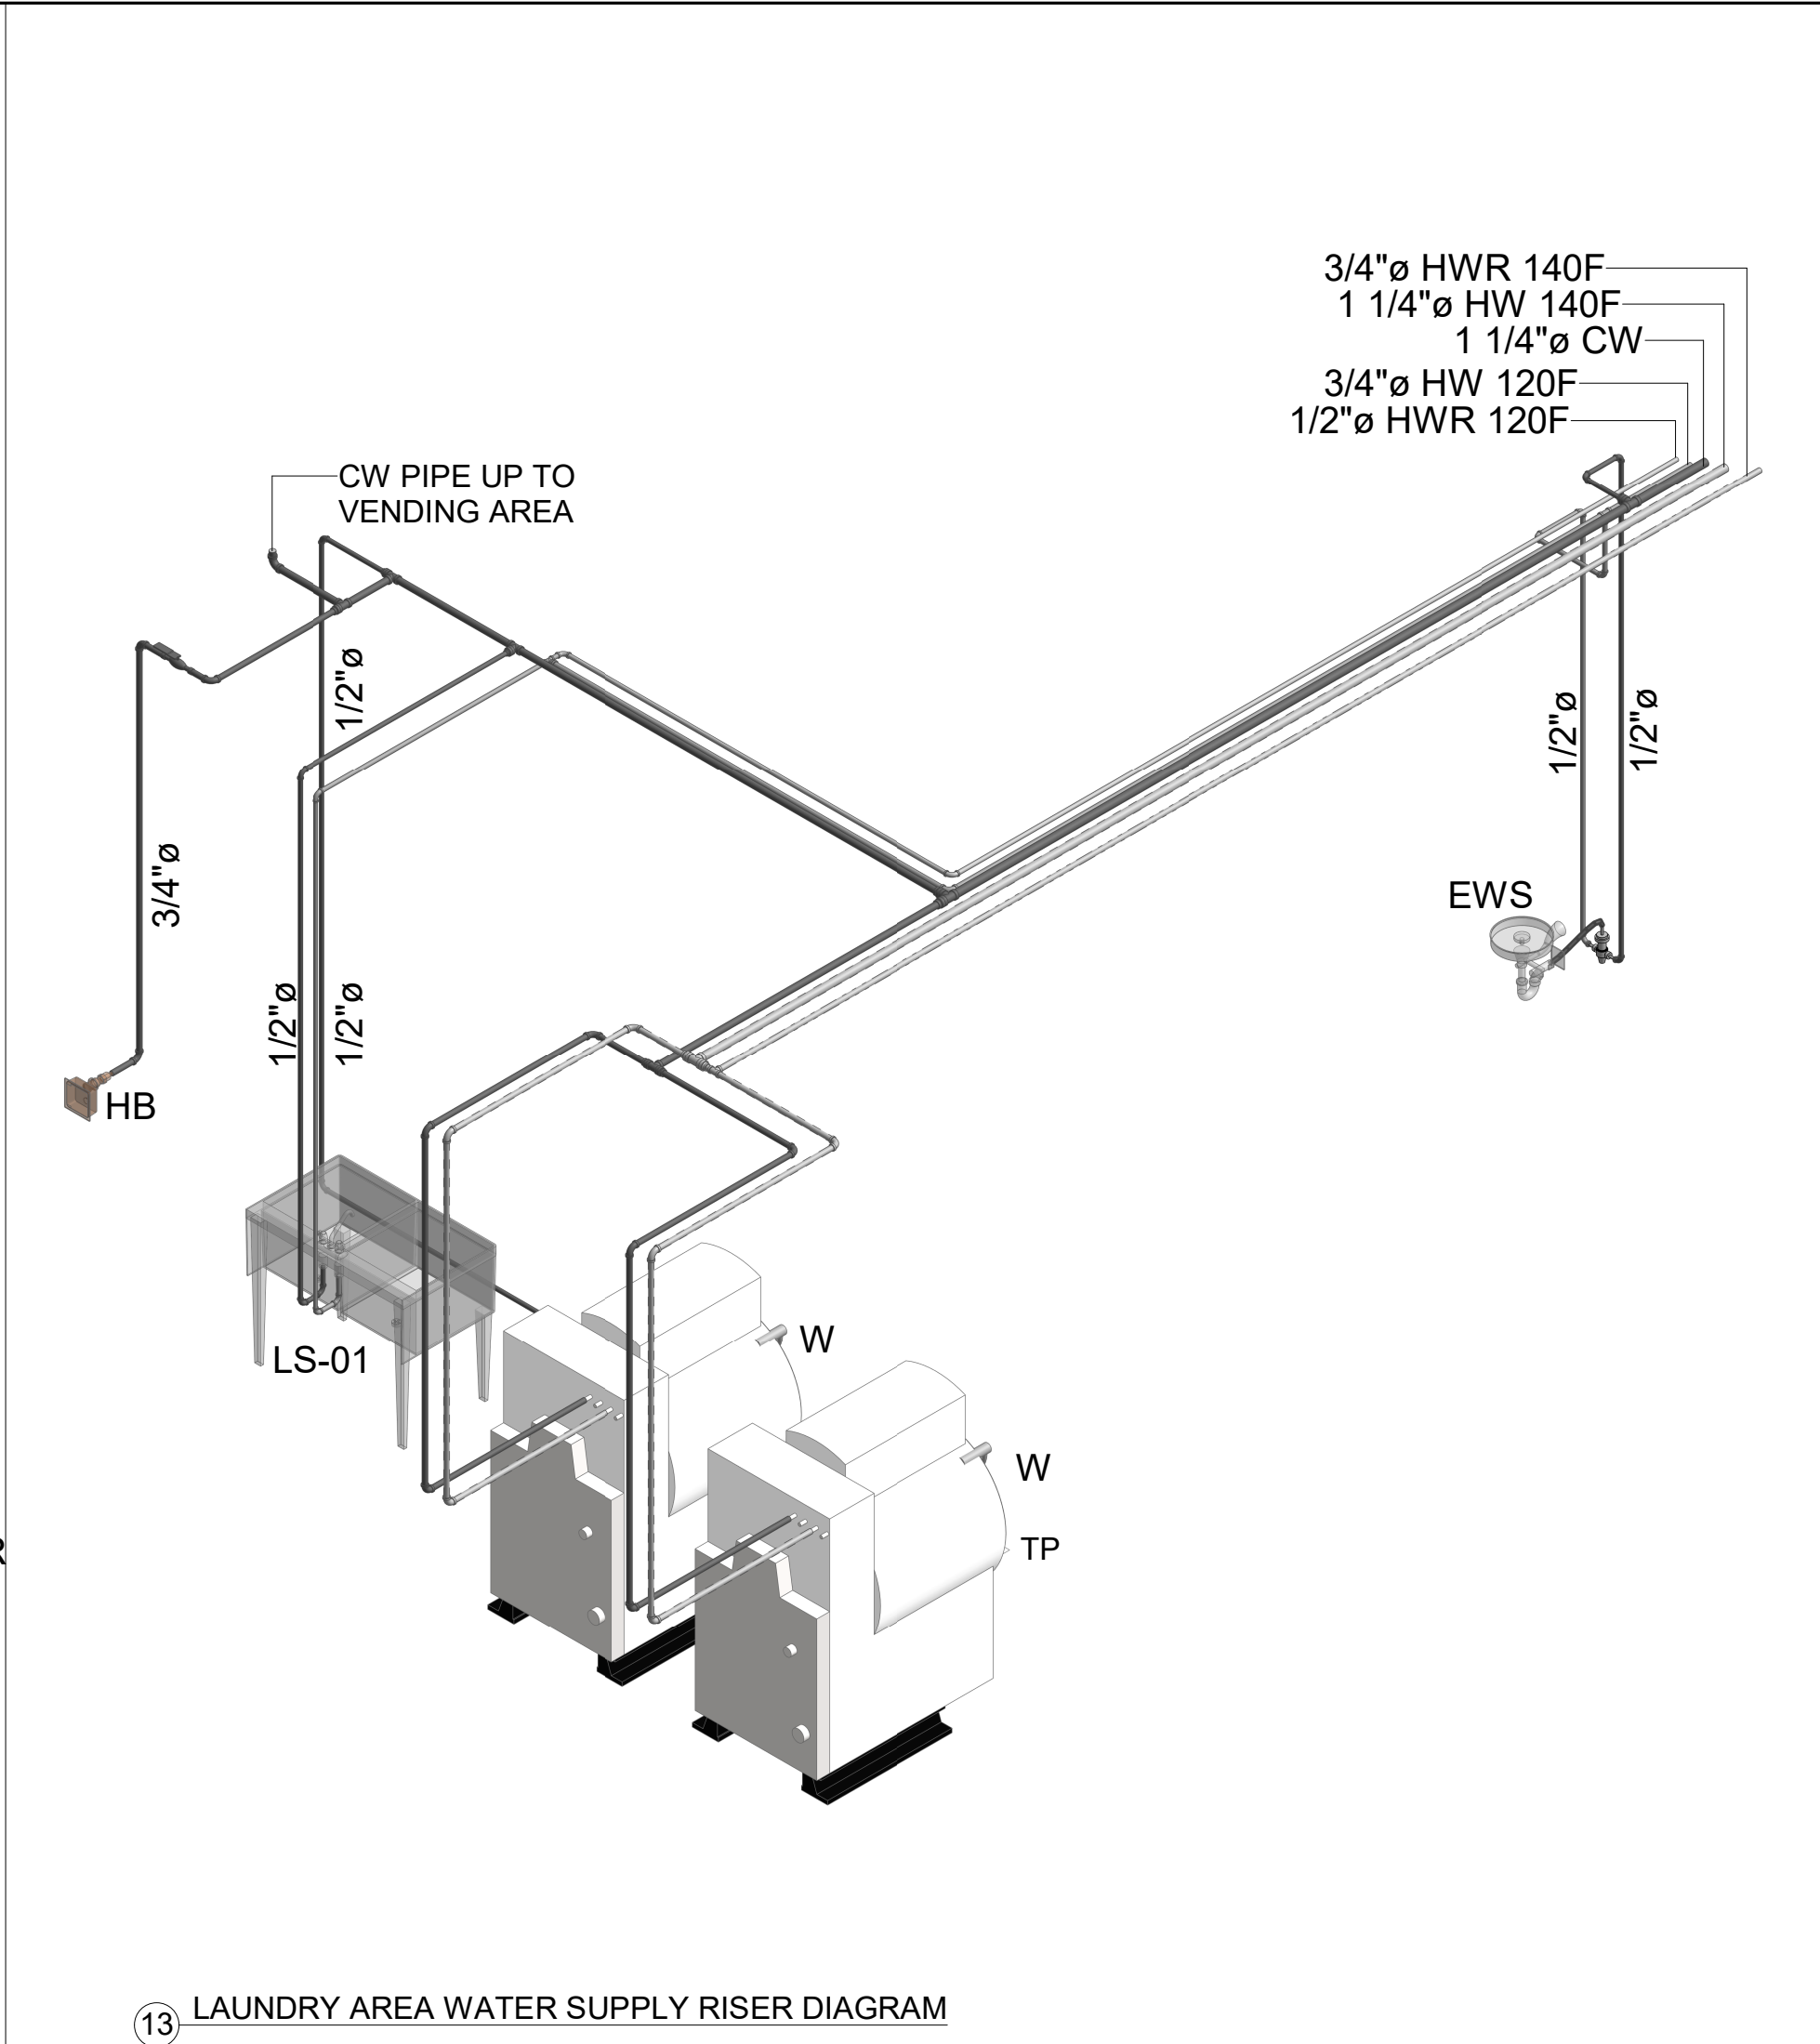
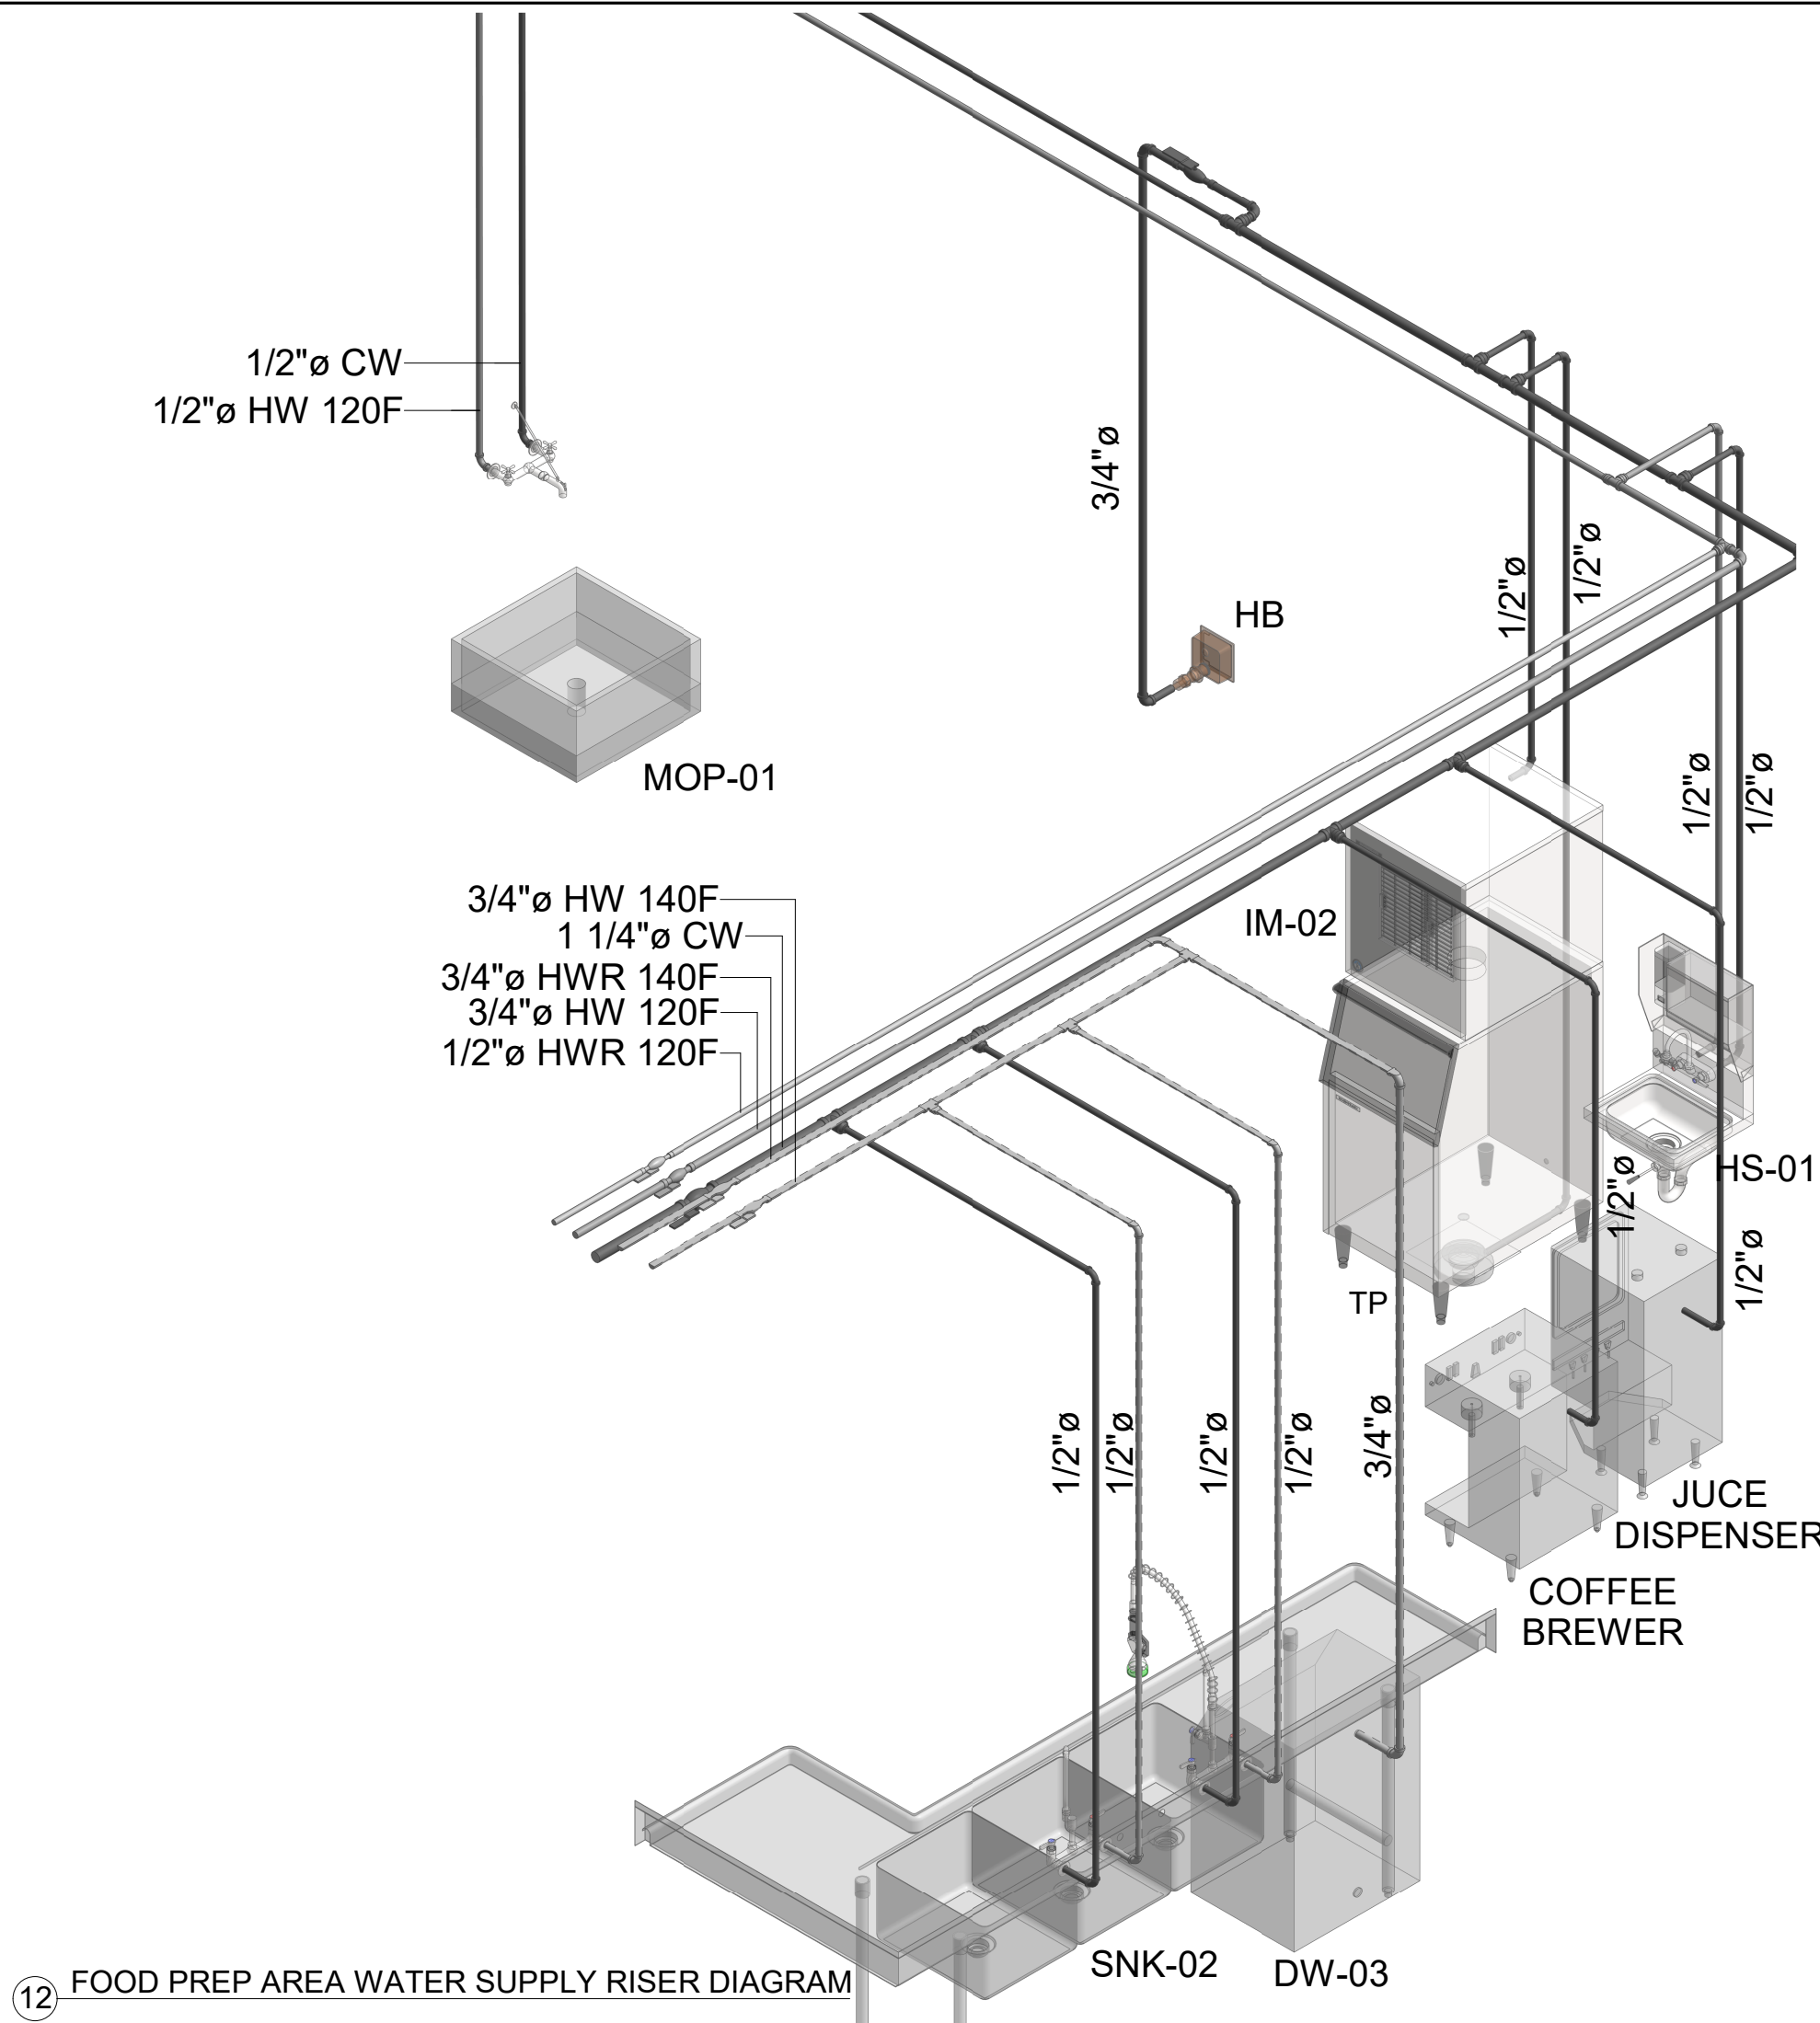
PROJECT NO.
B4-124-1803

SHEET NAME

UNIT SANITARY &
VENT RISER
DIAGRAM-B

DRAWINGS NO.


P-305B



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Seal:



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3500 S MERIDIAN, PUYALLUP, WA 98373
PROTOTYPE VERSION: V9.2 2014 FEB

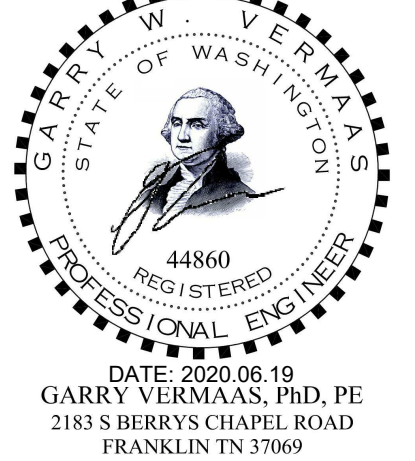ISSUE NO.	DELTA	ISSUE DATE	DESCRIPTION
2	P1	2020.06.03	ADDENDUM #1
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PROJECT NO.
B4-124-1803

SHEET NAME
UNIT WATER
SUPPLY &
SANITARY RISER
DIAGRAM

DRAWINGS NO.

P-306

NOT IN USE

B-20-0180
City of Puyallup



RICARDO J. MUNIZ-GUILLET, AIA
5453 NW 106TH DR
CORAL SPRINGS, FL 33076

Seal



**HOMEWOOD
SUITES**
BY HILTON™

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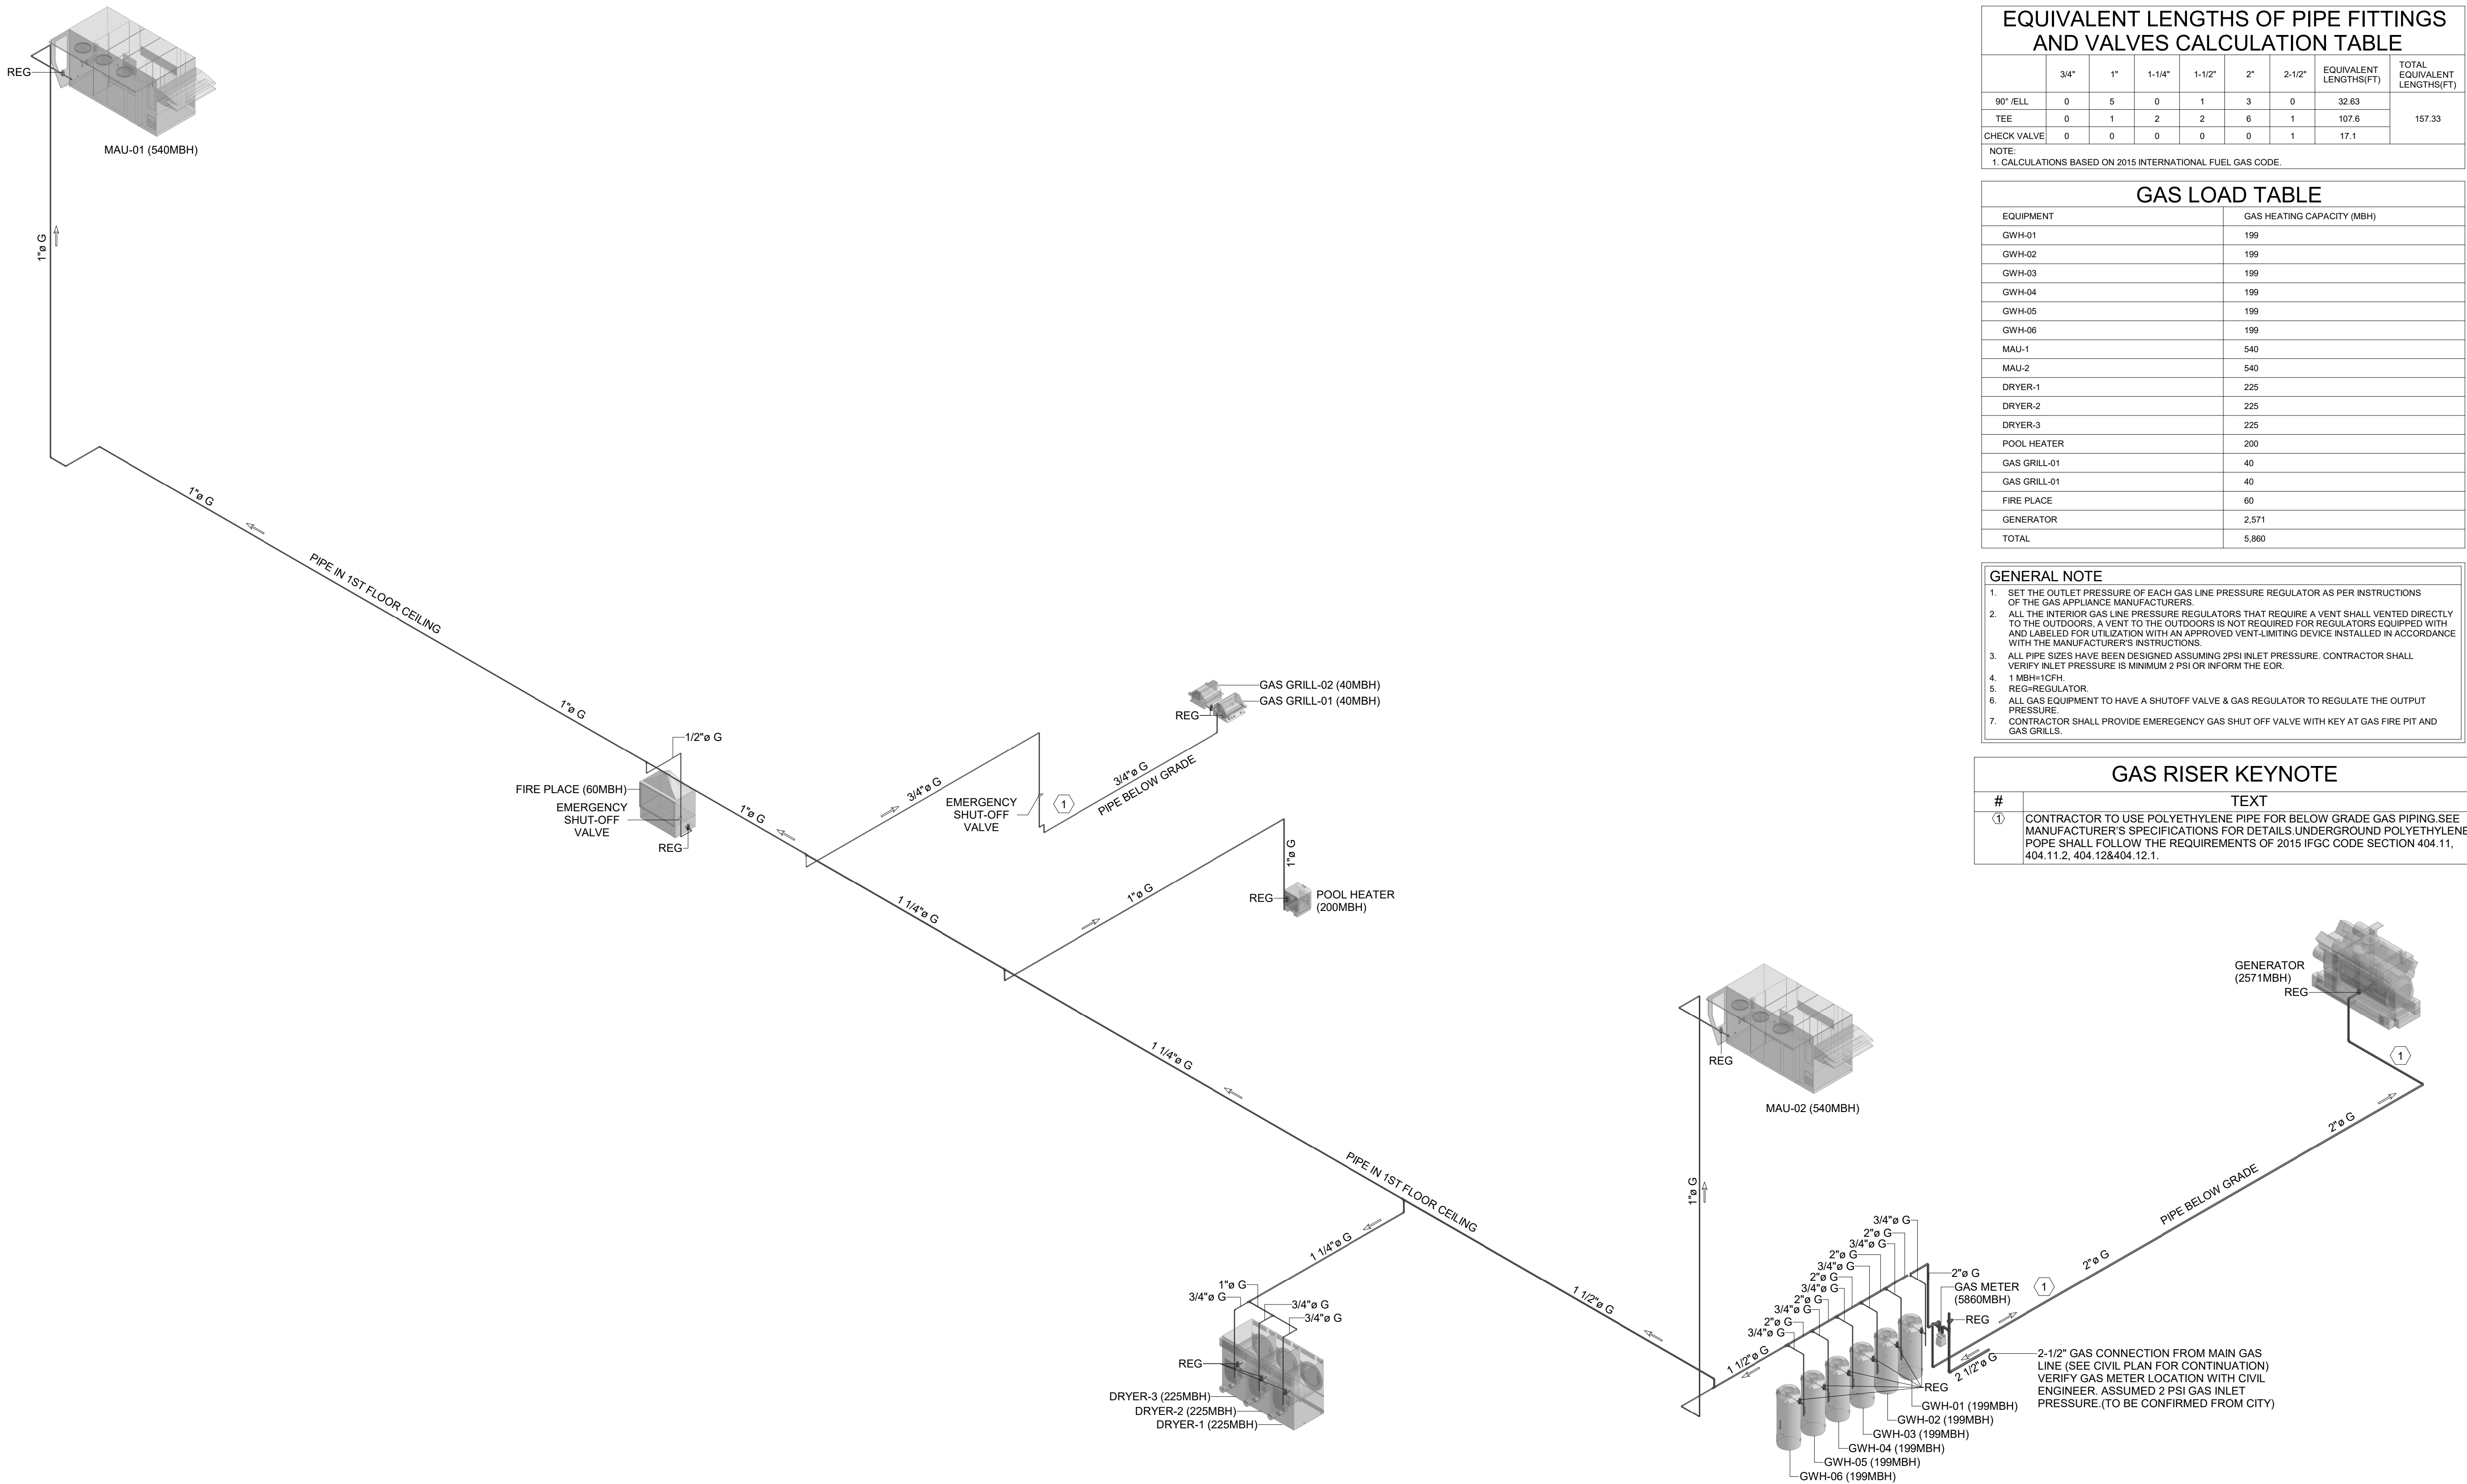
PROJECT NO. B4-124-1803

SHEET NAME

STORM WATER RISER DIAGRAM

DRAWINGS NO.

P-309



GAS SUPPLY CALCULATION TABLE

- PRESSURE DROP : 1.0 PSI FROM GAS METER TO EACH LINE REGULATOR.
 - PIPE MATERIAL : "SCHEDULE 40 METALLIC PIPE"
 - TOTAL LENGTH FROM MAU-01 TO GAS METER: 315 FT. SEE DIAGRAM DRAWING FOR SEGMENT LENGTH.
 - FITTINGS EQUIVALENT LENGTH: 157.33 FT.
 - EQUIVALENT TOTAL LENGTH (PLUS FITTING EQUIVALENT LENGTH): 472.33 FT.
- NOTE:
PIPING MATERIAL: SCHEDULE 40 METALLIC PIPE.
GAS: NATURAL. INLET PRESSURE: 2 PSI.
PRESSURE DROP: 1.0 PSI SPECIFIC GRAVITY: 0.80.
1. CALCULATIONS BASED ON 2015 INTERNATIONAL FUEL GAS CODE FROM TABLE 402.4(5)

EQUIVALENT LENGTHS OF PIPE FITTINGS AND VALVES CALCULATION TABLE

	3/4"	1"	1-1/4"	1-1/2"	2"	2-1/2"	EQUIVALENT LENGTHS(FT)	TOTAL EQUIVALENT LENGTHS(FT)
90°/ELL	0	5	0	1	3	0	32.63	157.33
TEE	0	1	2	2	6	1	107.6	
CHECK VALVE	0	0	0	0	0	1	17.1	

NOTE:
1. CALCULATIONS BASED ON 2015 INTERNATIONAL FUEL GAS CODE.

GAS LOAD TABLE


EQUIPMENT	GAS HEATING CAPACITY (MBH)
GWH-01	199
GWH-02	199
GWH-03	199
GWH-04	199
GWH-05	199
GWH-06	199
MAU-1	540
MAU-2	540
DRYER-1	225
DRYER-2	225
DRYER-3	225
POOL HEATER	200
GAS GRILL-01	40
GAS GRILL-01	40
FIRE PLACE	60
GENERATOR	2,571
TOTAL	5,860

GENERAL NOTE

- SET THE OUTLET PRESSURE OF EACH GAS LINE PRESSURE REGULATOR AS PER INSTRUCTIONS OF THE GAS APPLIANCE MANUFACTURERS.
- ALL THE INTERIOR GAS LINE PRESSURE REGULATORS THAT REQUIRE A VENT SHALL VENTED DIRECTLY TO THE OUTDOORS. A VENT TO THE OUTDOORS IS NOT REQUIRED FOR REGULATORS EQUIPPED WITH AND LABELED FOR UTILIZATION WITH AN APPROVED VENT LIMITING DEVICE INSTALLED IN ACCORDANCE WITH THE MANUFACTURER'S INSTRUCTIONS.
- ALL PIPE SIZES HAVE BEEN DESIGNED ASSUMING 2PSI INLET PRESSURE. CONTRACTOR SHALL VERIFY INLET PRESSURE IS MINIMUM 2 PSI OR INFORM THE EOR.
- 1 MBH=1CFH.
- REG=REGULATOR.
- ALL GAS EQUIPMENT TO HAVE A SHUTOFF VALVE & GAS REGULATOR TO REGULATE THE OUTPUT PRESSURE.
- CONTRACTOR SHALL PROVIDE EMERGENCY GAS SHUT OFF VALVE WITH KEY AT GAS FIRE PIT AND GAS GRILLS.

GAS RISER KEYNOTE

#	TEXT
①	CONTRACTOR TO USE POLYETHYLENE PIPE FOR BELOW GRADE GAS PIPING.SEE MANUFACTURER'S SPECIFICATIONS FOR DETAILS.UNDERGROUND POLYETHYLENE POPE SHALL FOLLOW THE REQUIREMENTS OF 2015 IFGC CODE SECTION 404.11, 404.11.2, 404.12&404.12.1.

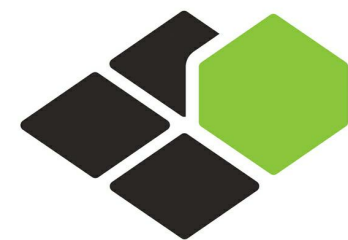


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PROJECT NO.
B4-124-1803

SHEET NAME

GAS SUPPLY RISER
DIAGRAM

DRAWINGS NO.

P-310

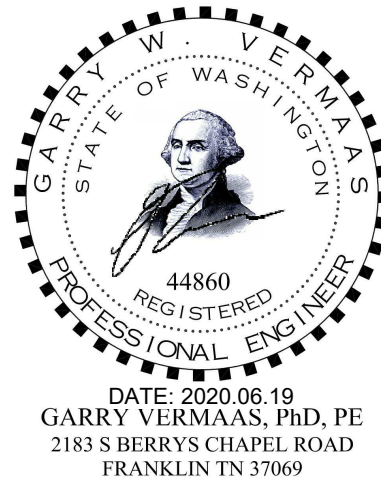PLUMBING FIXTURE SCHEDULE														
DWG MARK	FIXTURE TYPE	MANUFACTURER	MODEL	DESCRIPTION	FITTING MODEL & DESCRIPTION						WATER SUPPLY		SANITARY & VENT	
					TRIM & VALVE	SEAT	FAUCET	DRAIN	SHOWER HEAD	MISCELLANEOUS	CW	HW	WASTE/SOIL	VENT
SHR-01	SHOWER IN GUESTROOM BATHROOM	MINCEY MARBLE	SP-3460-C/SF	STANDARD RECTANGLE SHOWER PAN, CENTER DRAIN, SIZE-34" X 60". DRAIN OPENING-3-1/4" HOLE WIDTH, FLANGE-1" ATTACHED AT FACTORY, CURB-INTEGRAL L-3W X 3 1/2"H, MATERIAL MINCEY CLASSIC.	KOHLER, VALVE TRIM, MODEL: K-PLS15601-4-CP CHROME	-	-	K-9132-CP	KOHLER K-72419-CP SHOWERHEAD	-	1/2"	1/2"	2"	-
SHR-02	ROLL-IN SHOWER IN ADA GUESTROOM	MINCEY MARBLE	SP-3162-C/SF	62" x 31" x 1-1/2" SOLID ONE PIECE CONSTRUCTION SHOWER PAN ADA COMPLIANT ROLL-IN SHOWER PAN WITH A CENTER DRAIN AND A LIGHTLY TEXTURED WITH NON-SLIP FLOOR.	KOHLER, VALVE TRIM, MODEL: K-PLS15601-4-CP CHROME	BOBBICK FOLDING SHOWER SEAT WITH PADDED CUSHION, MODEL-B-517.518	-	K-9132-CP	KOHLER K-72419-CP SHOWERHEAD KOHLER K-22166-G HANDSHOWER	-	1/2"	1/2"	2"	-
TUB-01	BATH TUB IN GUESTROOM BATHROOM	KOHLER	K-715-Q(L) OR K-716-Q(R)	CAST IRON WITH SAFEGUARD® FINISH, INTEGRAL APRON, LEFT OR RIGHT DRAIN, 60"(1524 MM) X 30-1/4"(768 MM) X 14 "(356MM).	KOHLER, VALVE TRIM, MODEL: K-PLS15601-4-CP CHROME	-	-	WATCO 900-BN BATH TUB DRAIN	KOHLER K-72419-CP SHOWERHEAD	-	1/2"	1/2"	2"	-
TUB-02	BATH TUB IN ADA GUESTROOM BATHROOM	KOHLER	K-715-Q(L) OR K-716-Q(R)	CAST IRON WITH SAFEGUARD® FINISH, INTEGRAL APRON, LEFT OR RIGHT DRAIN, 60"(1524 MM) X 30-1/4"(768 MM) X 14 "(356MM).	KOHLER, VALVE TRIM, MODEL: K-PLS15601-4-CP CHROME	ACCESSIBLE PORTABLE/SECURED BATH SEAT, PHENOLIC, MODEL NO. WHPTB265150PW	-	WATCO 900-BN BATH TUB DRAIN	KOHLER K-72419-CP SHOWERHEAD KOHLER K-22166-G HANDSHOWER	-	1/2"	1/2"	2"	-
LAV-01	LAVATORY IN GUEST & ADA GUESTROOM BATHROOM	KOHLER	CAXTON K-2210	"VITREOUS CHINA UNDER MOUNT LAVATORY WITH OVERFLOW DRAIN AND CLAMP ASSEMBLY" BOWL: L-19 1/4"-H-10 3/4", W16 1/4" (FITS STANDARD 14" X 17" INCH COUNTERTOP CUTOUT).	-	-	-	KOHLER WIDESPREAD BATHROOM SINK FAUCET, K-15261-4RA	-	-	1/2"	1/2"	1-1/2"	1-1/2"
LAV-02	LAVATORY IN MEN'S & WOMEN'S TOILET	KOHLER	CAXTON K-2210	"VITREOUS CHINA UNDER MOUNT LAVATORY WITH OVERFLOW DRAIN AND CLAMP ASSEMBLY" BOWL: L-19 1/4"-H-10 3/4", W16 1/4" (FITS STANDARD 14" X 17" INCH COUNTERTOP CUTOUT).	-	-	-	KOHLER GEOMETRIC INSIGHT™ TOUCHLESS, K-7516 SINGLE-HOLE TOUCHLESS BATHROOM SINK FAUCET	-	-	1/2"	1/2"	1-1/2"	1-1/2"
LAV-03	LAVATORY IN UNISEX TOILET	KOHLER	BRENHAM™ K-1997-1	WALL MOUNT BATHROOM SINK WITH OVERFLOW DRAIN INCLUDES WALL HANGER VITREOUS CHINA, WHITE (SIZE:21-15/16" X 19-3/4").	-	-	-	KOHLER GEOMETRIC INSIGHT™ TOUCHLESS, K-7516 SINGLE-HOLE TOUCHLESS BATHROOM SINK FAUCET	-	-	1/2"	1/2"	1-1/2"	1-1/2"
WCL-01	WATER CLOSET TANK TYPE GUESTROOM BATHROOM	AMERICAN STANDARD	215CA-104	"CADET PRO" ELONGATED FLOOR MOUNTED, VITREOUS CHINA, HIGH EFFICIENCY TOILET (HET), ULTRA-LOW CONSUMPTION. DIMENSION : 30-1/8"X17-3/8"X28-7/8", COLOR: WHITE.	-	SEAT: #5321.110 EVERCLEAN® ELONGATED SEAT WITH SLOW CLOSE SNAP-OFF HINGES	-	-	-	-	1/2"	-	3"	2"
WCL-02	WATER CLOSET TANK TYPE ADA GUESTROOM BATHROOM	AMERICAN STANDARD	215AA-104	"CADET PRO" ELONGATED FLOOR MOUNTED, VITREOUS CHINA, HIGH EFFICIENCY TOILET (HET), ULTRA-LOW CONSUMPTION. DIMENSION : 30-1/8" X 17-3/8" 300-3/8", COLOR: WHITE.	-	SEAT: #5321.110 EVERCLEAN® ELONGATED SEAT WITH SLOW CLOSE SNAP-OFF HINGES	-	-	-	-	1/2"	-	3"	2"
WCL-03	WATER CLOSET FLOOR MOUNTED (FLUSHOMETER) FOR PUBLIC TOILET	AMERICAN STANDARD	3461.001	VITREOUS CHINA, FLOOR MOUNT FLUSHOMETER VALVE TOILET, HIGH EFFICIENCY, LOW CONSUMPTION, OPERATES IN THE RANGE OF 1.1 GPF TO 1.6 GPF (4.2 LPT TO 6.0 LPT) HIGH EFFICIENCY FLUSH VALVE (1.28 GPF OR 1.6/1.1 GPF DUAL FLUSH) 10"X12" WATER SURFACE AREA, 28-1/4"X14"X16-1/2" COLOR:WHITE.	-	AMERICAN STANDARD, 5901.100.020OPEN FRONT W/NO COVER, WHITE	AMERICAN STANDARD 6047.161.002 1.6GPF	-	-	1"	-	-	3"	2"
SNK-01	SINK IN GUEST & ADA GUESTROOM	KOHLER	UCL 1515	RECTANGULAR BOWL, NO FAUCET HOLES, REQUIRES WALL-OR COUNTER-MOUNT FAUCET, LUSTER BOWL FINISH, 14-1/4" X 11-3/4" X 7".	-	-	-	KOHLER CORALAIS KITCHEN SINK FAUCET, K-P15175-P	-	-	1/2"	1/2"	1-1/2"	1-1/2"
SNK-02	3-COMPARTMENT SINK IN FOOD PREP.	ADVANCE TABCO	94-3-54-18RL	THREE COMPARTMENT POT SINK WITH TWO DRAINBOARDS STAINLESS STEEL OF TOTAL LENGTH 91" AND A BOWL SIZE OF 20" X 16"X 14".	-	-	-	T&S BRASS AND BRONZE WORKS, INC. FAUCET MODEL: B-0133-BR, B-0231-EE	-	-	1/2"	1/2"	1-1/2"	1-1/2"
SNK-03	2-COMPARTMENT SINK IN BREAK ROOM	ADVANCE TABCO	DI-2-10	TWO COMPARTMENT DROP-IN SINK FEATURES A DEEP DRAWN ONE-PIECE BOWL DESIGN, 20 GAUGE, TYPE 304 STAINLESS STEEL (2) 10" X 14" X 10" BOWLS.	-	-	-	-	-	-	1/2"	1/2"	1-1/2"	1-1/2"
HS-01	HAND SINK IN FOOD PREP.	ADVANCE TABCO	7-PS-87	HAND SINK WITH SOAP DISPENSER, MADE OF 20 GAUGE 304 STAINLESS STEEL, OVERALL DIMENSIONS: 17 1/4" X 15 1/4" X 26 1/2".	-	-	-	-	-	-	1/2"	1/2"	1-1/2"	1-1/2"
LS-01	2-COMPARTMENT SINK IN LAUNDRY	MUSTEE	27F	OVERALL 34" X 40" X 24", 19 GALLON CAPACITY PER TUB, EXTRA DEEP 13" TUBS WITH SMOOTH SURFACES, ACCOMMODATES SINGLE OR DUAL-HANDLE FAUCETS, 4" OR 6" CENTERS, FLOOR MODEL, INCLUDES HEAVY GAUGE STEEL LEGS WITH ADJUSTABLE LEVELERS.	-	-	-	MOEN-74998 TWO HANDLE LAUNDRY FAUCET, CHROME PLATED FINISH	-	-	1/2"	1/2"	2"	2"
IM-02	ICEMAKER IN FOOD PREP.	HOSHIZAKI	KM-340MAH KM-340MMWH	CRESCENT CUBER ICEMAKER, AIR-COOLED.	-	-	-	-	-	-	3/4"	-	2"	-
MOP-1	MOP SINK IN FOOD PREP.	FIAT PRODUCTS	TSB100	24" X 24" SQUARE, TERRAZZO 12" MOP SERVICE BASIN.	-	-	-	FIAT MODEL NO: 830AA	-	-	1/2"	1/2"	2"	2"
DW-01	DISH WASHER IN GUEST ROOM	GE APPLIANCES	GSM2260VSS	GE SPACEMAKER® UNDER-THE-SINK DISHWASHER STAINLESS STEEL FINISH OF DIMENSIONS (W) 24" X (H) 34" X (D)25 3/4".	-	-	-	-	-	-	-	1/2"	2"	2"
DW-02	DISH WASHER IN ADA GUEST ROOM	GE APPLIANCES	GLDT696JSS	GE SPACEMAKER® UNDER-THE-SINK DISHWASHER STAINLESS STEEL FINISH OF DIMENSIONS (W) 24" X (H) 32 11/32" X (D)24".	-	-	-	-	-	-	-	1/2"	2"	2"
DW-03	DISH WASHER IN FOOD PREP.	HOBART	LXEI-2	THE LXEH BASE UNDERCOUNTER IS EQUIPPED WITH AUTOMATIC PUMPED DRAIN 32 RACKS PER HOUR CAPACITY.	-	-	-	-	-	-	-	1/2"	2"	2"
URL-1	URINAL IN PUBLIC AREA	KOHLER	K-4989-T	THE SIPHON JET URINAL SHALL BE MADE OF VITREOUS CHINA WITH A 3/4" TOP SPUD. URINAL SHALL BE 1.0 GALLON (3.7 L.) FLUSH. URINAL SHALL BE ADA COMPLIANT WHEN RM IS MOUNTED NO HIGHER THAN 17" (43.2CM) FROM FINISHED FLOOR.	AMERICAN STANDARD MANUAL URINAL FLUSH VALVE MODEL NO : 6045.101.002	-	-	-	-	-	-	-	2"	2"
EWS	EYE WASH STATION	HAWS CORP.	7260BT-7270BT	EYE WASH STATION WALL MOUNTED, STAINLESS STEEL, HAND OPERATING CONTROL, GREEN.	-	-	-	-	-	-	1/2"	-	2"	2"
CLO-1	FLOOR CLEANOUT	ZURN INDUSTRIES, INC.	ZN-1400-NH	FLOOR CLEAN OUT WITH CARPET CLAMPING FRAME.	-	-	-	-	-	-	-	-	4"	-
CLO-2	WALL CLEAN OUT	JOSAM, INC.	59609-CO	WALL CLEAN OUT WITH ACCESS COVER, STAINLESS STEEL COVER.	-	-	-	-	-	-	-	-	4"	-
FD-01	FLOOR DRAIN RESTROOM	JAYR SMITH MGF CO	2005 SERIES	FLOOR DRAIN WITH ADJUSTABLE STRAINER HEADS, NICKEL BRONZE.	-	-	-	-	-	-	1/2"	-	3"	-
FD-02	FLOOR DRAIN POOL EQUIPMENT/MECH ROOM/ LAUNDRY	JAY R. SMITH MFG CO.	2320	TRAP GUARD FLOOR DRAIN WITH RECESS STRAINER.	-	-	-	-	-	-	-	-	-	-
		PROVENT SYSTEMS	C-6331-ETG	FLOOR DRAIN WITH DUOCO CAST IRON BODY, MEDIUM DUTY DRAIN WITH TRACTOR GRATE AND 8-1/2" ROUND ADJUSTABLE TOP, NICKEL BRONZE.	-	-	-	-	-	-	1/2"	-	3"	-
		PROVENT SYSTEMS		MOUNT FLANGE FROM THE TOP WITH GYPCRETE FROM THE BOTTOM WITHOUT USE T-350 STRAINER WHEN DISCHARGING A RELIEF VALVE INTO THE HUB DRAIN.	-	-	-	-	-	-	-	-	-	-
HB	WALL HYDRANT	ZURN INDUSTRIES, INC.	Z-1305	ANTI-SIPHON, NON-FREEZE, AUTOMATIC DRAINING ENCASED WALL HYDRANT FOR FLUSH INSTALLATION OPTIONAL 3/4" AND 1" HOSE CONNECTION.	-	-	-	-	-	-	3/4"	-	-	-
ROOF HYDRANT	ROOF HYDRANT	ZURN INDUSTRIES, INC.	Z-1388	EXPOSED, NON-FREEZE, LEAD FREE ROOF HYDRANT, DURA COATED CAST IRON HEAD, 3/4" INLET CONNECTION.	-	-	-	-	-	-	3/4"	-	-	-
GB	WASHING MACHINE GREY BOX	GUY GRAY	82026	FURNISH & INSTALL GALVANIZED CENTER DRAIN OUTLET BOX.	-	-	-	-	-	-	-	-	-	-
TP	TRAP PRIMER	PRECISION PLUMBING PRODUCTS	OREGON NO.1	PROVIDE DISTRIBUTION WHERE UNIT SERVES MORE THAN ONE DRAIN.	-	-	-	-	-	-	1/2"	-	-	-
GD	GARBAGE DISPOSAL	WHIRPOOL	GC1000PE	GALVANIZED STEEL GRINDING WHEEL & SHREDDER RING.	-	-	-	-	-	-	-	-	-	-
COFFEE BREWER	COFFEE BREWER IN FOOD PREP	FETCO	CBS-2152H-TS	DUAL COFFEE BREWER WITH PORTABLE SERVER/HANDLE OPERATED SERIES OF SIZE 36-3/4" H X 12-3/4" W X 20-3/8"D.	-	-	-	-	-	-	1/2"	-	-	-
FSK-01	FLOOR SINK IN FOOD PREP	JAYR SMITH MGF CO.	3140	ACID RESISTANT COATED, SANITARY FLOOR AND INDIRECT WASTE DRAINS WITH MEDIUM RECEPTOR, DEEP AND EXTRA DEEP RECEPTOR, 12-1/2" SQUARE NICKEL BRONZE TOP.	-	-	-	-	-	-	-	-	3"	-
RD	ROOF DRAIN	ZURN INDUSTRIES, INC.	Z-100	CAST IRON BODY WITH ADJUSTABLE EXTENSION SLEEVE, POLYTHELENE DOME, COMBINED FLASHING CLAMP AND GRAVEL STOP.	-	-	-	-	-	-	-	-	4"	-
ORD	OVERFLOW ROOF DRAIN	ZURN INDUSTRIES, INC.	Z-100-W4	OVERFLOW STANDPIPE TYPE, DUOCO CAST IRON BODY WITH ADJUSTABLE EXTENSION SLEEVE, POLYETHYLENE DOME, COMBINED FLASHING CLAMP AND GRAVEL STOP.	-	-	-	-	-	-	-	-	4"	-
DF	DRINKING FOUNTAIN	HAWS	1119	UNIT IS MADE OF 18 GAUGE TYPE 304 STAINLESS STEEL WITH A SATIN FINISH THAT RESISTS STAINS AND CORROSION.	-	-	-	-	-	-	1/2"	-	1-1/2"	1-1/2"

NOTE : TO BE INSTALLED ACCORDING TO MANUFACTURER'S RECOMMENDATIONS REFER TO PLANS FOR LOCATIONS INSTALLATION TO MEET ADA GUIDELINES
BASE4 STRONGLY SUGGESTS TO USE AO SMITH CIRCUIT SOLVER THERMOSTATIC BALANCING VALVES FOR HOT WATER RE-CIRC LOOP. CIRCUIT SOLVER PRODUCT REP-JOHN ALTEPETER 219-384-4161.

WATER DEMAND SUMMARY			
FIXTURE	CWFU X NUM	HWFU X NUM	
BATHROOM GROUP (SHR/TUB, WCL, LAV)	3.5 x 108	1.8 x 108	
SNK AND DW (GUESTROOM)	1.5 x 108	1.5 x 108	
WCL (PUBLIC AREAS)	10 x 6	-	
URL (PUBLIC AREAS)	5 x 1	-	
LAV (PUBLIC AREAS)	1.5 x 4	1.5 x 4	
MOP SINK	3 x 1	3 x 1	
WASHER	3 x 2	3 x 2	
EWS	0.5 x 3	0.5 x 3	
LAUNDRY TUB	2 x 1	2 x 1	
3-COMPARTMENT SINK	3 x 1	3 x 1	
SERVICE SINK	2 x 1	2 x 1	
HAND SINK	1.5 x 1	1.5 x 1	
WM	2.25 x 2	2.25 x 2	
DW IN FOOD PREP.	-	1.4 x 1	
DF	0.5 x 2	-	
TP	0.5 x 30	-	
ICE MACHINE	0.5 x 5	-	
COFFEE MIC & JUCE DISPENSER	0.5 x 2	-	
HOSE BIB	2.25 x 15	-	
ROOF HYDRANT	1 x 1	-	
YARD HYDRANT	1 x 1	-	
TOTAL WSFU	689.75	387.3	
TOTAL GPM	160.8	100.3	

SEWER LOAD SUMMARY			
FIXTURE	DFU X NUM	TOTAL	
BATHROOM GROUP (SHR/TUB, WCL, LAV)	5 x 108	540	
SNK AND DW (GUESTROOM)	2 x 108	216	
WCL (PUBLIC AREAS)	4 x 6	24	
URL (PUBLIC AREAS)	2 x 1	2	
LAV (PUBLIC AREAS)	2 x 4	8	
MOP SINK	3 x 1	3	
WASHER	3 x 2	6	
EWS	2 x 3	6	
LAUNDRY TUB	2 x 1	2	
3-COMPARTMENT SINK	3 x 1	3	
SERVICE SINK	2 x 1	2	
HAND SINK	2 x 1	2	
WM	2 x 2	4	
DW IN FOOD PREP.	2 x 1	2	
DF	2 x 2	4	
FD	2 x 30	60	
FSK	2 x 2	4	
	TOTAL DFU	888	

PUMP SCHEDULE				
MARK	CP-1	CP-2	SP-1	BP-SET
MANUFACTURER	GRUNDFOS	GRUNDFOS	HYDRAMATIC	GRUNDFOS
MODEL NO.	UPS 32-160 F	UPS 32-80 F	SHEF 100	95055336 HYDRO MPC E 3CRE20-02
SIZE	1-1/2"	3/4"	2"	
TYPE	INLINE	INLINE	SUBMERSIBLE	INLINE
SERVICE	120° HWR	140° HWR	ELEVATOR SUMP & SUMP PIT	PRESSURE BOOSTING
GPM	14.0	6.0	90	200
TOTAL HEAD (FT/PSI)	15 PSI	7 PSI	20(Ft)	40 PSI
FLUID TEMP.(F)	120	140	-	-
IMPELLER DIA	-	-	-	-
KW	0.625	0.280	0.746	3.7
RPM	-	-	3450	-
ELECTRICAL (VOLT/PH)	115/1 V	115/1 V	230/1	3 x 208-230 V
OPER.WT.(LBS)	N/A	N/A	N/A	N/A
REMARKS	1	2	3	-
REMARKS	1. CIRCULATING PUMP OR GUEST ROOM SYSTEM (120°) AQUASTAT TO START PUMP WHEN TEMP. DROPS BELOW (110°) AND STOPS AT 120°.			
	2. CIRCULATING PUMP FOR KITCHEN SYSTEM (140°) AQUASTAT TO START WHEN TEMP. DROPS BELOW (130°) AND STOPS AT (140°).			
	3. REFER SHEET P-202B FOR SUMP PUMP LOCATION.			

GREASE INTERCEPTOR SIZING								
INTERCEPTOR SIZE	=	NO. OF MEALS PER PEAK HOUR	X	WASTE FLOW RATE	X	RETENTION TIME	X	STORAGE FACTOR
NO. OF MEALS PER PEAK HOUR	=	SEATING CAPACITY X PEAK FACTOR						
		= 47 X 1						
		= 47						
WASTE FLOW RATE	=	6 GALLON FLOW						
RETENTION TIME	=	2.5 HOURS						
STORAGE FACTOR	=	1.5						
INTERCEPTOR SIZE	=	47 X 6 X 2.5 X 1.5						
		= 1057.5 GALLONS						
GREASE INTERCEPTOR SIZE		= 1200 GALLONS						
NOTE: GREASE INTERCEPTOR SIZING IS DONE AS PER APPENDIX-H OF THE UNIFORM PLUMBING CODE.								

DOMESTIC WATER HEATER SCHEDULE					
MARK	GWH- 1,2,3,4,5 & 6				
MANUFACTURER	A.O.SMITH CYCLONE				
MODEL NO.	BTH-199A Mx				
TYPE	ST-60V-C				
FUEL	STORAGE TANK				
BURNER MOTOR(KW)	NATURAL GAS				
INPUT (MBH)	199				
HOT WATER CAPACITY 100 F RISE	235				
TOTAL HEAD (GAL)	100 USG				
FUEL ISZE (IN.)	3/4"				
ELECTRICAL (VOLT/PH)	120V AC,60 Hz				
REMARKS	1,2,3				
REMARKS	1. RECOVERY RATE BASED ON 100° F RISE 2. PROVIDE SIDE WALL DIRECT VENT / SEALED COMBUSTION. 3. SEE SPECIFICATION FOR APPROVED EQUALS				

THERMOSTATIC MIXING VALVE SCHEDULE

MARK	TMV-1
MANUFACTYRER	HOLBY
MODEL NO.	HOLBY 3000
SIZE	3"
MATERIAL	BRONZE
PRESSURE DROP (PSI)	10
SIZE MAXIMUM PRESSURE (PSI)	300 PSI
MAXIMUM TEMPERATURE (F)	120

MARK	ET-1
MANUFACTYRER	AMTROL
MODEL NO.	ST-60V-C
SERVICE	GWH- 1,2,3,4,5 & 6
TANK CAPACITY	25
CONNECTION SIZE	3/4"
REMARKS	1

DRAIN TROUGH SCHEDULE

MARK	MANUFACTURER	MODEL	LENGTH "A"	WIDTH "B"	HEIGHT "C"
DT-1	H & M	-	8'-2"	1'-4"	0'-8"

WATER SOFTENER SCHEDULE-ECO WATER MANUFACTURER'S

MODEL	RESIN TANK DIAMETER "A"	RESIN TANK HEIGHT "B"	INLET/OUTLET HEIGHT "C"	OVERALL HEIGHT "D"	BRINE TANK DIAMETER "E"	BRINE TANK HEIGHT "F"	SINGLE "G"	RESIN TANK SIZE (IN.)	RESIN QUANTITY (CU. FT.)	CONNECTING PIPE SIZE	SALT TANK CAPACITY (LBS.)	OPERATING PRESSURE	OPERATING TEMPERAT URE	MAX. DRAIN FLOW (GPM)	RECHARGE WATER USE (GAL.)	MAX. CLEAR WATER RONS	ELECTRICAL RATING
EW5252S	24"	72"	81"	86.5"	31"	51"	60"	24" X 72"	8	2" NPT	1500	30-125 PSI	35-100°F	12	302	20 PPM	24V/60Hz

GREASE INTERCEPTOR FOR SCHEDULE

MARK	MANUFACTURER	MODEL	LIQUID CAPACITY GALL
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