### **GENERAL NOTES**

- THE APPROVED PLANS SHALL NOT BE CHANGED OR ALTERED WITHOUT AUTHORIZATION FROM THE BUILDING OFFICIAL. THE APPROVED PLANS ARE
- REQUIRED TO BE ON THE JOB SITE. CONTRACTOR SHALL VERIFY AND CHECK ALL CONDITIONS AND DIMENSIONS AT THE
- BUILDING. REPORT ANY INCONSISTENCIES TO THE ARCHITECT. ALL WORK SHALL MEET LOCAL CODES AND ORDINANCES.
- ALL NAILING SHALL COMPLY WITH NAILING SCHEDULE OF THE IBC COMPLIANCE CARD TO BE POSTED VERIFYING INSULATION INSTALLED IN WALL
- ALL WOOD COMING IN CONTACT WITH CONCRETE SHALL BE PRESSURE TREATED
- IF ANY ERRORS, OMISSIONS, OR INCONSISTENCIES APPEAR IN THE DRAWINGS, SPECIFICATIONS, OR OTHER DOCUMENTS, THE CONTRACTOR SHALL NOTIFY THE OWNER OR ARCHITECT IN WRITING OF SUCH OMISSIONS, ERRORS, OR
- INCONSISTENCIES BEFORE PROCEEDING WITH THE WORK, OR ACCEPT FULL RESPONSIBILITY FOR COSTS TO RECTIFY SAME. TYPICAL DETAILS OR BUILDING STANDARDS SHALL APPLY WHERE NO SPECIFIC
- DETAILS ARE GIVEN. ALL DIMENSIONS SHALL TAKE PRECEDENCE OVER SCALE SHOWN ON PLANS. **ELEVATIONS. SECTIONS AND DETAILS.**
- 10. ALL EXIT DOORS TO BE OPERABLE FROM INSIDE THE BUILDING WITHOUT KEYS OR SPECIAL KNOWLEDGE OR EFFORT 1. FIRE EXTINGUISHERS SHALL BE PROVIDED PER NFPA #10, OR REQUIREMENTS OF

- 14. THE MEANS OF EGRESS, INCLUDING THE EXISTING DISCHARGE, SHALL BE ILLUMINATED AT ALL TIMES THE BUILDING IS OCCUPIED PER IBC 1006.1. ELECTRICAL
- SUBMITTAL MEETING ALL REQUIREMENTS. 15. MANUALLY OPERATED FLUSH BOLTS ARE NOT PERMITTED AND NO MORE THAI

DESIGN BUILD CONTRACTOR SHALL COMPLY AND SHALL SUBMIT A DEFERRED

- ONE OPERATION FOR THE UNLATCHING IS ALLOWED. 16. ALL NEW CONCRETE MUST HAVE A MINIMUM COMPRESSIVE STRENGTH OF 4,000
- 17. FOR EMERGENCY LIGHTING:
- 17.1 THE ILLUMINATION LEVEL SHALL BE AT 1 FC AT THE WALKING SURFACE.
- 17.2 POWER SUPPLY BY PREMISES POWER SUPPLY. 17.3 IN THE EVENT OF POWER FAILURE EMERGENCY LIGHTING SHALL BE PROVIDED FOR NO LESS THAN 90 MINUTES AT AISLES, CORRIDORS, EXIT DISCHARGE ELEMENTS, AND EXTERIOR LANDINGS.

# **ENERGY CODE REQUIREMENTS**

GOVERNING ENERGY CODE: 2018 IBC / 2018 WASHINGTON STATE ENERGY CODE COMPONENT PATH

BUILDING SPACE TYPE HEAT IS "OTHER" (ALL OTHERS INCLUDING HEAT PUMPS AND VARIABLE AIR VOLUME). ELECTRIC RESISTANCE HEATING NOT ALLOWED

R-38 CONTINUOUS

R-13 W/ R-10 RIGID

REQUIRED INSULATION VALUES FOR CONDITION SPACES

#### **CLIMATE ZONE 4C:**

BUILDING ROOF (NO ATTIC) OPAQUE WALLS MASS WALLS

METAL FRAMING WOOD FRAMING & OTHER **OPAQUE DOORS** FLOOR OVER UNCONDITIONED SPACE SLAB-ON-GRADE

U-0.37 EXISTING **VERTICAL GLAZING EXISTING** 

PROVIDE OCCUPANCY SENSORS AT ALL LOCATIONS WHERE REQUIRED BY WSEC SECTION C405.2. SEE LIGHTING BELOW.


PROVIDE AUTOMATIC CONTROLS TO TURN OFF LIGHTS DURING UNOCCUPIED HOURS AS REQUIRED BY WSEC SECTION C405.2. SEE LIGHTING BELOW.

ALL AREAS ENCLOSED BY WALLS OR FULL-HEIGHT PARTITIONS ARE REQUIRED TO HAVE AT LEAST ONE MANUAL CONTROL FOR LIGHTING.

EACH AREA REQUIRED TO HAVE MANUAL CONTROLS SHALL ALSO HAVE A CONTROL TO REDUCE LIGHTING BY 50% IN A REASONABLE UNIFORM ILLUMINATION PATTERN, OR PROVIDE AN OCCUPANCY SENSOR DEVICE.

OCCUPANCY SENSOR ARE REQUIRED IN: TRAINING ROOMS, CLASSROOMS, BREAKROOMS, CONFERENCE ROOMS, PRIVATE OFFICES, RESTROOMS, JANITOR ROOMS, STORAGE ROOMS, WAREHOUSES, AND ANY ROOM 300 SQUARE FEET OR LESS ENCLOSED BY FULL HEIGHT WALLS. THE SENSORS SHALL TURN OFF THE LIGHT WITHIN 30 MINUTES OF ALL OCCUPANTS LEAVING THE SPACE.

# SUBJECT SITE

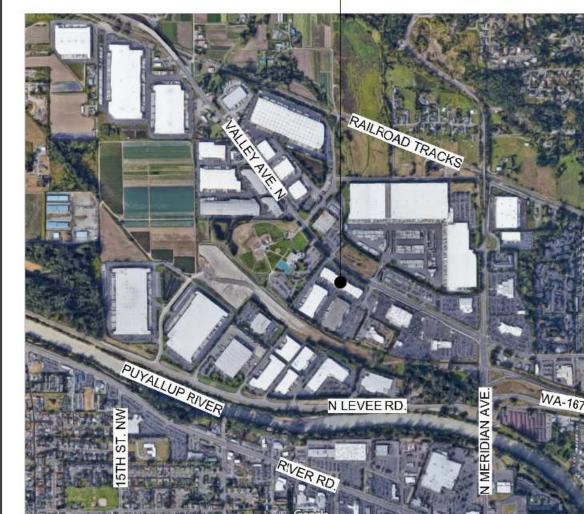

### SITE & BUILDING INFORMATION

TAXPAYER 5900 AIRPORT WAY S. SUITE 300 SEATTLE, WA 98108

TAX PARCEL NUMBER

402 VALLEY AVE. NW, SUITES A101-A103 PUYALLUP, WA 98371

2018 INTERNATIONAL BUILDING CODE W/ WASHINGTON STATE AMENDMENTS

PF - PUBLIC FACILITIES **EXISTING** 

**EXISTING EXISTING EXISTING EXISTING EXISTING** 

**EXISTING** EXISTING, NO CHANGE

# TYPICAL SYMBOLS

ALLOWABLE HEIGHT

**CONSTRUCTION TYPE** 

EXISTING OCCUPANCY TYPE

PROPOSED OCCUPANCY TYPE

ACTUAL HEIGHT

PROJECT ADDRESS

SITE STATISTICS

GOVERNING BUILDING CODE

**GOVERNING MUNICIPAL CODE** 

SITE AREA

ALLOWABLE LOT COVERAGE

SIDE (INTERIOR)


SIDE (STREET)

ALLOWABLE FAR

ACTUAL FAR

BUILDING STATISTICS

REQUIRED BUILDING SETBACKS

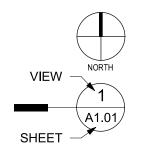

**NORTH ARROW** 

DETAIL REFERENCE

REFERENCE GRID LINES

INTERIOR ELEVATION

REFERENCE

**DETAIL CALL OUT** 

REFERENCE

ROOM TAG

**REVISION TAG** 


REVISION CLOUD

NEW DOOR TAG


WALL TAG

EXISTING DOOR TAG

EXISTING EXIT DOOR TAG

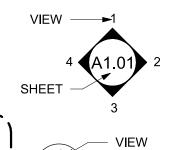

A1.01

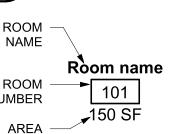

ROOM -NUMBER REVISION NUMBER

CLOUD

(EX) EX #

(#)

< # > \_\_\_

SECTION 21 TOWNSHIP 20 RANGE 04 QUARTER 13 PARCEL "C" OF DBLR 2002-09-18-5002 DESC AS FOLL L 1 OF S P 97-09-29-0267 TOG/W FOLL BEG AT SE COR OF SD L 1 TH N 27 DEG 09 MIN 43 SEC E 484.53 FT TH S 62 DEG 50 MIN 17 SEC E 45.56 FT TH S 32 DEG 10 MIN 00 SEC W 486.29 FT TO INTER OF NON-TANG C TO R RAD 3870 FT TH NWLY 3.15 FT THRU A CENT ANGLE OF 00 DEG 02 MIN 48 SEC TO POB ALSO TOG/W FOLL DESC PROP BEG AT SE COR OF ABOVE DESC PROP TH N 32 DEG 10 MIN 00 SEC E 486.29 FT TH S 62 DEG 50 MIN 17 SEC E 127.10 FT TH S 27 DEG 09 MIN 43 SEC W 475.43 FT TO INTER OF NON- TANG POB EASE OF REC OUT OF 5-008 & 5-009 SEG 2005-0690 11/02/04CL

## **OVERALL BUILDING AREAS**

OVERALL BUILDING AREAS PER 2018 INTERNATIONAL BUILDING CODE EXTERIOR FOOTPRINT FULL BUILDING 72,775 SF TENANT AREA THIS PERMIT 21,170 SF 21,170 SF

21,170 SF

21,170 SF

EXISTING OFFICE PROPOSED WAREHOUSE AREA OF WORK PUYALLUP MUNICIPAL CODE

> OCCUPANT LOADS PER TABLE 1004.5 OF THE 2018 INTERNATIONAL BUILDING CODE:

WAREHOUSE (S-1) @ 500 SF / OCCUPANT OCCUPANT LOAD = 43 TOTAL OCCUPANT LOAD = 43

TOTAL EXITS REQUIRED = 2

TOTAL EXITS PROVIDED = 9

# PLUMBING FIXTURES

PER TABLE 2902.1 OF THE 2018 INTERNATIONAL BUILDING CODE:

WATER CLOSETS WAREHOUSE (S-1)

1/100 @ 43 OCC. WATER CLOSETS REQUIRED .43 (0.22 M / 0.22 F) WATER CLOSETS PROVIDED

LAVATORIES REQUIRED LAVATORIES PROVIDED

0.43 LAVATORIES 1/100 @ 43 OCC. 0.43 (0.22 M / 0.22 F) 4 (2 M / 2 F)

THE APPROVED CONSTRUCTION PLANS, DOCUMENTS AND ALL ENGINEERING MUST BE POSTED ON THE JOB AT ALL

0.43 TOILETS

FULL SIZED LEDGIBLE COLOR PLANS ARE REQUIRED TO BE PROVIDED BY THE PERMITEE ON SITE FOR INSPECTION

**INSPECTIONS IN A VISIBLE AND READILY** 

ACCESSIBLE LOCATION.

# PROJECT TEAMS

**ARCHITECT:** JACKSON | MAIN ARCHITECTURE 311 FIRST AVE. S SEATTLE, WA 98104 (206) 324-4800

PROLOGIS 5900 AIRPORT WAY S. SUITE 300 SEATTLE, WA 98108

OWNER:

PROJECT SCOPE

PROJECT SCOPE INVOLVES THE DEMOLITION OF THE EXISTING OFFICE SPACE IN ORDER TO CONVERT TO NEW WAREHOUSE SPACE.

 $\sim$ 

# SEPARATE SUBMITTALS

GENERAL CONTRACTOR TO SUBMIT FOR AND OBTAIN SEPARATE PERMITS FOR

 ELECTRICAL WITH LABOR AND INDUSTRIES • FIRE SPRINKLER SYSTEMS WITH CITY OF PUYALLUP FIRE DEPARTMENT

EXISTING MECHANICAL SYSTEMS SHALL BE REMOVED.

SCOPE OF WORK CHANGED TO DEMO OF EXISTING OFC ONLY. NO NEW OFFICE AREA PART OF THIS TFO PER **APPLICATION** 

## DRAWING INDEX

G0.0 COVER SHEET ARCHITECTURAL A1.0 DEMOLITION & OVERALL EGRESS PLANS

A1.1 WAREHOUSE FP & RCP A4.0 PROLOGIS CUSTOMER FINISH STANDARDS A4.1 PROLOGIS CUSTOMER FINISH STANDARDS


P0.0 EXISTING PLUMBING LINES, FIXTURES, & CONNECTIONS

City of Puyallup Engineering Approval Permit Number B-21-0359 Staff Initial LL

The new plans show no changes to the plumbing. The bathrooms will not be relocated and the staff break room will not have a kitchen sink installed. LL

TFO - CONVERT OFFICE TO WAREHOUSE NO PLUMBING WORK, REMOVAL OF MECH ONLY. BUILDING & MECHANICAL

11/17/2021

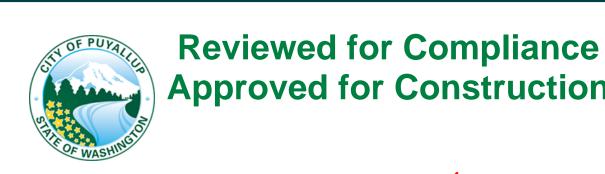

**Date of Review** 

By Janelle Montgomery

11/29/2021

**Reviewed for Compliance Approved for Construction** 

B-21-0359

PROLOGIS PUYALLUP 2 402 VALLEY AVE. NW



(206) 414-7600

PROJECT#

21008.08

JACKSON | MAIN

ARCHITECTURE

ARCHITECT

KATERINA PROCHASKA

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SEATTLE, WASHINGTON 98104

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KATERINA PROCHASKA@JACKSONMAIN COM

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**PROLOGIS** 

**SUITES** 

**PUYALLUP 2** 

A101-A103 T.I.

PUYALLUP, WA 98371

1 | 10/15/21 | REVISION 1 SUBMITTAL

10/15/21 REVISION 1 SUBMITTAL

PRINT RECORD

STATE OF WASHINGTO

5900 AIRPORT WAY S SUITE 300 SEATTLE, WA 98108

FACSIMILE: (206) 414-7601

SHEET TITLE:


**COVER SHEET** 

SHEET NUMBER

RELEASED FOR CONSTRUCTION NOT RELEASED FOR CONSTRUCTION



C TOR RAD 3870 FT TH NWLY 169.77 FT THRU CENT ANGLE OF 02 DEG 30 MIN 49 SEC TO

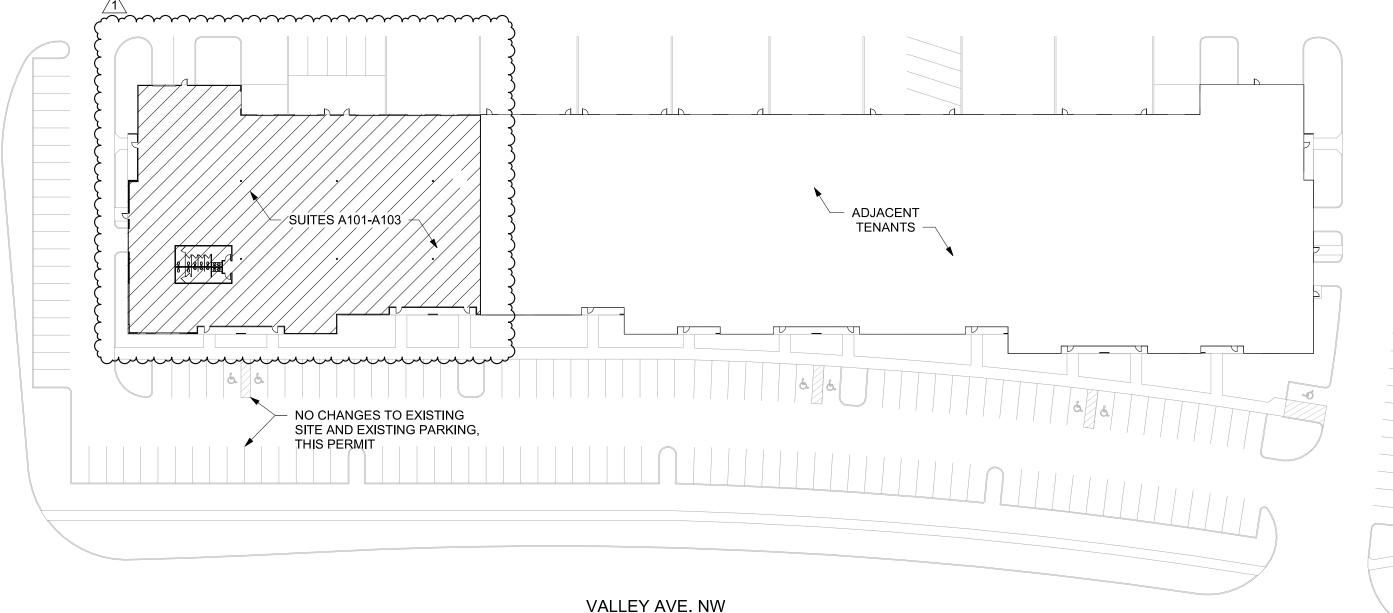

**OVERALL SITE PLAN** 

# **EGRESS NOTES**

**CODE NOTES:** 

PER PREVAILING BUILDING CODE, WHERE TWO EXITS, EXIT ACCESS DOORWAYS, EXIT ACCESS STAIRWAYS OR RAMPS, OR ANY COMBINATION THEREOF, ARE REQUIRED FOR ANY PORTION OF THE EXIT ACCESS, THEY SHALL BE PLACED A DISTANCE APART EQUAL TO NOT LESS THAN ONE-THIRD OF THE LENGTH OF THE OVERALL DIAGONAL DIMENSION OF THE BUILDING OR AREA TO BE SERVED.

**BUILDING DIAGONAL:** MIN. REQ'D. SEPARATION: PROVIDED SEPARATION:

215' - 8" 215" - 8" / 3 = 71 - 11"

78' - 4"

121' - 7"

PER SECTION 1017.2.2 OF THE 2018 INTERNATIONAL BUILDING CODE, EXIT ACCESS TRAVEL DISTANCE SHALL NOT EXCEED 250 FT. IN OFFICE AND 400 FT. IN WAREHOUSE.

EXIT PATH A: EXIT PATH B:

3. ALL EXISTING DOORS (EX) ARE AT LEAST 34" CLEAR AND ARE TO REMAIN AS-IS.

# **DEMOLITION NOTES**

REMOVE ALL EXISTING CONSTRUCTIONS AND FINISHES NECESSARY FOR THE COMPLETION OF THE WORK AS DEPICTED ON THE DRAWINGS. INCLUDING BUT NOT LIMITED TO, ITEMS SHOWN ON THE PLANS WITH DASHED LINES. NECESSARY DISCONNECTS AND ALTERATIONS TO EXISTING MECHANICAL AND ELECTRICAL SYSTEMS SHALL BE INCLUDED. PATCH ALL CONSTRUCTIONS AS REQUIRED TO REMAIN IN ACCORDANCE WITH THE CONTRACT DRAWINGS. WHERE CONTRACTOR IS DESIGNATED TO MAKE REMOVALS, DISPOSITION OF MATERIALS IS THE RESPONSIBILITY OF THE CONTRACTOR. VERIFY WITH OWNER THE DISPOSITION AND REMOVAL OF ANY COMPONENTS OF SALVAGEABLE VALUE. ALL REMOVALS AND SALVAGE, UNLESS SPECIFICALLY NOTED OR REQUESTED BY THE OWNER, SHALL BECOME THE PROPERTY OF THE CONTRACTOR.

REMOVE ONLY NON-LOAD BEARING CONSTRUCTION AND PARTITIONS. CONTRACTOR TO VERIFY, PRIOR TO REMOVAL THAT NO STRUCTURAL COMPONENTS, I.E. BEARING WALLS, BEAMS, HEADERS, ETC., SUPPORTING FLOOR, ROOF, OR CEILING JOISTS ARE DESIGNATED FOR REMOVAL, CONTACT THE ARCHITECT PRIOR TO REMOVAL OF ANY CONSTRUCTION IN QUESTION OR DEVIATING FROM THE DESIGN INTENT. CONTRACTOR'S NON-CONTACT OF ARCHITECT PRIOR TO REMOVAL OF ANY WORK INDICATES HIS COMPLETE UNDERSTANDING THAT NO LOAD BEARING OR STRUCTURAL WORK IS BEING ALTERED UNDER THIS CONTRACT ALL STRUCTURAL SYSTEMS SHALL BE MAINTAINED AND SHALL BE OF SUFFICIENT STRENGTH TO SUPPORT THE DESIGN LOADS AND TO RESIST THE DEFORMATION CAUSED BY SUCH

PATCH ALL FINISHES TO MATCH ADJACENT EXISTING, INCLUDING BUT NOT LIMITED TO, GYPSUM BOARD, PLASTER, ACOUSTIC SYSTEMS, WOOD TRIM, COVERS, BASE, PANELS, RAILS, AND WAINSCOT. VERIFY MATCH OF NEW FINISH MATERIALS TO EXISTING IN COLOR, TEXTURE, THICKNESS, CUT, ETC. PER THE FINISH SCHEDULE OR FINISH STANDARDS TO SATISFACTION OF OWNER PRIOR TO INSTALLATIONS. PROVIDE OTHER MATERIALS TO MATCH EXISTING WHEN REQUIRED. TO BE APPROVED BY OWNER.

PATCH EXISTING WALLS, GYPSUM DRYWALL, OR PLASTER TO MATCH EXISTING OF SUFFICIENT THICKNESS TO MAINTAIN UNIFORM WALL THICKNESS. ALL EXPOSED PORTIONS OF WALL SHALL BE FINISHED WITH THREE (3) COATS OF SPECKLING, SANDED, AND LEFT IN A PAINT-READY CONDITION.

WHERE APPLICABLE, LEVEL ALL EXISTING FLOORS AS REQUIRED TO RECEIVE NEW FLOOR FINISHES. INSTALL REQUIRED TRANSITION PIECES BETWEEN VARIOUS FLOOR FINISHES SUITABLE FOR CONDITIONS AND ACCEPTABLE TO THE OWNER. MATCH EXISTING WHEREVER POSSIBLE.

ARCHITECTURE



JACKSON MAIN ARCHITECTURE 311 FIRST AVENUE S. SEATTLE, WASHINGTON 98104 PHONE: (206) 324-4800 KATERINA.PROCHASKA@JACKSONMAIN.COM

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**PROLOGIS PUYALLUP 2 SUITES** 

PROLOGIS PUYALLUP 2 402 VALLEY AVE. NW PUYALLUP, WA 98371

A101-A103 T.I.



5900 AIRPORT WAY S SUITE 300 SEATTLE, WA 98108

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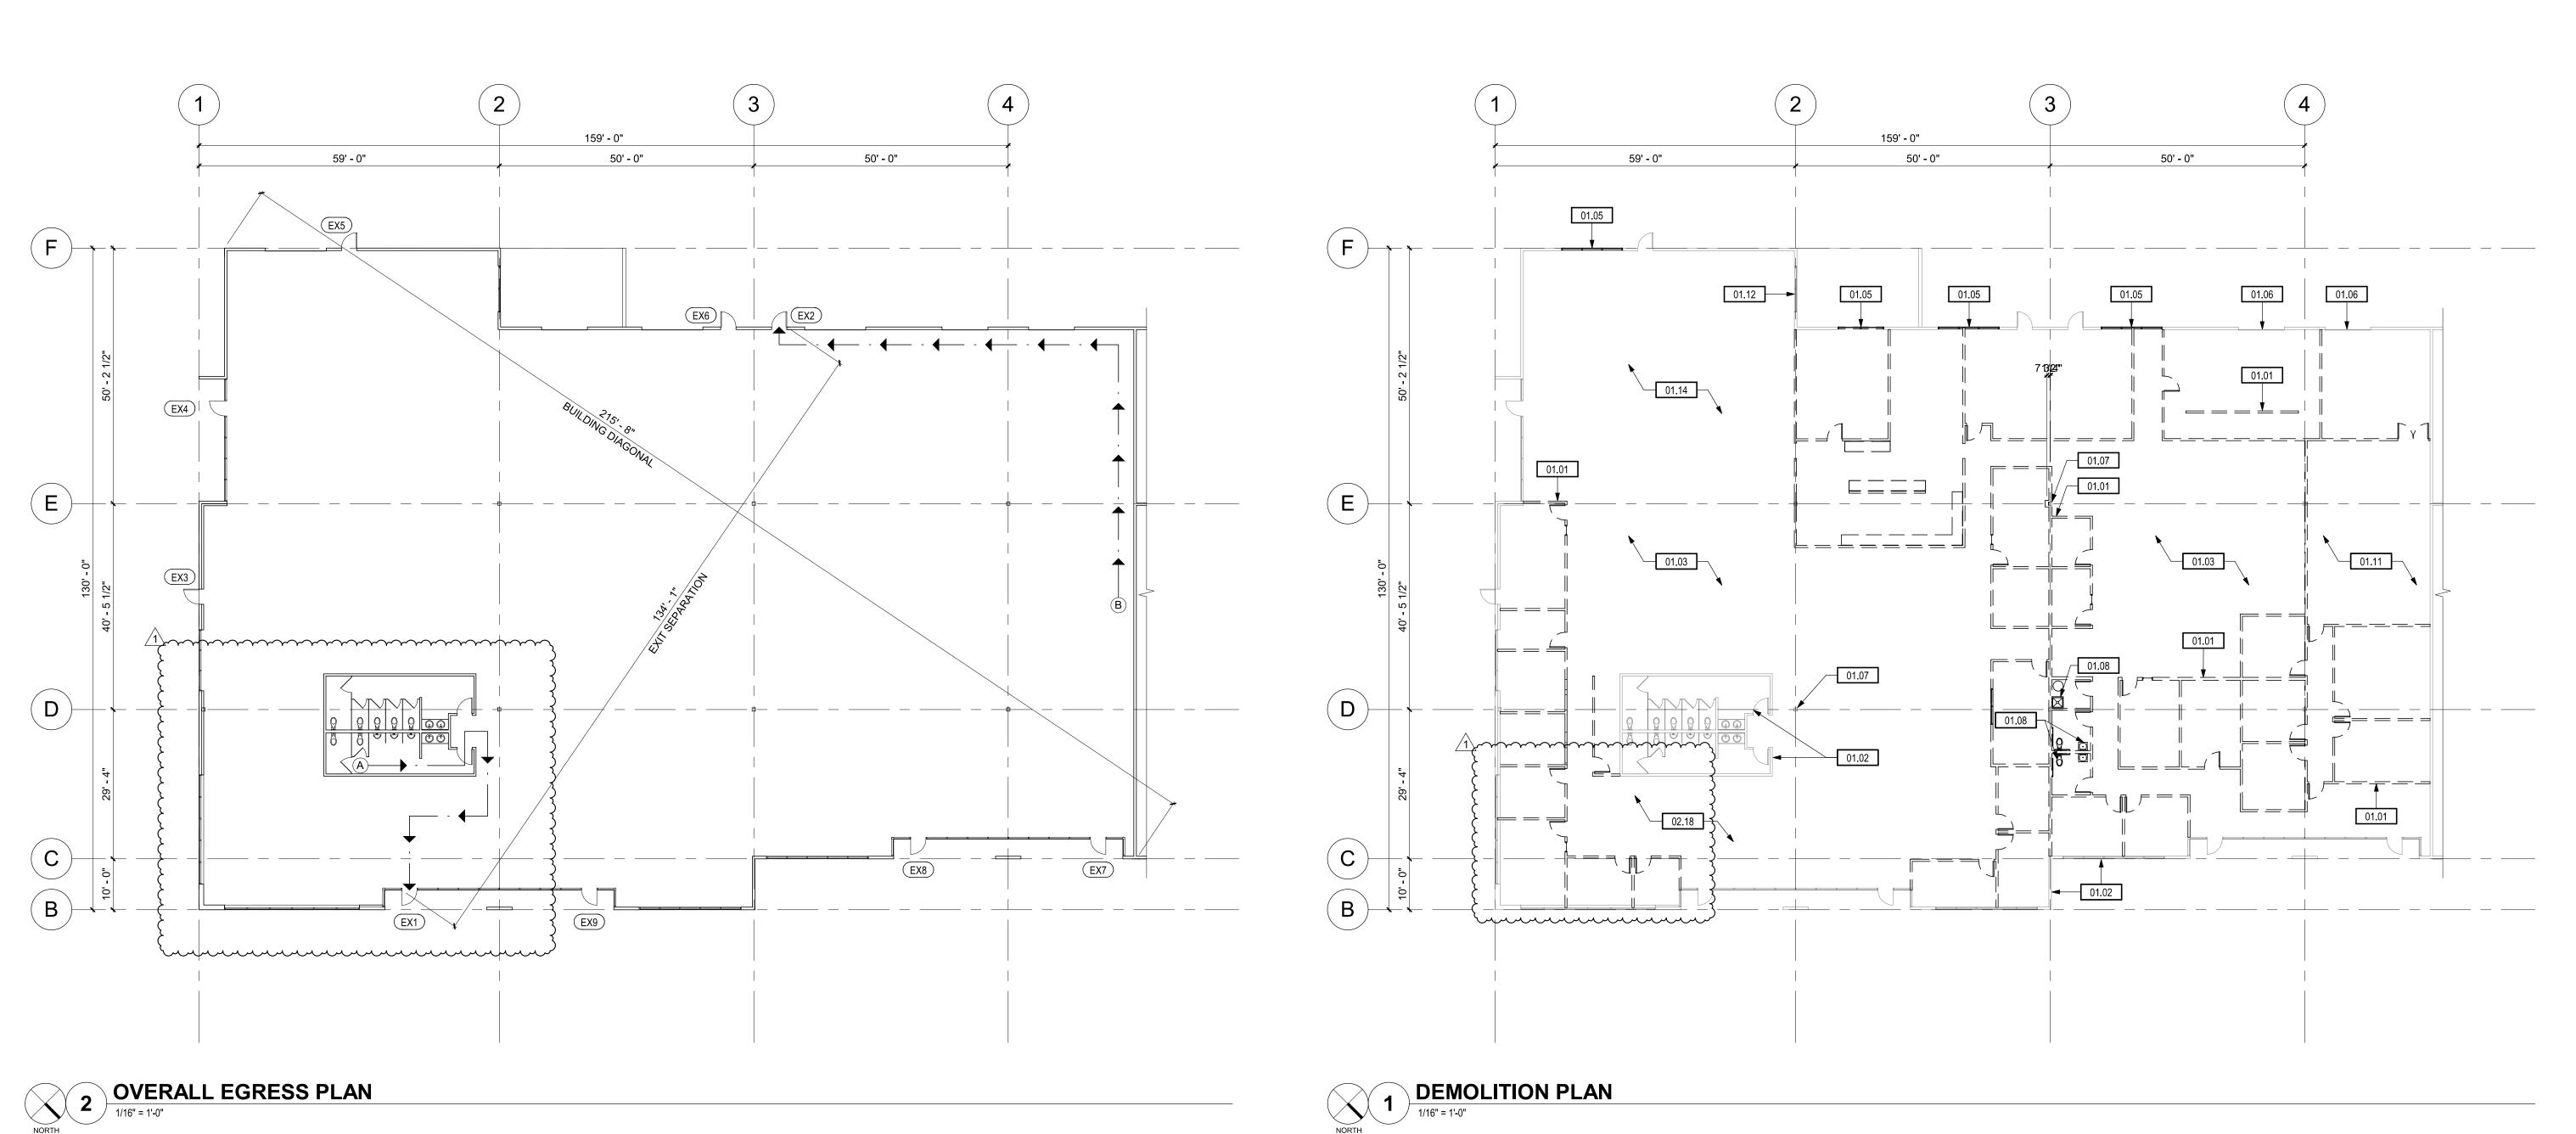
PROJECT# 21008.08

SHEET TITLE:

DEMOLITION & OVERALL EGRESS PLANS

SHEET NUMBER

RELEASED FOR CONSTRUCTION NOT RELEASED FOR CONSTRUCTION



REFLECTED CEILING PLAN NOTES 1. AT RATED OR NON-RATED ASSEMBLIES, SEAL ALL GAPS, CRACKS, AND PENETRATIONS WITH SEALANT APPROPRIATE TO ASSEMBLY TYPE, LOCATION, AND VISIBILITY. CONCEAL ALL LIGHTING CONDUITS, VERIFY DIMENSIONS BEFORE ORDERING MATERIALS AND PROCEEDING WITH THE WORK. ALL LIGHT FIXTURES SHALL BE IC-RATED (INSULATION CONTACT), UNLESS OTHERWISE REQUIRED BY BUILDING CODE, AND SHALL MAINTAIN REQUIRED FIRE RATING OF WALL/FLOOR/CEILING ASSEMBLY WHERE IT IS INSTALLED. 4. ALL LIGHTING, MEP FIXTURES, AND CEILING ACCESSORIES ON RCP'S FOR DIMENSIONAL PURPOSES ONLY. FIXTURE TYPES SHALL BE DICTATED BY M.E.P. DRAWINGS, U.N.O. NOTIFY ARCHITECT OF ANY DISCREPANCIES PRIOR TO INSTALLATION. 5. VERIFY W/ LOCAL FIRE MARSHALS APPROVAL OF ALL EXIT SIGNAGE LOCATIONS PRIOR TO ORDER OR INSTALL. CONFIRM APPROVAL WITH ARCHITECT.

13.3 IN THE EVENT OF POWER FAILURE EMERGENCY, LIGHTING SHALL BE PROVIDED

FOR NO LESS THAN 90 MIN. AT AISLES, CORRIDORS, EXIT DISCHARGE ELEMENTS,

AND EXTERIOR LANDINGS.

KATERINA PROCHASKA STATE OF WASHINGTON

ARCHITECTURE

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PROLOGIS PUYALLUP 2 402 VALLEY AVE. NW PUYALLUP, WA 98371



5900 AIRPORT WAY S SUITE 300 SEATTLE, WA 98108

PHONE: (206) 414-7600 FACSIMILE: (206) 414-7601

SHEET TITLE:


WAREHOUSE FP & RCP

PROJECT#

21008.08

SHEET NUMBER:

RELEASED FOR CONSTRUCTION NOT RELEASED FOR CONSTRUCTION

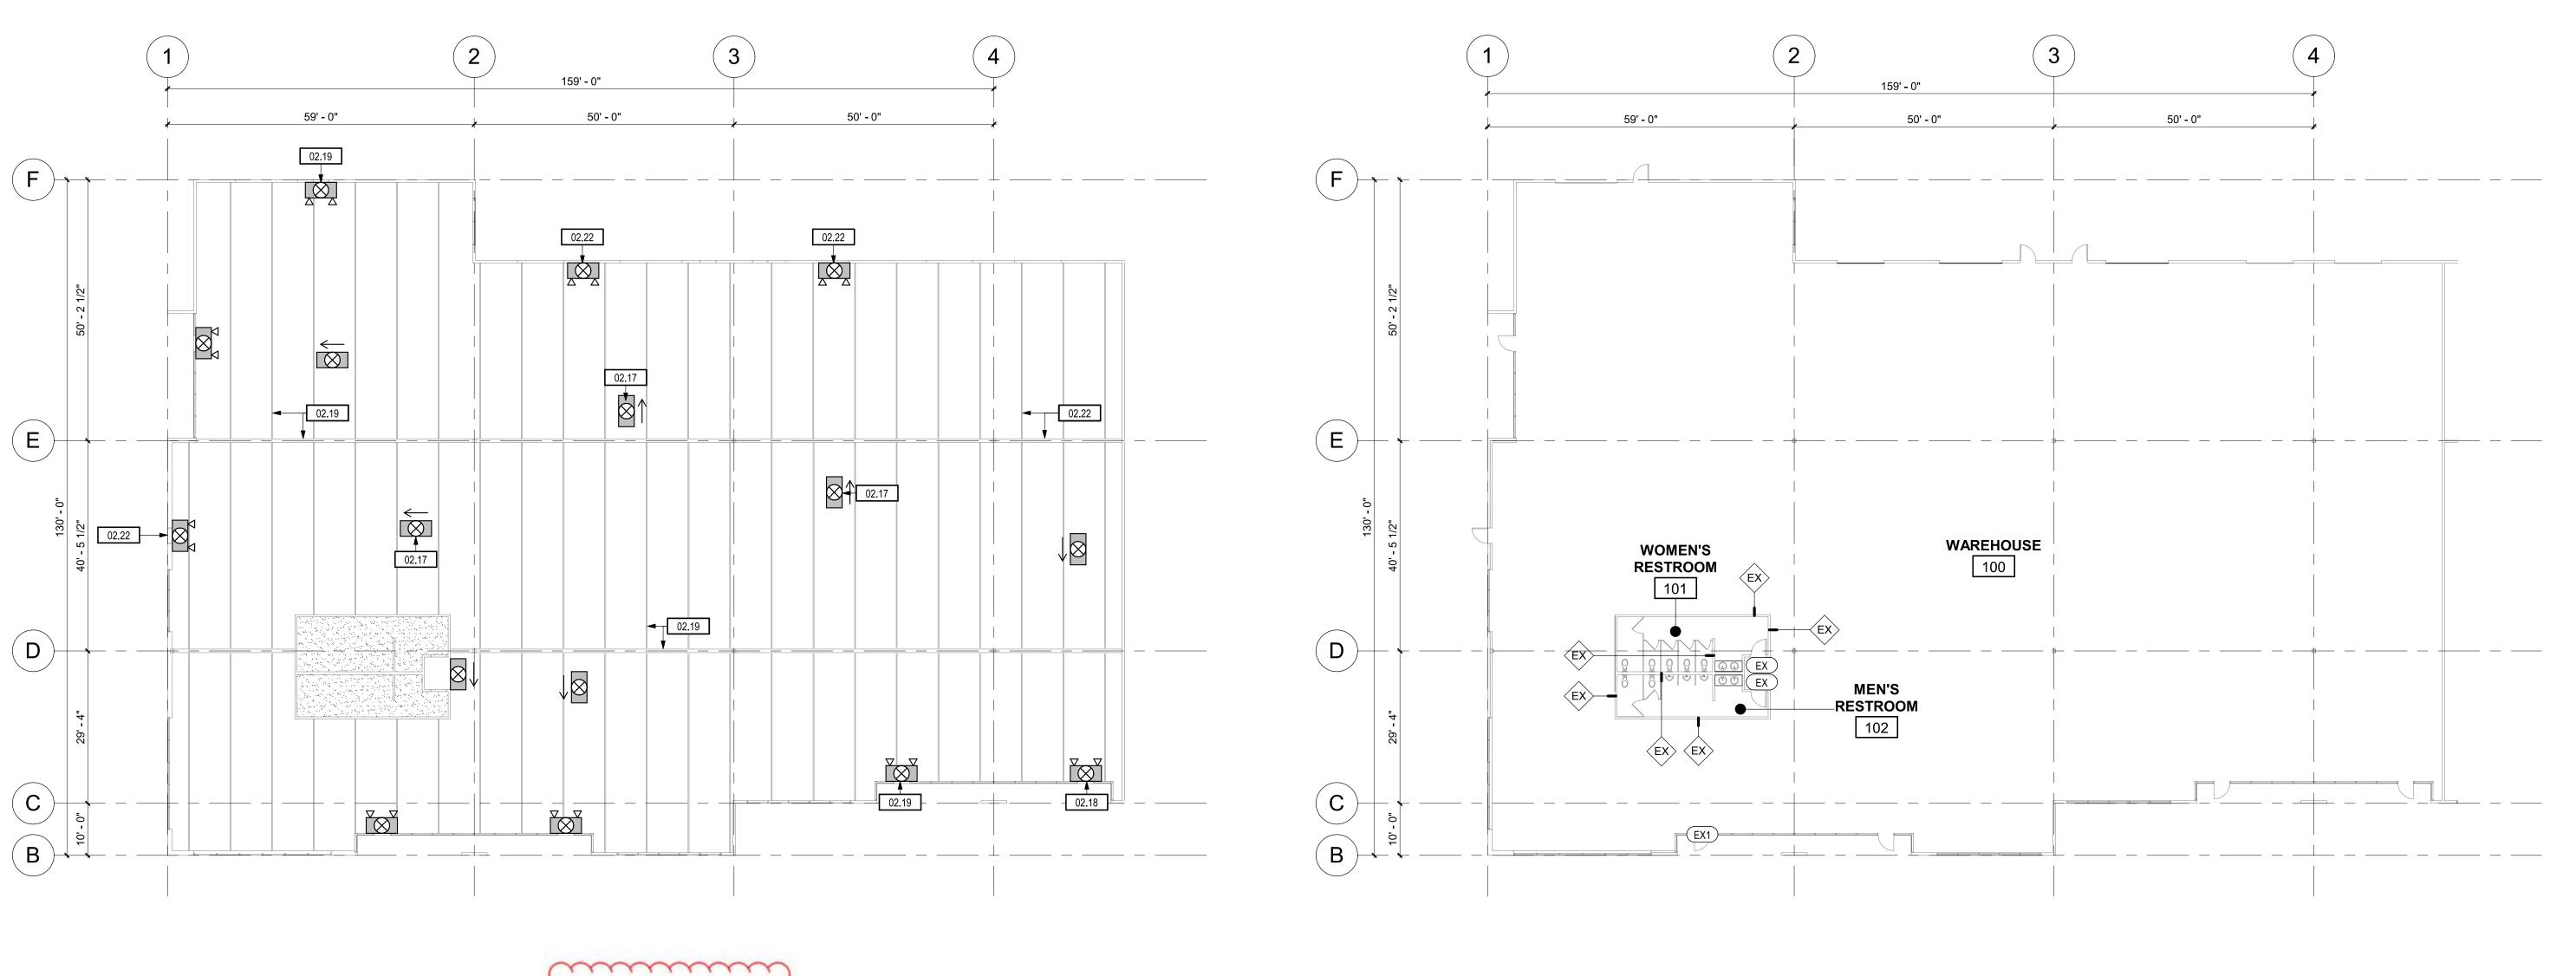

WAREHOUSE REFLECTED CEILING PLATING PL

AT CEILINGS OF 1,000 SF OR GREATER
PROVIDE CISCA-COMPLIANT SEISMIC BRACING WITH COMPRESSION STRUTS AT 12'-0" EACH WAY, ATTACH TO MAIN RUNNER, WITHIN 2" OF CROSS-RUNNER

INTERSECTION.

WAREHOUSE FLOOR PLAN

1/16" = 1'-0"

CEILING INSULATION: Where permitted by code furnish and install R-19 (or as required by the energy compliance

calculation), unfaced fiberglass batt insulation on top of the suspended acoustical ceiling at conditioned spaces.

7.3	THERMAL WALL INCLUATION! Euroleh and install B 42 (as as associated by the
	THERMAL WALL INSULATION: Furnish and install R-13 (or as required by the energy compliance calculation) unfaced fiberglass batt insulation from floor to roof in walls between conditioned and unconditioned spaces. Furnish and install R-13 at all furred exterior concrete wall at conditioned spaces. Provide a vapor barrier where required by code. For Seattle market, install R-10 rigid insulation from floor to roof in walls between conditioned and unconditioned spaces.
7.4	ACOUSTIC INSULATION: Furnish and install 3 1/2" unfaced fiberglass batt acoustic insulation in all toilet and shower room walls and ceilings, and demising wall at office area. The batt insulation at office demising wall should go the full height of the wall.
7.5	INSULATION FACING: All exposed fiberglass batt insulation shall have a white PSK-25 or approved equivalent facing.
7.6 7.7	SKYLIGHTS: Existing skylights in conditioned areas shall be sealed if they are vented.  ROOFING: The contractor shall use a roofing contractor certified to install the existing roofing material for patching of all roof penetrations. Prior to the work, contractor should verify with Prologis manager for the qualified roofers. The new roof penetrations shall be made in accordance with the roofing manufacturer's recommendations, such that the existing roofing warranty is maintained. The patch shall also meet all of the requirements stated in the building shall specifications. On built-up roofs, pipe and conduit penetrations at the roof shall receive galvanized pipe flashing with screw clamp and elastomeric sealant and shall also be hot asphalt patched with 4 ply.
7.8 7.9	ARCHITECTURAL SHEETMETAL: Furnish and install sheet metal cap flashing on top of any roof mounted wood sleepers approved by owner.  FIRE SAFING: Penetrations at one hour walls shall be fire safed or caulked.
DIVISION 8	INTERIOR DOORS AND FRAMES: Furnish and install 3'-0" x 7'-0" x 1-3/4", solid core, birch, B-3 stain prefinished dears in "Threely" prefinished black steel transa (clear encolored aluminum frames by ACI, Edipse or approved aqual in the San Francisco Bay Area), with 1-12" pairs of Heger BB1275 butto per door UCAN. (All office door shall receive a 2'-0" sidelight in the San Francisco Bay and Seatle Areas). Book reaching closes shall receive bell-bearing butto.  Droos and frames shall be 20 minutes rated where required. When working in an existing is read appare, the new dates and frames shall make the existing doors and frames U.C.N. Use matel frame for door backing, wood in not allowed.
32	MEW EXTERIOR OCCRS#RAMES: 20 gauge, full flush, 1-24" filek hallow need with discus benegated over or stead at littlewed hallow matal. Imstall overhead rain only fisching and wanther staboling on new hallow matal doesa. Here: 16 gauge with 2" faces and 5-2" steps tenned internal exmans miletal, weblied and ground arrests.
	INTERIOR DEADE HARDWARE: Furnish and install Schage AL108 Salum passage hardware on all dears accept single among absolute food for which shall receive Schlage AL408 phacey lades. The dear hardware chall have a broshed chame \$28 thich U.C.M. Furnish and install weather-stripping, absolute and drop scale of doors hardware operationed and non-conditioned areas. Furtish and install clears as all foliational share room deans. The clear shall be installed on the total aroman weathouse side of the door. When weating in an existing largest apace, the new clear hardware shall match the existing door hardware U.C.M.
8.4	EXTERIOR COOR HARDWARE. Make the coloting building hardware. Include door choses, mail alote, and latch sources an all new decry.
23	KETS: Owner shall relay all belong hardware
\$6 \$7	DCCR SIGNAGE: Include all algrage per sode (Handisan, Edit, etc.)  CAERHEAD DCCRS: Match the adding building conduced doors and door insulation. If no C.M. doors anist, was
******	invibied Coerhead Door Company or equal with 2" truck 20 gauge door vertest reinforced battom roll, with step pair flush purel coeffenet. Secondat exister concrete panels must be coeffied by a licensed structual engineer. No coeffuls will be allowed. Protect new overtoed door trucks with "Zee Guards": 200" trick bent plate, 4 bed long, lacted to the tilt-up wall penul to protect all lock overhead door tracks
義彦	(NTERICE WINDOW FRAMESIALASS: interior windows shall be 14" sleer temperal gloss sat in block "Timely" itemes for anodized aluminum frames in the S.F. Ray Asac) to reach the interior deer frames. Clasing height shall make door height, UCN; width shall be as Indicated on plans.
<b>教</b> 蒙	BIRFORS: IF until and install 4 high x 1/4 thick piete glass mirrors with two cools allow and absorption copper bushing, and supper said the proper said and a supper of the spiece and extending to the underside of the light short. If wall mounted leveluries are used, the mirror shall be a Bobrick 2436.
8.1	EXTERIOR GLASS: The glass in new storefront doors and "in-filled" truck door openings shall match the existing building glass. If the building glass is a long lead item, install gray vision glass (tempered if necessary) for temporary use until building standard glass is available.
8.11  DIVISION 9	WINDOW MULLIONS: Where interior drywall partitions meet the exterior window wall, furnish and install aluminum "false" mullions finished to match the existing exterior storefront.  FINISHES
Birioidira	
9.1	FIRE RATED WALLS: All Rated walls and partitions to meet UL U419 listed standards or equal. Metal studs with one layer of 5/8" type "X" gypsum board on each side from the floor to the roof deck. The stud size and spacing shall be per the stud manufacturer's tables and local code requirements. Install fire safing between the gypsum board and roof deck U.O.N. Provide proper UL listed head joint detail when required by code. Penetrations at one hour walls shall be fire safed or caulked per UL listings.
9.1 9.2	layer of 5/8" type "X" gypsum board on each side from the floor to the roof deck. The stud size and spacing shall be per the stud manufacturer's tables and local code requirements. Install fire safing between the gypsum board and roof deck U.O.N. Provide proper UL listed head joint detail when required by code. Penetrations at one hour walls
	layer of 5/8" type "X" gypsum board on each side from the floor to the roof deck. The stud size and spacing shall be per the stud manufacturer's tables and local code requirements. Install fire safing between the gypsum board and roof deck U.O.N. Provide proper UL listed head joint detail when required by code. Penetrations at one hour walls shall be fire safed or caulked per UL listings.  FULL HEIGHT DRYWALL PARTITIONS (including tenant demising walls): Metal studs with one layer of 5/8" type "X" gypsum board on each side from the floor to the roof deck with top slip track. The stud size and spacing shall be per the stud manufacturer's tables and local code requirements. Drywall installed above an acoustical ceiling shall be
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		MODITALWEST
	9.13	VINYL COMPOSITION TILE: Furnish and install 1/8" gauge, standard grade, VCT as manufactured by Tarkett, Azrock, or Armstrong. Install VCT in server rooms and IT closets. No VCT shall be installed in toilet rooms. Verify with Prologis Manager for final finish selection.
	9.14	RUBBER BASE: All areas receiving floor covering and new walls except the toilet rooms shall have 4" high topset rubber base as manufactured by Burke, Roppe, or Tarkett in a standard color. Install the rubber base on a continuously roll, not sectional. Verily with Prologis Manager for final finish selection.
	9.15	SHEET VINYL: New toilet rooms shall receive sheet vinyl flooring with a 6" integral flashed cove base with brushed aluminum trim on the top edge. All joints shall be heat welded and receive seam sealer. The sheet vinyl shall be Corlon or Mannington Magna. not available, need to specify later installed in all new toilet rooms. Verify with Prologis Manager for final finish selection.
	9.16	TRANSITION STRIPS: Furnish and install black vinyl transition strips at all changes in flooring material U.O.N.
	9.17	CERAMIC TILE: (Central Valley area only)
		RESTROOMS: Use 2x2 American Dlean ceramic tile or equal slip resistant on floors and 4x4 ceramic tile on walls as noted on plans.  ENTRANCES: When specified on plans, 8"x8" American Olean ceramic tile or equal.
		GROUT: color to be selected from manufacturer's standard colors. The tile floor shall be cleaned after installation to remove excess mortar and grout. The grout shall be sealed per manufacturer's recommendations. Verify with Prologis Manager for final finish selection.
	9.18	CONCRETE FLOOR SEALER: All concrete floor patches shall be resealed to match the existing concrete floor sealer / hardener in warehouse areas.
		PART: On walls reselving a stop invalve timbs, eaply one (1) cost of interior sound takes point, Shanata inthinus or equal in a standard light solar. Londot break raches, taket and shower researched the well at the entire burshall receive one (1) cost of lades sount-glass sound over one (1) cost of PVA easier. One of intrivid walls abell menture two costs of egypted lates point. Paint the vershause danising wells) and washouse wide of the office walls one (1) cost of interior that lates point if expired. Verify with Protogic blancaper for final finish selection. All expected transforms outcome 18-6 or inflar shall be painted CSHA yellow to 12-6 from A.P.F The momentum of the column above 12-6 to its rest shall be painted white.
		PART - REPAINT INTERRES: Value re-paining in an occupied area, vilice sare VCC paint in the appropriate limits. Adhere to all surface proposalizated application requirement per manufactural's protect specification data. Standard of quality shall be FPS Interview zero VCC product offering evolute PPS Piteburgh Paints Pure Performance Line.
	REST.	STAIN — NEW INTERIOR: Provide are (1) cost of state, one (1) opet of cooler, and two (2) costs of polyurathene salin finish for all history and decay. Adhere to all surface preparation and application togetoments per manufacturer's product operation data. Shandari of quality shall be PPGIPoter Paints protectional best perfect offering such as Poter Paints Wand Suantist or Pileburgh Paints Res Line.
		ASALTXXASBURZ: MC
	\$25	PANT - EXTERIOR: The extentor of the efficience bounce wall shall be pointed with extentor condit that white point. Adverse to all curtace preparation and application requirements per manufactural's product specification data. Secondard of quality shall be PROParter Points professional best product effecting such as Poster Paints Act Fac 100 or Philippural Points Speechtda.
	***	PANTING - DOCK EQUIPMENT - Paint dock levelors, leave enemal years glass lean One SAF 7065 with pit sagle period waste years years.
		WAREHOUSE FLOOR CTAIFING: helplied with the intent of future removed. Conduct states that blesting is INCT an autophidia method of their proposalen for sulpling. Use a modified appropriate limited at equal to interval and Interposal safety yellow; autostrations to be pre-approved by Prologie. Shiping to be removed using Smart Safe.
		BATTIERY CHARGER FLOCIA CONTING (Epecy): All new bullery charging sizes are to receive approximately 70 agrant feet of approximately response for the surface for surface for surface for chart and present the converte for installation of new approximate and present into converte for installation of new approximate and present recommendation. Apply one said of General Polymers 2078 100% solids agreey primar Apply two cools of General Polymers 3741 167% solids Newsier finish. General Polymers is the industrial fleet division of Stereoin Williams.
	DIVISION 10	SPECIALTIES SPECIALTIES
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	10.1 10.2 10.3 DIVISION 11	NAPKIN DISPOSALS: Bobrick B-2*0 sanitary napkin disposals in each women's toilet stall U.O.N.  PAPER TOWEL DISPENSER: Bobrick B-369 (for single accommodation tolet rooms) or a Bobrick B-3944 (for multiple accommodation toilet rooms) recessed paper towel dispenser with a waste receptacle U.O.N.  SEAT COVER DISPENSER: Bobrick B-221 seat cover dispenser in each toilet stall.  TOILET PAPER HOLDER: Bobrick B-686 double toilet paper holder.  GRAB BARS: Bobrick No. B6806-36 and B6806-42 stainless steel per ADA.  WASTE RECEPTACLE: Bobrick #B-3644  FRAMED MIRROR: Bobrick #B165-3436  ACCESSORY INSTALLATION: Contractor is responsible for all blocking and framing requirements, as well as any additional requirements for powered accessories.  TOILET PARTITIONS: Furnish and install metal, floor mounted, toilet partitions with a baked enamel finish by Global Steel, Knickerbocker or equal in manufacturers standard "quick ship" color. Project Manager may substitute plastic laminated partitions pending approval of specifications.  SIGNAGE: Furnish and install all handicap and exit signage as required by code.  DOCK EQUIPMENT  MANUFACTURER: All dock equipment when required by the customer as an upgrade shall be Arbon, Kelly / Serco, Nordock or Powerramp.  LEVELER PIT: All exposed edges of the dock leveler pit shall be protected with steel corner angles. The existing steel angle or channel at the face of the existing dock shall be replaced with new steel integrally tied to the new pit. Do not overcut the corners when sawcutting the concrete slab for the new pit. On the exterior wall, all edges must have a clean %" chamfer, accomplished by grinding or sawcutting the existing concrete with a %" chamfer and pouring the
	10.1 10.2 10.3 DIVISION 11	NAPKIN DISPOSALS: Bobrick B-270 sanitary napkin disposals in each women's toilet stall U.O.N.  PAPER TOWEL DISPENSER: Botrick B-369 (for single accommodation tolet rooms) or a Bobrick B-3944 (for multiple accommodation toilet rooms) recessed paper towel dispenser with a waste receptacle U.O.N.  SEAT COVER DISPENSER: Bobrick B-221 seat cover dispenser in each tolet stall.  TOILET PAPER HOLDER: Bobrick B-686 double toilet paper holder.  GRAB BARS: Bobrick No. B6806-36 and B6806-42 stainless steel per ADA.  WASTE RECEPTACLE: Bobrick #B-3644  FRAMED MIRROR: Bobrick #B165-3436  ACCESSORY INSTALLATION: Centractor is responsible for all blocking and framing requirements, as well as any additional requirements for powered accessories.  TOILET PARTITIONS: Furnish and install metal, floor mounted, toilet partitions with a baked enamel finish by Global Steel, Knickerbocker or equal in manufacturers standard "quick ship" color. Project Manager may substitute plastic laminated partitions pending approval of specifications.  SIGNAGE: Furnish and install all handicap and exit signage as required by code.  DOCK EQUIPMENT  MANUFACTURER: All dock equipment when required by the customer as an upgrade shall be Arbon, Kelly / Serco, Nordock or Powerramp.  LEVELER PIT: All exposed edges of the dock leveler pit shall be protected with steel corner angles. The existing steel angle or channel at the face of the existing dock shall be replaced with new steel integrally tied to the new pit. Do not overcut the corners when sawctiting the concrete slab for the new pit. On the exterior wall, all edges must have a clean ½' chamfer, accomplished by grinding or sawcutting the existing concrete with a ½' chamfer accomplished by grinding or sawcutting the existing concrete with a ½' chamfer accomplished by grinding or sawcutting the existing concrete with a ½' chamfer recessed pit
	10.1 10.2 10.3 DIVISION 11 11.1 11.2	NAPKIN DISPOSALS: Bobrick B-2*0 sanitary napkin disposals in each women's toilet stall U.O.N.  PAPER TOWEL DISPENSER: Botrick B-369 (for single accommodation tolet rooms) or a Bobrick B-3944 (for multiple accommodation toliet rooms) recessed paper towel dispenser with a waste receptacle U.O.N.  SEAT COVER DISPENSER: Bobrick B-221 seat cover dispenser in each tolet stall.  TOILET PAPER HOLDER: Bobrick B-286 double toilet paper holder.  GRAB BARS: Bobrick No. B6806-36 and B6806-42 stainless steel per ADA.  WASTE RECEPTACLE: Bobrick #B-3644  FRAMED MIRROR: Bobrick #B-3644  FRAMED MIRROR: Bobrick #B165-3436  ACCESSORY INSTALLATION: Contractor is responsible for all blocking and framing requirements, as well as any additional requirements for powered accessories.  TOILET PARTITIONS: Furnish and install metal, floor mounted, tollet partitions with a baked enamel finish by Global Steel, Knickerbocker or equal in manufacturers standard "quick ship" color. Project Manager may substitute plastic laminated partitions pending approval of specifications.  SIGNAGE: Furnish and install all handicap and exit signage as required by code.  DOCK EQUIPMENT  MANUFACTURER: All dock equipment when required by the customer as an upgrade shall be Arbon, Kelly / Serco, Nordock or Powerramp.  LEVELER PIT: All exposed edges of the dock leveler pit shall be protected with steel corner angles. The existing steel angle or channel at the face of the existing dock shall be replaced with new steel integrally ted to the new pit. Do not overcut the corners when sawcutting the concrete slab for the new pit. Or the exterior wall, all edges must have a clean ½* chamfer, accomplished by grinding or sawcutting the existing concrete with a ½* chamfer and pouring the new concrete with a ½* chamfer.  DOCK LEVELERS: Mechanical 6' s 8' 35,000 lb. capacity Arbon, Kelly / Serco, Nordock or Powerramp. The EOD mus be mounted per manufacturer's instructions and must be installed with a transition plate extending 12'minimum into the building if there is no exist
	10.1  10.2  10.3  DIVISION 11  11.1  11.2	NAPKIN DISPOSALS: Bobrick B-2'0 sanitary napkin disposals in each women's toilet stall U.O.N.  PAPER TOWEL DISPENSER: Botrick B-369 (for single accommodation tolet rooms) or a Bobrick B-3944 (for multiple accommodation tolet rooms) recessed paper towel dispenser with a waste receptacle U.O.N.  SEAT COVER DISPENSER: Bobrick B-221 seat cover dispenser in each tolet stall.  TOILET PAPER HOLDER: Bobrick B-886 double toilet paper holder.  GRAB BARS: Bobrick No. B6806-36 and B6806-42 stainless steel per ADA.  WASTE RECEPTACLE: Bobrick #B-3644  FRAMED MIRROR: Bobrick #B165-3436  ACCESSORY INSTALLATION: Contractor is responsible for all blocking and framing requirements, as well as any additional requirements for powered accessories.  TOILET PARTITIONS: Furnish and install metal, floor mounted, toilet partitions with a baked enamel finish by Global Steel, Knickerbocker or equal in manufacturers standard "quick ship" color. Project Manager may substitute plastic laminated partitions pending approval of specifications.  SIGNAGE: Furnish and install all handicap and exit signage as required by code.  DOCK EQUIPMENT  MANUFACTURER: All dock equipment when required by the customer as an upgrade shall be Arbon, Kelly / Serco, Nordock or Powerramp.  LEVELER PIT: All exposed edges of the dock leveler pit shall be protected with steel corner angles. The existing steel angle or channel at the face of the existing dock shall be replaced with new steel integrally teed to the new pit. Do not overeut the corners when sawcutting the concrete slab for the new pit. On the exterior wall, all edges must have a clean 3'c chamfer, accomplished by grinding or sawcutting the existing concrete with a 3'c chamfer.  DOCK LEVELERS: Mechanical 6' x 8' 35,000 lb. capacity Arbon, Kelly / Serco, Nordock or Powerramp. The EOD nust be mounted per manufacturer's instructions and must be installed with a transition plate extending 12' minimum into the building if there is no existing steel channel in the dock. Sawcut transition plate into the concrete fl
	10.1  10.2  10.3  DIVISION 11  11.1  11.2	NAPKIN DISPOSALS: Bobrick B-2 <sup>o</sup> 0 sanitary napkin disposals in each women's toilet stall U.O.N.  PAPER TOWEL DISPENSER: Botrick B-369 (for single accommodation tolet rooms) or a Bobrick B-3944 (for multiple accommodation toilet rooms) recessed paper towel dispenser with a waste receptacle U.O.N.  SEAT COVER DISPENSER: Bobrick B-221 seat cover dispenser in each tolet stall.  TOILET PAPER HOLDER: Bobrick B-266 double toilet paper holder.  GRAB BARS: Bobrick No. B6806-36 and B6806-42 stainless steel per ADA.  WASTE RECEPTACLE: Bobrick #B-3644  FRAMED MIRROR: Bobrick #B-3644  FRAMED MIRROR: Bobrick #B165-3436  ACCESSORY INSTALLATION: Contractor is responsible for all blocking and framing requirements, as well as any additional requirements for powered accessories.  TOILET PARTITIONS: Furnish and install metal, floor mounted, toilet partitions with a baked enamel finish by Global Steel, Knickerbocker or equal in manufacturers standard "quick ship" color. Project Manager may substitute plastic laminated partitions pending approval of specifications.  SIGNAGE: Furnish and install all handicap and exit signage as required by code.  DOCK EQUIPMENT  MANUFACTURER: All dock equipment when required by the customer as an upgrade shall be Arbon, Kelly / Serco, Nordock or Powerramp.  LEVELER PIT: All exposed edges of the dock leveler pit shall be protected with steel corner angles. The existing steel angle or channel at the face of the existing dock shall be replaced with new sleel integrally tied to the new pit. Do not overcut the corners when sawcutting the concrete slab for the new pit. On the exterior wall, all edges must have a clean % channel at the face of the existing one sawcutting the existing concrete with a % channel are complished by grinding or sawcutting the existing concrete with a % channel are comprished by grinding or sawcutting the existing concrete with a % channel are comprished by grinding or sawcutting the existing concrete with a % channel are comprished by grinding or sawcutting the concrete slab for
	10.1  10.2  10.3  DIVISION 11  11.1  11.2  11.3  11.4	NAPKIN DISPOSALS: Bobrick B-2'0 sanitary napkin disposals in each women's toilet stall U.O.N.  PAPER TOWEL DISPENSER: Botrick B-369 (for single accommodation tolet rooms) or a Bobrick B-3944 (for multiple accommodation tolet rooms) recessed paper towel dispenser with a waste receptacle U.O.N.  SEAT COVER DISPENSER: Bobrick B-221 seat cover dispenser in each tolet stall.  TOILET PAPER HOLDER: Bobrick B-886 double toilet paper holder.  GRAB BARS: Bobrick No. B6806-36 and B6806-42 stainless steel per ADA.  WASTE RECEPTACLE: Bobrick #B-3644  FRAMED MIRROR: Bobrick #B165-3436  ACCESSORY INSTALLATION: Contractor is responsible for all blocking and framing requirements, as well as any additional requirements for powered accessories.  TOILET PARTITIONS: Furnish and install metal, floor mounted, toilet partitions with a baked enamel finish by Global Steel, Knickerbocker or equal in manufacturers standard "quick ship" color. Project Manager may substitute plastic laminated partitions pending approval of specifications.  SIGNAGE: Furnish and install all handicap and exit signage as required by code.  DOCK EQUIPMENT  MANUFACTURER: All dock equipment when required by the customer as an upgrade shall be Arbon, Kelly / Serco, Nordock or Powerramp.  LEVELER PIT: All exposed edges of the dock leveler pit shall be protected with steel corner angles. The existing steel angle or channel at the face of the existing dock shall be replaced with new steel integrally teed to the new pit. Do not overeut the corners when sawcutting the concrete slab for new pit. On the exterior wall, all edges must have a clean 3'c chamfer, accomplished by grinding or sawcutting the existing concrete with a 3'c chamfer.  DOCK LEVELERS: Mechanical 6' 1 8' 35,000 lb. capacity Arbon, Kelly / Serco, Nordock or Powerramp. The EOD must be mounted per manufacturer's instructions and must be installed with a transition plate extending 12'minimum into the building if there is no existing steel channel in the dock. Sawcut transition plate into the concrete floor a
	10.1  10.2  10.3  DIVISION 11  11.1  11.2  11.3  11.4  11.5  11.6	NAPKIN DISPOSALS: Bobrick B-2'0 sanitary napkin disposals in each women's toilet stall U.O.N.  PAPER TOWEL DISPENSER: Botrick B-369 (for single accommodation tolet rooms) or a Bobrick B-3944 (for multiple accommodation tolet rooms) or cessed paper towel dispenser with a waste receptacle U.O.N.  SEAT COVER DISPENSER: Bobrick B-221 seat cover dispenser in each tolet stall.  TOILET PAPER HOLDER: Bobrick B-686 double toilet paper holder.  GRAB BARS: Bobrick No. B6806-38 and B6806-42 stainless steel per ADA.  WASTE RECEPTACLE: Bobrick #B-3644  FRAMED MIRROR: Bobrick #B165-3436  ACCESSORY INSTALLATION: Contractor is responsible for all blocking and framing requirements, as well as any additional requirements for powered accessories.  TOILET PARTITIONS: Furnish and install metal, floor mounted, toilet partitions with a baked enamel finish by Global Steel, Krinckerbocker or equal in manufacturers standard "quick ship" color. Project Manager may substitute plastic laminated partitions pending approval of specifications.  SIGNAGE: Furnish and install all handicap and exit signage as required by code.  DOCK EQUIPMENT  MANUFACTURER: All dock equipment when required by the customer as an upgrade shall be Arbon, Kelly / Serco, Nordock or Powerramp.  LEVELER PIT: All exposed edges of the dock leveler pit shall be protected with steel corner angles. The existing steel angle or channel at the face of the existing dock shall be protected with steel corner angles. The existing steel angle or channel at the face of the existing dock shall be protected with steel corner angles. The existing steel angle or channel at the face of the existing dock shall be protected with steel corner angles. The existing steel angle or channel at the face of the existing dock shall be replaced with new seel inlegatily ted to the new pit. Do not overcut the corners when sewclling the concrete slab for the new pit. On the exterior vall, all edges must have a clean %" channeler, accomplished by grinding or sawcutting the existing concrete with a 3%" cha
	10.1  10.2  10.3  DIVISION 11  11.1  11.2  11.3  11.4  11.5  11.6  11.7	NAPKIN DISPOSALS: Bobrick B-2'0 sanitary napkin disposals in each women's toilet stall U.O.N.  PAPER TOWEL DISPENSER: Bothick B-369 (for single accommodation tolet rooms) or a Bobrick B-3944 (for multiple accommodation tolet rooms) recessed paper flowel dispenser with a waste receptacle U.O.N.  SEAT COVER DISPENSER: Bobrick B-221 seat cover dispenser in each tolet stall.  TOILET PAPER HOLDER: Bobrick B-686 double toilet paper holder.  GRAB BARS: Bobrick No. B6806-36 and B6806-42 stainless stoel per ADA.  WASTE RECEPTACLE: Bobrick #B-36444  FRAMED MIRROR: Bobrick #B1653436  ACCESSORY INSTALLATION: Contractor is responsible for all blocking and framing requirements, as well as any additional requirements for powered accessories.  TOILET PARTITIONS: Furnish and install metal, floor mounted, toilet partitions with a baked enamel finish by Global Steel, Knokerbooker or equal in manufacturers standard "quick ship" color. Project Manager may substitute plastic laminated partitions pending approval of specifications.  SIGNAGE: Furnish and install all handicap and exit signage as required by code.  DOCK EQUIPMENT  MANUFACTURER: All dock equipment when required by the customer as an upgrade shall be Arbon, Kelly / Serco, Nordock or Powerramp.  LEVELER PIT: All exposed edges of the dock leveler pit shall be protected with steel corner angles. The existing steel angle or channel at the face of the existing dock shall be replaced with new steel integrally ted to the new pit. Do not overcut the corners when sexutting the concrete slab for the new pit. On the exterior wall, all deges must have a clean ½" chamfer, accomplished by grinding or sawcutting the existing concrete with a 3"c chamfer and pouring the new concrete with a 3"c chamfer; accomplished by grinding or sawcutting the existing concrete with a 4"c chamfer.  DOCK LEVELERS: Mechanical 6" x 8" 35,000 lb. capacity Arbon, Kelly / Serco, Nordock or Powerramp. The EOD nus be mounted per manufacturer's instructions and must be installed with a transition plate extending
	10.1  10.2  10.3  DIVISION 11  11.1  11.2  11.3  11.4  11.5  11.6  11.7  11.8	NAPKIN DISPOSALS: Bobrick B-270 sanitary napkin disposals in each women's tollet stall U.O.N.  PAPER TOWEL DISPENSER: Botrick B-389 (for single accommodation tolet rooms) or a Bobrick B-3944 (for multiple accommodation tolet rooms) recessed paper towel dispenser with a waste receptacle U.O.N.  SEAT COVER DISPENSER: Bobrick B-221 seat cover dispenser in each tolet stall.  TOILET PAPER HOLDER: Bobrick B-221 seat cover dispenser in each tolet stall.  TOILET PAPER HOLDER: Bobrick B-868 double tolet paper holder.  GRAB BARS: Bobrick No. B6806-36 and B6806-42 stainless steel per ADA.  WASTE RECEPTACLE: Bobrick #B-3644  FRAMED MIRROR: Bobrick #B165-3436  ACCESSORY INSTALLATION: Critractor is responsible for all blocking and framing requirements, as well as any additional requirements for powered accessories.  TOILET PARTITIONS: Furnish and install metal, floor mounted, tolet partitions with a baked enamel finish by Global Steel, Knickerbocker or equal mil manufacturers standard "quick ship" color. Project Manager may substitute plastic laminated partitions pending approval of specifications.  SIGNAGE: Furnish and install all handicap and exit signage as required by code.  DOCK BOUIPMENT  MANUFACTURER: All dock equipment when required by the customer as an upgrade shall be Arbon, Kelly / Serco, Nordock or Powerramp.  LEVELER PIT: All exposed edges of the dock leveler pit shall be protected with steel corner angles. The existing steel angle or channel at the face of the existing dock shall be replaced with new seel integrally led to the new pit. Do not overcut the corners when savcutting the concrete slab for the new pit. On the exterior wall, all edges must have a clean %"Channel", accomplished by grinding or savcutting the existing concrete with a 32" channel are properties of the shall be replaced with new seel integrally led to the new pit. Do not overcut the corners when savcutting for exacuting the existing plate extending 12"minimum into the buildingl if there is no existing sheel channel in the dock. Savcut rans
R	10.1  10.2  10.3  DIVISION 11  11.1  11.2  11.3  11.4  11.5  11.6  11.7  11.8  DIVISION 12	NAPKIN DISPOSALS: Bobrick B-2**0 sanitary napkin disposals in each women's toilet stall U.O.N.  PAPER TOWEL DISPENSER: Bobrick B-369 (for single accommodation tolet rooms) or a Bobrick B-3944 (for multiple accommodation toilet rooms) recessed paper towel dispenser with a waste receptacle U.O.N.  SEAT COVER DISPENSER: Bobrick B-22**1 seat cover dispenser in each tolet stall.  TOILET PAPER HOLDER: Bobrick B-268 double toilet paper holder.  GRAB BARS: Bobrick No. B6806-36 and B6806-42 stainless steel per ADA.  WASTE RECEPTACLE: Bobrick #B-3644  FRAMED MIRROR: Bobrick #B-3644  FRAMED MIRROR: Bobrick #B-36436  ACCESSORY INSTALLATION: Contractor is responsible for all blocking and framing requirements, as well as any additional requirements for powered accessories.  TOILET PARTITIONS: Furnish and install mitstall mitstal, floor mounted, toilet partitions with a baked enamel finish by Global Steel, Knickerbocker or equal in manufacturers standard "quick ship" color. Project Manager may substitute plastic laminated partitions perioding approval of specifications.  SIGNAGE: Furnish and install all handicap and exit signage as required by code.  DOCK EQUIRMENT  MANUFACTURER: All dock equipment when required by the customer as an upgrade shall be Arbon, Kelly / Serco, Nordock or Powerramp.  LEVELER PIT: All exposed edges of the dock leveler pit shall be protected with steel comer angles. The existing steel angle or channel at the face of the existing dock shall be replaced with new steel integrally teel to the new pit. Do not overcut the corners when sacutting the concrete slab for the new jit. On the existing wasture as a lean % chamiler, and pouring the new concrete with a % chamer.  DOCK LEVELERS: Mechanical 6' > 8' 35,000 lb. capacity Arbon, Kelly / Serco, Nordock or Powerramp, with recessed pit per manufacturer's oftenia.  EDGE OF DOCK LEVELERS: 72' vide x 3,000 lb. capacity Arbon, Kelly / Serco, Nordock or Powerramp. The EOD must be mounted per manufacturer's instructions and must be installed with a transition plat

DIVISION 15	NORTHWEST PLUMBING
DIVISION 15	
15.1.1	DESIGN BUILD: Unless engineered plumbing system drawings are included in the bid documents, the plumbing work shall be performed on a design-build basis. The design-build plumbing contractor shall furnish and install a complete and operative plumbing system to meet all local and state codes.
15.1.2	PLANS: Provide plumbing plans for architect's and owner's review and approval.
15.1.2.A	SEWED LINES: Sower, seil and wests lines within the building helev the finished fleer elevation shall be selectule 40.
15.1.3	SEWER LINES: Sewer, soil and waste lines within the building below the finished floor elevation shall be schedule 40 ABS plastic or schedule 40 PVC plastic pipe. Sewer, soil and waste lines within the building above the finished floor elevation shall be standard weight cast iron. ABS piping may be used above the finished floor if permitted by code and approved by the owner. All lines should be at least a 1% grade of gravity flow. Must ensure that tree roots will not interfere with path of the sewer, soil, and waste lines.
15.1.4	GAS LINES: All gas lines shall be run under the roof above the bottom cord of the trusses perpendicular or parallel to the existing roof structure. All new and existing gas lines within a single tenant space shall be connected to a separate gas meter.
15,1.5	PIPE MATERIAL: All pipe materials shall be subject to the requirements of the City and/or governing body. All domestic water, condensate, and smitty pan drain lines must be copper.
15.1.6	PLUMBING FIXTURES AND TRIM:
15.1.6.A	LAVATORY FOR VANITY: American Standard, " Cadet Everclean- Oval Countertop Sink", model 0419.444EC, white, self-rimming or equal with a Delta Model 523 LF HDF or Moen L4601 single lever type faucet assembly with a grid strainer and bright chrome finish. Furnish and install a Handy-Shield Drain Cover #3011 White by Plumberex Specialty Products under each lavatory.
15.1 A.B	YALL-HUVE LAVATORY: American Shardard, "Locative", model 6565.012, which, well maunted beautary or equal with a Color Nach 1555 LF FOF single lever type faucal meanually with a grid strainer and bright diverse fauch. Furrish and install a Handy-Straid Crain Cover 65511 White by Planthance Specially Products under sect lessing.
15.140	WATER CLOSET: American Standard, "Madema Flowing-Right Height" elempased, fluch valve inflat, 17" height, model SD4S-801 of approved aqual in white, with an Chambe 25% seat and a Stoom Will fluch valve
151.4D	MATER CLOSET IF WATER SUPPLY IS NOT SUPPICIENT FOR FLUSH VALVE Anation Sencera Cadar elongated practure easily and total, block if 2009-100 (active) with Classific 200 SETL (all easil (active) by non-hybrid appeal applications.
18.18.3	American Standard Cadel Right Height Elongated pressure ensisted toller, medal \$ 2377, 100 (white) with Okanite # 64 SETL toller seen (white) for ADA applications.
機式處原	URMAL: American Standard, "Absolutook Flokkled", model (1990-125, or approved capal, with a \$4" top appl. For Perferrit Area: American Standard, "Neglitarook Flokkled", model (1990-125), or approved equal, white. American Standard model (1990-125 corress eith flush valves
16.1.84	OCFFEE BAR / LUNCH FAXM SINK: Elwy, model LFAC 1916, stainless shall, with a Dalla 2100 featest. If the Lunch Room base cathosite 2-0" or longer, use so Elwy model GEOR 2201, Furnish and install a Handy-Sideld Brain Cover 2001 White by Frambaser Specially Products under each sink.
15.1.8.1 15.1.8.1	LAINDRY TRAY: When specified as a customer upgrade use Fist Products, bishbas-Guns, model FL-1, with 20 gallon capacity, or Flanshone Model Fist Littly Sink with a Dalla model 2125 is mery up issued.  SHOWER, ENGLOSUPE: When specified as a customer upgrade use Florestone, wheeltheir soccasiols fiberglass
ংশ্যার ও কেন্দ্রের	structured control course specimen as a customer appeared and therefore the specimen appeared independent specimen appeared in the specimen appeared in the speciment from the speciment of the s
15.1 & J	WATER HEATER: The water haster shall be A.O. Smith, State or appressed again sized to mentific demand. It shall be tooked on the waterhouse from in a smitty sen shall be a trub drain with a targ primer. The location shall be as tooked by the calling the made with distance unions. Installing the water facility in calling in mit slawed.
18.1.8.K 18.1.8.L	WATER COCLER: It drinking fountain is especified on the plan use Elsey model EZSTLAUC for the high-low drink fountain. If the boot jurisdiction requires the protection for a blind person, use Botalet model '618288' grap far; 1 %' stainless close. Install two grap have, one at each and of the bundion.  JANTOR'S HAND SINK Musica Dillious Novel & 18F — Floor mount, or blockel 1889 — wall have, or course.
15.1.6.M	Janitor's Mop Service Basin: Mustee Model # 62M 24" x 24" x 8 1/4" with Mustee Service Faucet Part No. 63.600A
15.1.7	chrome plated brass service sink faucet, ½" pipe eccentric inlets on 8" centers, or equal.  CONDENSATE DRAINS: Furnish and install copper condensate drainage lines with proper venting for all HVAC equipment. The lines shall be no smaller than 3/4" diameter and shall be located under the roof unless prohibited by
15.1.8	code. PVC condensate lines may not be used. In Reno, provide evaporator pans set in roof mastic.  SHUT-OFF VALVE: Furnish and install a main water line shut-off valve for the restrooms in the handicapped stall in
	the men's restroom, not above the ceiling, with an 8" x 8" painted steel access panel. Provide a typed label "Vain Water Valve" on the access panel.
15.1.9	MAIN WATER LINE: If a main domestic water line is not existing above the tenant space, furnish and install a 2" diameter copper water line at the roof installed above the bottom corc of the trusses, properly braced to avoid movement. At each future tenant space that the line crosses, install a 2" "T" with 2" gate valve (one valve per storefront door). Extend the water line through the tenant demising wall into the "downstream" adjacent tenant space with a 2" diameter gale valve. Furnish and install a 2" pressure reducing valve with an access panel at the water service entrance when required.
15.1.10	HOSE BIB: Provide one rooftop hose bib if not existing (freeze proof where required). Vendors to drain water after
15.1.11	each use.  CLEAN-OUTS: Furnish and install a brass floor clean-out cover at the proper finished elevation as required. If the clean-out is in the warehouse area, furnish and install a cast iron heavy duty traffic rated cover.
15.1.12	FLOOR DRAINS: Provide intoilet rooms where required by code.
15.1.13	INSULATION: Insulate all water piping (except Florida) with 1" insulation. Use 1 ½" insulation for piping in exterior walls.
DIVISION 15	FIRE PROTECTION
15.2.1	DESIGN BUILD: The fire protection work shall be performed on a design-build basis. The design-build fire protection contractor shall furnish and install all modifications to the existing fire sprinkler system to meet all applicable local and state fire state requirements. Sprinkler haves shall be dropped into all suspended colling areas. Vegration with a data IV company. In hallings with EEFR systems, maintain the necessary cleanages from all contractions.
15.2.2	PPS NATERIAL: All the spinder giping shall be standard schedule 10 for 3° piping, and schedule 7 for 4° and 2 %
15.2.3	piping U.C.A. Schools & jan may not be used.  STANDARD WALL: Schools 40 pipe is considered "standard well" pipe. Schools 10 pipe is acceptable in size & inchest langur provided submittels for Schools 10 pipe are approved by the Prologic Project Manager. Pipe connections what he welled to growed couplings (Victoria or approved equal). Threadaint this wat pipe abid not be used.
15.2.4	Schedule & and other thin wall pipes whell not be used.  THIH WALL: Schedule 7 Dyne flow "lines" pipes", or approved equal is acceptable for branch lines have from 8 Indiaes in dismoster provided extenditions for Schedule 7 Dyne-flow "theologice", or accept, are approved by the Protopic Project blennings. Pipes acomections shall be escided or provided couplings (Videolis or approved equal). Three-lable thin well pipes shall not be used.
15.2.5	EPRINIALER NEACH: The fre sprinter brooks in areas with springe shall be choose, sent-executed, with white executioners. When "execut book" arounded colling thes are used, sprinker books what he contend on the helf file.
15.2.6	HYTRALILIS TESTINGS. The contractor shall include the coat of any required by draube leading of the fire symbles system.
	FRE EXTINGUISHERS: Fre compulations shall be furnished and installed per sky live code. Extinguishers may be sail
15.2.7	Delta.
15.2.7 15.2.8	hang.  STETEN SHAT DOWN: The building may be equipped take on EEFR for protection system and bocater pump. The pump must be knied of gain to according any that in the system. The pump must be turned lack on immediately effect in complete each day. Herea must be used to drain down the system into the reserved catch begin to excit staining of occurred, exploit software, and damage to knotscape error. Context the Owner's property mension prior to prefer many prior to prefer any work on the live system, or descriveting the pump.





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PROLOGIS
PUYALLUP 2
SUITES
A101-A103 T.I.

PROLOGIS PUYALLUP 2 402 VALLEY AVE. NW PUYALLUP, WA 98371



5900 AIRPORT WAY S SUITE 300 SEATTLE, WA 98108

PHONE: (206) 414-7600 FACSIMILE: (206) 414-7601

PROJECT # 21008.08

SHEET TITLE:

PROLOGIS CUSTOMER FINISH STANDARDS

SHEET NUMBER:

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NOT RELEASED FOR CONSTRUCTION

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	CUSTOMER FINISH STANDARDS		
	NORTHWEST		
DIVISION 15	HVAC		
16,3.1	DESIGN SUITO: Unless engineered HVAC system drawings are included in the bid discurrents, the HVAC wind shall performed an a design-build basis. The design shall be based upon ASHRAE standards, local code, and weather date Calculating that he provided upon owner request. The design-build HVAC contractor shall furnish and install is sampled and operative HVAC system to meet all local and state codes.		
15.0.2	Plantin Residentially plans has pulled and smarks review and approval.		
ikag	MADISCHT! WHILE SAFEE BILLER SAFE SAFE DESIGNATION FOR PAIRS OR LEDGE WATERY, 2 live your compressor parts SERVICE SAFE WITH SERVICE SAFE SAFE SAFE DESIGNATION OF COMPRESSOR.		
<b>北京美</b> 和	CHANGE THAT SHATTALES TRATIFIES AND		
<b>15.2.</b> 5	LMC3c The MVAC units shall be gastelectric, bottom discharge, or manufactured by Cerriar, Trene, Laruest in foriging the Links shall be extended on a leveled, manufactured such. All mortop equipment shall be extendedly featured in the Section of Section (model SECCI) by Trene State Section (model SECCI) by Trene State Section (model SECCI) by Trene Spanish Section (model SECCI) by Trene Spanish Section (may only be used in the Las Veges or Process markets. When heat pumps are used, the process for the state Section (model section) by the section point within the last sold install engineers on all policing sections. The Denier and Section City seas, provide that pumps.		

accuments. In a five comment is a connected to a 7-day department of the mount. At manuscript is a connected to a 7-day department. It is a manuscript in a five to a five connected to a

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TIT Militic All was kannon Militigarahali harkerduma ekanpeta vida kading quadmatin main sani basadastaka. Tha

MALLER. Al confidentiarem nelleger apprehanderen fyr in del nelstandeler. Tensferylle austi panifel in beskeppen. Apprend plansk mydden all berkin friederen flishelleger anbelden,

Ludy product. Such absolutes dell'associa acque piesa dell'ass. Ludy product kon predicte (1877) i base

ALMERI: Filters shall be beared at the unit, not at the return register. Replace all existing filters after the conditions

DUST 監接的 DETECTORS; Smoke detectors shall be installed in all large 2000 of their greater ender stocker stocker

BESIGN XXII.O: Unless enginemed electrical cystem drawings are included in the bid documents, the blieblical work shell be perferred on a cheign-build back. The design-build electrical contractor shall turnish and install a complete:

METER SECTION: Furnish and includ an electrical mider section "bussed for house" recitions that exercise

REFER RAPINADA LED SPECIFICATION FOR DERERLING BULLATION AND FIXTURE REQUIREMENTS.

IFFNELLEGIUMS Funish and insidi Zolf leasts IEC lightlighters pails alonging corylic tens, who d is the XIIIII

ruh peris, memorie las fect conches agust dell'Arman periodesi ha code bat reches dianami (Estapose per fil al E

NORTERESCORE LIGHTINGS If not including in the Smill and should have investigated in the filter follows in exchange 25 foot

maliforn companion and evoid conflict the stage to the first scale that evolution (see all y part to place to the bands or minitor form, versions for the hyperitation of the minimal decide in a figure in a line in a code

3,171.ET SCACES: All pullet boxes for well switches, well receptedoe, telephone, ato shall be gaivenized steel or seat

RECEPTACLES: Furnish and install five (2) i 10V duplex receptables and one (1) telephone "ring and string" in each

DEDICATED RECEPTACLES: Firmish and install a dedicated 110 notification plex cutted in the falsiphone board and inso

if GREAPTACLES: Provide one GPI skeriotal outet in each tolled room and above the break room counter. Install

WAREHELISE SWITCHING: The warehouse lighting shall be controlled with lategral occupancy sensors, or in ent ni gnithgil no mut at (arobotnos gnithgil gnitasago) ásilva lauram a "vilahelibbé. Abbi lasol film sensionsa

ELECTRICAL CONDUIT / CONDUCTOR MATERIAL: All conduit shell be EINT or INC came. All consustans must be

CANCLUT DESTALLATIONS AI conside in some which eadings also be also at or close the betains of the

He existly may be installed below the eleb-or on leg of the med without the cannots written consission.

tieras of basita. Al capitile shall be ith el 20 degress of social to strubusl matrices, walk, liters, and callings

IELEM-CHE CONCLT: Funish and hazal a Z' dianasa maisl aendul da phene quiem bem he kalilog inteptene servine entrense is a kolephone based within the lement space. Use PPC where all and the by made. Field verify

createn of building telephone service entrance. Verity that the concluit does not electual EEFF1 aprinting basels.

dedicated 1107 outlets at the collection. Provide a dedicated 20 AMP GPI recounse if within 5 of any state.

recities (evident 30° A.F.F. based or opposes fiers plant librituse whall have 15° abidC californed had be placed to

PANEUS AND TRANSFORMESTS: The locations of the 277/400 will described panel, the transformer and transformer ad dedical panel shall be approved by the owner. Typically from stand be located on the office/weeksuse and edistriction the refer mores. The parent entrols had be beauted on a femble graph. The electrical consist and

gregarianism of a lampe. At design skall is taken in a detail on a detail of complate gauge for low pressure use. Pleasure deal scient from the unit to the base of the tradported beauties.

model than midding system, at absoluted distributed by well be removed.

erendarakik. Indoneringkan megbeliki Tahun biblibidenas

compassion be supported programment.

CONDINEATE DRAINS A PIPING: See section 15.1.7.

and disarative electrical avatery to meet all local and state codes.

office. Any encosed istephene bewas shall receive a blank cover.

Spessi Bay shall be provided in a location approved by Prologis.

raceser. EläFR appinkter hande stratt net be elektrocket by conduit.

SFI receptables wherever required by code.

PLANE: Proside electrical place for excitients and career's review and epprove.

ENERGY CALCS: Provide sixtrar-consistance code lighting calculations if received.

institution siteli ka sized in allow its a 25% kessassi in the curiose distribution in tea futus.

filias. "Alter dec (1) light flature man small asiliailea self flair to provide 24 haur lighting.

WAREHOUSE HEATERS: NIC

DRAFT STOPS: NIC

ARE COMPLETELY LEGIBLE.

**CONFIRM PLAN SHEETS** PRINTED FOR JOB SITE

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PROLOGIS® LED LIGHTING SPECIFICATIONS

work in the Prologis Americas portfolio. Prologis has selected Assity Brands to be the sola

This LED Lighting Specification sets product, install, and progurement audence for all LED lighting

TRIM COLOR: All light switches, outlets, and electrical trim shall be white U.O.N. LABELING: Label all panels, control points, switches, and motors as directed. Panels shall be identified by panel eligible. Eligibles shall have typed labels indicating the equipment which they cannot. Typed (clicality cannot Stacker and installed be supplied and installed.

unless otherwise required.

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LATELINES: (Lebs) all panels, control points, avinches, and motors as directod. Panels shall be intentified by general highless. Existing about hear byped labels indicating the equipment which they control. Types (about) panel scientification to be supplied and establed.

FELEPHONE BOARD: Furnish and install one, 4'x8'x3/4", APA C-D plugged (paint grade), fire retardant plywood elephone backboard for mounting customer's electrical or telephone equipment. Provide No. 6 copper ground wire

> menofacturer of LED lighting in the pertities. All LED lighting operal will need to be directed Carcusto Assistr's Nelland Accountings. National Account Prising Reference Acuity Branda Code 901-18-10355 Specific process flow starts scalleing the procurement process and correct contact for each

category (New Development, Til. Make Readly, Essentials) are attached as exhibits to this


#### LIGHTING SYSTEM DESIGN, PERFORMANCE AND INSTALLATION REQUIREMENTS

General Requirements: The following general requirements apply to all Prologis lighting projects:


- All work should be peoplified and pedanted in accordance with local codes. 2. Pitalianalità illuminalian siusilea are required for all projects. Reflectance values of scaled control and addition about the season on the space being lit, utilizing photos,
- Local, regional or tenant-driven specifications must be approved or directed by Prologis.
- 4. Branch wiring #2 and smaller shall be copper.
- Conduit and cable shall run parallel to or at 90° to building lines.
- Overhead conduits to be EMT. Alternate types for special conditions to be approved
- Junction boxes shall be labeled with source pariel and circuits contained. 8. Conduits above the roof deck (under the insulation) or within or below the slab are

#### Wsrehouse Specifications:

- A. Minimum Muminetien: Come venetouse sees 25 FC average, 12.5 FC minimum (30" AFF). Rackest eteles - 12 FC average, 7.5 FC minimum (30" AFF).
- B. Uniformity Nation Maximum to minimum of 4:1, average to minimum of 2:1.
- C. Design Considerations: Fabures shall be availy epaced across the floor plan. Lighting designer shall have the flexibility to shift perimeter light rows off of the typical spacing for the project to initialinize dark comer conditions and better illuminate the "Speed Bays" (the first column bay in from the dock wall). When available, racking plans should be used to develop a quality, costafficient lighting design. When racking plans are not available, and a new lighting layout is feasible, layouts based on diamond foture arrangements illuminate open floor plans well and constant politicae brodefes ed et econitit rand goridgen yaj goldon endul-of eldicali nicenor where listages fell disardly after a racidenia.

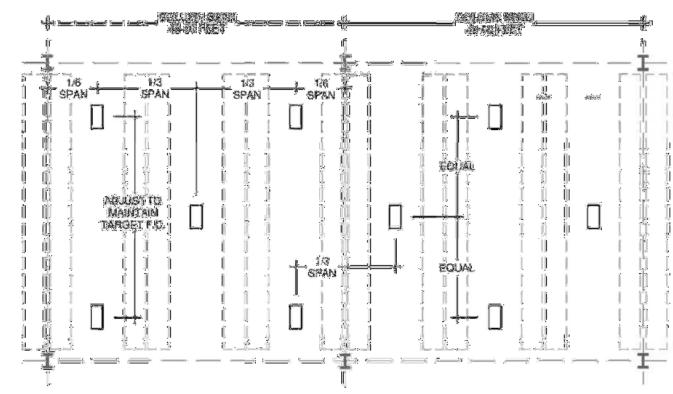

D. Fixture Mounting: Fixtures shall hang 0-6" above the bottom chord of the secondary roof framing members (above the Clear Height) to maximize warehouse volume. Please refer to the fixture mounting detail below. Lucatrative shall be installed with MC Catile whips containing #12 ATM3 reminders, 15" in length at as eleased by code. If allowed locally, a beliding-wide madels with o system (FELOG, hitsiff, rds.) may be used. Fjelores comed be also hed to the real deak without aggregal from Protein and the structural contress.

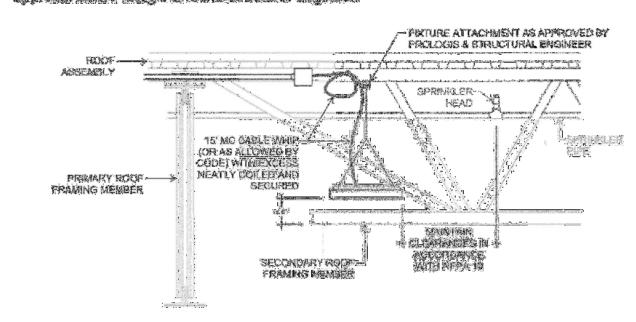

E. Controls: Local code will drive the level of controls required. At a minimum, luminaires should be provided with integral occupancy sensors (and daylight sensors when skylights are present) for local, non-networked control. All sensor and control types shall be selected by the design professional.

#### Office/Non-Warehouse Specifications:

#### ä. Binimum Illumination:

- L. Office: 55 FC average (50° AFF)
- 2. Conference rooms: 43 FC average (30" AFF) Corridors / circulation: 25 IFC average (30" AFF)
- 4. Restrooms, cafeteria, break areas: 30 FC average (32" AFF)

B. Uniformity Ratio: Maximum to minimum of 3:1, average to minimum of 2:1 C. Fixture Analication: Diumination for interior office suites should be provided with 2x2, 2x4, recessed downlights and linear fixtures as required to meet the design intent. No less than two fixtures per private office, one light fixture near each exterior exit door to provide 24-hour lighting, plus emergency and egress lighting per code.

D. Controls: Local cods will drive the level of controls required. At a minimum, nonnatacrised occupancy controls should be provided. All sensor and control types shall be selected by the design professional. Care should be taken to ensure the apecific asneon matches the use of the space, occupancy type, spatial and environmental factors, and local code.

#### **Exterior Lighting Specifications:**

#### A. Minhoem Humination:

- Trailer parking and truck courts: 0.5 FG average (at grade).
- Auto parking: 1 FC average (at grads)
- 3. Main building entry and exits: 5 FC average (at grade)
- Pedestriam walkways: 2 FC average (at grade)
- 5. General insific signilation: 1 (FC average (st grade)) B. Uniformity Raise Assess to minimum of 4:1

C. Fixture Application; Extense lighting projects shall samely sain all applicable codes and requirements. Illuminated in site! be provided first by wall parks, then by pola-mounted luminaires as a last resort, to meet the design intert. Wall packs shall be provided at exterior man doors and at truck dock grage. Pate lights shall be 30' and 45' fall in our and inuck traffic areas. respectively for an required by laced certely and shall not be lacebled to halfs-exposed areas. Fixture selections stands consistor site-account is about audit on bedalaht, unlight, and clare restrictions (collectively SLUSE), and presence of receding birds.

D. Controls: Localicade vali diva the least of seatable beauted. Exterior lighting shall, at a minimum, be controlled by an astronomic time clock system located near the house electrical panel. Time clock should include an override function so lighting can be forced 'on' during nonprogrammed hours to assist trouble shooting and replacement.

# LED HIGHBAY



#### \* SPECIFICATIONS:

- COLOR TEMP 5000K COLOR RENDERING - 80 CRI
- LUMENS- 24000 NOMINAL LPW TARGET -160 LPW NOMBAS o AMBIENT — 新自己等差别

- o LSXR SEMERAL (多种最高)
- o JOB PACE SE BATTERY DATE OF ATTLE THAT BE THE TOTAL MYOLT ONLY)
- CORD & PLUG (OPTION ONLY)
- DISTRIBUTION GND HVOLT (347-480)

# MOTION SENSOR



SENSOR PROGRAMMING A SPECIFICATIONS

#### LEXE 6 AC 1V 7.5M 7.5M VLP

CENS - HIGH BAY 380 OCCUPANCY TIME DELAY = 7.5 MINUTES DIM TO OFF TIME DELAY = 7.5 MINUTES HIGH TRIM = 100% Low trim = 10% Photocell = enabled divort and cimming Photocell set point = 4FC

#### SEQUENCE OF OPERATIONS

- UPON OCCUPANCY: LIGHTS TURN ON TO 199% AMBIENT LIGHT IS MEASURED BY THE PHOTOCONTROL AND IF DETECTED, WILL ADJUST THE LIGHT LEVEL TO 4 FC WHICH IS READ AT THE SERVICE AFTERWACANCY OF 7.5 MINUTES LIGHTS VALUE TO THE POR ANOTHER 7.5 MINUTES AND THEN SHUT DEF, PROVIDED NOT CONSTANCY IT DETECTED
- DURING THIS TIMEOUT PERIOD, OTHERWISE PROCESS STARTS ASSAIN. THIS GIVES A MAXIMUM ON TIME OF 15 MINUTES (7.5 @ 100% OR LESS, AND 7.5 @ 10%).

# MOUNTING BATTERY BACKUP MARIE SAMORES, PLANE, CLIL (ACC)ESS PLATE NOT REMOVABLE) HORS & BENCK LY-KATHER APPEARED BY

SATTERY BACK UP BACK BOX - NEEDED FOR STEP COWN WILL BE NEEDED FOR HYOLT

ARCHITECTURE

KATERINA PROCHASKA STATE OF WASHINGTON

JACKSON | MAIN ARCHITECTURE ALL PROST, MEMUES. **经约10至,为经济区**设于26年级574 Pathe (28) 221-1529 Externer Programmen Com

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**PROLOGIS PUYALLUP 2** SUITES A101-A103 T.I.

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SHEET TITLE:

PROLOGIS CUSTOMER

FINISH STANDARDS

SHEET NUMBER:

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# PLUMBING SITE PLAN NOTES

**KEYNOTES** 

**EXISTING SEWER LINE** 

EXISTING STORMWATER LINE

EXISTING FRESHWATER LINE EXISTING WATER VALVE, TYP. EXISTING WATER METER, TYP.

EXISTING CATCH BASIN, TYP.

EXISTING TRENCH DRAIN, TYP.

EXISTING SANITARY SEWER MANHOLE, TYP.

EXISTING SANITARY SEWER CLEANOUT, TYP.

EXISTING 20' WIDE WATERLINE EASEMENT PROPOSED LOCATION FOR NEW SAMPLING TEE

EXISTING STORM DRAIN CLEANOUT

- REFER TO G0.0 FOR SYMBOLS AND GENERAL PROJECT NOTES.
   GENERAL NOTES ON THIS PAGE DO NOT EXCLUDE NOTES ELSEWHERE; THIS DOCUMENT SET IS COMPLIMENTARY; NOTES ON OTHER SHEETS MAY HAVE BEARING/ APPLICATION TO
- WORK SHOWN ON THIS SHEET. 3. ALL EXISTING PLUMBING FIXTURES, LINES, ETC. ARE APPROXIMATE AND ARE SHOWN FOR REFERENCE ONLY; VERIFY EXACT LOCATION IN FIELD.

NOTE





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SHEET TITLE:

EXISTING PLUMBING LINES, FIXTURES, & CONNECTIONS

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