Approval of submitted plans is not an approval of omissions or oversights by this office or noncompliance with any applicable regulations of local government. The contractor is responsible for making sure that the building complies with all applicable codes and regulations of the local government.

City of Pevelopment & Pe ISSUED	ermitting Services
Building	Planning
Engineering	Public Works
Fire OF W	SHITTraffic

verizon^v

Received **Development Services** June 16, 2021 CITY OF PUYALLUP

VERIZON SITE NUMBER: 221424

VERIZON SITE NAME: BRADLEY PARK - A

SITE TYPE: **MONOPOLE**

TOWER HEIGHT: 120'-0"

BUSINESS UNIT #: 880329 3150 S MERIDIAN SITE ADDRESS: **PUYALLUP, WA 98373**

COUNTY: PIERCE

CITY OF PUYALLUP, **JURISDICTION:**

WA

VERIZON SUB 6-GHZ

VERITION SIGNATURE BLOCK

APPROVAL

RADIO

TELCO

MICROWAVE

FOLTPMENT

APPROVAL

SELE ACQUISITION PLANNER

CONSTRUCTION

PROJECT MANAGER

UTILITY MANAGER

PROJECT ADMINISTRATOR

CROWN CASTLE USA INC. SIGNATURE BLOCK

WO ADMINISTRATOR

SITE ACQUISITION

APPROVALS

DATE

DATE

CROWN CASTLE USA INC. SITE NAME: SHEET # SOUTH HILL MALL SITE ADDRESS: 3150 S MERIDIAN PUYALLUP, WA 98373 T-2 COUNTY: PIERCE MAP/PARCEL# 041904-408 AREA OF CONSTRUCTION: EXISTING LATITUDE: 47°09'43.5"N LONGTITUDE -122°17'40 0"W LAT/LONG TYPE: NAD83 GROUND ELEVATION: 442.91 FT CURRENT ZONING: TBD JURISDICTION: CITY OF PUYALLUP, WA OCCUPANCY CLASSIFICATION: U TYPE OF CONSTRUCTION: FACILITY IS UNMANNED AND NOT FOR A.D.A. COMPLIANCE: PROPERTY OWNER: WASHINGTON STATE DOT CROWN CASTLE USA, INC. 2000 CORPORATE DRIVE TOWER OWNER CANONSBURG, PA 15317 VERIZON WIRELESS CARRIER/APPLICANT 3245 158TH AVENUE MS 231 BELLEVUE, WA 98008 WITH THE WORK OR BE RESPONSIBLE FOR SAME ELECTRIC PROVIDER: TELCO PROVIDER TBD OWER SCOPE OF WORK: REMOVE (9) ANTENNAS REMOVE (6) RRHs REMOVE (2) HYBRID REMOVE (2) OVP PROJECT TEAM

SITE INFORMATION

C-2	EXISTING & NEW ELEVATION ANTENNA PLANS & CABLE SCHEDULE
C+4	EQUIPMENT SPECS
C-5	RFDS
C-6	CONFIGURATION DIAGRAM
G-1	GROUNDING PLAN
G ₂	GROUNDING DETAILS
G•3	GROUNDING DETAILS
ATTACHED	MOUNT MODIFICATION DESIGN
	AWINGS CONTAINED HEREIN ARE FORMATTEI 17. CONTRACTOR SHALL VERIFY ALL PLANS AN

DRAWING INDEX

TITLE SHEET

GENERAL NOTES

SHEET DESCRIPTION

PROJECT DESCRIPTION

THE PURPOSE OF THIS PROJECT IS TO ENHANCE EXISTING ELIGIBLE WIRELESS FACILITY.

TOWER SCORE OF WORK

- INSTALL (9) ANTENNAS INSTALL (3) RRHs
- · INSTALL (2) OVP • INSTALL (2) HYBRID CABLE

GROUND SCOPE OF WORK:

- REMOVE (2) OVP INSTALL (2) OVP

INSTALL MOUNT MODIFICATION PER MOUNT MODIFICATION DESIGNED BY TOWER ENGINEERING SOLUTIONS DATED 02/25/2021

NOTE: PRIOR TO ACCESSING/ENTERING THE SITE YOU MUST CONTACT THE CROWN NOC AT (800) 788-7011 & CROWN CONSTRUCTION MANAGER

CONTRACTOR PMI REQUIREMENTS PMI ACCESSED AT SMART TOOL VENDOR VzW LOCATION CODE (PSLC) *** PMI AND REQUIREMENTS ALSO EMBEDDED IN MOUNT

MOUNT MODIFICATION REQUIRED	Y
VzW APPROVED SMART KIT VEN	NDORS

REFER TO MOUNT MODIFICATION DRAWINGS PAGE FOR V2W SMART KIT APPROVED VENDORS



DRIVING DIRECTIONS FROM PIERCE COUNTY AIRPORT - THUN FIELD (16915 103RD AVE CT E, PUYALLUP, WA 98374, UNITED STATES): HEAD WEST ON 168TH ST E TOWARD MERIDIAN AVE E, TURN RIGHT AT THE 1ST CROSS STREET

ONTO WA 161 N/MERIDIAN AVE E. TURN RIGHT ONTO S MERIDIAN, TURN LEFT ONTO 30TH AVI SW, TURN LEFT

APPLICABLE CODES/REFERENCE **DOCUMENTS**

ALL WORK SHALL BE PERFORMED AND MATERIALS INSTALLED IN ACCORDANCE WITH THE CURRENT EDITIONS OF THE FOLLOWING CODES AS ADOPTED BY THE LOCAL GOVERNING AUTHORITIES. NOTHING IN THESE PLANS IS TO BE CONSTRUED TO

PERMIT WORK NOT CONFORMING TO THESE CODES:

 $\frac{\text{CODE TYPE}}{\text{BUILDING}}$ CODE 2018 IBC W/ W.A.C. AMENDMENTS MECHANICAL 2018 IMC W/ W.A.C. AMENDMENTS 2020 NEC W/ W.A.C. AMENDMENTS

REFERENCE DOCUMENTS:


STRUCTURAL ANALYSIS: BY OTHERS

DATED:

MOUNT ANALYSIS: TOWER ENGINEERING SOLUTIONS DATED: 03/31/2021

RFDS REVISION: 1 DATED: 12/01/2020

ORDER ID: 540457

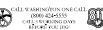









VERIZON SITE NUMBER: 221424

BU #: 880329 SOUTH HILL MALL 3150 S MERIDIAN

PUYALLUP, WA 98373 EXISTING 120'-0" MONOPOLE

2021.0060.0074

	ISSUED FOR:							
REV	DATE	DRWN	DESCRIPTION	DES./QA				
Α	03/25/2021	MIC	PRELIMINARY	CJ				
0	04/25/2021	MAN	CONSTRUCTION	CJ				



1100 E. WOODFIELD ROAD, SUITE 500

EMAIL: mdimitrov@fullertonengineering.com

JESSICA DORRIS - PROJECT MANAGER

CODY.CRANK@CROWNCASTLE.COM

JESSICA DORRIS@CROWNCASTLE.COM

CODY CRANK CONSTRUCTION MANAGER

1505 WESTLAKE AVENUE NORTH, SUITE 800

SCHAUMBURG, ILLINOIS 60173 MILEN DIMITROV

TEL: 847-908-8439

SEATTLE WA 98109

A&E FIRM:

CROWN CASTLE

USA INC. DISTRICT.

JURISDICTIONAL APPROVAL:

CROWN CASTLE USA INC. SITE ACTIVITY REQUIREMENTS:

- NOTICE TO PROCEED. NO WORK SHALL COMMENCE PRIOR TO CROWN CASTLE USA INC. WRITTEN NOTICE TO PROCEED (NTP) AND THE ISSUANCE OF A PURCHASE ORDER, PRIOR TO ACCESSING, CENTERING THE SITE YOU MUST CONTACT THE CROWN CASTLE USA INC. NOC AT 800-788-7011 & THE CROWN CASTLE
- "LOOK UP" CROWN CASTLE USA INC. SAFETY CLIMB REQUIREMENT: "LOOK UP" — CROWN CASTLE USA INC. SAFETY CLIMB REQUIREMENT:
 THE NITEGRITY OF THE SAFETY CLIMB ARIO ALL COMPONENTS OF THE CLIMBING FACILITY SHALL BE
 CONSIDERED DURING ALL STAGES OF DESIGN, INSTALLATION, AND INSPECTION. TOWER MODIFICATION, MOUNT
 REPROVEDEDLESS., AMOJOR EQUIPMENT INSTALLATIONS SHALL NOT COMPROMISE. THE INTEGRATOR OF
 STRUCTURE. THIS SHALL INCLUDE, BUT NOT BE LIMITED TO: PRICHING OF THE WIRE ROPE, BENDING OF
 THE WIRE ROPE FORM ITS SUPPORTS, DIRECT CONTACT OR CLOSE PROMINTY TO THE WER ROPE WHICH
 MAY CAUSE FRICTIONAL WEAR, IMPACT TO THE ANCHORAGE POINTS IN ANY WAY, OR TO IMPEDIE/BLOCK ITS
 INTERDED USE. ANY COMPROMISED SHETY CLIMB, INCLUDING EXISTING COOMINIONS MUST BE TAGGED DUTY
 AND REPORTED TO VIOLENCE THE TOWN CASTLE USA INC. POC OR CALL THE NOC TO GENERALE A SAFETY CLIMB
 MANTENANCE AND CONTRACTOR NOTICE TEXAST.
- PRIOR TO THE START OF CONSTRUCTION, ALL REQUIRED JURISDICTIONAL PERMITS SHALL BE OBTAINED. HIS INCLUDES, BUT IS NOT LIMITED TO, BUILDING, ELECTRICAL, MCHANICAL, FIRE, FLOOZ DONE ENVIRONMENTAL, AND ZONING, AFTER OHSTE ACTIVITIES AND CONSTRUCTION ARE COMPLETED, ALL REQUIRED PERMITS SHALL BE SATESIED AND CLOSED OUT ACCORDING TO LOCAL JURISDICTIONAL REQUIRED FER
- CLASS IN CONSTRUCTION, TO CERTIFY THE SUPPORTING STRUCTURE(3) OR MOUNTAINED. THE TRANSPORT OF THE TRANSPORT
- PROCEEDING WITH ANY SUCH CHANGE OF INSTALLATION.
 ALL MATERIALS FURNISHED AND INSTALLED SHALL BE IN STRICT ACCORDANCE WITH ALL APPLICABLE
 CODES, REGULATIONS AND ORDINANCES. CONTRACTOR SHALL ISSUE ALL APPROPRIATE NOTICES AND
 COMPLY WITH ALL LAWS, ORDINANCES, RULES, REQULATIONS AND LAWFUL DORCES OF ANY PUBLIC
 AUTHORITY RECARDING THE PERFORMANCE OF THE WORK. ALL WORK CARRED OUT SHALL COMPLY WITH
 ALL APPLICABLE WINDIPPAL AND UTILITY COMPANY SPECIFICATIONS AND LOCAL JURISDICTIONAL CODES.
- ORDINANCES AND APPLICABLE REGULATIONS ORDINANCES AND APPOLABLE REGULATIONS.

 THE CONTRACTOR SHALL INSTALL ALL EQUIPMENT AND MATERIALS IN ACCORDANCE WITH MANUFACTURER'S RECOMMENDATIONS UNLESS SPECIFICALLY STATED OTHERWISE.
- RECOMMENDATIONS UNLESS SEPCIFICALLY STATED OTHERWISE.

 THE CONTRACTOR SHALL CONNECT UTULTUT LOCATION SERVICES PROFIT OF THE STATE OF CONSTRUCTION.

 ALL EXISTING ACTIVE SERVER, WATER, GAS, ELECTRIC AND OTHER UTULTIES WHERE ENCOUNTERED IN THE WORK, SHALL BE PROTECTED AT ALL TIMES AND WHERE REQUIRED FOR THE PROPER EXCLUTION OF THE WORK, SHALL BE RELOCATED AS DIRECTED BY CONTRACTOR. STRENGE CAUTION SHOULD BE USED BY THE WORK, SHALL BE RELOCATED AS DIRECTED BY CONTRACTOR. STRENGE CAUTION SHOULD BE USED BY THE PROTECTION OF THE WORKING CREAT, THIS WILL NULLUE BUT NOT BE LUMBED TO A) FALL PROTECTION (5) CONFINED SPACE C) ELECTRICAL SAFETY D) TRENCHING AND EXCAVATION E)

 ALL SITE WORK SHALL BE AS INDICATED ON THE STAMPED CONSTRUCTION DRAWNINGS AND PROJECT SPECIFICATIONS, LAIRST APPROVED RESISON.

- SPECIFICATIONS, LATEST APPROVED REVISION.

 CONTRACTORS SHALL KEEP THE STEP EFFER MAN ACCUMULATING WASTE MATERIAL, DEBRIS AND TRASH AT THE COMPLETION OF THE WORK. IF NECESSARY, RUBBISH, STUMPS, DEBRIS, STOKS, STONES AND OTHER REFUSE SHALL DE REMOVED FROM THE SITE AND DEPOSED OF LEGALITY.

 ALL EXISTING INACTIVE SWEER, WATER, GAS, ELECTRIC AND OTHER UTILITY. WHICH INTERFERE WITH THE REPOSE CONTRACTOR OF THE WORK, OR DIRECT OTHER APPROVAL OF CONTRACTOR. THE WORK, OR DIRECT OTHER APPROVAL OF CONTRACTOR. TOWER OWNER, ROWN OSTILE USA NO. AND/OR LOCAL UTILITY. SHE APPROVAL OF CONTRACTOR. TOWER OWNER, ROWN OSTILE USA NO. AND/OR LOCAL UTILITY THE TECHNICAL SPECIFICATION FOR SITE SIGNAGE REQUIRED BY LOCAL JURISDICTION AND SIGNAGE REQUIRED ON INDIVIDUAL PIECES OF EQUIPMENT, ROOSS, AND SHELTERS.
- THE SITE SALL BE GRADED TO CAUSE SURFACE WATER TO FLOW AWAY FROM THE CARRIER'S EQUIPMENT AND TOWER AREAS. THE SUB GRADE SHALL BE COMPACTED AND BROUGHT TO A SMOOTH UNIFORM GRADE PRIOR TO FINISHED
- SURFACE APPLICATION
- SURFACE APPLICATION.
 THE AREAS OF THE OWNERS PROPERTY DISTURBED BY THE WORK AND NOT COVERED BY THE TOWER, EQUIPMENT OR DRIVEWAY, SHALL BE GRADED TO A UNIFORM SLOPE, AND STABULIZED TO PREVENT EROSION AS SPECIFIED ON THE CONSTRUCTION PRAWINGS AND/OR PROJECT SPECIFICATIONS.
- EROSION AS SPECIFED ON THE CONSTRUCTION DRAWNIGS AND/OR PROJECT SPECIFICATIONS.
 CONTRACTOR SHALL MAININEZ EDITIONS STEE QUEING CONSTRUCTION, SPECIAL MININEZ EDITIONS OF COURSE STEED CONSTRUCTION, SPECIAL BE IN CONFORMACE WITH THE LOCAL QUEINES.
 FOR EROSION AND SEDMENT CONTROL.

 THE CONTRACTOR SHALL PROTECT EXISTING IMPROVEMENTS, PAYMENTS, CURRS, LANDSCAPIG AND
 STRUCTURES. ANY DAMAGED PART SHALL BE REPARED AT CONTRACTOR'S EXPENSE TO THE SATISFACTION
 STRUCTURES. ANY DAMAGED PART SHALL BE REPARED AT CONTRACTOR'S EXPENSE TO THE SATISFACTION
 CONTRACTOR SHALL LEGALLY AND PROPERLY INSPIRED OF ALL SCAPE MATERIALS SUCH AS COMMAL
 CABLES AND OTHER ITEMS PREMOVED FROM THE ENSITING FACILITY. ANTENNAS REMOVED SHALL BE
 RETURNED TO THE OWNER'S DESIDEATED LOCATION.
- CONTRACTOR SHALL LEAVE PREMISES IN CLEAN CONDITION, TRASH AND DEBRIS SHOULD BE REMOVED FROM SITE ON A DAILY BASIS.
- NO FILL OR EMBANKMENT MATERIAL SHALL BE PLACED ON FROZEN GROUND. FROZEN MATERIALS, SNOW OR ICE SHALL NOT BE PLACED IN ANY FILL OR EMBANKMENT.

GENERAL NOTES:

- ENERAL NOTES:

 FOR the PURPOSE OF CONSTRUCTION DRAWING, THE FOLLOWING DEFINITIONS SHALL APPLY: CONTRACTOR: GENERAL CONTRACTOR RESPONSIBLE FOR CONSTRUCTION CARRET.

 CROWN CARRET.

 *

- LABOR NECESSARY TO COMPLETE ALL INSTALLATIONS AS INDICATED ON THE DRAWNINGS.
 THE CONTRACTOR SHALL INSTALL LECTURENT AND MATERIALS IN ACCORDANCE WITH MANUFACTURER'S RECOMMENDATIONS UNLESS SPECIFICALLY STATED OTHERWISE.
 IF THE SPECIFIED EQUIPMENT CAN NOT BE INSTALLED AS SHOWN ON THESE DRAWNINGS, THE CONTRACTOR SHALL FRONCES AN ALTERNATIVE MISTALLION FOR APPROVAL BY THE CARRIER AND CROWN CASTLE PRIOR TO PROCEEDING CONTRACTOR IS TO PERFORM AS THE INASTINATION MID. IS TO DETERMANE THE BEST FOUNTING OF ALL CONTING FOR INCOMPLINE OF THE POWER, AND TELCO AND FOR GROUNDING CABLES AS SHOWN IN THE POWER, TELCO, AND GROUNDING PLANTS.
- DRAWNIOS.

 THE PROTECT ENSINE, IMPROVINCENTS, PARLEMENTS, CURRES, LANGUARNE, AND STRUCTURES, AND HAD CONTROL TO STRUCTURES. AND HAD CONTROL TO STRUCTURES. AND HAD CONTROL TO STRUCTURES IN AND HAD CONTROL TO STRUCTURES. AND HAD CONTROL TO STRUCTURES IN AND HAD CONTROL TO STRUCTURES. AND HAD CONTROL TO STRUCTURES AND HAD CONTROL TO STRUCTURES. AND HAD CONTROL TO STRUCTURES AND HAD CONTROL TO STRUCTURES. AND HAD CONTROL TO STRUCTURES AND HAD CONTROL TO STRUCTURES. AND HAD CONTROL TO STRUCTURES AND HAD CONTROL TO STRUCTURES. AND HAD CONTROL TO STRUCTURES AND HAD CONTROL TO STRUCTURES. A
- DESIGNATED LOCATION.

 CONTRACTOR SHALL LEAVE PREMISES IN CLEAN CONDITION. TRASH AND DEBRIS SHOULD BE REMOVED FROM SITE ON A DAILY AREA.

CONCRETE, FOUNDATIONS, AND REINFORCING STEEL:

- ALL CONCRETE WORK SMALL BE IN ACCORDANCE WITH THE ACL 301, ACC 338, ACC 336, ASTM A184, ASTM A185 AND THE DESIGN AND CONSTRUCTION SPECIFICATION FOR CAST-IN-PRACE CONCRETE.

 WILLESS NOTED OFFERWES, SOLD ERRING PRESSURE USED FOR DESIGN OF SLABS AND FOUNDATIONS IS ASSUMED TO BE 1000 ps/.

 ALL CONCRETE SHALL HAVE A MAINIAN COUPRESSINE STENDITH (1'S) OF 3000 ps/ AT 28 DAYS, UNLESS MOTED ALL CONCRETE SHALL HAVE A MAINIAN COUPRESSINE STENDITH (1'S) OF 3000 ps/ AT 28 DAYS, UNLESS MOTED AND ALL CONCRETE SHALL HAVE AND AND ADMITS SHALL LOSSES FROM BROTH USE OF THE PROCEDENT THE PROCEDED AND ADMITS SHALL CONTROL AND EXTENDED AND ATT OF ACCURATION OF THE PROCEDENT THE PROCEDED TO PREZE THE OFFICE AND EXCURSE ENPOSED FOR (PREZE THAN CONCRETE SHALL BOTH OFFICE AND EXCURSE ENPOSED OF THE PROCEDED AND ADMITS AS FOLLOWS:
 #4 RAPS AND SMALLER 40 to:

GREENFIELD GROUNDING NOTES:

- ALL GROUND ELECTRODE STSTAUS (NOCLUDING TELECOMMUNICATION, RADIO, LIGHTNING PROTECTION AND AC POWER GES'S) SHALL BE BONDED TOSETHER AT OR BELON GRACE, BY TWO OR MORE COPPER BONDING CONDUCTORS IN ACCORDANCE WITH THE NEC.
- ACCUMINANCE, WITH THE, NEC.;

 THE CONTRACTOR SHALL PERFORM IEEE FALL—OF-POTENTAL RESISTANCE TO EARTH TESTING (PER IEEE 1100 AND 81) FOR GROUND ELECTRODE SYSTEMS, THE CONTRACTOR SHALL FURNISH AND INSTALL SUPPLEMENTAL, GROUND ELECTRODES AS NEEDED TO ACHIEVE A TEST RESULT OF 5 ONUS OR EAST OF THE CONTRACTOR IS RESPONSIBLE FOR PROPERTY SEQUENCING GROUNDING AND UNDERGROUND CONDUIT INSTALLATION AS TO PREVENT ANY LOSS OF CONTINUITY IN THE GROUNDING SYSTEM OR DAMAGE TO THE CONDUIT AND PROVIDE
- IESTING RESOLUTION TO TRAY SHALL BE GROUNDED AND MADE ELECTRICALLY CONTINUOUS WITH LISTED BONDING FITTINGS OR BY BONDING ACROS<mark>S THE DISCONTINUITY WITH #6 C</mark>OPPER WIRE UL APPROVED GROUNDING TYPE CONDUIT
- MEAN COUNTION IN THAT STALL BE UNKNOWNED AND WE LECTION TO THE ORDING CONDUCTOR. STRANGED COPPER CONDUCTORS WITH GREEN INSULATION, SZED IN ACCORDANCE WITH THE NCC, SHALL BE FURNISHED AND INSTALLED WITH THE POWER CIRCUITS TO STS EQUIPMENT.

 EACH CARRIEST PARKE SHALL BE DIED AS THE NCC REQUIRED EQUIPMENT GROUND CONDUCTOR. STRANGED COPPER CONDUCTORS WITH GREEN INSULATION, SZED IN ACCORDANCE WITH THE NCC, SHALL BE FURNISHED AND INSTALLED WITH THE POWER CIRCUITS TO STS EQUIPMENT.

 EACH CARRIEST PARKE SHALL BE DIED AS THE NCC REQUIRED AS THE NCC REPORT OF THE NCC REPORT
- CONNECTIONS OF THE REGIONAL BUS SHALL NOT BE DUDIEDLD UP OF STACKED BACK TO BACK CONNECTIONS OF OPPOSITE SIDE OF THE REGIONAL BACK TO BACK CONNECTIONS OF OPPOSITE SIDE OF THE PROPERTY OF THE ALL FORWARDS CONNECTIONS BELOW GROVE.

 COMPRESSION GROUND CONNECTIONS MAY BE REPLACED BY EXCHINENCE WILL CONNECTIONS.

 COMPRESSION GROUND CONNECTIONS MAY BE REPLACED BY EXCHINENCE WILL CONNECTIONS.

- 14. ICE BRIDGE BONDING CONDUCTIONS SHALL BE EXPITEMENTALLY BONDED OR BOLTED TO THE BRIDGE AND THE TOWER GROUND BAR.

 APPROVED A AMTORDARY CONTINUES (E. C. PONCHETTS CHALL BE USED ON ALL COUNTESSION AND BOLTESSION AND
- POINT. THE EXPRESE IND OF THE CONDUIT MUST BE SEALED WITH SUCOSE CAULE. (ADD TRANSITIONING CROUNCE STANDARD DETAIL AS WELL).

 FOUNT, THE EXPRESE IND OF THE CONDUIT MUST BE SEALED WITH SUCOSE CAULE. (ADD TRANSITIONING CROUNCE STANDARD DETAIL AS WELL).

 FOUNT, THE EXPRESE IND OF THE CROUNDED AND THE CONDUITORS ARE REQUIRED TO BE ROUTED TO GROUND. THE CONTROL FOR SHALL BOTT THE CONTROL FOR SHALL BOTT THE EXISTING GROUNDING SYSTEM, THE BUILDING STEEL COLUMNS, THE EXISTING GROUNDING SYSTEM, THE BUILDING STEEL COLUMNS, UCHTINNOR PROTECTION SYSTEM, AND BUILDING MAN WATER LINE (FERROUS OR NOMERROUS MELT) PHING ONLY).

ELECTRICAL INSTALLATION NOTES:

- ALL ELECTRICAL WORK SHALL BE PERFORMED IN ACCORDANCE WITH THE PROJECT SPECIFICATIONS, NEC AND ALL APPLICABLE
- FEDERAL, STATE, AND LOCAL CODES/ORDINANCES.
 CONDUIT ROUTINGS ARE SCHEMATIC. CONTRACTOR SHALL INSTALL CONDUITS SO THAT ACCESS TO EQUIPMENT IS NOT BLOCKED
 AND TRIP HAZARDS ARE ELIMINATED.
- CONDUTE ROUTINGS ARE SCHEMATIC. CONTRACTOR SHALL INSTALL CONDUTS SO THAT ACCESS TO EQUIPMENT IS NOT BLOCKED WINNING, RACKEWAY AND SUPPORT METHODS AND MERRIALS SHALL LOOPING WITH THE RECURSION OF THE RECURS OF THE RESURD OF THE 4.2.

- CIRCUIT (D'S).

 PANEL BOARDS (D NUMBERS) SHALL BE CLEARLY LABELED WITH PLASTIC LABELS.

 ALL THE WARPS SHALL BE CUT FLUSH WITH APPROVED CUTTING TOOL TO REMOVE SHARP EDGES.

 ALL THE WARPS SHALL BE CUT FLUSH WITH APPROVED CUTTING TOOL TO TEXT OF THE COPPER CONDUCTOR (#14 OR LARGER! WITH TYPE THHW, THINH, THINH, THINH, THINH, THINH, THINH, Z. THINH, DEPENDED SHALL BE SINGLE COPPER CONDUCTOR (#16 OR LARGER) WITH TYPE THINH, THINH, Z. THINH,

- AND NEC.

 15. ELECTRICAL METALLIC TUBING (EMT), INTERMEDIATE METAL CONDUIT (IMD), OR RIGID METAL CONDUIT (RNC) SHALL BE USED FOR EXPOSED INDOOR LOCATIONS.

 16. ELECTRICAL METALLIC TUBING (EMT) OR METAL—CLAD CABLE (MC) SHALL BE USED FOR CONCEALED INDOOR LOCATIONS.

 17. SCHEDULE AG PYC UNDERGROUND ON STRAGETS AND SCHEDULE BO PYC FOR ALL ELBOWS/906 AND ALL APPROVED ABOVE GRACE PYC CONDUIT.

- GRACE PVC CONDUIT.

 BUILDING HEAVEN METALUC CONDUIT (LIQUID-TITE FLEX) SHALL BE USED INDOORS AND OUTDOORS, WHERE VIBRATION LOUDLINGS FLEXIBLY METALUC CONDUIT AND TUBBIC FITTINGS SHALL BE THEADED OR COMPRESSION—TYPE AND APPROVED FOR THE LOCATION USED. SET SCREW FITTINGS ARE NOT ACCEPTABLE.
- CABINETS, BOXES AND WIRE WAYS SHALL BE LABELED FOR ELECTRICAL USE IN ACCORDANCE WITH NEMA, UL, ANSI/IEEE AND
- THE NEW.
 WIREWAYS SHALL BE METAL WITH AN ENAMEL FINISH AND INCLUDE A HINGED COVER, DESIGNED TO SWING OPEN DOWNWARDS
- WIREWAYS SHALL BE METAL WITH AN ENABLE FINISH AND INCLUDE A HINGED COVER, DESIGNED TO SWING OPEN DOWNWARDS (WREAVED SECONDET WIREWAYS DEVELOPED TO SWING OPEN DOWNWARDS (WREAVED SECONDET WITH SECONDE

- 24. EQUIPMENT CASINETS, TERMINAL BOXES, JUNCTION BOXES AND PULL BOXES SHALL BE CALVANIZED OR EFOXY-COAFED SHEET STEEL SHALL MEET OR EXCEED UL SO AND BE RATED NEAR 1 (OR BETTER) FOR INTERIOR LOCATIONS AND NEAM 3R (OR 55 ETTER) FOR EXTENDED LOCATIONS.

 25. ETTER) FOR EXTENDED LOCATIONS.

 26. EXCEED U. 514A AND NEAM OF 1 AND BE RATED NEAM 1 (OR BETTER) FOR INTERIOR LOCATIONS AND WEATHER PROTECTED (MP OR BETTER) FOR EXTENDED LOCATIONS.

 27. INTERIOR LOCATIONS AND STAND BE RATED HEMAT 1 (OR BETTER) FOR INTERIOR LOCATIONS.

 28. THE LOCATION STANDARD STAND BE RATED STANDARD STANDARD FOR EXTENDED FOR CATEGORY COATIONS.

 29. THE LOCATION STANDARD STAND

- INSTALL LAMICOID LABEL ON THE METER CENTER TO SHOW "VERIZON".
 ALL EMPTY/SPARE CONDUITS THAT ARE INSTALLED ARE TO HAVE A METERED MULE TAPE PULL CORD INSTALLED.

COND	UCTOR COL	OR CODE
SYSTEM	CONDUCTOR	COLOR
	A PHASE	BLACK
120/240V. 1Ø	B PHASE	RED
120/2404, 18	NEUTRAL	WHITE
	GROUND	GREEN
	A PHASE	BLACK
120/208V, 3Ø	B PHASE	RED
	C PHASE	BLUE
	NEUTRAL	WHITE
	GROUND	GREEN
	A PHASE	BROWN
	B PHASE	ORANGE OR PURPLE
277/480V, 3Ø	C PHASE	YELLOW
	NEUTRAL	GREY
	GROUND	GREEN
DC VOLTAGE	POS (+)	RED**
DC VOLIAGE	NEG (-)	BLACK**

* SEE NEC 210.5(C)(1) AND (2)
** POLARITY MARKED AT TERMINATION

GENERATOR
GLOBAL POSITIONING SYSTEM
GLOBAL SYSTEM FOR MOBILE
LONG TERM EVOLUTION

QUANTITY
RECTIFIER
RADIO BASE STATION
REMOTE ELECTRIC TILT
RADIO FREQUENCY DATA SHEET

UNIVERSAL MOBILE TELECOMMUNICATIONS SYSTEM WORK POINT

MASTER GROUND BAR MICROWAVE NEW NATIONAL ELECTRIC CODE

PROPOSED POWER PLANT

ABBREVIATIONS:

GEN GPS GSM LMGB MW (NEC) PGTCT REBS RET

RRH RRU SIAD TIMA TYP UMTS W.P.

ANTENNA EXISTING FACILITY INTERFACE FRAME

APWA UNIFORM COLOR CODE:

WHITE PROPOSED EXCAVATION PINK TEMPORARY SURVEY MARKINGS RED ELECTRIC POWER LINES, CABLES, CONDUIT, AND LIGHTING CABLES YELLOW GAS, OIL, STEAM, PETROLEUM, OR GASEOUS MATERIALS COMMUNICATION, ALARM OR SIGNAL LINES,
CABLES, OR CONDUIT AND TRAFFIC LOOPS BLUE POTABLE WATER

PURPLE RECLAIMED WATER, IRRIGATION, AND SLURRY LINES GREEN SEWERS AND DRAIN LINES

3245 158TH AVENUE MS 231 **CROWN**

verizon

CASTLE 505 WESTLAKE AVENUE NORTH, SUITE 80 SEATTLE WA 98109

FULLERTON ENGINEERING-DESIGN

100 F. WOODEIELD RD. STE 500, SCHAUMBURG, IL 6012

VERIZON SITE NUMBER: 221424

BU #: 880329 SOUTH HILL MALL 3150 S MERIDIAN

PUYALLUP, WA 98373 EXISTING 120'-0" MONOPOLE

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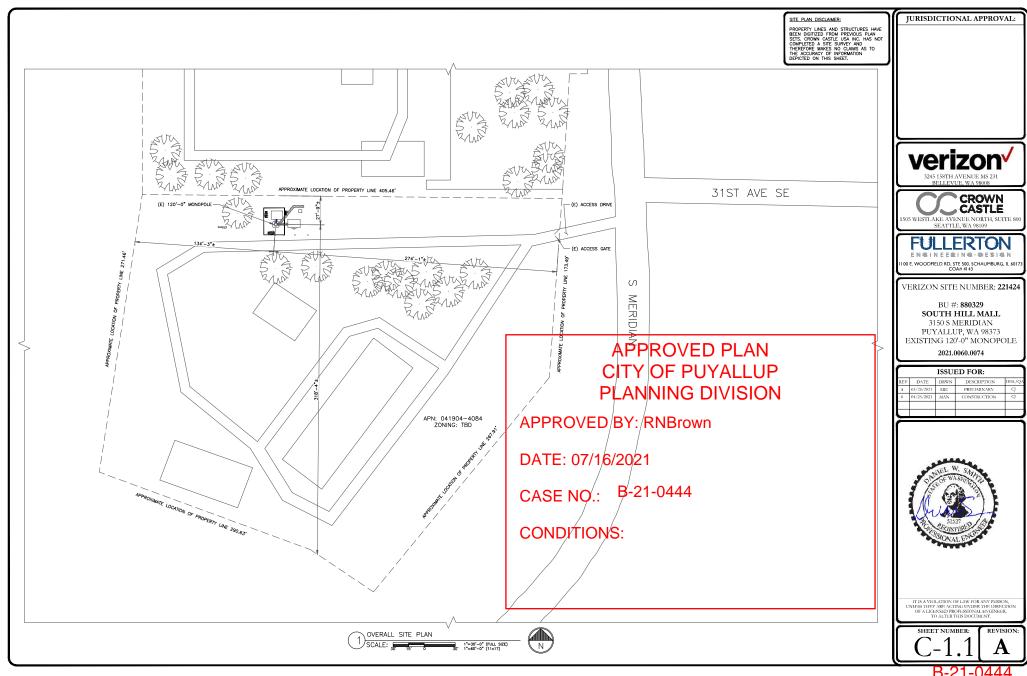


IT IS A VIOLATION OF LAW FOR ANY DURSON OF A LICENSED PROFESSIONAL ENGINEER, TO ALTER THIS DOCUMENT.

SHEET NUMBER-1 -Z


REVISION Α







JURISDICTIONAL APPROVAL:

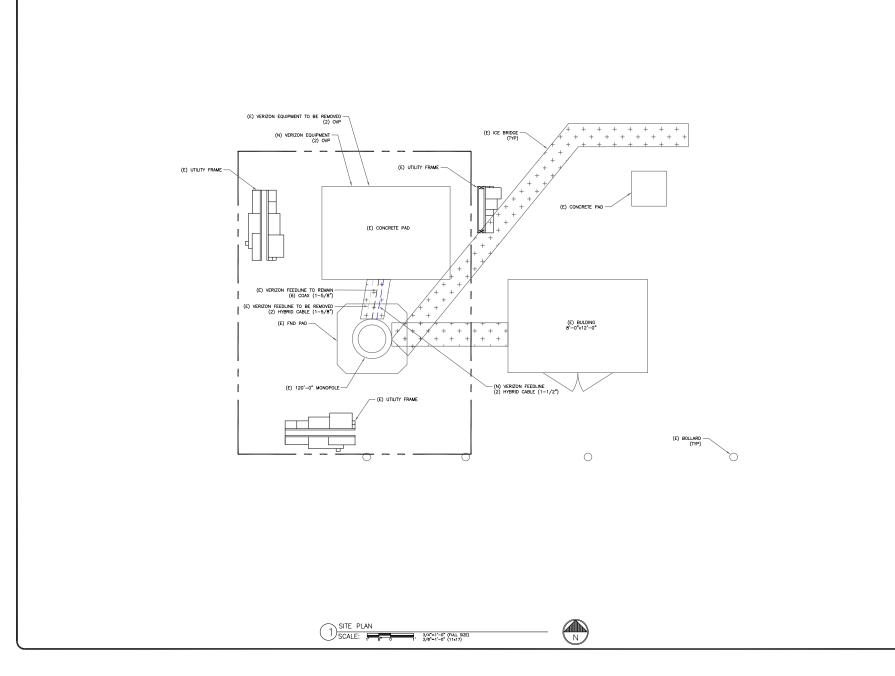





FULLERTON ENGINEERING BESIGN

100 E. WOODFIELD RD, STE 500, SCHAUMBURG, IL 60 17 COA# 4 143


VERIZON SITE NUMBER: 221424

BU #: 880329 SOUTH HILL MALL 3150 S MERIDIAN

PUYALLUP, WA 98373 EXISTING 120'-0" MONOPOLE

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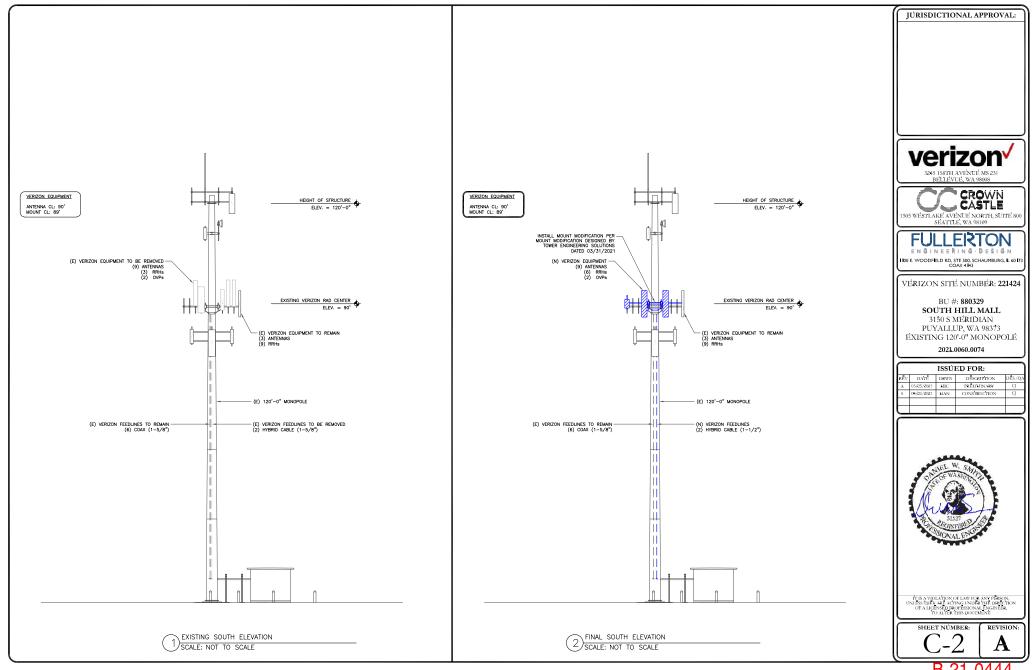
REV	DATE	DRWN	DESCRIPTION	DES./Q
Α	03/25/2021	MIC	PRELIMINARY	CJ
0	04/25/2021	MAN	CONSTRUCTION	CJ

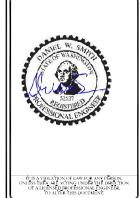

SHEET NUMBER: REVISION:

 $2 \mid \mathbf{A} \mid$








						ANTENNA SCHEDULE				
						ANTENNA SCHEDULE				
SECTOR	POS.	TECHNOLOGY	RAD CENTER	AZIMUTH	ANTENNA MANUFACTURER	ANTENNA MODEL	MECH. TILT	ELECT. TILT	TOWER MOUNTED EQUIPMENT	FEEDLINE TYPE
ALPHA	A1	CMDA	90'	90.	ANTEL	BXA-70090-8CF-EDIN-X	0.	ď	-	COAX
ALPHA	A2	LTE/5G	90"	90°	JMA	MX06FR0840-02	0*	ď	(1) ERICSSON RRUS 32 B2 (1) ERICSSON 4449	COAX
ALPHA	A3	LTE/5G	90'	90"	JMA	MX10FR0840-XX	0.	ď	(1) ERICSSON RRUS 32 B66 (1) RVZDC-6627-PF-48, (1) 4408 B48	HYBRID COAX
ALPHA	A4	LTE√5G	90'	90"	V Z M	SUB6 ANTENNA	0.	0.	-	COAX
BETA	B1	CMDA	90'	180	ANTEL	BXA-70090-8CF-EDIN-X	0,	o	-	-
BETA	B2	LTE/5G	90'	180	JMA	MX06FR0840-02	0.	ď	(1) ERICSSON RRUS 32 B2 (1) ERICSSON 4449	HYBRID
BETA	В3	LTE/5G	90'	180	JMA	MX10FR0840-XX	0.	o,	(1) ERICSSON RRUS 32 B66 (1) RVZDC-6627-PF-48, (1) 4408 B48	
BETA	B4	LTE/5G	-	-	VZM	SUB6 ANTENNA	0,	0,	-	-
GAMMA	C1	CMDA	90'	270°	ANTEL	BXA-70090-8CF-EDIN-X	0.	ď	-	-
GAMMA	C2	LTE/5G	90"	270°	JMA	MX06FR0840-02	0,	o	(1) ERICSSON RRUS 32 B2 (1) ERICSSON 4449	COAX
GAMMA	С3	LTE/5G	90'	270*	JMA	MX10FR0840-XX	0.	o	(1) ERICSSON RRUS 32 B66 (1) 4408 B48	COAX
GAMMA	C4	LTE√5G	-	-	V Z M	SUB6 ANTENNA	0.	0.	-	COAX

		CABLE SC	HEDULE	
STAT	rus	CABLE TYPE	SIZE	QUANTITY
EXIST	TING	COAX	1-5/8"	6
PROP	OSED	HYBRID	1-1/2"	2
	FIN	IAL CABLE QUANT	ITY	8

ANTENNA AND CABLE SCHEDULE 1) SCALE: NOT TO SCALE

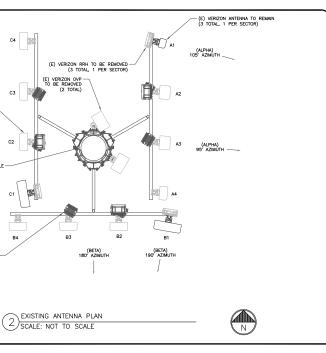

C4 13

C3

(E) VERIZON OVP TO BE REMOVED (2 TOTAL)


(GAMMA) 270' AZIMUTH

(E) 120'-0" MONOPOLE -

(GAMMA) 260° AZIMUTH

(E) VERIZON RRH TO REMAIN -(9 TOTAL, 3 PER SECTOR)

(E) VERIZON ANTENNA TO BE REMOVED (9 TOTAL, 3 PER SECTOR)

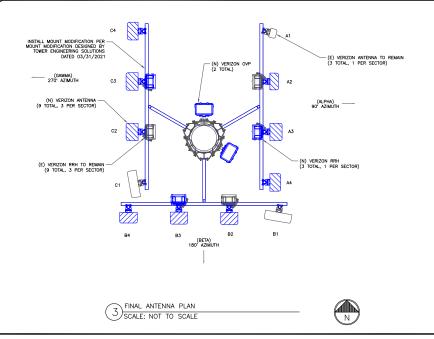

JURISDICTIONAL APPROVAL:





VERIZON SITE NUMBER: 221424

BU #: 880329 SOUTH HILL MALL 3150 S MERIDIAN PUYALLUP, WA 98373 EXISTING 120'-0" MONOPOLE


2021.0060.0074

VIE DRWN	DESCRIPTION	
	DESCRIPTION	DES./Q/
/2021 MIC	PRELIMINARY	CJ
/2021 MAN	CONSTRUCTION	. CJ







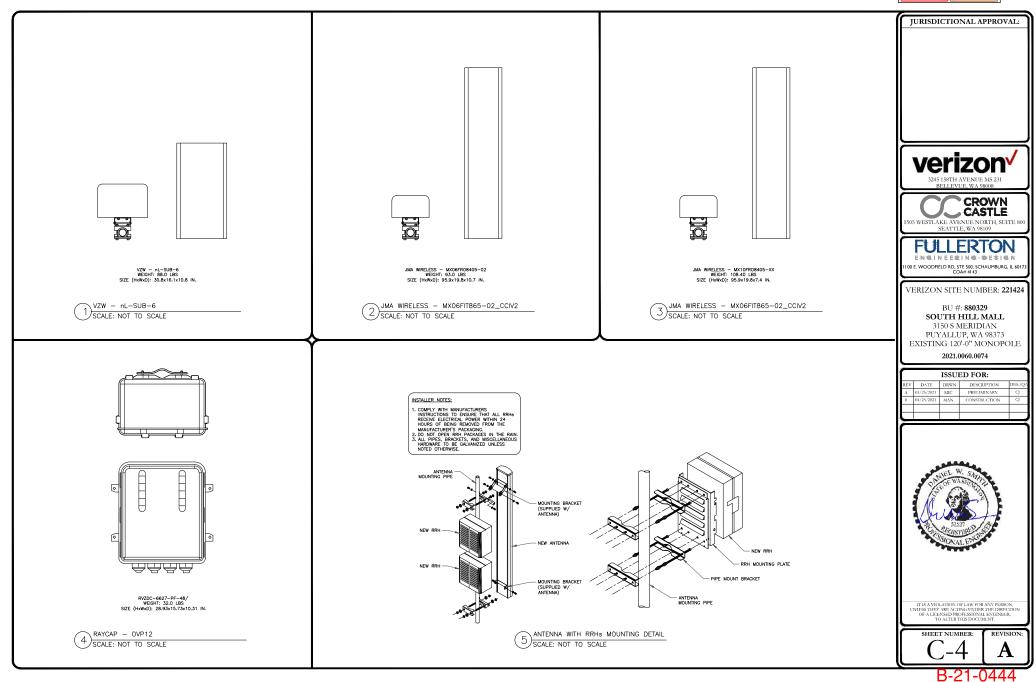

City of Puyallup
popment & Permitting Services
ISSUED PERMIT Planning Building Engineering Public Works Traffic Fire

verizon fuze RFDs

			Northwest > Seattle > BRAD					
		All, Fawad - fawad.ai@	verizonwireless.com + 12/1/	2020 9:15:26				
Project Details			Location In	formation				
Carrier Aggreg	ation: false			Site ID: 1	060657			
M	PT Id:			E-NodeB ID: 0019352,001352,0301352,301352				
e	CIP-0: false			PSLC: 221424 Switch Name: Tacoma Tower Owner:				
Project I	Name: 5G L-Sub6 - Car	rrier Add						
FUZE Prole	ect ID: 16225818							
Designed Sector Carrie				Tower Type: Monopole				
Designed Sector Carrie				Site Type: MACRO				
Additional Sector Carri				Street Address: 3150 S Meridan St.				
Additional Sector Carri				City: Puyallup				
SiteTraker Proje				State: WA				
		LAC AND AC CORD SC L C.AC						
re solution type a tech	Prep	;4G_AWS,4G_CBRS,5G_L-Sub6	e .	Zlp Code: 98373				
DEDC Desired C		zinnuth adjustment and moving 44	40	County: Pierce				
KFD5 Project 5	from shelter to		49	Latitude: 47.162078 / 47° 9° 43.4808° N				
	Eu#fler			Longitude: -	122.294456 / 122° 17' 40.0	416" W		
SOOD MICE LITE		000	80	-	tals	10		
Settor Azinetti Call / Dioda I III	Minn Re pr	00 100	303 200 88	80 3030	00 300 301313	200 200 200 200 200 200 200 200 200 200		
Cell / ENode I IID Artessa Hobel	desers	NEWSBERGOOK THE 1905-1-451-ELIE HE	CATALOGUE PROCESSOR AND	HOMERICONS-ES	HOM/NOMO-CO	MONTHUME-03		
Artenna Nelta	OWNER	(30913 AMPHENIX	(309685) ARPHONOL	. DA.	JMA.	200.		
Aprierra ContestinulPti Hachanical Dose-Titt(Ag.) Electrical Dose-Titt		*	90 0	**	86	**		
The Halphi	i i	ů	u u	14	ů.	ii ii		
Regulatory Frener TMA Holes TMA Hodel	126,05	346,87	SHEAP	11533	555.22	1813		
	fresen	Directo	Disser	Ercean	Ericusan	Brisson		
RRU Hodel Number of To, Re Lines	RAUSCO SO	AMINTO 12 Ed	88US32 92 64	681532 22 8,6	RAUS32 82 A,8	88US32 BG		
Poston Transitor Id	40400	463965)	493054	7600	240029	740005		
Source Tion work LTT	ATRIL,AN	ATOLL, MY	ATOLL, AM	KTOLL AN	ATOLL API	ATO 1, API		
Settor	01	82	23	91	60.3	13		
Azinetti Cell / Etiode S ID	80 H1353	198 301393	276 301358	301352	M1383	176 161153		
Artema Hodel	QUADRISMISSOCKT35-2550++45+8L (PDT35)	CMASES	ACHTEW000001-T01-1500(+45)-RED (34505)	HILLSTROOM-ex	WCQFR0845-bs	WELDTROSHE-up		
Antenna Holin Antenna Control(nu/F1)	AMHIENOL SG 9	AMPHENOL FL3	AMPRIDIO, ELI	36A 9C	JMA 80	36A 18		
Rechanical Down-TitrLleg.) Electrical Down-Titr		î	1	1	0	8		
Tip Height Regulatory Frence	94 19631	14 20.44	34 252,44	28626	396.36	76.16		
TMA Holes TMA Foot-si								
BBU Nake BBU Model Number of To, Ra Lines	Elesion ARIJASS BANA	Directi BRUGII DISA	Drissen Brussi Drisa	Ericator RELECTO BODA	Ericana Multicas trata	Efferen MILITO DOMA		
Postice	U	44		44	64	MACITUS DOMA		
Transmitter Ed.	ATOLL API	4629GH ATOLL 4FI	ADMIN AN	FOOTH ATOLL AN	ATOLL API	74200E1		
IND MICE COME.		000			BOLS			
Sector Agriculti Cell / Disolati 10	91 105	02 191	99 360	305	80 580	98 360		
Cell / Etude 8 10 Anterna Hodel	864-70090-007-039-0 (142718)	\$14-71045-4CF-4509/C (15657G	EU-70NO-0C7-050NHZ (55070)	EU-10090-ECT-EDIN-0 (362730):	80470044074009(2(05070)	\$104-70040-417-430MHZ (2585)		
Actions Pale	AMRIENOL	ANTEL	ANTEL.	AMPLENOL	ANTE.	APTEL		
Automa CentrellouPt) Medianical Dose-Tittleg.)	901	80.1 8	96.1 2	903 2	90.3 4	81 1		
Electrical Cover-Tills Tip Highs	0 94	9 H	9.	1	0 Pé	1		
Segulatory Frence TMA Kalia	29.20	407.74	62234	2929	407.54	80.36		
THA Hod-si RRG Valor								
RRU Model Rumber of To, Ra Utess								
Poston Travenitor lif								
Source	ATHL, AR	ATOLL,M	ATOLL, AM	ATOLL API	ATOLL, API	APD.L.(API		
Section Sectio	01	60	83	95	5-01.5 80	01		
Azimeth Call (Block S ID	95 00350	155 00370	276 001252	86 000312	556 601992	276 803353		
Cell / Block 9 ID Artessa Nodel	Otests 011312	HEXALEGNOSCI-LISP-GEO-H-KSI-SED NO 0023/2	003353 ExeterW00006-T00-655-(+45)-RED (309(27)	HOUSE/BUSHUS-ED	MXXX/T0064-43	HX0664/0940-03		
Antenna Haile Antenna Canterlina(Ft)	QUARTEL	AMPLICAL	ARPIDAOL	264	ptA	JAN.		
Arterna Centertine(Ft) Hechanical Dose-TiltiDeg (Electrical Dose-Tilt	90	*		10 0	10	90		
The Reight	å	a M	e M	3 14	9 H	3 H		
Regulatory Fower TMA Haire TMA Rodal	61.21	1836	115.96	38629	385.28	397.23		
MIC Pake	Efficience	Crimien	Driver	Priceson	Ericann	Erresen		
ARU Model Number of Tx, Ris Lines	13	U U	6949 33	44	44	4.4		
Poettier Trescritter id	460000	468400	450977.0	7400007	94.30393	2410022		
Source	ATOLL API	ATOLL API	ATOLL_AR	ATOLL_API	ATOLL AT	ATOLL, API		

WITS SHAFTS	0.100,000	ALLAL MA	ALLAL MA	AIMALAN.	MILE	Artist, Art
Sector	91	02	00	bs	tot .	99
Azinuth	30	190	270	86	1200	276
Cell / Ellodie B ID	391353	301363	565352	500,352	30357	201332
Artens Hodel	QUADETEREDOD-700-3100-(+4.5)-ELLE	QUADASEWISSES-TSS-2335-C+451-RED (344555)	QUAD-158W0000X-T03-2200-(-45)-8ED (3445-25):	M(1279-0560-w	NICO/SCOKO-ea	M03970006-es
Arterna Halo	ARPIDIOL	AMPHENDL	APPLICACE.	1944	MA	THA
Artessa CenterSine(Ft)	90.8	93.3	61.2	16	- 10	100
Madasial Down-Titt(Deg.) Section Down-Tit	0 0	0 1		- 1	- 4	
To Height	14	- i	ů.	ii ii	N N	11
legalatory Fower	15.8	25.04	25.04	868.54	6624	86626
TKA Helor				11111		
TMA Hotel	Strain					
BBU Make BBU Model	SAISSE BREA	Drivene BRUISTO BOSA	Drinner MUSDI DISSA	Ericenze MUSICI 966A	Treaser NA LISSO BIGGA	Ericsen BBUS23 B66A
Russier of To, Ro Unes	44	44	44	4.4	(4	4,4
Position						
Transmitter Id	488681	ASSOCIA	4500701	PERMI	146213	7405118
Searce	ATOLL ARE	NTOLL AR	ATOLL APR	ATOLL API	ATOL API	ATOLL, API
THE MICE CITE		0000			521.5	
Sector Azinotii	91 91	D2 240	89 270	96	ω	99 270
Call (Black & B)	1000	9035	001503	60.55	90.303	681353
Artens Notel	258658	HEX458CH00000KT90-750-0-451-RED	HEXASTRO0000X-T03-750-0+451-800	HOCOGREGISHO-CC	#X06750640-IC	WEST TO SECURITION OF THE PERSON OF THE PERS
		(30907E)	(304133)			
Artenna Hala	93MTEL	AMPHENDS.	ARRIGIO.	316A	MA	JMA
Artere Centellise(Ft) Medianiai Down-1915Deg.)	30 0	*		H.	10	94
Districal Down-Tits	3	- 1	3	2	9	1
The Straight	H	94	H	24	H	24
Segulatory Power TMA Make	15.25	104.18	154.29	36030	185.26	199.50
TMA Hain						
INC. Hotel	Chronist	Dresson	Driggen	Tromin	Ercason	Drivent
RRU Model	440	4445	4441	441	4449	6463
Buster of To, its Lines	4.4	44	44	4,4	5,4	64
Footbox Transmitter M	699037	4693602	4103687	TERROR	20000	7410114
Transmitter id Seurce	ATOLL API	ASSISSIO ATOLL API	ATOLL_API	ATOLL API	ATOLL API	ATOLL API
PRO MICE AGAIN					POLE	
Escia				6063	660	1663
Asieuti Cail / Block II				90	200	210
Arterra Fode				6000M/D040-03	#806750540-622	ES-CHROMONI
Antonna Raio				DIEK	300.	JMA :
Actoria Contestina(Ft				FB	16	50
Historical Down-Tittley. Electrical Down-Tit				0 2		- 4
Tip Height				14	M.	H
Regulatory Free				36618	38.3	197.23
TMA Kale						
TMA Hode MIN Febr				Dinesn	Dioses	Dysea
SRU Yede				Dispens	DYCHAR -	District.
Number of To, Ra Une				6.4	64	64
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Traumthir is Source				THROSE ATOLL, API	THICE ATOLLAN	704043 A7011 A71
				ATOLL, API		AHILLAN
NCodd				170000	tous	- 075
Siction Asimoth				nect to	860 381	1803 270
Cell / Block 6				E361,342	000.00	0.00103
Actaona Fode				S-Guid Antenna	1-5ubl-Accensis	6-Suid-Arterna
Arterna Kala Arterna Contestine Pt				ttió	190	190
Arterna Controllin/Ft Rectanical Deser-Titribes				80	W.	90
				2	8	9 3
The Haight				10.2	81	103
Regulatory Free				3.3	3029	10126
TWA Hole						
SEC NAME				Dromen	Disease	Distant
BRII Hode				VZHIL	VZZIII	ACEST.
Sizeber of Ti, Re Una Postine				Li .	4.0	4,4
Transmitter in				763600	70060	7000
Saro				ATOLA, API	ATOLL AN	ATSILAN
150e					50.3	
				91		87
Seto Ariest				91 10	34 381	107 270
Cell / Diodell II				301352 #030700000-re	30392	3030
Actions hade				WOLFICARD-O	RECOTACOMS on	H01070045-es
Arterna Halo				DAY	26A	190
Antenna Centerfreit				80		30
Rechanical Drose-Tittleg.					- 4	
				2	I M	1 H
Electrical Down-TB				TIE et	310.00	240
Electrical Done-TB Tip Hilgh				110,25	est.B	24.0
Electrical Donor-Th The Height						
Electrical Cover-TP TO 144gt Regulatory Fower TMA Hole TMA Hole						
Einstrikal Coner-TE Tip High Regulatory Frame TMA Kale TMA Hode REGULATORY			1	tower	Dromen	Disser
Electrical Const-TT To 144ght Regulatory Fower THA Rode THA Rode REE REAL REE RODE REE RODE				AACS DAD	4439 349	4-00 849
Enertical Green TE TO 144pt Regulatory Free TMA Rela TMA				Erroscon AAS End A.4	Drosen 8418 348 4,4	Disser 4-00 pag 4,4
Electrical Const-TT To 144ght Regulatory Frame THA Rode THA Rode REE REAL REE RODE REE RODE				AACS DAD	4439 349	4-00 849

JURISDICTIONAL APPROVAL:



CROWN CASTLE
1505 WESTLAKE AVENUE NORTH, SUITE 800
SEATILE, WA 98109

FULLERTON ENGINEERING BESIGN

VERIZON SITE NUMBER: 221424

BU #: 880329 SOUTH HILL MALL 3150 S MERIDIAN PUYALLUP, WA 98373 EXISTING 120'-0" MONOPOLE

2021.0060.0074

-				I
REV	DATE	DRWN	DESCRIPTION	DES./Q/
A	03/25/2021	MIC	PRELIMINARY	CJ
0	04/25/2021	MAN	CONSTRUCTION	CJ




IT IS A VIOLATION OF LAW FOR ANY PERSON, UNLESS THEY ARE ACTING UNDER THE DIRECTION OF A LICENSED PROFESSIONAL ENGINEER, TO ALTER THIS DOCUMENT.

SHEET NUMBER:






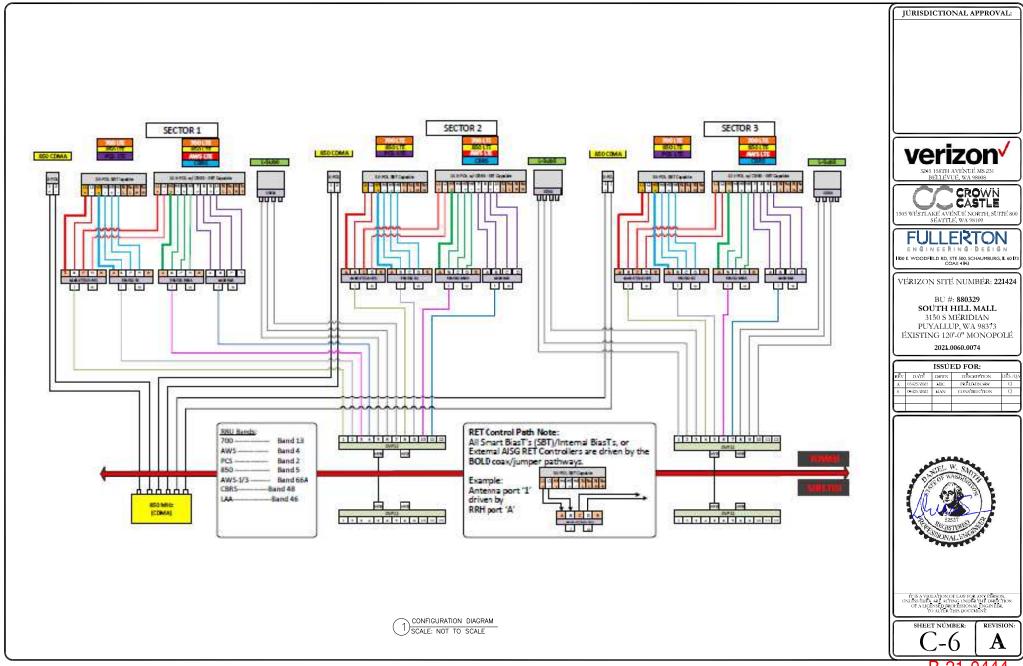



JURISDICTIONAL APPROVAL:

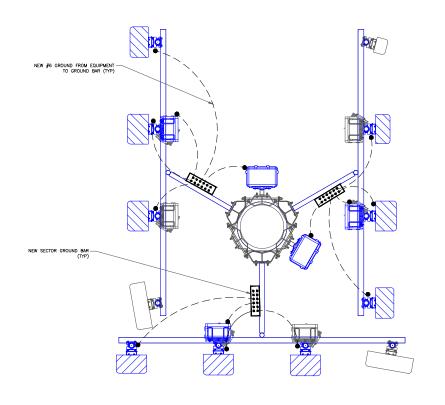

verizon

CROWN CASTLE 1505 WESTLAKE AVENUE NORTH, SUITE 800 SEATTLE, WA 98109

3245 158TH AVENUE MS 231 BELLEVUE, <u>WA 98008</u>

FULLERTON

I I 00 E. WOODFIELD RD, STE 500, SCHAUMBURG, IL 60 I COA# 41 43 VERIZON SITE NUMBER: 221424

BU #: 880329 SOUTH HILL MALL

3150 S MERIDIAN PUYALLUP, WA 98373 EXISTING 120'-0" MONOPOLE

2021.0060.0074

ISSUED FOR:							
REV	DATE	DRWN	DESCRIPTION	DES./QA			
A	03/25/2021	MIC	PRELIMINARY	CJ			
0	04/25/2021	MAN	CONSTRUCTION	CJ			



IT IS A VIOLATION OF LAW FOR ANY PERSON, UNLESS THEY ARE ACTING UNDER THE DIRECTION OF A LICENSED PROPESSIONAL ENGINEER, TO ALTER THIS DOCUMENT.

SHEET NUMBER:

REVISION: A


GROUNDING LEGEND

MECHANICAL CONNECTION

ANTENNA GROUNDING PLAN SCALE: NOT TO SCALE




IURISDICTIONAL APPROVAL:

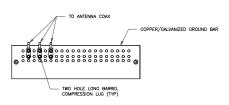

NOTES:

- 1. DOUBLING UP "OR STACKING" OF CONNECTIONS IS NOT PERMITTED.
- 2. EXTERIOR ANTIOXIDANT JOINT COMPOUND TO BE USED ON ALL EXTERIOR CONNECTIONS.
- 3. GROUND BAR SHALL NOT BE ISOLATED FROM TOWER. MOUNT DIRECTLY TO ANTENNA MOUNT STEEL.


ANTENNA SECTOR GROUND BAR DETAIL SCALE: NOT TO SCALE

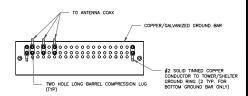

NOTES:

- 1. EXTERIOR ANTIOXIDANT JOINT COMPOUND TO BE USED ON ALL EXTERIOR CONNECTIONS.
- 2. GROUND BAR SHALL NOT BE ISOLATED FROM TOWER. MOUNT DIRECTLY TO TOWER STEEL (TOWER ONLY).
- 3. GROUND BAR SHALL BE ISOLATED FROM BUILDING OR SHELTER.

TOWER/SHELTER GROUND BAR DETAIL
SCALE: NOT TO SCALE

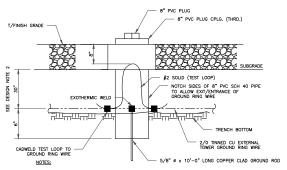

- 1. GROUND ROD SHALL BE DRIVEN VERTICALLY, NOT TO EXCEED 45 DEGREES FROM THE
- VERTICAL

 2. GROUND WIRE SHALL BE MIN. 30" BELOW GRADE OR 6" BELOW FROST LINE.

 (WHICH EVER IS GREATER) AS PER N.E.C. ARTICLE 250—50(D)

3 INSPECTION WELL DETAIL SCALE: NOT TO SCALE



CROWN CASTLE 1505 WESTLAKE AVENUE NORTH, SUITE 80 SEATTLE WA 98109

FULLERTON

I 100 E. WOODFIELD RD, STE 500, SCHAUMBURG, IL 60173 COA# 4143

VERIZON SITE NUMBER: 221424

BU #: **880329 SOUTH HILL MALL** 3150 S MERIDIAN

PUYALLUP, WA 98373 EXISTING 120'-0" MONOPOLE

2021.0060.0074

l	ISSUED FOR:							
ı	REV	DATE	DRWN	DESCRIPTION	DES./Q/			
ı	A	03/25/2021	MIC	PRELIMINARY	CJ			
ı	0	04/25/2021	MAN	CONSTRUCTION	CJ			
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•	7.				_			




IT IS A VIOLATION OF LAW FOR ANY PERSON, NLESS THEY ARE ACTING UNDER THE DIRECTION OF A LICENSED PROFESSIONAL ENGINEER, TO ALTUR THIS DOCUMENT.

G-2





REVISION

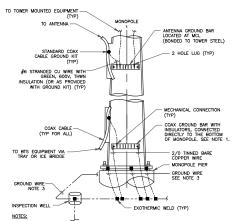

- NUMBER OF GROUNDING BARS MAY VARY DEPENDING ON THE TYPE OF TOWER, ANTENNA LOCATIONS AND CONNECTION ORIENTATION. COAXUAL CABLES EXCEEDING 200 FEET ON THE TOWER SHALL HAVE GROUND KITS AT THE MIDPONT. PROVIDE AS REQUIRED.
- ONLY MECHANICAL CONNECTIONS ARE ALLOWED TO BE MADE TO CROWN CASTLE USA INC. TOWERS. ALL MECHANICAL CONNECTIONS SHALL BE TREATED WITH AN ANTI-OXIDANT COATING.
- ALL TOWER GROUNDING SYSTEMS SHALL COMPLY WITH THE REQUIREMENTS OF THE RECOGNIZED EDITION OF ANSI/TIA 222 AND NFPA 780.

TYPICAL ANTENNA CABLE GROUNDING
SCALE: NOT TO SCALE

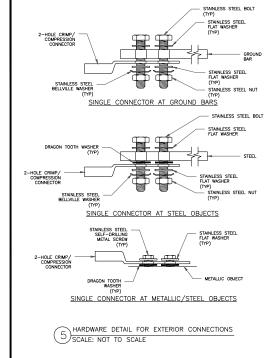

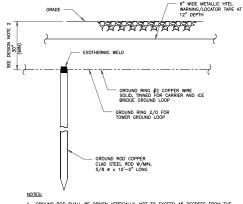


- GROUND ROD SHALL BE DRIVEN VERTICALLY, NOT TO EXCEED 45 DEGREES FROM THE VERTICAL
- VERTICAL


 GROUND WIRE SHALL BE MIN. 30" BELOW GRADE OR 6" BELOW FROST LINE.

 (WHICH EVER IS GREATER) AS PER N.E.C. ARTICLE 250-50(D)

GROUND ROD DETAIL
SCALE: NOT TO SCALE

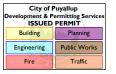


IURISDICTIONAL APPROVAL:

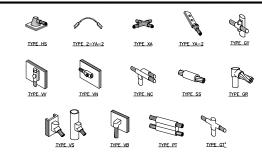


- ERICO EXCITERMIC "MOLD TYPES" SHOWN HERE ARE EXAMPLES. CONSULT WITH CONSTRUCTION MANAGER FOR SPECIFIC MOLDS TO BE USED FOR THIS PROJECT.
 MOLD TYPE ONLY TO BE USED BELOW GRADE WHEN CONNECTING GROUND RING TO GROUND ROD.

CADWELD GROUNDING CONNECTIONS SCALE: NOT TO SCALE

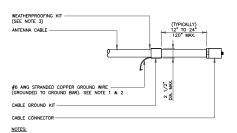


- DO NOT INSTALL CABLE GROUND KIT AT A BEND AND ALWAYS DIRECT GROUND WIRE DOWN TO GROUND BAR.
- GROUNDING KIT SHALL BE TYPE AND PART NUMBER AS SUPPLIED OR RECOMMENDED BY CABLE MANUFACTURER.
- WEATHER PROOFING SHALL BE TWO-PART TAPE KIT, COLD SHRINK SHALL NOT BE USED.
- CABLE GROUND KIT CONNECTION SCALE: NOT TO SCALE

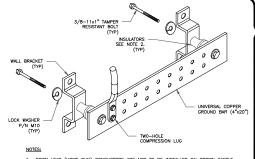

DOWN LEAD (HOME RUN) CONDUCTORS ARE NOT TO BE INSTALLED ON CROWN CASTLE USA INC. TOWER, PER THE GROUNDING DOWN CONDUCTOR POLICY GAS—STD—10091. NO MODIFICATION OR PRILLING TO TOWER STELL IS ALLOWED IN ANY FORM OR FASHION, CAD—WELDING ON THE TOWER AND/OR IN THE AIR ARE NOT PERMITTED.


2. OMIT INSULATOR WHEN MOUNTING TO TOWER STEEL OR PLATFORM STEEL USE INSULATORS WHEN ATTACHING TO BUILDING OR SHELTERS.

GROUND BAR DETAIL 6) SCALE: NOT TO SCALE

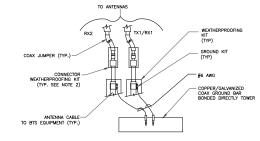


NOTES:

- DO NOT INSTALL CABLE GROUND KIT AT A BEND AND ALWAYS DIRECT GROUND WIRE DOWN TO ANTENNA GROUND BAR.
- 2. WEATHER PROOFING SHALL BE TWO-PART TAPE KIT. COLD SHRINK SHALL NOT BE USED.
- GROUND CABLE CONNECTION 4) SCALE: NOT TO SCALE

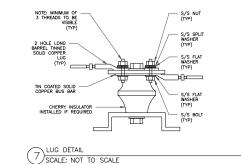


WIRE SIZE BURNDY LUG BOLT SIZE #6 AWG GREEN INSULATED YA6C-2TC38 3/8" - 16 NC S 2 BOLT 3/8" - 16 NC S 2 BOLT #2 AWG SOLID TINNED #2 AWG STRANDED YA2C-2TC38 3/8" - 16 NC S 2 BOLT #2/0 AWG STRANDED YA26-2TC38 3/8" - 16 NC S 2 BOLT 1/2" - 16 NC S 2 BOLT #4/0 AWG STRANDED YA28-2N

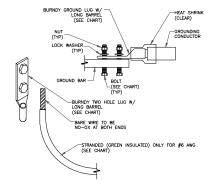


NOTES:

- ALL GROUNDING LUGS ARE TO BE INSTALLED PER MANUFACTURER'S SPECIFICATIONS. ALL HARDWARE BOLTS, NUTS, LOCK WASHERS SHALL BE STAINLESS STEEL ALL HARDWARE ARE TO BE AS FOLLOWS: BOLT, FLAT WASHER, GROUND BAR, GROUND LUG, FLAT WASHER AND NUT.
- MECHANICAL LUG CONNECTION 2) SCALE: NOT TO SCALE

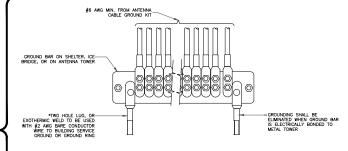

GROUNDWIRE INSTALLATION 5) SCALE: NOT TO SCALE

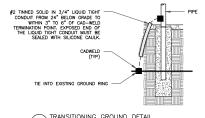

TRANSITIONING GROUND DETAIL (8) SCALE: NOT TO SCALE



CROWN CASTLE 505 WESTLAKE AVENUE NORTH, SUITE 80 SEATTLE WA 98109

FULLERTON

I 00 E. WOODFIELD RD, STE 500, SCHAUMBURG, IL 60 I COA# 41 43

VERIZON SITE NUMBER: 221424

BU #: 880329 SOUTH HILL MALL

3150 S MERIDIAN PUYALLUP, WA 98373 EXISTING 120'-0" MONOPOLE

2021.0060.0074

ISSUED FOR:							
REV	DATE	DRWN	DESCRIPTION	DES./QA			
A	03/25/2021	MIC	PRELIMINARY	CJ			
0	04/25/2021	MAN	CONSTRUCTION	CJ			



SHEET NUMBER: (T-

REVISION Α

MODIFICATION AND DESIGN DRAWINGS FOR EXISTING ANTENNA MOUNTS EXISTING MONOPOLE TOWER

PROPOSED CARRIER: VERIZON

TOWER OWNER: CROWN CASTLE / TOWER OWNER SITE #: 880329

CARRIER SITE #/NAME: 221424-VZW / BRADLEY PARK - A

COORDINATES (LATITUDE: 47.162078*, LONGITUDE: -122.294456*)

FUZE ID # 16225818

Contractor PIV	Contractor PMI Requirements		SHEET TITLE	REV
		T-1	TITLE SHEET	0
PMI Accessed At	https://pmi.vzwsmart.com	вом	BILL OF MATERIALS	0
		GN-1	GENERAL NOTES	0
Smart Tool Vendor Project	10049216	A-1	ANTENNA MOUNT MODIFICATION DETAILS	0
Number		A-2	ANTENNA MOUNT PHOTOS	0
VzW Location Code (PSLC)	221424	D-1	STANDARD DETAILS	0
V2W Editation Code (F3EC)		SAF-1	SAFETYCABLE GUIDE DETAILS	0
*** PMI and Requirements al	*** PMI and Requirements also embedded in Mount Analysis		CROSSOVER PLATE	
Re	port	VZWSMART-PLK7	MONOPOLE COLLAR MOUNT ASSEMBLY	
		VZWSMART-SFK4	T-ARM KIT	
VzW APPROVED S	MART KIT VENDORS			
	ation Drawings Page for Approved Vendors			

<u>N</u>

 THE MODIFICATION DRAWINGS ARE BASED ON THE TES PROJECT NO. 10037121, DATED 02/25/2021. Tower Engineering Solution:
1320 GREENWAY DRIVE, SUITE 600
IRVNG, TX 750.38
PH: 1972) 483-0607

verizon

10049216
CUSTOMER SITE NO:
221424-VZW
CUSTOMER SITE NAME:
BRADLEY PARK — A
3150 S MERIDIAN ST.
PUYALUP, WA 98373

Exp.08/12/2021



04/01/2021

DRAWN	BY: JM	CHECKE	D By	: BS/CHLE
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			T		BILL OF MATI	INIALS					
NTITY	QUANTITY PROVIDED	PART NUMBER		DESCRIPTIONS			SHEET LIST	PIECE WEIGHT (LBS)	WEIGHT (LB)	NOTES	
.2	12	VZWSMART-MSK2	CROSSOVER PLATE	MATERIAL & HARDWARE			A-1, VZWSMART-MSK2	15.0	180.0	Galvanized	
1	1	VZWSMART-PLK7	MONOPOLE COLLAR MOUNT ASSEMBLY				A-1, VZWSMART-PLK7	150.0	150.0	Galvanized	
3	3	VZWSMART-SFK4	T-ARM KIT				A-1, VZWSMART-SFK4	106.0	318.0	Galvanized	Tower Engineering So
											1320 GREENWAY DRIVE, SUITI
											1320 GREENWAY DRIVE, SUITE IRVING, TX 75038 PH: (972) 483–0607
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											TES JOB NO:
											10049216
											CUSTOMER SITE NO: 221424-VZW
											CUSTOMER SITE NAME:
											BRADLEY PARK -
			FOLIO	WING ITEMS ARE "CUSTOM	I" PARTS						3150 S MERIDIAN ST. PUYALLUP, WA 98373
3	3	PST350-15	3" PST (3.50" O.D X 0.216" THK) X 15'-0" A53				A-1	116.31	348.9	GALVANIZED (FINAL CUT LENGTH TO BE DETERMINED IN FIELD)	FUTALLUP, WA 983/3
2	2	TMP-2	PL 1/4" X 2" X 7" A36				D-1, SAF-1	1.00	2.0	GALVANIZED]
2	2	PN 115-203	SAFETY CABLE GUIDE (TUF-TUG OR EQUIV.)				SAF-1	0.00	0.0	GALVANIZED	- 1
2	5 3		BOLT 3/8" X 1 1/2" FULL THREAD SAE GR 5 BOLT 5/8" X 2" A325				SAF-1 SAF-1	0.00	0.0 1.1	(1) HHN & LKW-EA GALVANIZED (1) HHN & LKW-EA GALVANIZED	-
2	3		BOLI 5/8 X 2 A325				SAF-1	0.38	1.1	(1) HHN & LKW-EA GALVANIZED	
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				VZV	/ Mount Modification Kit	s - Approved ver	idors				-
		PerfectVi	sion		Metrosite Fabrio	ators IIC				Sabre Industries Inc	
act:		Wireless Sales	wirelesssales@perfect-vision.com	Contact:	Kent Ramey		metrositellc.com	Cont	tact:	Angie Welch akwelch@sabreindustries.com	BILL OF MATERIA
ne Num	ber	844.887.6723	micressares e periodi visioniconi	Phone Number	(O) 706.335.7045		706.982.9788		ne Number	866.428.6937	
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act:		Paula Boswell	paula.boswell@valmont.com	Contact:	Salvador Anguiano	Salvador.Ang	guiano@commscope.com				disclosure by any method is prohit except by express written permissi Tower Engineering Solutions, LLC. V
ne Num	iber	972.236.9843		Phone Number	817.304.7492						exception, the information on this
site			www.sitepro1.com	Website		www.	commscope.com				drawing/document remains the pro Tower Engineering Solutions, LLC.
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	facturore !!-+	ad are the only serve	und unders for the VaM Mount Vita Fact	manufacturor will be	uara of which kitch	on through the	ValAl approval pro	nd that -	in turn	oved to sell. Please note that the material utilized on the mount	71 BOM

GENERAL NOTES

- 1. ALL WORK SHALL COMPLY WITH THE ANSI/TIA-222-H, ANSI/ASSP A10.48, AND ANY OTHER GOVERNING BUILDING CODES AND OSHA SAFETY REGULATIONS.
- ALL WORK INDICATED ON THE DRAWINGS SHALL BE PERFORMED BY QUALIFIED CONTRACTORS EXPERIENCED IN TELECOMMUNICATIONS TOWER, POLE AND FOUNDATION CONSTRUCTION.
- THE CONTRACTOR SHALL BE RESPONSIBLE FOR THE DESIGN AND FABRICATION OF ALL MISCELLANEOUS PARTS (SUCH AS SHIMS),
- TEMPORARY SUPPORTS, AND GUYINGS, ETC., PER ANSI/ASSP A10.48, TO COMPLETE THE ASSEMBLY AS SHOWN IN THE DRAWINGS. CONTRACTOR SHALL PROCEED WITH THE INSTALLATION WORK CAREFULLY SO THE WORK WILL NOT DAMAGE ANY EXISTING CABLE,
- FOUIPMENT OR THE STRUCTURE. THE USE OF GAS TORCH OR WELDER, ARE NOT ALLOWED ON ANY TOWER STRUCTURE WITHOUT THE CONSENT OF THE TOWER OWNER.
- GENERALLY THE CONTRACTOR IS RESPONSIBLE TO CONDUCT AN ONSITE VISIT SURVEY OF THE JOB SITE AFTER AWARD, AND REPORT ANY ISSUES WITH THE SITE TO TES BEFORE PROCEEDING CONSTRUCTION.
- IT IS THE RESPONSIBILITY OF THE GC TO VERIFY THAT THERE IS NO INTERFERENCES (WITH SAFETY CLIMB BRACKETS, TRANSMISSION LINES, ETC.) PRIOR TO MOBILIZATION AND INSTALLATION OF THESE MODIFICATIONS.
- PLEASE NOTIFY TES IMMEDIATELY IF ANY INSTALLATION ISSUES OCCUR RELATED TO THIS DRAWING @ 972-483-0607 OR EMAIL-TESORDERS@TESTOWER.US

FABRICATION

- ALL STEEL SHALL MEET OR EXCEED THE MINIMUM STRENGTH AS SPECIFIED IN THE DRAWINGS. IF YIELD STRENGTH WAS NOT NOTED IN THE DRAWINGS, CONTRACTORS SHALL CONTACT TES FOR DIRECTION.
- 2. ALL FIELD CUT EDGES SHALL BE GROUND SMOOTH. ALL FIELD CUT AND DRILLED SURFACES SHALL BE REPAIRED WITH A MINIMUM OF TWO COATS OF ZINGA COLD GALVANIZING COMPOUND PER ASTM A780 AND MANUFACTURER'S RECOMMENDATIONS.

WELDING

- 1. ALL WELDING SHALL BE PERFORMED BY AWS CERTIFIED WELDERS AND IN ACCORDANCE WITH THE LATEST EDITION OF THE AWS WELDING CODE D1.1. ALL ELECTRODES TO BE LOW HYDROGEN, MATCHING FILLER METAL, PER AWS D1.1, UNO. (E70XX UNLESS
- PRIOR TO FIELD WELDING GALVANIZED MATERIAL, CONTRACTOR SHALL GRIND OFF GALVANIZING APPROX, 0.5" BEYOND THE PROPOSED FIELD WELD SURFACES.
- ALL WELDS SHALL BE INSPECTED VISUALLY. A MINIMUM OF 25% OF WELDS SHALL BE INSPECTED WITH DYE PENETRANT OR MAGNETIC PARTICLE TO MEET THE ACCEPTANCE CRITERIA OF AWS D1.1. 100% OF WELDS SHALL BE INSPECTED IF DEFECTS ARE
- 4. WELD INSPECTIONS SHALL BE PERFORMED BY AN AWS CERTIFIED WELD INSPECTOR.
- AFTER INSPECTION, ALL FIELD WELDED SURFACES SHALL BE REPAIRED WITH A MINIMUM OF TWO COATS OF ZINGA COLD GALVANIZING COMPOUND PER ASTM A780 AND MANUFACTURER'S RECOMMENDATIONS.

BOLTED ASSEMBLIES AND TIGHTENING OF CONNECTIONS

- ALL HIGH STRENGTH BOLTS SHALL CONFORM TO THE PROVISIONS OF THE SPECIFICATIONS FOR STRUCTURAL JOINTS USING A325 OR A490 BOLTS AS APPROVED BY THE RCSC.
- FLANGE BOLTS SHALL BE TIGHTENED BY THE AISC "TURN-OF-THE-NUT" METHOD. THE FOLLOWING TABLE SHOULD BE USED FOR THE "TURN-OF-THE-NUT" TIGHTENING.
- SPLICE BOLTS AND ALL OTHER BOLTS IN BEARING TYPE CONNECTIONS SHALL BE TIGHTENED TO A SNUG-TIGHT CONDITION.
- THE SNUG-TIGHT CONDITION IS DEFINED AS THE TIGHTNESS ATTAINED BY EITHER A FEW IMPACTS OF AN IMPACT WRENCH OR THE FULL EFFORT OF AN IRONWORKER WITH AN ORDINARY SPUD WRENCH TO BRING THE CONNECTED PLIES INTO FIRM CONTACT.
- HB HOLLO-BOLT SHALL BE INSTALLED PER ICC ESR-3330 INSTRUCTIONS.

VERIFICATION AND INSPECTION

IF APPLICABLE, VERIFICATION INSPECTION TO BE PERFORMED SHALL BE IN ACCORDANCE TO IBC-2018 SECTION 1705.2 FOR STEEL CONSTRUCTION AND TABLE 1705.3 FOR CONCRETE CONSTRUCTION.

TABLE 8.2 NUT ROTATION FROM SNUG-TIGHT CONDITION FOR TURN-OF-NUT PRETENSIONING $^{\mathfrak{a},\mathfrak{b}}$

	DISPOSITION OF OUTER FACE OF BOLTED PARTS					
BOLT LENGTH ^C	BOTH FACES NORMAL TO BOLT AXIS	ONE FACE NORMAL TO BOLT AXIS, OTHER SLOPED NOT MORE THAN 1:20 d	BOTH FACES SLOPED NOT MORE THAN 1:20 FROM NORMAL TO BOLT AXIS ^d			
NOT MORE THAN 4d _b	1/3 TURN	1/2 TURN	2/3 TURN			
MORE THAN 4d _b BUT NOT MORE THAN 8d _b	1/2 TURN	2/3 TURN	5/6 TURN			
MORE THAN 8d _b BUT NOT MORE THAN 12d _b	2/3 TURN	5/6 TURN	1 TURN			

- O NUT ROTATION IS RELATIVE TO BOLT REGARDLESS OF THE ELEMENT (NUT OR BOLT) BEING TURNED. FOR REQUIRED NUT ROTATIONS OF 1/2 TURN AND LESS, THE TOLERANCE IS PLUS OR MINUS 30 DEGREES: FOR REQUIRED NUT ROTATIONS OF 2/3 TURN AND MORE, THE TOLERANCE IS PLUS OR MINUS 45 DEGREES.
- b APPLICABLE ONLY TO JOINTS IN WHICH ALL MATERIAL WITHIN THE GRIP IS STEEL.
- WHEN THE BOLT LENGTH EXCEEDS 12db, THE REQUIRED NUT ROTATION SHALL BE DETERMINED BY ACTUAL TESTING IN A SUITABLE TENSION CALIBRATOR THAT SIMULATES THE CONDITIONS OF SOLIDLY FITTING STEEL.
- d BEVELED WASHER NOT USED.

SPECIFICATION FOR STRUCTURAL JOINTS USING ASTM A325 OR A490 BOLTS, JUNE 30, 2004 RESEARCH COUNCIL ON STRUCTURAL CONNECTIONS

INSTALLATION TORQUE REQUIRED FOR HOLLO BOLTS AND AJAX BOLTS:

- 1. HB12 HOLLO BOLT: 59 FT-LBS
- HB16 HOLLO BOLT: 140 FT-LBS HB20 HOLLO BOLT: 221 FT-LBS
- M20 AJAX BOLT: 280 FT-LBS.

FIELD HOT WORK PLAN NOTES:

FOLLOWING GUIDFLINES SHALL BE COMPLIED WITH:

- 1. CONTRACTOR'S RESPONSIBILITY TO COMPLETE A HOT WORK PLAN IF AWARDED PER CUSTOMER SPECIFICATIONS GUIDELINES FOR WELDING, CUTTING & SPARK PRODUCING WORK.
- HAVE A FIRE PLAN APPROVED BY THE CUSTOMER AND THEIR SAFETY MANAGEMENT DEPT.
- CONTRACTOR MUST OBTAIN THE CONTACT INFO OF THE LOCAL FIRE DEPARTMENT AND THE 911 ADDRESS OF THE TOWER SITE BEFORE CONSTRUCTION.
- CONTRACTOR SHALL MAKE SURE THAT CELL PHONE COVERAGE IS AVAILABLE IN THE TOWER SITE. IF CELL COVERAGE IS NOT AVAILABLE, AN IMMEDIATE AVAILABLE MEANS OF DIRECT COMMUNICATION WITH THE FIRE DEPARTMENT SHALL BE DETERMINED PRIOR TO CONSTRUCTION START.
- ALL CONSTRUCTION SHALL BE PERFORMED UNDER WIND SPEED LESS THAN 10 MPH ON THE GROUND LEVEL. IF WIND SPEED INCREASE, CONTRACTOR MUST DETERMINE IF CONSTRUCTION SHALL BE
- 6. FIRE SUPPRESSION EQUIPMENT MUST BE MADE AVAILABLE ON SITE AND READY TO USE.
- 7. CONTRACTOR SHALL ASSIGN A FIRE WATCHER TO PERFORM FIRE-FIGHTING DUTIES.
- ALL WELDERS SHALL BE AWS OR STATE CERTIFIED. THEY MUST ALSO BE EXPERIENCED IN WELDING ON GALVANIZED MATERIALS.
- IF IT IS POSSIBLE, ALL EXISTING COAX NEAR WELDING AREA SHALL BE TEMPORARILY MOVED AWAY FROM THE WELDING AREA BEFORE WELDING THE PLATES.
- 10. PLEASE REPORT ANY FIELD ISSUE TO TES @ 972-483-0607.



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verizon

10049216 CUSTOMER SITE NO: 221424-VZW CUSTOMER SITE NAME: BRADLEY PARK - A 3150 S MERIDIAN ST PUYALLUP, WA 98373

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SHEET NUMBER:

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SCOPE OF WORK

- (1) INSTALL NEW VZWSMART CROSSOVER PLATE KIT, (4) PER SECTOR. SEE SHEET VZWSMART-MSK2 FOR DETAILS.
- 2 INSTALL NEW 3" PST SUPPORT RAIL PIPE, (1) PER SECTOR.
- 3 INSTALL NEW VZWSMART MONOPOLE COLLAR MOUNT ASSEMBLY. SEE SHEET VZWSMART-PLK7 FOR
- 4 INSTALL NEW VZWSMART T-ARM KIT, (1) PER SECTOR. SEE SHEET VZWSMART-SFK4 FOR DETAILS.
- 5 INSTALL NEW SAFETY CLIMB GUIDES TO PREVENT EXISTING SAFETY CLIMB FROM RUBBING AGAINST EXISTING AND NEW COLLAR MOUNTS. SEE SHEET SAF-1 FOR DETAILS.
- 6 THE CONTRACTOR SHALL BE RESPONSIBLE FOR THE CLEAN-UP, REMOVAL AND DISPOSAL OF EXCESS MATERIALS USED AND REMOVED FROM THE STRUCTURE AT THE COMPLETION OF THE PROJECT.



-EXISTING ANTENNA MOUNT 9 90' ELEV


PHOTO 1

CONTRACTOR NOTE:

- 1. IT IS THE RESPONSIBILITY OF THE CONTRACTOR TO VERIFY THAT THERE IS NO INTERFERENCES WITH (PORT HOLES, SAFETY CLIMB BRACKETS, TRANSMISSION LINES, ETC.) PRIOR TO MOBILIZATION AND INSTALLATION OF THESE MODIFICATIONS.
- 2. PLEASE NOTIFY TES IMMEDIATELY IF ANY INSTALLATION ISSUES OCCUR RELATED TO THIS DRAWING © 972–483–0607 OR EMAIL-TESORDERS®TESTOWER.US

NOTES

- TEMPORARILY RELOCATE ANY EXISTING COAX ATTACHED TO THE LEGS AND/OR ANY OTHER MEMBERS WHERE OBSTRUCTION WITH THE PROPOSED MODIFICATION MAY OCCUR.
- WHEN FIELD CUTTING AND DRILLING ANGLES, USE SAME GAGE LINES AND EDGE DISTANCES AS INDICATED ON SHOP CUT AND DRILLED ENDS.
- APPLY (2) COATS OF ZINGA COLD GALVANIZING COMPOUND AS PER THE MANUFACTURER'S SPECIFICATIONS TO ALL FIELD CUT AND DRILLED AREAS.
- 4. MEMBERS IN BLUE COLOR ARE NEW REINFORCEMENTS.

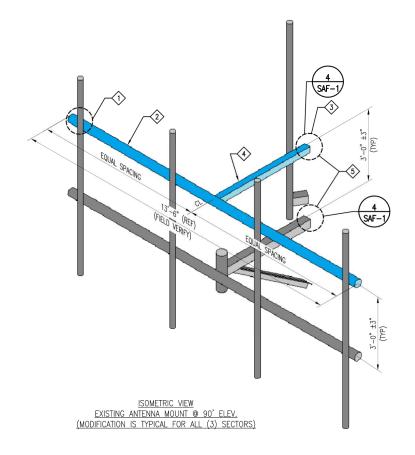

NO.	QTY.	PART NO.	DESCRIPTIONS
1	12	VZWSMART-MSK2	CROSSOVER PLATE
2	3	PST350-15	3" PST (3.50" O.D X 0.216" THK) X 15'-0" A53 GR-B 35KSI
3	1	VZWSMART-PLK7	MONOPOLE COLLAR MOUNT ASSEMBLY
4	3	VZWSMART-SFK4	T-ARM KIT



Tower Engineering Solutions
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IRVING, TX 75038
PM (673) 463, 0607

verizon /

10049216

CUSTOMER SITE NO:
221424—VZW

CUSTOMER SITE NAME:

BRADLEY PARK — A

3150 S MERIDIAN ST.
PLYVALUP, WA 98373

DRAWN BY: JM	CHECKED BY	: BS/CHLI
REV. DESCRIPTION FIRST ISSUE	BY JM	DATE 04/01/2

ANTENNA MOUNT MODIFICATION DETAILS

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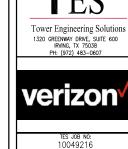


PHOTO 1

-EXISTING EQUIPMENT MUST BE RELOCATED UP OR DOWN ALONG THE MEMBER TO ACCOMMODATE



PHOTO 2



CUSTOMER SITE NO: 221424-VZW CUSTOMER SITE NAME: BRADLEY PARK - A 3150 S MERIDIAN ST. PUYALLUP, WA 98373



PHOTO 4

-INSTALL NEW SAFETY CLIMB GUIDE TO PREVENT EXISTING SAFETY CLIMB FROM RUBBING AGAINST EXISTING AND NEW COLLAR MOUNTS. SEE SHEET SAF-1 FOR DETAILS.



<u>PHOTO 3</u>

NOTE:
EXISTING RRUS/EQUIPMENT MAY BE RELOCATED
ALONG THE MEMBER TO ACCOMMODATE THE
INSTALLATION OF NEW MOUNT MODIFICATION



PHOTOS


ANTENNA MOUNT

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TES JOB NC:
10049216

CUSTOMER SITE NO:
221424 — VZW
CUSTOMER SITE NAME:
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3150 S MERIDUM ST.
PUYALUP, WA 98373

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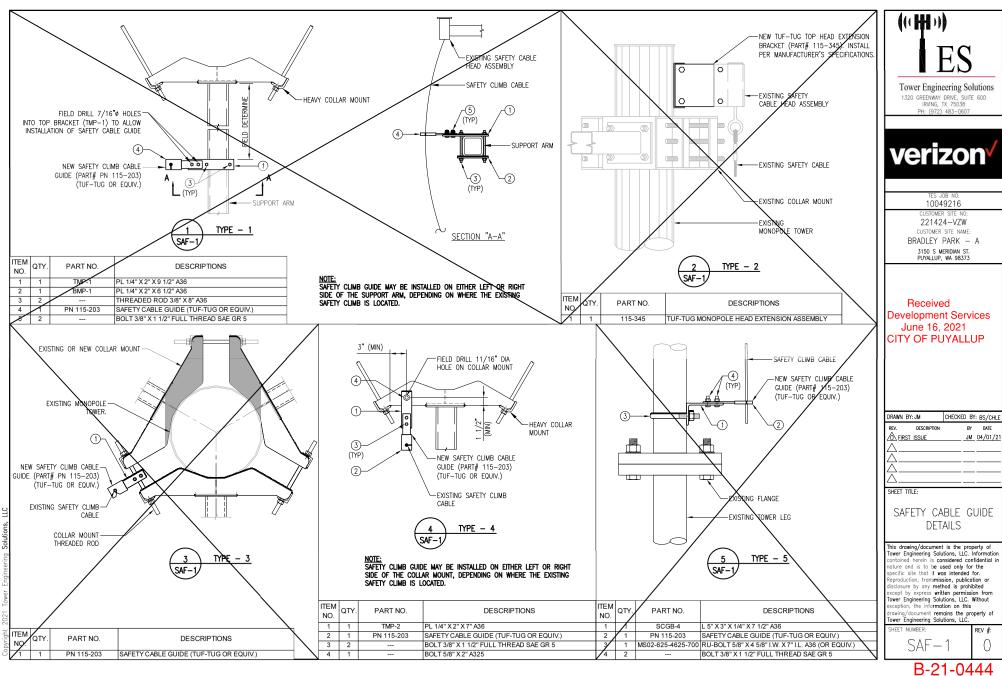
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NOTE 1. HO

NOTES: 1. HOT-DIPPED GALVANIZED PER ASTM A123. 2. ALL HOLES ARE 11/16" DIA. U.N.O

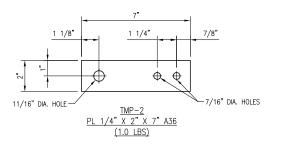






THE FOLLOWING DRAWINGS ARE INCLUDED FOR REFERENCE ONLY PLEASE REFER TO THE INSTALLATION DRAWINGS FOR ACTUAL INSTALLATION DETAILS



VzW SMART Tool[©] Vendor

verizon

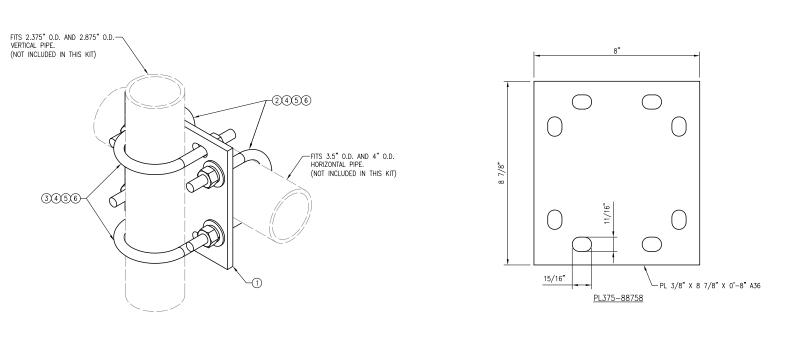

ITEM QTY.

3

4

NOTES:
1. HOT-DIPPED GALVANIZED PER ASTM A123.

5 8

6 8

PART NO.

PL375-88758

FW-625

LW-625

NUT-625

VZWSMART-MSK2 (CROSSOVER PLATE)

PL 3/8" X 8 7/8" X 0'-8" A36

2 MS02-625-4125-600 RU-BOLT 5/8" X 4 1/8" I.W. X 6" I.L. A36 (OR EQUIV.)

5/8" HDG USS FLAT WASHER

2 MS02-625-300-500 RU-BOLT 5/8" X 3" I.W. X 5" I.L. A36 (OR EQUIV.)

5/8" HDG LOCK WASHER

5/8" HDG HEX NUT

DESCRIPTION

SHEET #

MSK2-F1

RBC-1

RBC-1

GALVANIZED WT

WT

0

15

DRAWN BY: H.R CHECKED	BY: HMA
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