### **GENERAL NOTES**

### **ELECTRICAL NOTES:**

1) INSTALLATION SHALL COMPLY WITH NFPA 70, PARTICULARLY ARTICLE 760, AND SHALL ALSO COMPLY WITH NFPA 72, AND ALL LOCAL ELECTRICAL CODES AND LOCAL JURISDICTION REQUIREMENTS.

2) CONDUIT INDICATED ON PRINTS IS DIAGRAMMATIC AND MAY BE REROUTED PER FIELD REQUIREMENTS.

3) AC POWER SHALL NOT OCCUPY THE SAME CONDUIT AS FIRE PROTECTION CIRCUITS (MOST FIRE DETECTION CKT'S ARE NEC CLASS 3).

4) ALL SLC LOOP WIRING SHALL BE 2 CONDUCTOR #16, UNSHIELDED, FIRE ALARM CABLE OF THE PROPER RISER AND / OR PLENUM TYPE.

5) CONVENTIONAL FIRE DETECTION INITIATING DEVICE CIRCUITS OR NOTIFICATION APPLIANCE CIRCUITS SHALL NOT BE PARALLEL BRANCHED (TEE TAPPED) TO ENSURE SUPERVISION OF WIRING. ADDRESSABLE CLASS "B" FIRE DETECTION SIGNALING LINE CIRCUITS (SLC) MAY BE PARALLEL BRANCHED (TEE TAPPED) IF SO INDICATED ON THE SYSTEM PLANS.

6) OBSERVE POLARITY OF ALL FIRE DETECTION WIRING. POLARITY SHALL BE MAINTAINED THROUGHOUT ENTIRE SYSTEM; WIRE SHALL BE MARKED AND IDENTIFIED WHERE SPLICED, AND AT ANY JUNCTION BOXES. 7) THE FIRE ALARM PANEL GROUND SHALL BE A SEPARATE CONTINUOUS GROUND WIRE BACK TO THE SOURCE GROUND; CONDUIT

GROUND IS NOT ACCEPTABLE PER MANUFACTURER'S SPECIFICATIONS. 8) FIRE ALARM PANEL, AND ANY OTHER FIRE DETECTION EQUIPMENT REQUIRING 120VAC, SHALL BE SUPPLIED BY A DEDICATED CIRCUIT BREAKER OTHER (NON-FIRE DETECTION) EQUIPMENT SHALL NOT SHARE THE FIRE ALARM CIRCUIT(S). THIS BREAKER SHALL BE LOCKED AND CLEARLY MARKED "FIRE ALARM CIRCUIT CONTROL". 120VAC POWER BY OTHERS.

### FIRE ALARM INSTALLATION NOTES:

1) NOTIFY NORTHWEST FIRE SYSTEMS. OF ANY DESIGN QUESTIONS OR CHANGES CURRENT CONTRACT DRAWINGS PRIOR TO INSTALLATION.

2) ANY ALTERATIONS OR VARIATIONS FROM DRAWINGS SHOULD BE APPROVED PRIOR TO WORK PROCEEDING AND DOCUMENTED ON THE AS BUILT DRAWINGS. VERIFY DEVICE LOCATIONS PRIOR TO INSTALLATION.

3) REFERENCE FACTORY INSTRUCTION MANUALS DURING INSTALLATION OF FIRE CONTROL EQUIPMENT.

Fire

REVIEWED

FOR

DDrake

03/23/2022

9:09:34 AM

OFPUYA

4) DETECTORS SHALL NOT BE MOUNTED IN A DIRECT AIR STREAM. DO NOT INSTALL DETECTORS WITHIN 3'-0" OF AIR SUPPLY DIFFUSERS.

5) USE ONLY U.L. LISTED DEVICES.

6) DO NOT INSTALL DETECTOR HEADS UNTIL FINAL CLEANING HAS BEEN PERFORMED.

7) FIELD DETERMINE INTERFACE REQUIREMENTS AND LOCATIONS OF EQUIPMENT SUPPLIED BY OTHER TRADES. ( i.e.. SPRINKLER DEVICES, HVAC UNITS, FIRE DAMPERS, ELEVATOR CONTROLS, & FAN CONTROLS.)

City of Puyallup

Building

Engineering


Fire

Development & Permitting Services ISSUED PERMIT

Planning


Public Works

Traffic

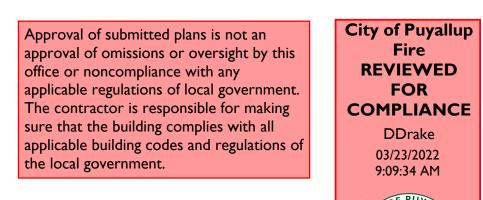

THE APPROVED CONSTRUCTION PLANS AND ALL ENGINEERING MUST BE POSTED ON THE JOB AT ALL INSPECTIONS IN A VISIBLE AND READILY ACCESSIBLE LOCATION.

### ead Permit

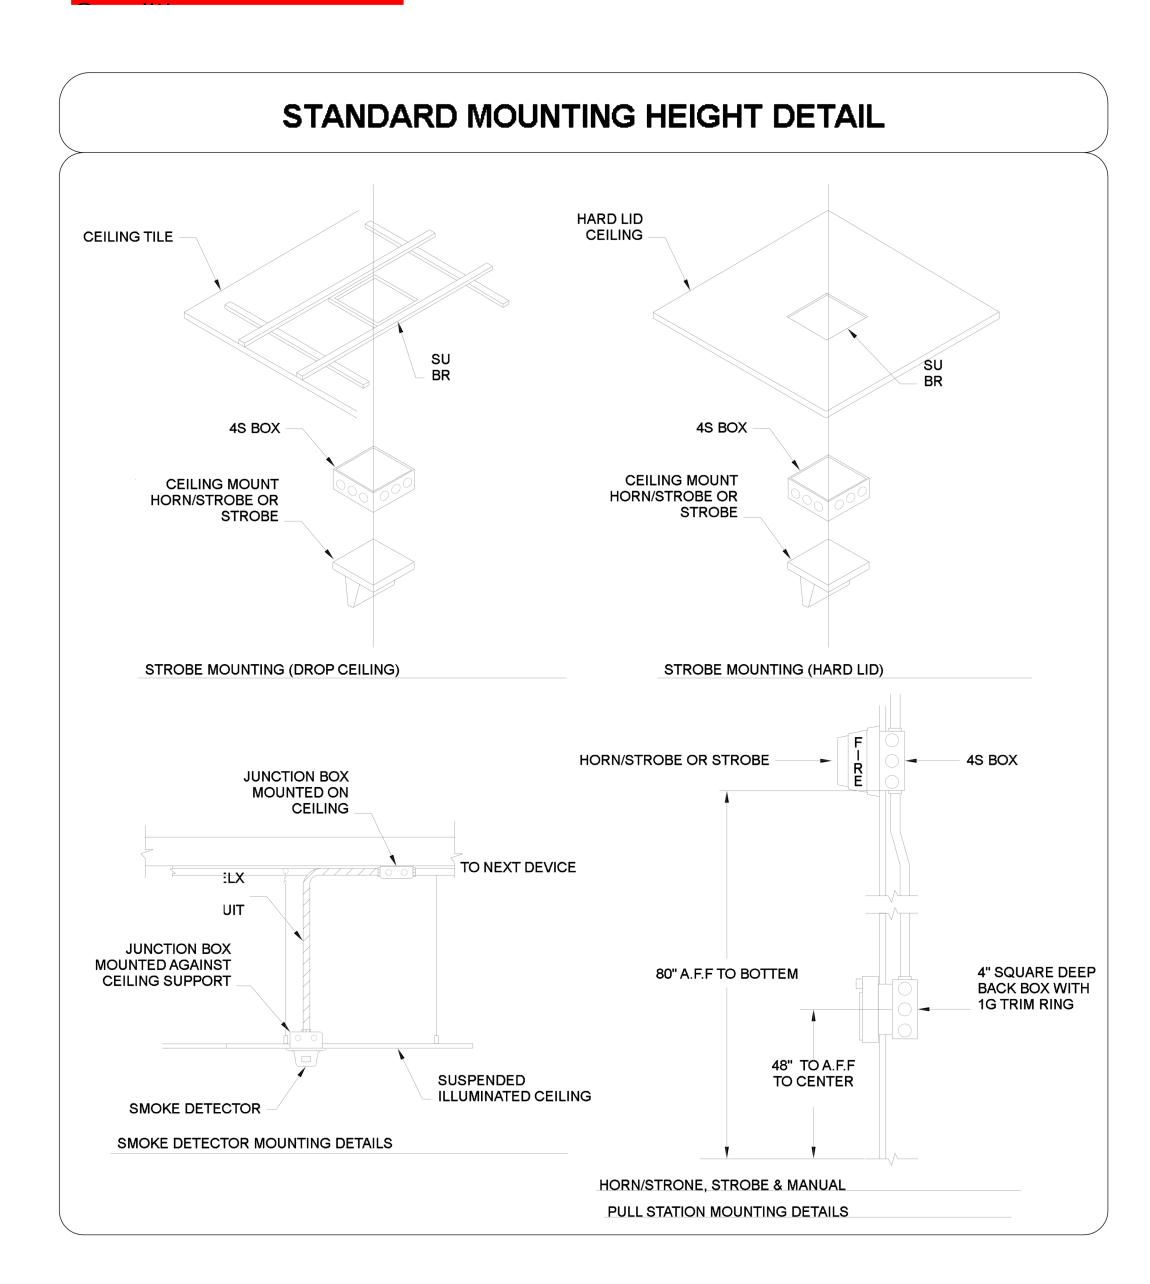

# ROUND ONE - T.I. BUILD OUT FIRE ALARM SYSTEM INSTALL 3500 S. MERIDIAN ST **PUYALLUP, WA 98373**


### SCOPE OF WORK:


NORTHWEST FIRE SYSTEMS WILL BE ADDING AND/RELOCATING FIRE ALARM DEVICES FOR TENANT BUILD OUT. NOTIFICATION WILL AND INITIATING DEVICES WILL BE INSTALLED TO MEET NFPA 72 AND LOCAL JURISDICTION REQUIREMENTS.

\*NOTE\* THE BUILDING HAS FULL SPRINKLER COVERAGE.

### MONITORING COMPANY INFORMATION NI/A

ADDRESS	N/A	
PHONE NUMBER	N/A	
	N/A	

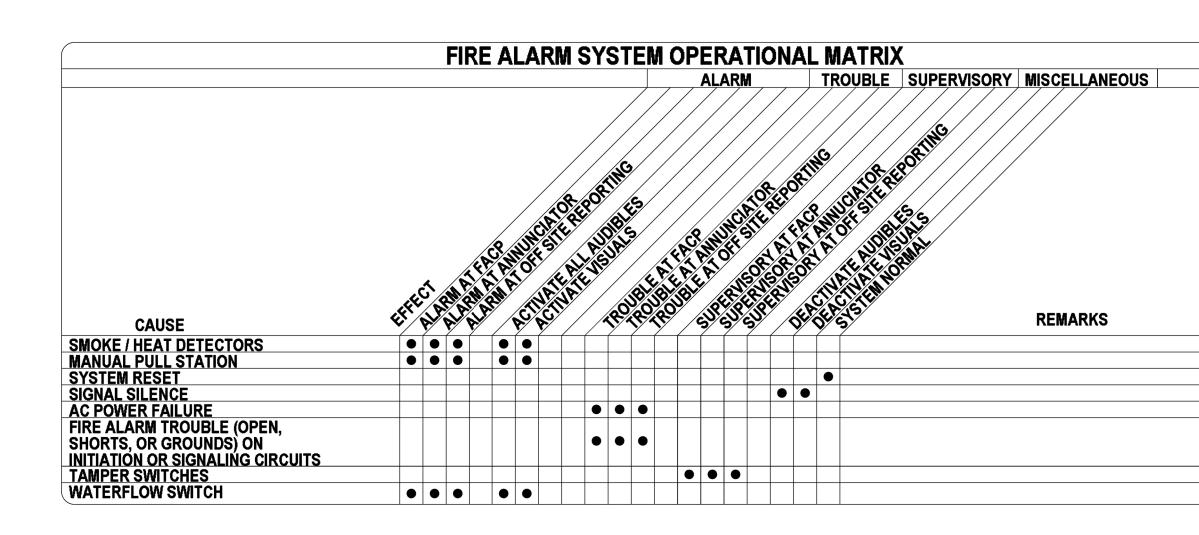

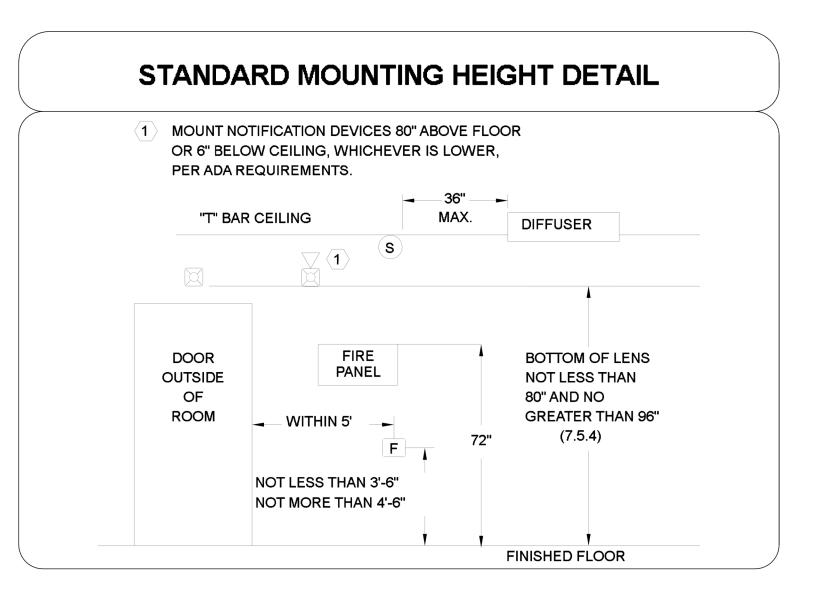


[							
	SYMBC	DL LEGEND					
SYMBOL	DESCRIPTION	MANUFACTURER	PART NUMBER	QUANTITY	USER TEXT	UL	FM
FACP	ENCLOSURE, TRANSPONDER, BLACK, SIZE D	GAMEWELL FCI	E3BB-BD/INX	1			
ANN	CAB A2 REMOTE FLUSH NGA ANN W/ PASSWORD PROTECTED	GAMEWELL FCI	E3BB-NGA-FLUSH	2			
INX1	ENCLOSURE, TRANSPONDER, BLACK, SIZE C	GAMEWELL FCI	E3BB-BC/INX	1			
RPS1	10AMP, 120VAC REMOTE CHARGER POWER SUPPLY, RED ENCLOSURE	HONEYWELL PRODUCTS	HPF-PS10	1			
S ABOVE	PHOTO, SMOKE, DETECTOR, BRIGHT WHITE	GAMEWELL FCI	ASD-PL3	109		S1913	3023594
	THERMAL HEAT DETECTOR 135F, BRIGHT WHITE	GAMEWELL FCI	ATD-L3	3		S2332	3023594
F	PULL STATION, SINGLE ACTION, ADDRESSABLE	GAMEWELL FCI	MS-7ASF	9		S2465	
X	STROBE, 2 WIRE, M-C, WHITE, CEILING	SYSTEM SENSOR	scw	5		S5512	3023572
BELOW	L-SERIES SPEAKER/STROBE, WHITE, CEILING	SYSTEM SENSOR	SPSCWL	57			
SP¢- WP	WALL SPEAKER STROBE RED OUTDOOR	SYSTEM SENSOR	SPSRK	1		S4048	
4.7K Ω <sup>ΕΟL</sup>	EOL-4.7K	GAMEWELL FCI	EOL-4.7	10			

### **CONTRACTOR INFORMATION**

SERVICE	CONTRACTOR	CONTRACT INFORMATION
INSTALLER	NW FIRE SYSTEMS	(206)772-7502
MONITORING	N/A	N/A
TESTING	NW FIRE SYSTEMS	(206)772-7502
RUNNER	NW FIRE SYSTEMS	(206)772-7502
MAINTENANCE	NW FIRE SYSTEMS	(206)772-7502
	I	

DRAWING DIRECTORY	
SHEET TITLE:	
COVER SHEET, AND GENERAL INFORMATION	
ROUND ONE - NORTH SIDE FIRE ALARM PLAN	
ROUND ONE - SOUTH SIDE FIRE ALARM PLAN	
ROUND ONE - CALCULATIONS	
ROUND ONE - RISER DIAGRAM	
-	SHEET TITLE: COVER SHEET, AND GENERAL INFORMATION ROUND ONE - NORTH SIDE FIRE ALARM PLAN ROUND ONE - SOUTH SIDE FIRE ALARM PLAN ROUND ONE - CALCULATIONS

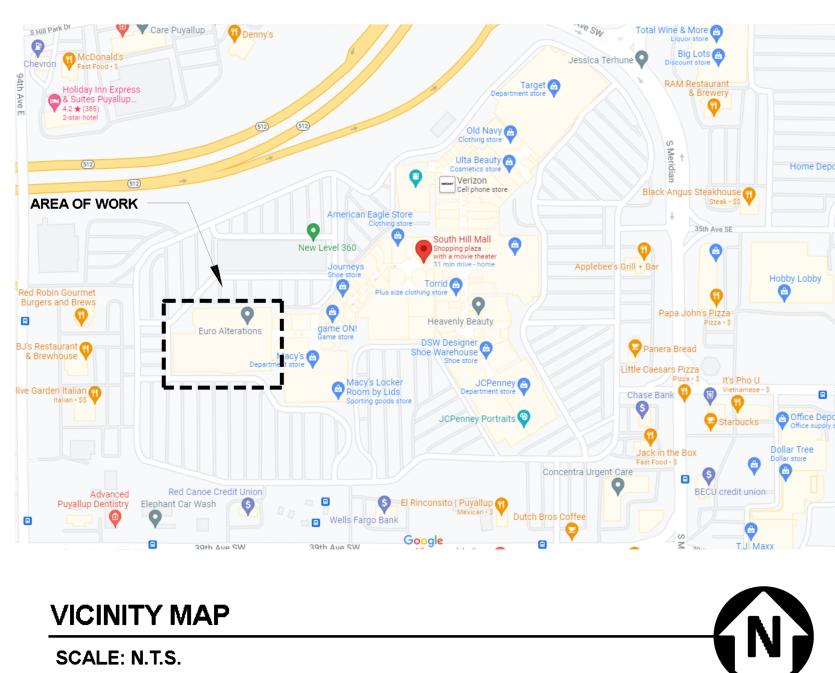








SHI	PRO		MIP		l	CONTRACT NAME: BOI IND ONE T I BUILD OLIT	ВΥ	DATE	REVISION DESCRIPTION	
ET TI	DJECI	Michae NiCET Technie Expires	ROVE (E RE( ET ST	IGNEI PHI LE	PHI LE	3500 S MERIDIAN ST, UNIT 900	P. LE 03	03/08/22 ISSUEI	ISSUED FOR REVIEW	Saving lives and Protecting Property
		Level cian ID	GAN			PUYALLUP WA 98373				
R PAG	<b>BER:</b> 970L	111 Fire			DAT 0	CONTRACT WITH: PANAS ELECTRIC				22043 33KU AVE. 3., BLUG U "NEN I, WA 33032 PHONE: 206 772 7502 * FAX: 206 772 7504
E		e Alarm 27	E: )3/08/2	3/08/2	E: )3/08/2	P.O. BOX 6639 KENT. WA 98023				WWW.NWFIRESYSTEMS.COM
		r.	2	2	2	ON-SITE CONTACT: PM VITALIY PANAS 253-335-5647				LIC # NORTHFS875MJ

COVER PAGE FIRE ALARM PLAN


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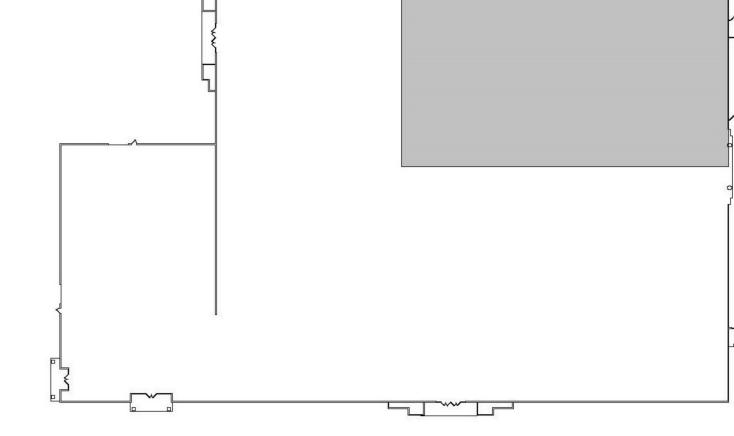
SHEET NUMBER:



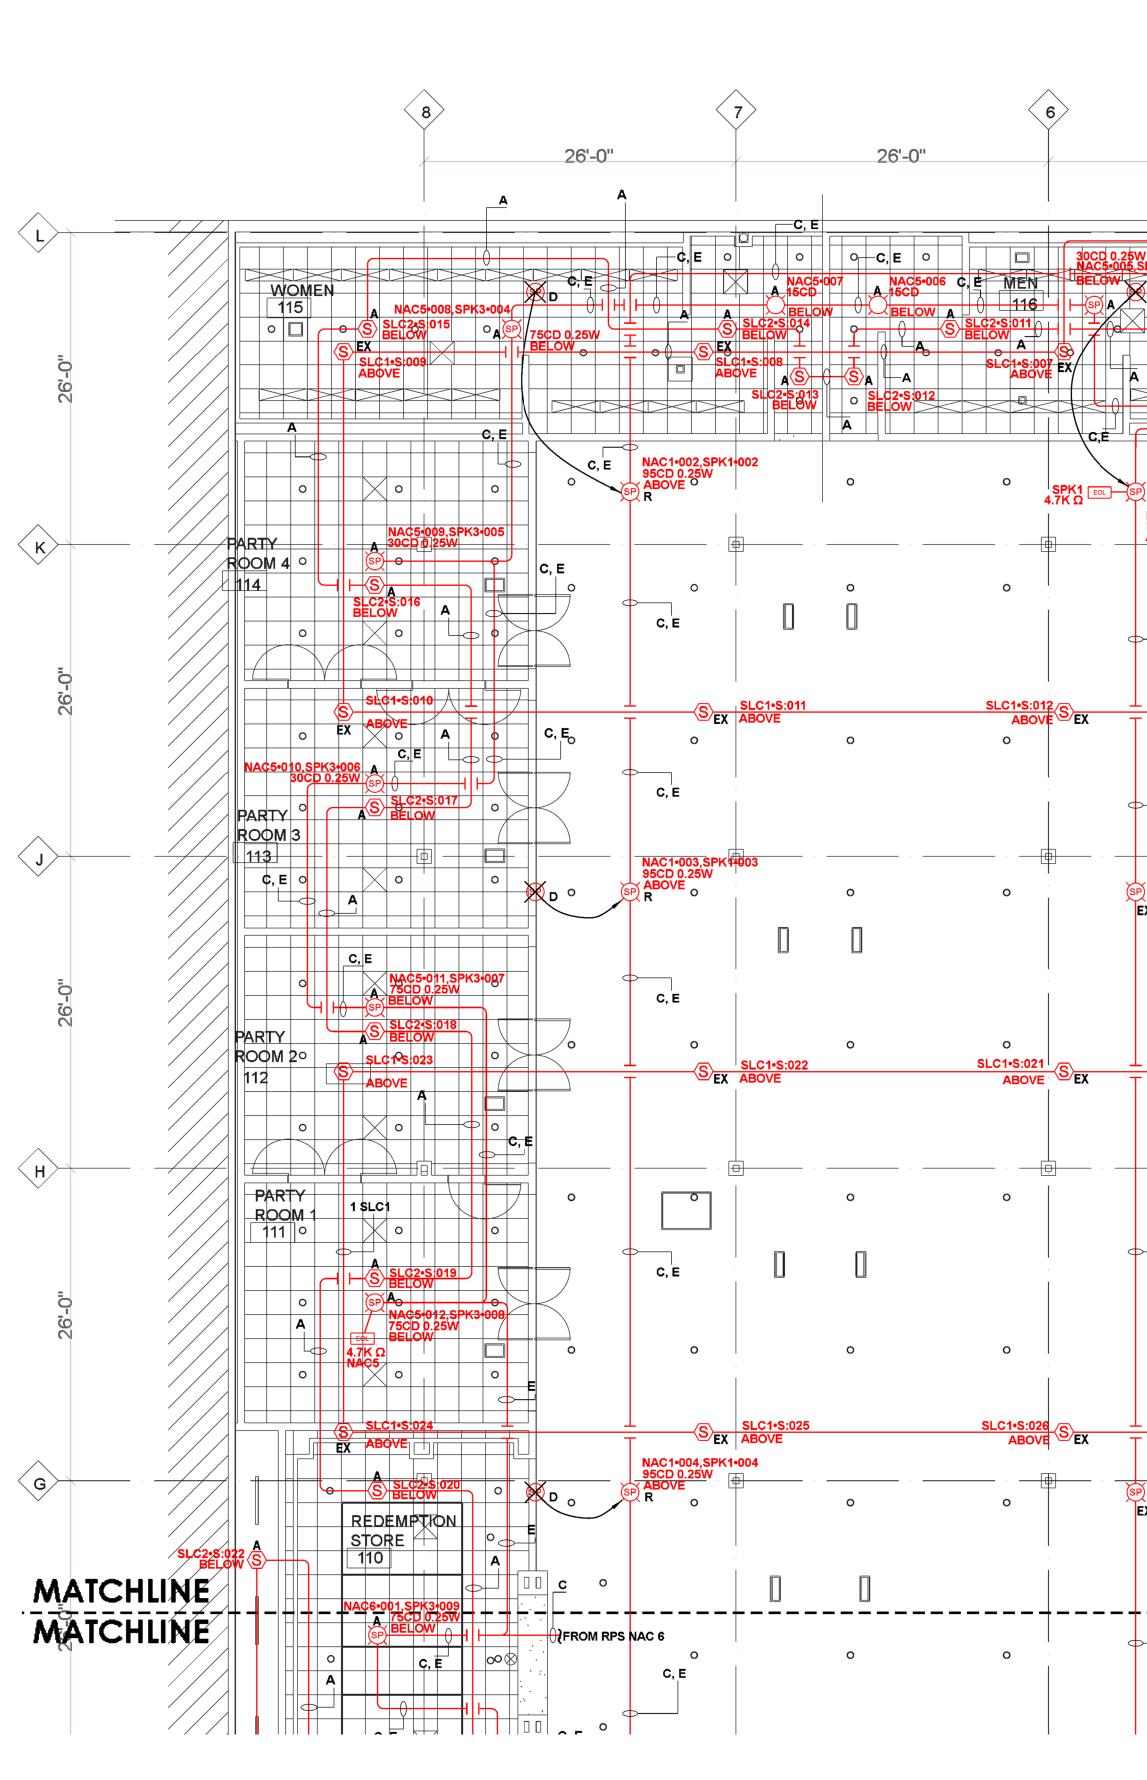

5	>	4	3		2
		SLC2	26'-0"	LOADING 26'-0'' AREA 125  c,e	,Е
	A A A A A A A A A A A A A A	LC1*S:001 NAC3*001 95CD 0.25W EX BELOW EX 3/SPK2 4 TO NAC 4 - 801 EX EX EX EX EX EX EX EX EX EX EX EX EX	F X X2+001 SLC1+S:002 ABOVE SLC2+S:001 ABOVE SLC1+S:005 SLC2+S:005 SLC2+S:004 SLC2+S:004 SLC2+S:004 SLC2+S:003 SLC2+S:004 SLC2+S:003 SLC2+S:003 SLC2+S:004 SLC2+S:003 SLC2+S:003 SLC2+S:003 SLC2+S:004 SLC2+S:003 SL	A NAC5-001 SPK3-001 SPK3 SPK3 BELOW A SIC2-S:002 BELOW SA FROM RPS NA S-003 SPK2-002 A D 0.25W SEX A SLC1-S:004 ELECTRICAL 124	C NAC4-00 95CD 0.23
NAC2-001,SPK1-017     15CD       95CD 0.25W     6       ABOVE     C,E       C,E     0       C, E     0	A FAMILY C,E TOILET 119 TOILET			о SPK2	
о о С, Е	SEX ABOVE	0 0	SLC1•S:014	S SLC1. S EX ABOVE	S:015 O C, E
NAC2•002,SPK1•016 95CD 0.25W EX ABOVE	ο	o (SP) NAC3-00 95CD 0. EX ABOVE	04,SPK2•003 25W	o	
0 0	O SLC1•S:020 EX ABOVE	0 0 SE)	o <u>SLC1•S:019</u> ( ABOVE	o S SLC1•S EX ABOVE	o 1:018
о С, Е	0	• • •	• • • • • • • • • • • • • • • • • • •	0	• •
o o .	GAME o ROOM 127 SLC1•S:027 EX ABOVE	о о о	O SLC1-S:028 ( ABOVE	O SEX ABOVE	C, E o
NAC2•003,SPK1•015 95CD 0.25W EX ABOVE O	o	o EX ABOVE		o	
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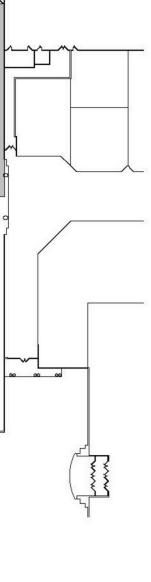


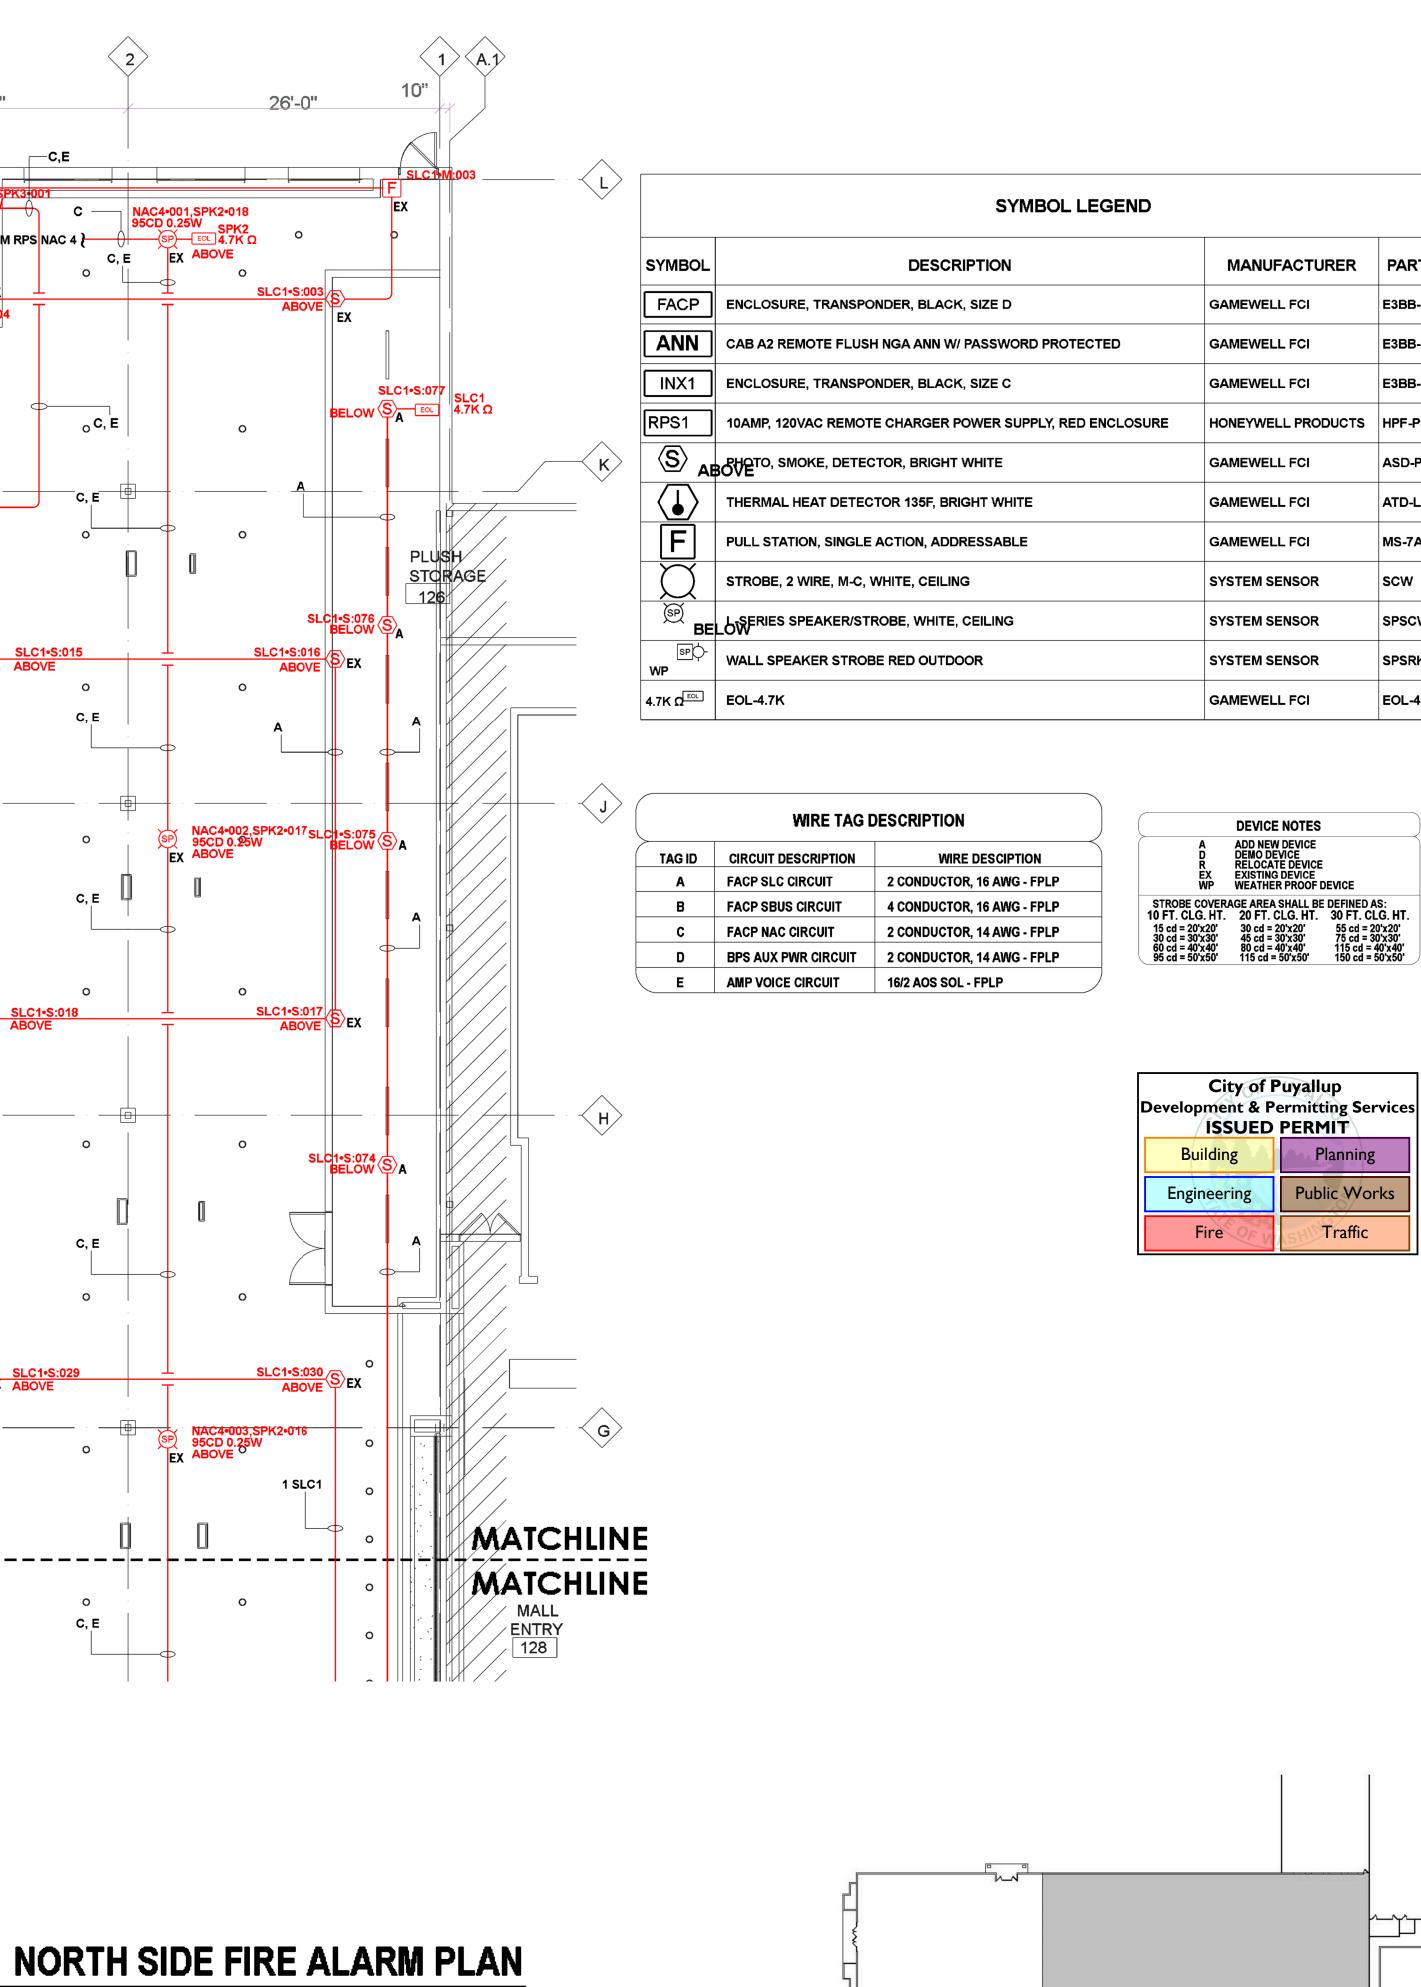



# **KEY PLAN**

SCALE: N.T.S.

PART NUMBER
E3BB-BD/INX
E3BB-NGA-FLUSH
E3BB-BC/INX
HPF-PS10
ASD-PL3
ATD-L3
MS-7ASF
scw
SPSCWL
SPSRK
EOL-4.7



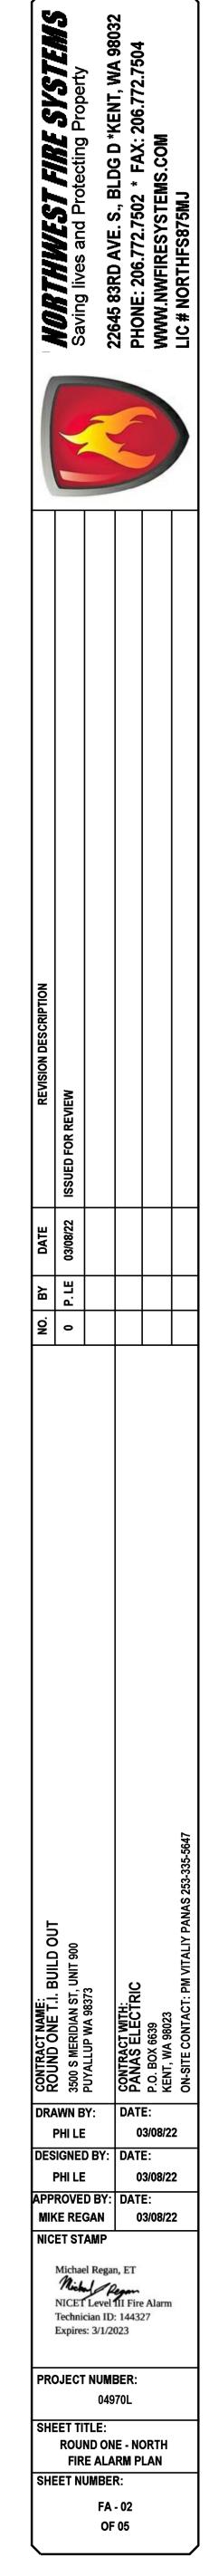


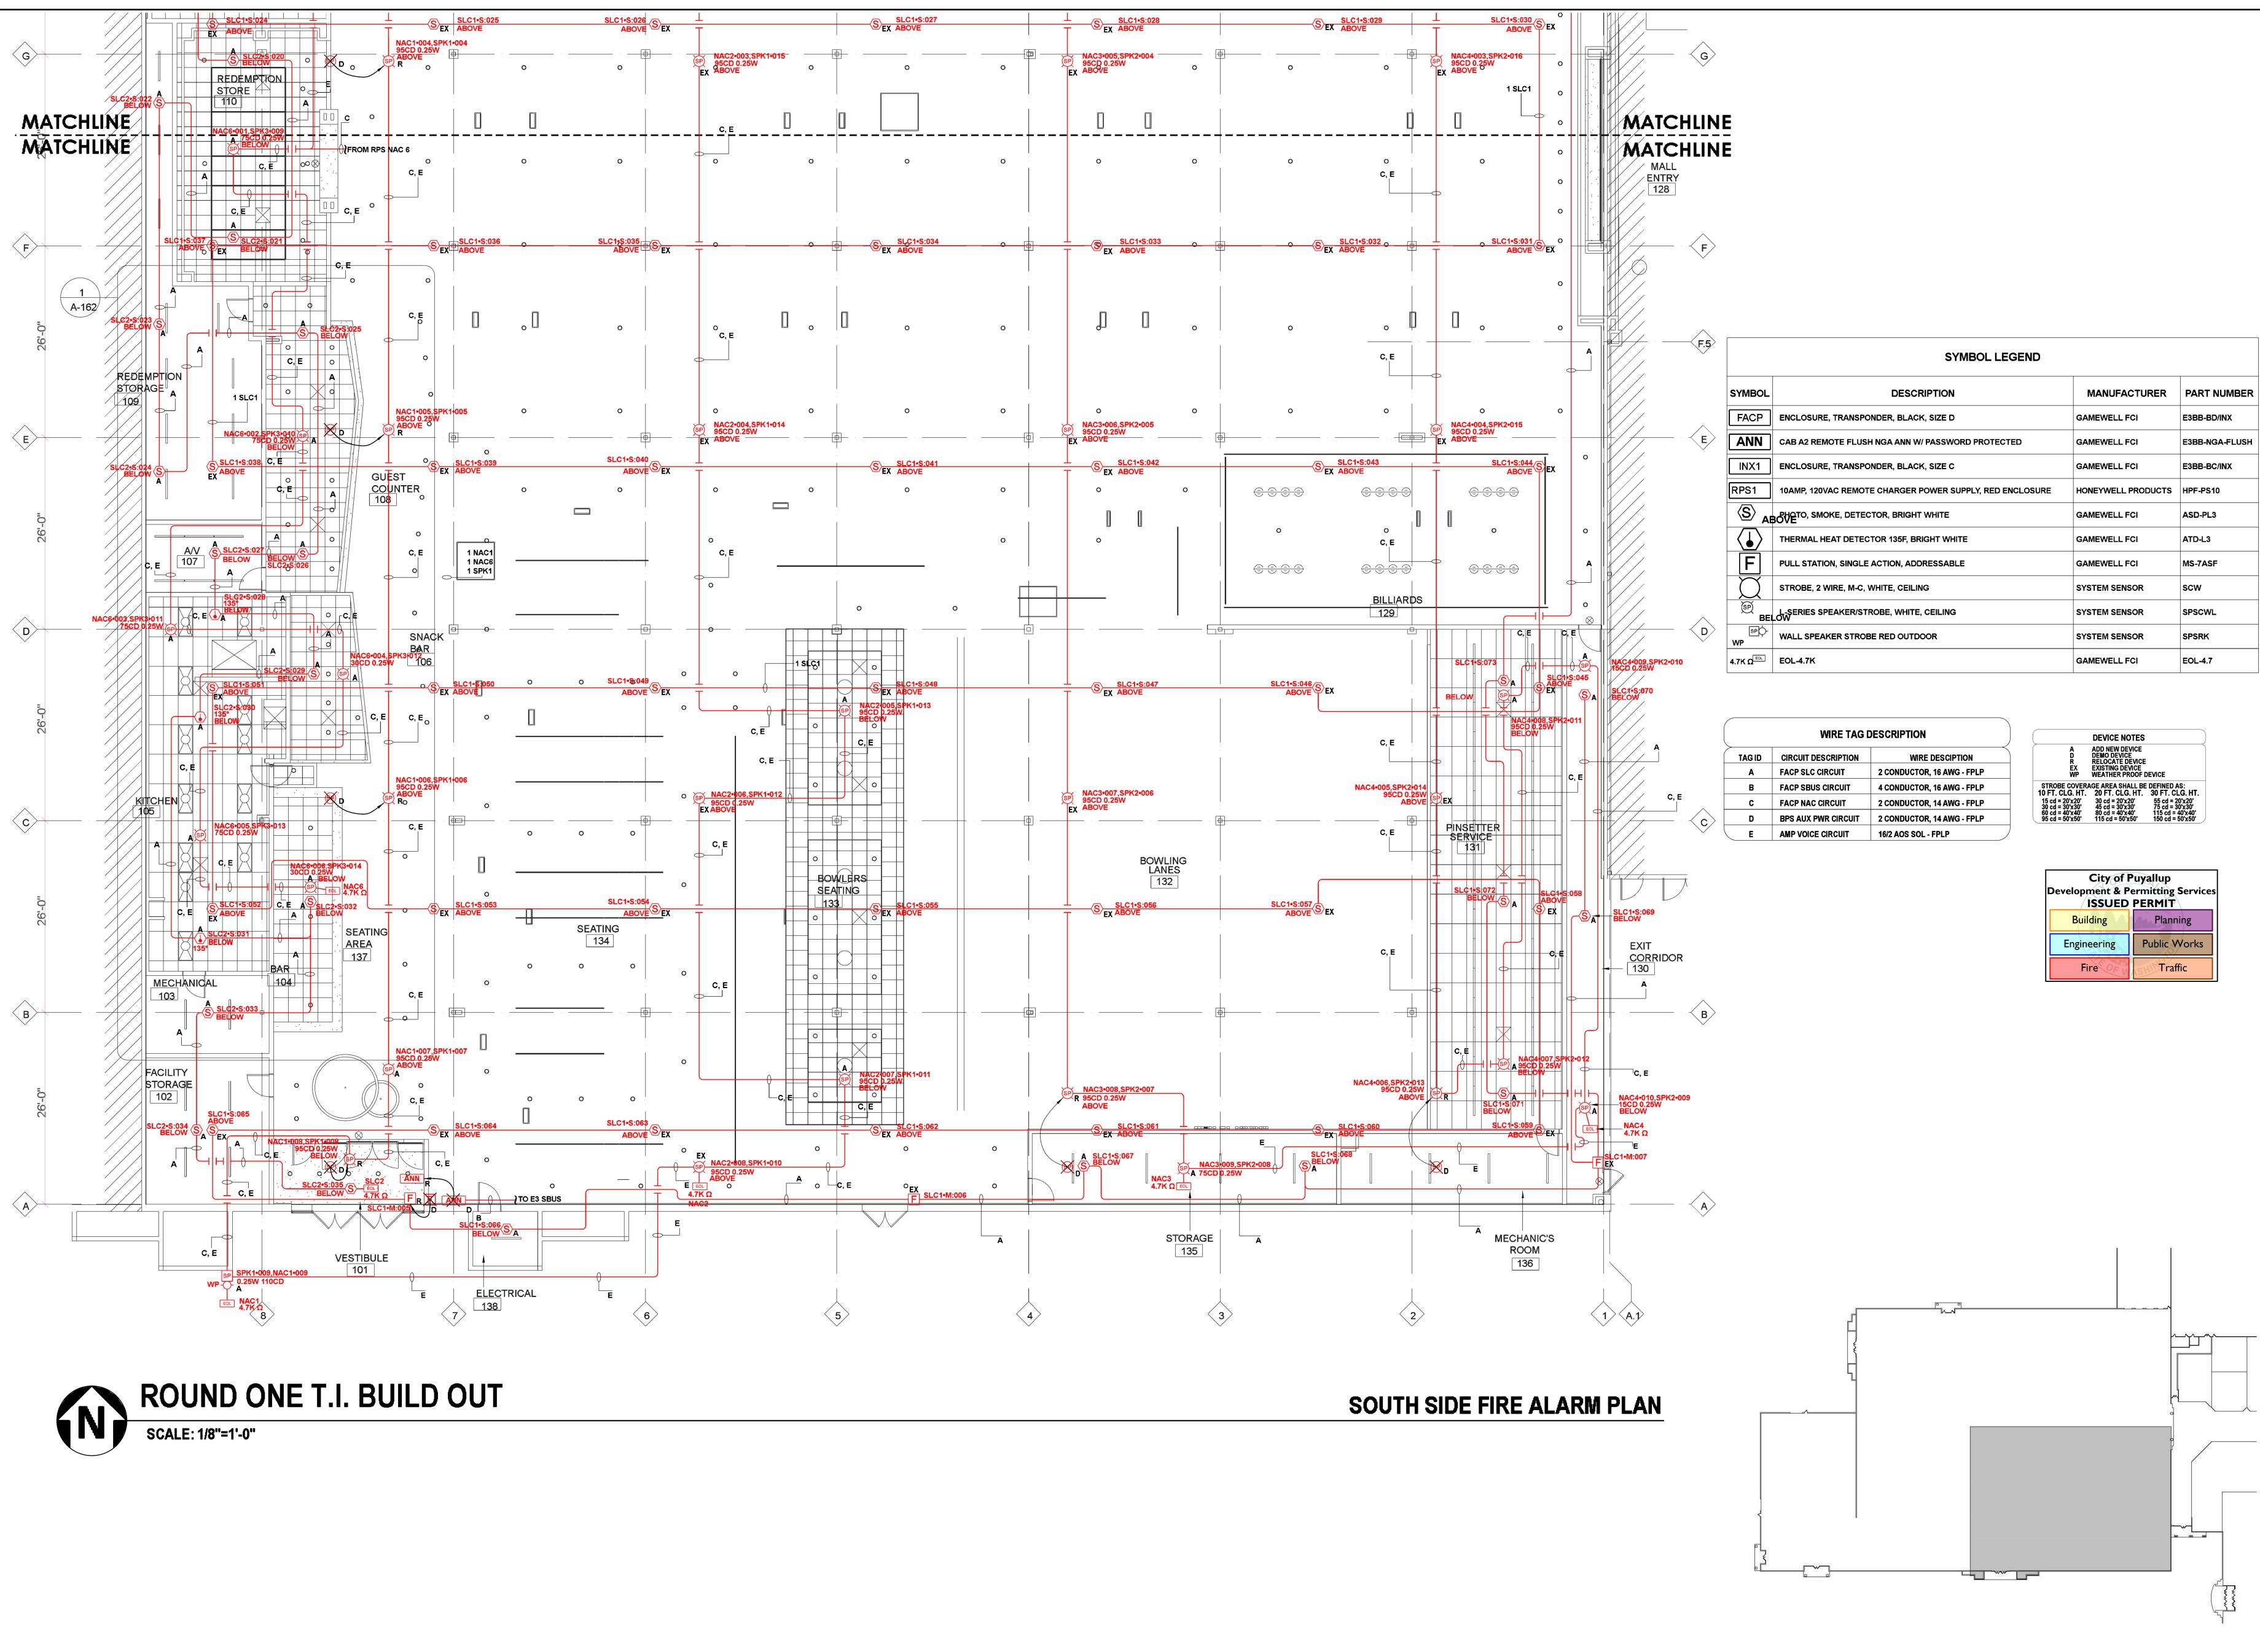

**KEY PLAN** 

SCALE: N.T.S.

PART NUMBER
E3BB-BD/INX
E3BB-NGA-FLUSH
E3BB-BC/INX
HPF-PS10
ASD-PL3
ATD-L3
MS-7ASF
scw
SPSCWL
SPSRK

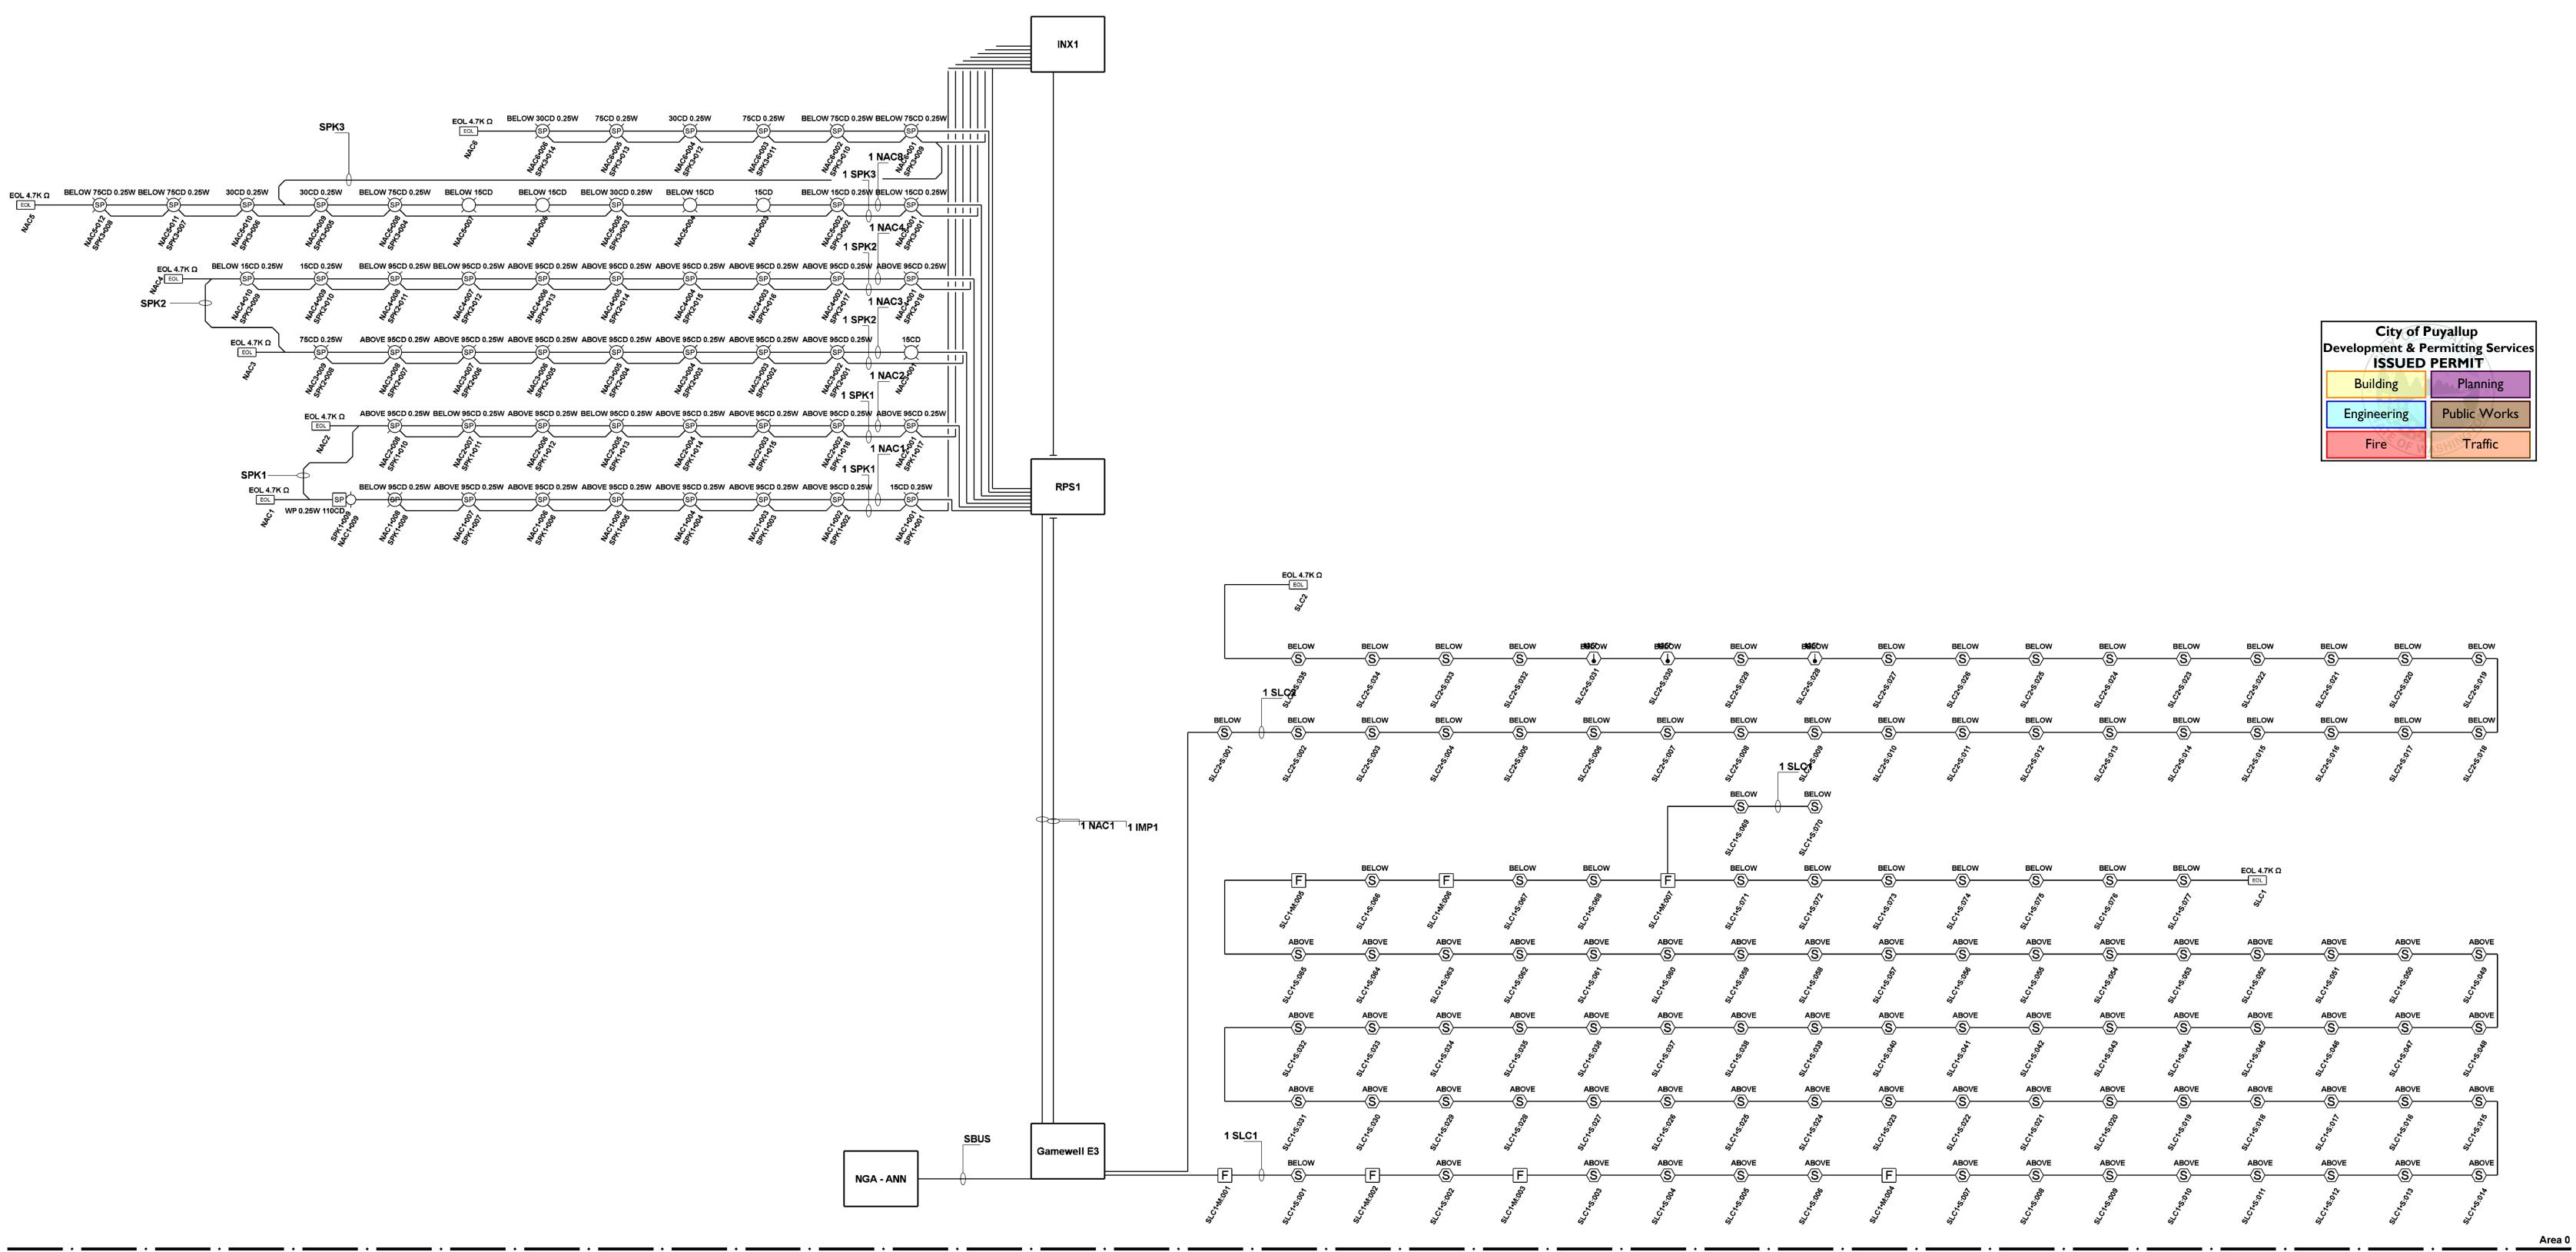

## **RISER DIAGRAM**

City of Puyallup Development & Permitting Service ISSUED PERMIT					
Planning					
Public Works					
Traffic					

INCENTICATION DESCRIPTION INCENTICATION DESCRIP	NORTHWEST FIRE SYSTEMS	Saving lives and Protecting Property	23646 8300 AVE C BI DC D *KENT WA 08033	PHONE: 206.772.7502 * FAX: 206.772.7504	WWW.NWFIRESYSTEMS.COM	LIC # NORTHFS875MJ
Image: Solution of the second seco		~				
Image: State in the state		SSUEU FOR REVIEW				
O       O       O         O       O       O	Y DATE					
DRAWN BY: DATE: PHI LE 03/08/22 DESIGNED BY: DATE: PHI LE 03/08/22 APPROVED BY: DATE: MIKE REGAN 03/08/22 NICET STAMP Michael Regan, ET Michael Regan, ET Mi	NO NO NO NO					
SHEET ITTLE: ROUND ONE - RISER DIAGRAM FIRE ALARM PLAN	DRAW PH DESIG PH APPRC MIKE NICET MI EX PROJI	N BY: I LE NED B I LE VED E REGA STAN CET Le chaician pires: 3 ECT N D ONE	BY: N IP tegar V/1/20 UME 049 E: E:	DATI 0 DATI 0 DATI 0 DATI 0 DATI 0 DATI 0 SER: 70L	E: 3/08/2 E: 3/08/2 E: 3/08/2 e Alarm 27 DIAGI	2 2 2

		PART NO:E3BB-BD/INX - ENCLOSURE, TRANSPONE	ER, BLACK, SIZE D			
PART NO.	QTY.	DESCRIPTION	STANDBY	TOTAL STANDBY	ALARM	TOTAL ALARM
		PANEL EQUIPMENT				
ILI-MB-E3	1	ILI - MAIN BOARD, (VELOCITI OR CLIP MODE)	162.0000MA	162.0000MA	300.000MA	300.0000N
PM-9	1	POWER SUPPLY MODULE - 9-AMP	50.000MA	50.000MA	50.000MA	50.0000N
LCD-E3	1	LCD KEYPAD DISPLAY	24.0000MA	24.0000MA	28.0000MA	28.0000
AM-50-70	1	INX 50 WATT, 70V, AMPLIFIER	49.0000MA	49.0000MA	2300.0000MA	2300.0000
			TOTAL PANEL STBY	285.0000MA	TOTAL PANEL ALARM	2678.0000N
		PERIPHERAL DEVICES				
ASD-PL3	109	PHOTO, SMOKE, DETECTOR, BRIGHT WHITE (SIGNALING LINE)	0.2000MA	21.8000MA	2.0000MA	218.0000
MS-7ASF	7	PULL STATION, SINGLE ACTION, ADDRESSABLE (SIGNALING LINE)	0.3000MA	2.1000MA	10.0000MA	70.0000N
EOL-4.7	2	EOL-4.7K (SIGNALING LINE)	0.0000MA	0.0000MA	0.0000MA	0.0000
ATD-L3	3	THERMAL HEAT DETECTOR 135F, BRIGHT WHITE (SIGNALING LINE)	0.2000MA	0.6000MA	2.0000MA	6.0000N
HPF-PS10	1	10AMP, 120VAC REMOTE CHARGER POWER SUPPLY, RED ENCLOSURE, HPF-PS10_MB (NOTIFICATION)	2.0000MA	2.0000MA	2.0000MA	2.0000N
HPF-PS10	1	10AMP, 120VAC REMOTE CHARGER POWER SUPPLY, RED ENCLOSURE (NOTIFICATION)	2.0000MA	2.0000MA	2.0000MA	2.0000N
			TOTAL PERIPHERAL STBY	28.5000MA	TOTAL PERIPH ALARM	298.0000M
			TOTAL STANDBY AMPS	313.5000MA	TOTAL ALARM AMPS	2976.0000N

COMPENSATION FACTORS - STANDBY: 1.2 ALARM: 1.2 REQUIREMENT WITH COMPENSATION:

### 

		PART NO:HPF-PS10 - 10AMP, 120VAC REMOT	E CHARGER POWER SUPPLY, F	RED ENCLOSURE		
PART NO.	QTY.	DESCRIPTION	STANDBY	TOTAL STANDBY	ALARM	TOTAL ALARM
		PANEL EQUIPMENT				
IPF-PS10_MB	1	MAINBOARD FOR THE HPF-PS10	65.0000MA	65.0000MA	145.0000MA	145.0000MA
			TOTAL PANEL STBY	65.0000MA	TOTAL PANEL ALARM	145.0000MA
		PERIPHERAL DEVICES				
SPSRK	1	WALL SPEAKER STROBE RED OUTDOOR (NOTIFICATION) 110CD	0.0000MA	0.0000MA	202.0000MA	202.0000MA
SPSCWL	30	L-SERIES SPEAKER/STROBE, WHITE, CEILING (NOTIFICATION) 95CD	0.0000MA	0.0000MA	134.0000MA	4020.0000MA
SPSCWL	5	L-SERIES SPEAKER/STROBE, WHITE, CEILING (NOTIFICATION) 15CD	0.0000MA	0.0000MA	41.0000MA	205.0000MA
EOL-4.7	6	EOL-4.7K (NOTIFICATION)	0.0000MA	0.0000MA	0.0000MA	0.0000MA
scw	5	STROBE, 2 WIRE, M-C, WHITE, CEILING (NOTIFICATION) 15CD	0.0000MA	0.0000MA	120.0000MA	600.0000MA
SPSCWL	8	L-SERIES SPEAKER/STROBE, WHITE, CEILING (NOTIFICATION) 75CD	0.0000MA	0.0000MA	111.0000MA	888.0000MA
SPSCWL	5	L-SERIES SPEAKER/STROBE, WHITE, CEILING (NOTIFICATION) 30CD	0.0000MA	0.0000MA	63.0000MA	315.0000MA
			TOTAL PERIPHERAL STBY	0.0000MA	TOTAL PERIPH ALARM	6230.0000MA
			TOTAL STANDBY AMPS	65.0000MA	TOTAL ALARM AMPS	6375.0000MA
					STANDBY TIME: 24	
					ALARM TIME: 15	
					BATTERY REQUIREME	INT: 3.154AH
		COMPENSATION	FACTORS - STANDBY: 1.2 AL	ARM: 1.2 REQUIREN	MENT WITH COMPENSATI	ON: 3.785AH

BATTERY CALCULATIONS FOR ROUND ONE T.I. PANEL: INX1								
	PART NO:E3BB-BC/INX - ENCLOSURE, TRANSPONDER, BLACK, SIZE C							
PART NO.	QTY.	DESCRIPTION	STANDBY	TOTAL STANDBY	ALARM	TOTAL ALARM		
		PANEL EQUIPMENT						
PM-9	1	POWER SUPPLY MODULE - 9-AMP	50.0000MA	50.0000MA	50.0000MA	50.0000MA		
AM-50-70	2	INX 50 WATT, 70V, AMPLIFIER	49.0000MA	98.0000MA	2300.0000MA	4600.0000MA		
			TOTAL PANEL STBY	148.0000MA	TOTAL PANEL ALARM	4650.0000MA		
		PERIPHERAL DEVICES						
E3BB-BD/INX	1	ENCLOSURE, TRANSPONDER, BLACK, SIZE D (POWER)	0.0000MA	0.0000MA	0.0000MA	0.0000MA		
EOL-4.7	2	EOL-4.7K (NOTIFICATION)	0.0000MA	0.0000MA	0.0000MA	0.0000MA		
SPSRK	1	WALL SPEAKER STROBE RED OUTDOOR (NOTIFICATION) 80DB 0.25 WATTS	0.0000MA	0.0000MA	0.0000MA	0.0000MA		
SPSCWL	48	L-SERIES SPEAKER/STROBE, WHITE, CEILING (NOTIFICATION) 77DB 0.25 WATTS	0.0000MA	0.0000MA	0.0000MA	0.0000MA		
			TOTAL PERIPHERAL STBY	0.0000MA	TOTAL PERIPH ALARM	0.0000MA		
			TOTAL STANDBY AMPS	148.0000MA	TOTAL ALARM AMPS	4650.0000MA		
					STANDBY TIME: 24 H	HRS 3.552AH		
					ALARM TIME: 15	MIN 1.163AH		
					BATTERY REQUIREME	ENT: 4.715AH		
	COMPENSATION FACTORS - STANDBY: 1.2 ALARM: 1.2 REQUIREMENT WITH COMPENSATION: 5.6							

# **BATTERY CALCS**

		CIRCUIT CALCULATIONS PANEL: RI	PS1 CARD	: 20 CIRCI	JIT:NAC1	
		CIRCUIT NAME: NA	C1			
		CIRCUIT TYPE: NOTIFICATION TERMINAL VOLTA	GE: 20.2V:DC	AMPERAGE:	2.0000A	
		CABLE: 14/2 SOL JKT FPLR 1N	1 RL RED #14	ļ		
		CALCULATIONS BASED ON RUNNIN	IG TOTAL LEN	GTH.		
		DESIGN CRITERIA: AMBIENT TEMPERATURE: 167°F	AX. OPERATIN	IG VOLTAGE D	ROP: 18%	
DEVICE	PART NO	APPLIANCE DESC	DISTANCE	CURRENT	VOLTAGE	VOLTAGE DROP
	HPF-PS10	PANEL			20.2V	
001	SPSCWL	L-SERIES SPEAKER/STROBE, WHITE, CEILING, 15CD	14'-0	41.0000MA	20.0985V	(0.1015V)
002	SPSCWL	L-SERIES SPEAKER/STROBE, WHITE, CEILING, 95CD	83'-0	134.0000MA	19.5175V	(0.581V)
003	SPSCWL	L-SERIES SPEAKER/STROBE, WHITE, CEILING, 95CD	33'-0	134.0000MA	19.3137V	(0.2038V)
004	SPSCWL	L-SERIES SPEAKER/STROBE, WHITE, CEILING, 95CD	49'-0	134.0000MA	19.0513V	(0.2623V)
005	SPSCWL	L-SERIES SPEAKER/STROBE, WHITE, CEILING, 95CD	49'-0	134.0000MA	18.8293V	(0.222V)
006	SPSCWL	L-SERIES SPEAKER/STROBE, WHITE, CEILING, 95CD	49'-0	134.0000MA	18.6476V	(0.1817V)
007	SPSCWL	L-SERIES SPEAKER/STROBE, WHITE, CEILING, 95CD	36'-0	134.0000MA	18.5437V	(0.1039V)
008	SPSCWL	L-SERIES SPEAKER/STROBE, WHITE, CEILING, 95CD	17'-0	134.0000MA	18.5086V	(0.0351V)
009	SPSRK	WALL SPEAKER STROBE RED OUTDOOR, 110CD	38'-0	202.0000MA	18.4615V	(0.0471V)
	EOL-4.7	EOL-4.7K	2'-0	0.0000MA	18.4615V	(0V)
			370'-0	1181.0000MA		
					TOTAL CU	RRENT: 1181.0000MA
		(ТО	TAL VDROP PE	RCENT:8.61%)	TOTAL VOLT	AGE DROP : 1.7385V

		CIRCUIT CALCULATIONS PANE	L: RPS1 CA	RD:	20 CIRCL	JIT:NAC2	
			ME: NAC2				
		CIRCUIT TYPE: NOTIFICATION TERMINAL \	/OLTAGE: 20.2V:	DC	AMPERAGE:	2.0000A	
		CABLE: 14/2 SOL JKT FF	PLR 1M RL RED	#14			
		CALCULATIONS BASED ON F	RUNNING TOTAL	LENG	STH.		
		DESIGN CRITERIA: AMBIENT TEMPERATURE: 16	7°F MAX. OPER	ATING	g voltage df	ROP: 18%	
DEVICE	PART NO	APPLIANCE DESC	DISTAN	CE	CURRENT	VOLTAGE	VOLTAGE DRO
	HPF-PS10	PANEL				20.2V	
001	SPSCWL	L-SERIES SPEAKER/STROBE, WHITE, CEILING, 950	CD 4	7'-0	134.0000MA	19.8906V	(0.3094)
002	SPSCWL	L-SERIES SPEAKER/STROBE, WHITE, CEILING, 950	D 3	3'-0	134.0000MA	19.7006V	(0.1901)
003	SPSCWL	L-SERIES SPEAKER/STROBE, WHITE, CEILING, 950	D 4	9'-0	134.0000MA	19.4587V	(0.2419)
004	SPSCWL	L-SERIES SPEAKER/STROBE, WHITE, CEILING, 950	D 4	9'-0	134.0000MA	19.2571V	(0.2016)
005	SPSCWL	L-SERIES SPEAKER/STROBE, WHITE, CEILING, 950	D 5	57'-0	134.0000MA	19.0695V	(0.1876)
006	SPSCWL	L-SERIES SPEAKER/STROBE, WHITE, CEILING, 950	D 3	1'-0	134.0000MA	18.993V	(0.0765)
007	SPSCWL	L-SERIES SPEAKER/STROBE, WHITE, CEILING, 950	D 5	57'-0	134.0000MA	18.8992V	(0.0938)
008	SPSCWL	L-SERIES SPEAKER/STROBE, WHITE, CEILING, 950	D 3	1'-0	134.0000MA	18.8737V	(0.0255)
	EOL-4.7	EOL-4.7K		3'-0	0.0000MA	18.8737V	(0)
			35	57'-0	1072.0000MA		

(TOTAL VDROP PERCENT:6.57%) TOTAL VOLTAGE DROP : 1.3263V

CIRCUIT CALCULATIONS	PANEL: RPS1 CARD: 20 CIR	CUIT:NAC3
	CIRCUIT NAME: NAC3	

	CIRCUIT NAME: NAC3					
		CIRCUIT TYPE: NOTIFICATION TERMINAL VOLTA	GE: 20.2V:DC	AMPERAGE:	2.0000A	
		CABLE: 14/2 SOL JKT FPLR 1	/I RL RED #14	,		
		CALCULATIONS BASED ON RUNNI	NG TOTAL LEN	GTH.		
		DESIGN CRITERIA: AMBIENT TEMPERATURE: 167°F	AX. OPERATIN	IG VOLTAGE D	ROP: 18%	
DEVICE	PART NO	APPLIANCE DESC	DISTANCE	CURRENT	VOLTAGE	
	HPF-PS10	PANEL			20.2V	
001	SCW	STROBE, 2 WIRE, M-C, WHITE, CEILING, 15CD	14'-0	120.0000MA	20.0995V	
002	SPSCWL	L-SERIES SPEAKER/STROBE, WHITE, CEILING, 95CD	10'-0	134.0000MA	20.0351V	
003	SPSCWL	L-SERIES SPEAKER/STROBE, WHITE, CEILING, 95CD	22'-0	134.0000MA	19.9115V	
004	SPSCWL	L-SERIES SPEAKER/STROBE, WHITE, CEILING, 95CD	65'-0	134.0000MA	19.5998V	
005	SPSCWL	L-SERIES SPEAKER/STROBE, WHITE, CEILING, 95CD	49'-0	134.0000MA	19.4052V	
006	SPSCWL	L-SERIES SPEAKER/STROBE, WHITE, CEILING, 95CD	49'-0	134.0000MA	19.2508V	
007	SPSCWL	L-SERIES SPEAKER/STROBE, WHITE, CEILING, 95CD	49'-0	134.0000MA	19.1368V	
008	SPSCWL	L-SERIES SPEAKER/STROBE, WHITE, CEILING, 95CD	39'-0	134.0000MA	19.0781V	
009	SPSCWL	L-SERIES SPEAKER/STROBE, WHITE, CEILING, 75CD	26'-0	111.0000MA	19.0604V	
	EOL-4.7	EOL-4.7K	2'-0	0.0000MA	19.0604V	
			325'-0	1169.0000MA		

TOTAL CURRENT: 1169.0000MA (TOTAL VDROP PERCENT: 5.64%) TOTAL VOLTAGE DROP : 1.1396V

		CIRCUIT CALCULATIONS	PANEL: RF	S1 CARD	: 20 CIRCI	JIT:NAC4	
	CIRCUIT NAME: NAC4						
		CIRCUIT TYPE: NOTIFICATION	TERMINAL VOLTAG	GE: 20.2V:DC	AMPERAGE:	2.0000A	
		CABLE: 14	/2 SOL JKT FPLR 1M	RL RED #14			
		CALCULATION	S BASED ON RUNNIN	G TOTAL LEN	GTH.		
		DESIGN CRITERIA: AMBIENT TEMP	PERATURE: 167°F M	AX. OPERATIN	G VOLTAGE D	ROP: 18%	
DEVICE	PART NO	APPLIANCE DES	c	DISTANCE	CURRENT	VOLTAGE	VOLTAGE DRO
	HPF-PS10	PANEL				20.2V	
001	SPSCWL	L-SERIES SPEAKER/STROBE, WHITE	, CEILING, 95CD	127'-0	134.0000MA	19.3001V	(0.8999)
002	SPSCWL	L-SERIES SPEAKER/STROBE, WHITE	, CEILING, 95CD	49'-0	134.0000MA	18.9933V	(0.3069)
003	SPSCWL	L-SERIES SPEAKER/STROBE, WHITE	, CEILING, 95CD	49'-0	134.0000MA	18.7267V	(0.2666)
004	SPSCWL	L-SERIES SPEAKER/STROBE, WHITE	, CEILING, 95CD	49'-0	134.0000MA	18.5004V	(0.2262)
005	SPSCWL	L-SERIES SPEAKER/STROBE, WHITE	, CEILING, 95CD	49'-0	134.0000MA	18.3145V	(0.1859)
006	SPSCWL	L-SERIES SPEAKER/STROBE, WHITE	, CEILING, 95CD	39'-0	134.0000MA	18.1986V	(0.1159)
007	SPSCWL	L-SERIES SPEAKER/STROBE, WHITE	, CEILING, 95CD	13'-0	134.0000MA	18.1707V	(0.0279)
008	SPSCWL	L-SERIES SPEAKER/STROBE, WHITE	, CEILING, 95CD	54'-0	134.0000MA	18.0991V	(0.0716)
009	SPSCWL	L-SERIES SPEAKER/STROBE, WHITE	, CEILING, 15CD	15'-0	41.0000MA	18.0915V	(0.0076)
010	SPSCWL	L-SERIES SPEAKER/STROBE, WHITE	, CEILING, 15CD	63'-0	41.0000MA	18.0757V	(0.0159)
	EOL-4.7	EOL-4.7K		3'-0	0.0000MA	18.0757V	(0)
				510'-0	1154.0000MA		
						TOTAL CU	RRENT: 1154.0000M
	(TOTAL VDROP PERCENT:10.52%) TOTAL VOLTAGE DROP : 2.1243V						

# **VOLTAGE DROPS**

STANDBY TIME: 24 HRS 7.524AH 0.744AH ALARM TIME: 15 MIN 8.268AH BATTERY REQUIREMENT: 9.922AH

		CIRCUIT CALCULATIONS PANE	L: RPS1 CARI	D: 20 CIRCI	JIT:NAC5	
		CIRCUIT NAI	ME: NAC5			
		CIRCUIT TYPE: NOTIFICATION TERMINAL	VOLTAGE: 20.2V:DC	AMPERAGE:	2.0000A	
		CABLE: 14/2 SOL JKT FI	PLR 1M RL RED #1	4		
		CALCULATIONS BASED ON F	RUNNING TOTAL LEI	igth.		
	1	DESIGN CRITERIA: AMBIENT TEMPERATURE: 16	7°F MAX. OPERATI	NG VOLTAGE D	ROP: 18%	
DEVICE	PART NO	APPLIANCE DESC	DISTANCE	CURRENT	VOLTAGE	VOLTAGE DROP
	HPF-PS10	PANEL			20.2V	
001	SPSCWL	L-SERIES SPEAKER/STROBE, WHITE, CEILING, 150	CD 62'-0	41.0000MA	19.7873V	(0.4127∨)
002	SPSCWL	L-SERIES SPEAKER/STROBE, WHITE, CEILING, 150	CD 97'-0	41.0000MA	19.1662V	(0.6212V)
003	s scw	STROBE, 2 WIRE, M-C, WHITE, CEILING, 15CD	20'-0	120.0000MA	19.0431V	(0.123V)
004	scw	STROBE, 2 WIRE, M-C, WHITE, CEILING, 15CD	18'-0	120.0000MA	18.9456V	(0.0975∨)
005	SPSCWL	L-SERIES SPEAKER/STROBE, WHITE, CEILING, 300	CD 26'-0	63.0000MA	18.824V	(0.1216V)
006	s scw	STROBE, 2 WIRE, M-C, WHITE, CEILING, 15CD	18'-0	120.0000MA	18.7467V	(0.0773V)
007	scw	STROBE, 2 WIRE, M-C, WHITE, CEILING, 15CD	9'-0	120.0000MA	18.7147V	(0.032V)
900	SPSCWL	L-SERIES SPEAKER/STROBE, WHITE, CEILING, 750	CD 24'-0	111.0000MA	18.6471V	(0.0676V)
009	SPSCWL	L-SERIES SPEAKER/STROBE, WHITE, CEILING, 300	CD 31'-0	63.0000MA	18.5809V	(0.0662V)
010	SPSCWL	L-SERIES SPEAKER/STROBE, WHITE, CEILING, 300	CD 37'-0	63.0000MA	18.5161V	(0.0647∨)
011	SPSCWL	L-SERIES SPEAKER/STROBE, WHITE, CEILING, 750	CD 29'-0	111.0000MA	18.4766V	(0.0395V)
012	SPSCWL	L-SERIES SPEAKER/STROBE, WHITE, CEILING, 750	CD 43'-0	111.0000MA	18.4473V	(0.0293V)
	EOL-4.7	EOL-4.7K	3'-0	0.0000MA	18.4473V	(0V)
			417'-0	1084.0000MA		

TOTAL CURRENT: 1084.0000MA (TOTAL VDROP PERCENT:8.68%) TOTAL VOLTAGE DROP : 1.7527V

		CIRCUIT CALCULATIONS	PANEL: RF	S1 CARD	20 CIRC	UIT:NAC6	
			CIRCUIT NAME: NA	C6			
		CIRCUIT TYPE: NOTIFICATION	TERMINAL VOLTAG	GE: 20.2∨:DC	AMPERAGE	2.0000A	
		CABLE: 1	4/2 SOL JKT FPLR 1M	RL RED #14			
		CALCULATION	NS BASED ON RUNNIN	G TOTAL LENG	STH.		
		DESIGN CRITERIA: AMBIENT TEM	PERATURE: 167°F M	AX. OPERATIN	G VOLTAGE D	ROP: 18%	
DEVICE	PART NO	APPLIANCE DE	SC	DISTANCE	CURRENT	VOLTAGE	VOLTAGE DROP
	HPF-PS10	PANEL				20.2V	
001	SPSCWL	L-SERIES SPEAKER/STROBE, WHIT	E, CEILING, 75CD	152'-0	111.0000MA	19.668V	(0.532V
002	SPSCWL	L-SERIES SPEAKER/STROBE, WHIT	E, CEILING, 75CD	56'-0	111.0000MA	19.5102V	(0.1578V
003	SPSCWL	L-SERIES SPEAKER/STROBE, WHIT	E, CEILING, 75CD	44'-0	111.0000MA	19.4162V	(0.094V
004	SPSCWL	L-SERIES SPEAKER/STROBE, WHIT	E, CEILING, 30CD	29'-0	63.0000MA	19.374V	(0.0422V
005	SPSCWL	L-SERIES SPEAKER/STROBE, WHIT	E, CEILING, 75CD	41'-0	111.0000MA	19.3302V	(0.0438V
006	SPSCWL	L-SERIES SPEAKER/STROBE, WHIT	E, CEILING, 30CD	22'-0	63.0000MA	19.3217V	(0.0085V
	EOL-4.7	EOL-4.7K		3'-0	0.0000MA	19.3217V	(0V
				347'-0	570.0000MA		
						TOTAL CI	JRRENT: 570.0000MA
(TOTAL VDROP PERCENT:4.35%) TOTAL VOLTAGE DROP : 0.8783V							

City of Puyallup Development & Permitting Services ISSUED PERMIT			
Building	Planning		
Engineering	Public Works		
Fire OF W	Traffic		

LTAGE DROP	
(0.3094V)	

(0.000 11)
(0.1901V)
(0.2419V)
(0.2016V)
(0.1876V)
(0.0765V)
(0.0938V)
(0.0255V)
(0V)
PENT: 1072 0000MA

VOLTAGE DROP

(0.1005V)	
(0.0644V)	
(0.1236V)	
(0.3117V)	
(0.1947V)	
(0.1543V)	
(0.114V)	
(0.0587V)	
(0.0177V)	
(0V)	

OLTAGE DR	OP

(0.8999V)
(0.3069V)
(0.2666V)
(0.2262V)
(0.1859V)
(0.1159V)
(0.0279V)
(0.0716V)
(0.0076V)
(0.0159V)

<b>NORTHWEST FIRE SYSTEMS</b> Saving lives and Protecting Property         Saving lives and Protecting Property         22645 83RD AVE. S., BLDG D *KENT, WA 98032         PHONE: 206.772.7502 * FAX: 206.772.7504         WWW.NWFIRESYSTEMS.COM         LIC # NORTHFS875MJ					
NO. BY DATE REVISION DESCRIPTION	0 P. LE 11/18/21 ISSUED FOR REVIEW	1 P. LE 03/03/22 REV01 ISSUED FOR REVIEW			
I DES I APPI MIK NIC PRC SHE RO	WN B PHI LE IGNEI PHI LE ROVE (E REC ET ST Michae NICET Technic Expires	Y: DBY: DBY: GAN AMP el Regau Level cian ID s: 3/1/2 NUMI 049 TLE: DNE - C E ALA UMBE FA	DAT 1 DAT 1 DAT 1 III Fire 1443: 023 BER: 70L	E: 1/18/2 E: 1/18/2 E: 1/18/2 27	1