

	QTY	BOTANICAL NAME	COMMON NAME	SIZE & SPACING		
	TREES					
•	5	STYRAX JAPONICUS	JAPANESE SNOWBELL	2" CALIPER, SPACING PER PLAN		
	SHRUBS					
, , ,	16	AZALEA 'PURPLE GEM'	PURPLE GEM AZALEA	2 GALLON, 3' O.C. SPACING		
Ø	25	CALAMAGROSTIS 'KARL FOERSTER'	KARL FOERSTER FEATHER REED GRASS	3 GALLON, 3' O.C. SPACING		
÷	5	BERBERIS THUNBERGII 'ROSE GLOW'	ROSE GLOW JAPANESE BARBERRY	3 GALLON, 4' O.C. SPACING		
		GROUNDCOVER				
0	51	HEMEROCALLIS 'STELLA DE ORO'	STAR OF GOLD DAY LILY	1 GALLON, 24" O.C. SPACING		
I	40	ARCTOSTAPHYLOS UVA-URSI	KINNIKINNICK	1 GALLON, 3' O.C. SPACING		

1. CONTRACTOR IS RESPONSIBLE FOR PROVIDING PLANT QUANTITIES AS SHOWN ON DRAWINGS.

- 2. CONTRACTOR SHALL PROVIDE SOIL AMENDMENT AND TOPSOIL PLACEMENT PER CITY OF PUYALLUP DETAILS.
- 3. CONTRACTOR SHALL PROVIDE PRUNING OF REQUIRED TREES AND SHRUBS FOR THE PURPOSE OF MAINTAINING TREES OR SHRUBS IN A HEALTHY AND THRIVING CONDITION AND/OR TO ENHANCE ITS NATURAL GROWTH FORM. TREES AND SHRUBS SHALL NOT BE EXCESSIVELY PRUNED SUCH THAT IT ADVERSELY AFFECTS THE HEALTHY LIVING CONDITION OF THE PLANT, SIGNIFICANTLY DAMAGES THE NATURAL GROWTH OF THE PLANT, OR ELIMINATES OR SIGNIFICANTLY REDUCES THE PURPOSE FOR THE PLANTING. TOPPING, AN EXTREME FORM OF PRUNING OF TREES REQUIRED BY THIS SECTION IS PROHIBITED. THIS PROHIBITION DOES NOT APPLY TO PRUNING TO REMOVE A SAFETY HAZARD, TO REMOVE DEAD OR DISEASED MATERIAL, OR TO AVOID OVERHEAD POWER LINES. PROVIDE PRUNING AS PER THE LANDSCAPE MAINTENANCE PLAN.

PLANT IMAGES



JAPANESE SNOWBELL



PURPLE GEM AZALEA



STAR OF GOLD DAY LILY



FOERSTER'S FEATHER REED GRASS




KINNIKINNICK


ROSE GLOW JAPANESE BARBERRY





PURPLE ROCK ROSE

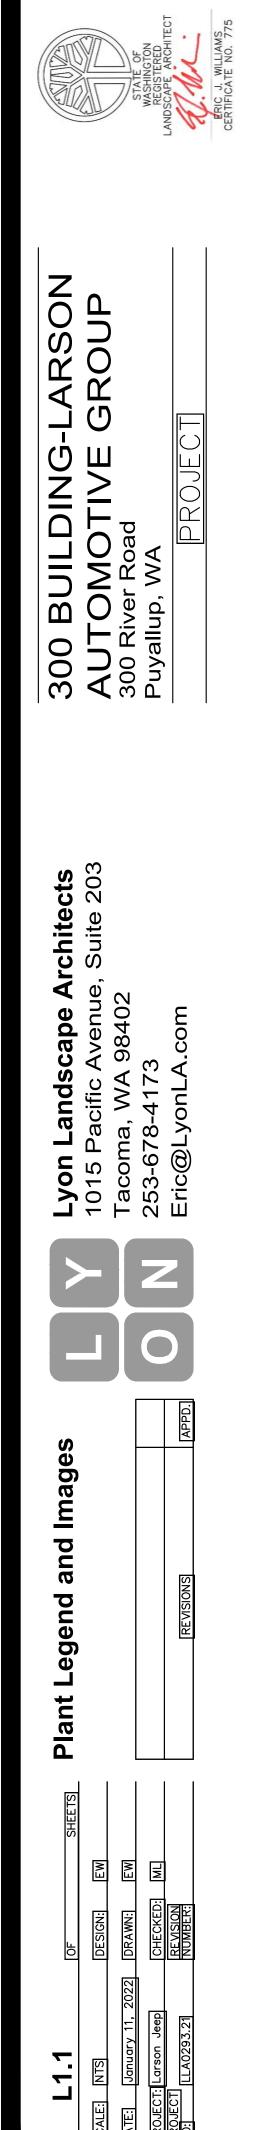

Set Final

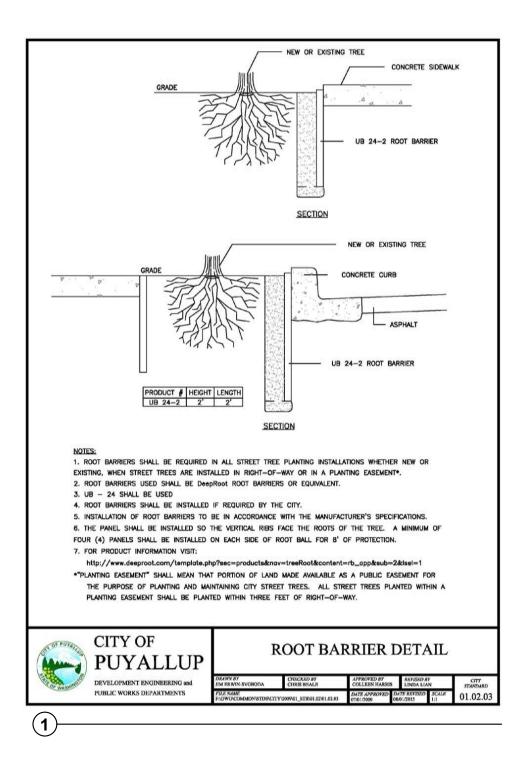

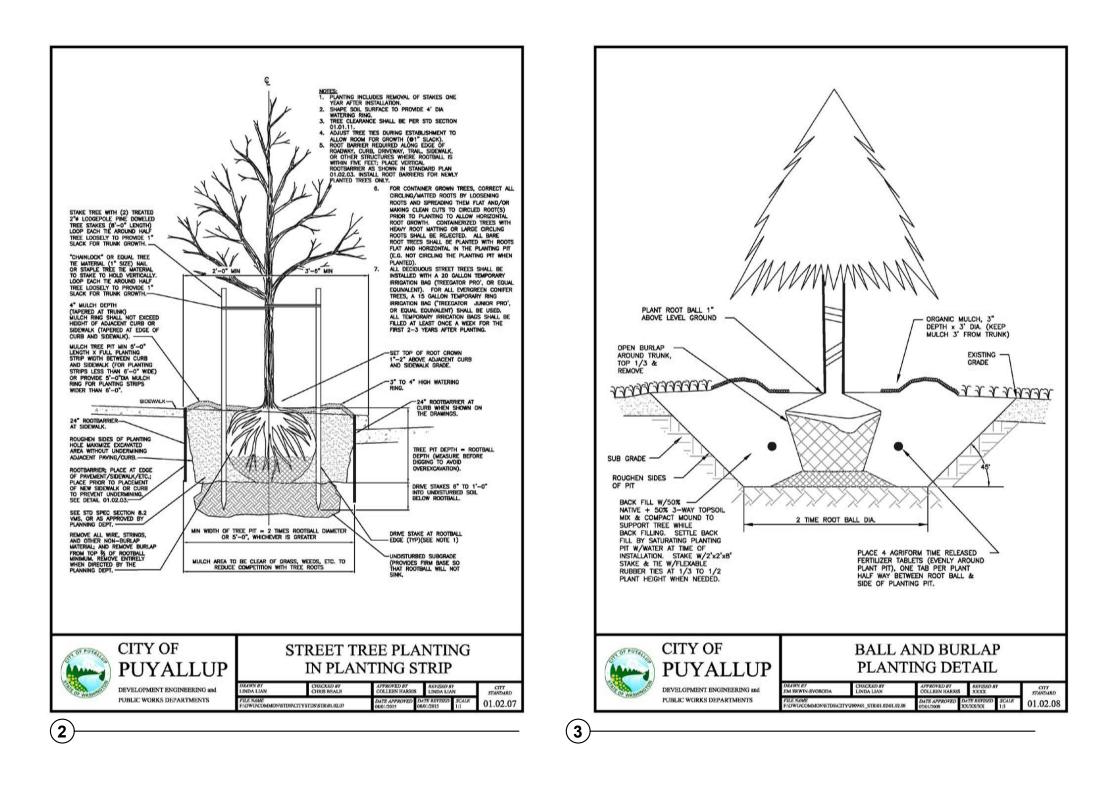


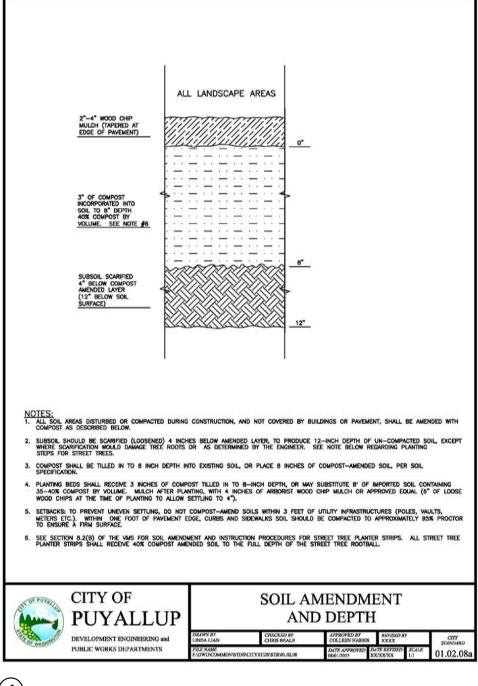

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		STATE OF	WASHINGTON REGISTERED	A.M.	CERTIFIC J. WILLIAN
300 BUILDING-LARSON	AUTOMOTIVE GROUP	300 River Road	Puyallup, WA	PROJECT	
Lyon Landscape Architects	1015 Pacific Avenue, Suite 203	l acoma, WA 98402	253-678-4173	Eric@LyonLA.com	
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nting				APD.	
Puyallup Standard Planting	& Soil Details			REVISIONS	
SHEETS	EW	EW	ML		
OF	DESIGN:	022 DRAWN:	CHECKED:	REVISION NUMBER:	
L1.2	SCALE: As Shown	DATE: January 11, 2022	PROJECT: Larson Jeep	PR0JECT NO: LA0293.21	

Final Set

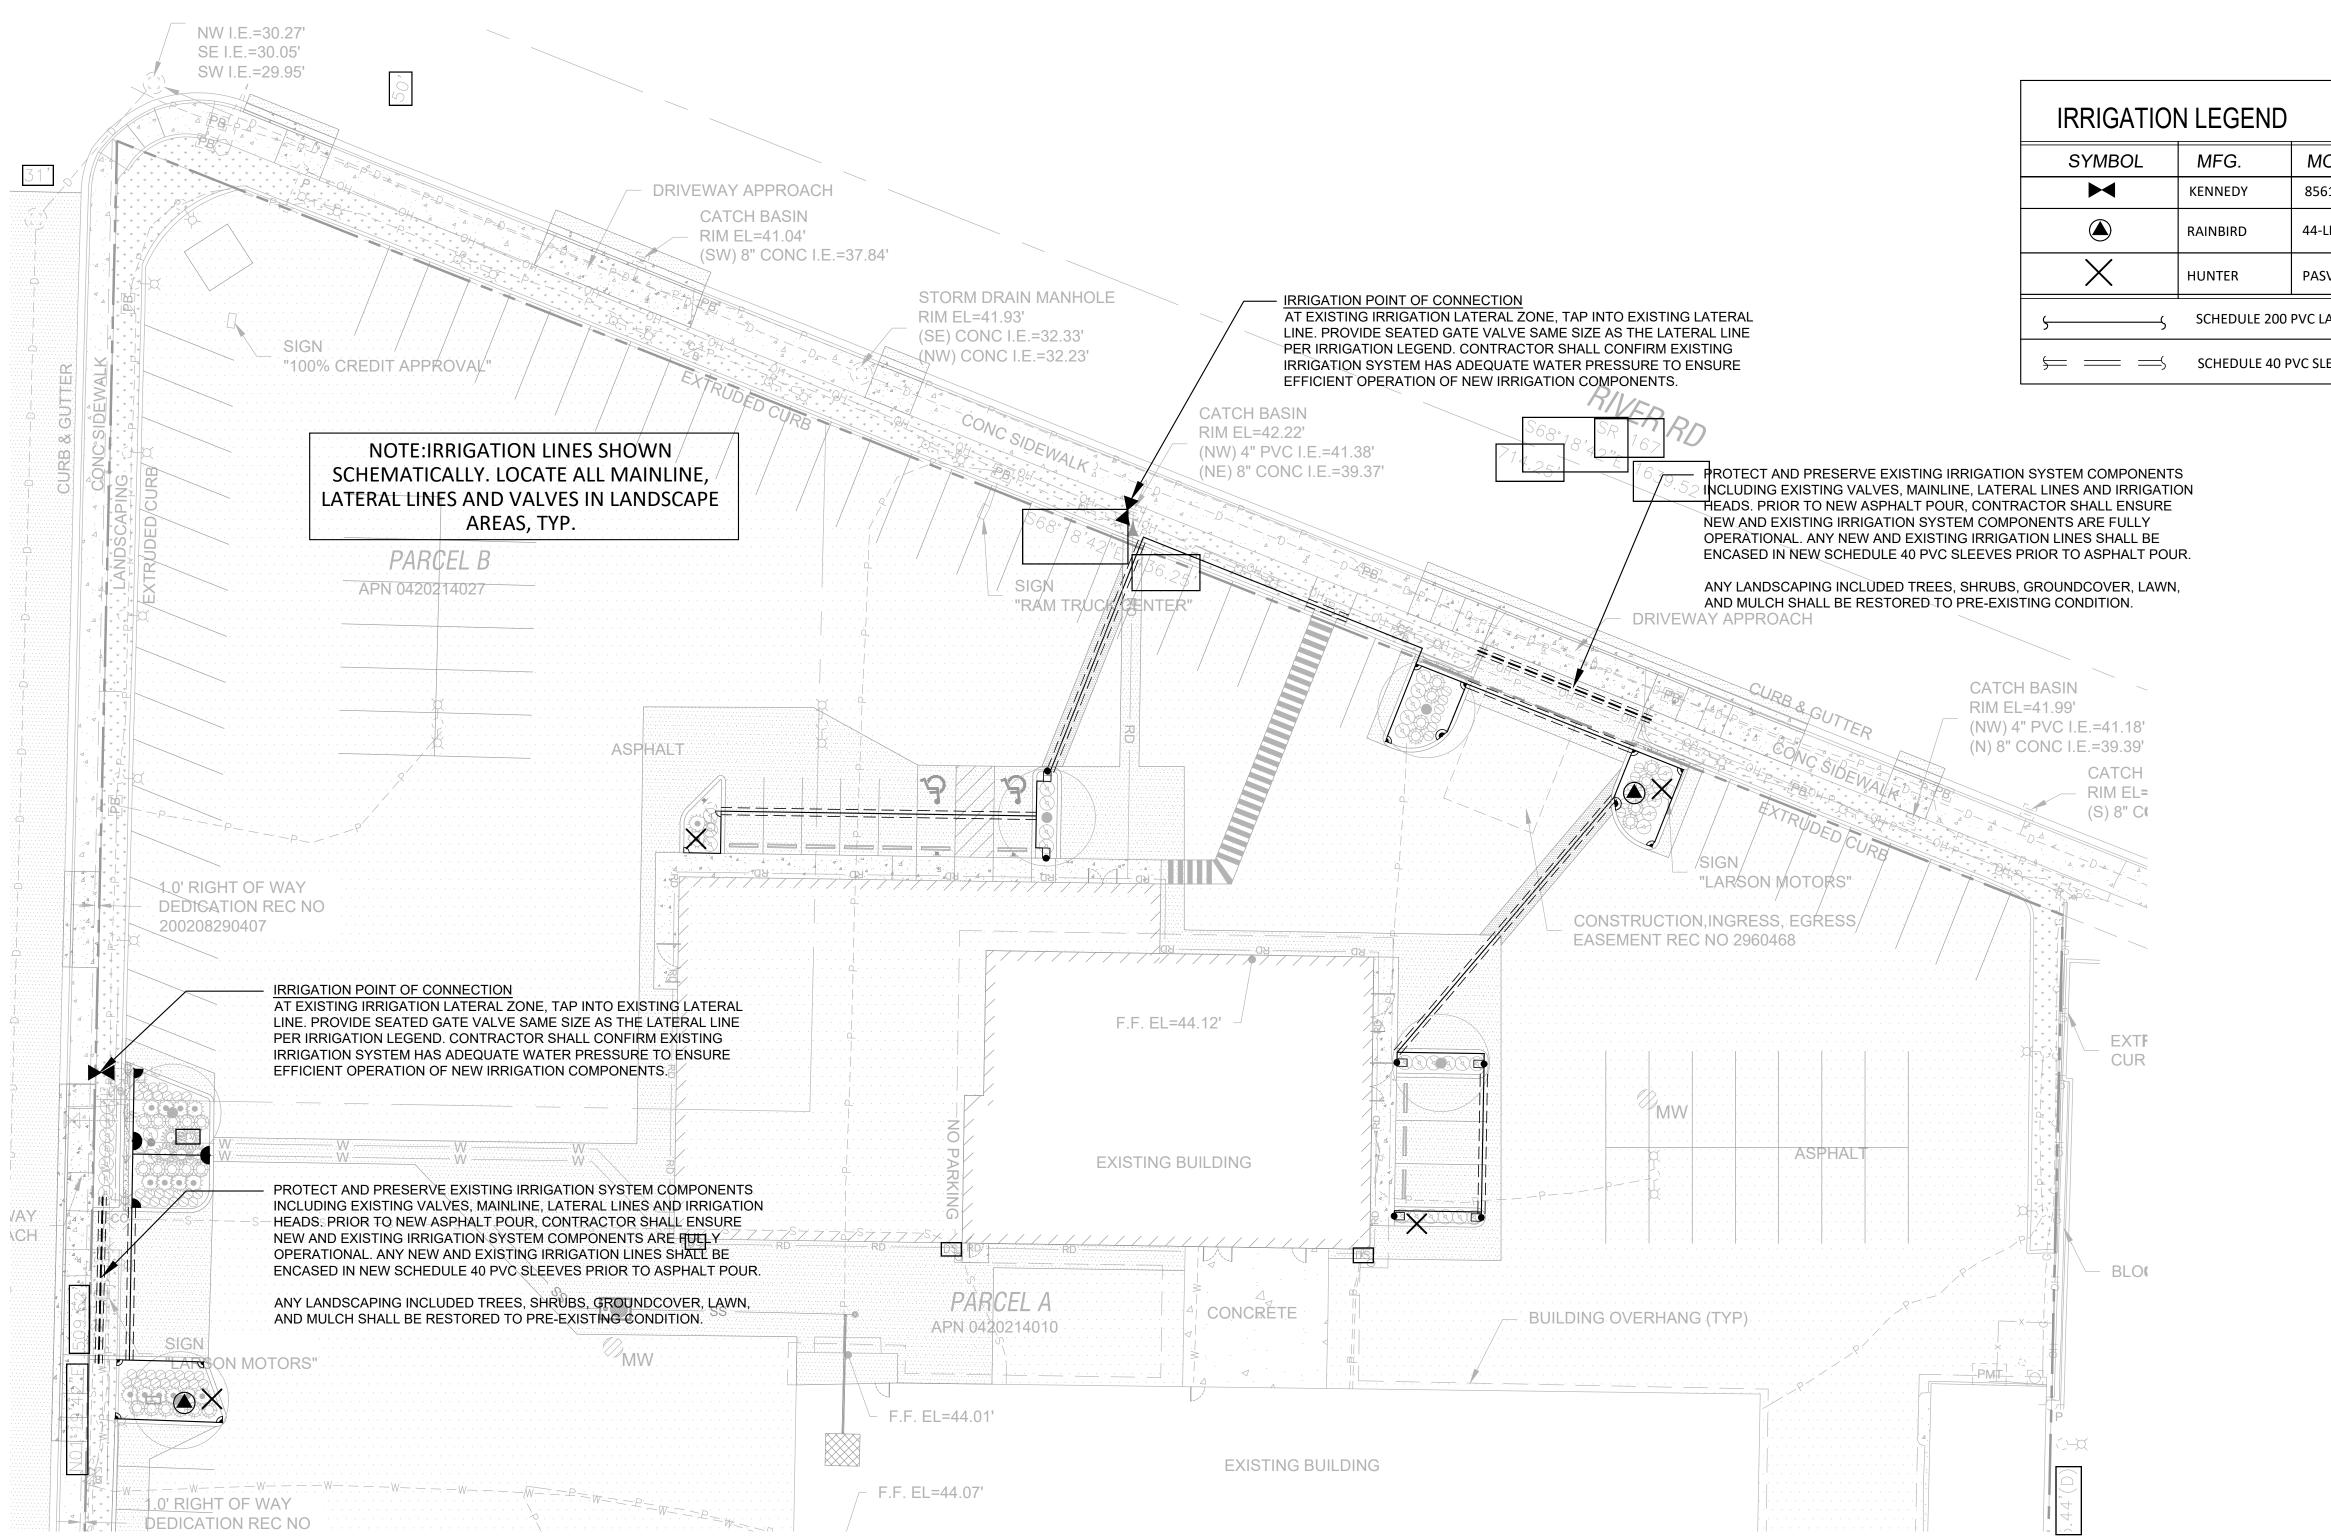

ODEL #	DESCRIPTION		
51ASS	RESILIENT SEATED GATE VALVE (SIZE TO MATCH EXISTING LATERAL LINE)		
LRC	1" BRASS QUICK COUPLING VALVE (QCV) W/ LOCKING RUBBER COVER, SUPPLY W/ COUPLER KEY & LOCKING COVER KEY		
SV-101	1" MANUAL DRAIN VALVE		
ATERAL LINES, SIZE TO ENSURE MAX PRESSURE OF 7 F/S.			

SCHEDULE 40 PVC SLEEVES @ 24" DEPTH, MIN. 4" DIAMETER, SIZE TO ACCOMODATE MAINLINE, LATERAL LINES, WIRING

IRRIGATION HEAD SCHEDULE							
SYM.	CATALOG NUMBER	RADIUS	GPM	PSI			
SPRAY HEADS							
	RAINBIRD 1800-MPR-8Q	8	0.26	30			
A	RAINBIRD 1800-MPR-12Q	12	0.65	30			
	RAINBIRD 1800-MPR-12H	12	1.30	30			
	RAINBIRD 1800-MPR-15Q	15	0.95	30			
	RAINBIRD 1800-MPR-15H	15	1.85	30			
	RAINBIRD 1800-MPR-15EST	4'X15'	0.61	30			
	RAINBIRD 1800-MPR-15SST	4'X30'	1.21	30			
PROVIDE 6" HEADS FOR LANDSCAPE PLANTING AREAS							

IRRIGATION - GENERAL NOTES

- 1. CONFIRM WATER PRESSURE PRIOR TO STARTING OF WORK.
- 2. THE CONTRACTOR SHALL BE FULLY RESPONSIBLE FOR THE LOCATION AND PROTECTION OF ALL EXISTING UTILITIES. THE CONTRACTOR SHALL VERIFY ALL UTILITY LOCATIONS PRIOR TO CONSTRUCTION BY CALLING THE UNDERGROUND LOCATE LINE AT 1-800-424-5555 A MINIMUM OF 48 HOURS PRIOR TO ANY EXCAVATION.
- 3. CONTRACTOR IS RESPONSIBLE FOR PROTECTING ALL EXISTING IMPROVEMENTS. DAMAGE TO EXISTING IMPROVEMENTS BY THE CONTRACTOR SHALL BE REPAIRED OR REPLACED BY THE CONTRACTOR AND/OR QUALIFIED INSTALLERS/TRADES ACCEPTABLE TO THE SOLE SATISFACTION OF THE CONSTRUCTION OBSERVER AND AT NO COST TO THE OWNER.
- 4. CONTRACTOR SHALL COORDINATE ALL WORK WITH THE GENERAL CONTRACTOR. ALL CONSTRUCTION CONFLICTS SHALL BE BROUGHT TO THE ATTENTION OF THE GENERAL CONTRACTOR AND CONSTRUCTION OBSERVER IMMEDIATELY UPON RECOGNITION.
- 5. CONTRACTOR IS RESPONSIBLE FOR A THOROUGH CLEAN-UP FOR HIS/HER RESPECTIVE WORK, DAILY AND AT PROJECT CLOSE-OUT.
- 6. ALL PIPING UNDER HARD SURFACES SHALL BE SLEEVED. CONTRACTOR IS REQUIRED TO INSTALL DUCTILE IRON PIPE FOR IRRIGATION PIPE SLEEVES UNDER PAVEMENTS. D.I. SLEEVE SHALL BE FOUR INCHES (4") LARGER THAN THE IRRIGATION MAINLINE PIPE SIZE. END OF SLEEVE SHALL EXTEND FOUR FEET (4') BEYOND EDGE OF PAVEMENT. MINIMUM DEPTH OF BURY FROM FIN. GRADE TO TOP OF SLEEVE SHALL BE ONE FOOT (12").
- 7. PIPE SIZE SHALL BE THE SAME ON BOTH SIDES OF VALVES. PIPE SHALL REMAIN CONSTANT BETWEEN PIPE SIZE CALLOUTS. 3/4" CLASS 200 PVC SHALL BE THE SMALLEST LATERAL LINE USED.
- 8. FIELD VERIFY ALL SPRINKLER HEAD LOCATIONS (FLAGGING) BEFORE TRENCHING.
- 9. WHERE TWO OR MORE PIPES SHARE THE SAME TRENCH, MAINTAIN A 4" SEPARATION BETWEEN PIPES. DO NOT CROSS PIPES OVER EACH OTHER UNLESS THEY ARE AT A 90 DEGREE ANGLE.
- 10. IRRIGATION SITE PLAN IS SCHEMATIC. IRRIGATION PLUMBING AND EQUIPMENT SHALL BE INSTALLED IN TURF OR LANDSCAPE BED AREAS AND WITHIN PROPERTY BOUNDARIES. THE CONTRACTOR SHALL CONSIDER ALL SITE FEATURES IN THE INSTALLATION OF IRRIGATION IMPROVEMENTS. THE CONTRACTOR SHALL BE RESPONSIBLE FOR SUPPLYING AND INSTALLING ALL IRRIGATION EQUIPMENT NECESSARY FOR A COMPLETE AND FUNCTIONAL IRRIGATION SYSTEM. FIELD VERIFY ALL EXISTING EQUIPMENT LOCATIONS AND REPORT ANY INCONSISTENCIES TO CONSTRUCTION OBSERVER/OWNER'S REPRESENTATIVE.
- 11. SPRINKLER HEAD SYMBOLS SCHEMATICALLY REPRESENT DESIRED SPRAY PATTERNS. FIELD ADJUSTMENTS AND VERIFICATION OF SPRAY PATTERNS WILL BE NECESSARY. ADJUST SPRAY PATTERNS TO WATER LANDSCAPE AREA ONLY AND MINIMIZE OVERSPRAY ONTO PAVEMENT.



10' 20' 4

Graphic Scale: 1" = 20'-0"

STATE OF WASHINGTON REGISTERED LANDSCAPE ARCHITECT

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300 BUILDING-LARSON AUTOMOTIVE GROUP 300 River Road Puyallup, WA

