STEP BY STEP GATEWAY

3303 8th AVE SE PUYALLUP, WA 98372 FIRE ALARM SYSTEM

EVERGREEN FIRE AND SECURITY
CERTIFIED BY UNDERWRITERS LABORATORIES

<u></u>	DRAWING SHEET INDEX			
	SHEET NO.	DESCRIPTION		
	FA-000	COVER SHEET		
	FA-001	PROJECT INFORMATION		
	FA-100	STEP BY STEP GATEWAY - SITE PLAN		
	FA-101	STEP BY STEP GATEWAY - FLOOR PLAN		
	FA-500	PANEL DETAILS		
	FA-501	CONNECTION DETAILS		
	FA-502	DEVICE DETAILS		
	FA-503	DEVICE DETAILS (CONT.)		
	FA-600	RISER		
	FA-601	MATRIX		
	FA-602	BATTERY CALCS		



EVERGREEN FIRE AND SECURITY 2111 SOUTH 90TH STREET TACOMA, WA. 98444 253-627-3794

T CERTIFICATION INFO
114223
IV
FIRE ALARMS
08/01/23
BRIAN LINDBO

GENERAL NOTES

REVISION DATE CAD/DESIGN

JOB NAME

JOB DETAILS

B.LINDBO

D.MOLMEN

A.MURPHREE

STEP BY STEP GATEWAY

CREATION DATE: 01/24/2022

DRAWING SCALE: VARIES

TITLE PAGE

DESIGNED BY:

DRAWN BY:

CHECKED BY:

PAGE NUMBER FA-000

PRELIMINARY

GENERAL SYSTEM NOTES

- 1. METALLIC RACEWAY SHALL BE USED IF REQUIRED BY CODE.
- 2. ALL RACEWAYS MUST BE FREE OF MOISTURE.
- 3. REFER TO EVERGREEN FIRE & SECURITY (EFS) FIRE DATA SHEETS FOR PROPER TYPE AND SIZES OF REQUIRED DEVICE MOUNTING BOXES. ELECTRICAL CONTRACTOR IS RESPONSIBLE FOR PROPER INSTALLATION OF ALL DEVICES.
- 4. AC VOLTAGE IS NOT PERMITTED IN THE SAME RACEWAY AS FIRE ALARM WIRING.
- 5. UNRELATED (NON-FIRE) WIRING SHALL NOT BE IN THE SAME RACEWAY AS FIRE ALARM WIRING.
- 6. ALL CONTRACTOR FIELD WIRING MUST ENTER TOP AND/OR BOTTOM RIGHT OF FIRE ALARM CONTROL PANEL ONLY. SEE DATA SHEET.
- 7. ALL FIRE ALARM WIRING SHALL TEST FREE OF OPENS, SHORTS, AND GROUNDS.
- 8. ALL WIRES SHALL BE LABELED AND TAGGED.
- 9. ELECTRICAL CONTRACTOR IS RESPONSIBLE FOR PROVIDING AND INSTALLING ALL CONDUIT AND BACK BOXES. EFS WILL PROVIDE ALL SPECIALTY BACK BOXES FOR ELECTRICAL CONTRACTOR INSTALLATION.
- 10. ALL WIRE SHALL MEET ALL APPLICABLE NATIONAL ELECTRICAL CODE ARTICLES FOR FIRE ALARM AND LOW VOLTAGE WIRING.

FIRE SYSTEM DESIGNED BY:

EVERGREEN FIRE & SECURITY
TACOMA, WASHINGTON
EVERGREEN FIRE & SECURITY
TACOMA, WASHINGTON
FIRE SYSTEM EQUIPMENT BY:
EVERGREEN FIRE & SECURITY
TACOMA, WASHINGTON

WIRE CHART					
CIRCUIT TYPE	CABLE TYPE	NO.	GAUGE	COLOR	NOTES
ADDRESSABLE INITIATING CIRCUIT	FPLR	А	16/2	RED JACKET	
INDICATING CIRCUIT - BELL CIRCUIT	FPLR	В	12/2	RED JACKET	
INDICATING CIRCUIT - FA NAC	FPLR	N	12/2	RED JACKET	
ANNUNCIATOR CIRCUIT	FPLR	L	16/4	RED JACKET	
REMOTE LED CIRCUIT	FPLR	R	16/2	RED JACKET	
REMOTE TEST SWITCH	FPLR	Т	16/4	RED JACKET	

SYMB	OL INDEX				
SYMBOL	DESCRIPTION	MANUFACTURE	MODEL NUMBER	ВАСК ВОХ	QTY
FACP	FIRE ALARM CONTROL PANEL	SILENT KNIGHT	IFP-300	EFS TO SUPPLY	1
ANN	REMOTE ANNUNCIATOR	SILENT KNIGHT	00RA-1000	EFS TO SUPPLY	1
RTS	REMOTE TEST SWITCH	SILENT KNIGHT	RTS151KEY	4 SQ. DEEP BOX SINGLE GANG MUD RING	1
<u>S</u>	PHOTOELECTRIC SMOKE & SENSOR BASE (A BY SMOKE INDICATES ABOVE T-BAR CEILING)	SILENT KNIGHT	IDP-PHOTO-W B300-6	4 SQ. DEEP BOX SINGLE GANG MUD RING	23
<u>\$</u>	INTELLIGENT DUCT SMOKE DETECTOR	SILENT KNIGHT	DNR IDP-PHOTO-R-W	EFS TO SUPPLY	1
F	DOUBLE ACTION ADDRESSABLE PULL STATION	SILENT KNIGHT	IDP-PULL-DA	4 SQ. DEEP BOX SINGLE GANG MUD RING	1
М	SINGLE INPUT MONITOR MODULE	SILENT KNIGHT	IDP-MONITOR	4 SQ. DEEP BOX	2
DM	DUAL INPUT MONITOR MODULE	SILENT KNIGHT	IDP-MONITOR-2	4 SQ. DEEP BOX	4
CR	CONTROL RELAY MODULE	SILENT KNIGHT	IDP-RELAY	4 SQ. DEEP BOX	1
H	CEILING MOUNT HORN/STROBE	SYSTEM SENSOR	PC2WL	4 SQ. DEEP BOX SINGLE GANG MUD RING	8
Ē	WEATHERPROOF HORN/STROBE	SYSTEM SENSOR	P2RK	EFS TO SUPPLY	1
F	FIRE STROBE, WALL	SYSTEM SENSOR	SWL	5 SQ. BOX 4 SQ. MUD RING	2
В	WEATHERPROOF SPRINKLER BELL	SYSTEM SENSOR	SSM-24-10	EFS TO SUPPLY	1
LI	LED INDICATOR	SYSTEM SENSOR	RA100Z	4 SQ. DEEP BOX SINGLE GANG MUD RING	6
FS	FLOW SWITCH (F.B.O.)	F.B.O.	F.B.O.	F.B.O.	1
8	TAMPER SWITCH (F.B.O.)	F.B.O.	F.B.O.	F.B.O.	4
PIV	POST INDICATOR VALVE (F.B.O.)	F.B.O.	F.B.O.	F.B.O.	1
LA-	LOW AIR	F.B.O.	F.B.O.	F.B.O.	1
PS-	PRESSURE SWITCH	F.B.O.	F.B.O.	F.B.O.	1
			1	ļ	1



EVERGREEN FIRE AND SECURITY 2111 SOUTH 90TH STREET TACOMA, WA. 98444 253-627-3794

	<u> </u>	NICET CERTIFICATION INFO
	NICET #	114223
	LEVEL	IV
	SUB-FIELD	FIRE ALARMS
	EXPIRATION DATE	08/01/23
	NAME	BRIAN LINDBO
Ш		

GENERAL NOTES

REVISIONS/NOTES

REVISION

DATE

CAD/DESIGN

JOB DETAILS

DESIGNED BY:
DRAWN BY:
CHECKED BY:
CREATION DATE:
DRAWING SCALE:
DESIGNED BY:
A.MURPHREE
D.MOLMEN
01/24/2022
VARIES


JOB NAME

STEP BY STEP GATEWAY

PROJECT INFORMATION

PAGE NUMBER FA-001

____02 OF ___11

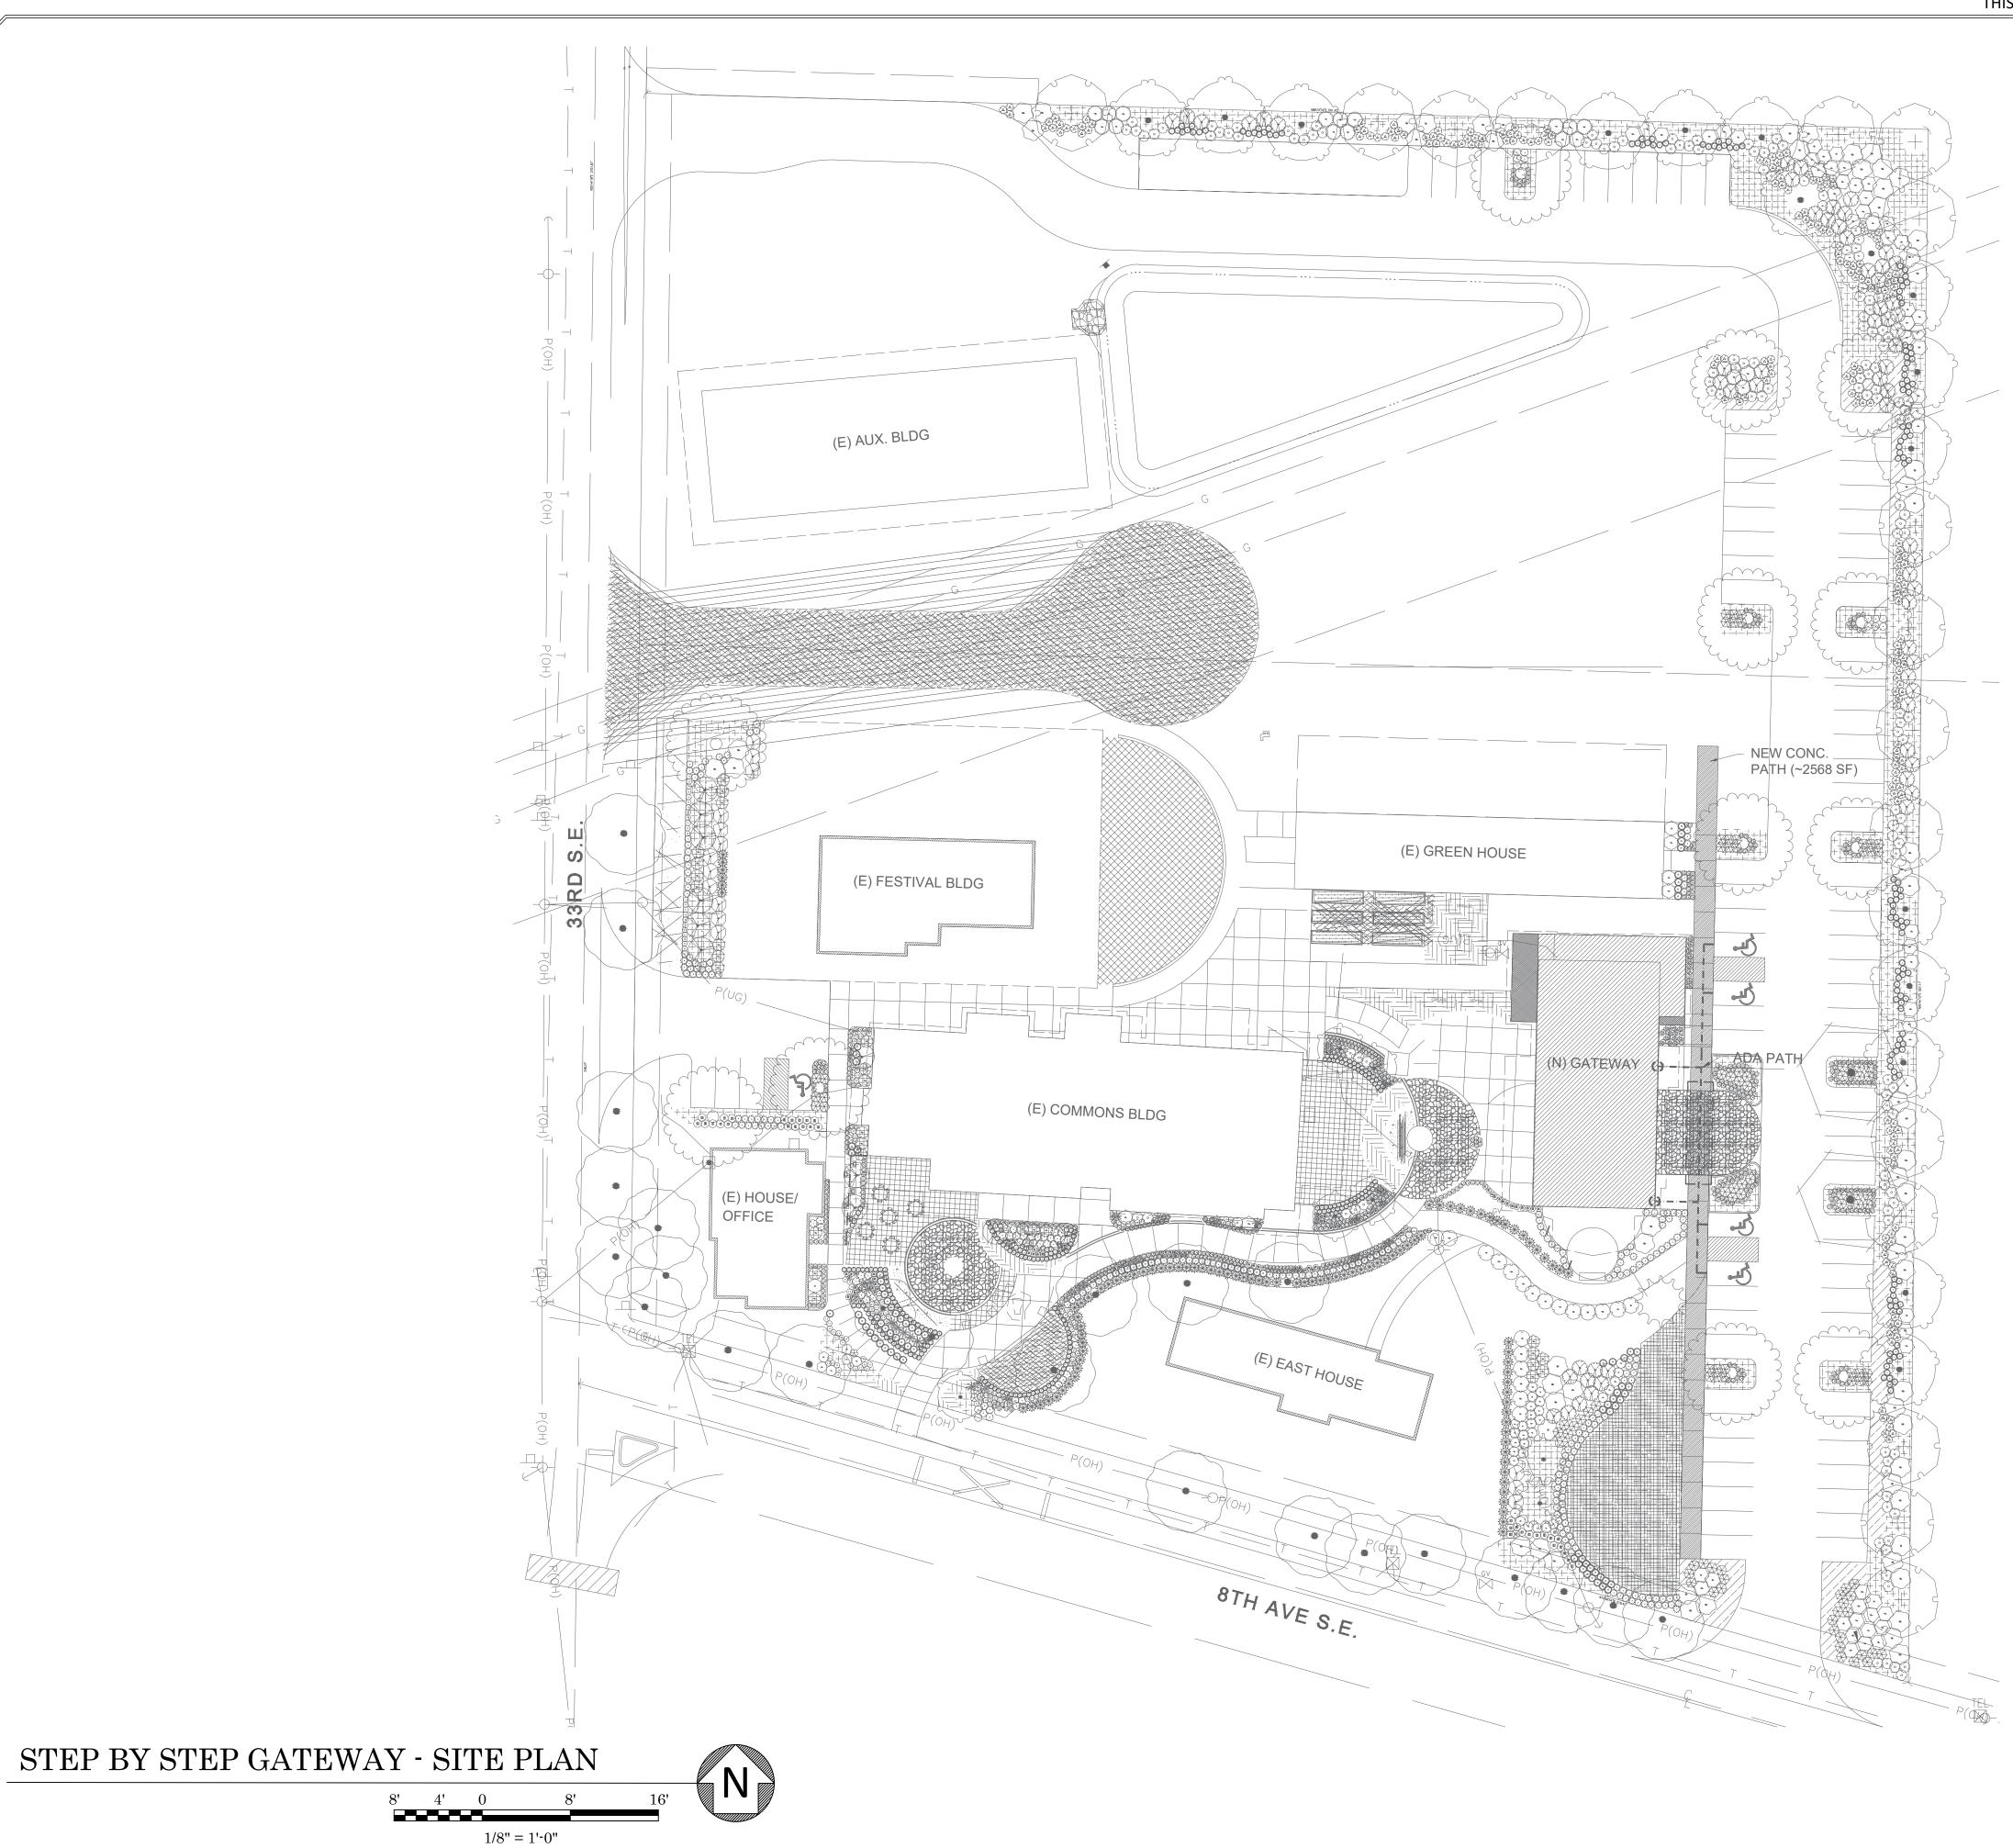



EVERGREEN FIRE AND SECURITY 2111 SOUTH 90TH STREET TACOMA, WA. 98444 253-627-3794

NICET CERTIFICATION INFO

NICET # 114223

LEVEL IV

SUB-FIELD FIRE ALARMS

EXPIRATION DATE 08/01/23

NAME BRIAN LINDBO

GENERAL NOTES

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REVISION

DATE CAD/DESIGN

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DRAWN BY:
CHECKED BY:
CREATION DATE:
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A.MURPHREE
D.MOLMEN
01/24/2022
VARIES

JOB NAME


JOB DETAILS

STEP BY STEP GATEWAY

STEP BY STEP GATEWAY - SITE PLAN

PAGE NUMBER FA-100

____03___OF ___11___

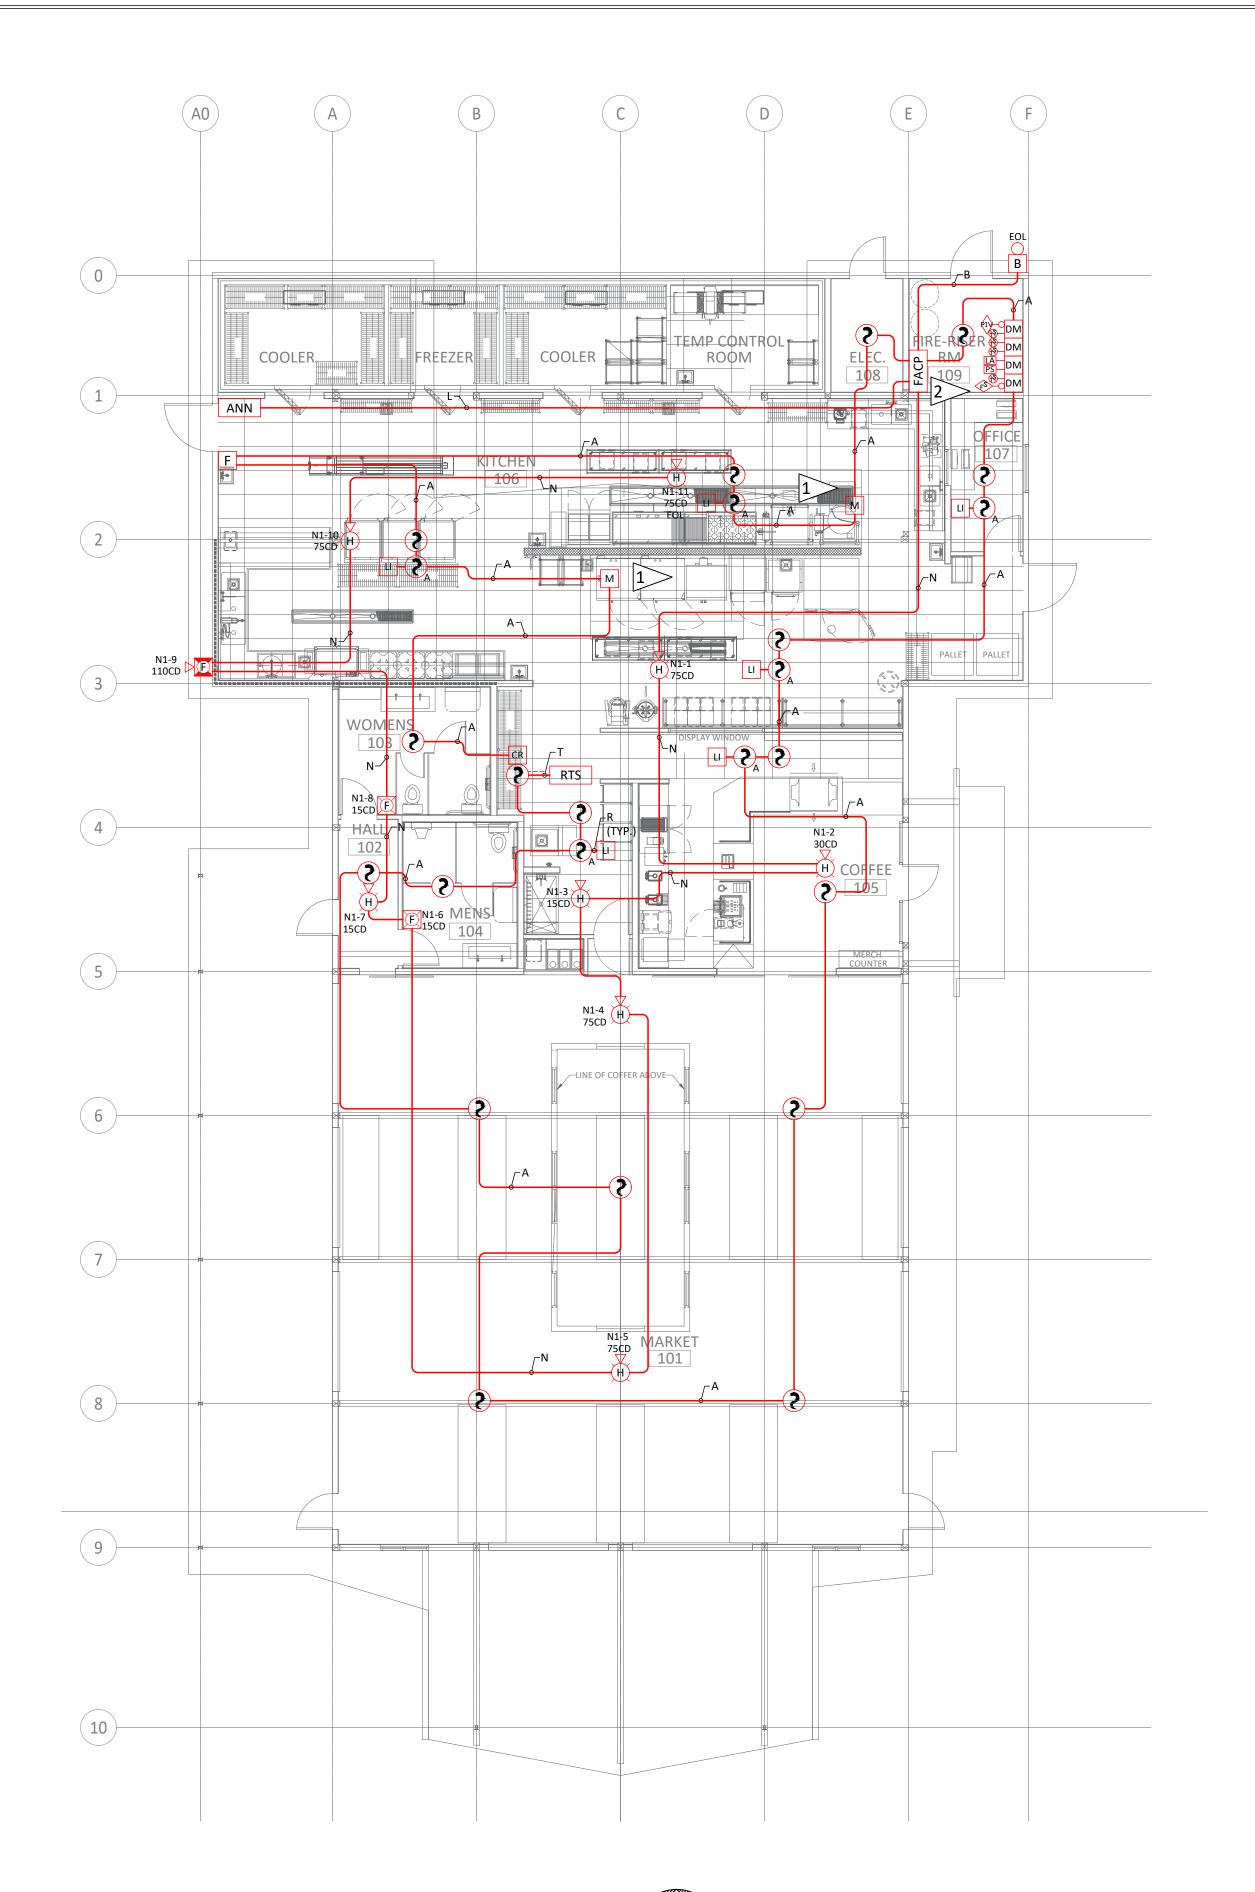

SYMBO	DL LEGEND	
SYMBOL	DESCRIPTION	QT
FACP	FIRE ALARM CONTROL PANEL	1
ANN	REMOTE ANNUNCIATOR	1
RTS	REMOTE TEST SWITCH	1
(\$)	PHOTOELECTRIC SMOKE & SENSOR BASE (A BY SMOKES INDICATES ABOVE T-BAR CEILING)	23
<u>\$</u>	INTELLIGENT DUCT SMOKE DETECTOR	1
F	DOUBLE ACTION ADDRESSABLE PULL STATION	1
M	SINGLE INPUT MONITOR MODULE	2
DM	DUAL INPUT MONITOR MODULE	4
CR	CONTROL RELAY MODULE	1
H	CEILING MOUNT HORN/STROBE	8
Ē	WEATHERPROOF HORN/STROBE	1
F	FIRE STROBE, WALL	2
В	WEATHER PROOF SPRINKLER BELL	1
LI	LED INDICATOR	6
₽	FLOW SWITCH (F.B.O.)	1
89	TAMPER SWITCH (F.B.O.)	1
♀	POST INDICATOR VALVE (F.B.O.)	1
LA—	LOW AIR	1
PS—	PRESSURE SWITCH	1

WIRE CHART				
CABLE USE	CABLE TYPE	NO.	GAUGE	COLOR
ADDRESSABLE INITIATING CIRCUIT	FPLR	Α	16/2	RED JACKET
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REMOTE LED CIRCUIT	FPLR	R	16/2	RED JACKET
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PRELIMINARY



EVERGREEN FIRE AND SECURITY 2111 SOUTH 90TH STREET TACOMA, WA. 98444 253-627-3794

	NICET CERTIFICATION INFO
NICET #	114223
LEVEL	IV
SUB-FIELD	FIRE ALARMS
EXPIRATION DATE	E 08/01/23
NAME	BRIAN LINDBO

GENERAL NOTES

1 KITCHEN HOOD ANSUL SYSTEM MONITORING MODULE.

2 TWO PHONE LINES ARE REQUIRED FOR MOITORING VIA PHONE LINES.

REVISION CAD/DESIGN

JOB DETAILS

DESIGNED BY:
DRAWN BY:
CHECKED BY:
CREATION DATE:
DRAWING SCALE:
DESIGNED BY:
A.MURPHREE
D.MOLMEN
01/24/2022
VARIES

JOB NAME


STEP BY STEP GATEWAY


STEP BY STEP GATEWAY - FLOOR PLAN

PAGE NUMBER FA-101

____04___OF____

1/8" = 1'-0"

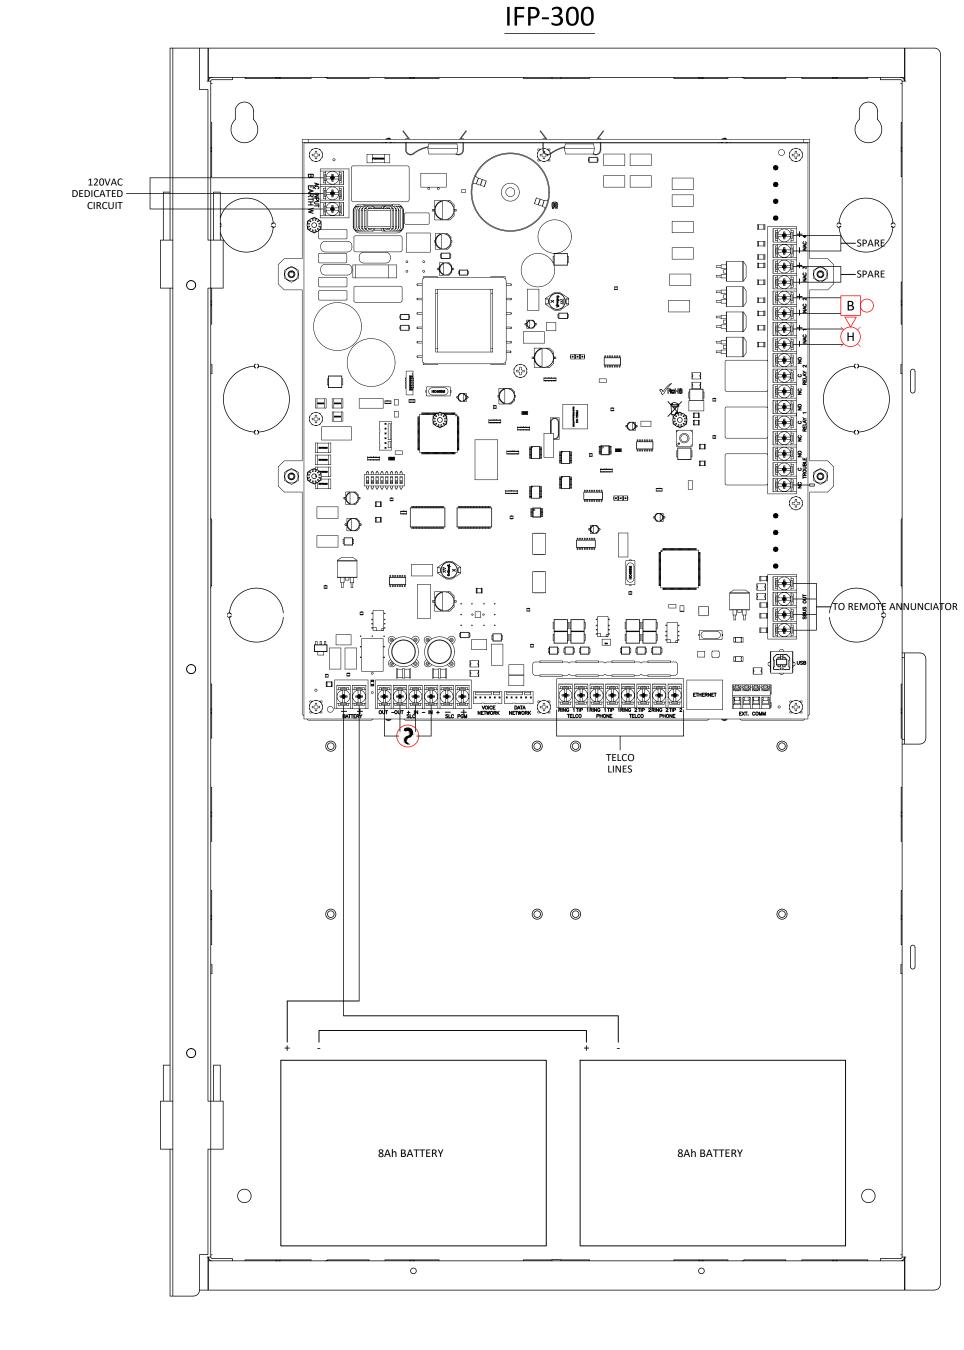

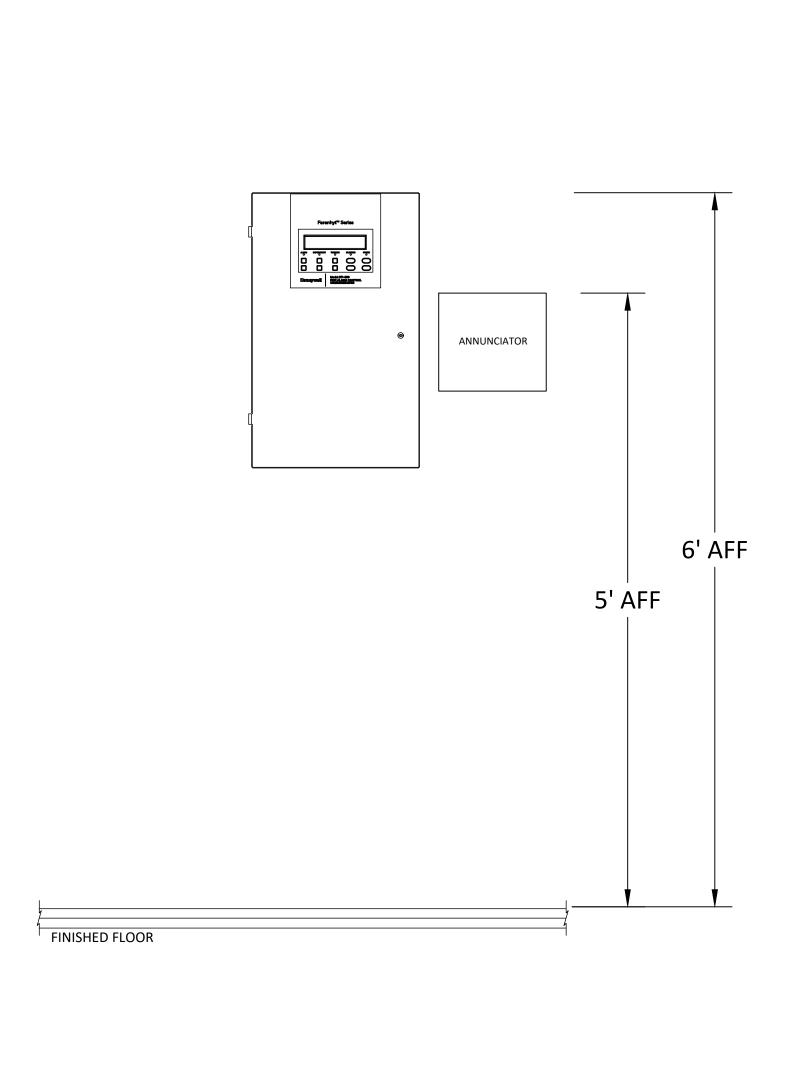

FIRE AND SECURITY

EVERGREEN FIRE AND SECURITY 2111 SOUTH 90TH STREET TACOMA, WA. 98444 253-627-3794

NICET CERTIFICATION INFO NICET # 114223 LEVEL SUB-FIELD FIRE ALARMS EXPIRATION DATE 08/01/23 BRIAN LINDBO

GENERAL NOTES

REVISIONS/NOTES REVISION DATE CAD/DESIGN

DESIGNED BY: B.LINDBO A.MURPHREE DRAWN BY: CHECKED BY: D.MOLMEN CREATION DATE: 01/24/2022
DRAWING SCALE: VARIES

JOB DETAILS

JOB NAME


STEP BY STEP GATEWAY


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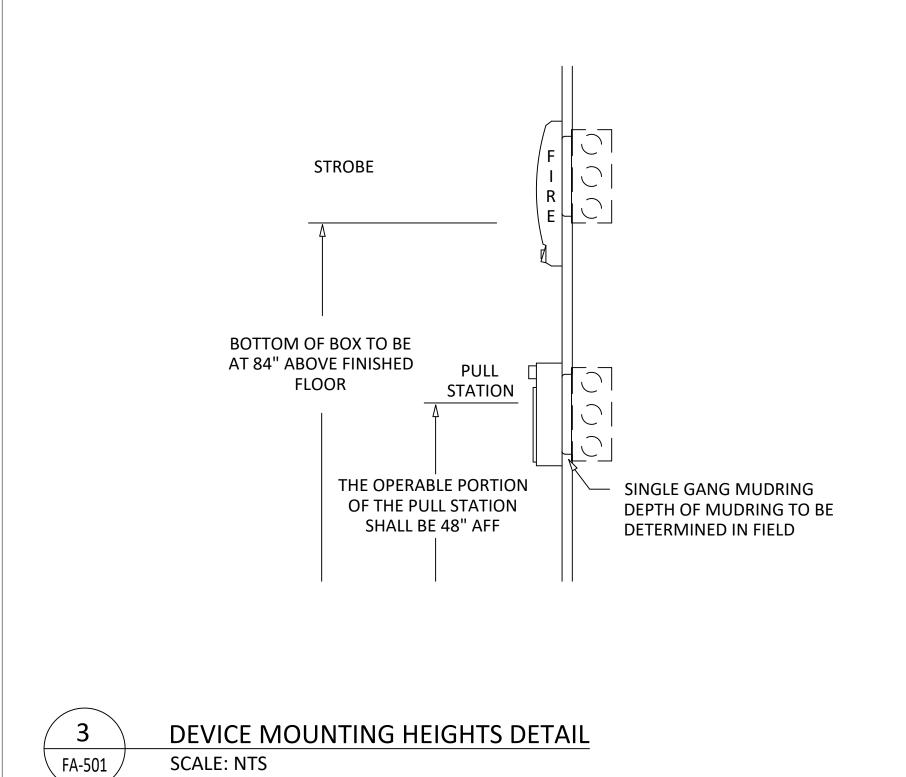
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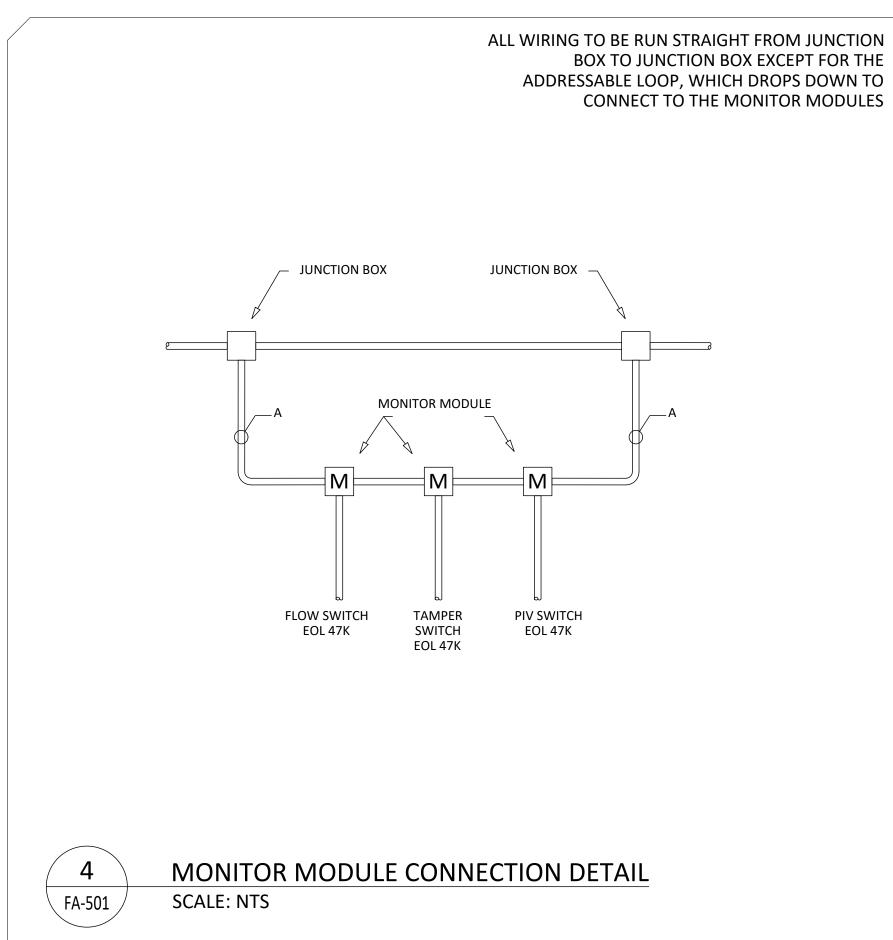
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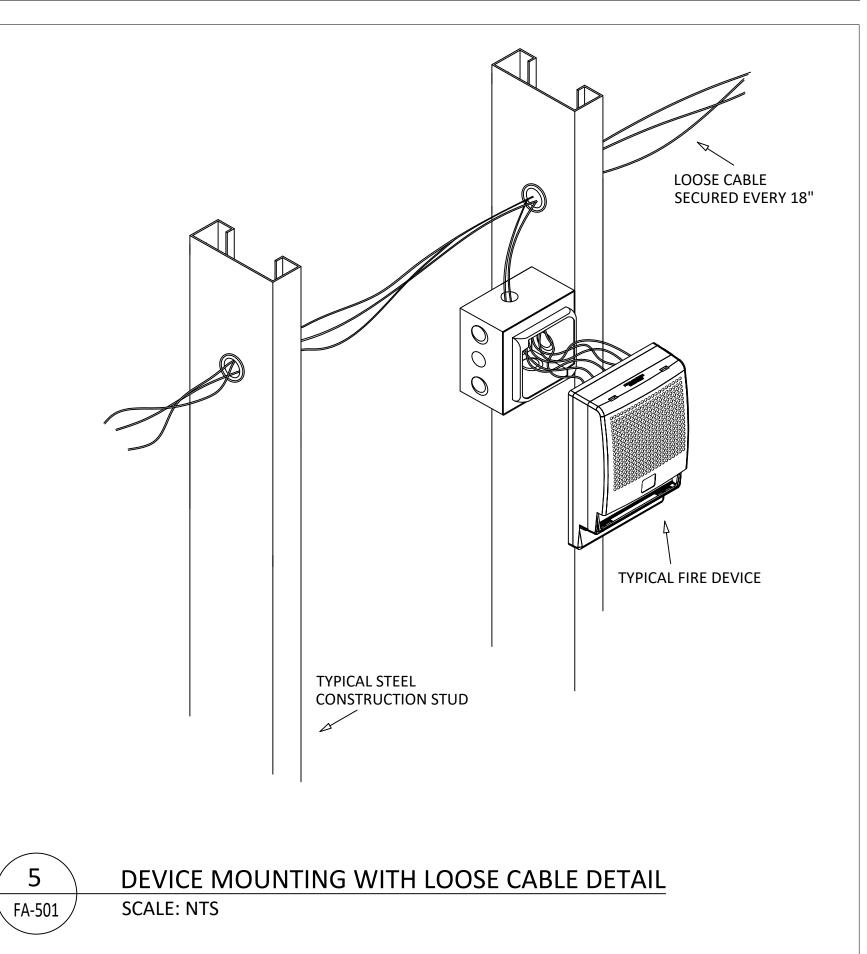
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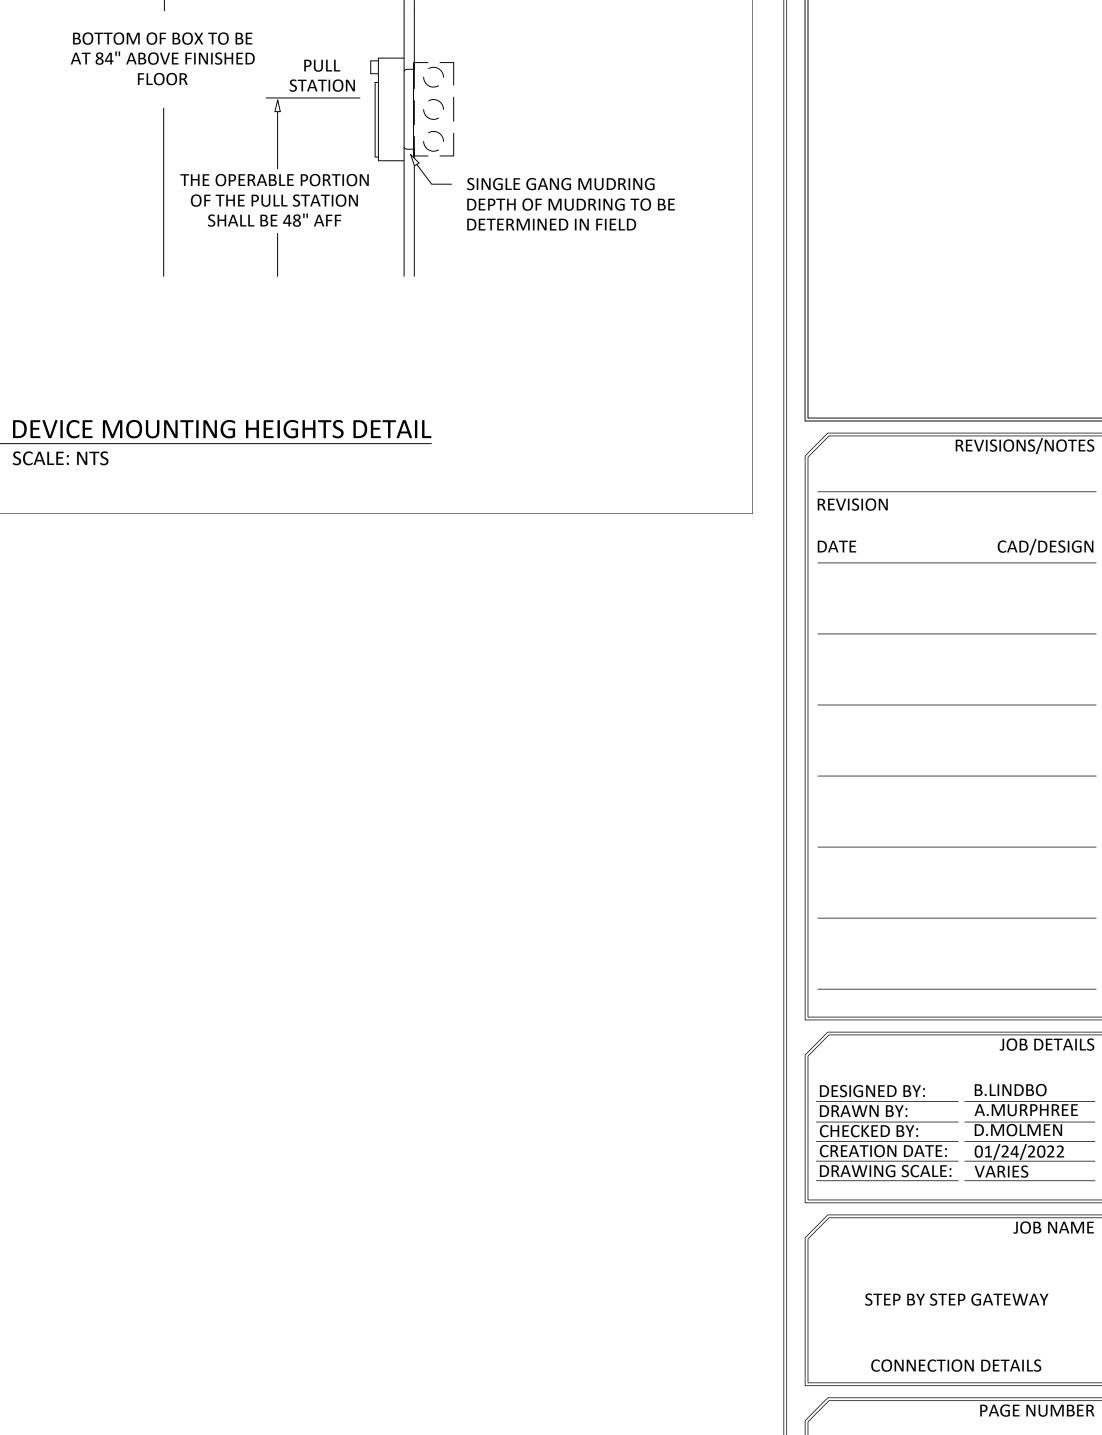








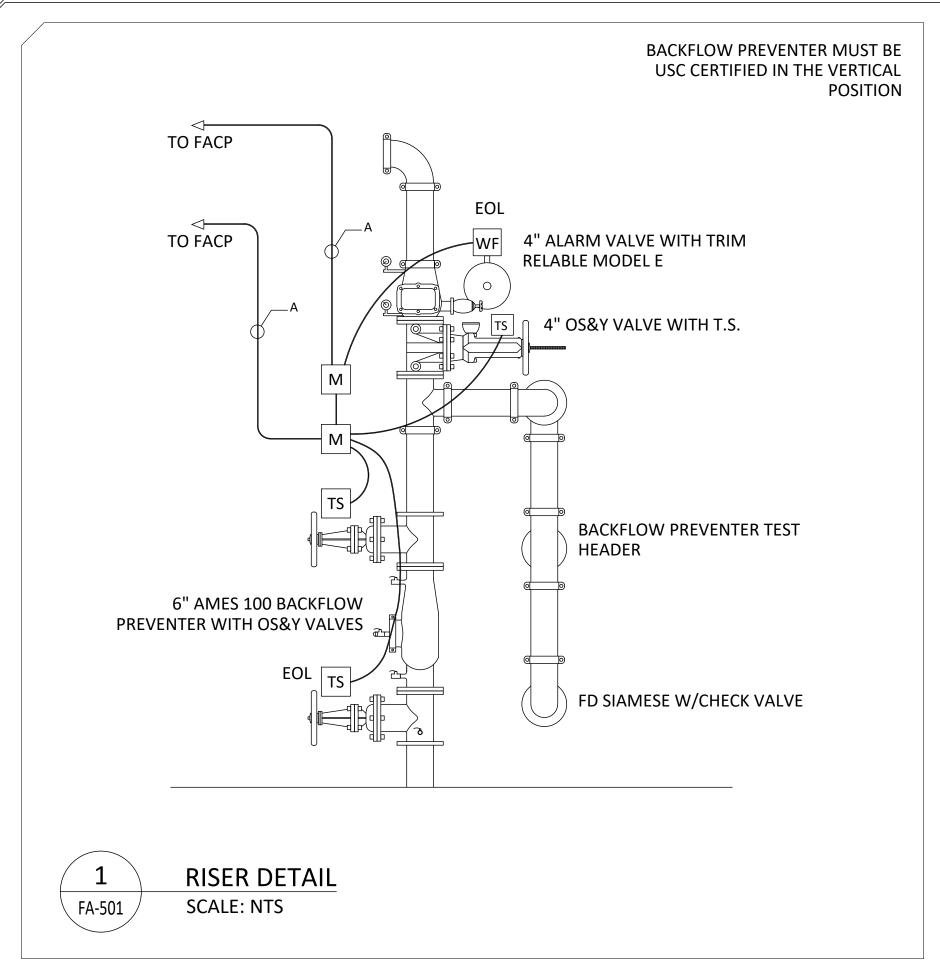

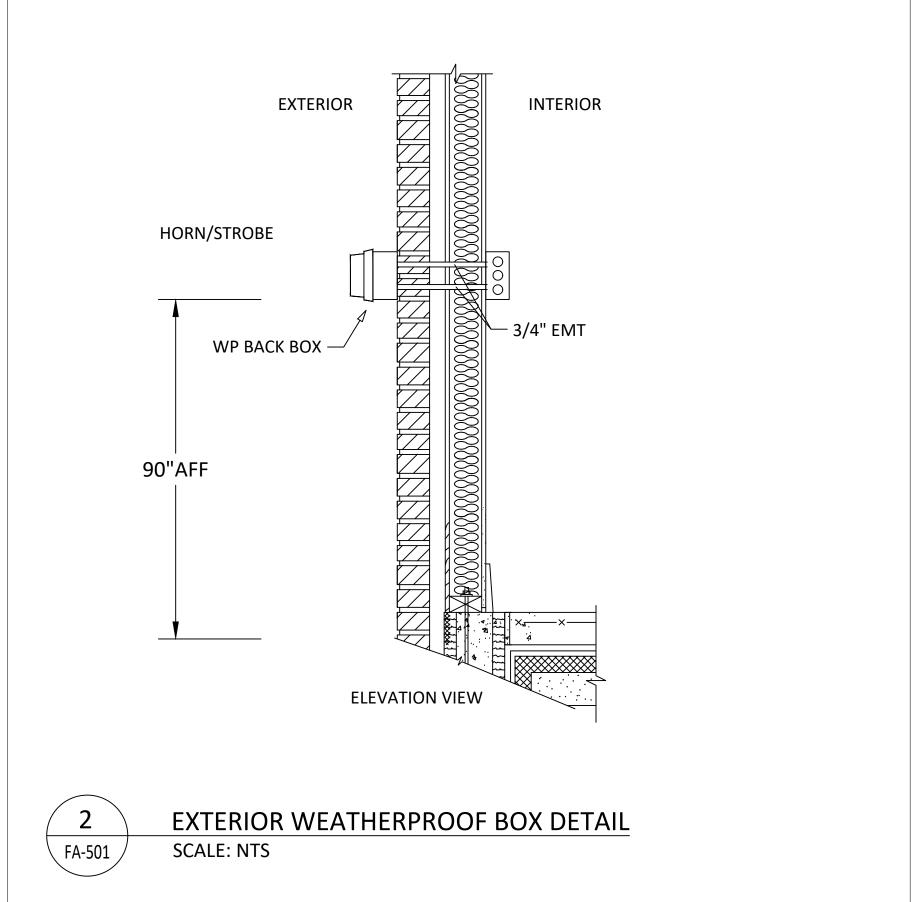

CONNECTION DETAILS

PRELIMINARY

Plot Date 2/7/2022 11:48 AM File Name 100533 STEP BY STEP GATEWAY_07FEB2022_FINAL v1.0

Evergreen FIRE AND SECURITY

EVERGREEN FIRE AND SECURITY 2111 SOUTH 90TH STREET TACOMA, WA. 98444 253-627-3794

NICET CERTIFICATION INFO NICET # 114223 LEVEL SUB-FIELD FIRE ALARMS **EXPIRATION DATE** 08/01/23 BRIAN LINDBO

GENERAL NOTES


REVISIONS/NOTES


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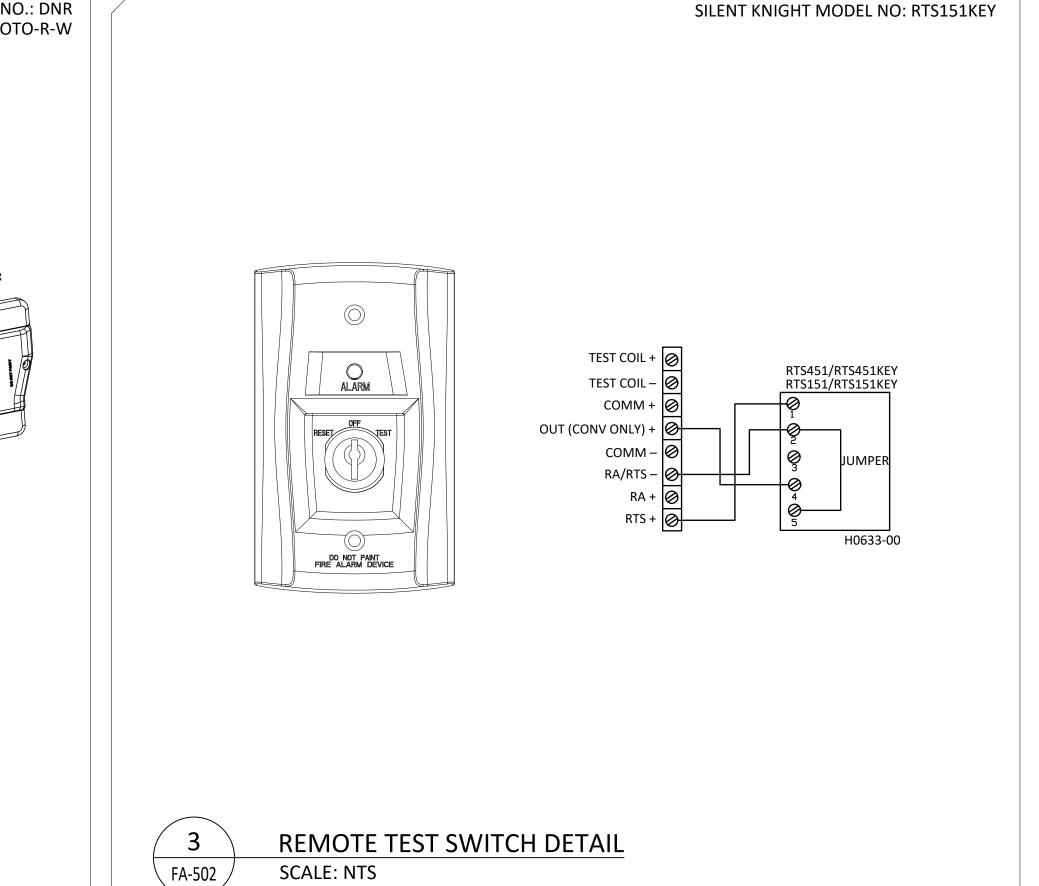
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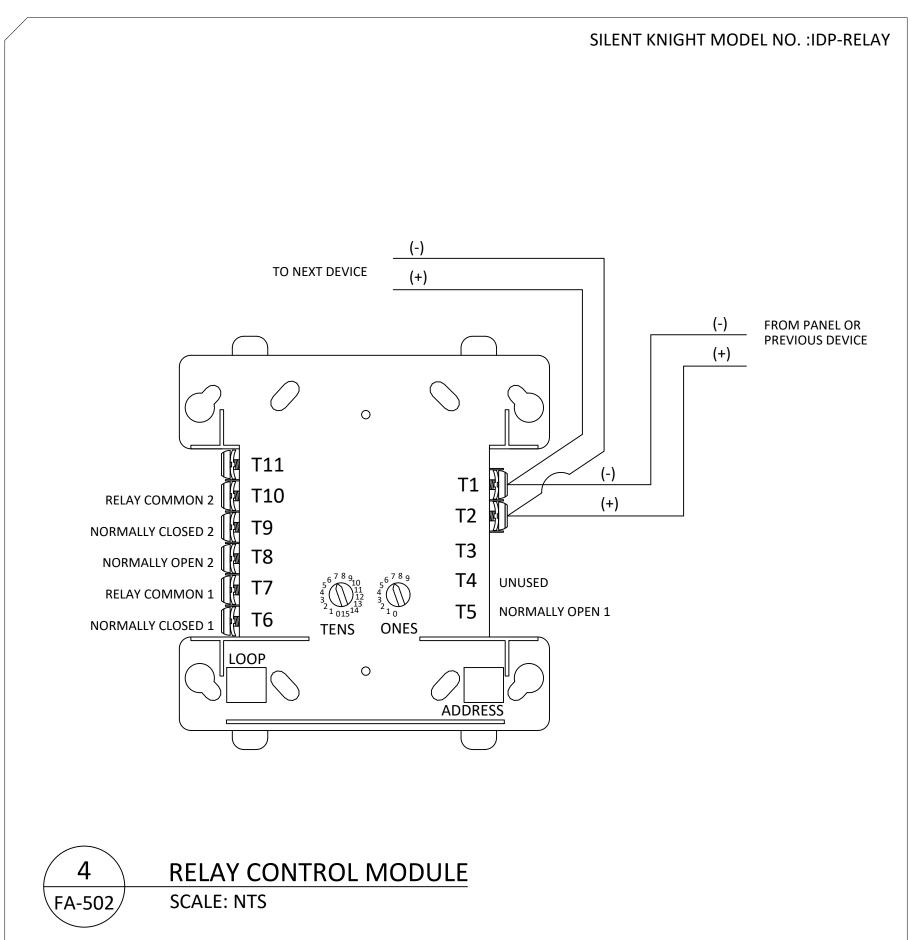
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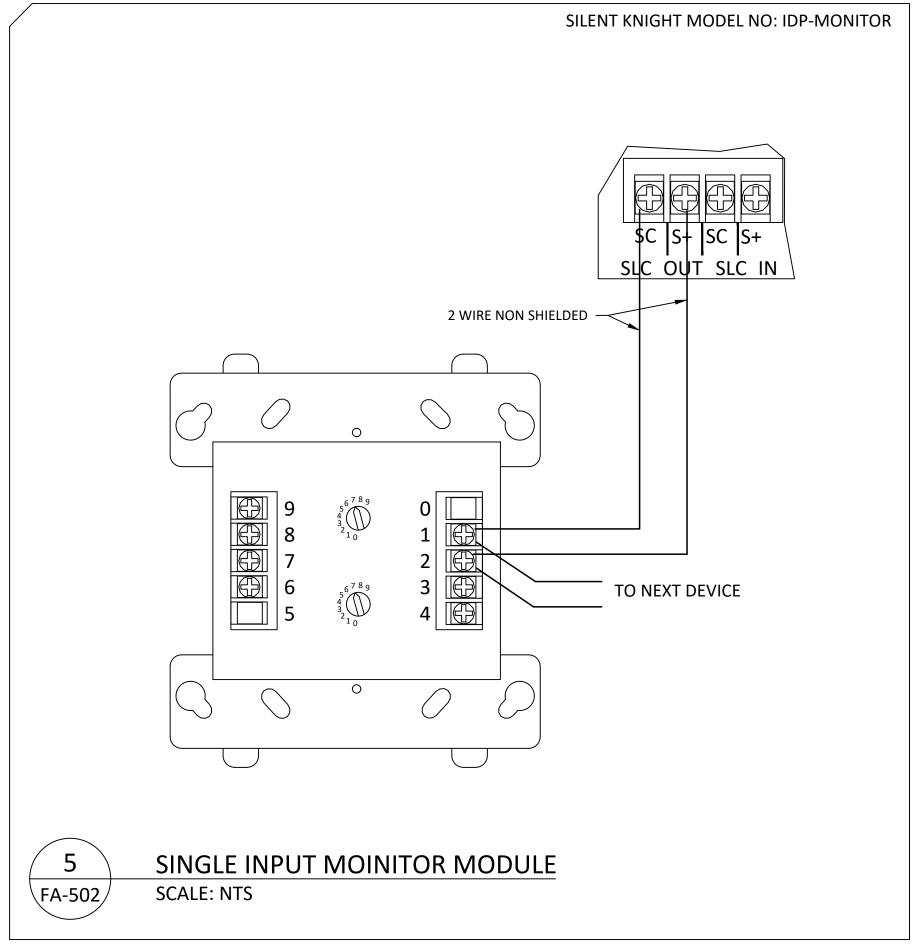
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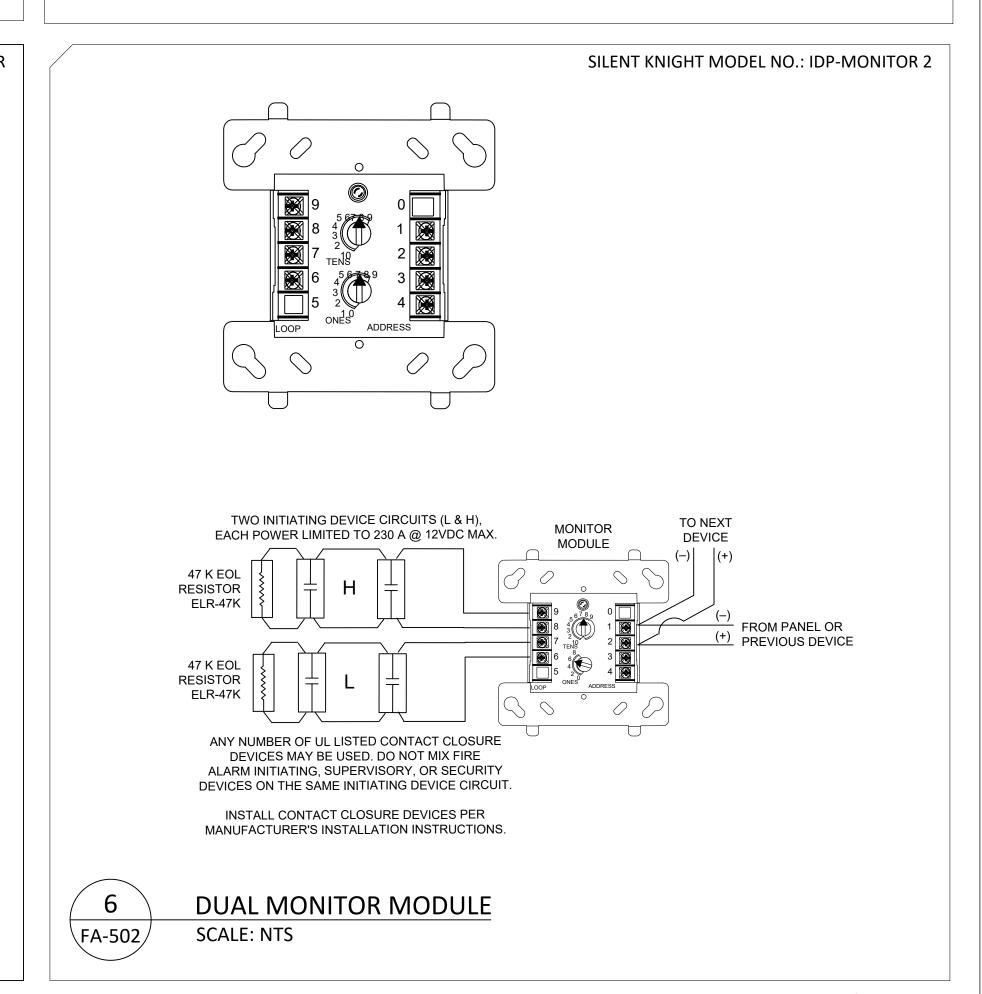








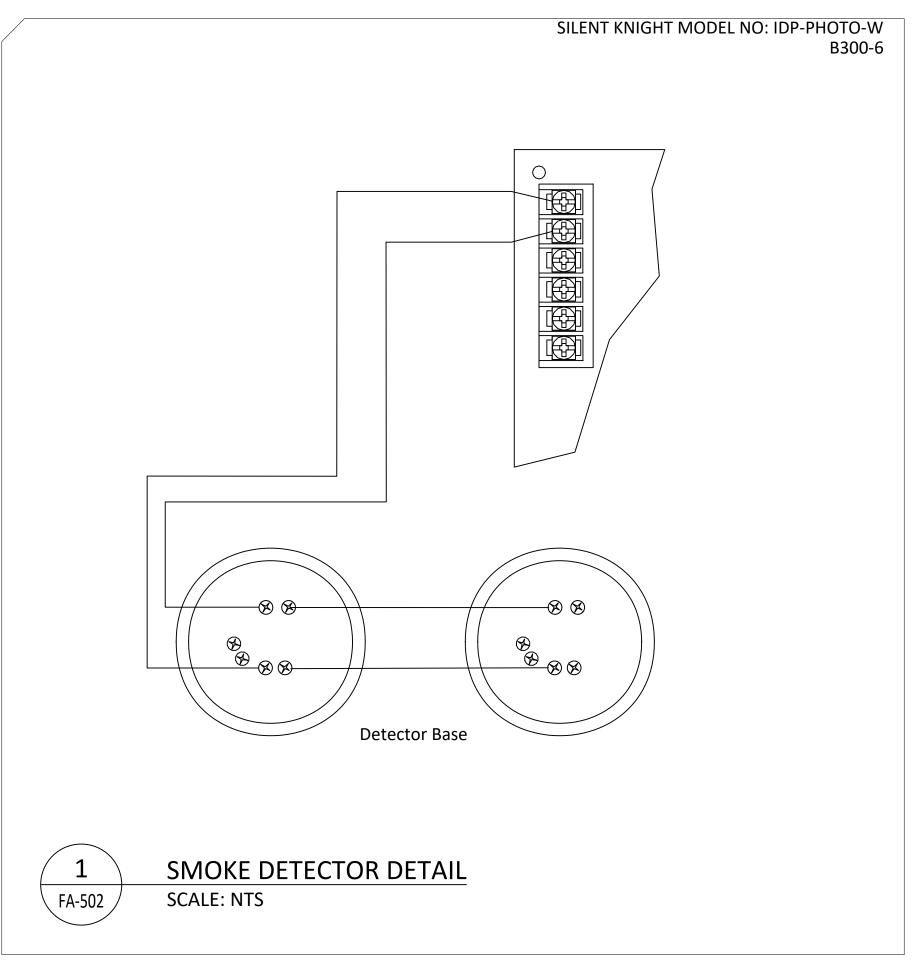

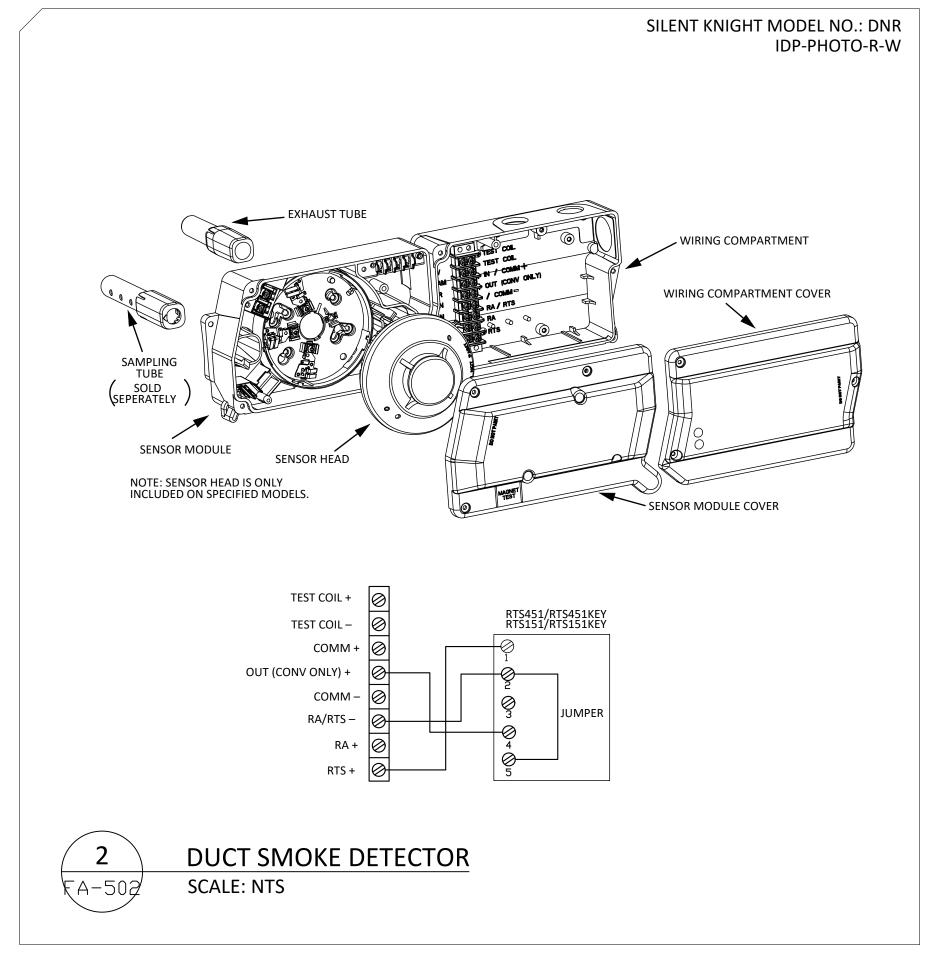

PRELIMINARY



EVERGREEN FIRE AND SECURITY 2111 SOUTH 90TH STREET TACOMA, WA. 98444 253-627-3794

		NICET CERTIFICATION INFO
	NICET #	114223
	LEVEL	IV
	SUB-FIELD	FIRE ALARMS
	EXPIRATION DATE	08/01/23
	NAME	BRIAN LINDBO
1 II	•	<u> </u>

GENERAL NOTES

REVISIONS/NOTES

REVISION

CAD/DESIGN

DESIGNED BY:
DRAWN BY:
CHECKED BY:
CREATION DATE:
DRAWING SCALE:
DOB DETAILS

B.LINDBO
A.MURPHREE
D.MOLMEN

01/24/2022
VARIES


JOB NAME


STEP BY STEP GATEWAY


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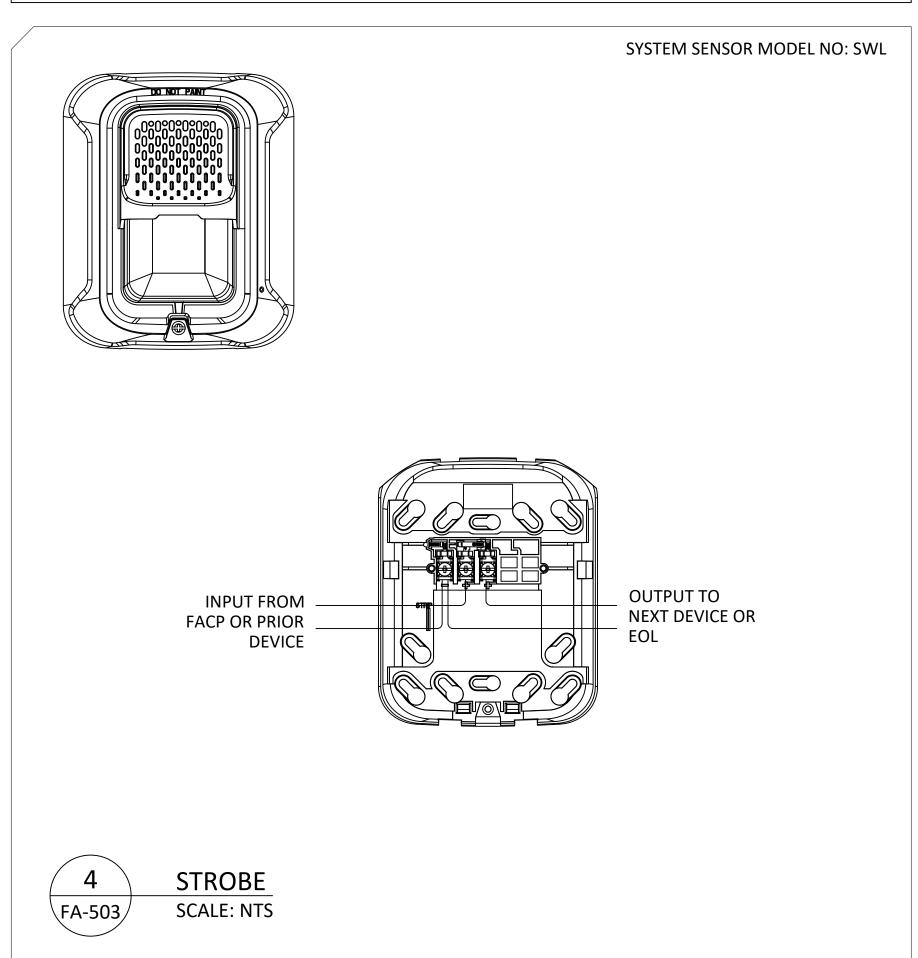
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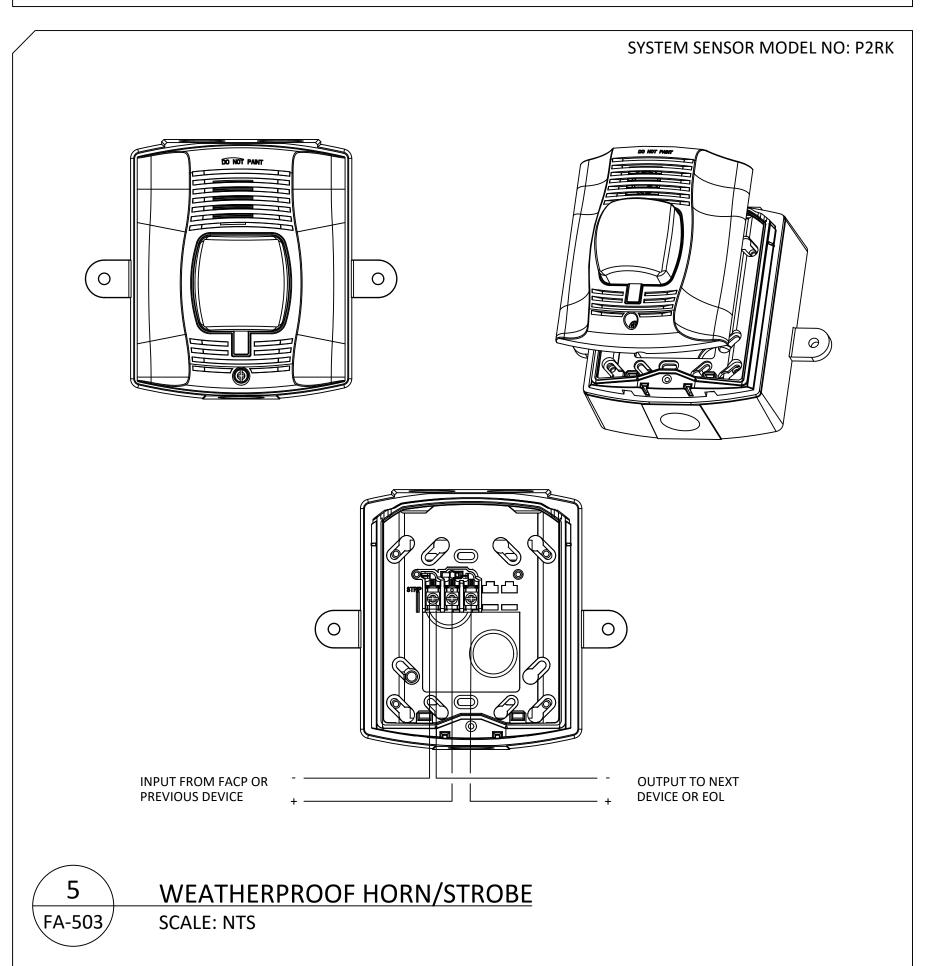
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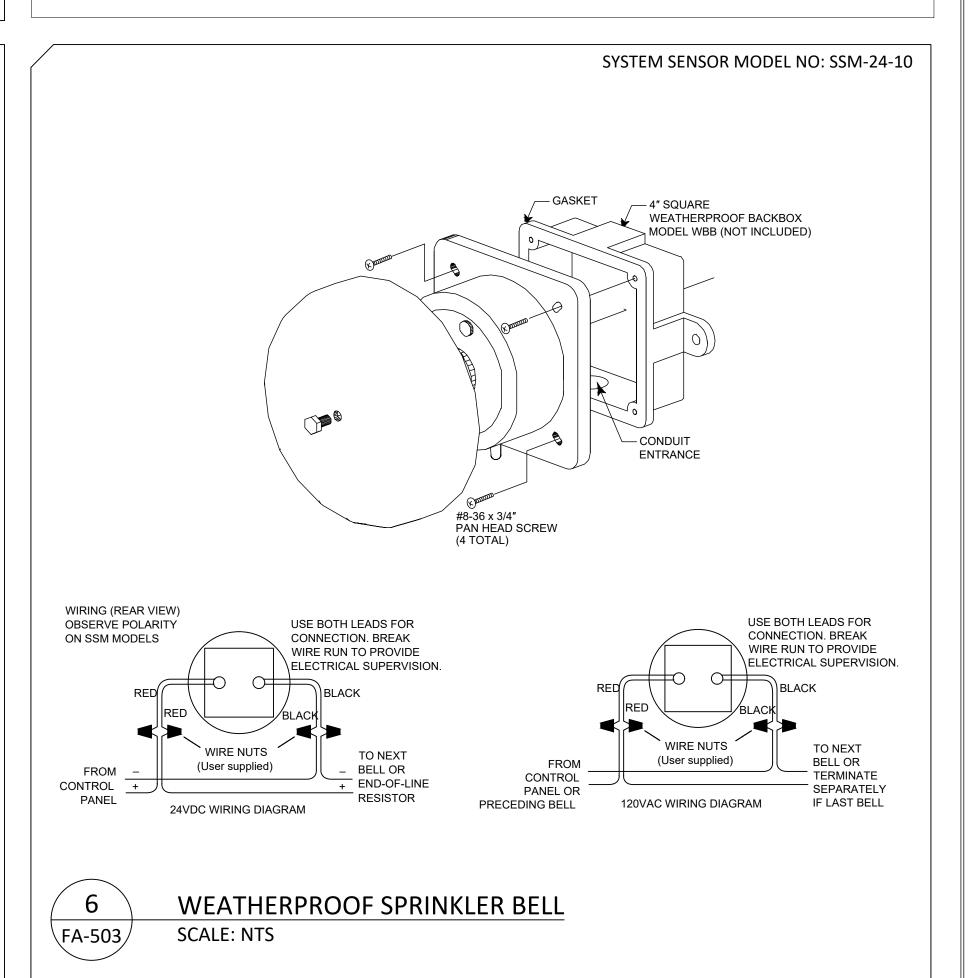







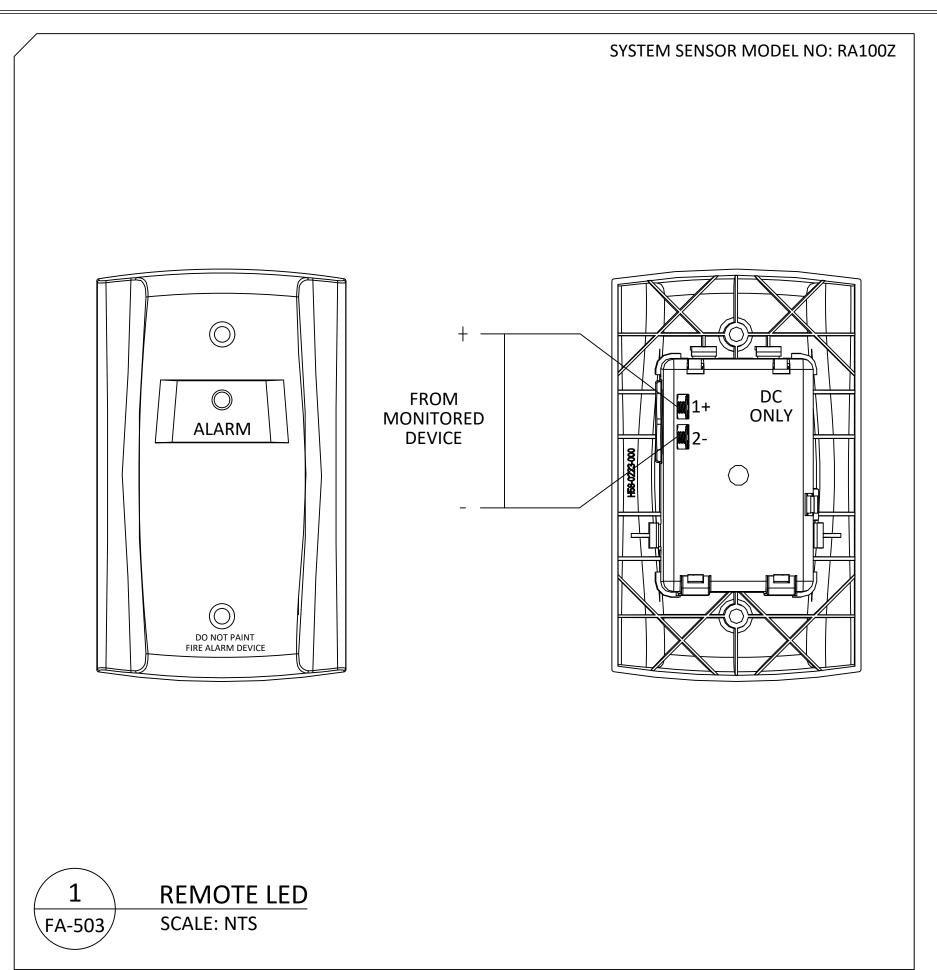

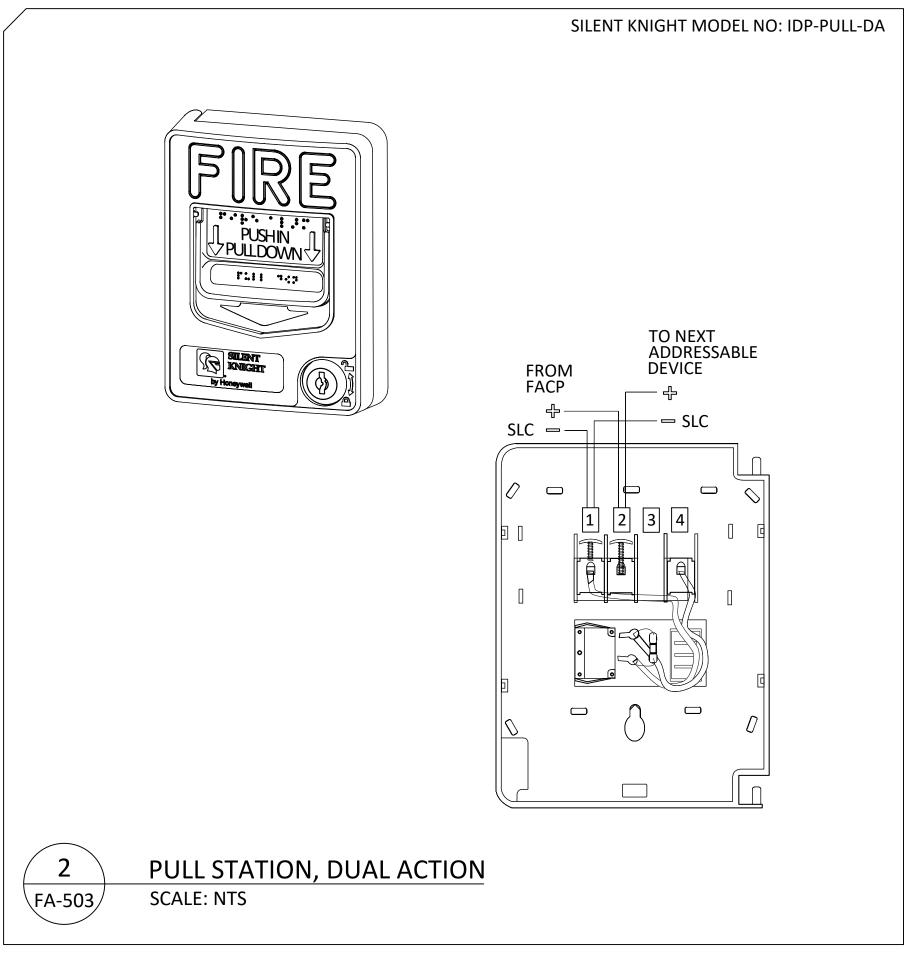

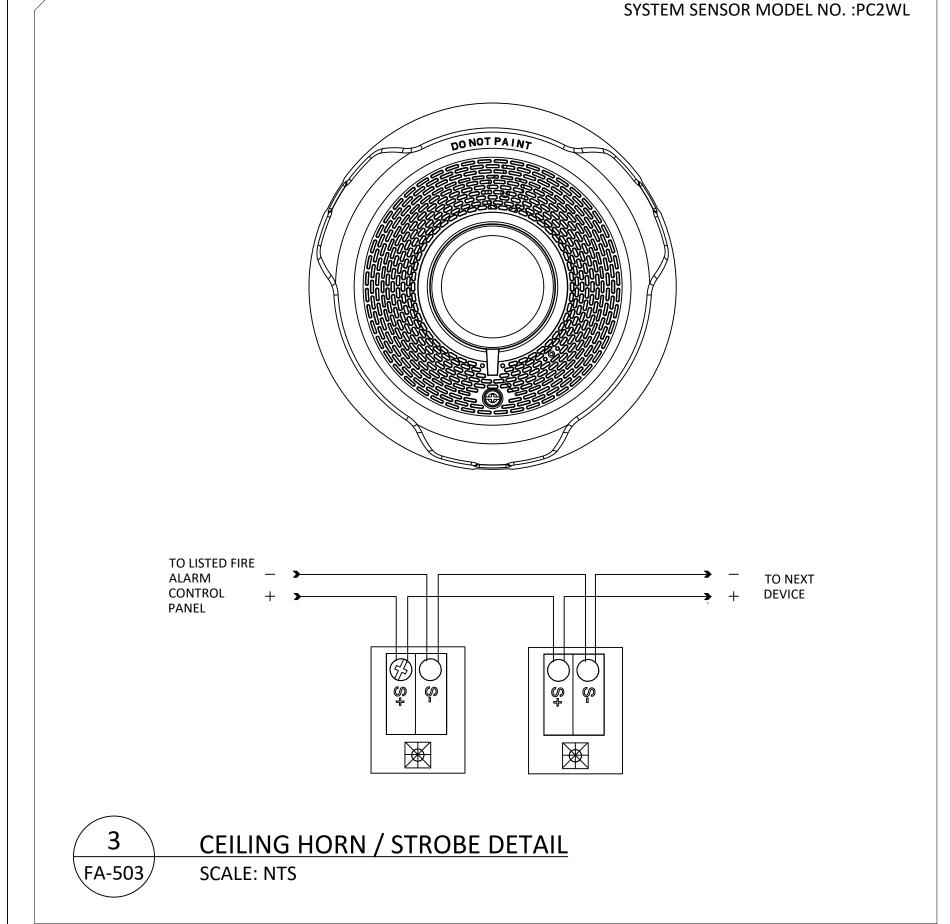

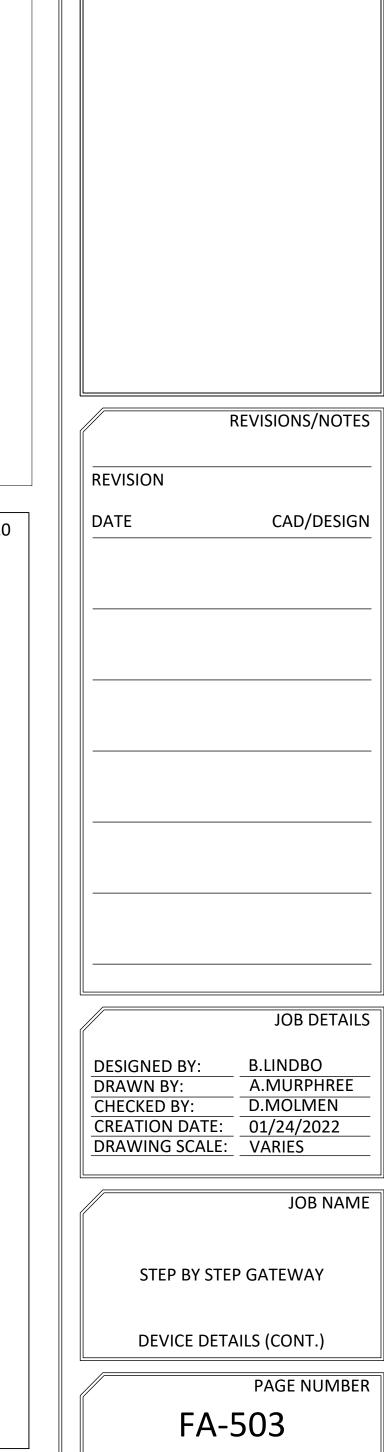

08 OF

Evergreen FIRE AND SECURITY

NICET CERTIFICATION INFO

114223

FIRE ALARMS

GENERAL NOTES

08/01/23 BRIAN LINDBO

EVERGREEN FIRE AND SECURITY 2111 SOUTH 90TH STREET TACOMA, WA. 98444 253-627-3794


NICET #

EXPIRATION DATE

LEVEL SUB-FIELD

DEVICE DETAILS (CONT.)

PRELIMINARY

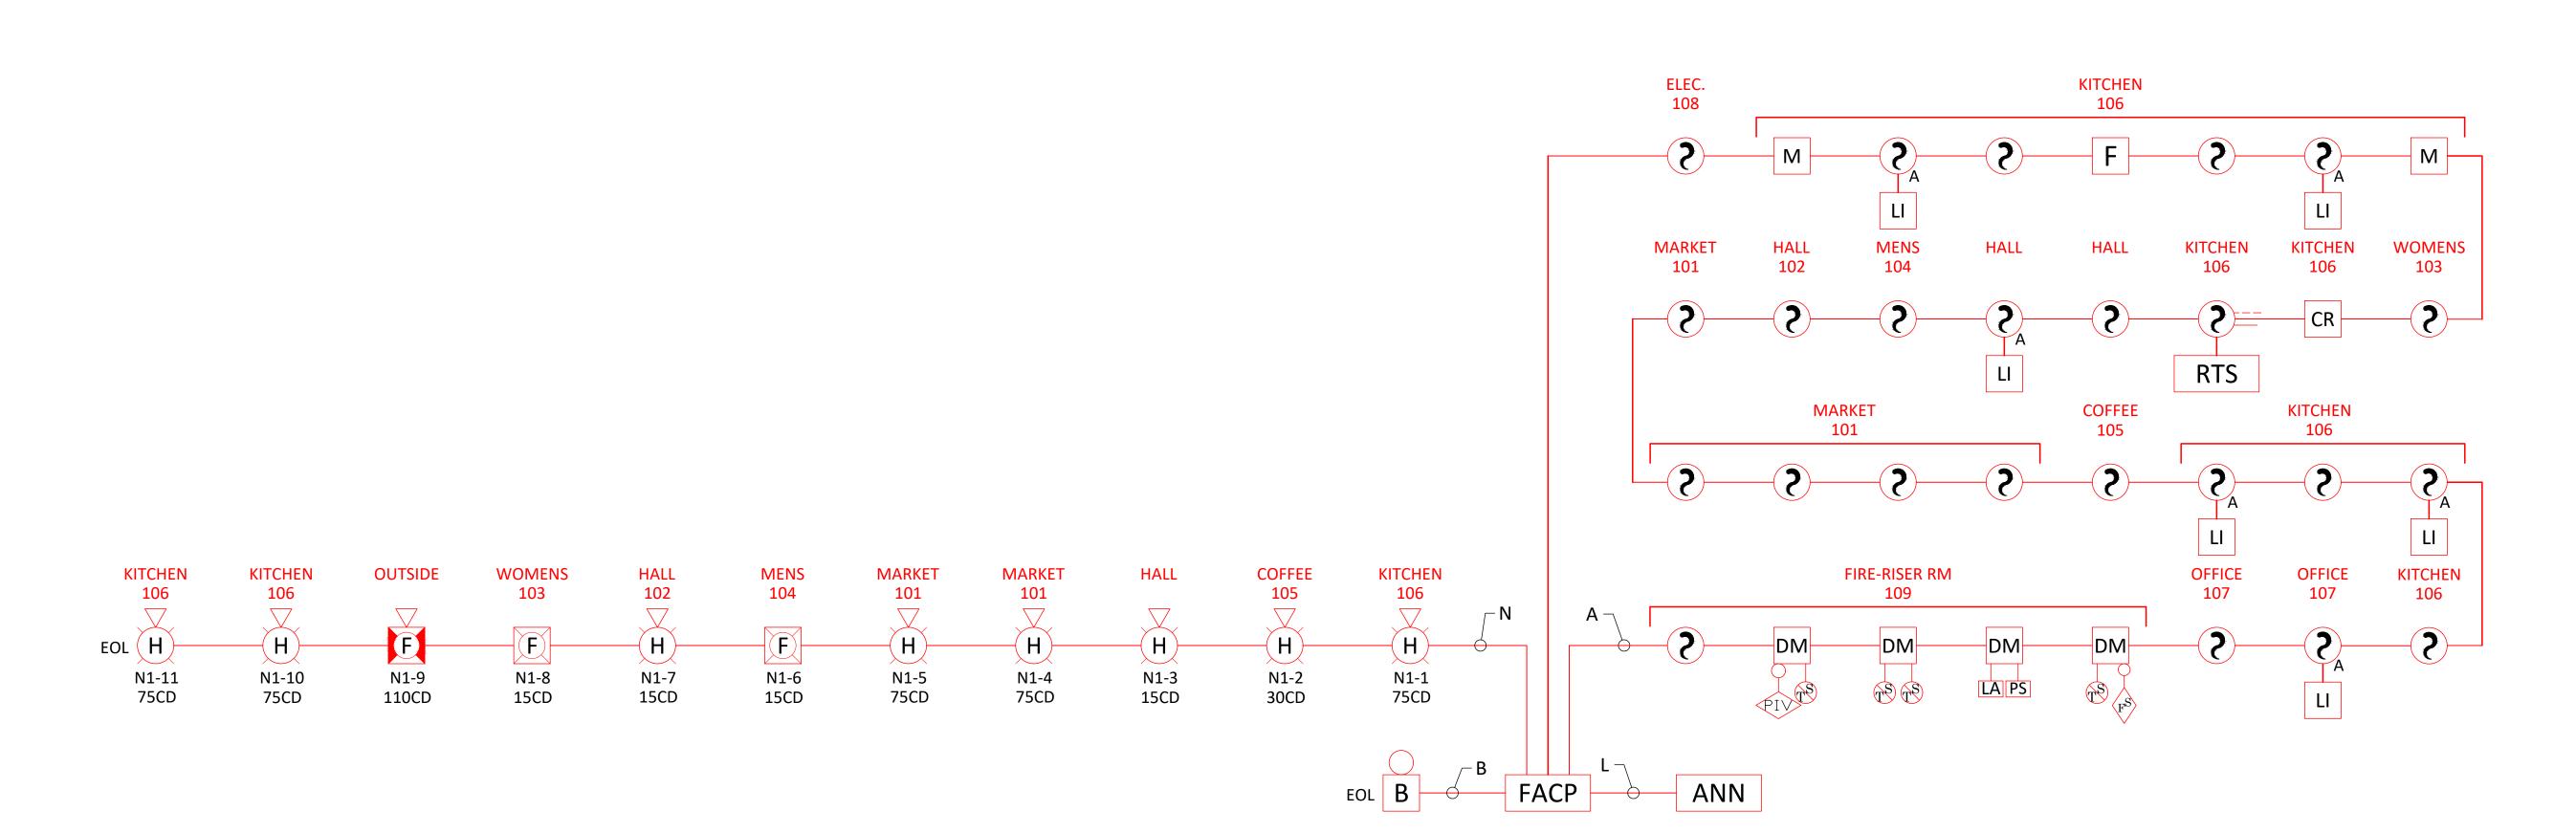

Evergreen FIRE AND SECURITY

EVERGREEN FIRE AND SECURITY 2111 SOUTH 90TH STREET TACOMA, WA. 98444 253-627-3794

- 1		
		NICET CERTIFICATION INFO
	NICET #	114223
	LEVEL	IV
	SUB-FIELD	FIRE ALARMS
	EXPIRATION DATE	08/01/23
	NAME	BRIAN LINDBO
	 	

GENERAL NOTES

/	REVISIONS/NOTES
EVISION	
NATE	CAD/DESIGN
OATE	CAD/DESIGN
/	JOB DETAILS
	· · · · · · · · · · · · · · · ·

DESIGNED BY:	B.LINDBO
DRAWN BY:	A.MURPHREE
CHECKED BY:	D.MOLMEN
CREATION DATE:	01/24/2022
DRAWING SCALE:	VARIES

	JOD IV NVIL
STEP BY STEP GATE	EWAY

RISER DIAGRAM

	PAGE NU
F	A-600

____09 OF ___11

AUX FUNCTIONS

EVAC SIGNALS

Evergreen
FIRE AND SECURITY

EVERGREEN FIRE AND SECURITY 2111 SOUTH 90TH STREET TACOMA, WA. 98444 253-627-3794

(NICET CERTIFICATION INFO
	NICET #	114223
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	EXPIRATION DATE	08/01/23
	NAME	BRIAN LINDBO

GENERAL	NOTES

	REVISIONS/NOTES
EVISION	
ATE	CAD/DESIGN

JOB DETAILS

DESIGNED BY:
DRAWN BY:
CHECKED BY:
CREATION DATE:
DRAWING SCALE:
DESIGNED BY:
A.MURPHREE
D.MOLMEN
O1/24/2022
VARIES

JOB NAME

STEP BY STEP GATEWAY

MATRIX


PAGE NUMBER FA-601

____10___OF ___11___

FIRE ALARM SYSTEM OPERATION MATRIX	AUDIO-VISUAL COMMON TROUBLE INDICATION	AUDIO-VISUAL SUPERVISORY INDICATIO	AUDIO-VISUAL GENERAL ALARM	COMMON TROUBLE SIGNAL TO CENTRA	SUPERVISORY SIGNAL TO CENTRAL STA	GENERAL FIRE ALARM TO CENTRAL STATION	SPRINKLER WATER FLOW ALARM TO CENTRAL STATION	FACILITY FIRE EVACUATION AUDIO-VISU SIGNAL	EXTERIOR WATER FLOW BELL	ILLUMINATE REMOTE LED	SHUT DOWN HVAC FANS
FIRE ALARMS											
MANUAL FIRE ALARM PULL STATION			X			Х		Х			
WATER FLOW			Х				Х	Х	Х		
ABOVE CEILING SMOKE DETECTORS			Х			Х		Х		Х	
SMOKE DETECTORS			Х			Х		Х			
PRESSURE SWITCH			Х				Х	Х	Х		
SUPERVISORY SIGNALS											
DUCT SMOKE DETECTOR		Х			Х						Х
SPRINKLER SUPERVISORY VALVE		Х			Х						
PIV		Х			Х						
LOW AIR		Х			Х						
TROUBLE CONDITIONS											
FACP LOW BATTERY VOLTAGE	Χ			X							
FACP CIRCUIT FAULT	Х			Х							
FACP COMPONENT FAILURE	Х			Х							
FACP AC POWER FAILURE	Х			Х							

TRANSMIT SIGNAL TO CENTRAL STATION

ANNUNCIATON AT FACP PANEL

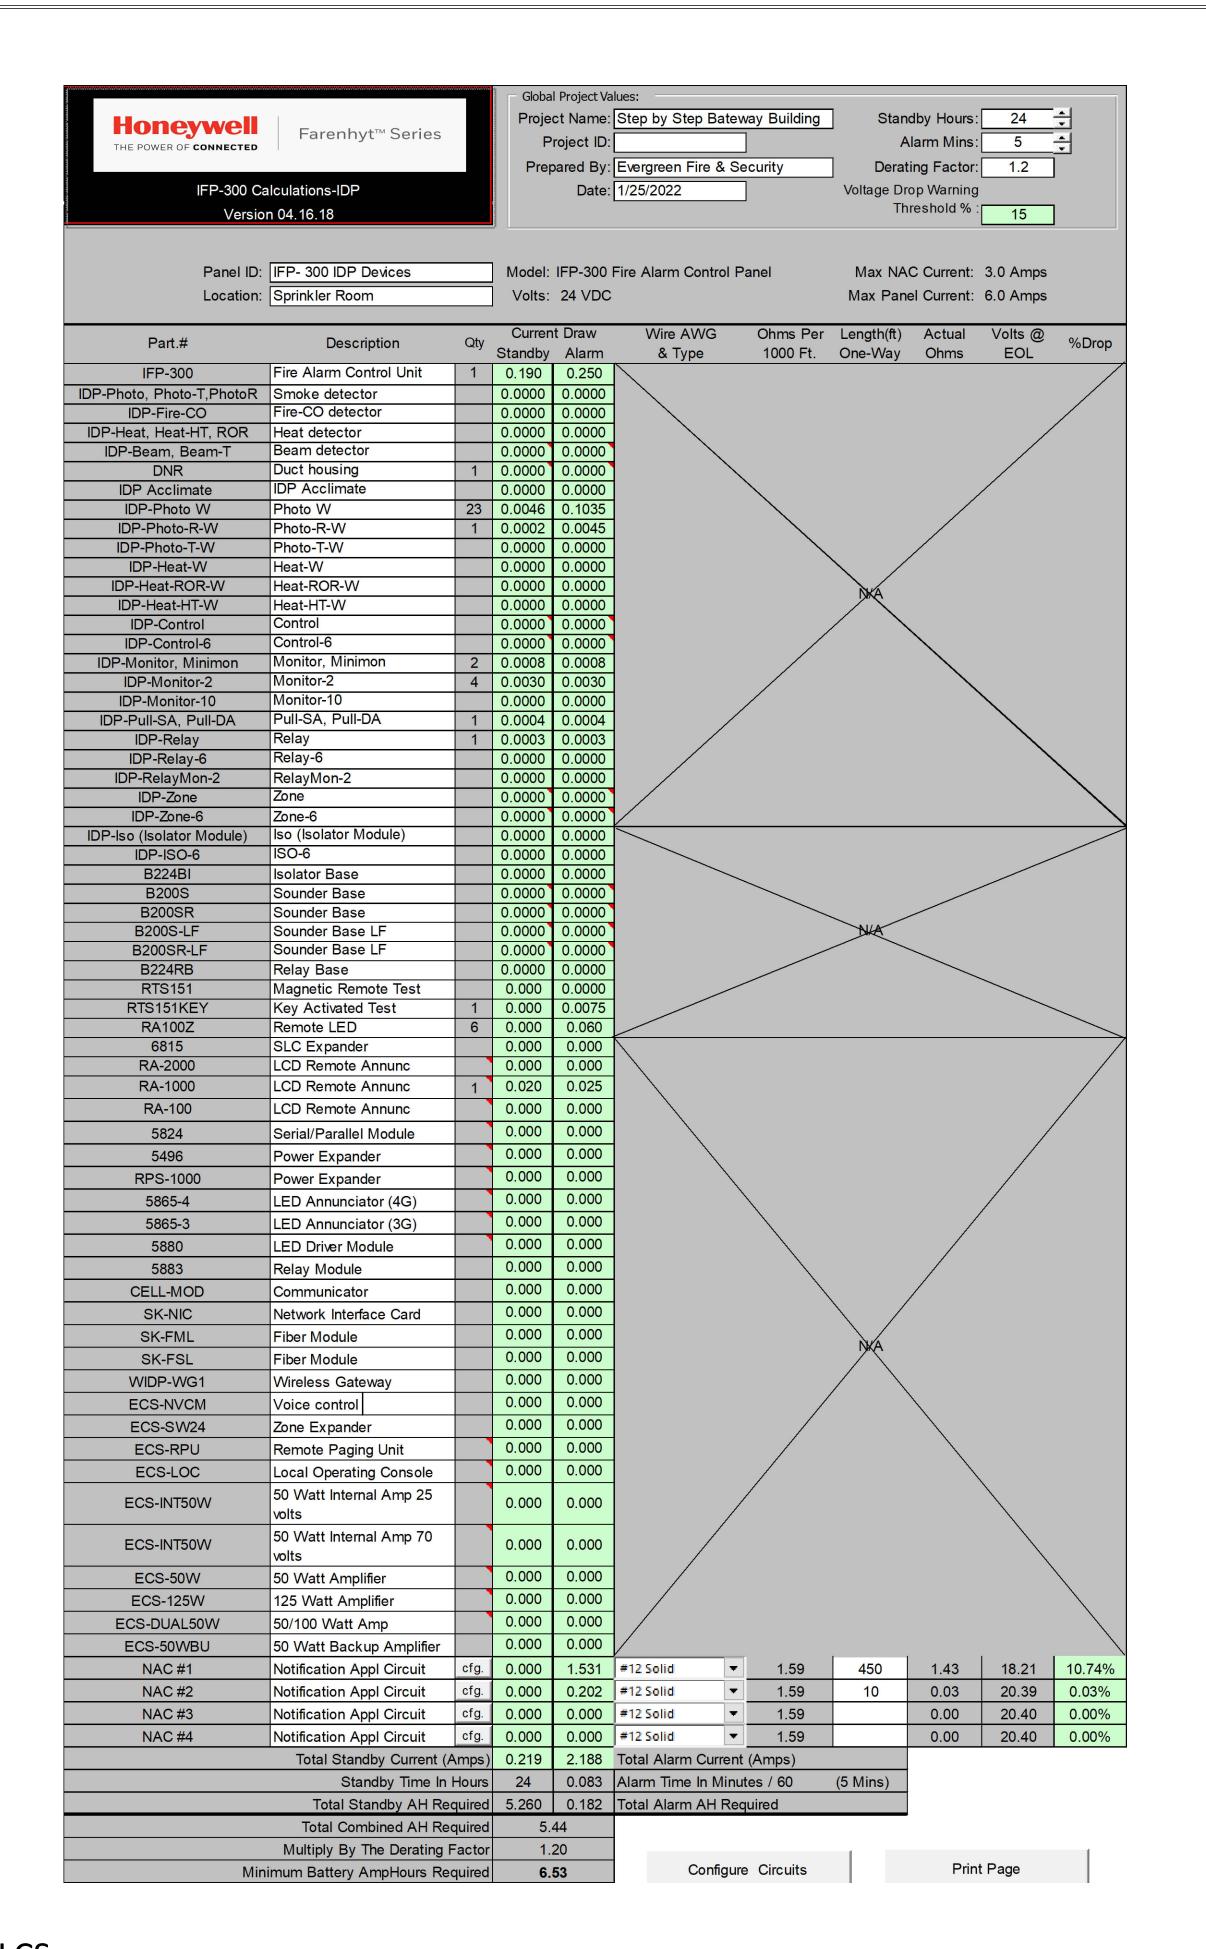

Honeywell THE POWER OF CONNECTED Farenhyt™ Series	Circuit Configuration		Print Circuits Detail
- Project Information Project Name: Step by S Prepared By: Evergreen		Project Da	ID: 0 te: 1/25/2022

e (5cd)		Use:	Notification A		-
		Current Dr	ow Each		
Scd)		Standby	Alarm	Current D Standby	raw Total Alarm
Jean .	▼	0.000	0.066	0.000	0.132
Strobe (15cd)	▼	0.000	0.091	0.000	0.182
Strobe (30cd)	▼ [0.000	0.116	0.000	0.116
Strobe (75cd)	▼	0.000	0.176	0.000	0.880
Strobe (110cd)	▼	0.000	0.221	0.000	0.221
-	-	0.000	0.000	0.000	0.000
-	▼	0.000	0.000	0.000	0.000
				0.000	0.000
			Totals	0.000	1.531
		▼	▼ 0.000		

Ckt. Numb	er: NAC #2			Panel ID:	IFP- 300 IDF	P Devices	
Ckt. Nam	ne: Notification Appl Circu	it		Use:	Notification A	Appl Circuit	-
Qty	De	evice		Current D Standby	raw Each Alarm	Current D Standby	raw Total Alarm
1	System Sensor Water Flo	w Bell	▼	0.000	0.202	0.000	0.202
	Unused		▼	0.000	0.000	0.000	0.000
	Unused		▼	0.000	0.000	0.000	0.000
	Unused		▼	0.000	0.000	0.000	0.000
	Unused		▼	0.000	0.000	0.000	0.000
	Unused		▼	0.000	0.000	0.000	0.000
	Unused		▼	0.000	0.000	0.000	0.000
						0.000	0.000
< F	Return To Main	Edit Device	Da	tabase	Totals	0.000	0.202

Ckt. Number: NAC	; #3			Panel ID:	IFP- 300 IDF	P Devices	
Ckt. Name: Notif	ication Appl Circui	t		Use:	Notification /	Appl Circuit	-
Qty	De	vice		Current D	raw Each	Current D	raw Total
		VIOC		Standby	Alarm	Standby	Alarm
Unus	sed		-	0.000	0.000	0.000	0.000
Unus	sed		-	0.000	0.000	0.000	0.000
Unus	sed		-	0.000	0.000	0.000	0.000
Unus	sed		-	0.000	0.000	0.000	0.000
Unus	sed		-	0.000	0.000	0.000	0.000
Unus	sed		-	0.000	0.000	0.000	0.000
Unus	sed		-	0.000	0.000	0.000	0.000
						0.000	0.000
< Return T		Edit Device			Totals	0.000	0.000

Ckt. Nam	ne: Notification Appl Circu	iit		Use:	Notification	Appl Circuit	▼
Qty	y Device			Current D Standby	Current Draw Each Current Draw Standby Alarm Standby A		
	Unused		•	0.000	0.000	0.000	0.000
	Unused		•	0.000	0.000	0.000	0.000
	Unused		•	0.000	0.000	0.000	0.000
	Unused		•	0.000	0.000	0.000	0.000
	Unused		•	0.000	0.000	0.000	0.000
	Unused		•	0.000	0.000	0.000	0.000
	Unused		•	0.000	0.000	0.000	0.000
						0.000	0.000
	Return To Main	Edit Device	Do	toboso	Totals	0.000	0.000

Evergreen FIRE AND SECURITY

EVERGREEN FIRE AND SECURITY 2111 SOUTH 90TH STREET TACOMA, WA. 98444 253-627-3794

ſ		NICET CERTIFICATION INFO
	NICET #	114223
	LEVEL	IV
	SUB-FIELD	FIRE ALARMS
	EXPIRATION DATE	08/01/23
	NAME	BRIAN LINDBO

GENERAL NOTES

REVISIONS/NOTES

REVISION

DATE CAD/DESIGN

JOB NAME

JOB DETAILS

B.LINDBO

D.MOLMEN

A.MURPHREE

STEP BY STEP GATEWAY

CREATION DATE: 01/24/2022

DRAWING SCALE: VARIES

BATTERY CALCS

DESIGNED BY:

CHECKED BY:

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