







MARK	DATE	DESCRIPTION
	3/19/2021	DESIGN DEVELOPMENT
	4/2/2021	PERMIT SET

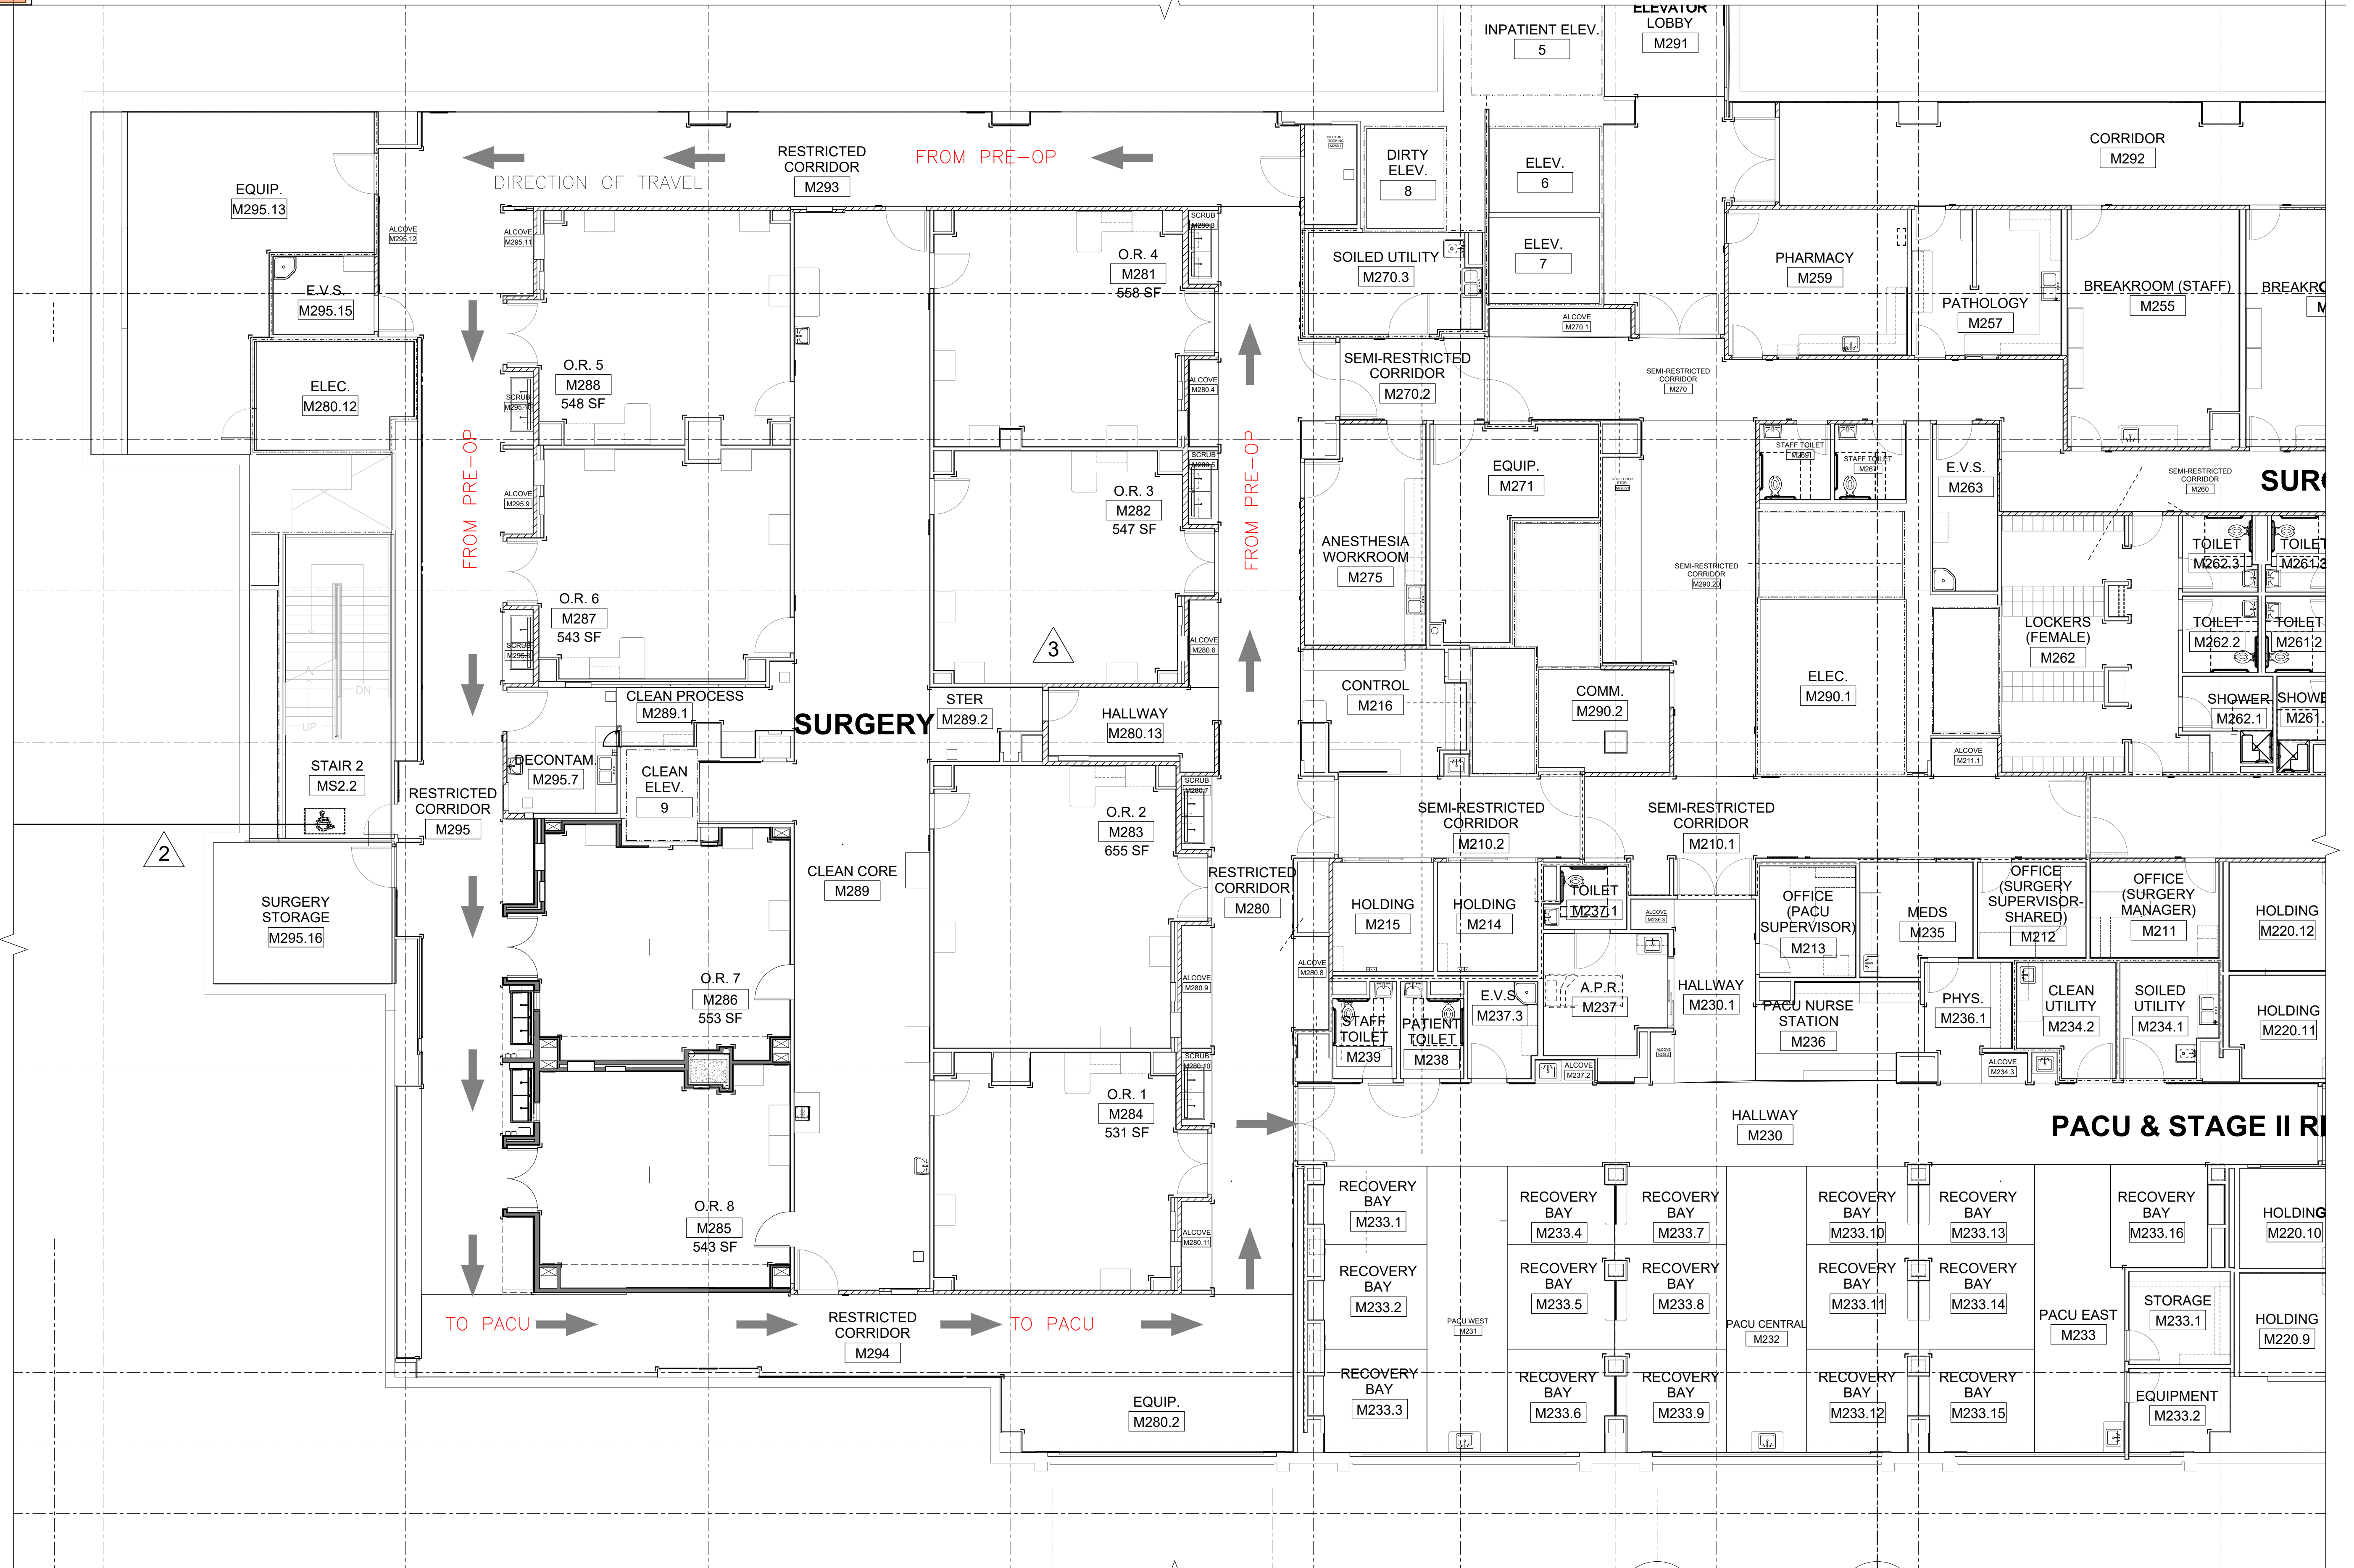

PARTIAL SECOND FLOOR PLAN

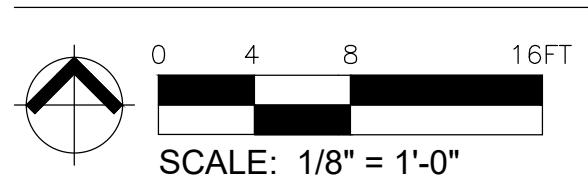


















City of Puyallup  
Development & Permitting  
ISSUED PERMIT

Building Planning  
Engineering Public Works  
Fire Traffic



**DOOR SCHEDULE**

NUMBER	CLASS	NEW	SIZE	THICKNESS	TYPE	MATERIAL	FINISH	FRAME			DETAIL			GLAZING		FIRE RATING	LEAD SHIELDING	HARDWARE SCHEDULE										NOTES	
								TYPE	MATERIAL	FINISH	HEAD	JAMB	THRESHOLD	TYPE	RATING			HINGES	LOCK	CYLINDER	CLOSER	WALL STOP	OVERHEAD STOP	GASKETING	PANIC	KICKPLATE	MAGNETIC HOLD-OPEN		FINISH
M285.1		NEW	6'-0" X 7'-0"	1 3/4"	B	SC	PL	F-2	HM	MP	2/A7.1	2/A7.0 SIM	-	GL3	NR	NR	Y	6	N	N	Y	Y	N	N	N	Y	N	DC	1, 2, 3, 4, 5, 6
M285.2		NEW	3'-0" X 7'-0"	1 3/4"	A	SC	PL	F-1	HM	MP	2/A7.1	2/A7.0 SIM	-	GL3	NR	NR	Y	3	N	N	Y	Y	N	N	N	Y	N	DC	1, 3, 4, 5, 6
M286.1		NEW	6'-0" X 7'-0"	1 3/4"	B	SC	PL	F-2	HM	MP	2/A7.1	2/A7.0 SIM	-	GL3	NR	NR	Y	6	N	N	Y	Y	N	N	N	Y	N	DC	1, 2, 3, 4, 5, 6
M286.2		NEW	3'-0" X 7'-0"	1 3/4"	A	SC	PL	F-1	HM	MP	2/A7.1	2/A7.0 SIM	-	GL3	NR	NR	Y	3	N	N	Y	Y	N	N	N	Y	N	DC	1, 3, 4, 5, 6


**DOOR TYPES**

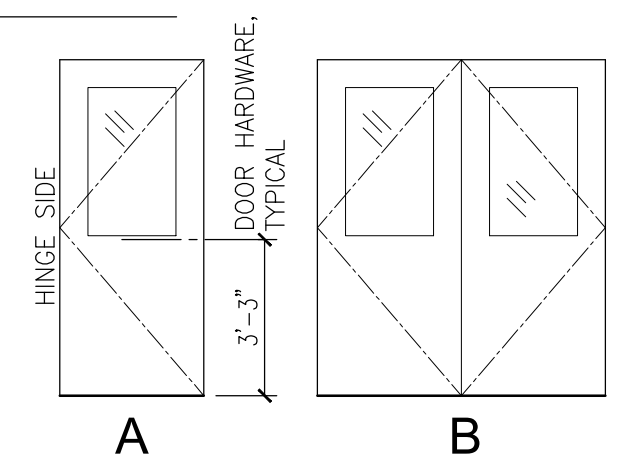

**DOOR FRAMES**

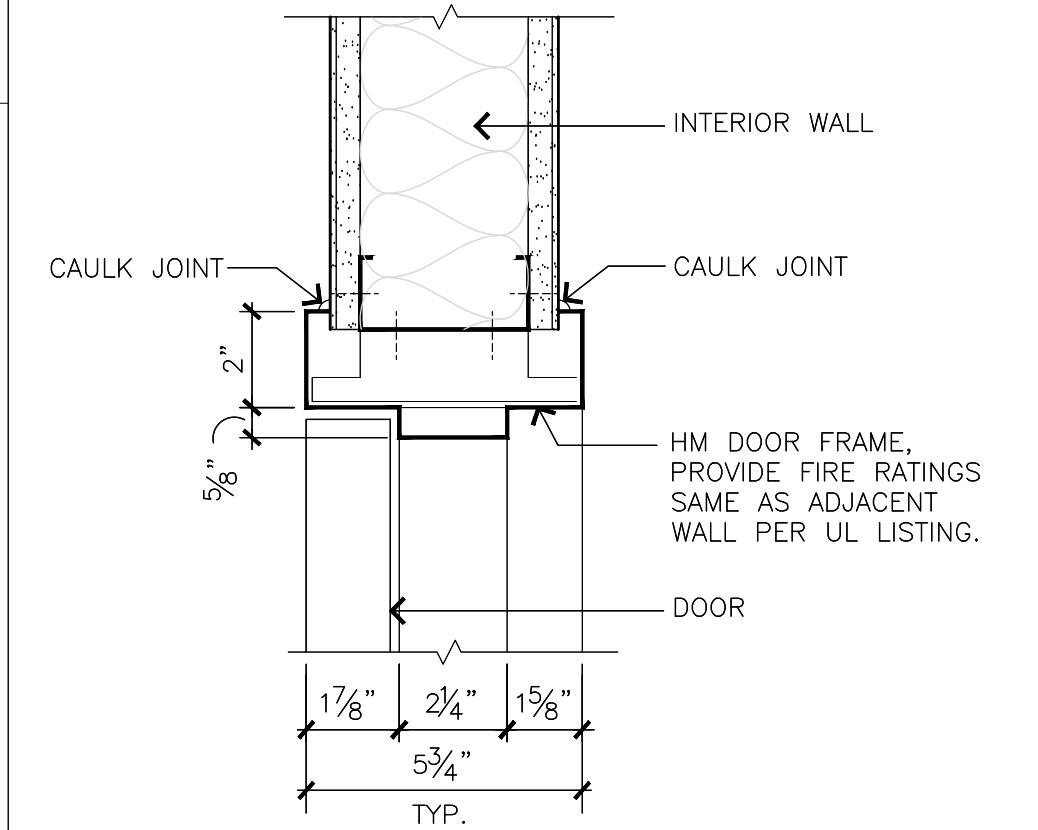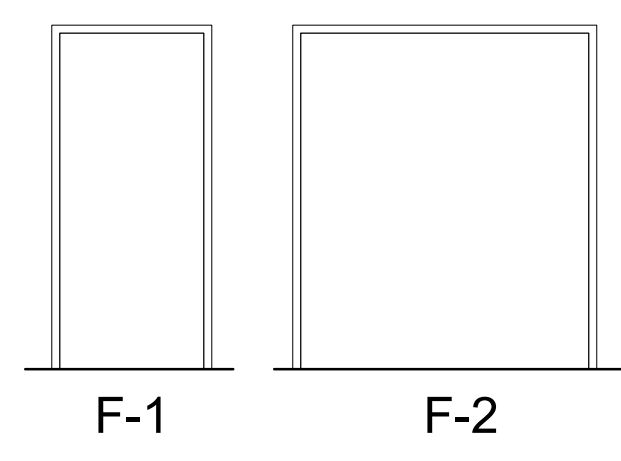

**2 DOOR - HEAD**  
SCALE: 3" = 1'-0"

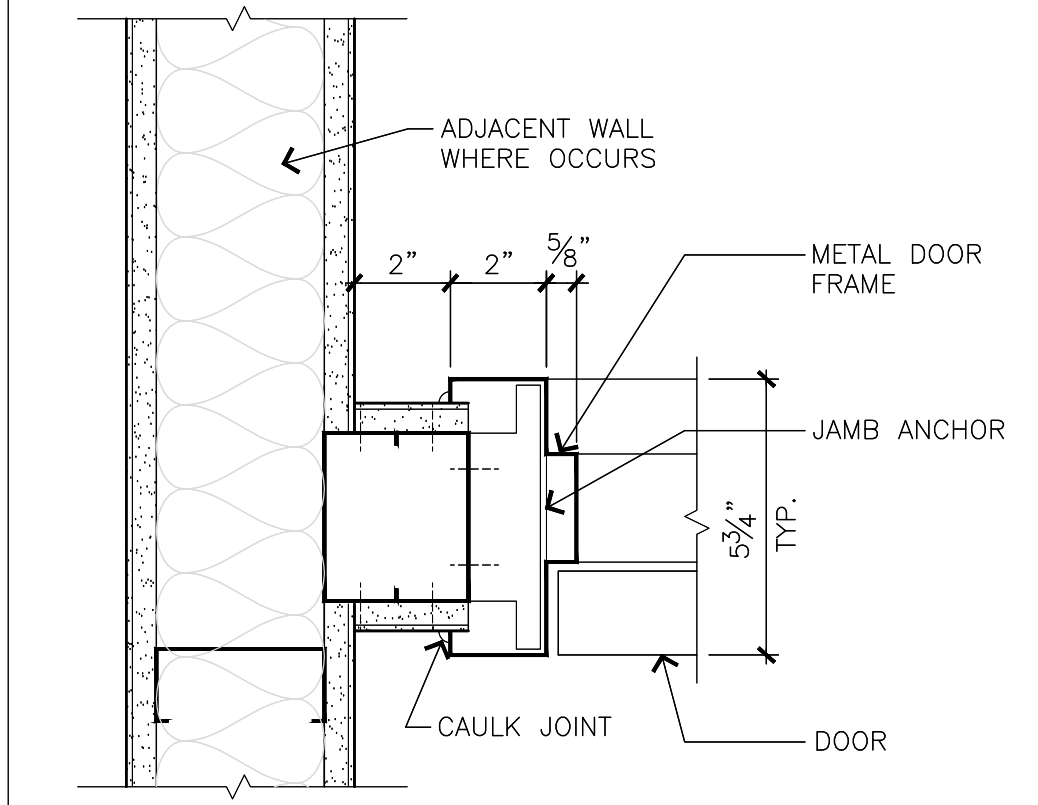

**1 DOOR - JAMB**  
SCALE: 3" = 1'-0"

**GENERAL NOTES**

- ALL DOORS TO BE 1 3/4" THICK, UNLESS NOTED OTHERWISE.
- DOOR GLAZING COLUMN REFERS TO DOOR, SIDELIGHT AND TRANSOM.
- LABEL COLUMN NUMBER INDICATES THE RATING IN MINUTES, UNLESS NOTED OTHERWISE.
- GLAZING DIMENSIONS FOR DOOR TYPES ARE TO INSIDE OF FRAME (CLEAR GLAZING AREA).
- RELITE GLAZING AND STOP TO OCCUR ON CORRIDOR/HALLWAY SIDE OF FRAME, UNLESS NOTED OTHERWISE.
- STRIKE JAMB DETAIL IS SIMILAR TO HINGE JAMB DETAIL, UNLESS NOTED OTHERWISE.
- VERIFY WALL CONSTRUCTION FOR FRAME DEPTH.
- ALL DOOR HARDWARE SHOULD COMPLY WITH 'ADA' REQUIREMENTS. SEE SPEC FOR HARDWARE SET INFORMATION.
- VERIFY EXISTING WALL CONSTRUCTION FOR FRAME DEPTHS.
- DOOR HARDWARE TO MATCH EXISTING.

**CODED NOTES**

- NEW DOORS TO BE FINISHED TO MATCH DOORS OF SURGICAL DEPARTMENT.
- CARD READER AND ELECTRIC DOOR STRIKE (SEE ELECTRICAL)
- SEE DETAIL 19/A8.1 FOR MANEUVERING CLEARANCES AT DOORS.
- SEE RADIATION SHIELDING REPORT FOR REQUIRED LEAD THICKNESS
- PROVIDE PIVOT SET HINGES IN LEAD SHIELDED DOORS - ARCHITECTURAL BUILDERS HARDWARE MFG. ITEM #L0147, OR APPROVED EQUAL.
- PROVIDE DOOR PROTECTION, EACH SIDE OF DOOR

**LEGEND**

GENERAL:	N	NO	GLAZING:	CW	CLEAR WIRE
	N/A	NOT APPLICABLE		CT	CLEAR TEMPERED
	Y	YES		TT	TINTED TEMPERED
THICKNESS:	TYPICAL	ALL DOORS 1 3/4" UNLESS OTHERWISE INDICATED		FL	FIRELITE
	BM	BY MANUFACTURER		VC	VISION CONTROL (INTEGRAL BLINDS)
	O	THICKNESS TO MATCH EXIST. FRAME (VERIFY)		LC	LEAD SHIELDING
MATERIAL:	SC	SOLID CORE WOOD (TYPICAL)	FIRE RATING:	20, 60, 90	MIN. 1, 1 1/2 HOUR, ETC. - INDICATES LABEL
	HM	HOLLOW METAL	FRAME:	HM	HOLLOW METAL
	AG	ALUMINUM AND GLASS		AL	ALUMINUM
	WV	WOOD PANEL/VINYL		S	STEEL
FINISH:	PL	PLASTIC LAMINATE		BM	BY MANUFACTURER
	MP	METAL, PAINTED		O	EXISTING FRAME TO REMAIN. PAINT TO MATCH ADJACENT WALL.
	AA	ANODIZED ALUMINUM, MILL FINISH		WD	WOOD, PAINTED
	BM	BY MANUFACTURER	HARDWARE:	DC	DULL CHROME
	NF	NATURAL FINISH (SYNTHETIC)			
	WS	WOOD, STAINED (TYPICAL)			

**FINISH SCHEDULE**

ROOM NO.	ROOM NAME	FLOORING		BASE		NORTH WALL			EAST WALL			SOUTH WALL			WEST WALL			CEILING			CODED NOTES	P-LAM	WAINSCOT	ROOM NO.	
		MATL	FIN	CLR	FIN	CLR	MATL	FIN	CLR	MATL	FIN	CLR	MATL	FIN	CLR	MATL	FIN	HEIGHT							
M285	OPERATING ROOM #8	(E)CONC	SV	SV1	ICB	SV1	(E)GWB	PT	P1	(E)GWB	PT	P1	(E)GWB	PT	P1	GWB	PT	P1	ACT	FF	9'-6"	(1)(2)	-	WC-1	M285
M286	OPERATING ROOM #7	(E)CONC	SV	SV1	ICB	SV1	(E)GWB	PT	P1	(E)GWB	PT	P1	(E)GWB	PT	P1	GWB	PT	P1	ACT	FF	9'-6"	(1)(2)	-	WC-1	M286
M294	CORRIDOR	(E)CONC	SV	SV2	RB	RB1	(E)GWB	PT	P1	(E)GWB	PT	P1	(E)GWB	PT	P1	(E)GWB	PT	P1	ACT	FF	8'-0"	(1)	-	-	M294
M295	CORRIDOR	(E)CONC	SV	SV2	RB	RB1	(E)GWB	PT	P1	(E)GWB	PT	P1	(E)GWB	PT	P1	(E)GWB	PT	P1	ACT	FF	8'-0"	(1)	-	-	M295
M295.1	GURNEY ALCOVE	(E)CONC	SV	SV2	RB	RB1	(E)GWB	PT	P1	(E)GWB	PT	P1	(E)GWB	PT	P1	(E)GWB	PT	P1	ACT	FF	8'-0"	(1)(2)	-	-	M295.1
M295.3	SCRUB AREA	(E)CONC	SV	SV2	RB	RB1	(E)GWB	PT	P1	(E)GWB	PT	P1	(E)GWB	PT	P1	(E)GWB	PT	P1	ACT	FF	8'-0"	(1)(2)	-	WC-1	M295.3
M295.4	SCRUB AREA	(E)CONC	SV	SV2	RB	RB1	(E)GWB	PT	P1	(E)GWB	PT	P1	(E)GWB	PT	P1	(E)GWB	PT	P1	ACT	FF	8'-0"	(1)(2)	-	-	M295.4
M295.6	GURNEY ALCOVE	(E)CONC	SV	SV2	RB	RB1	(E)GWB	PT	P1	(E)GWB	PT	P1	(E)GWB	PT	P1	(E)GWB	PT	P1	ACT	FF	8'-0"	(1)(2)	-	-	M295.6

**GENERAL NOTES**

- AN ASTERISK (\*) IN THE FINISH SCHEDULE REFERENCES CODED NOTES IN THE REMARKS COLUMN.
- ALL FLOORING / COLOR TRANSITIONS, WHERE REQUIRED, SHALL BE CENTERED UNDER DOOR.
- PAINT ALL INTERIOR MECHANICAL LOUVERS, WHERE EXPOSED, TO MATCH ADJACENT SURFACE, UNLESS NOTED OTHERWISE.
- SEE REFLECTED CEILING PLAN FOR CEILING FINISH INFORMATION.
- PAINT ALL DOOR AND RELITE FRAMES, NEW AND EXISTING, UNLESS NOTED OTHERWISE.
- SEE INTERIOR ELEVATIONS FOR FINISHES ON WALLS WITH MULTIPLE FINISHES.
- SEE INTERIOR ELEVATIONS, REFLECTED CEILING PLAN, AND INTERIOR DESIGN MATERIALS PLAN FOR EXTENT AND LOCATION OF ACCENT PAINT COLORS.
- FLOORING INSTALLATION TO COORDINATE WITH CASEWORK INSTALLATION.

**CODED NOTES**

- NEW FLOORING
- NEW CEILING

**ABBREVIATIONS**

ADJ	ADJUSTABLE	GMU	GLAZED MASONRY UNIT	TB(#)	TACK BOARD (LENGTH)
AC	ACOUSTIC TREATMENT	GYP	GYP GYPSUM WALL BOARD	TBS	TO BE SELECTED
ACC	ACCORDION DOOR	GWB	GYP GYPSUM WALLBOARD	TG	TONGUE & GROOVE CEDAR, STAINED
ACT	ACOUSTICAL CEILING TILE	MATL	MATERIAL	TP	TOILET PARTITION
ADA	AMERICANS WITH DISABILITIES	MDF	MEDIUM DENSITY FIBERBOARD	TYP	TYPICAL
AV	AUDIO/VISUAL	MTL	METAL	UNO	UNLESS NOTED OTHERWISE
AWC	ACOUSTICAL WALLCOVERING	MTL-S	METAL SIDING	UPT	UNGLAZED PORCELAIN TILE
AWP	ACOUSTICAL WALL PANEL	MASN	MASONRY	V	VOLUME
BD	BOARD	NIC	NOT IN CONTRACT	VCT	VINYL COMPOSITION TILE
BRK	BRICK	NTS	NOT TO SCALE	VP	VENEER PLASTER
BROOM	LIGHT BROOM FINISH (CONCRETE)	OC	ON CENTER	VWC	VINYL WALLCOVERING
CAB	CABINET	OP	OPERABLE PARTITION	WB(#)	WHITE BOARD (LENGTH)
CG	CORNER GUARD	PLAM	PLASTIC LAMINATE	WD	WOOD
CLR	COLOR	PL	PLASTIC LAMINATE	WDM	WALK OFF MAT
CK	CORK	PLA	PLASTER	WRGWB	WATER-RESISTANT GYP BD
CMU	CONCRETE MASONRY UNIT	PNL	PANEL		
CNC	CONCRETE	PR(#)	PROJECTION SCREEN (LENGTH)		
CPT	CARPET	PT	PAINT		
CT	CERAMIC TILE	PTD	PAPER TOWEL DISPENSER		
CSV	COVERED SHEET VINYL	PWD	PLYWOOD		
DF	DRINKING FOUNTAIN	RB	RUBBER		
(E)	EXISTING	RB	RUBBER BASE		
EP	EPOXY PAINT	RF	RUBBER FLOORING		
EX-S	EXPOSED STRUCTURE	RC	ROLL-UP CURTAIN		
FF	FACTORY FINISH	SD	LIQUID SOAP DISPENSER		
FIN	FINISH	SEM	SURFACE-MOUNTED ENTRY MAT		
FLR	FLOOR	SF	STOREFRONT		
FRP	FIBERGLASS REINFORCED PLASTIC	SV	SHEET VINYL		

**InSight**  
HealthCare Architecture  
KLanglois@InSightDesignStudio.biz  
12345 Lake City Way NE #2108  
Seattle, WA 98125  
206-601-6645

8466 REGISTERED ARCHITECT  
*Karssea M. Langlois*  
Karssea M. Langlois  
STATE OF WASHINGTON

OWNER:  
**MultiCare Tacoma General Hospital**

PROJECT NAME:  
**OR 7&8 Buildout**


Good Samaritan Hospital  
401 15th Ave SE  
Puyallup, WA 98372

MARK	DATE	DESCRIPTION
	3/19/2021	DESIGN DEVELOPMENT
	4/2/2021	PERMIT SET


PROJECT NO. 31232  
DRAWN BY: K LANGLOIS  
DATE: 2 APRIL 2021  
COPYRIGHT TO:  
InSight Healthcare Architecture

SHEET TITLE:  
**DOOR & FINISH SCHEDULES, DETAILS**


SHEET #:  
**A7.1**

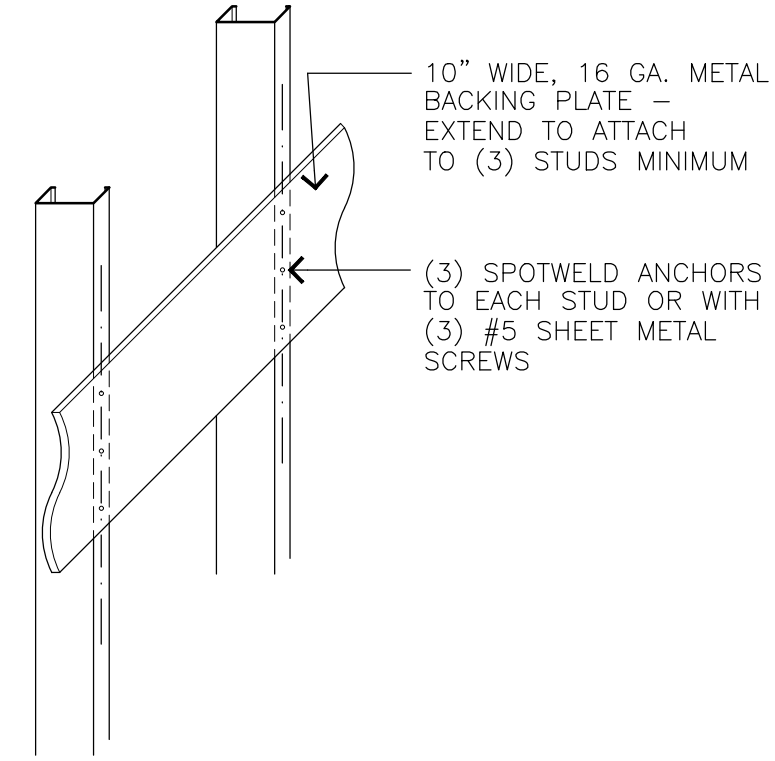


**20** BACKING PLATE  
N.T.S.

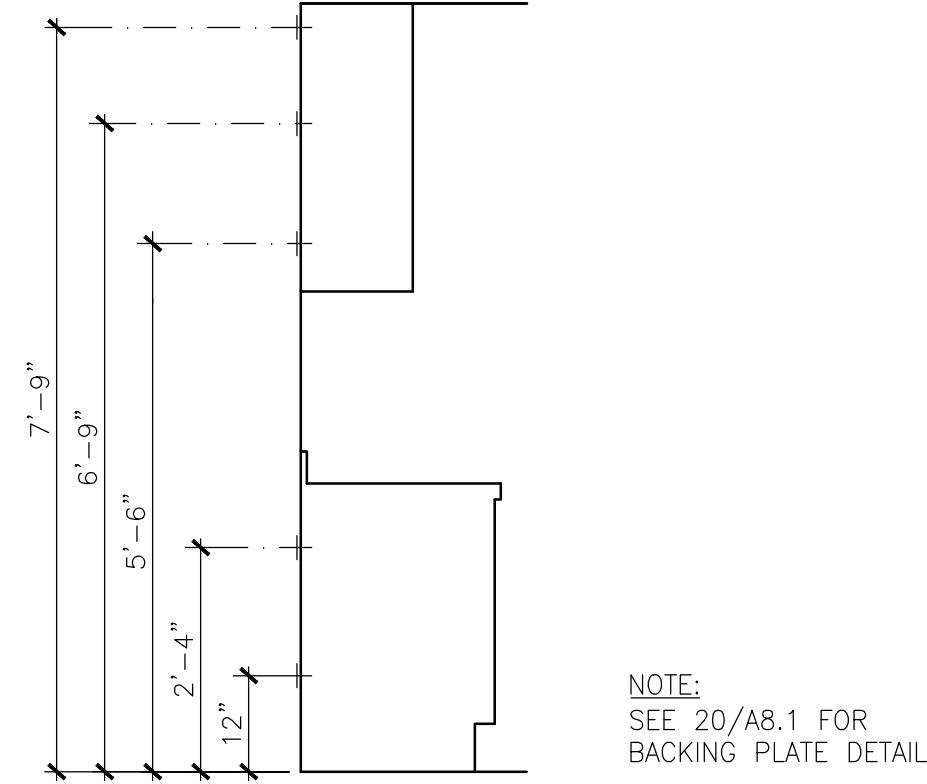

**19** BACKING PLATE HTS. AT CABS.  
SCALE: 1/2" = 1'-0"

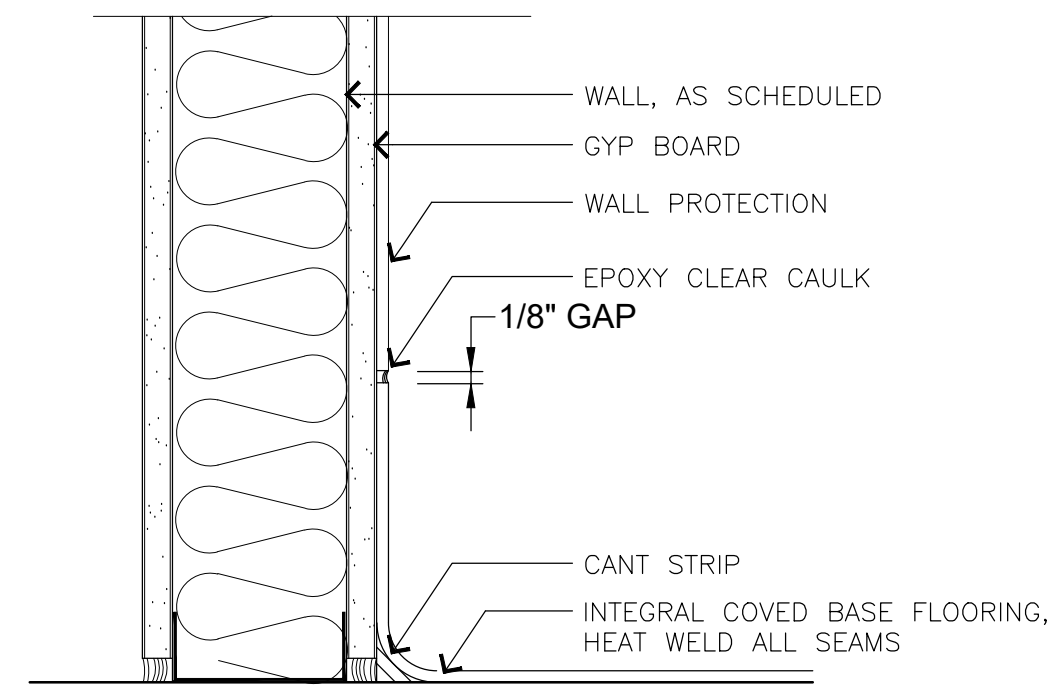

**10** INTEGRAL COVERED BASE  
SCALE: 1-1/2" = 1'-0"

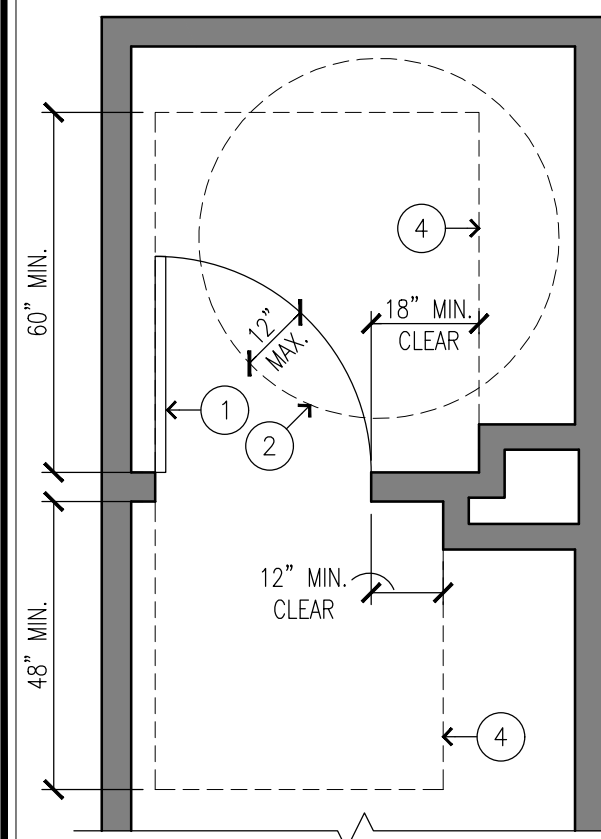


**5** ADA DOOR - MANEUVERING SPACE  
SCALE: 3/8" = 1'-0"

**GENERAL NOTES:**


1. FOR ADDITIONAL INFORMATION REFER TO ANSI A117.1-2003

**KEYED NOTES:**


- ① DOOR SHALL HAVE A MINIMUM CLEAR OPENING WIDTH OF 32" (MEASURED FROM FACE OF DOOR TO OPPOSITE JAMB WHEN DOOR IS IN OPEN POSITION)
- ② 60" DIAMETER TURNING SPACE
- ③ MANEUVERING SPACE: FRONT APPROACH, PULL SIDE
- ④ MANEUVERING SPACE: FRONT APPROACH, PUSH SIDE

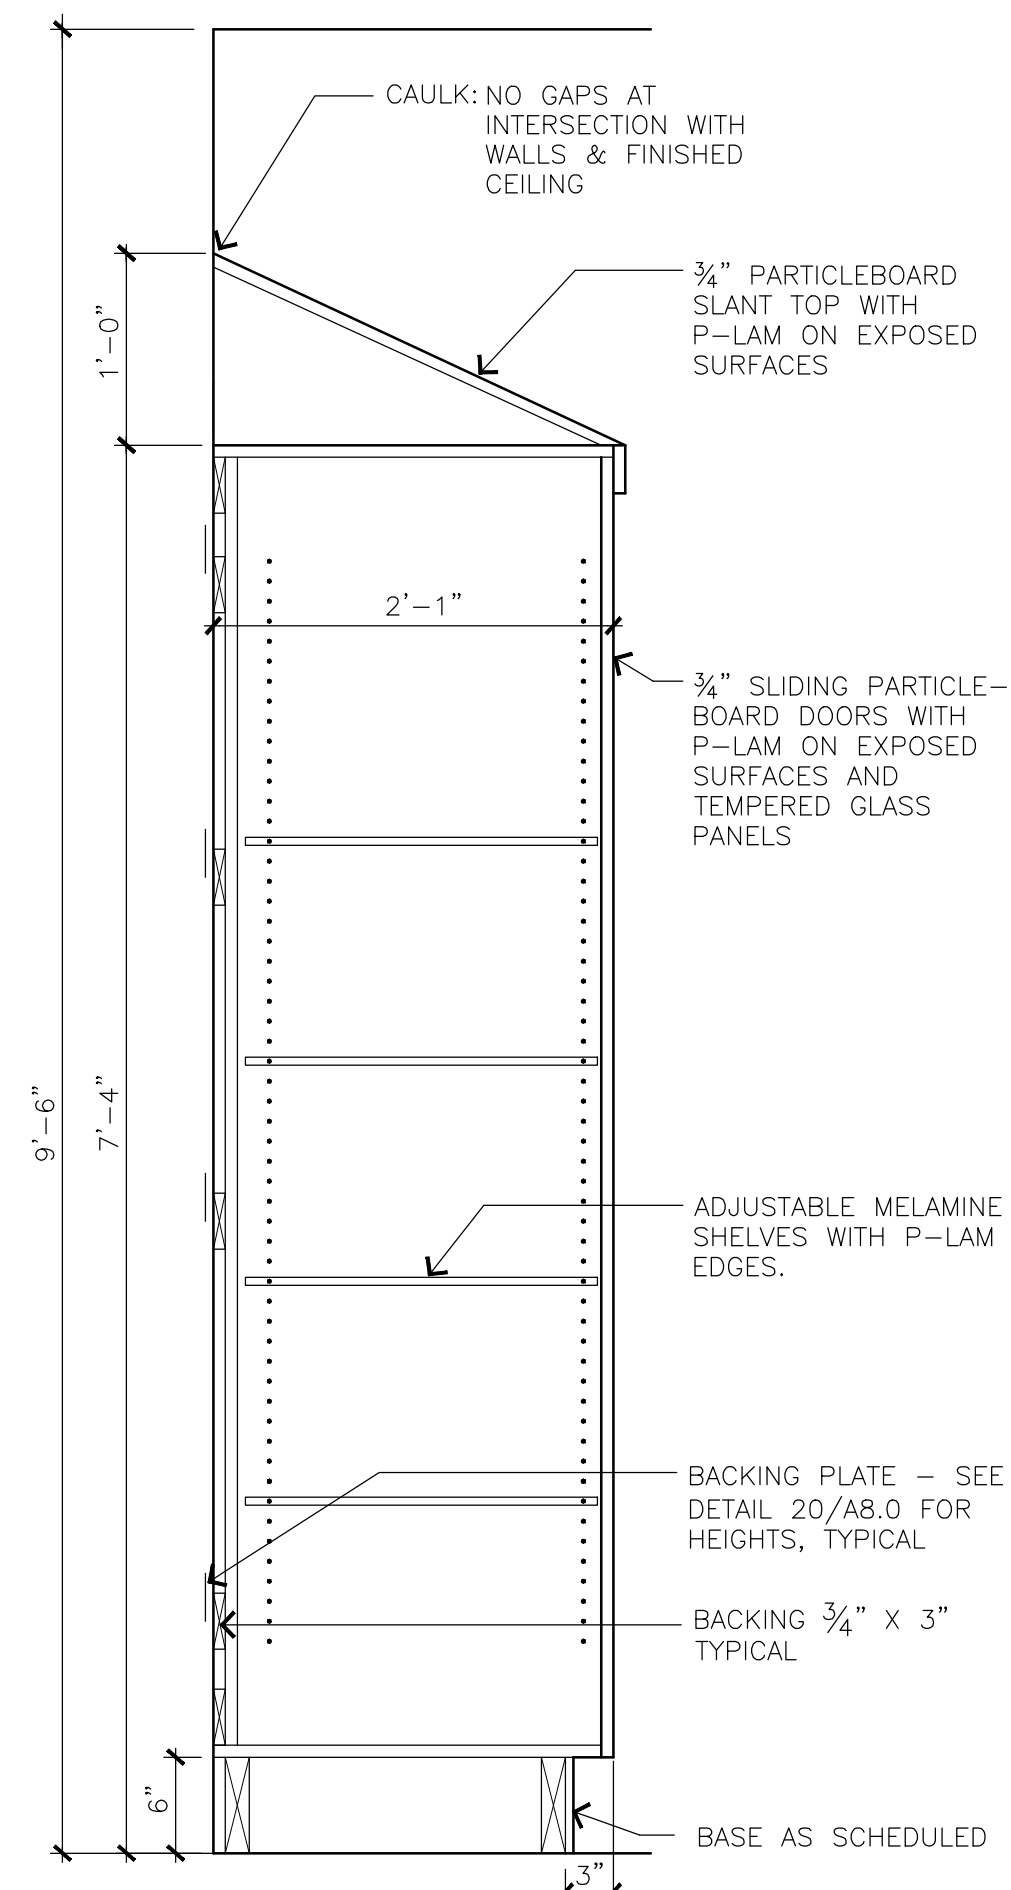


**4** FULL-HT CABINET  
SCALE: 1" = 1'-0"

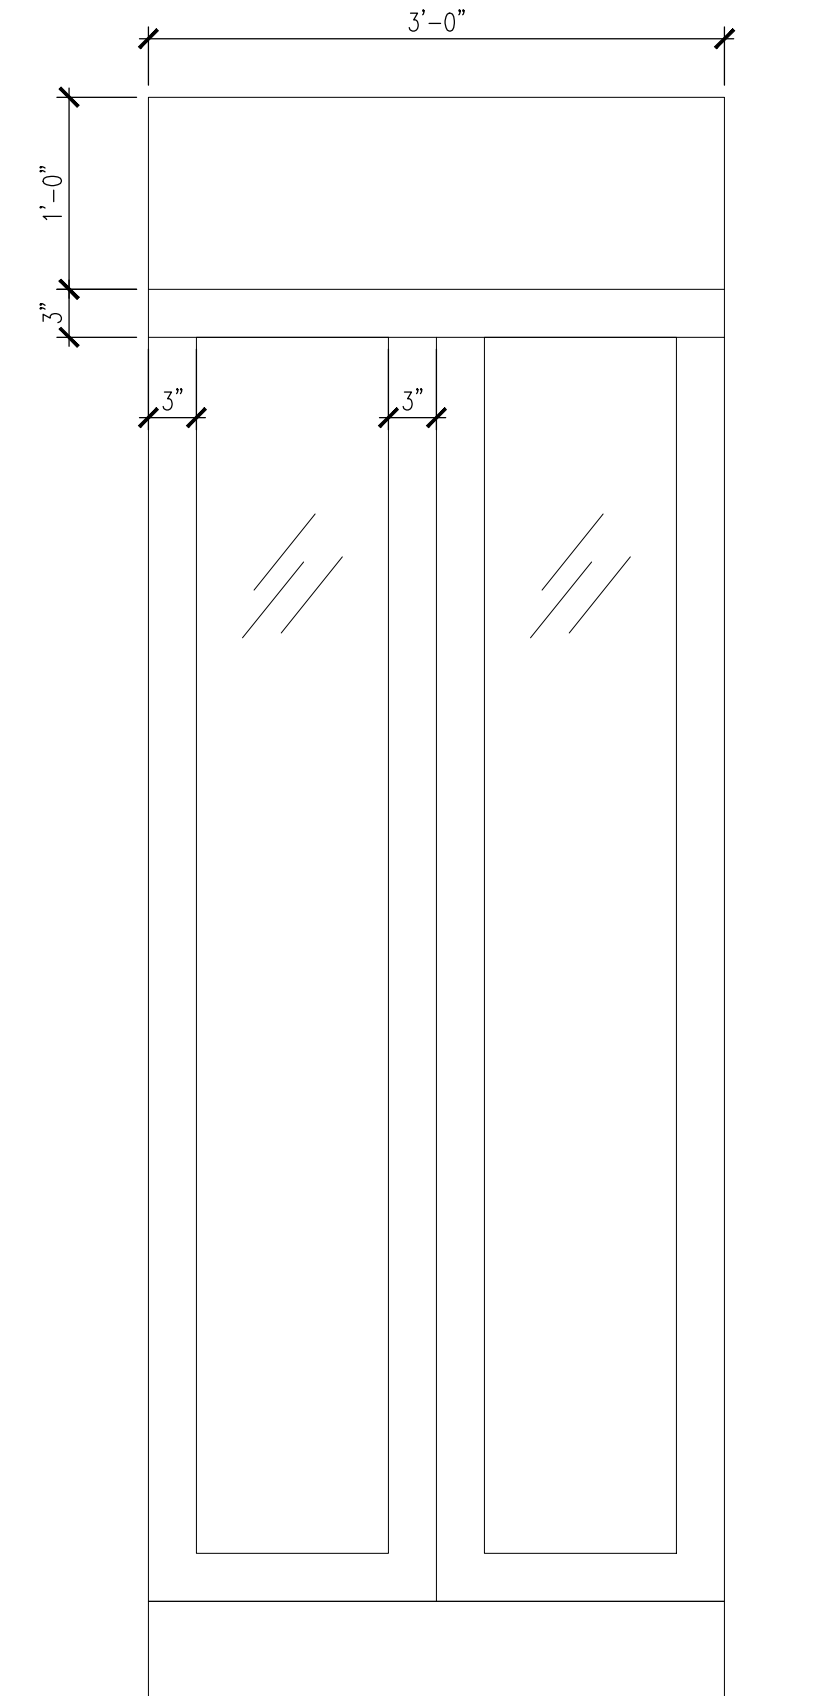


MARK	DATE	DESCRIPTION
	3/19/2021	DESIGN DEVELOPMENT
	4/2/2021	PERMIT SET

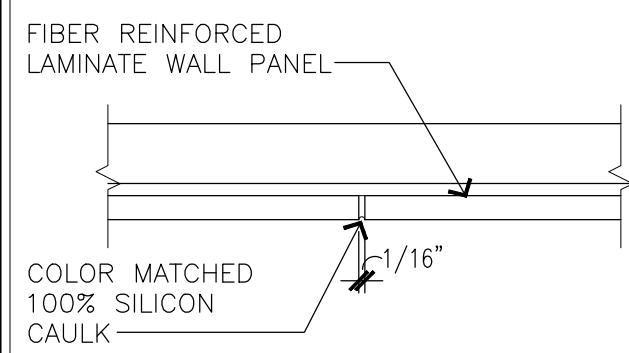

**TYP. VERTICAL JOINT**  
NOT TO SCALE

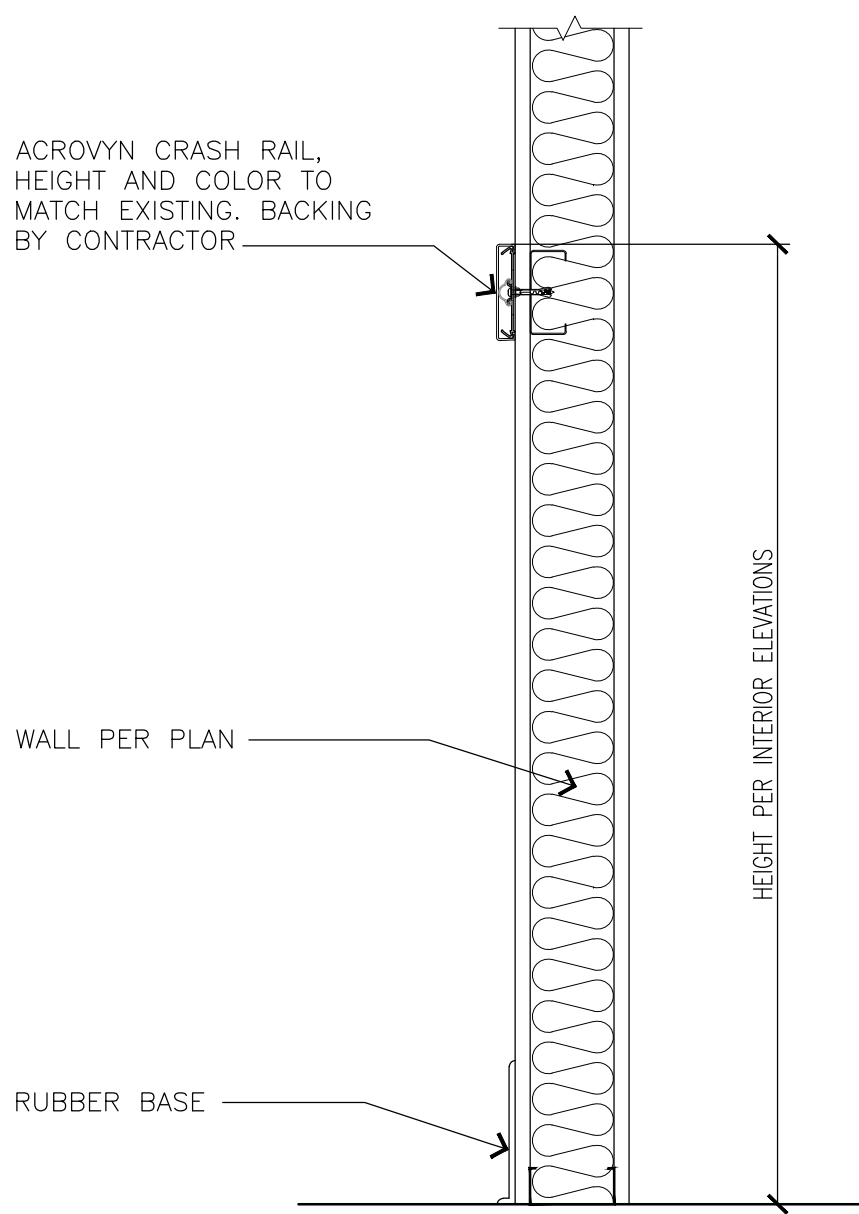

**10 TYP. FIBER REINFORCED LAMINATE WAINSCOT**  
SCALE: 1-1/2" = 1'-0"

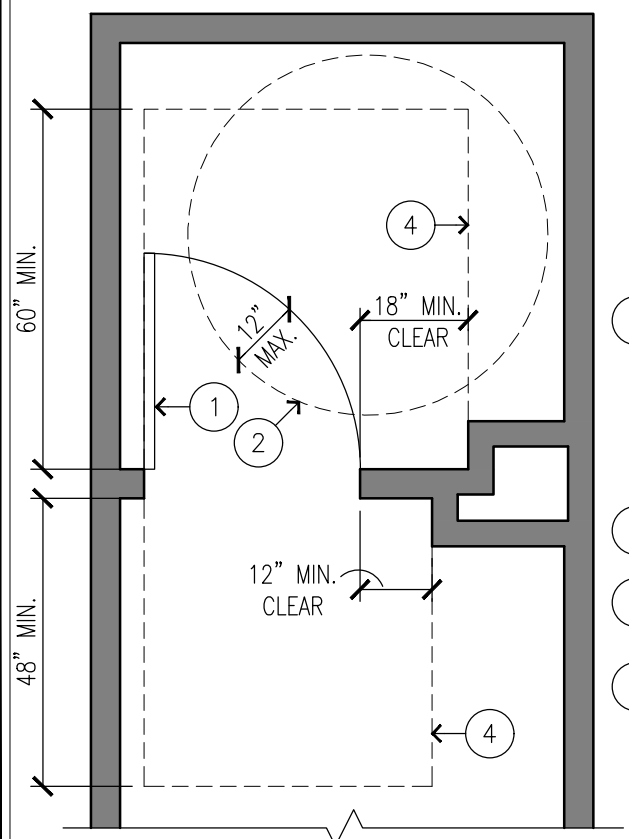

**5 ADA DOOR - MANEUVERING SPACE**  
SCALE: 3/8" = 1'-0"

**GENERAL NOTES:**

1. FOR ADDITIONAL INFORMATION REFER TO ANSI A117.1-2003


**KEYED NOTES:**

- DOOR SHALL HAVE A MINIMUM CLEAR OPENING WIDTH OF 32" (MEASURED FROM FACE OF DOOR TO OPPOSITE JAMB WHEN DOOR IS IN OPEN POSITION)
- 60" DIAMETER TURNING SPACE
- MANEUVERING SPACE: FRONT APPROACH, PULL SIDE
- MANEUVERING SPACE: FRONT APPROACH, PUSH SIDE


- INTERIOR PARTITION TYPE 1: NR**  
5/8" Type 'X' GWB to deck above  
4" metal studs @ 16" o.c. to deck above  
Sound attenuation batts to fill call cavity  
5/8" Type 'X' GWB to deck above
- INTERIOR PARTITION TYPE 2: NR**  
5/8" Type 'X' GWB to deck above  
4" metal studs @ 16" o.c. to deck above  
Sound attenuation batts to fill call cavity  
Lead lining per shielding report  
5/8" Type 'X' GWB to deck above
- INTERIOR PARTITION TYPE 3: NR**  
5/8" Type 'X' GWB to deck above  
6" metal studs @ 16" o.c. to deck above  
Sound attenuation batts to fill call cavity  
Lead lining per shielding report  
5/8" Type 'X' GWB to deck above
- INTERIOR PARTITION TYPE 1: NR**  
3-5/8" metal studs @ 16" o.c. to deck above  
Sound attenuation batts to fill call cavity  
Lead lining per shielding report  
5/8" Type 'X' GWB to deck above
- INTERIOR PARTITION TYPE 2: NR**  
Existing 5/8" Type 'X' GWB to deck above  
Existing 4" metal studs @ 16" o.c. to deck above  
Sound attenuation batts to fill call cavity  
Lead lining per shielding report  
5/8" Type 'X' GWB to deck above

**GENERAL WALL TYPE NOTES**


- ALL WALL SUBSTRATES AND SHEATHINGS EXTEND TO DECL ABOVE UNO.
- PROVIDE FLOOR OR ROOF ACOUSTICAL INSULATION IN ALL INTERIOR FRAMED WALLS AND FLOOR/CEILING ASSEMBLIES UNO.
- ACOUSTICAL INSULATION NOT REQUIRED AT PARTIAL HEIGHT AND PARTIAL LENGTH (STUB) WALLS, WALLS BETWEEN STORAGE ROOMS, WALLS BETWEEN STORAGE ROOMS AND HALLWAYS, ELECTRICAL ROOMS, OR OTHER STORAGE ROOM
- ANY PENETRATION THROUGH A RATED WALL, INCLUDING THOSE FOR PIPES, CONDUITS, AND DUCTS SHALL BE FIRE CAULKED. SEE MECH./ELEC. DRAWINGS FOR ITEMS THAT PENETRATE.
- TYPICAL INTERIOR WALL TYPE IS TYPE '4'. UNO. TYPICAL INTERIOR WALL IS NOT FLAGGED, EXCEPT FOR CLARITY.
- ALL STUD FRAMING AND FURRING 16" O.C. UNO.
- A WALL TYPE CONTINUES THE FULL ROOM LENGTH, INCLUDING ANY JOGS, ANGLES, RECESSES, OR STUB WALLS, UNO. ANY WALL SEGMENT NOT FLAGGED IS TO BE CONSTRUCTED PER THE ADJACENT WALL OR NEAREST FLAGGED WALL, UNLESS SHOWN OTHERWISE.
- WHERE DIFFERENT STUD SIZES / LAYERS OF SHTHG OCCUR ALONG A CORRIDOR/ HALLWAY WALL, IT IS INTENDED THAT THE CORRIDOR SIDES ALIGN UNO.
- ALL GWB SURFACES AND MASONRY TO BE PREPARED FOR PAINT GRADE FINISH UNO.
- SEE INTERIOR ELEVATIONS FOR LOCATIONS OF P-LAM MDF, ACOUSTICAL PANELS OR OTHER APPLIED WALL FINISHES.
- USE WATER RESISTANT GYP. BD IN MOISTURE PRONE AREAS

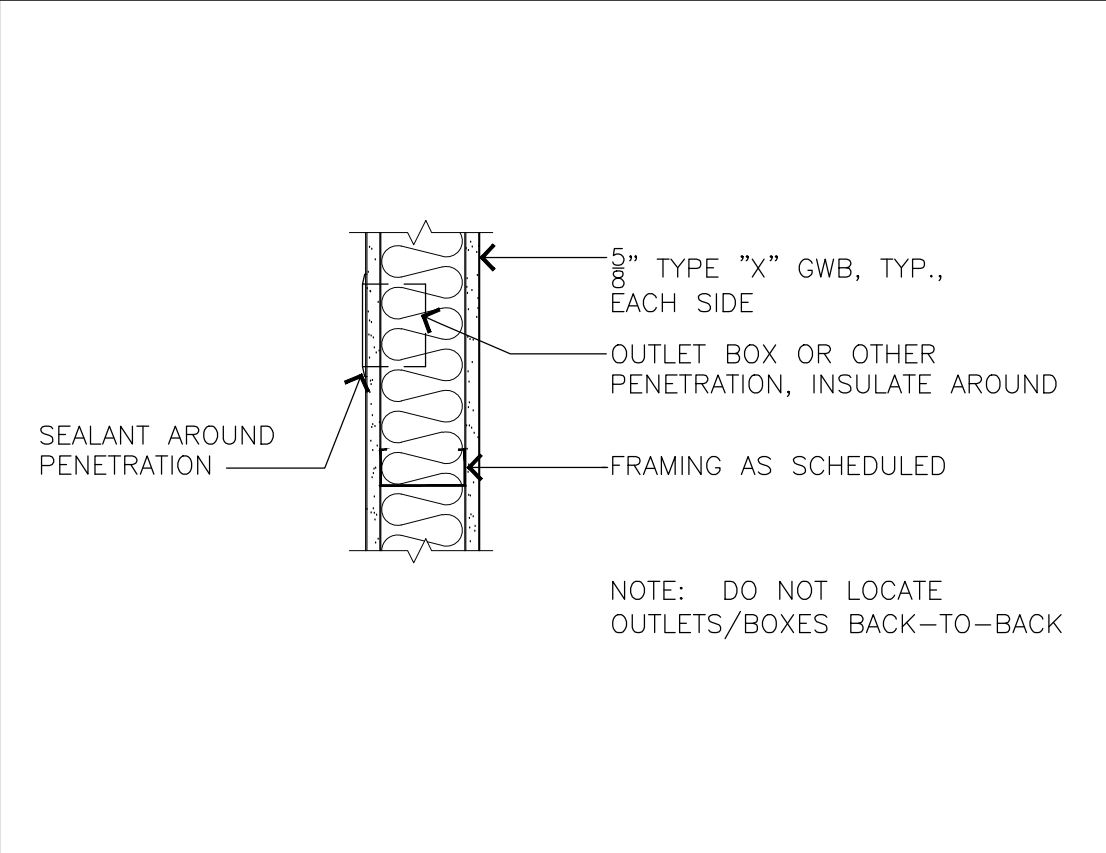


**7 PARTITION - TYPICAL PENETRATIONS**  
SCALE: 1-1/2" = 1'-0"

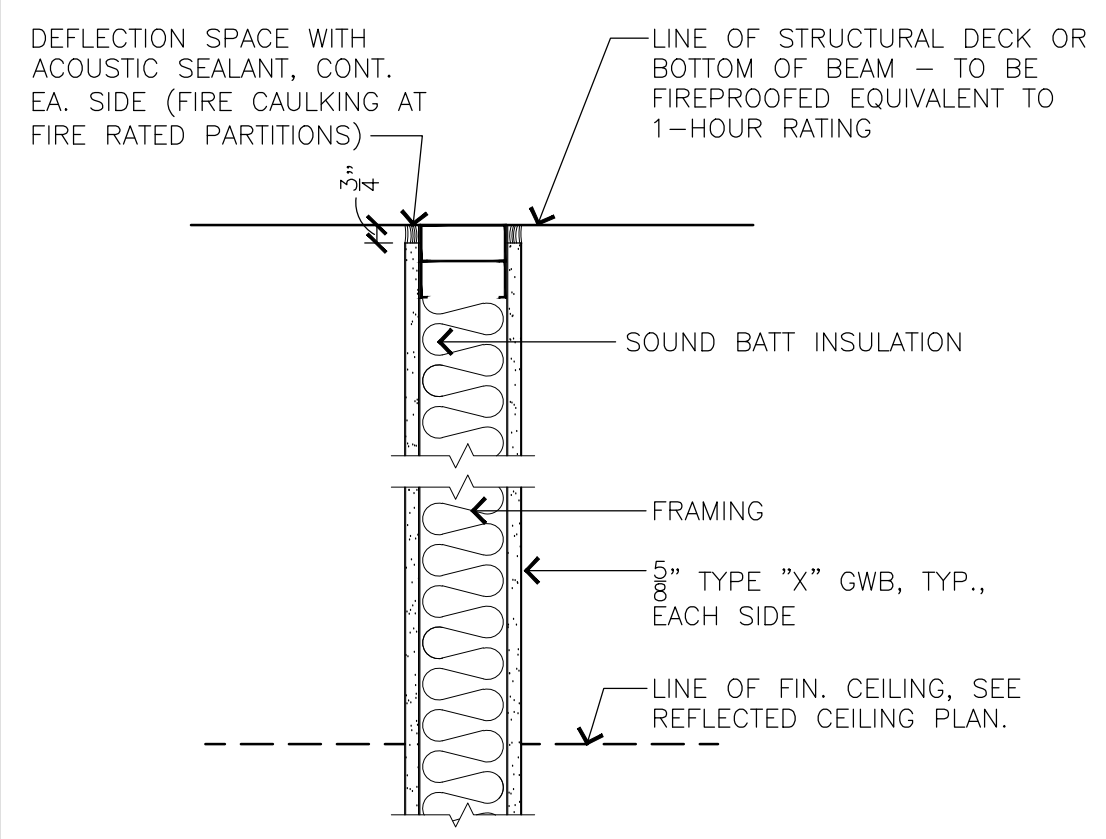

**2 FULL HEIGHT PARTITION**  
SCALE: 1-1/2" = 1'-0"

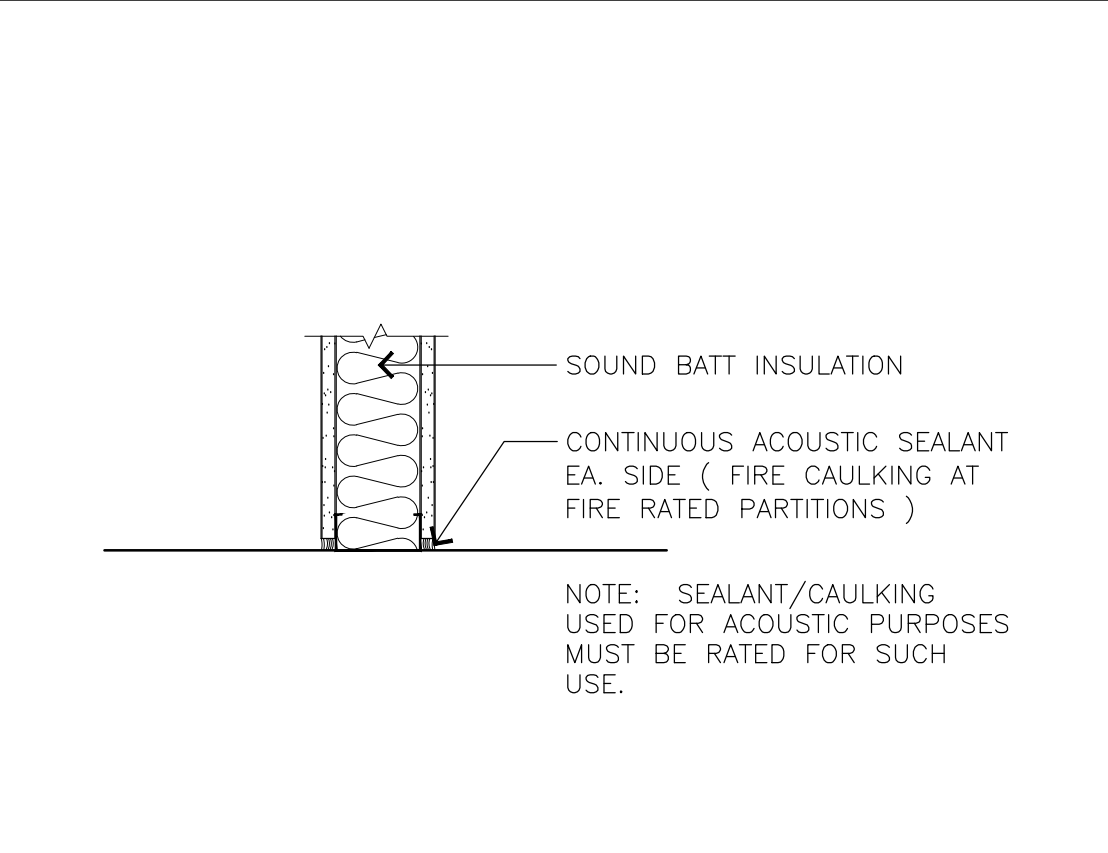

**6 PARTITION - TYPICAL SILL**  
SCALE: 1-1/2" = 1'-0"

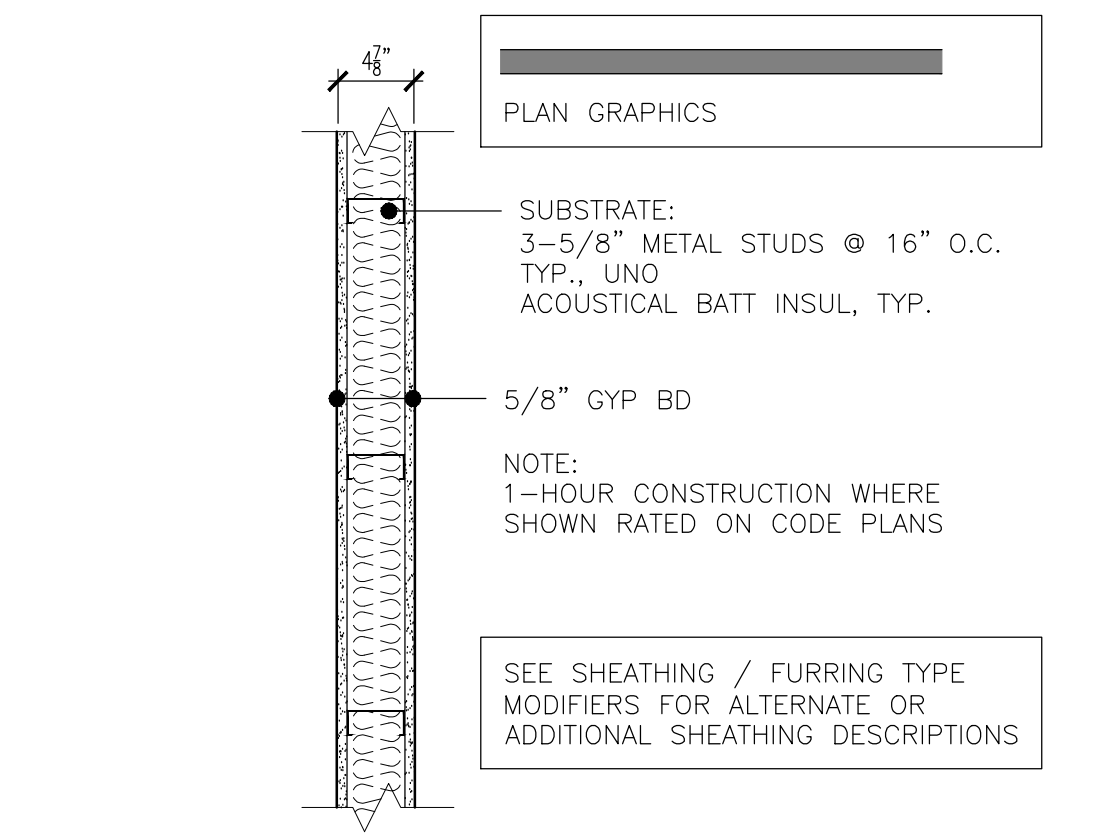

**1 TYPICAL INTERIOR WALL**  
SCALE: 1" = 1'-0"

OWNER:



PROJECT NAME:  
**OR 7&8 Buildout**  
Good Samaritan Hospital  
401 15th Ave SE  
Puyallup, WA 98372

MARK	DATE	DESCRIPTION
	3/19/2021	DESIGN DEVELOPMENT
	4/2/2021	PERMIT SET



City of Puyallup  
Development & Permitting Services  
ISSUED PERMIT

Building	Planning
Engineering	Public Works
Fire	Traffic

STATEMENT OF SPECIAL INSPECTIONS:

SPECIAL INSPECTION: SPECIAL INSPECTION SHALL BE PROVIDED PER THE REQUIREMENTS OF IBC SECTION 1704 AND 1705 AND AS NOTED HEREIN.

STRUCTURAL SYSTEM	VERIFICATION AND INSPECTION	CONTINUOUS	PERIODIC	COMMENTS	REFERENCES
STEEL CONSTRUCTION	MATERIAL VERIFICATION OF HIGH-STRENGTH BOLTS, NUTS AND WASHERS		X		AISC 360 CHAPTER N5
	HIGH-STRENGTH BOLTING A. SNUG-TIGHT JOINTS B. PRETENSIONED AND SLIP-CRITICAL JOINTS USING TURN-OF-NUT WITH MATCHMARKING, TWIST OFF BOLTS OR DIRECT TENSION INDICATOR METHODS OF INSTALLATION		X X		AISC 360 CHAPTER N5 AISC 341 CHAPTER J7
	MATERIAL VERIFICATION OF STRUCTURAL STEEL A. FOR STRUCTURAL STEEL, IDENTIFICATION MARKINGS TO CONFORM TO AISC 360 B. MANUFACTURER'S CERTIFIED MILL TEST REPORTS			X X	MANUFACTURER TO PROVIDE CERTIFIED MILL TEST REPORTS AISC 360 CHAPTER N5 AISC 341 CHAPTER J6
	MATERIAL VERIFICATION OF WELD FILLER MATERIALS A. IDENTIFICATION MARKINGS TO CONFORM TO AWS SPECIFICATIONS LISTED IN GENERAL NOTES B. MANUFACTURER'S CERTIFICATE OF COMPLIANCE			X X	MANUFACTURER TO PROVIDE CERTIFICATE OF COMPLIANCE AISC 360 CHAPTER N5
	INSPECTION OF WELDING A. COMPLETE AND PARTIAL JOINT PENETRATION GROOVE WELDS B. MULTI-PASS FILLET WELDS C. SINGLE-PASS FILLET WELDS > 5/16" D. PLUG AND SLOT WELDS E. SINGLE-PASS FILLET WELDS ≤ 5/16" F. FIELD-INSTALLED WELDED STUDS	X X X X		X X	SPECIAL INSPECTIONS IN THIS SECTION ARE WAIVED WHERE FABRICATION IS PERFORMED ON THE PREMISES OF A FABRICATOR REGISTERED AND APPROVED IN ACCORDANCE WITH IBC SECTION 1704.2.5 <b>WABO Fabricators required by Puyallup per IBC 1704.2.5 Special inspection of fabricated items</b>
CONCRETE	ANCHORS POST-INSTALLED IN HARDENED CONCRETE (MECHANICAL ANCHORS INSTALLED IN ANY DIRECTION)			X	PERIODIC INSPECTION TO INCLUDE A QUANTITY OF 10% WITH A MINIMUM OF (5) ANCHORS INSPECTED PER INSTALLER ON A DAILY BASIS. ACI 318: 17.8.2 MFR EVAL REPORT MFR PUBLISHED INSTALLATION INSTRUCTIONS <b>Anchors: Provide ICC -ESR on site for inspections Special inspection is required; See ICC ESR for additional details.</b>
SUSPENDED CEILINGS	ANCHORAGE AND SEISMIC BRACING		X		

TESTING AND SPECIAL INSPECTION REPORTS SHALL BE PREPARED FOR EACH INSPECTION ITEM ON A DAILY BASIS WHENEVER WORK IS PERFORMED ON THAT ITEM. REPORTS SHALL BE DISTRIBUTED TO OWNER, CONTRACTOR, BUILDING OFFICIAL, ARCHITECT AND STRUCTURAL ENGINEER OF RECORD.

GENERAL CONTRACTOR SHALL SUBMIT A WRITTEN CONTRACTOR'S STATEMENT OF RESPONSIBILITY TO THE BUILDING OFFICIAL AND OWNER PRIOR TO COMMENCEMENT OF WORK. THE CONTRACTOR'S STATEMENT OF RESPONSIBILITY SHALL INCLUDE ACKNOWLEDGMENT OF AWARENESS OF THE SPECIAL INSPECTION REQUIREMENTS CONTAINED IN THE STATEMENT OF SPECIAL INSPECTION.

Final letters are required do all special inspection, third party inspection and inspection by registered professionals. Inspectors may require final letters per IBC 104.4.

ABBREVIATION LIST			
@	AT	HDR	HEADER
A.B.	ANCHOR BOLT	HGR	HANGER
ADD'L	ADDITIONAL	HORIZ.	HORIZONTAL
A.F.F.	ABOVE FINISH FLOOR	HSS	HOLLOW STRUCTURAL SECTION
ALT.	ALTERNATE	HT	HEIGHT
ARCH.	ARCHITECTURAL	INT.	INTERIOR
BLD'G	BUILDING	JST	JOIST
BLK'G	BLOCKING	JT	JOINT
BM	BEAM	L	ANGLE
B.O.F.	BOTTOM OF FOOTING	L.F.R.S.	LATERAL FORCE-RESISTING SYSTEM
BOT.	BOTTOM	L.L.	LIVE LOAD
BRB	BUCKLING RESTRAINED BRACE	LLH	LONG LEG HORIZONTAL
BRG	BEARING	LLV	LONG LEG VERTICAL
BTWN	BETWEEN	LOC.	LOCATION
B.U.	BUILT UP	LSL	LAMINATED STRAND LUMBER
(C-)	CAMBER	LVL	LAMINATED VENEER LUMBER
CANT.	CANTILEVER	MAX.	MAXIMUM
CFS	COLD-FORMED STEEL	M.B.	MACHINE BOLT
C.J.	CONTROL/CONSTRUCTION JOINT	MECH.	MECHANICAL
CL	CENTERLINE	MEZZ.	MEZZANINE
CLR.	CLEARANCE	MFR	MANUFACTURER
CMU	CONCRETE MASONRY UNIT	MIN.	MINIMUM
COL.	COLUMN	MISC.	MISCELLANEOUS
CONC.	CONCRETE	MTL	METAL
CONN.	CONNECTION	N.F.	NEAR FACE
CONST.	CONSTRUCTION	N.S.	NEAR SIDE
CONT.	CONTINUOUS	NTS	NOT TO SCALE
CONTR.	CONTRACTOR	O.C.	ON CENTER
COORD.	COORDINATE	OPN'G	OPENING
C.P.	COMPLETE PENETRATION	OPP.	OPPOSITE
CTR'D	CENTERED	P.A.F.	POWDER ACTUATED FASTENER
C.Y.	CUBIC YARD	PERP.	PERPENDICULAR
DBL.	DOUBLE	PL	PLATE
DGM	DEMAND CRITICAL WELD	P.P.	PARTIAL PENETRATION
D.F.	DOUGLAS FIR	P.P.T.	PRESERVATIVE PRESSURE TREATED
DIA. OR φ	DIAMETER	P.S.F.	POUNDS PER SQUARE FOOT
DIAG.	DIAGONAL	PSL	PARALLAM
DIM.	DIMENSION	P.T.	POST TENSION
D.L.	DEAD LOAD	PN	PLYWOOD
DWG	DRAWING	REINF.	REINFORCEMENT
DWL	DOWEL	REQ'D	REQUIRED
(E)	EXISTING	SCHED.	SCHEDULE
EA.	EACH	SCL	STRUCTURAL COMPOSITE LUMBER
E.F.	EACH FACE	SHT'G	SHEATHING
EL.	ELEVATION	SIM.	SIMILAR
ELEV.	ELEVATOR	S.O.G.	SLAB ON GRADE
ENGR	ENGINEER	SQ.	SQUARE
EQ.	EQUAL	STD	STANDARD
E.W.	EACH WAY	STIFF.	STIFFENER
EXP.	EXPANSION	STL	STEEL
EXT.	EXTERIOR	STRUCT.	STRUCTURAL
FDN	FOUNDATION	T&B	TOP & BOTTOM
F.F.	FAR FACE	T&G	TONGUE AND GROOVE
FLR	FLOOR	THR'D	THREADED
F.O.M.	FACE OF MASONRY	T.O.F.	TOP OF FOOTING
F.O.S.	FACE OF STUD	T.O.S.	TOP OF STEEL
FRMG	FRAMING	TRT'D	TREATED
F.R.T.	FIRE RETARDANT TREATED	TYP.	TYPICAL
F.S.	FAR SIDE	U.N.O.	UNLESS NOTED OTHERWISE
FTG	FOOTING	U.T.	ULTRASONIC TESTED
GA.	GAGE/GAUGE	VERT.	VERTICAL
GALV.	GALVANIZED	W	WITH
GL.	GLULAM	W.P.	WORK POINT
GR.	GRADE	WT	WEIGHT
GWB	GYPSUM WALL BOARD	W.W.R.	WELDED WIRE REINFORCING

InSight  
HealthCare Architecture  
KLanglois@InSightDesignStudios.biz  
12345 Lake City Way NE #2108  
Seattle, WA 98125  
206-601-6645

OWNER:  
**MultiCare Tacoma General Hospital**

PROJECT NAME:  
**OR 7&8 Buildout**

Good Samaritan Hospital  
401 15th Ave SE  
Puyallup, WA 98372

MARK	DATE	DESCRIPTION
	3/19/2021	DESIGN DEVELOPMENT
	4/2/2021	PERMIT SET

PROJECT NO. 31232  
DRAWN BY: RSC  
DATE: 2 APRIL 2021  
COPYRIGHT TO:  
InSight Healthcare Architecture

SHEET TITLE:  
GENERAL NOTES

SHEET #:  
**S1.01**

**PCS**  
Structural Solutions  
Seattle | Tacoma | Portland  
www.pcs-structural.com















City of Puyallup Development & Permitting Services	ISSUED PERMIT
Building	Planning
Engineering	Public Works
Fire	Fire


TRACK THICKNESS (MILS)	ALLOWABLE LOAD (POUNDS)	INTERIOR WALL HEIGHT
33	106	31'-10"
43	174	52'-4"
54	344	
60	475	

3" MIN. TRACK W/ 1" GAP

TRACK THICKNESS (MILS)	ALLOWABLE LOAD (POUNDS)	INTERIOR WALL HEIGHT
33	41	14'-1"
43	92	27'-8"
54	177	
60	299	

\*DISTANCE BETWEEN WALL STUD SUPPORTS


STUD THICKNESS	ALLOWABLE LOAD
33	530#
43	709#
54	1602#
60	1855#

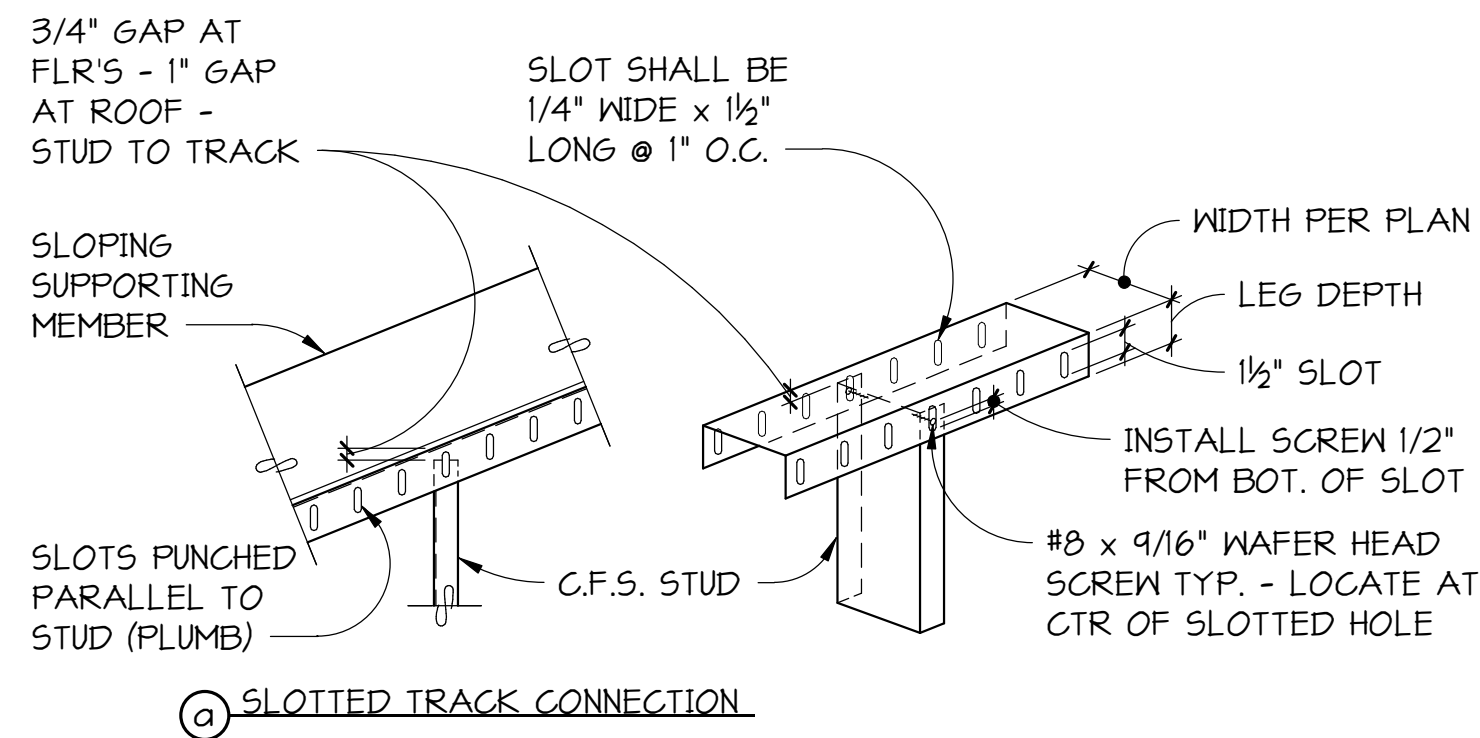


INTERIOR NON-BEARING COLD-FORMED STEEL WALL STUDS			
5 PSF (ASD) LIVE LOAD, 1/360 DEFLECTION LIMIT			
REQUIRED BRIDGING TYPE	STUD SIZE	STUD MIL	
		STUD SPACING	MAXIMUM STUD HEIGHT ALLOWED
4	400S125	33	15'-11"
	600S125	43	21'-4"
1 OR 2 OR 5 OR 4	400S137	43	17'-2"
		54	18'-5"
	400S162	43	18'-0"
		54	19'-3"
	400S200	43	19'-0"
		54	20'-4"
600S137	43	23'-8"	
	54	25'-5"	
600S162	43	24'-9"	
	54	26'-6"	
600S200	43	26'-0"	
	54	27'-11"	

- NOTES:
- FOR TYPICAL COLD-FORMED STEEL WALL STUD BRIDGING DETAIL SEE 2/55.01.
  - INFORMATION SHOWN FOR S125 STUDS TAKEN FROM THE GYPSUM CONSTRUCTION HAND BOOK BY CGC INC. - INFORMATION SHOWN FOR ALL OTHER STUDS TAKEN FROM ICC ES LEGACY REPORT ER-4943P\*.
  - 43 MIL MINIMUM REQUIRED AT MASONRY VENEER. BRIDGING TYPE BASED ON STUD SIZE AND HEIGHT.

NOTE: PROVIDE LOAD BEARING SHIMS OR GROUT BETWEEN UNDERSIDE OF WALL BOTTOM TRACK OR RIM TRACK AND SUPPORT BELOW AT STUD OR JOIST LOCATION WHERE GAP GREATER THAN 1/4" OCCURS.

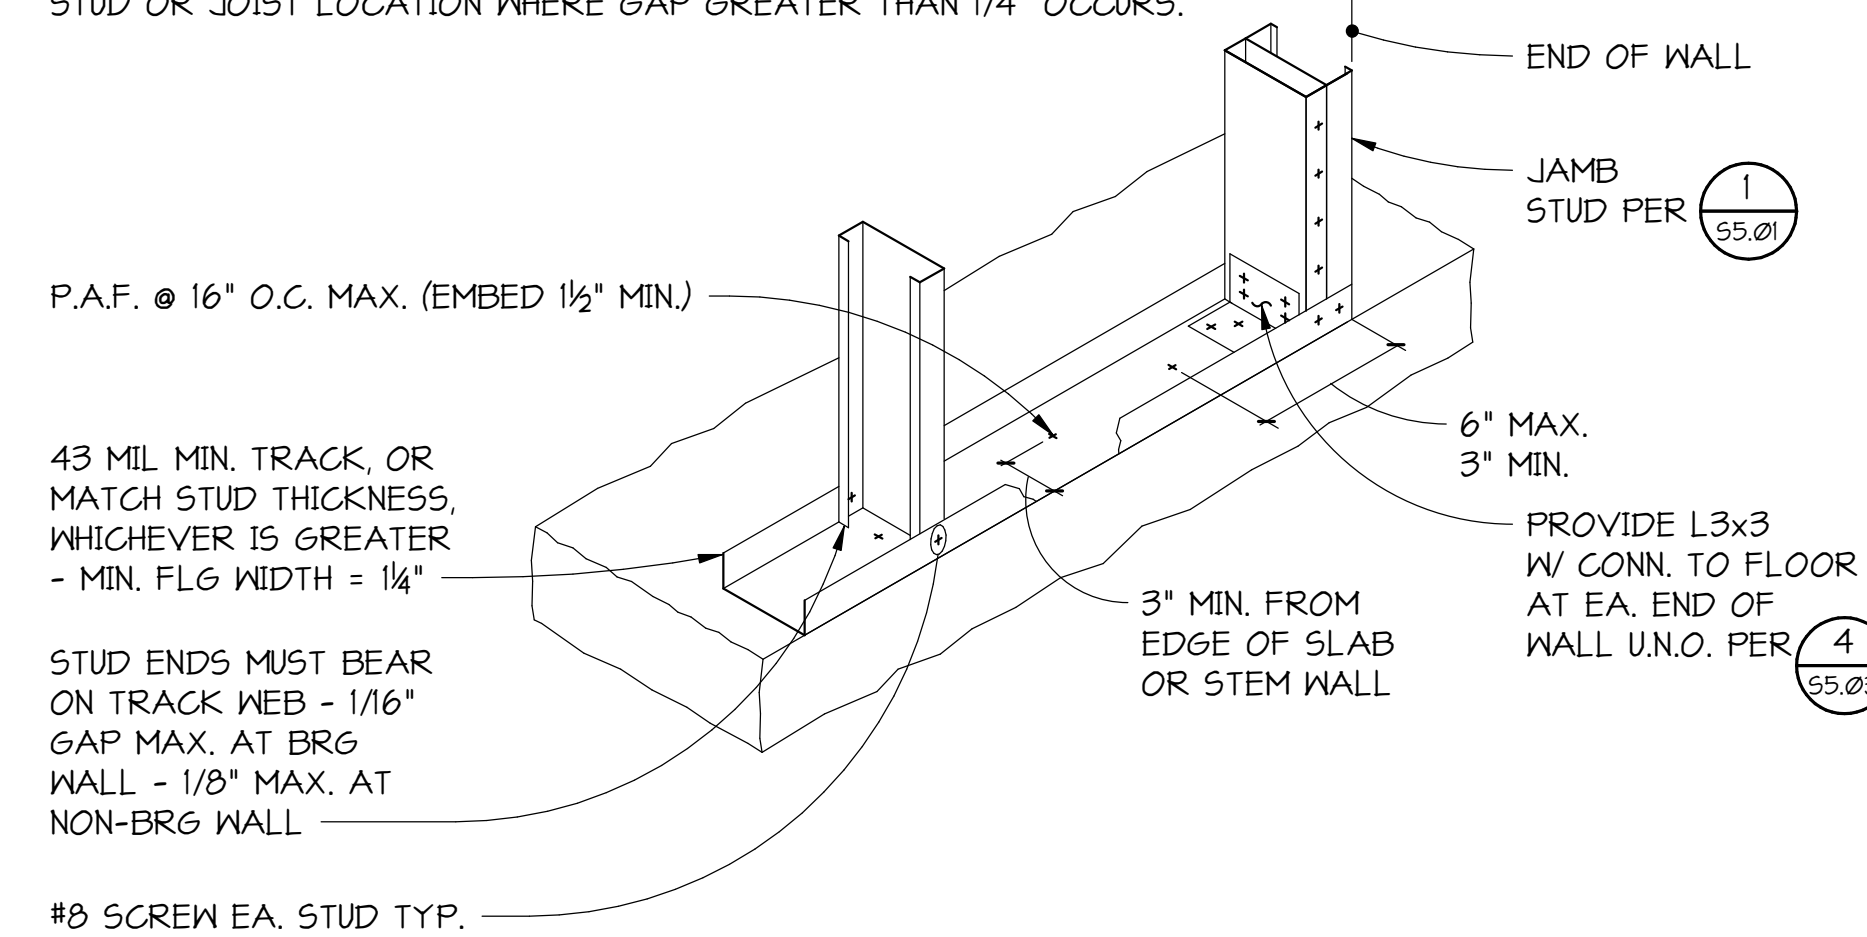



(3) TYPICAL NON-BEARING COLD-FORMED STEEL AND TRACK ATTACHMENT

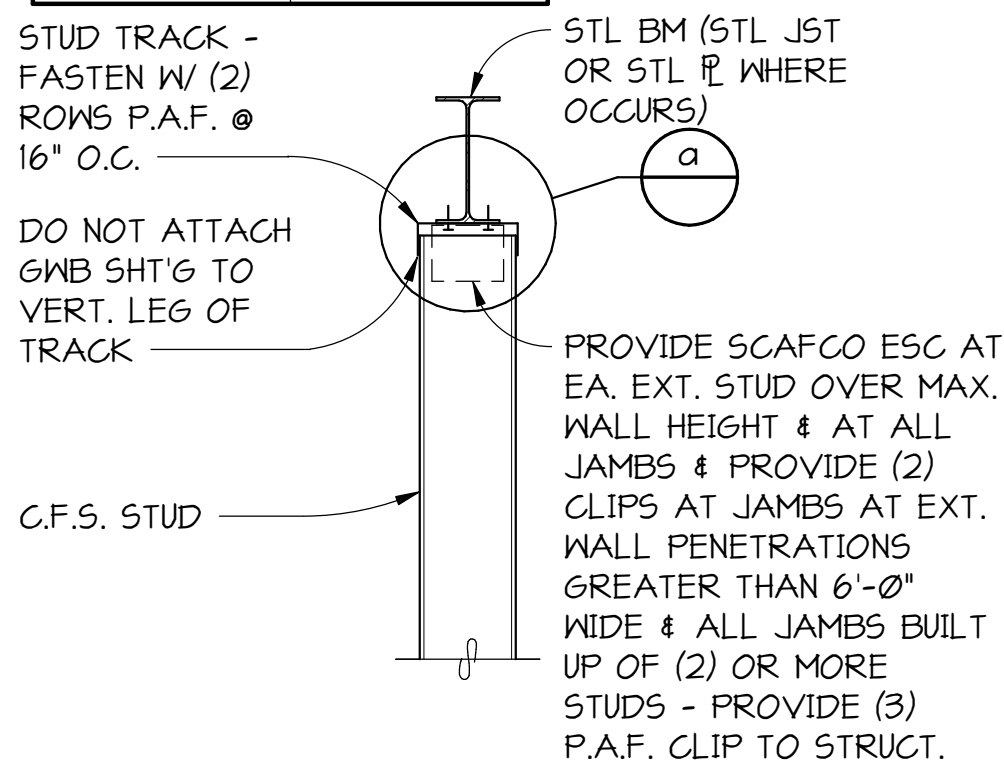

(1) TYPICAL NON-BEARING COLD-FORMED STEEL WALL EXTENDING TO STRUCTURE ABOVE


(1) SECTION NO SCALE

(2) SCHEDULE NO SCALE

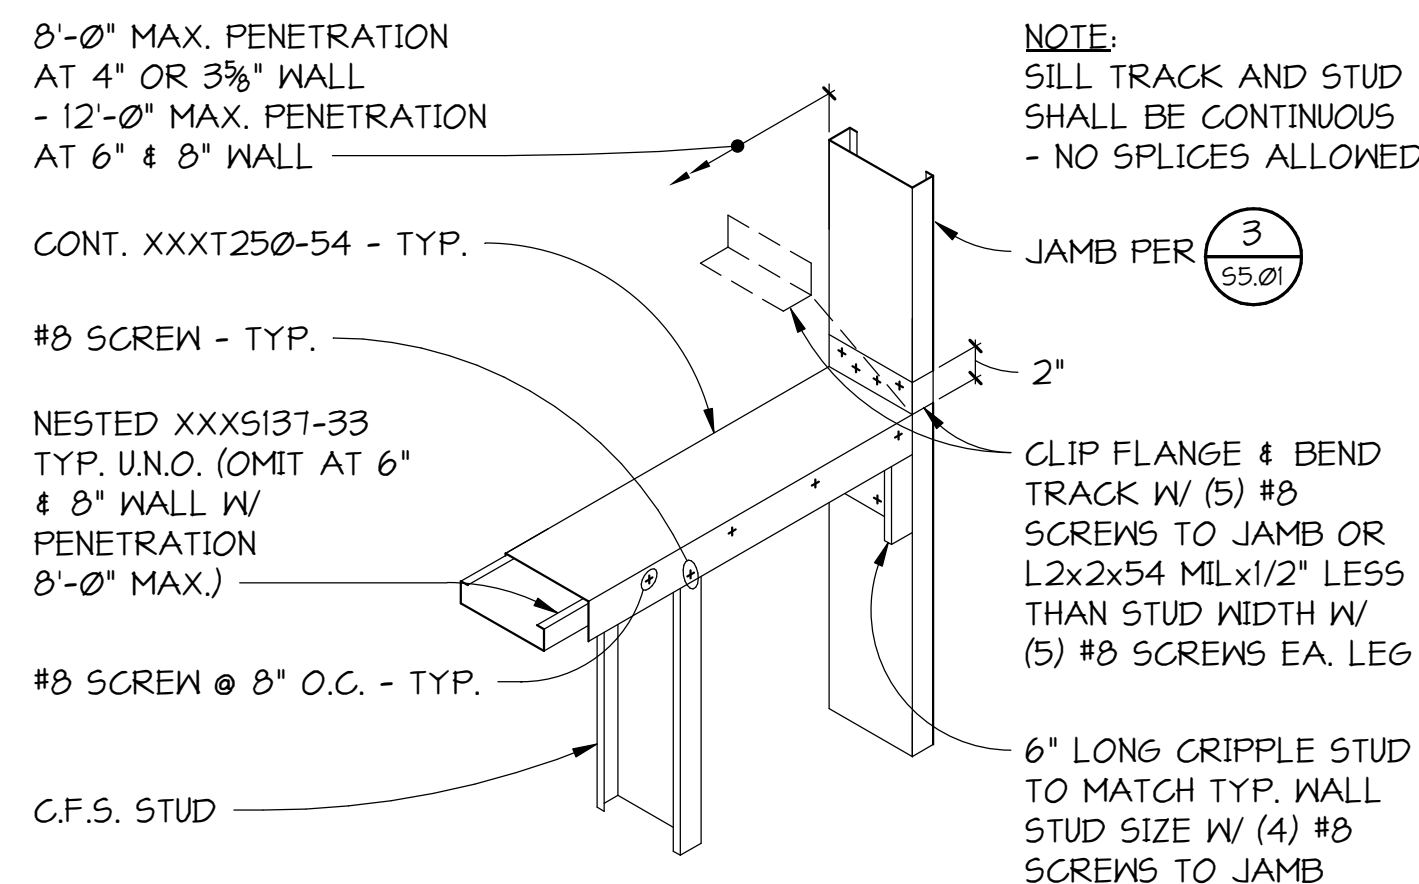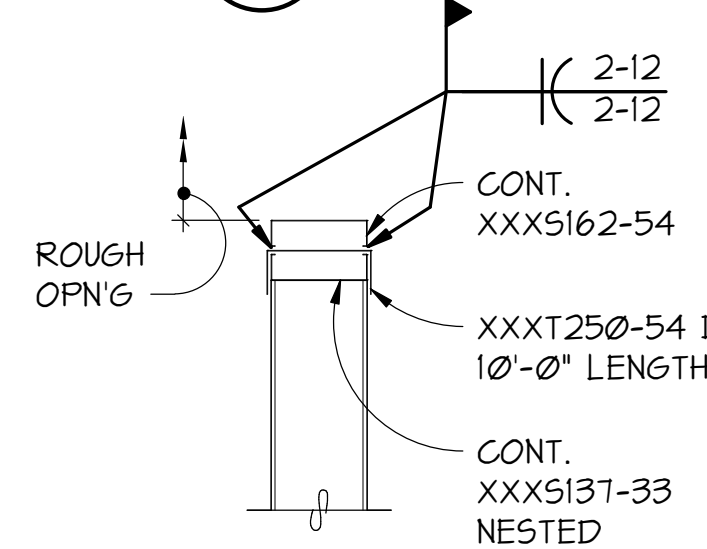

(5) TYPICAL SILL AT NON-BEARING COLD-FORMED STEEL WALL PENETRATION AT 16'-0" MAXIMUM STUD HEIGHT

(5) DETAIL NO SCALE

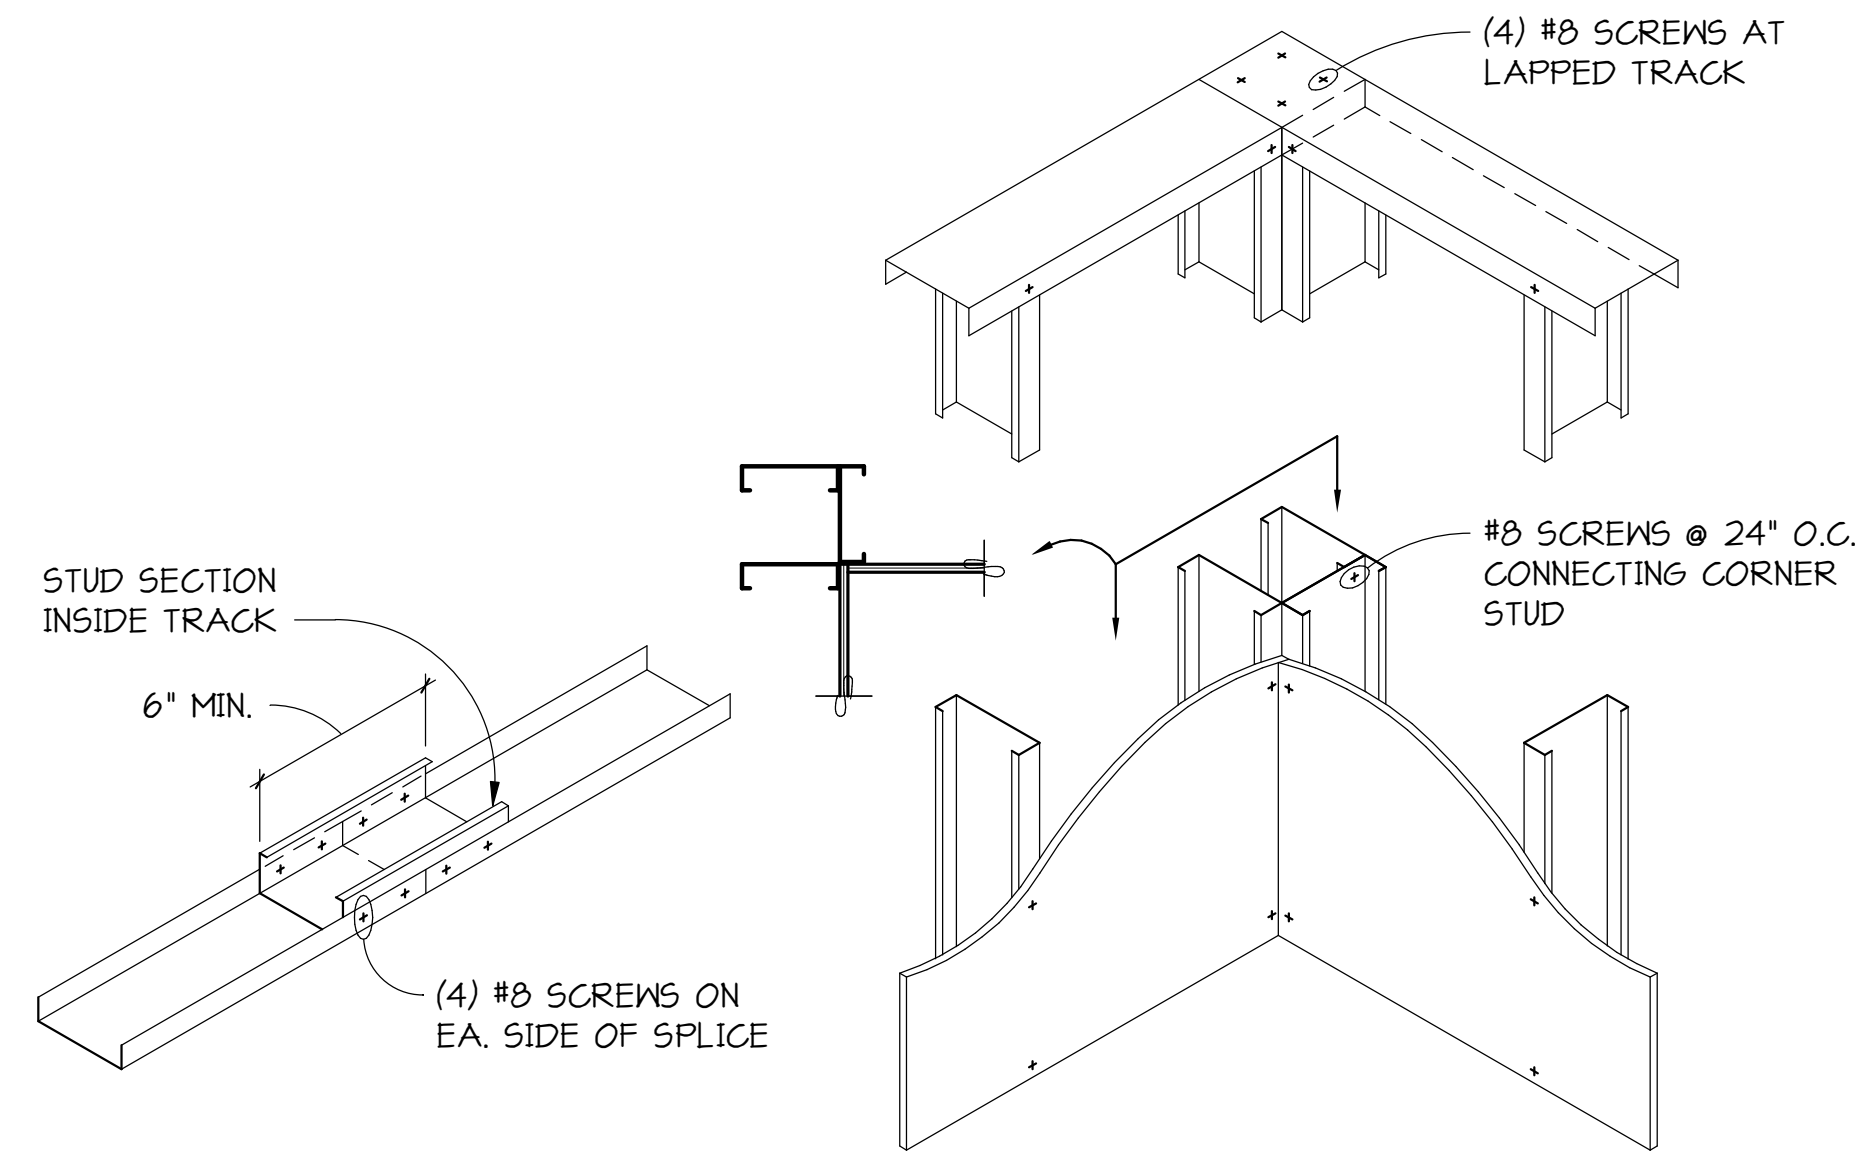


(a) TYPICAL COLD-FORMED STEEL BOTTOM/TOP TRACK SPLICE

(b) TYPICAL COLD-FORMED STEEL WALL CORNER

(6) DETAIL NO SCALE

NOTE: PROVIDE LOAD BEARING SHIMS OR GROUT BETWEEN UNDERSIDE OF WALL BOTTOM TRACK OR RIM TRACK AND SUPPORT BELOW AT STUD OR JOIST LOCATION WHERE GAP GREATER THAN 1/4" OCCURS.

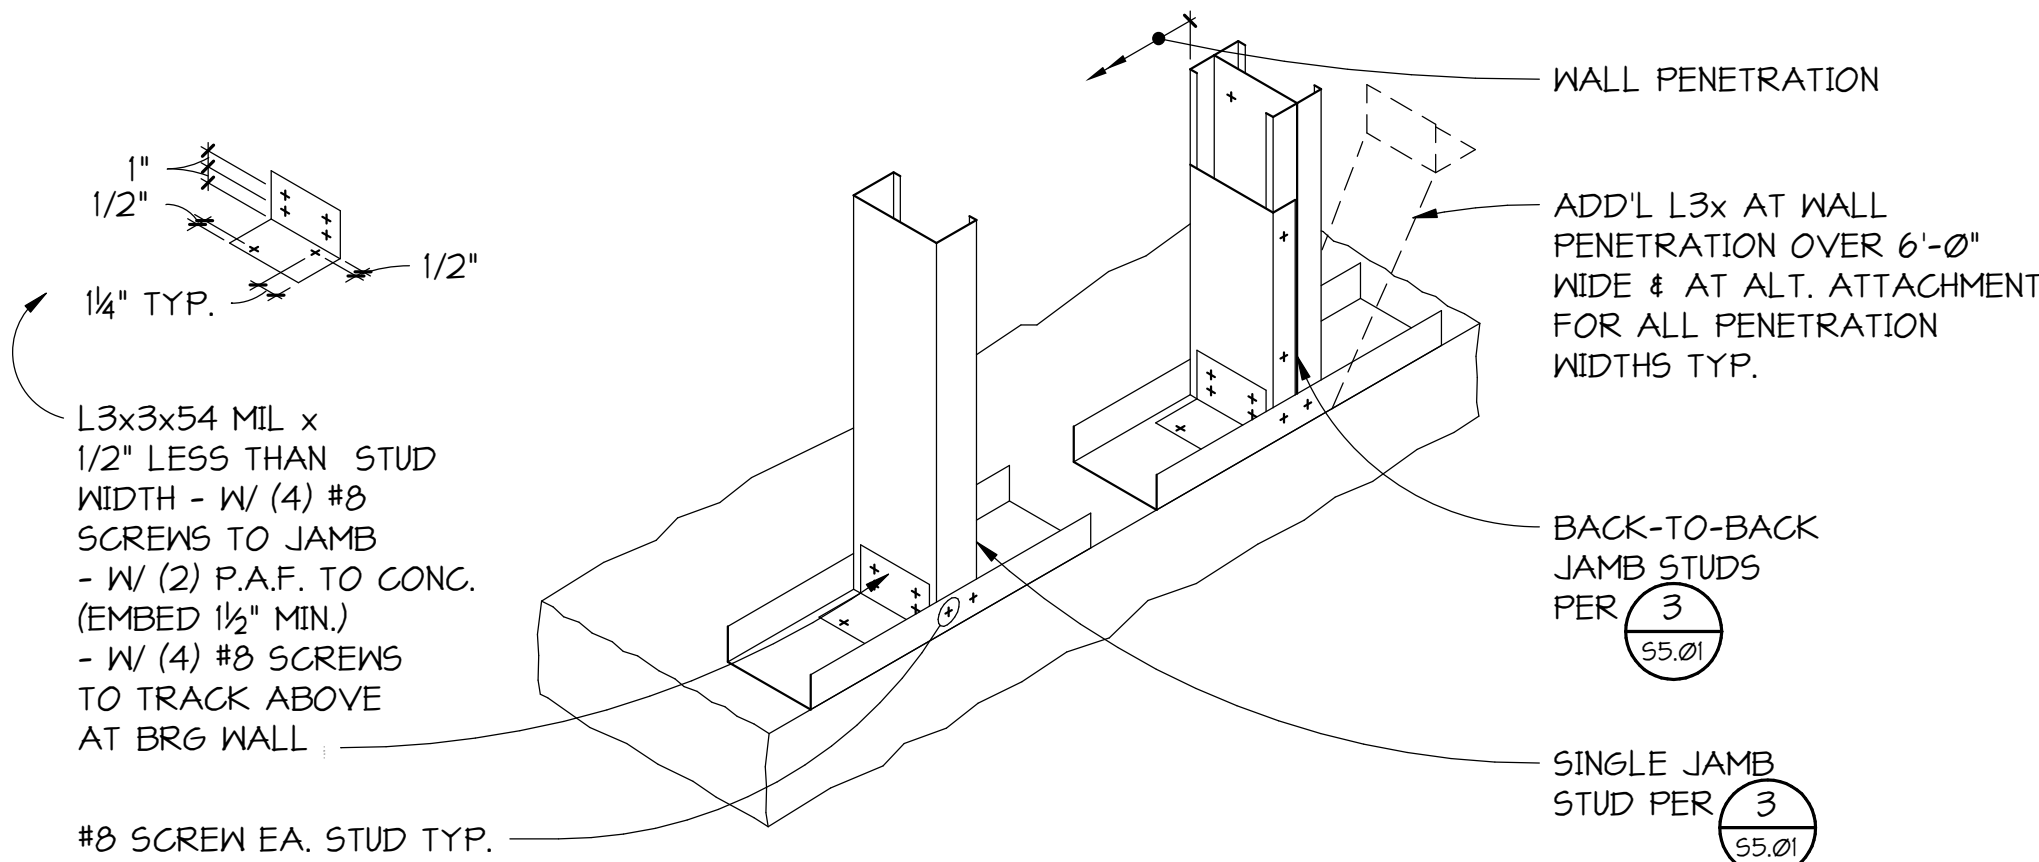

(4) TYPICAL NON-BEARING COLD-FORMED STEEL JAMB STUD ATTACHMENT

(4) DETAIL NO SCALE

InSight  
HealthCare Architecture  
KLanglois@InsightDesignStudios.biz  
12345 Lake City Way NE #2108  
Seattle, WA 98125  
206-601-6645

OWNER:  
MultiCare Tacoma General Hospital  
PROJECT NAME:  
**OR 7&8 Buildout**  
Good Samaritan Hospital  
401 15th Ave SE  
Puyallup, WA 98372


MARK	DATE	DESCRIPTION
	3/19/2021	DESIGN DEVELOPMENT
	4/2/2021	PERMIT SET

PROJECT NO. 31232  
DRAWN BY: RSC  
DATE: 2 APRIL 2021  
COPYRIGHT TO:  
InSight Healthcare Architecture

SHEET TITLE:  
NON-BEARING COLD FORMED STEEL FRAMING DETAILS

SHEET #:  
S5.03

**PCS**  
Structural Solutions  
Seattle | Tacoma | Portland  
www.pcs-structural.com

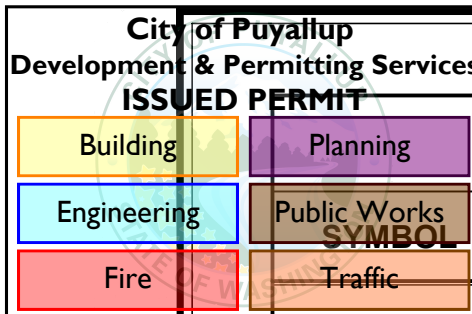

### MECHANICAL LEGEND

DESCRIPTION	ABBREV.	DESCRIPTION
WASTE OR SOIL (W)	AFF	ABOVE FINISHED FLOOR
VENT (V)	AHJ	AUTHORITY HAVING JURISDICTION
COLD WATER (CW)	AHU	AIR HANDLING UNIT
HOT WATER (HW)	APPROX	APPROXIMATELY
HOT WATER CIRCULATING (HWC)	ARCH	ARCHITECTURAL
HEATING WATER SUPPLY (HWS)	ASSY	ASSEMBLY
HEATING WATER RETURN (HWR)	AAV	AUTOMATIC AIR VENT
CHILLED WATER SUPPLY (CHS)	BDD	BACKDRAFT DAMPER
CHILLED WATER RETURN (CHR)	B.O.D.	BOTTOM OF DUCT
CONDENSATE (C)	BTU	BRITISH THERMAL UNIT
NATURAL GAS (G)	BTUH	BRITISH THERMAL UNIT/HOUR
MEDICAL AIR (MA)	BLDG	BUILDING
MEDICAL VACUUM (MV)	CAP	CAPACITY
MEDICAL OXYGEN (OX)	CLG	CEILING
WASTE ANESTHESIA GAS DISPOSAL (WAGD)	CO	CLEANOUT
NITROUS OXIDE (N2O)	COP	COEFFICIENT OF PERFORMANCE
CARBON DIOXIDE (CO2)	COMP	COMPRESSOR
INSTRUMENT AIR	CONN	CONNECTION
RAIN LEADER (RL)	CONT	CONTINUE, CONTINUATION
	CFH	CUBIC FEET PER HOUR
	CFM	CUBIC FEET PER MINUTE
	CT	CLOSED TRANSITION
	CW	COLD WATER
	CWV	COMBINATION WASTE/VENT
	DEG F, °F	DEGREE FAHRENHEIT
	DIA, Ø	DIAMETER
	DDC	DIRECT DIGITAL CONTROL
	DAT	DISCHARGE AIR TEMPERATURE
	DN	DOWN
	DWG	DRAWING
	DB	DRY BULB
	EA	EACH
	EF	EXHAUST FAN
	EFF	EFFICIENCY

### MECHANICAL GENERAL DEMOLITION NOTES

- DEMOLITION DRAWINGS ARE INTENDED TO ONLY GIVE A GENERAL REPRESENTATION OF THE DEMOLITION INVOLVED, AND DO NOT CONSTITUTE A FULL LISTING OF ALL ITEMS REQUIRING REMOVAL. NOT ALL ITEMS TO BE DEMO'D ARE SHOWN. CONTRACTOR IS RESPONSIBLE TO REVIEW EXISTING CONDITIONS, EXISTING DRAWINGS, AND MECHANICAL GENERAL DEMOLITION NOTES.
- A PRE-BID WALK-THRU IS A MANDATORY REQUIREMENT. IT IS THE CONTRACTOR'S RESPONSIBILITY TO REVIEW SITE CONDITIONS AND TO IDENTIFY ALL DEMOLITION WORK, AND INCLUDE IN HIS BID ALL COSTS FOR DEMOLITION & DISPOSAL. NOT ALL PLUMBING FIXTURES & HVAC ITEMS TO BE DEMO'D ARE SHOWN; SEE GENERAL NOTES FOR REQUIREMENTS.
- EXIST. DUCTS, EQUIPMENT, PIPING, AIR INLETS/OUTLETS, PLUMBING FIXTURES SHOWN DASHED REPRESENT MAJOR MECHANICAL ITEMS TO BE REMOVED. SEE GENERAL NOTES, DRAWING NOTES & KEYED NOTES WHICH COVER ALL OTHER MISC. MECHANICAL ITEMS TO BE REMOVED.
- ALL EXIST. ITEMS NOT BEING REUSED SHALL BE REMOVED. THIS INCLUDES SUCH ITEMS AS THERMOSTATS, CONTROL DEVICES, CONTROL WIRING, PNEUMATIC TUBING, DUCTS, FANS, PIPING, GRILLES, SUPPORTS, VALVES, CURBS, AND RELATED ACCESSORIES.
- ABANDONED ITEMS, ANCHORS, INSERTS, PIPE STUBS, AND OTHER PROJECTIONS NOT BEING CONCEALED BY NEW CONSTRUCTION SHALL BE REMOVED TO 1" BELOW THE ADJACENT FINISHED SURFACE, AND THE DISTURBED AREA PATCHED.
- PATCH ALL WALL/FLOOR/CEILING OPENINGS LEFT BY REMOVAL OF EXIST. ITEMS. PATCH SO AS TO MATCH FINISH OF ADJACENT UNDISTURBED AREA.
- REFERENCE ARCHITECTURAL DRAWINGS FOR WHERE CEILING/WALL AND OTHER GENERAL DEMOLITION WORK IS BEING DONE.
- SEE MECHANICAL FLOOR PLANS FOR HVAC DUCTS THAT ARE BEING REUSED.
- WHERE EXIST. DUCTS ARE REUSED, AND EXIST. BRANCH DUCTS ARE REMOVED, PROVIDE SHEET METAL PATCH WITH INSULATION AT UNUSED CONNECTION (INSULATION REQUIRED ON SUPPLY AIR DUCTS ONLY).
- WHERE EXIST. PLUMBING FIXTURES ARE REMOVED, CAP OFF CW, HW, VENT & WASTE PIPING AT A CONCEALED LOCATION (I.E. ABOVE CEILING OR INSIDE WALL).
- WHEREVER FLOOR DRAINS ARE REMOVED, LOCATE AND REMOVE TRAP PRIMER THAT SERVED DRAIN(S) AND CAP OFF CW PIPING.
- PROVIDE TEMPORARY CAP-OFF OF ALL EXIST. SYSTEMS TO ALLOW CONTINUED USE OF ALL SYSTEMS UNTIL THE FINAL SYSTEM COMPONENTS ARE INSTALLED AND CONNECTED (INCLUDE HWS/HWR, CHS/CHR, CW, HW, WASTE, VENT, CONTROLS, DUCTWORK, ETC.).
- HOLD ALL REMOVED ITEMS FOR OWNERS REVIEW. ITEMS SELECTED BY OWNER FOR SALVAGE SHALL BE MOVED BY THE CONTRACTOR TO THE OWNERS STORAGE ROOM (VERIFY EXACT LOCATION WITH OWNER). ITEMS NOT SELECTED BY OWNER FOR SALVAGE SHALL BE DISPOSED OF OFF SITE BY CONTRACTOR.
- ALL EXISTING ITEMS ASSOCIATED WITH DEMO'D ITEMS SHALL BE REMOVED. THIS INCLUDES SUCH ITEMS AS HANGERS, THERMOSTATS, DAMPERS, CURBS, SUPPORTS, CONTROL WIRING/CONDUIT, UNIONS, VALVES, PIPING, DUCTS, AND SIMILAR ACCESSORIES.
- ROUTING SHOWN OF EXISTING ITEMS IS APPROXIMATE, CONTRACTOR SHALL FIELD VERIFY LOCATIONS, CONTENTS, AND FLOW DIRECTION OF ALL PIPING & DUCTS. LABELING SHOWN ON PLANS HAS NOT BEEN VERIFIED.
- PROVIDE CAP-OFF OF ALL EXISTING UTILITIES THAT ARE CUT OR SERVED DEMO'D ITEMS. SYSTEMS TO BE CAPPED OFF INCLUDE HW, CW, WASTE, VENT, HWS, HWR, RL, HWC, SA DUCTS, RA DUCTS, AND EXHAUST DUCTS. ALL CAP-OFFS SHALL OCCUR IN A CONCEALED LOCATION.
- SEE PLUMBING AND HVAC FLOOR PLANS FOR RECONNECTION OF NEW PIPING AND DUCTWORK.

### MECHANICAL LEGEND

SYMBOL	DESCRIPTION	ABBREV.	DESCRIPTION
	FLOOR CLEANOUT (FCO)	ELEC	ELECTRICAL, ELECTRIC
	ISOLATION VALVE - SEE SPECIFICATIONS FOR TYPE	EMCS	ENERGY MANAGEMENT CONTROL SYSTEM
	BALANCING VALVE	EER	ENERGY EFFICIENCY RATIO
	TWO-WAY CONTROL VALVE	EAT	ENTERING AIR TEMPERATURE
	THREE-WAY CONTROL VALVE	EWB	ENTERING WET BULB
	PIPE UP	EDB	ENTERING DRY BULB
	PIPE DOWN	EOL	END OF LINING
	PIPE TEE IN LINE, BRANCH PIPE DOWN	EXH	EXHAUST
	UNION	EXIST	EXISTING
	RELIEF VALVE OR SAFETY VALVE	ESP	EXTERNAL STATIC PRESSURE
	STRAINER WITH BLOW-OFF VALVE	ETR	EXISTING TO REMAIN
	CONCENTRIC REDUCER	F	FIRE
	HOSE BIBB	FV	FACE VELOCITY
	AUTOMATIC AIR VENT	FBM	FEET PER MINUTE
	MANUAL AIR VENT	FLEX	FLEXIBLE
	PRESSURE GAUGE	FL	FLOOR
	PRESSURE REDUCING VALVE	FCO	FLOOR CLEAN OUT
	THERMOMETER	FLA	FULL LOAD AMPS
	DUCT (FIRST FIGURE, SIDE SHOWN)	GAL	GALLON
	FLAT OVAL DUCT (FIRST FIGURE, SIDE SHOWN)	G	GAS
	LINED DUCT (DIM. FOR NET FREE AREA)	HB	HOSE BIBB
	RISE (R) OR DROP (D) ARROW IN DIRECTION OF FLOW	HP	HORSE POWER
	DUCT SECTION (SUPPLY)	HW	HOT WATER
	DUCT SECTION (EXHAUST OR RETURN)	HWC	HOT WATER CIRCULATION
	ROUND DUCT OR FLAT OVAL	INTEGR.	INTEGRAL
	VOLUME DAMPER (MANUAL)	IN	INCH
	MOTORIZED DAMPER	I.E.	INVERT ELEVATION
	FLEXIBLE CONNECTION	KW	KILOWATT
	SMOKE DAMPER	L	LINING
	COMBINATION FIRE/SMOKE DAMPER	LAT	LEAVING AIR TEMPERATURE
	FIRE DAMPER	LDB	LEAVING DRY BULB
	FLEXIBLE DUCT	LWT	LEAVING WATER TEMPERATURE
	ELBOW WITH TURNING VANES	LWB	LEAVING WET BULB
	DUCT UP (RECTANGULAR)	MAV	MANUAL AIR VENT
	DUCT DOWN (RECTANGULAR)	MAX	MAXIMUM
	DUCT UP (ROUND)	MBH	MANUFACTURER THOUSAND BTUH
	DUCT DOWN (ROUND)	MCA	MIDDLE
	CEILING OUTLET	MECH	MECHANICAL
	CEILING INLET	MIN	MINIMUM
	WALL OUTLET (OR INLET)	NO	NORMALLY OPEN
	THERMOSTAT	NC	NORMALLY CLOSED
		NO.	NUMBER
		NTS	NOT TO SCALE
		OBD	OPPOSED BLADE DAMPER
		OA	OUTSIDE AIR
		OAI	OUTSIDE AIR INTAKE
		PH	PHASE
		P.D.I.	PLUMBING AND DRAINAGE INST.
		PD	PRESSURE DROP
		R	RETURN
		RLA	RATED LOAD AMPS
		REF	REFERENCE
		RL	RAIN LEADER
		REL	REFRIGERANT LIQUID
		RG	REFRIGERANT GAS
		REQ'D	REQUIRED
		RA	RETURN AIR
		RPM	REVOLUTIONS PER MINUTE
		RM	ROOM
		RVI	ROOF VENT INTAKE
		RVR	ROOF VENT RELIEF
		S	SUPPLY
		SA	SUPPLY AIR
		SCO	SURFACE CLEANOUT
		SCW	SCIENCE COLD WATER
		S.O.	SCREENED OPENING
		SS	STAINLESS STEEL
		TEMP	TEMPERATURE
		TD	TRANSFER DUCT
		TG	TRANSFER GRILLE
		TYP	TYPICAL
		UNO	UNLESS NOTED OTHERWISE
		VFD	VARIABLE FREQUENCY DRIVE
		VTR	VENT THROUGH ROOF
		V	VOLTS, VOLTAGE, VENT
		WC	WATER COLUMN
		WCO	WALL CLEAN OUT
		WL	WALL LOUVER
		W	WASTE
		WA	WATT
		WB	WET BULB
		WTG	WALL TRANSFER GRILLE
		W	WITH
		ZD	ZONE DAMPER
	DETAIL/SECTION IDENTIFICATION NUMBER		
	SHEET ON WHICH DETAIL IS SHOWN		

NOTE: FOR DESCRIPTION OF OTHER ABBREVIATIONS SEE SYMBOL LISTING TO THE LEFT, EQUIPMENT/ITEMS SCHEDULES, AND ABBREVIATIONS LISTED IN SPECIFICATIONS

### MECHANICAL DRAWING INDEX

M0.01	MECHANICAL LEGEND & NOTES
M0.02	MECHANICAL GENERAL NOTES
M0.03	MECHANICAL SCHEDULES
M0.04	EXISTING EQUIPMENT MECHANICAL SCHEDULES
M1.01	PARTIAL 2ND FLOOR PLAN - PLUMBING DEMO
M1.02	ENLARGED PLAN OR 7 & 8 - PLUMBING DEMO
M1.11	PARTIAL 2ND FLOOR PLAN - HVAC DEMO
M1.12	ENLARGED PLAN OR 7 & 8 - HVAC DEMO
M3.01	PARTIAL 2ND FLOOR PLAN - PLUMBING
M3.02	ENLARGED PLAN OR 7 & 8 - PLUMBING
M3.11	PARTIAL 2ND FLOOR PLAN - MED GAS
M3.12	ENLARGED PLAN OR 7 & 8 - MED GAS
M3.20	PLUMBING DETAILS
M4.01	PARTIAL 2ND FLOOR PLAN - HVAC
M4.02	ENLARGED PLAN OR 7 & 8 - HVAC
M4.03	ENLARGED PARTIAL PLAN - 3RD FLOOR HVAC
M4.04	ENLARGED PARTIAL PLAN - 4TH FLOOR HVAC
M4.20	MECHANICAL DETAILS
M4.21	MECHANICAL DETAILS



OWNER:

**MultiCare**  
Tacoma General Hospital

PROJECT NAME:  
**OR 7&8  
Buildout**

Good Samaritan  
Hospital  
401 15th Ave SE  
Puyallup, WA 98372

MARK	DATE	DESCRIPTION
	3/19/2021	DESIGN DEVELOPMENT
	4/2/2021	PERMIT SET

PROJECT NO. **31232**


DRAWN BY:

DATE: **2 APRIL 2021**

COPYRIGHT TO:  
InSight Healthcare Architecture

SHEET TITLE:  
**MECHANICAL  
LEGEND &  
NOTES**

SHEET #:  
**M0.01**

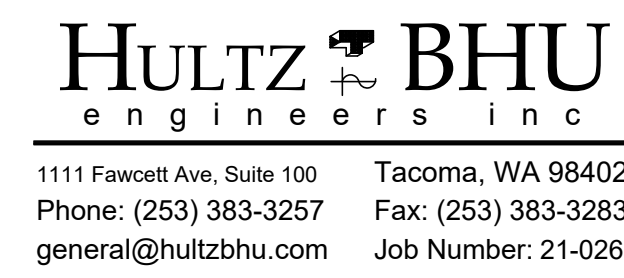

1111 Fawcett Ave, Suite 100 Tacoma, WA 98402  
Phone: (253) 383-3257 Fax: (253) 383-3283  
general@hultzbhu.com Job Number: 21-026

PLOTTED: Apr 02, 2021 11:04am  
 DWG PATH: C:\Users\mrbh\AppData\Local\Temp\AcPublish\_45976\21-026\_110\_01-03.dwg  
 PLOTTED BY: MrBH





City of Puyallup  
Development & Permitting Services  
**ISSUED PERMIT**

Building	Planning
Engineering	Public Works
Fire	Traffic

### PLUMBING FIXTURE SCHEDULE

SYMBOL	DESCRIPTION	W	V	CW	HW	TOTAL WSFU	CW WSFU	HW WSFU	DFU	REMARKS
P-6A	SCRUB SINK	3"	2"	1/2"	1/2"	3	2.25	2.25	3	WALL MOUNT. W/ FOOT PEDAL OPERATOR

### AIR INLET & OUTLET SCHEDULE

SYMBOL	TYPE	MANUFACTURER AND SERIES NUMBER	REMARKS
CD	CEILING DIFFUSER	TITUS PAS-AA	ALUMINUM PERFORATED FACE DIFFUSER
CRG	CEILING RETURN GRILLE	TITUS PAS	ALUMINUM PERFORATED FACE GRILLE
CEG	CEILING EXHAUST GRILLE	TITUS PAS	ALUMINUM PERFORATED FACE GRILLE
WSR	WALL SUPPLY REGISTER	KRUEGER SERIES 5880H	DOUBLE DEFLECTION, HORIZ. FACE BARS, VERT. REAR BARS 3/4" o.c.
WEG	WALL RETURN GRILLE	KEES GHD40 RETURN	HORIZ. FACE BARS 1/2" O.C., 40" DEFLECTION

**NOTES:**

1. CEILING DIFFUSERS (CD) SHALL HAVE NO. & DIRECTION OF THROWS AS INDICATED ON PLANS. (E.G. CD-3 = 3 WAY THROW)
2. ALL AIR TERMINALS SHALL HAVE FACTORY FINISH, COLOR AS SELECTED BY ARCHITECT.
3. SEE LEGEND FOR TERMINOLOGY USED IN AIR TERMINAL CALL-OUTS ON DRAWINGS.
4. SEE ARCH. FINISH SCHEDULE FOR CEILING TYPES, PROVIDE AIR TERMINALS TO MATCH CEILING CONSTRUCTION INSTALLED IN.
5. SEE HVAC PLANS FOR CRITICAL CARE AREA SPECIALIZED GRILLES.

#### VENTILATION DESIGN CRITERIA - HEALTHCARE AREAS

Project:	GSH MULTICARE - OR 7 & 8																			5160			
Job No:	21-026																			1500			
																				29.07%			
	ASHRAE TABLE 7.1									Room Size			Calculated Airflows				Design Airflows & Actual Pressure Relationships						
Unit No.	Room Name and Number	Code Title for Function of Space	Pressure Relationship	Code OA ach	Code Total ach	All Rm Air Exh ?	Air Circ by Rm Units	Design RH %	Design Temp deg F	Room SF	Room Ht	Room Vol	Code OA CFM by ACH	Code OA CFM by IMC	Code Total CFM	Code Min EA CFM	Design Supply Air (SA)	Design Exhaust Air (EA)	Design Return Air (RA)	Excess Air SA-EA-RA	Pressure Relationship	Filter Bank 1 & 2 MERV	OA Provided
Existing SAHU-2A	OR 7 - M286	Operating Room	P	3	15	N/R	NO	30-60	70-75	553	8.46	4678	234	33	1170		2580	2400		180	P	7	750
Existing SAHU-2C	OR 8 - M285	Operating Room	P	3	15	N/R	NO	30-60	70-75	543	8.46	4594	230	33	1148		2580	2400		180	P	7	750




**InSight HealthCare Architecture**  
K.Langlois@insightdesignstudio.biz  
12345 Lake City Way NE #2108  
Seattle, WA 98125  
206-601-6645



**SIGNED**  
4-2-2021

OWNER:



PROJECT NAME:  
**OR 7&8 Buildout**

Good Samaritan Hospital  
401 15th Ave SE  
Puyallup, WA 98372

MARK	DATE	DESCRIPTION
	3/19/2021	DESIGN DEVELOPMENT
	4/2/2021	PERMIT SET


PROJECT NO. 31232

DRAWN BY:

DATE: 2 APRIL 2021  
COPYRIGHT TO:  
InSight Healthcare Architecture


SHEET TITLE:  
**MECHANICAL SCHEDULES**

SHEET #:  
**M0.03**



1111 Fawcett Ave, Suite 100 Tacoma, WA 98402  
Phone: (253) 383-3257 Fax: (253) 383-3283  
general@hultzbhu.com Job Number: 21-026

PLOTTED: Apr 02, 2021 - 11:04am  
 DWG PATH: C:\Users\mtdib\OneDrive\My Documents\Temp\AcPublish\459176\21-026\M0\_01-03.dwg  
 PLOTTED BY: mtdib

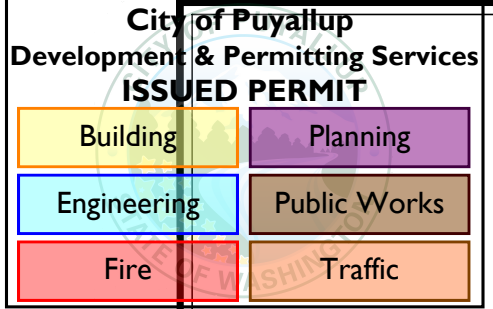

MARK LOCATION SERVICES	OR 8		OR 7	
	MECH-1 SAHU-2C	MECH-2 SAHU-2A	MECH-3 SAHU-2D	MECH-4 SAHU-2B
TYPE	MECH RM	MECH RM	MECH RM	MECH RM
AIR	MECH RM	MECH RM	MECH RM	MECH RM
FLUID	MECH RM	MECH RM	MECH RM	MECH RM
OPER WEIGHT	MECH RM	MECH RM	MECH RM	MECH RM
BASIS OF DESIGN	MECH RM	MECH RM	MECH RM	MECH RM
NOTES:	1. 20% PROPYLENE GLYCOL.			

MARK LOCATION SERVICES	OR 7				OR 8			
	SAHU-1A LEVEL 4 4" PLEATED	SAHU-1E LEVEL 1 EAST 4" PLEATED	SAHU-1W LEVEL 1 WEST 4" PLEATED	SAHU-2A LEVEL 4 4" PLEATED	SAHU-2B LEVEL 4 4" PLEATED	SAHU-2C LEVEL 4 4" PLEATED	SAHU-2D LEVEL 4 4" PLEATED	SAHU-2E LEVEL 4 4" PLEATED
PREFILTERS	TYPE	TYPE	TYPE	TYPE	TYPE	TYPE	TYPE	TYPE
FUTURE FILTER BANK	TYPE	TYPE	TYPE	TYPE	TYPE	TYPE	TYPE	TYPE
HEAT RECOVERY COIL	TYPE	TYPE	TYPE	TYPE	TYPE	TYPE	TYPE	TYPE
PREHEATING COIL	TYPE	TYPE	TYPE	TYPE	TYPE	TYPE	TYPE	TYPE
COOLING COIL	TYPE	TYPE	TYPE	TYPE	TYPE	TYPE	TYPE	TYPE
STEAM HUMIDIFIER	TYPE	TYPE	TYPE	TYPE	TYPE	TYPE	TYPE	TYPE
PLenum FAN	TYPE	TYPE	TYPE	TYPE	TYPE	TYPE	TYPE	TYPE
FINAL FILTERS	TYPE	TYPE	TYPE	TYPE	TYPE	TYPE	TYPE	TYPE
SOUND ATTENUATION	TYPE	TYPE	TYPE	TYPE	TYPE	TYPE	TYPE	TYPE
OPER WEIGHT	TYPE	TYPE	TYPE	TYPE	TYPE	TYPE	TYPE	TYPE
BASIS OF DESIGN	TYPE	TYPE	TYPE	TYPE	TYPE	TYPE	TYPE	TYPE
NOTES:	1. EACH AHU, RF, AND EF IS DESIGNED TO MEET SUPPLY FAN CFM WITH ONE FAN NOT RUNNING AT FUTURE MAX CAPACITY. 2. TOTAL STATIC PRESSURE IS CALLED OUT AT CURRENT/FUTURE CONDITIONS AND INCLUDES ALL COMPONENTS, AND 1.75 IN. WG ALLOWANCE FOR FILTER LOADING AND FUTURE FILTER. 3. NOMINAL AIRFLOW QUANTITY IS FOR ALL FANS RUNNING FOR THE AHU AT THE CURRENT AIRFLOW CAPACITY. 4. PROVIDE PERFORMANCE DATA FOR THE FOLLOWING CONDITIONS: MAXIMUM CFM PER FAN AT MAXIMUM UNIT AIRFLOW (N=1) FANS RUNNING, NOMINAL CFM PER FAN AT MAXIMUM UNIT AIRFLOW (N=7) FANS RUNNING. 5. SELECT COOLING, HEATING AND HEAT RECOVERY COILS WITH A 20% PROPYLENE GLYCOL MIXTURE. 6. ALL SAHUS OPERATE ON EMERGENCY POWER. 7. FAN CONTRACTOR SHALL ADJUST FANS FOR ACTUAL CFM BASED ON THE SUM OF TERMINAL UNIT CFM PLUS ACTUAL DUCT LEAKAGE. 8. PERFORMANCE CURVE IS BASED ON FUTURE CONDITIONS.							

MARK LOCATION SERVICES	OR 8				OR 7			
	MECH-1 SAHU-2C	MECH-2 SAHU-2A	MECH-3 SAHU-2D	MECH-4 SAHU-2B	MECH-1 SAHU-2C	MECH-2 SAHU-2A	MECH-3 SAHU-2D	MECH-4 SAHU-2B
TYPE	MECH RM	MECH RM	MECH RM	MECH RM	MECH RM	MECH RM	MECH RM	MECH RM
AIR	MECH RM	MECH RM	MECH RM	MECH RM	MECH RM	MECH RM	MECH RM	MECH RM
FLUID	MECH RM	MECH RM	MECH RM	MECH RM	MECH RM	MECH RM	MECH RM	MECH RM
OPER WEIGHT	MECH RM	MECH RM	MECH RM	MECH RM	MECH RM	MECH RM	MECH RM	MECH RM
BASIS OF DESIGN	MECH RM	MECH RM	MECH RM	MECH RM	MECH RM	MECH RM	MECH RM	MECH RM
NOTES:	1. 20% PROPYLENE GLYCOL.							

MARK LOCATION SERVICES	OR 8		OR 7	
	H-1 SAHU-2C	H-2 SAHU-2A	H-3 SAHU-2D	H-4 SAHU-2B
TYPE	MECH RM	MECH RM	MECH RM	MECH RM
AIR	MECH RM	MECH RM	MECH RM	MECH RM
FLUID	MECH RM	MECH RM	MECH RM	MECH RM
OPER WEIGHT	MECH RM	MECH RM	MECH RM	MECH RM
BASIS OF DESIGN	MECH RM	MECH RM	MECH RM	MECH RM
NOTES:	1. PRESSURE AT INLET OF CONTROL VALVE, SERVS 1000-EM. 2. STEAM DISTRIBUTION MAINS ARE INSTALLED IN AIR HANDLING UNIT. 3. CAPACITY BASED ON 100% OSA, 15 DEGREE EAST AND 50 DEGREE LAT.			

MARK LOCATION SERVICES	OR 8				OR 7			
	SA-1 SAHU-2C	SA-2 SAHU-2A	SA-3 SAHU-2D	SA-4 SAHU-2B	SA-1 SAHU-2C	SA-2 SAHU-2A	SA-3 SAHU-2D	SA-4 SAHU-2B
TYPE	MECH RM	MECH RM	MECH RM	MECH RM	MECH RM	MECH RM	MECH RM	MECH RM
AIR	MECH RM	MECH RM	MECH RM	MECH RM	MECH RM	MECH RM	MECH RM	MECH RM
FLUID	MECH RM	MECH RM	MECH RM	MECH RM	MECH RM	MECH RM	MECH RM	MECH RM
OPER WEIGHT	MECH RM	MECH RM	MECH RM	MECH RM	MECH RM	MECH RM	MECH RM	MECH RM
BASIS OF DESIGN	MECH RM	MECH RM	MECH RM	MECH RM	MECH RM	MECH RM	MECH RM	MECH RM

NOTE: THESE SCHEDULES ARE FOR EXISTING UNITS INSTALLED IN 2008 AS PART OF A SHELL AND CORE PROJECT. SHOWN FOR CONTRACTOR'S INFORMATION.

**HULTZ BHU**  
engineers inc  
1111 Favocat Ave, Suite 100  
Tacoma, WA 98402  
Phone: (253) 383-3257 Fax: (253) 383-3283  
general@hultzbhu.com Job Number: 21-026



OWNER:  
**MultiCare Tacoma General Hospital**  
PROJECT NAME:  
**OR 7&8 Buildout**  
Good Samaritan Hospital  
401 15th Ave SE  
Puyallup, WA 98372

MARK	DATE	DESCRIPTION
3/19/2021		DESIGN DEVELOPMENT
4/2/2021		PERMIT SET

PROJECT NO. 31232  
DRAWN BY:  
DATE: 2 APRIL 2021  
COPYRIGHT TO:  
InSight Healthcare Architecture


SHEET TITLE:  
**EXISTING MECHANICAL SCHEDULES**

SHEET #:  
**M0.04**


PLOTTED BY: Notch  
PLOT DATE: Apr 02, 2021 - 11:04am  
DWG PATH: C:\Users\mrbto\AppData\Local\Temp\AcPublish\_L5976\21-026\_M0\_01-03.dwg

City of Puyallup  
Development & Permitting Services  
**ISSUED PERMIT**


Building	Planning
Engineering	Public Works
Fire	Traffic

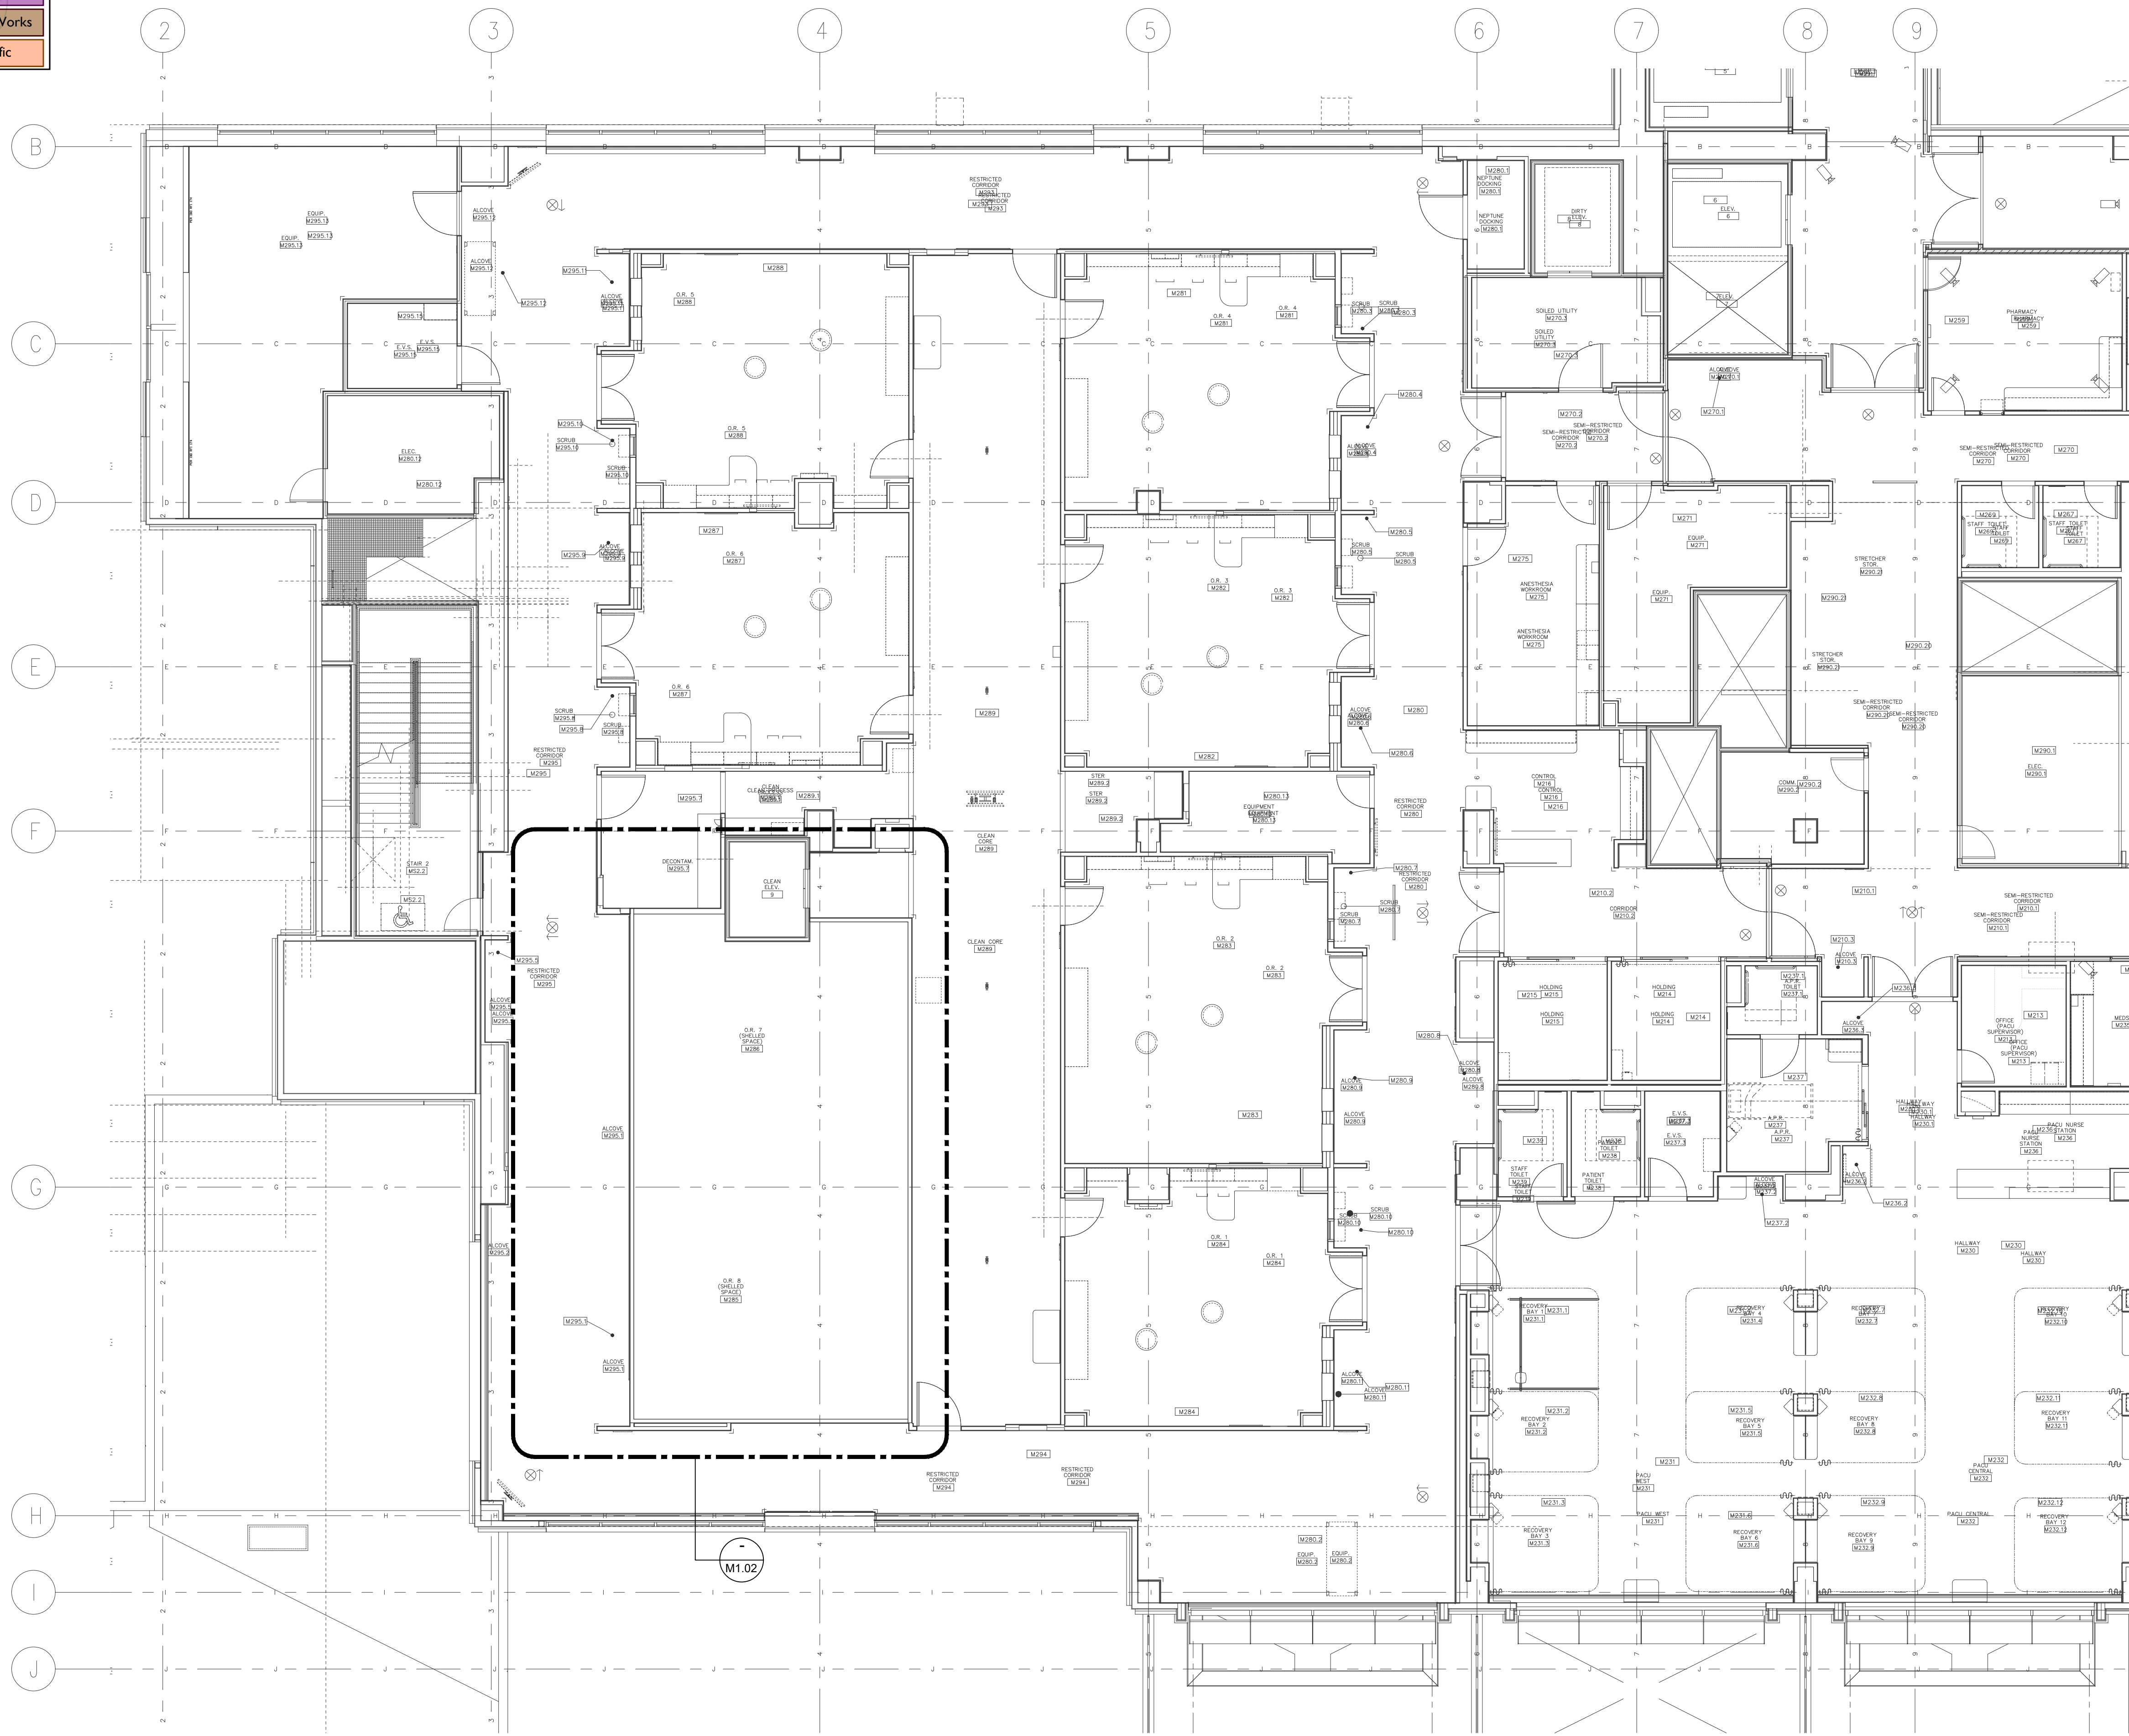

**GENERAL NOTES:**  
1. FOR GENERAL DEMOLITION NOTES SEE SHEET M0.02.

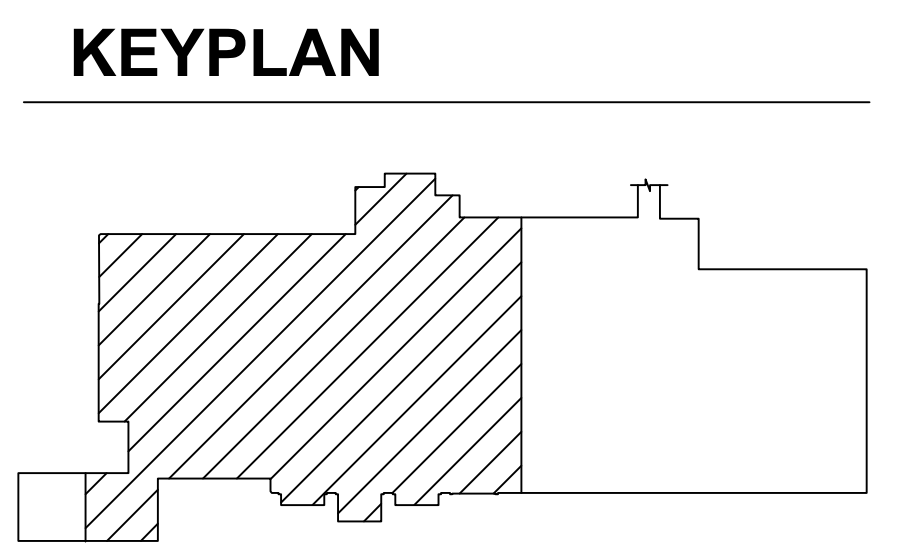

**PARTIAL 2ND FLOOR PLAN - PLUMBING DEMO**

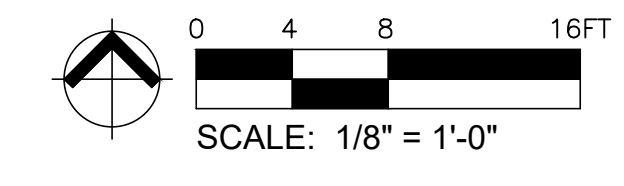

**HULTZ BHU**  
engineers inc

1111 Fawcett Ave, Suite 100 Tacoma, WA 98402  
Phone: (253) 383-3257 Fax: (253) 383-3283  
general@hultzbhu.com Job Number: 21-026

PLOTTED: Apr 02, 2021 - 11:04am  
 DWG PATH: I:\2021-366521-026\Acad\Tech\21-026\_T101.dwg  
 PLOTTED BY: MdB

**InSight**  
HealthCare Architecture  
KLanglois@InSightDesignStudio.biz  
12345 Lake City Way NE #2108  
Seattle, WA 98125  
206-601-6645

SIGNED  
4-2-2021

OWNER:  
**MultiCare Tacoma General Hospital**

PROJECT NAME:  
**OR 7&8 Buildout**  
Good Samaritan Hospital  
401 15th Ave SE  
Puyallup, WA 98372

MARK	DATE	DESCRIPTION
	3/19/2021	DESIGN DEVELOPMENT
	4/2/2021	PERMIT SET

PROJECT NO. **31232**

DRAWN BY:


DATE: **2 APRIL 2021**  
COPYRIGHT TO:  
InSight Healthcare Architecture

SHEET TITLE:  
**PARTIAL 2ND FLOOR PLAN - PLUMBING DEMO**

SHEET #:  
**M1.01**

City of Puyallup  
Development & Permitting Services  
**ISSUED PERMIT**


Building	Planning
Engineering	Public Works
Fire	Traffic

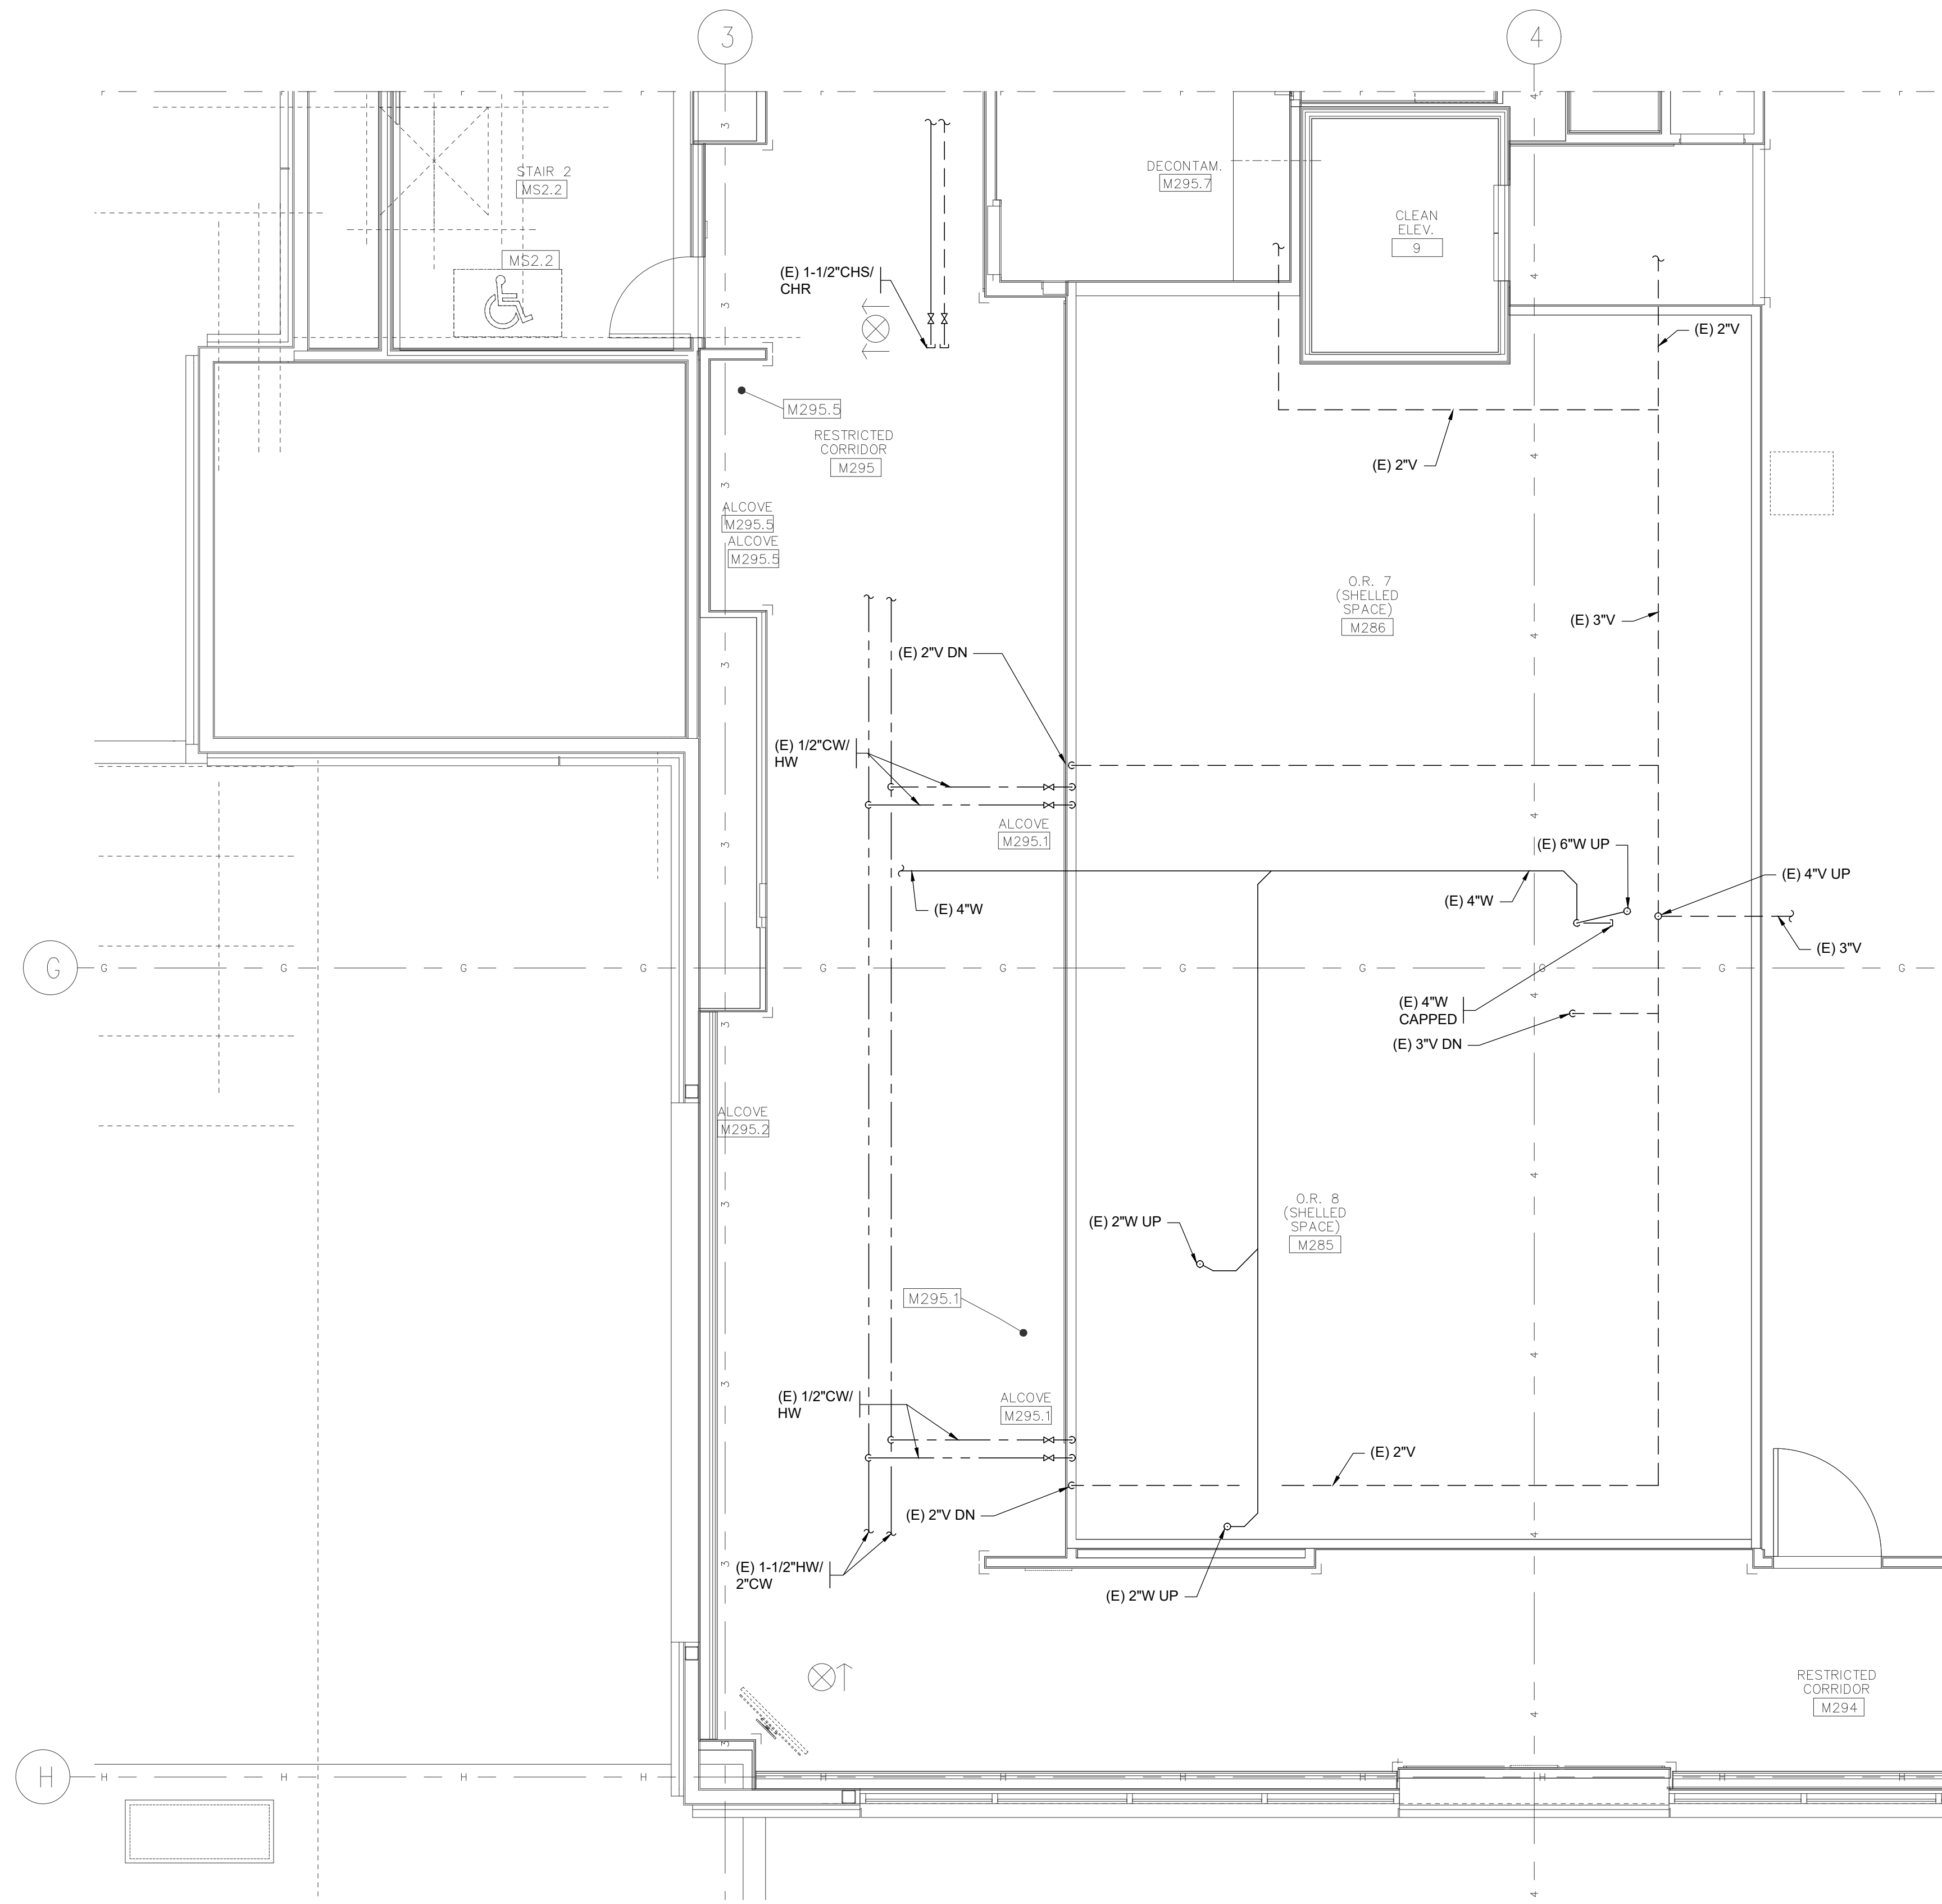

**GENERAL NOTES:**

1. FOR GENERAL DEMOLITION NOTES SEE SHEET M0.02.

**KEYPLAN**

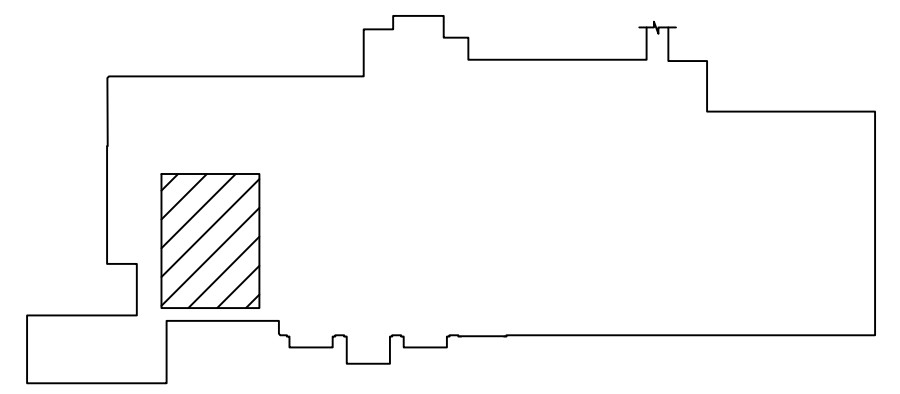

**ENLARGED PLAN OR 7 & 8 - PLUMBING DEMO**



**HULTZ & BHU**  
engineers inc

1111 Fawcett Ave, Suite 100 Tacoma, WA 98402  
Phone: (253) 383-3257 Fax: (253) 383-3283  
general@hultzbhu.com Job Number: 21-026

**InSight**  
HealthCare Architecture  
KLanglois@insightdesignstudio.biz  
12345 Lake City Way NE #2108  
Seattle, WA 98125  
206-601-6645

SIGNED  
4-2-2021

OWNER:  
**MultiCare**  
**Tacoma General Hospital**

PROJECT NAME:  
**OR 7&8**  
**Buildout**

Good Samaritan  
Hospital  
401 15th Ave SE  
Puyallup, WA 98372

MARK	DATE	DESCRIPTION
	3/19/2021	DESIGN DEVELOPMENT
	4/2/2021	PERMIT SET

PROJECT NO. 31232

DRAWN BY:

DATE: 2 APRIL 2021

COPYRIGHT TO:  
InSight Healthcare Architecture

SHEET TITLE:


**ENLARGED**  
**PLAN OR 7 & 8 -**  
**PLUMBING**  
**DEMO**

SHEET #:


**M1.02**

PLOTTED: Apr 02, 2021 - 11:04am PLOTTED BY: MdB  
DWG PATH: I:\2021 - 366521-026\Acad\Tech\21-026\_T102.dwg


City of Puyallup Development & Permitting Services <b>ISSUED PERMIT</b>	
Building	Planning
Engineering	Public Works
Fire	Traffic

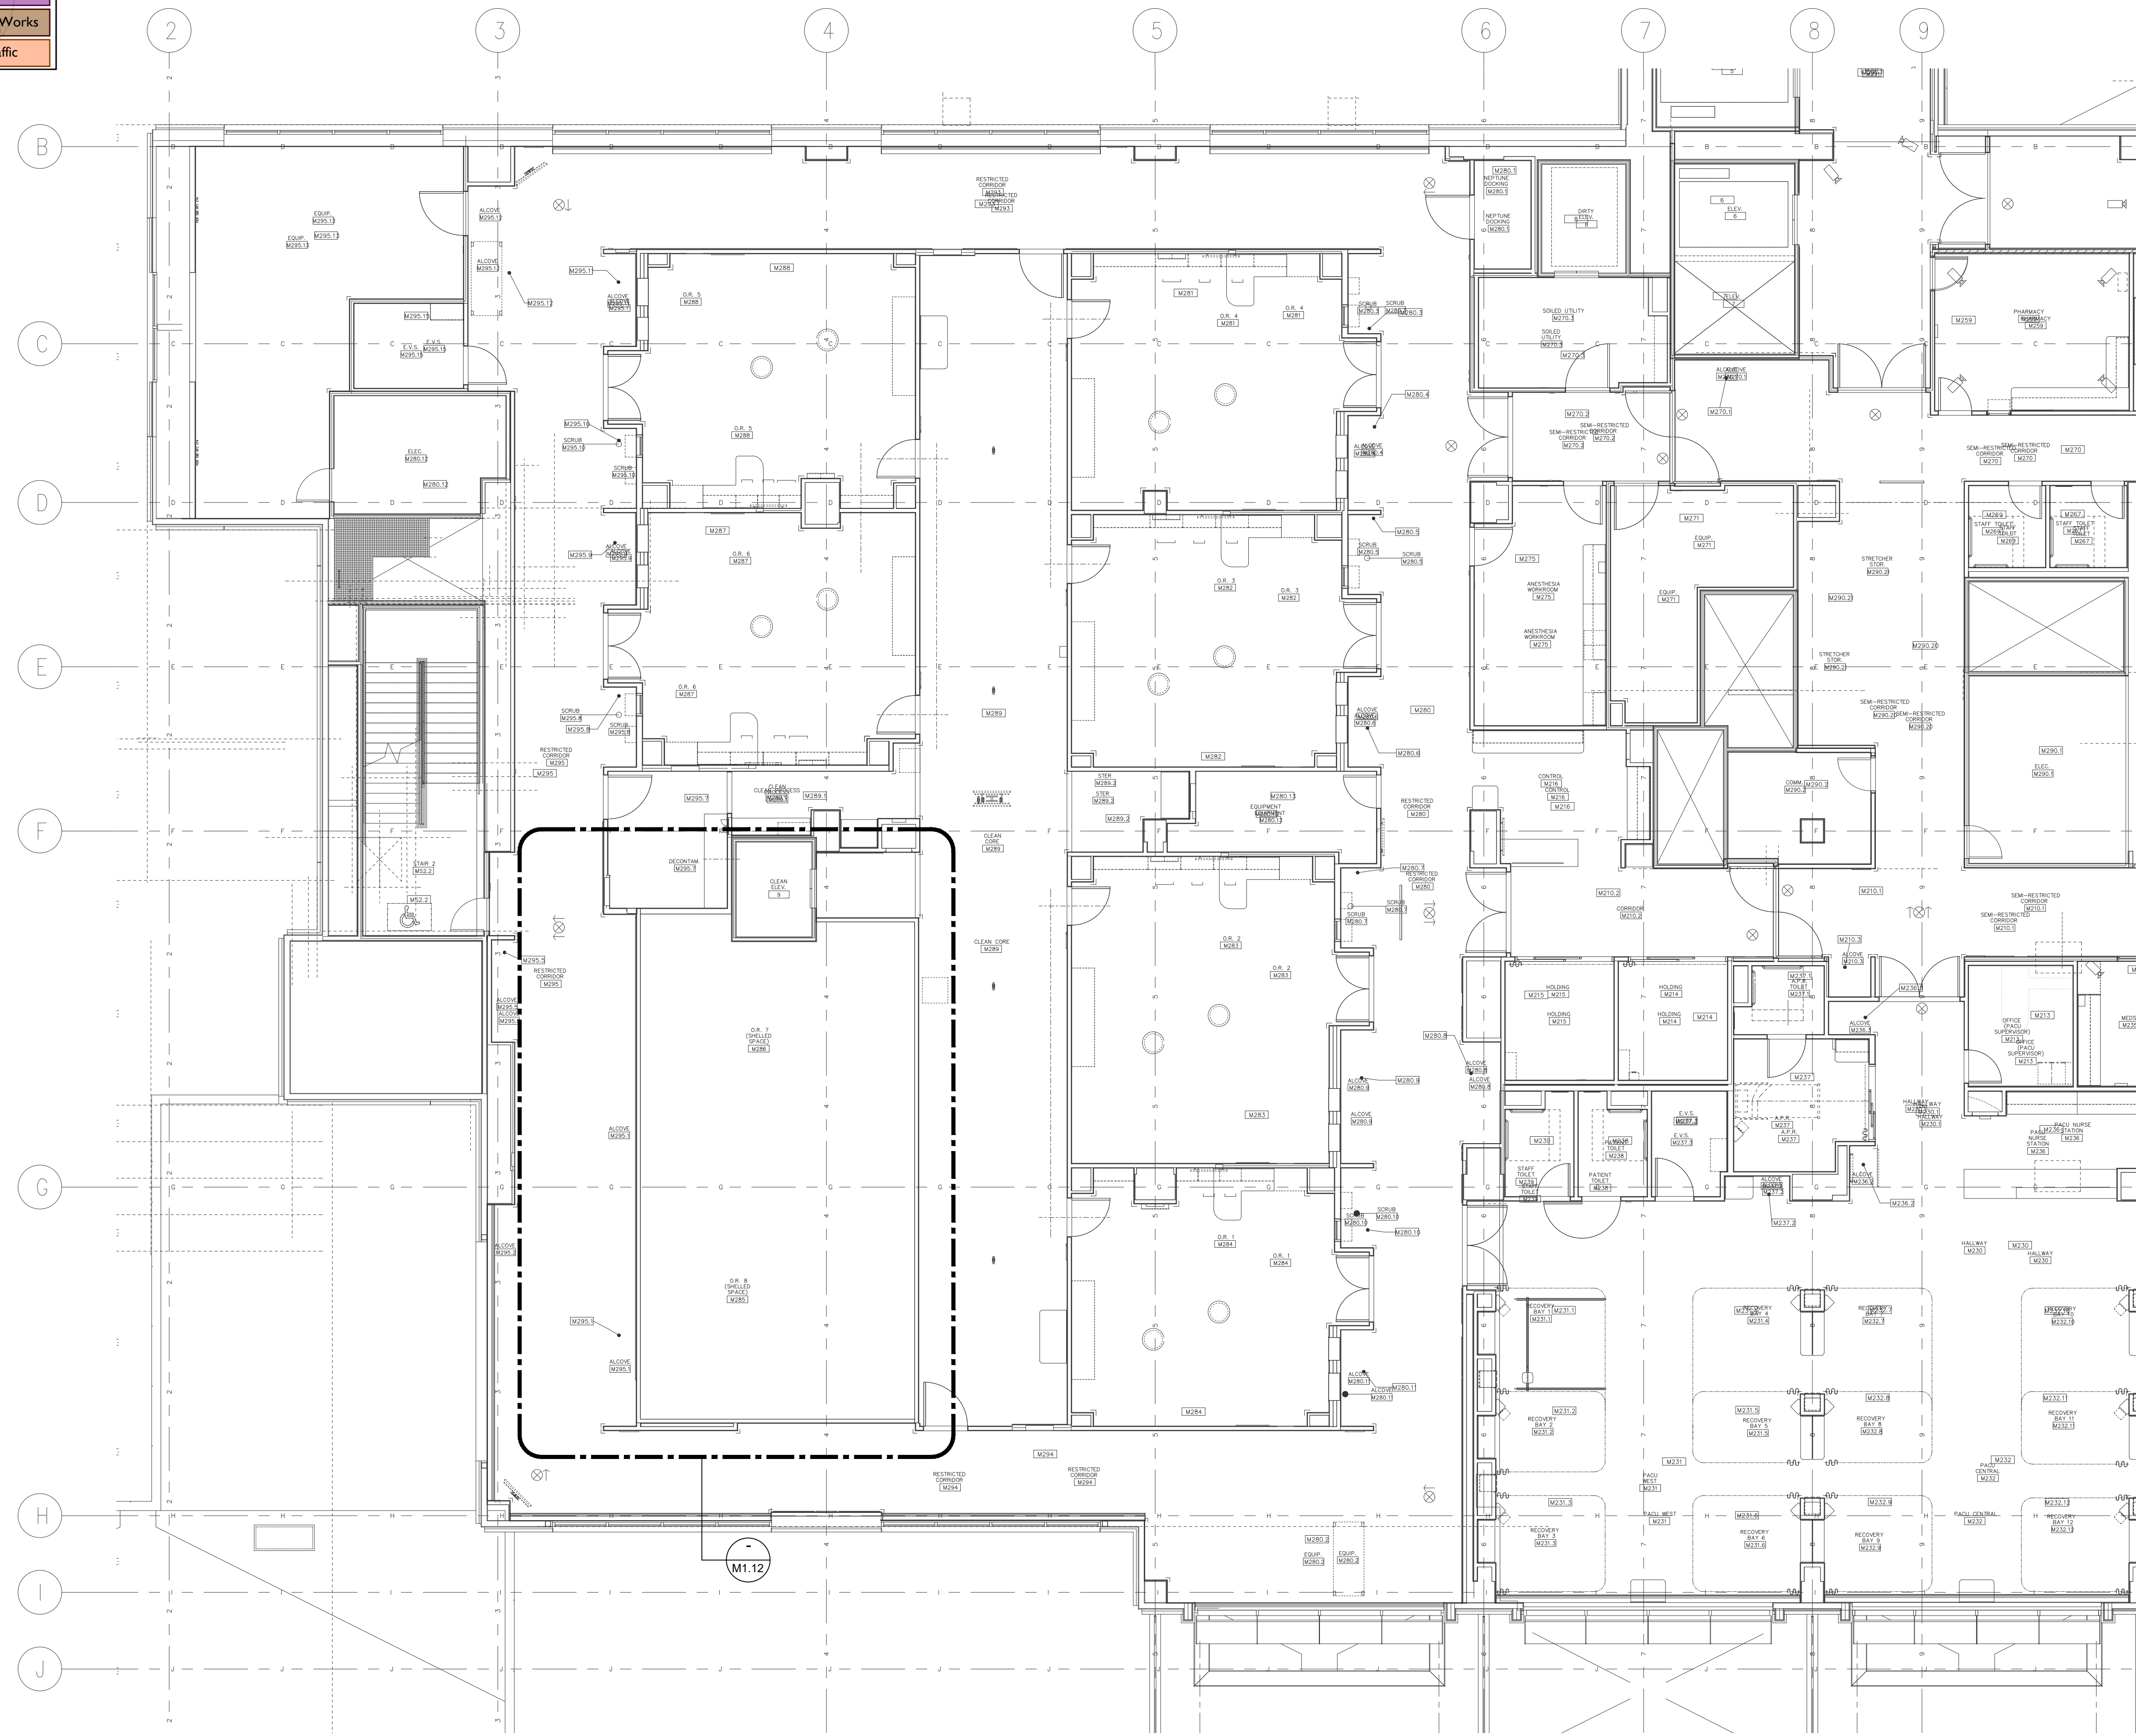

**GENERAL NOTES:**  
 1. FOR GENERAL DEMOLITION NOTES SEE SHEET M0.02.

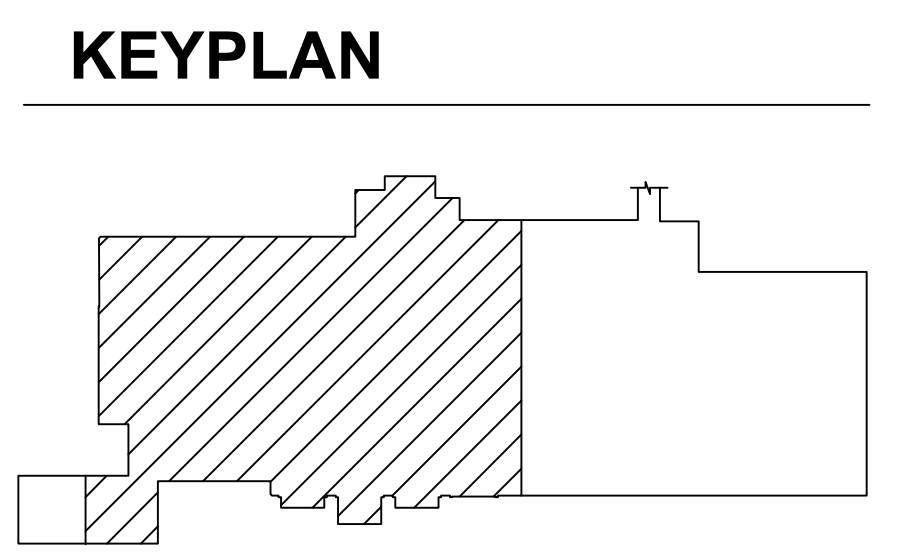

PARTIAL 2ND FLOOR PLAN - HVAC DEMO

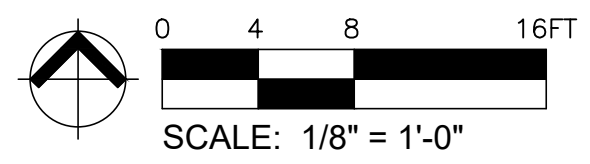

**HULTZ BHU**  
engineers inc

1111 Fawcett Ave, Suite 100 Tacoma, WA 98402  
 Phone: (253) 383-3257 Fax: (253) 383-3283  
 general@hultzbhu.com Job Number: 21-026

PLOTTED: Apr 02, 2021 - 11:05am PLOTTED BY: MdLB  
 DWG PATH: I:\2021-366521-026-VCSA\hvac\21-026-J111.dwg

**InSight**  
HealthCare Architecture  
 KLanglois@InSightDesignStudio.biz  
 12345 Lake City Way NE #2108  
 Seattle, WA 98125  
 206-601-6645

SIGNED  
4-2-2021

OWNER:  
**MultiCare Tacoma General Hospital**

PROJECT NAME:  
**OR 7&8 Buildout**  
 Good Samaritan Hospital  
 401 15th Ave SE  
 Puyallup, WA 98372

MARK	DATE	DESCRIPTION
	3/19/2021	DESIGN DEVELOPMENT
	4/2/2021	PERMIT SET

PROJECT NO. 31232

DRAWN BY:

DATE: 2 APRIL 2021  
 COPYRIGHT TO:  
 InSight Healthcare Architecture


SHEET TITLE:  
**PARTIAL 2ND FLOOR PLAN - HVAC DEMO**

SHEET #:  
**M1.11**

City of Puyallup  
Development & Permitting Services

**ISSUED PERMIT**

Building	Planning
Engineering	Public Works
Fire	Traffic

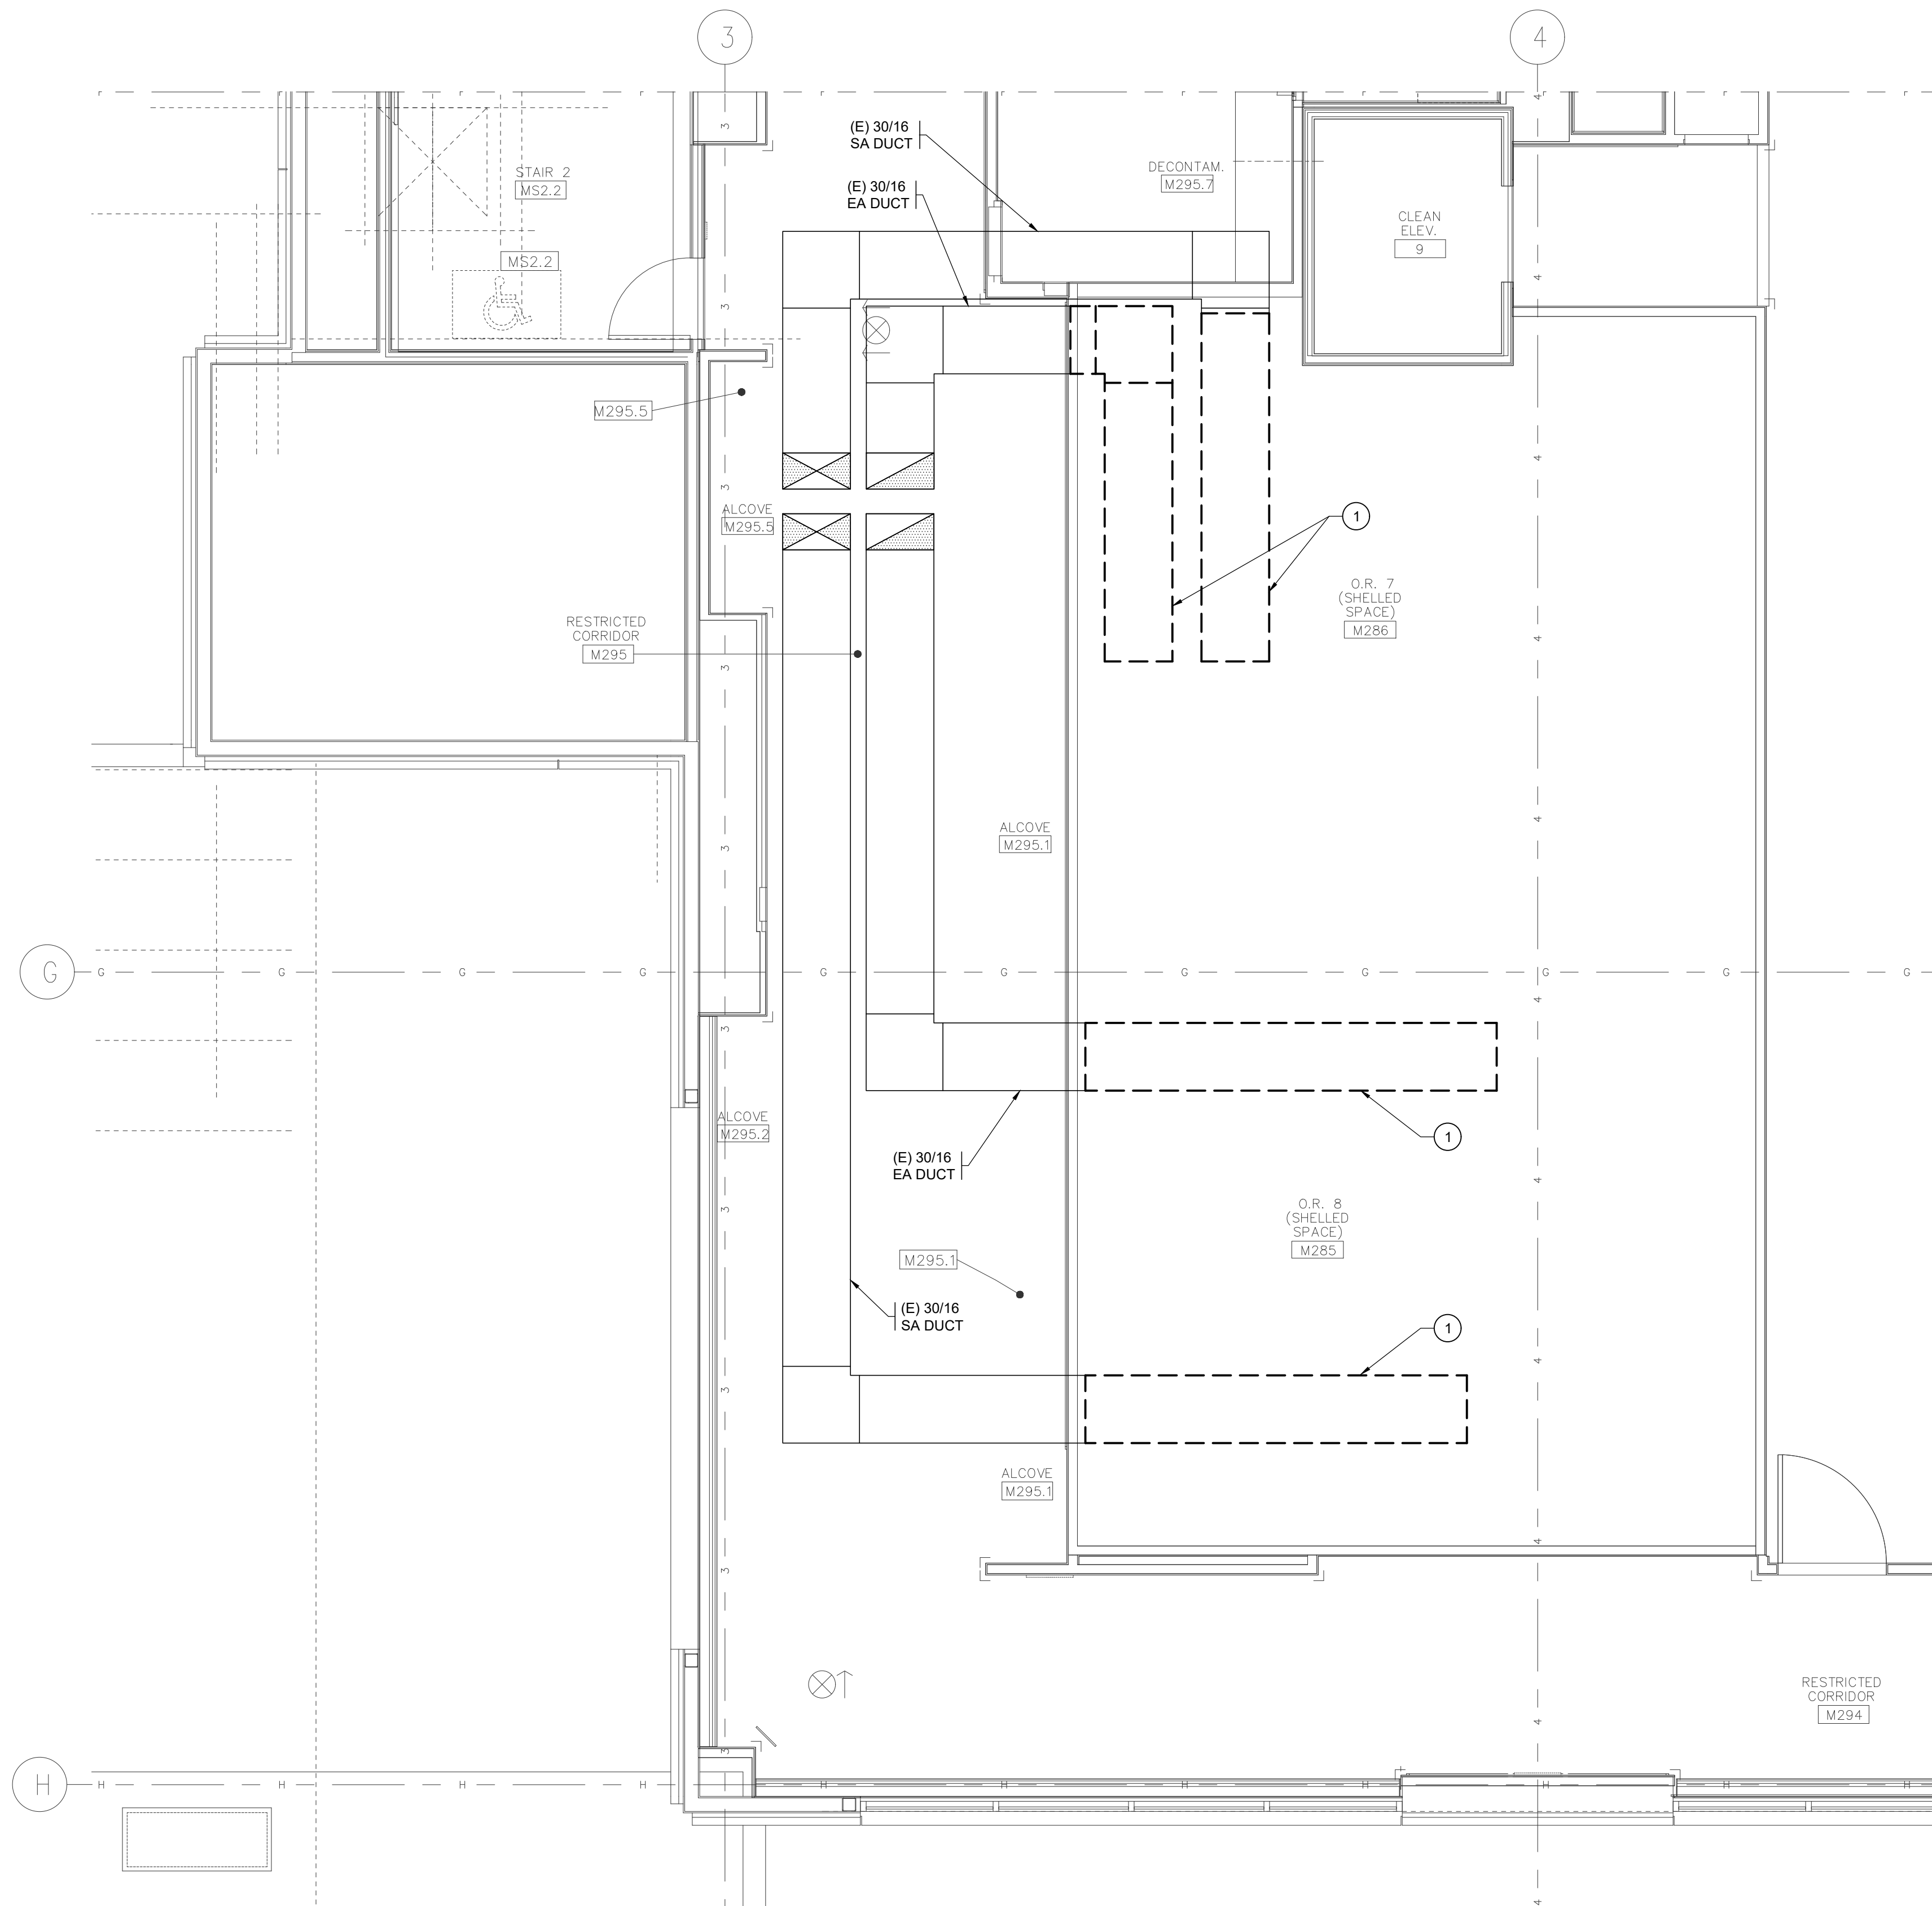


**GENERAL NOTES:**

1. FOR GENERAL DEMOLITION NOTES SEE SHEET M0.02.

**KEYED NOTES:**

- 1 REMOVE (E) DUCTWORK AND ASSOCIATED SUPPORTS & ACCESSORIES.

**KEYPLAN**

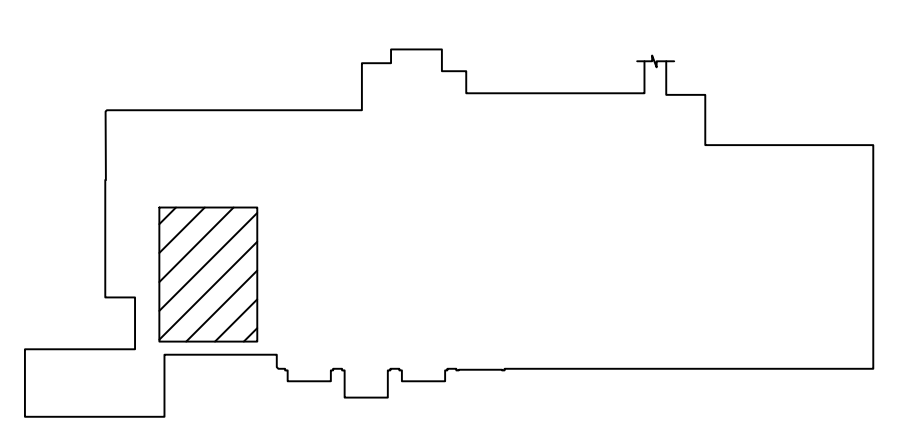

ENLARGED PLAN OR 7 & 8 - HVAC DEMO



**HULTZ BHU**  
engineers inc

1111 Fawcett Ave, Suite 100 Tacoma, WA 98402  
Phone: (253) 383-3257 Fax: (253) 383-3283  
general@hultzbhu.com Job Number: 21-026

*InSight*  
**HealthCare Architecture**  
KLanglois@InSightDesignStudio.biz  
12345 Lake City Way NE #2108  
Seattle, WA 98125  
206-601-6645

SIGNED  
4-2-2021

OWNER:

**MultiCare**  
**Tacoma General Hospital**

PROJECT NAME:  
**OR 7&8  
Buildout**  
Good Samaritan  
Hospital  
401 15th Ave SE  
Puyallup, WA 98372

MARK	DATE	DESCRIPTION
	3/19/2021	DESIGN DEVELOPMENT
	4/2/2021	PERMIT SET

PROJECT NO. 31232

DRAWN BY:

DATE: 2 APRIL 2021

COPYRIGHT TO:  
InSight Healthcare Architecture


SHEET TITLE:

**ENLARGED  
PLAN OR 7 & 8 -  
HVAC DEMO**

SHEET #:

**M1.12**


PLOTTED: Apr 02, 2021 - 11:05am PLOTTED BY: mdhb  
 DWG PATH: P:\2021-2022\366521-026\Acad\Tech\N21-026-PL112.dwg

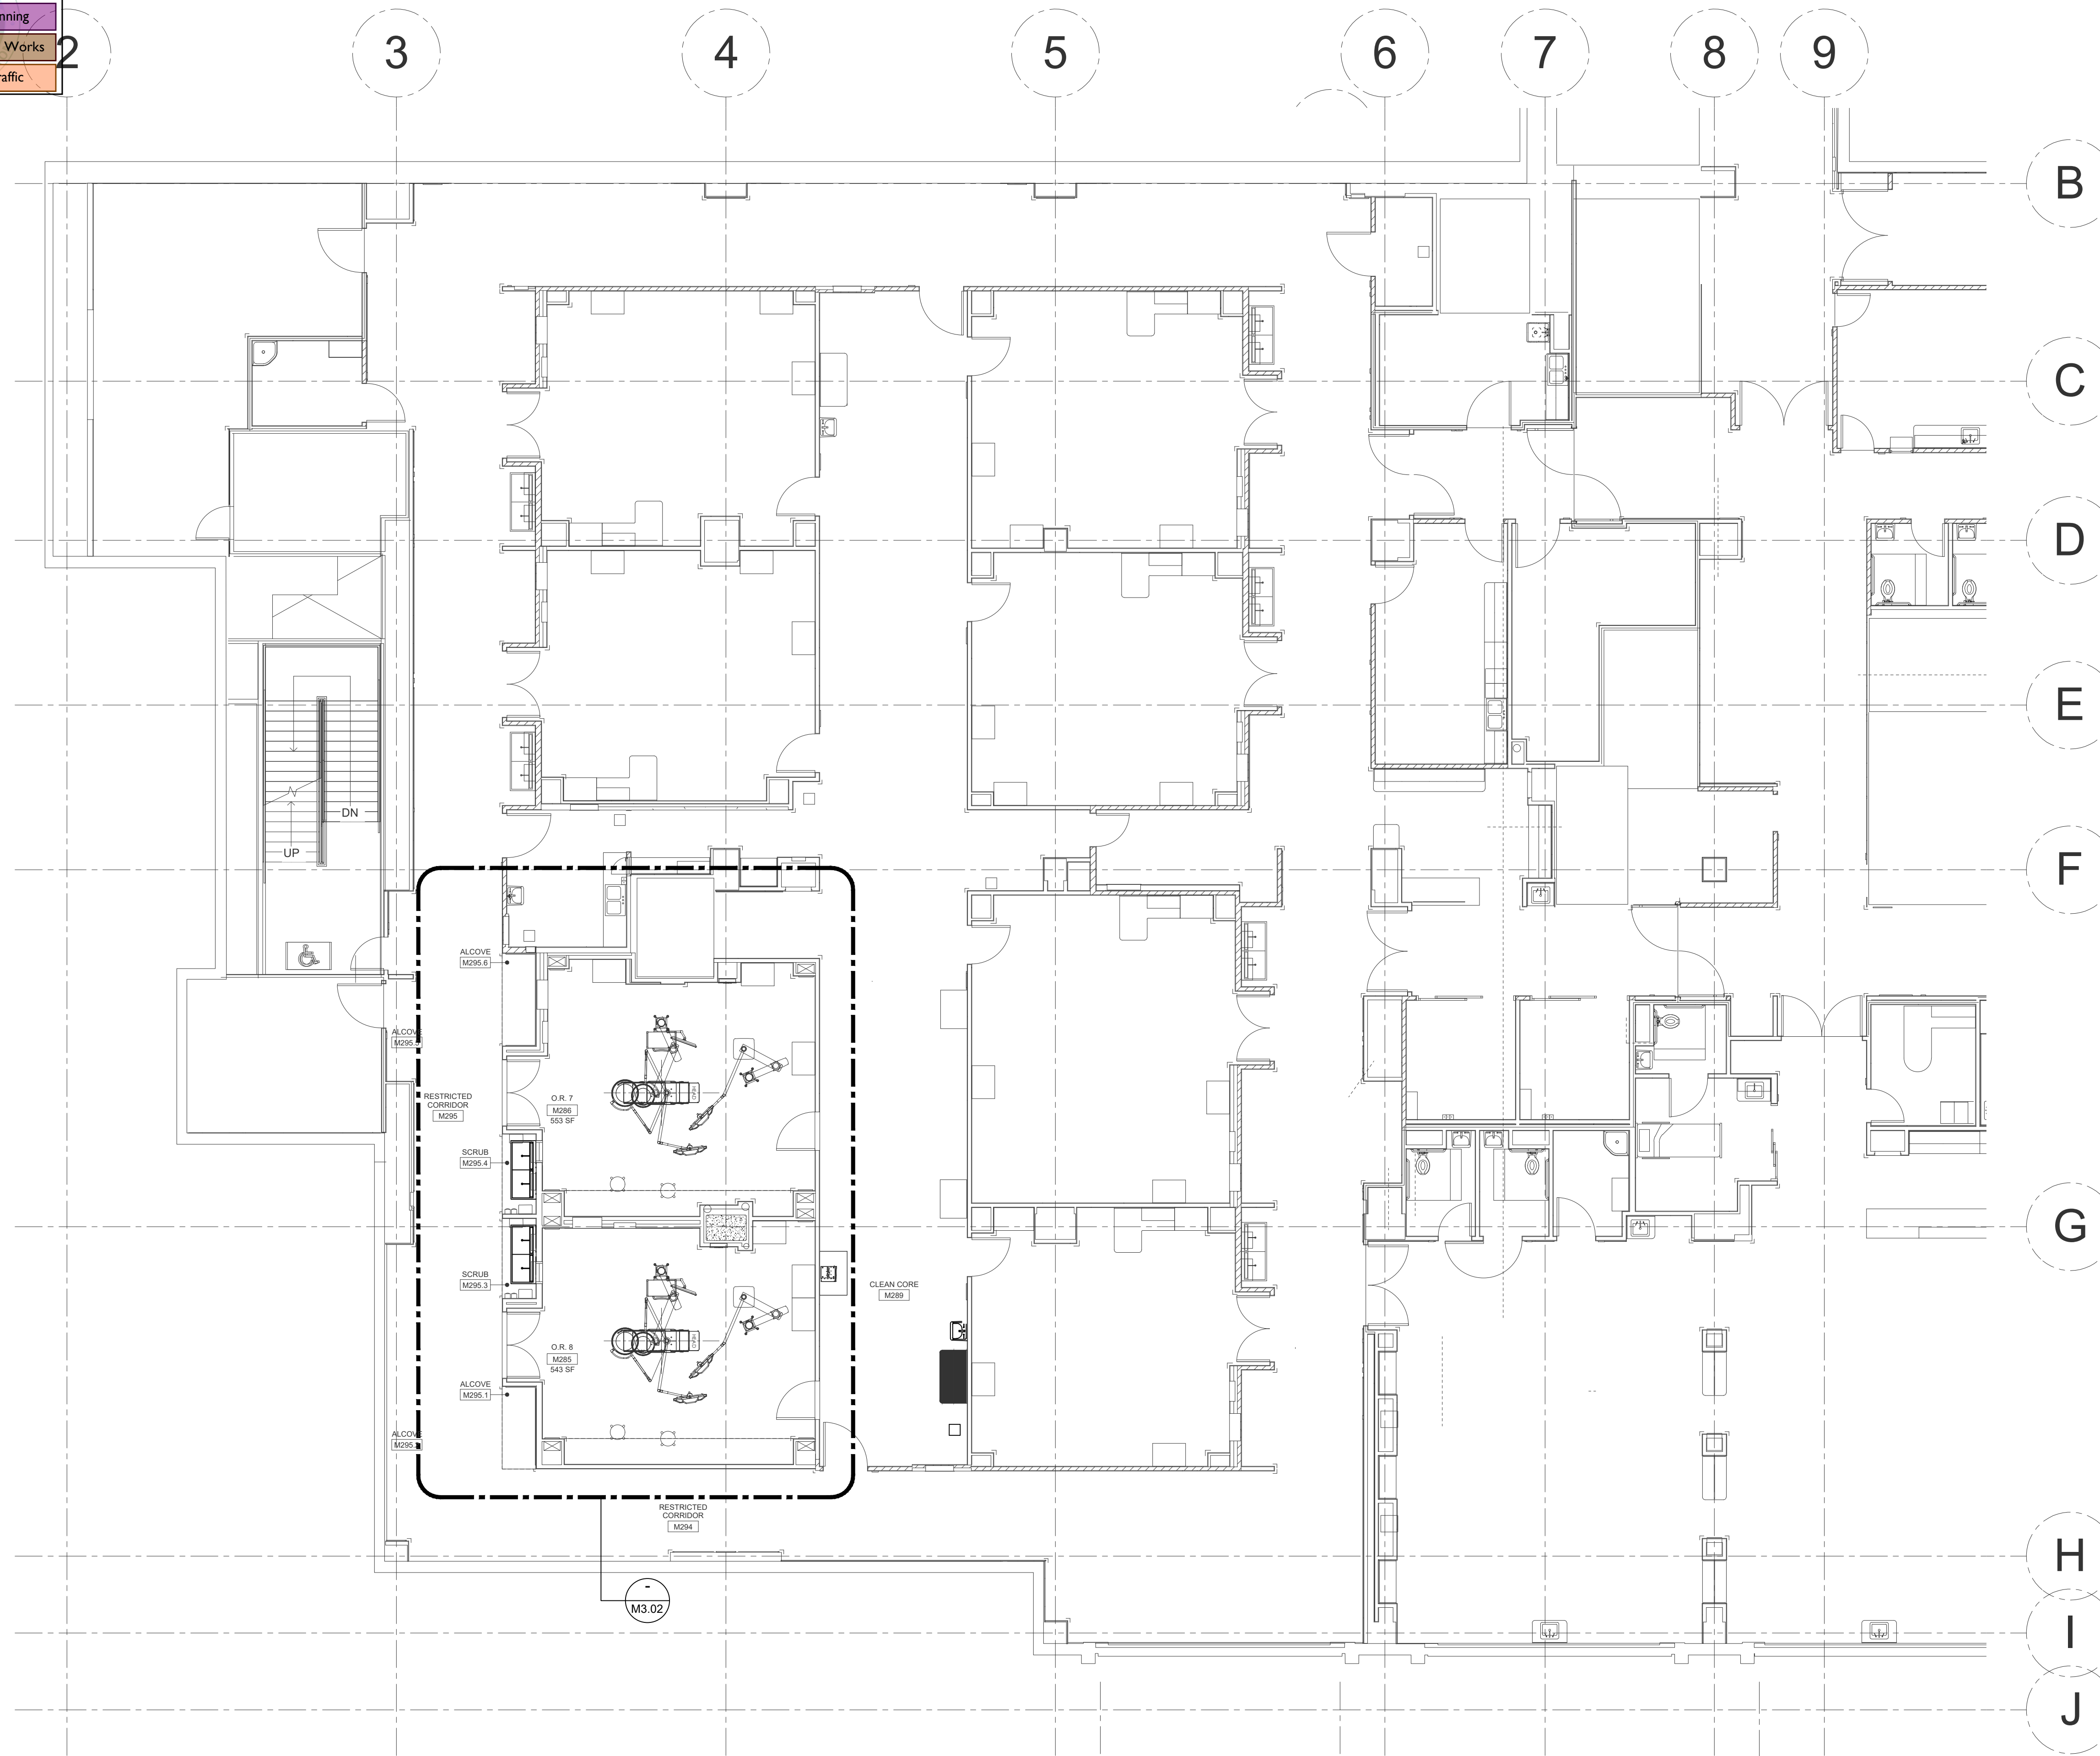


**GENERAL NOTES:**

1. FOR GENERAL NOTES SEE SHEET M0.01 & M0.02.
2. FOR PIPING SIZES TO INDIVIDUAL FIXTURES, SEE PLUMBING FIXTURE SCHEDULE ON SHEET M0.03.
3. OFFSET VTR'S AND PIPING AS REQUIRED TO AVOID DUCTWORK AND OTHER OBSTRUCTIONS. VTR'S SHALL BE A MINIMUM OF 15 FEET FROM ANY OUTSIDE AIR OPENING.
4. PROVIDE PIPING CONNECTIONS TO EQUIPMENT PER EQUIPMENT MFR'S REQUIREMENTS.

**KEYPLAN**

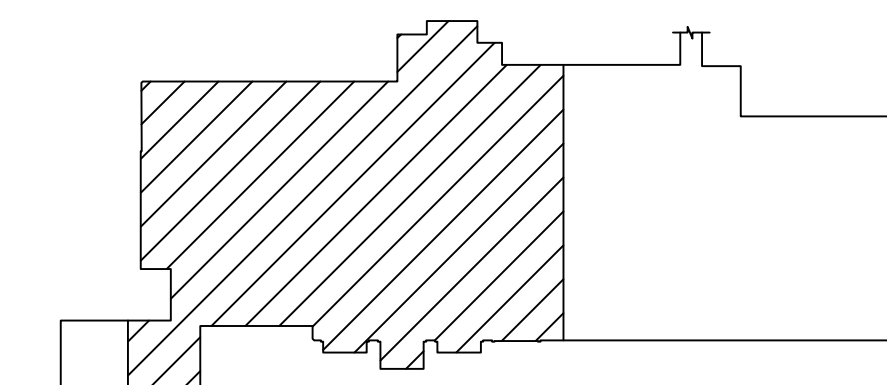

PARTIAL 2ND FLOOR PLAN - PLUMBING

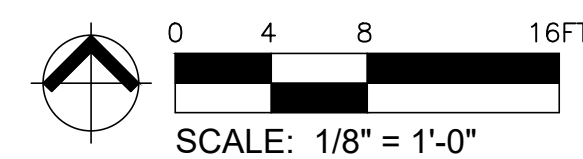

**HULTZ BHU**  
engineers inc

1111 Fawcett Ave, Suite 100 Tacoma, WA 98402  
Phone: (253) 383-3257 Fax: (253) 383-3283  
general@hultzbhu.com Job Number: 21-026

InSight  
HealthCare Architecture  
KLanglois@InSightDesignStudio.biz  
12345 Lake City Way NE #2108  
Seattle, WA 98125  
206-601-6645

SIGNED  
4-2-2021

OWNER:

**MultiCare Tacoma General Hospital**

PROJECT NAME:  
**OR 7&8 Buildout**

Good Samaritan  
Hospital  
401 15th Ave SE  
Puyallup, WA 98372

MARK	DATE	DESCRIPTION
	3/19/2021	DESIGN DEVELOPMENT
	4/2/2021	PERMIT SET

PROJECT NO. 31232


DRAWN BY:

DATE: 2 APRIL 2021  
COPYRIGHT TO:  
InSight Healthcare Architecture

SHEET TITLE:  
**PARTIAL 2ND FLOOR PLAN - PLUMBING**

SHEET #:  
**M3.01**

PLOTTED: Apr 02, 2021 - 11:05am  
 DWG PATH: I:\2021 - Jobs\21-026\Acad\Tech\N21-026\_L15.dwg  
 PLOTTED BY: mdhb

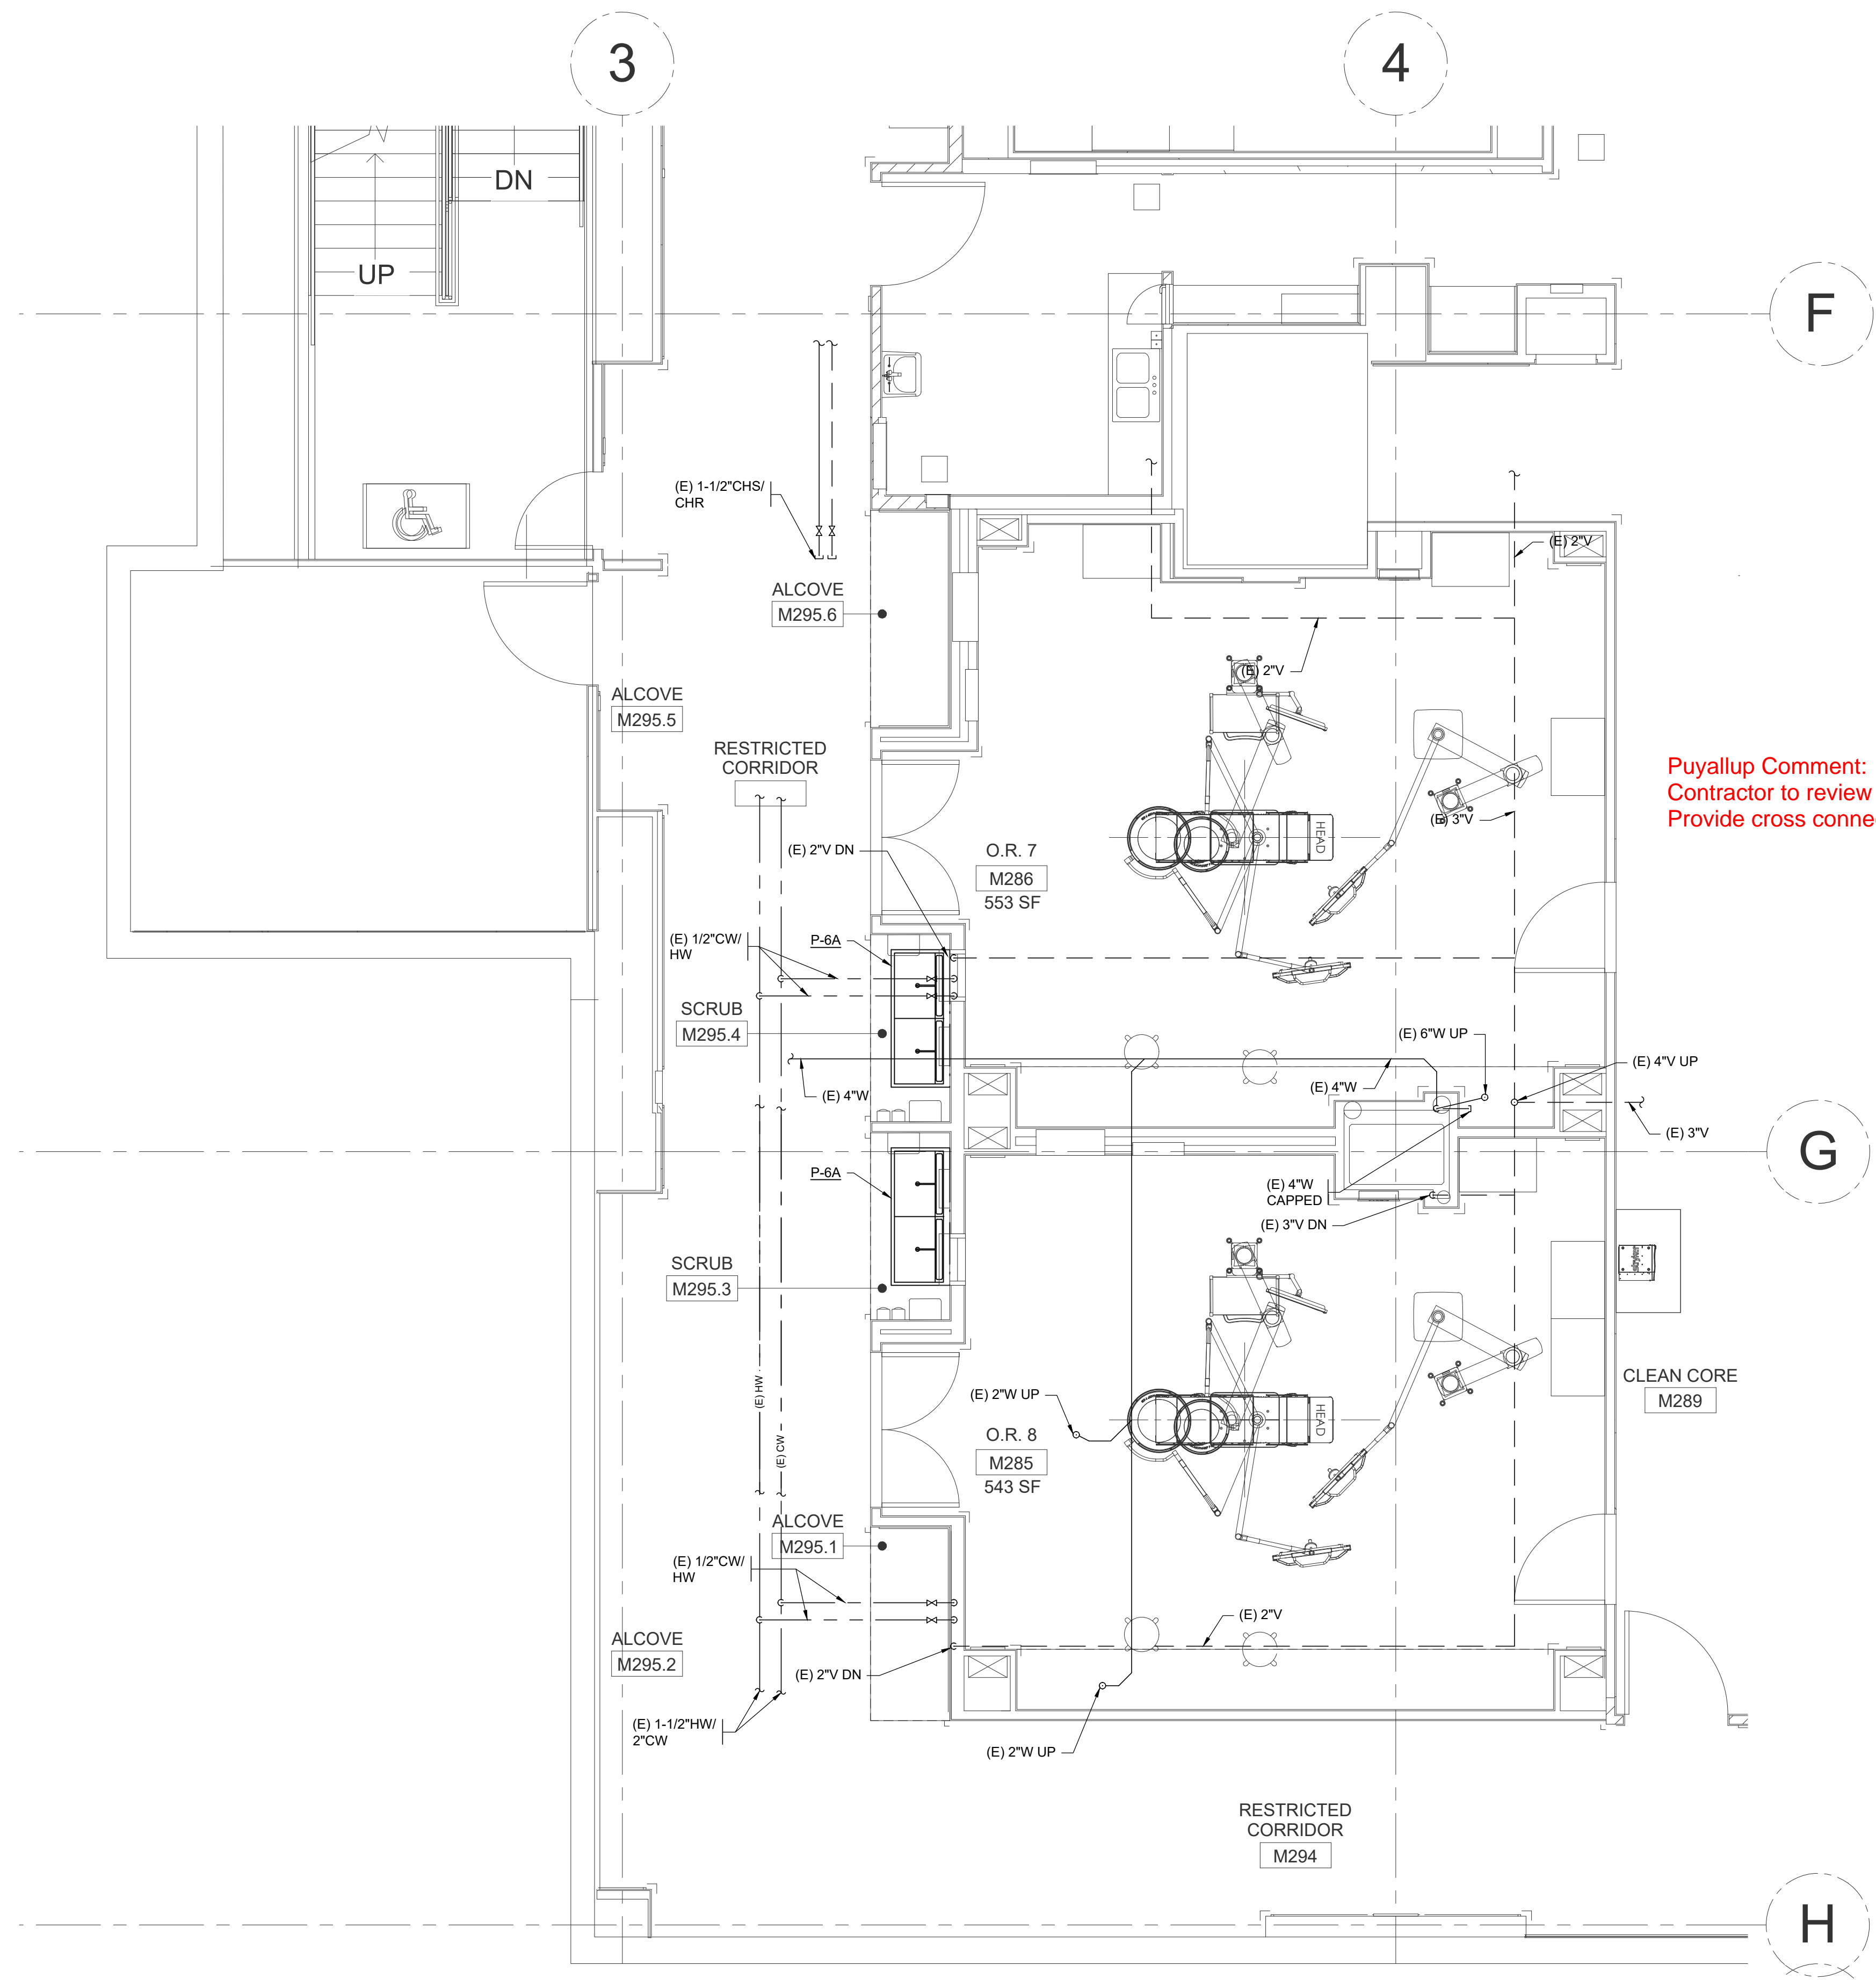


**Puyallup Comment:**  
Contractor to review trap seals function and service at floor drains.  
Provide cross connection per the Uniform Plumbing Code.

**GENERAL NOTES:**

1. FOR GENERAL NOTES SEE SHEET M0.01 & M0.02.
2. FOR PIPING SIZES TO INDIVIDUAL FIXTURES, SEE PLUMBING FIXTURE SCHEDULE ON SHEET M0.03.
3. OFFSET VTR'S AND PIPING AS REQUIRED TO AVOID DUCTWORK AND OTHER OBSTRUCTIONS. VTR'S SHALL BE A MINIMUM OF 15 FEET FROM ANY OUTSIDE AIR OPENING.
4. PROVIDE PIPING CONNECTIONS TO EQUIPMENT PER EQUIPMENT MFR'S REQUIREMENTS.

**KEYPLAN**

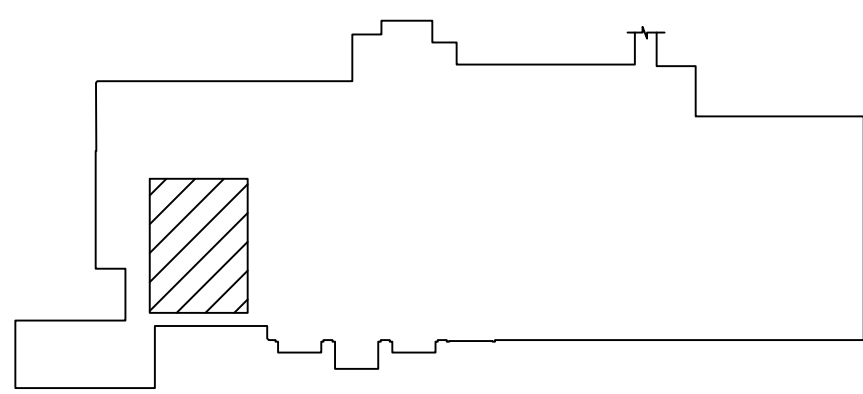

**ENLARGED PLAN OR 7 & 8 - PLUMBING**



MARK	DATE	DESCRIPTION
	3/19/2021	DESIGN DEVELOPMENT
	4/2/2021	PERMIT SET

PROJECT NO. 31232

DRAWN BY:

DATE: 2 APRIL 2021

COPYRIGHT TO:  
InSight Healthcare Architecture


SHEET TITLE:

**ENLARGED PLAN OR 7 & 8 - PLUMBING**

SHEET #:

PLOTTED: Apr 02, 2021 - 11:05am PLOTTED BY: hdt4b  
DWG PATH: I:\2021 - 306521-026-ACORN\hca\21-026-13.02.dwg



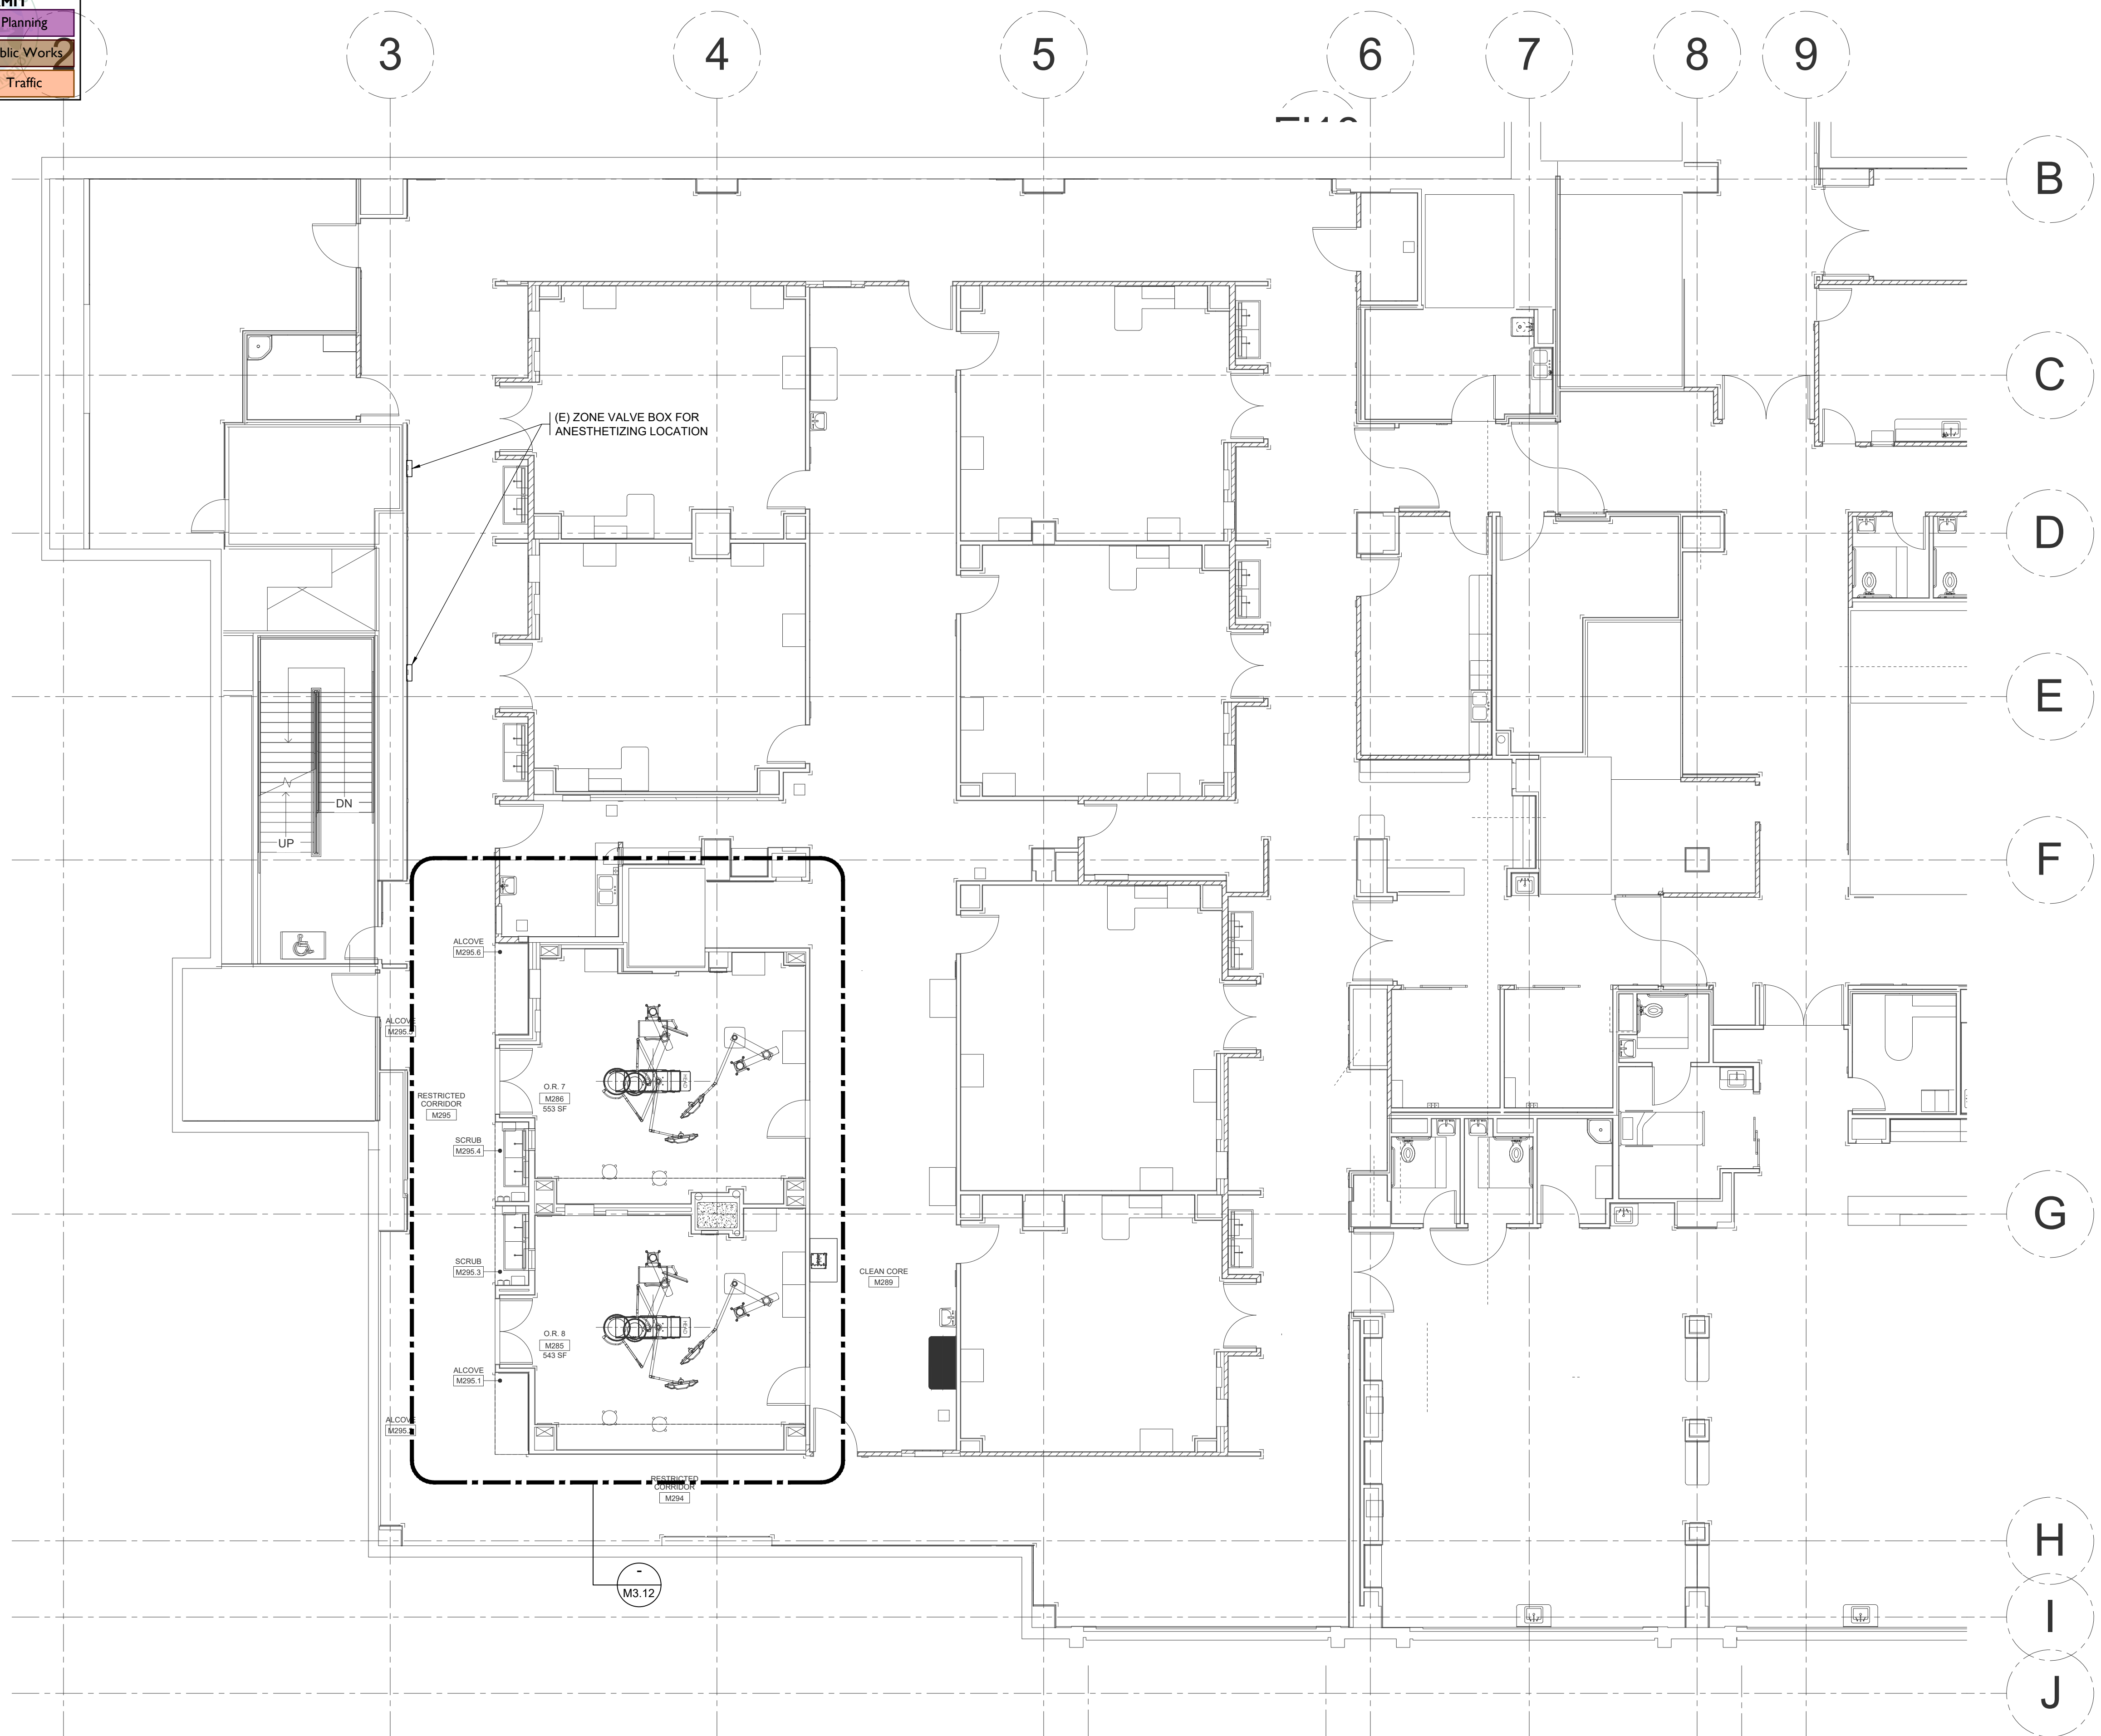


**GENERAL NOTES:**

- FOR GENERAL NOTES SEE SHEET M0.01 & M0.02.
- MEDICAL GAS SYSTEM SHALL COMPLY WITH NFPA 99 AS A LEVEL 1 PIPED SYSTEM.
- CONTRACTOR SHALL PROVIDE 3RD PARTY MEDICAL GAS LINE VERIFICATION REPORT. PRELIMINARY TESTING PARTY: MEDICAL GAS SERVICES: 425-877-9823

**KEYED NOTES:**

1 -

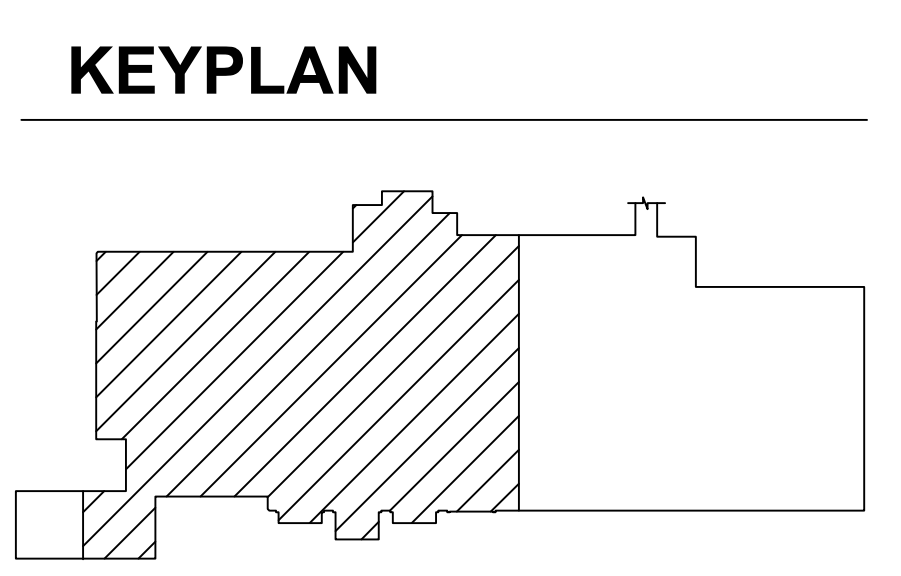

**PARTIAL 2ND FLOOR PLAN - MED GAS**

SCALE: 1/8" = 1'-0"

PLOTTED: Apr 02, 2021 - 11:05am PLOTTED BY: mdhb  
 DWG PATH: I:\2021-366521-026-Acacia\hca\21-026\_113.dwg

**InSight**  
HealthCare Architecture  
KLanglois@InSightDesignStudio.biz  
12345 Lake City Way NE #2108  
Seattle, WA 98125  
206-601-6645

SIGNED  
4-2-2021

OWNER:

**MultiCare Tacoma General Hospital**

PROJECT NAME:  
**OR 7&8 Buildout**

Good Samaritan Hospital  
401 15th Ave SE  
Puyallup, WA 98372

MARK	DATE	DESCRIPTION
	3/19/2021	DESIGN DEVELOPMENT
	4/2/2021	PERMIT SET

PROJECT NO. 31232

DRAWN BY:


DATE: 2 APRIL 2021  
COPYRIGHT TO:  
InSight Healthcare Architecture

SHEET TITLE:  
**PARTIAL 2ND FLOOR PLAN - MED GAS**

SHEET #:  
**M3.11**

City of Puyallup  
Development & Permitting Services  
**ISSUED PERMIT**

Building	Planning
Engineering	Public Works
Fire	Traffic

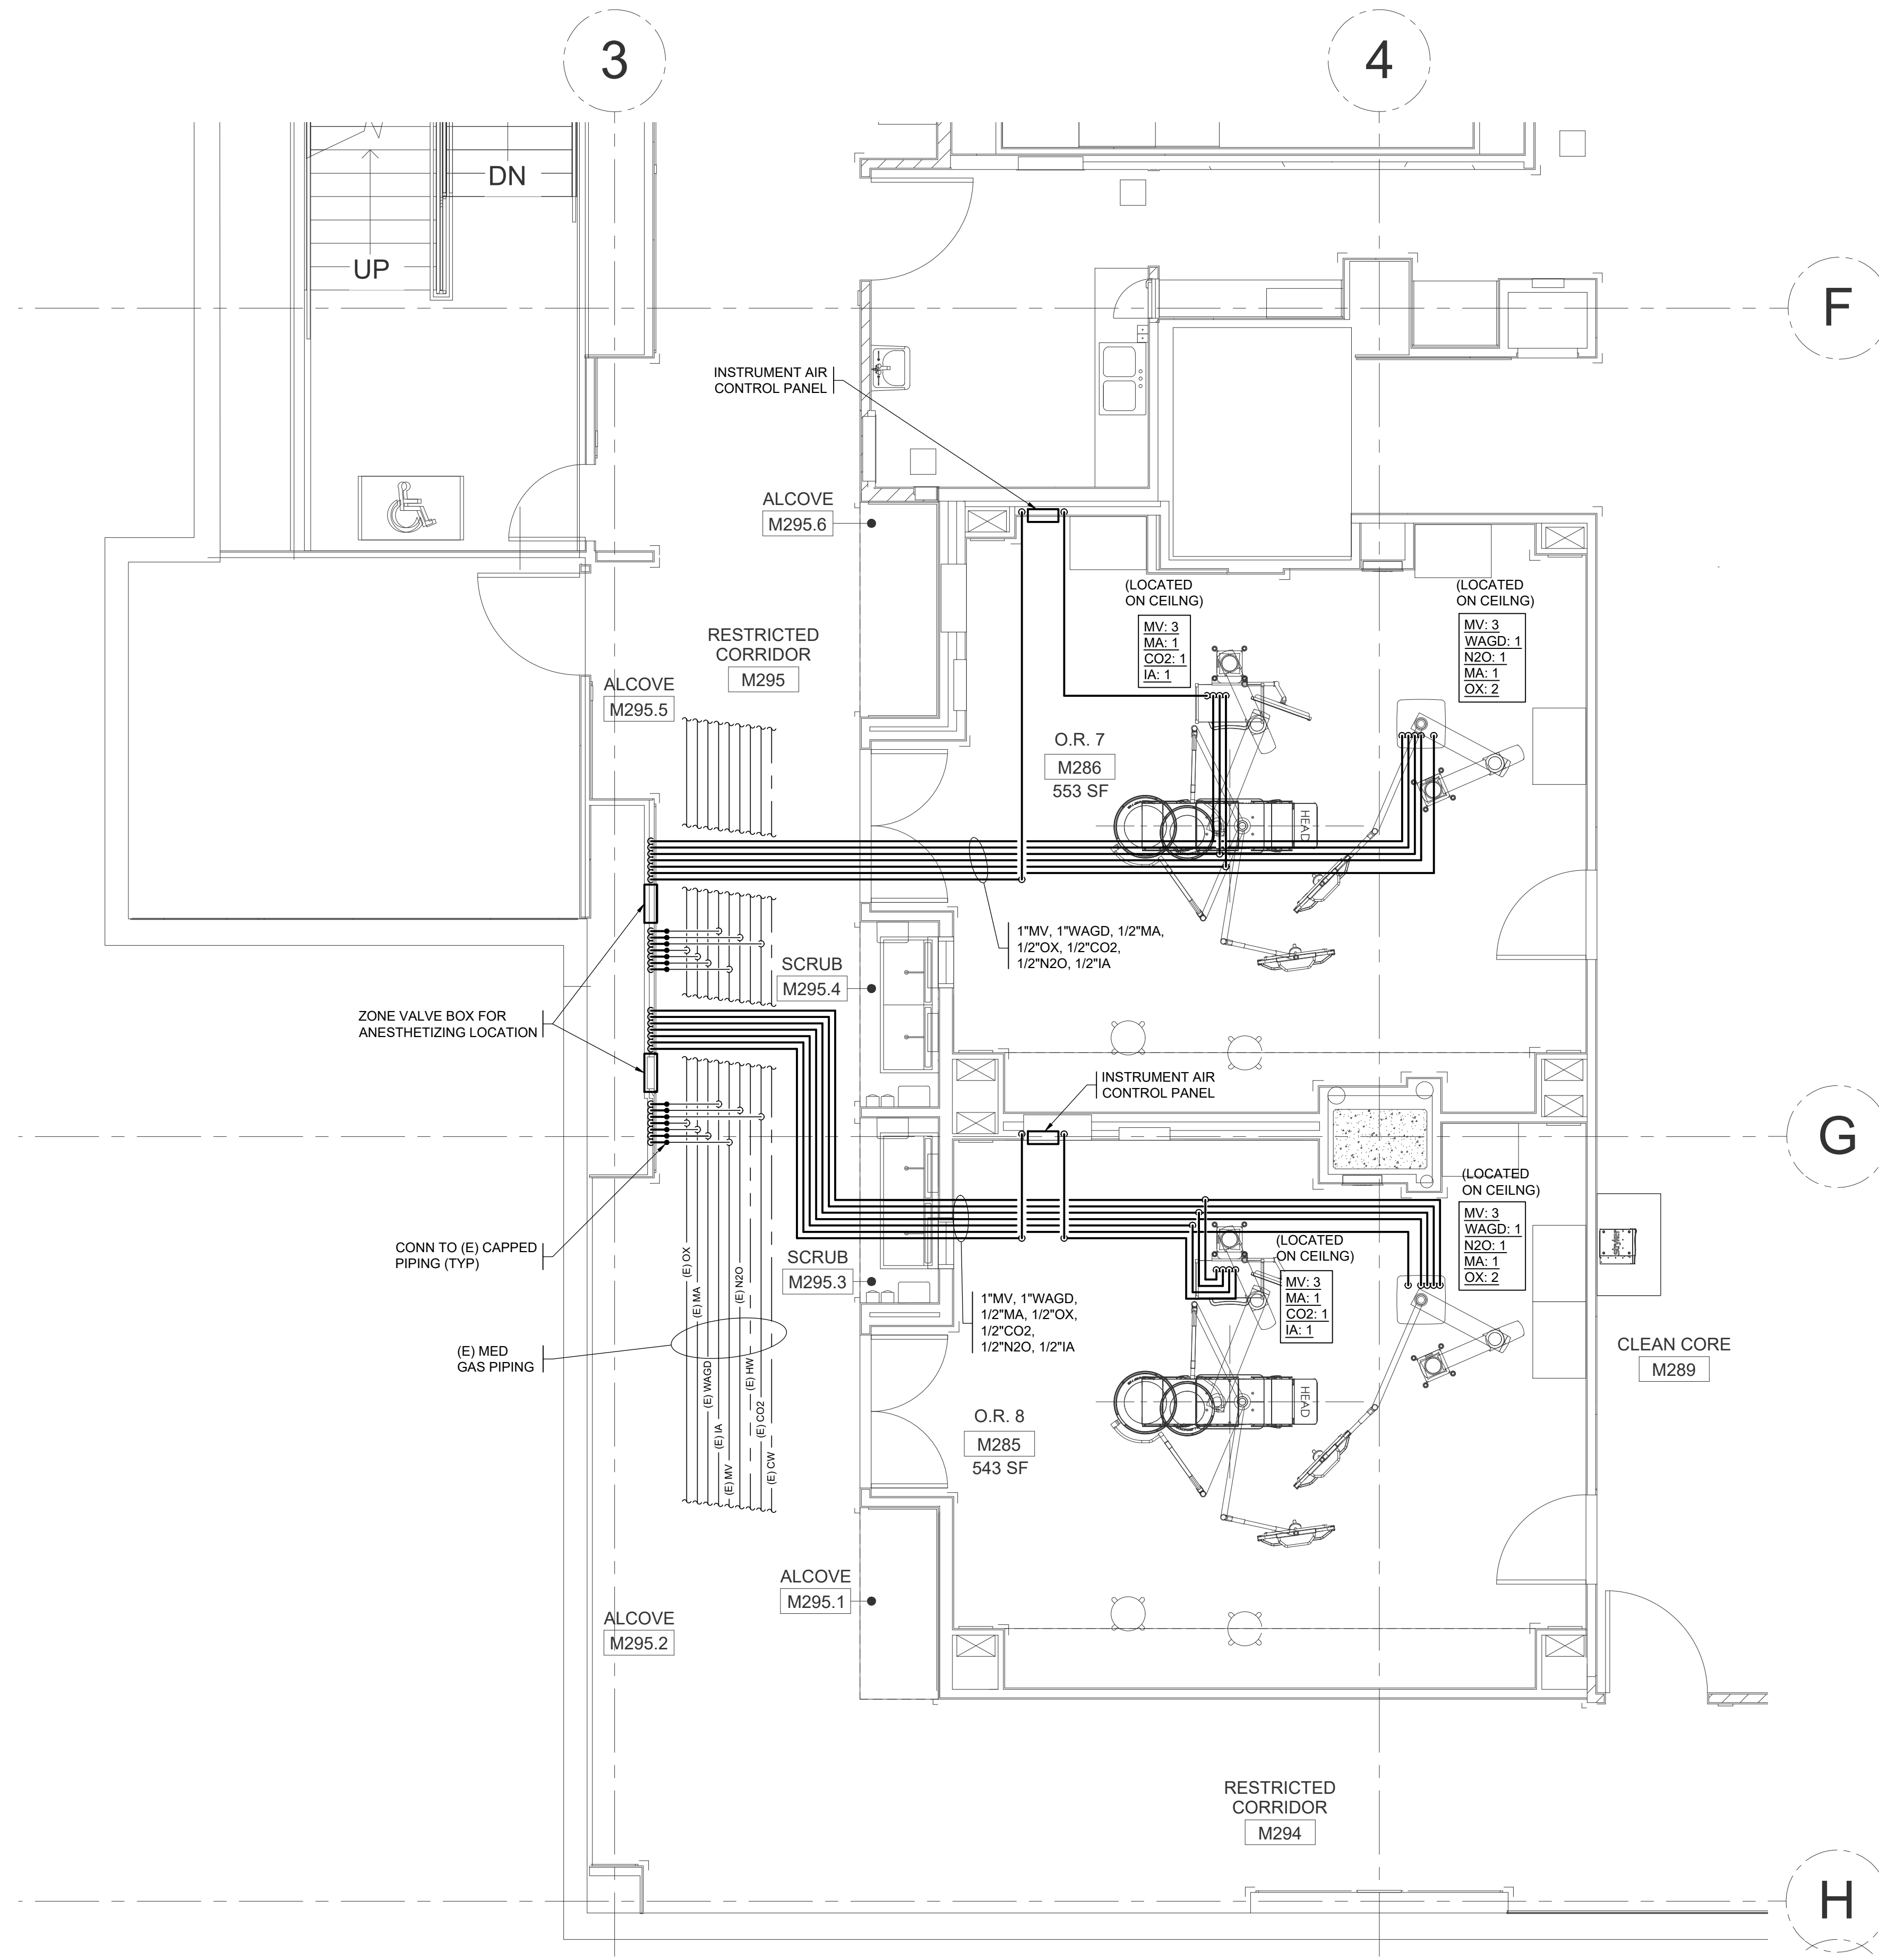

- GENERAL NOTES:**
- FOR GENERAL NOTES SEE SHEET M0.01 & M0.02.
  - MEDICAL GAS SYSTEM SHALL COMPLY WITH NFPA 99 AS A LEVEL 1 PIPED SYSTEM.
  - CONTRACTOR SHALL PROVIDE 3RD PARTY MEDICAL GAS LINE VERIFICATION REPORT. PRELIMINARY TESTING PARTY: MEDICAL GAS SERVICES: 425-877 9623

InSight  
HealthCare Architecture  
KLanglois@InSightDesignStudio.biz  
12345 Lake City Way NE #2108  
Seattle, WA 98125  
206-601-6645

**MICHAEL LEO FINE**  
REGISTERED PROFESSIONAL ENGINEER  
SIGNED  
4-2-2021

OWNER:  
**MultiCare Tacoma General Hospital**

PROJECT NAME:  
**OR 7&8 Buildout**

Good Samaritan Hospital  
401 15th Ave SE  
Puyallup, WA 98372

MARK	DATE	DESCRIPTION
	3/19/2021	DESIGN DEVELOPMENT
	4/2/2021	PERMIT SET


PROJECT NO. 31232  
DRAWN BY:  
DATE: 2 APRIL 2021  
COPYRIGHT TO:  
InSight Healthcare Architecture

SHEET TITLE:  
**ENLARGED PLAN OR 7 & 8 - MED GAS**

SHEET #:  
**M3.12**

**ENLARGED PLAN OR 7 & 8 - MED GAS**

SCALE: 1/4" = 1'-0"

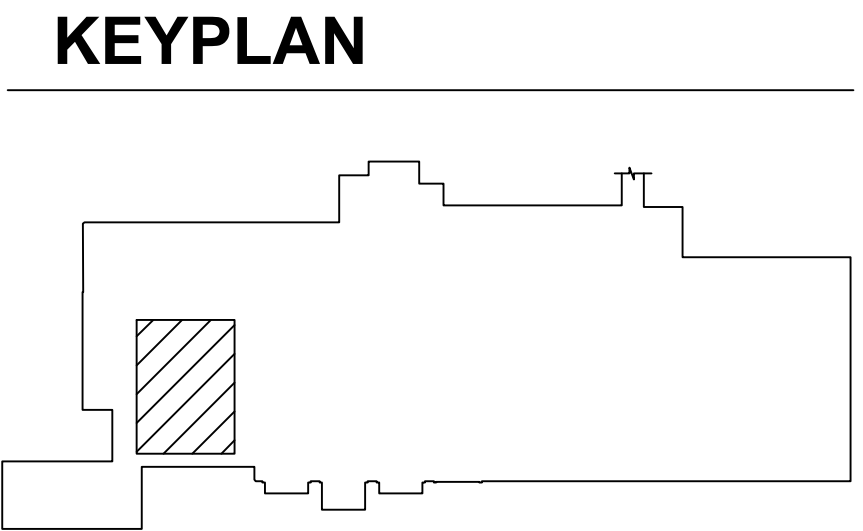


**HULTZ BHU**  
engineers inc

1111 Fawcett Ave, Suite 100 Tacoma, WA 98402  
Phone: (253) 383-3257 Fax: (253) 383-3283  
general@hultzbhu.com Job Number: 21-026

PLOTTED: Apr 02, 2021 - 11:05am  
 DWG PATH: I:\2021-306521-026-000\hca\21-026-L15.dwg  
 PLOTTED BY: mdh

City of Puyallup Development & Permitting Services ISSUED PERMIT	
Building	Planning
Engineering	Public Works
Fire	Traffic

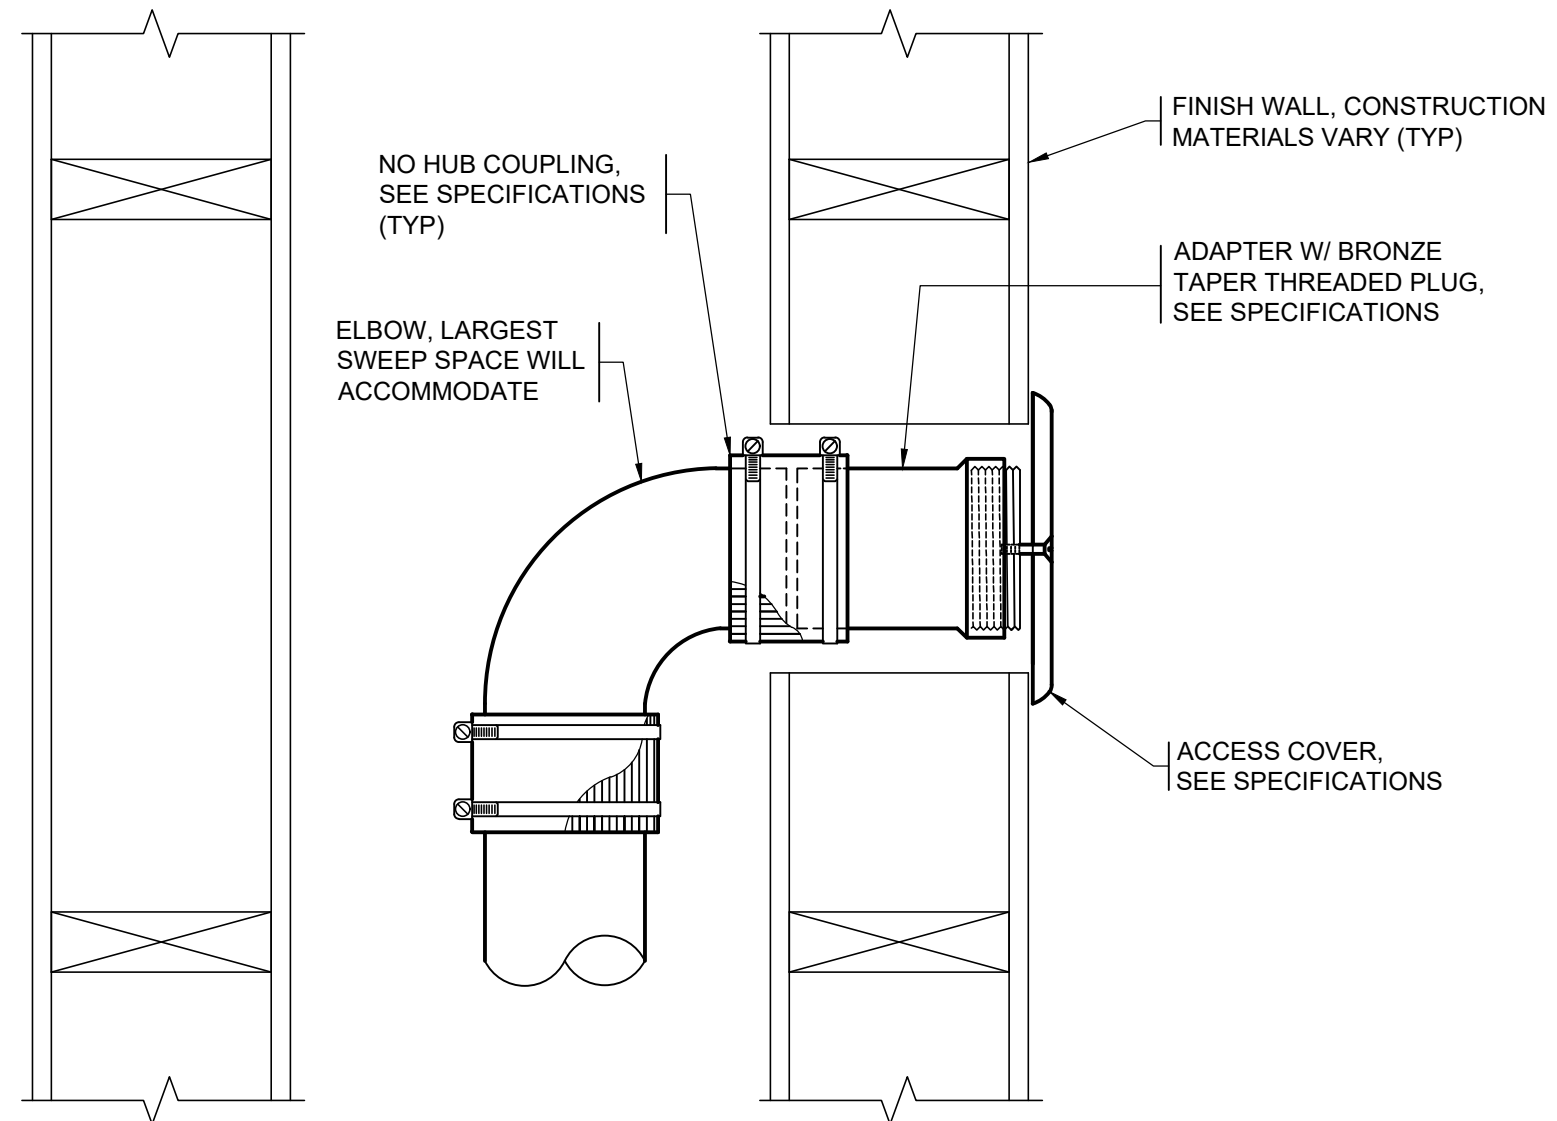


WALL CLEANOUT-W/ ELBOW

3

NTS

M3.20

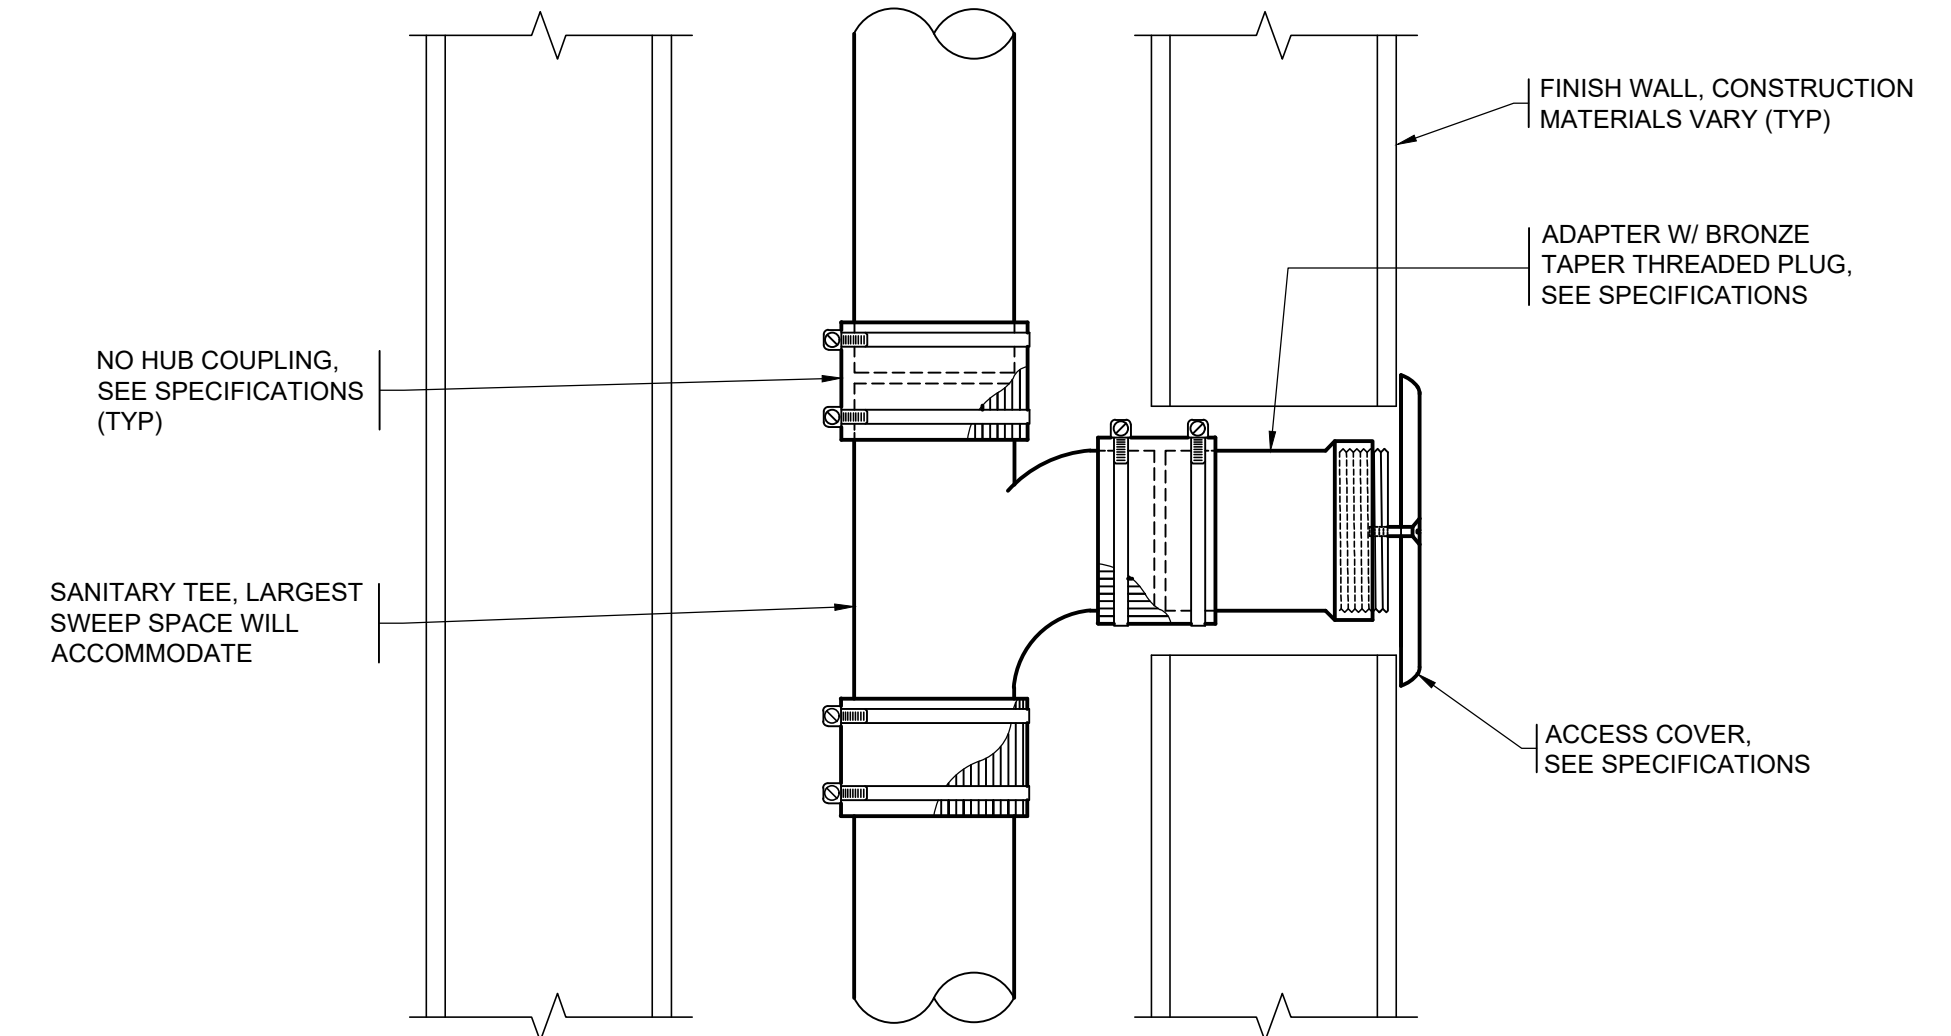


WALL CLEANOUT-W/ TEE IN CHASE

1

NTS

M3.20

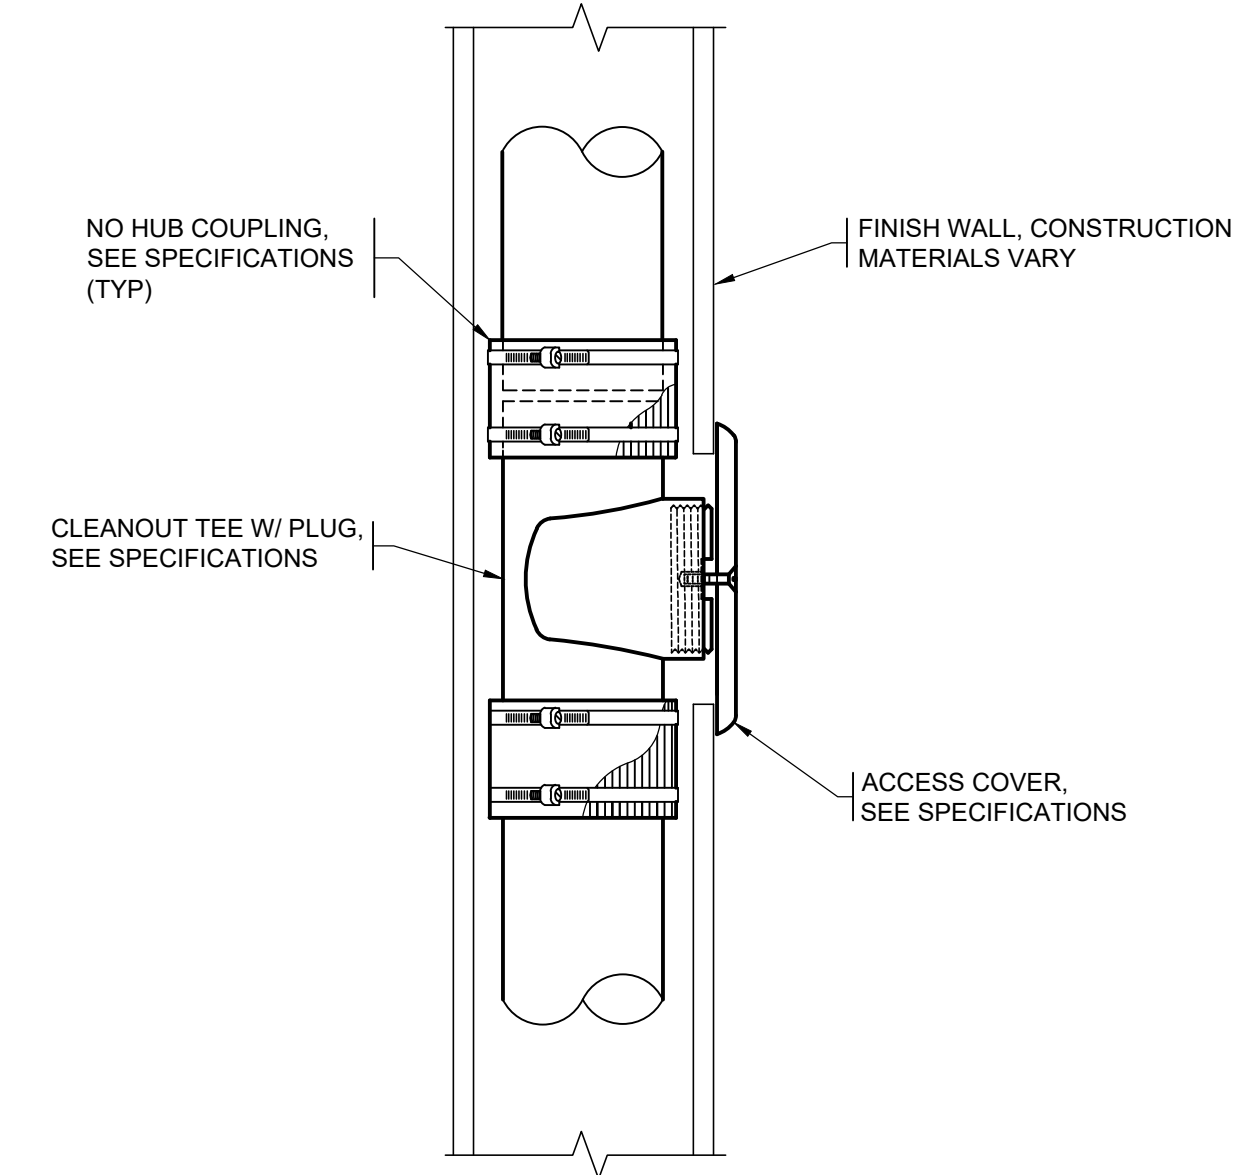


WALL CLEANOUT-IN WALL

2

NTS

M3.20

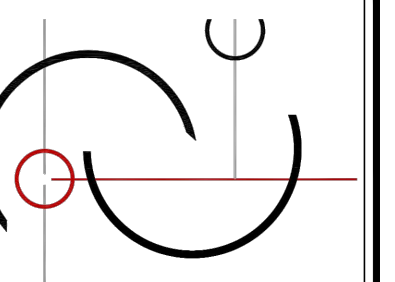

InSight  
HealthCare Architecture  
KLan@InSightDesignStudio.biz  
12345 Lake City Way NE #2108  
Seattle, WA 98125  
206-601-6645



OWNER:

MultiCare  
Tacoma General Hospital

PROJECT NAME:

OR 7&8  
Buildout

Good Samaritan  
Hospital  
401 15th Ave SE  
Puyallup, WA 98372

MARK	DATE	DESCRIPTION
	3/19/2021	DESIGN DEVELOPMENT
	4/2/2021	PERMIT SET

PROJECT NO. 31232

DRAWN BY:

DATE: 2 APRIL 2021

COPYRIGHT TO:

InSight Healthcare Architecture

SHEET TITLE:

PLUMBING  
DETAILS

SHEET #:


M3.20

HULTZ & BHU  
engineers inc


1111 Fawcett Ave, Suite 100 Tacoma, WA 98402  
Phone: (253) 383-3257 Fax: (253) 383-3283  
general@hultzbhu.com Job Number: 21-026

City of Puyallup  
Development & Permitting Services  
**ISSUED PERMIT**


Building	Planning
Engineering	Public Works
Fire	Traffic

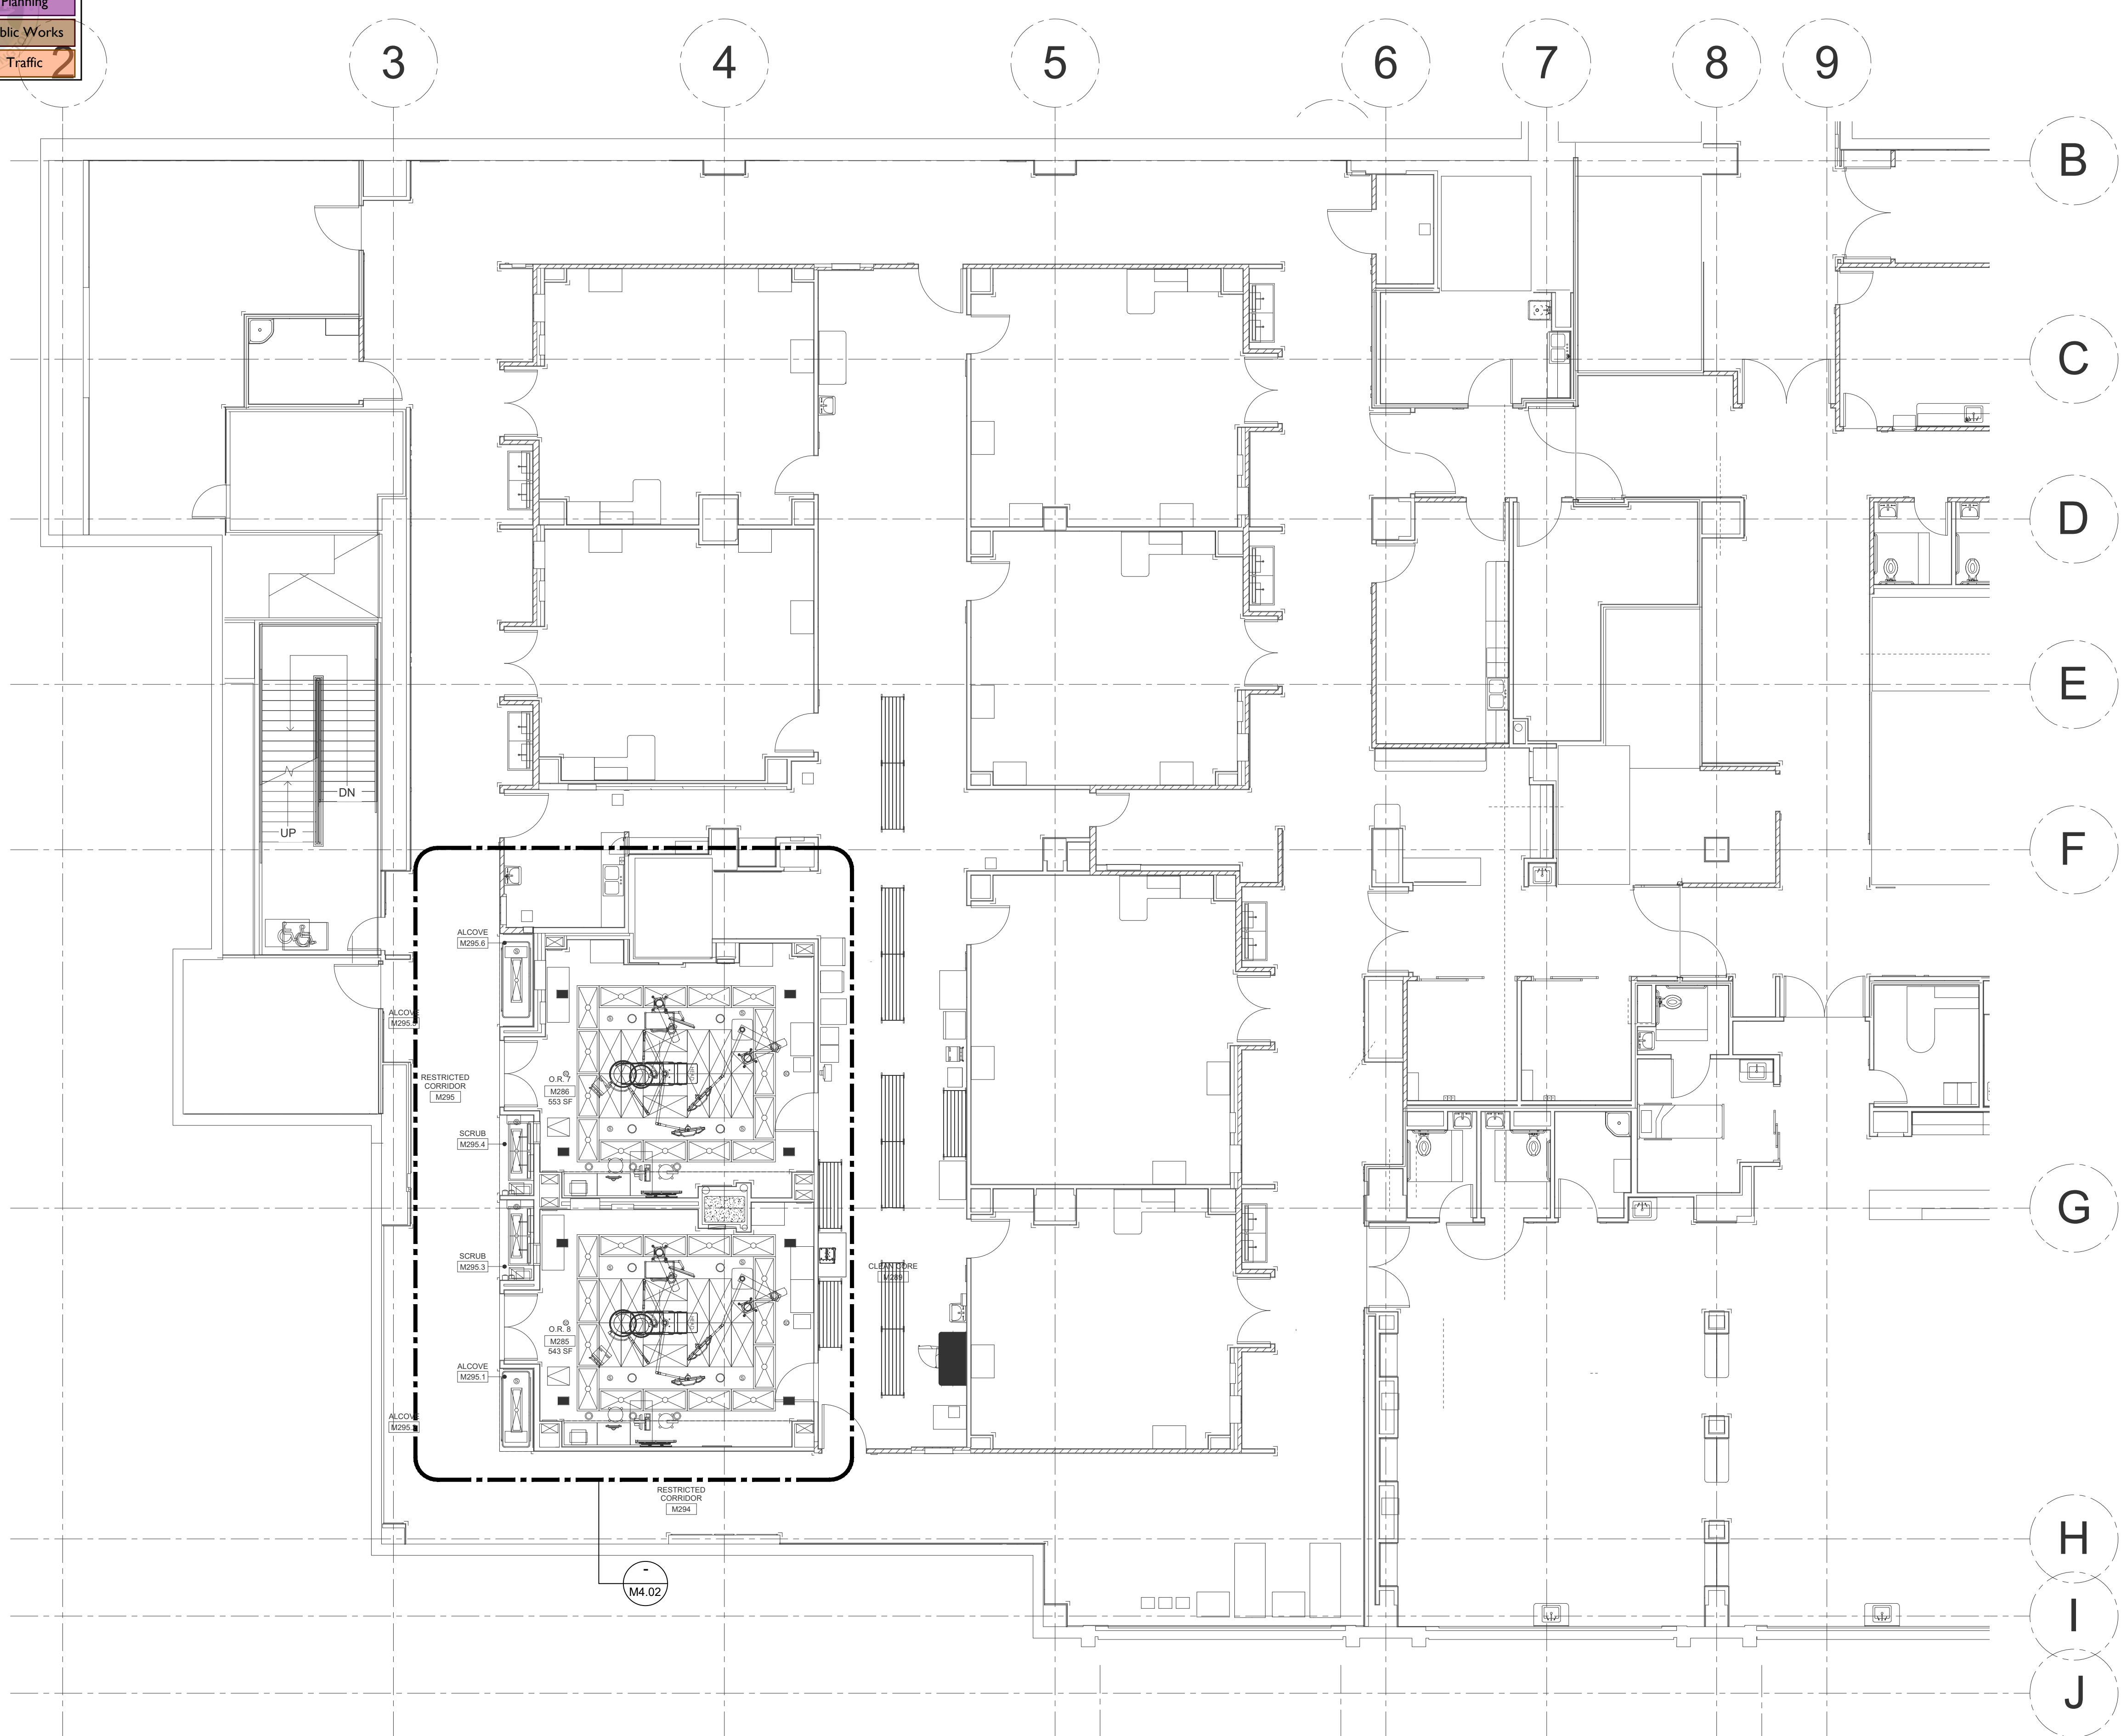

**GENERAL NOTES:**  
1. FOR GENERAL NOTES SEE SHEET M0.01 & M0.02.

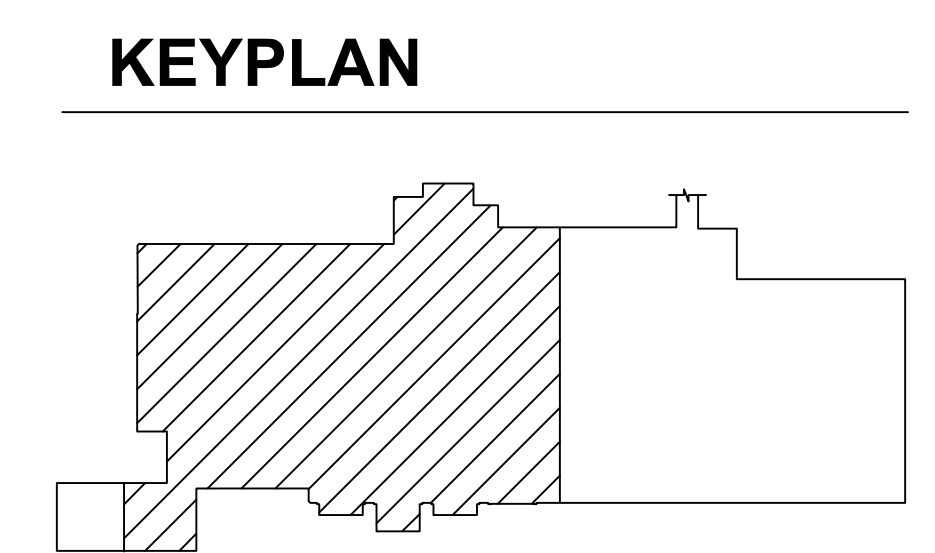

**PARTIAL 2ND FLOOR PLAN - HVAC**

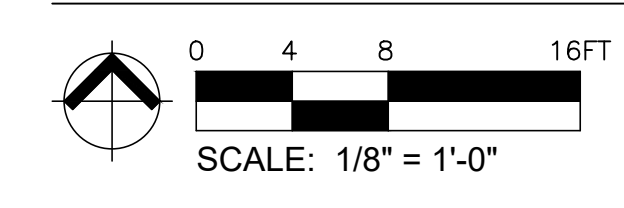

**HULTZ BHU**  
engineers inc

1111 Fawcett Ave, Suite 100 Tacoma, WA 98402  
Phone: (253) 383-3257 Fax: (253) 383-3283  
general@hultzbhu.com Job Number: 21-026

**InSight**  
HealthCare Architecture  
KLanglois@InsightDesignStudio.biz  
12345 Lake City Way NE #2108  
Seattle, WA 98125  
206-601-6645

SIGNED  
4-2-2021

OWNER:

**MultiCare**  
Tacoma General Hospital

PROJECT NAME:  
**OR 7&8  
Buildout**

Good Samaritan  
Hospital  
401 15th Ave SE  
Puyallup, WA 98372

MARK	DATE	DESCRIPTION
	3/19/2021	DESIGN DEVELOPMENT
	4/2/2021	PERMIT SET

PROJECT NO. 31232


DRAWN BY:

DATE: 2 APRIL 2021  
COPYRIGHT TO:  
InSight Healthcare Architecture

SHEET TITLE:  
**PARTIAL 2ND  
FLOOR PLAN -  
HVAC**

SHEET #:  
**M4.01**

PLOTTED: Apr 02, 2021 - 11:05am PLOTTED BY: rhd/bb  
 DWG PATH: I:\2021-3065\21-026\Acad\Mech\21-026\_P14.dwg

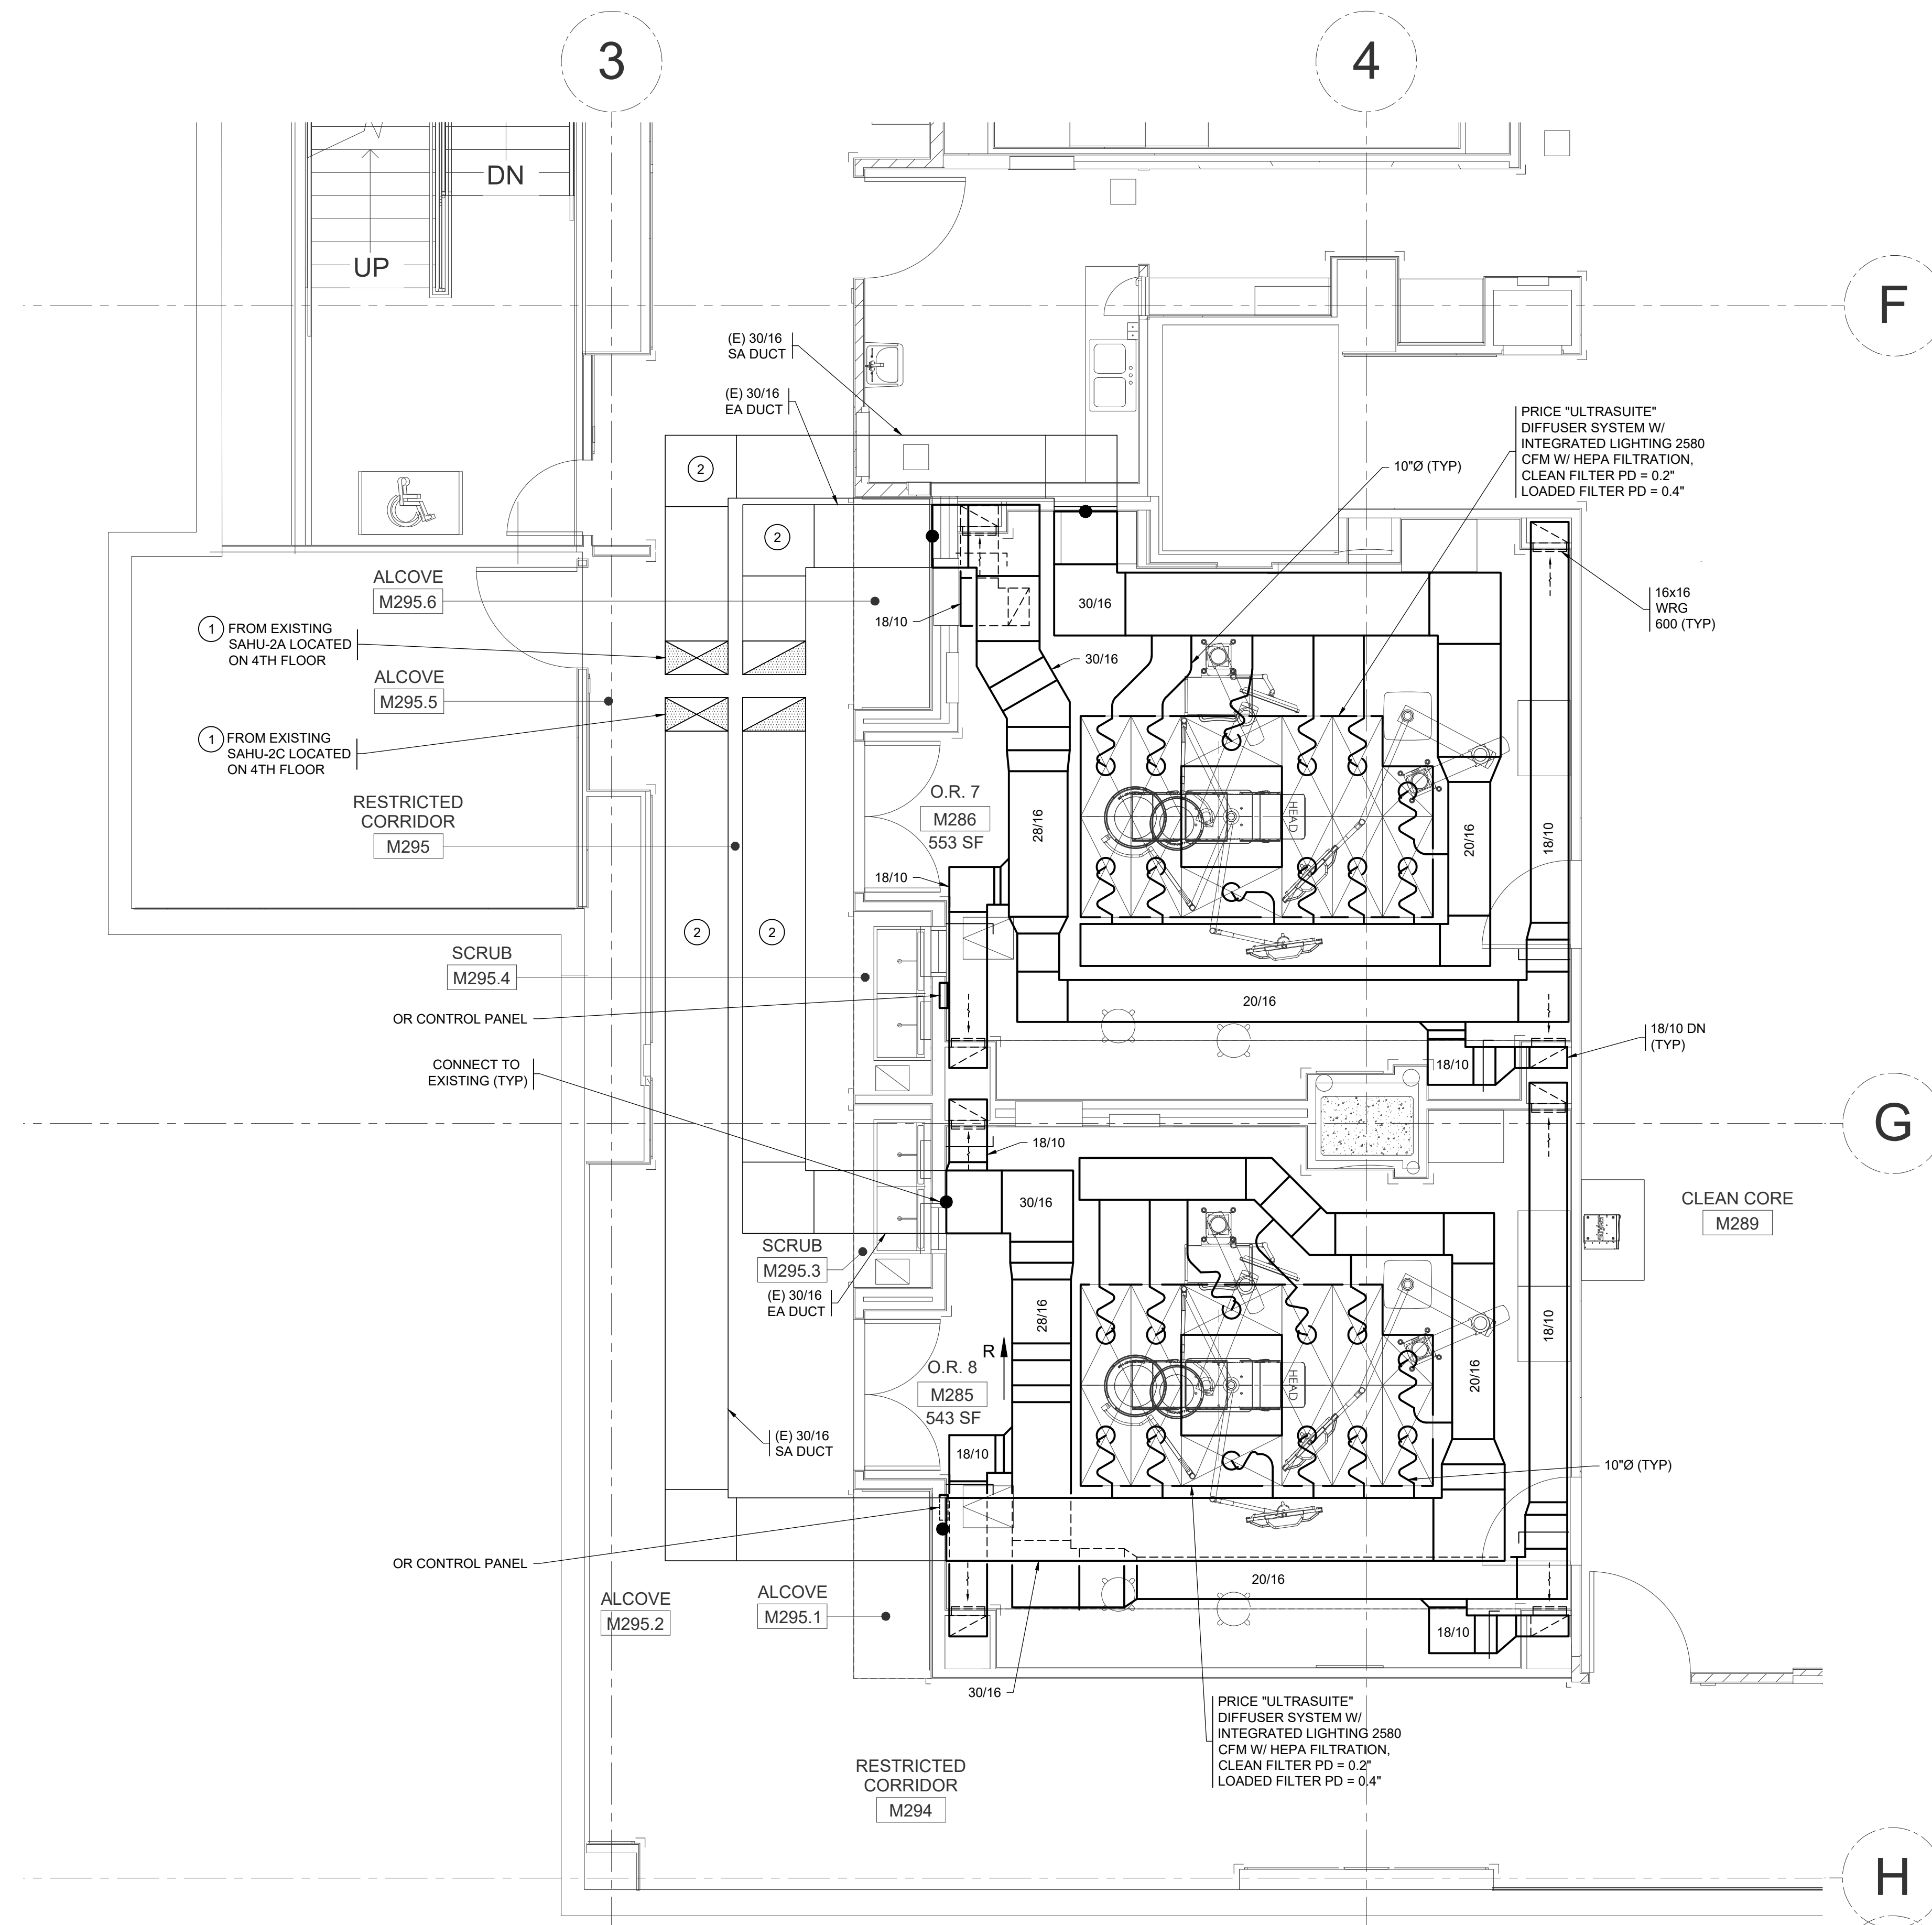


**GENERAL NOTES:**

- 1. FOR GENERAL NOTES SEE SHEET M0.01 & M0.02.

**KEYED NOTES:**

- 1. EXISTING HVAC UNITS WERE INSTALLED IN 2008 AS PART OF A SHELL AND CORE PROJECT. EXISTING UNITS ARE MANUFACTURED BY HAAKON. CONTRACTOR SHALL OBTAIN NEW START-UP/RECOMMISSIONING BY MANUFACTURER. WORK INCLUDES UNIT WITH PRE-FILTERS, SOUND ATTENUATOR, HEAT RECOVERY COIL, HYDROMIC PRE-HEAT COIL, COOLING COIL, FAN, FINAL FILTERS, REHEAT COIL.
- 2. PROVIDE PROFESSIONAL DUCT CLEANING OF EXISTING DUCTWORK, FROM OR, TO EXISTING HVAC UNITS. ALSO, PROVIDE COMPLETE CLEANING OF EXISTING HVAC UNITS. CLEAN UNIT INSIDE AND OUT. PROVIDE BALANCING OF ALL COMPONENTS.

**KEYPLAN**

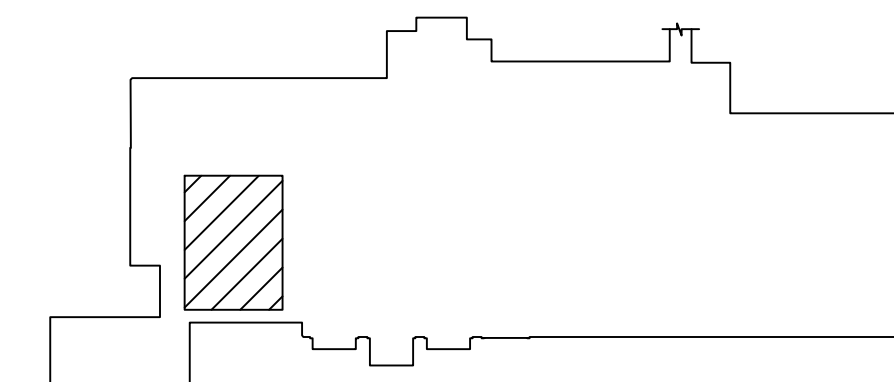

ENLARGED PLAN OR 7 & 8 - HVAC



OWNER:

MultiCare Tacoma General Hospital

PROJECT NAME:

**OR 7&8 Buildout**

Good Samaritan Hospital  
401 15th Ave SE  
Puyallup, WA 98372

MARK	DATE	DESCRIPTION
	3/19/2021	DESIGN DEVELOPMENT
	4/2/2021	PERMIT SET

MARK	DATE	DESCRIPTION

PROJECT NO. 31232

DRAWN BY:

DATE: 2 APRIL 2021

COPYRIGHT TO:

InSight Healthcare Architecture

SHEET TITLE:

**ENLARGED PLAN OR 7 & 8 - HVAC**

SHEET #:

**M4.02**




**GENERAL NOTES:**

- FOR GENERAL NOTES SEE SHEET M0.01 & M0.02.

**KEYED NOTES:**

- NOT USED.
- PROVIDE PROFESSIONAL DUCT CLEANING OF EXISTING DUCTWORK. FROM OR, TO EXISTING HVAC UNITS. ALSO, PROVIDE COMPLETE CLEANING OF EXISTING HVAC UNITS. CLEAN UNIT INSIDE AND OUT. PROVIDE BALANCING OF ALL COMPONENTS.

**KEYPLAN**

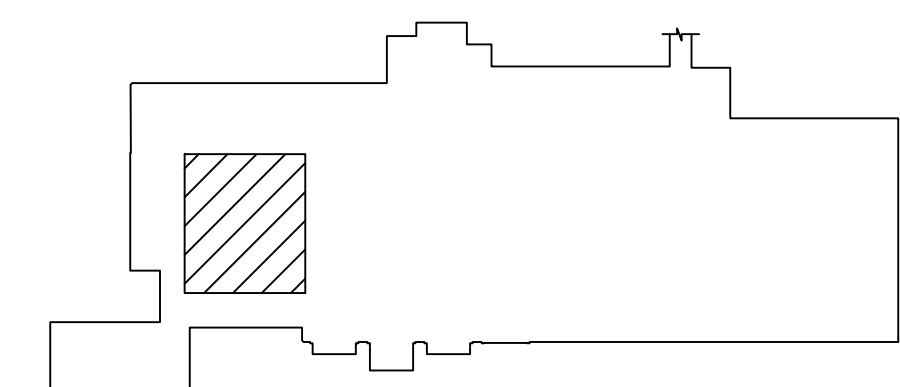

ENLARGED PARTIAL PLAN - 3RD FLOOR HVAC



OWNER:

**MultiCare**  
Tacoma General Hospital

PROJECT NAME:

**OR 7&8  
Buildout**

Good Samaritan  
Hospital  
401 15th Ave SE  
Puyallup, WA 98372

MARK	DATE	DESCRIPTION
	3/19/2021	DESIGN DEVELOPMENT
	4/2/2021	PERMIT SET

PROJECT NO. 31232

DRAWN BY:

DATE: 2 APRIL 2021

COPYRIGHT TO:


InSight Healthcare Architecture

SHEET TITLE:

**ENLARGED  
PARTIAL PLAN -  
3RD FLOOR  
HVAC**


SHEET #:

**M4.03**

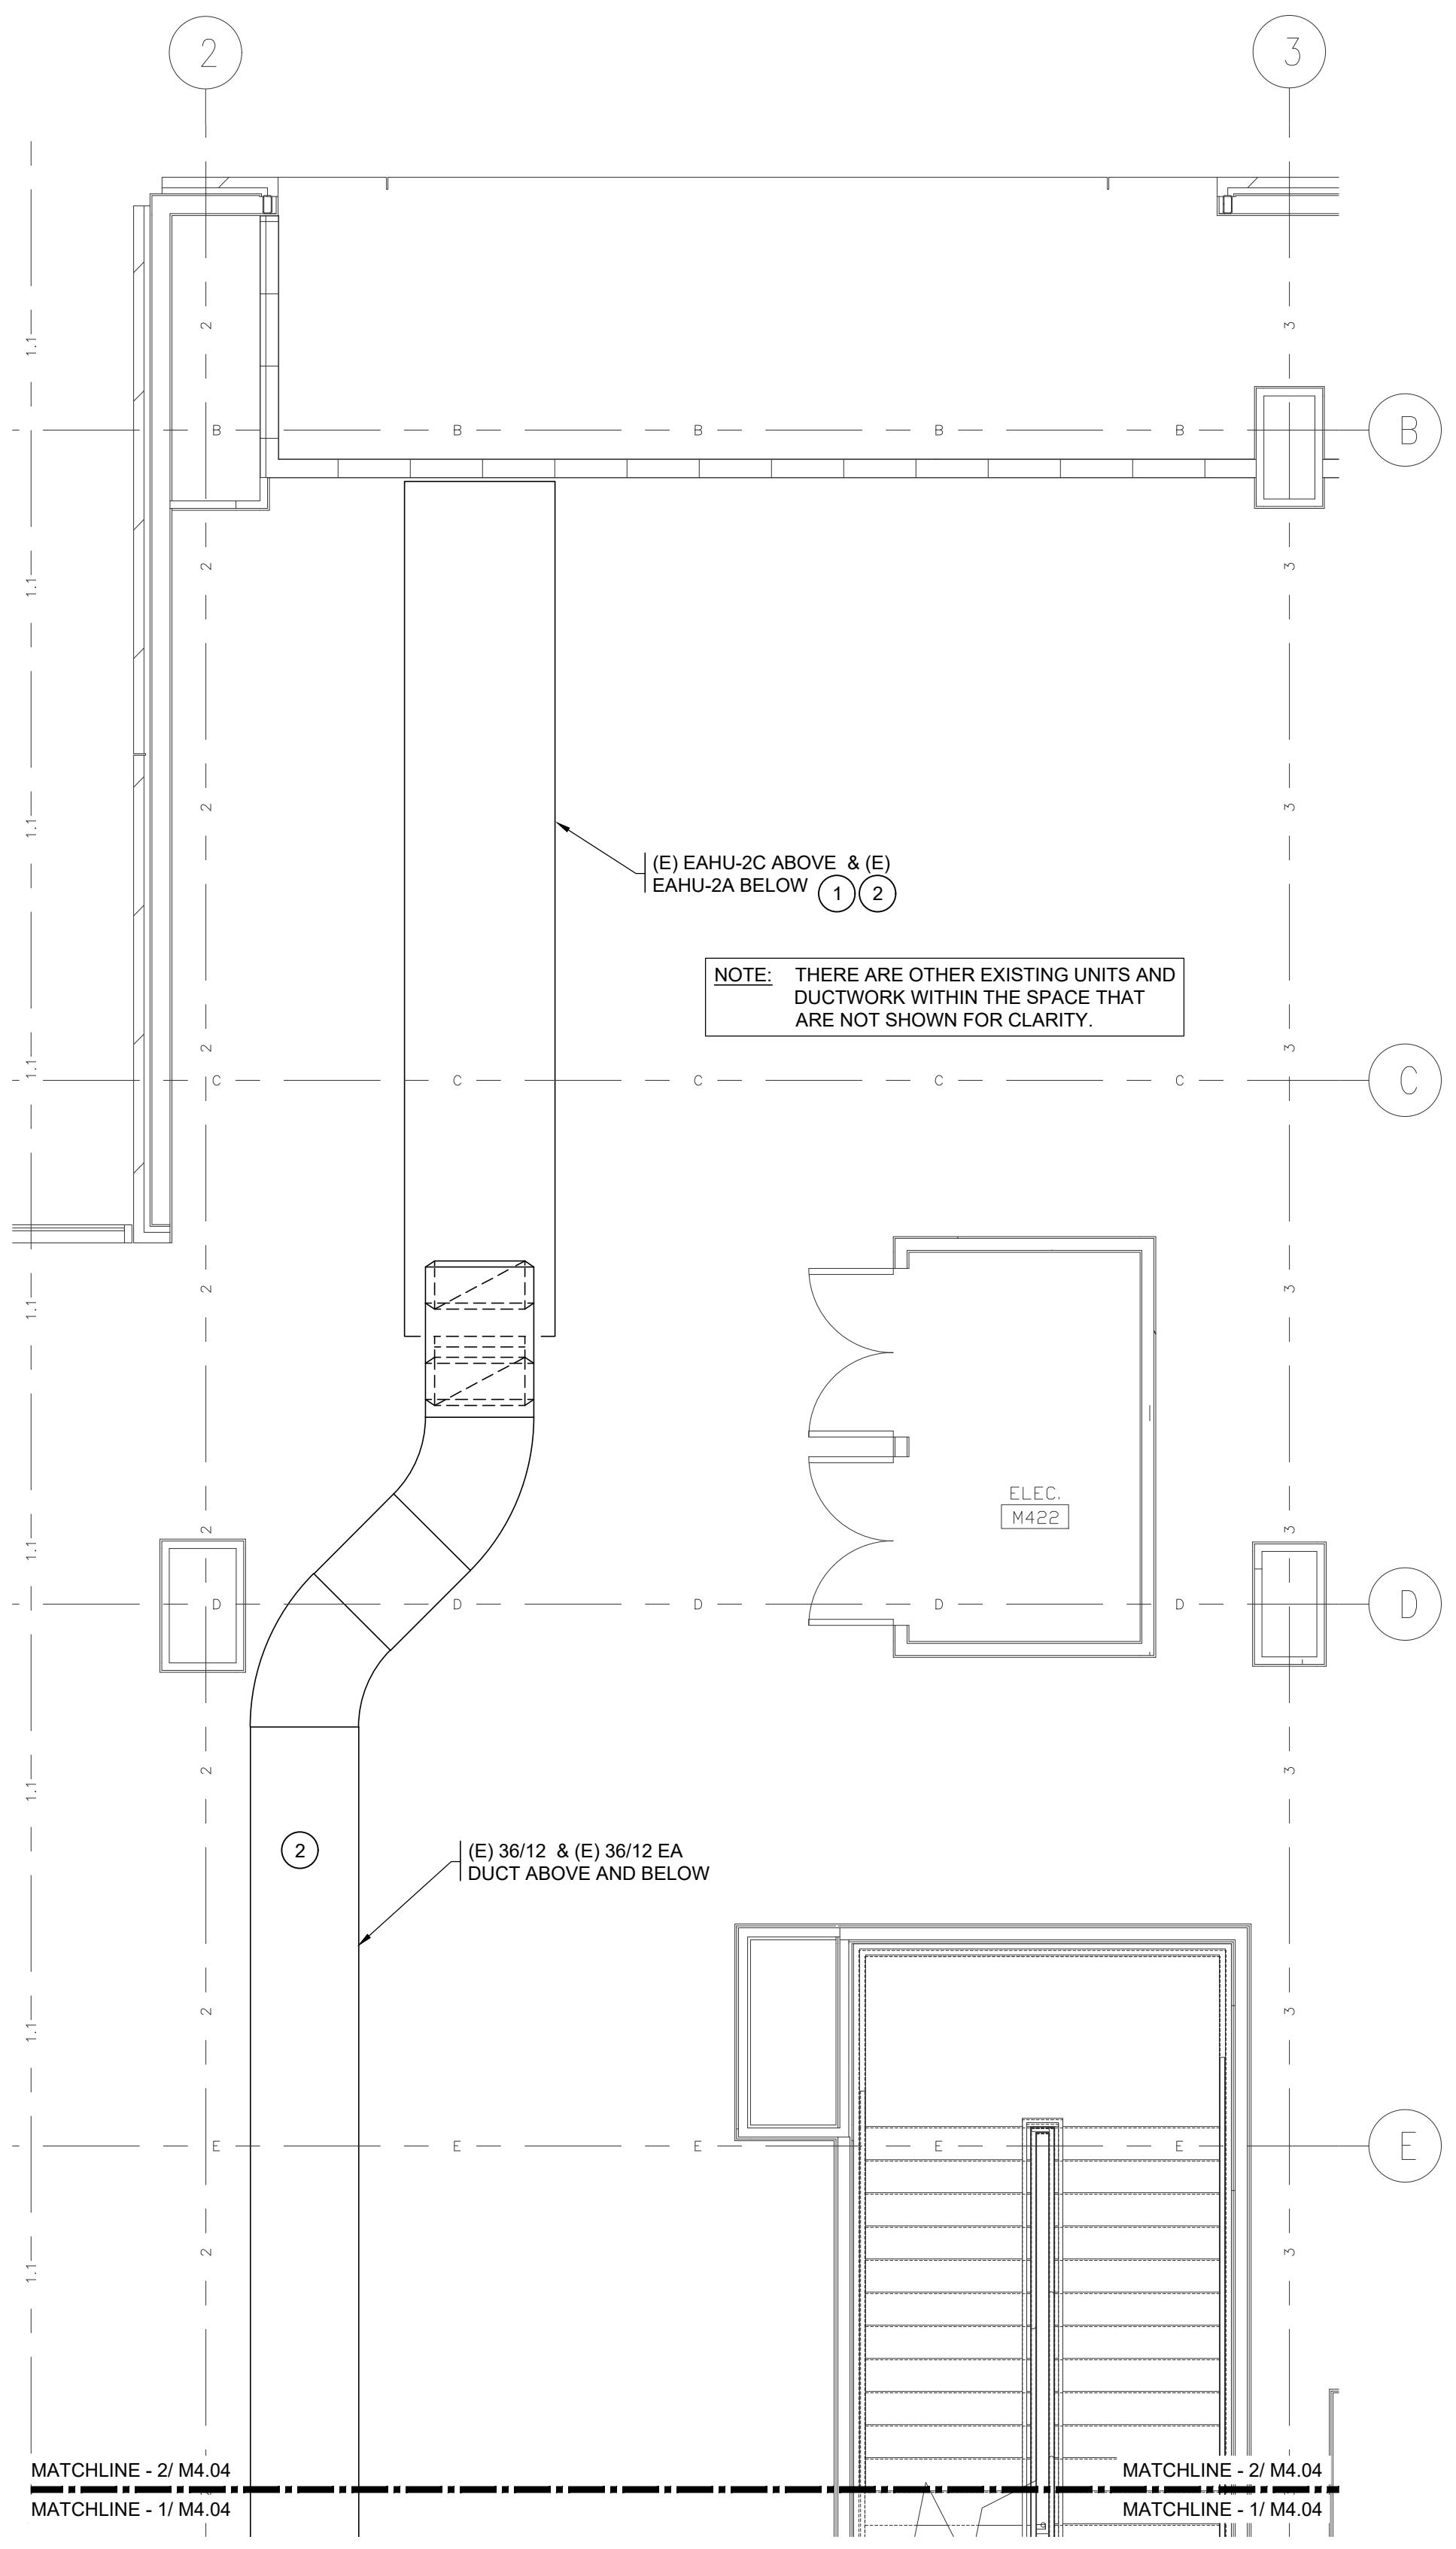

**2** ENLARGED PARTIAL PLAN - 4TH FLOOR HVAC  
M4.04

SCALE: 1/4" = 1'-0"

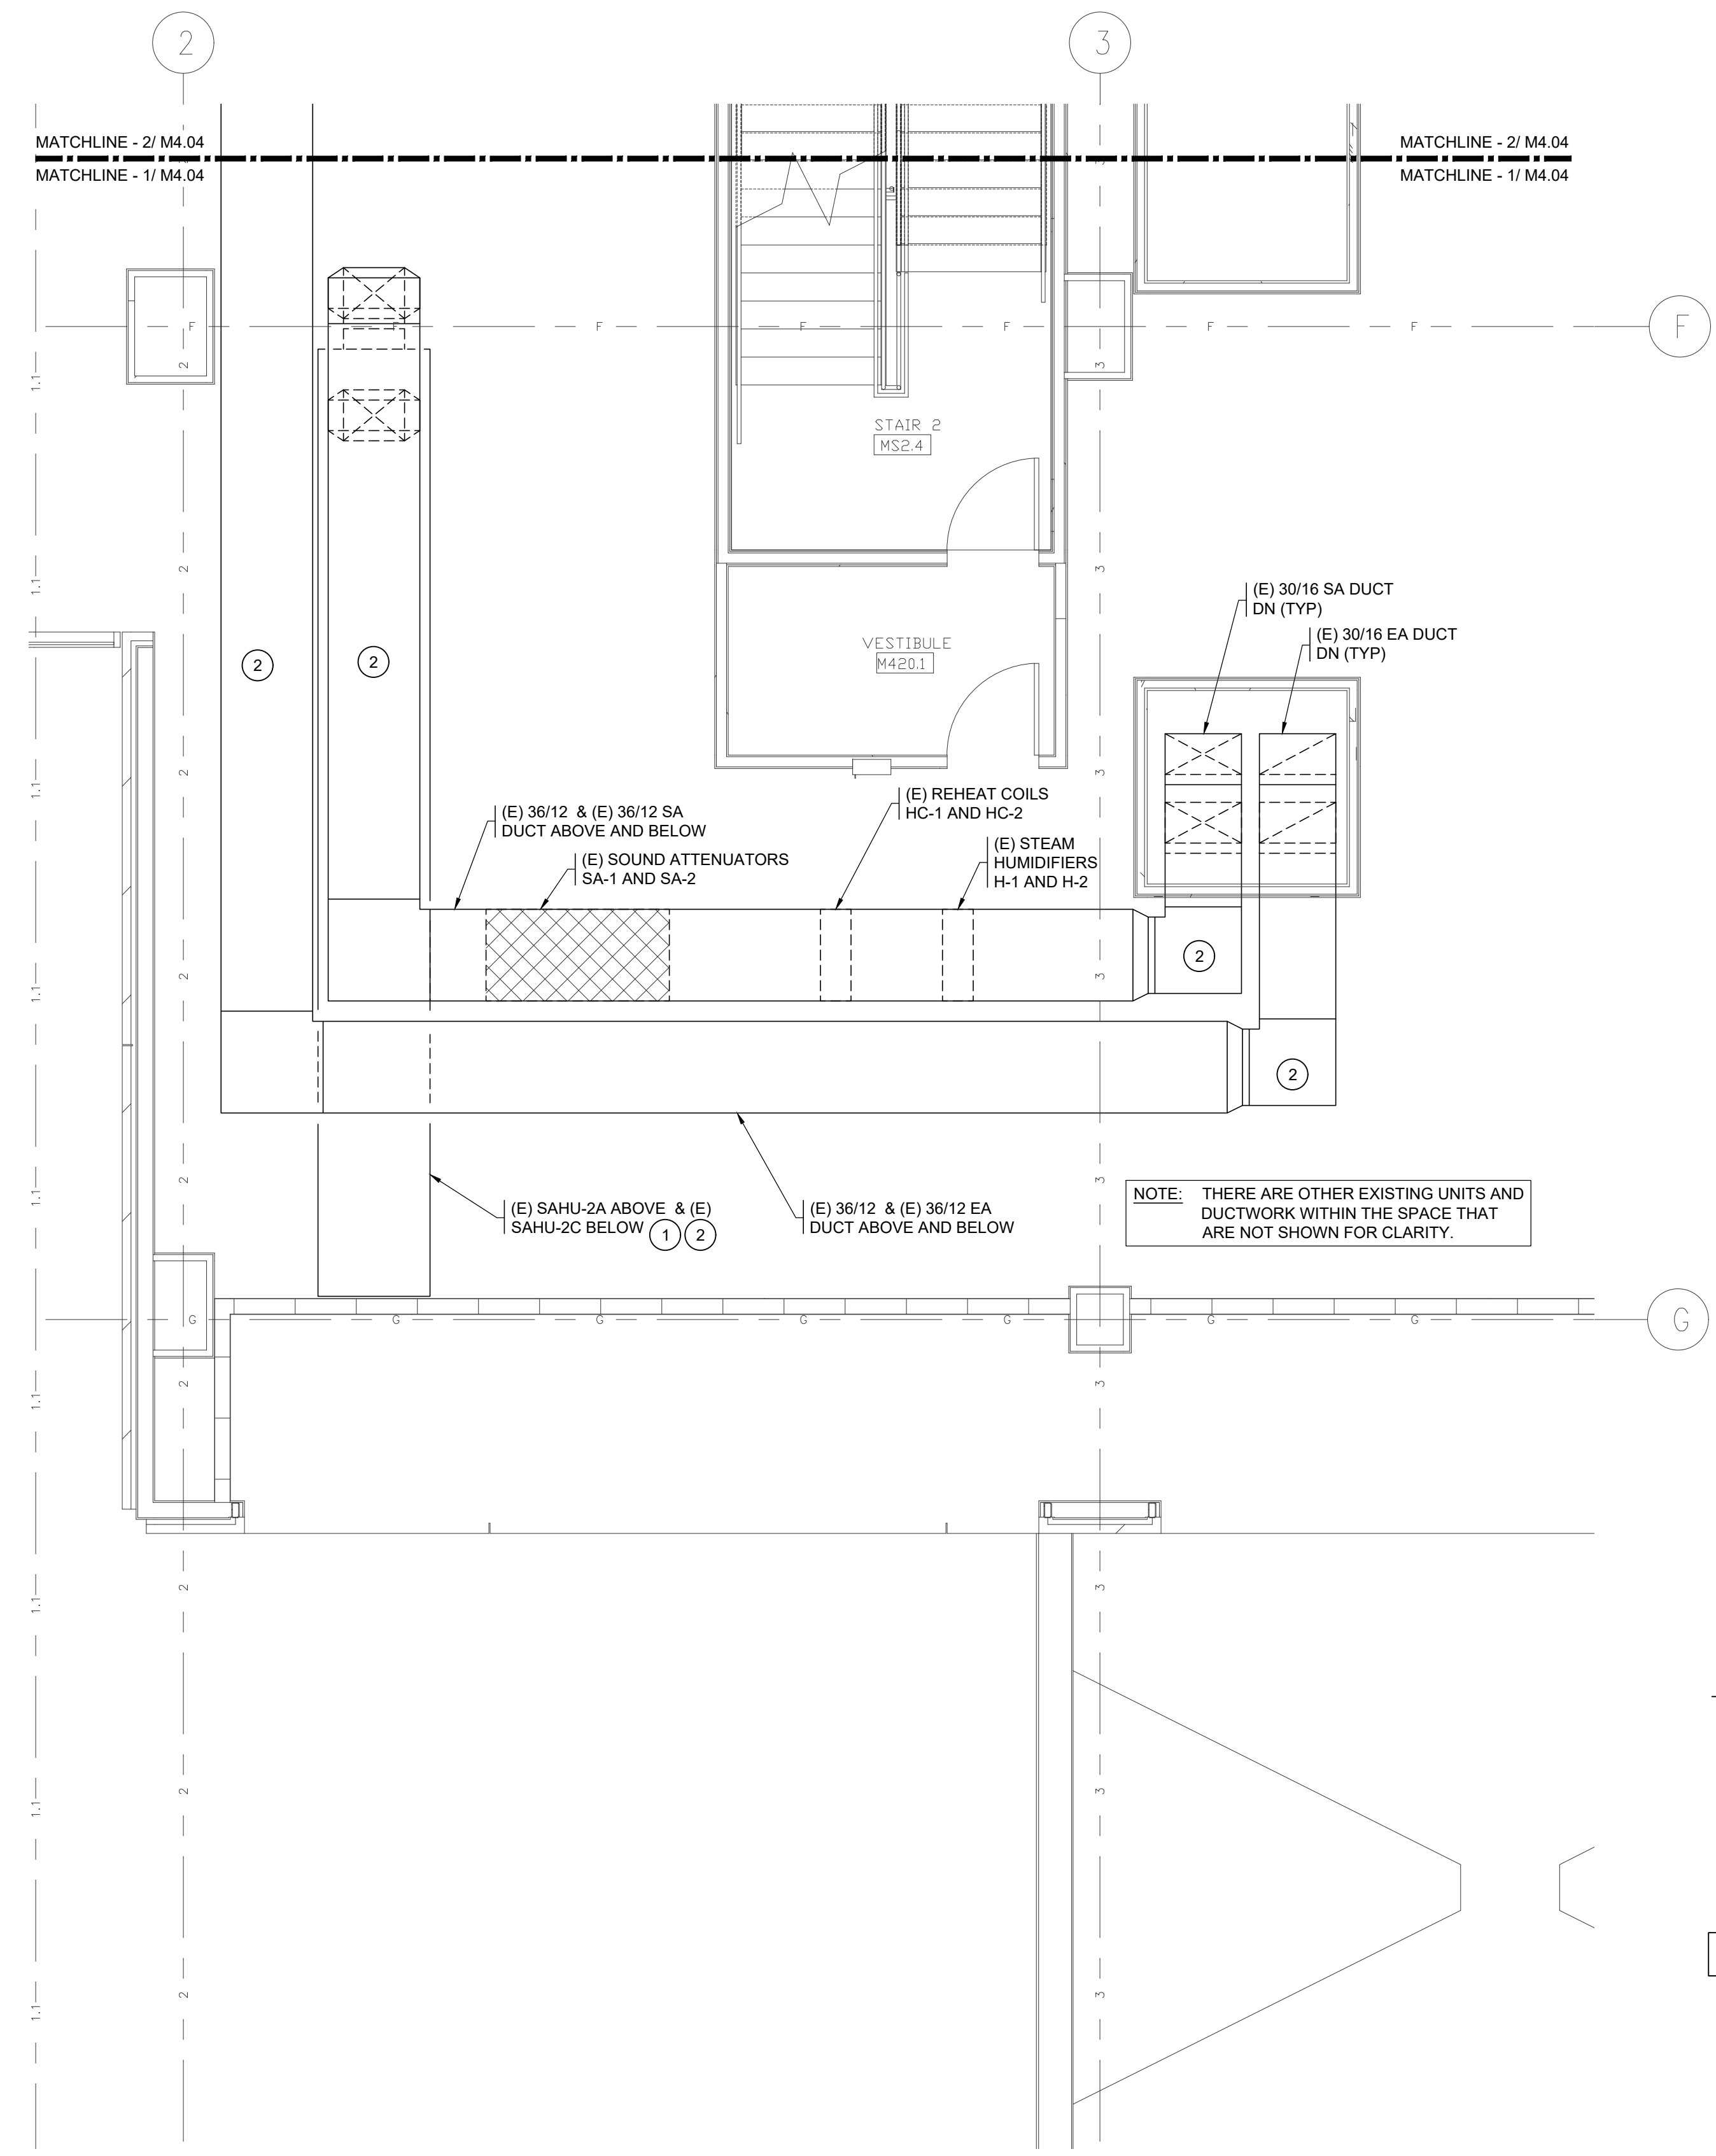

**1** ENLARGED PARTIAL PLAN - 4TH FLOOR HVAC  
M4.04

SCALE: 1/4" = 1'-0"


**GENERAL NOTES:**

- FOR GENERAL NOTES SEE SHEET M0.01 & M0.02.

**KEYED NOTES:**

- EXISTING HVAC UNITS WERE INSTALLED IN 2008 AS PART OF A SHELL AND CORE PROJECT. EXISTING UNITS ARE MANUFACTURED BY HAAKON. CONTRACTOR SHALL OBTAIN NEW START-UP/RECOMMISSIONING BY MANUFACTURER. WORK INCLUDES UNIT WITH PRE-FILTERS, SOUND ATTENUATOR, HEAT RECOVERY COIL, HYDRONIC PRE-HEAT COIL, COOLING COIL, FAN, FINAL FILTERS, REHEAT COIL.
- PROVIDE PROFESSIONAL DUCT CLEANING OF EXISTING DUCTWORK, FROM OR TO EXISTING HVAC UNITS. ALSO, PROVIDE COMPLETE CLEANING OF EXISTING HVAC UNITS. CLEAN UNIT INSIDE AND OUT. PROVIDE BALANCING OF ALL COMPONENTS.

**KEYPLAN**

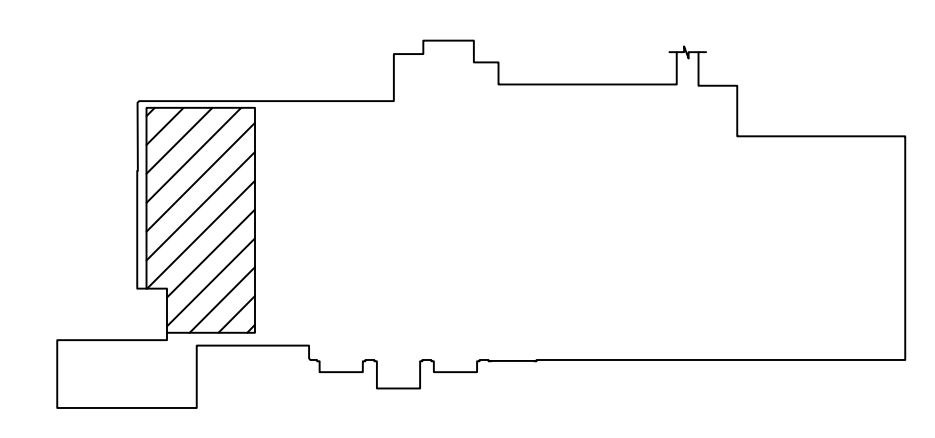

InSight  
HealthCare Architecture  
KLanglois@insightdesignstudio.biz  
12345 Lake City Way NE #2108  
Seattle, WA 98125  
206-601-6645

SIGNED  
4-2-2021

OWNER:

MultiCare  
Tacoma General Hospital

PROJECT NAME:  
**OR 7&8  
Buildout**

Good Samaritan  
Hospital  
401 15th Ave SE  
Puyallup, WA 98372

MARK	DATE	DESCRIPTION
	3/19/2021	DESIGN DEVELOPMENT
	4/2/2021	PERMIT SET

PROJECT NO. 31232



DRAWN BY:

DATE: 2 APRIL 2021  
COPYRIGHT TO:  
InSight Healthcare Architecture



SHEET TITLE:  
**ENLARGED  
PARTIAL PLAN -  
4TH FLOOR  
HVAC**

SHEET #:  
**M4.04**


PLOTTED: Apr 02, 2021 - 11:06am PLOTTED BY: hdt/bb  
DWG PATH: I:\2021-366521-026-Acacia\hvac\21-026\_P4.M4.04.dwg

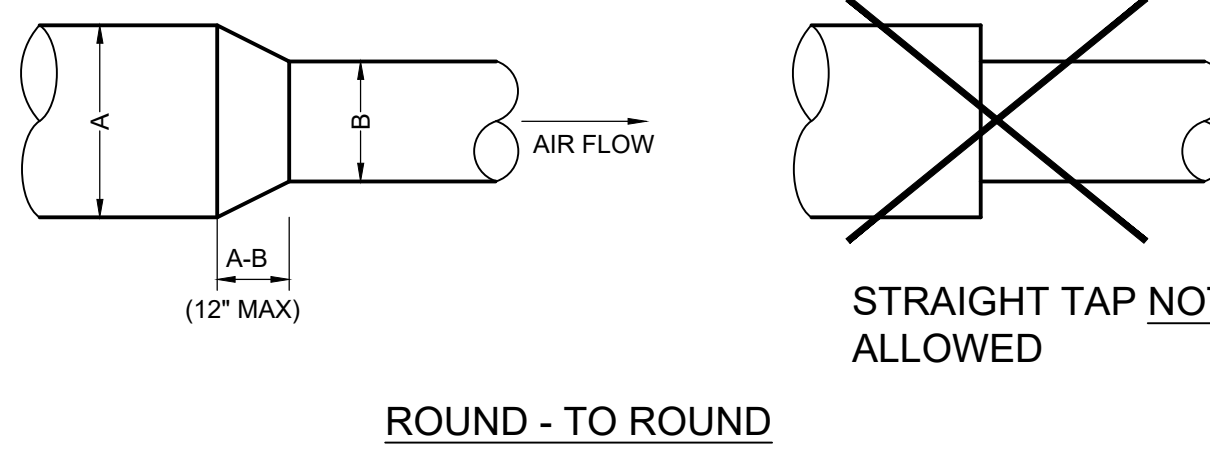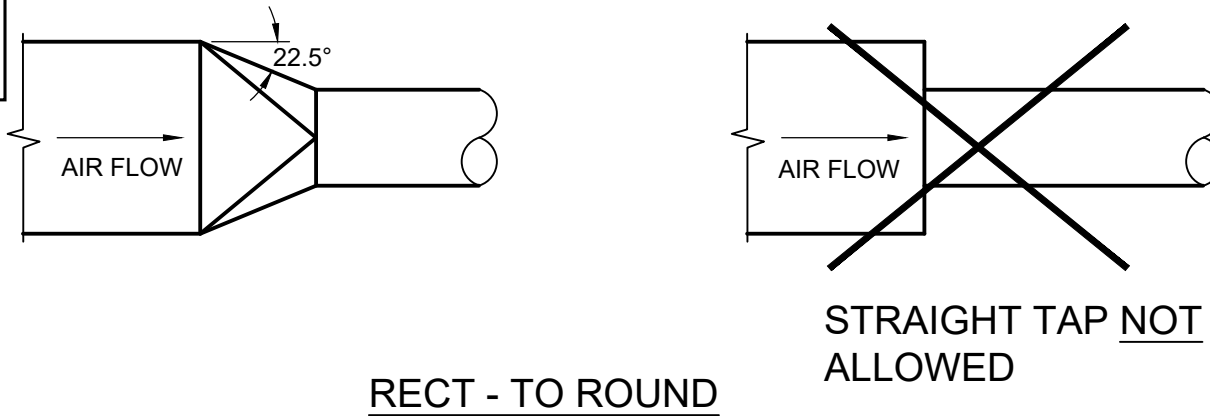


**ROUND TRANSITIONS** 3  
M4.20

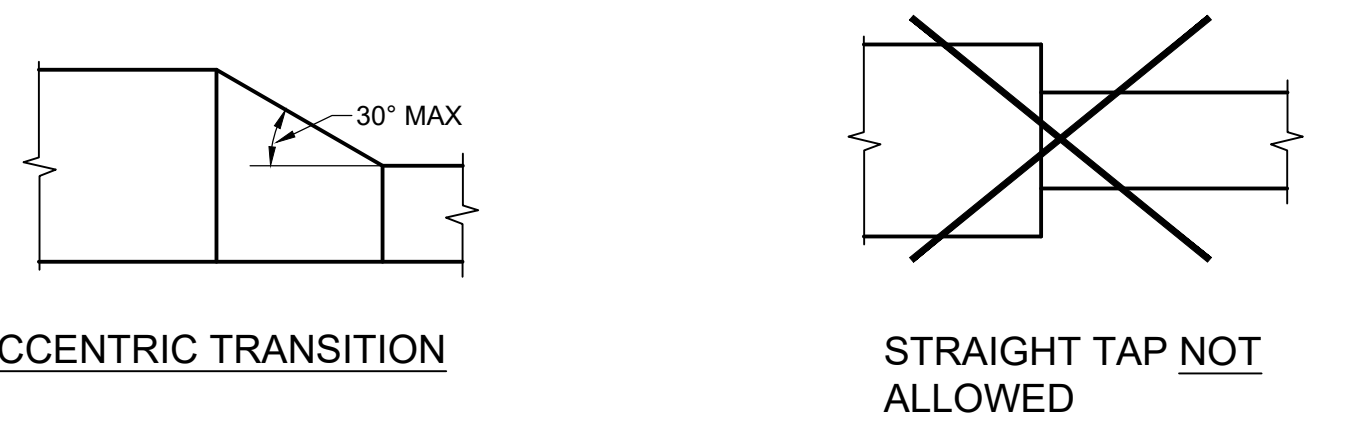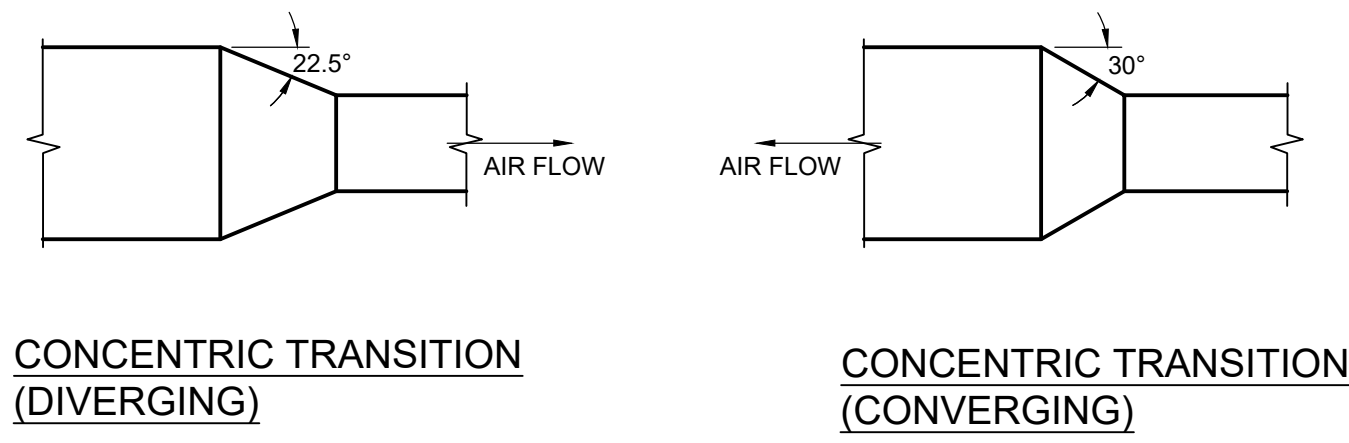


**RECT-TO-RECT TRANSITIONS** 6  
M4.20

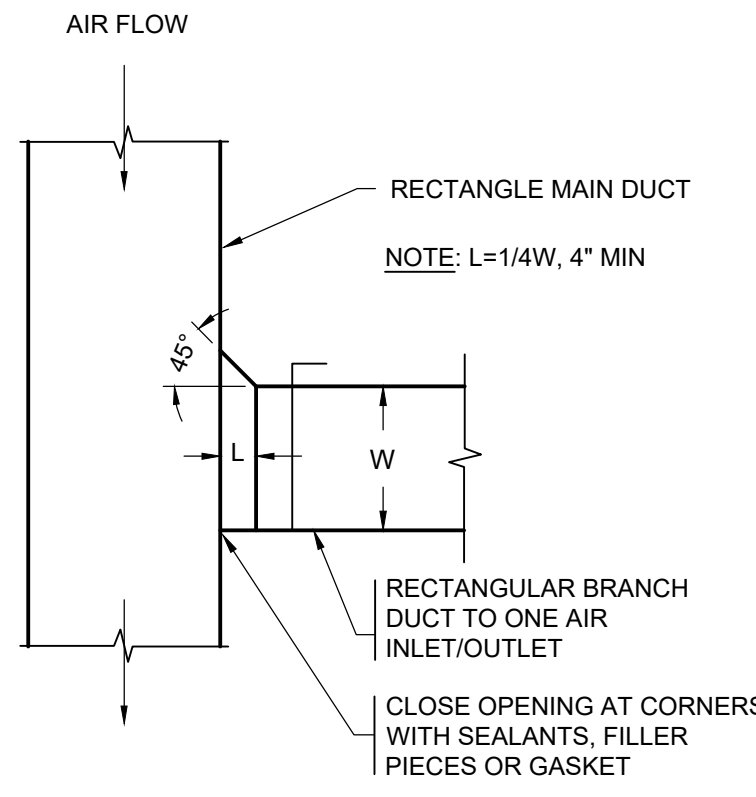

**RECT-TO-RECT BRANCH DUCT CONNECTION** 2  
M4.20

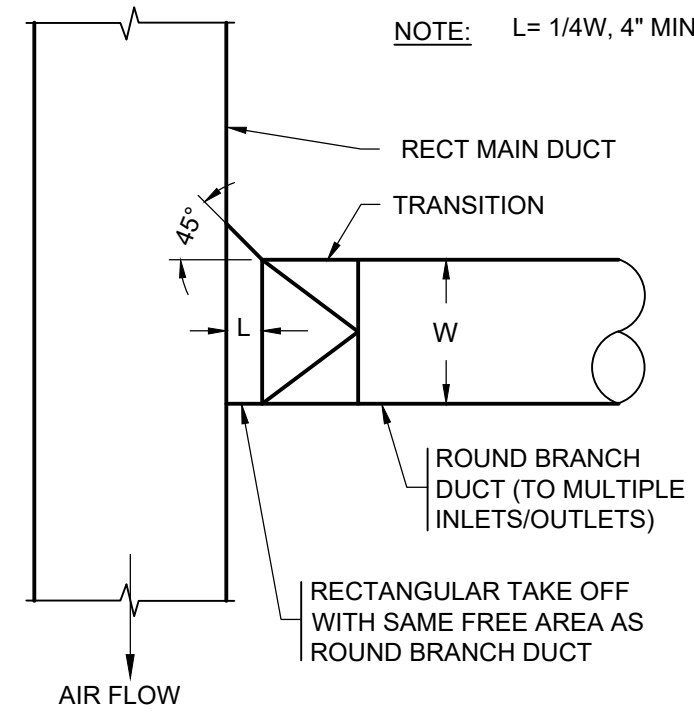


**RECT-TO-ROUND BRANCH DUCT CONNECTION** 5  
M4.20

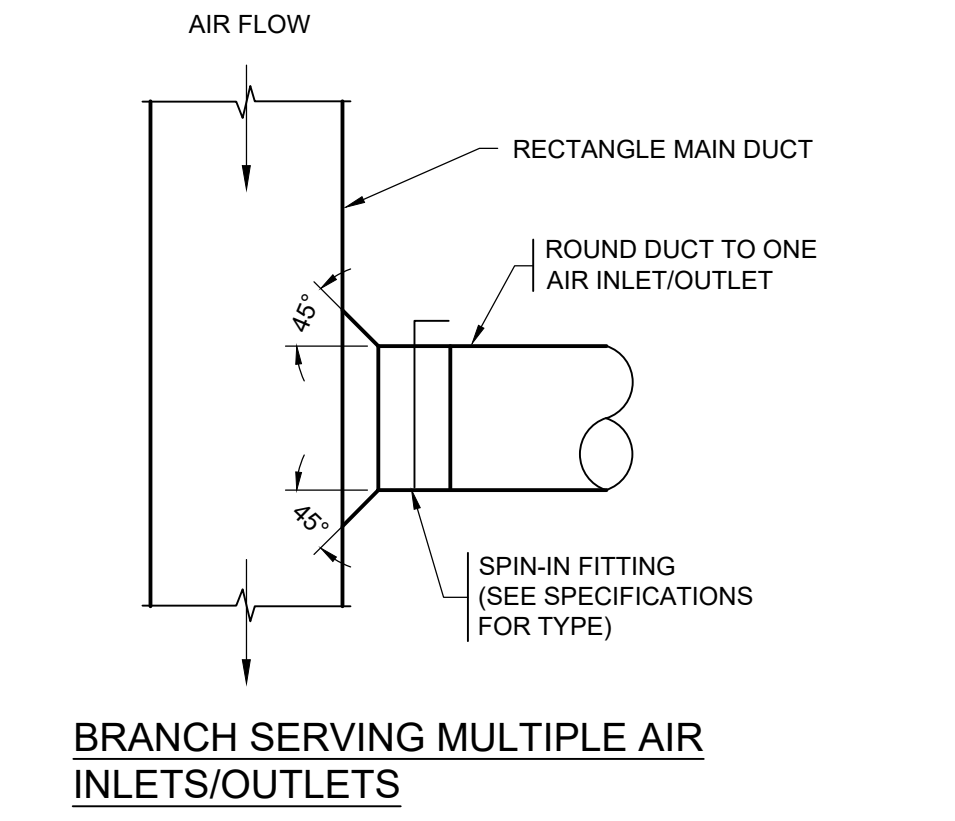


NOTE:  
WHERE MAIN DUCT DOES NOT HAVE ADEQUATE HEIGHT TO ACCEPT ROUND DUCT, PROVIDE RECTANGULAR CONNECTION, WITH SAME FREE AREA AS ROUND DUCT, AND TRANSITION TO ROUND

**RECT-TO-ROUND BRANCH DUCT CONNECTION** 1  
M4.20

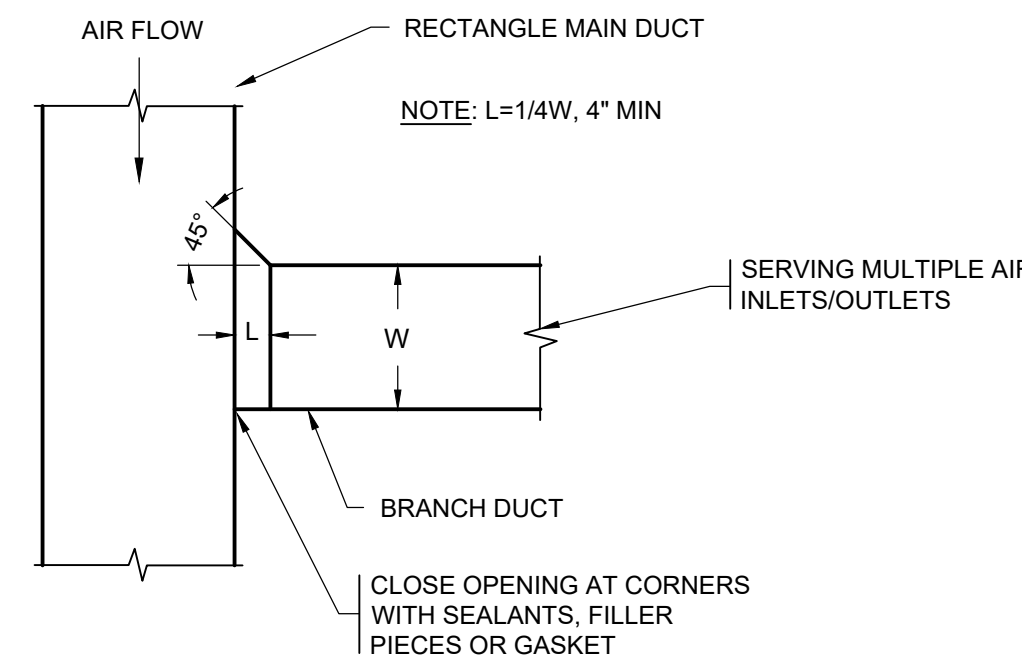

**RECT-TO-RECT BRANCH DUCT CONNECTION** 4  
M4.20

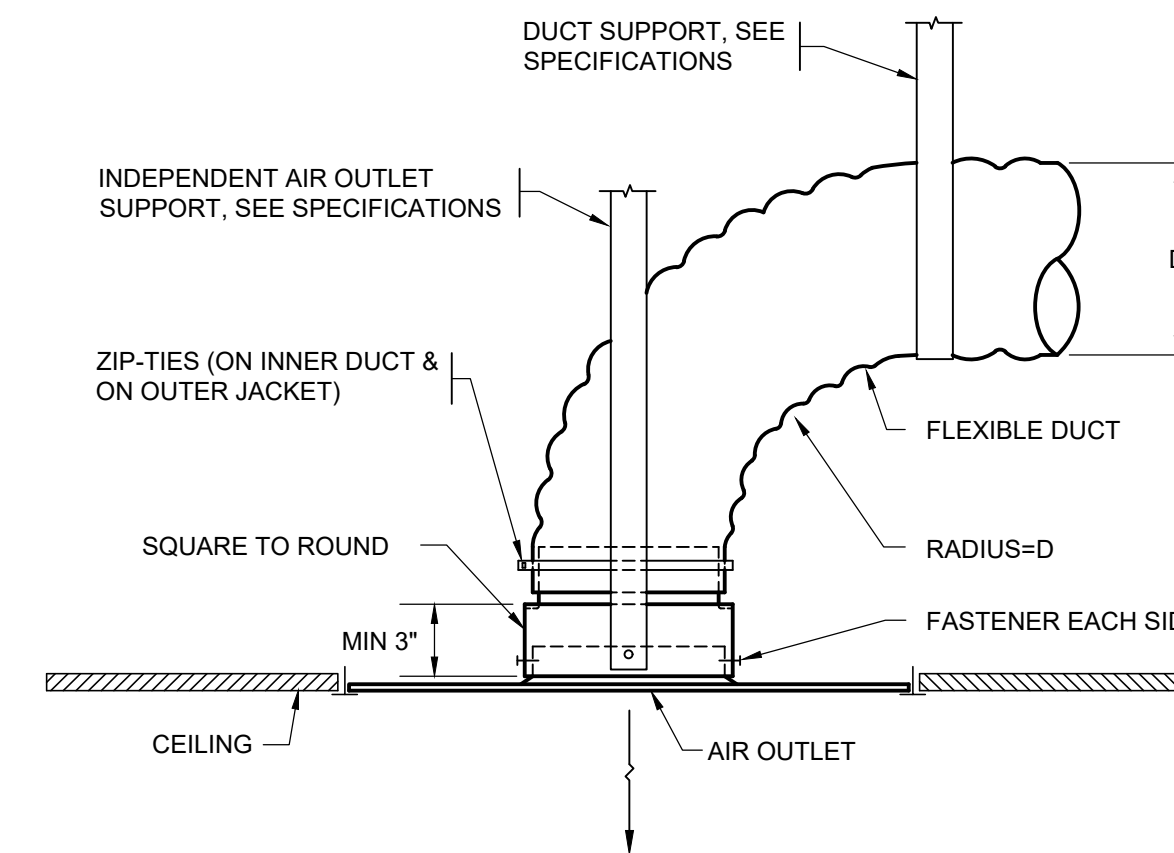

- NOTES:**
1. USE WHERE ADEQUATE SPACE IS AVAILABLE FOR FLEX DUCT RADIUS, AND WHERE FLEX DUCT IS SHOWN ON PLANS TO AIR OUTLET.
  2. NOT ALLOWED AT TRANSFER DUCTS.
  3. WHEN THERE IS INSUFFICIENT ROOM TO MAINTAIN FLEX DUCT RADIUS, SEE DETAIL TITLED "TIGHT CONDITION - FLEX DUCT AIR OUTLET CONNECTION."
  4. NOT ALLOWED WHERE LINED "CANS" (OR LINED DUCTS) SHOWN (OR REQ'D) AT AIR OUTLETS.
  5. CEILING TYPE & AIR OUTLET FRAME STYLE MAY VARY FROM THAT DEPICTED.
  6. NOT ALL SUPPORTS SHOWN FOR CLARITY.

**FLEX DUCT AIR OUTLET CONNECTION** 7  
M4.20

OWNER:

MultiCare  
Tacoma General Hospital

PROJECT NAME:

OR 7&8  
Buildout

Good Samaritan  
Hospital  
401 15th Ave SE  
Puyallup, WA 98372

MARK	DATE	DESCRIPTION
	3/19/2021	DESIGN DEVELOPMENT
	4/2/2021	PERMIT SET

PROJECT NO. 31232

DRAWN BY:

DATE: 2 APRIL 2021  
COPYRIGHT TO:

InSight Healthcare Architecture

SHEET TITLE:


MECHANICAL  
DETAILS

SHEET #:

M4.20





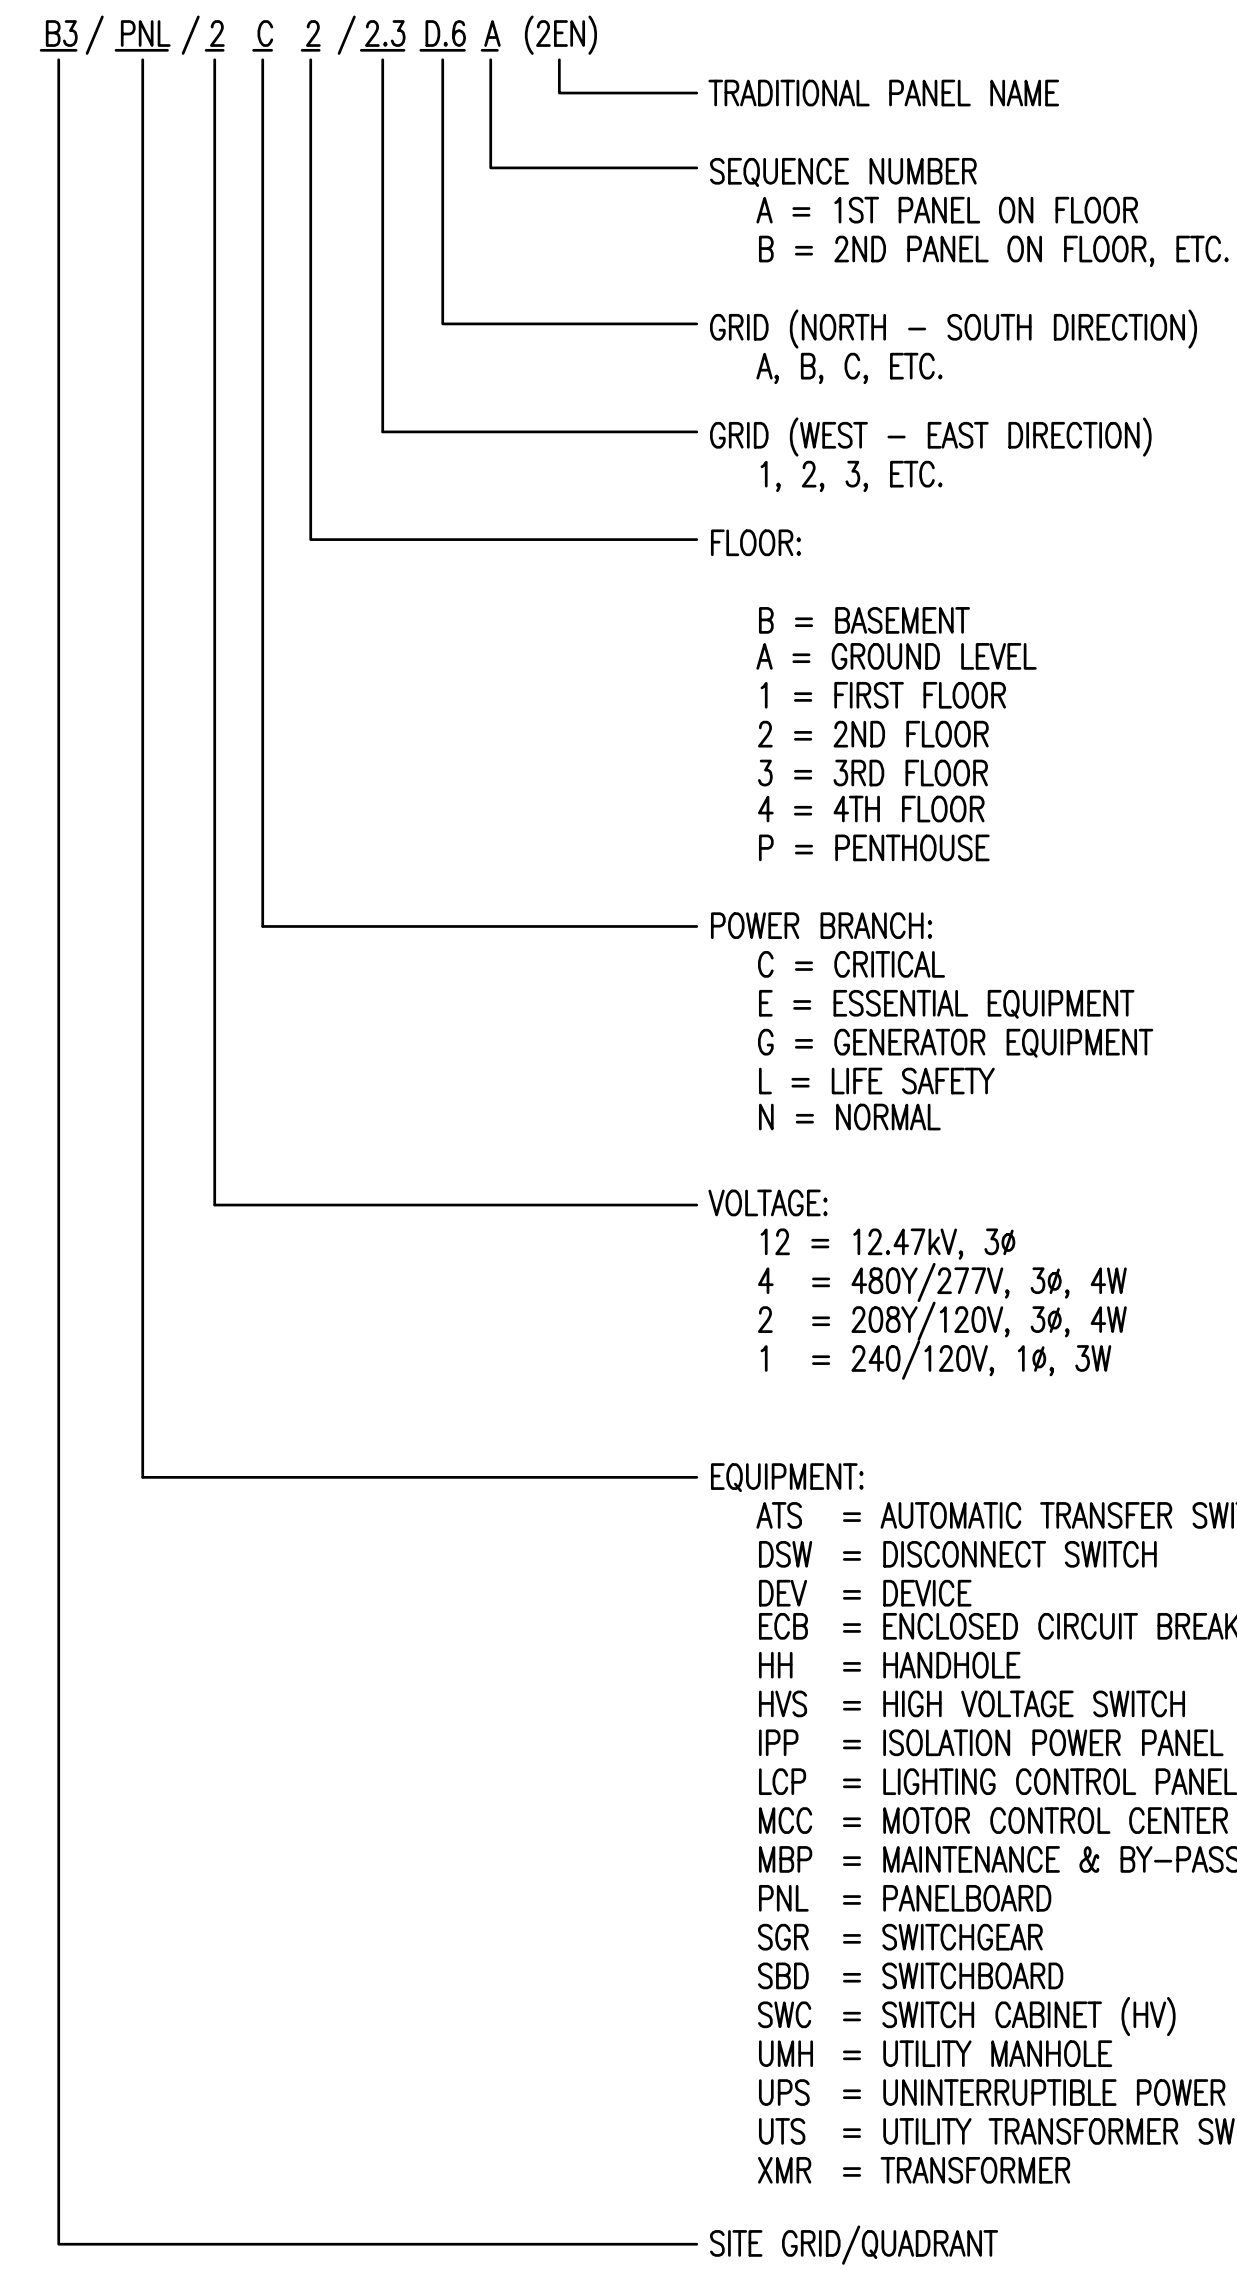

ABBREVIATIONS (SOME ABBREVIATIONS MAY NOT BE USED ON DRAWINGS)	
ABBREV	DESCRIPTION
A or AMP	AMPERES
AIC	AMPERE INTERRUPTING CAPACITY
ARCH	ARCHITECTURAL
AWG	AMERICAN WIRE GAUGE
C	CONDUIT
CB	CIRCUIT BREAKER
CKT	CIRCUIT
CT	CURRENT TRANSFORMER
CU	COPPER
DIA	DIAMETER
DIV	DIVISION
DRC	DIGITAL ROOM CONTROLLER
DWG	DRAWING
ELEC	ELECTRIC
EMT	ELECTRICAL METALLIC TUBING
EXST or (E)	EXISTING
FA	FIRE ALARM
FLA	FULL LOAD AMPS
FLEX	FLEXIBLE CONDUIT
GND	GROUND
HP	HORSEPOWER
HZ	HERTZ
J-BOX	JUNCTION BOX
KVA	KILOVOLT AMPERES
KW	KILOWATTS
LTG	LIGHTING
MAX	MAXIMUM
MCA	MINIMUM CIRCUIT AMPS
MCM or KCM	THOUSAND CIRCULAR MILS
MDP	MAIN DISTRIBUTION PANELBOARD
MDS	MAIN DISTRIBUTION SWITCHBOARD
MIN	MINIMUM
MOP or MOCF	MAXIMUM OVERCURRENT PROTECTION
N or NEUT	NEUTRAL
NTS	NOT TO SCALE
$\emptyset$ or PH	PHASE
PNL	PANEL
RM	ROOM
SP	SINGLE POLE
STD	STANDARD
SW	SWITCH
SWBD	SWITCHBOARD
TYP	TYPICAL
UL	UNDERWRITERS LABORATORY
V	VOLTS
VA	VOLT AMPERES
W	WATTS
W/	WITH
WP	WEATHER PROOF

ELECTRICAL LEGEND (SOME SYMBOLS MAY NOT BE USED ON DRAWINGS)			
SITE / EXTERIOR		POWER	
○	POLE	⊖	SINGLE RECEPTACLE (NEMA 5-20R) (SUBSCRIPT - SEE DUPLEX RECEPTACLE)
▲	TRANSFORMER	⊖*	DUPLEX RECEPTACLE (NEMA 5-20R) ASTERISK INDICATES COUNTER HEIGHT OUTLET (DUPLEX RECEPTACLE SHOWN)
▲	PAD MOUNTED TRANSFORMER	⊖*	FOURPLEX RECEPTACLE (NEMA 5-20R)
⊗	PAD MOUNTED SWITCH	⊖*	GFCI DUPLEX RECEPTACLE (NEMA 5-20R)
E	HANDHOLE OR VAULT	⊖*	TAMPER RESISTANT (DUPLEX RECEPTACLE SHOWN)
P	P PRIMARY ELECTRIC (ABOVE 600V)	⊖*	SPLIT WIRED DUPLEX RECEPTACLE (NEMA 5-20R)
C	E SECONDARY ELECTRIC (BELOW 600V)	⊖*	SPLIT WIRED RECEPTACLE, 1/2 OF RECEPTACLE IS CONTROLLED BY OCCUPANCY SENSOR OR TIME SWITCH
C	C COMMUNICATIONS	⊖*	DUPLEX RECEPTACLE ON EMERGENCY CIRCUIT
DISTRIBUTION		⊖*	SPECIAL PURPOSE OUTLET (AS NOTED)
▬	PANELBOARD - SURFACE	⊖*	JUNCTION BOX - CEILING OR EXPOSED
▬	PANELBOARD - EXISTING (SURFACE PANEL SHOWN)	⊖*	BLANKED OUTLET - CEILING
▬	PANELBOARD - FLUSH	⊖*	EQUIPMENT CONNECTION SUBSCRIPT: WH WATER HEATER HD HAND DRYER WD WASTE DISPOSER
▬	SWITCHBOARD OR MCC (DRAWN TO SCALE)	CALLOUTS	
▬	DISCONNECT SWITCH	200-4-G	FEEDER CALLOUT X-Y-Z. SEE SCHEDULE.
▬	FUSED DISCONNECT SWITCH	200/150-3P	DEVICE SIZE / FUSE OR TRIP RATING - No. OF POLES
▬	MAGNETIC MOTOR STARTER OR OTHER MOTOR CONTROL DEVICE AS SCHEDULED	XXX	FIXTURE SYMBOL
▬	DRY TYPE TRANSFORMER	⊖	BUBBLE NOTE TAG SYMBOL: # - IDENTIFYING NUMBER
▬	CROSS LINES INDICATE NUMBER OF CONDUCTORS IF MORE THAN TWO WIRE CIRCUIT. LONG DENOTES NEUTRAL. DOT DENOTES GROUND. DOTTED HASH MARK INDICATES ISOLATED GROUND. CONDUIT IS 1/2" AND CONDUCTOR IS #12 AWG UNLESS OTHERWISE NOTED OR SCHEDULED. ONLY BRANCH CIRCUIT HOMERUNS ARE INDICATED WITH CONDUCTOR COUNT. SEE GENERAL ELECTRICAL NOTES.	⊖	CONDUIT OR FEEDER SYMBOL: (SEE RACEWAY SCHEDULE) # - IDENTIFYING NUMBER
▬	WIRING CONCEALED IN CEILING OR WALL	⊖	DRAWING REVISION SYMBOL: # - IDENTIFYING NUMBER
▬	WIRING CONCEALED UNDERGROUND OR BELOW FLOOR	⊖	SCHEDULED EQUIPMENT CONNECTION (INCLUDE ALL WIRING, DISCONNECTING MEANS, CONTROL AND OTHER REQUIREMENTS SCHEDULED)
▬	WIRING EXPOSED	⊖	DETAIL SYMBOL: (AS INDICATED ON DRAWINGS) # - IDENTIFYING NUMBER B - SHEET WHERE DETAIL SHOWN
▬	WIRING HOMERUN	⊖	DETAIL SYMBOL: (AS INDICATED ON DRAWINGS) # - IDENTIFYING NUMBER B - SHEET WHERE DETAIL SHOWN
▬	CONDUIT UP, DOWN	REMODEL	
▬	FLEXIBLE WIRING CONNECTION	▬	HEAVY LINE WEIGHT = NEW WORK (2 X 4 LAY-IN SHOWN)
		▬	STANDARD LINE WEIGHT = EXISTING TO REMAIN (RECEPTACLE SHOWN)
		▬	CROSS HATCH LINE WORK = ELECTRICAL DEMOLITION (RECEPTACLE SHOWN)
		▬	BROKEN LINE WORK = ELECTRICAL DEMOLITION (RECEPTACLE SHOWN)
		⊖(N)	STANDARD LINE WEIGHT WITH (N) = EXISTING TO BE REPLACED OR MODIFIED (SEE REMODEL NOTES) (RECEPTACLE SHOWN)


**GENERAL ELECTRICAL NOTES:**

- BRANCH CIRCUIT NOTES:
  - VERIFY BRANCH CIRCUIT WIRE COUNT BEFORE PULLING CONDUCTORS. PROVIDE REQUIRED CONDUCTORS TO EACH OUTLET AND DEVICE FOR PHASE, NEUTRAL AND EQUIPMENT GROUND BASED ON CIRCUIT DESIGNATIONS SHOWN AND AS OTHERWISE INDICATED ON PLANS OR NOTE BELOW.
  - PROVIDE SEPARATE NEUTRAL CONDUCTOR FOR BRANCH CIRCUITS SERVING RECEPTACLE OUTLETS UNLESS OTHERWISE INDICATED.
  - VERIFY BACK BOX REQUIREMENTS OF EQUIPMENT FURNISHED UNDER OTHER THAN DIVISION 26 SECTIONS AND EQUIPMENT FURNISHED BY OWNER.


**ELECTRICAL SPECIFICATIONS:**

- DIVISION 26**
- CONDUIT INDOOR: EMT CONDUIT FOR DRY AND DAMP LOCATIONS.
  - STEEL FLEXIBLE CONDUIT FOR FINAL CONNECTIONS TO RECESSED LIGHT FIXTURES AND EQUIPMENT SUBJECT TO VIBRATION OR MOVEMENT.
  - EMT & FLEXIBLE CONDUIT FITTINGS: STEEL; COMPRESSION.
  - GRC & IMC FITTINGS: THREADED RIGID STEEL FITTINGS.
  - CONDUCTORS: SHALL BE COPPER.
  - NON-SPECIFIED ITEMS: NOT ALL ITEMS ARE SPECIFIED, BUT SHALL BE PROVIDED TO PROVIDE FULLY OPERATIONAL SYSTEMS. ALL NON-SPECIFIED ITEMS SHALL BE SUITABLE FOR HEALTHCARE AND COMMERCIAL APPLICATIONS.
  - ALL OTHER WORK SHALL BE IN COMPLIANCE WITH EQUIPMENT SCHEDULES AND AS INDICATED AND SHALL BE PER THE MULTICARE MASTER SPECIFICATIONS FOR USE ON ALL HOSPITAL PROJECTS DATED 31 MARCH 2014.
  - AVOID HOT WORK WHEN POSSIBLE. IF UNAVOIDABLE USE FM GLOBAL HOT WORK PERMIT PROCESS AND USE ALL PRECAUTIONS REQUIRED TO PREVENT HOT WORK RELATED FIRES.
- DIVISION 27**
- COORDINATE WITH OWNER'S VENDOR TO OBTAIN PROPOSED ROUTING AND RECOMMENDED LOCATION AND SIZE OF CONDUIT SLEEVES FOR INSTALLING OPEN SIGNAL CABLES THRU FIRE RATED CONSTRUCTION, DRAFT STOPS, AND PARTITION WALLS IN ACCESSIBLE CEILING SPACES. SIZE SLEEVES WITH 25% MINIMUM SPACE CAPACITY. INDICATE ON SHOP DRAWINGS FOR COORDINATION.
  - REFER TO MULTICARE MASTER SPECIFICATIONS FOR USE ON ALL HOSPITAL PROJECTS.

**EQUIPMENT NOMENCLATURE KEY**

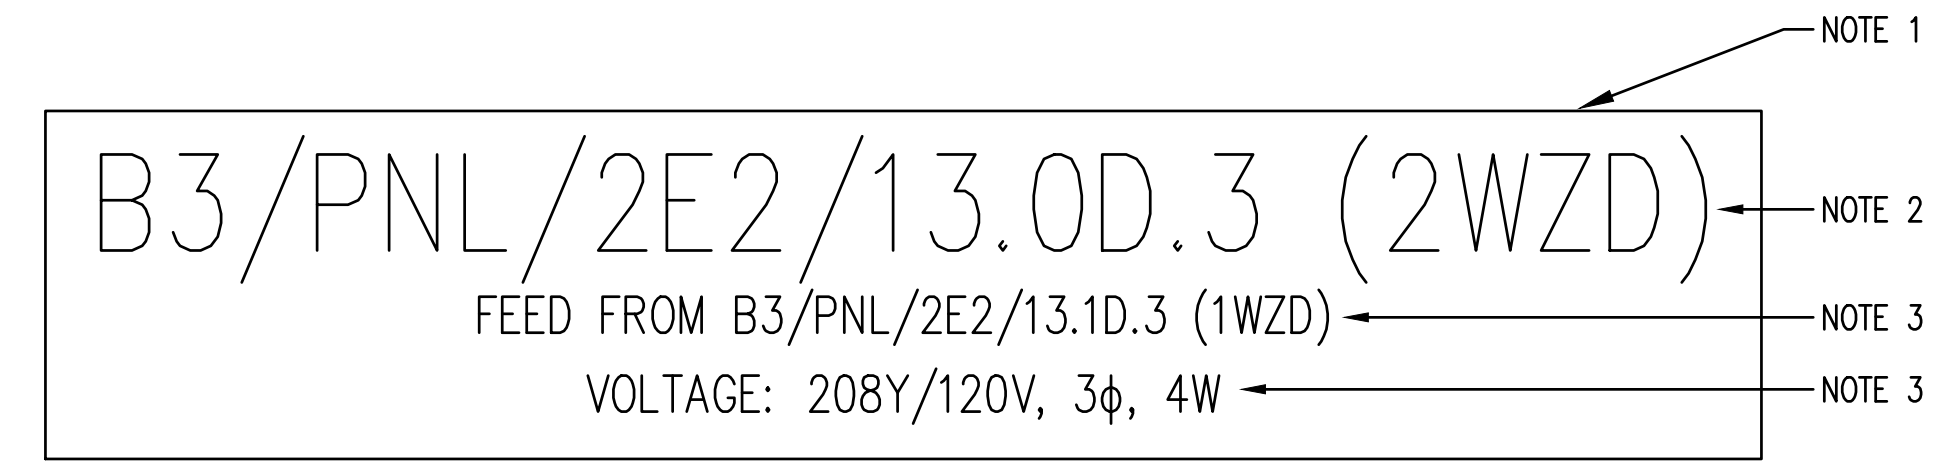

- NOTES:**
- ENGRAVED THREE-LAYER LAMINATED PLASTIC WITH WHITE LETTERS. BLACK BACKGROUND FOR NORMAL POWER. ORANGE BACKGROUND FOR CRITICAL POWER. RED BACKGROUND FOR LIFE SAFETY POWER. BLUE BACKGROUND FOR ESSENTIAL EQUIPMENT POWER.
  - 1/2-INCH HIGH LETTERS.
  - 3/16-INCH HIGH LETTERS.


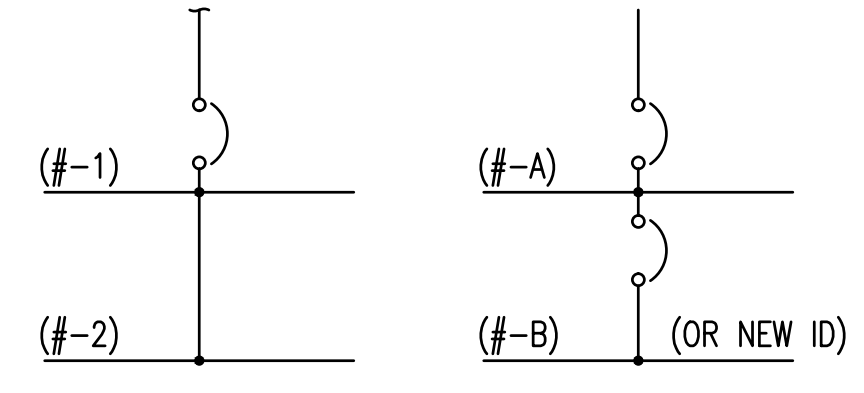


OWNER:  
**MultiCare Tacoma General Hospital**  
PROJECT NAME:  
**OR 7&8 Buildout**  
Good Samaritan Hospital  
401 15th Ave SE  
Puyallup, WA 98372


MARK	DATE	DESCRIPTION
	3/19/2021	DESIGN DEVELOPMENT
	4/2/2021	PERMIT SET

PROJECT NO. 31232  
DRAWN BY:  
DATE: 2 APRIL 2021  
COPYRIGHT TO: InSight Healthcare Architecture  
SHEET TITLE:  
**LEGEND, NOTES & ABBREVIATIONS**  
SHEET #:  
**E0.01**

MARK	DATE	DESCRIPTION
	3/19/2021	DESIGN DEVELOPMENT
	4/2/2021	PERMIT SET

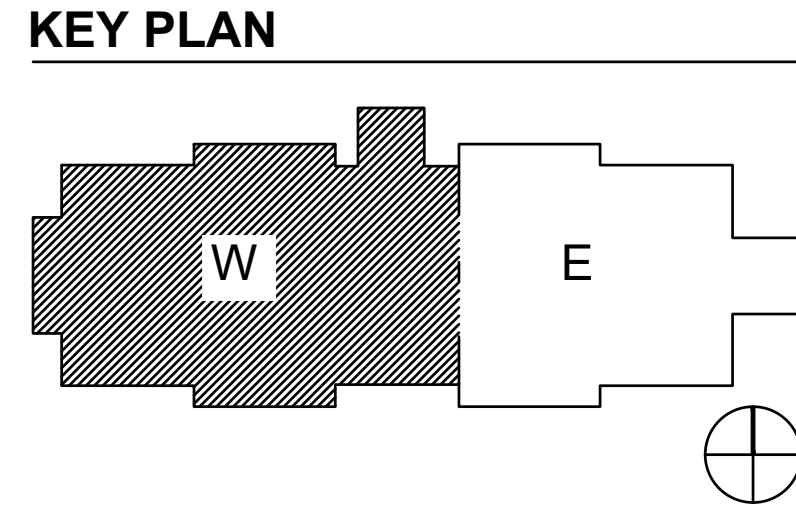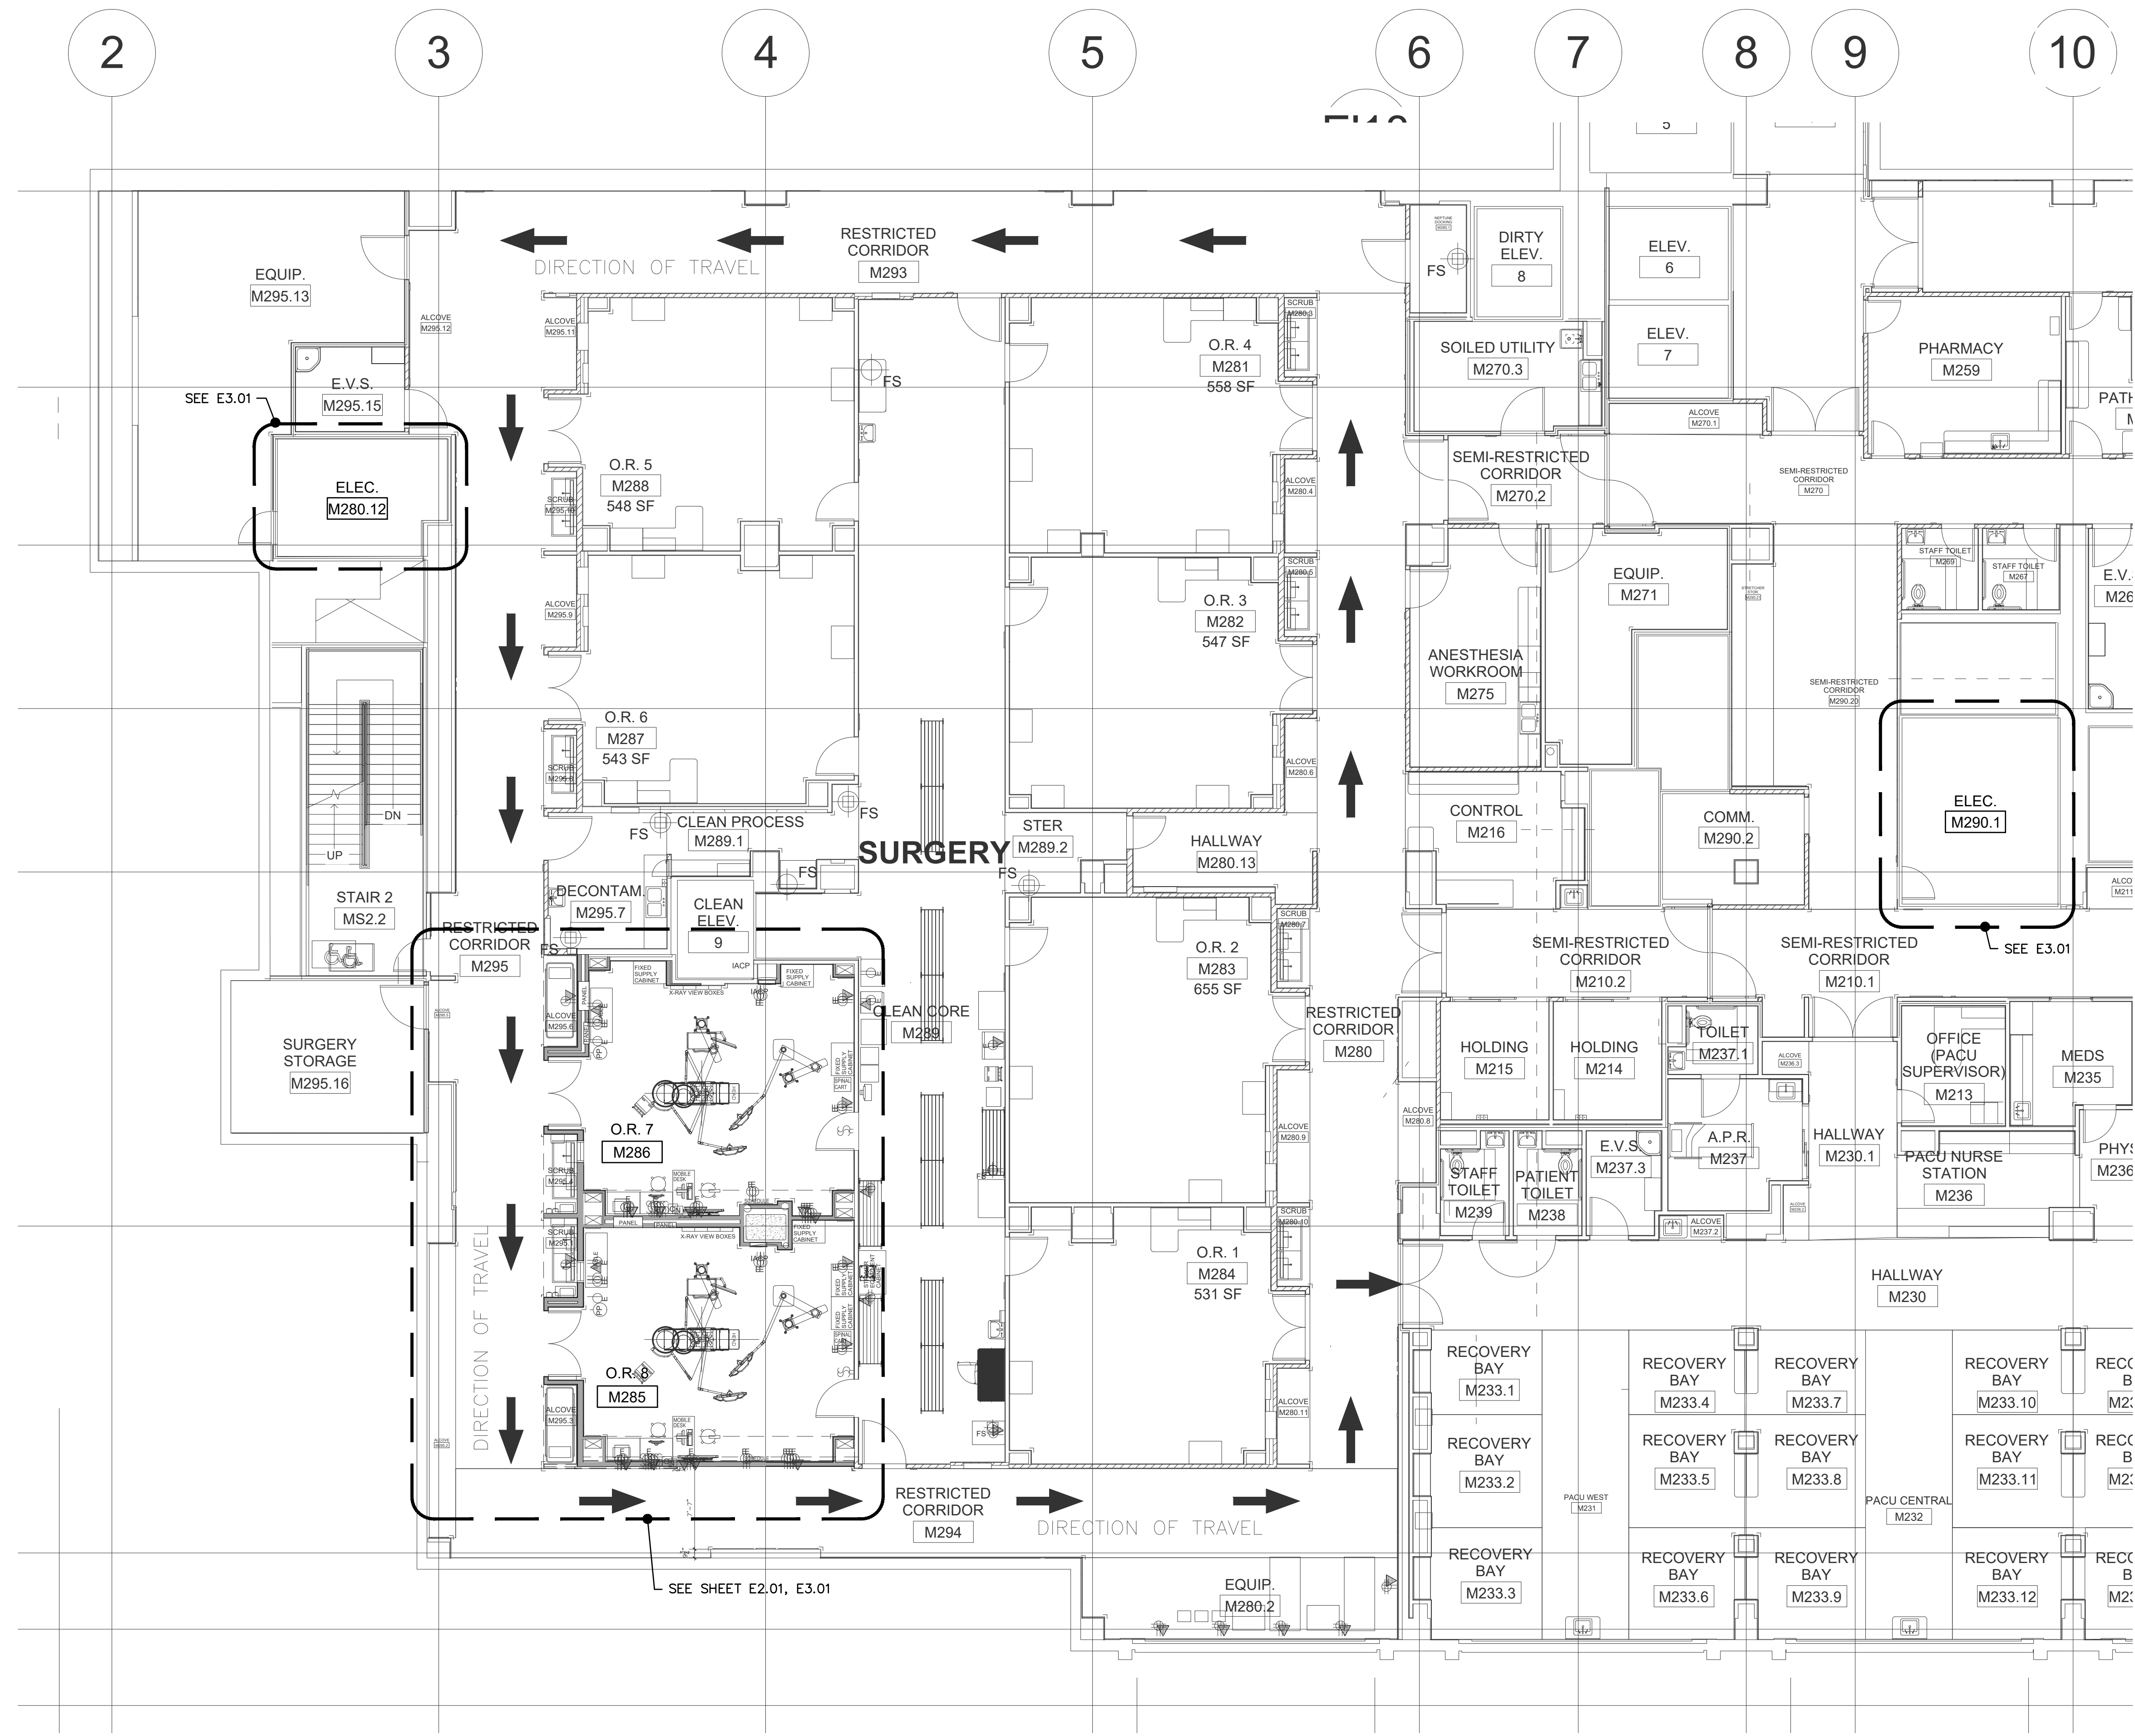


**SECOND FLOOR PLAN - WEST**  
SCALE: 1/8" = 1'-0"

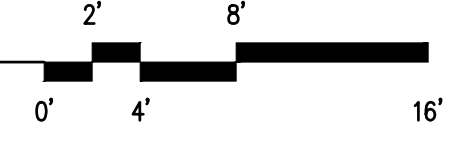


PLOTTED: Apr 02, 2021 - 11:55am  
 DWG PATH: I:\2021\_jobs\21-026\_Vico\Elec\21-028 E101 PARTIAL FLOOR PLAN.dwg  
 PLOTTED BY: NeilM  
 DATE: 02 APRIL 2021

LUMINAIRE SCHEDULE							
TYPE	DESCRIPTION	MANUFACTURER	LAMP	VOLTAGE	INPUT WATTS	BALLAST/DRIVER	REMARKS
G1	RECESSED, 1'X4', LED FIXTURE, ACRYLIC LENS, ANTIMICROBIAL FINISH, SYMMETRIC, DRYWALL KIT	HE WILLIAMS MDS	LED 4000K 7000 LUMEN	120	62	0-10V DIMMING	
G2	RECESSED, 2'X4', LED FIXTURE, ACRYLIC LENS, ANTIMICROBIAL FINISH, ASYMMETRIC, DRYWALL KIT	HE WILLIAMS MDS	LED 5000K 11600 LUMEN	120	98	0-10V DIMMING	
R	RECESSED LENS LED DOWNLIGHT, ROUND OVERLAP TRIM, REGRESSED LENS, WARM DIFFUSE REFLECTOR.		LED 4000K 1500 LUMEN	120	25	0-10V DIMMING	
US	ULTRASUITE LIGHTING/HVAC ASSEMBLY TASK LIGHTING.	ULTRASUITE	LED 5100K	120	2'-123 3'-156 4'-190 2457W	0-10V DIMMING	FIXTURE AND REMOTE DRIVER CABINET FURNISHED BY ULTRASUITE

NOTES:  
1. LED LUMENS ARE BASED ON TOTAL ILLUMINATION OUTPUT OF THE LUMINAIRE UNLESS OTHERWISE INDICATED.  
2. LED DRIVERS FOR LOW VOLTAGE DIMMING SHALL BE 0-10 VOLTS UNLESS OTHERWISE INDICATED.

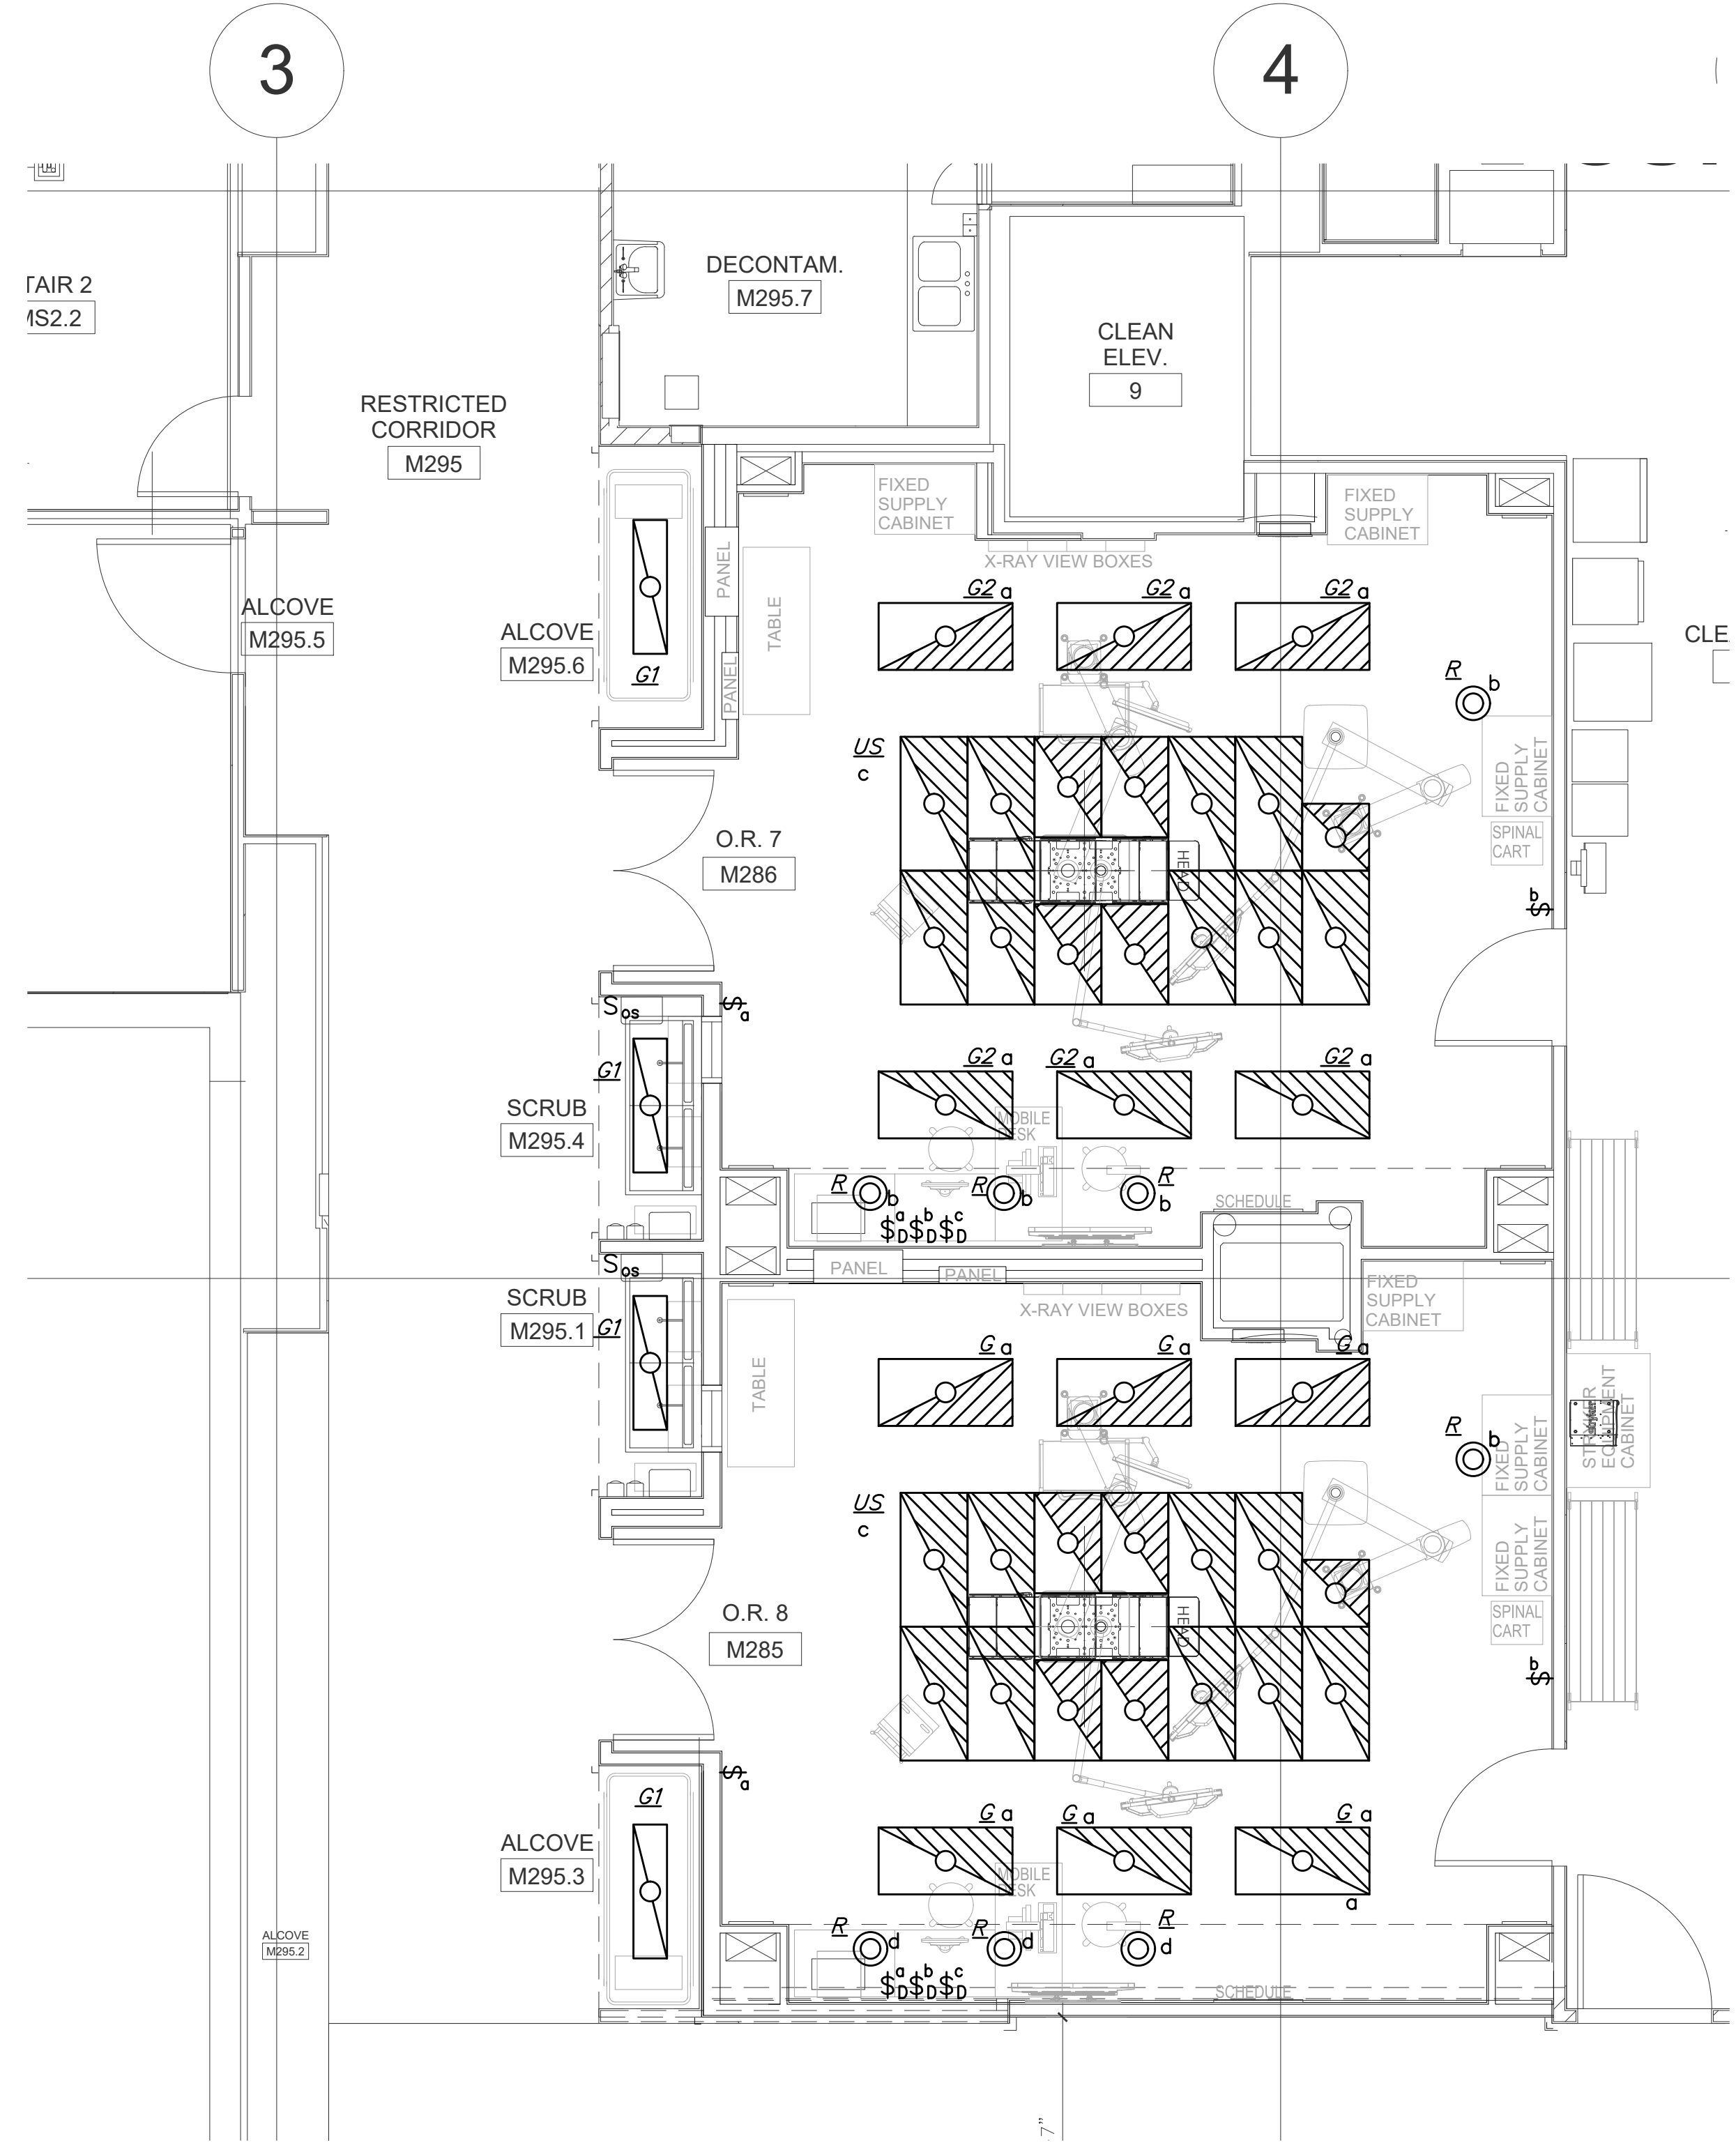

**OR 7 & 8**  
SCALE: #####  
SCALE 1/4" = 1'-0"

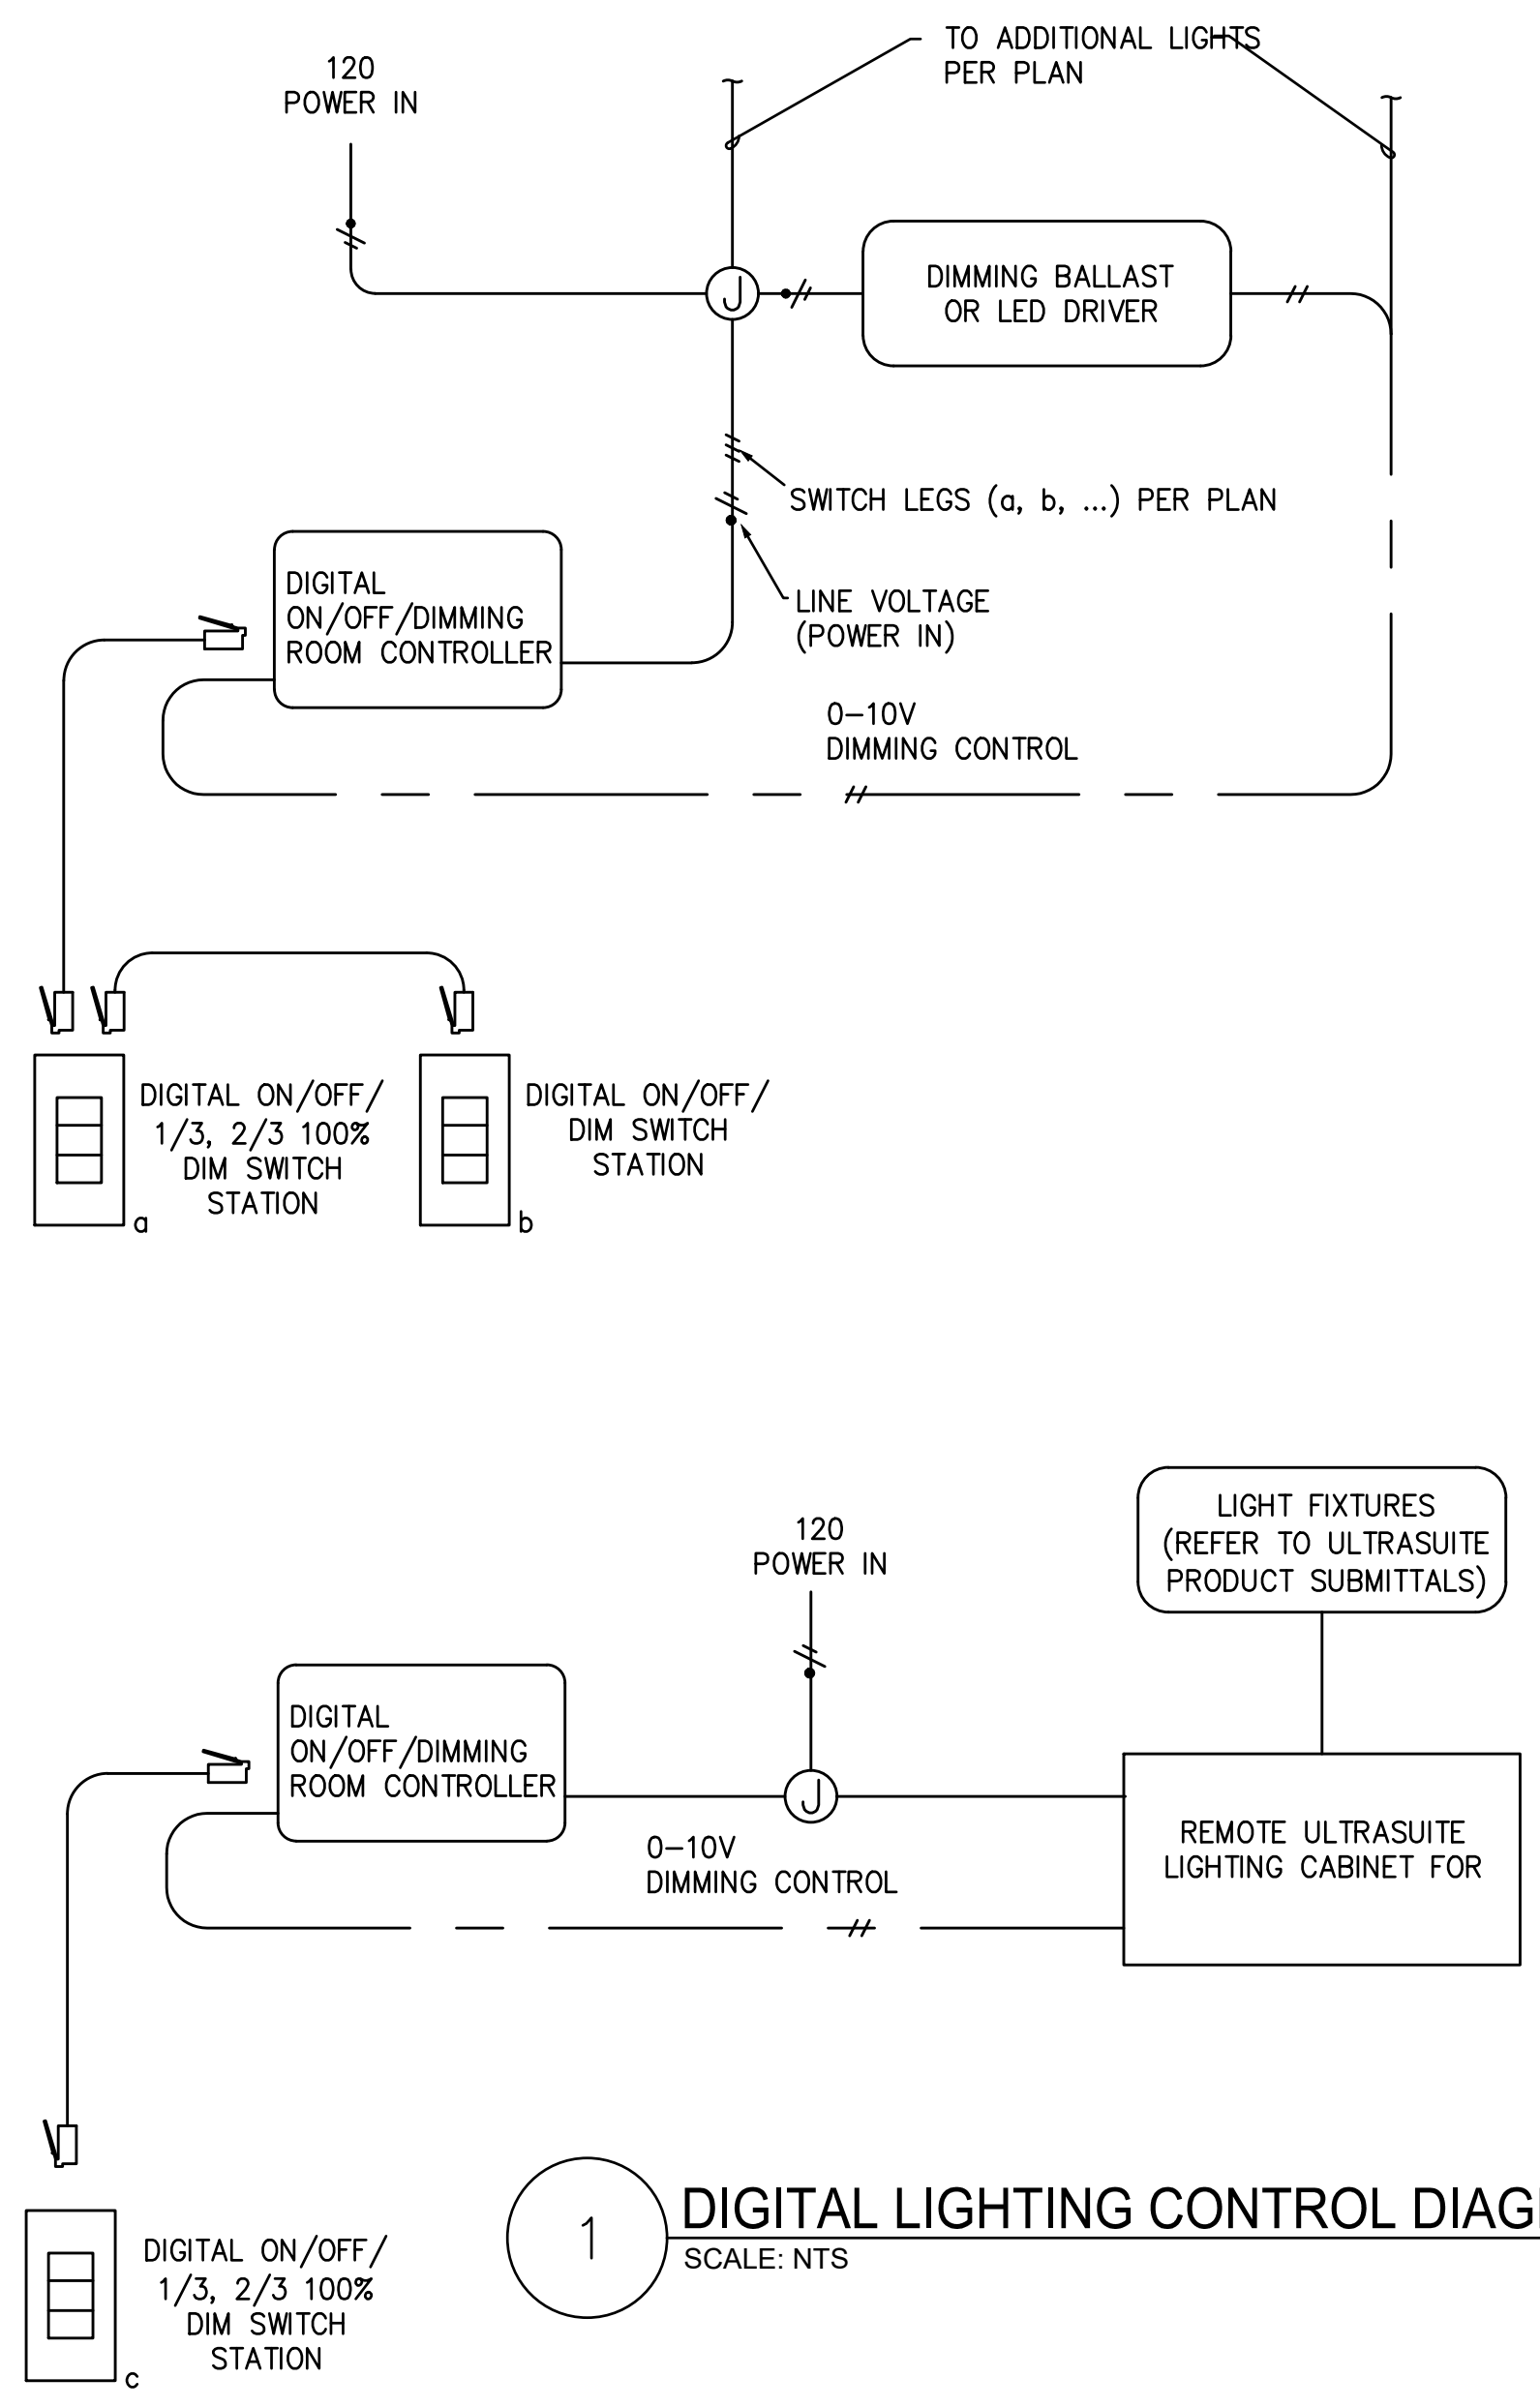

**1 DIGITAL LIGHTING CONTROL DIAGRAMS**  
SCALE: NTS





FEEDER SCHEDULE - ABOVE 1000V						
PLAN MARK	CONDUIT SIZE	CONDUCTORS	600V GROUNDED NEUTRAL	600V GROUND	AMPACITY	REMARKS
A		3 #4/0 15kV MV-105	#4/0		315	
B		3 #1/0 15kV MV-105	#1/0		215	
C	6"	3 #750 AL 15kV MV-105	#4/0		490	
D	6"	SPARE				
E	4"	3 #2 15kV MV-105	#2		165	
F	4"	SPARE				
G	6"	SPARE				
H	4"	3 #2 15kV MV-105	#4/0		165	

GENERAL NOTES:


- FEEDER SCHEDULE SHOWS EXISTING INSTALLATION.
- COPPER CONDUCTORS UNLESS NOTED OTHERWISE.
- CONDUIT PATHWAY USED AS GROUND CONDUCTOR UNLESS NOTED OTHERWISE.
- NO. IN FRONT OF PLAN MARK INDICATES NUMBER OF PARALLEL RUNS IF MORE THAN ONE.

GENERAL NOTES:

- CABLE NUMBERS ABY901 THRU ABY934 & ABY955 THRU ABY957 ARE CUSTOMER OWNED.
- PUGET LOCK ON P-4847 POS.1 IS NORMAL OPEN

ONE-LINE RISER LEGEND

- PLAN NOTE
- FEEDER CALLOUT
- CONTINUATION

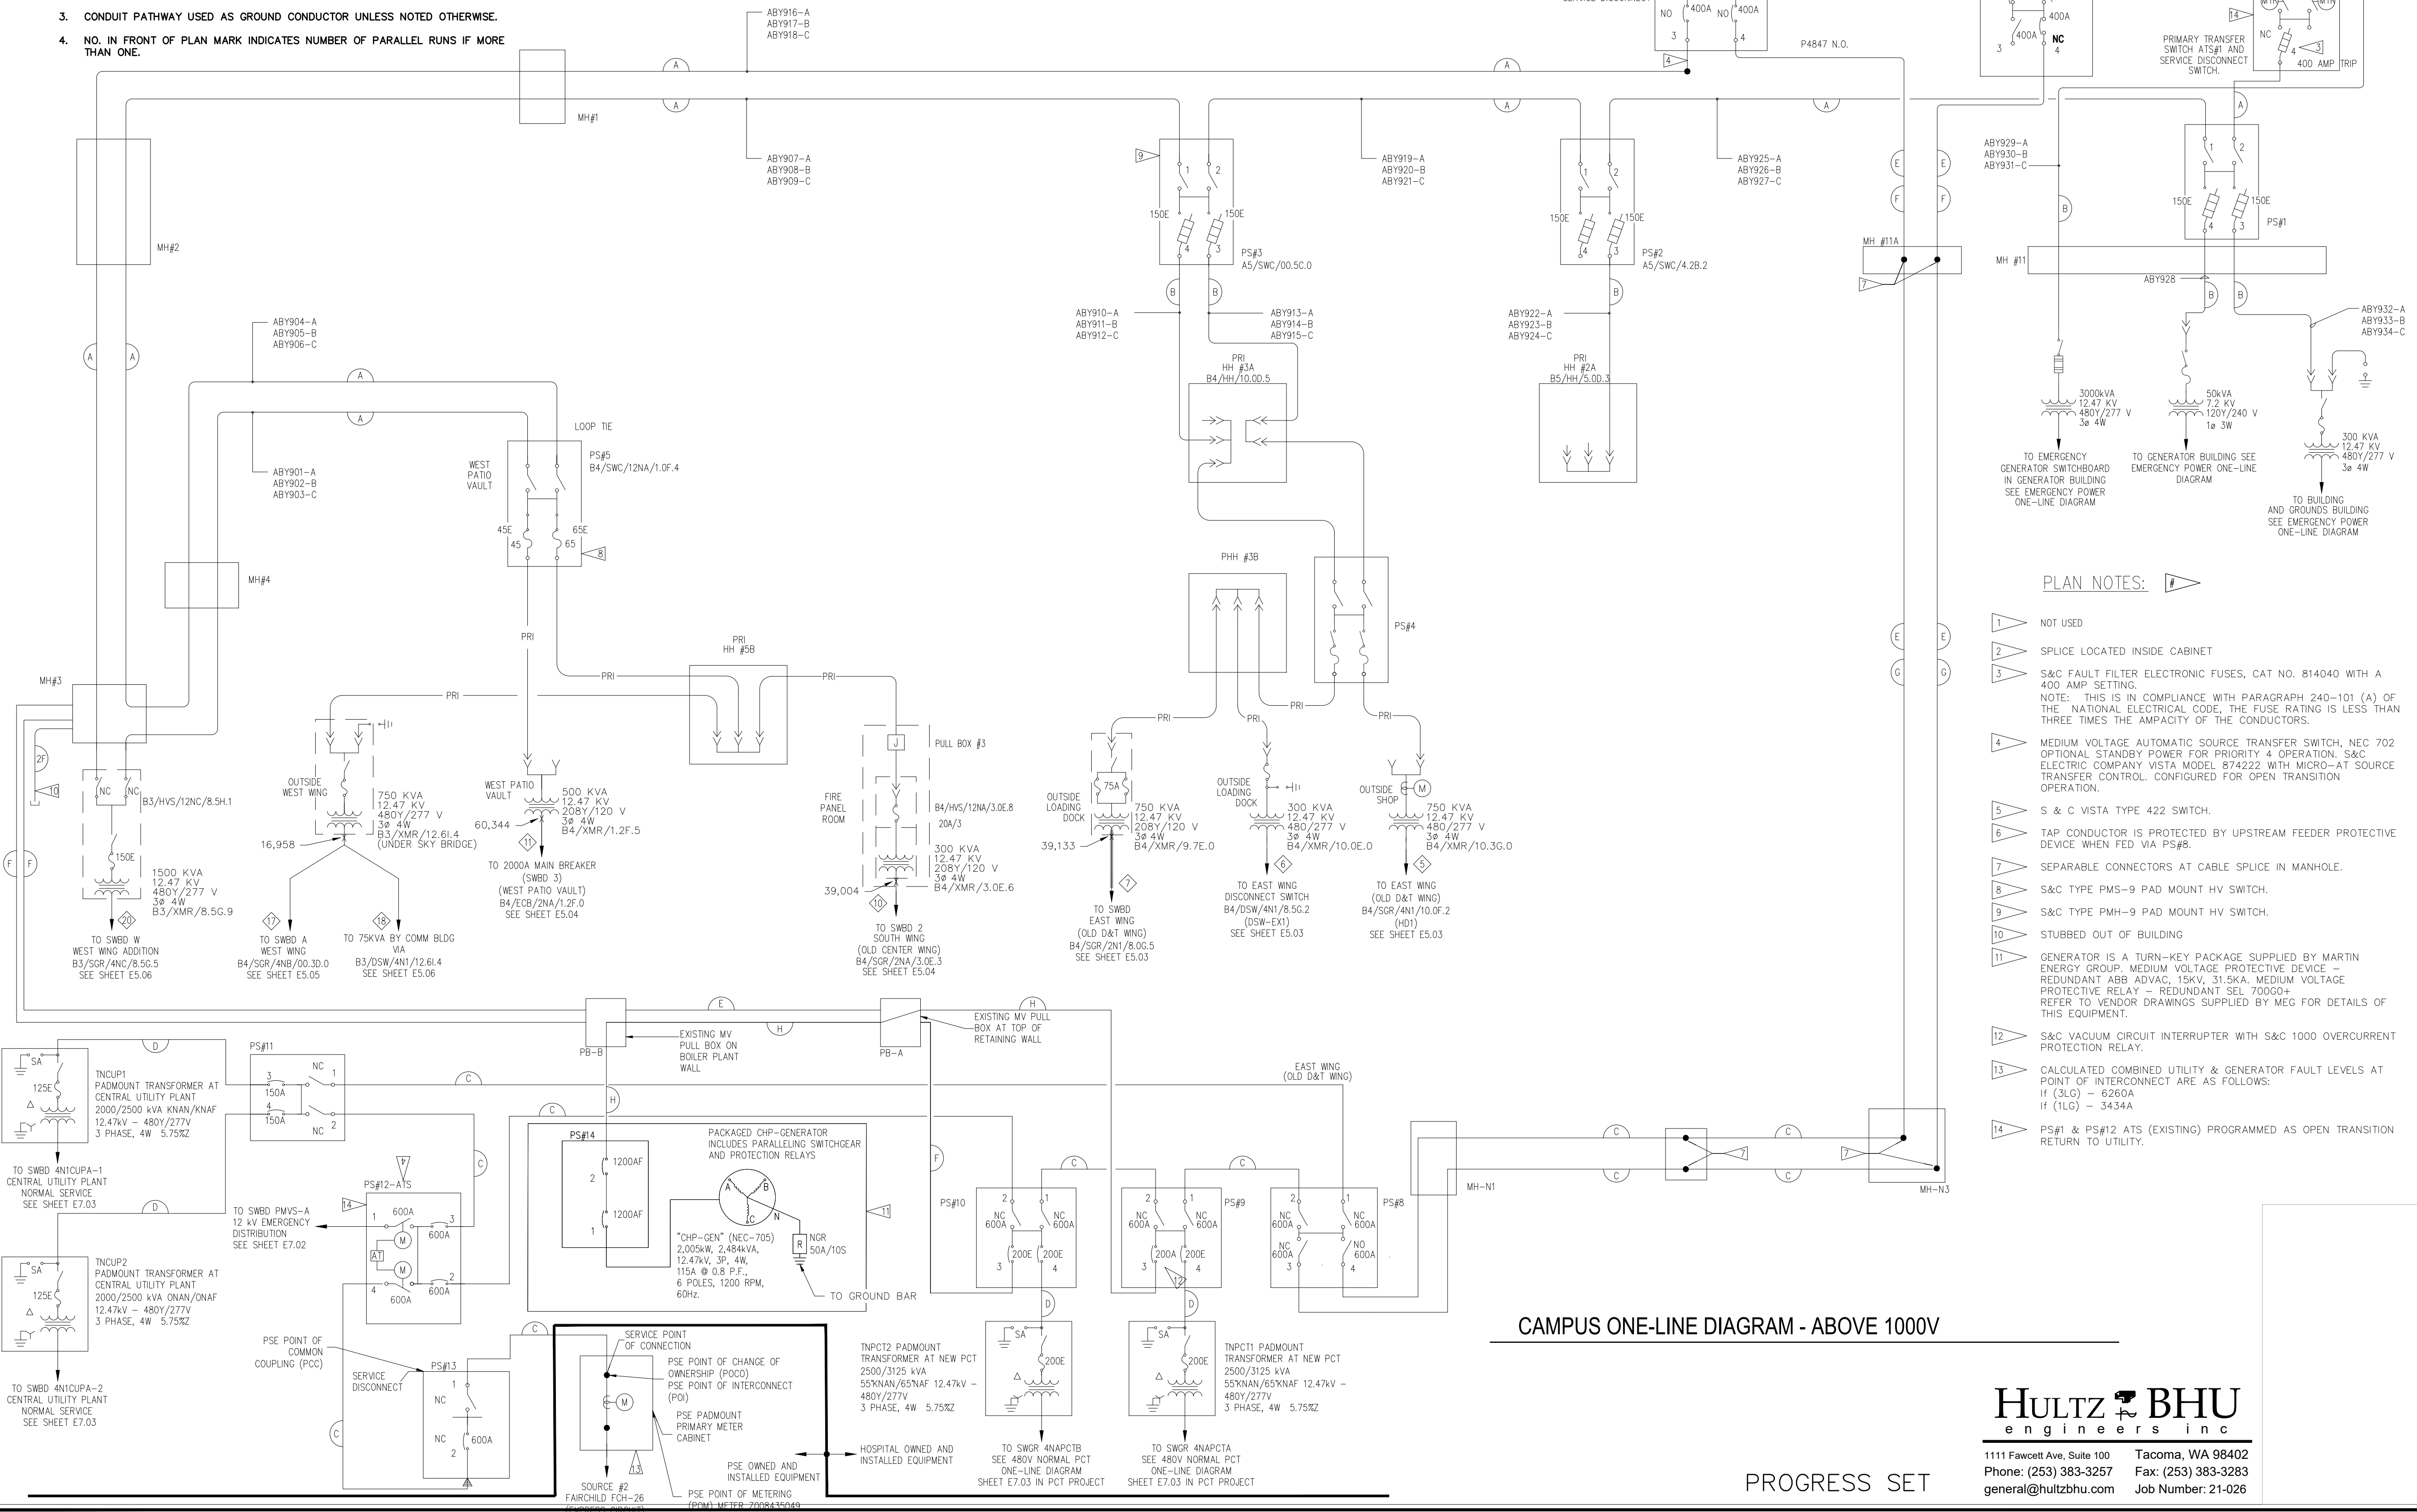

PLAN NOTES:

- NOT USED
- SPLICE LOCATED INSIDE CABINET
- S&C FAULT FILTER ELECTRONIC FUSES, CAT NO. B14040 WITH A 400 AMP SETTING.  
NOTE: THIS IS IN COMPLIANCE WITH PARAGRAPH 240-101 (A) OF THE NATIONAL ELECTRICAL CODE, THE FUSE RATING IS LESS THAN THREE TIMES THE AMPACITY OF THE CONDUCTORS.
- MEDIUM VOLTAGE AUTOMATIC SOURCE TRANSFER SWITCH, NEC 702 OPTIONAL STANDBY POWER FOR PRIORITY 4 OPERATION. S&C ELECTRIC COMPANY VISTA MODEL B74222 WITH MICRO-AT SOURCE TRANSFER CONTROL. CONFIGURED FOR OPEN TRANSITION OPERATION.
- S & C VISTA TYPE 422 SWITCH.
- TAP CONDUCTOR IS PROTECTED BY UPSTREAM FEEDER PROTECTIVE DEVICE WHEN FED VIA PS#8.
- SEPARABLE CONNECTORS AT CABLE SPLICE IN MANHOLE.
- S&C TYPE PMS-9 PAD MOUNT HV SWITCH.
- S&C TYPE PMH-9 PAD MOUNT HV SWITCH.
- STUBBED OUT OF BUILDING
- GENERATOR IS A TURN-KEY PACKAGE SUPPLIED BY MARTIN ENERGY GROUP. MEDIUM VOLTAGE PROTECTIVE DEVICE - REDUNDANT ABB ADVAC. 15KV, 31.5KA. MEDIUM VOLTAGE PROTECTIVE RELAY - REDUNDANT SEL 700G0+ REFER TO VENDOR DRAWINGS SUPPLIED BY MEG FOR DETAILS OF THIS EQUIPMENT.
- S&C VACUUM CIRCUIT INTERRUPTER WITH S&C 1000 OVERCURRENT PROTECTION RELAY.
- CALCULATED COMBINED UTILITY & GENERATOR FAULT LEVELS AT POINT OF INTERCONNECT ARE AS FOLLOWS:  
IF (3LG) - 6280A  
IF (1LG) - 3434A
- PS#1 & PS#12 ATS (EXISTING) PROGRAMMED AS OPEN TRANSITION RETURN TO UTILITY.

CAMPUS ONE-LINE DIAGRAM - ABOVE 1000V

**HULTZ & BHU**  
engineers inc

1111 Fawcett Ave, Suite 100 Tacoma, WA 98402  
Phone: (253) 383-3257 Fax: (253) 383-3283  
general@hultzbhu.com Job Number: 21-026

PROGRESS SET

**InSight**  
HealthCare Architecture  
Klanglois@InSightDesignStudio.biz  
12345 Lake City Way NE #2108  
Seattle, WA 98125  
206.601.6645

SIGNED  
02 APRIL 2021

OWNER:  
**MultiCare**  
Tacoma General Hospital

PROJECT NAME:  
**OR 7&8**  
Buildout

Good Samaritan  
Hospital  
401 15th Ave SE  
Puyallup, WA 98372

MARK	DATE	DESCRIPTION
	3/19/2021	DESIGN DEVELOPMENT
	4/2/2021	PERMIT SET

PROJECT NO. **31232**

DRAWN BY:

DATE: **2 APRIL 2021**  
COPYRIGHT TO:  
InSight Healthcare Architecture

SHEET TITLE:  
**CAMPUS ONE-LINE DIAGRAM - ABOVE 1000V**

SHEET #:  
**E5.00**


Apr 02, 2021 - 11:55am PLOTTED BY: NeilH  
DWG PATH: t:\2021\_pos\21-026\Kco\Elec\21-028 E701 ONE-LINE RISER DIAGRAMS.dwg  
DNC PATH:

City of Puyallup  
Development & Permitting Services  
**ISSUED PERMIT**

Building Planning  
Engineering Public Works  
Fire Traffic

**InSight HealthCare Architecture**  
KLanglois@InSightDesignStudio.biz  
12345 Lake City Way NE #2108  
Seattle, WA 98125  
206.601.6645

**SIGNED**  
02 APRIL 2021

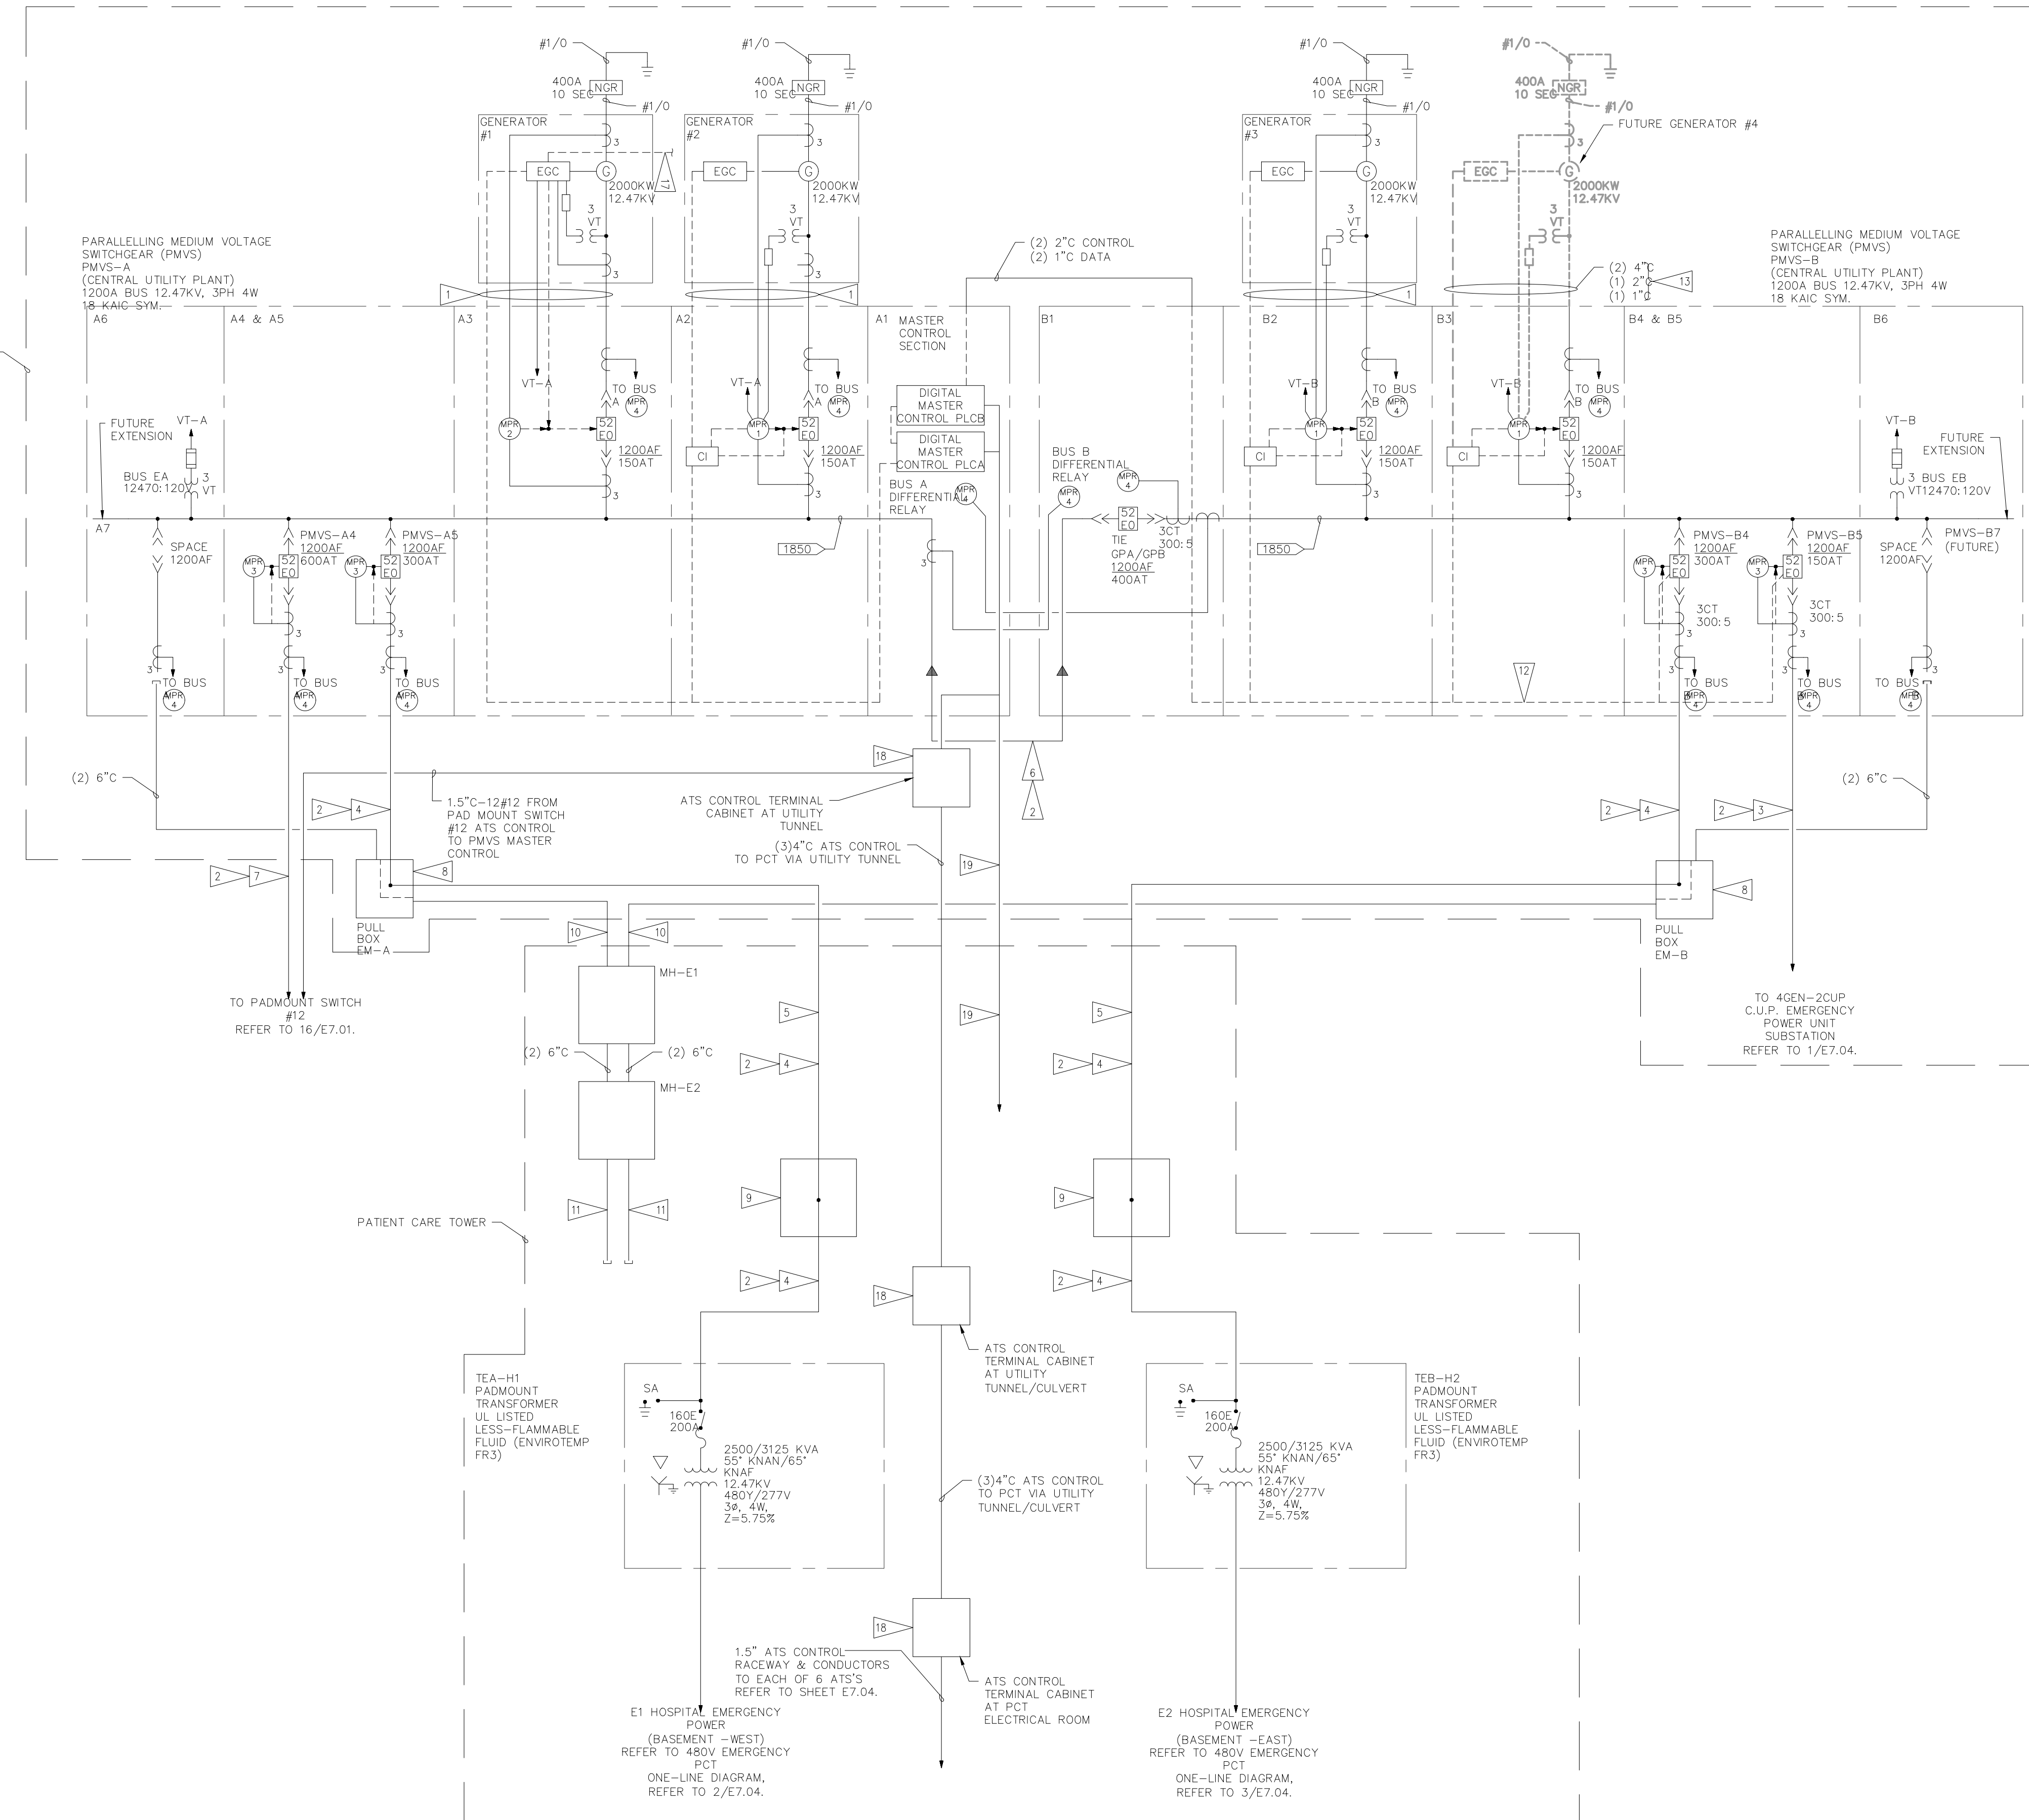

- PLAN NOTES:**
- 1 (1) 4" C-3#2 CU 15KV MV-105, 1#2 CU 600V XHHW GROUND (POWER) (1) 4" C SPARE, (1) 2" C FOR CONTROL, (1) 1" C FOR DATA ROUTED WITH GENERATOR POWER FEEDER.
  - 2 SPARE RACEWAY SAME SIZE AS FOR FEEDER, ROUTED WITH THE FEEDER RACEWAY.
  - 3 (1) 4" C-3#2 CU 15KV MV-105, 1#2 CU 600V XHHW GROUND.
  - 4 (1) 6" C-3#4/0 AL 15KV MV-105, 1#4/0 CU 600V XHHW GROUND.
  - 5 FEEDER ROUTED FROM CUP SWITCHGEAR TO PATIENT CARE TOWER VIA UTILITY TUNNEL.
  - 6 SWITCHGEAR TIE FEEDER, (1) 6" C-3#350 KCMIL AL 15KV MV-105, 1#350 KCMIL AL 600V XHHW GROUND, (1) 6" C SPARE.
  - 7 EMERGENCY TO NORMAL FEEDER FOR OPTIONAL SERVICE TO SOUTH 12.47KV NORMAL POWER SYSTEM, (1) 6" C-3#750 KCMIL AL 15KV MV-105, 1#4/0 CU 600V XHHW GROUND.
  - 8 PULL BOX 72"H X 80"W 18"D NEMA 3 WITH HINGED COVERS FOR FEEDER IN UTILITY TUNNEL AT CENTRAL PLANT. BARRIERS IN PULLBOX SEPARATE THE CIRCUITS.
  - 9 PULL BOX FOR 12470 VOLT EMERGENCY FEEDERS TO PCT TRANSFORMERS. PULLBOX LOCATED IN UTILITY TUNNEL AT TUNNEL/CULVERT SWITCH VAULT AREA.
  - 10 (2) 6" C TO SITE VIA UTILITY TUNNEL FOR FUTURE PHASES 12.47KV EMERGENCY POWER SERVICE.
  - 11 (2) 6" C RUN EAST TO NEAR MH-N3 FOR EXTENSION TO FUTURE PHASES 12.47KV EMERGENCY POWER SERVICE.
  - 12 GENERATOR SWITCHGEAR SECTION WITH INTERCONNECTING WIRING, TERMINALS AND CONNECTIONS READY FOR FUTURE GENERATOR OPERATION.
  - 13 CONDUITS TO 5 FEET OUTSIDE NORTH BUILDING FOUNDATION AND CAPPED FOR FUTURE USE.
  - 14 NOT USED.
  - 15 NOT USED.
  - 16 NOT USED.
  - 17 PERMISSIVE PARALLELING EXTENDED TO EACH EGG.
  - 18 TERMINAL CABINET 36"H X 48"W X 12"D NEMA 3 WITH HINGED COVER.
  - 19 1" ATS CONTROL RACEWAY AND CONDUCTORS VIA UTILITY TUNNEL/CULVERT TO EACH OF 2 FIRE PUM ATS/CONTROLLERS. REFER TO SHEET 4E7.04.

**DALLY TOWER - EMERGENCY ONE-LINE DIAGRAM - ABOVE 1000V**

PLOTTED BY: Neilcy  
 DATE: Apr 02, 2021 - 11:55am  
 FILE: I:\2021\_pos\21-026\_Voco\Elec\21-028 E7.01 ONE-LINE RISER DIAGRAMS.dwg  
 DWG PATH:

OWNER:

**MultiCare Tacoma General Hospital**

PROJECT NAME:  
**OR 7&8 Buildout**

Good Samaritan Hospital  
401 15th Ave SE  
Puyallup, WA 98372

MARK	DATE	DESCRIPTION
	3/19/2021	DESIGN DEVELOPMENT
	4/2/2021	PERMIT SET

PROJECT NO. 31232

DRAWN BY:

DATE: 2 APRIL 2021  
COPYRIGHT TO:  
InSight Healthcare Architecture

SHEET TITLE:  
**DALLY TOWER - EMERGENCY ONE-LINE DIAGRAM - ABOVE 1000V**

SHEET #:  
**E7.02**

**HULTZ BHU**  
engineers inc

1111 Fawcett Ave, Suite 100 Tacoma, WA 98402  
Phone: (253) 383-3257 Fax: (253) 383-3283  
general@hultzbhu.com Job Number: 21-026

PROGRESS SET



City of Puyallup  
Development & Permitting Services  
**ISSUED PERMIT**

Building Planning  
Engineering Public Works  
Fire Traffic

**InSight**  
HealthCare Architecture  
KLanglois@InSightDesignStudio.biz  
12345 Lake City Way NE #2108  
Seattle, WA 98125  
206.601.6645

**SIGNED**  
02 APRIL 2021

OWNER:  
**MultiCare Tacoma General Hospital**

PROJECT NAME:  
**OR 7&8 Buildout**

Good Samaritan  
Hospital  
401 15th Ave SE  
Puyallup, WA 98372

MARK	DATE	DESCRIPTION
	3/19/2021	DESIGN DEVELOPMENT
	4/2/2021	PERMIT SET

PROJECT NO. 31232

DRAWN BY:

DATE: 2 APRIL 2021  
COPYRIGHT TO:  
InSight Healthcare Architecture

SHEET TITLE:  
**DALLY TOWER -  
NORMAL ONE-LINE  
DIAGRAM - 1000V  
OR LESS**

SHEET #:  
**E7.03**


FEEDER SCHEDULE

FEEDER NO.	CONDUIT	COPPER CONDUCTORS		AMPACITY
		CONDUCTORS	WIRE	
A3	1"	3#4	+#8 G	85
A4	1.25"	4#4	+#8 G	85
B3	1.25"	3#2	+#8 G	115
B4	1.25"	4#2	+#8 G	115
G3	1.5"	3#1	+#6 G	130
C4	1.5"	4#1	+#1 G	130
C5	2"	3#1	+2#1/0 N + #6 G	130
J5	2"	3#1/0	+#1/0 N + #4 G	230

FEEDER SCHEDULE

FEEDER NO.	ALUMINUM CONDUIT	CONDUCTORS		AMPACITY
		CONDUCTORS	WIRE	
D3	1.5"	3#1/0	+#6 G	120
D4	1.5"	4#1/0	+#6 G	120
E3	1.5"	3#2/0	+#4 G	135
F3	2"	3#3/0	+#4 G	155
F4	2"	4#3/0	+#4 G	155
G3	2"	3#4/0	+#4 G	180
J3	2.5"	3#300	+#2 G	230
J4	3"	4#300	+#2 G	230
K3	3"	3#350	+#2 G	250
K4	3"	4#350	+#2 G	250
N3	3.5"	3#600	+#1 G	340
2H4	(2) 3"	4#250	+#1 G EA.	410
2K3	(2) 3"	3#350	+#1/0 G EA.	500
2M4	(2) 3.5"	4#500	+#3/0 G EA.	620
3L3	(3) 3"	3#400	+#3/0 G EA.	810
3L4	(3) 3.5"	4#400	+#3/0 G EA.	810
4K4	(4) 3"	4#350	+#4/0 G EA.	1000
4N4	(4) 4"	4#600	+#350 G EA.	1360
5N4	(5) 4"	4#600	+#400 G EA.	1700
6N4	(6) 4"	4#600	+#600 G EA.	2040
8P4	(8) 4"	4#750	+#750 G EA.	3080

PLAN NOTES:  
NOT USED

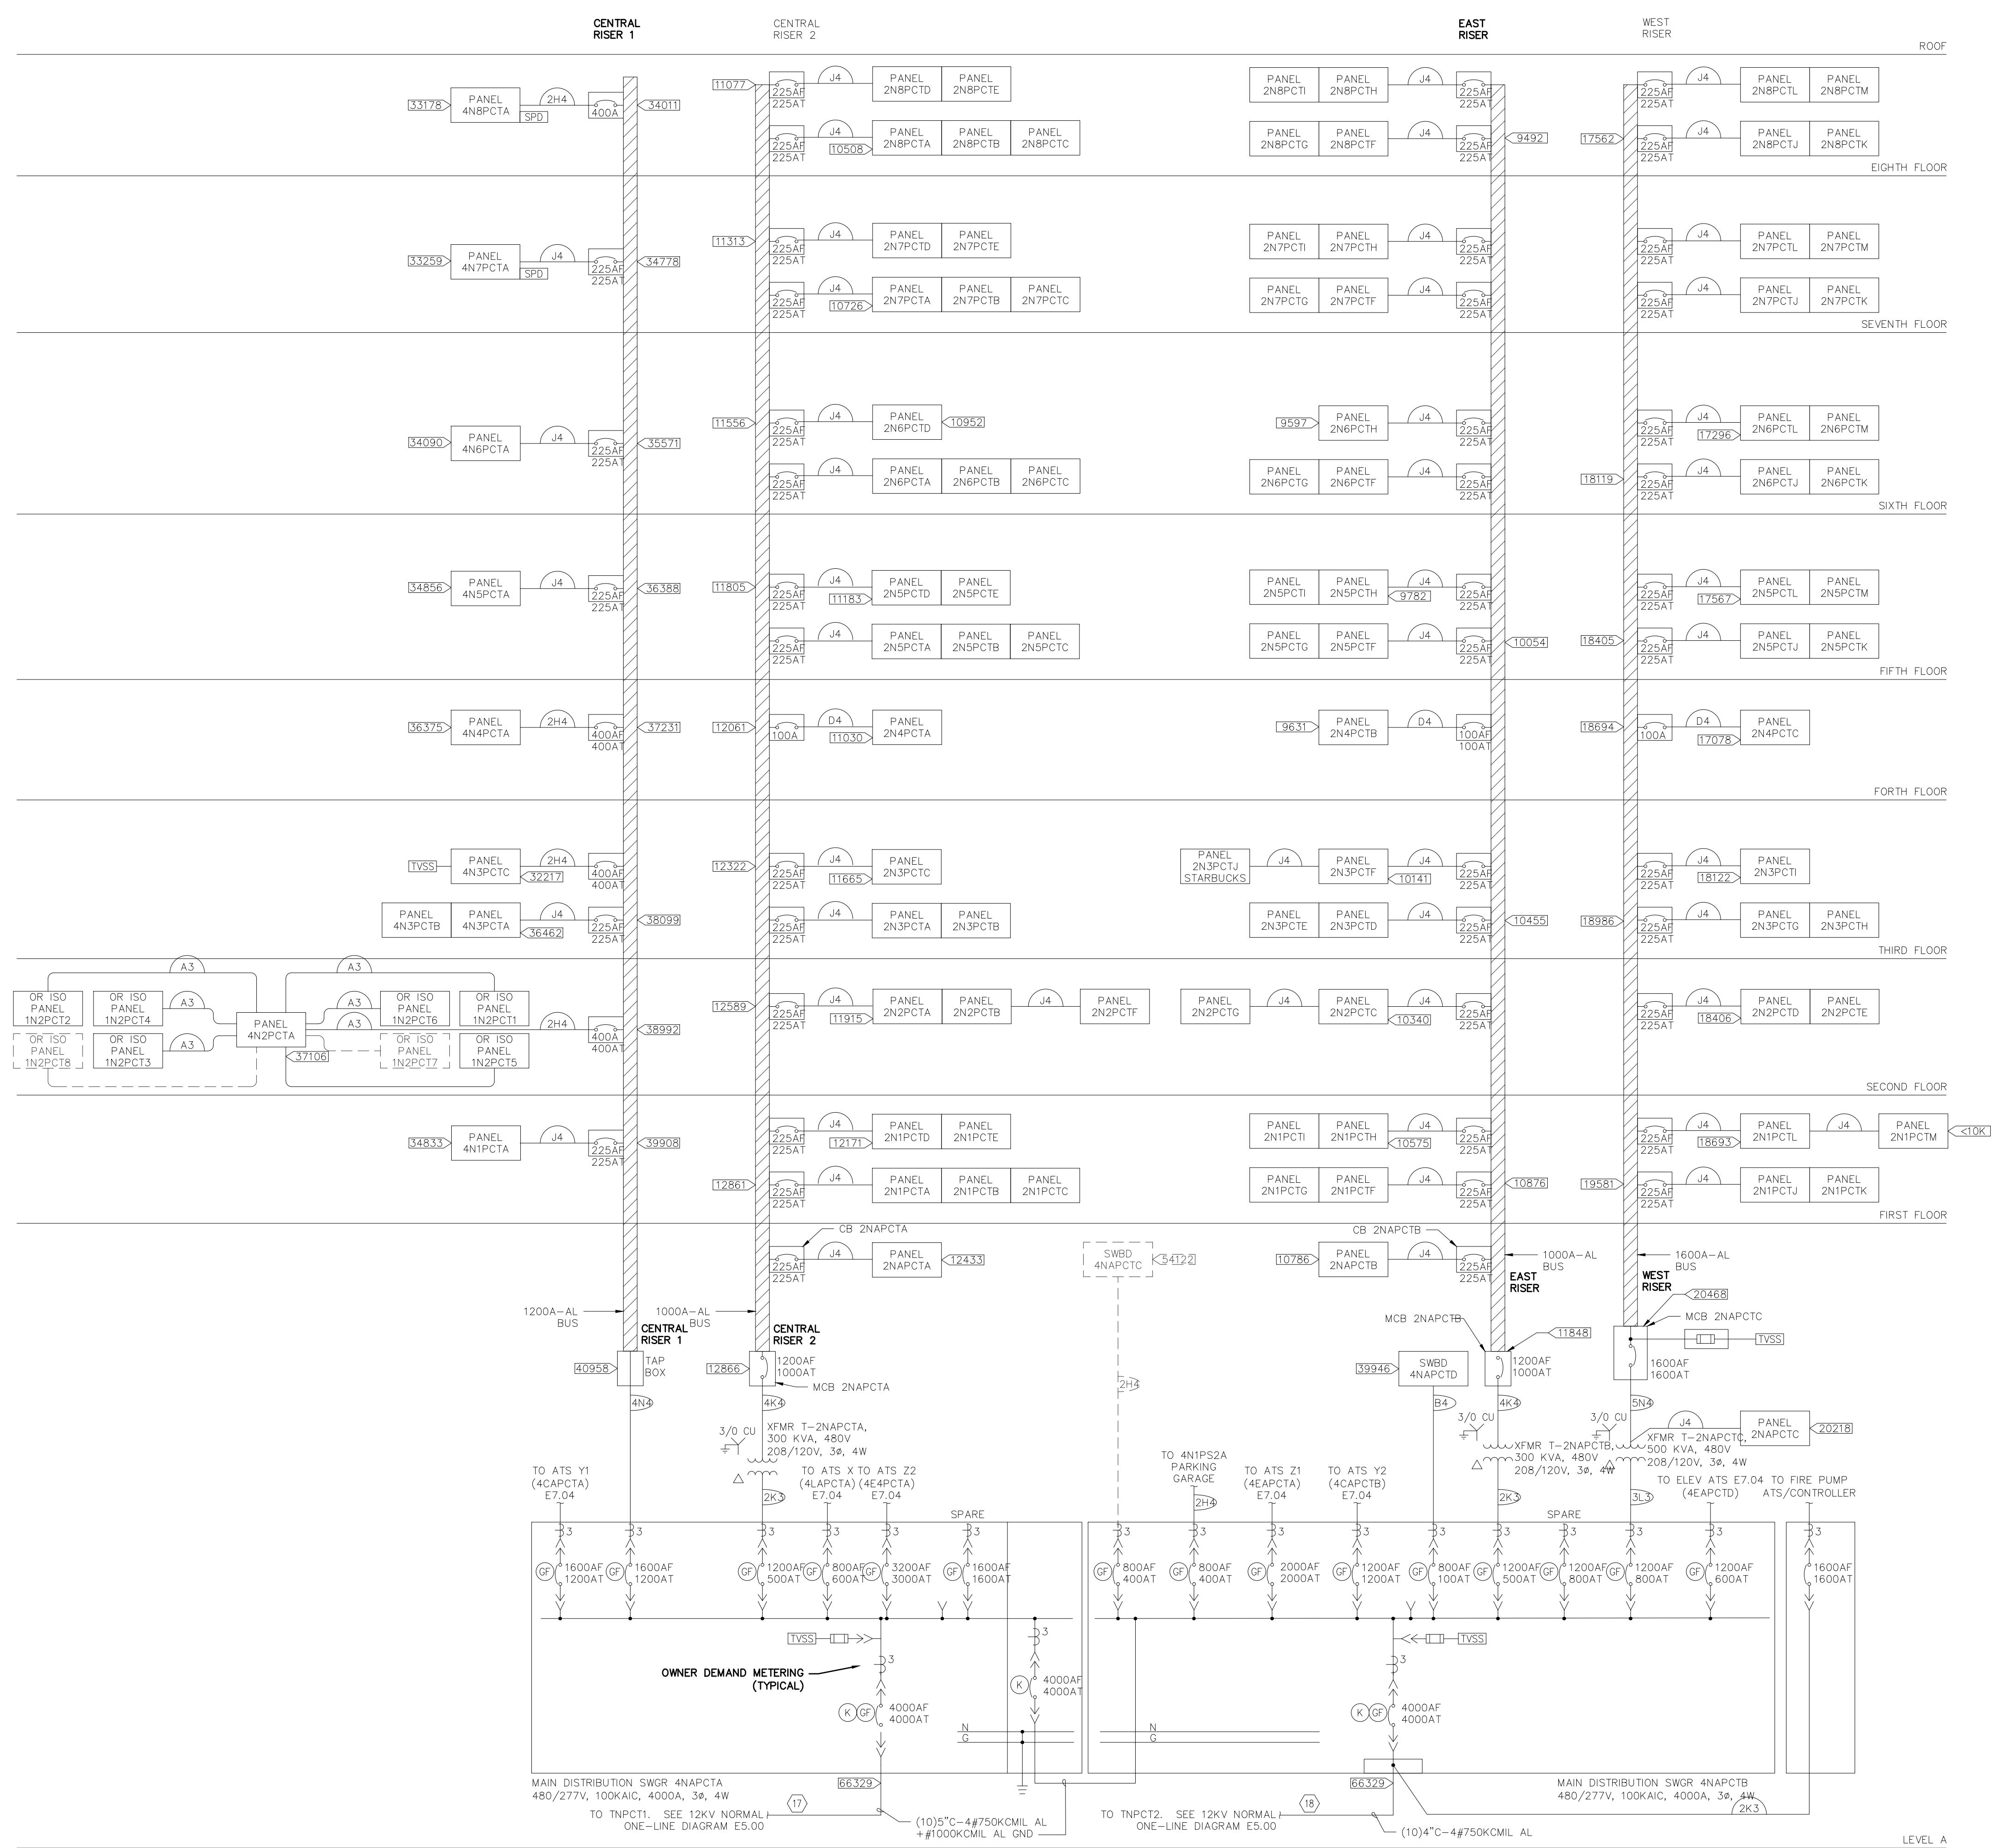


PLOTTED BY: NeilM  
 DATE: Apr 02, 2021 11:55am  
 FILE: t:\2021\_pos\21-026\Acad\Elec\21-028 E7.03 ONE-LINE RISER DIAGRAMS.dwg  
 Dwg Path:  
 Neil

PROGRESS SET



City of Puyallup  
Development & Permitting Services  
**ISSUED PERMIT**

Building Planning  
Engineering Public Works  
Fire Traffic

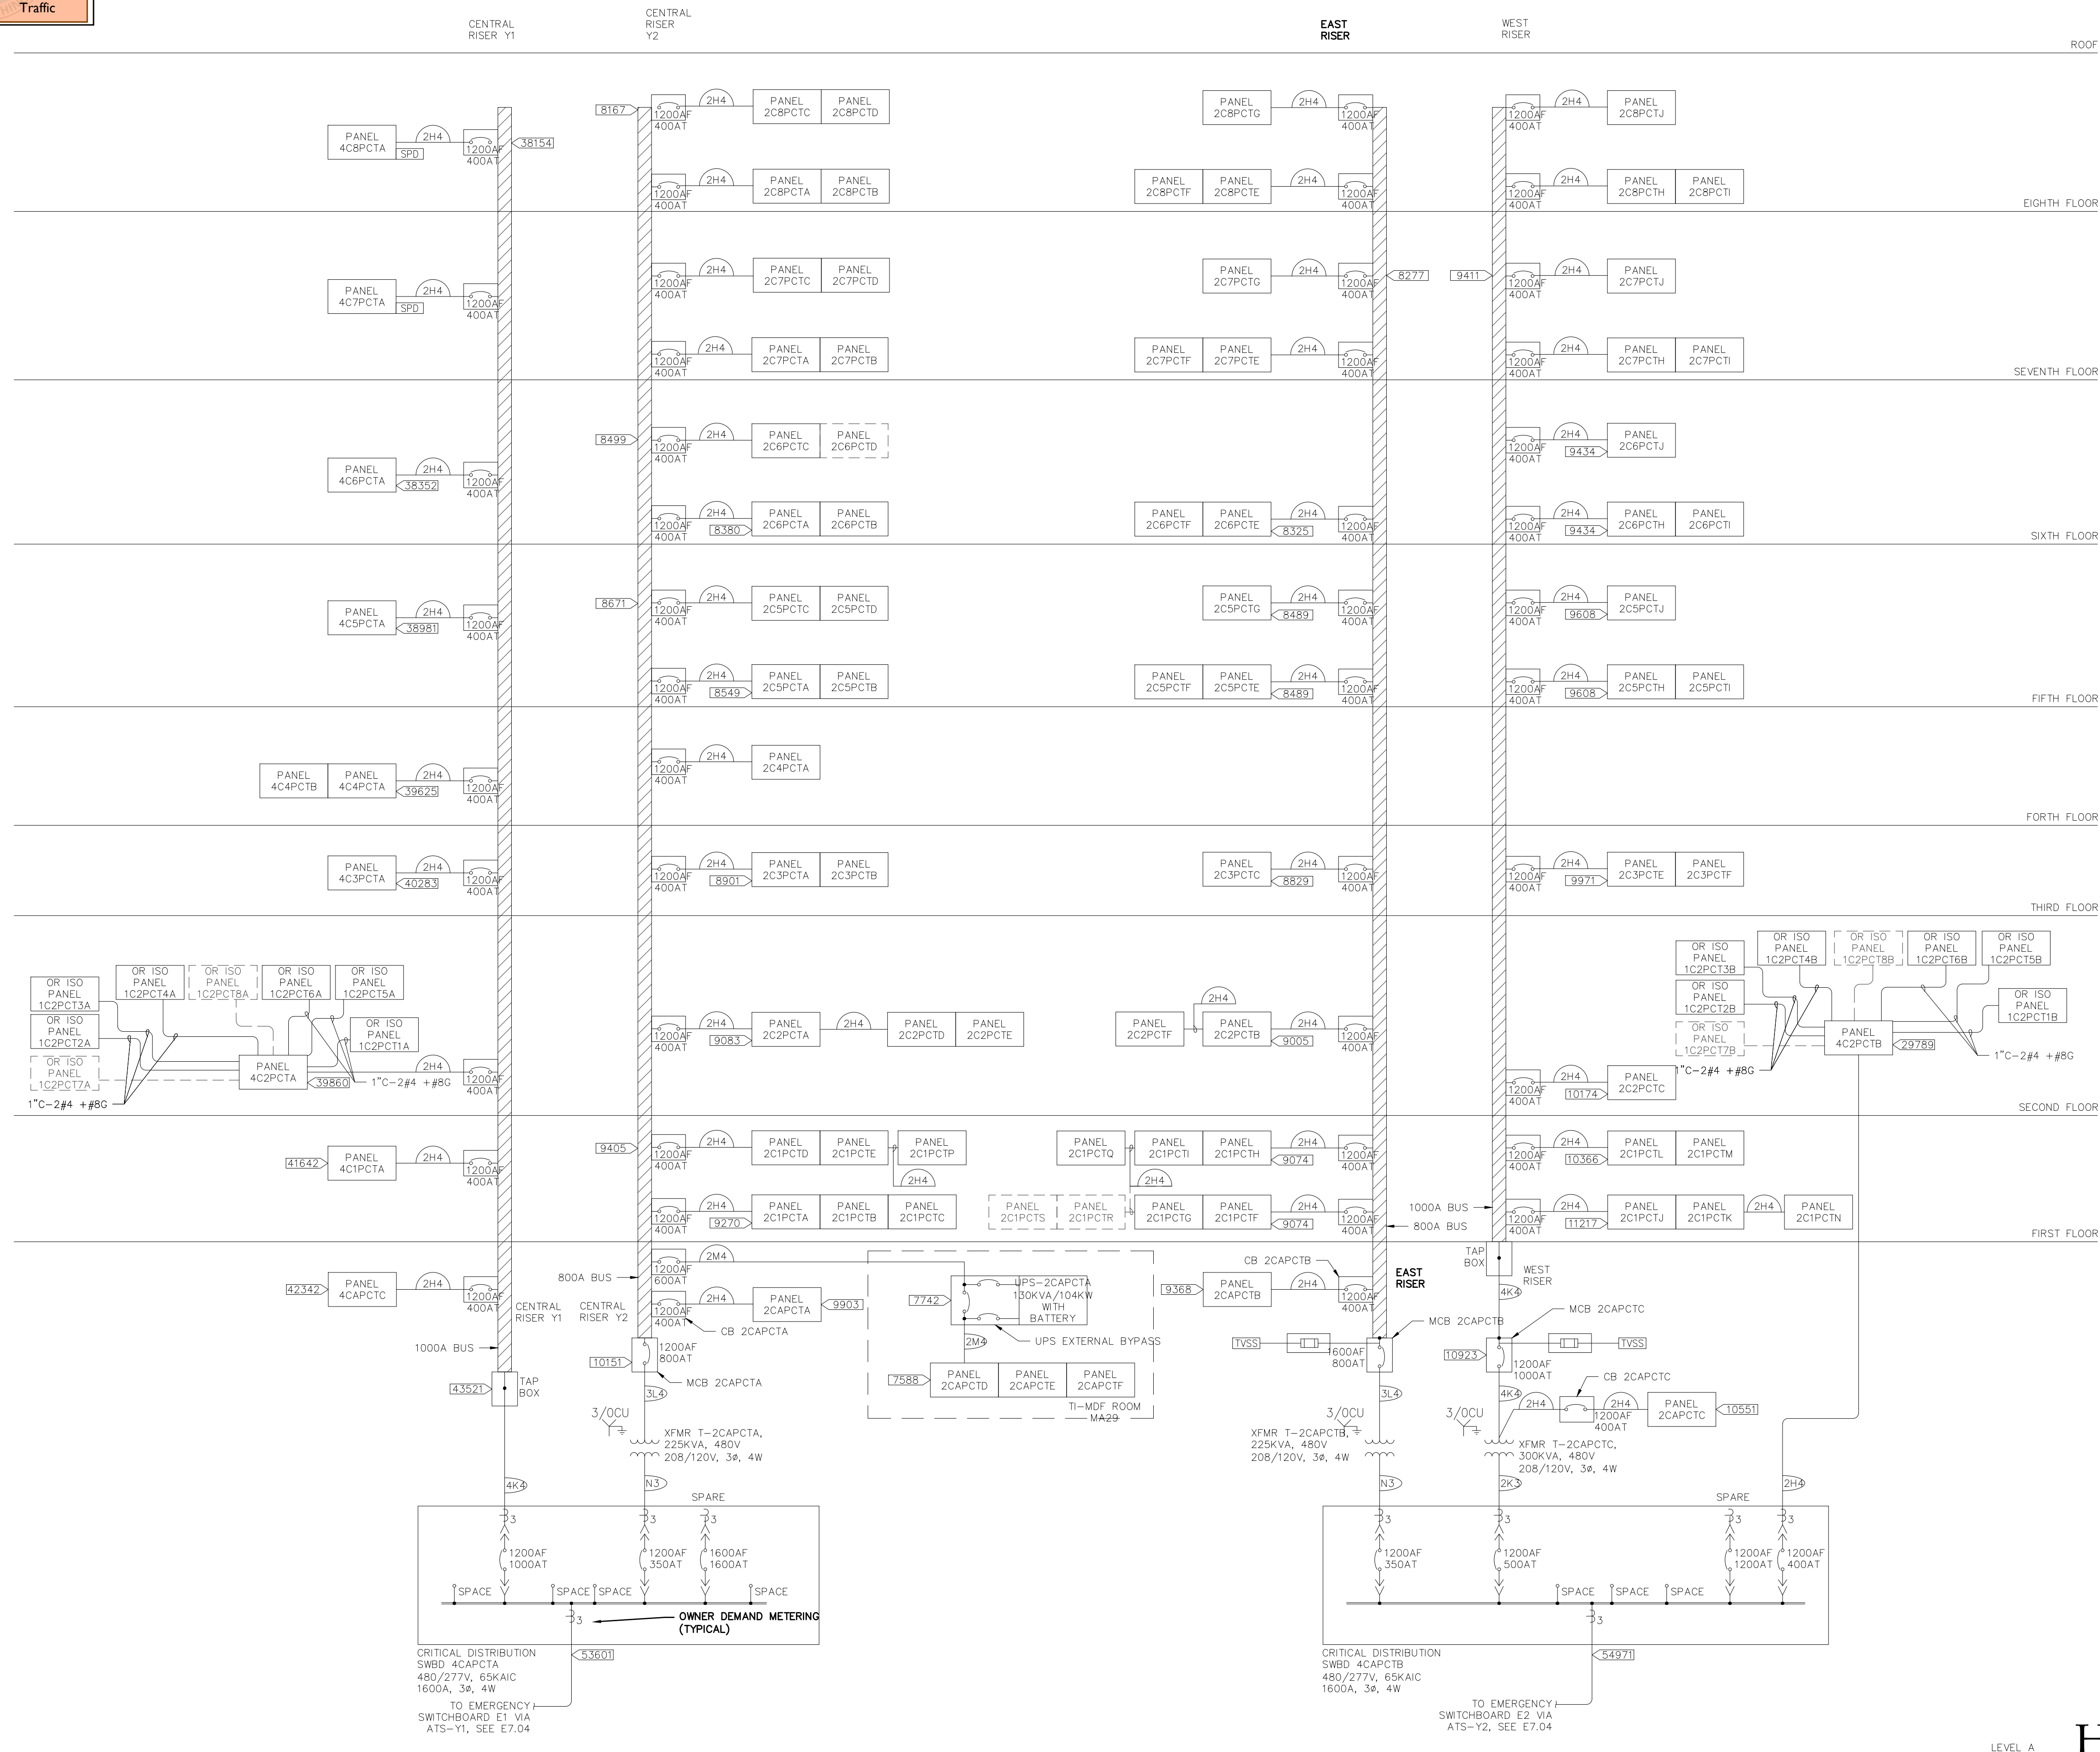

**GENERAL NOTES:**  
REFER TO SHEET E7.03 FOR FEEDER SCHEDULES.

**PLAN NOTES:**  
NOT USED

InSight  
HealthCare Architecture  
KLanglois@InSightDesignStudio.biz  
12345 Lake City Way NE #2108  
Seattle, WA 98125  
206.601.6645

THOMAS URQUHART  
STATE OF WASHINGTON  
REGISTERED PROFESSIONAL ENGINEER  
SIGNED  
02 APRIL 2021

OWNER:  
MultiCare Tacoma General Hospital

PROJECT NAME:  
**OR 7&8  
Buildout**

Good Samaritan  
Hospital  
401 15th Ave SE  
Puyallup, WA 98372

MARK	DATE	DESCRIPTION
	3/19/2021	DESIGN DEVELOPMENT
	4/2/2021	PERMIT SET

PROJECT NO. **31232**

DRAWN BY:

DATE: **2 APRIL 2021**  
COPYRIGHT TO:  
InSight Healthcare Architecture

SHEET TITLE:  
**DALLY TOWER -  
CRITICALLY ONE-LINE  
DIAGRAM - 1000V  
OR LESS**

SHEET #:  
**E7.05**


**DALLY TOWER - CRITICALLY ONE-LINE DIAGRAM - 1000V OR LESS**  
REVISED

PROGRESS SET

**HULTZ BHU**  
engineers inc

1111 Fawcett Ave, Suite 100 Tacoma, WA 98402  
Phone: (253) 383-3257 Fax: (253) 383-3283  
general@hultzbhu.com Job Number: 21-026

PLOTTED BY: NeilM  
 PLOTTED: Apr 02, 2021 11:55am  
 FILE: I:\2021\_pos\21-026\_Vaco\Elec\21-028 E7.01 ONE-LINE RISER DIAGRAMS.dwg  
 DWG PATH:

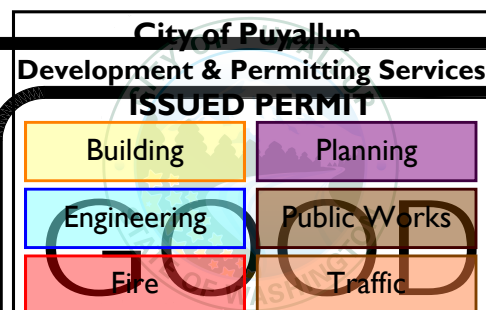

# SAMARITAN HOSPITAL

OR'S #7,8  
-  
1421 3RD ST SE  
PUYALLUP, WA 98372  
DATE: 02MAR21

## DIRECTORY

SALES REP: NATE BAKER 425.478.4290  
NATHAN.BAKER@STRYKER.COM

PROJECT MANAGER: DAN MITCHELL 214.422.2216  
DAN.MITCHELL@STRYKER.COM

ENGINEER: DALE HARDEE 843-727-5389  
DALE.HARDEE@STRYKER.COM

## TABLE OF CONTENTS

REVISION SUMMARY.....(C) SHEET SECTION

EQUIPMENT LAYOUTS ..... (R) SHEET SECTION

PRE-INSTALL NOTES ..... (P) SHEET SECTION

### ENGINEERING APPROVAL


AUTHORIZED SIGNATURE:

DRAWING#: WA-1386840\_3

## APPROVED REVISION: 3

DISCLAIMER: THIS DOCUMENT CONTAINS CONFIDENTIAL AND PROPRIETARY INFORMATION OF STRYKER. NEITHER THIS DOCUMENT NOR THE INFORMATION HEREIN MAY BE REPRODUCED, USED, OR DISCLOSED TO OR FOR THE BENEFIT OF ANY THIRD PARTY WITHOUT THE PRIOR WRITTEN CONSENT OF STRYKER.

571 SILVERON BLVD.  
FLOWER MOUND, TX 75028  
PHONE: (877) 789-8106  
WWW.STRYKER.COM

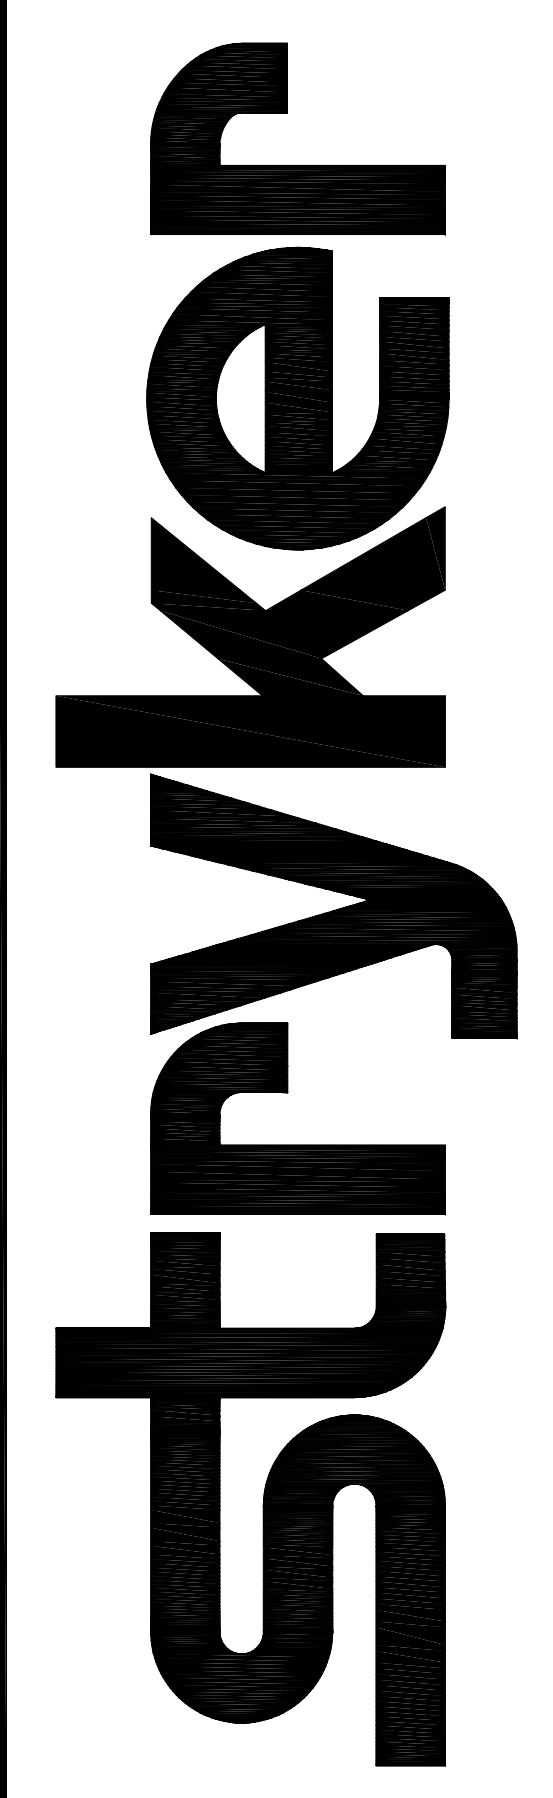

**PRELIMINARY**  
DISCLAIMER: THIS DRAWING IS IN A PRELIMINARY STATUS AND PENDING FINAL APPROVAL. ALL DRAWINGS IN A PRELIMINARY STATUS SHALL NOT BE USED FOR CONSTRUCTION.

REP: NATE BAKER  
PJM: DAN MITCHELL  
SHEET: TITLE

**SUMMARY LIST OF CHANGES**

REV	KEY #	DESCRIPTION OF CHANGE	ROOM #
3	1	ADDED NEW BACKGROUND	OR'S 7,8



571 SILVERON BLVD.  
 FLOWER MOUND, TEXAS 75028  
 PHONE: (817) 789-8106  
 www.stryker.com

REV:	DATE:	DRAWING #:	DRAFTER	IR
3	02MAR21	WA-1386840_3	EMONTGOMERY	1
		REFERENCE #:		
		DRC388824		

**DISCLAIMER**  
 THIS DOCUMENT CONTAINS CONFIDENTIAL AND PROPRIETARY INFORMATION OF STRYKER. NEITHER THIS DOCUMENT NOR THE INFORMATION HEREIN MAY BE REPRODUCED, USED, OR DISCLOSED TO OR FOR THE BENEFIT OF ANY THIRD PARTY WITHOUT THE PRIOR WRITTEN CONSENT OF STRYKER.

**REVISION SUMMARY**

**GOOD SAMARITAN HOSPITAL**  
 OR'S #7,8  
 PUYALLUP, WA 98372

REP: NATE BAKER  
 PM: DAN MITCHELL

SHEET:  
**C-1**

**PRELIMINARY**  
 DISCLAIMER: THIS DRAWING IS IN A PRELIMINARY STATUS AND PENDING FINAL APPROVAL. ALL DRAWINGS IN A PRELIMINARY STATUS SHALL NOT BE USED FOR CONSTRUCTION.


City of Puyallup  
Development & Permitting Services  
**NOT ISSUED PERMIT (OTHERWISE SPECIFIED)**

Building	Planning
Engineering	Public Works
Fire	Traffic

EQUIPMENT SCHEDULE		
KEY ITEM	NAME	QTY
E	S-SERIES SPS-2-C ANESTHESIA BOOM 1000mm TOP ARM 1400mm UDM ARM	1
F	TANDEM TOP S-SERIES SPS-3-T EQUIPMENT BOOM 1300mm TOP ARM BOTTOM UDM/F528/F628 1400mm, 1300mm & 1200mm ARMS	1
H1	CUSTOM CABINET <b>(MOUNTED 6' OFF FLOOR)</b>	1
H2	NURSE DESK	1
J	SWITCHPOINT INFINITY 3	1
K	CHROMOPHARE SK BOX	1
K9	TC UDM JUNCTION BOX	1
K10	UDM JUNCTION BOX	1
L	CHROMOPHARE® SURGICAL LIGHT WALL CONTROL PANEL (RECESSED MOUNT) (LOCATION TBD)	1
M	FLUSH RECTANGULAR CEILING SPEAKER	4
P	55" WALL MONITOR	1
P2	CONNECTED OR TOUCHPANEL	1

CONDUIT SCHEDULE		
CONDUIT RUN ITEM - ITEM	CONDUIT QTY	CONDUIT SIZE
E - J	1	2"
E - J	1	1 1/4"
F - J	2	2"
F - J	2	1 1/4"
K - L	1	1"
K - *	1	1"
K10 - K	2	1"
M - J	1	1 1/4"
P - J	1	1 1/4"
P2 - J	1	1 1/4"

\* - TERMINATE AT CLOSEST ELECTRICAL PANEL

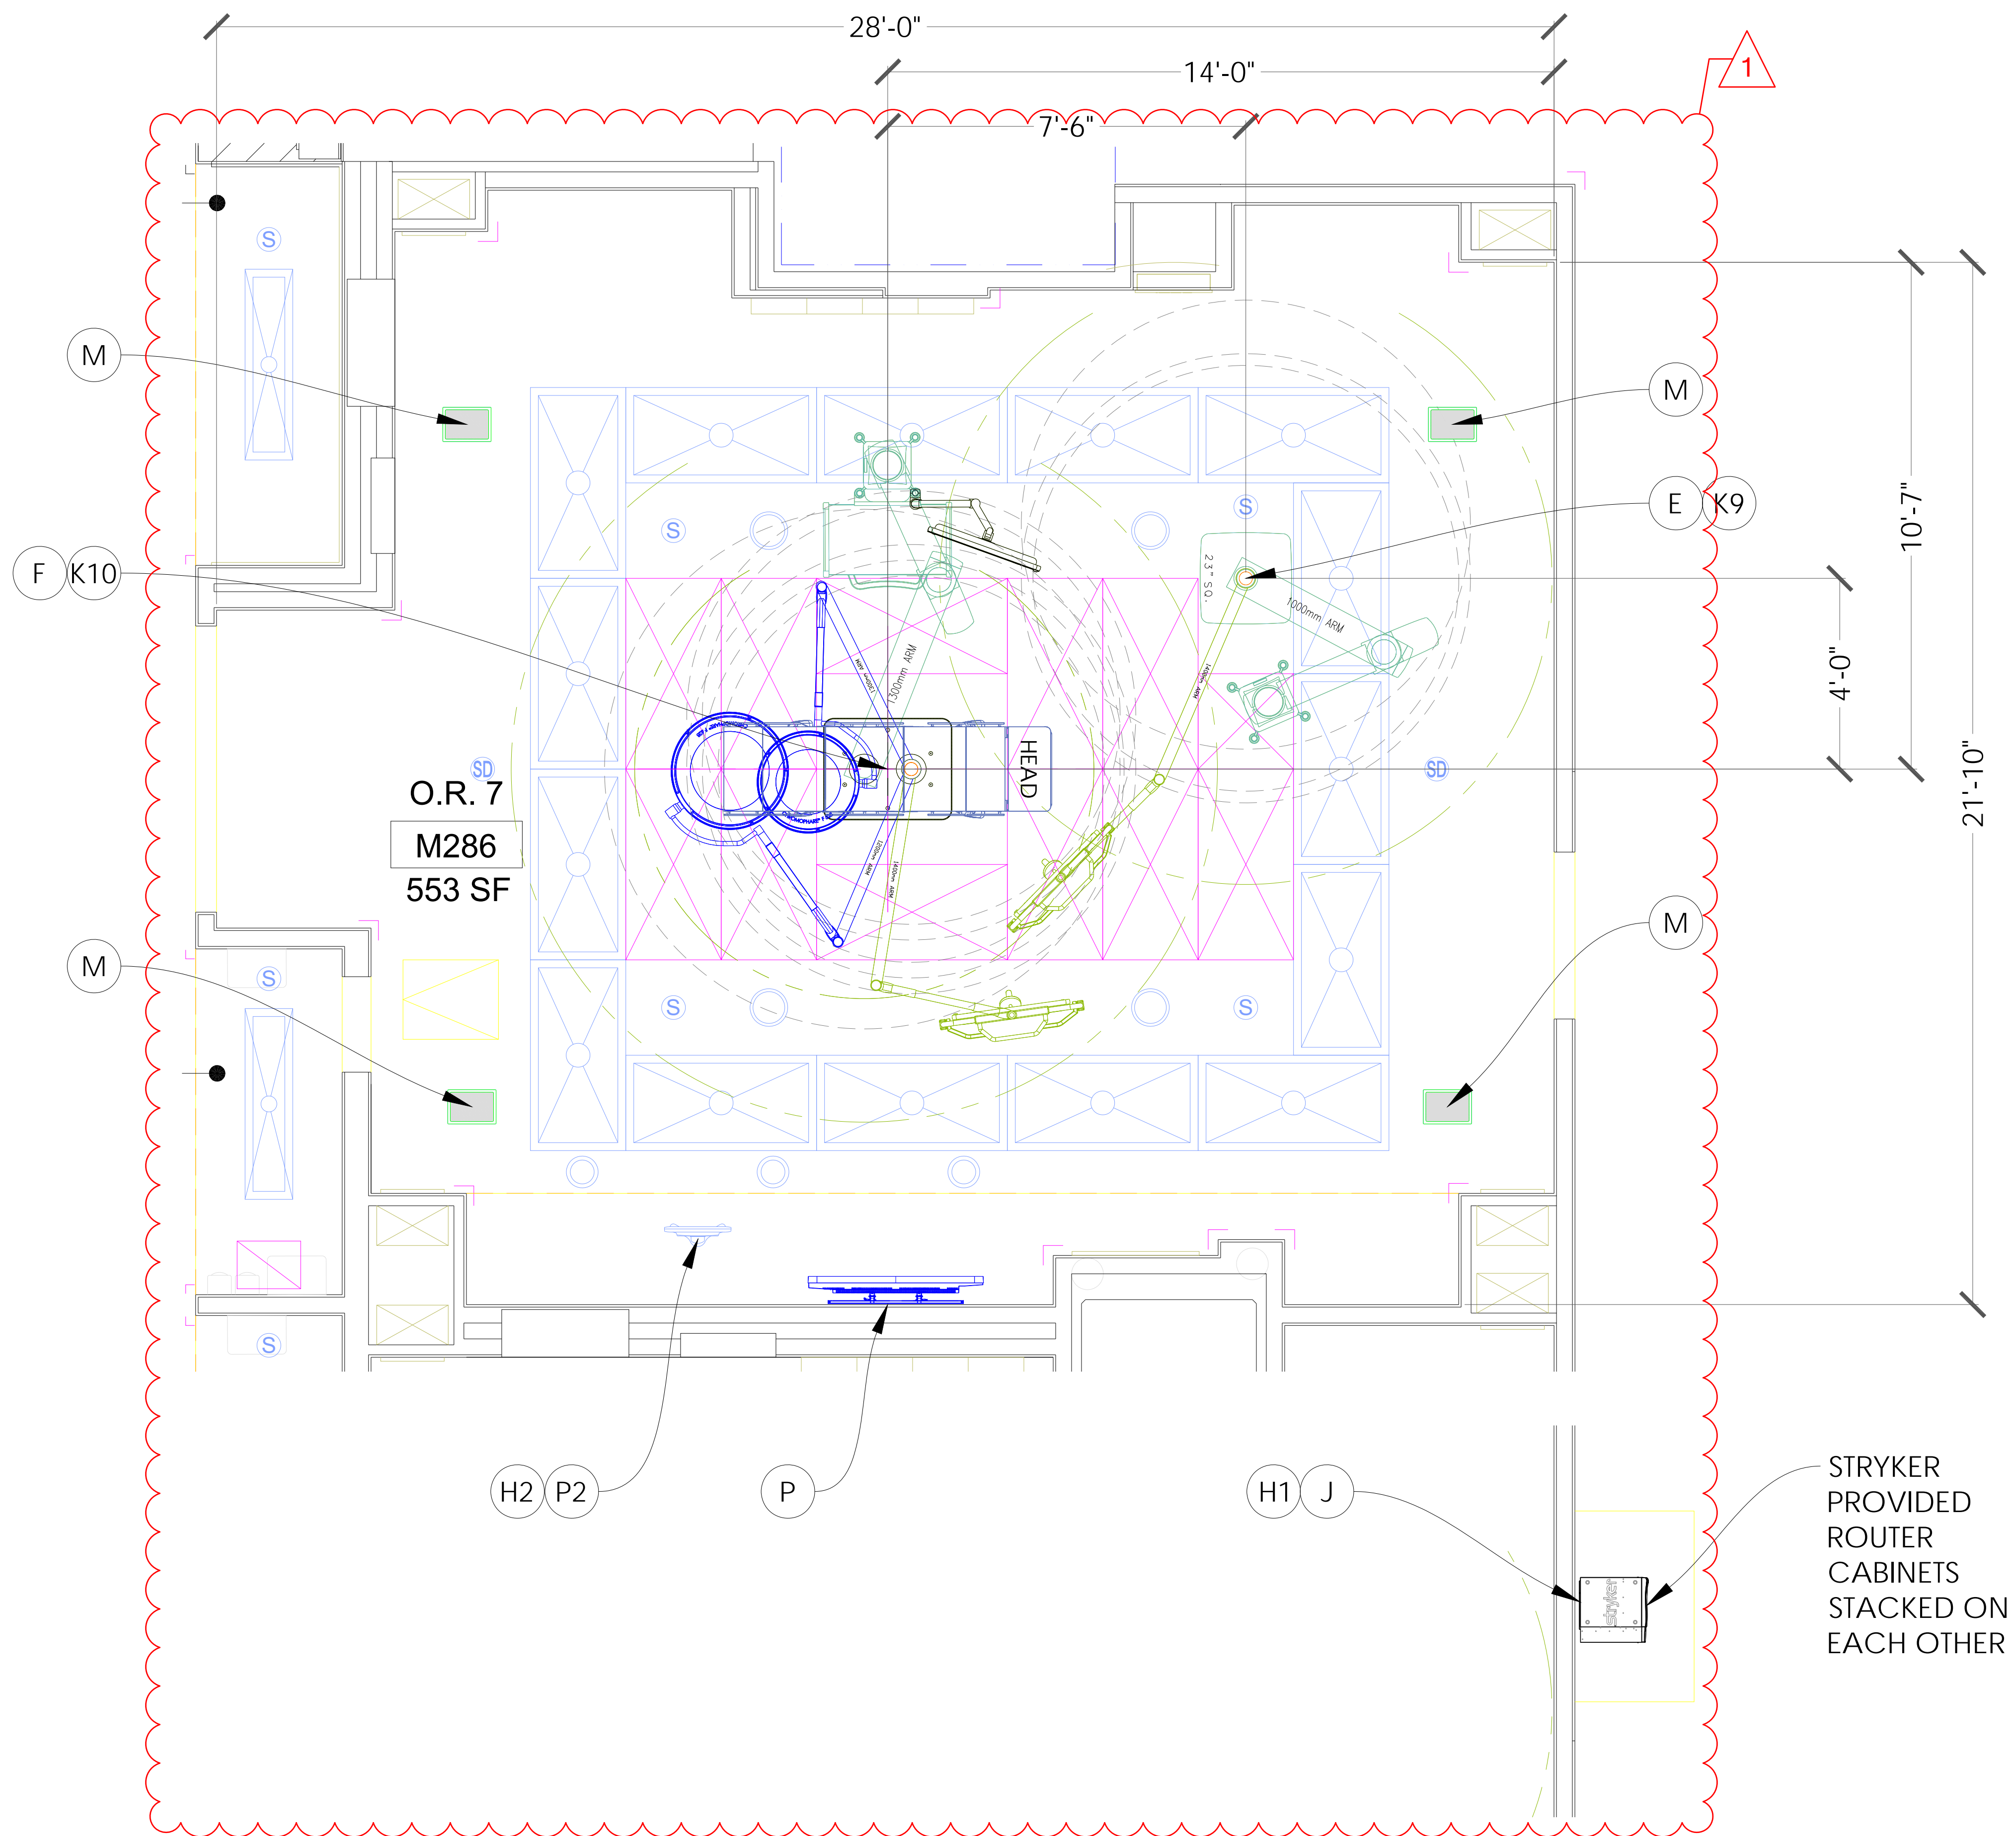

**stryker**

571 SILVERON BLVD.  
FLOWER MOUND, TEXAS 75028  
PHONE: (877) 789-8106  
www.stryker.com

REV: DATE:	DRAWING #:	WA-138840_3	DRAFTER	IR
3	02MAR21	REFERENCE #:	DRC38824	EMONTGOMERY

**DISCLAIMER**  
THIS DOCUMENT CONTAINS CONFIDENTIAL AND PROPRIETARY INFORMATION OF STRYKER. NEITHER THIS DOCUMENT NOR THE INFORMATION HEREIN MAY BE REPRODUCED, USED, OR DISCLOSED TO OR FOR THE BENEFIT OF ANY THIRD PARTY WITHOUT THE PRIOR WRITTEN CONSENT OF STRYKER.

**EQUIPMENT LAYOUT**  
OR 7

GOOD SAMARITAN HOSPITAL  
ORS #7.8  
PUYALLUP, WA 98372

REP: NATE BAKER  
PM: DAN MITCHELL

SHEET:  
**R - OR 7**

**PRELIMINARY**  
DISCLAIMER: THIS DRAWING IS IN A PRELIMINARY STATUS AND PENDING FINAL APPROVAL. ALL DRAWINGS IN A PRELIMINARY STATUS SHALL NOT BE USED FOR CONSTRUCTION.

SCALE: 1/2" = 1'-0"

AUTOCAD DRAWING TEMPLATE | TEM100XX | REV. A

PLOT STAMP: MONTGOMERY, ERIC | DATE: 3/2/2021 10:47 AM


**EQUIPMENT SCHEDULE**

KEY ITEM	NAME	QTY
E	S-SERIES SPS-2-C ANESTHESIA BOOM 1000mm TOP ARM 1400mm UDM ARM	1
F	TANDEM TOP S-SERIES SPS-3-T EQUIPMENT BOOM 1300mm TOP ARM BOTTOM UDM/F528/F628 1400mm, 1300mm & 1200mm ARMS	1
H1	CUSTOM CABINET (MOUNTED 6' OFF FLOOR)	1
H2	NURSE DESK	1
J	SWITCHPOINT INFINITY 3	1
K	CHROMOPHARE SK BOX	1
K9	TC UDM JUNCTION BOX	1
K10	UDM JUNCTION BOX	1
L	CHROMOPHARE® SURGICAL LIGHT WALL CONTROL PANEL (RECESSED MOUNT) (LOCATION TBD)	1
M	FLUSH RECTANGULAR CEILING SPEAKER	4
P	55" WALL MONITOR	1
P2	CONNECTED OR TOUCHPANEL	1

**CONDUIT SCHEDULE**

CONDUIT RUN ITEM - ITEM	CONDUIT QTY	CONDUIT SIZE
E - J	1	2"
E - J	1	1 1/4"
F - J	2	2"
F - J	2	1 1/4"
K - L	1	1"
K - *	1	1"
K10 - K	2	1"
M - J	1	1 1/4"
P - J	1	1 1/4"
P2 - J	1	1 1/4"

\* - TERMINATE AT CLOSEST ELECTRICAL PANEL

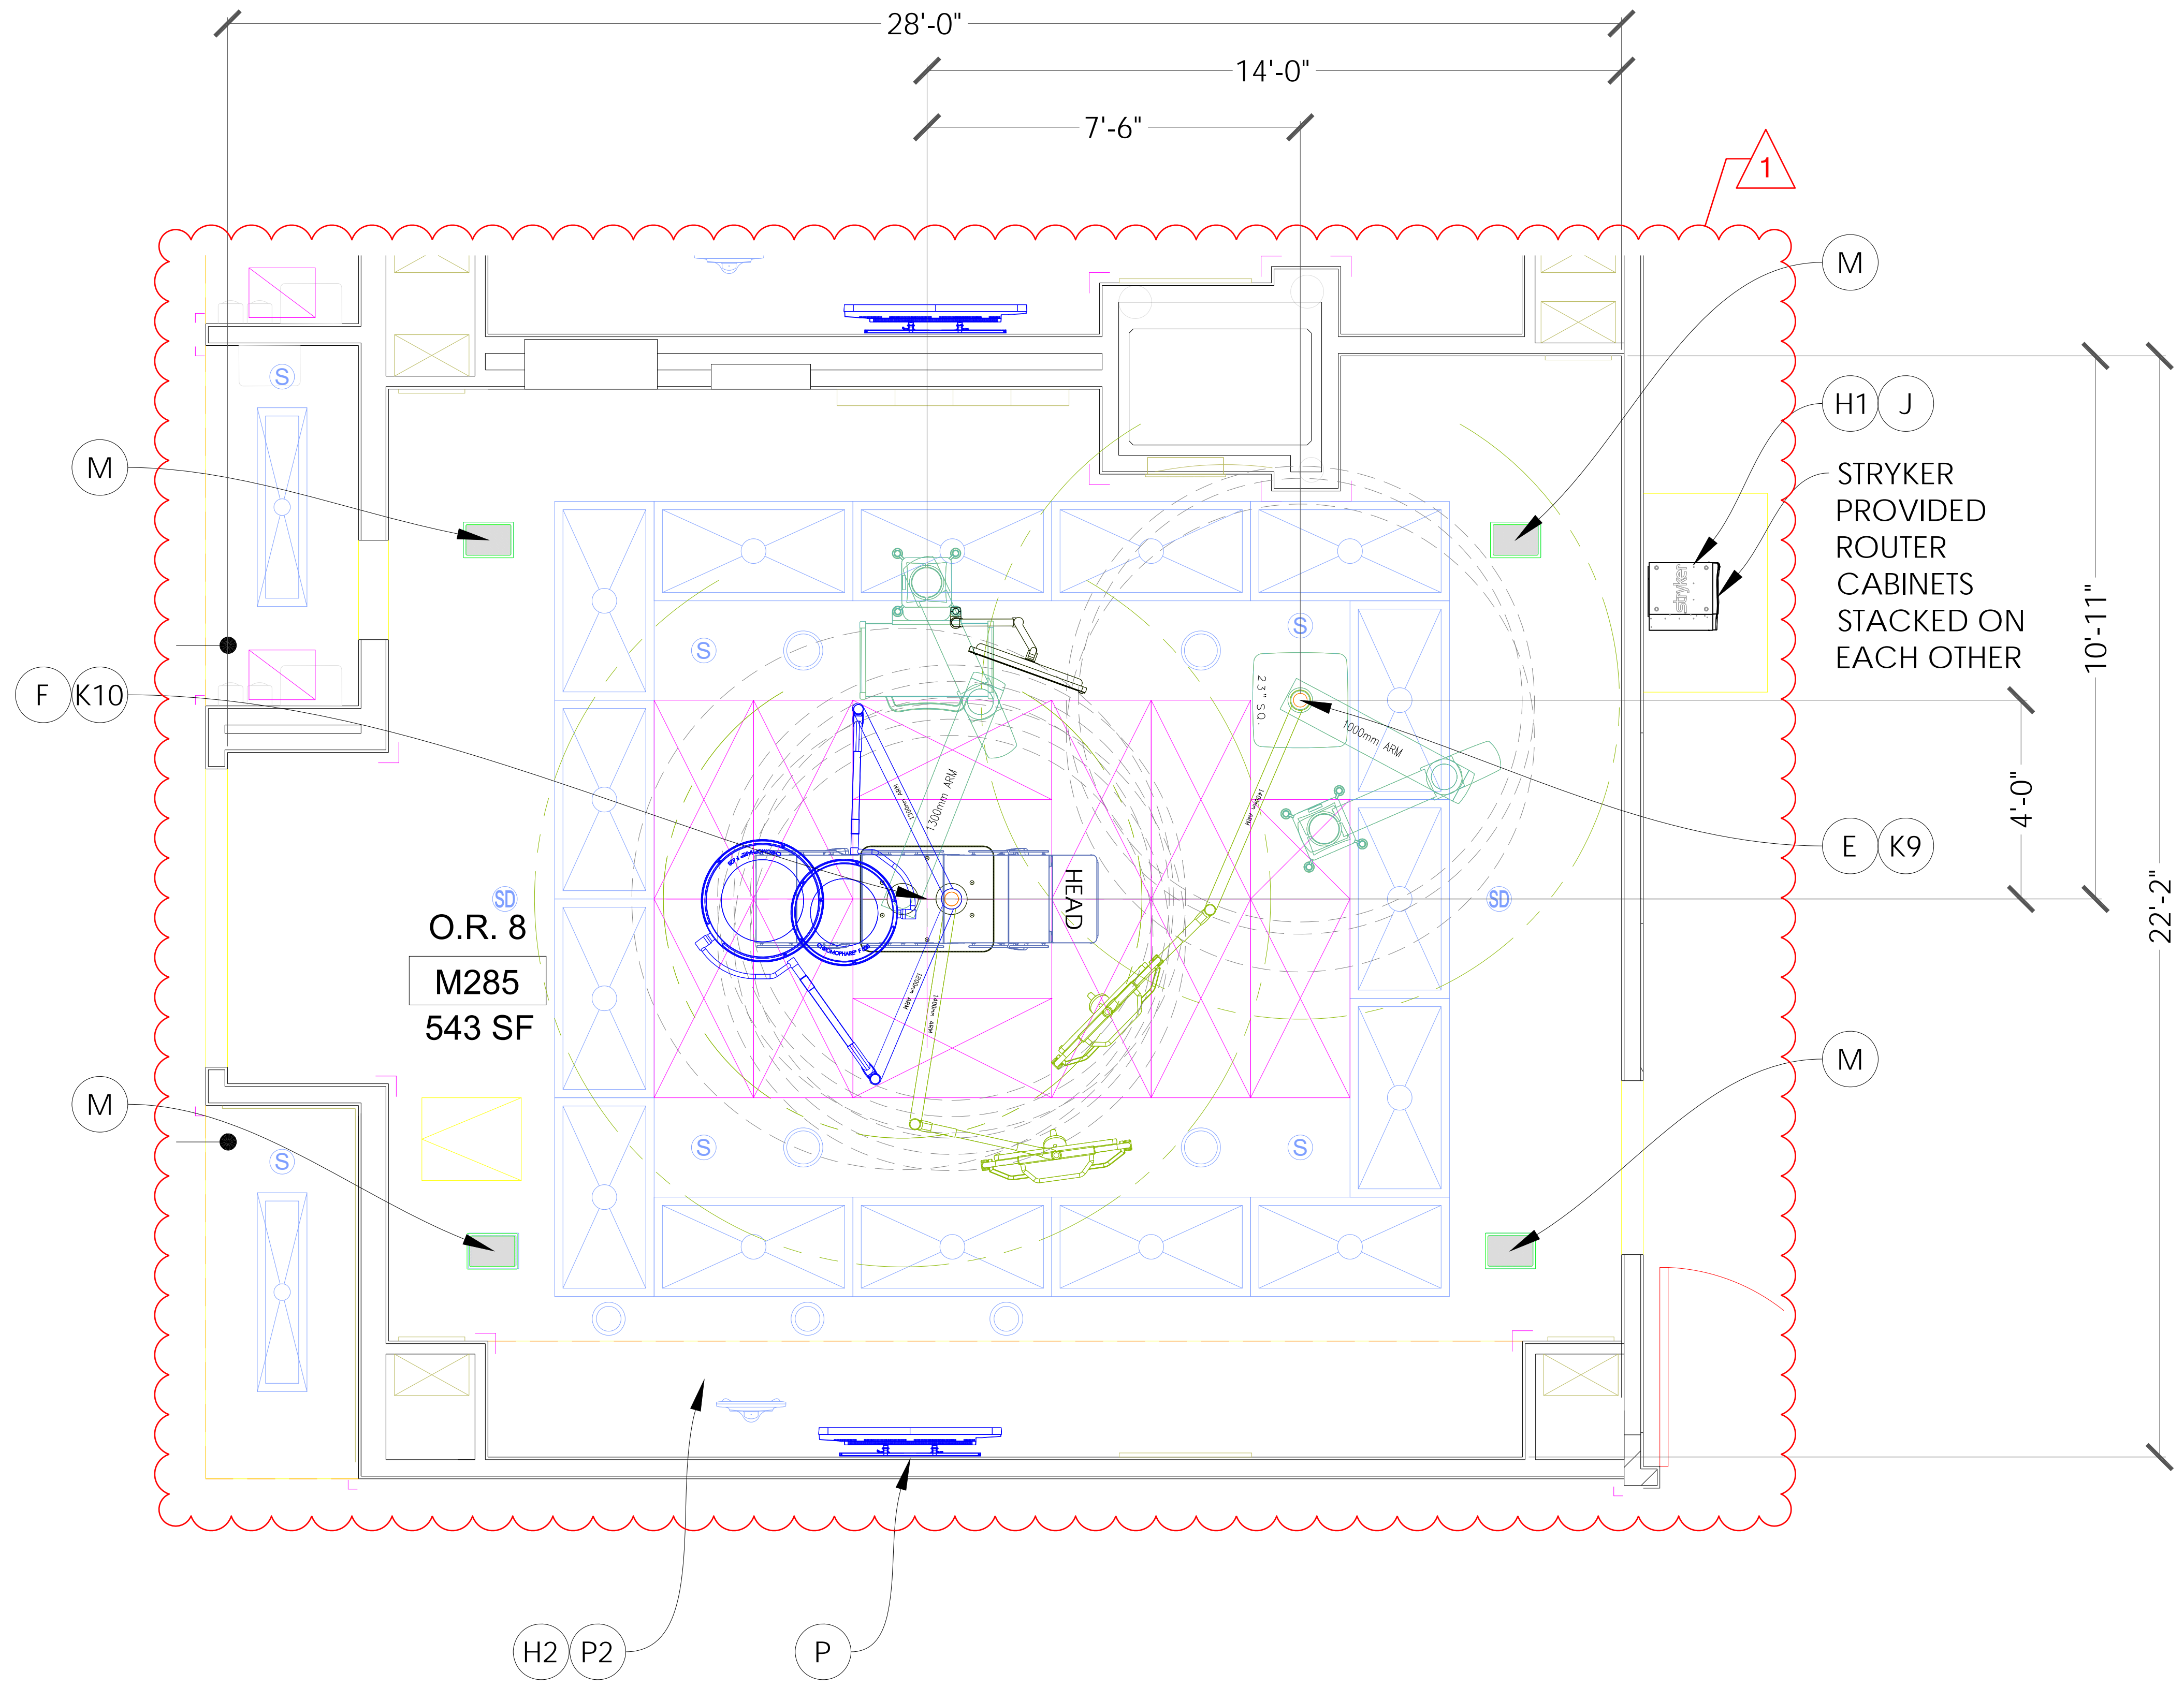

**stryker**

571 SILVERON BLVD.  
FLOWER MOUND, TEXAS 75028  
PHONE: (877) 789-8106  
www.stryker.com

REV: DATE:	DRAWING #:	WA-1388840_3	DRAFTER	IR
3	02/MAR/21	REFERENCE #:	DRC388824	EMONTGOMERY

**DISCLAIMER**  
THIS DOCUMENT CONTAINS CONFIDENTIAL AND PROPRIETARY INFORMATION OF STRYKER. NEITHER THIS DOCUMENT NOR THE INFORMATION HEREIN MAY BE REPRODUCED, USED, OR DISCLOSED TO OR FOR THE BENEFIT OF ANY THIRD PARTY WITHOUT THE PRIOR WRITTEN CONSENT OF STRYKER.

**EQUIPMENT LAYOUT**  
OR 8  
GOOD SAMARITAN HOSPITAL  
OR'S #7.8  
PUYALLUP, WA 98372

**PRELIMINARY**  
DISCLAIMER: THIS DRAWING IS IN A PRELIMINARY STATUS AND PENDING FINAL APPROVAL. ALL DRAWINGS IN A PRELIMINARY STATUS SHALL NOT BE USED FOR CONSTRUCTION.

REP: NATE BAKER  
P/M: DAN MITCHELL  
SHEET:  
**R - OR 8**

City of Puyallup  
Development & Permitting Services

**NOTES (UNLESS OTHERWISE SPECIFIED)**

1. ALL CONDUIT RUNS INCLUDE INSULATED BUSHINGS AND PULL STRINGS.

2. CONDUIT RUNS CANNOT EXCEED 45' FROM END-TO-END. DO NOT EXCEED FOUR (4) 90 DEGREE BENDS.

3. CABLES BETWEEN ITEMS OVER 45 FEET IN LENGTH ARE PROVIDED BY THE CUSTOMER / CONTRACTOR. PLEASE REFER TO EQUIPMENT LIST FOR CABLE SPECIFICATIONS.

4. THE PRE-INSTALL MANUAL REQUIREMENTS SUPERSEDE ALL PRE-INSTALL NOTES IN THIS DRAWING PACKAGE.


5. EQUIPMENT LIST:

**PRE-INSTALL NOTES SCHEDULE**

KEY ITEM	NAME
E	<p><b>S-SERIES TC BOOM WITH UDM</b></p> <p>STRUCTURAL: STRYKER COMMON PRE-INSTALL PLATE SHALL BE INSTALLED BY CUSTOMER/CONTRACTOR AT 3-INCH, ± .25-INCH ABOVE FINISHED CEILING PER CUSTOMER PROVIDED STRUCTURAL ENGINEER SPECS.</p> <p>- TO ENSURE ADEQUATE ROOM FOR INSTALLATION OF THE S-SERIES BOOM THE OWNER AND/OR CONTRACTOR MUST ENSURE THAT STRUCTURAL/UTILITY COMPONENTS DO NOT INTERFERE WITH ANY PART OF THE S-SERIES BOOM. THIS "NO-FLY" ZONE EXTENDS 12-INCHES FROM THE MOUNTING PLATE ON ALL SIDES, AND 16-INCHES UP FROM THE FINISHED CEILING.</p> <p>- REQUIRED: A 21-INCH SQUARE HOLE CENTERED ON STRYKER PRE-INSTALL PLATE IN THE FINISHED CEILING IS REQUIRED FOR INSTALLATION. A 23-INCH SQUARE CEILING COVER CONCEALS HOLE AFTER BOOM IS INSTALLED</p> <p>POWER: REFER TO S-SERIES MANUFACTURING SERVICE MODULE DRAWING FOR ELECTRICAL CIRCUIT COUNT.</p> <p>- THE CONTRACTOR / ELECTRICIAN TO HARDWIRE STRYKER ELECTRICAL WHIP DURING STRYKER INSTALLATION.</p> <p>- ALL ELECTRICAL CIRCUITS SHALL BE CONNECTED TO S-SERIES JUNCTION BOX OR BOXES.</p> <p>- TWO SEPARATE JUNCTION BOXES: A TC JUNCTION BOX AND UDM JUNCTION BOX (BOTH SUPPLIED BY STRYKER AND MEASURE 10-INCH HEIGHT X 8-INCH WIDTH X 4-INCH DEPTH) MUST BE MOUNTED WITHIN 18-INCHES OF BOOM MOUNT AND ACCESSIBLE FROM THE ACCESS PANEL. THESE ARE MOUNTED BY AN ELECTRICIAN AND IS REQUIRED FOR POWER AND CABLING.</p> <p>-IF UDM MONITOR IS POWERED VIA AC POWER, CONTRACTOR TO PROVIDE AN AC CIRCUIT TO THE AC TERMINAL BLOCK IN THE TC JUNCTION BOX.</p> <p>- THE S-SERIES JUNCTION BOX (7.4" x 3.5" x 3.74") ARRIVES ATTACHED TO THE S-SERIES BOOM FLANGE BY A GROUND WIRE. THE JUNCTION BOX MUST BE MOUNTED ADJACENT TO THE MED GAS LINES BY THE CUSTOMER/CONTRACTOR ACCORDING TO NATIONAL AND LOCAL BUILDING CODES.</p> <p>REQUIRED ACCESS PANEL: ONE (1) 24-INCH X 24-INCH ACCESS PANEL ADJACENT TO BOOM, SO JUNCTION BOX(ES), UDM JB AND MED GAS LINES CAN BE EASILY ACCESSED.</p> <p>CONDUIT: REFER TO ROOM LAYOUT FOR CONDUIT SIZE. TERMINATE ALL CONDUITS WITHIN 18-INCHES OF THE CENTER OF THE CEILING MOUNT.</p> <p>PLUMBING: INSTALL VALVE BRIDGE TO TOP OF PRE-INSTALL PLATE. ALL GAS LINES MUST BE TERMINATED WITH STRYKER SUPPLIED GAS RISERS BY CUSTOMER/MEDGAS INSTALLER.</p> <p>- ALL FINAL DISS CONNECTIONS TO BE MADE BY CUSTOMER/MEDGAS INSTALLER AFTER STRYKER INSTALLATION.</p>

**PRE-INSTALL NOTES SCHEDULE**

KEY ITEM	NAME
F	<p><b>TANDEM S-SERIES BOOM WITH UDM/LIGHT/LIGHT</b></p> <p>STRUCTURAL: STRYKER TANDEM COMMON PRE-INSTALL PLATE SHALL BE INSTALLED BY CUSTOMER/CONTRACTOR AT 3-INCH, ± .25-INCH ABOVE FINISHED CEILING PER CUSTOMER PROVIDED STRUCTURAL ENGINEER SPECS.</p> <p>- TO ENSURE ADEQUATE ROOM FOR INSTALLATION OF THE S-SERIES BOOM THE OWNER AND/OR CONTRACTOR MUST ENSURE THAT STRUCTURAL/UTILITY COMPONENTS DO NOT INTERFERE WITH ANY PART OF THE S-SERIES BOOM. THIS "NO-FLY" ZONE EXTENDS 12-INCHES FROM THE MOUNTING PLATE ON ALL SIDES, AND 16-INCHES UP FROM THE FINISHED CEILING.</p> <p>- REQUIRED: A 23-INCH x 27-INCH RECTANGLER HOLE CENTERED ON THE STRYKER PRE-INSTALL PLATE IN THE FINISHED CEILING IS REQUIRED FOR INSTALLATION. A 25-INCH X 32-INCH RECTANGLE CEILING COVER CONCEALS HOLE AFTER BOOM IS INSTALLED</p> <p>POWER: REFER TO S-SERIES MANUFACTURING SERVICE MODULE DRAWING FOR ELECTRICAL CIRCUIT COUNT.</p> <p>- THE CONTRACTOR / ELECTRICIAN TO HARDWIRE STRYKER ELECTRICAL WHIP DURING STRYKER INSTALLATION.</p> <p>- ALL ELECTRICAL CIRCUITS SHALL BE CONNECTED TO S-SERIES JUNCTION BOX OR BOXES.</p> <p>- A SEPARATE UDM JUNCTION BOX (SUPPLIED BY STRYKER AND MEASURES 10-INCH HEIGHT X 8-INCH WIDTH X 4-INCH DEPTH) MUST BE MOUNTED WITHIN 18-INCHES OF BOOM MOUNT AND ACCESSIBLE FROM THE ACCESS PANEL. THIS IS MOUNTED BY AN ELECTRICIAN AND IS REQUIRED FOR MONITOR POWER.</p> <p>-IF UDM MONITOR IS POWERED VIA AC POWER, CONTRACTOR TO PROVIDE AN AC CIRCUIT TO THE AC TERMINAL BLOCK ON THE FLANGE TUBE.</p> <p>- THE S-SERIES JUNCTION BOX (7.4" x 3.5" x 3.74") ARRIVES ATTACHED TO THE S-SERIES BOOM FLANGE BY A GROUND WIRE. THE JUNCTION BOX MUST BE MOUNTED ADJACENT TO THE MED GAS LINES BY THE CUSTOMER/CONTRACTOR ACCORDING TO NATIONAL AND LOCAL BUILDING CODES.</p> <p>REQUIRED ACCESS PANEL: ONE (1) 24-INCH X 24-INCH ACCESS PANEL ADJACENT TO BOOM, SO JUNCTION BOXES, TC JUNCTION BOX, UDM JB AND MED GAS LINES CAN BE EASILY ACCESSED.</p> <p>CONDUIT: REFER TO ROOM LAYOUT FOR CONDUIT SIZE. TERMINATE ALL CONDUITS WITHIN 18-INCHES OF THE CENTER OF THE CEILING MOUNT.</p> <p>PLUMBING: INSTALL VALVE BRIDGE TO TOP OF PRE-INSTALL PLATE. ALL GAS LINES MUST BE TERMINATED WITH STRYKER SUPPLIED GAS RISERS BY CUSTOMER/MEDGAS INSTALLER.</p> <p>- ALL FINAL DISS CONNECTIONS TO BE MADE BY CUSTOMER/MEDGAS INSTALLER AFTER STRYKER INSTALLATION.</p>

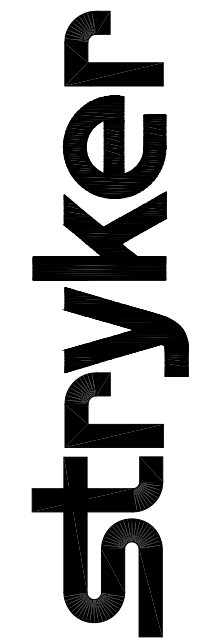

571 SILVERON BLVD.  
FLOWER MOUND, TEXAS 75028  
PHONE: (817) 769-8106  
www.stryker.com

REV: 3	DATE: 02/MAR/21	DRAWING #: WA-1388840_3	DRAFTER: EMONTGOMERY	IR: 1
--------	-----------------	-------------------------	----------------------	-------

**DISCLAIMER**

THIS DOCUMENT CONTAINS CONFIDENTIAL AND PROPRIETARY INFORMATION OF STRYKER. NEITHER THIS DOCUMENT NOR THE INFORMATION HEREIN MAY BE REPRODUCED, USED, OR DISCLOSED TO OR FOR THE BENEFIT OF ANY THIRD PARTY WITHOUT THE PRIOR WRITTEN CONSENT OF STRYKER.

**PRE-INSTALL NOTES**

GOOD SAMARITAN HOSPITAL  
ORS #7.8  
PUYALLUP, WA 98372

REP: NATE BAKER  
PM: DAN MITCHELL

SHEET:  
**P - 1**

**PRELIMINARY**

DISCLAIMER: THIS DRAWING IS IN A PRELIMINARY STATUS AND PENDING FINAL APPROVAL. ALL DRAWINGS IN A PRELIMINARY STATUS SHALL NOT BE USED FOR CONSTRUCTION.



City of Puyallup  
Development & Permitting Services

ISSUED PERMIT  
OTHERWISE SPECIFIED)

1. ALL CONDUIT RUNS INCLUDE INSULATED BUSHINGS AND PULL STRINGS.

2. CONDUIT RUNS CANNOT EXCEED 45' FROM END-TO-END. DO NOT EXCEED FOUR (4) 90 DEGREE BENDS.

3. CABLES BETWEEN ITEMS OVER 45 FEET IN LENGTH ARE PROVIDED BY THE CUSTOMER / CONTRACTOR. PLEASE REFER TO EQUIPMENT LIST FOR CABLE SPECIFICATIONS.

4. THE PRE-INSTALL MANUAL REQUIREMENTS SUPERSEDE ALL PRE-INSTALL NOTES IN THIS DRAWING PACKAGE.

5. EQUIPMENT LIST:

**PRE-INSTALL NOTES SCHEDULE**

KEY ITEM	NAME
H	<p><b>PRINTER</b> DIMENSIONS: 12.5"W X 8.2"H X 16.7"D DATA: NONE BACKBOX: NONE</p> <p><b>HUB</b> DIMENSIONS: 13" W x 6" H x 17" D TOTAL SPACE REQUIRED: 21" W x 14" H X 28" D POWER: ONE (1) STANDARD OUTLET WITHIN 18" OF HUB LOCATION. DATA: ONE (1) ETHERNET CONNECTION</p>
J	<p><b>SWITHCPOINT INFINITY 3</b> DIMENSIONS: - MEDIA ROUTER: 20.6"W X 24"H X 17"D - TOTAL SPACE REQUIRED: 27.5"W X 31"H X 29"D POWER: SIXTEEN (16) ELECTRICAL RECEPTACLES AT THE MEDIA ROUTER LOCATION ALL RECEPTACLES REQUIRE CRITICAL POWER ALL ELECTRICAL CIRCUITS SHALL BE INSTALLED IN ACCORDANCE WITH THE LOCAL BUILDING CODE OR WHAT IS SPECIFIED IN THE IBC. DATA: ONE (1) ETHERNET CONNECTION BACKBOX: ONE (1) 18"W X 18"H X 4"D (OR LARGER) JUNCTION BOX FLUSH MOUNTED. - SET BOTTOM OF BOX 9" ABOVE FINISHED FLOOR. NOTE: TERMINATE ALL INTEGRATION CONDUITS TO THIS JUNCTION BOX.</p>
K	<p><b>SK BOX FOR CHROMOPHARE LIGHTING (IN CEILING)</b> ENCLOSURE DIMENSIONS/MOUNTING: - SINGLE ENCLOSURE 19.69" X 15.75" X 7.87" (1-2 LIGHTHEADS), WEIGHT = 64LBS - DOUBLE ENLCOSURE 19.69" X 31.5" X 7.87" (3-4 LIGHTHEADS), WEIGHT = 128 LBS - MUST REMAIN ACCESSIBLE AFTER INSTALLATION (THROUGH NEARBY ACCESS PANEL). HINGED DOORS MUST HAVE COMPLETE FREEDOM OF MOVEMENT IN CEILING AND MUST NOT EVER BE OBSTRUCTED CONDUIT: - MAXIMUM LENGTH OF 45 FEET (15M) OF CONDUIT RUN TO BOTH THE MOUNTING PLATE AND THE TO WALL CONTROL BOX - TWO (2) 1" FROM SK ENCLOSURE TO EACH LIGHT MOUNTING LOCATION, - ONE (1) 1" BETWEEN LIGHT MOUNTING LOCATIONS, - ONE (1) 1" FOR MAINS 120VAC TO SK ENCLOSURE (UP TO TWO(2)) LIGHTS PER CIRCUIT). POWER: - MAINS AC POWER SHOULD BE 120 VAC, 50/60 HZ CONNECTED WITH 3 WIRE, 12 AWG MIN., 600 V TERMINATED TO FUSED TERMINAL BLOCK INSIDE THE SK ENCLOSURE - DC WIRING FROM SK ENCLOSURE TO MOUNTING PLATE SHOULD BE 12 AWG, 600 VOLT, 1 WIRE PAIR PER LIGHT HEAD AND 1 GROUND WIRE PER MOUNTING PLATE. WIRES TERMINAT AT NON-FUSED TERMINAL BLOCK INSIDE THE SK ENCLOSURE AND FALL A MINIMUM OF 18 INCHES BELOW THE CEILING AT THE MOUNTING PLATE - CONTRACTOR IS RESPONSIBLE FOR RUNNING POWER FROM AN AC MAINS SUPPLY TO THE SK BOX - CONTRACTOR IS RESPONSIBLE FOR RUNNING DC WIRING FROM THE SK ENCLOSURE TO THE SURGICAL LIGHT MOUNTING PLATE - CONTRACTOR IS RESPONSIBLE FOR MAKING BOTH AC AND DC CONNECTIONS IN THE SK ENCLOSURE.</p>

**PRE-INSTALL NOTES SCHEDULE**

KEY ITEM	NAME
K9	<p><b>UDM TC JUNCTION BOX</b> IS TO BE MOUNTED WITHIN 3FT OF BOOM MOUNT AND ACCESSABLE FROM THE ACCESS PANEL. UPON EQUIPMENT INSTALLTION AN ELECTRONICS MODULE WILL BE INSTALLED BY STRYKER INSTALLATION TEAM AND THE LOW VOLTAGE CAN BE TERMINATED TO THE MODULE PLATE BY THE ELECTRICIAN. UDM: - AC TERMINAL BLOCK IS PROVIDED IN THE TC JUNCTION BOX FOR THE UDM MONITOR. THIS WILL ONLY BE USED IF AC POWER IS USED FOR THE UDM MONITOR. - THIS TC JUNCTION BOX WILL HOUSE TERMINAL BLOCKS FOR SURGICAL LIGHT AND MONITOR POWER.</p>
K10	<p><b>UDM JUNCTION BOX</b> (SUPPLIED BY STRYKER AND MEASURES 10-INCH HEIGHT X 8-INCH WIDTH X 4-INCH DEPTH) MUST BE MOUNTED WITHIN 18-INCHES OF SUSPENSION MOUNT AND ACCESSIBLE FROM THE ACCESS PANEL. THIS IS MOUNTED BY AN ELECTRICIAN AND IS REQUIRED FOR MONITOR CABLING.</p>
L	<p><b>CHROMOPHARE WALL CONTROL (RECESSED)</b> CONDUIT: ONE (1) 1" CONDUIT WITH FINISH GROMMETS TO SK ENCLOSURE OR ON TUBE ELECTRONICS. BACK BOX: NONE. WALL CONTROL RECEIVES CONDUIT. POWER: NONE</p>
M	<p><b>FLUSH MOUNTED RECTANGULAR CEILING SPEAKER</b> CONDUIT: - REFER TO ROOM LAYOUT FOR CONDUIT QUANTITY AND SIZE STRUCTURAL: CUSTOMER/CONTRACTOR TO CUT ONE 7 1/4"W X 10 3/4"L (TEMPLATE SUPPLIED W/ SPEAKER) IN THE WALL AT EACH SPEAKER MOUNTING LOCATION. MINIMUM 4" CEILING CLEARANCE.</p>
P	<p><b>55" WALL LCD</b> CONDUIT: REFER TO ROOM LAYOUT FOR CONDUIT QUANTITY AND SIZE BACK BOX: ONE (1) 4"W X 4"H JUNCTION BOX WITH SINGLE-GANG MUD RING - MOUNTED DIRECTLY ABOVE THE TOP OF THE MOUNTING BRACKET. POWER: ONE (1) STANDARD DUPLEX OUTLET MOUNTED ADJACENT TO JUNCTION BOX. STRUCTURAL: CUSTOMER/CONTRACTOR TO MOUNT STRYKER PROVIDED BRACKET TO THE WALL IN THE DESIRED LOCATION WITH PROPER REINFORCEMENT TO SUPPORT THE MONITOR PRIOR TO STRYKER INSTALLATION. DIMENSIONS: 51.9" x 30.5" x 4.7" NOTE: STRYKER PROJECT MANAGER WILL PROVIDE MOUNTING SPECIFICATIONS.</p>
P2	<p><b>TOUCHPANEL</b> CONDUIT: - REFER TO ROOM LAYOUT FOR CONDUIT QUANTITY AND SIZE BACK BOX: ONE (1) 4"W X 4"H JUNCTION BOX WITH SINGLE-GANG MUD RING - MOUNT J-BOX WITHIN 18" OF TOUCH PANEL LOCATION GCX TRACK: CONTRACTOR TO MOUNT 4" X 7" (W X H) TRACK VERTICALLY ON THE WALL AT A CUSTOMER SPECIFIED HEIGHT ABOVE FINISHED FLOOR POWER: ONE (1) STANDARD OUTLET WITHIN 18" OF TOUCH PANEL LOCATION.</p>

**stryker**

571 SILVERON BLVD.  
FLOWER MOUND, TEXAS 75028  
PHONE: (817) 789-8106  
www.stryker.com

REV: DATE:	DRAWING #:	IR
3	WA-1388840_3	1
	REFERENCE #:	DRAFTER
	02MAR21	EMONTGOMERY

**DISCLAIMER**  
THIS DOCUMENT CONTAINS CONFIDENTIAL AND PROPRIETARY INFORMATION OF STRYKER. NEITHER THIS DOCUMENT NOR THE INFORMATION HEREIN MAY BE REPRODUCED, USED, OR DISCLOSED TO OR FOR THE BENEFIT OF ANY THIRD PARTY WITHOUT THE PRIOR WRITTEN CONSENT OF STRYKER.

**PRE-INSTALL NOTES**

**GOOD SAMARITAN HOSPITAL**  
ORS #7.8  
PUYALLUP, WA 98372

REP: NATE BAKER  
P.M: DAN MITCHELL

SHEET:  
**P - 2**

**PRELIMINARY**  
DISCLAIMER: THIS DRAWING IS IN A PRELIMINARY STATUS AND PENDING FINAL APPROVAL. ALL DRAWINGS IN A PRELIMINARY STATUS SHALL NOT BE USED FOR CONSTRUCTION.