300 BUILDING - LARSON AUTOMOTIVE GROUP

OWNER / APPLICANT

LARSON AUTOMOTIVE GROUP 7815 SOUTH TACOMA WAY TACOMA, WA 98409 CONTACT: MARK NELSON EMAIL: MARKNELSON@LOOKLARSON.COM

PHONE: (253) 377-1645

CIVIL ENGINEER

MOMENTUM CIVIL 1145 BROADWAY, SUITE 1 TACOMA, WA 98402 CONTACT: MARC PUDISTS, P.E EMAIL: MARCP@MOMENTUMCIVIL.COM PHONE: (253) 405-4474

CONTACT: DREW HARRIS, P.E. EMAIL: DREWH@MOMENTUMCIVIL.COM

PHONE: (253) 319-1506 **SURVEYOR**

INFORMED LAND SURVEY 3215 SOUTH 12TH STREET TACOMA, WA 98405 **CONTACT: EVAN WAHLSTROM** EMAIL: EWAHLSTROM@I-LANDSURVEY.COM PHONE: (253) 627-2070

ARCHITECT

CASTINO ARCHITECTURE 8911 71ST AVE NW GIG HARBOR, WA 98332 **CONTACT: JIM CASTINO** FMAIL: JIMPILOT22@GMAIL COM PHONE: (253) 973-6680

GEOTECHNICAL ENGINEER

GEORESOURCES CONTACT: NEIL FERGUSON, P.E. 4809 PACIFIC HIGHWAY EAST FIFE, WA 98424 PHONE: (253) 896-1011

LANDSCAPE ARCHITECT

LYON LANDSCAPE ARCHITECTS CONTACT: ERIC WILLIAMS, ASLA 1015 PACIFIC AVENUE, SUITE #203 **TACOMA. WA 98402** PHONE: (253) 678-4173

SITE ELECTRICAL ENGINEER

DANARD ELECTRIC INC. CONTACT: STEVE DANARD 18819 38TH AVE. E TACOMA, WA 98446 PHONE: (253) 875-8650

GENERAL NOTES

- CONTRACTOR SHALL PROVIDE TRAFFIC CONTROL PLAN TO THE CITY OF PUYALLUP FOR REVIEW AND OBTAIN APPROVED PLAN PRIOR TO THE PRECONSTRUCTION MEETING AND PRIOR TO ANY WORK WITHIN THE RIGHT-OF-WAY. MOMENTUM CIVIL IS NOT RESPONSIBLE FOR TRAFFIC CONTROL.
- CONTRACTOR SHALL VERIFY THE LOCATIONS OF UNDERGROUND UTILITIES PRIOR TO ANY EXCAVATION. DEPTHS TO GRAVITY PIPE CONNECTIONS SHOULD BE POT HOLED. NOTIFY THE ENGINEER IF ELEVATIONS DIFFER FROM THE PLANS.
- SPECIFICATIONS FOR ROAD, BRIDGE AND MUNICIPAL CONSTRUCTION, DATED 2021, UNLESS SUPERSEDED BY A CITY STANDARD, THIS PLAN SET, OR AN ORDER OF THE ENGINEER OR OWNER.
- ALL EARTHWORK SHALL BE PERFORMED ACCORDING TO THE RECOMMENDATIONS CONTAINED IN THE PROJECT SPECIFIC GEOTECHNICAL REPORT BY GEORESOURCES, DATED THE 8TH OF AUGUST, 2021. CONTRACTOR TO INSTALL IRRIGATION SLEEVING AND ELECTRICAL AND LIGHTING

SITE INFORMATION

PARCEL NUMBER(S): 0420214010, 0420214027, 0420281154* (*THIS PLAN SET IS BEING SUBMITTED CONCURRENTLY WITH A LOT COMBINATION APPLICATION THAT WILL COMBINE PARCELS 0420214027 AND 0420214010) PROJECT ADDRESS: 300 RIVER ROAD, PUYALLUP, WA 98371 EXISTING ZONING: GENERAL COMMERCIAL PROPOSED ZONING: GENERAL COMMERCIAL TOTAL SITE AREA: 3.09 ACRES

REPLACED PGIS:

TOTAL NEW + REPLACED IMPERVIOUS SURFACE:

4TH STREET NW GRIND AND OVERLAY: 7,530 SF

SITE VOLUME CALCULATIONS CUT VOLUME: 800+/- CY FILL VOLUME: 900+/- CY NET CUT-TO-FILL: 100+/- CY (FILL)

NOTE: ALL VOLUMES ARE APPROXIMATE AND ARE PROVIDED FOR PERMITTING PURPOSES ONLY AND REPRESENT FINISH GRADE TO STRIPPED SUBGRADE. CONTRACTOR SHALL RELY ON THEIR OWN ESTIMATES FOR DETERMINING ACTUAL EARTHWORK QUANTITIES. THE VOLUMES LISTED ABOVE DO NOT ACCOUNT FOR TRENCHING, STRUCTURAL EXCAVATION, EXPANSION/COMPACTION FACTORS OR ANY

STA: 50+00.00, 0.00

-Northing: 683826.45

Easting: 1193347.72

UTILITY PURVEYORS / SERVICES

SEWER: CITY OF PUYALLUP PUBLIC WORKS 333 S. MERIDIAN PUYALLUP, WA 98371

PHONE: (253) 841-5505 WATER: CITY OF PUYALLUP - WATER DIVISION 333 S. MERIDIAN PUYALLUP, WA 98371


PHONE: (253) 841-5505

PHONE: (253) 864-4171


CITY OF PUYALLUP - FIRE SERVICES & PREVENTION 333 S. MERIDIAN, 2ND FLOOR PUYALLUP, WA 98371

POWER: PUGET SOUND ENERGY PHONE: (888) 225-5773

PUGET SOUND ENERGY PHONE: (888) 225-5773

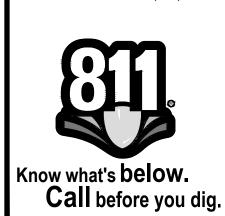

CIVIL CONSTRUCTION PLANS (PERMIT_ RIGHT-OF-WAY PLANS (PERMIT_

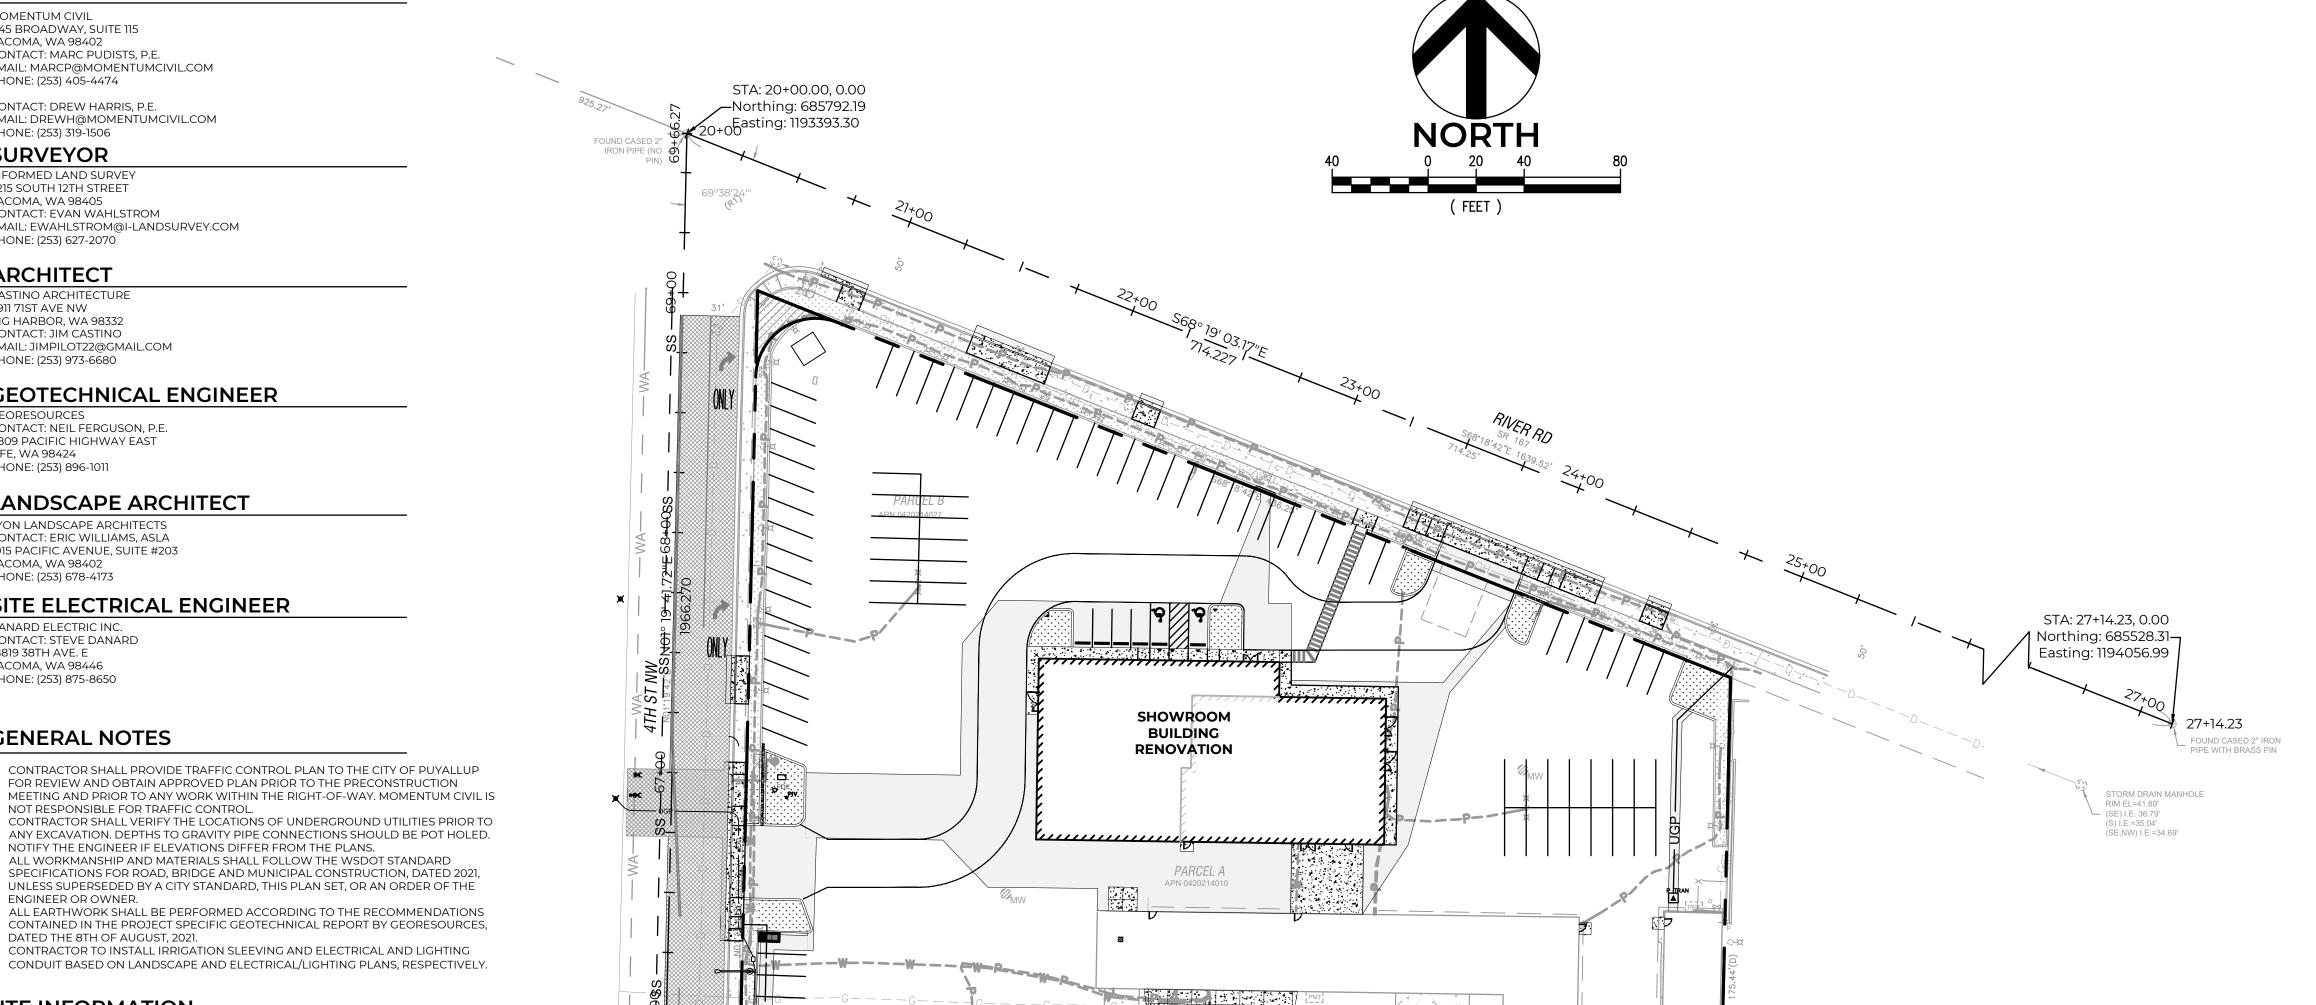

City of Puyallup **Development & Permitting Services ISSUED PERMIT** THIS PLAN SET IS BEING SUBMITTED Building Planning CONCURRENTLY WITH A LOT COMBINATION APPLICATION THAT WILL COMBINE PARCELS Public Works Engineering 0420214027 AND 0420214010

Puyallup River PROJECT SITE 6th Ave NW 5th Ava NW

APPROVED

CITY OF PUYALLUP DEVELOPMENT ENGINEERING

NOTE: THIS APPROVAL IS VOID AFTE.

THE CITY WILL NOT BE RESPONSIBLE

180 DAYS FROM APPROVAL DATE.

FIELD CONDITIONS MAY DICTATE

DETERMINED BY THE DEVELOPMENT

CHANGES TO THESE PLANS AS

ENGINEERING MANAGER.

THESE PLANS.

VICINITY MAP SCALE: 1' = 1000'

Civil Sheet Index

Sheet # Ref # Sheet Title

C1.0 CIVIL COVER C1.1 GENERAL NOTES

C1.2 GENERAL NOTES

C2.0 EXISTING CONDITIONS

C2.1 TESC & DEMOLITION PLAN

C2.2 TESC DETAILS

C3.0 CIVIL SITE PLAN

C3.1 CIVIL DETAILS

C3.2 CIVIL DETAILS

C3.3 CHANNELIZATION PLAN

C3.4 CHANNELIZATION DETAILS C4.0 GRADING AND DRAINAGE PLAN

C4.1 GRADING ENLARGEMENTS

C4.2 STORM DRAINAGE DETAILS

C4.3 DRIVEWAY SITE DISTANCE

C5.0 UTILITY PLAN

C5.01 UTILITY AND LANDSCAPE OVERLAY PLAN

C5.1 WATER DETAILS

C5.2 SEWER AND WATER DETAILS

C5.3 SEWER SERVICE PROFILES

Landscape Architectural Sheet Index

Sheet # Ref # Sheet Title

L1.0 LANDSCAPE PLANS

L1.1 PLANT LEGEND AND IMAGE

PUYALLUP STANDARD PLANTING AND

SOIL DETAILS

24 L2.0 IRRIGATION PLAN

Site Electrical Sheet Index

Sheet # Ref # Sheet Title

Traffic

25 ES1.00 Street Lighting Plan



PERMIT SET

OVE

ILDING

CHECKED BY: M. PUDISTS DESIGNED BY: K. MURPHY DRAWN BY: K. MURPHY

HORZ. DATUM: NAD83(11) VERT. DATUM: **NAVD88**

PROJECT NO. LARS-0001

SHEET NO. 1 of 25

REFERENCE NO. **C1.0**

ALL WORK IN CITY RIGHT-OF-WAY REQUIRES A PERMIT FROM THE CITY OF PUYALLUP. PRIOR TO ANY

WORK COMMENCING, THE GENERAL CONTRACTOR SHALL ARRANGE FOR A PRECONSTRUCTION

WILL PERFORM WORK SHOWN ON THE ENGINEERING PLANS, REPRESENTATIVES FROM ALL

ENGINEERING SERVICES TO SCHEDULE THE MEETING (253) 841-5568. THE CONTRACTOR IS

RESPONSIBLE TO HAVE THEIR OWN APPROVED SET OF PLANS AT THE MEETING.

WATER SYSTEM AND PROVISION OF SANITARY SEWER SERVICE.

DETAILS SHALL BE ON SITE DURING CONSTRUCTION.

B-30.30-03 (OLYMPIC FOUNDRY NO. SM60V OR EQUAL).

SERVICES STAFF PRIOR TO INSTALLATION.

DUCTILE IRON PIPE SHALL BE 1.0 FOOT.

PROTECTED FROM SEDIMENTS.

THE STORM PIPE.

POLYPROPYLENE PIPE.

CONSTRUCTION (HEREINAFTER REFERRED TO AS THE "CITY STANDARDS").

ENGINEER SHALL BE CONTACTED IMMEDIATELY IF A CONFLICT EXISTS.

THIS PROJECT. SHALL BE DONE SO AT THE DEVELOPER'S EXPENSE.

10. MANHOLE RING AND COVER SHALL CONFORM TO CITY STANDARD DETAIL 06.01.02.

MEETING AT THE DEVELOPMENT SERVICES CENTER TO BE ATTENDED BY ALL CONTRACTORS THAT

AFTER COMPLETION OF ALL ITEMS SHOWN ON THESE PLANS AND BEFORE ACCEPTANCE OF THE

PROJECT, THE CONTRACTOR SHALL OBTAIN A "PUNCH LIST" PREPARED BY THE CITY'S INSPECTOR

PLANS SHALL BE COMPLETED TO THE SATISFACTION OF THE CITY PRIOR TO ACCEPTANCE OF THE

BRIDGE, AND MUNICIPAL CONSTRUCTION (HEREINAFTER REFERRED TO AS THE "STANDARD

DETAILING REMAINING ITEMS OF WORK TO BE COMPLETED. ALL ITEMS OF WORK SHOWN ON THESE

ALL MATERIALS AND WORKMANSHIP SHALL CONFORM TO THE STANDARD SPECIFICATIONS FOR ROAD,

SPECIFICATIONS"), WASHINGTON STATE DEPARTMENT OF TRANSPORTATION AND AMERICAN PUBLIC

WORKS ASSOCIATION, WASHINGTON STATE CHAPTER, LATEST EDITION, UNLESS SUPERSEDED OR

AMENDED BY THE CITY OF PUYALLUP CITY STANDARDS FOR PUBLIC WORKS ENGINEERING AND

A COPY OF THESE APPROVED PLANS AND APPLICABLE CITY DEVELOPER SPECIFICATIONS AND

ANY REVISIONS MADE TO THESE PLANS MUST BE REVIEWED AND APPROVED BY THE DEVELOPER'S

ENGINEER AND THE ENGINEERING SERVICES STAFF PRIOR TO ANY IMPLEMENTATION IN THE FIELD.

CONSTRUCTION. CALL (811) AT LEAST TWO WORKING DAYS IN ADVANCE. THE OWNER AND HIS/HER

THE CITY SHALL NOT BE RESPONSIBLE FOR ANY ERRORS AND/OR OMISSIONS ON THESE PLANS.

7. ANY STRUCTURE AND/OR OBSTRUCTION WHICH REQUIRE REMOVAL OR RELOCATION RELATING TO

9. ALL STORM MANHOLES SHALL CONFORM TO CITY STANDARD DETAIL NO. 02.01.01. FLOW CONTROL

DURING CONSTRUCTION, ALL EXISTING AND NEWLY INSTALLED DRAINAGE STRUCTURES SHALL BE

MANHOLE/OIL WATER SEPARATOR SHALL CONFORM TO CITY STANDARD DETAIL NO. 02.01.06 AND

CATCH BASINS TYPE I SHALL CONFORM TO CITY STANDARD DETAIL NO.02.01.02 AND 02.01.03 AND

12. CATCH BASINS TYPE II SHALL CONFORM TO CITY STANDARD DETAIL NO.02.01.04 AND SHALL BE USED

UNLESS NOTED AS ROUND) SHALL CONFORM TO WSDOT STANDARD PLAN B-30.20-04 (OLYMPIC

FOUNDRY NO. SM60 OR EQUAL). VANED GRATES SHALL CONFORM TO WSDOT STANDARD PLAN

13. CAST IRON OR DUCTILE IRON FRAME AND GRATE SHALL CONFORM TO CITY STANDARD DETAIL

14. STORMWATER PIPE SHALL BE ONLY PVC, CONCRETE, DUCTILE IRON, OR DUAL WALLED

SHALL BE USED ONLY FOR DEPTHS LESS THAN 5 FEET FROM TOP OF THE GRATE TO THE INVERT OF

FOR DEPTHS GREATER THAN 5 FEET FROM TOP OF THE GRATE TO THE INVERT OF THE STORM PIPE.

NO.02.01.05. GRATE SHALL BE MARKED WITH "DRAINS TO STREAM". SOLID CATCH BASIN LIDS (SQUARE

THE USE OF ANY OTHER TYPE SHALL BE REVIEWED AND APPROVED BY THE ENGINEERING

PVC PIPE SHALL BE PER ASTM D3034, SDR 35 FOR PIPE SIZE 15-INCH AND SMALLER AND F679

UNDERDRAIN PIPE. MINIMUM COVER ON CONCRETE PIPE SHALL NOT LESS THAN 3.0 FEET.

EXCEED ASTM F2736 AND AASHTO M330, TYPE S, OR TYPE D. 36-INCH THROUGH 60-INCH

PIPE SHALL MEET OR EXCEED ASTM F2881 AND AASHTO M330, TYPE S, OR TYPE D. TESTING

SHALL BE PER ASTM F1417. MINIMUM COVER OVER POLYPROPYLENE PIPE SHALL BE 3-FEET.

DUCTILE IRON PIPE SHALL BE CLASS 50, CONFORMING TO AWWA C151. MINIMUM COVER ON

CONCRETE PIPE SHALL CONFORM TO THE WSDOT STANDARD SPECIFICATIONS FOR CONCRETE

POLYPROPYLENE PIPE (PP) SHALL BE DUAL WALLED, HAVE A SMOOTH INTERIOR AND EXTERIOR

CORRUGATIONS AND MEET WSDOT 9-05.24(1). 12-INCH THROUGH 30-INCH PIPE SHALL MEET OR


THE CONTRACTOR SHALL HAVE ALL UTILITIES VERIFIED ON THE GROUND PRIOR TO ANY

APPLICABLE UTILITY COMPANIES. THE PROJECT OWNER AND APPROPRIATE CITY STAFF. CONTACT

mlldes CITY OF PUYALLUP DEVELOPMENT ENGINEERING

80 DAYS FROM APPROVAL DATE. THE CITY WILL NOT BE RESPONSIBL THESE PLANS. FIELD CONDITIONS MAY DICTATE CHANGES TO THESE PLANS AS DETERMINED BY THE DEVELOPMENT ENGINEERING MANAGER.

APPROVED

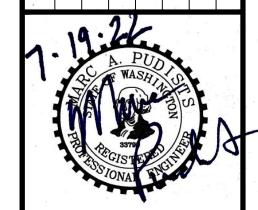

PERMIT SET

 \supset AUTO 0 Ž DING

PHONE: 253.319.1504 CHECKED BY: M. PUDISTS DESIGNED BY: K. MURPHY

DRAWN BY: K. MURPHY HORZ. DATUM: NAD83(11) VERT. DATUM: **NAVD88**

7/19/22

PROJECT NO. LARS-0001

SHEET NO. 2 of 25 REFERENCE NO. **C1.1**

CITY OF PUYALLUP GENERAL NOTES - REVISED 06/06/2012

- ALL WORK IN CITY RIGHT-OF-WAY REQUIRES A PERMIT FROM THE CITY OF PUYALLUP. PRIOR TO ANY WORK COMMENCING, THE GENERAL CONTRACTOR SHALL ARRANGE FOR A PRECONSTRUCTION MEETING AT THE DEVELOPMENT SERVICES CENTER TO BE ATTENDED BY ALL CONTRACTORS THAT WILL PERFORM WORK SHOWN ON THE APPROVED ENGINEERING PLANS, REPRESENTATIVES FROM ALL APPLICABLE UTILITY COMPANIES, THE PROJECT OWNER AND APPROPRIATE CITY STAFF. CONTACT ENGINEERING SERVICES AT (253-841-5568) TO SCHEDULE THE MEETING. THE CONTRACTOR IS RESPONSIBLE TO HAVE THEIR OWN SET OF APPROVED PLANS AT THE MEETING.
- AFTER COMPLETION OF ALL ITEMS SHOWN ON THESE PLANS AND BEFORE ACCEPTANCE OF THE PROJECT THE CONTRACTOR SHALL OBTAIN A "PUNCH LIST" PREPARED BY THE CITY'S INSPECTOR DETAILING REMAINING ITEMS OF WORK TO BE COMPLETED. ALL ITEMS OF WORK SHOWN ON THESE PLANS SHALL BE COMPLETED TO THE SATISFACTION OF THE CITY PRIOR TO ACCEPTANCE OF THE WATER SYSTEM AND PROVISION OF SANITARY SEWER SERVICE.
- ALL MATERIALS AND WORKMANSHIP SHALL CONFORM TO THE STANDARD SPECIFICATIONS FOR ROAD, BRIDGE, AND MUNICIPAL CONSTRUCTION (HEREINAFTER REFERRED TO AS THE "STANDARD SPECIFICATIONS"), WASHINGTON STATE DEPARTMENT OF TRANSPORTATION AND AMERICAN PUBLIC WORKS ASSOCIATION, WASHINGTON STATE CHAPTER, LATEST EDITION, UNLESS SUPERSEDED OR AMENDED BY THE CITY OF PUYALLUP CITY STANDARDS FOR PUBLIC WORKS ENGINEERING AND CONSTRUCTION (HEREINAFTER REFERRED TO AS THE "CITY STANDARDS").
- A COPY OF THESE APPROVED PLANS AND APPLICABLE CITY DEVELOPER SPECIFICATIONS AND DETAILS SHALL BE ON SITE DURING CONSTRUCTION
- ANY REVISIONS MADE TO THESE PLANS MUST BE REVIEWED AND APPROVED BY THE DEVELOPER'S ENGINEER AND THE CITY PRIOR TO ANY IMPLEMENTATION IN THE FIELD. THE CITY SHALL NOT BE RESPONSIBLE FOR ANY ERRORS AND/OR OMISSIONS ON THESE PLANS.
- THE CONTRACTOR SHALL HAVE ALL UTILITIES VERIFIED ON THE GROUND PRIOR TO ANY CONSTRUCTION. CALL (811) AT LEAST TWO WORKING DAYS IN ADVANCE. THE OWNER AND HIS/HER ENGINEER SHALL BE CONTACTED IMMEDIATELY IF A CONFLICT EXISTS.
- ANY STRUCTURE AND/OR OBSTRUCTION THAT REQUIRES REMOVAL OR RELOCATION RELATING TO THIS PROJECT SHALL BE DONE SO AT THE DEVELOPER'S EXPENSE.
- LOCATIONS OF EXISTING UTILITIES ARE APPROXIMATE. IT SHALL BE THE CONTRACTOR'S RESPONSIBILITY TO DETERMINE THE TRUE ELEVATIONS AND LOCATIONS OF HIDDEN UTILITIES. ALL VISIBLE ITEMS SHALL BE THE ENGINEER'S RESPONSIBILITY.
- THE CONTRACTOR SHALL INSTALL, REPLACE, OR RELOCATE ALL SIGNS, AS SHOWN ON THE PLANS OR AS AFFECTED BY CONSTRUCTION, PER CITY STANDARDS.
- 10. POWER, STREET LIGHT, CABLE, AND TELEPHONE LINES SHALL BE IN A TRENCH LOCATED WITHIN A 10-FOOT UTILITY EASEMENT ADJACENT TO PUBLIC RIGHT-OF-WAY. RIGHT-OF-WAY CROSSINGS SHALL HAVE A MINIMUM HORIZONTAL SEPARATION FROM OTHER UTILITIES (SEWER, WATER, AND STORM) OF 5 FEET.
- ALL CONSTRUCTION SURVEYING FOR EXTENSIONS OF PUBLIC FACILITIES SHALL BE DONE UNDER THE DIRECTION OF A WASHINGTON STATE LICENSED LAND SURVEYOR OR A WASHINGTON STATE LICENSED PROFESSIONAL CIVIL ENGINEER.
- 12. DURING CONSTRUCTION, ALL PUBLIC STREETS ADJACENT TO THIS PROJECT SHALL BE KEPT CLEAN OF ALL MATERIAL DEPOSITS RESULTING FROM ON-SITE CONSTRUCTION, AND EXISTING STRUCTURES SHALL BE PROTECTED AS DIRECTED BY THE CITY.
- CERTIFIED RECORD DRAWINGS ARE REQUIRED PRIOR TO PROJECT ACCEPTANCE.
- A NPDES STORMWATER GENERAL PERMIT MAY BE REQUIRED BY THE DEPARTMENT OF ECOLOGY FOR THIS PROJECT. FOR INFORMATION CONTACT THE DEPARTMENT OF ECOLOGY, SOUTHWEST REGION OFFICE AT (360)407-6300.
- ANY DISTURBANCE OR DAMAGE TO CRITICAL AREAS AND ASSOCIATED BUFFERS, OR SIGNIFICANT TREES DESIGNATED FOR PRESERVATION AND PROTECTION SHALL BE MITIGATED IN ACCORDANCE WITH A MITIGATION PLAN REVIEWED AND APPROVED BY THE CITY'S PLANNING DIVISION. PREPARATION AND IMPLEMENTATION OF THE MITIGATION PLAN SHALL BE AT THE DEVELOPER'S EXPENSE.

- FLAGGED IN THE FIELD AND OBSERVED DURING CONSTRUCTION.
- ALL REQUIRED SEDIMENTATION AND EROSION CONTROL FACILITIES MUST BE CONSTRUCTED AND IN OPERATION PRIOR TO ANY LAND CLEARING AND/OR OTHER CONSTRUCTION TO ENSURE THAT SEDIMENT LADEN WATER DOES NOT ENTER THE NATURAL DRAINAGE SYSTEM. THE CONTRACTOR SHALL SCHEDULE AN INSPECTION OF THE EROSION CONTROL FACILITIES PRIOR TO ANY LAND CLEARING AND/OR OTHER CONSTRUCTION. ALL EROSION AND SEDIMENT FACILITIES SHALL BE MAINTAINED IN SATISFACTORY CONDITION AS DETERMINED BY THE CITY, UNTIL SUCH TIME THAT CLEARING AND/OR OTHER CONSTRUCTION IS COMPLETED AND THE POTENTIAL FOR ON-SITE EROSION HAS PASSED. THE IMPLEMENATION. MAINTENANCE, REPLACEMENT, AND ADDITIONS TO THE EROSION AND SEDIMENTATION CONTROL SYSTEMS SHALL BE THE RESPONSIBILITY OF THE PERMITEE.
- THE EROSION AND SEDIMENTATION CONTROL SYSTEM FACILITIES DEPICTED ON THESE PLANS ARE INTENDED TO BE MINIMUM REQUIREMENTS TO MEET ANTICIPATED SITE CONDITIONS. AS CONSTRUCTION PROGRESSES AND UNEXPECTED OR SEASONAL CONDITIONS DICTATE, FACILITIES WILL BE NECESSARY TO ENSURE COMPLETE SILTATION CONTROL ON THE SITE. DURING THE COURSE OF CONSTRUCTION, IT SHALL BE THE OBLIGATION AND RESPONSIBILITY OF THE PERMITTEE TO ADDRESS ANY NEW CONDITIONS THAT MAY BE CREATED BY HIS ACTIVITIES AND TO PROVIDE ADDITIONAL FACILITIES, OVER AND ABOVE THE MINIMUM REQUIREMENTS, AS MAY BE NEEDED TO PROTECT ADJACENT PROPERTIES, SENSITIVE AREAS, NATURAL WATER COURSES, AND/OR
- APPROVAL OF THESE PLANS IS FOR GRADING, TEMPORARY DRAINAGE, EROSION AND SEDIMENTATION CONTROL ONLY. IT DOES NOT CONSTITUTE AN APPROVAL OF PERMANENT STORM DRAINAGE DESIGN, SIZE OR LOCATION OF PIPES, RESTRICTORS, CHANNELS, OR RETENTION FACILITIES.
- ANY DISTURBED AREA WHICH HAS BEEN STRIPPED OF VEGETATION AND WHERE NO FURTHER WORK IS ANTICIPATED FOR A PERIOD OF 30 DAYS OR MORE, MUST BE IMMEDIATELY STABILIZED WITH MULCHING, GRASS PLANTING, OR OTHER APPROVED EROSION CONTROL TREATMENT APPLICABLE TO THE TIME OF YEAR IN QUESTION. GRASS SEEDING ALONE WILL BE ACCEPTABLE ONLY DURING THE MONTHS OF APRIL THROUGH SEPTEMBER INCLUSIVE. SEEDING MAY PROCEED OUTSIDE THE SPECIFIED TIME PERIOD WHENEVER IT IS IN THE INTEREST OF THE PERMITTEE BUT MUST BE AUGMENTED WITH MULCHING, NETTING, OR OTHER TREATMENT APPROVED BY THE CITY.
- 12. IN CASE EROSION OR SEDIMENTATION OCCURS TO ADJACENT PROPERTIES, ALL CONSTRUCTION WORK WITHIN THE DEVELOPMENT THAT WILL FURTHER AGGRAVATE THE SITUATION MUST CEASE, AND THE OWNER/CONTRACTOR WILL IMMEDIATELY COMMENCE RESTORATION METHODS. RESTORATION ACTIVITY WILL
- 13. NO TEMPORARY OR PERMANENT STOCKPILING OF MATERIALS OR EQUIPMENT SHALL OCCUR WITHIN CRITICAL AREAS OR ASSOCIATED BUFFERS, OR THE CRITICAL ROOT ZONE FOR VEGETATION PROPOSED FOR RETENTION.

PARKING LOT STRIPING SPECIFICATIONS

- SURFACES SHOULD BE CLEAN, DRY, AND FREE FROM LOOSE OR PEELING PAINT. REMOVE ALL OIL, DUST, GREASE, DIRT, AND OTHER FOREIGN MATERIAL TO
- ENSURE ADEQUATE ADHESION. DO NOT APPLY WHEN AIR OR SURFACE TEMPERATURES ARE BELOW 40°F.
- WHITE OR A303 YELLOW USING EITHER AIRLESS OR CONVENTIONAL LINE STRIPING EQUIPMENT. USE THE FOLLOWING SETTINGS AS A GUIDE-ACTUAL SETTINGS DEPEND ON ATMOSPHERIC CONDITIONS AT THE TIME OF APPLICATION:

1800-2700 PSI $\frac{1}{4}$ "- $\frac{3}{8}$ " ID 0.015"-0.017"

 FILTER 60 MESH

VM&P NAPTHA R1K3

 ATOMIZATION PRESSURE 45-80 PSI

USE. APPLY AT 15 MILS WET PER COAT (2 COATS REQUIRED). APPLIED AT THIS RATE AT 70°F AND 50% RELATIVE HUMIDITY, PAINT WILL DRY WITH NO TRAFFIC PICKUP AFTER 20 MINUTES.

CITY OF PUYALLUP GRADING, EROSION AND SEDIMENT CONTROL NOTES - REVISED 06/06/2012 CITY OF PUYALLUP STORMWATER NOTES - REVISED 06/06/2012

- ALL LIMITS OF CLEARING AND AREAS OF VEGETATION PRESERVATION AS PRESCRIBED ON THE PLANS SHALL BE CLEARLY
- STORM DRAINAGE SYSTEMS.
- CONTINUE UNTIL SUCH TIME AS THE AFFECTED PROPERTY OWNER IS SATISFIED.

- ALWAYS FOLLOW ALL APPLICABLE GOVERNING AUTHORITY'S STANDARDS.
- 3. APPLY SHERWIN-WILLIAMS SETFAST PREMIUM ALKYD ZONE MARKING PAINT A300

 PRESSURE HOSE TIP

 REDUCTION ONLY IF NECESSARY, UP TO 1PT/GAL

CONVENTIONAL

GUN BLINKS 21 (BLEEDER) OR EQUIVALENT FLUID NOZZLE AIR NOZZLE INTERNAL MIX, #709

• FLUID PRESSURE 40-70 PSI ONLY IF NECESSARY, UP TO 1PT/GAL REDUCTION VM&P NAPTHA R1K3

• MIX PAINT THOROUGHLY BY BOXING, STIRRING, OR POWER AGITATION BEFORE

GENERAL CONTRACTOR TO RE-STRIPE THE LOT 45 DAYS AFTER OPENING.

MOMENTUM CIVIL 1145 BROADWAY, SUITE 115 TACOMA, WA 98402

15. TRENCHING, BEDDING, AND BACKFILL FOR PIPE SHALL CONFORM TO CITY STANDARD DETAIL NO. 06.01.01.

FOR PIPE SIZES 18 TO 27 INCH. MINIMUM COVER ON PVC PIPE SHALL BE 3.0 FEET.

- 16. STORM PIPE SHALL BE A MINIMUM OF 10 FEET AWAY FROM BUILDING FOUNDATIONS AND/OR ROOF LINES.
- 17. ALL STORM DRAIN MAINS SHALL BE TESTED AND INSPECTED FOR ACCEPTANCE AS OUTLINED IN SECTION 406 OF THE CITY OF PUYALLUP SANITARY SEWER SYSTEM STANDARDS.
- 18. ALL TEMPORARY SEDIMENTATION AND EROSION CONTROL MEASURES, AND PROTECTIVE MEASURES FOR CRITICAL AREAS AND SIGNIFICANT TREES SHALL BE INSTALLED PRIOR TO INITIATING ANY CONSTRUCTION ACTIVITIES.

CITY OF PUYALLUP WATER SYSTEM NOTES

- ALL WORK IN CITY RIGHT-OF-WAY REQUIRES A PERMIT FROM THE CITY OF PUYALLUP. PRIOR TO ANY WORK COMMENCING, THE GENERAL CONTRACTOR SHALL ARRANGE FOR A PRECONSTRUCTION MEETING AT THE DEVELOPMENT SERVICES CENTER TO BE ATTENDED BY ALL CONTRACTORS THAT WILL PERFORM WORK SHOWN ON THE ENGINEERING PLANS, REPRESENTATIVES FROM ALL APPLICABLE UTILITY COMPANIES, THE PROJECT OWNER AND APPROPRIATE CITY STAFF. CONTACT ENGINEERING SERVICES TO SCHEDULE THE MEETING (253) 841-5568. THE CONTRACTOR IS RESPONSIBLE TO HAVE THEIR OWN APPROVED SET OF PLANS AT THE MEETING
- AFTER COMPLETION OF ALL ITEMS SHOWN ON THESE PLANS AND BEFORE ACCEPTANCE OF THE PROJECT, THE CONTRACTOR SHALL OBTAIN A "PUNCH LIST" PREPARED BY THE CITY'S INSPECTOR DETAILING REMAINING ITEMS OF WORK TO BE COMPLETED. ALL ITEMS OF WORK SHOWN ON THESE PLANS SHALL BE COMPLETED TO THE SATISFACTION OF THE CITY PRIOR TO ACCEPTANCE OF THE WATER SYSTEM AND PROVISION OF SANITARY SEWER SERVICE.
- ALL MATERIALS AND WORKMANSHIP SHALL CONFORM TO THE STANDARD SPECIFICATIONS FOR ROAD, BRIDGE, AND MUNICIPAL CONSTRUCTION (HEREINAFTER REFERRED TO AS THE "STANDARD SPECIFICATIONS"), WASHINGTON STATE DEPARTMENT OF TRANSPORTATION AND AMERICAN PUBLIC WORKS ASSOCIATION, WASHINGTON STATE CHAPTER, LATEST EDITION, UNLESS SUPERSEDED OR AMENDED BY THE CITY OF PUYALLUP CITY STANDARDS FOR PUBLIC WORKS ENGINEERING AND CONSTRUCTION (HEREINAFTER REFERRED TO AS THE "CITY STANDARDS"), OR AS DIRECTED BY FRUITLAND MUTUAL WATER COMPANY (FMWC), VALLEY WATER (VW), OR TACOMA CITY WATER (TCW) IS THE PURVEYOR.
- A COPY OF THESE APPROVED PLANS AND APPLICABLE CITY DEVELOPER SPECIFICATIONS AND DETAILS SHALL BE ON SITE DURING
- CONSTRUCTION. ANY REVISIONS MADE TO THESE PLANS MUST BE REVIEWED AND APPROVED BY THE DEVELOPER'S ENGINEER, THE ENGINEERING SERVICES STAFF, AND THE FMWC, VW OR TCW WHEN SERVED BY THAT PURVEYOR, PRIOR TO ANY IMPLEMENTATION IN THE FIELD. THE CITY SHALL NOT BE RESPONSIBLE FOR ANY ERRORS AND/OR OMISSIONS ON THESE PLANS.
- THE CONTRACTOR SHALL HAVE ALL UTILITIES VERIFIED ON THE GROUND PRIOR TO ANY CONSTRUCTION. CALL (811) AT LEAST TWO WORKING DAYS IN ADVANCE. THE OWNER AND HIS/HER ENGINEER SHALL BE CONTACTED IMMEDIATELY IF A CONFLICT EXISTS.
- ANY STRUCTURE AND/OR OBSTRUCTION WHICH REQUIRES REMOVAL OR RELOCATION RELATING TO THIS PROJECT SHALL BE DONE SO AT
- BACTERIOLOGICAL (COLIFORM AND IRON BACTERIA) TEST SAMPLES WILL BE TAKEN BY THE CITY (OR FMWC, VW OR TCW WHEN SERVED BY THAT PURVEYOR) AND PAID FOR BY THE CONTRACTOR, EXCEPT FOR CAPITAL IMPROVEMENT PROJECTS (CIP) WHICH SHALL BE PAID FOR
- WATER MAINS SHALL HAVE A MINIMUM COVER OF 36 INCHES FROM PAVED FINAL GRADE IN IMPROVED RIGHT-OF-WAY AND IMPROVED EASEMENTS, AND A MINIMUM OF 48 INCHES IN UNIMPROVED RIGHT-OFWAY AND UNIMPROVED EASEMENTS.
- 10. PIPE FOR WATER MAINS SHALL BE DUCTILE IRON CONFORMING TO SECTION 7-09 OF THE STANDARD SPECIFICATIONS, CLASS 52 WITH TYTON OR APPROVED EQUAL JOINTS. PIPE SHALL BE CEMENT LINED IN ACCORDANCE WITH A.S.A. SPECIFICATION A 21.4-1964.
- . CONNECTIONS TO EXISTING WATER MAINS TYPICALLY SHALL BE WET TAPS THROUGH A TAPPING TEE AND TAPPING VALVE AND SHALL BE MADE BY A CITY APPROVED CONTRACTOR. THE TAPPING SLEEVE SHALL BE ROMAC SST ALL STAINLESS STEEL TAPPING SLEEVE OR APPROVED EQUAL. A TWO-PIECE EPOXY COATED OR DUCTILE IRON TAPPING SLEEVE MAY BE USED ON DUCTILE IRON PIPE, WHEN THE TAP IS SMALLER THAN THE WATER MAIN SIZE I.E. 6-INCH TAP ON 8-INCH PIPE. THE CITY (OR FMWC, VW OR TCW WHEN SERVED BY THAT PURVEYOR) SHALL APPROVE THE TIME AND LOCATION FOR THESE CONNECTIONS.
- 12. ALL WATER MAINS AND APPURTENANCES SHALL BE HYDROSTATICALLY TESTED AT 200 PSI IN ACCORDANCE WITH STANDARD SPECIFICATION 7-09.3(23). PRESSURE TESTING SHALL NOT BE PERFORMED UNTIL SATISFACTORY PURITY SAMPLES HAVE BEEN RECEIVED, EXCEPT WHEN NEW WATER MAINS ARE INSTALLED INDEPENDENTLY FROM THE WATER SYSTEM PIPING.
- 13. FIRE HYDRANTS SHALL BE INSTALLED IN ACCORDANCE WITH CITY STANDARD DETAIL 03.05.01 AND AS DIRECTED BY THE CITY OF PUYALLUP FIRE CODE OFFICIAL
- 14. VALVE MARKER POSTS SHALL BE INSTALLED WHERE VALVE BOXES ARE HIDDEN FROM VIEW OR IN UNPAVED AREAS. THE INSTALLATION SHALL BE IN ACCORDANCE WITH CITY STANDARD DETAIL 03.01.02.
- 15. RESILIENT SEATED WEDGE GATE VALVES SHALL BE USED FOR 10-INCH MAINS AND SMALLER. BUTTERFLY VALVES SHALL BE USED FOR MAINS GREATER THAN 10 INCHES.
- 16. PIPE FITTING FOR WATER MAINS SHALL BE DUCTILE IRON AND SHALL BE MECHANICAL JOINT CONFORMING TO AWWA SPECIFICATION
- 17. WATER MAIN PIPE AND SERVICE CONNECTIONS SHALL BE A MINIMUM OF 10 FEET AWAY FROM BUILDING FOUNDATIONS AND/OR ROOF
- 18. WHERE A WATER MAIN CROSSES THE NORTHWEST GAS PIPELINE, THE WATER LINE SHALL BE CASED WITH PVC PIPE A MINIMUM OF 10 FEET BEYOND EACH SIDE OF THE GAS LINE EASEMENT. CONTACT WILLIAMS NORTHWEST PIPELINE BEFORE THE CROSSING IS MADE.
- 19. TRENCHING, BEDDING, AND BACKFILL FOR WATER MAINS SHALL BE INSTALLED IN ACCORDANCE WITH CITY STANDARD DETAIL 06.01.01.
- 20. ALL COMMERCIAL AND INDUSTRIAL DEVELOPMENTS, IRRIGATION SYSTEMS, AND MULTI-FAMILY WATER SERVICE CONNECTIONS SHALL BE PROTECTED BY A DOUBLE CHECK VALVE ASSEMBLY OR A REDUCED PRESSURE BACKFLOW ASSEMBLY AS DIRECTED BY THE CITY (OR FMWC, VW OR TCW WHEN SERVED BY THAT PURVEYOR) CONFORMING TO CITY STANDARD DETAILS 03.04.01, 03.04.02, AND 03.04.03.
- 21. ANY LEAD JOINT FITTING DISTURBED DURING CONSTRUCTION SHALL BE REPLACED WITH A MECHANICAL JOINT FITTING AT THE
- 22. WHEN HYDRAULIC FIRE FLOW MODELING IS REQUIRED FOR A PROJECT, THE CITY WILL ISSUE A PERMIT. THE HYDRAULIC MODELING CRITERIA IS BASED ON THE PROJECTED 2030 WATER DEMAND, WHILE MAINTAINING A MINIMUM SYSTEM PRESSURE OF 20 POUNDS PER SQUARE INCH AND A MAXIMUM VELOCITY OF 10 FEET PER SECOND.
- 23. WHEN USING A FIRE HYDRANT FOR NON-FIREFIGHTING PURPOSES, A CITY HYDRANT METER MUST BE USED. COORDINATE THE ACQUISITION OF THE HYDRANT METER WITH THE CITY'S UTILITY BILLING DIVISION AT PUYALLUP CITY HALL. A CITY APPROVED BACKFLOW PROTECTION ASSEMBLY SHALL BE INSTALLED BY THE PERSON REQUESTING USE OF A FIRE HYDRANT. THE ASSEMBLY SHALL BE ACCOMPANIED BY A CURRENT BACKFLOW ASSEMBLY TEST REPORT. THE TEST REPORT SHALL BE AVAILABLE AT THE SITE FOR THE DURATION OF THE HYDRANT USE.
- 24. SHOULD A BREAK OCCUR ON ANY CITY WATER MAIN, THE CONTRACTOR SHALL FOLLOW THE CITY'S ADOPTED "WATER MAIN BREAK PROCEDURE" ISSUED TO THEM AT THE PRE-CONSTRUCTION MEETING AND NOTIFY THOSE CONNECTED TO THE SYSTEM IN THE IMPACTED AREA AS OUTLINED IN THE PROCEDURE.
- 25. WATER MAIN REPAIRS (REFERENCES: AWWA C651-14 AND WSDOT STANDARD SPECIFICATION SECTION 7-09) (NOTE: A PLANNED WATER
- MAIN REPAIR SHALL BE APPROVED BY THE CITY INSPECTOR AND/OR WATER DIVISION SUPERVISOR PRIOR TO COMMENCING WORK.) REPAIR WITHOUT DEPRESSURIZATION - SMALL LEAKS SHALL BE REPAIRED USING REPAIR BANDS WHILE MAINTAINING POSITIVE PRESSURE IN THE WATER MAIN. VALVES SURROUNDING THE LEAK WILL BE PARTIALLY SHUT BY THE CITY WATER DEPARTMENT TO REDUCE THE FLOW AND PRESSURE TO THE AREA. BLOWOFFS AND HYDRANTS IN THE REDUCED PRESSURE AREA MAY BE OPENED AS NEEDED TO FURTHER REDUCE THE PRESSURE. THE WATER MAIN TRENCH SHALL BE OVER-EXCAVATED TO ALLOW WATER IN THE TRENCH TO BE PUMPED OUT AND MAINTAINED BELOW THE LEVEL OF THE WATER MAIN. THE REPAIR SHALL BE COMPLETED WITH THE WATER MAIN PRESSURE REMAINING POSITIVE. AFTER THE REPAIR IS MADE, THE SYSTEM SHALL BE FULLY PRESSURIZED AND A VISUAL LEAK INSPECTION WILL BE COMPLETED. THE WATER MAIN IN THE AFFECTED AREA SHALL BE FLUSHED TO ACHIEVE THREE PIPE VOLUMES PULLED FROM THE PIPE (DISTANCE MEASURED FROM VALVE OPENED FOR FLUSHING TO THE EXIT HYDRANT OR BLOWOFF).
- REPAIR/CUT-IN WITH DEPRESSURIZATION TRENCH SHALL BE OVER EXCAVATED AND DEWATERED BELOW THE WATER MAIN. FLUSH WATER FROM PIPE FROM EACH DIRECTION UNTIL IT RUNS CLEAR. IMMEDIATELY PRIOR TO INSTALLATION OF A NEW PIPE SECTION FOR REPAIR OR CUT IN TEE, ALL NEW FITTINGS AND PIPE SPOOLS SHALL BE SWABBED WITH A FIVE PERCENT (5%) CHLORINE SOLUTION (MINIMUM). THE INTERIOR OF THE EXISTING PIPE SHALL BE SWABBED WITH A FIVE PERCENT (5%) CHLORINE SOLUTION AT LEAST 6 FEET IN EACH DIRECTION FROM EXPOSED CUT ENDS. THE WATER MAIN IN THE AFFECTED AREA SHALL BE FLUSHED TO ACHIEVE THREE PIPE VOLUMES PULLED FROM THE PIPE (DISTANCE MEASURED FROM THE VALVE OPENED FOR FLUSHING TO THE EXIT HYDRANT OR BLOWOFF). CUSTOMERS SHALL BE NOTIFIED AFTER THE WATER MAIN IS FLUSHED AND REPAIRS HAVE BEEN COMPLETED, AS OUTLINED IN THE "WATER MAIN BREAK PROCEDURE."
- 26. NEW WATER MAIN INSTALLATION:
- EACH NEW WATER MAIN SECTION SHALL BE DELIVERED, STACKED AND STORED ONSITE WITH ENDS PLUGGED. THE PLUGS SHALL REMAIN IN THE PIPE UNTIL EACH PARTICULAR SECTION IS INSTALLED. NATIONAL SANITATION FOUNDATION (NSF) APPROVED SIXTY-FIVE PERCENT (65%) CALCIUM HYPOCHLORITE SHALL BE ADDED TO THE UPSTREAM END OF EACH PIPE SECTION, AND AT EACH HYDRANT TEE IN THE AMOUNT GIVEN IN THE TABLE BELOW (OR PER APPROVED MANUFACTURER SPECIFICATIONS). THE MINIMUM AMOUNT OF CALCIUM HYPOCHLORITE ADDED SHOULD BE SUFFICIENT TO ACHIEVE A 50 MG/L CONCENTRATION WITHIN THE IMPACTED AREA.
- NEW WATER MAINS SHALL BE FILLED USING AN APPROVED BACKFLOW PREVENTION ASSEMBLY. THE WATER MAIN SHALL BE FILLED FROM THE LOWER ELEVATION END SO THAT AS THE WATER MAIN IS FILLED, THE CHORINE IS CONTACTED, DISSOLVED AND SPREAD RELATIVELY UNIFORM THROUGH THE LENGTH OF THE NEW WATER MAIN. THE FILL RATE SHALL BE MINIMIZED SO THAT THE VELOCITY OF THE WATER IS LESS THAN 1 FT/SEC (SEE TABLE ABOVE). SUCCESSFUL PRESSURE TEST AND BACTERIOLOGICAL TESTS SHALL BE COMPLETED AND PROVIDED TO THE CITY PRIOR TO ANY NEW MATER MAIN CONNECTION TO THE EXISTING WATER SYSTEM.
- THE CHLORINATED WATER WILL BE ALLOWED TO REMAIN IN CONTACT WITH THE NEW WATER MAIN SYSTEM FOR 24 TO 72 HOURS. AFTER 24 HOURS, WATER MAY BE ADDED TO THE WATER MAIN FOR THE PURPOSES OF PRESSURE TESTING. THE WATER IN THE MAIN USED FOR PRESSURE TESTING MUST REMAIN IN THE WATER MAIN UNTIL PRESSURE TEST IS COMPLETED. IF NECESSARY, LIQUID CHLORINE SHALL BE INJECTED INTO THE WATER MAIN WITH FILL WATER TO MAINTAIN A CONCENTRATION IN THE WATER MAIN ABOVE 50 MG/L. UNDER NO CIRCUMSTANCE SHALL "SUPER" CHLORINATED WATER BE ALLOWED TO SIT WITHIN A NEW WATER MAIN FOR MORE THAN 5 DAYS.

- PRESSURE TESTING INCLUDES TESTING AGAINST NEW VALVES AND HYDRANTS. EACH VALVE SHALL BE TESTED BY CLOSING EACH IN TURN AND REDUCING THE PRESSURE BEYOND THE VALVE. THE PRESSURE ON THE BACK SIDE OF THE VALVE SHOULD NOT BE ELIMINATED. CARE MUST BE TAKEN THAT, DURING THIS PROCESS, POSITIVE PRESSURE REMAINS THROUGHOUT THE SYSTEM BEING TESTED AT ALL TIMES. ALL HYDRANT FOOT VALVES SHALL BE OPEN DURING PRESSURE TESTING SO THAT THE PRESSURE TEST IS AGAINST THE HYDRANT VALVE. PRESSURE TESTING WILL NOT BE ALLOWED AGAINST ANY EXISTING VALVES.
- AFTER SUCCESSFUL PRESSURE TESTING, THE WATER MAIN SHALL BE THOROUGHLY FLUSHED TO REMOVE ALL "SUPER" CHLORINATED WATER FROM THE NEW WATER MAIN. FLUSHING OF NEW OR EXTENDED WATER MAINS SHALL BE CONDUCTED PER WSDOT SPECIFICATION 7-09.3(24)A WITH A MINIMUM VELOCITY DEVELOPED WITHIN THE PIPE WHILE FLUSHING OF 2.5 FEET PER SECOND (FPS) ALL FLUSHED WATER SHALL BE DECHLORINATED PRIOR TO DISPOSAL. THE CONTRACTOR SHALL BE RESPONSIBLE FOR DISPOSAL OF ALL CHLORINATED WATER FLUSHED FROM MAINS. THE CITY SHALL APPROVE THE DISPOSAL METHOD PRIOR TO IMPLEMENTATION IN THE FIELD. THE CONTRACTOR SHALL UTILIZE ONSITE DISPOSAL METHODS, IF AVAILABLE. DISPOSAL OF FLUSH WATER TO THE SANITARY SEWER SYSTEM SHALL NOT BE ALLOWED WITHOUT WRITTEN PERMISSION FROM THE WATER POLLUTION CONTROL PLANT (WPCP) SUPERVISOR. ANY PLANNED DISCHARGE TO A STORMWATER SYSTEM SHALL BE DECHLORINATED TO A CONCENTRATION OF 0.1 PPM OR LESS, PH ADJUSTED (IF NECESSARY) TO BE BETWEEN 6.5 AND 8.5, AND VOLUMETRICALLY AND VELOCITY CONTROLLED TO PREVENT ANY RESUSPENSION OF SEDIMENTS. THE CITY WILL REQUIRE INDEPENDENT TESTING THROUGHOUT THE WATER DISCHARGE PROCESS TO ENSURE COMPLIANCE OF THESE STANDARDS ARE MET.
- SAMPLES FOR BACTERIOLOGICAL ANALYSIS SHALL BE COLLECTED AFTER FLUSHING AND AGAIN 24 HOURS AFTER THE FIRST SET OF SAMPLES.
- ALL CLOSURE/FINAL CONNECTION FITTINGS SHALL BE SPRAYED CLEAN AND THEN SWABBED WITH A FIVE PERCENT (5%) CHLORINE SOLUTION IMMEDIATELY PRIOR TO INSTALLATION PER AWWA STANDARD C651. ADDITIONAL SAMPLES FOR BACTERIOLOGICAL ANALYSIS SHALL BE COLLECTED FROM THE IMMEDIATE VICINITY OF THE NEW OR REPLACED WATER MAIN AND ANALYZED AFTER THE FINAL CONNECTIONS ARE MADE. IF NECESSARY, ADDITIONAL FLUSHING SHALL BE CONDUCTED AND ADDITIONAL SAMPLES SHALL BE COLLECTED UNTIL SATISFACTORY RESULTS ARE OBTAINED.


	Pipe Volume	5-gram	Hypochlorite Granules		Maximum
Pipe Diameter (Inches)	per 18 feet (gal)	tablets per pipe section	Ounces per 500 feet	Teaspoons per 18 feet	Fill Rate (gpm)_
4	35	1	1.7	0.2	40
6	53	1	3.8	0.4	90
8	70	2	6.7	0.7	150
12	106	4	15.1	1.4	350
16	141	6	27	2.5	600

CITY OF PUYALLUP SEWER SYSTEM NOTES

- 1. ALL WORK IN CITY RIGHT-OF-WAY REQUIRES A PERMIT FROM THE CITY OF PUYALLUP. PRIOR TO ANY WORK COMMENCING, THE GENERAL CONTRACTOR SHALL ARRANGE FOR A PRECONSTRUCTION MEETING AT THE DEVELOPMENT SERVICES CENTER TO BE ATTENDED BY ALL CONTRACTORS THAT WILL PERFORM WORK SHOWN ON THE ENGINEERING PLANS, REPRESENTATIVES FROM ALL APPLICABLE UTILITY COMPANIES, THE PROJECT OWNER AND APPROPRIATE CITY STAFF. CONTACT ENGINEERING SERVICES TO SCHEDULE THE MEETING (253) 841-5568. THE CONTRACTOR IS RESPONSIBLE TO HAVE THEIR OWN APPROVED SET OF PLANS AT THE MEETING.
- 2. AFTER COMPLETION OF ALL ITEMS SHOWN ON THESE PLANS AND BEFORE ACCEPTANCE OF THE PROJECT, THE CONTRACTOR SHALL OBTAIN A "PUNCH LIST" PREPARED BY THE CITY'S INSPECTOR DETAILING REMAINING ITEMS OF WORK TO BE COMPLETED. ALL ITEMS OF WORK SHOWN ON THESE PLANS SHALL BE COMPLETED TO THE SATISFACTION OF THE CITY PRIOR TO ACCEPTANCE OF THE SEWER SYSTEM AND PROVISION OF SANITARY SEWER SERVICE.
- ALL MATERIALS AND WORKMANSHIP SHALL CONFORM TO THE STANDARD SPECIFICATIONS FOR ROAD, BRIDGE, AND MUNICIPAL CONSTRUCTION (HEREINAFTER REFERRED TO AS THE "STANDARD SPECIFICATIONS"), WASHINGTON STATE DEPARTMENT OF TRANSPORTATION AND AMERICAN PUBLIC WORKS ASSOCIATION, WASHINGTON STATE CHAPTER, LATEST EDITION, UNLESS SUPERSEDED OR AMENDED BY THE CITY OF PUYALLUP CITY STANDARDS FOR PUBLIC WORKS ENGINEERING AND CONSTRUCTION (HEREINAFTER REFERRED TO AS THE "CITY STANDARDS").
- A COPY OF THESE APPROVED PLANS AND APPLICABLE CITY DEVELOPER SPECIFICATIONS AND DETAILS SHALL BE ON SITE DURING
- ANY REVISIONS MADE TO THESE PLANS MUST BE REVIEWED AND APPROVED BY THE DEVELOPER'S ENGINEER AND THE ENGINEERING SERVICES STAFF PRIOR TO ANY IMPLEMENTATION IN THE FIELD. THE CITY SHALL NOT BE RESPONSIBLE FOR ANY ERRORS AND/OR
- 6. THE CONTRACTOR SHALL HAVE ALL UTILITIES VERIFIED ON THE GROUND PRIOR TO ANY CONSTRUCTION. CALL (811) AT LEAST TWO WORKING DAYS IN ADVANCE. THE OWNER AND HIS/HER ENGINEER SHALL BE CONTACTED IMMEDIATELY IF A CONFLICT EXISTS.
- 7. ANY STRUCTURE AND/OR OBSTRUCTION WHICH REQUIRE REMOVAL OR RELOCATION RELATING TO THIS PROJECT SHALL BE DONE SO AT THE DEVELOPER'S EXPENSE.
- MINIMUM GRADE ON ALL 4 INCH RESIDENTIAL SIDE SEWERS SHALL BE 2 PERCENT AND 6 INCH COMMERCIAL SIDE SEWERS SHALL BE 1 PERCENT; MAXIMUM SHALL BE 8 PERCENT. ALL SIDE SEWERS SHALL BE 6 INCHES WITHIN CITY RIGHT-OF-WAY.
- 9. SIDE SEWERS SHALL BE INSTALLED IN ACCORDANCE WITH CITY STANDARD NOS. 04.03.01, 04.03.02, 04.03.03 AND 04.03.04. SIDE SEWER
- INSTALLATION WORK SHALL BE DONE IN ACCORDANCE WITH THE WASHINGTON INDUSTRIAL SAFETY AND HEALTH ACT (WISHA). 10. ALL SEWER PIPE SHALL BE PVC, POLYPROPYLENE, OR DUCTILE IRON. PVC SEWER PIPE SHALL CONFORM TO ASTM D-3034, SDR35 FOR PIPE SIZES 15-INCH AND SMALLER AND ASTM F679 FOR PIPE SIZES 18- TO 27-INCH, DUCTILE IRON PIPE SHALL BE CLASS 51 OR GREATER, LINED WITH PROTECTO 401TM EPOXY LINING OR EQUIVALENT, UNLESS OTHERWISE NOTED. 12-INCH THROUGH 30-INCH POLYPROPYLENE PIPE (PP) SHALL BE DUAL WALLED, HAVE A SMOOTH INTERIOR AND EXTERIOR CORRUGATIONS AND MEET WSDOT 9-05.24(2). IT SHALL MEET OR EXCEED ASTM F2764. 36-INCH THROUGH 60-INCH PP PIPE SHALL BE TRIPLE WALLED AND MEET WSDOT 9-05.24(2). IT SHALL MEET OR EXCEED ASTM F2764. PP SHALL HAVE A MINIMUM PIPE STIFFNESS OF 46 PII WHEN TESTED IN ACCORDANCE WITH ASTM D2412. TESTING SHALL BE PER ASTM F1417. TRENCHING, BEDDING, AND BACKFILL SHALL BE IN ACCORDANCE WITH CITY STANDARD NO. 06.01.01.

MINIMUM COVER ON PVC AND PP PIPE SHALL BE 3.0 FEET. MINIMUM COVER ON DUCTILE IRON PIPE SHALL BE 1.0 FOOT.


- 11. SANITARY SEWER MANHOLE FRAMES AND COVERS SHALL CONFORM TO CITY STANDARD NO. 06.01.02. 12. SANITARY SEWER MANHOLES SHALL CONFORM TO CITY STANDARD NOS. 04.01.01, 04.01.02, 04.01.03 AND 04.01.04. ALL MANHOLES SHALL BE CHANNELED FOR FUTURE LINES AS SPECIFIED ON THESE PLANS. MANHOLE STEPS AND LADDER SHALL CONFORM TO STANDARD NO. 06.01.03.
- 13. SANITARY SEWER PIPE AND SIDE SEWERS SHALL BE 10 FEET AWAY FROM BUILDING FOUNDATIONS AND/OR ROOF LINES WITH THE EXCEPTION OF SIDE SEWERS THAT PROVIDE SERVICE TO A SINGLE-FAMILY RESIDENCE. AT THE DISCRETION OF THE REVIEW ENGINEER, A LICENSED PROFESSIONAL ENGINEER WILL BE REQUIRED TO STAMP THE DESIGN TO ACCOUNT FOR DEPTH OR PROXIMITY TO FOUNDATION, STEEP SLOPES, OR OTHER FACTORS.
- 14. NO SIDE SEWERS SHALL BE CONNECTED TO ANY HOUSE OR BUILDING UNTIL ALL MANHOLES ARE ADJUSTED TO THE FINISHED GRADE OF THE COMPLETED ASPHALT ROADWAY AND THE ASPHALT PATCH AND SEAL AROUND THE RING ARE ACCEPTED.
- 15. FOR COMMERCIAL DEVELOPMENTS IN WHICH SOURCES OF GREASE AND/OR OILS MAY BE INTRODUCED TO THE CITY SANITARY SEWER SYSTEM, A CITY APPROVED GREASE INTERCEPTOR SHALL BE INSTALLED DOWNSTREAM FROM THE SOURCE.
- 16. ONCE SEWER AND ALL OTHER UTILITY CONSTRUCTION IS COMPLETED, ALL SANITARY SEWER MAINS AND SIDE SEWERS SHALL BE TESTED PER SECTION 406 OF THE CITY STANDARDS.

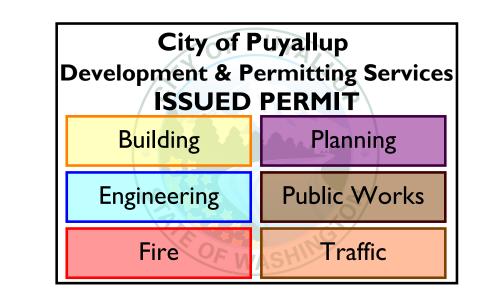

APPROVED

CITY OF PUYALLUP DEVELOPMENT ENGINEERING

NOTE: THIS APPROVAL IS VOID AFTER 180 DAYS FROM APPROVAL DATE. THE CITY WILL NOT BE RESPONSIBLE FOR ERRORS AND/OR OMISSIONS ON THESE PLANS. FIELD CONDITIONS MAY DICTATE CHANGES TO THESE PLANS AS DETERMINED BY THE DEVELOPMENT ENGINEERING MANAGER.

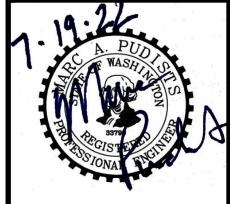

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MOMENTUM CIVIL 1145 BROADWAY, SUITE 115 PHONE: 253.319.1504


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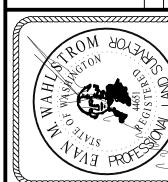
7/19/22

PROJECT NO. LARS-0001


SHEET NO. **3** of **25**

REFERENCE NO. **C1.2**



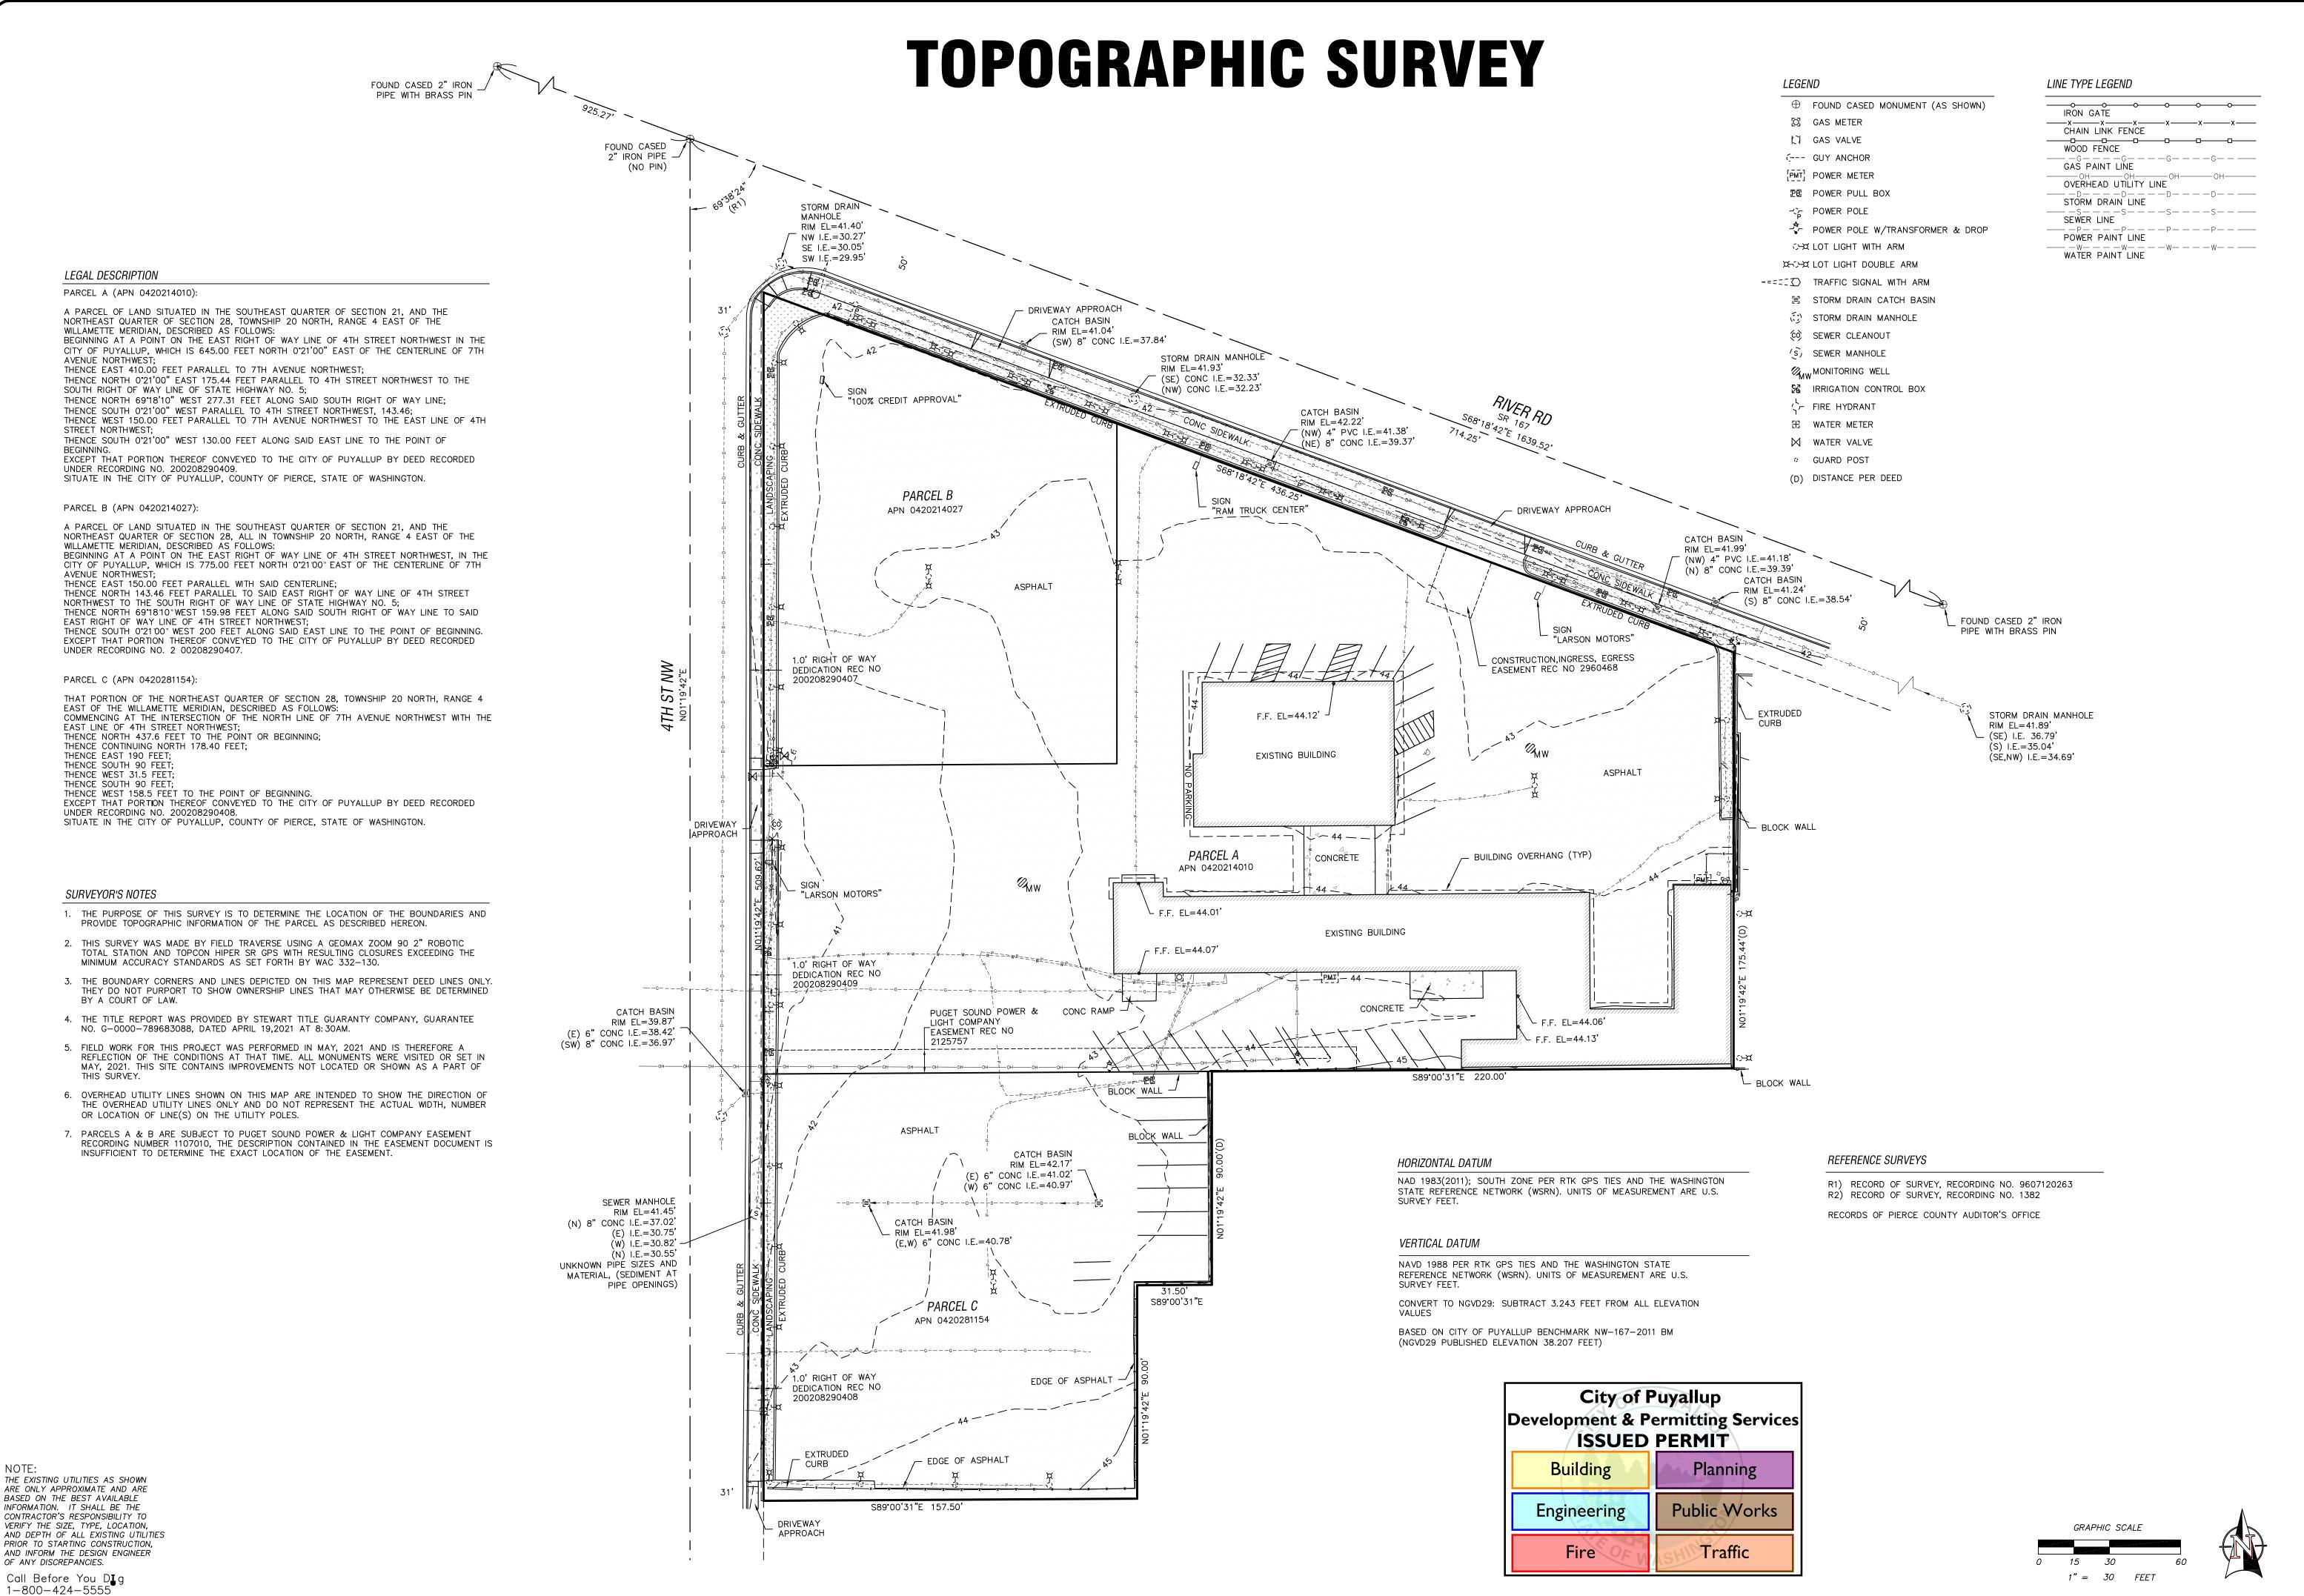

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CITY OF PUYALLUP

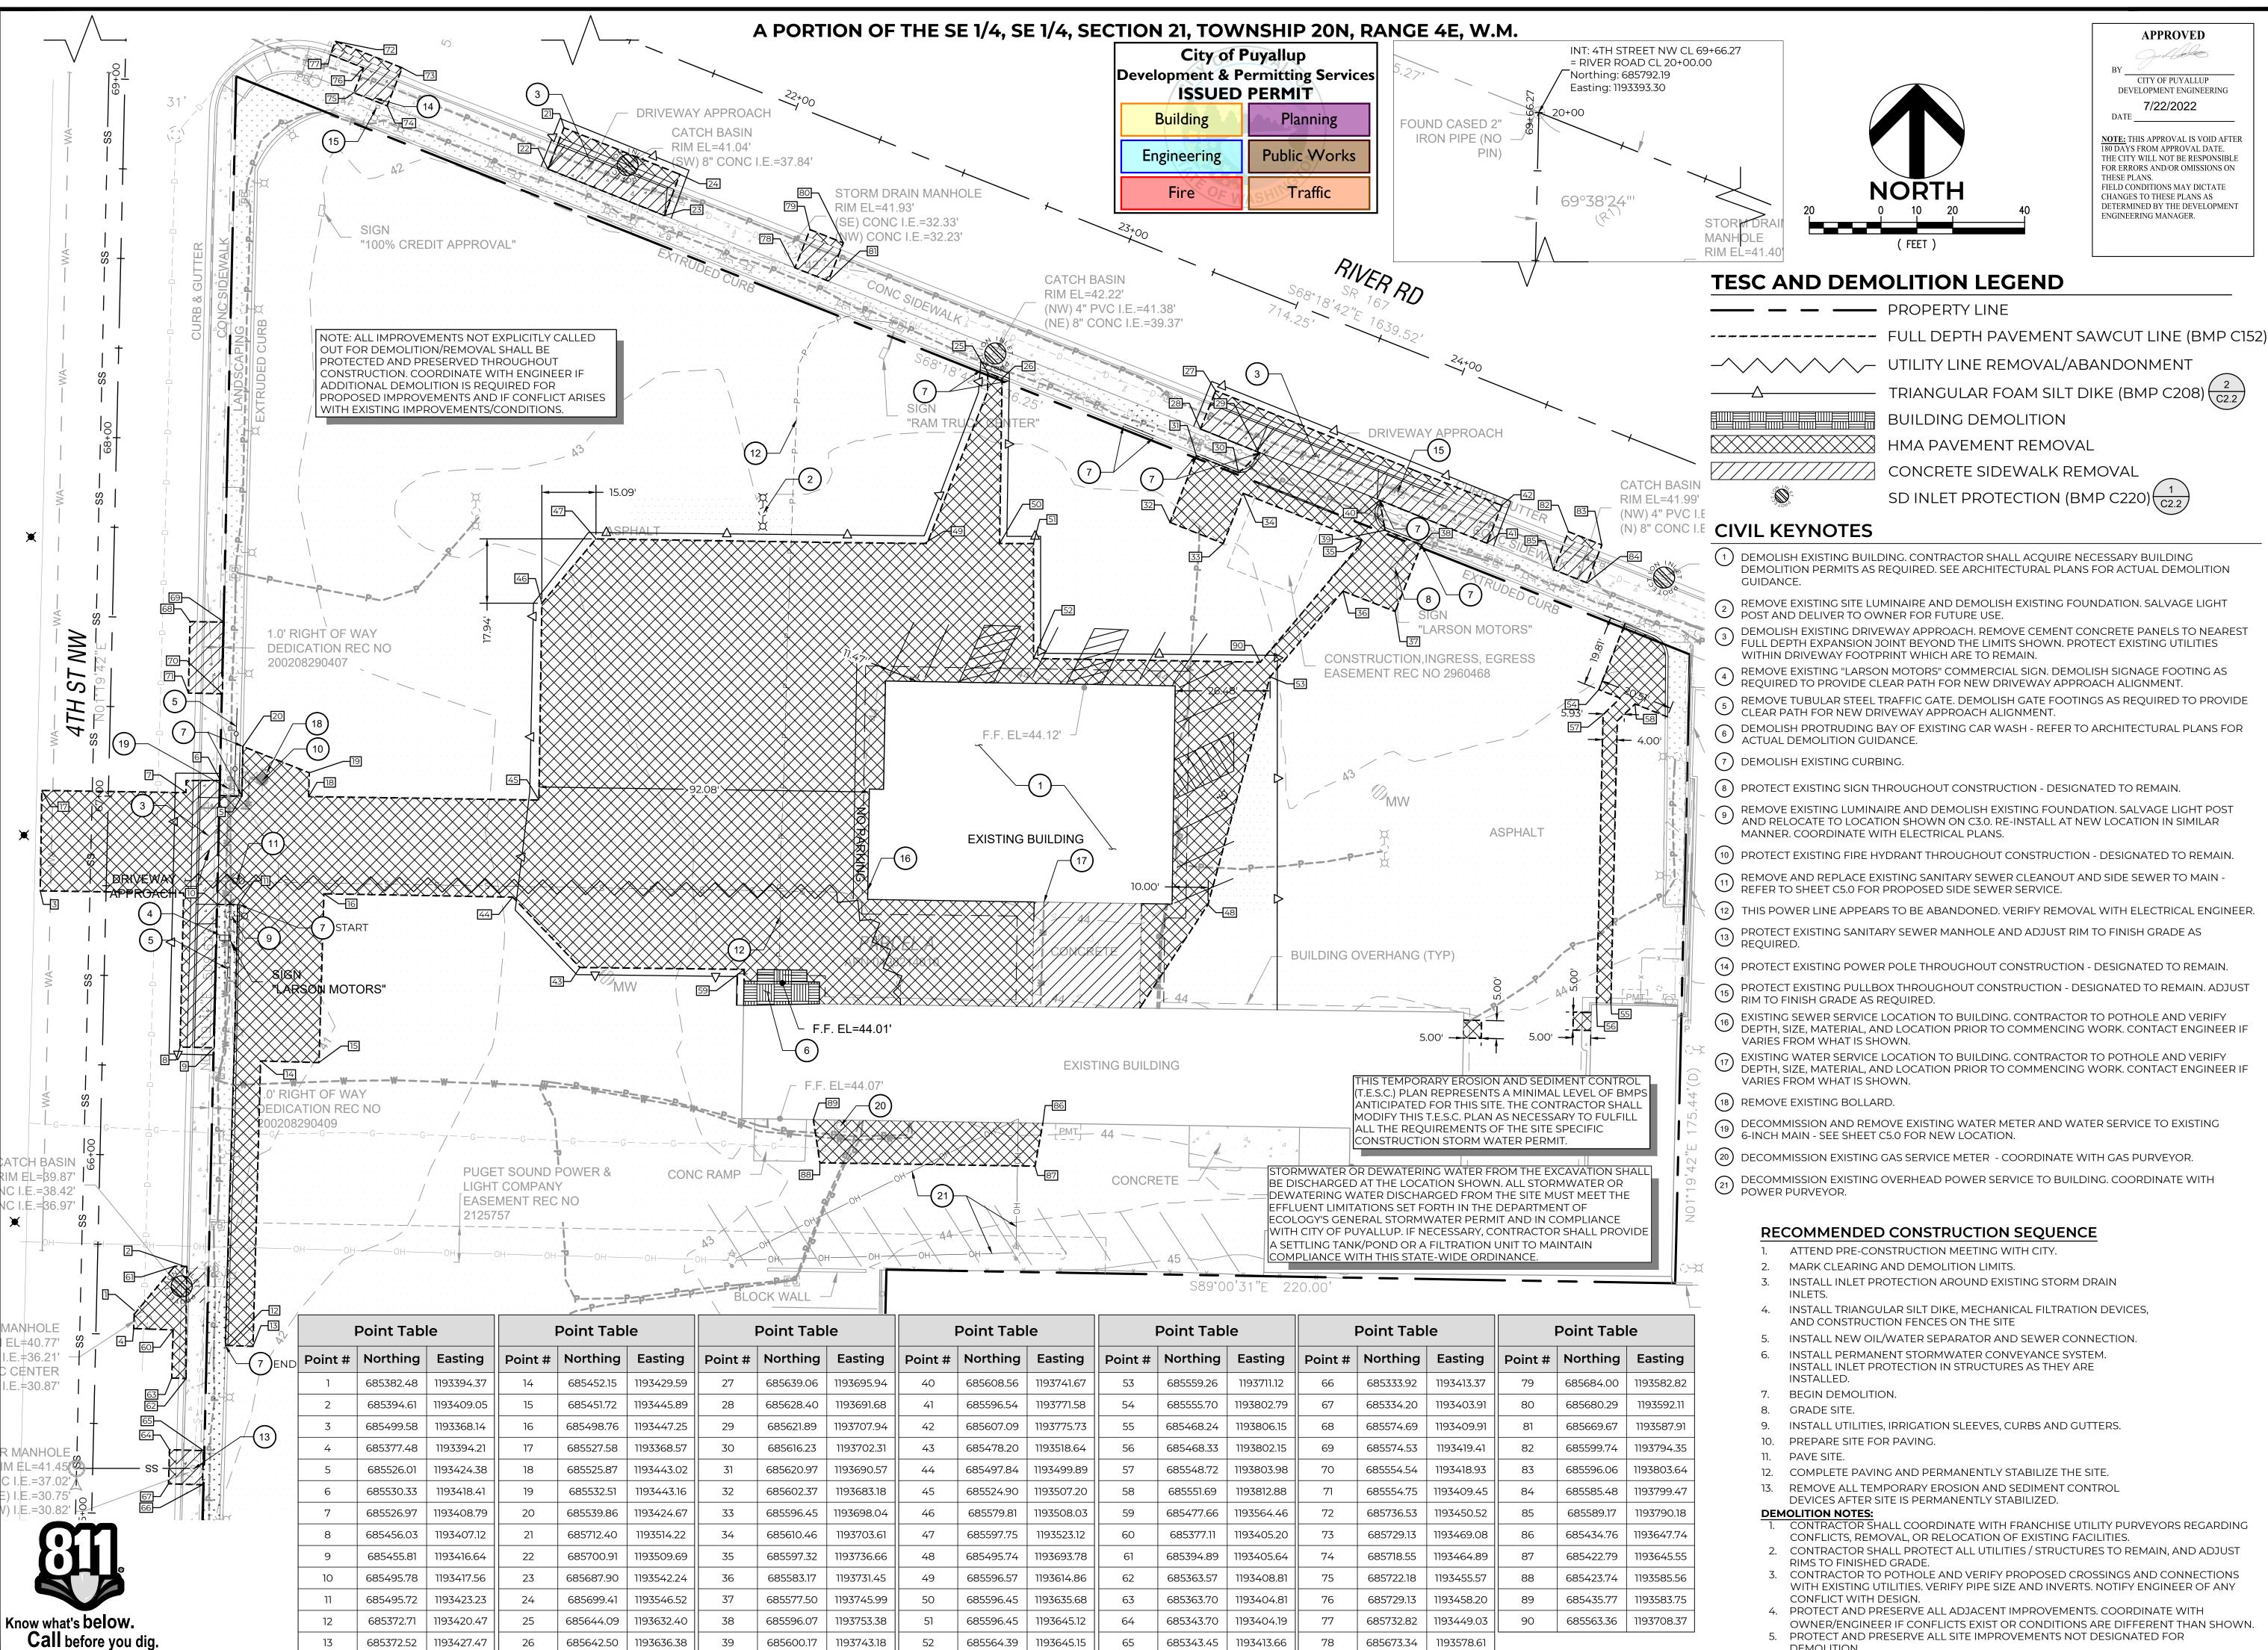DEVELOPMENT ENGINEERING 7/22/2022

NOTE: THIS APPROVAL IS VOID AFTER 180 DAYS FROM APPROVAL DATE. THE CITY WILL NOT BE RESPONSIBLE FOR ERRORS AND/OR OMISSIONS OF THESE PLANS. FIELD CONDITIONS MAY DICTATE CHANGES TO THESE PLANS AS DETERMINED BY THE DEVELOPMENT ENGINEERING MANAGER.

APPROVED

TESC AND DEMOLITION LEGEND

PROPERTY LINE

TRIANGULAR FOAM SILT DIKE (BMP C208) $\frac{2}{C2.2}$

BUILDING DEMOLITION

HMA PAVEMENT REMOVAL

CONCRETE SIDEWALK REMOVAL

SD INLET PROTECTION (BMP C220) $\left(\frac{1}{C2.2}\right)$

- $\binom{1}{1}$ DEMOLISH EXISTING BUILDING. CONTRACTOR SHALL ACQUIRE NECESSARY BUILDING DEMOLITION PERMITS AS REQUIRED. SEE ARCHITECTURAL PLANS FOR ACTUAL DEMOLITION
- REMOVE EXISTING SITE LUMINAIRE AND DEMOLISH EXISTING FOUNDATION. SALVAGE LIGHT POST AND DELIVER TO OWNER FOR FUTURE USE.
- DEMOLISH EXISTING DRIVEWAY APPROACH. REMOVE CEMENT CONCRETE PANELS TO NEAREST FULL DEPTH EXPANSION JOINT BEYOND THE LIMITS SHOWN. PROTECT EXISTING UTILITIES WITHIN DRIVEWAY FOOTPRINT WHICH ARE TO REMAIN
- REMOVE EXISTING "LARSON MOTORS" COMMERCIAL SIGN. DEMOLISH SIGNAGE FOOTING AS REQUIRED TO PROVIDE CLEAR PATH FOR NEW DRIVEWAY APPROACH ALIGNMENT.
- REMOVE TUBULAR STEEL TRAFFIC GATE. DEMOLISH GATE FOOTINGS AS REQUIRED TO PROVIDE TEMOVE TUBULAR STEEL TRAFFIC GATE. DEMOCIONES CLEAR PATH FOR NEW DRIVEWAY APPROACH ALIGNMENT.
- 6 DEMOLISH PROTRUDING BAY OF EXISTING CAR WASH REFER TO ARCHITECTURAL PLANS FOR ACTUAL DEMOLITION GUIDANCE.
- (7) DEMOLISH EXISTING CURBING.
- $\left(\begin{smallmatrix} 8 \end{smallmatrix}
 ight)$ PROTECT EXISTING SIGN THROUGHOUT CONSTRUCTION DESIGNATED TO REMAIN.
- PREMOVE EXISTING LUMINAIRE AND DEMOLISH EXISTING FOUNDATION. SALVAGE LIGHT POST AND RELOCATE TO LOCATION SHOWN ON C3.0. RE-INSTALL AT NEW LOCATION IN SIMILAR MANNER. COORDINATE WITH ELECTRICAL PLANS.
- (10) PROTECT EXISTING FIRE HYDRANT THROUGHOUT CONSTRUCTION DESIGNATED TO REMAIN.
- REMOVE AND REPLACE EXISTING SANTIANT SETTING REFER TO SHEET C5.0 FOR PROPOSED SIDE SEWER SERVICE. REMOVE AND REPLACE EXISTING SANITARY SEWER CLEANOUT AND SIDE SEWER TO MAIN -
- (12) THIS POWER LINE APPEARS TO BE ABANDONED. VERIFY REMOVAL WITH ELECTRICAL ENGINEER
- PROTECT EXISTING SANITARY SEWER MANHOLE AND ADJUST RIM TO FINISH GRADE AS REQUIRED.
- (14) PROTECT EXISTING POWER POLE THROUGHOUT CONSTRUCTION DESIGNATED TO REMAIN.
- PROTECT EXISTING PULLBOX THROUGHOUT CONSTRUCTION DESIGNATED TO REMAIN. ADJUST RIM TO FINISH GRADE AS REQUIRED.
- EXISTING SEWER SERVICE LOCATION TO BUILDING. CONTRACTOR TO POTHOLE AND VERIFY DEPTH, SIZE, MATERIAL, AND LOCATION PRIOR TO COMMENCING WORK. CONTACT ENGINEER IF
- EXISTING WATER SERVICE LOCATION TO BUILDING. CONTRACTOR TO POTHOLE AND VERIFY DEPTH, SIZE, MATERIAL, AND LOCATION PRIOR TO COMMENCING WORK. CONTACT ENGINEER IF
- DECOMMISSION AND REMOVE EXISTING WATER METER AND WATER SERVICE TO EXISTING 6-INCH MAIN SEE SHEET C5.0 FOR NEW LOCATION.
- (20) DECOMMISSION EXISTING GAS SERVICE METER COORDINATE WITH GAS PURVEYOR.
- DECOMMISSION EXISTING OVERHEAD POWER SERVICE TO BUILDING. COORDINATE WITH POWER PURVEYOR.

RECOMMENDED CONSTRUCTION SEQUENCE

- ATTEND PRE-CONSTRUCTION MEETING WITH CITY.
- MARK CLEARING AND DEMOLITION LIMITS.
- INSTALL INLET PROTECTION AROUND EXISTING STORM DRAIN
- INSTALL TRIANGULAR SILT DIKE, MECHANICAL FILTRATION DEVICES,
- AND CONSTRUCTION FENCES ON THE SITE INSTALL NEW OIL/WATER SEPARATOR AND SEWER CONNECTION.
- INSTALL PERMANENT STORMWATER CONVEYANCE SYSTEM INSTALL INLET PROTECTION IN STRUCTURES AS THEY ARE
- INSTALLED.
- BEGIN DEMOLITION.
- INSTALL UTILITIES, IRRIGATION SLEEVES, CURBS AND GUTTERS.
- 10. PREPARE SITE FOR PAVING.
- 12. COMPLETE PAVING AND PERMANENTLY STABILIZE THE SITE.
- 13. REMOVE ALL TEMPORARY EROSION AND SEDIMENT CONTROL DEVICES AFTER SITE IS PERMANENTLY STABILIZED.

DEMOLITION NOTES:

- CONTRACTOR SHALL COORDINATE WITH FRANCHISE UTILITY PURVEYORS REGARDING CONFLICTS, REMOVAL, OR RELOCATION OF EXISTING FACILITIES. 2. CONTRACTOR SHALL PROTECT ALL UTILITIES / STRUCTURES TO REMAIN, AND ADJUST
- RIMS TO FINISHED GRADE 3. CONTRACTOR TO POTHOLE AND VERIFY PROPOSED CROSSINGS AND CONNECTIONS
- WITH EXISTING UTILITIES. VERIFY PIPE SIZE AND INVERTS. NOTIFY ENGINEER OF ANY CONFLICT WITH DESIGN.
- 4. PROTECT AND PRESERVE ALL ADJACENT IMPROVEMENTS. COORDINATE WITH OWNER/ENGINEER IF CONFLICTS EXIST OR CONDITIONS ARE DIFFERENT THAN SHOWN. 5. PROTECT AND PRESERVE ALL SITE IMPROVEMENTS NOT DESIGNATED FOR

MOMENTUM CIVI 1145 BROADWAY, SUITE 115 TACOMA, WA 98402 PHONE: 253.319.1504

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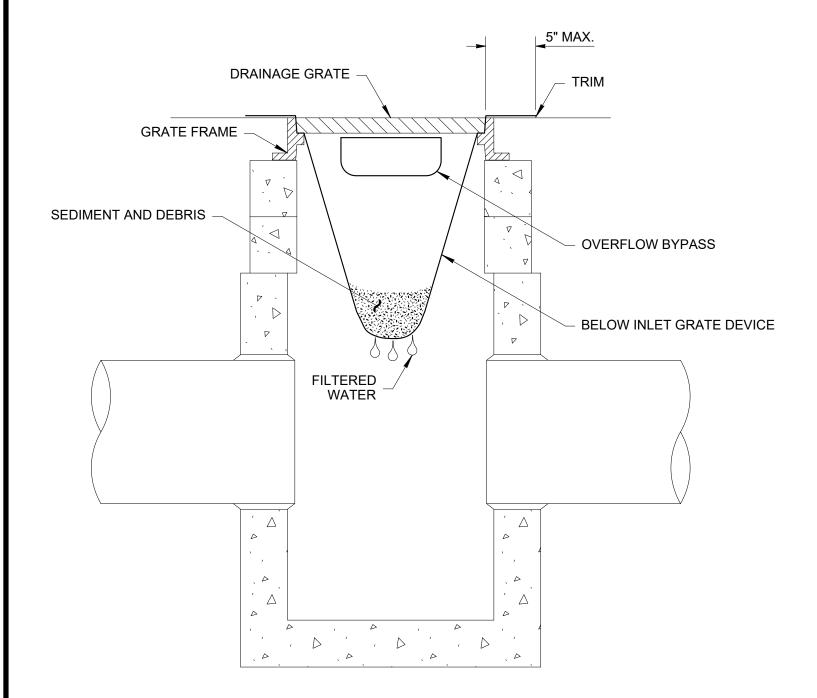
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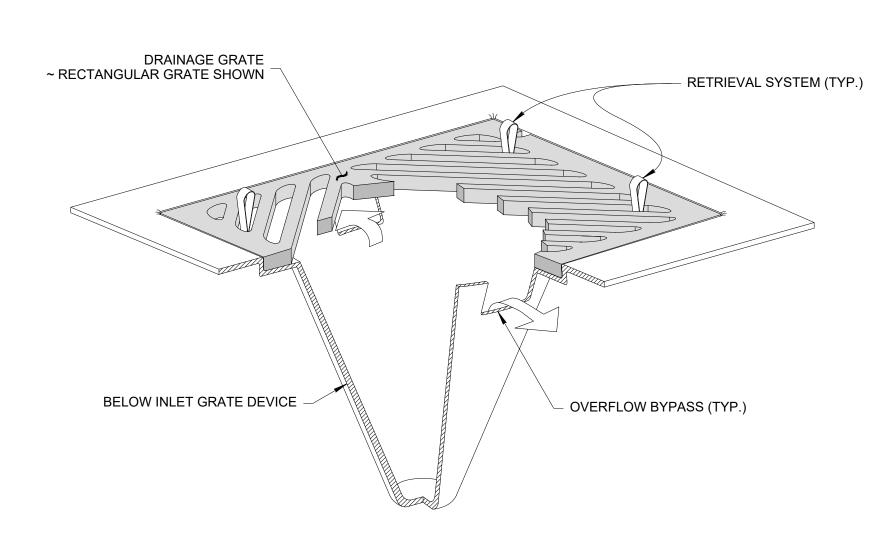
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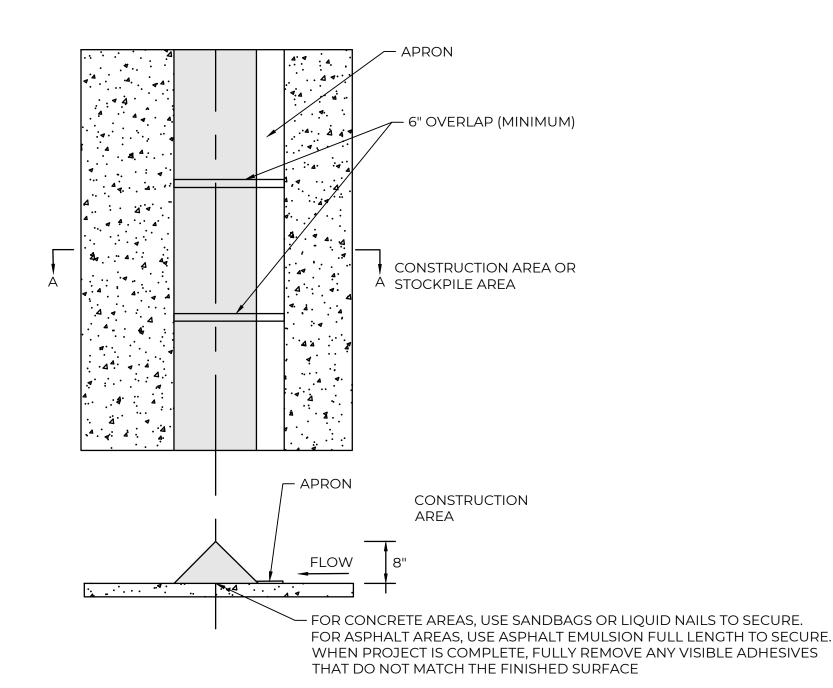
A PORTION OF THE SE 1/4, SE 1/4, SECTION 21, TOWNSHIP 20N, RANGE 4E, W.M.

- 1. Size the Below Inlet Grate Device (BIGD) for the storm water structure it will service.
- 2. The BIGD shall have a built-in high-flow relief system (overflow bypass).
- The retrieval system must allow removal of the BIGD without spilling the collected material.
- 4. Perform maintenance in accordance with WSDOT Standard Specification 8-01.3(15).















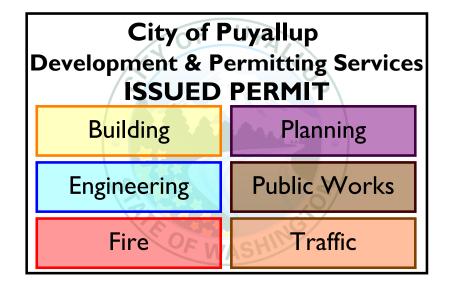

APPROVED

BY ______CITY OF PUYALLUP DEVELOPMENT ENGINEERING 7/22/2022

NOTE: THIS APPROVAL IS VOID AFTER 180 DAYS FROM APPROVAL DATE.
THE CITY WILL NOT BE RESPONSIBLE FOR ERRORS AND/OR OMISSIONS ON THESE PLANS.
FIELD CONDITIONS MAY DICTATE
CHANGES TO THESE PLANS AS DETERMINED BY THE DEVELOPMENT ENGINEERING MANAGER.

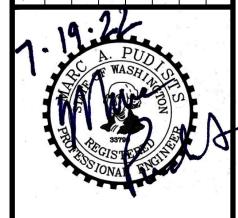

PERMIT SET

DETAI 300 BUILDING - LARSON AUTON CASTINO ARCHITECT

MOMENTUM CIVIL 1145 BROADWAY, SUITE 115 TACOMA, WA 98402 PHONE: 253.319.1504


CHECKED BY: M. PUDISTS DESIGNED BY: **K. MURPHY** DRAWN BY: K. MURPHY HORZ. DATUM:NAD83(11)

VERT. DATUM: **NAVD88**

7/19/22 PROJECT NO. LARS-0001

SHEET NO. 6 of 25

REFERENCE NO. **C2.2**

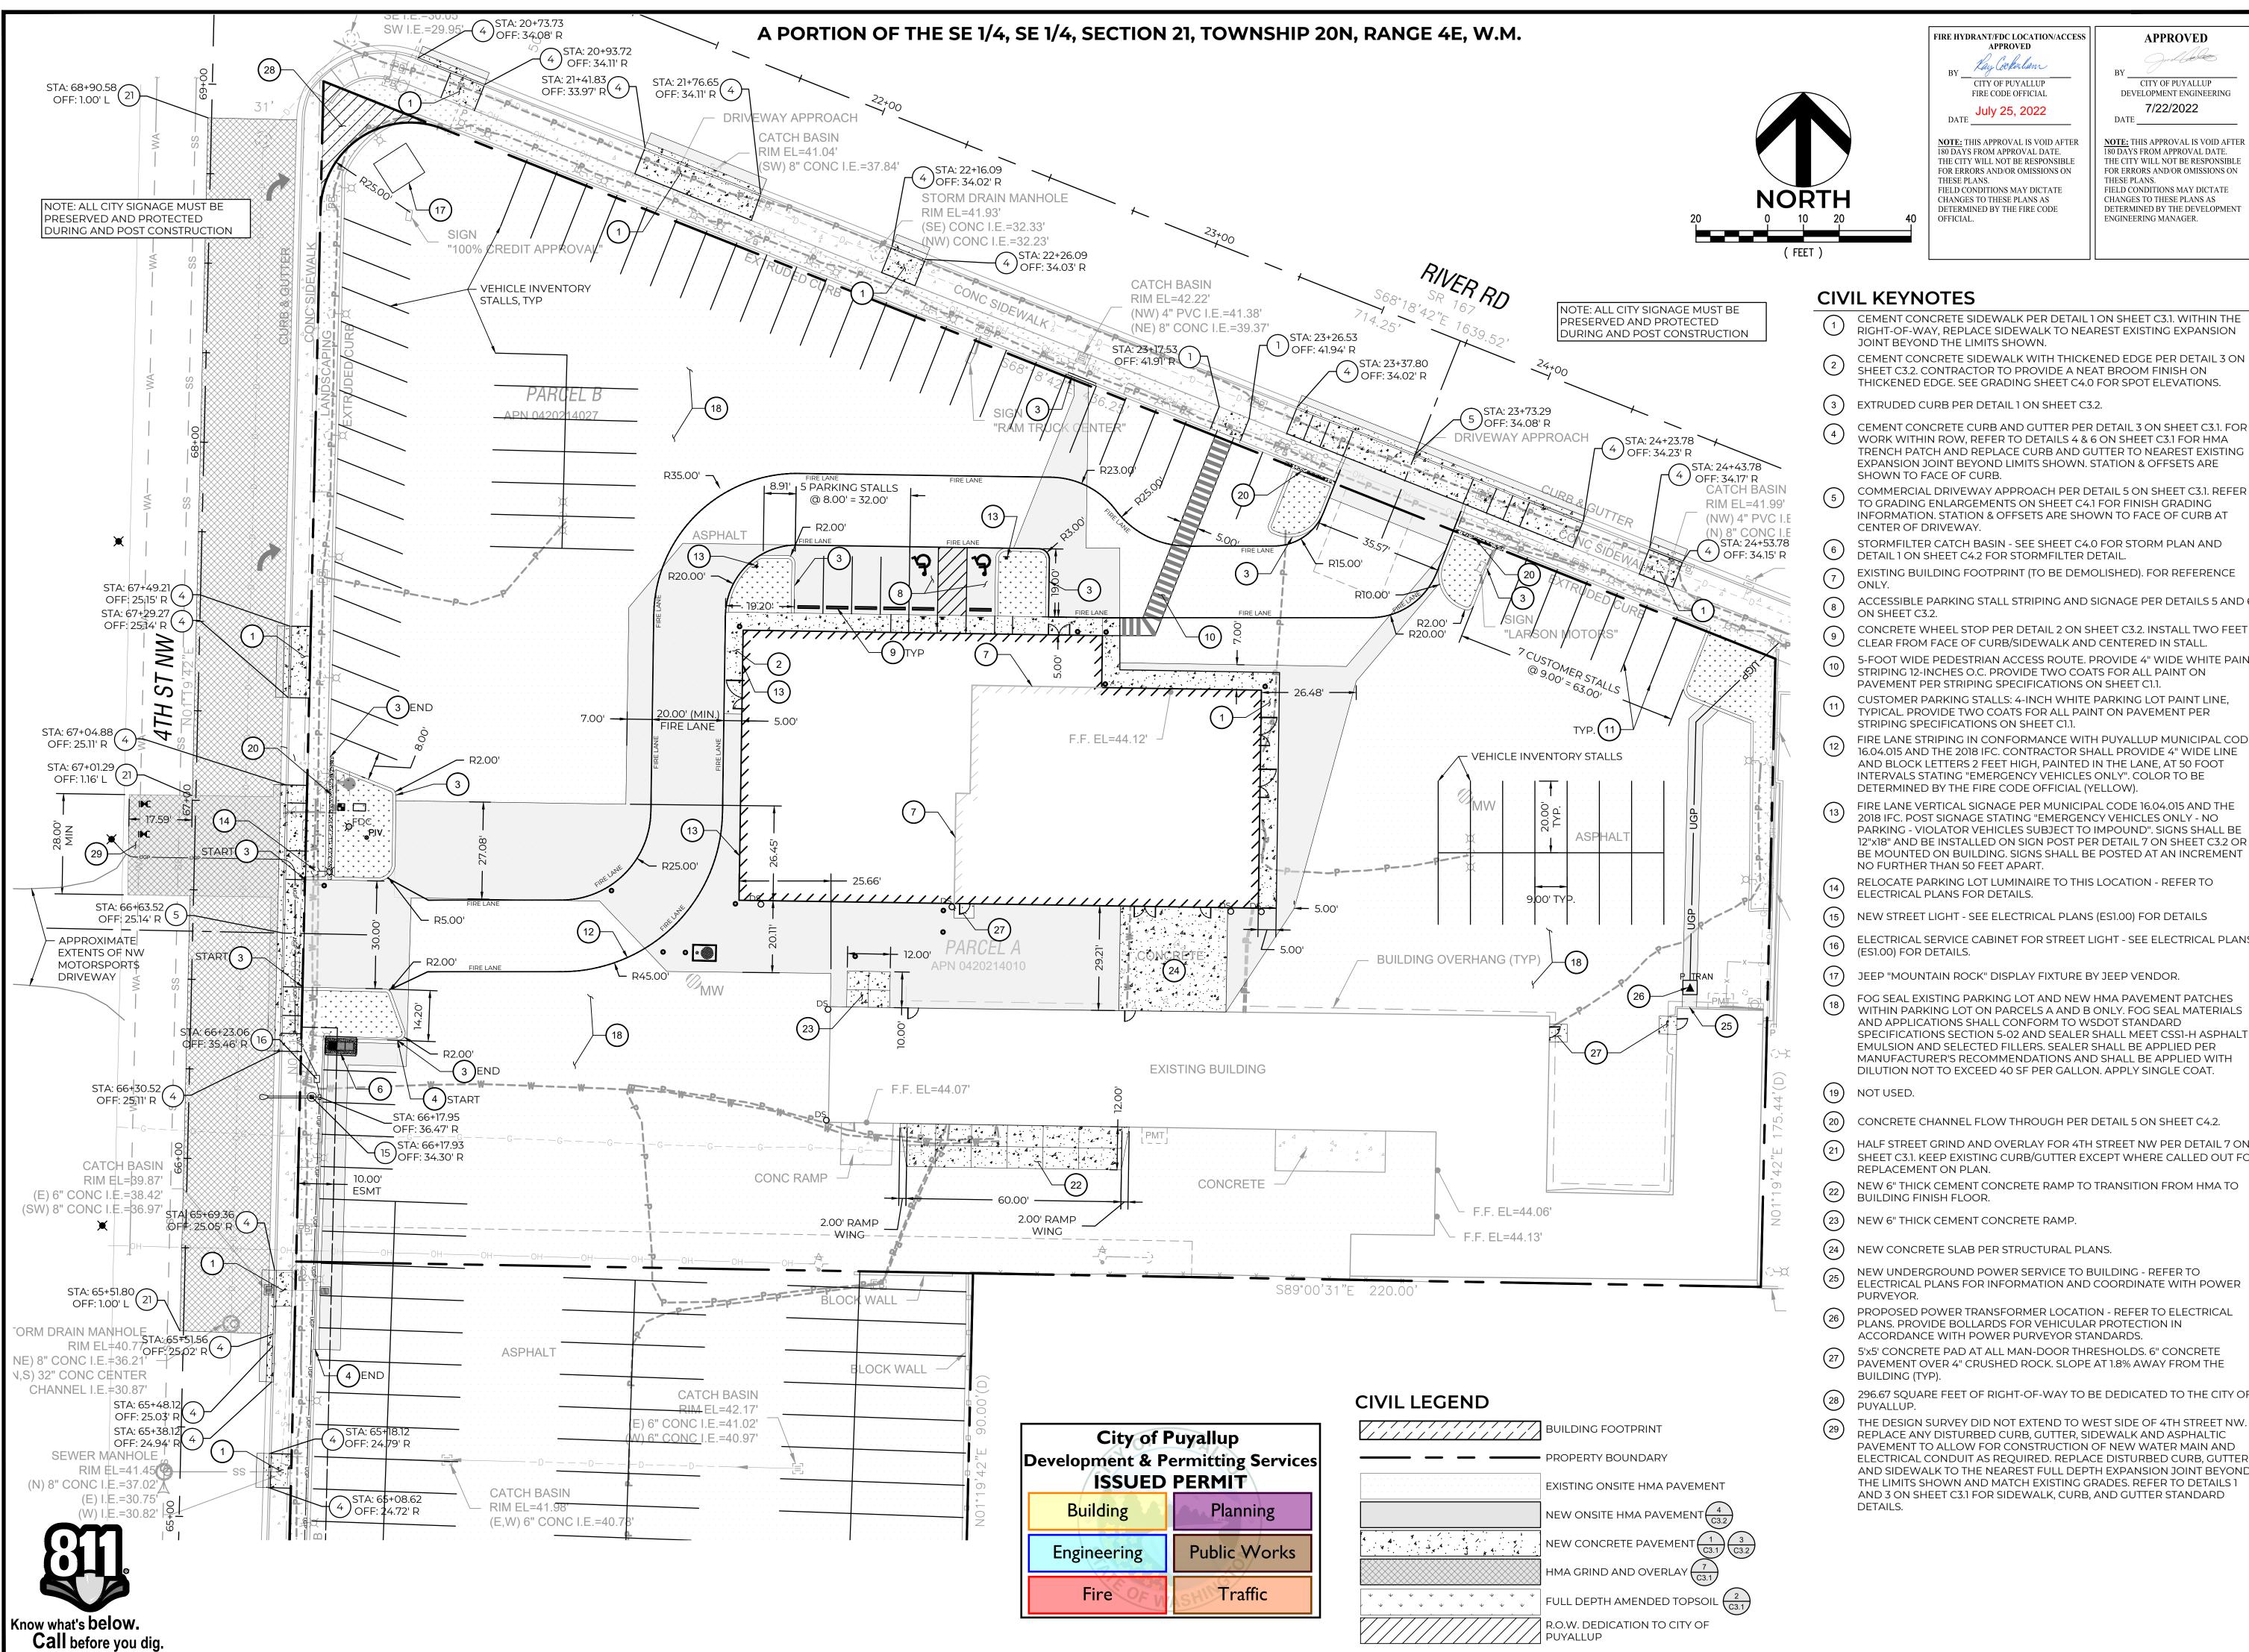

CITY OF PUYALLUP FIRE CODE OFFICIAL

FIRE HYDRANT/FDC LOCATION/ACCESS

July 25, 2022

NOTE: THIS APPROVAL IS VOID AFTER 80 DAYS FROM APPROVAL DATE. THE CITY WILL NOT BE RESPONSIBLE FOR ERRORS AND/OR OMISSIONS ON THESE PLANS. FIELD CONDITIONS MAY DICTATE CHANGES TO THESE PLANS AS DETERMINED BY THE FIRE CODE

APPROVED

CITY OF PUYALLUP DEVELOPMENT ENGINEERING 7/22/2022

THESE PLANS.

NOTE: THIS APPROVAL IS VOID AFTER 180 DAYS FROM APPROVAL DATE. THE CITY WILL NOT BE RESPONSIBLE


FOR ERRORS AND/OR OMISSIONS ON

FIELD CONDITIONS MAY DICTATE

DETERMINED BY THE DEVELOPMENT

CHANGES TO THESE PLANS AS

ENGINEERING MANAGER.

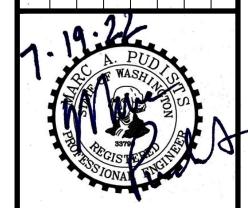

PERMIT SET

AUTO

DING

ACCESSIBLE PARKING STALL STRIPING AND SIGNAGE PER DETAILS 5 AND 6

CONCRETE WHEEL STOP PER DETAIL 2 ON SHEET C3.2. INSTALL TWO FEET CLEAR FROM FACE OF CURB/SIDEWALK AND CENTERED IN STALL.

5-FOOT WIDE PEDESTRIAN ACCESS ROUTE. PROVIDE 4" WIDE WHITE PAINT STRIPING 12-INCHES O.C. PROVIDE TWO COATS FOR ALL PAINT ON PAVEMENT PER STRIPING SPECIFICATIONS ON SHEET C1.1.

CUSTOMER PARKING STALLS: 4-INCH WHITE PARKING LOT PAINT LINE, TYPICAL. PROVIDE TWO COATS FOR ALL PAINT ON PAVEMENT PER STRIPING SPECIFICATIONS ON SHEET C1.1.

FIRE LANE STRIPING IN CONFORMANCE WITH PUYALLUP MUNICIPAL CODE 16.04.015 AND THE 2018 IFC. CONTRACTOR SHALL PROVIDE 4" WIDE LINE AND BLOCK LETTERS 2 FEET HIGH, PAINTED IN THE LANE, AT 50 FOOT INTERVALS STATING "EMERGENCY VEHICLES ONLY". COLOR TO BE DETERMINED BY THE FIRE CODE OFFICIAL (YELLOW)

FIRE LANE VERTICAL SIGNAGE PER MUNICIPAL CODE 16.04.015 AND THE 2018 IFC. POST SIGNAGE STATING "EMERGENCY VEHICLES ONLY - NO PARKING - VIOLATOR VEHICLES SUBJECT TO IMPOUND". SIGNS SHALL BE 12"x18" AND BE INSTALLED ON SIGN POST PER DETAIL 7 ON SHEET C3.2 OR BE MOUNTED ON BUILDING. SIGNS SHALL BE POSTED AT AN INCREMENT NO FURTHER THAN 50 FEET APART.

RELOCATE PARKING LOT LUMINAIRE TO THIS LOCATION - REFER TO RELOCATE PARKING LOT LUMINAII ELECTRICAL PLANS FOR DETAILS.

(15) NEW STREET LIGHT - SEE ELECTRICAL PLANS (ES1.00) FOR DETAILS

ELECTRICAL SERVICE CABINET FOR STREET LIGHT - SEE ELECTRICAL PLANS

(ES1.00) FOR DETAILS.

(17) JEEP "MOUNTAIN ROCK" DISPLAY FIXTURE BY JEEP VENDOR.

FOG SEAL EXISTING PARKING LOT AND NEW HMA PAVEMENT PATCHES WITHIN PARKING LOT ON PARCELS A AND B ONLY. FOG SEAL MATERIALS AND APPLICATIONS SHALL CONFORM TO WSDOT STANDARD SPECIFICATIONS SECTION 5-02 AND SEALER SHALL MEET CSS1-H ASPHALT EMULSION AND SELECTED FILLERS. SEALER SHALL BE APPLIED PER MANUFACTURER'S RECOMMENDATIONS AND SHALL BE APPLIED WITH DILUTION NOT TO EXCEED 40 SF PER GALLON. APPLY SINGLE COAT.

NOT USED.

(20) CONCRETE CHANNEL FLOW THROUGH PER DETAIL 5 ON SHEET C4.2.

HALF STREET GRIND AND OVERLAY FOR 4TH STREET NW PER DETAIL 7 ON SHEET C3.1. KEEP EXISTING CURB/GUTTER EXCEPT WHERE CALLED OUT FOR REPLACEMENT ON PLAN.

NEW 6" THICK CEMENT CONCRETE RAMP TO TRANSITION FROM HMA TO BUILDING FINISH FLOOR.

(23) NEW 6" THICK CEMENT CONCRETE RAMP.

NEW CONCRETE SLAB PER STRUCTURAL PLANS.

NEW UNDERGROUND POWER SERVICE TO BUILDING - REFER TO ELECTRICAL PLANS FOR INFORMATION AND COORDINATE WITH POWER

PROPOSED POWER TRANSFORMER LOCATION - REFER TO ELECTRICAL PLANS. PROVIDE BOLLARDS FOR VEHICULAR PROTECTION IN ACCORDANCE WITH POWER PURVEYOR STANDARDS.

5'x5' CONCRETE PAD AT ALL MAN-DOOR THRESHOLDS. 6" CONCRETE PAVEMENT OVER 4" CRUSHED ROCK. SLOPE AT 1.8% AWAY FROM THE

296.67 SQUARE FEET OF RIGHT-OF-WAY TO BE DEDICATED TO THE CITY OF

THE DESIGN SURVEY DID NOT EXTEND TO WEST SIDE OF 4TH STREET NW

REPLACE ANY DISTURBED CURB, GUTTER, SIDEWALK AND ASPHALTIC PAVEMENT TO ALLOW FOR CONSTRUCTION OF NEW WATER MAIN AND ELECTRICAL CONDUIT AS REQUIRED. REPLACE DISTURBED CURB, GUTTER AND SIDEWALK TO THE NEAREST FULL DEPTH EXPANSION JOINT BEYOND THE LIMITS SHOWN AND MATCH EXISTING GRADES. REFER TO DETAILS 1 AND 3 ON SHEET C3.1 FOR SIDEWALK, CURB, AND GUTTER STANDARD DETAILS.




CHECKED BY: M. PUDISTS DESIGNED BY: **K. MURPHY** DRAWN BY: K. MURPHY HORZ. DATUM: NAD83(11)


VERT. DATUM: **NAVD88** 7/19/22

PROJECT NO. LARS-0001

SHEET NO. **7** of **25**

REFERENCE NO. **C3.0**

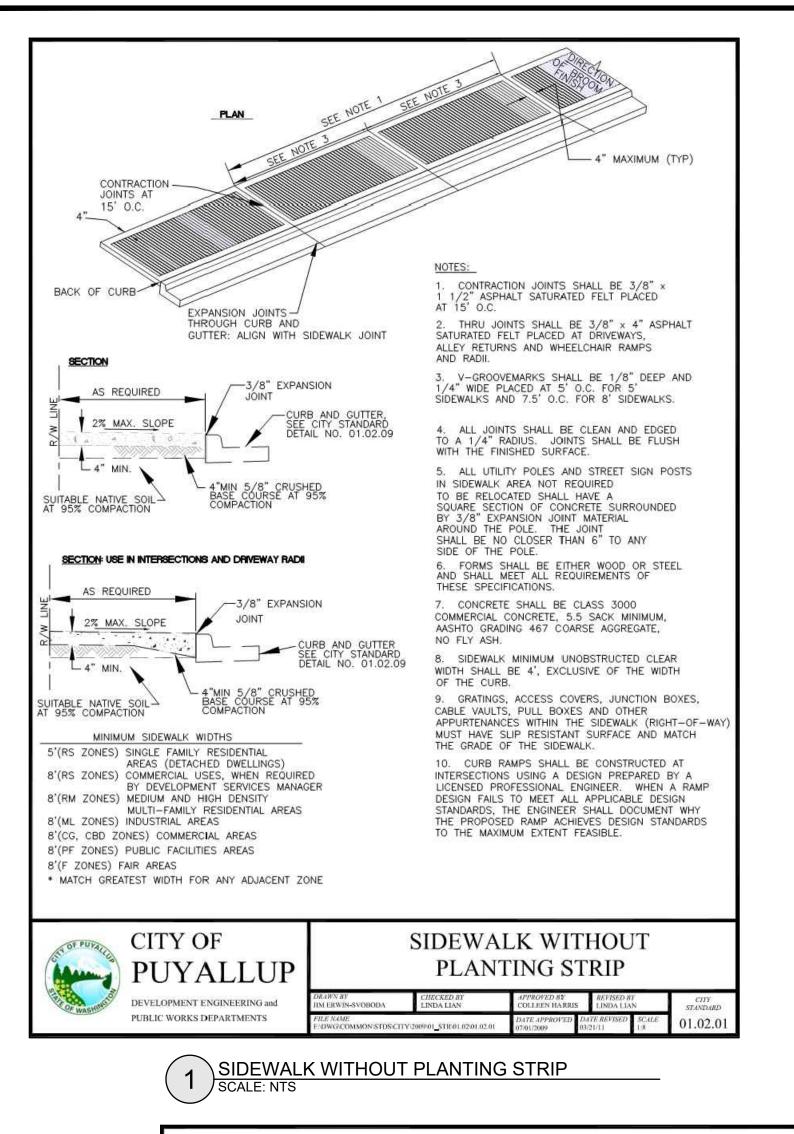

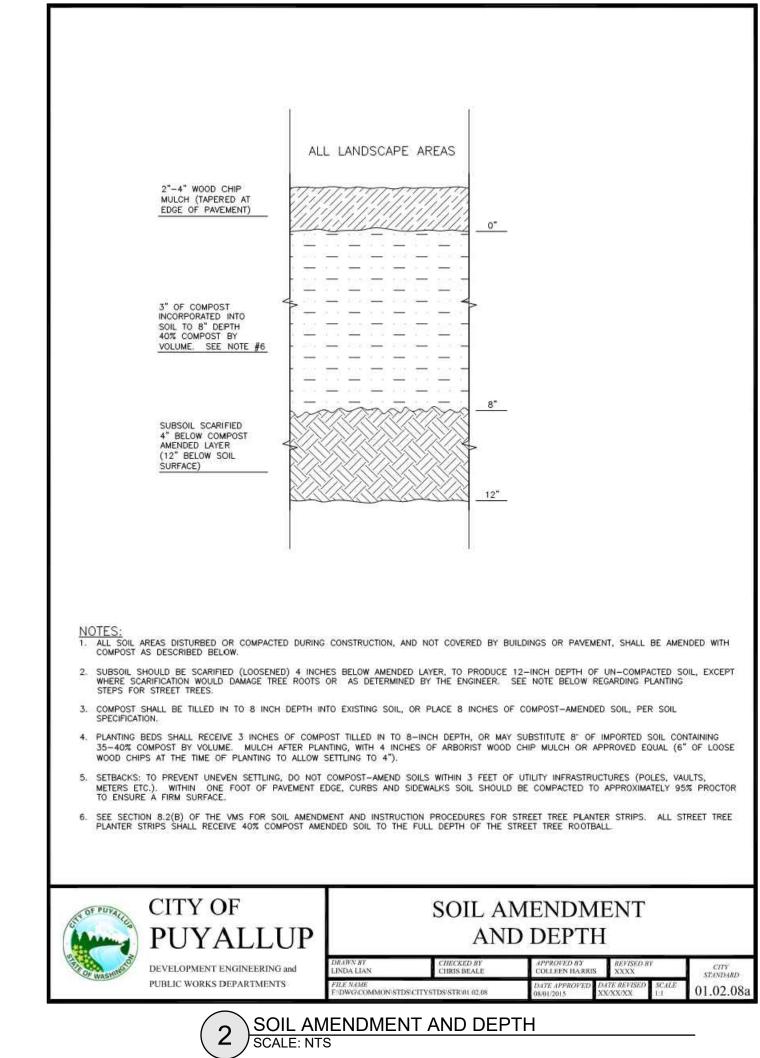

TOP OF ADJACENT SIDEWALK

SPLIT APPROACH SECTION (B)

- 6" CONCRETE

- 4" CRUSHED SURFACING

BACK OF SIDEWALK

_3/8" EXPANSION JOINT

SCALE: 1" = 10"

TOP OF ADJACENT SIDEWALK

SECTION (A)


TO BE USED AS AN OPTION TO THE URBAN APPROACH WHEN GRADES ARE CREATING A SITE CONSTRAINT.
JOINTS IN PAVING SLAB SHALL NOT EXTEND INTO DRIVEWAY. ALL JOINTS SHALL BE CLEAN AND EDGED.
CONCRETE SHALL BE COMMERCIAL CONCRETE, 5.5 SACK MINIMUM, AASHTO GRADIING 467 COARSE AGGREGATE, NO FLY ASH.
* 30 FEET MINIMUM WIDTH FOR TWO WAY TRAFFIC. MAXIMUM WIDTH DEPENDANT ON VEHICLE VOLUME AND DESIGN VEHICLE

* 30 FEET MINIMUM WIDTH FOR TWO WAY TRAFFIC. MAXIMUM WIDTH DEPENDANT ON VEHICLE VOLUME AND DESIGN VEHICLE TYPE.

4. DROP, APPROACH RAMPS SHALL NOT EXCEED 8.3%, AS MEASURED WITH A SMART LEVEL, UNLESS RAMP LENGTH IS EXTENDED

VARIABLE WIDTH

A PORTION OF THE SE 1/4, SE 1/4, SECTION 21, TOWNSHIP 20N, RANGE 4E, W.M.

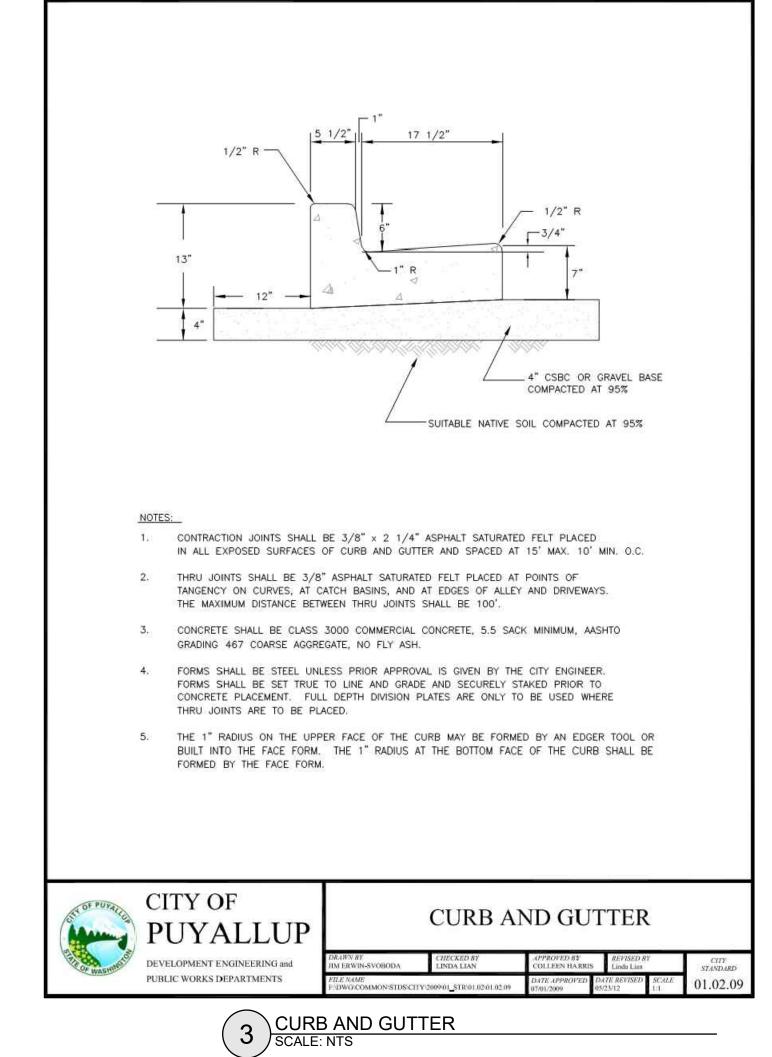

CITY OF PUYALLUP CITY OF PUYALLUP FIRE CODE OFFICIAL DEVELOPMENT ENGINEERING 7/22/2022 DATE July 25, 2022 **NOTE:** THIS APPROVAL IS VOID AFTER **NOTE:** THIS APPROVAL IS VOID AFTER 180 DAYS FROM APPROVAL DATE. 80 DAYS FROM APPROVAL DATE. THE CITY WILL NOT BE RESPONSIBLE THE CITY WILL NOT BE RESPONSIBLE FOR ERRORS AND/OR OMISSIONS ON FOR ERRORS AND/OR OMISSIONS ON THESE PLANS. THESE PLANS. FIELD CONDITIONS MAY DICTATE FIELD CONDITIONS MAY DICTATE CHANGES TO THESE PLANS AS CHANGES TO THESE PLANS AS DETERMINED BY THE FIRE CODE DETERMINED BY THE DEVELOPMENT ENGINEERING MANAGER. OFFICIAL. City of Puyallup **Development & Permitting Services ISSUED PERMIT** Building Planning **Public Works** Engineering Traffic Fire

FIRE HYDRANT/FDC LOCATION/ACCESS

APPROVED Kay Cockerham **APPROVED**

PERMIT SET

URE

ILDING

AGENCY AT THE EXPENSE OF THE CONTRACTOR. 8. THE FACE OF THE GUTTER LIP AND EDGES OF EXISTING ASPHALT MEET LINES SHALL BE TACK COATED PRIOR TO PAVEMENT PLACEMENT. WHEN SUCCESSIVE LIFTS OF ASPHALT ARE REQUIRED, A TACK COAT SHALL BE DISTRIBUTED UNIFORMLY OVER THE PREVIOUS LIFT AT A RATE OF 0.06-0.08 GALLONS PER SQUARE YARD AT A TEMPERATURE OF 100°F AND SHALL BE ALLOWED TO SET TO A TACKY STATE PRIOR TO THE PLACEMENT OF THE NEXT LIFT.

7. THE MAXIMUM COMPACTED THICKNESS OF ANY SINGLE LIFT

SHALL MEET WSDOT STANDARD SPEC. 5-04.3(9) TO A

MINIMUM AVERAGE COMPACTED DRY DENSITY OF 91 PERCENT

OF THE MAXIMUM DENSITY AS DETERMINED BY WSDOT TEST

METHOD SPECIFIED IN STANDARD SPEC. 5-04.3(10)B. PERIOD

COMPLIANCE TESTS SHALL BE MADE BY A CERTIFIED TESTING

9. ALL MEET LINES BETWEEN LIFTS OF ASPHALT SHALL BE UNIFORM AND VERTICAL. THE MEET LINES SHALL BE CLEANED AND TACK COATED.

REVIEW ENGINEER TO BE INSTALLED PRIOR TO THE INSTALLATION OF 10. ANY CHANGES TO THE STANDARD PAVEMENT SECTION SHALL REQUIRE APPROVAL BY THE DEVELOPMENT REVIEW ENGINEER. A PLACE A GEOTEXTILE FABRIC OVER THE PREPARED SUBGRADE WITH STRUCTURAL PAVEMENT CROSS SECTION DESIGN WITH A TWO FOOT MINIMUM OVERLAP, THE FABRIC SHALL BE INSTALLED CALCULATIONS SHALL BE REQUIRED.

PAVEMENT SHALL MATCH

EXISTING PAVEMENT DEPTH, 3" MINIMUM

EXISTING ASPHALT

ASPHALT CONCRETE PAVEMENT SHALL BE INSTALLED IN ACCORDANCE 11. ALL MANHOLE FRAMES, VALVE FRAMES AND MONUMENT COVERS SHALL BE INSTALLED AFTER PLACEMENT OF ASPHALT IF MORE THAN ONE LIFT IS NECESSARY, FRAMES AND LIDS WILL BE ADJUSTED TO FINISH GRADE AT FIRST LIFT AS DIRECTED BY THE CITY.

12. ASPHALT SHALL BE HMA CL 1/2" PG 64-22

MOMENTUM CIVIL 1145 BROADWAY, SUITE 115 TACOMA, WA 98402 PHONE: 253.319.1504

CHECKED BY: M. PUDISTS DESIGNED BY: **K. MURPHY** DRAWN BY: K. MURPHY

HORZ. DATUM: NAD83(11) VERT. DATUM: **NAVD88** 7/19/22

ROJECT NO. LARS-0001

SHEET NO. 8 of 25

FULL LANE WIDTH OR HALF STREET WIDTH 2" GRIND/OVERLAY (SEE NOTE 6, OPTION B) CUT BACK FULL DEPTH ASPHALT 6" CONCRETE (SEE NOTE 6, OPTION B) CENTERLINE OF - 4" CRUSHED POTHOLE - OPTION A SURFACING EXISTING ROADWAY POTHOLE - OPTION B SAWCUT & TRENCH WINDOW NEW SEWER MAIN EQUIRING POTHOLE (SEE NOTE 6) 1.40. (SEE NOTE 6, OPTION B) FULL LANE OR HALF STREET WIDTH 2" GRIND/OVERLAY 4" (MINIMUM) HMA CL ½" PG 64-22 (OR MATCH EXISTING THICKNESS, 24" MIN. CUT BACK (TYP.) FUL DEPTH ASPHALT REPLACEMENT WHICHEVER IS GREATER NOTES: REQUIRED TRENCH ALL SAWCUTS SHALL BE TACK COATED AT THE FACE - 2" GRIND/OVERLAY BE SEALED WITH AR4000W. SCALE: 1" = 2" 2" MIN. CRUSHED SURFACING TOP COURSE (SEE NOTE 3) SURFACING BASE COURSE BASE AND SUBBASE MATERIAL SHALL BE COMPACTED TO 95% OF THE MODIFIED PROCTOR MAXIMUM DRY DENSITY. INITIAL BACKFILLING SHALL BE PERFORMED ONLY AFTER INSPECTION AND APPROVAL OF THE INSTALLED PIPE OR STRUCTURE. THE TRENCH BACKFILL MATERIAL SHALL BE IN ACCORDANCE WITH CITY STANDARD DETAIL NO. 06.01.01. ALL BACKFILL FOR PIPE TRENCHES SHALL BE MECHANICALLY COMPACTED BY A POWER-OPERATED MECHANICAL TAMPER(S) AS SPECIFIED IN WSDOT STANDARD SPEC. 2-03.3 (14)C, COMPACTING EARTH EMBANKMENTS, METHOD C OF THE WSDOT STANDARD SPECIFICATIONS. IF PAVING SURFACES ADJACENT TO THE TRENCH OPENING MAY BE DAMAGED WHERE TRENCHES ARE MADE PARALLEL TO THE STREET, OR WHERE

A NUMBER OF CROSS TRENCHES ARE LAID IN CLOSE PROXIMITY TO ONE ANOTHER OR WHERE THE EQUIPMENT USED MAY CAUSE SUCH DAMAGE, THE CITY ENGINEER MAY REQUIRE A NEGOTIATED CONTRIBUTION FROM THE PERMITTEE FOR RESURFACING IN LIEU OF PATCHING.

F THE TOTAL AREA OF THE PROPOSED PATCH OR PROBABLE DAMAGED AREA EXCEEDS 25 PERCENT OF THE TOTAL PAVEMENT SURFACING BETWEEN CURB FACES OR BETWEEN CONCRETE GUTTER EDGES IN ANY BLOCK, SUCH NEGOTIATIONS SHALL BE CARRIED ON AND CONTRIBUTIONS AGREED UPON PRIOR TO ISSUANCE OF A PERMIT. SUCH CONTRIBUTIONS SHALL BE IN ADDITION TO THE STANDARD PERMIT FEE.

OPTION A - UP TO A 10" DIAMETER CORE DRILL IS ALLOWED. CORE HOLES MADE DURING UTILITY POTHOLES SHALL BE BACKFILLED WITH CDF TO WITHIN 4" OF FINISHED GRADE. 4" OF HMA SHALL THEN BE PLACED AND COMPACTED, FLUSH WITH EXISTING GRADE. OPTION B - FOR POTHOLE WINDOWS LARGER THAN 10" IN DIAMETER OR TRENCHING COMPLETED IN EXISTING ROADWAY, THE CONTRACTOR SHALL MEET CITY STANDARD 06.01.01 FOR PIPE BEDDING AND BACKFILL REQUIREMENTS. PAVEMENT RESTORATION SHALL BE ACCOMPLISHED BY INSTALLING THE TRENCH PATCH, AS SHOWN HEREIN, AND THEN GRINDING/OVERLAYING TO A MINIMUM DEPTH OF 2". THE LIMITS OF THE REQUIRED GRIND/OVERLAY SHALL BE TO THE NEAREST LANE LINE, OR HALF STREET, AND SHALL BE A MINIMUM OF 18 FEET LONG (LONGITUDINALLY ALONG ROADWAY) CENTERED AT LOCATION OF PATCH. NOTE: IF EXISTING ASPHALT THICKNESS IS LESS THAN 3", FULL DEPTH

PAVEMENT REPLACEMENT, IN LIEU OF GRIND/OVERLAY, TO MEET A MINIMUM ASPHALT THICKNESS OF 4" WILL BE REQUIRED.

(12') IS REQUIRED CENTERED ON ROADWAY. NO LONGITUDINAL JOINTS WILL BE ALLOWED IN THE WHEEL PATH. ALL MANHOLE FRAMES, VALVE FRAMES AND MONUMENT COVERS SHALL BE INSTALLED AFTER PLACEMENT OF ASPHALT. IF MORE THAN ONE LIFT IS NECESSARY, FRAMES AND LIDS WILL BE ADJUSTED TO FINISH GRADE AT FIRST LIFT AS DIRECTED BY THE CITY.

WHERE LOCATION OF TRENCH OR POTHOLE WINDOW INTERSECTS ROAD CENTERLINE, A MINIMUM GRIND AND OVERLAY OF ONE FULL LANE WIDTH

OFFICE

STREET PATCH

01.01.2

CITY OF PUBLIC WORKS DEPARTMENTS

WSDOT STANDARD SPEC. 4-04.

PER MANUFACTURER SPECIFICATIONS.

HALF STREET IMPROVEMENT



Call before you dig.

CURB CUT DEVELOPMENT ENGINEERING and PUBLIC WORKS DEPARTMENTS

36" MIN. WIDTH (SEE NOTE BELOW) ---

TO BE SEALED

WITH AR4000

GUTTER EDGE TO BE

SUBGRADE, SEE CITY

NO. 01.01.01 NOTE 2

NOTE: THE 36" MINIMUM PAVEMENT PATCH SHALL BE INCREASED IN WIDTH IF THE RESULTING MEET LINE WOULD LIE WITHIN A LANE WHEEL PATH.

STANDARD DETAIL

IF REPLACING CURB AND GUTTER REMOVE EXISTING TO NEAREST

EXPANSION JOINTS EACH WAY.

TACK SEALED WITH CRS2

— EXPANSION JOINTS 10' SPACING TYP. ———

NOTE: IF DRIVEWAY IS BEING INSTALLED, REMOVE EXISTING

REPLACE ANY DAMAGED ASPHALT BY

WIDTH NOTED ABOVE.

SAWCUTING EXISTING ASPHALT PARALLEL WITH

PLAN VIEW

FLOW LINE, LEAVING A MINIMUM REPLACEMENT

CURB AND GUTTER TO NEAREST EXPANSION JOINT. SAWCUTS

NOT PERMITTED WITHOUT PRIOR APPROVAL OF THE ENGINEER.

BE REMOVED

2" CRUSHED SURFACING

10" GRAVEL BASE

SCALE: 1:1

-CURB

SCALE: 1:2

DEVELOPMENT ENGINEERING and PUBLIC WORKS DEPARTMENTS

CONCRETE BARRIER CURB AND GUTTER

CONCRETE BARRIER CURB AND GUTTER

3/8" EXPANSION JOINT

URBAN COMMERCIAL

SPLIT APPROACH

STREET PATCH

SCALE: NTS

GRIND AND OVERLAY OR SAWCUT EXISTING PAVEMENT

CURB AND GUTTER INSTALLED

PER CITY STANDARD DETAIL NO. 01.02.09

10" SUBBASE MATERIAL

SUBGRADE PREPARATION SHALL MEET THE REQUIREMENTS OF

SUBBASE MATERIAL SHALL BE GRAVEL BORROW MEETING THE

REQUIREMENTS OF WSDOT STANDARD SPEC. 9-03.14(1) OR

RESPONSIBILITY OF THE CONTRACTOR TO MEET THE COMPACTION

REQUIREMENTS AND CONTROL ALL WORK. THE CITY OF PUYALLUP

RESERVES THE RIGHT TO REQUIRE TESTS AT THE CONTRACTOR'S

CRUSHED BALLAST MEETING THE REQUIREMENTS OF WSDOT STANDARD

SPEC. 9-03.9(1). CRUSHED SURFACING SHALL MEET THE GRADATION

REQUIREMENTS OF WSDOT STANDARD SPEC. 9-03.9(3). THE SUBBASE

AND BASE MATERIAL SHALL BE INSTALLED IN ACCORDANCE WITH

. SOIL STABILIZATION FABRIC MAY BE REQUIRED BY THE DEVELOPMENT

THE BASE MATERIAL. WHEN REQUIRED, THE CONTRACTOR SHALL

WITH WSDOT STANDARD SPEC 5-04. DESIGN ENGINEER SHALL

. TEMPERATURE SHALL NOT EXCEED 325°F AT DISCHARGE OF THE

PLANT NOR BE LESS THAN 185°F LEAVING THE SPREADER BOX.

SUBMIT A STATE APPROVED HMA MIX FOR APPROVAL.

WSDOT STANDARD SPEC. 2-06.3(1). IT SHALL BE THE

. ALL DEPTHS ARE MINIMUM COMPACTED DEPTHS.

EXPENSE.

TACK SEALED WITH AR4000

AND REMOVE BROKEN OR CRACKED ASPHALT TO MAKE A

NEAT CLEAN LINE TO MATCH TO EXISTING PAVEMENT. ---

FULL DEPTH TRANSITION

ZONE

HALF STREET

SUITABLE NATIVE SOILS SUBGRADE

IMPROVEMENT

7 HALF STREET IMPROVEMENT

reference no. **C3.1**

12" --

DRIVEWAY APPROACH

6'-0" PLAN —(2) #7 REBAR ADHESIVE PER WSDOT SECTION 9-26 OR APPROVED EQUAL - PAVEMENT SECTION 1" HOLE FOR REBAR (2) 24" LENGTH #5 REBAR SECTION

2 CONCRETE WHEEL STOP
SCALE: NTS

WIDTH AS SPECIFIED ON DRAWINGS GRADE POINT-OR ROADWAY THICKENED EDGE COMPACTED SUBGRADE -CONC CL 5(3/4) ---NOTES:

1. "H" SHALL BE 6" FROM FINISHED GRADE UNLESS OTHERWISE SPECIFIED

2. VERTICAL BACKFACE OF CURB SHALL BE FORMED AGAINST NATIVE EARTH WHERE PRACTICAL, OTHERWISE BY BACKFORM LEFT IN PLACE

A PORTION OF THE SE 1/4, SE 1/4, SECTION 21, TOWNSHIP 20N, RANGE 4E, W.M.

SIDEWALK WITH THICKENED EDGE SCALE: NTS

City of Puyallup **Development & Permitting Services ISSUED PERMIT** Building Planning Public Works Engineering Traffic

APPROVED CITY OF PUYALLUP FIRE CODE OFFICIAL July 25, 2022 NOTE: THIS APPROVAL IS VOID AFTER

180 DAYS FROM APPROVAL DATE.

THE CITY WILL NOT BE RESPONSIBLE

FOR ERRORS AND/OR OMISSIONS ON

FIELD CONDITIONS MAY DICTATE

CHANGES TO THESE PLANS AS

— HMA CLASS 1/2", PG 64-28

TOP COURSE PER

BASE COURSE PER

WSDOT 9.03-9(3)

WSDOT 9.03-9(3)

DETERMINED BY THE FIRE CODE

THESE PLANS.

FIRE HYDRANT/FDC LOCATION/ACCESS

CITY OF PUYALLUP

DEVELOPMENT ENGINEERING 7/22/2022

NOTE: THIS APPROVAL IS VOID AFTER 180 DAYS FROM APPROVAL DATE. THE CITY WILL NOT BE RESPONSIBLE FOR ERRORS AND/OR OMISSIONS ON THESE PLANS. FIELD CONDITIONS MAY DICTATE CHANGES TO THESE PLANS AS DETERMINED BY THE DEVELOPMENT ENGINEERING MANAGER.

APPROVED

- CRUSHED SURFACING CRUSHED SURFACING 12" GRAVEL BASE PER WSDOT STD SPEC 9-03.10 (EXISTING SOILS MAY BE USED IF THEY MEET THIS SPECIFICATION). COMPACT SUBGRADE TO 95% PER MODIFIED PROCTOR TEST

PERMIT SET

BUILDING

1. ALL DEPTHS SHOWN ARE COMPACTED DEPTHS.

2. THE CONTRACTOR SHALL EXPOSE EXISTING SUBGRADE, PROOF ROLL AND COMPACT TO 95% PER MODIFIED PROCTOR TEST. IF YIELDING CONDITIONS ARE ENCOUNTERED, YIELDING MATERIALS SHALL BE REPLACED WITH IMPORTED STRUCTURAL FILL MATERIAL THE DEPTH OF MATERIAL REPLACEMENT SHALL BE DETERMINED BY THE GEOTECHNICAL ENGINEER.

ONSITE HMA PAVEMENT SECTION

SIGN POST

INSTALLATION FOR

INSIDE PAVED AREA


1 EXTRUDED CURB SCALE: NTS

- 1. ACCESSIBLE PARKING AND ACCESSIBLE AISLES SHALL NOT EXCEED 1:50 IN SLOPE IN ANY DIRECTION. IF ONLY ONE ACCESS AISLE IS INSTALLED, IT IS TO BE A VAN SIZE.
- 2. PARKING STALL DIMENSIONING SHALL BE IN ACCORDANCE WITH THAN WHAT IS SHOWN ON THE SITE LAYOUT PLAN.
- STRIPING ON ASPHALT PARKING LOTS. 4. CONTRACTOR SHALL USE 4" WIDE YELLOW REFLECTIVE PAINT FOR

3. CONTRACTOR SHALL USE 4" WIDE WHITE REFLECTIVE PAINT FOR

STRIPING ON CONCRETE PARKING LOTS.

5. ALL PAINT MARKINGS SHALL BE INSTALLED WITH TWO COATS.

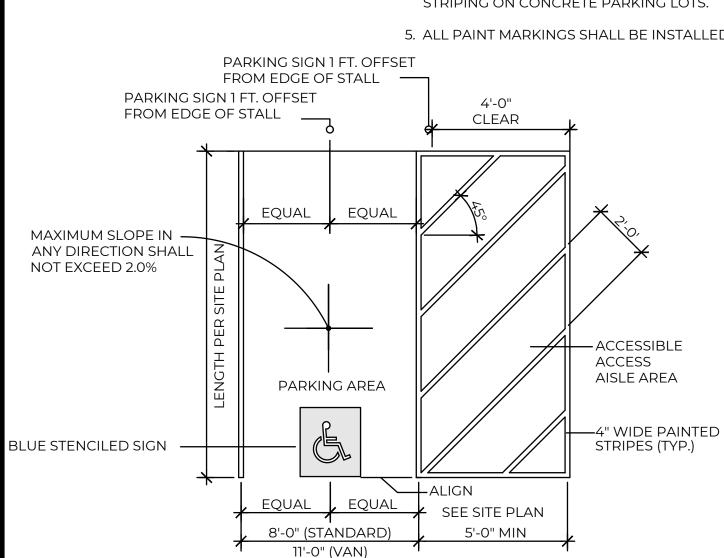

SIGN POST - 2" SQ,-12-GAGE STEEL TUBE LOWER SIGN POST SUPPORT — $2\frac{1}{4}$ " SQ, 12-GAGE STEEL TUBE DRIVE RIVET OR CORNER BOLT WITH NUT AND WASHERS -TWO REQUIRED 3000 PSI_ CONCRETE 2'-0" SIGN DETAIL

1. WHERE SIGN IS LOCATED WITHIN SIDEWALK, LOCATE 12" FROM FACE OF CURB, AND TERMINATE TOP OF SIGN FOUNDATION BELOW SIDEWALK (SIDEWALK SURFACE MUST BE

ACCESSIBILITY SIGN

MUTCD R7-8 (TYP.) AND

MUTCD R7-8P BELOW

(WHERE APPLICABLE)

CONTINUOUS). 2. SIGNS IDENTIFYING VAN PARKING SPACES SHALL CONTAIN THE DESIGNATION "VAN ACCESSIBLE" WITH MUTCD R7-8P.

3. SIGNS SHALL BE 60-INCHES MINIMUM ABOVE

THE FLOOR OF THE PARKING SPACE, MEASURED TO THE BOTTOM OF THE SIGN. 4. A VERTICAL "NO PARKING" SIGN SHALL BE ERECTED AT THE HEAD OF EACH ACCESS AISLE LOCATED ADJACENT TO AN ACCESSIBLE

PARKING SPACE. SIGNAGE SHALL NOT BLOCK THE PEDESTRIAN ACCESS ROUTE. 4. ALL SIGNAGE SHALL BE IN ACCORDANCE WITH

WITH WAC 1101.2.9

SIGN PANEL-SHOULDER COLLARED BOLT (TYP.) SIGN POST: 2 ½" SQUARE, 12- GAGE STEEL TUBE CONCRETE LOWER SLIP PLATE STUB —(LOWER SIGN POST SUPPORT NOT SHOWN) FINISHED _ ISOMETRIC VIEW LOWER SIGN POST SUPPORT 3" SQUARE,-7-GAGE STEEL TUBE EXPLODED VIEW
TYPE SB-3 SLIP BASE ASSEMBLY COMMERCIAL CONCRETE 18" DIAMETER ELEVATION SLIP PLATE DETAIL NOTES: FOR TYPE SB-3

DIMENSIONS FOR THE PARTS USED TO ASSEMBLE THE BASE CONNECTIONS ARE INTENTIONALLY NOT SHOWN. BASE CONNECTIONS ARE PATENTED, MANUFACTURED PRODUCTS
THAT ARE IN COMPLIANCE WITH NCHRP 350 CRASH TEST CRITERIA. THE BASE CONNECTION DETAILS ARE ONLY SHOWN TO ILLUSTRATE HOW PARTS ARE ASSEMBLED 2. DO NOT TIGHTEN ANY SINGLE SLIP PLATE BOLT TO THE RECOMMENDED TORQUE BEFORE

PRETIGHTENING THE OTHER BOLTS. PROGRESSIVELY TIGHTEN THE THREE SLIP PLATE BOLTS IN 10 FT-LB INCREMENTS, ALTERNATELY, TO A FINAL TORQUE OF 40 FT-LB ON EACH. 3. TOP OF CONCRETE FOUNDATION SHALL BE SMOOTH, DENSE AND UNIFORM TO

FINISHED GROUND LINE.

FIRE LANE VERTICAL SIGNAGE POST INSTALLATION

MOMENTUM CIVIL 1145 BROADWAY, SUITE 115 **TACOMA, WA 98402** PHONE: 253.319.1504

CHECKED BY: M. PUDISTS DESIGNED BY: K. MURPHY DRAWN BY: K. MURPHY

HORZ. DATUM: NAD83(11) VERT. DATUM: **NAVD88** 7/19/22

PROJECT NO. LARS-0001

REFERENCE NO. **C3.2**

SHEET NO. **9** of **25**

ACCESSIBLE PARKING AND ACCESS AISLE

ACCESSIBILITY SIGN INSTALLATION



Know what's **below. Call** before you dig.

CITY OF PUYALLUP

DEVELOPMENT ENGINEERING 7/22/2022

NOTE: THIS APPROVAL IS VOID AFTER 180 DAYS FROM APPROVAL DATE. THE CITY WILL NOT BE RESPONSIBLE FOR ERRORS AND/OR OMISSIONS ON THESE PLANS. FIELD CONDITIONS MAY DICTATE CHANGES TO THESE PLANS AS DETERMINED BY THE DEVELOPMENT ENGINEERING MANAGER.

- 8-INCH WHITE GORE STRIPE WITH TYPE 2W RPMS @ 20-FT O.C. PER DETAIL
- PAVEMENT MARKER LETTERING "ONLY" PER DETAILS 1 AND 2 ON SHEET
- 4) RIGHT TURN PAVEMENT ARROW PER DETAILS 2 AND 4 ON SHEET C3.4.
- EXISTING CENTERLINE STRIPING BEYOND PROJECT LIMITS.
- PROTECT EXISTING STOP-BAR AND PEDESTRIAN CROSSWALK STRIPING. IF DISTURBED, CONTRACTOR SHALL REPLACE PER CITY OF PUYALLUP
- APPLY TWO COATS YELLOW PAINT ON CURBING TO MATCH EXISTING CONDITIONS. PAINT SHALL CONFORM TO WSDOT STANDARD SPECIFICATION 9-34. REPAINT ALL CURBING THAT CURRENTLY HAS YELLOW PAINT.


CIVIL KEYNOTES

4-INCH DOUBLE YELLOW CENTERLINE STRIPE WITH TYPE 2YY @ 20-FT O.C. PER DETAIL 3 ON SHEET C3.4.

4-INCH YELLOW CENTERLINE WITH 10-FT STRIPE 40-FT O.C. ALIGN WITH

STANDARD DETAIL 01.03.11

City of Puyallup **Development & Permitting Services ISSUED PERMIT** Planning Building Public Works Engineering Traffic

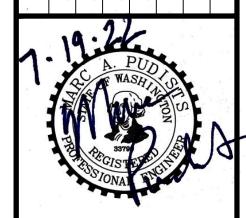

PERMIT SET

1145 BROADWAY, SUITE 115 TACOMA, WA 98402 PHONE: 253.319.1504

CHECKED BY: M. PUDISTS DESIGNED BY: K. MURPHY DRAWN BY: **K. MURPHY** HORZ. DATUM: NAD83(11)


VERT. DATUM: **NAVD88**

DATE: **7/19/22**


PROJECT NO. LARS-0001 SHEET NO. **10** of **25**


REFERENCE NO. **C3.3**


PAVEMENT MARKINGS, INCLUDING CROSSWALKS, SHALL BE TYPE A LIQUID HOT APPLIED THERMOPLASTIC. PER STANDARD SPECIFICATIONS, SECTION 9-34 PAVEMENT MARKING MATERIAL, 9-34.1 GENERAL. 1 PAVEMENT MARKER ONLY SCALE: NTS PAVEMENT MARKER CITY OF "ONLY" DEVELOPMENT ENGINEERING and PUBLIC WORKS DEPARTMENTS

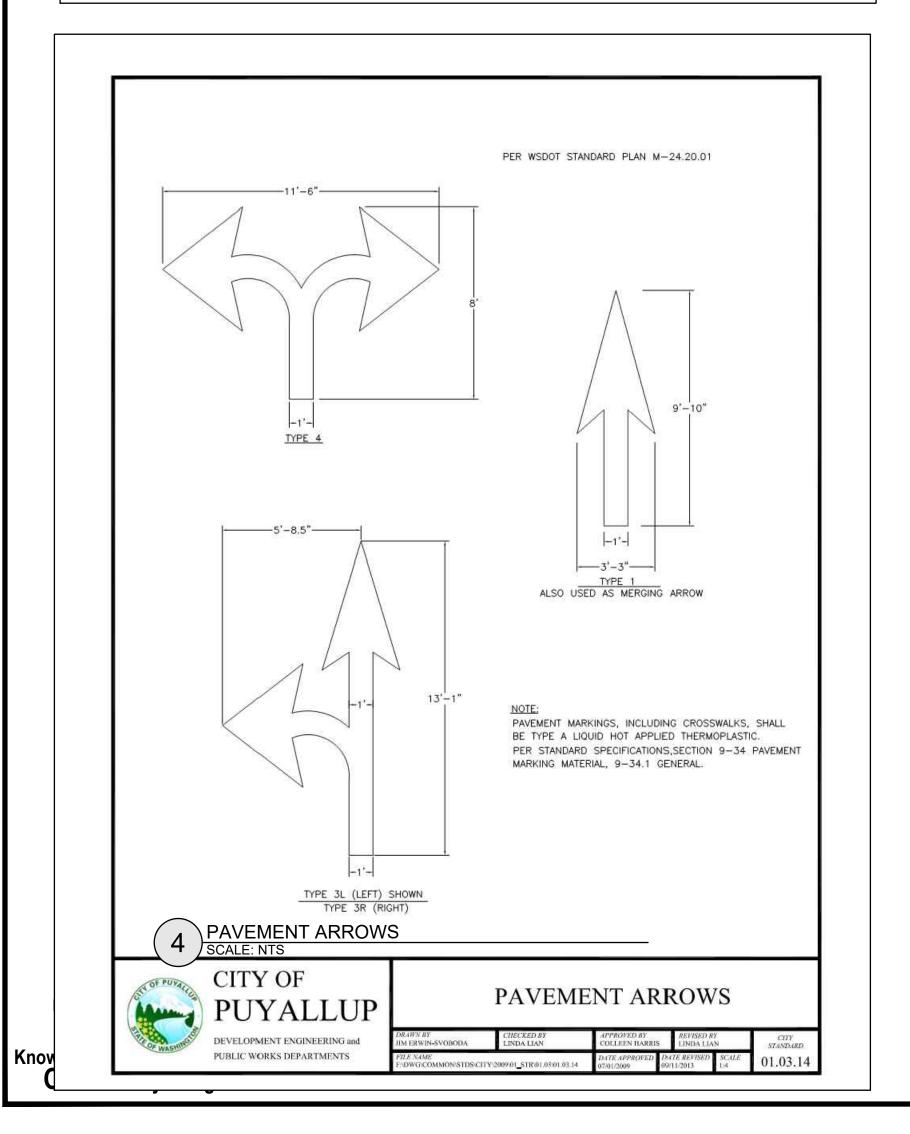

A PORTION OF THE SE 1/4, SE 1/4, SECTION 21, TOWNSHIP 20N, RANGE 4E, W.M.

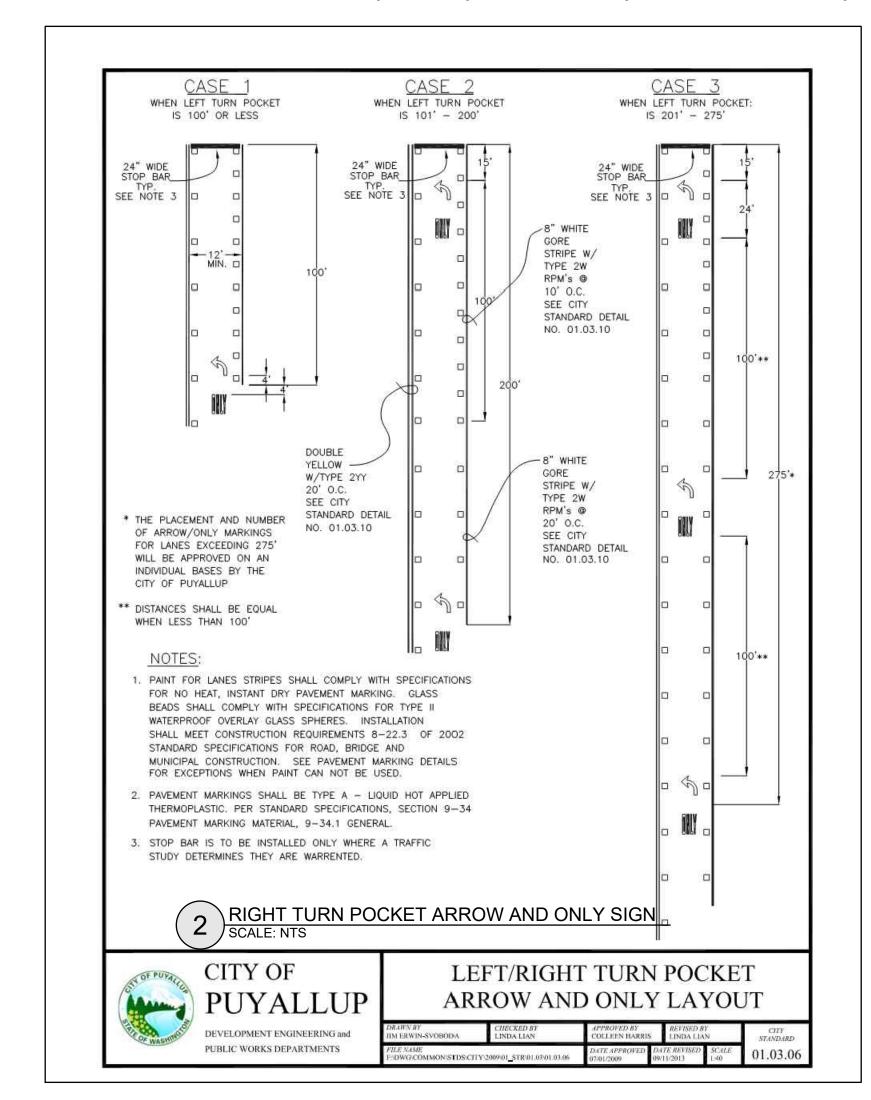

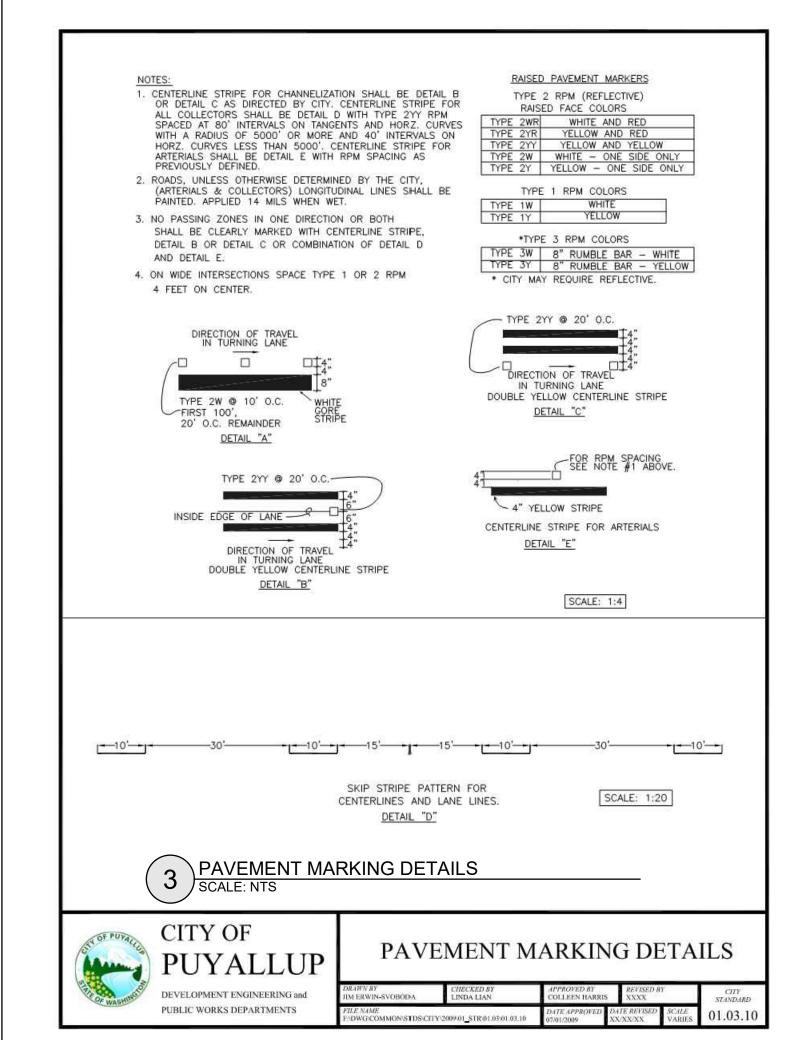

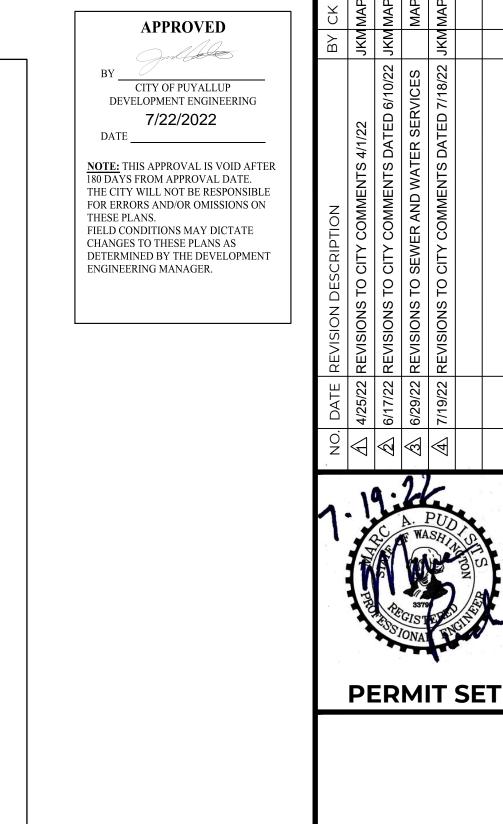



1OTIVE GROUP

300 BUILDING - LARSON AUTOI


NELIZATION


MOMENTUM CIVIL 1145 BROADWAY, SUITE 115 TACOMA, WA 98402 PHONE: 253.319.1504 CHECKED BY: M. PUDISTS DESIGNED BY: K. MURPHY DRAWN BY: K. MURPHY HORZ. DATUM: NAD83(11) VERT. DATUM: **NAVD88** DATE: **7/19/22**


PROJECT NO. LARS-0001


SHEET NO. **11** of **25** REFERENCE NO. **C3.4**

City of Puyallup **Development & Permitting Services ISSUED PERMIT** Building **Planning** Public Works Engineering Traffic

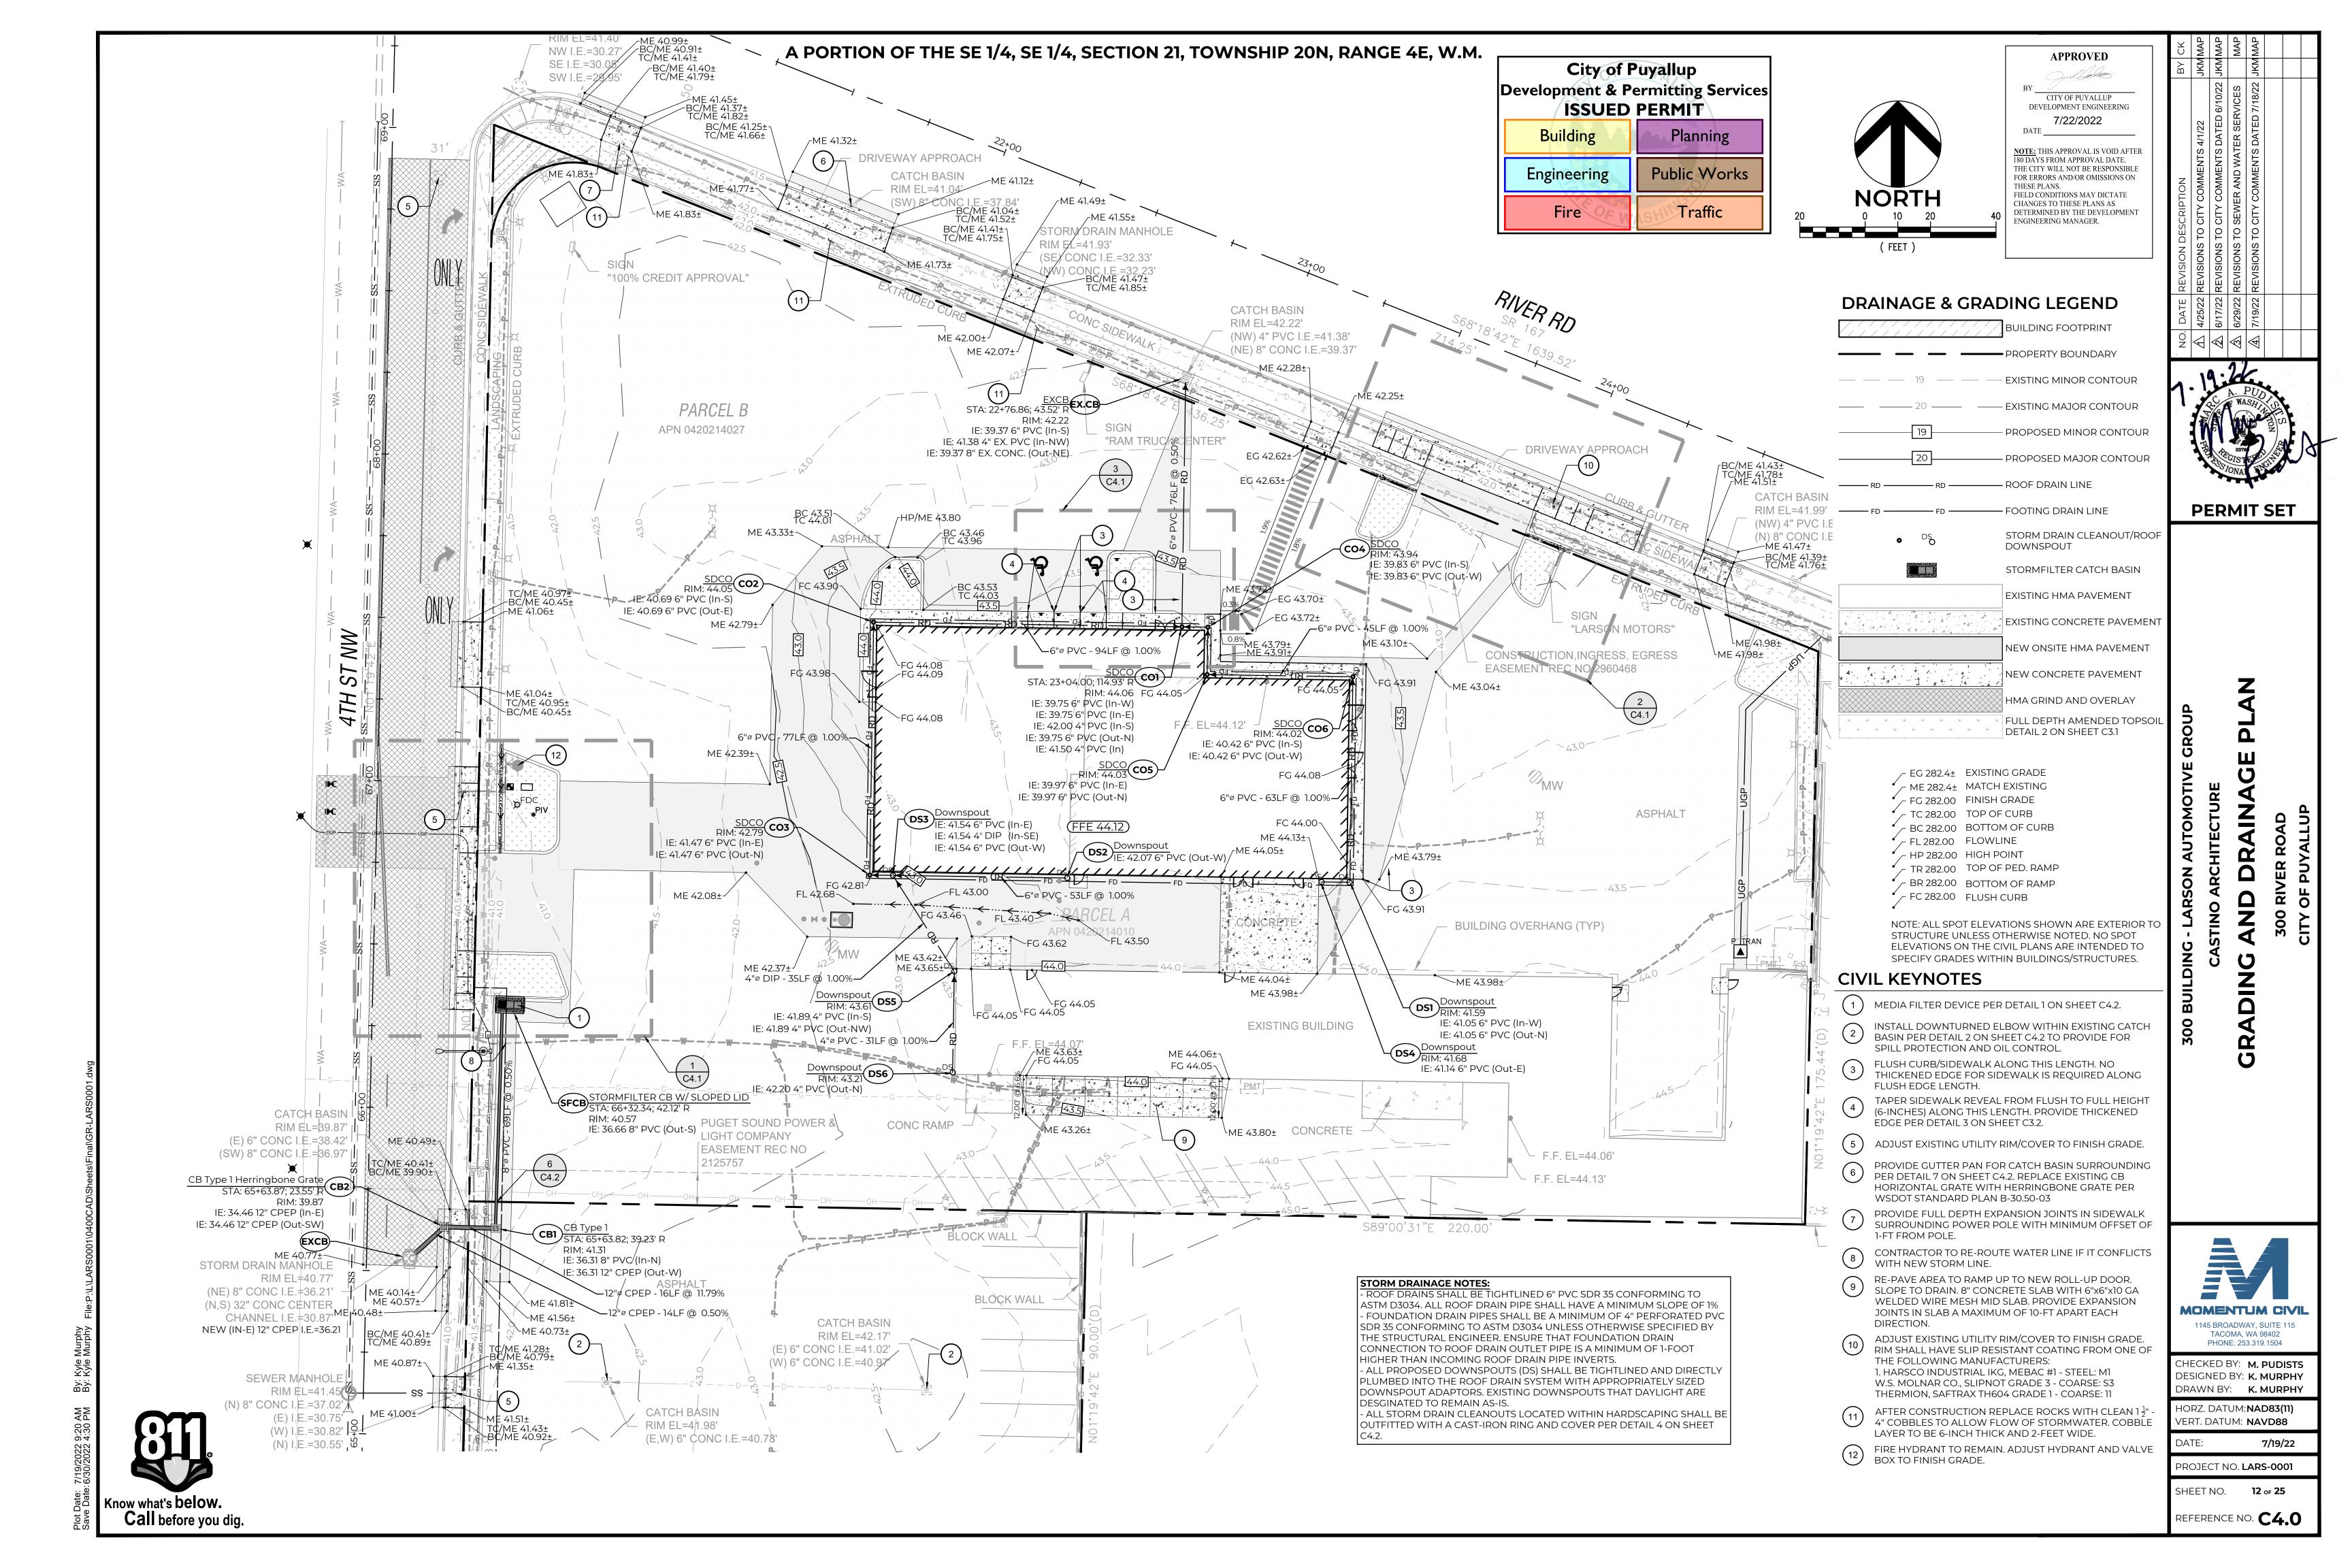

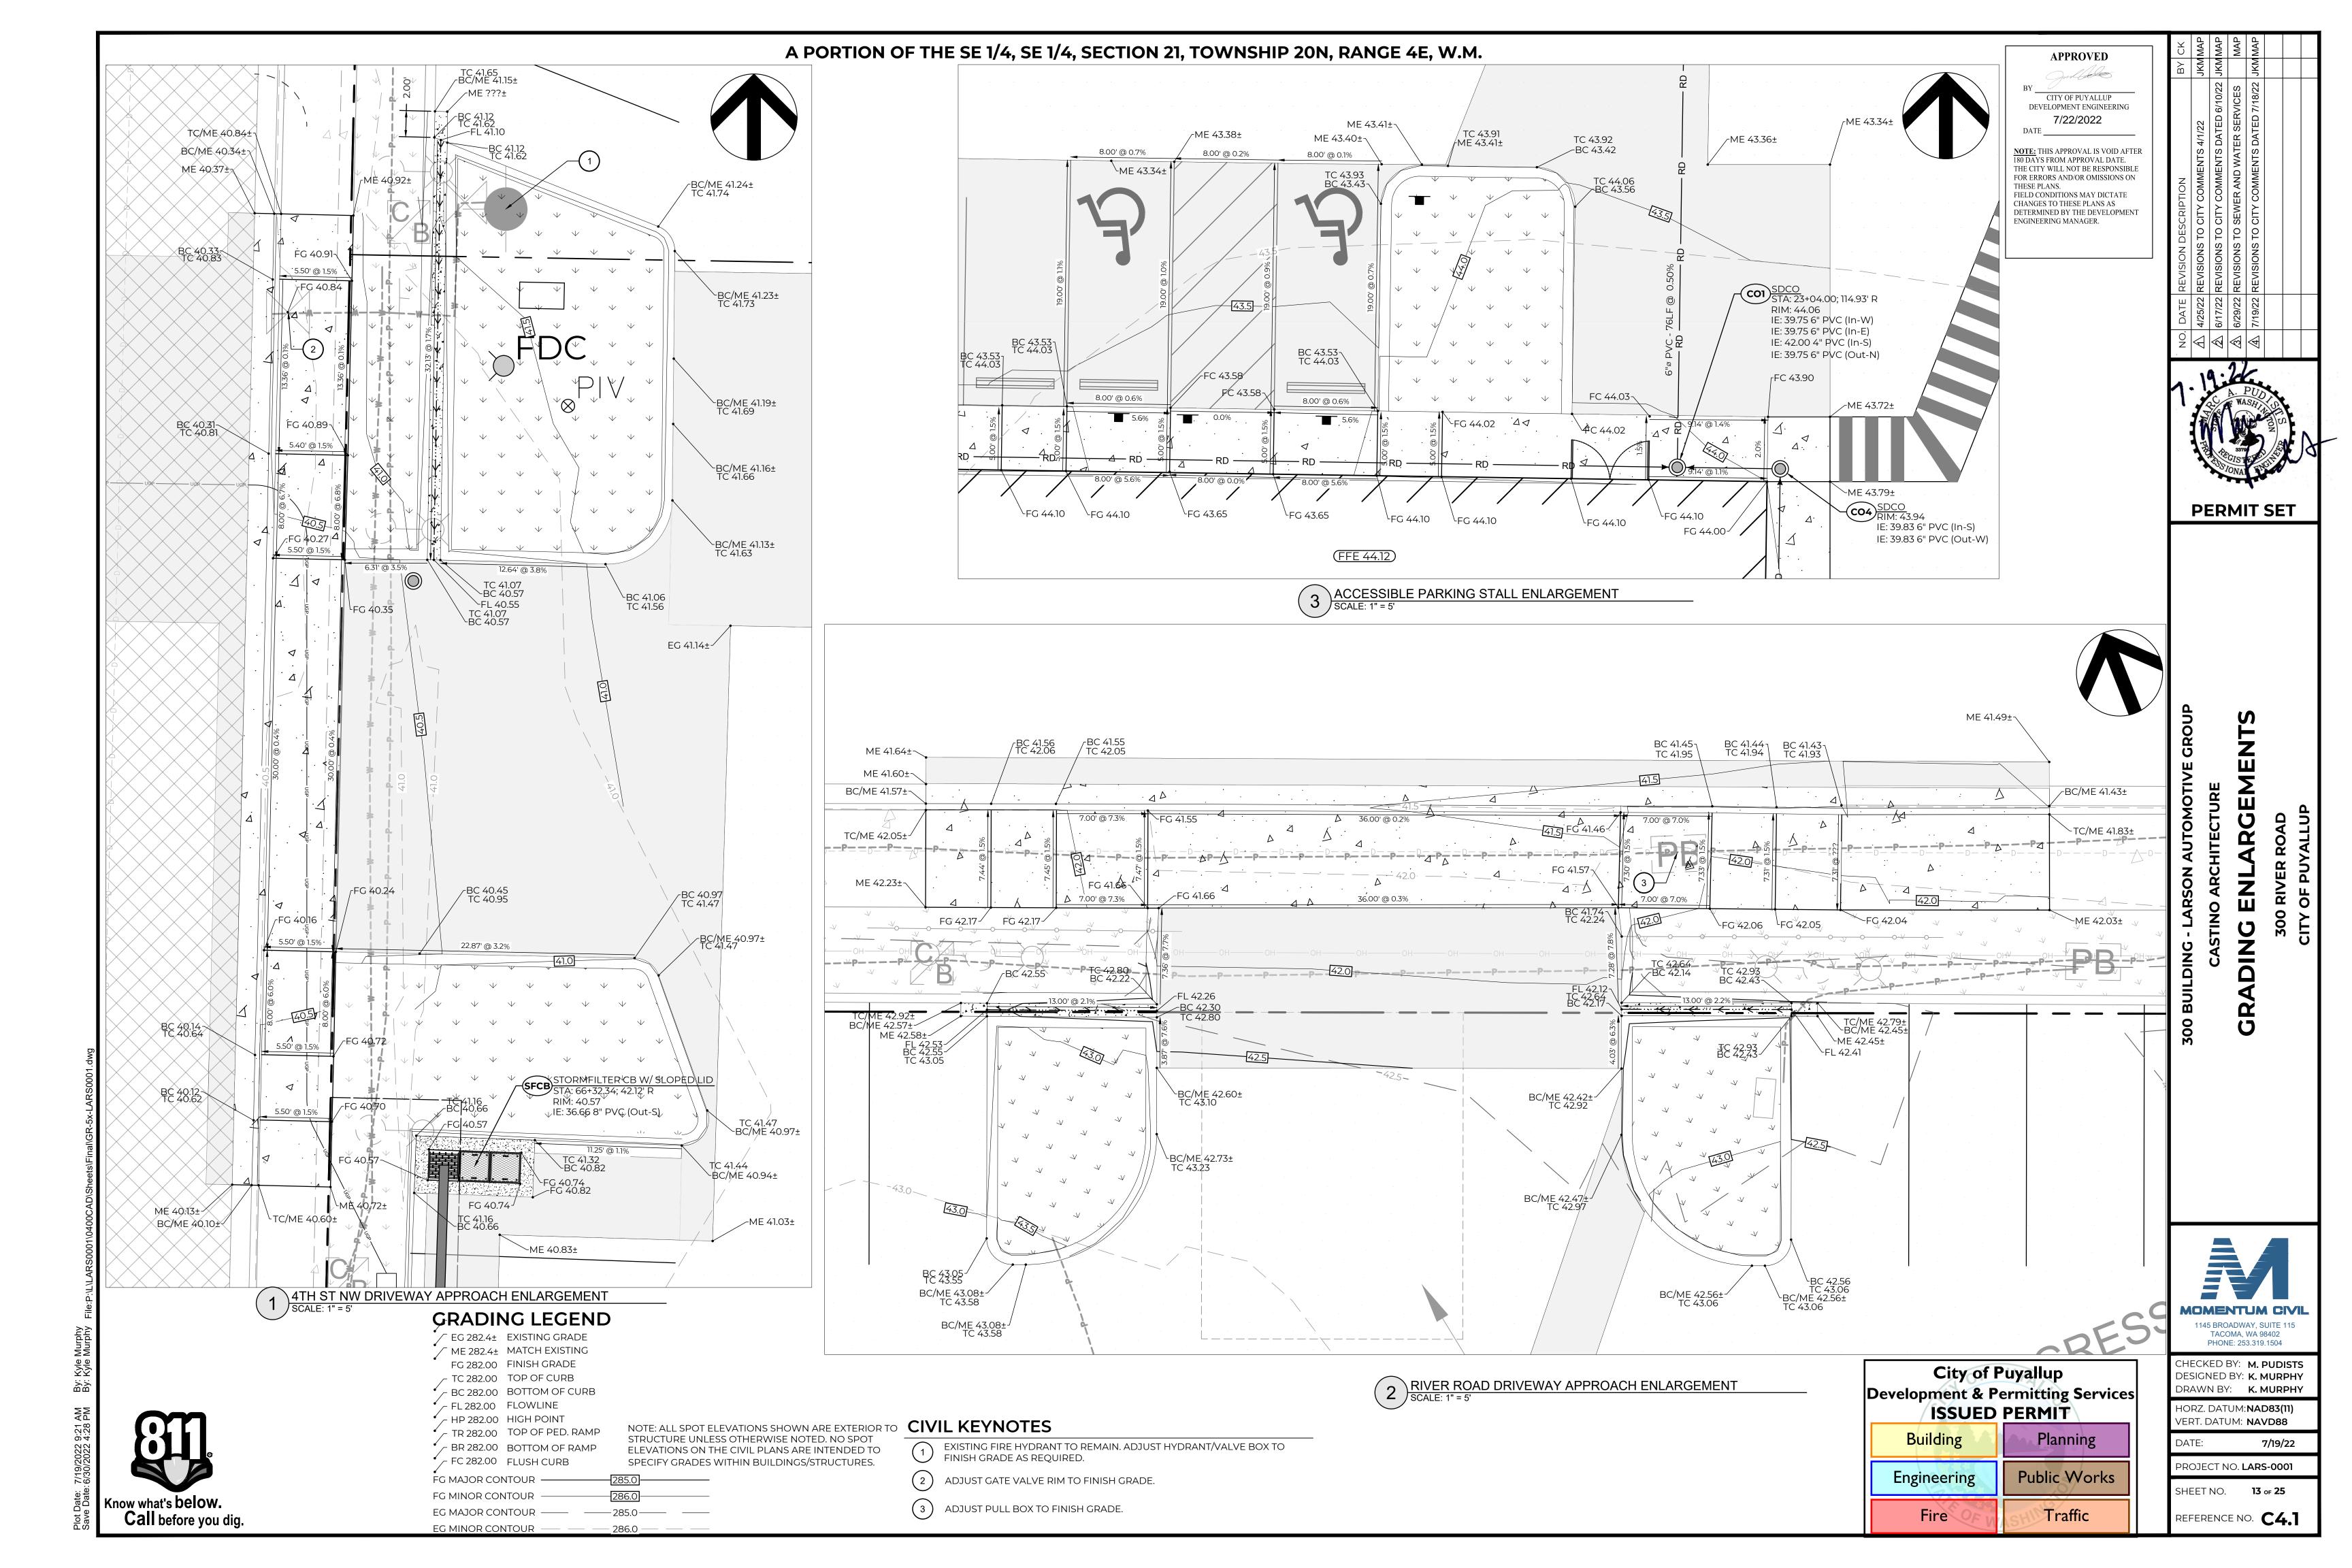

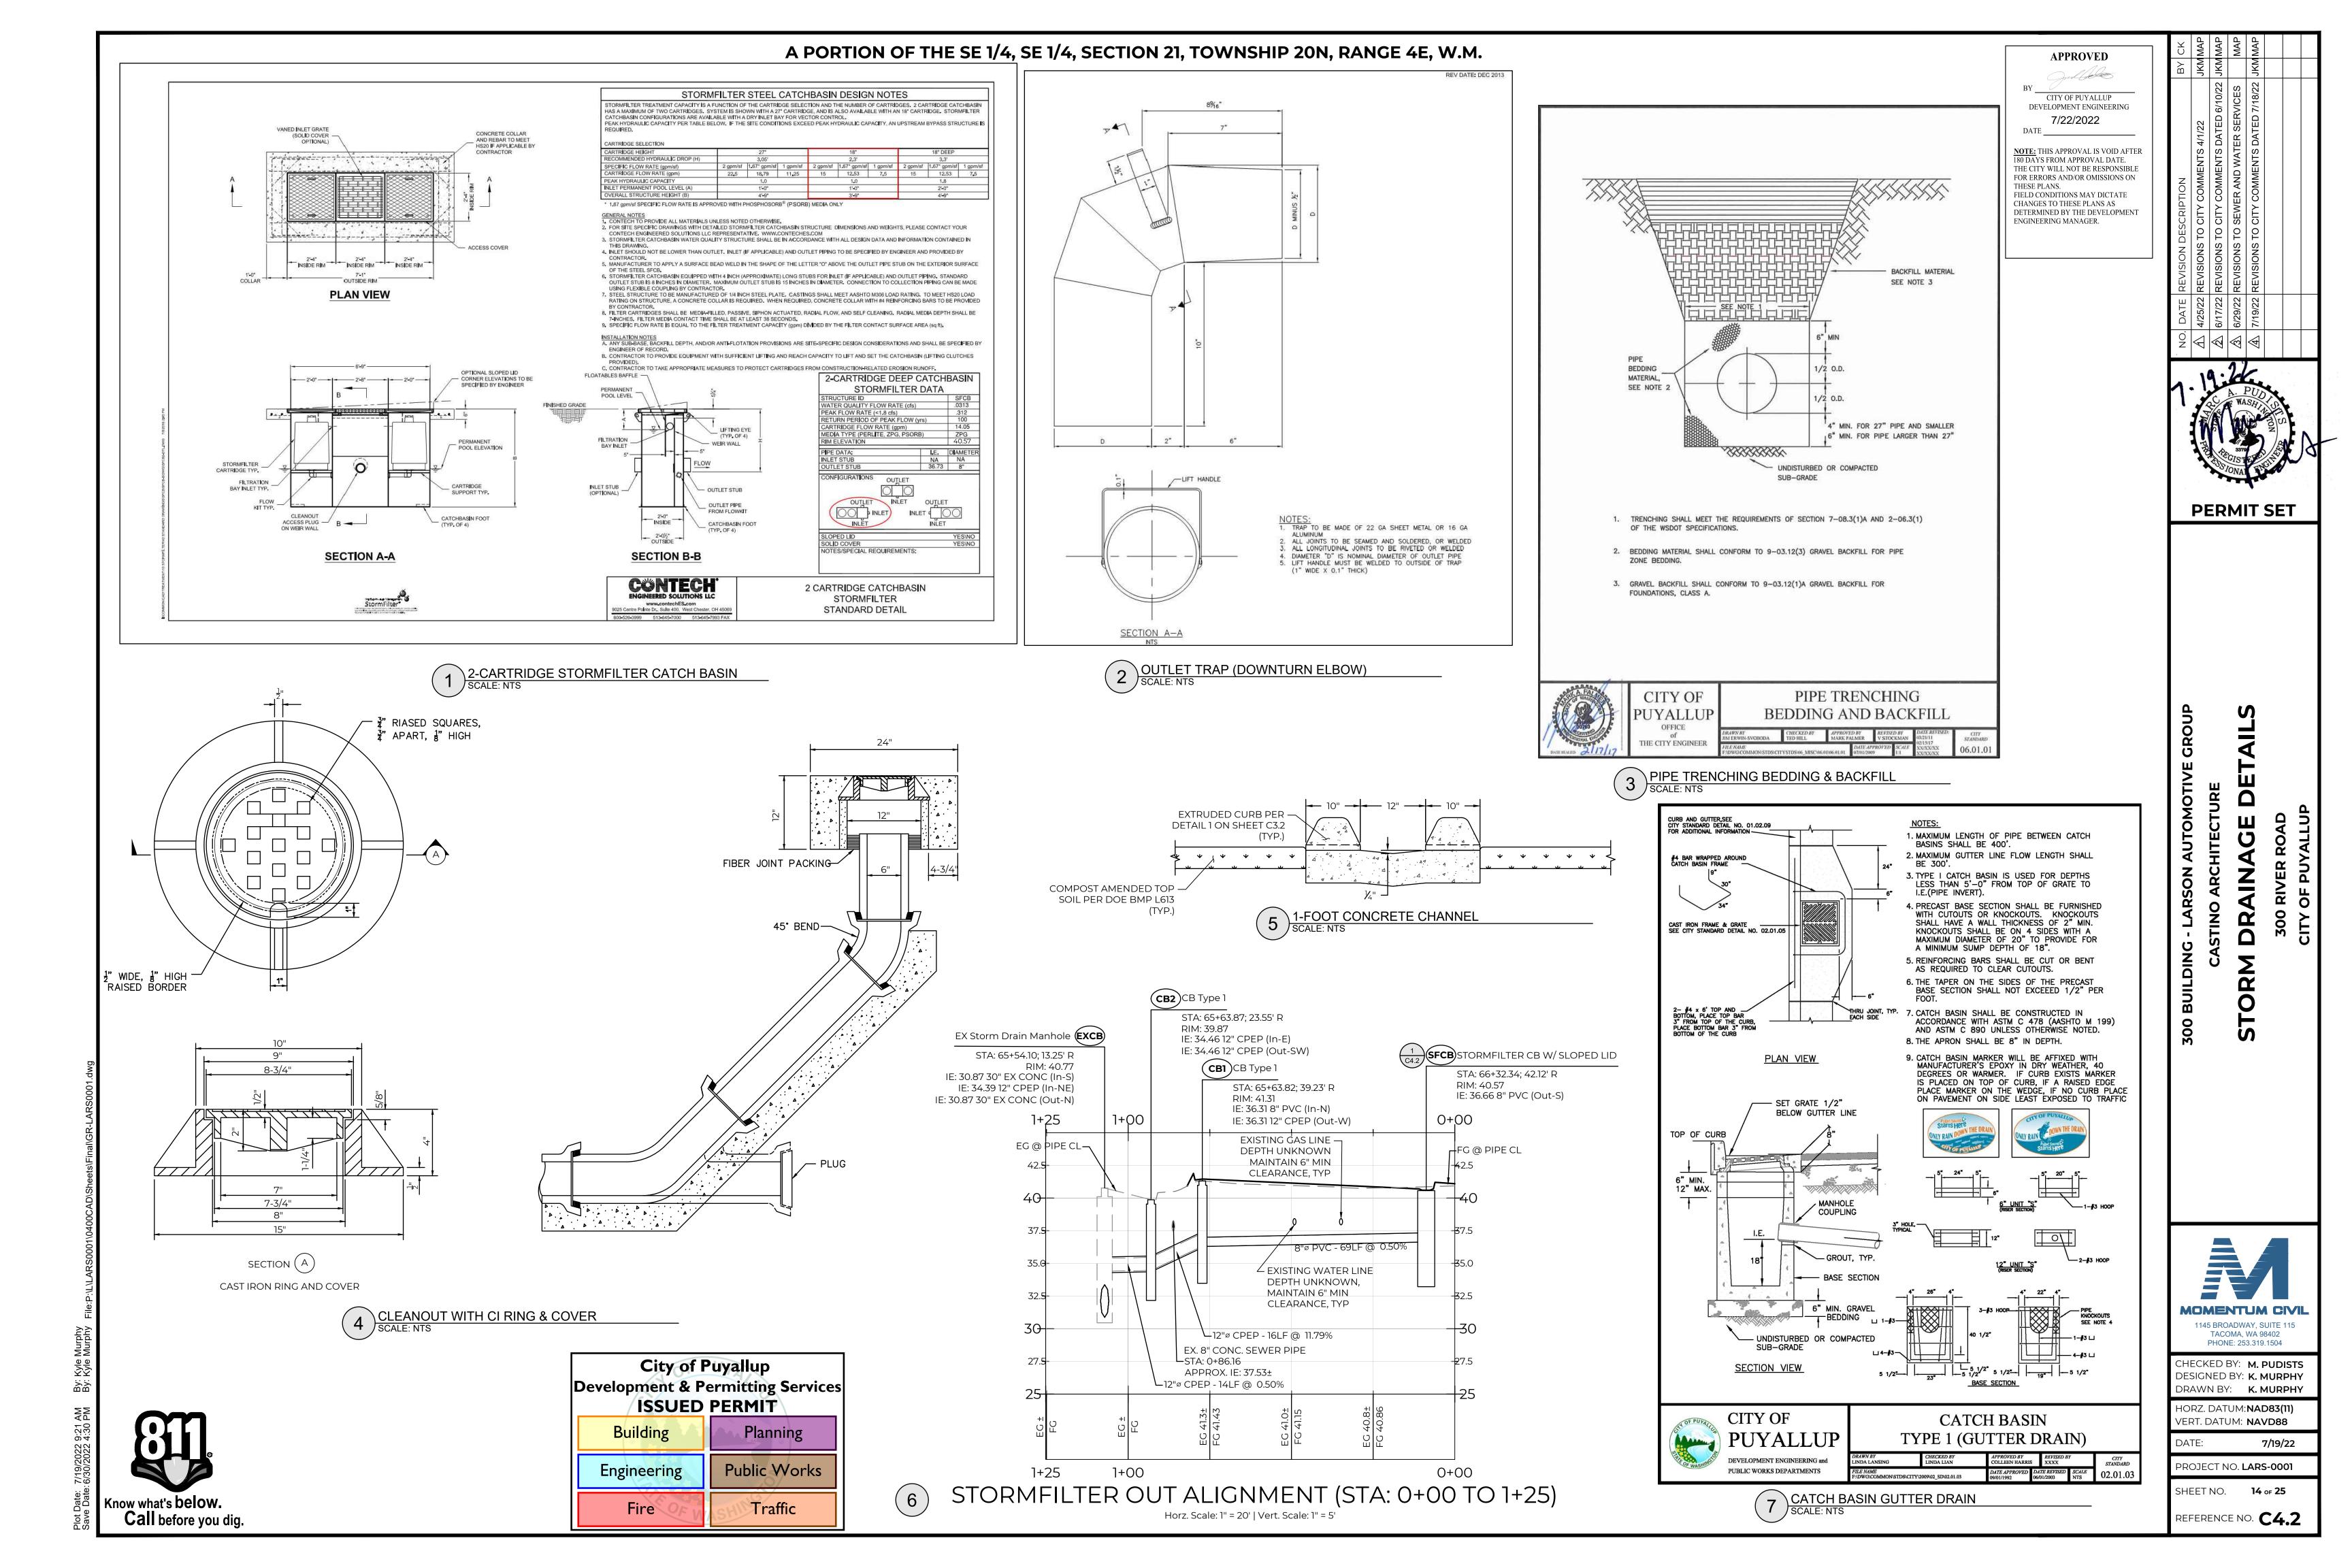

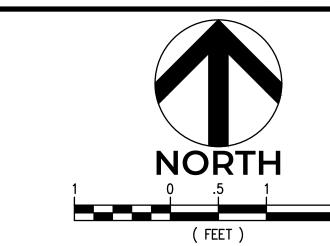

BY CITY OF PUYALLUP
DEVELOPMENT ENGINEERING 7/22/2022

NOTE: THIS APPROVAL IS VOID AFTER 180 DAYS FROM APPROVAL DATE.
THE CITY WILL NOT BE RESPONSIBLE FOR ERRORS AND/OR OMISSIONS ON THESE PLANS.
FIELD CONDITIONS MAY DICTATE
CHANGES TO THESE PLANS AS
DETERMINED BY THE DEVELOPMENT
ENGINEERING MANAGER.

PERMIT SET

WAY

300 BUILDING - LARSON AUTO


1145 BROADWAY, SUITE 115 TACOMA, WA 98402 PHONE: 253.319.1504

CHECKED BY: M. PUDISTS DESIGNED BY: K. MURPHY DRAWN BY: K. MURPHY


HORZ. DATUM: NAD83(11) VERT. DATUM: **NAVD88**

7/19/22 PROJECT NO. LARS-0001

SHEET NO. **15** of **25** REFERENCE NO. **C4.3**

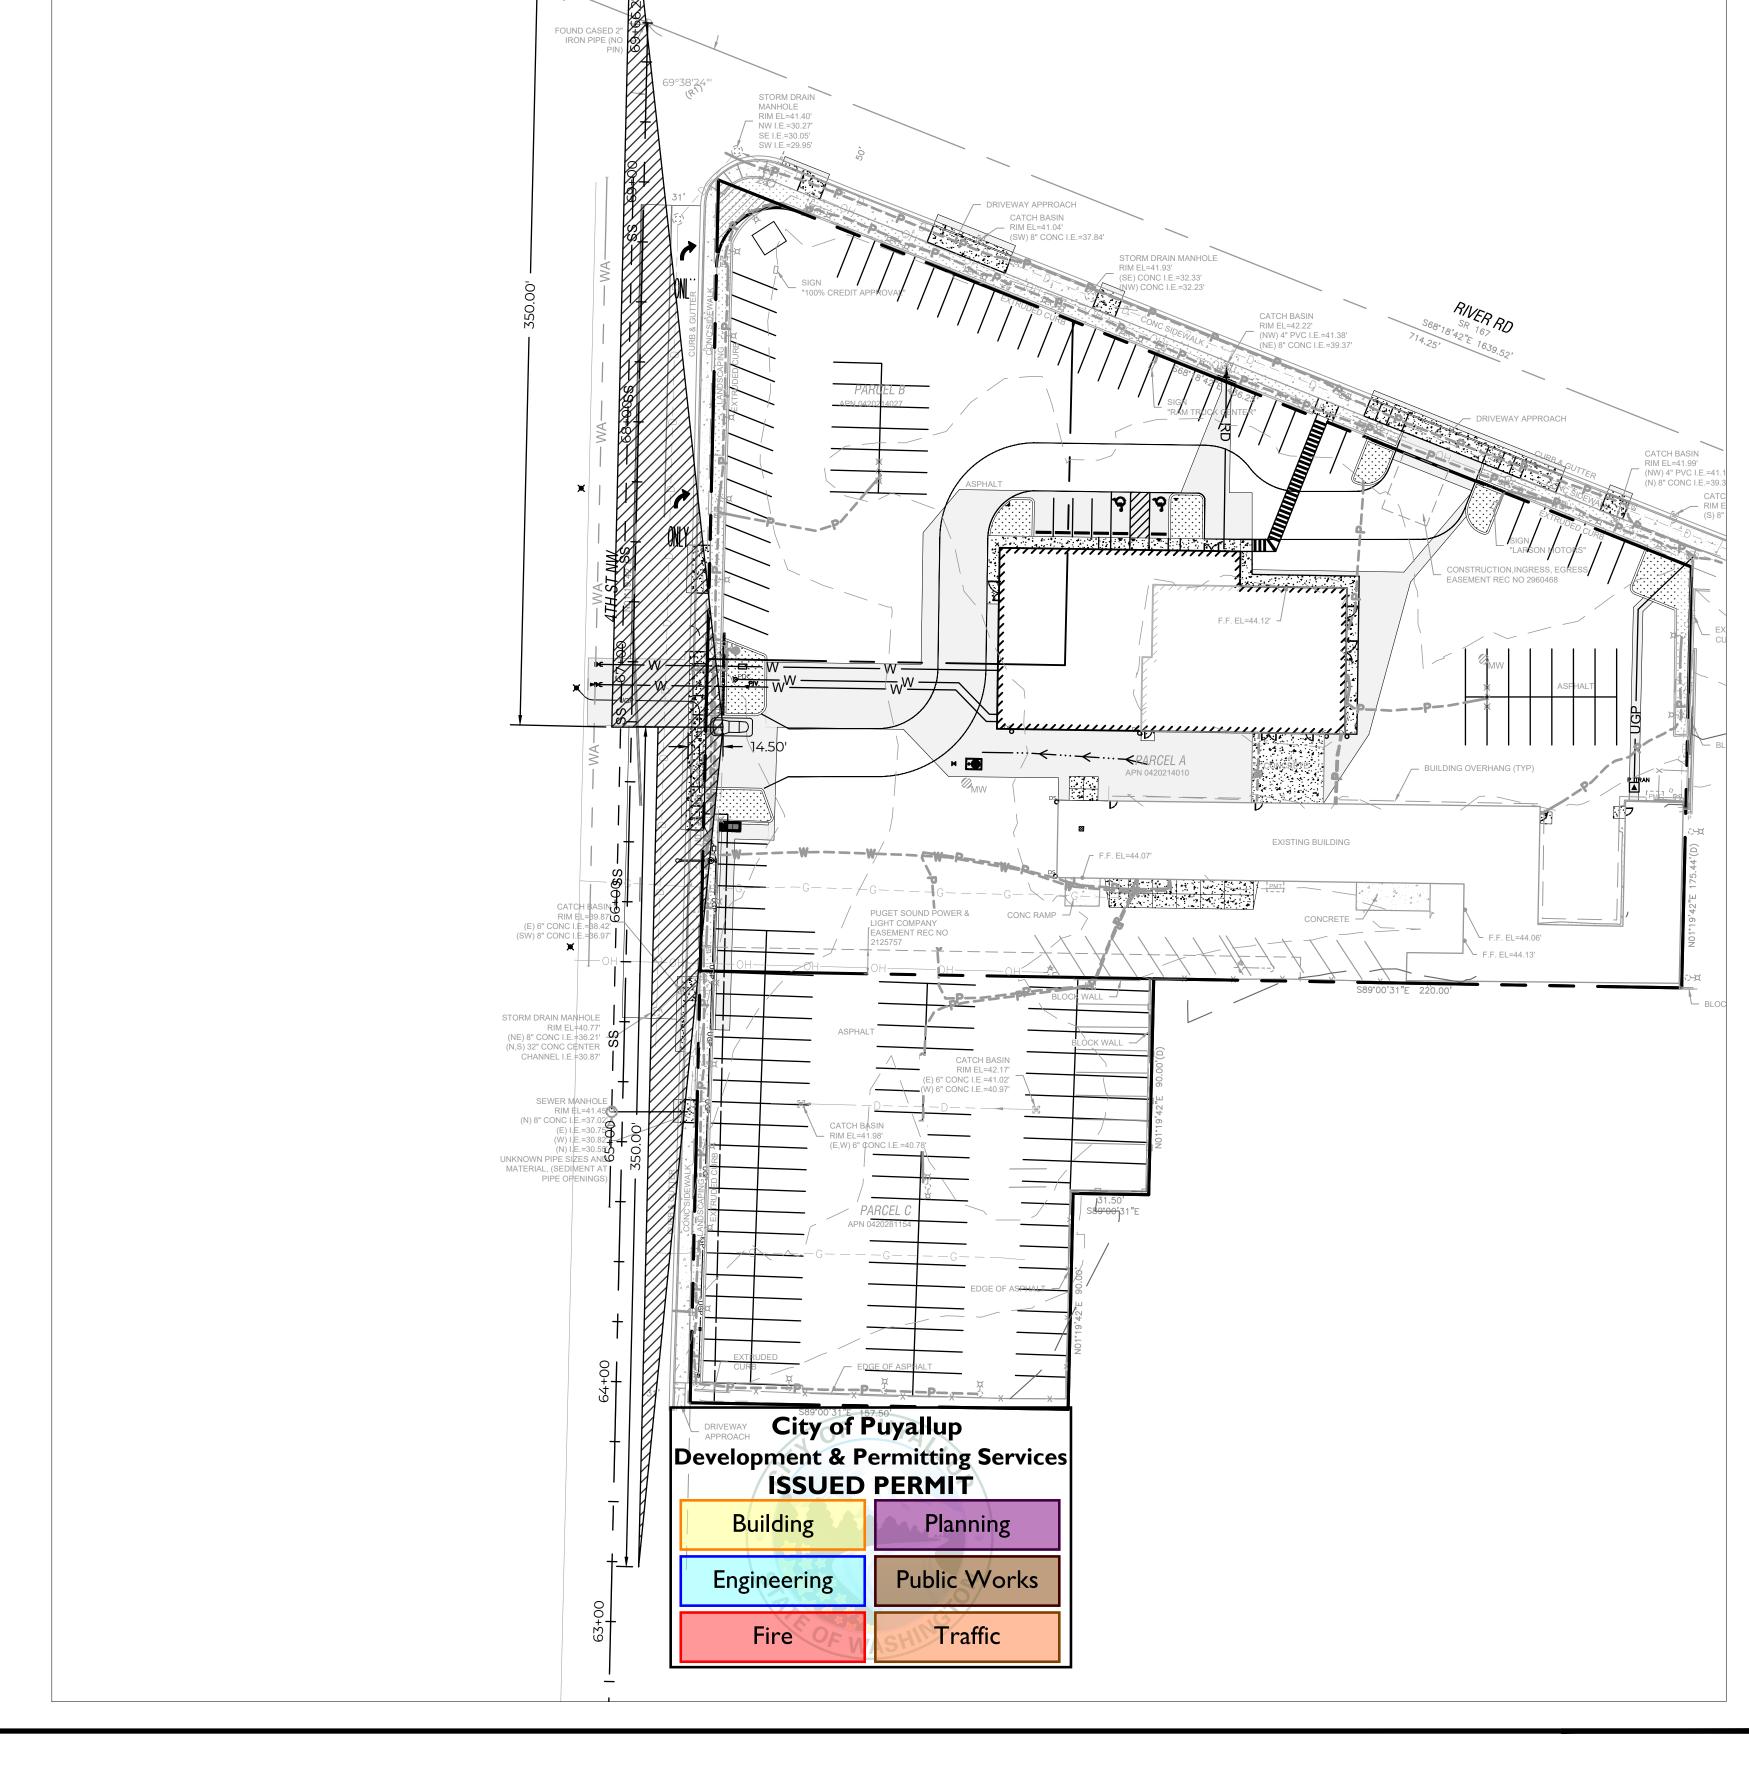



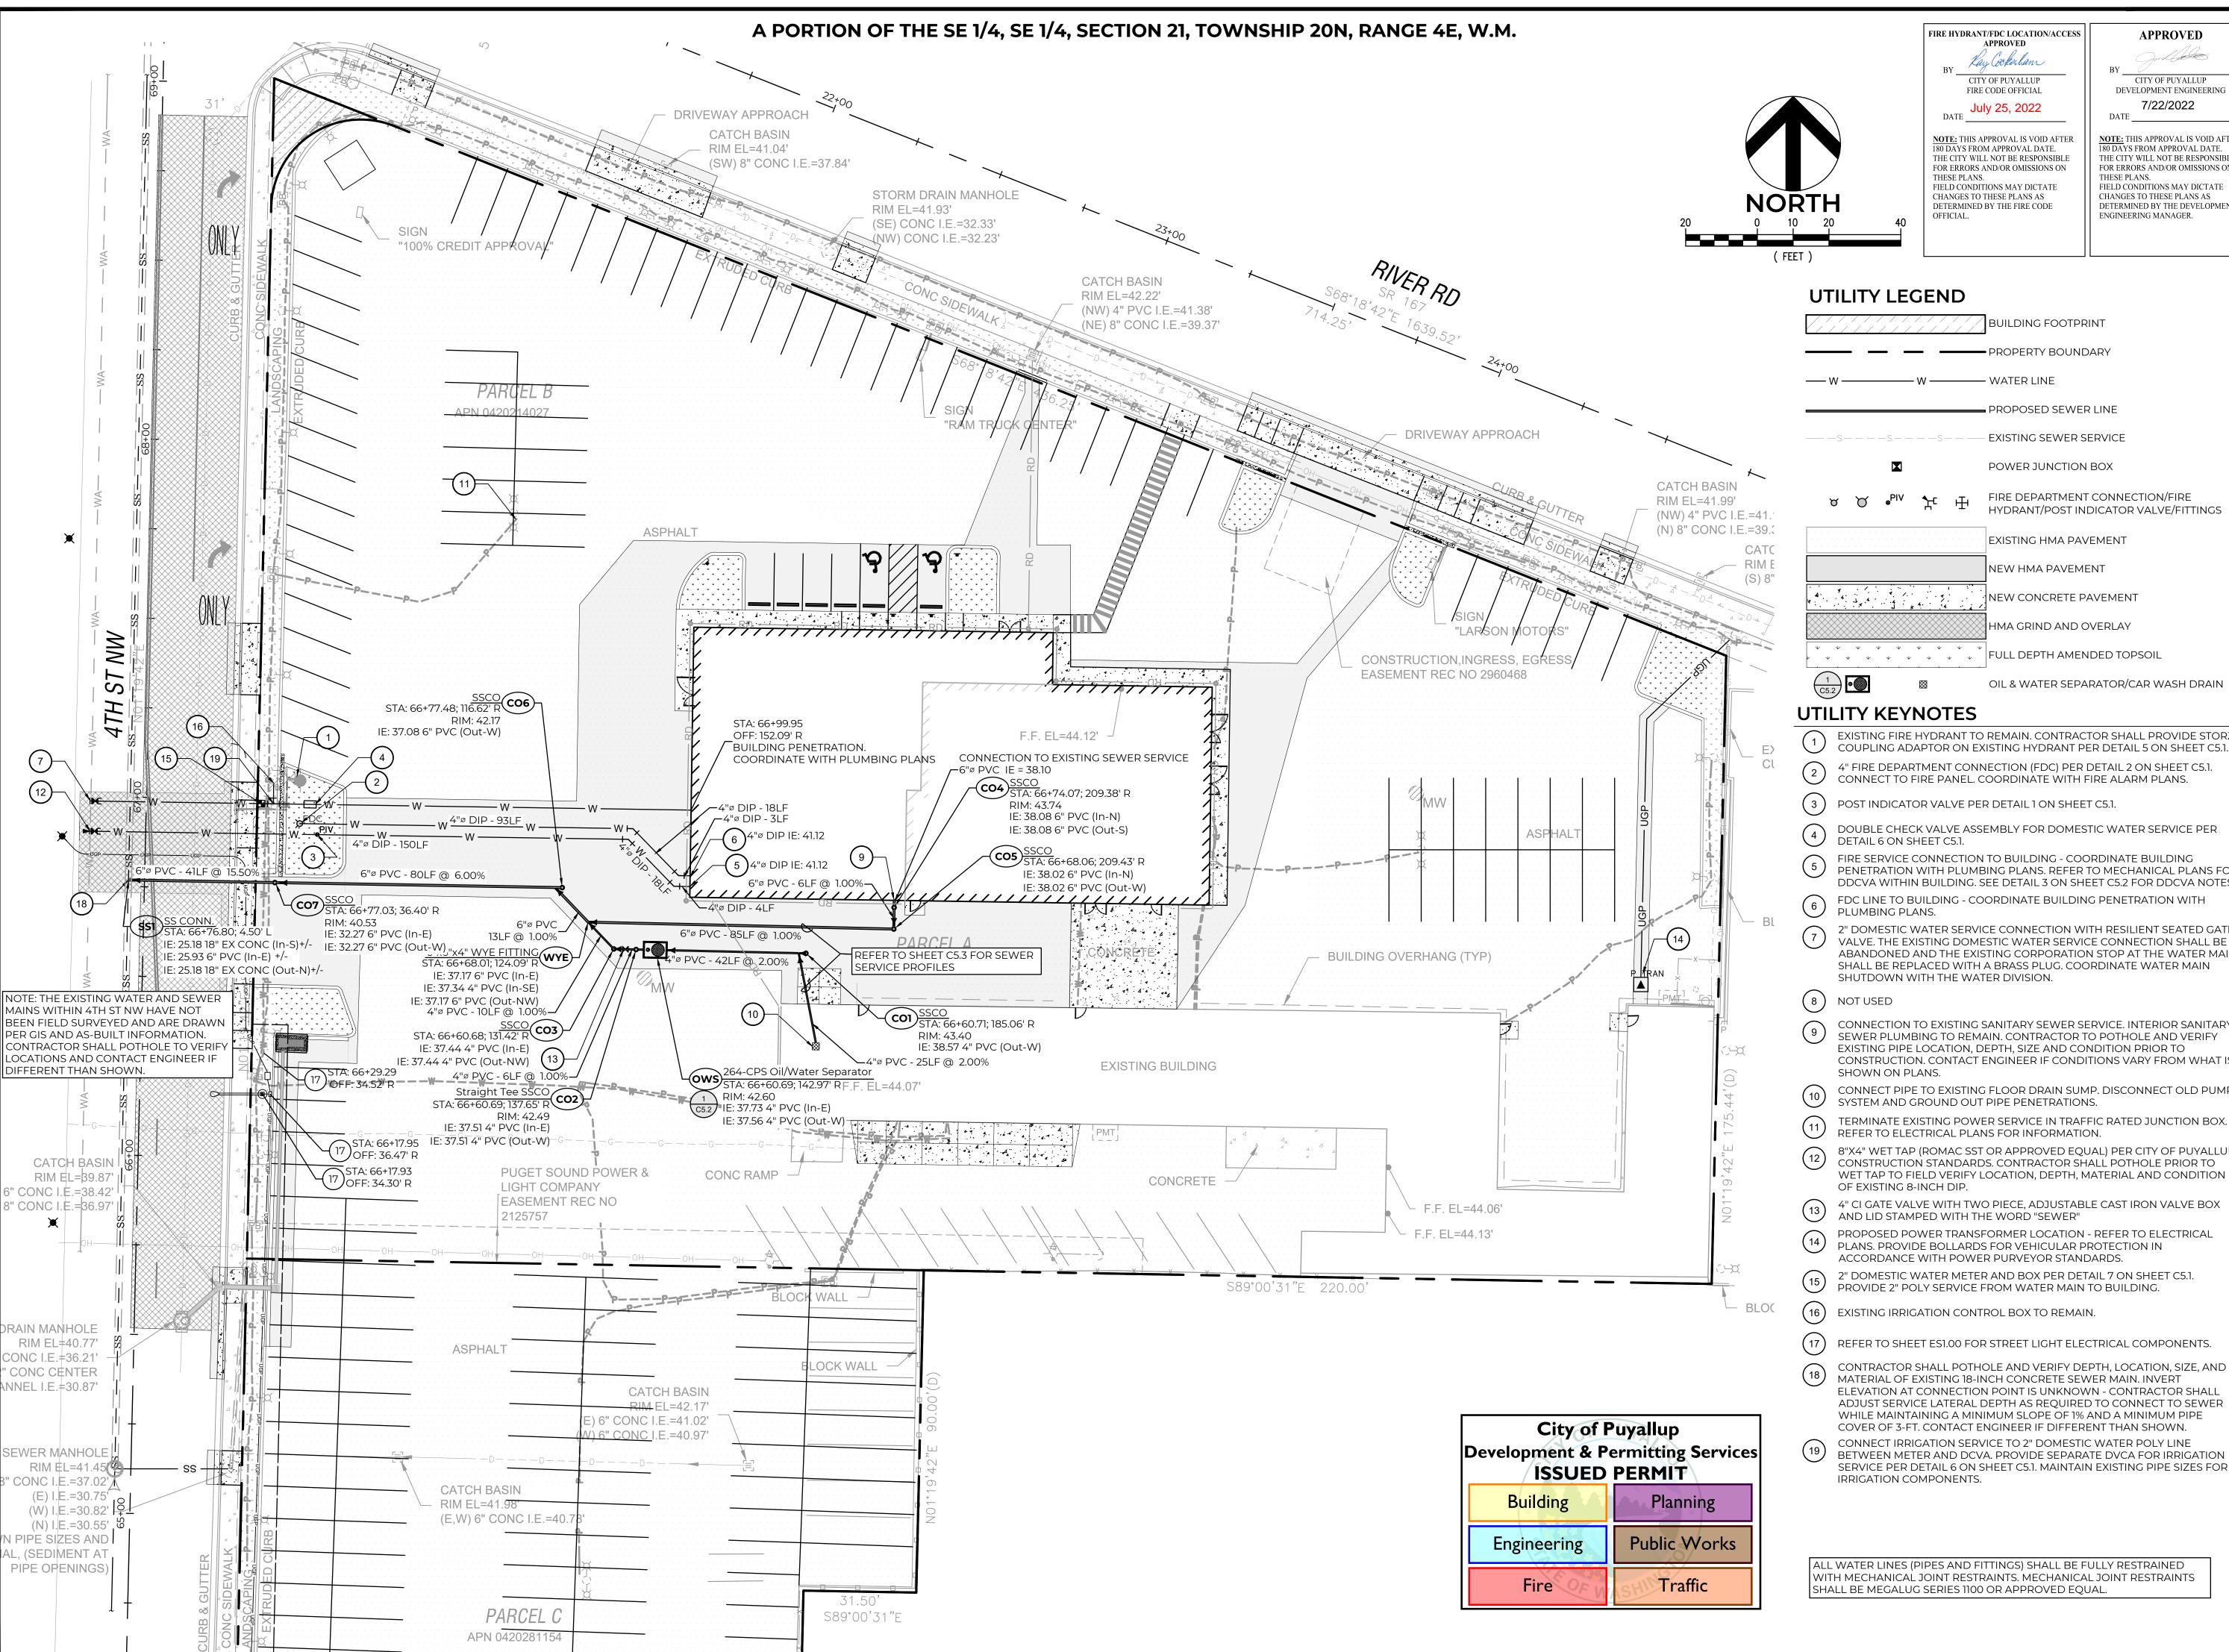

FIRE HYDRANT/FDC LOCATION/ACCESS APPROVED

BUILDING FOOTPRINT

PROPERTY BOUNDARY

■ PROPOSED SEWER LINE

EXISTING SEWER SERVICE

POWER JUNCTION BOX

EXISTING HMA PAVEMENT

NEW CONCRETE PAVEMENT

HMA GRIND AND OVERLAY

NEW HMA PAVEMENT

FIRE DEPARTMENT CONNECTION/FIRE

HYDRANT/POST INDICATOR VALVE/FITTINGS

CITY OF PUYALLUP FIRE CODE OFFICIAL

July 25, 2022

NOTE: THIS APPROVAL IS VOID AFTER 80 DAYS FROM APPROVAL DATE. THE CITY WILL NOT BE RESPONSIBL FOR ERRORS AND/OR OMISSIONS ON THESE PLANS. FIELD CONDITIONS MAY DICTATE CHANGES TO THESE PLANS AS DETERMINED BY THE FIRE CODE

– W — WATER LINE

CITY OF PUYALLUP DEVELOPMENT ENGINEERING

7/22/2022

NOTE: THIS APPROVAL IS VOID AFTER 80 DAYS FROM APPROVAL DATE. THE CITY WILL NOT BE RESPONSIBLE FOR ERRORS AND/OR OMISSIONS ON THESE PLANS. FIELD CONDITIONS MAY DICTATE CHANGES TO THESE PLANS AS DETERMINED BY THE DEVELOPMENT ENGINEERING MANAGER.

PERMIT SET

AUTO

UILDING

FULL DEPTH AMENDED TOPSOIL

OIL & WATER SEPARATOR/CAR WASH DRAIN

UTILITY KEYNOTES

- EXISTING FIRE HYDRANT TO REMAIN. CONTRACTOR SHALL PROVIDE STORZ COUPLING ADAPTOR ON EXISTING HYDRANT PER DETAIL 5 ON SHEET C5.1.
- 4" FIRE DEPARTMENT CONNECTION (FDC) PER DETAIL 2 ON SHEET C5.1. CONNECT TO FIRE PANEL. COORDINATE WITH FIRE ALARM PLANS.
- POST INDICATOR VALVE PER DETAIL 1 ON SHEET C5.1.
- DOUBLE CHECK VALVE ASSEMBLY FOR DOMESTIC WATER SERVICE PER DETAIL 6 ON SHEET C5.1.
- FIRE SERVICE CONNECTION TO BUILDING COORDINATE BUILDING PENETRATION WITH PLUMBING PLANS. REFER TO MECHANICAL PLANS FOR DDCVA WITHIN BUILDING. SEE DETAIL 3 ON SHEET C5.2 FOR DDCVA NOTES.
- FDC LINE TO BUILDING COORDINATE BUILDING PENETRATION WITH PLUMBING PLANS.
- 2" DOMESTIC WATER SERVICE CONNECTION WITH RESILIENT SEATED GATE VALVE. THE EXISTING DOMESTIC WATER SERVICE CONNECTION SHALL BE ABANDONED AND THE EXISTING CORPORATION STOP AT THE WATER MAIN SHALL BE REPLACED WITH A BRASS PLUG. COORDINATE WATER MAIN SHUTDOWN WITH THE WATER DIVISION.
- NOT USED
- CONNECTION TO EXISTING SANITARY SEWER SERVICE. INTERIOR SANITARY SEWER PLUMBING TO REMAIN. CONTRACTOR TO POTHOLE AND VERIFY EXISTING PIPE LOCATION, DEPTH, SIZE AND CONDITION PRIOR TO CONSTRUCTION. CONTACT ENGINEER IF CONDITIONS VARY FROM WHAT IS SHOWN ON PLANS.
- CONNECT PIPE TO EXISTING FLOOR DRAIN SUMP. DISCONNECT OLD PUMP SYSTEM AND GROUND OUT PIPE PENETRATIONS.
- TERMINATE EXISTING POWER SERVICE IN TRAFFIC RATED JUNCTION BOX.
- REFER TO ELECTRICAL PLANS FOR INFORMATION. 8"X4" WET TAP (ROMAC SST OR APPROVED EQUAL) PER CITY OF PUYALLUP CONSTRUCTION STANDARDS. CONTRACTOR SHALL POTHOLE PRIOR TO
- 4" CI GATE VALVE WITH TWO PIECE, ADJUSTABLE CAST IRON VALVE BOX AND LID STAMPED WITH THE WORD "SEWER"
- PROPOSED POWER TRANSFORMER LOCATION REFER TO ELECTRICAL PLANS. PROVIDE BOLLARDS FOR VEHICULAR PROTECTION IN ACCORDANCE WITH POWER PURVEYOR STANDARDS.
- 2" DOMESTIC WATER METER AND BOX PER DETAIL 7 ON SHEET C5.1. PROVIDE 2" POLY SERVICE FROM WATER MAIN TO BUILDING.
- (16) EXISTING IRRIGATION CONTROL BOX TO REMAIN.
- REFER TO SHEET ES1.00 FOR STREET LIGHT ELECTRICAL COMPONENTS.
- CONTRACTOR SHALL POTHOLE AND VERIFY DEPTH, LOCATION, SIZE, AND MATERIAL OF EXISTING 18-INCH CONCRETE SEWER MAIN. INVERT ELEVATION AT CONNECTION POINT IS UNKNOWN - CONTRACTOR SHALL ADJUST SERVICE LATERAL DEPTH AS REQUIRED TO CONNECT TO SEWER WHILE MAINTAINING A MINIMUM SLOPE OF 1% AND A MINIMUM PIPE COVER OF 3-FT. CONTACT ENGINEER IF DIFFERENT THAN SHOWN.
- CONNECT IRRIGATION SERVICE TO 2" DOMESTIC WATER POLY LINE BETWEEN METER AND DCVA. PROVIDE SEPARATE DVCA FOR IRRIGATION SERVICE PER DETAIL 6 ON SHEET C5.1. MAINTAIN EXISTING PIPE SIZES FOR IRRIGATION COMPONENTS.

ALL WATER LINES (PIPES AND FITTINGS) SHALL BE FULLY RESTRAINED WITH MECHANICAL JOINT RESTRAINTS. MECHANICAL JOINT RESTRAINTS SHALL BE MEGALUG SERIES 1100 OR APPROVED EQUAL




CHECKED BY: M. PUDISTS DESIGNED BY: K. MURPHY DRAWN BY: K. MURPHY HORZ. DATUM: NAD83(11)

VERT. DATUM: **NAVD88** 7/19/22

PROJECT NO. LARS-0001

SHEET NO. 16 of 25

REFERENCE NO. **C5.0**

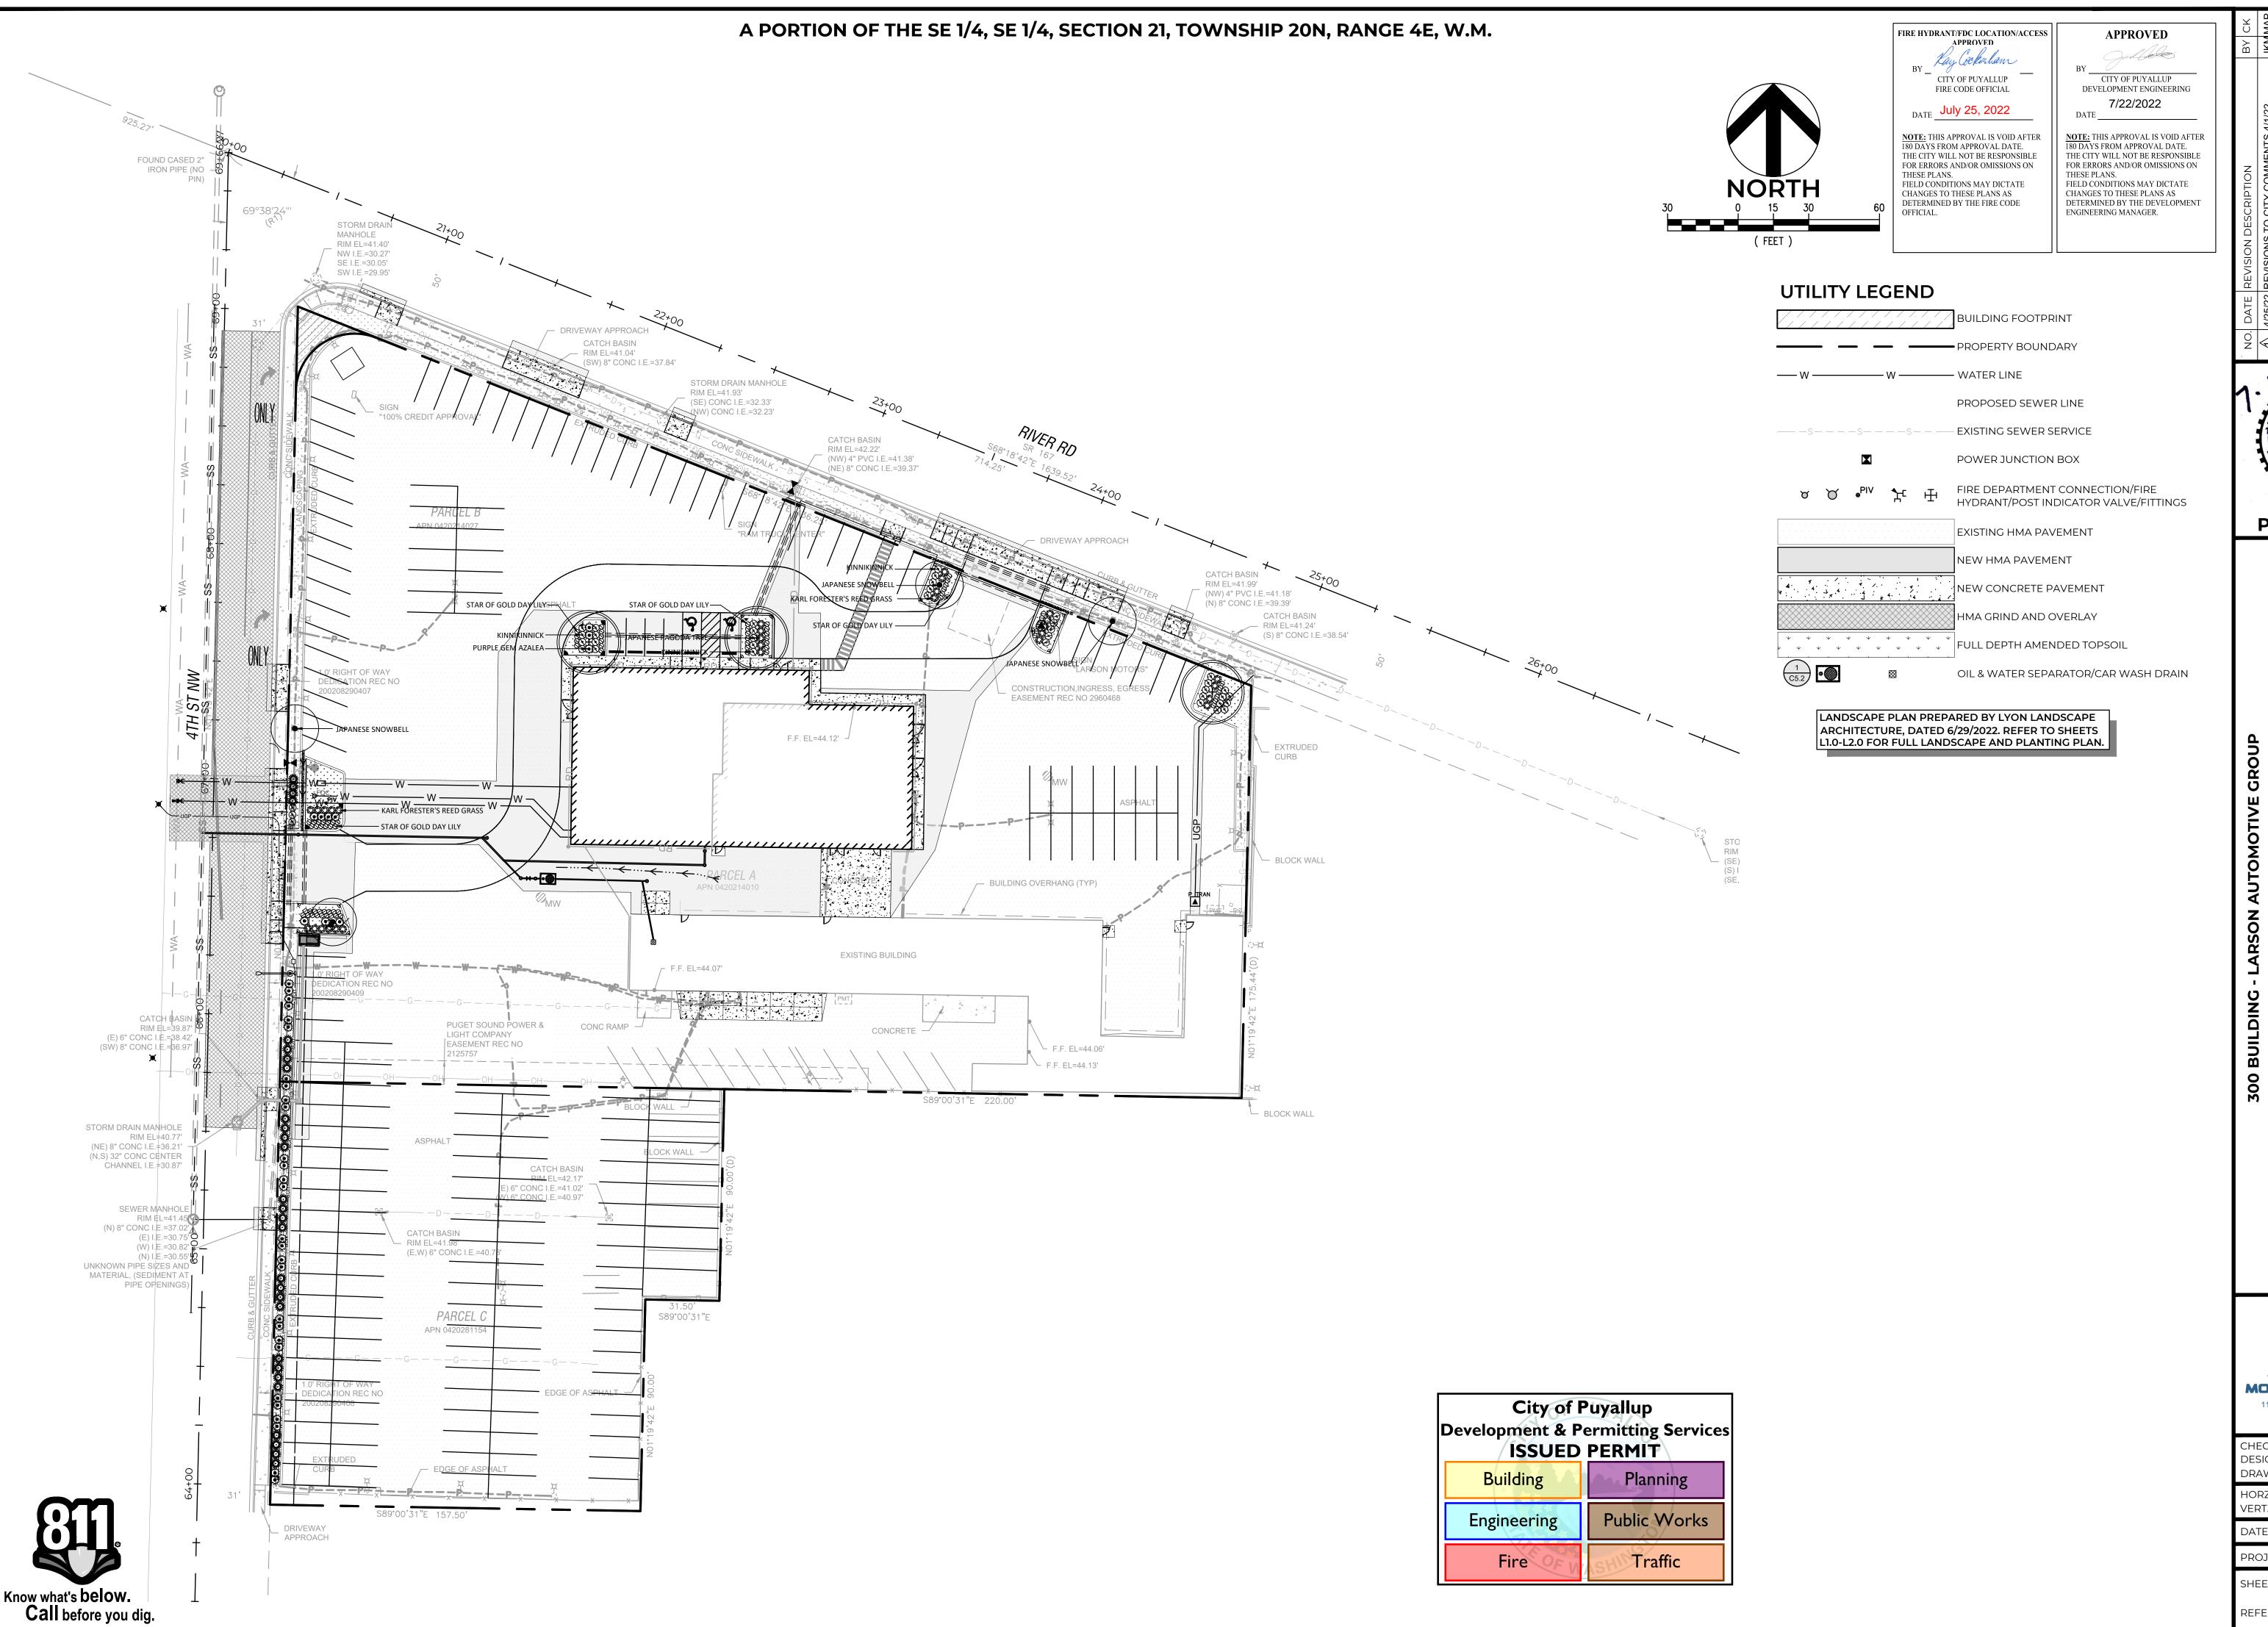

PERMIT SET

ANDSCAPE

MOMENTUM CIVIL 1145 BROADWAY, SUITE 115 TACOMA, WA 98402 PHONE: 253.319.1504

CHECKED BY: M. PUDISTS DESIGNED BY: K. MURPHY DRAWN BY: K. MURPHY

HORZ. DATUM: NAD83(11) VERT. DATUM: **NAVD88**

7/19/22 PROJECT NO. LARS-0001

SHEET NO. **17** of **25**

REFERENCE NO. **C5.01**

POST INDICATOR VALVE

90° BEND | 45° BEND | 22.5° BEND | 11.25° BEND

1,225

7,660

LOAD LBS/SF

1,000

2,000

3,000

4,000

10,000


7,545


HRUST BLOCKING TABLE


2,405

21,640

71,085 38,470 19,615

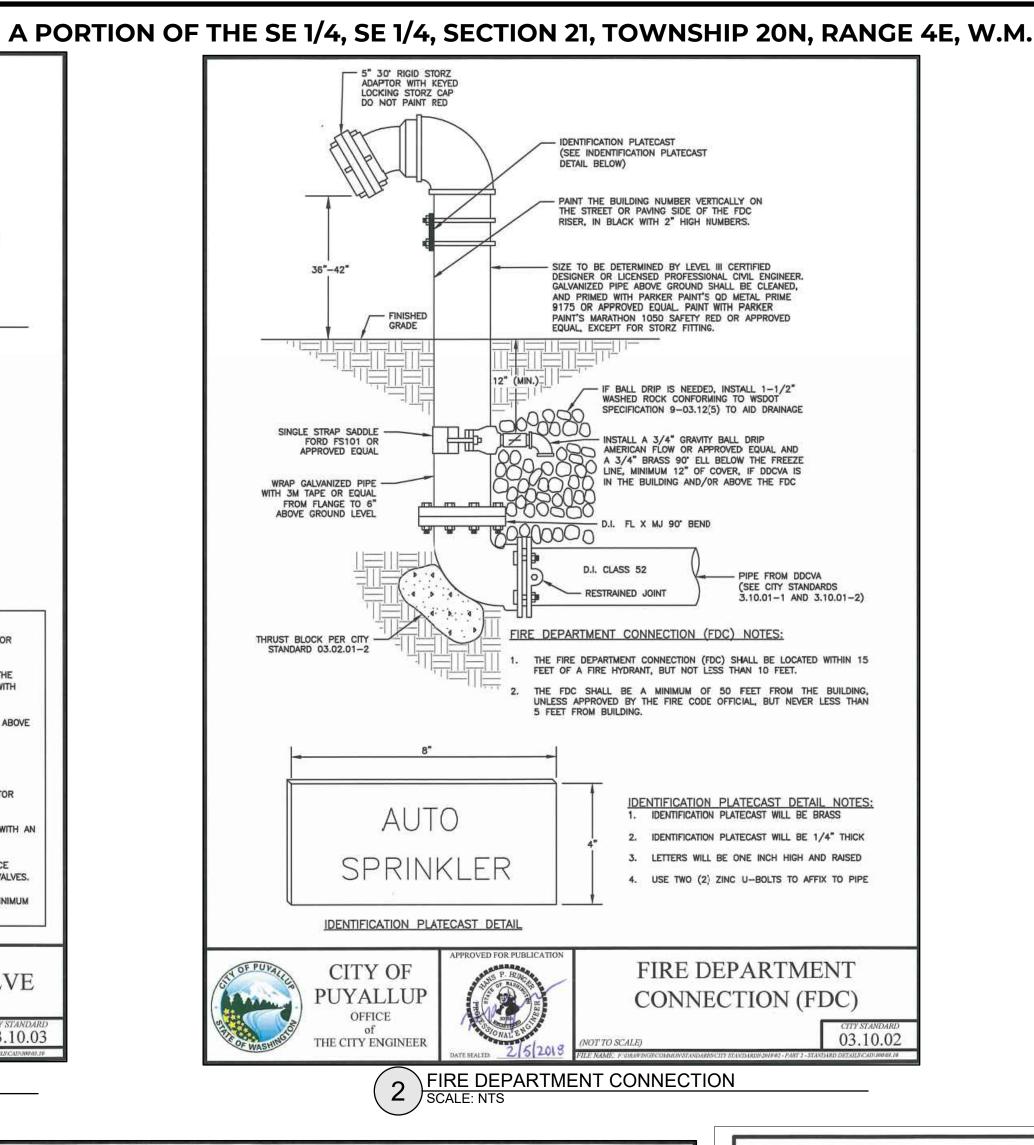

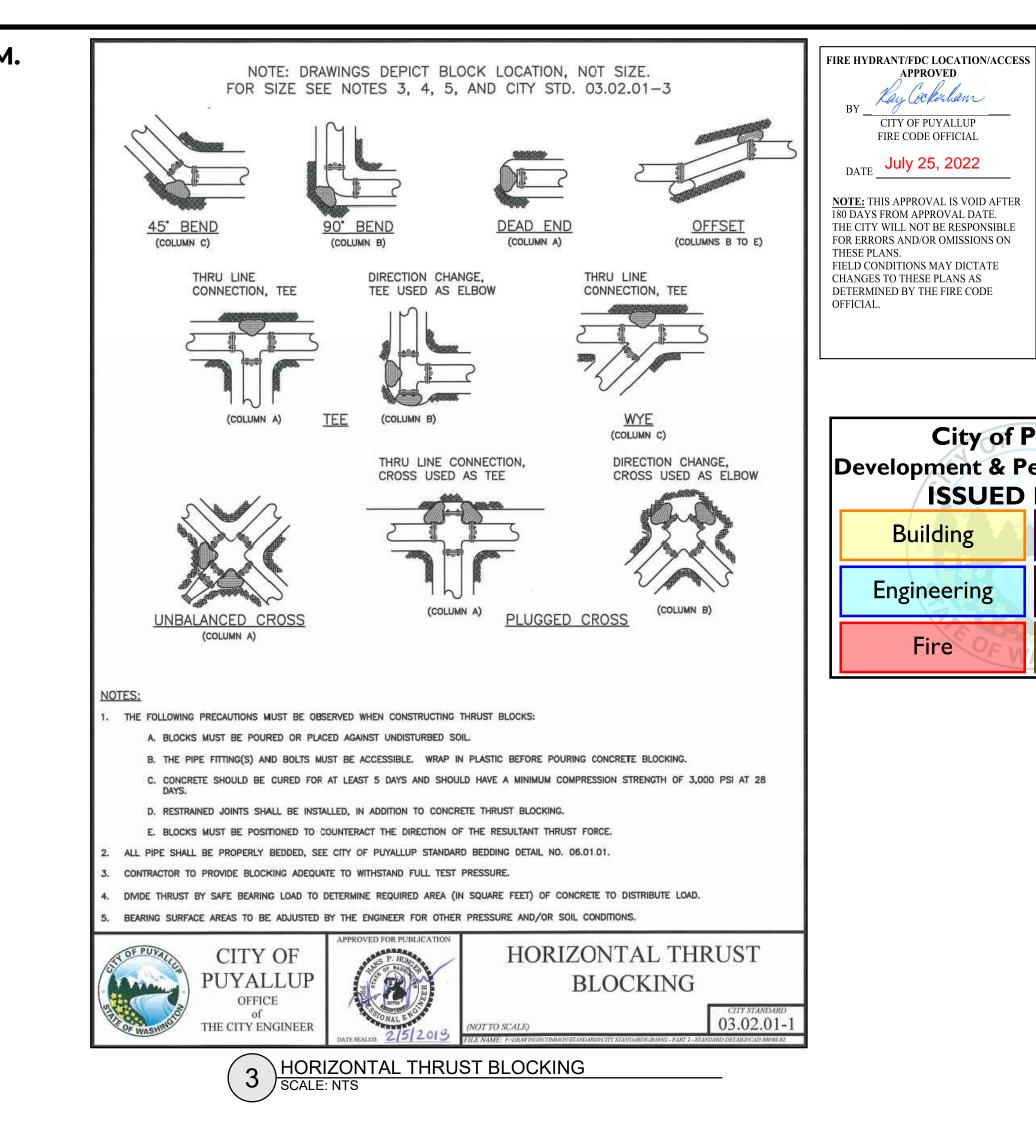

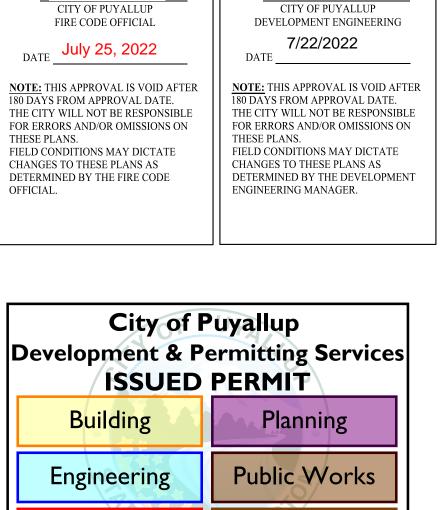


Traffic

Kay Cockerham

Fire

APPROVED

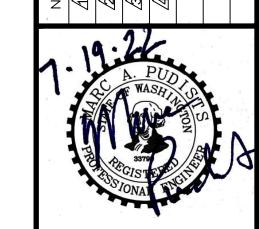

PERMIT SET

AUTO S

MOMENTUM CIVII 1145 BROADWAY, SUITE 115 TACOMA, WA 98402


PHONE: 253.319.1504 CHECKED BY: M. PUDISTS DESIGNED BY: **K. MURPHY** DRAWN BY: K. MURPHY

> HORZ. DATUM:**NAD83(11)** /ERT. DATUM: **NAVD88**

PROJECT NO. **LARS-0001**

REFERENCE NO. **C5.1**

6 DCVA SCALE: NTS

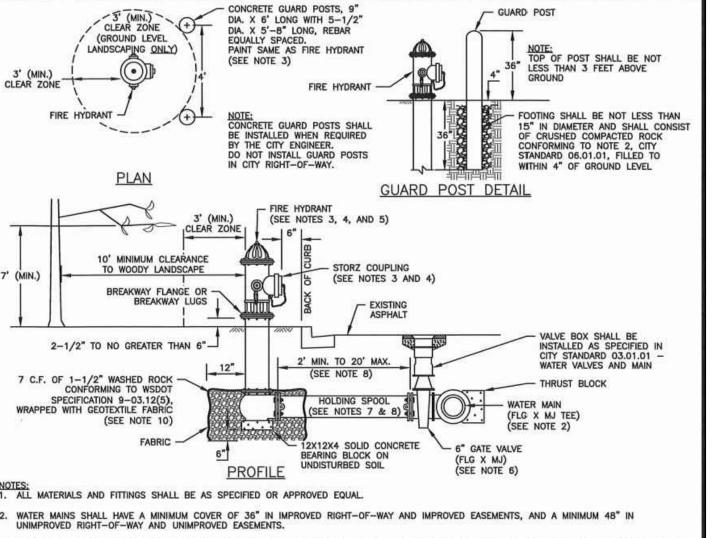

THE FIRE HYDRANT AND CONCRETE GUARD POSTS SHALL BE PAINTED, RUST-OLEUM SAFETY YELLOW #7543 (TWO COATS) OR AN APPROVED EQUAL THE STORZ FITTING SHALL NOT BE PAINTED. (#B TACOMA STEAMER PORT THREAD) WITH A 5" 'STORZ' COUPLING AND BLIND CAP INSTALLED ON THE STEAMER PORT, (STEAMER PORT SHALL FACE THE STREET), 1-1/4" PENTAGONAL OPERATING NUT (COUNTER-CLOCKWISE OPENING), O-RING TYPE STUFFING BOX, AUTOMATIC BARREL DRAINS AND 5-1/4" MAIN VALVE OPENING. HYDRANTS SHALL BE DESIGNED IN A MANNER THAT WILL PREVENT BARREL BREAKAGE WHEN STRUCK BY A VEHICLE. HYDRANTS SHALL CONFORM TO THE LATEST REVISION OF AWWA SPECIFICATIONS NO. C 502-73 FOR FIRE HYDRANTS FOR ORDINARY WATER SERVICE. FIRE HYDRANTS SHALL INCLUDE THE ENTIRE ASSEMBLY COMPLETE, INCLUDING HYDRANT, GATE VALVE AND BOX, CONNECTING BIRDING ENTRINGS AND ACCESSORIES.


FIRE HYDRANTS SHALL BE AVK, CLOW MEDALLION, M & H 129S, MUELLER CENTURION, OR WATEROUS. GATE VALVES SHALL CONFORM TO THE LATEST AWWA SPECIFICATIONS FOR COLD WATER, RESILIENT SEATED WEDGE GATE VALVES, 200 PSI WORKING PRESSURE. THEY SHALL BE IRON-BODIED BRONZE-MOUNTED, NON-RISING STEM, COUNTER-CLOCKWISE OPENING, MECHANICAL JOINT BY FLANGED. VALVE STEMS SHALL BE PROVIDED WITH 0-RING SEALS AND SHALL BE AS MANUFACTURED BY THE MUELLER COMPANY OR APPROVED


THE HOLDING SPOOL SHALL BE A MECHANICAL-JOINT (M.J.) HOLDING SPOOL, WITH THE USE OF MEGA-LUG CONNECTORS OR APPROVED EQUAL WITH CLASS 52 DUCTILE IRON PIPE.


IF DISTANCE BETWEEN WATER MAIN AND FIRE HYDRANT IS GREATER THAN 17 FEET, RESTRAINED JOINTS ARE REQUIRED ON ANY ADDITIONAL JOINTS. THE MAXIMUM 6-INCH HYDRANT RUN ALLOWED IS 20 FEET. ANY PROPOSED HYDRANT RUN EXCEEDING 20' IN LENGTH SHALL BE SIZED USING AN ENGINEERED HYDRAULIC FIRE FLOW MODEL. ANY HYDRANT RUN EXCEEDING 50 FEET IN LENGTH SHALL BE NO LESS THAN 8-INCHES IN DIAMETER.

FIRE HYDRANTS SHALL BE LOCATED A MINIMUM OF 50 FEET FROM A BUILDING OR STRUCTURE.

A MINIMUM THREE FOOT (3') RADIUS UNOBSTRUCTED CLEAR ZONE (WORK AREA) SHALL BE PROVIDED AROUND ALL FIRE HYDRANTS. ADDITIONALLY, NO WOODY LANDSCAPE SHALL BE PLANTED WITHIN TEN FEET (10') OF ANY FIRE HYDRANT. OVERREACHING BRANCHES OF TREES ADJACENT TO

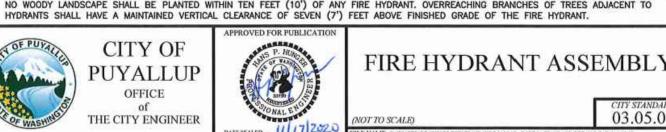

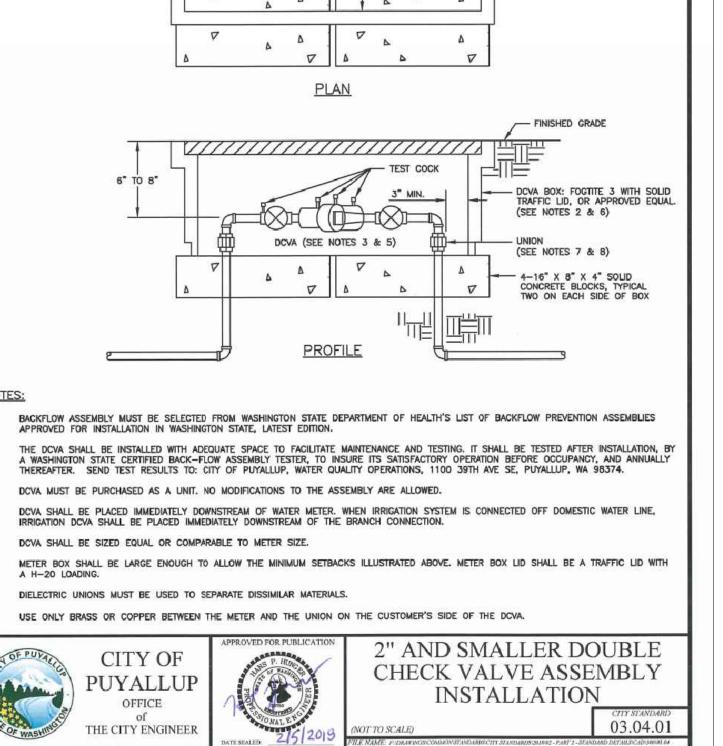

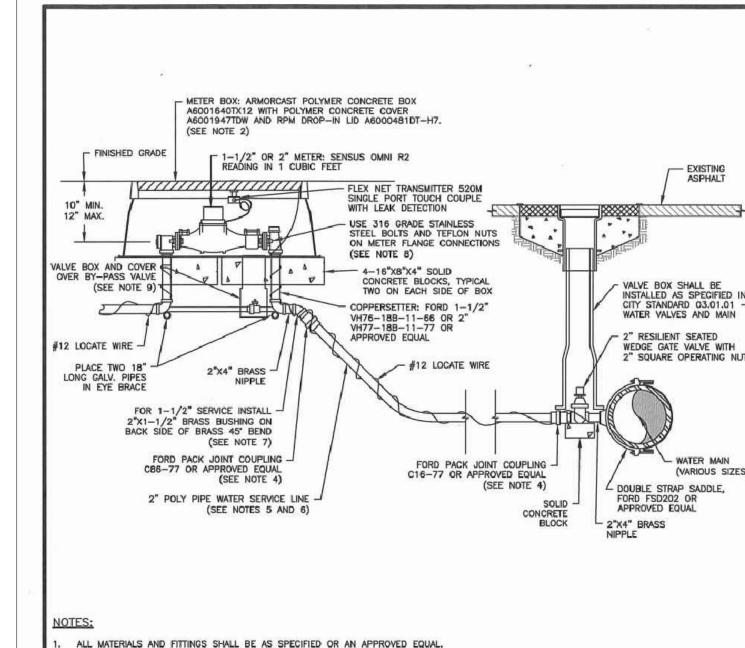

ALL MATERIALS AND FITTINGS SHALL BE AS SPECIFIED OR AN APPROVED EQUAL.

NORMALLY THE WATER METER BOX SHOULD BE LOCATED IN THE PLANTING STRIP. IF SIDEWALK IS AGAINST THE CURB, PLACE METER BOX DIRECTLY BEHIND THE SIDEWALK. THE WATER METER BOX SHALL NOT BE LOCATED IN HARD SURFACES. WHEN UNAVOIDABLE, EXCEPTIONS CAN BE MADE AT END OF CUL-DE-SACS OR PAN HANDLED LOTS.

WATER MAINS SHALL HAVE A MINIMUM COVER OF 36" IN IMPROVED RIGHT-OF-WAY AND IMPROVED EASEMENTS, AND A MINIMUM OF 48" IN UNIMPROVED RIGHT-OF-WAY AND UNIMPROVED EASEMENTS.

ALL POLY PIPE COUPLINGS SHALL USE PIPE INSERT STIFFENERS.


THE WATER SERVICE LINE SHALL BE BEDDED IN WASHED SAND WITH 36" OF COVER BELOW FINISHED GRADE WITHIN THE RIGHT-OF-WAY. THE WATER SERVICE LINE SHALL BE ONE CONTINUOUS PIECE WITH NO SPLICES.

ALL POLY PIPE SHALL BE HIGH DENSITY POLY (IRON PIPE SIZE) MEETING ASTM D-2239-SIDR 7, BLUE IN COLOR, 200 PSI MINIMUM.

FOR A 1-1/2" WATER SERVICE, ALL MATERIAL SHALL BE 2" FROM THE WATER MAIN TO THE COPPERSETTER. REDUCE FROM 2" TO 1-1/2"

THE STAINLESS STEEL METER FLANGE BOLTS SHALL BE 5/8" DIAMETER FOR THE 1-1/2" METER, AND 3/4" DIAMETER FOR THE 2" METER.

PROVIDE A 6" CIRCULAR VALVE BOX WITH COVER (APPLIED ENGINEERING PRODUCT MODEL 708 WITH GREEN LID OR AN APPROVED EQUAL) OVER BY-PASS VALVE.

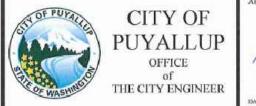

SCALE: NTS

2 INCH WATER SERVICE CONNECTION

1-1/2" AND 2"

WATER SERVICE CONNECTION

\THRUST BLOCKING TABLI

\ FIRE HYDRANT ASSEMBLY SCALE: NTS

SEE CITY STANDARDS 03.02.01-1 AND 03.02.01-2 FOR ADDITIONAL INFORMATION.

TABLE 2: THRUST AT FITTINGS AT 200 PSI

4,440

39,985

TABLE 3: BEARING VALUE OF SOIL

27,770 15,030

38,485 54,425 29,455 15,015

3,140

7,070

19,635

50,265

SAND AND GRAVEL CEMENTED WITH CLAY

200

MUCK, PEAT, ETC.

SAND AND GRAVEL

SOFT CLAY/ALLUVIAL SOIL

10 DETERMINE THRUST AT PRESSURES OTHER THAN PSI SHOWN, MULTIPLY THE THRUST OBTAINED IN TABLE 2 BY THE RATIO OF THE PRESSURE THE THRUST ON A 12 INCH, 90° BEND AT 300 PSI.

OFFICE


 $39,985 \times \frac{300}{200} = 59,978 LBS$ TO DETERMINE THE BEARING AREA OF THE THRUST BLOCK IN SQUARE FEET (SF):

SEE TABLE 3, BEARING VALUE OF SOIL FOR SAND AND GRAVEL BEARING VALUE FROM TABLE 3 IS 3,000 LBS/SF


59,978 LBS + 3000 LB/SF = 20 SF OF AREA CONTRACTOR TO PROVIDE BLOCKING ADEQUATE TO WITHSTAND FULL TEST PRESSURE

AREAS SHALL BE ADJUSTED FOR OTHER PRESSURE CONDITIONS. NO WATER MAIN SHALL DEAD END AGAINST A MAIN LINE VALVE. DEAD END WATER MAINS SHALL BE BLOCKED AGAINST A RESTRAINED MECHANICAL JOINT (M.J.) PLUG OR CAP.


SHEET NO. 18 of 25

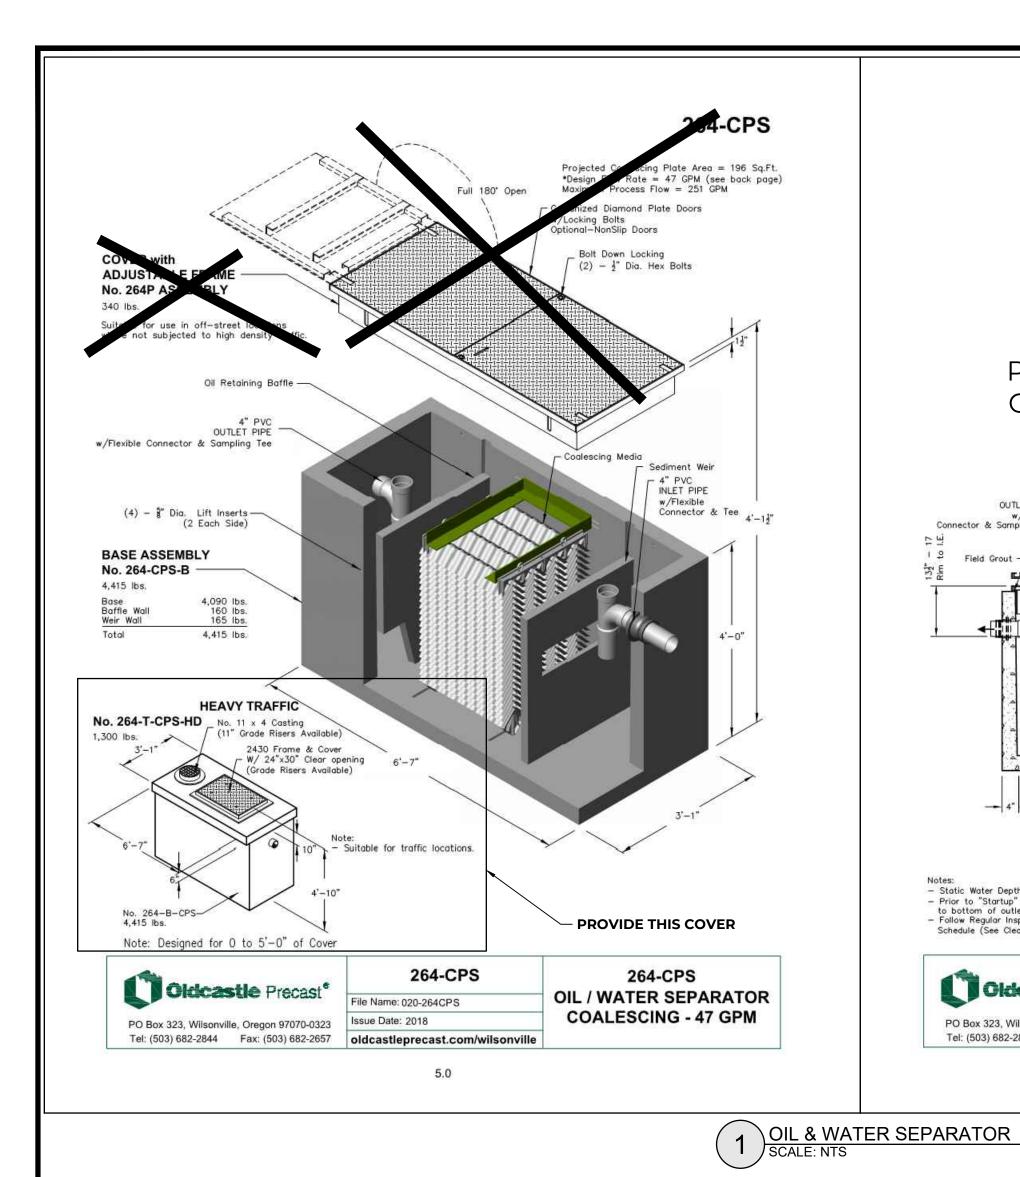

PROVIDE HEAVY TRAFFIC COVER NO. 264 T-CPS-HD

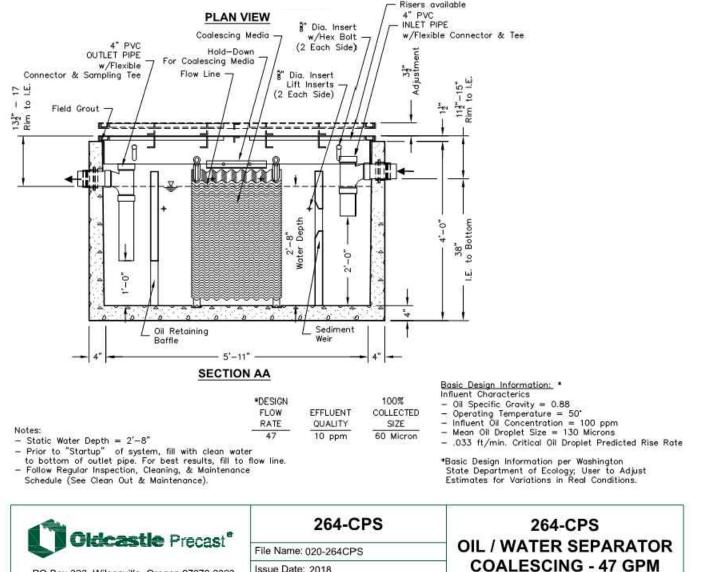

" RIASED SQUARES, " APART, 🖁 HIGH ½" WIDE, ½" HIGH RAISED BORDER

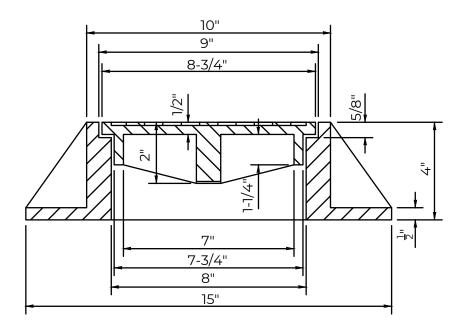



City of Puyallup

Development & Permitting Services

ISSUED PERMIT

Planning

Public Works

Traffic

FIBER JOINT PACKING

Building

Engineering

Fire

SECTION (A)

CAST IRON RING AND COVER

NOTES FOR: DOUBLE DETECTOR CHECK VALVE ASSEMBLY (DDCVA) INSTALLATION CITY STANDARD 03.10.01-1

Tel: (503) 682-2844 Fax: (503) 682-2657 oldcastleprecast.com/wilsonville

BACKFLOW ASSEMBLY MUST BE SELECTED FROM WASHINGTON STATE DEPARTMENT OF HEALTH'S LIST OF BACKFLOW PREVENTION ASSEMBLIES APPROVED FOR INSTALLATION IN WASHINGTON STATE, LATEST EDITION.

THE DDCVA SHALL BE INSTALLED WITH ADEQUATE SPACE TO FACILITATE MAINTENANCE AND TESTING. IT SHALL BE TESTED AFTER INSTALLATION, BY A WASHINGTON STATE CERTIFIED BACK-FLOW ASSEMBLY TESTER, TO INSURE ITS SATISFACTORY OPERATION BEFORE OCCUPANCY, AND ANNUALLY THEREAFTER. SEND TEST RESULTS TO: CITY OF PUYALLUP, WATER QUALITY OPERATIONS, 1100 39TH AVE SE, PUYALLUP, WA 98374. DDCVA MUST BE PURCHASED AS A UNIT. NO MODIFICATIONS TO THE ASSEMBLY ARE ALLOWED.

DDCVA IS ALLOWED TO BE LOCATED WITHIN A BUILDING AS APPROVED BY THE FIRE CODE OFFICIAL, WHEN THE DDCVA IS LOCATED WITHIN A

PIPE SHALL BE CONNECTED TO THE NEAREST APPROVED ON-SITE STORM DRAINAGE STRUCTURE.

PO Box 323, Wilsonville, Oregon 97070-0323

BUILDING, THE FIRE DEPARTMENT CONNECTION (FDC) BALL DRIP SHALL DRAIN TO THE NEAREST APPROVED ON-SITE STORM DRAINAGE STRUCTURE. IN A VAULT INSTALLATION, IF VAULT CANNOT BE DRAINED TO DAYLIGHT, A 1/4 HP SUMP PUMP SHALL BE INSTALLED IN THE SUMP PIT OF THE VAULT. IT SHALL BE WIRED PER WASHINGTON STATE ELECTRICAL CODE, AND INSPECTED BY A STATE ELECTRICAL INSPECTOR. THE DISCHARGE

DDCVA OUTSIDE STEM AND YOKE (OS&Y) GATE VALVES, AND THE POST INDICATOR VALVE (PIV), SHALL HAVE SUPERVISED TAMPER SWITCHES. ALL ELECTRICAL SHALL BE INSPECTED BY A WASHINGTON STATE ELECTRICAL INSPECTOR.

IN A VAULT INSTALLATION, RUN TWO 3/4" SCHEDULE 80 P.V.C. CONDUITS TO THE VAULT. ONE WILL BE USED FOR A GFCI PROTECTED OUTLET, AND ONE WILL BE FOR LOW VOLTAGE COMING FROM THE FIRE ALARM PANEL. INSTALL AN APPLETON FSCA OR FDCA CAST DEVICE BOX OR

IN A VAULT INSTALLATION, RUN LOW VOLTAGE WIRE INSIDE VAULT AND TO PIV THROUGH SEAL-TIGHT FLEX CONDUIT. CONDUIT SHALL BE SECURELY FASTENED PERPENDICULAR OR HORIZONTALLY TO THE WALLS OF THE VAULT.

WATER METER SHALL BE A SENSUS SRII TRPL READING IN 1 CUBIC FEET. PIPE SUPPORTS SHALL BE RUST-PROTECTED WITH ALUMINUM PAINT.

SECURED AGAINS

MASTIC AND MORTAR

TO BLDG. -

- FLOW FROM FIRE DEPARTMENT

CONNECTION (FDC)
(SEE CITY STANDARDS 03.10.01-2,

NOTES 12 AND 13, AND 03.10.02)

L SUMP PIT WITH OR WITHOUT DRAI

NOTE 5 AND 03.11.01)

(SEE CITY STANDARDS 03.10.01-2,


2. THE FDC SHALL BE LOCATED WITHIN 15 FEET OF A FIRE HYDRANT, BUT NOT LESS THAN 10 FEET.

THE FDC AND PIV SHALL BE A MINIMUM OF 50 FEET FROM A BUILDING, UNLESS APPROVED BY THE CITY OF PUYALLUP FIRE CODE OFFICIAL, BUT

A DDCVA INSTALLED MORE THAN 5 FEET ABOVE THE FLOOR LEVEL MUST HAVE A PLATFORM UNDER IT FOR THE TESTER OR MAINTENANCE PERSON TO STAND ON, THE PLATFORM MUST BE OSHA APPROVED AND MEET ALL APPLICABLE SAFETY STANDARDS AND CODES.

NOTE: THE PERMITEE IS SEEKING TO PLACE DDCVA WITHIN BUILDING - THIS DETAIL IS BEING FURNISHED FOR THE SAKE OF ITS NOTES AND COMPLIANCE WITH CITY OF PUYALLUP STANDARDS.



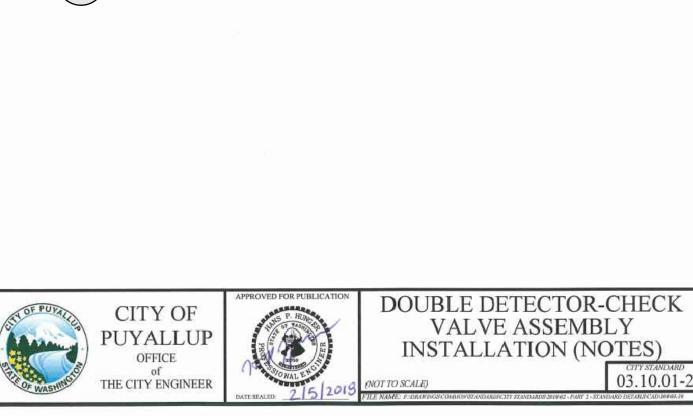

NOTES FOR CONNECTING TAPS ON EXISTING SEWER MAINS

. THE TEE FITTING SHALL BE A ROMAC INDUSTRIES STYLE "CB" SEWER SADDLE (OR APPROVED EQUAL). ONLY NEW SADDLE AND PARTS SHALL BE INSTALLED. DUE TO PIPE SIZE MATERIALS OR PIPE CONDITION, THE CITY ENGINEER MAY REQUIRE AN ALTERNATE METHOD/MATERIAL BE USED.

. THE SEWER MAIN TAP SHALL BE CUT WITH A SEWER PIPE TAPPING MACHINE (HOLE SAW) CAPABLE OF RETAINING THE COUPON, 3. THE ROUND HOLE CUT INTO THE SEWER MAIN SHALL BE NO LARGER THAN THE INSIDE DIAMETER OF THE SADDLE GASKET. THE


4. THE COUPON SHALL BE RETAINED AND SURRENDERED TO THE INSPECTOR. THE PERMIT HOLDER WILL PAY ALL COSTS ASSOCIATED WITH THE LOCATION AND RETRIEVAL OF A LOST COUPON, ADDITIONALLY THE PERMIT HOLDER WILL BE HELD LIABLE FOR ANY SUBSEQUENT DAMAGES CAUSED BY A LOST COUPON.


5. BOLTS SHALL BE TORQUED TO MANUFACTURE SPECIFICATIONS, THEN RETORQUED AFTER 10 MINUTES.


6. NO TAPS SHALL BE ALLOWED ON EXISTING SEWER MAINS OVER 18" IN DIAMETER, CONNECTIONS INTO SEWER MAINS OVER 18" IN DIAMETER SHALL INTERSECT THE SEWER MAIN IN A MANHOLE, IN SOME CASES THE CITY ENGINEER MAY ALLOW A VARIANCE TO

ALL TRENCHING, BEDDING, AND BACKFILL SHALL BE IN ACCORDANCE WITH CITY STANDARD DETAIL NO. 06.01.01. ALL ASPHALT REPAIR SHALL BE IN ACCORDANCE WITH CITY STANDARD NO. 01.01.20. ALL ADDITIONAL UTILITY AND RIGHT OF WAY REPAIRS SHALL BE INACCORDANCE WITH THE "CITY STANDARDS" MANUAL.

8. THE CITY OF PUYALLUP WILL CONDUCT A "SEWER MAIN VIDEO INSPECTION" OF THE SEWER TAP. THE PERMIT HOLDER WILL BE REQUIRED TO REPAIR ANY SEWER TAP CONSTRUCTION DEFECTS FOUND BY THE CITY INSPECTORS. THE COST OF ALL REPAIRS AND SUBSEQUENT "SEWER MAIN VIDEO INSPECTIONS" WILL BE THE RESPONSIBILITY OF THE PERMIT HOLDER. THE DAMAGE DEPOSIT POSTED BY THE BUILDER WILL BE HELD UNTIL PROBLEMS ARE CORRECTED. DUE TO PUBLIC HEALTH AND SAFETY, BUILDING OCCUPANCY WILL NOT BE ALLOWED UNTIL REPAIRS ARE COMPLETED AND ACCEPTED BY THE CITY ENGINEER.

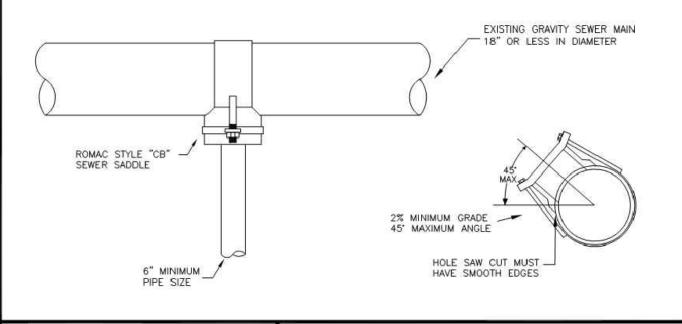

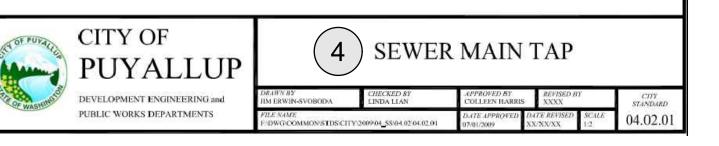

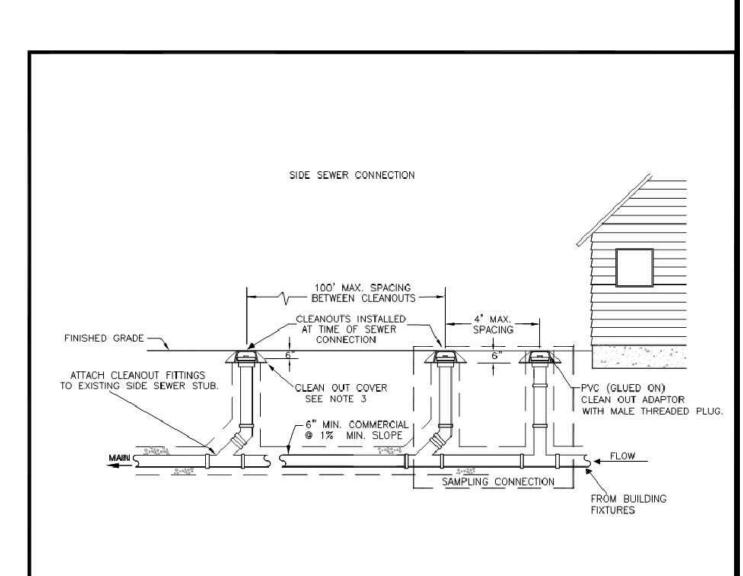

NOTES:

1. SAMPLING CONNECTION SHALL BE INSTALLED OUT SIDE WITH UNOBSTRUCTED ACCESS AT ALL TIMES.


2. A SAMPLING CONNECTION SHALL BE INSTALLED FOR EACH COMMERCIAL / RETAIL

CLEAN OUT AND SAMPLING CONNECTION COVERS: A) FOR NON-VEHICULAR TRAFFIC INSTALLATIONS USE "CARSON" MODEL 910 GREEN YARD BOX WITH BOLT DOWN LID MARKED SEWER OR

APPROVED EQUAL. B) FOR ASPHALT, GRAVEL, OR TRAFFIC INSTALLATIONS SEE CITY STANDARD DETAIL NO. 04.03.05 FRAME AND COVER SECTION.

 EACH CLEANOUT ASSEMBLY SHALL CONSIST OF: ONE CLEANOUT ADAPTER, HUB x FEMALE, FIPT, PVC SI AND ONE CLEANOUT PLUG, MOPT WITH RAISED NUT, PVC SDR35.

COMMERCIAL SIDE SEWER CONN. WITH SAMPLING CONN.

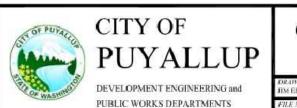

COMMERCIAL SIDE SEWER CONNECTION WITH SAMPLING CONNECTION

APPROVED

DEVELOPMENT ENGINEERING

NOTE: THIS APPROVAL IS VOID AFTER 180 DAYS FROM APPROVAL DATE. THE CITY WILL NOT BE RESPONSIBLE

FOR ERRORS AND/OR OMISSIONS ON

FIELD CONDITIONS MAY DICTATE CHANGES TO THESE PLANS AS

ENGINEERING MANAGER.

DETERMINED BY THE DEVELOPMENT

THESE PLANS.

7/22/2022

CITY OF PUYALLUP

PERMIT SET

AUTO

DING

MOMENTUM CIVII 1145 BROADWAY, SUITE 115 TACOMA, WA 98402 PHONE: 253.319.1504

CHECKED BY: M. PUDISTS DESIGNED BY: **K. MURPHY** DRAWN BY: K. MURPHY HORZ. DATUM: NAD83(11)

VERT. DATUM: **NAVD88** 7/19/22

PROJECT NO. LARS-0001

19 of **25**

OFFICE

BED VAULT IN MINIMUM 6" OF CRUSHED — ROCK CONFORMING TO NOTE 2, CITY STANDARD DETAIL 06.01.01

MEGA LUG RING ~ SECURED AGAINST VAULT WALL

POST INDICATOR VALVE -

(SEE CITY STANDARD

FROM MAIN

PUBLIC PRIVATE

FLOW --

INSTALLATION LOCATION NOTE:

FROM FIRE ALARM PANEL

03.10.01-2, NOTE 8)

INCOMING POWER -

PRECAST CONCRETE VAULT WITH LADDER -AND SAFETY POST. VAULT SHALL MEET CITY STANDARD 03.11.01 AND BE SUFFICIENT SIZED TO MEET THE MINIMUM

(SEE CITY STANDARD 03.10.01-2, NOTE 9)

03.10.01-2, NOTE 10)

POST INDICATOR VALVE (PIV)

(SEE CITY STANDARD 03.10.03 FOR ADDITIONAL INFORMATION)

3/4" BRASS 90" (DOWN) -

CITY STANDARD 03.10.01-2 COVERS ADDITIONAL NOTES FOR THIS DETAIL.

DOUBLE DETECTOR—CHECK VALVE ASSEMBLY (DDCVA) MAY BE INSTALLED WITHIN A BUILDING. THE PLAN AND PROFILE VIEW OF THIS DETAIL SHOWS ALTERNATIVE EXTERIOR VALUE INSTALLATION.

BBBBBBBBBBBBBBBBB


SAFETY POST

03.11.01)

DOUBLE DETECTOR-CHECK VALVE ASSEMBLY INSTALLATION 03.10.01-

REFERENCE NO. **C5.2**

A PORTION OF THE SE 1/4, SE 1/4, SECTION 21, TOWNSHIP 20N, RANGE 4E, W.M.

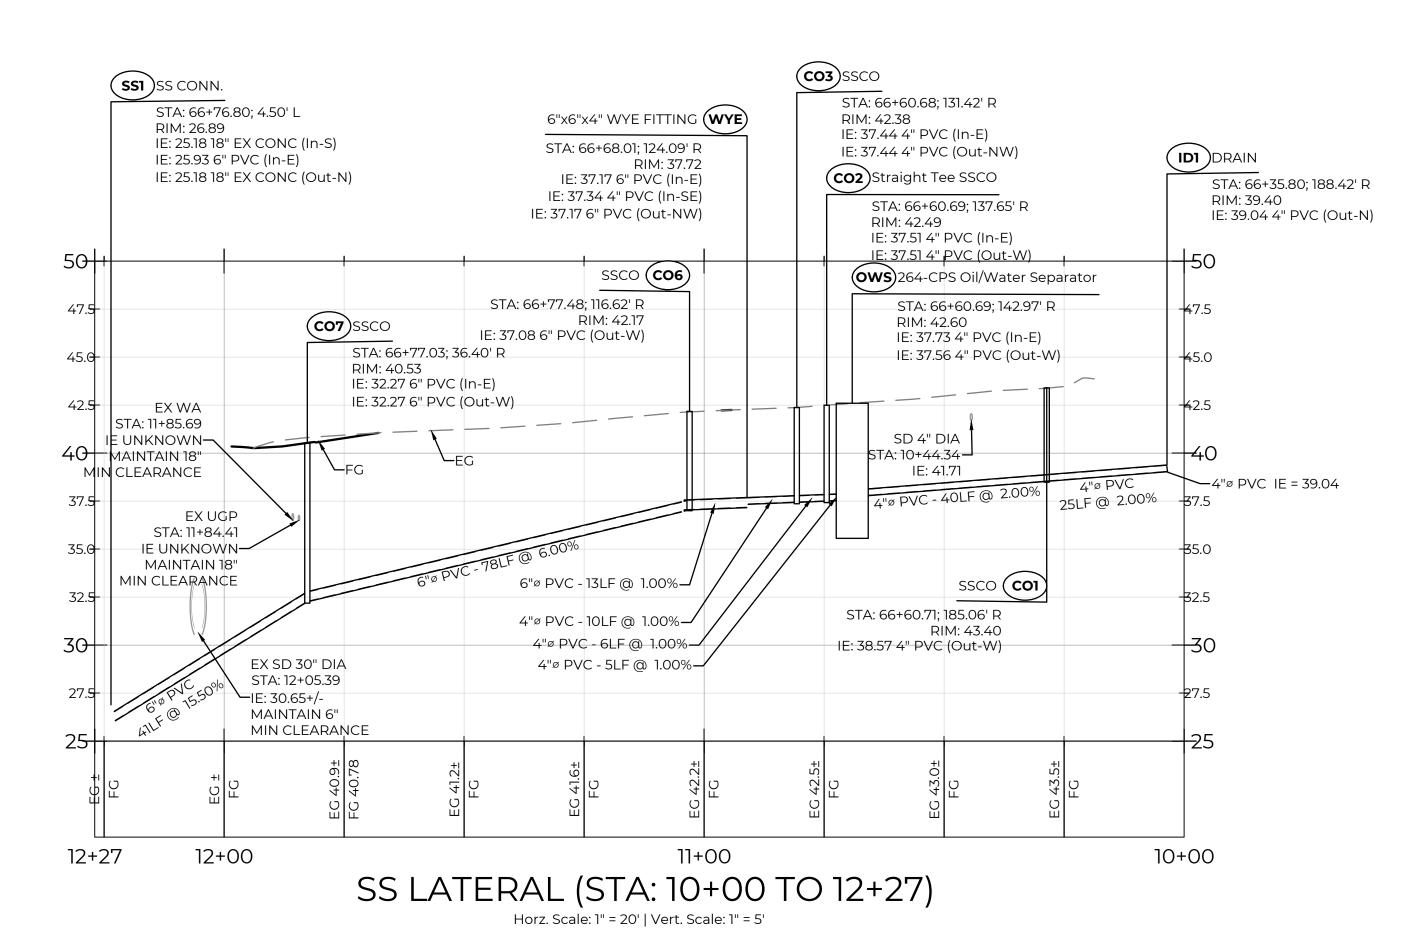

STA: 66+68.06; 209.43' R RIM: 43.58 IE: 38.02 6" PVC (In-N) IE: 38.02 6" PVC (Out-W) STA: 66+74.07; 209.38' R RIM: 43.74 IE: 38.08 6" PVC (In-N) IE: 38.08 6" PVC (Out-S) 21+00 STA: 66+68.01; 124.09' R RIM: 37.72 IE: 37.17 6" PVC (In-E) IE: 37.34 4" PVC (In-SE) 45.0 IE: 37.17 6" PVC (Out-NW) SD 6" DIA STA: 20+92.35 SD 4" DIA STA: 20+38.74 **-40** IE: 42.05 IE: 41.62 6"ø PVC - 85LF @ 1.00% **−**6"ø PVC IE = 38.10 6"ø PVC - 6LF @ 1.00%-- BUILDING PENETRATION, REFER TO PLUMBING 6"ø PVC - 2LF @ 1.00%-PLANS FOR CONTINUATION 32.5

20+00 21+00 SS LATERAL TO SHOWROOM (STA: 20+00 TO 21+00) Horz. Scale: 1" = 20' | Vert. Scale: 1" = 5'

FIRE HYDRANT/FDC LOCATION/ACCESS Kay Cockerham CITY OF PUYALLUP

NOTE: THIS APPROVAL IS VOID AFTER

180 DAYS FROM APPROVAL DATE.

THE CITY WILL NOT BE RESPONSIBLE

FOR ERRORS AND/OR OMISSIONS ON

FIELD CONDITIONS MAY DICTATE

DETERMINED BY THE FIRE CODE

CHANGES TO THESE PLANS AS

FIRE CODE OFFICIAL _{DATE} July 25, 2022


THESE PLANS.

CITY OF PUYALLUP DEVELOPMENT ENGINEERING 7/22/2022

> NOTE: THIS APPROVAL IS VOID AFTER 180 DAYS FROM APPROVAL DATE. THE CITY WILL NOT BE RESPONSIBLE FOR ERRORS AND/OR OMISSIONS ON THESE PLANS. FIELD CONDITIONS MAY DICTATE CHANGES TO THESE PLANS AS DETERMINED BY THE DEVELOPMENT ENGINEERING MANAGER.

APPROVED

Julia S

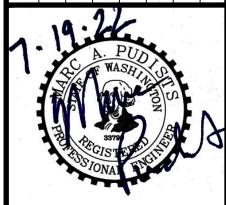

PERMIT SET

SERVICE

MOTIVE GROUP

300 BUILDING - LARSON AUTON CASTINO ARCHITECT



CHECKED BY: M. PUDISTS DESIGNED BY: K. MURPHY DRAWN BY: K. MURPHY HORZ. DATUM: NAD83(11)


VERT. DATUM: **NAVD88**

DATE: **7/19/22**

PROJECT NO. LARS-0001 SHEET NO. **20** of **25**

REFERENCE NO. **C5.3**

City of Puyallup **Development & Permitting Services ISSUED PERMIT Planning** Building Public Works Engineering Traffic Fire

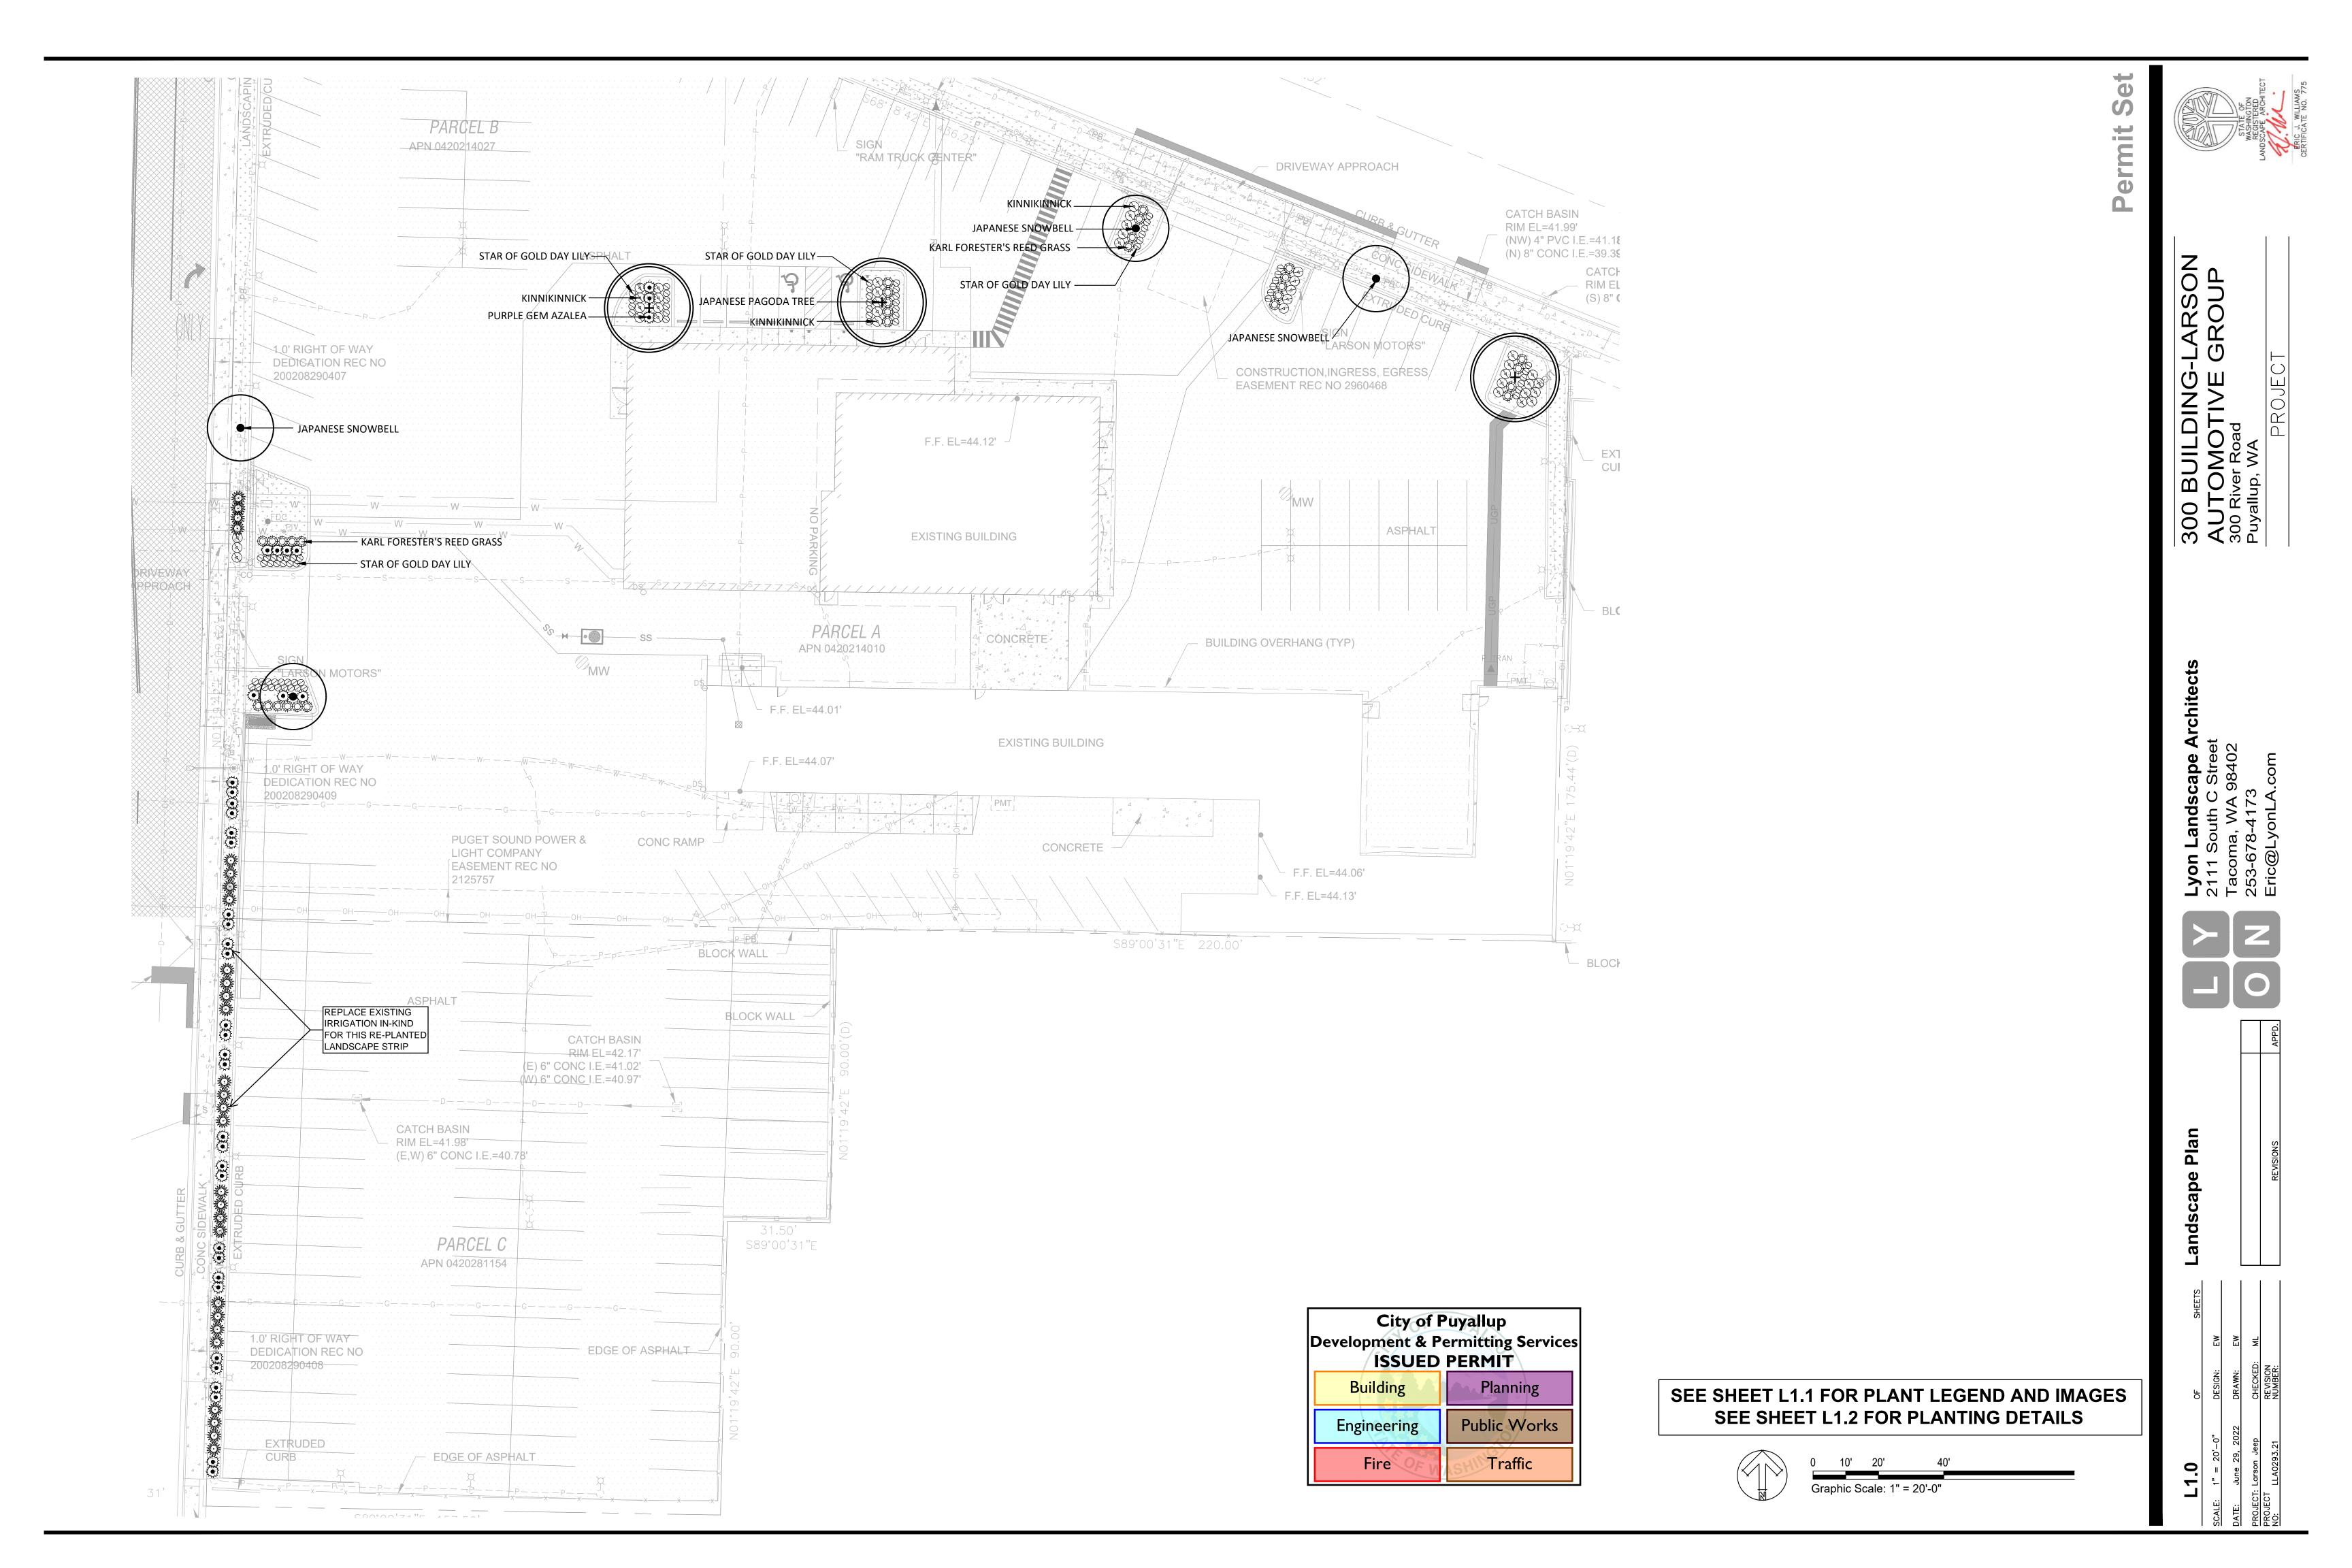

PLANT LEGEND

QTY	BOTANICAL NAME	COMMON NAME	SIZE & SPACING		
TREES					
3	STYPHNOLOBIUM JAPONICUM	JAPANESE PAGODA TREE	2" CALIPER, SPACING PER PLAN		
2	STYRAX JAPONICUS	JAPANESE SNOWBELL	2" CALIPER, SPACING PER PLAN		
	SHRUBS				
10	AZALEA 'PURPLE GEM'	PURPLE GEM AZALEA	2 GALLON, 3' O.C. SPACING		
29	CALAMAGROSTIS 'KARL FOERSTER'	KARL FOERSTER FEATHER REED GRASS	3 GALLON, 3' O.C. SPACING		
4	BERBERIS THUNBERGII 'ROSE GLOW'	ROSE GLOW JAPANESE BARBERRY	3 GALLON, 4' O.C. SPACING		
	GROUNDCOVER				
72	HEMEROCALLIS 'STELLA DE ORO'	STAR OF GOLD DAY LILY	1 GALLON, 24" O.C. SPACING		
38	ARCTOSTAPHYLOS UVA-URSI	KINNIKINNICK	1 GALLON, 3' O.C. SPACING		
	3 2 10 29 4	TREES 3 STYPHNOLOBIUM JAPONICUM 2 STYRAX JAPONICUS SHRUBS 10 AZALEA 'PURPLE GEM' 29 CALAMAGROSTIS 'KARL FOERSTER' 4 BERBERIS THUNBERGII 'ROSE GLOW' GROUNDCOVER 72 HEMEROCALLIS 'STELLA DE ORO'	TREES 3 STYPHNOLOBIUM JAPONICUM JAPANESE PAGODA TREE 2 STYRAX JAPONICUS JAPANESE SNOWBELL SHRUBS 10 AZALEA 'PURPLE GEM' PURPLE GEM AZALEA 29 CALAMAGROSTIS 'KARL FOERSTER' KARL FOERSTER FEATHER REED GRASS 4 BERBERIS THUNBERGII 'ROSE GLOW' ROSE GLOW JAPANESE BARBERRY GROUNDCOVER 72 HEMEROCALLIS 'STELLA DE ORO' STAR OF GOLD DAY LILY		

LANDSCAPE NOTES AND SOIL QUALITY

- 1. CONTRACTOR IS RESPONSIBLE FOR PROVIDING PLANT QUANTITIES AS SHOWN ON DRAWINGS.
- 2. CONTRACTOR SHALL PROVIDE SOIL AMENDMENT AND TOPSOIL PLACEMENT PER CITY OF PUYALLUP DETAILS.
- 3. CONTRACTOR SHALL PROVIDE PRUNING OF REQUIRED TREES AND SHRUBS FOR THE PURPOSE OF MAINTAINING TREES OR SHRUBS IN A HEALTHY AND THRIVING CONDITION AND/OR TO ENHANCE ITS NATURAL GROWTH FORM. TREES AND SHRUBS SHALL NOT BE EXCESSIVELY PRUNED SUCH THAT IT ADVERSELY AFFECTS THE HEALTHY LIVING CONDITION OF THE PLANT, SIGNIFICANTLY DAMAGES THE NATURAL GROWTH OF THE PLANT, OR ELIMINATES OR SIGNIFICANTLY REDUCES THE PURPOSE FOR THE PLANTING. TOPPING, AN EXTREME FORM OF PRUNING OF TREES REQUIRED BY THIS SECTION IS PROHIBITED. THIS PROHIBITION DOES NOT APPLY TO PRUNING TO REMOVE A SAFETY HAZARD, TO REMOVE DEAD OR DISEASED MATERIAL, OR TO AVOID OVERHEAD POWER LINES. PROVIDE PRUNING AS PER THE LANDSCAPE MAINTENANCE PLAN.

PLANT IMAGES





JAPANESE PAGODA TREE

JAPANESE SNOWBELL









PURPLE GEM AZALEA

FOERSTER'S FEATHER REED GRASS

ROSE GLOW JAPANESE BARBERRY

PURPLE ROCK ROSE









STAR OF GOLD DAY HILV


KINNIKINNICK


City of Puyallup Development & Permitting Service ISSUED PERMIT				
Building	Planning			
Engineering	Public Works			
Fire OF V	Traffic			

Lyon Landscape Architects	2111 South C Street	Tacoma, WA 98402
	-	
	_	

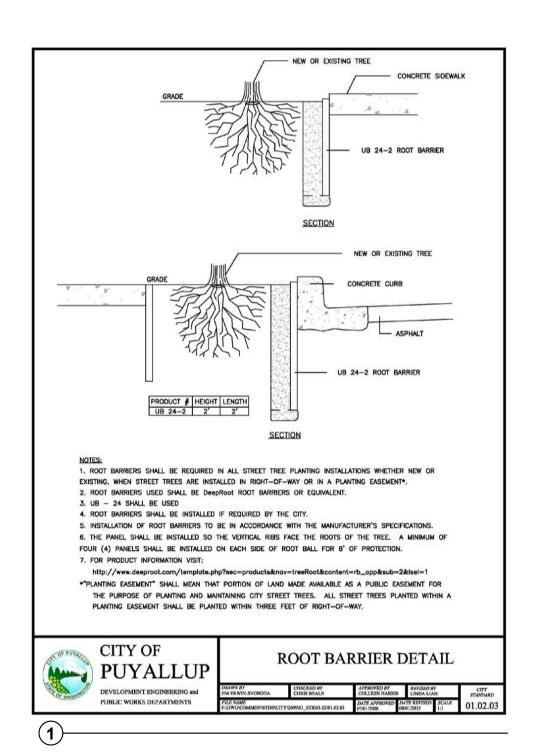

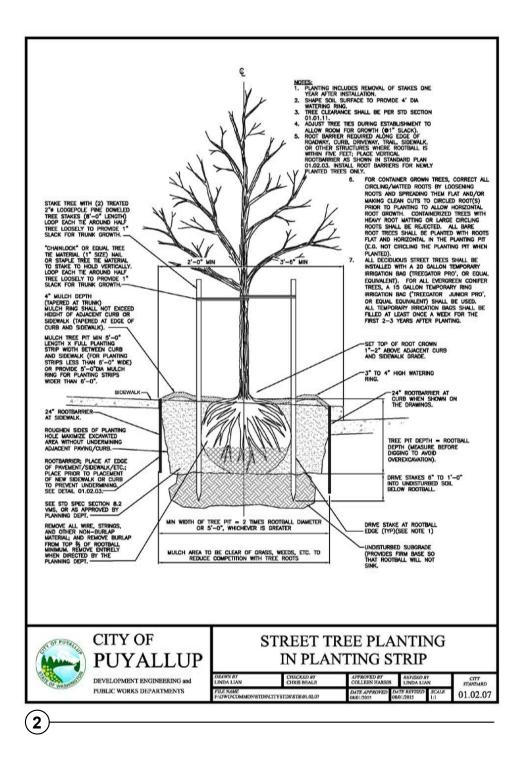

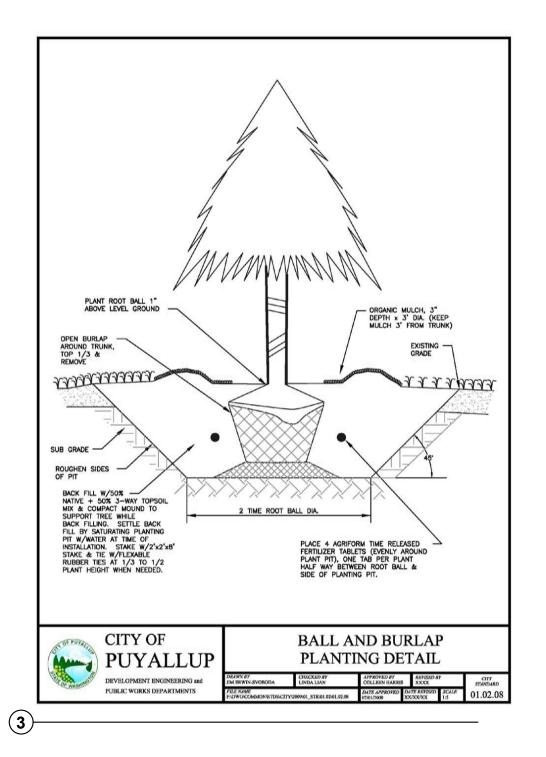

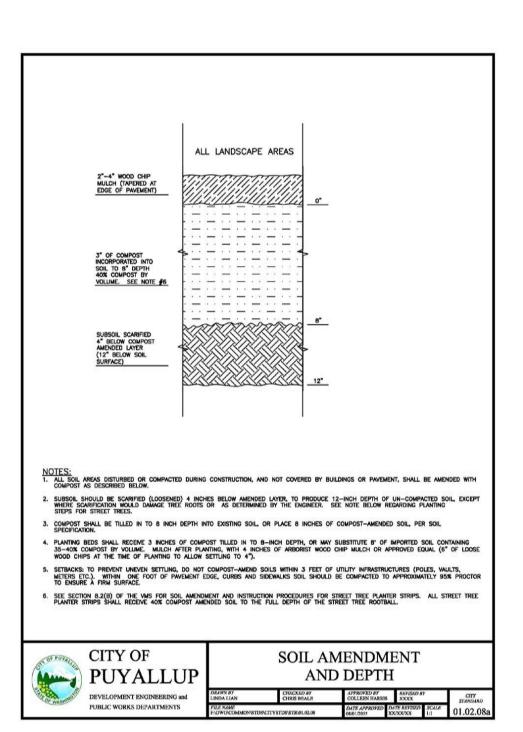

City of Puyallup **Development & Permitting Services ISSUED PERMIT** Planning Building Public Works Engineering Traffic

ndscape Architects
th C Street
WA 98402





Puyallup Stane & Soil Details



0 2

0

IRRIGATION HEAD SCHEDULE

RADIUS GPM PSI

8 0.26 30

12 0.65 30

12 1.30 30

15 0.95 30

4'X15' 0.61 30

4'X30' 1.21 30

1.85 30

SYM. CATALOG NUMBER

SPRAY HEADS

□ RAINBIRD 1800-MPR-8Q

RAINBIRD 1800-MPR-12Q

► RAINBIRD 1800-MPR-15Q

RAINBIRD 1800-MPR-15H

RAINBIRD 1800-MPR-15EST

RAINBIRD 1800-MPR-15SST

AT NO COST TO THE OWNER.

SLEEVE SHALL BE ONE FOOT (12").

TRENCHING.

PAVEMENT.

PROVIDE 6" HEADS FOR LANDSCAPE PLANTING AREAS

LOCATION AND PROTECTION OF ALL EXISTING UTILITIES. THE CONTRACTOR SHALL VERIFY ALL UTILITY LOCATIONS PRIOR TO CONSTRUCTION BY CALLING THE UNDERGROUND LOCATE LINE AT 1-800-424-5555 A MINIMUM OF 48 HOURS PRIOR TO ANY EXCAVATION.

IMPROVEMENTS. DAMAGE TO EXISTING IMPROVEMENTS BY THE

CONTRACTOR AND/OR QUALIFIED INSTALLERS/TRADES ACCEPTABLE

CONTRACTOR. ALL CONSTRUCTION CONFLICTS SHALL BE BROUGHT

HIS/HER RESPECTIVE WORK, DAILY AND AT PROJECT CLOSE-OUT.

CONTRACTOR IS REQUIRED TO INSTALL DUCTILE IRON PIPE FOR

END OF SLEEVE SHALL EXTEND FOUR FEET (4') BEYOND EDGE OF

PAVEMENT. MINIMUM DEPTH OF BURY FROM FIN. GRADE TO TOP OF

SHALL REMAIN CONSTANT BETWEEN PIPE SIZE CALLOUTS. 3/4" CLASS

4" SEPARATION BETWEEN PIPES. DO NOT CROSS PIPES OVER EACH

10. IRRIGATION SITE PLAN IS SCHEMATIC. IRRIGATION PLUMBING AND EQUIPMENT SHALL BE INSTALLED IN TURF OR LANDSCAPE BED AREAS AND WITHIN PROPERTY BOUNDARIES. THE CONTRACTOR SHALL CONSIDER ALL SITE FEATURES IN THE INSTALLATION OF IRRIGATION IMPROVEMENTS. THE CONTRACTOR SHALL BE

RESPONSIBLE FOR SUPPLYING AND INSTALLING ALL IRRIGATION EQUIPMENT NECESSARY FOR A COMPLETE AND FUNCTIONAL IRRIGATION SYSTEM. FIELD VERIFY ALL EXISTING EQUIPMENT

11. SPRINKLER HEAD SYMBOLS SCHEMATICALLY REPRESENT DESIRED SPRAY PATTERNS. FIELD ADJUSTMENTS AND VERIFICATION OF

SPRAY PATTERNS WILL BE NECESSARY. ADJUST SPRAY PATTERNS TO WATER LANDSCAPE AREA ONLY AND MINIMIZE OVERSPRAY ONTO

LOCATIONS AND REPORT ANY INCONSISTENCIES TO CONSTRUCTION

200 PVC SHALL BE THE SMALLEST LATERAL LINE USED.

OTHER UNLESS THEY ARE AT A 90 DEGREE ANGLE.

OBSERVER/OWNER'S REPRESENTATIVE.

IRRIGATION PIPE SLEEVES UNDER PAVEMENTS. D.I. SLEEVE SHALL BE FOUR INCHES (4") LARGER THAN THE IRRIGATION MAINLINE PIPE SIZE.

TO THE SOLE SATISFACTION OF THE CONSTRUCTION OBSERVER AND

CONTRACTOR SHALL BE REPAIRED OR REPLACED BY THE

TO THE ATTENTION OF THE GENERAL CONTRACTOR AND CONSTRUCTION OBSERVER IMMEDIATELY UPON RECOGNITION.


RAINBIRD 1800-MPR-12H

-LARSON GROUP

300 BUILDING-AUTOMOTIVE 300 River Road Puyallup, WA

Irrig

Graphic Scale: 1" = 20'-0"

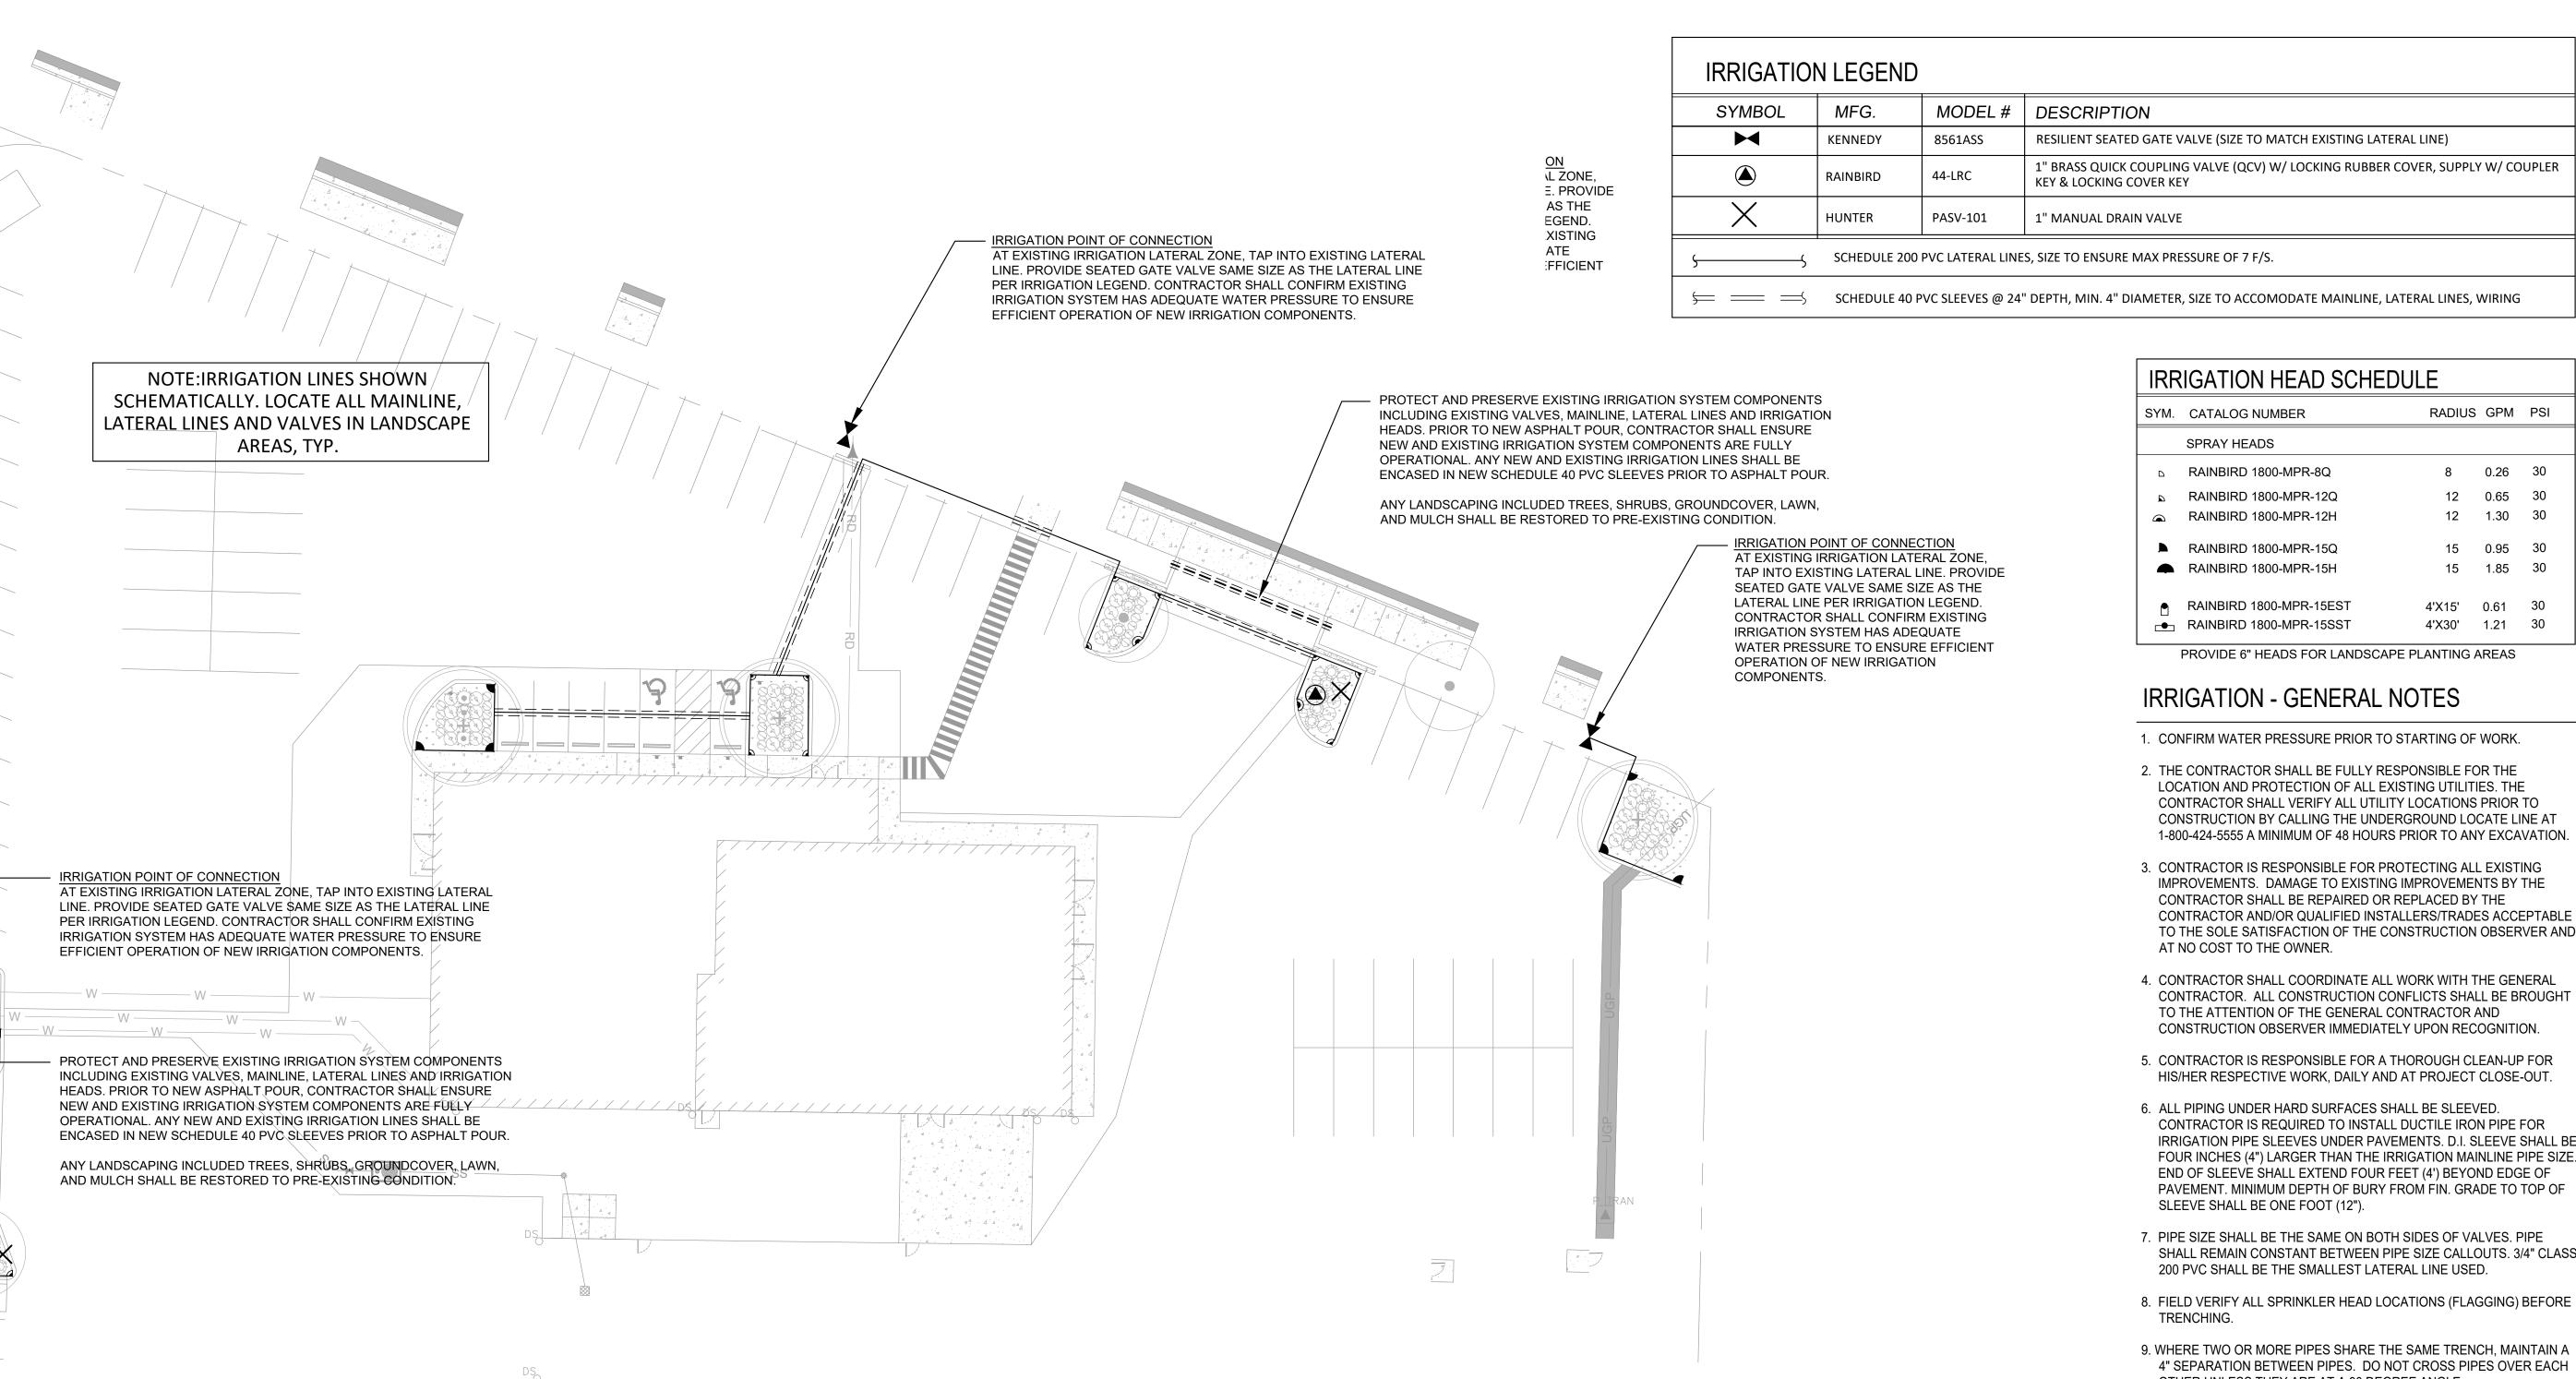

City of Puyallup **Development & Permitting Services ISSUED PERMIT** Planning Building

Public Works Engineering Traffic



Symbol Avg Max Min Max/Min Avg/M

4TH STREET LIGHTING LEVELS X 0.6 fc 4.1 fc 0.0 fc N/A N/A


x^{0.0} **x**^{0.0} **x**^{0.0} **x**^{0.0} **x**^{0.1} **x**^{0.1} **x**^{0.1} **x**^{0.0} **x**^{0.0}

 $\mathbf{x}^{0.0}$ $\mathbf{x}^{0.0}$ $\mathbf{x}^{0.0}$ $\mathbf{x}^{0.1}$ $\mathbf{x}^{0.1}$ $\mathbf{x}^{0.2}$ $\mathbf{x}^{0.1}$

x^{0.1} **x**^{0.1} **x**^{0.2} **x**^{0.3} **x**^{0.4} **x**^{0.4} **x**^{0.2} **x**^{0.1} **x**^{0.1}

x^{0.1} **x**^{0.2} **x**^{0.4} **x**^{0.6} **x**^{0.6} **x**^{0.6} **x**^{0.3} **x**^{0.2} **x**^{0.1}

EXISTING PSE POLE MOUNTED FIXTURE *** *** *** ***

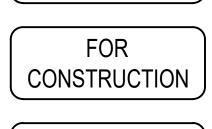

REVISIONS:

CITY COMMENTS - 7/19/22

DANARD ELECTRIC INC.


Quality Since 1947 18819 38TH AVE. E. TACOMA, WA 98446 PH: (253) 875-8650 FAX: (253) 875-8649 COMMITTED TO BUILDING A BETTER WORLD


JUN. 29, 2022 18525C PROJECT NO.:


FILE NAME: 4TH STREET

LIGHTING PLAN

SHEET NO:

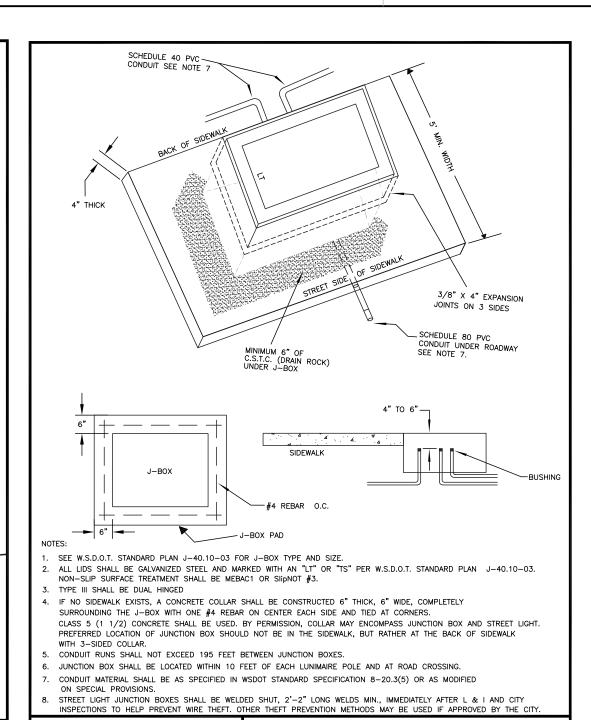

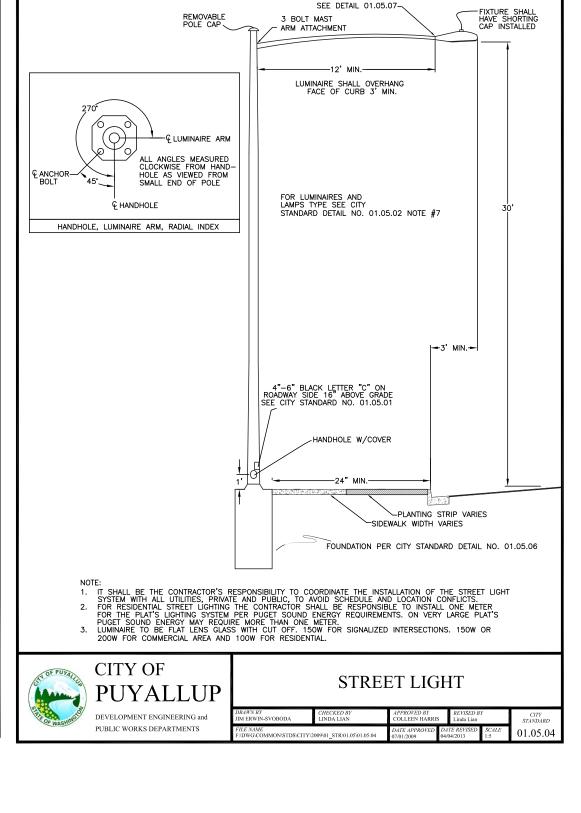

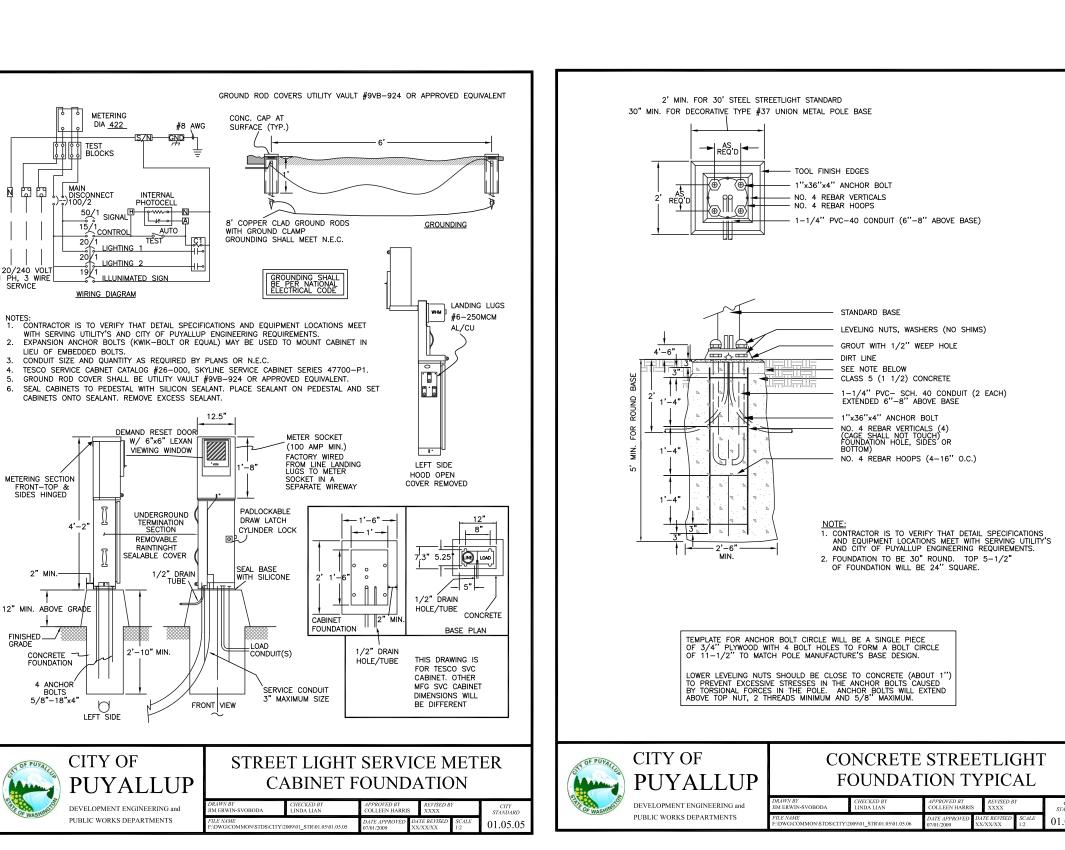

SEE CITY STANDARD DETAIL NO. 01.05.02

HAND HOLD

CONDUCTORS SHALL BE TYPE USE (XLP) INSULATED, STRANDED, COPPER, #8 A.W.G. MINIMUM SIZE

TYPICAL STREET LIGHT

INSTALLATION

FOR LUMINAIRE SPECIFICATION —

A METER SERVICE DISCONNECT IS REQUIRED FOR EACH BRANCH CIRCUIT. SEE CITY STANDARD DETAIL NO. 01.05.05
 INSTALLATION SHALL CONFORM TO NATIONAL ELECTRICAL CODE, WSDOT, AND CITY STANDARDS.

CODE, WSDOT, AND CITY STANDARDS.

3. PHASING TAPE IS NOT ALLOWED.

4. ALL WIRES SHALL BE INSTALLED IN CONDUIT AS SPECIFIED ABOVE.

5. ALL SPLICES SHALL BE MADE IN A JUNCTION BOX. WIRE NUTS WILL NOT BE ALLOWED. SPLICES SHALL BE CENTERED AND ENCASED IN 3M SCOTCHCAST EPOXY KIT TYPE 82—A1, 82—B1, OR CITY APPROVED EQUAL.

OTHER GEL TAP SPLICE KITS AND DIRECT BURIAL AND SUBMERSIBLE SPLICES TO BE BE ALLOWED IF APPROVED BY THE CITY.

6. GROUND ROD COVER SHALL BE UTILITY VAULT #9VB—924 OR APPROVED EQUIVALENT.

SERVICE, SEE CITY STANDARD DETAIL NO. 01.05.05

CITY OF

IN-LINE FUSED WATER TIGHT ELECTRICAL DISCONNECT SEE CITY STANDARD DETAIL NO. 01.05.02 NOTE #6

GROUND WIRE

2 EACH GROUNDING

(TYP.) WITH COVERS/

SEE CITY STANDARD

