Branch Facilities Office #18004 Puyallup, WA

Approval of submitted plans is not an approval of omissions or building codes and regulations of the local government.


oversight by this office or noncompliance with any applicable regulations of local government. The contractor is responsible for making sure that the building complies with all applicable

Owner:

BUILDING/PLUMBING/MECHANICAL PERMIT 2018 CODES

H&R BIOCK

mFULL SIZED LEDGIBLE **COLOR** PLANS ARE REQUIRED TO BE PROVIDE BY THE PERMITTEE ON SITE FOR ALL INSPECTIONS MIN. PLAN SIZE 24 X 36

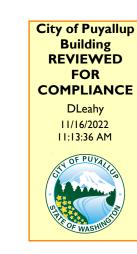

PROJECT TEAM

BUILDING OWNER / PROPERTY MANAGER CONTACT:

Carrie Walker (245) 307-1333

If a sewer sampling tee is not currently installed at this site the installation of one will be required prior to occupancy. A separate utility permit must be obtained prior to the installation of a sewer sampling tee

See permit for additional requirements. 09/28/2022 9:06:26 AM


All commercial development must have a sampling tee installed on their sewer lateral. See Standard Detail 04.03.04

evelopment & Permitting Services **ISSUED PERMIT Public Works** Engineering Traffic

AREA OF WORK: H&R BLOCK (B) - BUSINESS PROFESSIONAL SERVICES

APPROVED PLAN CITY OF PUYALLUP PLANNING DIVISION APPROVED BY: GClark DATE: 09/28/2022 CASE NO.: PRCTI20221400 **CONDITIONS:**

PROJECT LOCATION

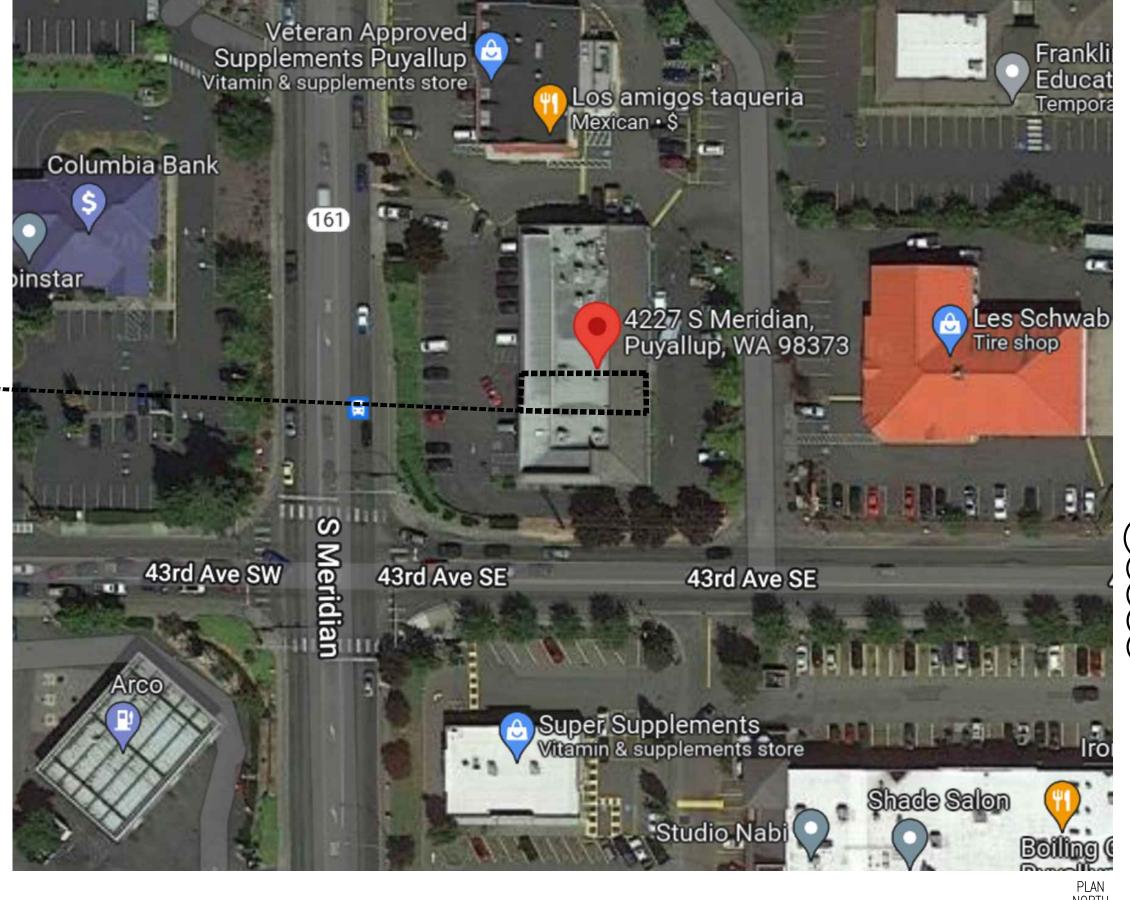

SITE PLAN

OFFICE TYPE

PHONE SYSTEM

PHONE SYSTEM: NORTEL

NOTE TO CONTRACTOR

IT IS THE CONTRACTOR'S RESPONSIBILITY TO THOROUGHLY REVIEW THE OWNER'S DESIGN INTENT DRAWINGS & NOTIFY THE ARCHITECT IMMEDIATELY WITH ANY MAJOR DISCREPENCIES. THE ARCHITECT SHALL IN NO WAY BE HELD RESPONSIBLE FOR ANY DIFFERENCES BETWEEN THE DESIGN INTENT AND ARCHITECT PROVIDED DRAWINGS.

EXTERIOR SIGN NOTES

SIGNAGE: GENERAL CONTRACTOR (GC) TO VERIFY EXISTENCE & FUNCTIONALITY OF SIGN CIRCUIT ALONG SIGN BAND SERVING SUBJECT SPACE. EXISTING CIRCUIT MUST BE LOCATED IN/ON THE SIGN BAND ABOVE THE SUBJECT SPACE & WITHIN SIX FEET (6') OF THE CENTERLINE OF THE SPACE. THE CIRCUIT SHOULD BE DIRECT FEED FROM THE ELECTRICAL PANEL WITHIN THE TENANT SPACE & BE FED THROUGH A TIME CLOCK OR PHOTOCELL. SHOULD THE CIRCUIT NOT EXIST AND/OR BE DEEMED NON-FUNCTIONAL, GC TO PROVIDE INSTALLATION OF NEW DEDICATED SIGN CIRCUIT, PHOTOCELL & JUNCTION BOX TO BE MOUNTED WITHIN THE SIGN BAND NO MORE THAN SIX FEET (6') FROM THE CENTERLINE OF THE SUBJECT SPACE. COST FOR INSTALLATION OF THE CIRCUIT, J-BOX & PHOTOCELL TO BE INCLUDED IN THE BASE ÉLECTRICAL BID FOR THE PROJECT.

PROJECT INFORMATION

- APPLICABLE CODES:

- 2018 UNIFORM PLUMBING CODE W/ WA.ST. AMENDMENTS
- CONSTRUCTION TYPE: II-B UNPROTECTED
- OCCUPANCY GROUP: (B) BUSINESS
- NUMBER OF STORIES: SINGLE
- SPRINKLER SYSTEM: NO
- FIRE ALARM: NO
- PROJECT AREA:
- PARTIAL FIRST FLOOR 1620 SF (LEASE AREA)
- OCCUPANT LOAD:
- BUSINESS AREA: 1084 NET SF / 150 = 8 OCCUPANTS
- WAITING AREA: 129 NET SF / 7 = 19 OCCUPANTS • TOTAL: 27 OCCUPANTS

LIST OF DRAWINGS

- T1 COVER SHEET A1 DEMOLITION / CONSTRUCTION / FINISH PLANS
- A2 REFLECTED CEILING / POWER / VOICE DATA PLANS
- A3 FURNITURE PLAN / DETAILS / PARTITION TYPES
- A4 DOOR SCHEDULES AND DETAILS A5 SEISMIC CEILING DETAILS
- **ELECTRICAL SHEETS EO ELECTRICAL COVER SHEET**
- E1 ELECTRICAL DEMOLITION PLAN
- E2 LIGHTING PLAN
- E3 POWER AND SYSTEMS PLANS E4 ELECTRICAL ONE-LINE AND PANEL SCHEDULE

H&R BLOCK NOTES

9. ALL EXISTING CEILING TILES TO REMAIN; DAMAGED TO BE REPLACED.

HORIZONTAL CONDUIT CAN BE INSTALLED; PAINT TO MATCH WALL COLOR.

12. ALL RESTROOMS TO RECEIVE NEW ADA GRAB BARS AS NEEDED PER CODE.

- E5 LIGHTING COMPLIANCE CERTIFICATE E6 ELECTRICAL SPECIFICATIONS

- MECHANICAL SHEETS
- M0 MECHANICAL COVER SHEET
- M1 MECHANICAL DEMOLITION PLAN

P2 PLUMBING PLAN

1. CONTRACTOR TO FIELD VERIFY ALL EXISTING CONDITIONS; IF THERE ARE ANY CHANGES, REVISIONS, OR DISCREPANCIES PLEASE CALL:

ELIZABETH (314) 380-4578 OR CHRIS (314)530-8006

2. MECHANICAL, ELECTRICAL AND PLUMBING (MEP) ARE ALL DESIGN-BUILD; MEP CONTRACTORS REQUIRED TO OBTAIN NECESSARY

SHOULD BE LEGRAND OR LEVITON, OR SIMILAR PRODUCT.DO NOT PAINT ANY OUTLET DEVICES OR FACEPLATES.

7. ALL DOORS (INTERIOR) TO BE PAINTED TO MATCH WALL COLOR; SEE SHEET 6. USE SEMI-GLOSS FINISH ON DOORS.

EXISTING DUPLEX RECEPTACLES CAN BE USED TO MEET REQUIREMENTS IF WITHIN 6" OF DESIRED LOCATION.

8. REMOVE WALL-COVERING AND CHAIR RAIL IF EXISTING; PATCH/REPAIR AS NEEDED TO ACCEPT NEW FINISHES.

6. CONFIRM NIGHT LIGHTS AS NEEDED PER CODE. INSTALL NEW EXIT SIGNS AS REQUIRED PER LOCAL CODE.

11. 3-WAY SWITCH SHALL BE INSTALLED AT EACH MEANS OF EGRESS FROM DEMISED SPACE IF NOT EXISTING

3. CONTRACTOR TO PROVIDE NEW ELECTRICAL DEVICES AS INDICATED ON PLAN. IF SCHEDULED TO REMAIN, VERIFY EXISTING DEVICES ARE IN GOOD WORKING CONDITION. REMOVE AND PATCH DEVICES THAT ARE EXISTING OVER 18" AFF IF LOCATED IN LOBBY OR TAX AREA. NEW, EXISTING, AND BLANK OUTLET DEVICES AND FACEPLATES SHOULD BE GREY IN COLOR TO MATCH P7 AND P9 WALLS. NEW, EXISTING, AND BLANK OUTLET DEVICES AND FACEPLATES SHOULD BE BLACK IN COLOR TO MATCH P13 WALLS. ALL DEVICES

4. CONTRACTOR TO PROVIDE A BOX AND PULLSTRING AT EACH VOICE/DATA LOCATION (SEE IT NOTES AND LOCATIONS ON SHEET A2)

10. REMOVE ALL VERTICAL CONDUIT/PANDUIT LOCATED IN MAIN LOBBY AND TAX AREAS. PATCH/REPAIR PARTITIONS AS NEEDED TO

ACCEPT NEW FINISHES. ALL NEW ELECTRICAL AND LOW VOLTAGE DROPS TO BE FISHED IN WALLS. IF UNABLE TO FISH NEW WIRING,

EXISTING AND NEW PARTITION DIMENSION TOLERANCE IS 2" TO 6" UNLESS NOTED AS HOLD.

AND COORDINATE WITH IDENTIFIED LOW VOLTAGE VENDOR FOR CABLE INSTALLATION.

- M2 MECHANICAL PLAN M3 MECHANICAL & PLUMBING DETAILS
- M4 MECHANICAL & PLUMBING SCHEDULES
- M5 MECHANICAL & PLUMBING SCHEDULES
- M6 MECHANICAL & PLUMBING SPECIFICATIONS M7 MECHANICAL & ENERGY COMPLIANCE
- documents not exhibiting this seal. PLUMBING SHEETS P1 PLUMBING DEMO PLAN

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and all responsibility for such plans, drawings or

BUILDING COMMENTS 10/17/22

······· 2 BUILDING REVISION 2 11/08/21

319 North 4th Street

(314) 231-5700

TO BE DETERMINED

PROFESSIONAL ENGINEER:

Phone: 303.796.6000


PROFESSIONAL SEAL:

MKK now IMEG Consulting Engineers 7600 E Orchard Road, Suite 250-S


Greenwood Village, CO 80111


PROJECT TEAM: GENERAL CONTRACTOR:


St. Louis, Missouri 63102

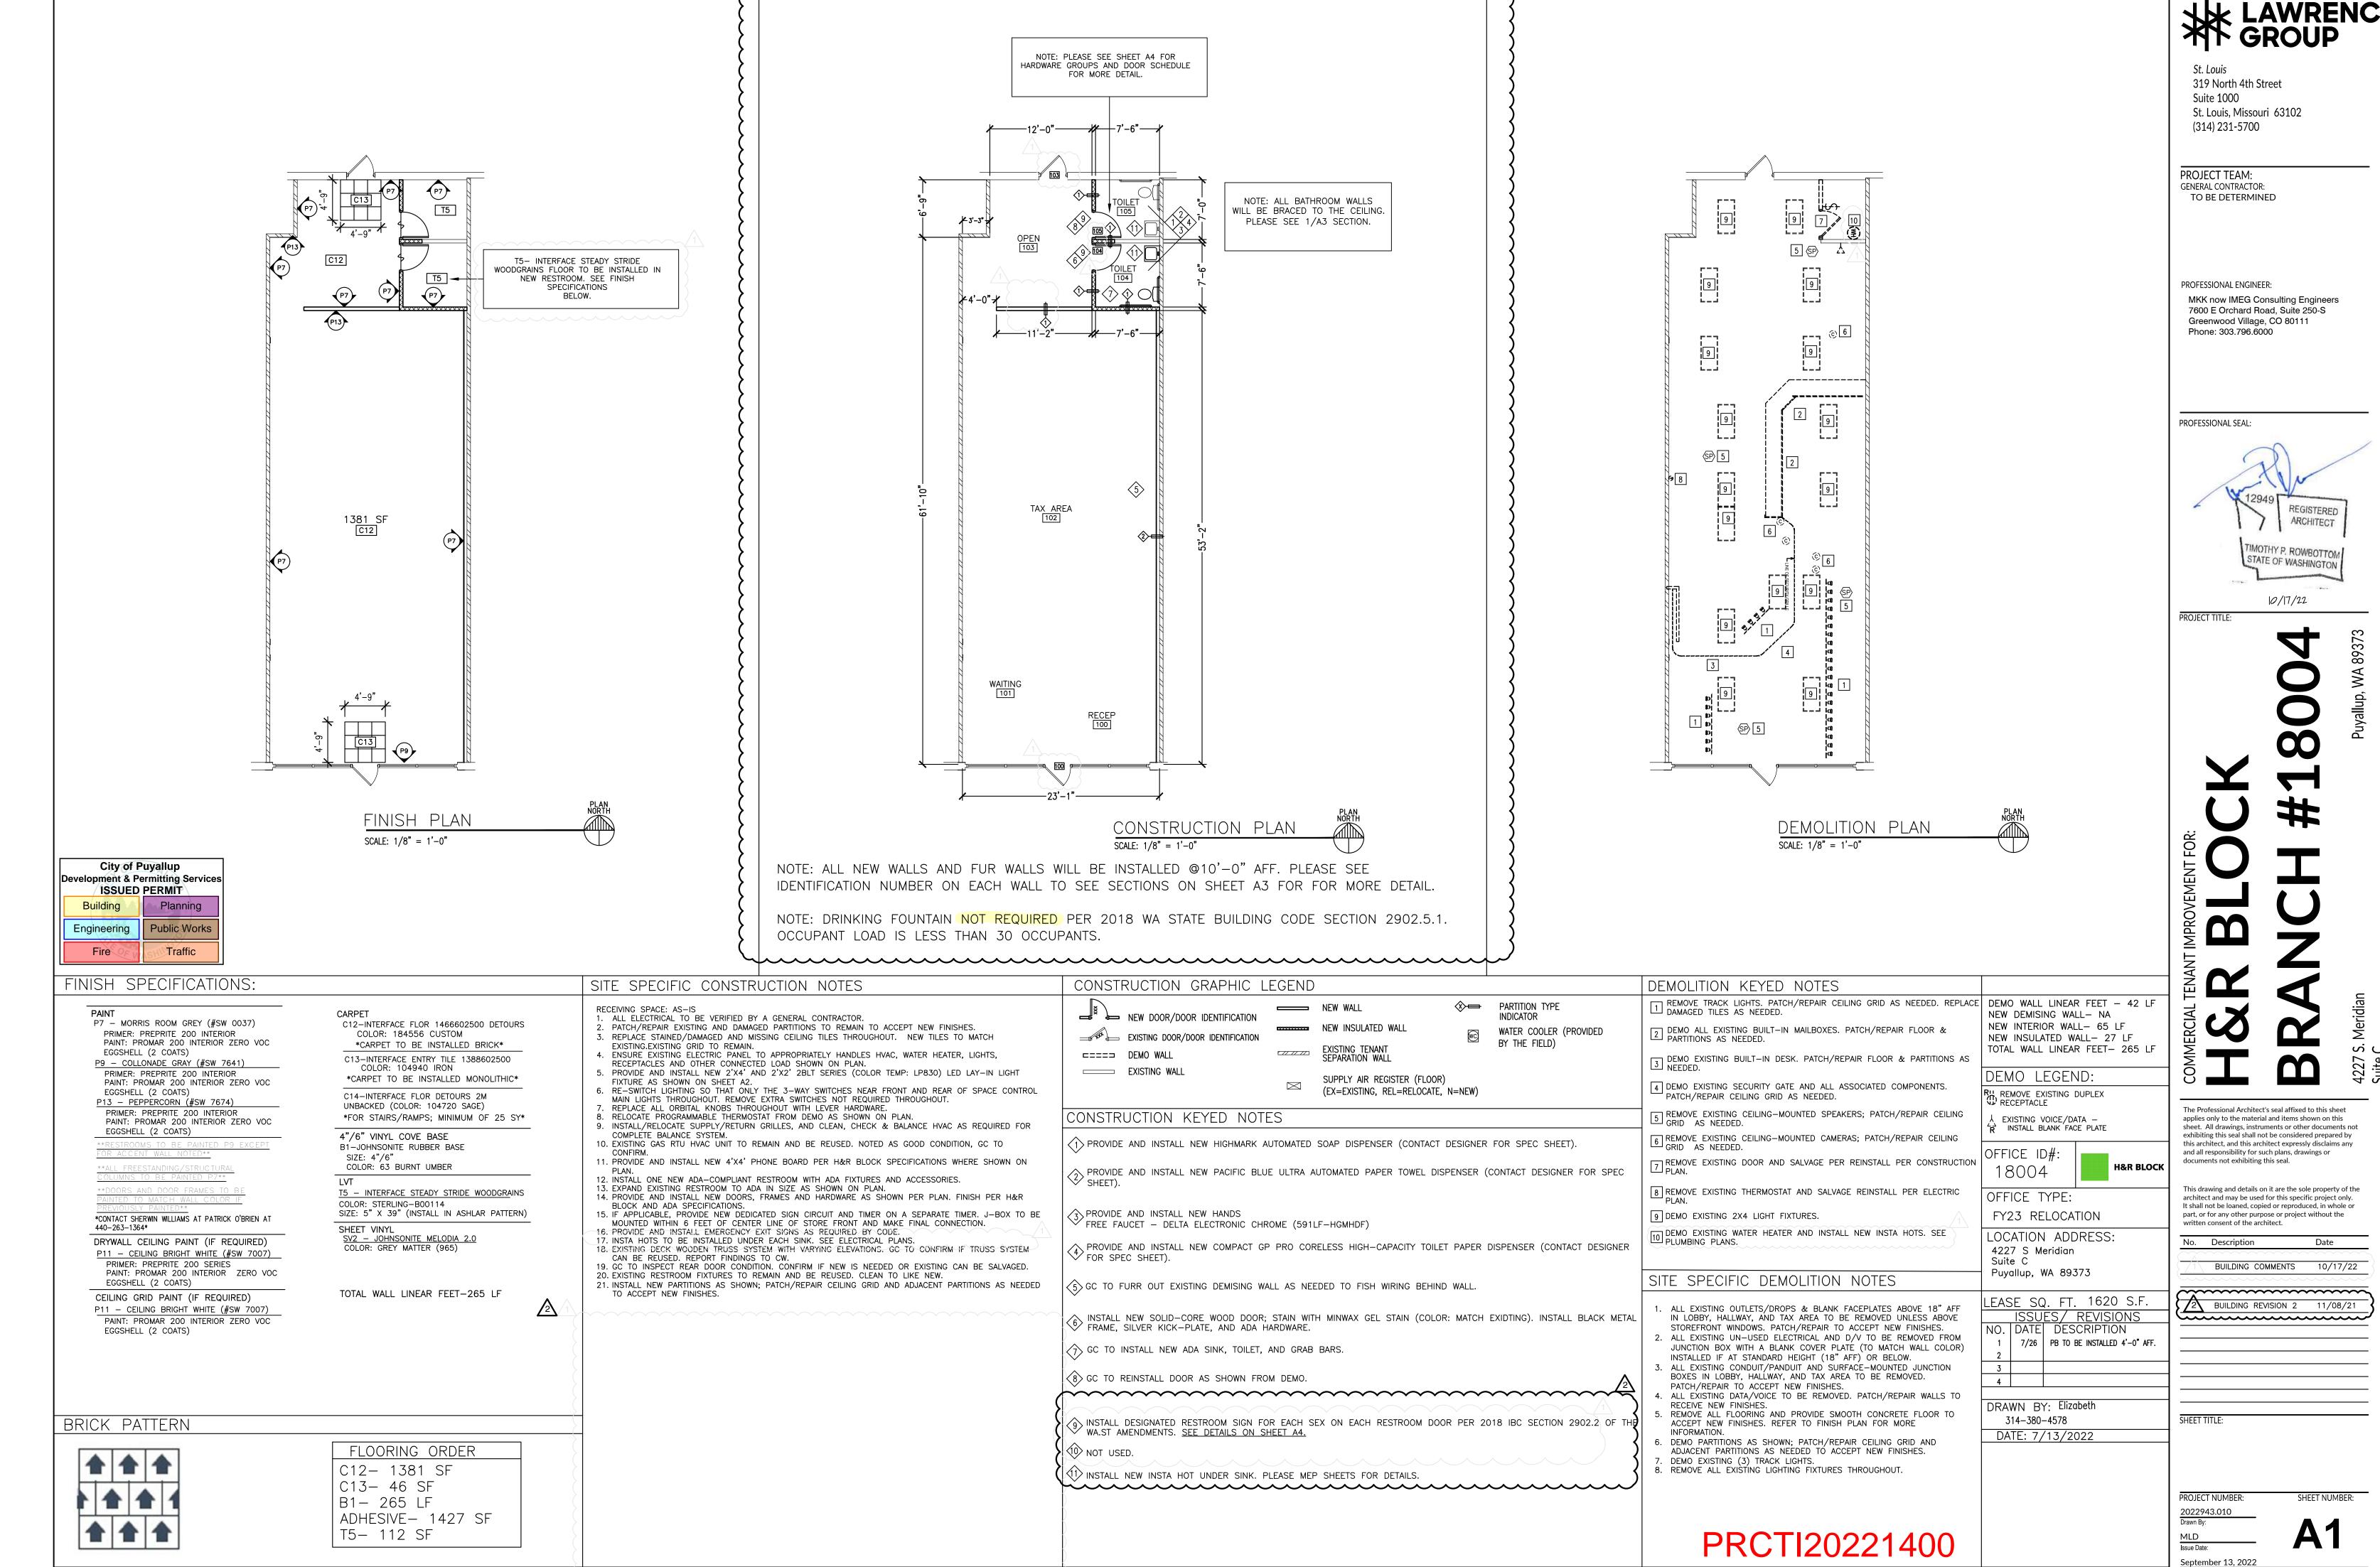

~~~~~~~~<u>/2</u>\

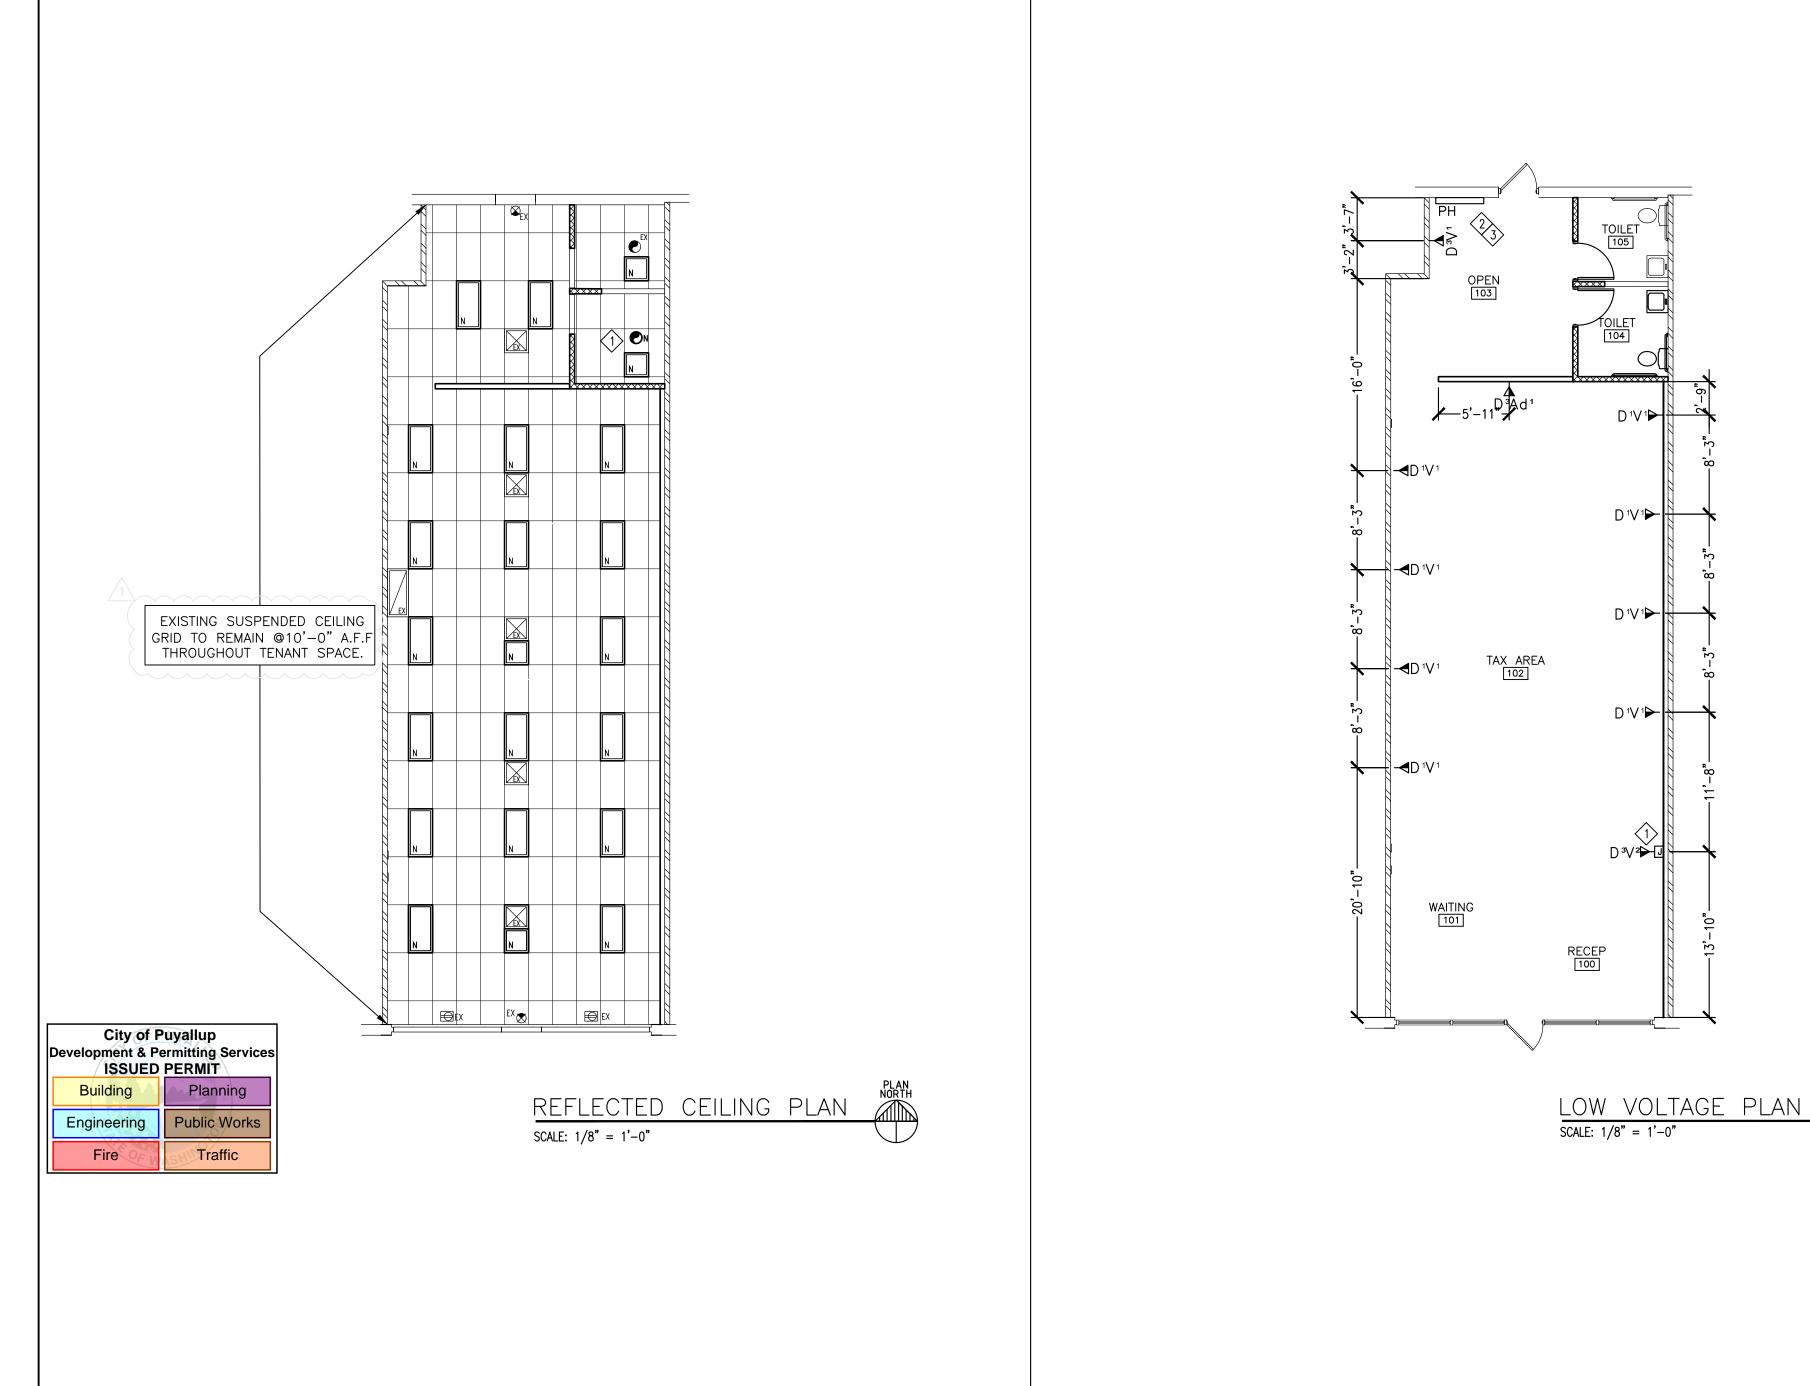

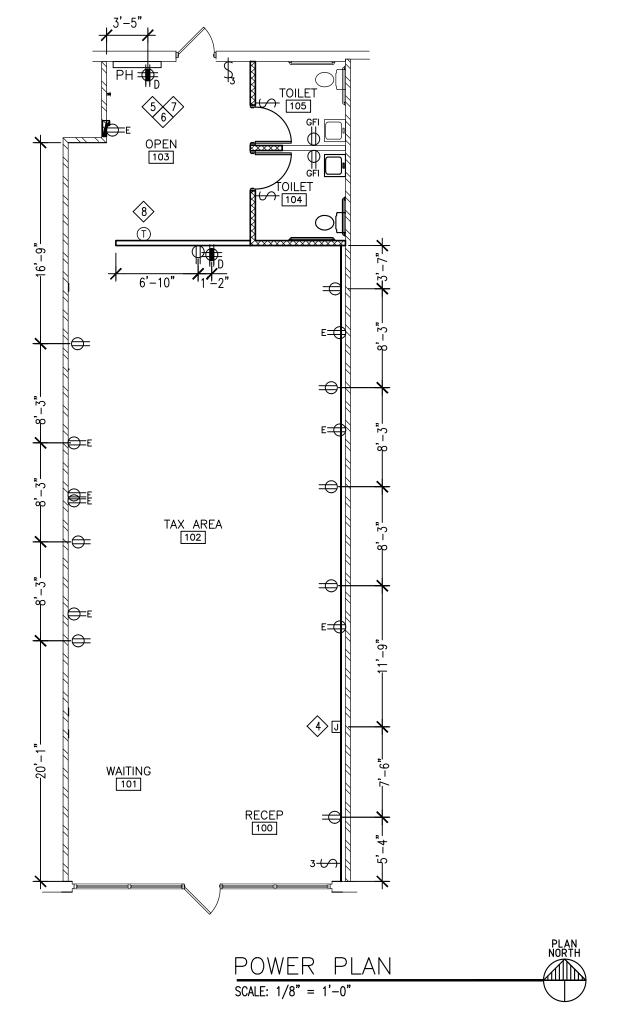

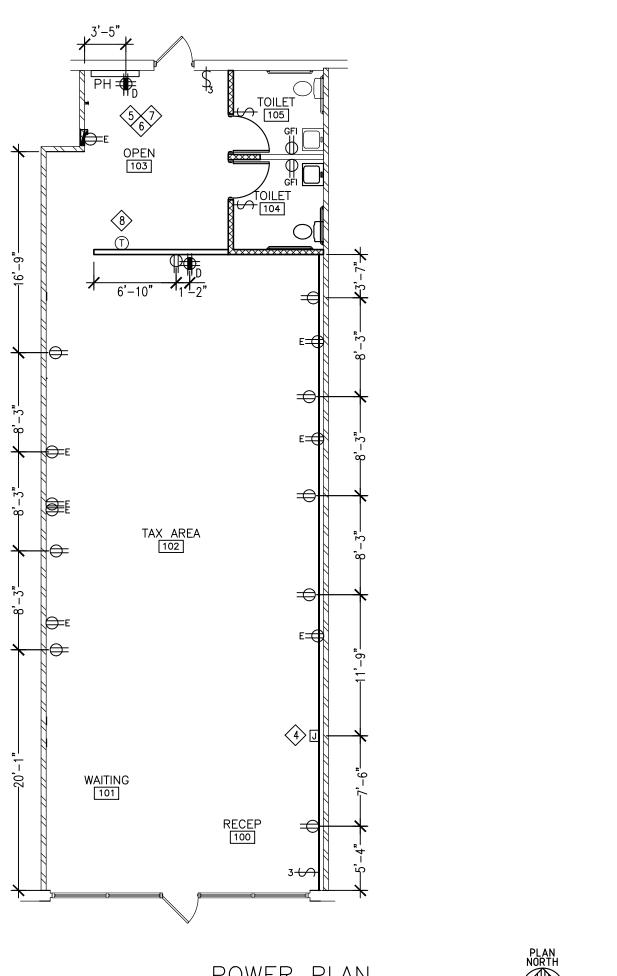



PROFESSIONAL ENGINEER:

PROJECT TEAM: GENERAL CONTRACTOR: TO BE DETERMINED

MKK now IMEG Consulting Engineers 7600 E Orchard Road, Suite 250-S Greenwood Village, CO 80111 Phone: 303.796.6000



PROJECT TITLE:

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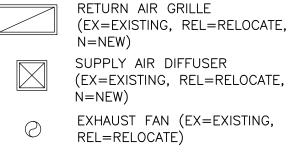
BUILDING COMMENTS 10/17/22

2 BUILDING REVISION 2 11/08/21 

PROJECT NUMBER:

PRCTI20221400

CSP POWER WHIP & D/V HOOK-UP



EXHAUST FAN (EX=EXISTING, REL=RELOCATE, N=NEW)

EXIT SIGN (EX=EXISTING,

REL=RELOCATE, N=NEW)

2'X4' LED LIGHT FIXTURE

2'X2' LED LIGHT FIXTURE

N=NEW)

N=NEW)

(E=EXISTING, REL=RELOCATE,

(E=EXISTING, REL=RELOCATE,

CEILING DUPLEX (EX=EXISTING,

REL=RELOCATE, N=NEW)

CEILING PLAN GENERAL NOTES THIS PLAN IS A DESIGN INTENT DRAWING ONLY. ALL ELECTRICAL LOAD CALCULATIONS ARE TO BE COMPLETED BY A LICENSED ENGINEER. 2. SWITCHING IS NOT SHOWN. TO BE COMPLETED BY A LICENSED ENGINEER.

REFLECTED CEILING PLAN GRAPHIC LEGEND

CEILING PLAN KEYED NOTES

(1) GC TO INSTALL NEW EXHAUST FAN IN RESTROOM.

1. SUPPLY AND INSTALL [1] WHITE, 1-GANG, 3. SUPPLY AND INSTALL [1] WHITE, 1-GANG, BLANK WALL-PLATE AS SHOWN ON PLANS. BLANK WALL-PLATE AS SHOWN ON PLANS. ALIGN INSTALL HEIGHT WITH ELECTRICAL WALL DRILL 7/8" HOLE IN CENTER OF PLATE. ALIGN PRODUCT SIZE AND INSTALL HEIGHT WITH - HUBBELL PART #: NP7W DATA/VOICE WALL PLATE. 2. SUPPLY AND INSTALL [1] BLACK, 1" SPLIT - THOMAS & BETTS PART #: DCCBWH LOOM CORRUGATED TUBING AROUND DATA 4. SUPPLY AND INSTALL [1] BLACK, 90 DEGREE CABLES AND INSERT TUBING INTO LOW VOLTAGE TUBING CONNECTOR IN BLANK WALL PLATE. CABLE PLATE. - HUBBELL PART #: P0509NBK - PANDUIT PART #: CLT100F-C20

<u>CSP DESK IT</u> WALL INSTALLATION

Power Whip Connection (1) Data # -(1) Voice (1) Data # Outlet Outlet L(I) Data Duplex Outlet-\*If Flatwire, Data/Voice Entry -Duplex Outlet

WALL TERMINATIONS -DATA (D)-BLUE, CAT 6, RJ45 CONNECTOR/JACKS -VOICE (V)-WHITE, CAT 6, RJ45 CONNECTORS/JACKS TERMINATE ON BLUE PAIRS -ANALOG (A)-BLACK, CAT 6, RJ45 CONNECTORS/JACKS TERMINATE ON ORANGE PAIRS

CANVAS CSP DESK ELECTRICAL

LABEL ALL TERMINATIONS AT THE BACK ROOM (PATCH PANEL AND 66 BLOCK) AND WALL JACKS BEGINNING AT THE RECEPTION COUNTER MOVING COUNTER CLOCKWISE AS YOU ENTER THE SPACE. PARTITION WALLS ARE LABELED MOVING COUNTER CLOCKWISE WITH PERIMETER WALLS. POWER POLES ARE LABELED LAST IF USED IN THE SPACE. NUMBER SEQUENCE AS FOLLOWS: DATA- D1, D2, D3, D4... VOICE- V1, V2, V3, V4... ANALOG- A1, A2, A3, A4...

CONTRACTOR TO INSTALL JUNCTION BOX AS DIMENSIONED (6" FROM FINISHED FLOOR TO BOTTOM OF EACH J-BOX) AT WALL: - JUNCTION BOX TO HAVE ELECTRICAL WHIP TO ACCOMMODATE (6) DUPLEX OUTLETS.

LEC/CLEC SERVICE TO BE LOCATED WITHIN 2'-0" OF PHONE

 $\stackrel{(6)}{\sim}$  contractor to provide and install New 4'x4' phone board PER PLAN AT 4'-0" AFF.

 $\langle 7 \rangle$  contractor to provide and install new dedicated quad at PHONE BOARD LOCATION.

LOW VOLTAGE KEYED NOTES

- JUNCTION BOX TO HAVE (3) DATA AND (2) VOICE CABLES RETURN TRIP AFTER FURNITURE ARRIVES TO RUN CABLING FOR DATA AND VOICE AT KNOCK OUTS IN PANEL BASE. 2 ALL DATA/VOICE CONNECTIONS TO BE CONSOLIDATED TO NEW

PHONE BOARD LOCATION PER PLAN.

POWER / VOICE DATA PLAN GRAPHIC LEGEND F ELECTRICAL PANEL

☐ 4'x4' PLYWOOD PHONE BOARD, PAINTED (LABEL VISIBLE) VOICE/DATA -DV ASSUME SINGLE GANG BOX TO BE INSTALLED AT EACH LOCATION WITH A MUDRING AND PULLSTRING

VOICE/DATA (FLOOR BOX)ASSUME SINGLE GANG BOX AT EACH LOCATION. IF REQ'D BY CODE, PENDANTS INSTALL 1" CONDUIT STUBBED AT CEILING AT ALL NEW PARTITIONS; MUDRING AND PULLSTRING ONLY AT EXIST. PARTITIONS A EXISTING DEDICATED, GROUNDED 20-AMP QUAD, MARKED w/ORANGE DEVICE

DUPLEX RECEPTACLE ♥ QUADRAPLEX RECEPTACLE

DE EXISTING DUPLEX RECEPTACLE # EXISTING QUADRAPLEX RECEPTACLE

 $\Phi_{R}$  remove existing duplex receptacle (see demo plan) SITE SPECIFIC NOTES

ALL EXISTING UN-USED D/V TO BE REMOVED FROM JUNCTION BOX WITH A BLANK COVER PLATE (TO MATCH WALL

GENERAL NOTES

. CATEGORY 6 WIRING MUST BE USED FOR ALL CABLE RUNS (DATA, VOICE, AND ANALOG). . ALL CABLE RUNS MUST BE SUSPENDED ABOVE THE CEILING USING J HOOKS, O RINGS, OR AS LOCAL CODE REQUIRES.

\$ switch

**J** ЈВОХ

\$, 3-WAY SWITCH

① THERMOSTAT

VOICE/DATA

EXISTING DATA

L EXISTING VOICE

O- OCCUPANCY SENSOR

EXISTING JUNCTION BOX TO BE RE-USED

ÉJB - NEW CAT 6 CABLING TO BE INSTALLED PER

5. EXTEND TELCO DMARC INTO BACK ROOM USING A TWENTY FIVE (25) PAIR OUTDOOR CABLE AND TERMINATE ON 66 6. DMARC EXTENSION- PLEASE REFER TO THE LOW VOLTAGE SPECIFICATIONS FOR INSTRUCTIONS AND ADDITIONAL

POWER KEYED NOTES RETURN TRIP AFTER FURNITURE ARRIVES TO MAKE POWER CONNECTION AT THE WALL AND TERMINATE AT KNOCK OUTS IN

5 BOARD. IF EXISTING D-MARC & PATCH PANEL ARE NOT IN LOCATION SHOWN, NOTIFY CONTACT.

(8) RELOCATE THERMOSTAT AS SHOWN FROM DEMO.


CONTRACTOR TO INSTALL JUNCTION BOX AS DIMENSIONED (6" FROM FINISHED FLOOR TO BOTTOM OF EACH J-BOX) AT WALL:

GC TO EXTEND DMARC INTO SUITE.

COLOR) INSTALLED OVER THE BOX.

3. PROVIDE 2' to 3' SERVICE LOOPS ABOVE CEILING. 4. TERMINATE AND LABEL ALL CABLING AT WALL AND BACK ROOM (PATCH PANEL AND 66 BLOCK)

Issue Date: September 13, 2022

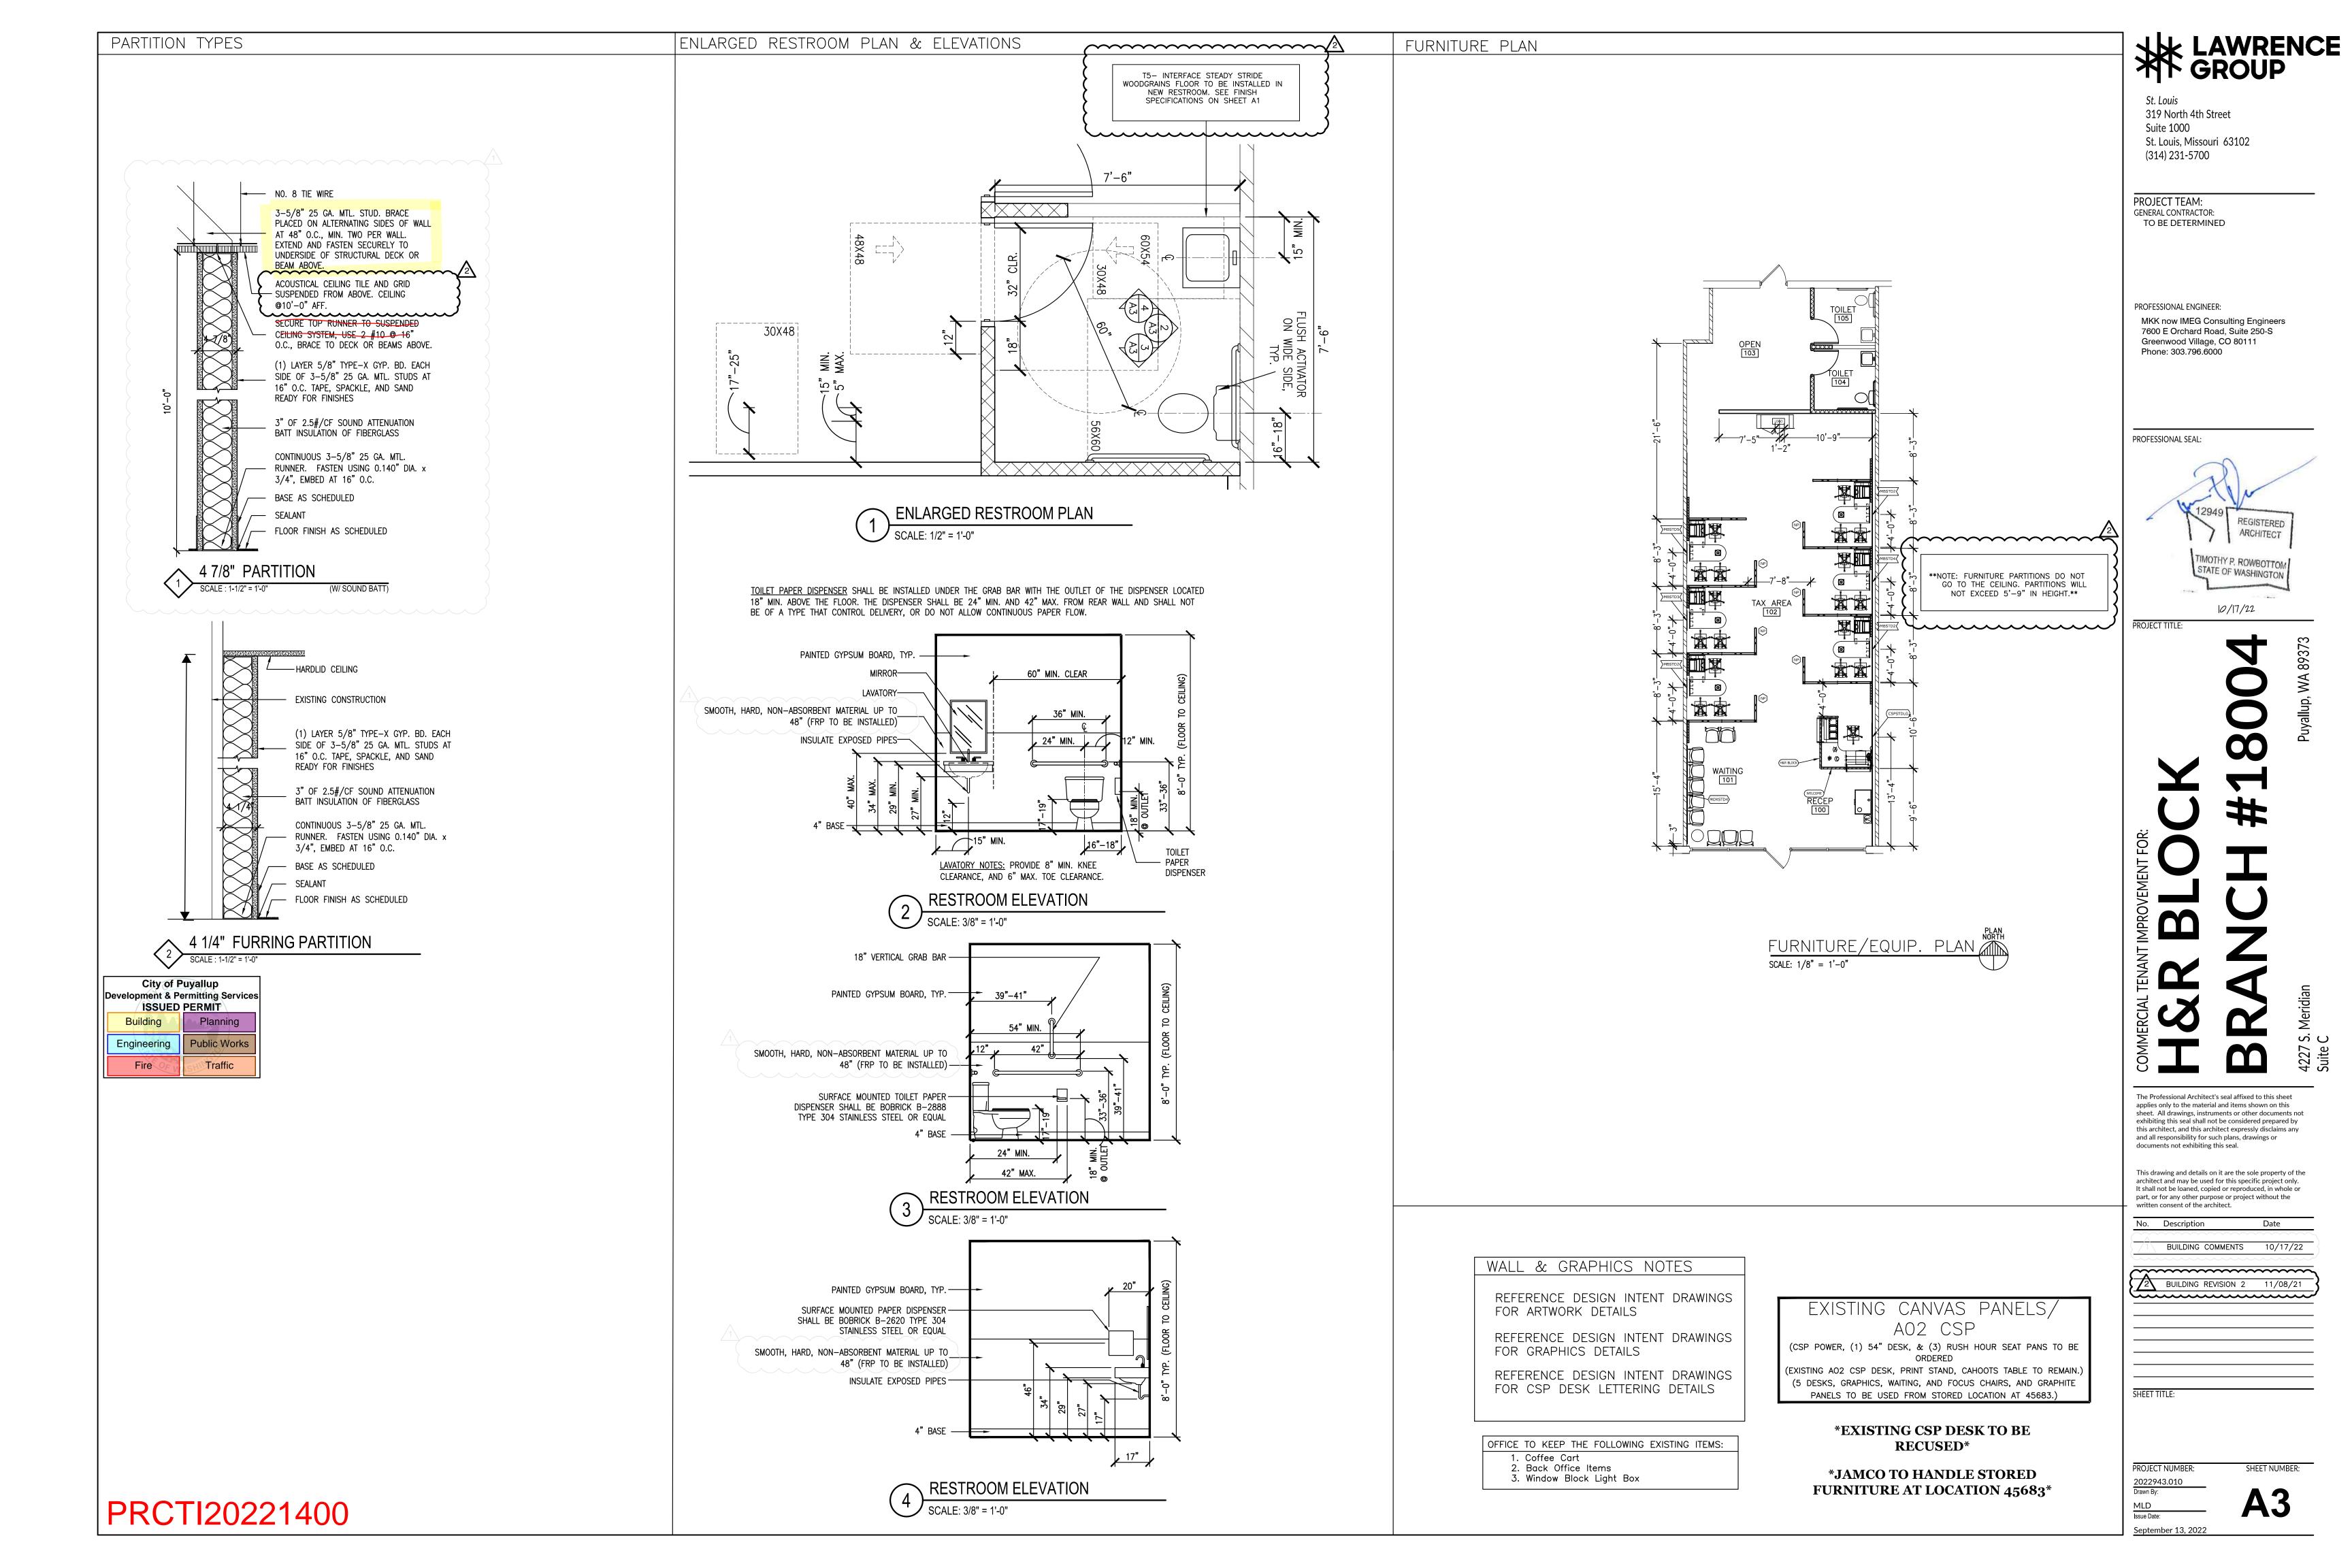

#### DOOR SCHEDULE HARDWARE NO. **ROOM NAME** NOTES **RECEPTION EXIST** НМ 100 НМ GROUP #2 3'-0"X7'-0" **OPEN EXIST** 103 3'-0"X7'-0" HM НМ GROUP #1 GROUP #4 **TOILET** 104 Α 3'-0"X7'-0" WD WD 105 TOILET 3'-0"X7'-0" WD WD GROUP #4 Α

#### REMARKS

- 1. UPGRADE EXISTING DOOR HARDWARE TO BE FULLY ACCESSIBLE AS REQUIRED. 2. HAWORTH ENCLOSE DOOR TO MATCH SLIDING DOORS TO BE EQUIPPED WITH BUTT
- HINGES IN LIEU OF SLIDING SLIDING HARDWARE.

#### HARDWARE GROUPS

GROUP #1: (SINGLE DOOR WITH PASSAGE SET)

- BB1279 4.5X4.5 HAGER 3 HINGES 1 PASSAGE SET ND10S ATHENS 626 SCHLAGE 1 FLOOR MOUNT DOORSTOP **IVES** 441 US26D 64 CHARCOAL **GYLNN JOHNSON** 3 DOOR SILENCERS
- TO MATCH DOORSTOP IVES 1 DOOR CLOSER
- GROUP #2: (GLAZED STOREFRONT ENTRY)
- **MCKINNEY** CONTINUOUS HINGE MCK-12HD, CL, MK 1 DEADLATCH 4900, 628, AD **ADAMS RITE** 1 PADDLE OPERATOR 4591, 628, AD **ADAMS RITE** AS REQUIRED, 626, RJ CORBIN RUSSWIN 1 CYLINDER BF15747, US32D-316, RO ROCKWOOD 1 PUSH/PULL BAR 1 SURFACE CLOSER UNIJ7500 7786, 689, RO ROCKWOOD 1 THRESHOLD 1715AK, PE **PEMKO** 
  - NOTE: SWEEPS & SEALS TO BE MFG'S STANDARD TO MATCH FRAMING SUPPLIED AND INSTALLED BY ALUMINUM DOOR SUPPLIER

#### GROUP #3: (DETEX SET)

- CONTINUOUS HINGE **MCKINNEY** MCK-25HD, CL, MK V40xEB DETEX 1 EXIT DEVICE 1 CYLINDER RIM CYLINDER **BEST LOCKS** NORTON 1 SURFACE CLOSER CPS7500, 689, NO **PEMKO** THRESHOLD 1715AK, PE **PEMKO** 2891AS, PE 1 GASKETING 1 RAIN GUARD 346C, PE **PEMKO** 345ANB. PE **PEMKO** 1 SWEEP
- GROUP #4: (PRIVACY SET)
- 3 HINGES 1 PRIVACY SET 1 FLOOR MOUNT DOORSTOP
- 441 US26D 3 DOOR SILENCERS 64 CHARCOAL 1 DOOR CLOSER TO MATCH DOORSTOP IVES

#### GROUP #5: (SLIDING DOOR WITH PASSAGE SET BY HAWORTH) 1" DIAMETER 30" PULL HANDLE

#### **GROUP #6: (CORRIDOR LOCKSET)**

3 HINGES 1 CORRIDOR LOCKSET

**NO LOCKSET** 

- ND73PD 441 US26D 1 FLOOR MOUNT DOORSTOP 64 CHARCOAL TO MATCH DOORSTOP IVES
- 3 DOOR SILENCERS 1 DOOR CLOSER
- GROUP #7: (BYPASS) 1 BYPASS TRACK SYSTEM

2 ACCESSIBLE DOOR PULLS

1 BYPASS LOCKSET AS REQ'D

- **HAGER** BB1279 4.5X4.5 SCHLAGE ND40S ATHENS 626
  - **IVES GYLNN JOHNSON**

**HAGER** 

**IVES** 

SCHLAGE

GYLNN JOHNSON

B66-650 SERIES; ALL NEW PAINTED DOORS AND/OR DOOR FRAMES TO BE ORDERED PRE-PRIMED. 10. USE KNOCKDOWN METAL DOOR FRAMES.

2 UNITS HORIZONTAL (50-PERCENT SLOPE).

**GENERAL DOOR NOTES** 

TENANT

REQUIREMENTS

EGRESS DIRECTION.

CODE REQUIREMENTS

KNOWLEDGE OR SPECIAL EFFORT

1. CONFIRM DOOR FUNCTION REQUIREMENTS AT ALL SCHEDULED OPENINGS WITH

SPECIAL LOCKING ARRANGEMENTS TO COMPLY WITH APPLICABLE BUILDING CODE

3. HAND-ACTIVATED DOOR OPENING HARDWARE, HANDLES, PULLS, LATCHES, LOCKS

AND OTHER OPERATING DEVICES SHALL HAVE A SHAPE THAT IS EASY TO GRASP

WITH ONE HAND AND DOES NOT REQUIRE TIGHT GRASPING, TIGHT PINCHING OR

TWISTING OF THE WRIST TO OPERATE. HARDWARE SHALL BE CENTERED BETWEEN

30 AND 44 INCHES ABOVE THE FLOOR. LATCHING AND LOCKING DOORS THAT ARE

HAND-ACTIVATED SHALL BE OPERABLE BY LEVER-TYPE HARDWARE, PANIC BARS,

WHICH EGRESS IS TO BE MADE WITHOUT THE USE OF A SPECIAL KEY OR SPECIAL

EQUIPMENT SUCH THAT EMERGENCY MEANS OF EGRESS DOORS EQUIPPED WITH

AUTOMATICALLY RELEASE AND OPEN IN ACCORDANCE WITH APPLICABLE BUILDING

PUSH-PULL ACTIVATING BARS, U-SHAPED HANDLES OR OTHER HARDWARE

DESIGNED TO PROVIDE PASSAGE. LOCKED EXIT DOORS SHALL OPERATE IN

4. ALL MEANS OF EGRESS DOORS SHALL BE READILY OPENABLE FROM THE SIDE

5. SECURITY CONTRACTOR RESPONSIBLE TO CONFIRM AND INSTALL NECESSARY

SPECIAL LOCKING DEVICES SHALL. IN THE EVENT OF AN EMERGENCY.

6. FIELD VERIFY ALL DOOR SIZES PRIOR TO FABRICATION AND INSTALLATION.

8. DOORS SHALL HAVE A MAXIMUM OPENING FORCE OF 5 LBF. THE FLOOR OR

MAGNETIC LOCKS, KEY PAD, PUSH BUTTONS COMBINATION LOCKS OR OTHER

7. ALL DOOR CLOSERS TO BE INSTALLED ON INTERIOR SIDE OF ROOM/SPACE, TYP.

LANDING AT DOORS SHALL NOT BE MORE THAN 1/2 INCH LOWER THAN THE

THRESHOLD OF THE DOORWAY. CHANGE IN LEVEL BETWEEN 1/4 INCH AND 1/2


9. VERIFY FINAL DOOR & FRAME FINISHES WITH TENANT, TYPICAL. WHERE DOORS

INCH SHALL BE BEVELED WITH A SLOPE NO GREATER THAN ONE UNIT VERTICAL IN


AND/OR FRAMES ARE PAINTED. USE SHERWIN WILLIAMS, ACRYLIC, PRO INDUSTRIAL

2. G.C. TO COORDINATE KEYING WITH BUILDING MANAGEMENT AND TENANT. ALL

#### **DOOR TYPES**

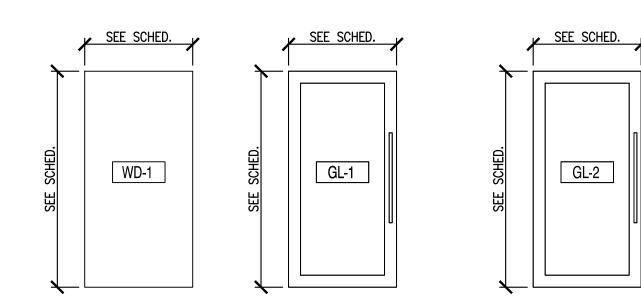

NEW AW-1 PC-5 **GRADE WOOD DOOR** 

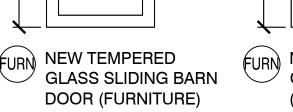

FURN NEW TEMPERED **GLASS SWING DOOR** (FURNITURE)

#### 7600 E Orchard Road, Suite 250-S Greenwood Village, CO 80111 Phone: 303.796.6000

MKK now IMEG Consulting Engineers

PROFESSIONAL ENGINEER

PROFESSIONAL SEAL:

St. Louis

**Suite 1000** 

PROJECT TEAM:

GENERAL CONTRACTOR:


TO BE DETERMINED


319 North 4th Street

(314) 231-5700

St. Louis, Missouri 63102

#### FRAME TYPES

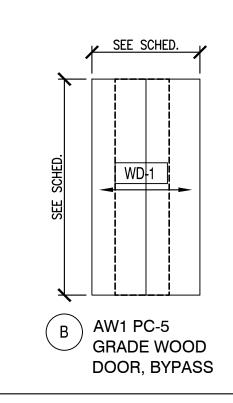

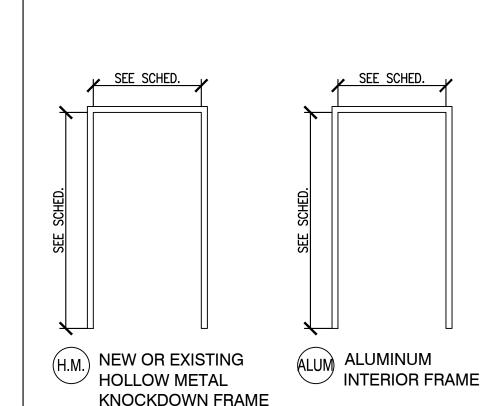

REGISTERED ARCHITECT MOTHY P. ROWBOTTON

10/17/22

STATE OF WASHINGTON

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2 BUILDING REVISION 2 11/08/21

PROJECT NUMBER:

September 13, 2022

RESTROOM SIGNAGE


#### ROOM OR EXIT SIGN SCHEDULE (A) "EXIT" (B) "TO EXIT" (C) "RESTROOM" (D) RESTROOM DOOR MOUNTED SIGNAGE REFERENCE ACCESSIBILITY PLAN FOR LOCATIONS

- RAISED CHARACTERS: RAISED CHARACTERS SHLL BE  $\frac{1}{32}$  INCH MIN ABOVE THEIR BACKGROUND, BE UPPERCASE AND SHALL BE SAN SERIF. CHARACTERS SHALL NOT BE ITALIC, OBLIQUE, SCRIPT, HIGHLY DECORATIVE OR OF OTHER UNUSUAL FORMS. CHARACTER PROPORTIONS SHALL BE SELECTED FROM FONTS WHERE THE WIDTH OF THE UPPERCASE LETTER "O" IS 60% MIN AND 110% MAX OF THE HEIGHT OF THE UPPERCASE LETTER "I". CHARACTER HEIGHT MEASURED VERTICALLY FROM THE BASELINE OF THE CHARACTER SHALL BE & MIN AND 2" MAX BASED ON HEIGHT OF THE UPPER CASE LETTER "I". STROKE THICKNESS OF THE UPPERCASE LETTER "I' SHALL BE 15% MAX OF THE HEIGHT OF THE CHARACTER. CHARACTER SPACING SHALL BE MEASURED BETWEEN THE TWO CLOSEST POINTS OF ADJACENT RAISED CHARACTERS WITHIN A MESSAGE, EXCLUDING WORD SPACES. WHERE CHARACTERS HAVE RECTANGULAR CROSS SECTIONS, SPACING BETWEEN INDIVIDUAL RAISED CHARACTERS SHALL BE 1 MIN AND 4 TIMES THE RAISED CHARACTER STROKE WIDTH MAX. WHERE CHARACTERS HAVE OTHER CROSS SECTIONS, SPACING BETWEEN INDIVIDUAL RAISED CHARACTERS SHALL BE 12" MIN AND 4 TIMES THE RAISED CHARACTER STROKE WIDTH MAX AT THE BASE OF THE CROSS SECTIONS. AND 1" MIN AND 4 TIMES THE RAISED CHARACTER STROKE WIDTH MAX AT THE TOP OF THE CROSS SECTIONS. CHARACTERS SHALL BE SEPARATED FROM RAISED BOARDERS AND DECORATIVE ELEMENTS & MIN. SPACING BETWEEN THE BASELINES OF SEPARATE LINES OF RAISED CHARACTERS WITHIN A MESSAGE SHALL BE 135% MIN AND 170% MAX OF THE RAISED CHARACTER HEIGHT. TEXT SHALL BE HORIZONTAL FORMAT.
- BRAILLE: BRAILLE SHALL BE CONTRACTED (GRADE 2). BRAILLE DOTS SHALL HAVE A DOMED OR ROUNDED SHAPE. REFERENCE TABLE 11B-703.3.1 FOR BRAILLE DIMENSIONS. THE INDICATION OF AN UPPERCASE LETTER OR LETTERS SHALL ONLY BE USED BEFORE THE FIRST WORD OF SENTENCES, PROPER NOUNS AND NAMES, INDIVIDUAL LETTERS OF THE ALPHABET, INITIALS AND ACRONYMS. BRAILLE SHALL BE POSITIONED BELOW THE CORRESPONDING TEXT IN A HORIZONTAL FORMAT, FLUSH LEFT OR CENTERED. IF TEXT IS MULTI-LINED, BRAILLE SHALL BE PLACED BELOW THE ENTIRE TEXT. BRAILLE SHALL BE SEPARATED 3" MIN AND 3" MAX FROM ANY OTHER TACTILE CHARACTERS AND §" MIN FROM RAISED BORDERS AND DECORATIVE ELEMENTS.
- VISUAL CHARACTERS AND THEIR BACKGROUND SHALL HAVE A NON-GLARE FINISH. CHARACTERS SHALL CONTRAST WITH THEIR BACKGROUND WITH EITHER LIGHT CHARACTERS ON A DARK BACKGROUND OR DARK CHARACTERS ON A LIGHT BACKGROUND. CHARACTERS SHALL BE UPPERCASE OR LOWERCASE OR A COMBINATION OF BOTH. CHARACTERS SHALL BE CONVENTIONAL IN FORM. CHARACTERS SHALL NOT BE ITALIC, OBLIQUE, SCRIPT, HIGHLY DECORATIVE OR OF OTHER UNUSUAL FORMS. CHARACTER PROPORTIONS SHALL BE SELECTED FROM FONTS WHERE THE WIDTH OF THE UPPERCASE LETTER "O" IS 60% MIN AND 110% MAX OF THE HEIGHT OF THE UPPERCASE LETTER "I". CHARACTER HEIGHT MEASURED VERTICALLY FROM THE BASELINE OF THE CHARACTER SHALL BE 🖁 MIN AND 2" MAX BASED ON HEIGHT OF THE UPPER CASE LETTER "I". SEE TABLE 11B-703.5.5 FOR MIN CHARACTER HEIGHT. VIEWING DISTANCE SHALL BE MEASURED AS THE HORIZONTAL DISTANCE BETWEEN THE CHARACTER AND AN OBSTRUCTION PREVENTING FURTHER APPROACH TOWARDS THE SIGN. CHARACTER HEIGHT SHALL BE BASED ON HEIGHT OF THE UPPER CASE LETTER "I". VISUAL CHARACTERS SHALL BE 40" MIN ABOVE THE FINISH FLOOR. STROKE THICKNESS OF THE UPPERCASE LETTER "I" SHALL BE 10% MIN AND 20% MAX OF THE HEIGHT OF THE CHARACTER. CHARACTER SPACING SHALL BE MEASURED BETWEEN THE TWO CLOSEST POINTS OF ADJACENT CHARACTERS, EXCLUDING WORD SPACES. SPACING BETWEEN INDIVIDUAL CHARACTERS SHALL BE 10% MIN AND 35% MAX OF CHARACTER HEIGHT. LINE SPACING BETWEEN THE BASELINES OF SEPARATE LINES OF CHARACTERS WITHIN A MESSAGE SHALL BE 135% MIN AND 170% MAX OF THE CHARACTER HEIGHT. TEXT SHALL BE IN A HORIZONTAL FORMAT.

IBC section: 1101.2.6 (ICC A117.1 Section 703.6.3.1) International symbol of


Where the International Symbol of Accessibility is required, it shall be proportioned complying with ICC A117.1 Figure 703.6.3.1. All interior and exterior signs depicting the International Symbol of Accessibility shall be white on a blue background.

 $\cdots$ 

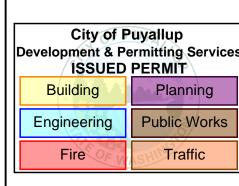


RESTROOM DOOR MOUNTED SIGNAGE: FOR UNI-SEX RESTROOMS, PROVIDE A DOOR MOUNTED RESTROOM SIGN THAT IS A  $\frac{1}{4}$ " THICK, 12" IN DIAMETER CIRCLE WITH A  $\frac{1}{4}$ " THICK TRIANGLE SUPERIMPOSED ON A CIRCLE. THIS SIGN SHALL CONTRAST WITH THE DOOR EITHER LIGHT ON A DARK BACKGROUND OR DARK ON A LIGHT BACKGROUND. NOTE: BRAILLE IS NOT ALLOWED ON DOOR MOUNTED SIGNS FOR SAFETY REASONS.


BB1279 4.5X4.5

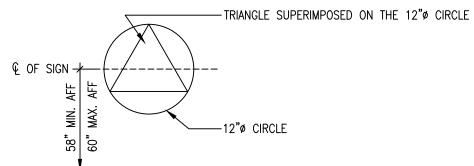


THIS SIGN WITH RAISED CHARACTERS AND GRADE 2 BRAILLE IS REQUIRED FOR PERMANENT ROOMS AND SPACES OF A BUILDING.

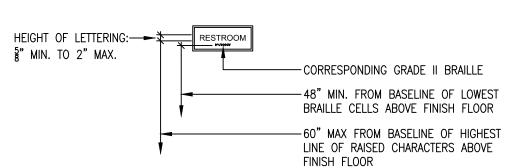

RESTROOM SIGNAGE, INSTALLATION HEIGHT AND LOCATION:

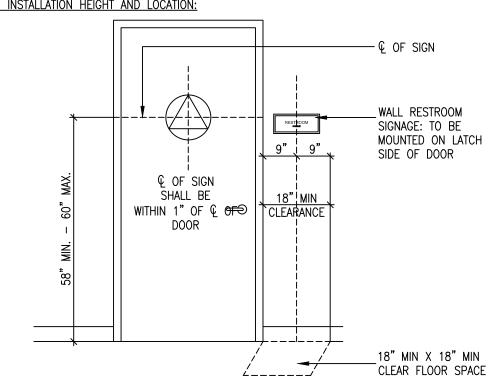



PERMANENT ROOM OR SPACE SIGNAGE, INSTALLATION HEIGHT AND LOCATION:

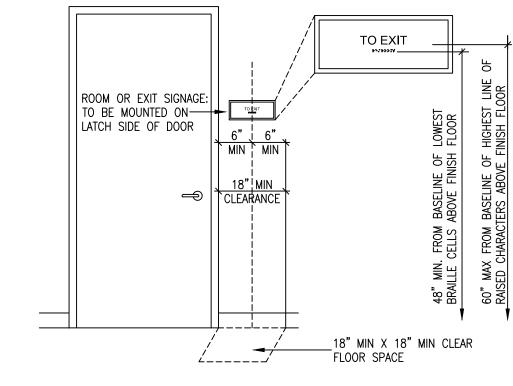



SINGLE SEX WALL SIGN

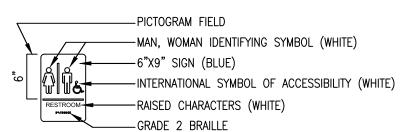

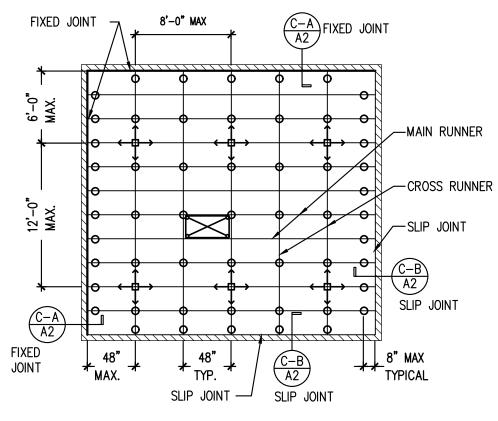

COMPRESSION STRUT AT 8'-0" X 12'-0" O.C. MINIMUM SEE DETAIL 0/A.9

• 12 GA. VERTICAL HANGER WIRE AT 48" O.C. EACH WAY MINIMUM

FIXTURE WITH VERTICAL HANGER WIRE AT EACH CORNER

CONNECTED TO STRUCTURE ABOVE

TYPICAL DIAGRAMMATIC
SUSPENDED CEILING PLAN

SCALE : 1/8" = 1'-0"

B SUSPENDED CEILING PLAN
NO SCALE

3/4" ELEC. CONDUIT FROM ACOUSTICAL

TÎLE CEILING RUNNERS TO BOTTOM

MAIN RUNNERS


CROSS RUNNERS

12 GAUGE SPLAY BRACE

WIRE WITH 4 TIGHT TURNS IN

1 1/2" - TYP. TOP & BOTTOM

OF STRUCTURE — INSTALL PER CODE.

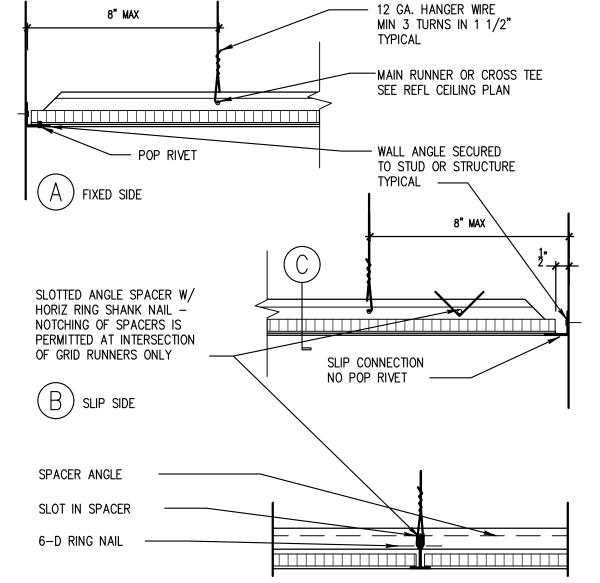

 $/^2$ 

SECTION @ SLIP SIDE

12 GAUGE VERTICAL HANGER

IN 1 1/2" - TYP. TOP & BOTTOM

WIRES @ 4'-0" O.C. EACH
WAY WITH 3 TIGHT TURNS

- 12 GAUGE SPLAY BRACE

TURNS IN 1 1/2" - TYP. TOP & BOTTOM -


8'-0" TO 12'-0" ON CENTER

2" MAX. FROM SPLAY WIRES

TO CROSS RUNNERS

WIRE WITH 4 TIGHT

TYP. CEILING GRID WALL RUNNER
NO SCALE

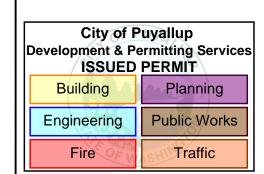

\*\* LAWRENCE GROUP


St. Louis
319 North 4th Street
Suite 1000
St. Louis, Missouri 63102
(314) 231-5700

PROJECT TEAM:
GENERAL CONTRACTOR:
TO BE DETERMINED

PROFESSIONAL ENGINEER:

MKK now IMEG Consulting Engineers
7600 E Orchard Road, Suite 250-S
Greenwood Village, CO 80111
Phone: 303.796.6000

PROFESSIONAL SEAL:

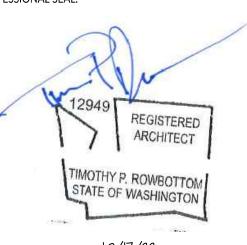

PROJECT TITLE:

RANCH #

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No. Description Date

BUILDING COMMENTS 10/17/22

BUILDING REVISION 2 11/08/21


PROJECT NUMBER: 2022943.010

Drawn By:

MLD

Issue Date:

September 13, 2022

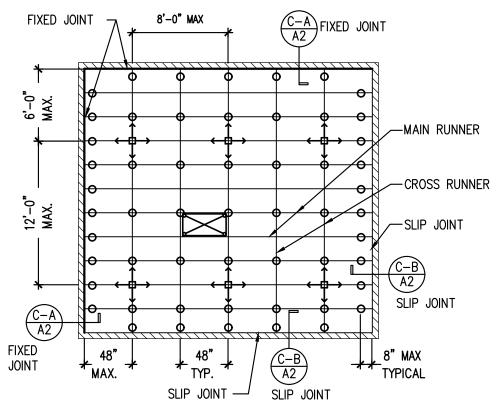

COMPRESSION STRUT AT 8'-0" X 12'-0" O.C. MINIMUM SEE DETAIL 0/A.9

• 12 GA. VERTICAL HANGER WIRE AT 48" O.C. EACH WAY MINIMUM


FIXTURE WITH VERTICAL HANGER WIRE AT EACH CORNER

CONNECTED TO STRUCTURE ABOVE


TYPICAL DIAGRAMMATIC
SUSPENDED CEILING PLAN

SCALE : 1/8" = 1'-0"

- (B)

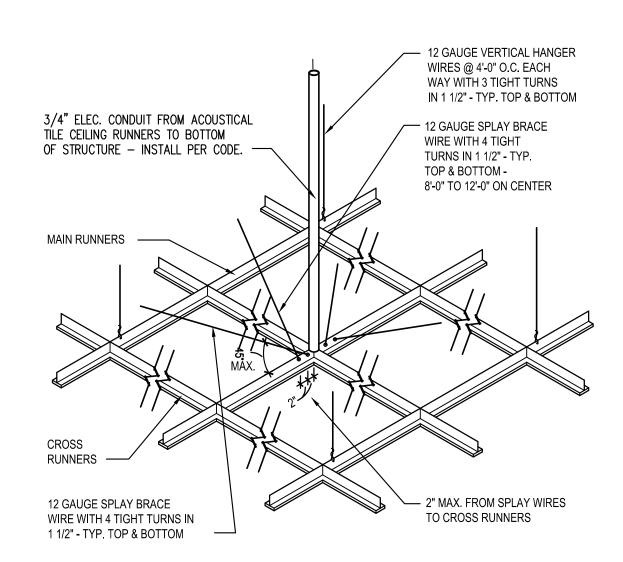

B SUSPENDED CEILING PLAN NO SCALE

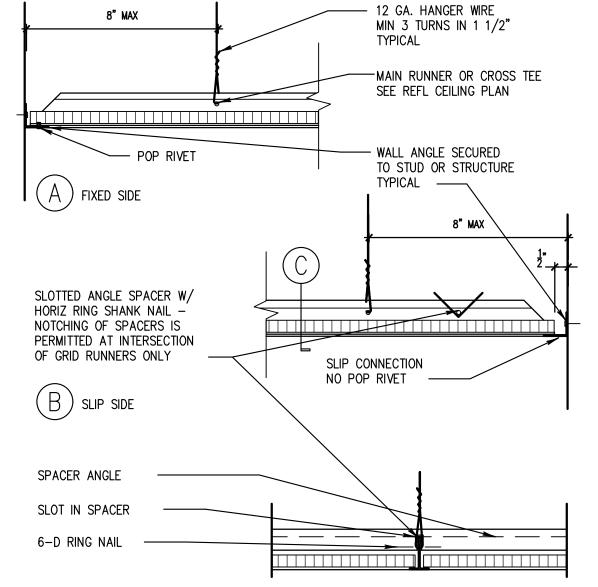

 $/^2$ 

SECTION @ SLIP SIDE

TYP. CEILING GRID WALL RUNNER
NO SCALE

City of Puyallup
Development & Permitting Services
ISSUED PERMIT

Building Planning

Engineering Public Works

Fire Traffic

LAWRENCE GROUP


St. Louis
319 North 4th Street
Suite 1000
St. Louis, Missouri 63102
(314) 231-5700

PROJECT TEAM:
GENERAL CONTRACTOR:
TO BE DETERMINED

PROFESSIONAL ENGINEER:

MKK now IMEG Consulting Engineers
7600 E Orchard Road, Suite 250-S
Greenwood Village, CO 80111
Phone: 303.796.6000

PROFESSIONAL SEAL:

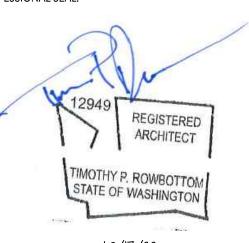

PROJECT TITLE:

イント 4 #18004

ARK BLO

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No. Description Date

BUILDING COMMENTS 10/17/22

BUILDING COMMENTS 10/17/22

2 BUILDING REVISION 2 11/08/21

SHEET TITLE:


PROJECT NUMBER:
2022943.010
Drawn By:

Drawn By:

MLD

Issue Date:

September 13, 2022

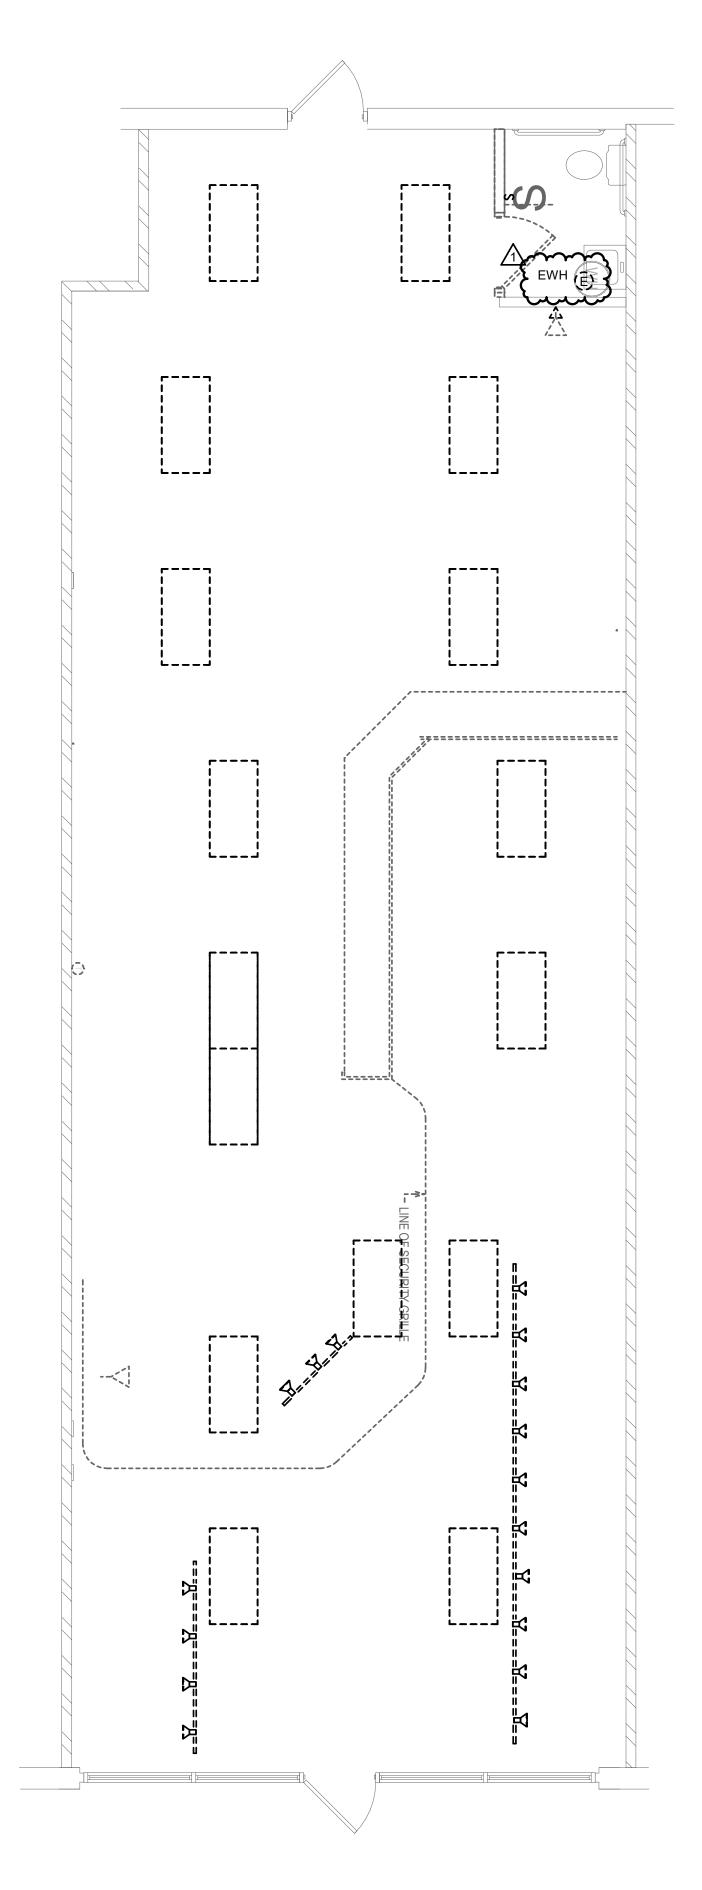

#### **GENERAL NOTES (DEMOLITION):**

- A. FOR DEVICES NOTED IN HEAVY LINE WEIGHT, REMOVE EXISTING DEVICE, CONDUIT AND ASSOCIATED WIRING BACK TO POINT OF ORIGIN, UNLESS OTHERWISE NOTED. RETAIN CIRCUIT CONTINUITY FOR REMAINING DEVICES IF REQUIRED. PATCH WALL AND FINISH TO MATCH NEW/EXISTING WALL SURFACE.
- B. DISCONNECT AND REMOVE ALL DEVICES AND ASSOCIATED CONDUIT AND CONDUCTORS FOR ALL ELECTRICAL DEVICES ON WALLS SCHEDULED TO BE REMOVED. RETAIN CIRCUIT CONTINUITY FOR REMAINING DEVICES IF REQUIRED. PATCH WALL AND FINISH TO MATCH NEW/EXISTING WALL SURFACE.
- C. DISCONNECT AND REMOVE EXISTING LIGHTING UNLESS OTHERWISE NOTED AS EXISTING TO REMAIN. SAVE AND PROTECT EXISTING CONDUIT AND CONDUCTORS FOR CONNECTION TO NEW OR RELOCATED LUMINAIRES. FIXTURES NOTED WITH AN "R" ARE TO BE RELOCATED. REFER TO NEW LIGHTING PLAN FOR ADDITIONAL INFORMATION.

KEYNOTES #



St. Louis 319 North 4th Street Suite 1000 St. Louis, Missouri 63102 (314) 231-5700


PROJECT TEAM: GENERAL CONTRACTOR: BHR BUILDERS LLC Contact: Donna Barboza (Mitchell) Phone: 936-433-9192

PROFESSIONAL ENGINEER:



IMEG Corp 7600 E Orchard Road, Suite 250-S Greenwood Village, CO 80111 Phone: 303.796.6000 IMEG Project No.: 22001727.36

PROFESSIONAL SEAL:

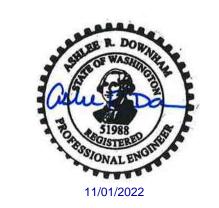

PROJECT TITLE:

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| No | Description       | Date           |
|----|-------------------|----------------|
| 1  | BUILDING COMMENTS | 10/17/20<br>22 |
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SHEET TITLE:

ELECTRICAL **DEMOLITION PLAN** 

PROJECT NUMBER: SHEET NUMBER: 2022924.005 Drawn By:

ARD
Issue Date:

AUGUST 19, 2022

PRCTI20221400

City of Puyallup **Development & Permitting Services** ISSUED PERMIT


Planning

Public Works

Traffic

Building

Engineering

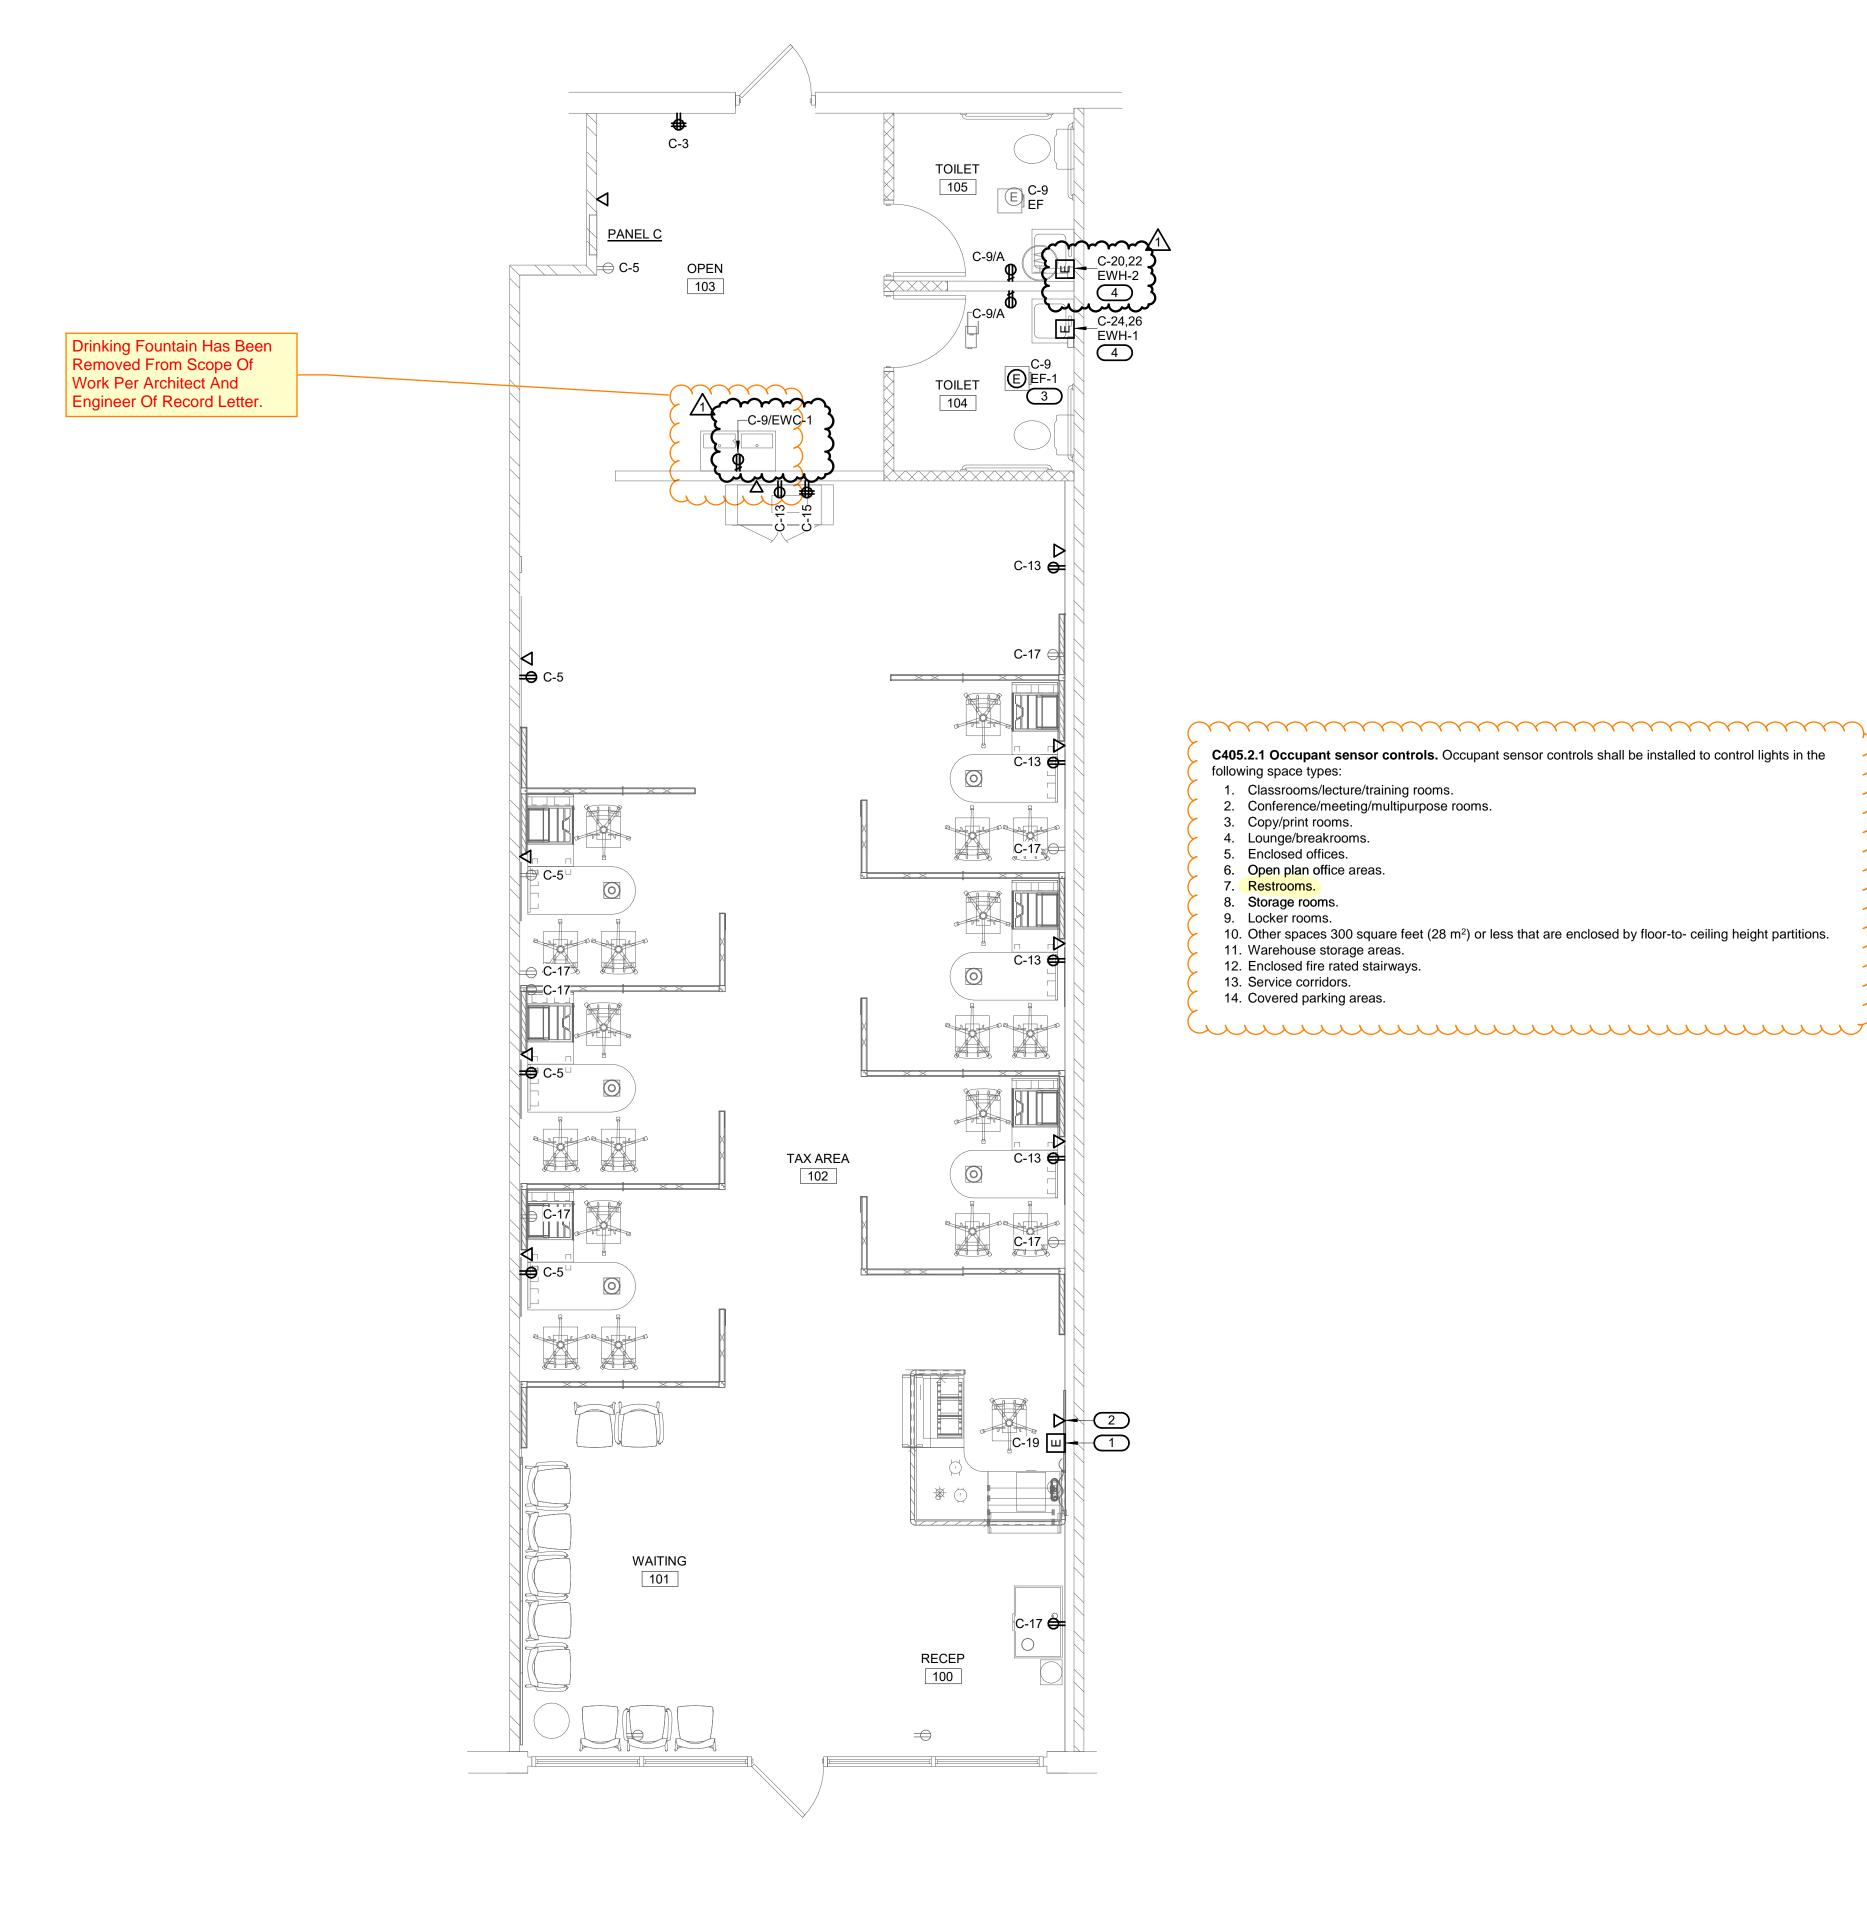

#### **GENERAL NOTES (POWER):**

- B. DEVICES SHOWN IN LIGHT LINE WEIGHT ARE EXISTING TO REMAIN. DEVICES SHOWN IN
- D. THE INFORMATION ON THESE DRAWINGS HAS BEEN ASCERTAINED FROM EXISTING DRAWINGS AND FIELD OBSERVATIONS. THIS INFORMATION IS AS ACCURATE AS REQUIRED TO ACHIEVE THE END RESULT AS INDICATED BY THE CONTRACT DOCUMENTS.
- E. RECIRCUIT EXISTING DEVICES TO NEW CIRCUIT AS INDICATED.

#### KEYNOTES #

- SUPPLYING POWER TO THE PORTABLE PARTITIONS SHALL BE SIMULTANEOUSLY DISCONNECTED AT THE ELECTRICAL PANELBOARD WHERE THE BRANCH CIRCUITS ORIGINATE PER N.E.C., ARTICLE 605 REQUIREMENTS. THE CIRCUITS SHALL BE DISCONNECT BY BREAKER HANDLE TIES OR AS DIRECTED BY LOCAL JURISDICTION. VERIFY AND ENSURE EXACT METHOD OF SIMULTANEOUSLY DISCONNECTING WITH LOCAL JURISDICTION FIELD INSPECTOR PRIOR TO CONNECTION OF PORTABLE PARTITIONS. COORDINATE EXACT LOCATION OF SERVICE AND CONNECTIONS TO FURNITURE PANEL WITH PARTITION INSTALLER AS REQUIRED. FINAL CONNECTION TO PARTITIONS SHALL BE BY THE ELECTRICAL CONTRACTOR. ALL WIRING FROM ELECTRICAL PANEL TO POWER WHIP CONNECTION SHALL BE #12 WIRING IN 3/4" CONDUIT.
- BREAKER TO THE CIRCUIT SERVING WATER HEATER. CONNECT AS REQUIRED AND COORDINATE EXACT LOCATION AND REQUIREMENTS WITH PLUMBING CONTRACTOR PRIOR TO ROUGH-IN. CONNECT WITH #10 WIRES.

- A. REFER TO ARCHITECTURAL PLANS FOR ADDITIONAL INFORMATION INCLUDING SPECIFIC LOCATIONS AND REQUIREMENTS FOR DEVICES.
- HEAVY LINE WEIGHT ARE NEW.
- C. REVIEW ENGINEERING DOCUMENTS IN CONJUNCTION WITH ARCHITECTURAL PLANS AND COORDINATE WORK TO INCLUDE REQUIREMENTS OF BOTH DISCIPLINES.
- CONDITIONS WOULD ALLOW. IT IS THE RESPONSIBILITY OF THE CONTRACTOR TO VISIT THE SITE, PRIOR TO BID, AND BECOME FAMILIAR WITH THE EXTENT OF THE WORK REQUIRED. NO EXTRAS WILL BE ALLOWED FOR ALTERATIONS OF A FORESEEABLE NATURE THAT ARE

- 1 PROVIDE CONNECTION TO MODULAR PARTITIONS. THE MULTIWIRE BRANCH CIRCUITS
- 2 MODULAR PARTITIONS TELEPHONE/DATA SERVICE POINTS. ELECTRICAL CONTRACTOR SHALL INSTALL JUNCTION BOX AND CONDUIT WITH PULL WIRE FOR CABLING INSTALLATION. ALL CABLING INSTALLATION AND TERMINATIONS SHALL BE BY TENANT COMMUNICATIONS CONTRACTOR. REFER TO BUILDING SPECIFICATION NOTES FOR ADDITIONAL INFORMATION. COORDINATE ALL REQUIREMENTS AND SERVICE POINTS WITH COMMUNICATIONS CONTRACTOR PRIOR TO ROUGH-IN.
- 3 EXHAUST FAN EF-1: 13W, 120V, 1PH. THE FAN IS PROVIDED AND INSTALLED BY MECHANICAL CONTRACTOR, WIRED BY ELECTRICAL CONTRACTOR. PROVIDE DISCONNECTING MEANS AS REQUIRED PER N.E.C. EXHAUST FAN SHALL BE CONTROLLED BY LIGHT SWITCH SERVING THIS ROOM.
- 4 ELECTRIC WATER HEATER EWH-1: 4100W, 208V, 1PH. PROVIDE A LOCK OFF TYPE CIRCUIT

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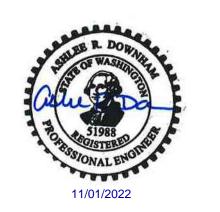
PROJECT TEAM: GENERAL CONTRACTOR: BHR BUILDERS LLC Contact: Donna Barboza (Mitchell) Phone: 936-433-9192

PROFESSIONAL ENGINEER:



IMEG Corp 7600 E Orchard Road, Suite 250-S Greenwood Village, CO 80111 Phone: 303.796.6000 IMEG Project No.: 22001727.36

PROFESSIONAL SEAL:



PROJECT TITLE:

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| No | Description       | Date           |
|----|-------------------|----------------|
| 1  | BUILDING COMMENTS | 10/17/20<br>22 |
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SHEET TITLE:

POWER AND SYSTEMS PLAN

PROJECT NUMBER: SHEET NUMBER: 2022924.005 Drawn By:

ARD
Issue Date: AUGUST 19, 2022

PRCTI20221400

City of Puyallup Development & Permitting Services **ISSUED PERMIT** 

Planning

Public Works

Traffic


Building

Engineering

Fire

POWER AND SYSTEMS PLAN


1/4" = 1'-0"

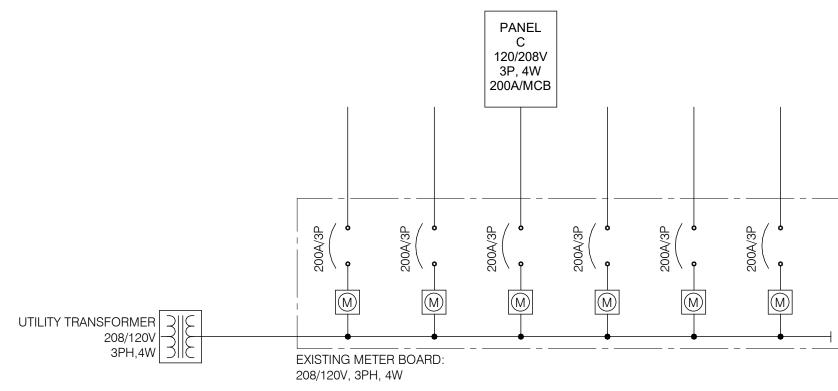


## 1 ELECTRICAL ONE-LINE DIAGRAM NO SCALE

#### **GENERAL NOTES (ONE-LINE):**

- A. LIGHT LINE WEIGHT INDICATES EXISTING WORK TO REMAIN. HEAVY LINE WEIGHT INDICATES NEW. NO NEW WORK REQUIRED IN THIS SCOPE OF WORK
- B. ELECTRICAL CONTRACTOR SHALL FIELD CONFIRM EXISTING ONE-LINE DIAGRAM. IF DISCREPANCIES EXIST, NOTIFY ENGINEER IMMEDIATELY.
- C. CONTRACTOR SHALL PERFORM FIELD TESTING REQUIRED IN SECTION 260519, 3.04 FOR ALL EXISTING METER BOARD AND PANEL CONNECTIONS AND PANEL FEEDERS.

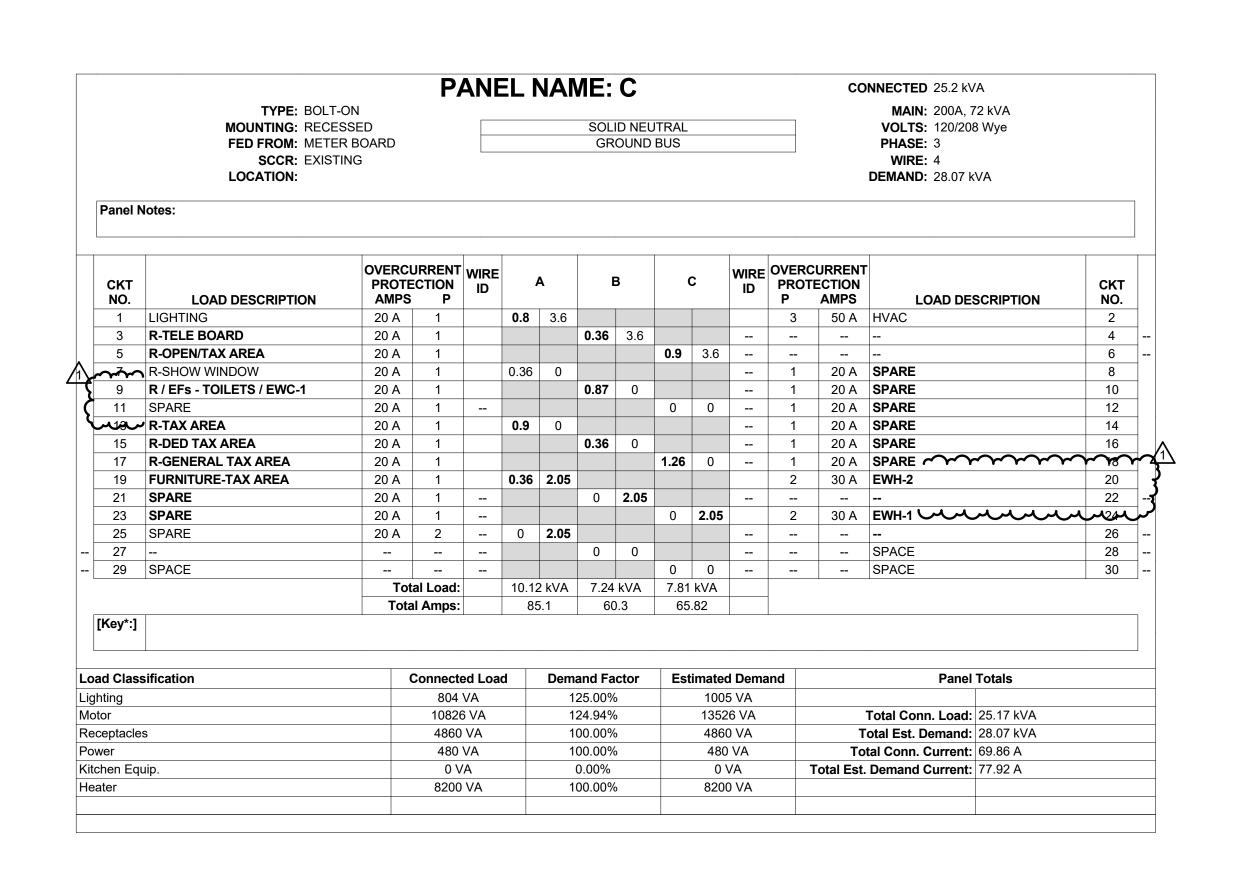

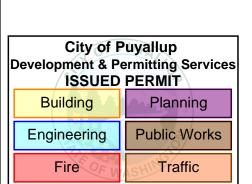

\*\*\* LAWRENCE GROUP

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St. Louis, Missouri 63102
(314) 231-5700


PROJECT TEAM:
GENERAL CONTRACTOR:
BHR BUILDERS LLC
Contact: Donna Barboza (Mitchell)
Phone: 936-433-9192

PROFESSIONAL ENGINEER:



IMEG Corp 7600 E Orchard Road, Suite 250-S Greenwood Village, CO 80111 Phone: 303.796.6000 IMEG Project No.: 22001727.36

PROFESSIONAL SEAL:

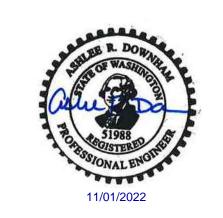

PROJECT TITLE:

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documents not exhibiting this seal.

| No | Description       | Date           |  |  |  |
|----|-------------------|----------------|--|--|--|
| 1  | BUILDING COMMENTS | 10/17/20<br>22 |  |  |  |
|    |                   |                |  |  |  |
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SHEET TITLE:

ELECTRICAL

ONE-LINE AND PANEL


SCHEDULE


PROJECT NUMBER: SHEET NUMBER:


2022924.005
Drawn By:

ARD
Issue Date:
AUGUST 19, 2022

PRCTI20221400

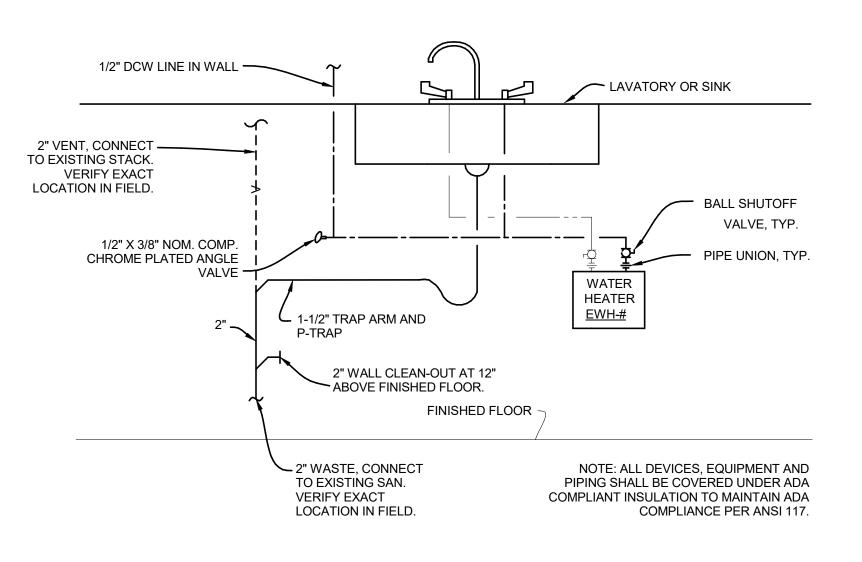

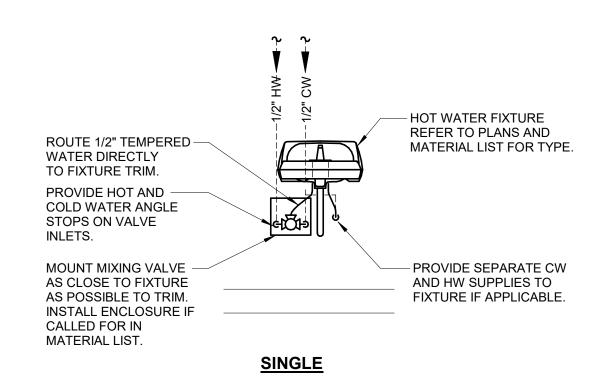


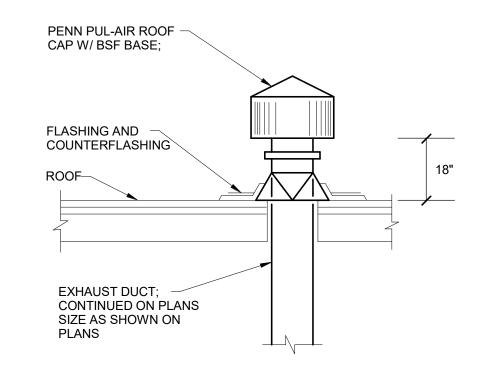





LAVATORY MIXING VALVE DETAIL

3 EXHAUST ROOF CAP DETAIL
NO SCALE

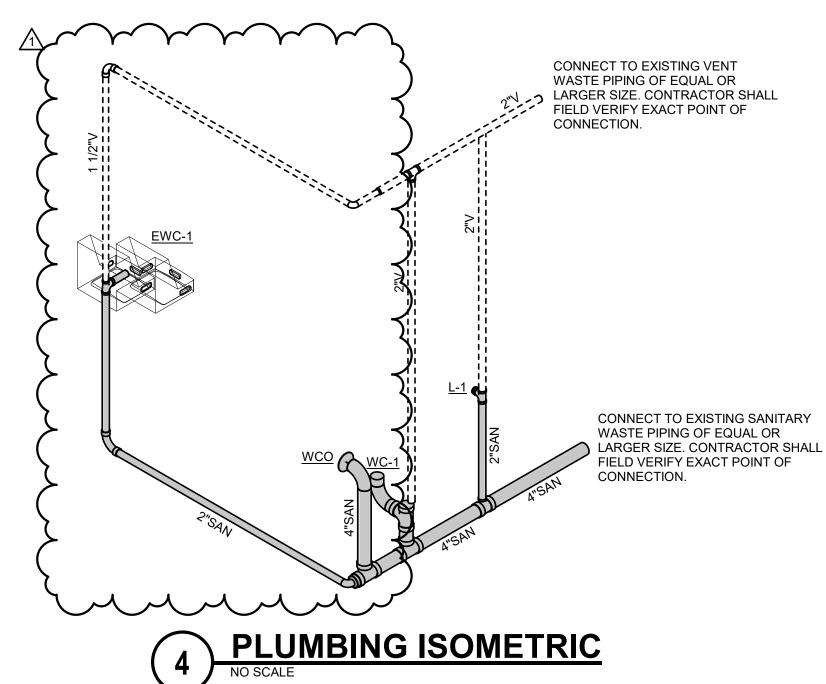

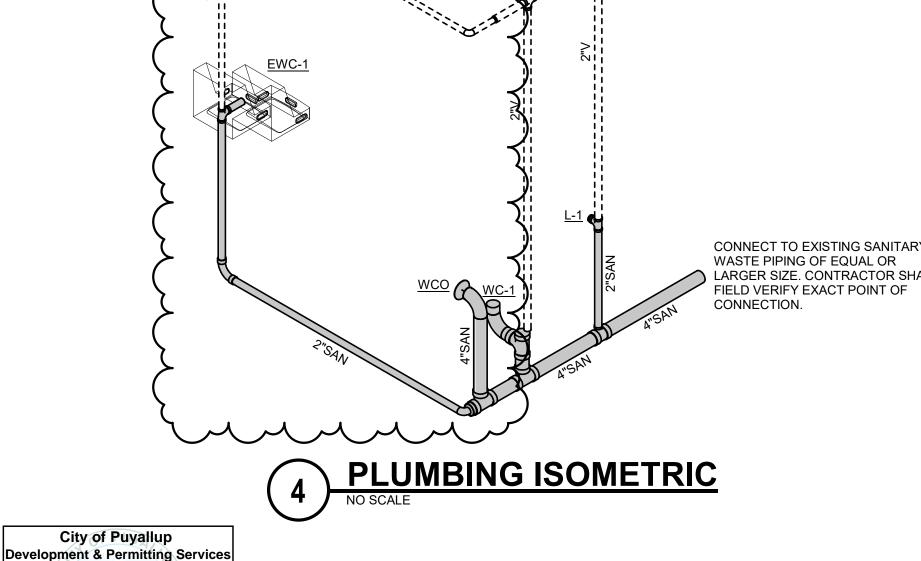

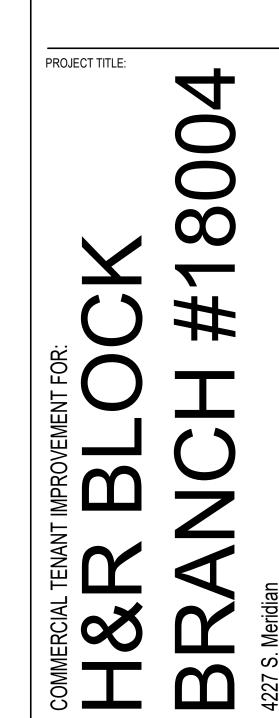

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Date

10/17/20

documents not exhibiting this seal.

1 BUILDING COMMENTS

No Description

SHEET TITLE:

AUGUST 19, 2022

St. Louis

Suite 1000

PROJECT TEAM:

GENERAL CONTRACTOR:

BHR BUILDERS LLC

Phone: 936-433-9192

PROFESSIONAL ENGINEER:

IMEG Corp

PROFESSIONAL SEAL:

Contact: Donna Barboza (Mitchell)

7600 E Orchard Road, Suite 250-S

EXP.04.22.2024

Greenwood Village, CO 80111

IMEG Project No.: 22001727.36

Phone: 303.796.6000

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319 North 4th Street

St. Louis, Missouri 63102

PRCTI20221400

ISSUED PERMIT

Planning

Public Works

Traffic

Building

Engineering

PROJECT NUMBER: SHEET NUMBER: 2022924.005 Drawn By: ABN Issue Date:

MECHANICAL AND

PLUMBING DETAILS

|            |          | SERVICE          | EXPO         | OSED         | CONCI        | EALED        |                 |                |
|------------|----------|------------------|--------------|--------------|--------------|--------------|-----------------|----------------|
| SYSTEM     | LOCATION | NOTE 1           | RECTANGULAR  | ROUND / OVAL | RECTANGULAR  | ROUND / OVAL | MINIMUM R-VALUE | SPECIFIC NOTES |
|            |          | MAIN             | 1-1/2" LINER | 1-1/2" LINER | 1-1/2" LINER | 1-1/2" LINER | R-6             |                |
| SUPPLY AIR | INDOOR   | MAIN TO TERMINAL | 1-1/2" LINER |              | 1-1/2" LINER | 2" WRAP      | R-6             |                |
|            |          | TERMINAL TO GRD  | 1-1/2" LINER |              | 1-1/2" LINER | 2" WRAP      | R-6             |                |
| RETURN AIR | INDOOD   | MAIN             | 1" LINER     | 1" LINER     | 1" LINER     | 1" LINER     | R-4             |                |
| ETURN AIR  | INDOOR   | BRANCH           | 1" LINER     |              | 1" LINER     | 1-1/2" WRAP  | R-4             |                |

#### **GENERAL NOTES:**

1) MINIMUM R-VALUE BASED ON 2015 IECC REQUIREMENTS.

2) DUCT SIZES SHOWN ARE INSIDE CLEAR DIMENSIONS. LINER, WHERE USED, WILL NEED TO BE FACTORED INTO THE DUCT SIZE.

3) THE INSULATION THICKNESS GIVEN MEETS OR EXCEEDS THE REQUIRED R-VALUE FOR THE BASIS OF DESIGN (JOHNS MANVILLE). INSTALLED PRODUCT SHALL MEET OR EXCEED THE LISTED R-VALUE; INSULATION THICKNESS AND CORRESPONDING DUCT SIZE (FOR LINER) SHALL BE INCREASED FOR ALTERNATES THAT

CANNOT MEET THIS THICKNESS TO PERFORMANCE CONDITION.

4) R-VALUES FOR WRAP SHALL BE SHOWN USING THEIR INSTALLED CONDITION RATING AS NOTED ON THE MANUFACTURER'S SPECIFICATION SHEET.

5) JACKET (PVC OR METAL) SHALL BE INSTALLED AS REQUIRED BY THE SPECIFICATIONS.

6) FLEXIBLE DUCT SHALL BE AS NOTED IN THE "AIR DUCT ACCESSORIES" SPECIFICATION.

7) DUCT WRAP IS ALLOWED TO BE BLANKET OR BOARD; CONTRACTOR OPTION.

8) MULTIPLE LAYERS OF WRAP OR LINER TO ACHIEVE TOTAL R-VALUE ARE ACCEPTABLE IF INSTALLED PER MANUFACTURER'S INSTRUCTIONS.

**DEFINITIONS**:

EXPOSED DUCT: DUCT THAT IS EXPOSED TO VIEW IN OCCUPIED OR UNOCCUPIED SPACES THAT ARE CONDITIONED.

CONCEALED DUCT: DUCT THAT IS CONCEALED IN CHASES, SHAFTS, CEILING PLENUMS OR OTHER ASSEMBLY WITHIN THE INSULATED BUILDING ENVELOPE.

MAIN DUCT: DUCT FROM THE AIR HANDLING UNIT TO FINAL TERMINAL TAKEOFF.

MAIN TO TERMINAL DUCT: THIS IS A BRANCH DUCT; TYPICALLY THE DUCT FROM THE MAIN TAKEOFF TO THE TERMINAL (VAV BOX OR EQUIVALENT).


TERMINAL TO GRD DUCT: THIS IS A BRANCH DUCT DOWNSTREAM OF THE TERMINAL (VAV BOX, HEAT PUMP, FAN COIL OR EQUIVALENT).

OUTSIDE AIR TEMPERED: TEMPERED OUTSIDE AIR IS AIR THAT IS HEATED OR COOLED TO WITHIN 10 DEG F OF THE SPACE/SURROUNDING TEMPERATURE.

INDOOR: DUCT LOCATIONS WITHIN THE INSULATED BUILDING ENVELOPE.

|        | FAN SCHEDULE                                                                                                           |            |     |     |        |       |    |     |         |  |       |                  |       |          |
|--------|------------------------------------------------------------------------------------------------------------------------|------------|-----|-----|--------|-------|----|-----|---------|--|-------|------------------|-------|----------|
| ITEM   | TYPE                                                                                                                   | AREA       | CFM | ESP | DRIVE  | SONES |    | МОТ | OR DATA |  | OP WT | MANUFACTURER     | NOTES | CONTROLS |
|        | SERVED INWC TYPE W RPM V-PH STRTR LBS & MODEL NO.                                                                      |            |     |     |        |       |    |     |         |  |       |                  |       |          |
| EF-1   | CEILING                                                                                                                | TOILET 104 | 75  | 0.3 | DIRECT | 0.5   | 13 | 900 | 115-1   |  | 20    | GREENHECK SP-A90 | 1, 2  | SWITCH   |
| NOTES: | NOTES: 1. PROVIDE INTEGRAL DISCONNECT SWITCH, BACKDRAFT DAMPER, VIBRATION ISOLATORS AND FLEXIBLE CONNECTION ON OUTLET. |            |     |     |        |       |    |     |         |  |       |                  |       |          |

2. FAN SHALL BE CONTROLLED FROM LIGHT SWITCH IN RESTROOM.

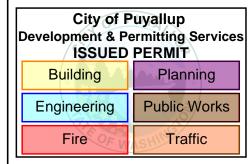

|       | PLUMBING FIXTURE AND EQUIPMENT SCHEDULE |                                                 |                                        |             |       |              |          |        |          |      |       |        |        |             |                                  |
|-------|-----------------------------------------|-------------------------------------------------|----------------------------------------|-------------|-------|--------------|----------|--------|----------|------|-------|--------|--------|-------------|----------------------------------|
| PLAN  | FIXTURE                                 | ICC/ANSI A117.1                                 | MANUFACTURER                           | SERIES      | TRIM  | SERIES       | SUPPLIES | TRAP / | DRAIN    | CW   | HW /  | WASTE  | VENT   | WATER       | NOTES / REMARKS                  |
| CODE  |                                         | COMPLIANT#                                      | \\\\\\\\\\\\\\\\\\\\\\\\\\\\\\\\\\\\\\ |             | ~~~   | ~~~          |          | WASTE  | $\sim$   |      | TEPHO | ~~     |        | CONSUMPTION |                                  |
| EWC-1 | ELECTRIC WATER COOLER  BI-LEVEL, WM     | YES - ANSI A117.1<br>ed from scope<br>COMPLIANT | HALSEY<br>Of WORK<br>TAYLOR            | HAC8BLSS-NF |       |              | W/STOP   | P-TRAP | INTEGRAL | 1/2" |       | 1 1/2" | 1 1/2" |             | 3, ELECT: 120/1v, 4 FLA, PLUG-IN |
|       | MANNOR                                  | MES ANDVATED                                    | AMERICAN SID.                          | 0355012     | DELTA | A9TLA HGMHDA | WISTOPS  | OFFSEL |          | لير  | 172   | 11/2   | 1/2    | M. GPM      |                                  |
|       | CHINA, WM                               | COMPLIANT                                       |                                        |             |       |              |          | P-TRAP |          |      |       |        |        |             | 4" CENTER SET                    |
| WC-1  | WATER CLOSET                            | YES - ANSI A117.1                               | AMERICAN STD.                          | 2467.100    |       |              | W/STOPS  |        |          | 1/2" |       | 4"     | 2"     | 1.1 GAL     | W/OPEN FRONT NO LID SEAT         |
|       | FM, PA TANK                             | COMPLIANT                                       |                                        |             |       |              |          |        |          |      |       |        |        | PER FLUSH   | WaterSense LISTED                |
| WCO   | WALL CLEANOUT                           |                                                 | J.R. SMITH                             | 4532S       |       |              |          |        |          |      |       | SEE    |        |             |                                  |
|       |                                         |                                                 | ZURN                                   | Z1466       |       |              |          |        |          |      |       | PLANS  |        |             |                                  |
| WMV-1 | THERMAL MIXING                          |                                                 | WATTS                                  | LFUSG-B     |       |              |          |        |          | 3/8" | 3/8"  |        |        |             | INSTALL DOWNSTREAM OF            |
|       | VALVE, FIXTURE                          |                                                 | ZURN                                   | ZW3870XLT   |       |              |          |        |          |      |       |        |        |             | FIXTURE STOPS                    |
|       | ,                                       |                                                 | 1                                      | 1           | 1     | 1            | 1        | 1      | 1        | 1    |       | 1      |        |             | ,                                |

CH = CHILD HEIGHT, CM = CEILING MOUNTED, CP = CHROME PLATED, CT = COUNTERTOP, FM = FLOOR MOUNTED, FV = FLUSH VALVE, PA = PRESSURE ASSIST, SS = STAINLESS STEEL,

TP = PROVIDE TRAP PRIMER (TP-1) ADJACENT TO FIXTURE, WM = WALL MOUNTED (PROVIDE WITH A FLOOR MOUNTED CONCEALED CARRIER), UCT = UNDER COUNTERTOP

#### GENERAL NOTES:

LEGEND:

1. WHERE FIXTURE/EQUIPMENT MODEL NUMBERS ARE GIVEN THESE ARE FOR REFERENCE ONLY. WRITTEN

SPECIFICATION REQUIREMENTS AND SCHEDULE NOTES HOLD PRESIDENCE. THE MORE STRIGENT SHALL APPLY.

2. SEE ARCHITECTURAL DWGS FOR MOUNTING HEIGHTS ON ALL WALL MOUNTED FIXTURES/EQUIPMENT,
ARCHITECTURAL DRAWINGS TAKE PRECEDENCE OVER ANY VALUES WITHIN THIS SCHEDULE.

3. THE MINIMUM WASTE/VENT PIPE SIZE FOR BURIED PIPE SHALL BE 2".

4. ALL ACCESIBLE FIXTURES SHALL COMPLY WITH ICC/ANSI A117.1 (ADA), REFERENCE ARCH DWGS FOR SPECIFIC LOCATIONS. SEE NOTES.

5. ALL FIXTURES AND EQUIPMENT SHALL BE INSTALLED PER THE MANUFACTURER'S WRITTEN INSTALLATION INSTRUCTIONS.

#### SPECIFIC NOTES:


1. AUTOMATIC-TYPE ELECTRONIC SENSOR TRIM, BATTERY POWERED.

2 PROVIDE WITH ASSET 1070 RATED THERMAL MIXING VALVE (WMV-1) COCATED DOWNSTREM OF PIXTURE STOPS LINCESS SERVED FROM AN ASSE 1070 RATED GROUP-FIXTURE THERMAL MIXING VALVE

COOLING CAPACITY: 7.5 GPH COOLED TO 50°F AT AN AMBIENT AIR TEMPERATURE OF 90°F AND ENTERING WATER TEMPERATURE OF 80°F.

| SYSTEM                                             | INSULATION TYPE                                                                                                                                                                                  | FLUID TEMPERATURE RANGE     |        | <1"   1" to 1-1/4"   1-1/2" to 3"   4" to 6"   8" a |        |        | SPECIFIC NOTI |  |
|----------------------------------------------------|--------------------------------------------------------------------------------------------------------------------------------------------------------------------------------------------------|-----------------------------|--------|-----------------------------------------------------|--------|--------|---------------|--|
| DOMESTIC COLD WATER                                |                                                                                                                                                                                                  | 1/2"                        | 1/2"   | 1"                                                  | 1"     | 1"     | 1             |  |
| CAMECTIC LICT WATER AND DOMESTIC LICT WATER DECIDO | OLACO FIDER OR MINERAL FIDER PREFORMED DIDE INCLILATION                                                                                                                                          | 141 TO 200 DEG F            | 1-1/2" | 1-1/2"                                              | 2"     | 2"     | 2"            |  |
| OMESTIC HOT WATER AND DOMESTIC HOT WATER RECIRC    | GLASS FIBER OR MINERAL FIBER PREFORMED PIPE INSULATION                                                                                                                                           | < 140 DEG F                 | 1"     | 1"                                                  | 1-1/2" | 1-1/2" | 1-1/2"        |  |
|                                                    | 1) FOR PIPING EXPOSED TO THE OUTSIDE AMBIENT CONDITIONS OR PIPING 2) FOR PIPING EXPOSED TO THE OUTSIDE AMBIENT CONDITIONS PROVID 3) ALL INSULATION EXPOSED TO UV CONDITIONS SHALL BE PROTECTED I | E PROTECTIVE JACKET (SEE SP | ECIFIC | CATIONS).                                           |        |        |               |  |
|                                                    | 4) MINIMUM THERMAL CONDUCTIVITY "k" VALUE FOR FLEXIBLE ELASTOME 5) MINIMUM THERMAL CONDUCTIVITY "k" VALUE FOR GLASS FIBER SHALL                                                                  |                             | -      |                                                     |        |        |               |  |

1) PROVIDE PIPE INSULATION WICKING SYSTEM ON ALL EXISTING SYTEMS THAT ARE OPERATIONAL DURING INSTALLATION.

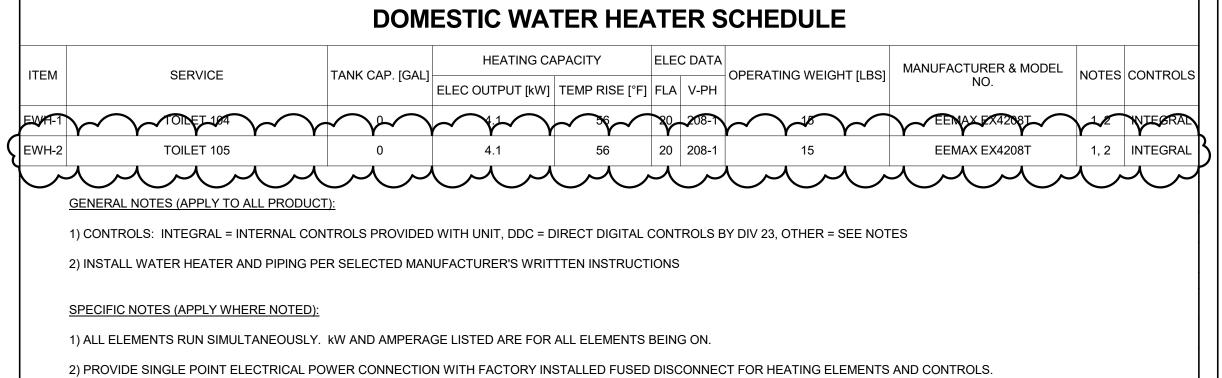

| EXISTING EQUIPMENT BALANCING SCHEDULE |                    |                  |                     |                           |              |       |  |  |  |  |  |
|---------------------------------------|--------------------|------------------|---------------------|---------------------------|--------------|-------|--|--|--|--|--|
| UNIT                                  | AREA SERVED        | NOMINAL          | SUPPLY AIRFLOW      | OUTSIDE AIR AIRFLOW       | MANUFACTURER | NOTES |  |  |  |  |  |
| ONTI                                  | ARLA SLRVLD        | TONNAGE          | (CFM)               | (CFM)                     | & MODEL      |       |  |  |  |  |  |
| (E) AH-1                              | H&R BLOCK SUITE    | 5.0              | 2000                | 140                       | TRANE YSC060 | 1     |  |  |  |  |  |
| NOTES:                                | 1. REFER TO SPECIE | ICATIONS FOR BAL | ANCING ITEMS REQUIE | RED. PROVIDE ALL ITEMS IN | FINAL REPORT |       |  |  |  |  |  |

# WHERE NOTED THE PLUMBING FIXTURE, EQUIPMENT AND ASSOCIATED ACCESSORIES

SHALL BE ICC/ANSI A117.1 (ADA) COMPLIANT. EXPOSED CW, HW AND W PIPING ALONG WITH

MIXING VALVE SHALL BE INSULATED. PIPING WITHIN CASEWORK THAT OPENS FOR FIXTURE

USE IS CONSIDERED EXPOSED.

\*\*\* LAWRENCE GROUP

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319 North 4th Street
Suite 1000
St. Louis, Missouri 63102
(314) 231-5700

PROJECT TEAM:
GENERAL CONTRACTOR:
BHR BUILDERS LLC
Contact: Donna Barboza (Mitchell)
Phone: 936-433-9192

PROFESSIONAL ENGINEER:



7600 E Orchard Road, Suite 250-S Greenwood Village, CO 80111 Phone: 303.796.6000 IMEG Project No.: 22001727.36

PROFESSIONAL SEAL:



PROJECT TITLE:

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S. Meridian

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| No | Description       | Date           |
|----|-------------------|----------------|
| 1  | BUILDING COMMENTS | 10/17/20<br>22 |
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SHEET TITLE:

MECHANICAL AND
PLUMBING
SCHEDULES
PROJECT NUMBER: SHEET NUMBER:

2022924.005 Drawn By: ABN

ABN
Issue Date:
AUGUST 19, 2022

#### **GENERAL NOTES - PLUMBING:**

A. CONTRACTOR SHALL NOTIFY ENGINEER OF ANY DISCREPANCIES IN EXISTING CONDITIONS.

#### KEYNOTES #

1 WATER CLOSET TO REMAIN. CONTRACTOR SHALL CLEAN AND RETURN TO LIKE NEW CONDITION.

LAVATORY TO REMAIN. CONTRACTOR SHALL CLEAN AND RETURN TO WATER HEATER LOCATED ON FLOOR BELOW LAVATORY FOR EXISTING RESTROOM TO BE REMOVED. REMOVE ALL ASSOCIATED HW PIPING. REMOVE CW PIPING BACK TO NEAREST ASSOCIATED ACTIVE MAIN AND

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PROJECT TEAM: GENERAL CONTRACTOR: BHR BUILDERS LLC Contact: Donna Barboza (Mitchell)

Phone: 936-433-9192



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| 1  | BUILDING COMMENTS | 10/17/20<br>22 |  |  |  |  |
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SHEET TITLE:

**PLUMBING DEMOLITION PLAN** 

PROJECT NUMBER: SHEET NUMBER: 2022924.005 Drawn By: ABN Issue Date:

AUGUST 19, 2022

1 PLUMBING DEMOLITION PLAN
1/4" = 1'-0"

ISSUED PERMIT Building Engineering Public Works Traffic

City of Puyallup
Development & Permitting Services

## TOILET М3 Drinking Fountain Has Been Removed From Scope Of Work Per Architect And Engineer Of Records Letter. TAX AREA 102 WAITING 100

#### **GENERAL NOTES - PLUMBING:**

A. CONTRACTOR SHALL NOTIFY ENGINEER OF ANY DISCREPANCIES IN EXISTING CONDITIONS.

#### KEYNOTES #

PROVIDE 1/2" CW PIPING DOWN IN WALL TO NEW WATER CLOSET, WC-#. REFER TO PLUMBING FIXTURE AND EQUIPMENT SCHEDULE FOR MORE INFORMATION.

- PROVIDE 1/2" CW PIPING DOWN IN WALL TO NEW LAVATORY, L-#. ROUTE 1/2" CW PIPING TO INSTANTANEOUS WATER HEATER, EWH-1, LOCATED BENEATH LAVATORY. ROUTE 1/2" HW PIPING FROM OUTLET OF WATER HEATER TO LAVATORY. REFER TO WATER HEATER DETAIL, MIXING VALVE DETAIL, WATER HEATER SCHEDULE AND PLUMBING FIXTURE AND EQUIPMENT SCHEDULE FOR MORE INFORMATION.
- CONNECT NEW 3/4" CW PIPING TO EXISTING CW PIPING OF EQUAL OR LARGER SIZE. CONTRACTOR SHALL FIELD VERIFY EXACT POINT OF CONNECTION. PROVIDE ISOLATION VALVE AT POINT OF CONNECTION.
- PROVIDE 1/2" CW PIPING DOWN IN WALL TO NEW ELECTRIC WATER COOLER, EWC-#. REFER TO PLUMBING FIXTURE AND EQUIPMENT SCHEDULE FOR MORE INFORMATION.
- PROVIDE NEW INSTANTANEOUS WATER HEATER, EWH-#, BELOW EXISTING LAVATORY. ROUTE 1/2" CW PIPING TO WATER HEATER. ROUTE 1/2" HW PIPING FROM OUTLET OF WATER HEATER TO EXISTING LAVATORY. REFER TO WATER HEATER DETAIL, MIXING VALVE DETAIL AND WATER HEATER SCHEDULE FOR MORE INFORMATION.

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| No | Description       | Date           |
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| 1  | BUILDING COMMENTS | 10/17/20<br>22 |
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SHEET TITLE: PLUMBING PLAN

PROJECT NUMBER: SHEET NUMBER: 2022924.005 Drawn By:

ABN Issue Date: AUGUST 19, 2022

PRCTI20221400

City of Puyallup Development & Permitting Services ISSUED PERMIT

Public Works

Traffic

Building

Engineering