



ABBREVIATIONS

Table with 3 columns: GENERAL, HVAC, and other abbreviations. Includes terms like ACCESS DOOR, AIR HANDLING UNIT, BACKDRAFT DAMPER, etc.


PIPING IDENTIFICATION

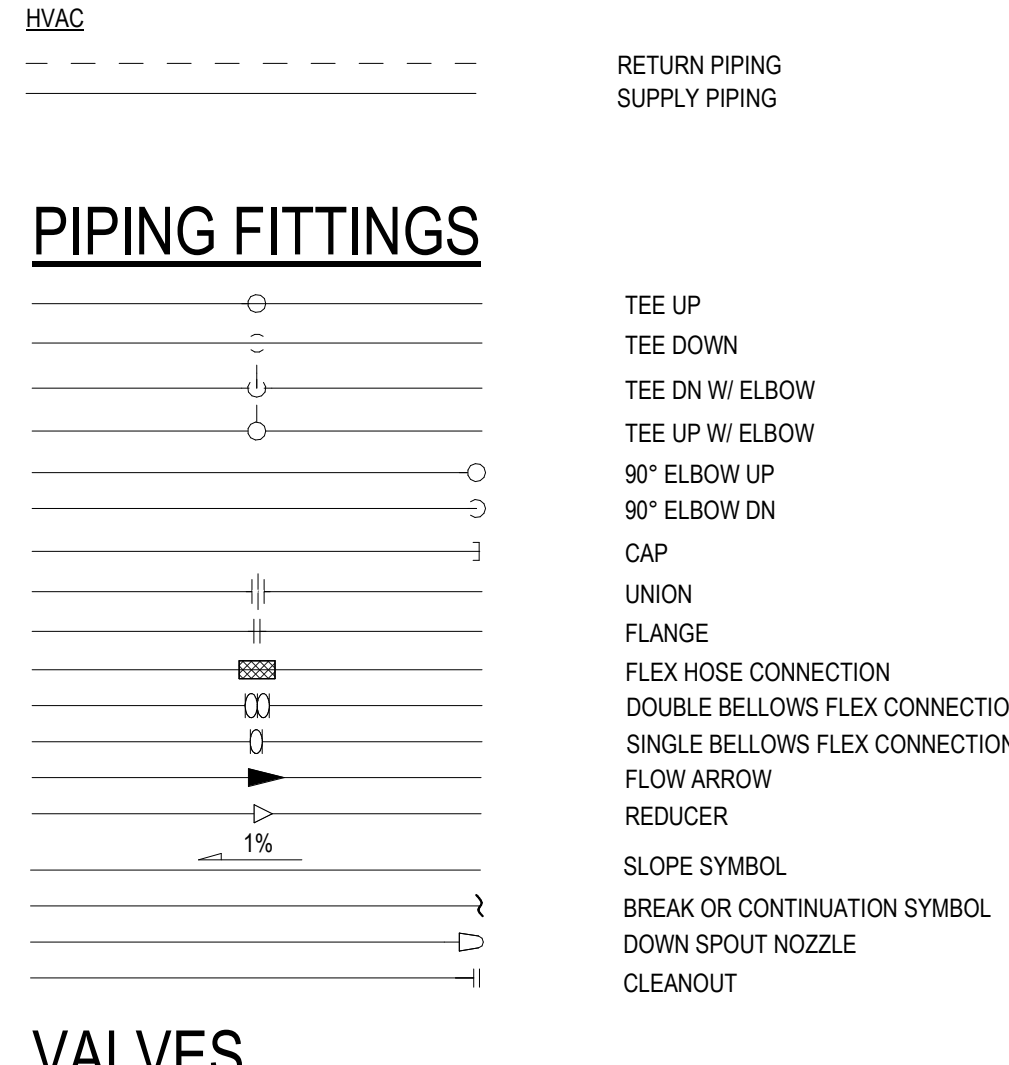


VALVES

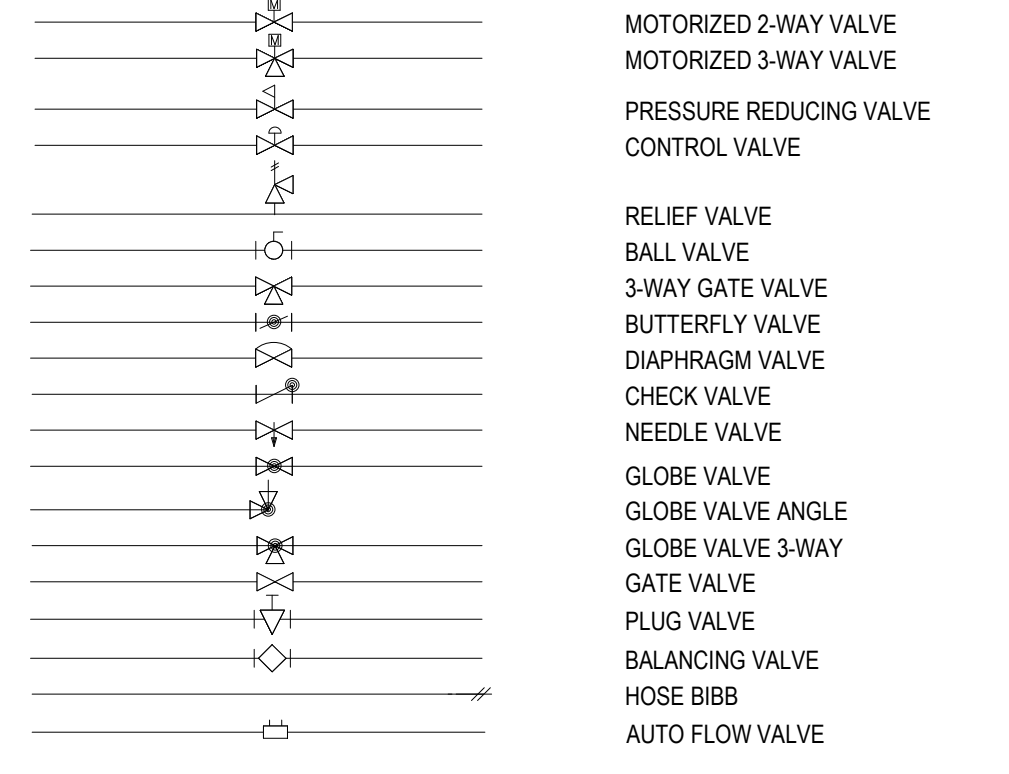


PIPING ACCESSORIES

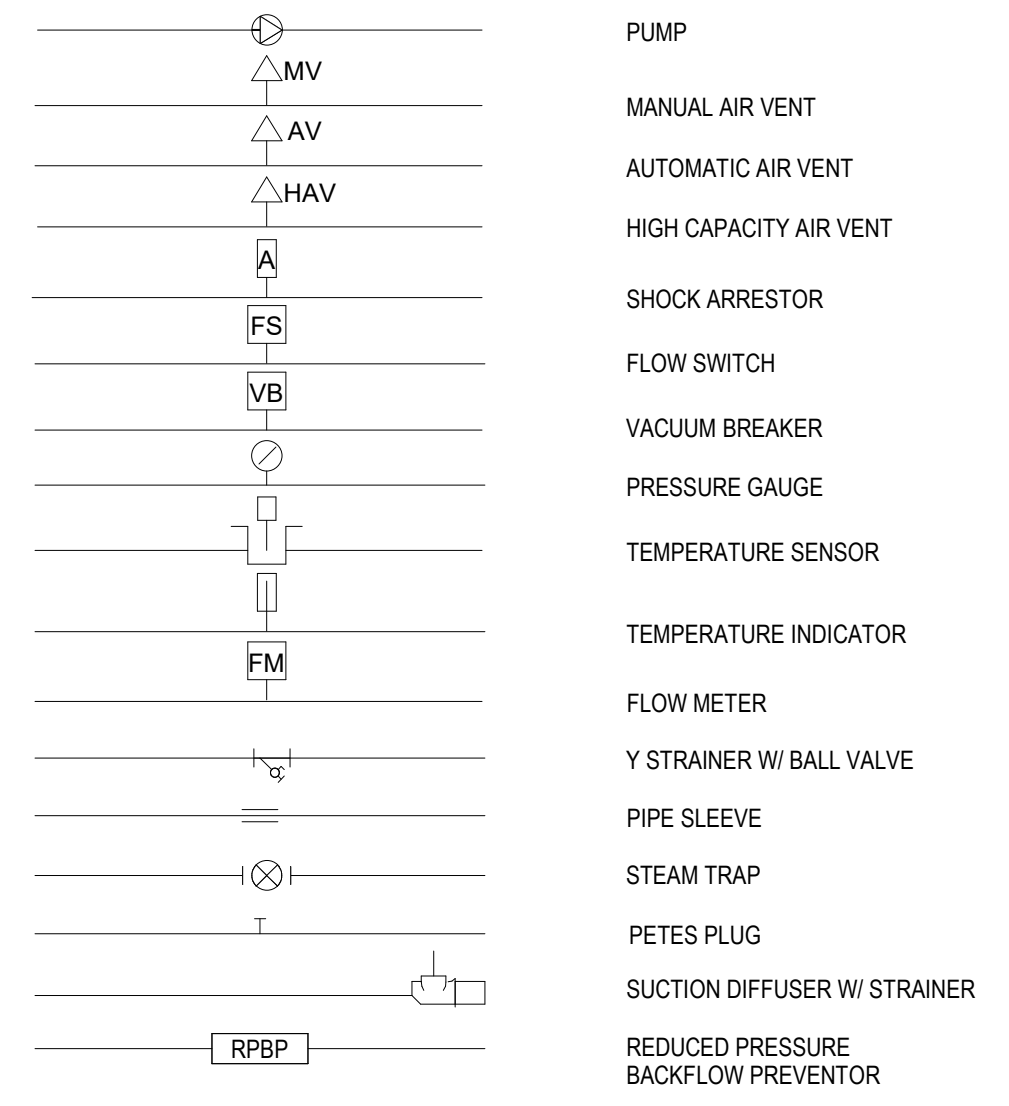


INSTRUMENTATION AND CONTROLS

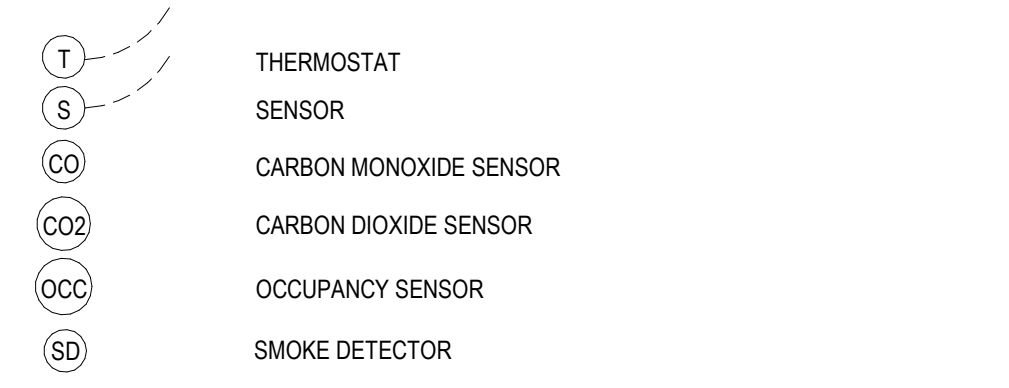


GENERAL INFORMATION SYMBOLS

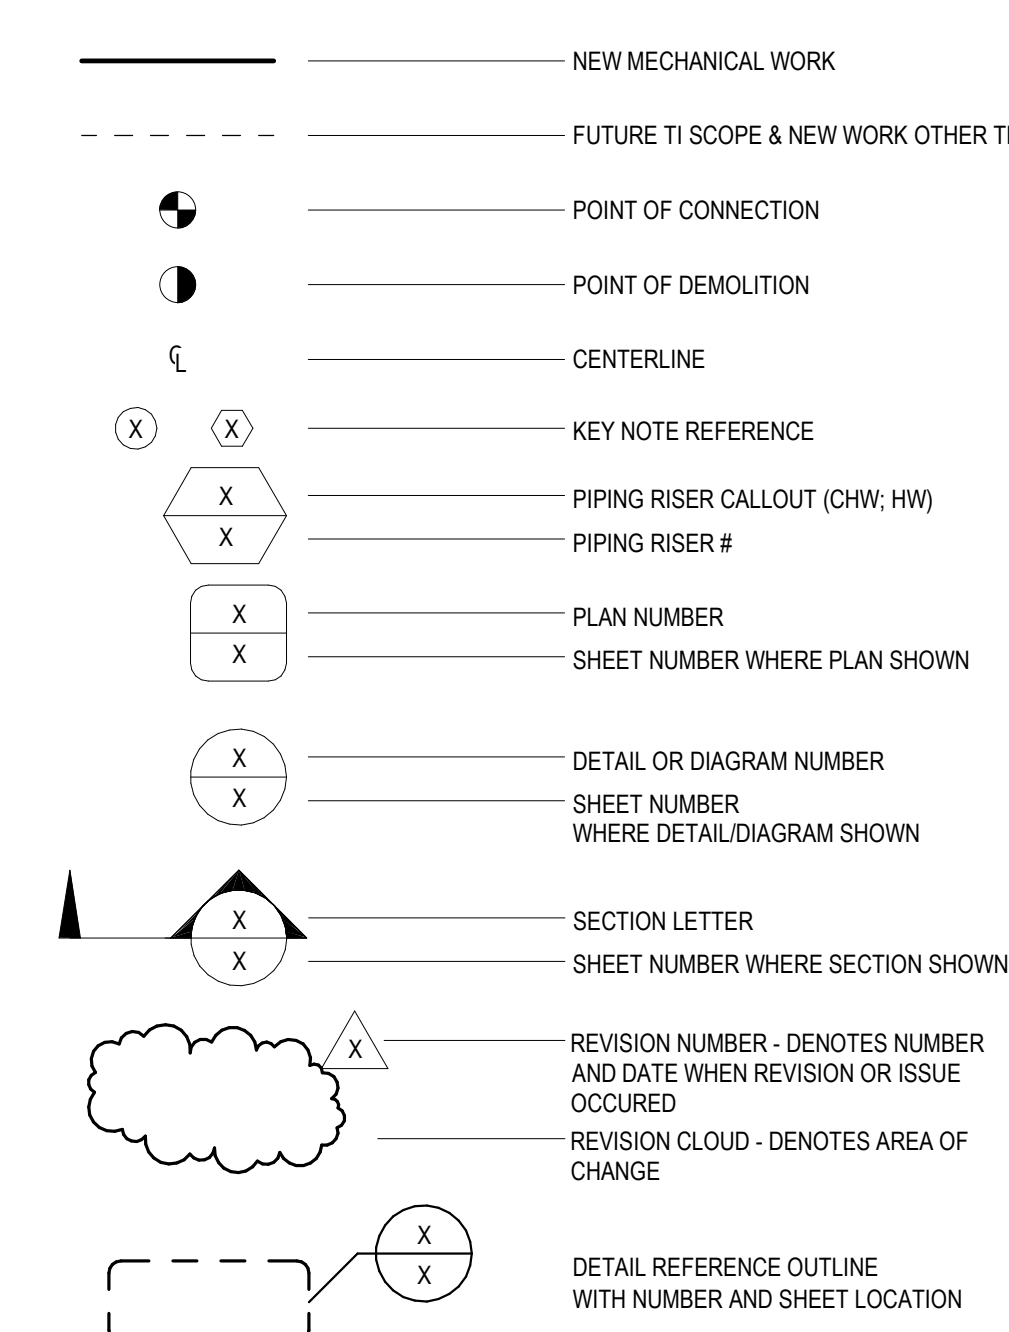

DUCTWORK ACCESSORIES

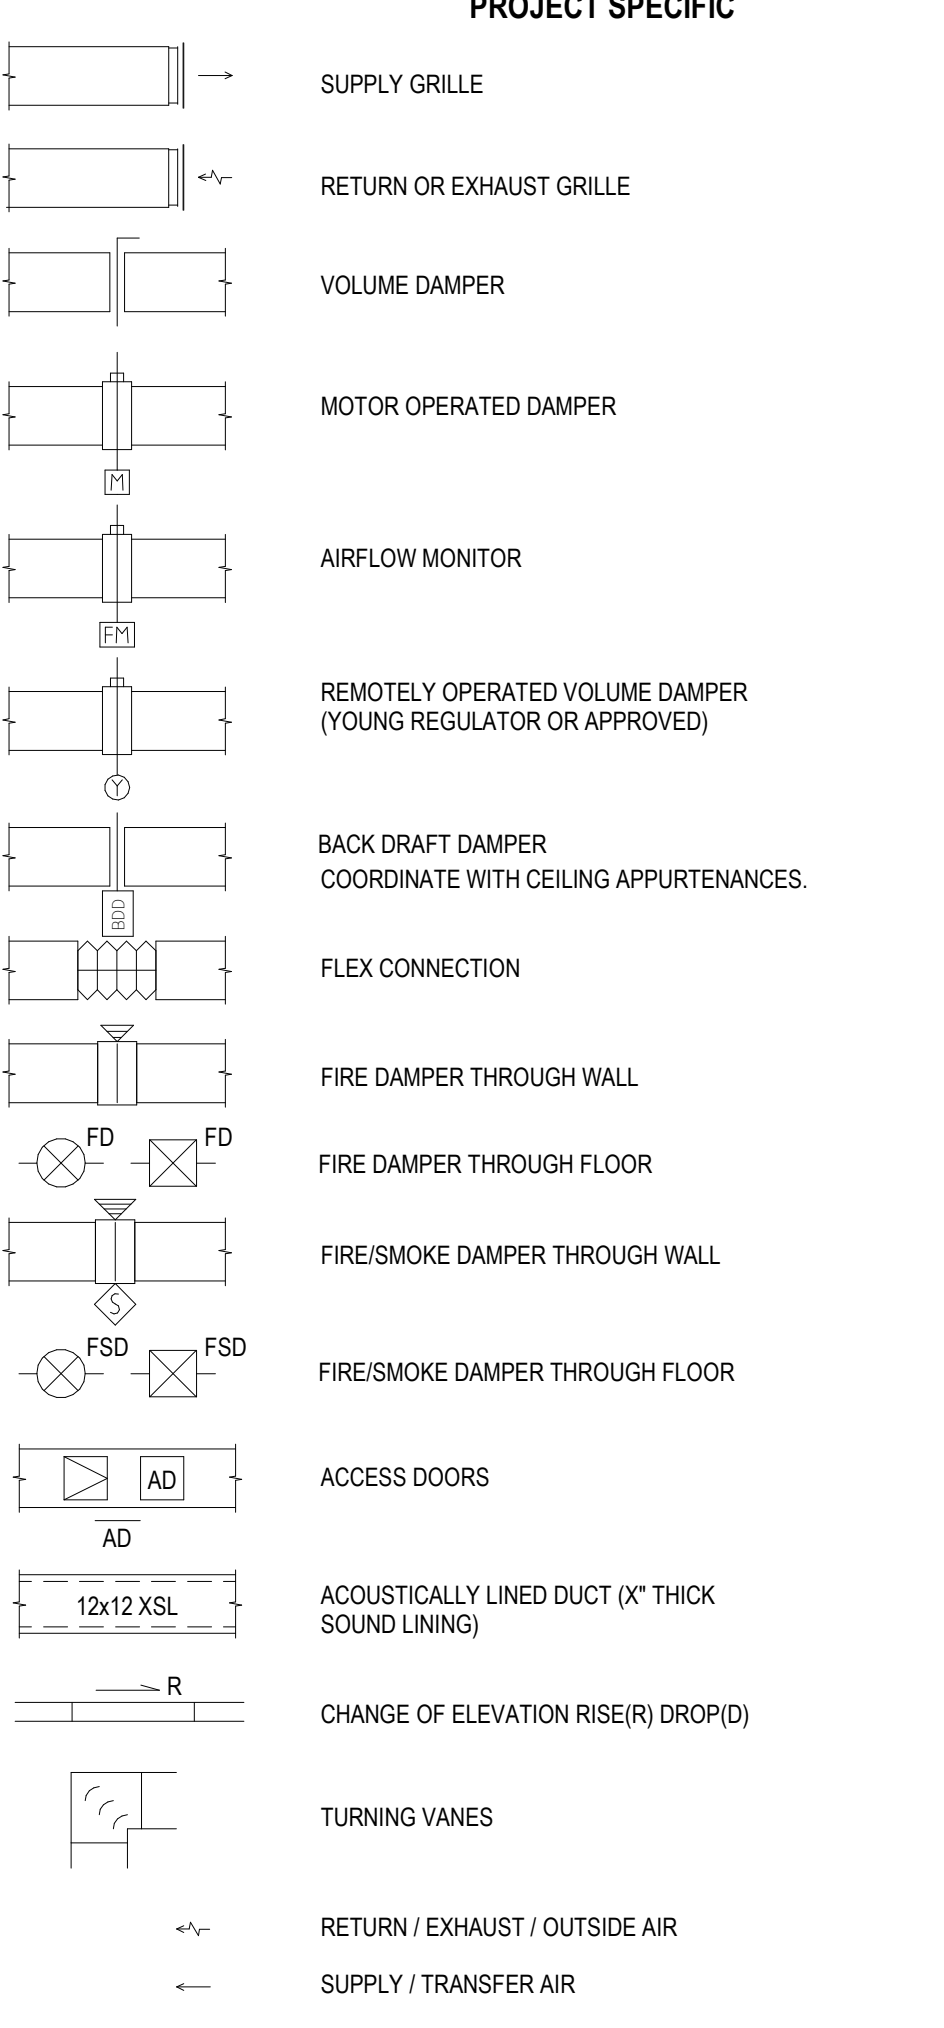


DUCTWORK

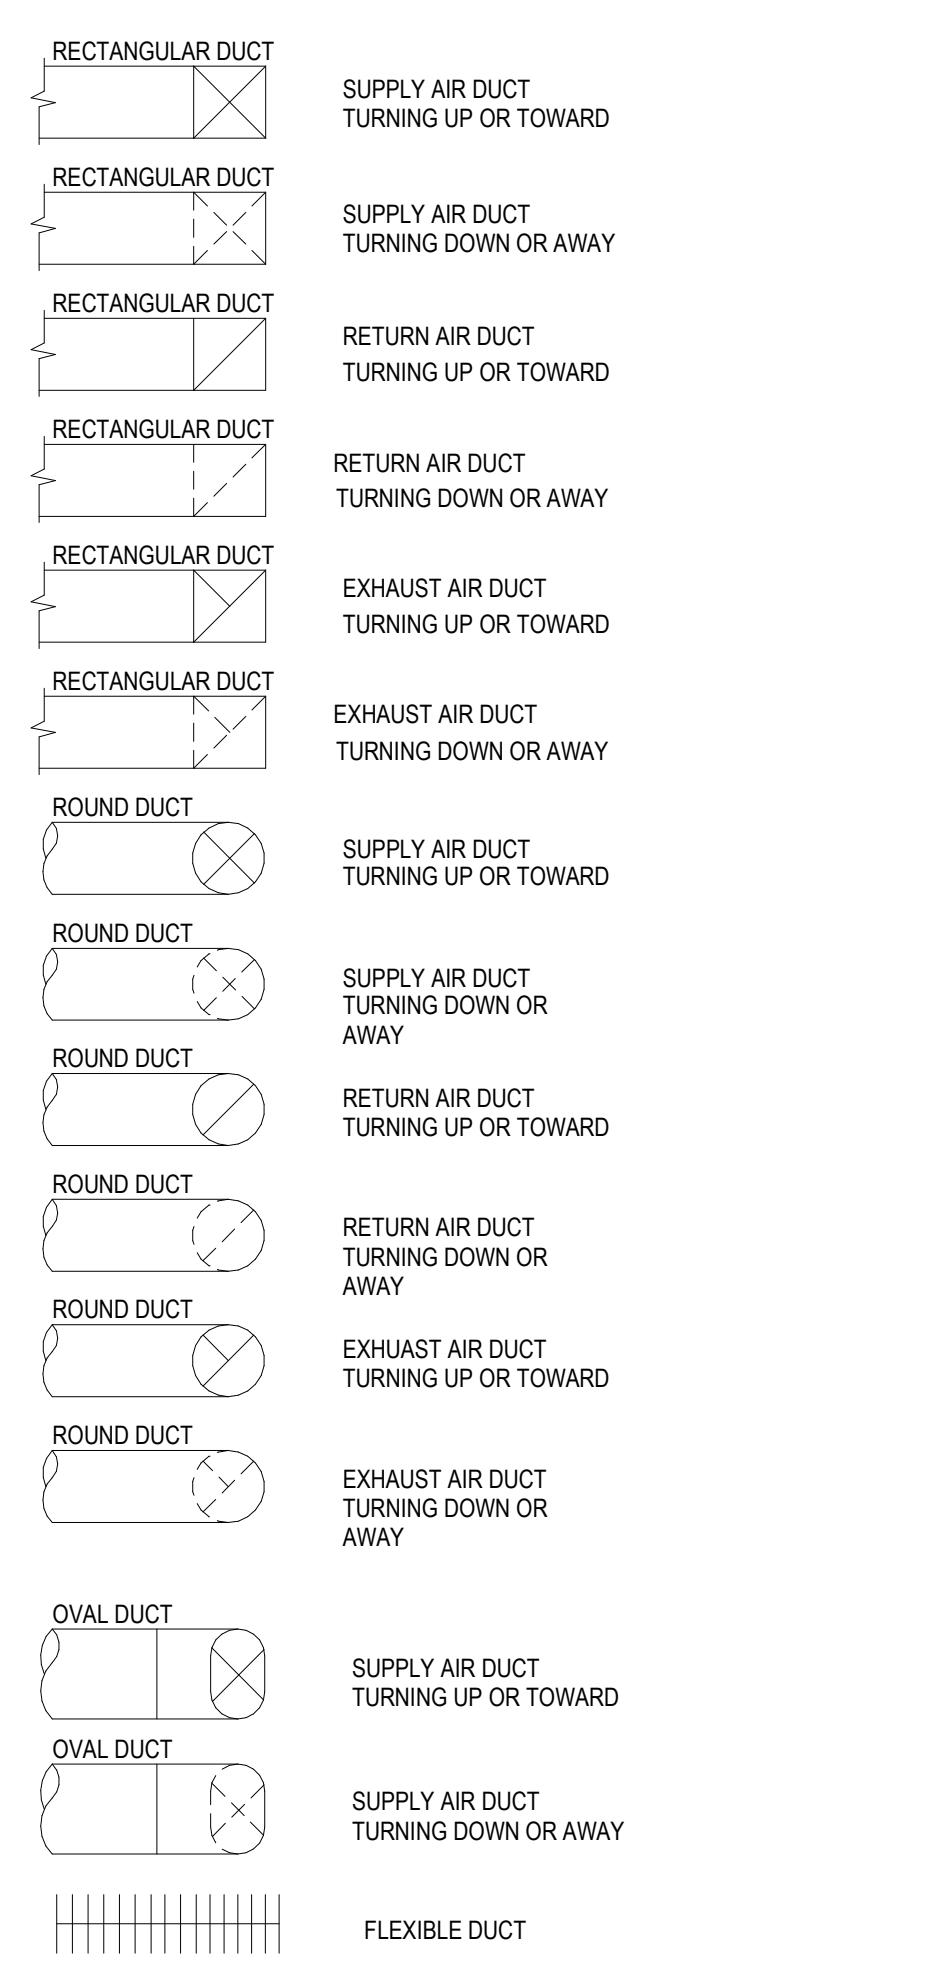


DEMOLITION NOTES

- List of demolition notes including: 1. DEMOLITION DRAWINGS ARE INCLUDED TO GIVE A COMMON BASIS FOR BIDDING... 2. REMOVE EXISTING HVAC EQUIPMENT AS INDICATED...

GRILLE/REGISTER/DIFFUSER

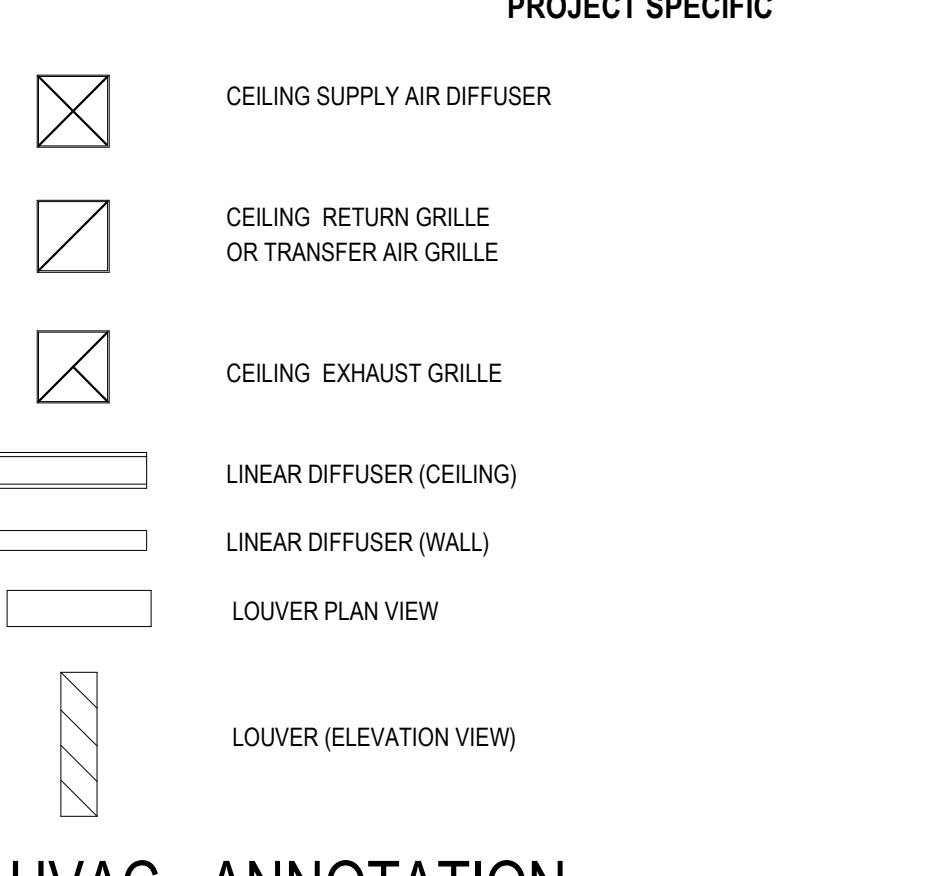

HVAC - ANNOTATION

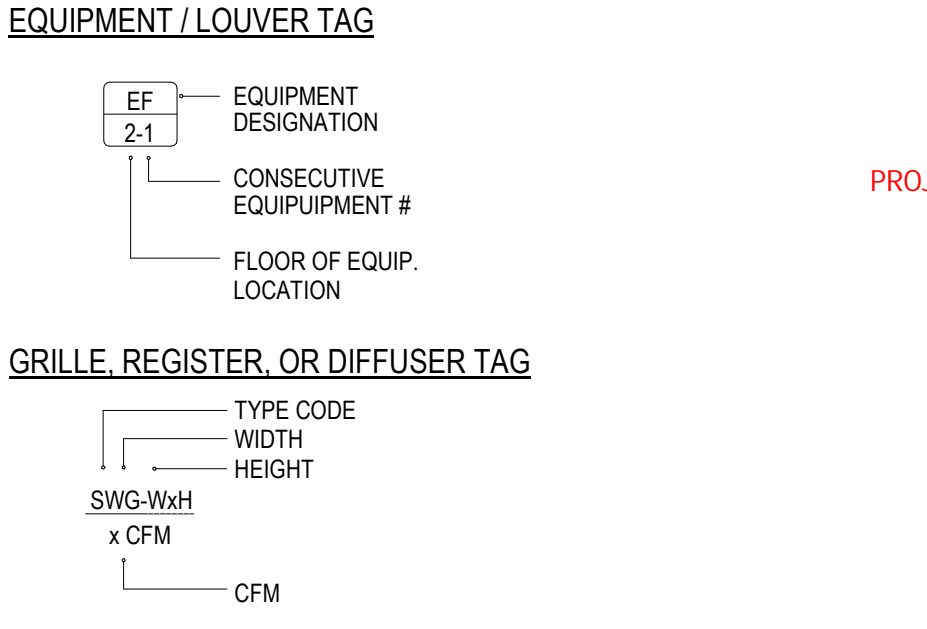

MECHANICAL INDEX table with columns: SHEET NO., SHEET NAME, M-001, M-040, M-111, S-201.



GENERAL NOTES

- 1. VERIFY LOCATIONS AND DIMENSIONS OF ALL EQUIPMENT AND COORDINATE ALL WORK PRIOR TO START OF CONSTRUCTION. 2. OBTAIN APPROVAL OF STRUCTURAL ENGINEER PRIOR TO INSTALLATION OF PENETRATIONS...


VICINITY MAP

LEGAL DESCRIPTION

PARCEL NUMBER: 5870000151

THE APPROVED CONSTRUCTION PLANS, DOCUMENTS AND ALL ENGINEERING MUST BE POSTED ON THE JOB AT ALL INSPECTIONS IN A VISIBLE AND READILY ACCESSIBLE LOCATION.

FULL SIZED LEDGIBLE COLOR PLANS ARE REQUIRED TO BE PROVIDED BY THE PERMITEE ON SITE FOR INSPECTION

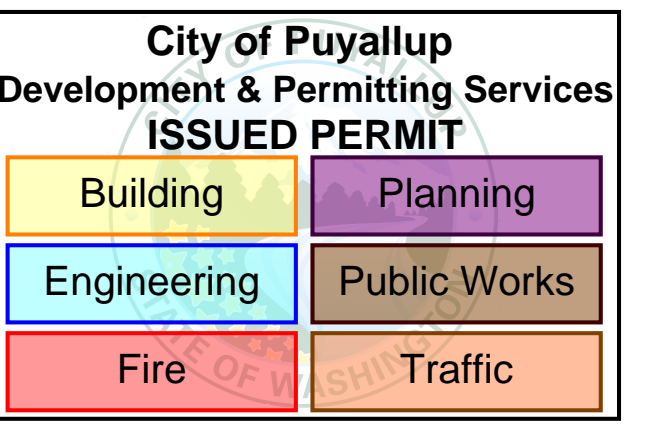

SEATTLE: 5005 3RD AVENUE S PO BOX 24567 SEATTLE, WA 98124 1-800-669-6223

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PROJECT: PUYALLUP HS

SERVER RM SPLIT SYSTEM

105 7TH ST. S.W. PUYALLUP, WA. 98371

CONSULTANTS:

PRMH20221752

City of Puyallup Building APPROVED stamp. Includes text: 'See permit for additional requirements.', 'JMontgomery 11/23/2022 6:56:02 AM', and the City of Puyallup logo.

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ISSUES table with columns: NO, DATE, DESCRIPTION. Row 1: 11-07-2022, MECHANICAL PERMIT SET.

DESIGNED: A. SADIGH, DRAWN: A. SADIGH, CHECKED: D. MA, JOB NO: 123130-001, ISSUED ON: 11/23/2022, SHEET TITLE:

MECHANICAL LEGEND, ABBREVIATIONS, VICINITY MAP & B.O.D.

SHEET NUMBER:

M-001

HVAC BASIS OF DESIGN table with columns: BASIS FOR PROJECT, BASIS FOR LOAD CALCULATIONS, BASIS FOR SCOPE OF WORK, CRITERIA, CRITERIA SOURCE.

HVAC PIPING SPECIFICATION

ID	CATEGORY	SERVICE DESCRIPTION	MANUFACTURER, PRODUCT OR EQUAL	PRESSURE TEST PROCEDURE			
				MEDIA	TEST PRESSURE	DURATION	CODE
CNDS	CONDENSATE DRAIN	CONDENSATE DRAIN FROM EQUIPMENT COIL DRAIN PANS		WATER	PLUG OUTLET AND FILL SYSTEM FROM LOWEST TO HIGHEST POINT OF TEST SECTION	MIN 15 MINUTES VISUAL CHECKS FOR LEAKS	2018 UPC SECTION 123.0
	PIPE IDENTIFICATION MARKER	WHITE LETTERING ON GREEN BACKGROUND - ANSIAISME 13.1 - 2007	HANPLY (HANSEN SUPPLY), MARKING SERVICES INC. MS-970 (INDOOR); MS-995 (OUTDOOR); DURALABEL				
	DESIGN OPERATING PRESS & TEMP	ATMOSPHERIC					
	SIZES THRU 2"						
	PIPE MATERIAL	COPPER TUBE TYPE L ASTM B88	-				
	JOINTS	SWT, THREADED AT SPECIAL TIES AS APPLICABLE	-				
	FITTINGS	WROTCOPPERBRONZE SWT JOINT	-				
COUPLINGS	WROTCOPPERBRONZE SWT JOINT	-					
RL / RS	REFRIGERANT LIQUID / REFRIGERANT SUCTION	REFRIGERANT PIPING FOR HEATING AND COOLING		INERT GAS - NITROGEN OR CARBON DIOXIDE	1.5 TIMES PRESSURE RELIEF VALVE SETTING	1 HOUR	2018 IMC, SECTION 1108
PIPE IDENTIFICATION MARKER	BLACK LETTERING ON ORANGE BACKGROUND - ANSIAISME A 13.1 - 2007	HANPLY (HANSEN SUPPLY), MARKING SERVICES INC. MS-970 (INDOOR); MS-995 (OUTDOOR); DURALABEL					
RATED OPERATING PRESS & TEMP	PER ASTM B31.5 REFRIGERATION PIPING AND HEAT TRANSFER COMPONENTS						
SIZES THRU 1 1/8"							
PIPE MATERIAL	PRE-INSULATED COPPER TUBING ON ROLLS, ASTM-B280 - SEALED AND CAPPED AT ENDS	PDM - GELCOPPER PRE-INSULATED COPPER ROLL (1/4" - 1 - 1/8")					
INSULATION	POLYETHYLENE CLOSED CELL FOAM - ASTM C 1427 COMPLIANT - UL94 & UL 723 (FLAME SPREAD<25 & SMOKE DEVELOPMENT <50)	-					
JOINTS	SILVER BRAZED AND NITROGEN PURGE PER ASTM B885	-					
FITTINGS	WROTCOPPERBRONZE SWT JOINT PER ASTM B16.22	-					
SPECIALTIES	MISC.	PROJECT SPECIFIC REQUIREMENTS - SEE SPECIFICATION 232300 "REFRIGERANT PIPING"					



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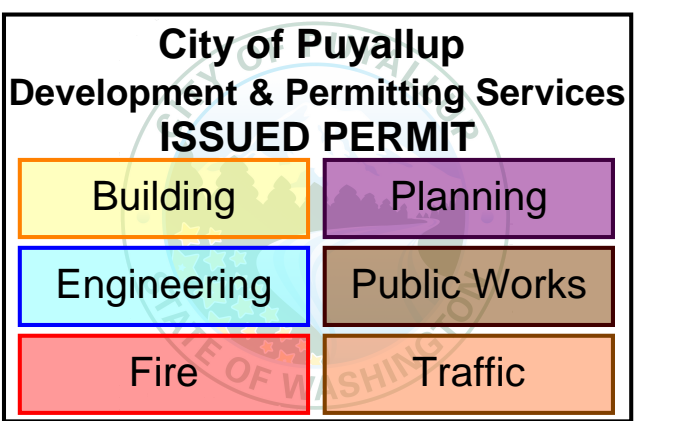
PUYALLUP HS

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SPLIT SYSTEM**

105 7TH ST. S.W.
PUYALLUP, WA. 98371

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MECHANICAL PIPE INSULATION SCHEDULE - WASHINGTON

FROM 2018 WSEC TABLE C403, 10.3

SPECIFICATION: 230700 HVAC INSULATION

PIPING SYSTEM	TEMP RANGE (Deg F)	THERMAL COND.	MEAN RATING TEMPERATURE	INSULATION MATERIAL	INSULATION THICKNESS					NOTES
					<1"	1" TO <1-1/2"	1 1/2" TO 4"	4" - 8"	OVER 8"	
REFRIGERANT SUCTION	< 40	0.20 - 0.26	75	E	0.5	1.0	1.0	1.0	1.0	1, 3, 4, 10
REFRIGERANT HOT-GAS	141-200	0.25 - 0.29	125	E	1.5	2.0	2.0	20.0	1.0	1, 3, 4, 10, 12

E. ELASTOMERIC CLOSED CELL INSULATION

KEY NOTES:

- FOR PIPING CLAMPED TO UNISTRUT SUPPORTS, UTILIZE RIGID INSERTS WITH SHEETMETAL SHIELDS CONTINUOUS THROUGH THE HANGER; UTILIZE CALCIUM SILICATE INSERTS OR STYRENE INSERTS
- UTILIZE RIGID INSERTS AND SHEETMETAL SHIELDS; INSULATION TO BE CONTINUOUS THROUGH THE HANGER; UTILIZE CALCIUM SILICATE INSERTS OR STYRENE INSERTS
- JACKETING: ALUMINUM ROLLED JACKETING (ARJ) APPLIED TO EXTERIOR PIPING INSULATION EXPOSED TO WEATHER (I.E. ROOFTOP PIPING). SEE INSULATION SPEC FOR ALTERNATE JACKETING AND LOCATIONS.
- ASTM E 84 OR UL 723 TESTED TO FLAME SPREAD INDEX OF 25 AND SMOKE DEVELOPED INDEX OF NOT EXCEEDING 450
- REFRIGERANT HOT-GAS INSULATION FOR PERSONNEL PROTECTION ONLY, NOT REQUIRED BY ENERGY CODE AND MAY USE 1/2" E INSULATION FOR ALL SIZES.
- MANUFACTURER'S LINE SETS MAY BE USED IN LIEU OF ELASTOMERIC INSULATION AND MUST MEET ENERGY CODE AND SMOKE & FLAME REQUIREMENTS.

SPLIT SYSTEM UNIT SCHEDULE		
DESCRIPTION		
DRIVE TAG #	FCU-01	CU-01
LOCATION	SERVER RM	OUTSIDE WALL
QUANTITY		
SCOPE QUALIFIER (PROJECT PHASE, FUTURE, ALTERNATE, ETC)	PROJECT PHASE	PROJECT PHASE
TYPE AND ARRANGEMENT (INDOOR/OUTDOOR, HORIZONTAL/VERTICAL)	INDOOR	OUTDOOR
AREA / SYSTEM SERVED	SERVER RM	
MANUFACTURER DATA		
STATUS (AS PROPOSED, AS APPROVED, AS BUILT)	AS PROPOSED	AS PROPOSED
MANUFACTURER	MITSUBISHI	PUY-ANMKAY
MODEL NUMBER (OR CUSTOM)	PKA-ANMKAY	PUY-ANMKAY
OVERALL PHYSICAL DIMENSIONS		
LENGTH x WIDTH x HEIGHT (IN)	46-1/16 x 11-5/8 x 14-3/8	41-15/16 x 13 x 12-11/16
ACCESS RESTRICTIONS: (FRONT / REAR / LEFT / RIGHT / TOP), EXPLANATION	21' x 1' x 2' 4"	20' x 2' 4" x 1' 4" x 2' 0"
OPERATING HEIGHT, INCLUDE BASE WEIGHT (LBS)	46	21
FACTORY CURB	NO	NO
SITE BUILT CURB OR PAD BY	NONE	WALL BRACKET
SIZE & TYPE OF EACH SUCTION PIPE CONN. (IN, CTS)	BRAZED & S/B	BRAZED & S/B
SIZE & TYPE OF EACH LIQUID PIPE CONN. (IN, CTS)	BRAZED & S/B	BRAZED & S/B
CONDENSATE DRAIN CONNECTION SIZE (IN)	3/8	3/8
FILTRATION		
FILTER SECTION (A/C) & BANK FILTER NUMBER		WASHABLE
DIRECT REFRIGERANT EXPANSION (DX) COOLING COIL		-
REFRIGERANT TYPE USED IN COIL	R410A	R410A
QUANTITY OF REFRIGERANT (LBS)	10.0 LB @ 0.2	
DESIGN COOLING OUTDOOR AMBIENT AIR DRYBULB TEMP. (°F)	78.5	86
COOLING COIL ENTERING AIR DRYBULB TEMPERATURE (°F) (°F)	55.0	-
COOLING COIL LEAVING AIR DRYBULB TEMPERATURE (°F)	30.0	-
DX COOLING COIL MAXIMUM TOTAL (MBH)	708.0 (300)	3880
FAN MOTOR	DC MOTOR	1/8
FAN MOTOR TYPE		S/B
DISCHARGE PIPE CONNECTION SIZE AND TYPE (IN, CTS)	3/8	-
LIQUID PIPE CONNECTION SIZE AND TYPE (IN, CTS)	3/8	-
EA COOLING COIL ROWS / FIN SPACING	-	-
DX COOLING COIL FACE AREA (FT²)	-	-
REFRIGERANT CONTROL	LEV	18.5
SEER @ 95% CONDITIONS	-	13
SEER MINIMUM REQUIRED PER CODE	-	9
CONDENSATE PUMP INCLUDED	YES	-
LOW AMBIENT OPERATION MINIMUM TEMPERATURE (°F)	-	-
ELECTRICAL		
QUANTITY OF ELECTRICAL CONNECTIONS	1	1
VOLTAGE / PHASE	-	208/200/1
MINIMUM CIRCUIT AMPACITY (MCA) (AMPS)	-	25
OVERCURRENT PROTECTION (INDICATE MOOP OR MFP)	NO	31
3-Ø TERMINAL POWER SOURCE (REQUIRED)	NO	NA
SMOKE DETECTOR PROVIDED AND WIRED BY ELECT (RETURN, SUPPLY, NONE)	NONE	NA
MINIMUM SHORT CIRCUIT CURRENT RATING (SCCR) (AMPS)	-	5000
STARTER PROVIDED BY	NONE	NONE
DISCONNECT PROVIDED BY	ELECTRICAL	ELECTRICAL
VARIABLE FREQUENCY DRIVE PROVIDED BY	NONE	NONE
CODE REQUIRED ELECTRICAL OUTLET PROVIDED BY	ELECTRICAL	ELECTRICAL
CONTROLS		
CONTROL METHOD	FACTORY CONTROL: KUMO CLOUD	
CONTROLS INTERFACE / PROTOCOL	STAND ALONE THERMOSTAT	
ACOUSTICAL & SEISMIC		
SOUND PRESSURE LEVEL (SPL)	42	52
QUANTITY OF SEISMIC ATTACHMENTS (PER UNIT) TO STRUCTURE	NONE	SEE STRUCTURAL (S6-1)
MANUFACTURER'S CERTIFICATE OF COMPLIANCE INCLUDED PER IRC TYP-4	YES	YES
NOTES:	3	1, 2

1. PROVIDE WITH BRACKET FOR STRUCTURAL ATTACH TO THE WALL.
2. PROVIDE WITH WIND BAFFLE.
3. PROVIDE WITH CONDENSATE PUMP.

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DESIGNED: A. SADIGH
DRAWN: A. SADIGH
CHECKED: D. MA
JOB NO: 123130-001
ISSUED ON:
SHEET TITLE:

SCHEDULE AND SPECIFICATIONS


SHEET NUMBER:

M-060



PHOTO OF CHILLER YARD

LOCATION OF CONDENSER UNIT (CU-01) ON THE WALL

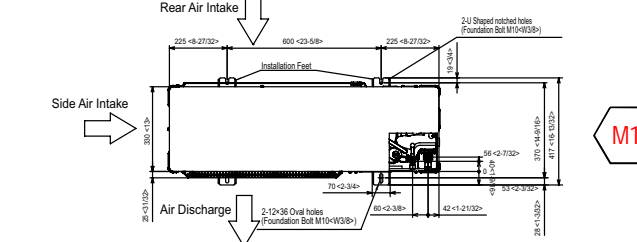


GENERAL NOTES

1. NEW WORK SHOWN IN RED

KEYNOTES

- M1 INSTALL NEW OUTDOOR CONDENSER (CU-01) ON BRACKET AND ATTACH TO CMU WALL (7'-0" ABOVE THE GROUND LEVEL) MAINTAIN AIR FLOW IN REAR, SIDE AND FRONT. MAINTAIN SERVICE CLEARANCES PER MANUFACTURER'S RECOMMENDATION. FOR SEISMIC ATTACHMENT REFER TO SHEET S-001, DETAIL (SK-1).
- M2 INSTALL NEW 3/8" & 5/8" REFRIGERATION LINES (LIQUID & GAS) FROM CONDENSING UNIT (INSULATED) THRU THE CONCRETE WALL TO INDOOR UNIT. (FIRE CAULK THE PENETRATIONS)
- M3 INSTALL NEW WALL MOUNTED FAN COIL UNIT (FCU-01) ON THE WALL FACING TO THE FRONT OF THE SERVER RACKS. (6'-0" A.F.F.)
- M4 CONNECT NEW 3/4" CONDENSATE DRAIN (PUMPED) TO EXISTING FLOOR DRAIN IN MECHANICAL ROOM.

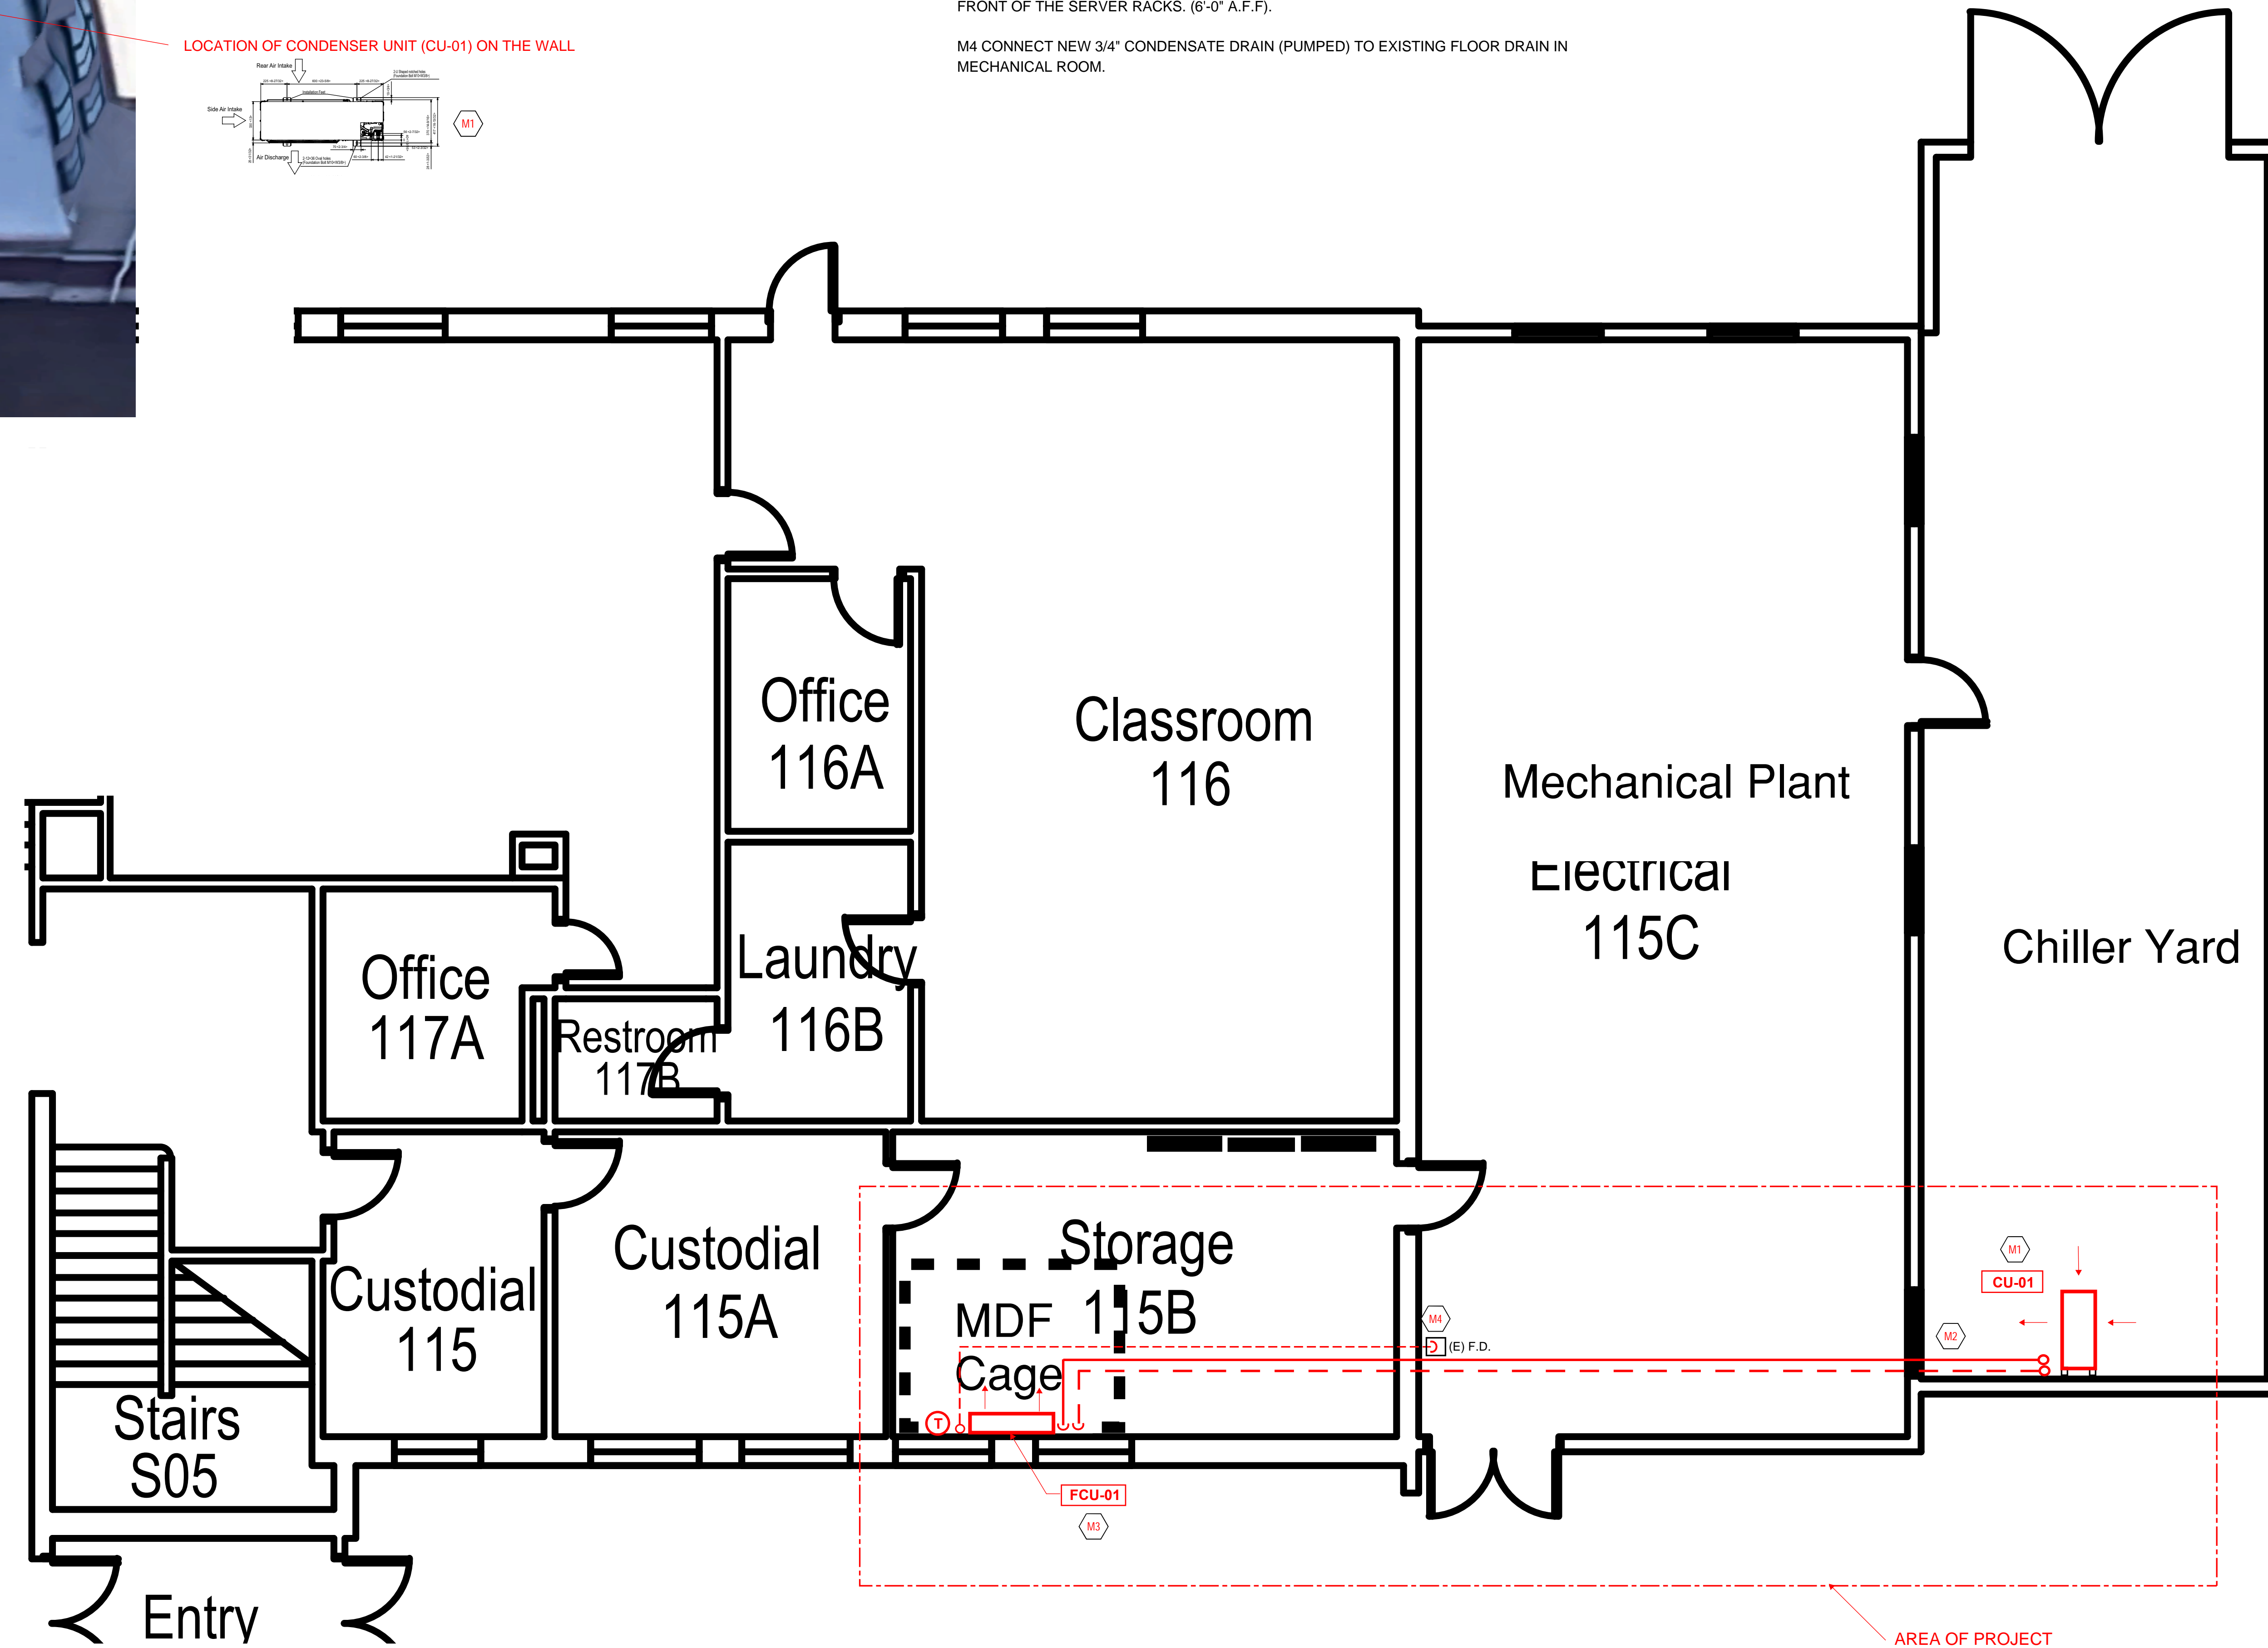

1 PARTIAL MECHANICAL FLOOR PLAN
 M-111 SCALE: 1/4" = 1'-0"



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PROJECT:

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CONSULTANTS:

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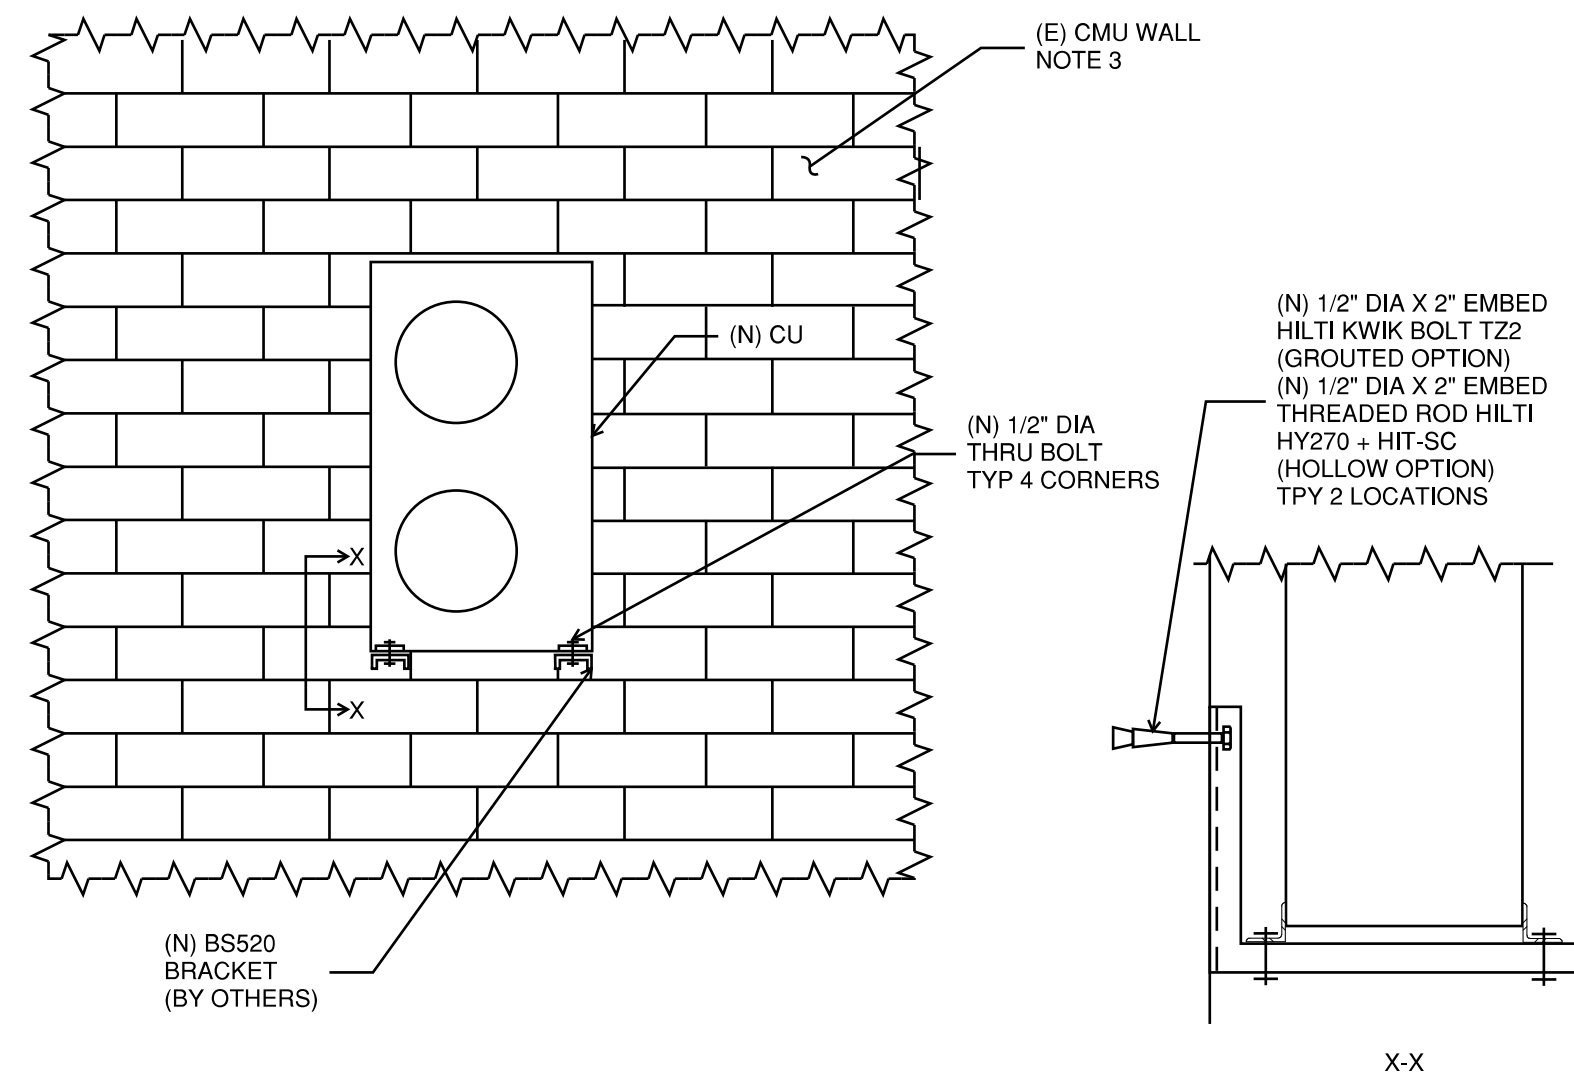
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1	11-07-2022	MECHANICAL PERMIT SET

DESIGNED: A. SADIGH
 DRAWN: A. SADIGH
 CHECKED: D. MA
 JOB NO: 123130-001

SHEET TITLE:
**PATIAL FLOOR PLAN-
 MECHANICAL**

SHEET NUMBER:

M-111



CONNECTION DETAIL
 SCALE: NTS
 NOTES:
 1. (N) DENOTES "NEW"; (E) DENOTES "EXISTING".
 2. SEE MECHANICAL DRAWINGS FOR ADDITIONAL INFO.
 3. CONTRACTOR TO CONFIRM IF CMU WALL IS GROUTED OR HOLLOW.



PROJECT: PUYALLUP HIGH SCHOOL
 105 7TH ST SW
 PUYALLUP, WA 98371

DESIGNED: HBS
 DRAWN: HBS
 CHECKED: JWG
 APPROVED: 123130

SHEET TITLE: CONN DETAIL
 SHEET NUMBER: SK-1


PKA-A36KA7 & PUY-A36NKA7(-BS)
 36,000 BTU/H WALL-MOUNTED INDOOR UNIT
 36,000 BTU/H COOLING ONLY OUTDOOR

Job Name: _____ Date: _____
 System Reference: _____


Indoor Unit: PKA-A36KA7
 Outdoor Unit: PUY-A36NKA7
 Standard Model
 Seacoast Model

- INDOOR UNIT FEATURES**
- Sleek, compact design
 - Simple installation
 - Vane setting for air flow direction control
 - Auto fan speed mode
 - Ideal for spaces such as server rooms, daycare centers, classrooms, churches, small offices, and more
 - Multiple control options available:
 - kumo cloud® smart device app for remote access
 - Third party interface options
 - Wired or wireless controllers
- OUTDOOR UNIT FEATURES**
- Variable speed INVERTER-driven compressor
 - Power receiver pre-charged with refrigerant volume for piping length up to 100 ft
 - Low ambient cooling down to -40°F, providing 100% capacity (with wind baffles)
 - 24-hour continuous operation (cooling mode)
 - High pressure protection
 - Fail restart
 - Superior energy and operational efficiency

INDOOR UNIT DIMENSIONS: PKA-A36KA7

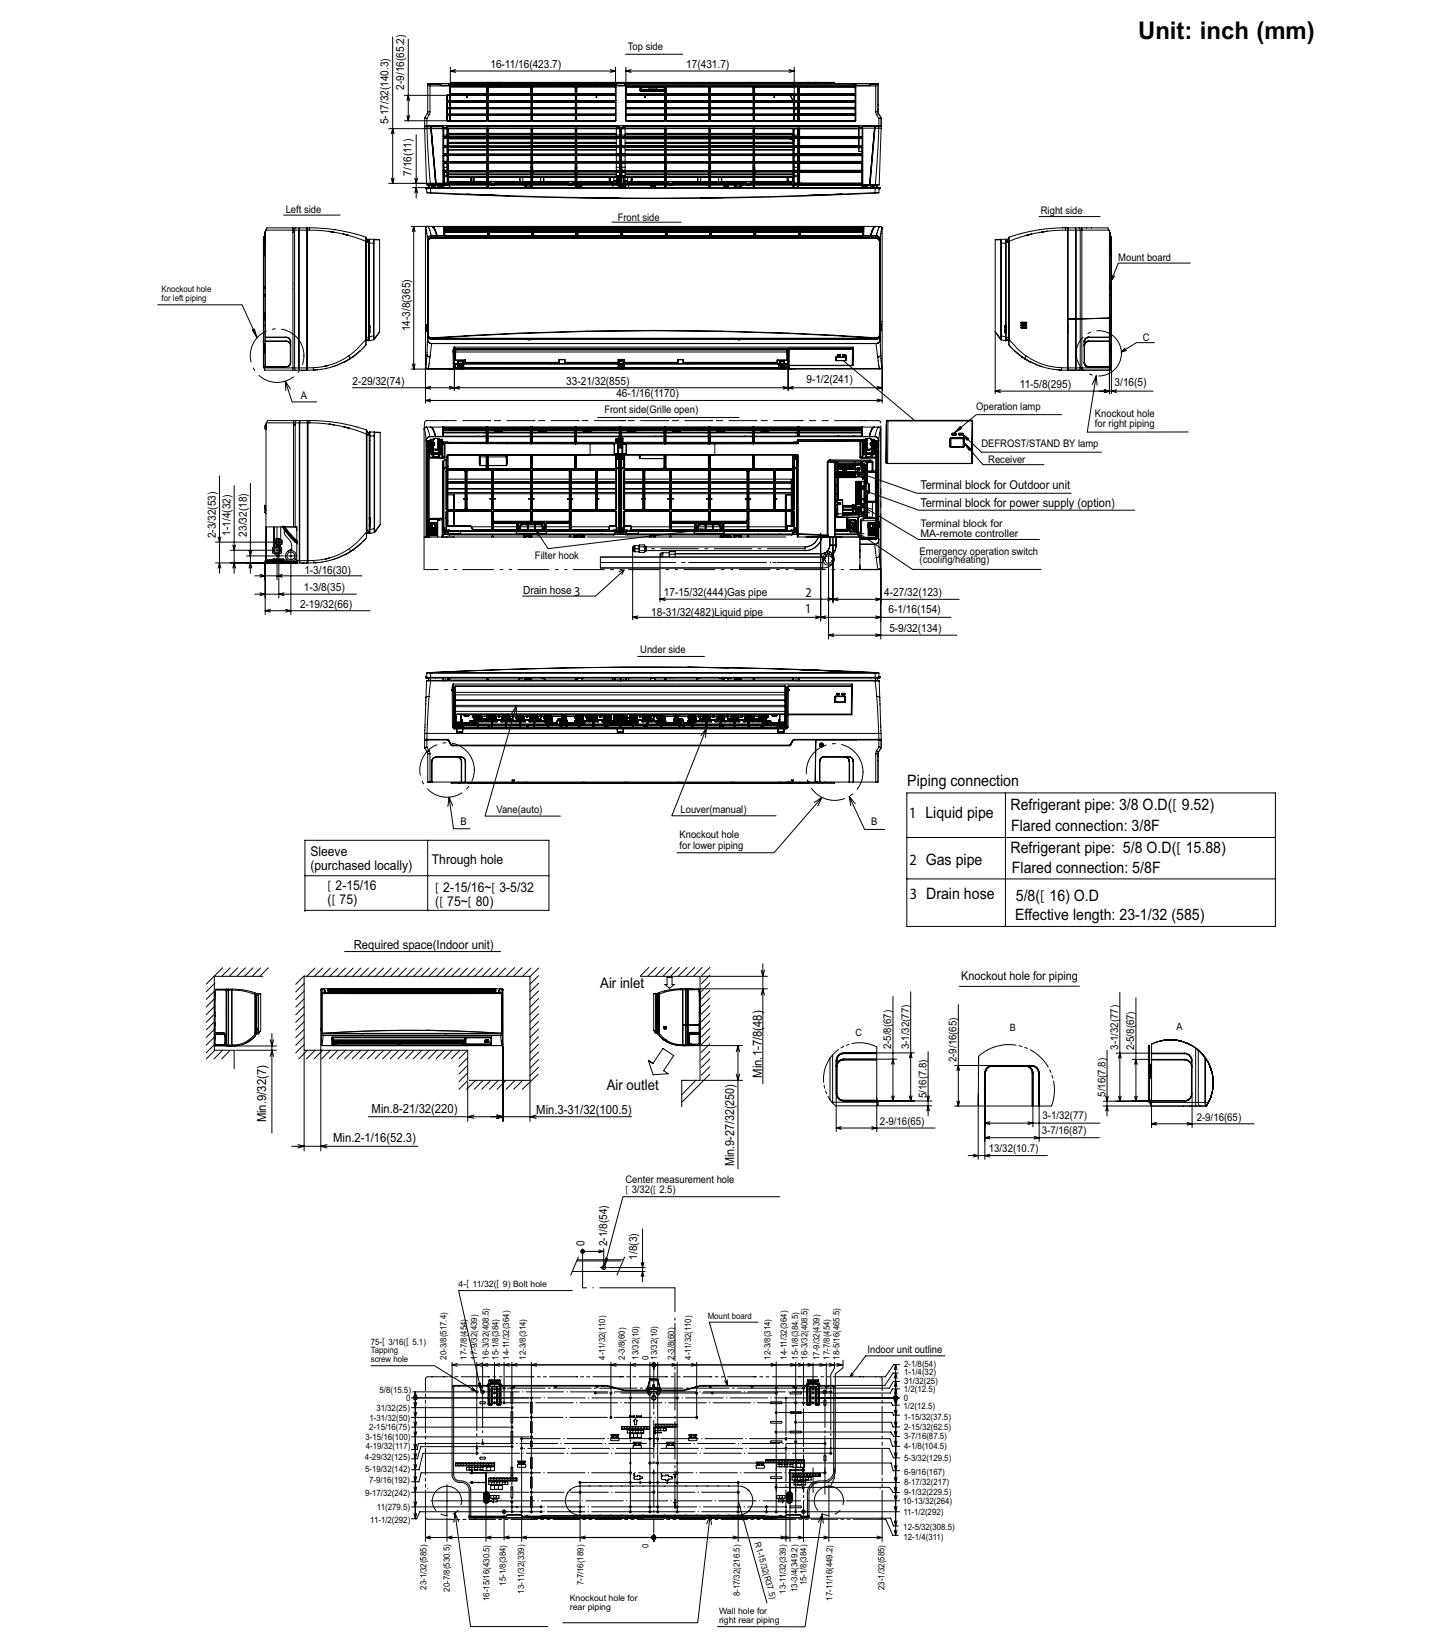

OUTDOOR UNIT DIMENSIONS: PUY-A36NKA7(-BS)

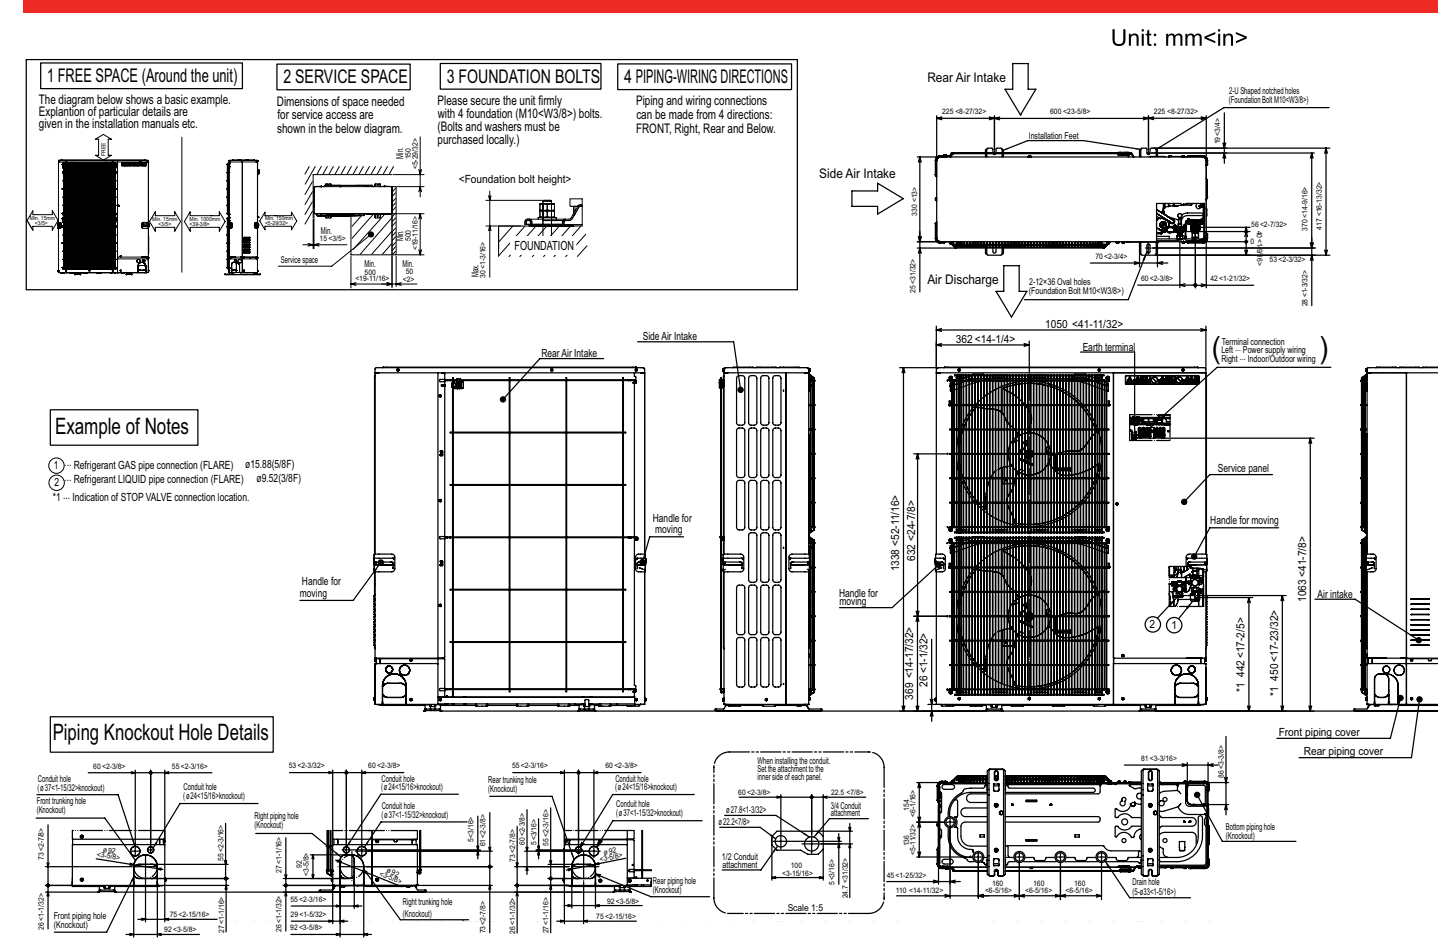

Brackets & Floor Supports

HEAVY DUTY WALL BRACKET

Heavy duty wall bracket. Supplied with screws only. CAPACITY: 440 Lbs / 200 Kg

Model	Material	Dimension (mm) (AxB)	Dimension (inch)(AxB)	Pallet/Ctn (pcs)
B530	Gal. Steel	520x400	20 1/2" x 15 3/4"	117

WALL BRACKET WITHOUT BAR

Wall bracket without bar. Supplied with screws, washers, & anchors. CAPACITY: 300 Lbs / 140 Kg

Model	Material	Dimension (mm) (AxB)	Dimension (inch)(AxB)	Pallet/Ctn (pcs)
B540	Gal. Steel	605x400	23 7/8" x 15 3/4"	117

ADJUSTABLE WALL BRACKET WITH BAR

Adjustable wall bracket with bar. Supplied with screws, washers, & anchors. CAPACITY: 660 Lbs / 300 Kg

Model	Material	Dimension (mm) (AxBxC)	Dimension (inch)(AxBxC)	Pallet/Ctn (pcs)
B530A-KR208	Gal. Steel	520x400x60	20 1/2" x 15 3/4" x 2 3/8"	117



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Engineering	Public Works
Fire	Traffic

REGISTRATION:

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1	11-07-2022	MECHANICAL PERMIT SET

DESIGNED: HBS
 DRAWN: HBS
 CHECKED: JWG
 JOB NO: 123130-001
 ISSUED ON:
 SHEET TITLE:

**DETAIL AND
 AND EQUIPMENT DATA
 SHEET**

SHEET NUMBER:
S-001