

PRCTI20221628

City of Puyallup **Development & Permitting Services ISSUED PERMIT** Building Planning **Public Works** Engineering Traffic Fire

APPROVED PLAN CITY OF PUYALLUP PLANNING DIVISION APPROVED BY: GClark DATE: 10/31/2022

CASE NO.: PRCTI20221628

CONDITIONS:

Engineering APPROVED See permit for additional requirements. Linda Lian 10/31/2022 7:57:09 AM

City of Puyallup

Developmen

www.sgadesigngroup.com STATE OF WASHINGTON 10/14/2022

SGA Design Group, P.C.

437 South Boulder, Suite 550

Tulsa, Oklahoma 74119.3609

p: 918.587.8600 f. 918.587.8601

PROJECT LOCATION:

3511 5TH ST SE, PUYALLUP, WA 98374

LOME'S RESTROOM REMODEL

PUYALLUP, WA

PROJECT DIRECTORY

SGA DESIGN GROUP, P.C. ARCHITECT 1437 S BOULDER AVE, SUITE 550 TULSA, OK 74119 (918) 587-8602 EXT.214 (918) 587-8601

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PLUMBING ENGINEER:

PROJECT MANAGER

ELECTRICAL ENGINEER:

FAX:

jmyers@pageinterworks.com PAGE INTERWORKS 923 MAIN ST NORTH WILKESBORO, NC 28659

jmyers@pageinterworks.com

GENERAL NOTES

1.a. ALL FINISHES TO BE AS NOTED & SHALL NOT HAVE SMOKE DEVELOPED RATINGS GREATER THAN 450

1.b. INTERIOR FINISHES OF WALLS & CEILINGS IN ALL ROOMS OR ENCLOSED SPACES SHALL HAVE A CLASS C FLAME SPREAD INDEX 76-200; SMOKE DEVELOPED INDEX

1.f. THE REQUIRED FLAME SPREAD OR SMOKE DEVELOPED INDEX OF SURFACES IN EXISTING BUILDINGS MAY BE ACHIEVED BY APPLICATION OF APPROVED FIRE

ALL ELECTRICAL WORK SHALL CONFORM TO LOCAL CODES. THE REQUIREMENTS OF THE NATIONAL ELECTRICAL CODE. & NFPA 72 THE CONTRACT WORK SHALL INCLUDE FURNISHING ALL MATERIALS, EQUIPMENT, TOOLS, LABOR & SERVICES NECESSARY FOR COMPLETION OF THE PROJECT. THE G.C. SHALL PERFORM ALL WORK IN CONFORMITY WITH THOSE LAWS HAVING JURISDICTION WHETHER OR NOT SUCH WORK IS SPECIFICALLY SHOWN ON THESE DRAWINGS, INCLUDING ALL SEISMIC REQUIREMENTS. THE G.C. SHALL PROCURE & PAY FOR ALL NECESSARY BUILDING PERMITS & SHALL BE REIMBURSED FOR GENERAL BUILDING PERMIT COSTS BY OWNER. BUSINESS LICENSE COSTS ARE NOT REIMBURSABLE.

THE G.C. SHALL BE RESPONSIBLE FOR THE QUALITY OF WORKMANSHIP & FOR COMPLIANCE WITH THE DESIGN. THE G.C. SHALL CORRECT ALL ERRORS & DEVIATIONS AS NO EXISTING TO REMAIN OR REFURBISHED ITEMS TO BE USED UNLESS WRITTEN AUTHORIZATION FROM LOWE'S IS RECEIVED. FIRE EXTINGUISHERS TO HAVE INSPECTION

TAG WITH INSTALLATION DATE ATTACHED. THE G.C. SHALL PROVIDE & INSTALL FIRE EXTINGUISHERS PER LOCAL FIRE MARSHALL REQUIREMENTS.

LANDLORD, MALL OR OWNER.

ALL WOOD BLOCKING, STUDS, PLYWOOD, ETC. TO BE FIRE RETARDANT. AT THE TIME OF SUBMITTING FINAL BID, THE G.C. SHALL VERIFY ALL RELEVANT DIMENSIONS, ANGLES, & EXISTING CONDITIONS BEFORE PROCEEDING WITH THE AFFECTED WORK & NOTIFY THE ARCHITECT OF ANY DISCREPANCIES IMMEDIATELY. ALL DISCREPANCIES SHALL BE RESOLVED PRIOR TO PROCEEDING WITH AFFECTED

THE G.C. SHALL CONTACT LOWE'S IMMEDIATELY IF THEY ENCOUNTER ANY HAZARDOUS MATERIALS. EXACT LOCATIONS OF PIPING, DUCTWORK, CONDUIT & FIXTURES SHALL BE COORDINATED BETWEEN CONTRACTORS & SUBCONTRACTORS TO AVOID INTERFERENCE.

. G.C. TO HIRE A LICENSED SPRINKLER CONTRACTOR TO DESIGN & INSTALL / MODIFY SPRINKLER SYSTEM. HEAD REPLACEMENT TO MEET ALL LOCAL & NATIONAL CODES EACH CONTRACTOR SHALL COORDINATE ARCHITECTURAL DRAWINGS BEFORE PROCEEDING WITH THE WORK & SHALL NOTIFY THE ARCHITECT OF ANY DISCREPANCIES OR

CONFLICTS IMMEDIATELY. ALL DISCREPANCIES SHALL BE RESOLVED PRIOR TO THE CONTRACTOR PROCEEDING WITH AFFECTED WORK. SHOULD ANY OF THE DETAILED INSTRUCTIONS ON THE DRAWINGS CONFLICT WITH THE NOTES OR SPECIFICATIONS OR WITH EACH OTHER, THE STRICTEST PROVISION ADDITIONAL WORK, IF APPLICABLE, MUST BE AUTHORIZED IN WRITING BY BOTH THE LOWE'S CONSTRUCTION PROJECT MANAGER & ARCHITECT AFTER THE FORMAL

REQUEST FOR INFORMATION (RFI) PROCESS HAS BEEN COMPLETED (GC ISSUES AN RFI TO THE ARCHITECT, IF THE CLARIFICATIONS AND / OR SUPPLEMENTAL INFORMATION INVOLVE AN ADJUSTMENT IN THE CONTRACT SUM, THE ARCHITECT SHALL ISSUE A WORK CHANGE PROPOSAL REQUEST TO THE G.C. TO OBTAIN PRICE QUOTATIONS NEEDED FOR NEGOTIATING CHANGES IN THE CONTRACT FOR CONSTRUCTION). JOB SITE CLEANING: DURING DEMOLITION & CONSTRUCTION, THE JOB SITE & BUILDING INTERIOR SHALL BE CLEANED ON A DAILY BASIS, INCLUDING REMOVAL OF TRASH, RUBBLE, DEBRIS & ORGANIZATION OF MATERIALS & EQUIPMENT. UPON COMPLETION OF THE WORK, THE JOB SITE & BUILDING INTERIOR SHALL BE THOROUGHLY CLEANED,

INCLUDING ALL AREAS OF THE BUILDING MADE DIRTY BY CONSTRUCTION WORK. THE G.C. SHALL REMOVE TRASH, RUBBLE, TOOLS, EQUIPMENT & EXCESS MATERIALS FROM THE PREMISES. THE BUILDING IS TO BE LEFT IN PERFECTLY CLEAN CONDITION G.C. IS TO PROVIDE SUPERVISION OF ALL TRADES / SUBS (INCLUDING THOSE HIRED BY LOWE'S) AS WELL AS ON-SITE SUPERVISION UNTIL JOB IS FINISHED. G.C. IS REQUIRED TO HAVE 30-YARD DUMPSTERS AVAILABLE DURING CONSTRUCTION & THROUGH THE FIXTURE INSTALL PROCESS, AT A LOCATION APPROVED BY THE

LOWE'S RESTROOM REMODEL PROJECTS REQUIRE THE USE OF PORTABLE RESTROOM TRAILERS. CONTACT: ROYAL RESTROOMS-EMERSON WATERS - 866-652-3255 OR COMFORT ZONE PORTABLES - 770-772-8066

ALTERNATIVE SERVICE PROVIDERS MAY BE UTILIZED HOWEVER MUST BE PRE-APPROVED BY LOWE'S PROJECT MANAGER

SINGLE TRAILER WITH ADA FACILITIES REQUIIRED AS A STANDARD MINIMUM. LOWE'S PROJECT MANAGER TO REVIEW TIME OF YEAR AND SALES VOLUME WITH THE STORE MANAGER TO DETERMINE IF ONE OR TWO TRAILERS WILL BE REQUIRED. CONTRACTOR TO COORDINATE WITH LOWE'S PROJECT MANAGER FOR SITE SPECIFIC REQUIREMENTS.

LOWE'S PROJECT MANAGER TO COORDINATE WITH STORE PERSONNEL TO PROVIDE DAILY CLEANING OF TEMPORARY RESTROOMS. CONTRACTOR TO COORDINATE AND MANAGE ALL SERVICE AND DISPOSAL PROCESSES FOR TEMPORARY RESTROOMS.

CODE AND BUILDING DATA

PROJECT SCOPE:

FULL REMODEL IN CUSTOMERS RESTROOM BY UPDATING PLUMBING FIXTURES, RESTROOM PARTITIONS, WALL FINISHES, AND FLOOR FINISHES. ALL MECHANICAL, ELECTRICAL, PLUMBING SYSTEMS, & SPRINKLER SYSTEM ARE EXISTING TO REMAIN. ALL EGRESS DOORS / INTERIOR

2018 INTERNATIONAL BUILDING CODE W/ WA AMENDMENTS 2018 WASHINGTON STATE ENERGY CODE W/ WA AMENDMENTS MECHANICAL CODE: 2018 INTERNATIONAL MECHANICAL CODE W/ WA AMENDMENT ELECTRICAL CODE: 2020 NATIONAL ELECTRICAL CODE W/ WA AMENDMENTS PLUMBING CODE: 2018 INTERNATIONAL PLUMBING CODE W/ WA AMENDMENTS 2018 INTERNATIONAL FIRE CODE W/ WA AMENDMENTS ACCESSIBILITY CODE: 2009 ICC ANSI 117.1 & CHAPTER 11 OF WASHINGTON BUILDING CODE

USE AND OCCUPANCY CLASSIFICATION: M - MERCANTILE - USE EXISTING TO REMAIN

CONSTRUCTION CLASSIFICATION (TYPE):

(EXISTING, TO REMAIN UNCHANGED)

V-B - FULLY SPRINKLERED FIRE-RESISTANCE RATING REQUIRED PER SITE SPECIFIC LOCATION: STRUCTURAL FRAME:

EXTERIOR BEARING WALLS: INTERIOR BEARING WALLS / COLUMNS: 0 HOURS INTERIOR NON-BEARING WALLS: FLOOR CONSTRUCTION: 0 HOURS ROOF CONSTRUCTION:

 $^{ exttt{I}}$ ALLOWABLE HEIGHT and BUILDING AREAS: (EXISTING, TO REMAIN UNCHANGED)

ALLOWABLE AREA: UNLIMITED

ALLOWABLE HEIGHT: 75'-0" ACTUAL HEIGHT: 28'-8" AT FRONT PARAPET, 47'-4" AT MAIN ENTRY PARAPET

OCCUPANT LOAD:

(EXISTING, TO REMAIN UNCHANGED) GROSS AREA OF BUILDING: 153,464 SQ. FT

60 SQ. FT./OCC. (GROSS) 107,567 SQ. FT./60 1,793 OCCUPANTS (GROSS AREA) OFFICE AREA 150 SQ. FT./OCC. (GROSS) 3,937 SQ. FT./100 39 OCCUPANTS STOCK/RECEIVING AREA 300 SQ. FT/OCC. (GROSS) 9,177 SQ. FT./300 31 OCCUPANTS 150 SQ. FT/OCC. (GROSS) 1,378 SQ. FT./300 5 OCCUPANTS 300 SQ. FT/OCC. (GROSS) 16,072 SQ. FT/300

15,333 SQ. FT/60

153,464 SQ. FT.

256 OCCUPANTS

2,178 OCCUPANTS

¹ EGRESS REQUIREMENTS:

GARDEN CENTER

(EXISTING, TO REMAIN UNCHANGED)

REQUIRED EGRESS WIDTH: 2178 X 0.20 = 435.6" PROVIDED EGRESS WIDTH: MINIMUM NUMBER OF EXITS (SALES AREA): 4 EXITS PROVIDED NUMBER OF EXITS (SALES AREA): 16 EXITS

60 SQ. FT/OCC. (GROSS)

REQUIRED EXIT ACCESS TRAVEL DISTANCE: 250' MAX TRAVEL DISTANCE PROVIDED EXIT ACCESS TRAVEL DISTANCE: LESS THAN 250' TRAVEL DISTANCE

PLUMBING FIXTURE REQUIREMENTS:

(EXISTING, TO REMAIN UNCHANGED) WATER CLOSET (MEN) 1/500 OCC. (PER APP. CODE) 4 (PER APP. CODE) WATER CLOSET (WOMEN) 1/500 OCC. (PER APP. CODE) 4 (PER APP. CODE) 1/750 OCC. (PER APP. CODE) 3 (PER APP. CODE)

THE EMPLOYEE BREAK ROOM.

LAVATORIES (WOMEN) 1/750 OCC. (PER APP. CODE) 3 (PER APP. CODE) *WHERE MORE THAN (2) DF'S ARE REQUIRED, A WATER COOLER CAN BE PROVIDED IN


EXITING IS NOT BEING AFFECTED AND WILL REMAIN THE SAME

DRAWING INDEX

SHEET INDEX ARCHITECTURAL DRAWINGS C0.1 COVER SHEET A1.0 ACCESSIBILITY DETAILS A1.1 | RESTROOM FLOOR PLANS & ELEVATIONS PLUMBING DRAWINGS DEMOLITION PLUMBING RESTROOM REMODEL **ELECTRICAL DRAWINGS** LIGHTING/POWER PLAN RESTROOM REMODEL

> C0.1: Provide site plan with location of temporary portable restroom and indicate total number to be provided.

VICINITY MAP

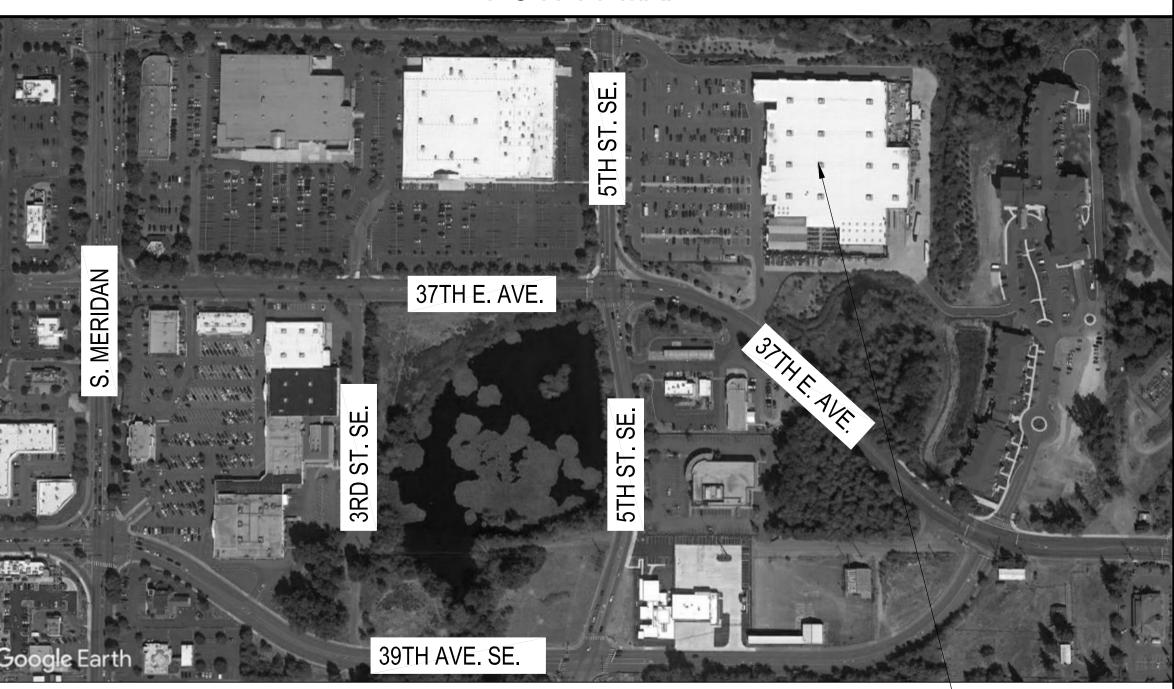


N Imagery @ 2020 Google, Map data @ 2022 Google

PROJECT LOCATION

REVISIONS

PRE-BID SET POST BID SET ISSUE DATE DATE DESCRIPTION

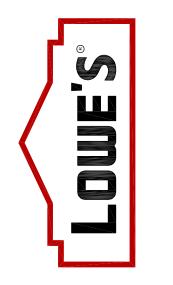

PROJECT NUMBER:

PROJECT LOCATION:


ISSUE DATE:

10.14.22 VGH

SHEET TITLE:

COVER SHEET

SHEET NUMBER:

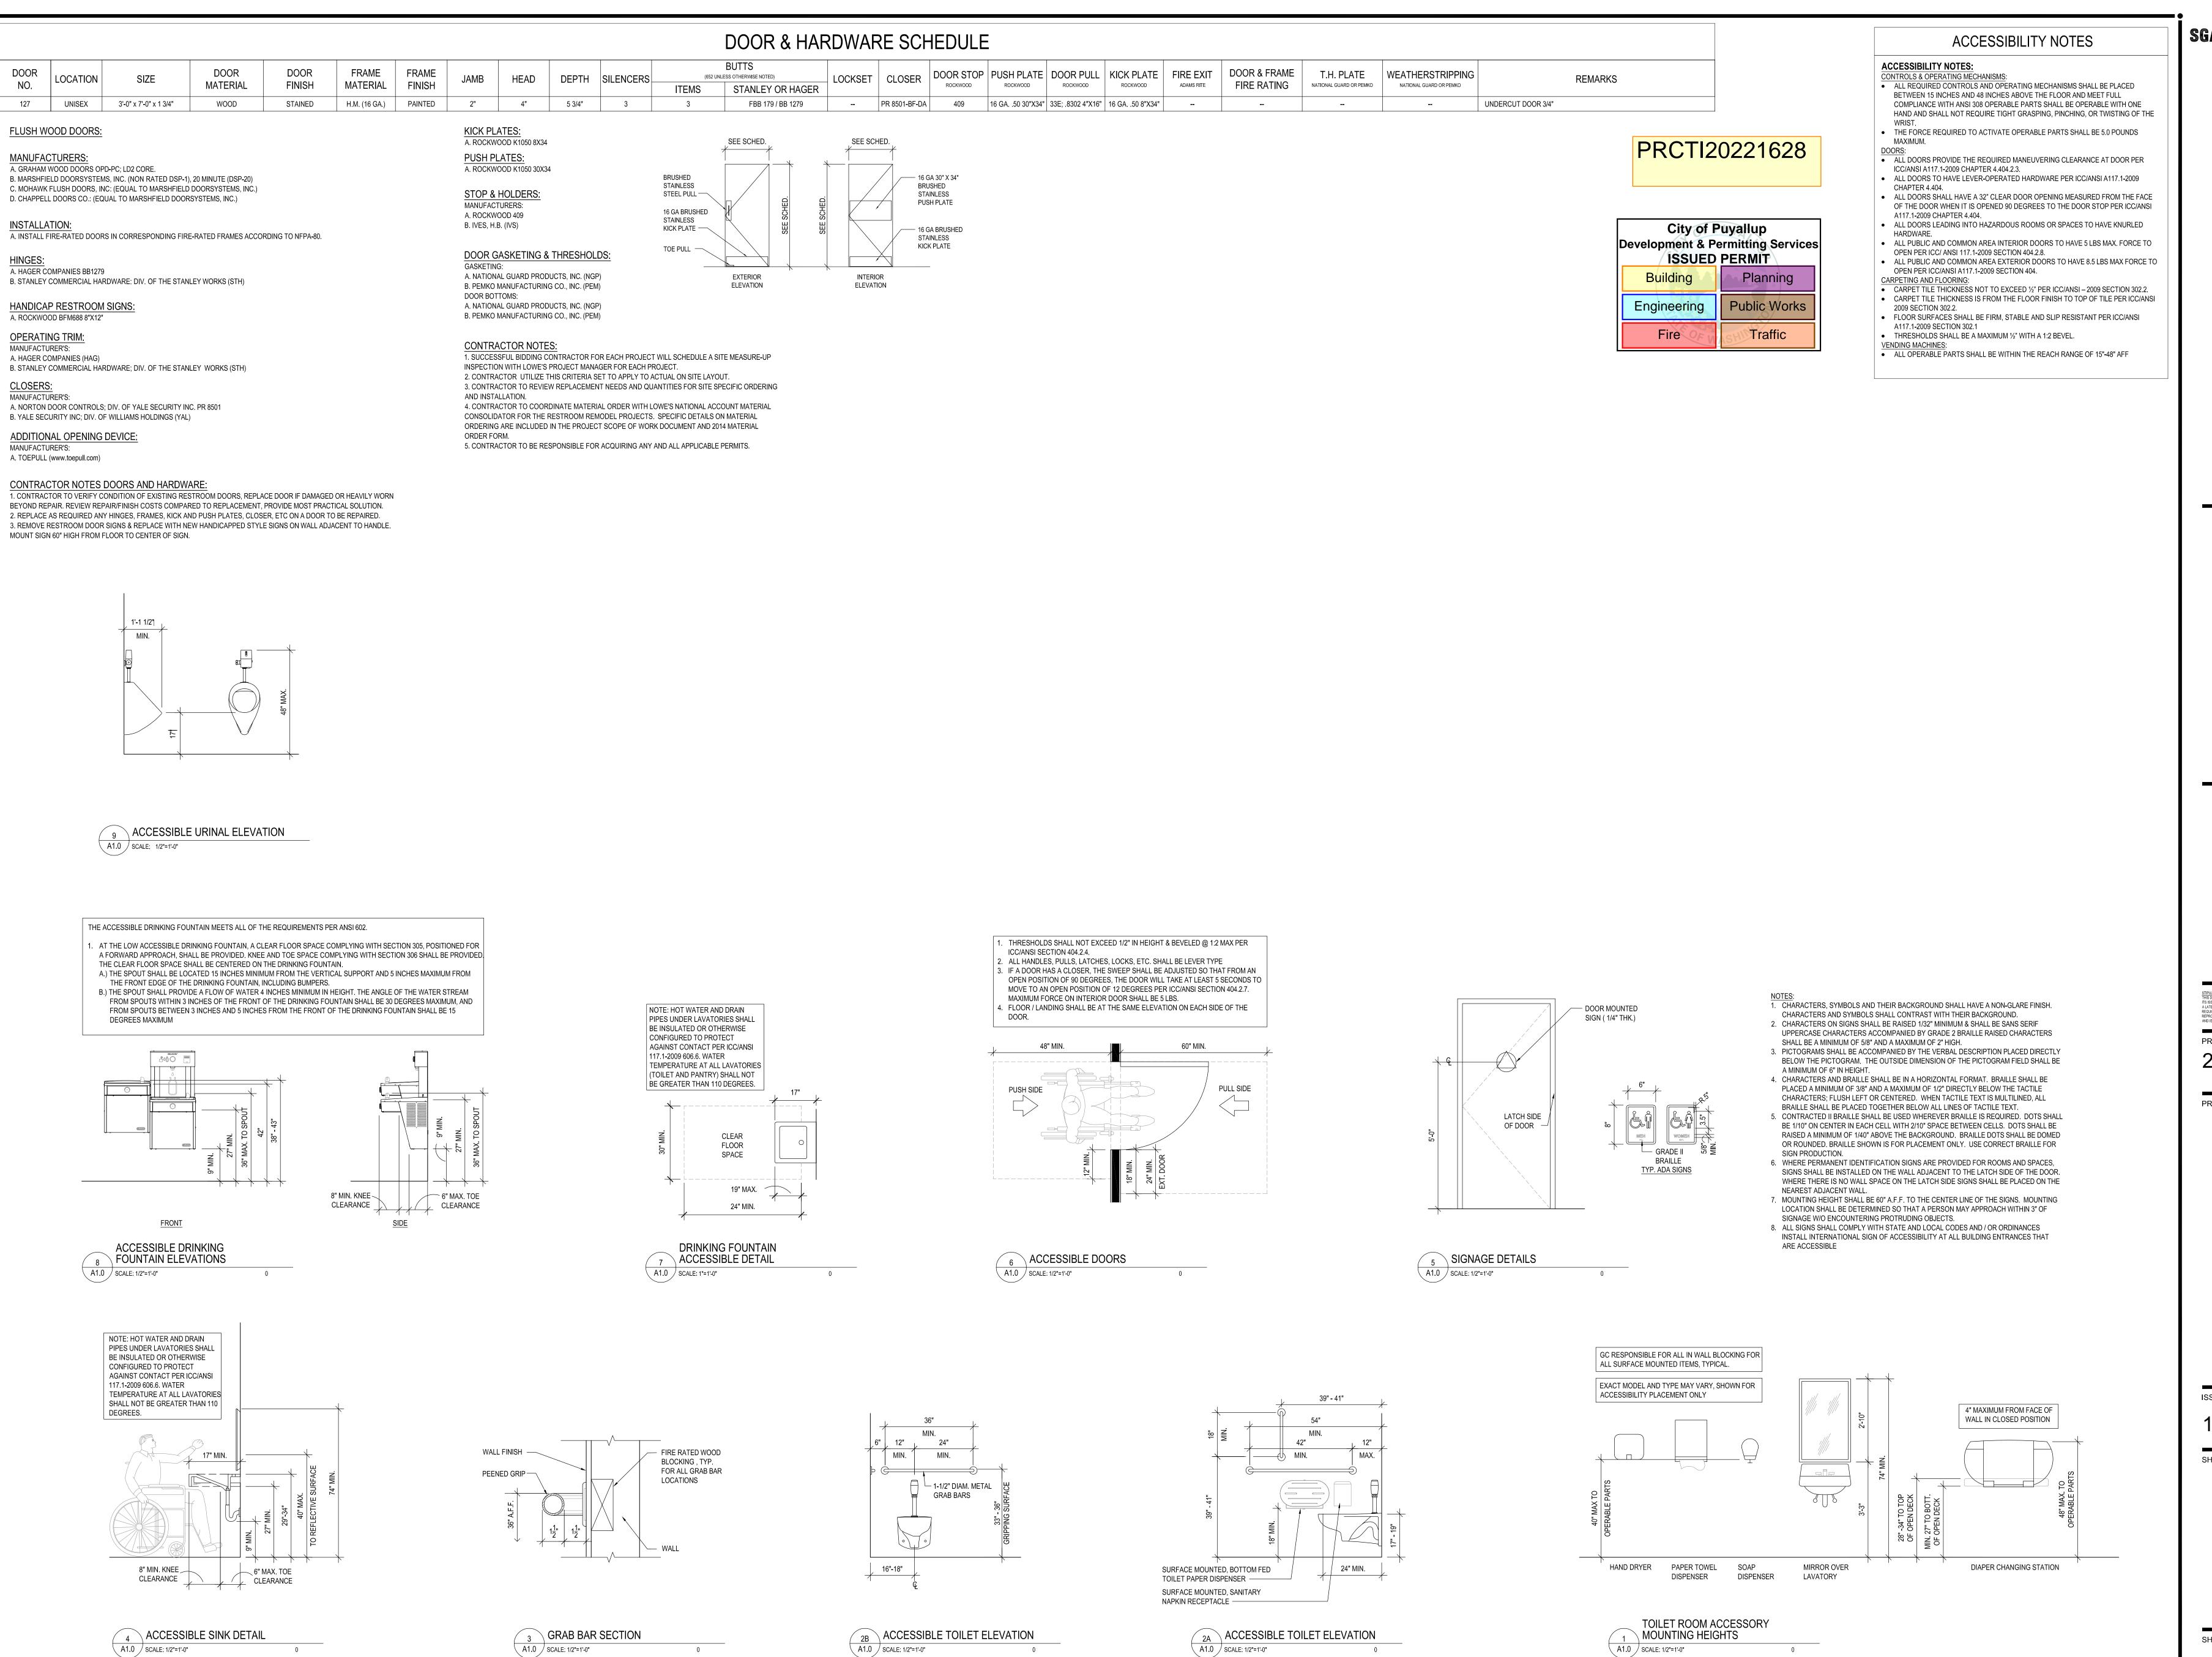

GA Design Group, P.C. \S

1437 South Boulder, Suite 550 Tulsa, Oklahoma 74119.3609 p: 918.587.8600 f: 918.587.8601 www.sgadesigngroup.com

REGISTERED ARCHITECT,
MITCHEL RAY GARRETT STATE OF WASHINGTON

REVISIONS

PRE-BID SET POST BID SET ISSUE DATE

DATE DESCRIPTION

STIPULATION FOR REUSE
THIS DRAWING WAS PREPARED FOR USE ON A SPECIFIC SITE CONTEMPORANEOUSLY WIT
ITS ISSUE DATE ON AND IT IS NOT SUITABLE FOR USE ON A DIFFERENT PROJECT SITE OR.
A LATER TIME. USE OF THIS DRAWING FOR REFERENCE OR EXAMPLE ON ANOTHER PROJE
REQUIRES THE SERVICES OF PROPERLY LICENSED ARCHITECTS AND ENGINEERS.
REPRODUCTION OF THIS DRAWING FOR REUSE ON ANOTHER PROJECT IS NOT AUTHORIZE
AND IS CONTRARY TO THE LAW.

PROJECT NUMBER: 2219006

PROJECT LOCATION:

511 5TH ST SE UYALLUP, WA 983

LCCUE DATE:

10.14.22


SHEET TITLE:

ACCESSIBILITY

DETAILS

SHEET NUMBER:

11

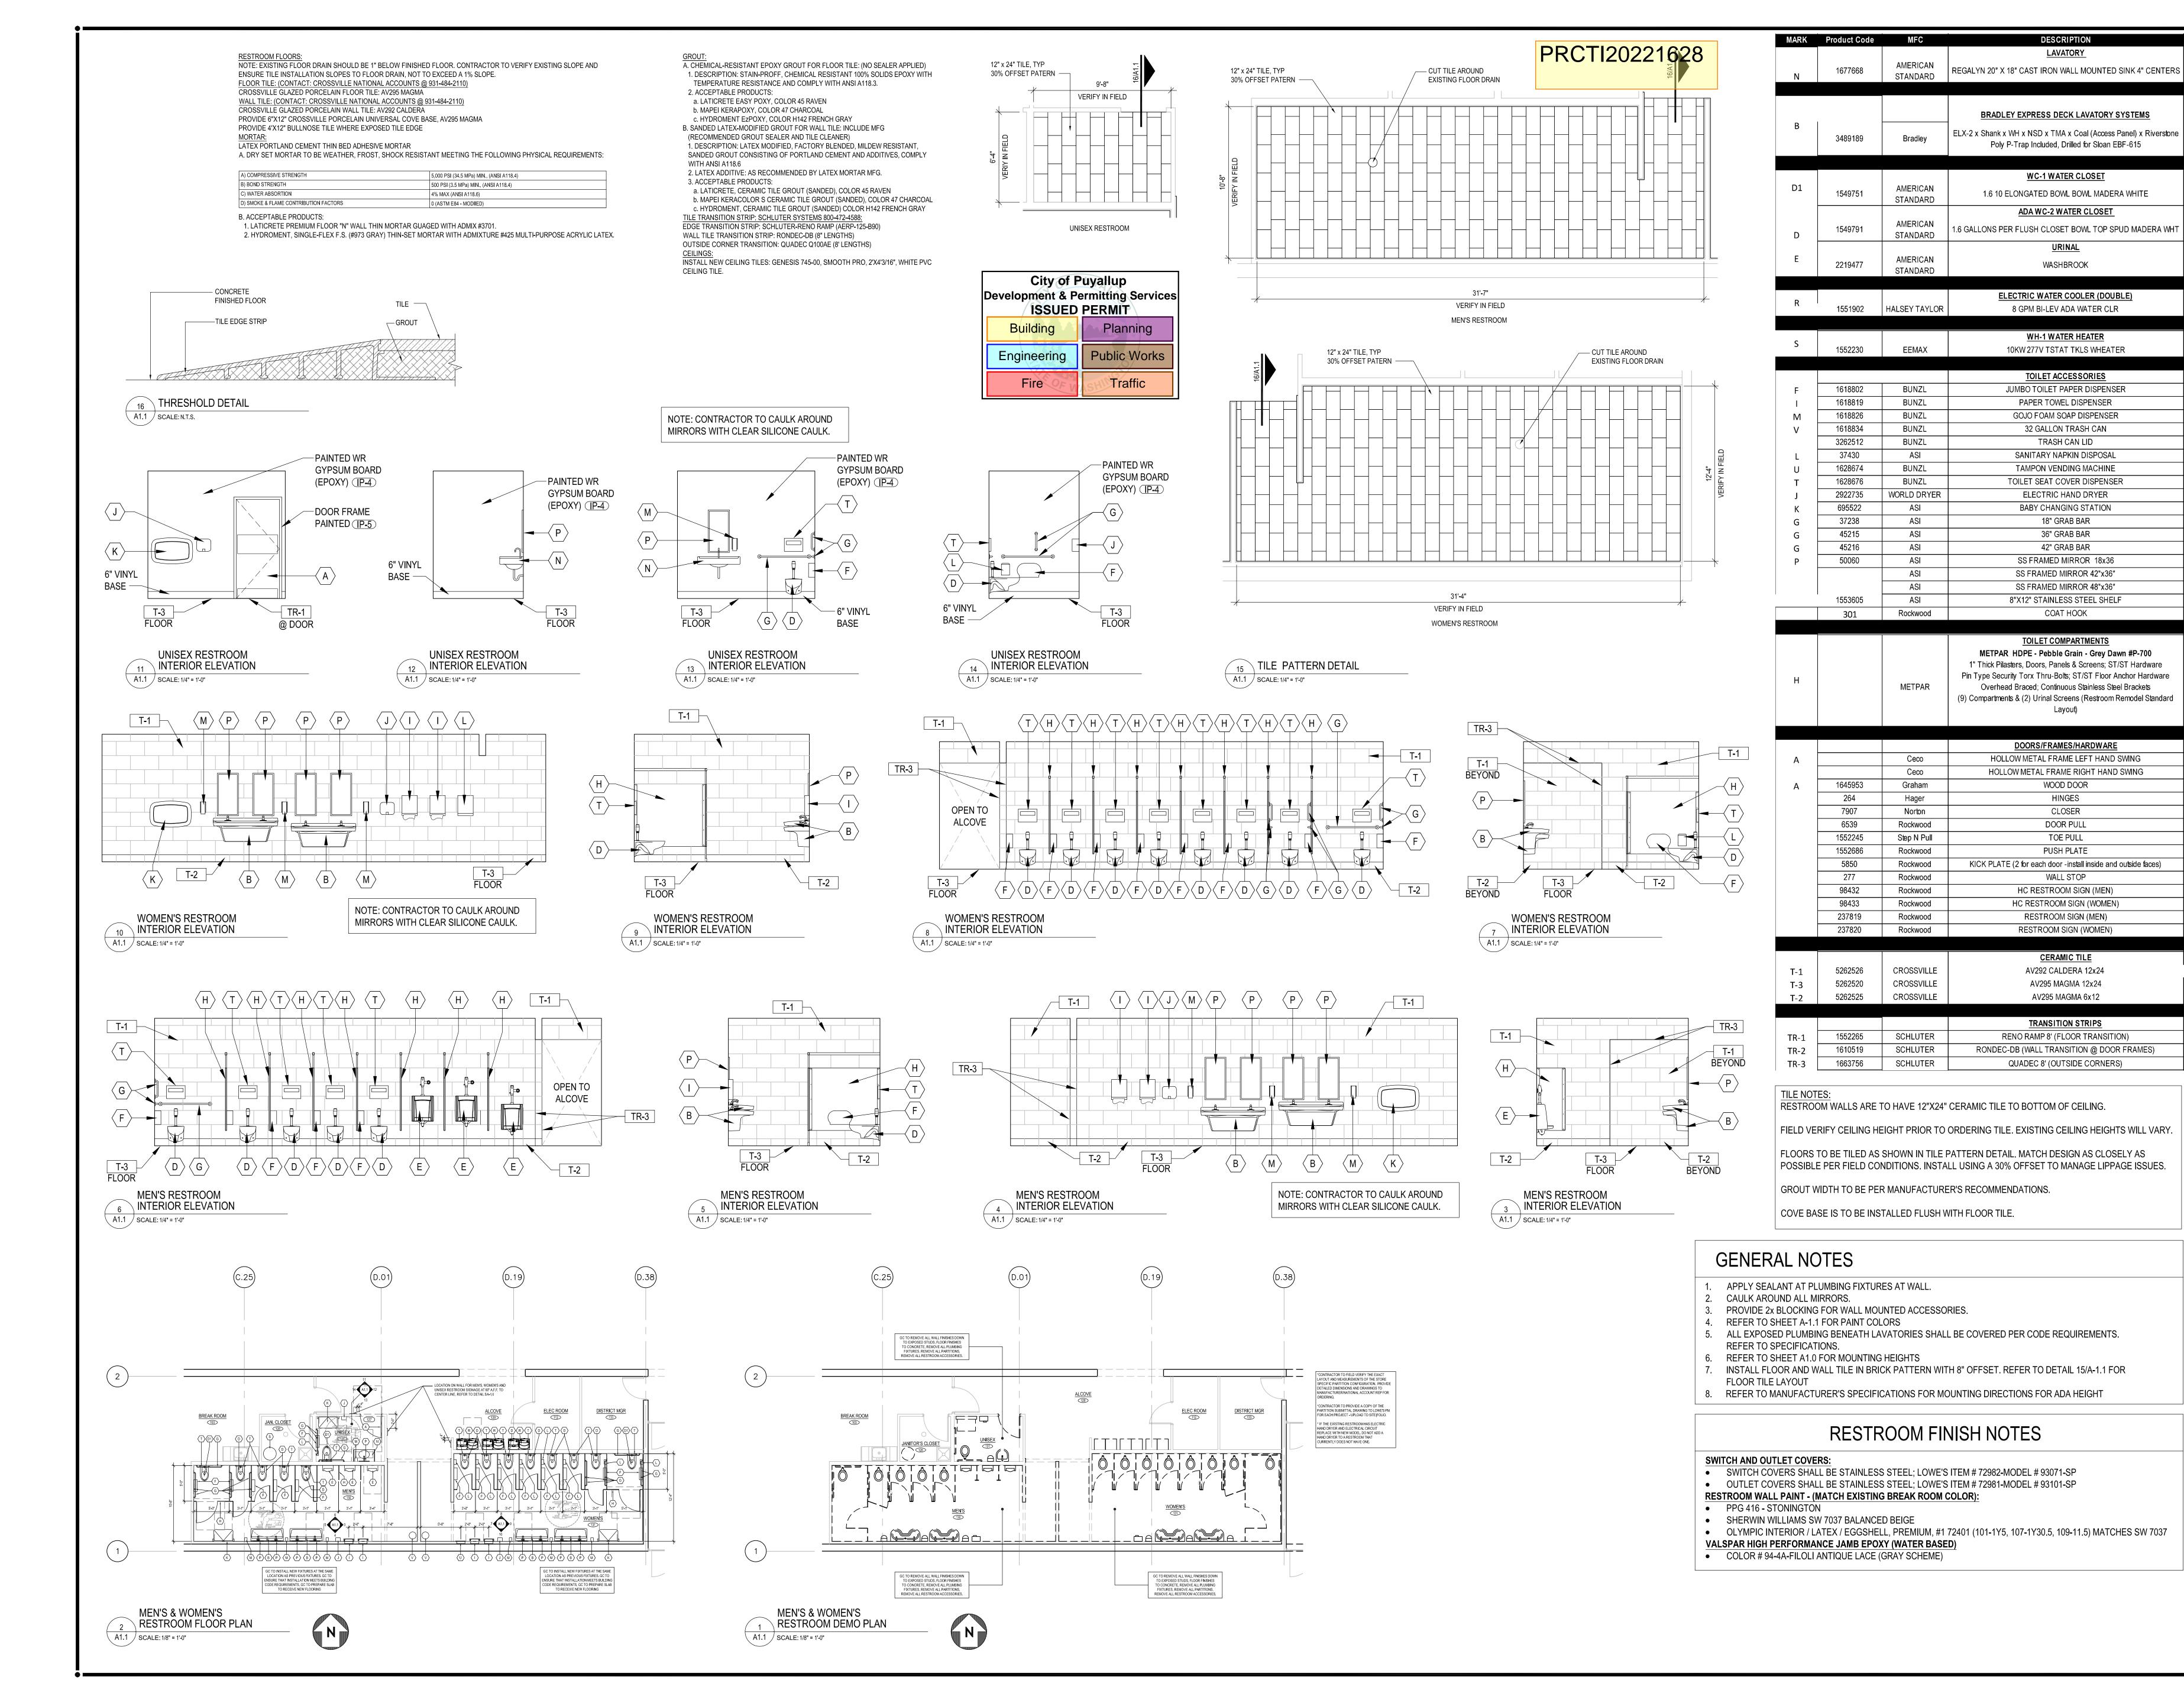

1437 South Boulder, Suite 550 Tulsa, Oklahoma 74119.3609 p: 918.587.8600 f: 918.587.8601 www.sgadesigngroup.com

ARCHITECT/ MITCHEL RAY GARRETT STATE OF WASHINGTON 10/14/2022

REVISIONS PRE-BID SET POST BID SET ISSUE DATE DATE DESCRIPTION

PROJECT NUMBER: 2219006

PROJECT LOCATION:

9837

ISSUE DATE:


10.14.22

SHEET TITLE:

RESTROOM

FLOOR PLANS & ELEVATIONS

SHEET NUMBER:

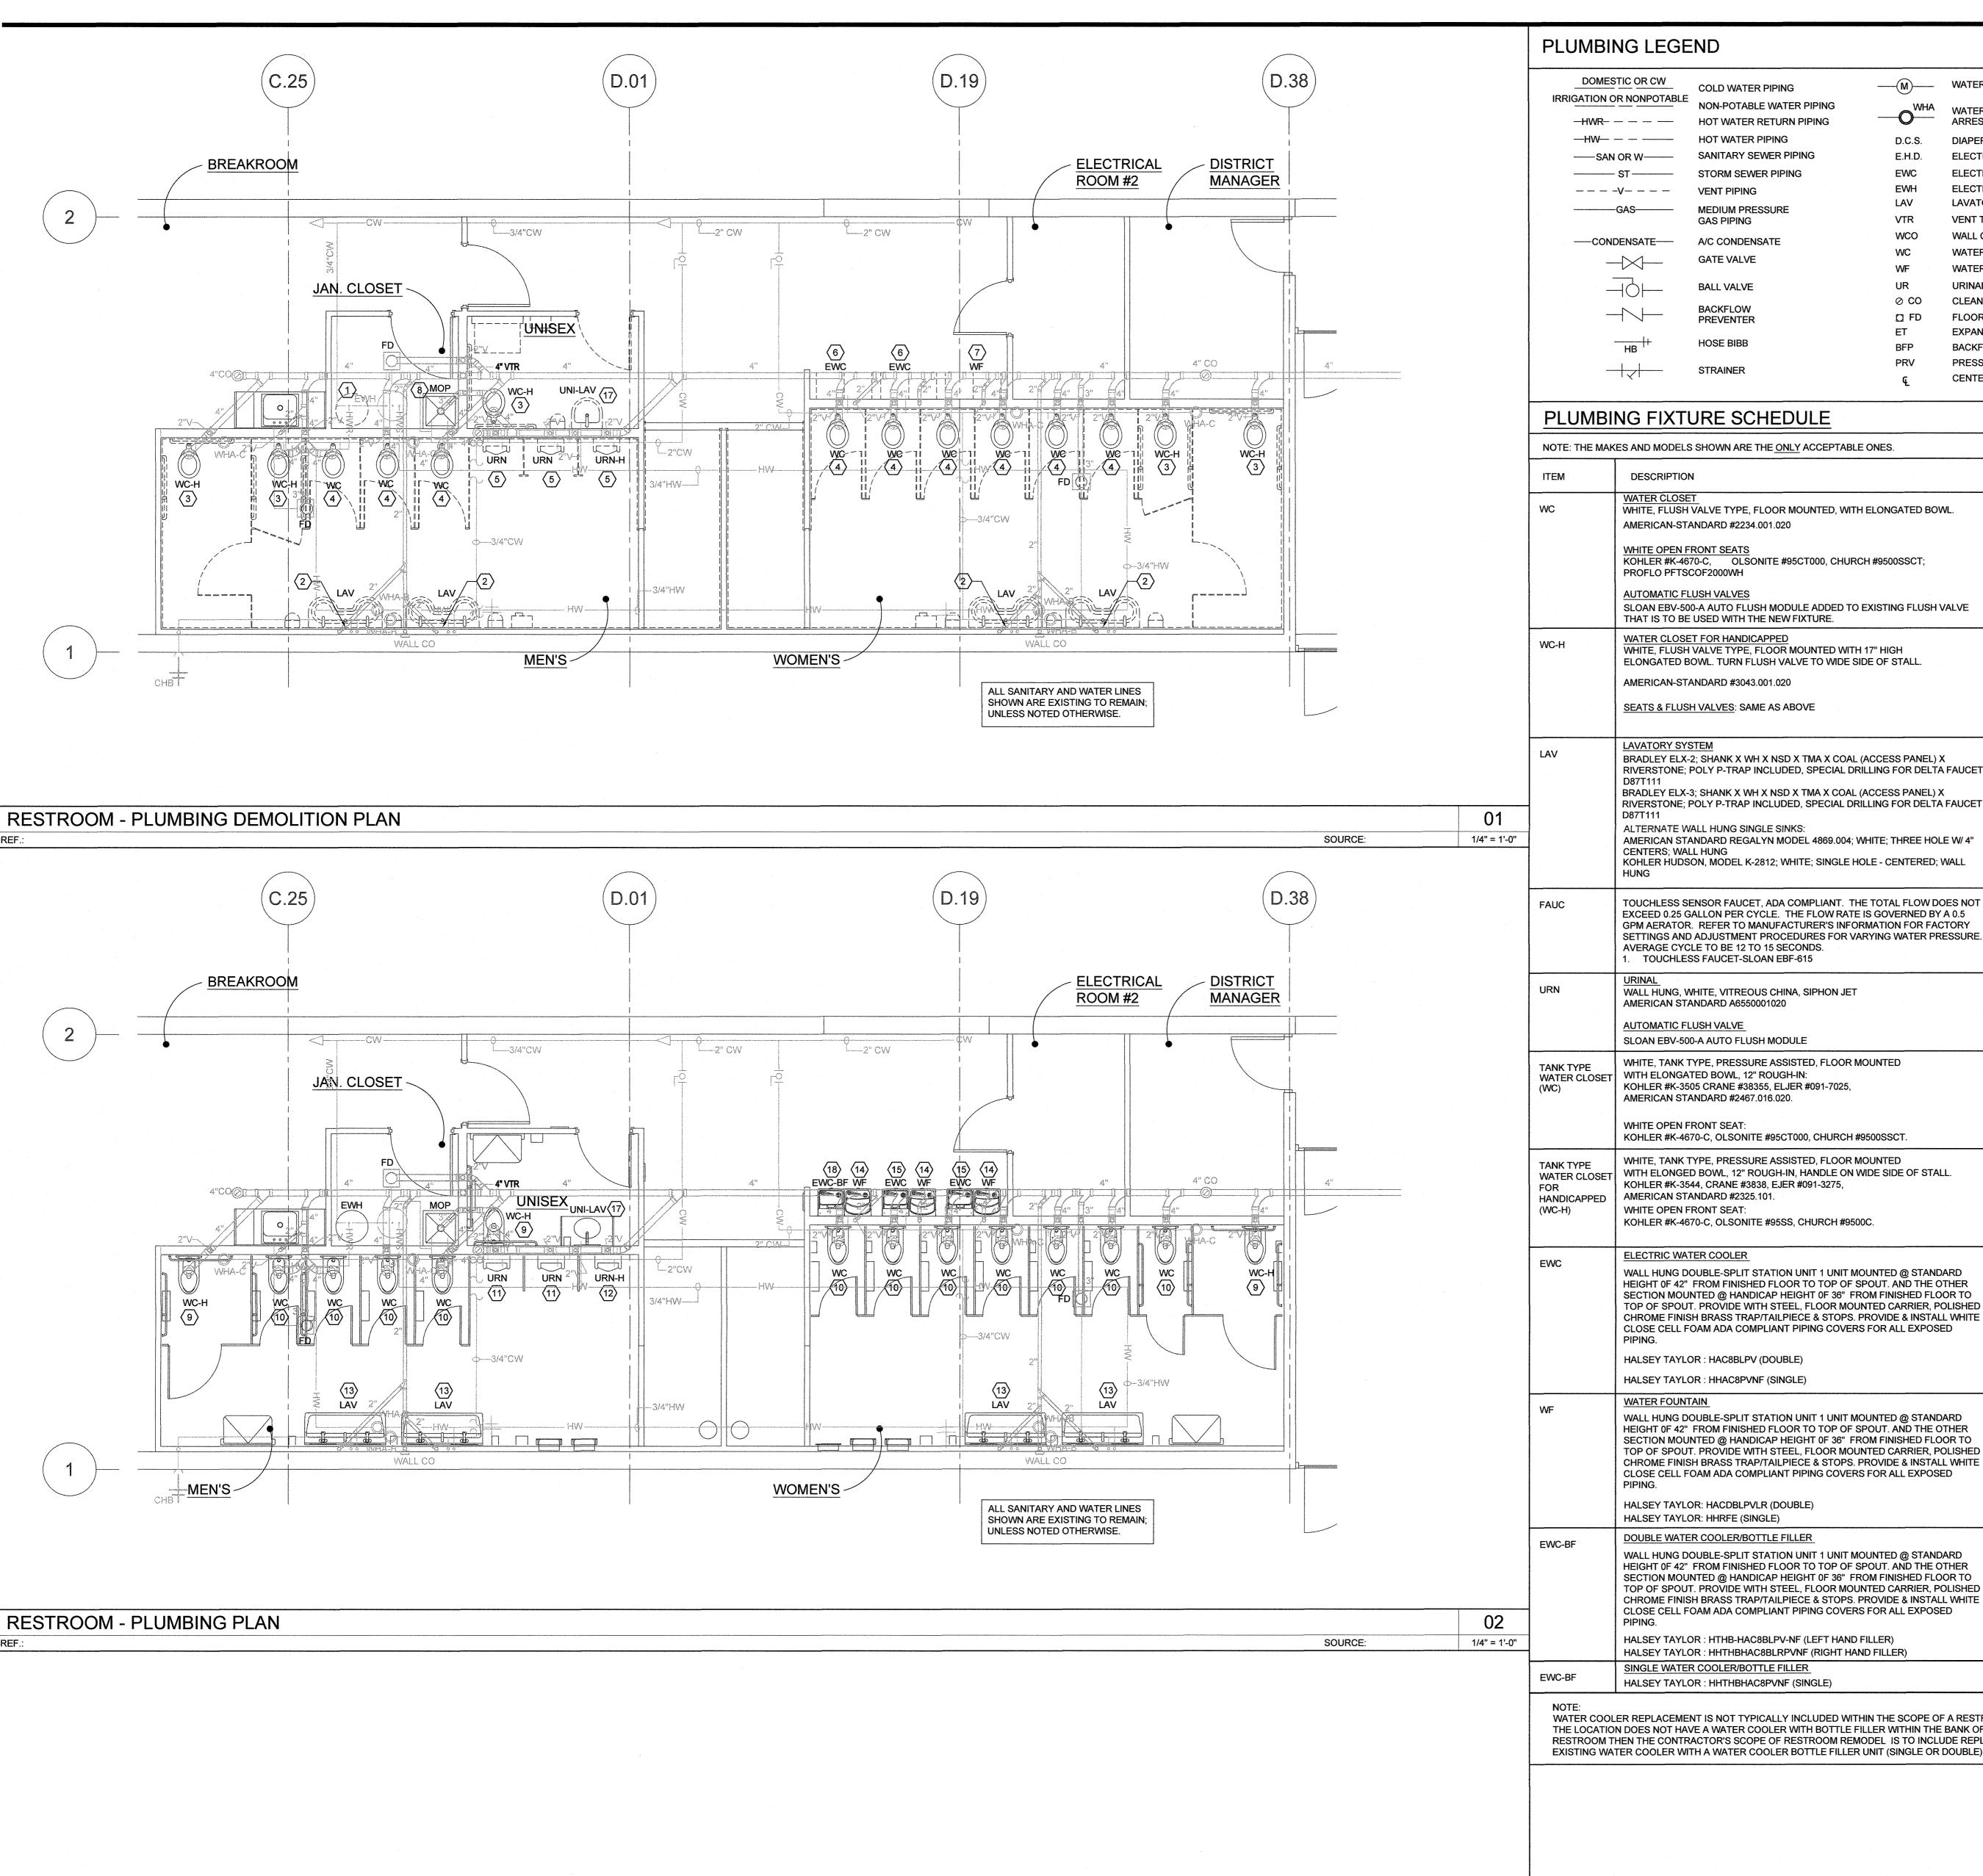

DOMESTIC OR CW IRRIGATION OR NONPOTABLE	COLD WATER PIPING	(M)	WATER METER
IRRIGATION OF NONPOTABLE	NON-POTABLE WATER PIPING	WHA	WATER HAMMER
-HWR	HOT WATER RETURN PIPING	—O—	ARRESTOR
—HW— — — —	HOT WATER PIPING	D.C.S.	DIAPER CHANGING STATION
SAN OR W	SANITARY SEWER PIPING	E.H.D.	ELECTRIC HAND DRYER
ST	STORM SEWER PIPING	EWC	ELECTRIC WATER COOLER
	VENT PIPING	EWH	ELECTRIC WATER HEATER
GAS	MEDIUM PRESSURE	LAV	LAVATORY
S/10	GAS PIPING	VTR	VENT THRU ROOF
——CONDENSATE——	A/C CONDENSATE	WCO	WALL CLEANOUT
N 4	GATE VALVE	WC	WATER CLOSET
		WF	WATER FOUNTAIN
	BALL VALVE	UR	URINAL
	BACKFLOW	⊘ CO	CLEAN OUT (PLUG FOR CONDENSATE)
	PREVENTER	□ FD	FLOOR DRAIN WITH TRAP PRIMER
		ET	EXPANSION TANK
HB +	HOSE BIBB	BFP	BACKFLOW PREVENTER
	STRAINER	PRV	PRESSURE RELIEF VALVE
1 < 1		Œ.	CENTER LINE

PLUMBING FIXTURE SCHEDULE

ALTERNATE WALL HUNG SINGLE SINKS:

NOTE: THE MAKES AND MODELS SHOWN ARE THE <u>ONLY</u> ACCEPTABLE ONES. DESCRIPTION WHITE, FLUSH VALVE TYPE, FLOOR MOUNTED, WITH ELONGATED BOWL. AMERICAN-STANDARD #2234.001.020 KOHLER #K-4670-C, OLSONITE #95CT000, CHURCH #9500SSCT; PROFLO PFTSCOF2000WH AUTOMATIC FLUSH VALVES SLOAN EBV-500-A AUTO FLUSH MODULE ADDED TO EXISTING FLUSH VALVE THAT IS TO BE USED WITH THE NEW FIXTURE. WATER CLOSET FOR HANDICAPPED WHITE, FLUSH VALVE TYPE, FLOOR MOUNTED WITH 17" HIGH ELONGATED BOWL. TURN FLUSH VALVE TO WIDE SIDE OF STALL. AMERICAN-STANDARD #3043.001.020 SEATS & FLUSH VALVES: SAME AS ABOVE BRADLEY ELX-2; SHANK X WH X NSD X TMA X COAL (ACCESS PANEL) X RIVERSTONE; POLY P-TRAP INCLUDED, SPECIAL DRILLING FOR DELTA FAUCET BRADLEY ELX-3; SHANK X WH X NSD X TMA X COAL (ACCESS PANEL) X RIVERSTONE; POLY P-TRAP INCLUDED, SPECIAL DRILLING FOR DELTA FAUCET

	ALTERNATE WALL HUNG SINGLE SINKS: AMERICAN STANDARD REGALYN MODEL 4869.004; WHITE; THREE HOLE W/ 4" CENTERS; WALL HUNG KOHLER HUDSON, MODEL K-2812; WHITE; SINGLE HOLE - CENTERED; WALL HUNG				·	
FAUC	TOUCHLESS SENSOR FAUCET, ADA COMPLIANT. THE TOTAL FLOW DOES NOT EXCEED 0.25 GALLON PER CYCLE. THE FLOW RATE IS GOVERNED BY A 0.5 GPM AERATOR. REFER TO MANUFACTURER'S INFORMATION FOR FACTORY SETTINGS AND ADJUSTMENT PROCEDURES FOR VARYING WATER PRESSURE. AVERAGE CYCLE TO BE 12 TO 15 SECONDS. 1. TOUCHLESS FAUCET-SLOAN EBF-615		AGE			
URN	URINAL WALL HUNG, WHITE, VITREOUS CHINA, SIPHON JET AMERICAN STANDARD A6550001020	1"	<u>-</u>	2"	2"	
-	AUTOMATIC FLUSH VALVE SLOAN EBV-500-A AUTO FLUSH MODULE					
TANK TYPE WATER CLOSET (WC)	WHITE, TANK TYPE, PRESSURE ASSISTED, FLOOR MOUNTED WITH ELONGATED BOWL, 12" ROUGH-IN: KOHLER #K-3505 CRANE #38355, ELJER #091-7025, AMERICAN STANDARD #2467.016.020.	1/2"	<u>-</u>	4"	2"	
	WHITE OPEN FRONT SEAT: KOHLER #K-4670-C, OLSONITE #95CT000, CHURCH #9500SSCT.			-		
TANK TYPE WATER CLOSET FOR HANDICAPPED (WC-H)	WHITE, TANK TYPE, PRESSURE ASSISTED, FLOOR MOUNTED WITH ELONGED BOWL, 12" ROUGH-IN, HANDLE ON WIDE SIDE OF STALL. KOHLER #K-3544, CRANE #3838, EJER #091-3275, AMERICAN STANDARD #2325.101. WHITE OPEN FRONT SEAT:	1"		2"	1-1/2"	
	KOHLER #K-4670-C, OLSONITE #95SS, CHURCH #9500C.		·			
EWC	ELECTRIC WATER COOLER WALL HUNG DOUBLE-SPLIT STATION UNIT 1 UNIT MOUNTED @ STANDARD HEIGHT 0F 42" FROM FINISHED FLOOR TO TOP OF SPOUT. AND THE OTHER SECTION MOUNTED @ HANDICAP HEIGHT 0F 36" FROM FINISHED FLOOR TO TOP OF SPOUT. PROVIDE WITH STEEL, FLOOR MOUNTED CARRIER, POLISHED CHROME FINISH BRASS TRAP/TAILPIECE & STOPS. PROVIDE & INSTALL WHITE CLOSE CELL FOAM ADA COMPLIANT PIPING COVERS FOR ALL EXPOSED PIPING.	1/2"		2"	2"	
	HALSEY TAYLOR: HAC8BLPV (DOUBLE)					
	HALSEY TAYLOR : HHAC8PVNF (SINGLE)					
WF	WATER FOUNTAIN WALL HUNG DOUBLE-SPLIT STATION UNIT 1 UNIT MOUNTED @ STANDARD HEIGHT 0F 42" FROM FINISHED FLOOR TO TOP OF SPOUT. AND THE OTHER SECTION MOUNTED @ HANDICAP HEIGHT 0F 36" FROM FINISHED FLOOR TO TOP OF SPOUT. PROVIDE WITH STEEL, FLOOR MOUNTED CARRIER, POLISHED CHROME FINISH BRASS TRAP/TAILPIECE & STOPS. PROVIDE & INSTALL WHITE CLOSE CELL FOAM ADA COMPLIANT PIPING COVERS FOR ALL EXPOSED PIPING.	1/2"	-	2"	2"	
	HALSEY TAYLOR: HACDBLPVLR (DOUBLE) HALSEY TAYLOR: HHRFE (SINGLE)					
EWC-BF	DOUBLE WATER COOLER/BOTTLE FILLER					
	WALL HUNG DOUBLE-SPLIT STATION UNIT 1 UNIT MOUNTED @ STANDARD HEIGHT 0F 42" FROM FINISHED FLOOR TO TOP OF SPOUT. AND THE OTHER SECTION MOUNTED @ HANDICAP HEIGHT 0F 36" FROM FINISHED FLOOR TO TOP OF SPOUT. PROVIDE WITH STEEL, FLOOR MOUNTED CARRIER, POLISHED CHROME FINISH BRASS TRAP/TAILPIECE & STOPS. PROVIDE & INSTALL WHITE CLOSE CELL FOAM ADA COMPLIANT PIPING COVERS FOR ALL EXPOSED PIPING.	1/2"	-	2"	2"	

HALSEY TAYLOR: HHTHBHAC8PVNF (SINGLE)

WATER COOLER REPLACEMENT IS NOT TYPICALLY INCLUDED WITHIN THE SCOPE OF A RESTROOM REMODEL, HOWEVER, IF THE LOCATION DOES NOT HAVE A WATER COOLER WITH BOTTLE FILLER WITHIN THE BANK OF WATER COOLERS OUTSIDE THE

HALSEY TAYLOR: HTHB-HAC8BLPV-NF (LEFT HAND FILLER)

SINGLE WATER COOLER/BOTTLE FILLER

HALSEY TAYLOR: HHTHBHAC8BLRPVNF (RIGHT HAND FILLER)

PLUMBING GENERAL NOTES

- ALL PLUMBING WORK SHALL COMPLY WITH THE LATEST EDITION OF THE APPLICABLE PLUMBING CODES INCLUDING ALL AMENDMENTS, LOCAL ORDINANCES AND FEDERAL CODES AND ORDINANCES.
- ALL WORK SHALL BE PERFORMED BY QUALIFIED TECHNICIANS EXPERIENCED IN THE PLUMBING TRADE. ALL WORK WILL BE INSTALLED IN A NEAT AND WORKMAN-LIKE MANNER ACCORDING TO RECOGNIZED TRADE PRACTICES.
- THE DRAWINGS ARE DIAGRAMMATIC AND INDICATE THE GENERAL LOCATION OF EQUIPMENT, PIPES, VALVES, ETC. IT IS THE INTENT OF THESE DRAWINGS AND SPECIFICATIONS THAT COMPLETE PLUMBING SYSTEMS BE FURNISHED, INSTALLED, TESTED AND READY FOR OPERATION. WHETHER OR NOT EVERY ITEM FOR THE REQUIRED EQUIPMENT, ACCESSORIES, AND PLUMBING DEVICES ARE SHOWN. REFERENCE SHALL BE MADE TO THE FULL DRAWING PACKAGE INCLUDING ARCHITECTURAL, STRUCTURAL, ELECTRICAL, FIRE PROTECTION AND SITE DRAWINGS FOR COORDINATION AND POSSIBLE CONFLICTS. THE PLUMBING SUB-CONTRACTOR SHALL, WITHOUT EXTRA CHARGES, MAKE REASONABLE MODIFICATIONS IN THE LAYOUT AS NEEDED TO PREVENT CONFLICTS WITH OTHER TRADES, OR FOR PROPER EXECUTION OF THE WORK. FIELD VERIFY ALL DIMENSIONS BEFORE FABRICATING ANY PIPE WORK.
- GENERAL CONTRACTOR IS RESPONSIBLE FOR VERIFYING HOT WATER SOURCE AVAILABLE, ADDITIONALLY A NEW MIXING VALVE WILL BE REQUIRED FOR ALL NEW SINKS.


KEYED NOTES

- (1) EXISTING FIXTURE "EWH" TO REMAIN IN PLACE AND BE OPERATIONAL.
- $\langle 2 \rangle$ EXTEND EXISTING PIPES AS REQUIRED.
- (3) EXISTING FIXTURE "WC-H" TO BE REMOVED AND PROPERLY DISPOSED OF, CONTRACTOR TO VERIFY EXISTING FLUSH VALVE IS OPERATIONAL FOR REUSE WITH NEW FIXTURE.
- $\langle 4 \rangle$ EXISTING FIXTURE "WC" TO BE REMOVED AND PROPERLY DISPOSED OF, CONTRACTOR TO VERIFY EXISTING FLUSH VALVE IS OPERATIONAL FOR REUSE WITH NEW FIXTURE.
- \$\langle 5 \rangle \text{ EXISTING FIXTURE "URN" TO BE REMOVED AND PROPERLY DISPOSED OF, CONTRACTOR TO VERIFY EXISTING FLUSH VALVE IS OPERATIONAL FOR REUSE WITH NEW FIXTURE.
- (6) EXISTING FIXTURE "EWC" TO BE REMOVED AND PROPERLY DISPOSED OF.
- (7) EXISTING FIXTURE "WF" TO BE REMOVED AND PROPERLY DISPOSED OF.
- (8) EXISTING FIXTURE "MOP" TO REMAIN IN PLACE AND BE OPERATIONAL.
- (9) NEW FIXTURE "WC-H" AT NEW LOCATION. MODIFY EXISTING PLUMBING AS REQUIRED.
- (10) NEW FIXTURE "WC" AT NEW LOCATION. MODIFY EXISTING PLUMBING AS REQUIRED.
- $\langle 11 \rangle$ NEW FIXTURE "URN" AT NEW LOCATION, MODIFY EXISTING PLUMBING AS REQUIRED.
- $\langle 12 \rangle$ NEW FIXTURE "URN-H" AT NEW LOCATION. MODIFY EXISTING PLUMBING AS REQUIRED. (13) NEW FIXTURE "LAV" AT NEW LOCATION. MODIFY EXISTING PLUMBING AS REQUIRED.
- (14) NEW FIXTURE "WF" AT NEW LOCATION. MODIFY EXISTING PLUMBING AS REQUIRED.
- $\langle 15 \rangle$ NEW FIXTURE "EWC" AT NEW LOCATION. MODIFY EXISTING PLUMBING AS REQUIRED.
- (16) NEW FIXTURE "EWH" AT NEW LOCATION. MODIFY EXISTING PLUMBING AS REQUIRED. (17) NEW FIXTURE "UNI-LAV" AT NEW LOCATION. MODIFY EXISTING PLUMBING AS REQUIRED.
- (18) NEW FIXTURE "EWC-BF" AT NEW LOCATION. MODIFY EXISTING PLUMBING AS REQUIRED.

NOTE TO BIDDERS: THESE CONTRACT DOCUMENTS HAVE BEEN DESIGNED AND DRAWN ASSUMING EXISTING BUILDING CONDITIONS MATCH THE ORIGINAL DRAWINGS. IT HOWEVER, REMAINS THE RESPONSIBILITY OF THE CONTRACTOR TO VERIFY ALL EXISTING CONDITIONS PRIOR TO SUBMISSION OF A BID AND TO THE FOUND BETWEEN WHAT IS SHOWN ON THE DRAWINGS AND THE EXISTING FIELD CONDITIONS SHALL BE BROUGHT TO THE ATTENTION OF THE GENERAL CONTRACTOR OR LOWE'S PROJECT MANAGER TO DETERMINE WHAT ACTION SHOULD BE TAKEN.


PRCTI20221628

City of Puyallup **Development & Permitting Services ISSUED PERMIT** Building Planning Engineering **Public Works** Traffic Fire

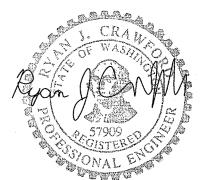



DATE DESCRIPTION

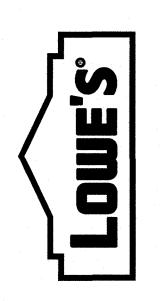

PROJECT NUMBER: 2219006

PROJECT LOCATION:

ISSUE DATE:

10.14.22

SHEET TITLE:

DEMOLITION PLUMBING RESTROOM REMODEL

SHEET NUMBER:

PRCTI20221628



(D.19)

WOMEN'S

ROOM #2

MANAGER

City of Puyallup Development & Permitting Services ISSUED PERMIT			
Building	Planning		
Engineering	Public Works		
	0/		

		2. FASTENING OF ANYTHING TO THE METAL ROOF DECK IS PROHIBITED. ANY CONTRACTOR RESPONSIBLE FOR DRILLING, PUNCHING, OR OTHERWISE PENETRATING THE METAL ROOF DECK WILL BE REQUIRED TO REPLACE (NOT REPAIR) THE
City of Puyallup evelopment & Permitting Services ISSUED PERMIT		COMPLETE VINNING OF CHEMICAGO CHOWN ON THESE BIV WINGOAND AG ESTIMED.
Building	Planning	4. THE INSTALLATION SHALL COMPLY WITH THE CURRENT EDITION OF THE NATIONAL ELECTRICAL CODE (NEC), STATE AND LOCAL CODES.
Share		5. ALL MATERIALS SHALL BE NEW AND SHALL BE LISTED BY THE UNDERWRITER'S

THOSE SPECIFIED IN THE N.E.C.

02 1/4" = 1'-0"

SOURCE:

KEYED NOTES

GENERAL NOTES

LABORATORIES, INC (UL).

WALLS, CEILINGS, OR FLOORS.

DOORS AS REQUIRED FOR ELECTRICAL WORK.

INDICATED) FROM PANEL BOARD TO FIRST OUTLET.

TRADES AND POSSIBLE ADDITIONAL ELECTRICAL WORK.

- (1) EXISTING LIGHTING FIXTURES TO REMAIN IN PLACE AND OPERATIONAL.
- $\langle 2 \rangle$ PAPER TOWEL DISPENSER.
- (3) SEE ARCHITECTURAL SHEETS FOR EXACT LOCATIONS OF THE NEW HAND DRYERS.

6. THE ELECTRICAL SUBCONTRACTOR SHALL ARRANGE FOR AND PAY FOR ALL INSPECTION FEES AND INSPECTIONS. SUBMIT COPY OF FINAL INSPECTION REPORT TO LOWE'S PROJECT

7. ALL RACEWAYS SHALL BE RUN PARALLEL OR PERPENDICULAR TO STRUCTURAL MEMBERS,

8. PROVIDE ALL EXPANSION FITTINGS, PITCH POCKETS, EQUIPMENT SUPPORTS, AND ACCESS

9. ALL CONDUIT BELOW CONCRETE SLABS OR EXTENDED ON MASONRY WALLS SHALL BE RIGID,

10. PROVIDE EQUIPMENT LABELS FOR DISCONNECT SWITCHES, WIRING TROUGHS, ETC. TO IDENTIFY EQUIPMENT OR EQUIPMENT SERVICE. LABELS SHALL BE 1/8" THICK OF PHENOLIC

11. ALL CONDUCTORS SHALL BE COPPER, TYPE THHN/THWN. WIRE FOR CONNECTION TO LIGHTING FIXTURES SHALL BE AS REQUIRED BY THE U.L. LABEL. NO. 12 AWG SHALL BE THE MINIMUM SIZE USED FOR POWER WIRING. NO.14 AWG MAY BE USED FOR CONTROL WIRING ONLY. 120 AND 277 VOLT CIRCUITS IN EXCESS OF 100' SHALL BE #10 AWG (OR LARGER AS

12. REFER TO ARCHITECTURAL AND PLUMBING SHEETS FOR COORDINATION WITH OTHER

13. ALL CONDUIT SHALL BE RUN IN THE AREA ABOVE THE BOTTOM CHORD OF THE ROOF JOISTS

USING MANUFACTURER APPROVED CLIPS, HANGERS, TRAPEZE, ETC. (SEE NOTE 7 ABOVE). CONDUIT MAY REST ON BOTTOM CHORD OF JOISTS, BUT MAY NOT BE SUSPENDED BELOW THE JOIST. ALL CONDUIT MUST BE ANCHORED AND FASTENED AT INTERVALS NOT EXCEEDING


HOT-DIPPED GALVANIZED STEEL CONDUIT OR RIGID CODE APPROVED PVC.

MATERIAL, MACHINE ENGRAVED TO EXPOSE CONTRASTING INNER CORE.


- 4 EXISTING DISCONNECT TO REMAIN IN PLACE AND OPERATIONAL.
- (5) EXISTING POWER FOR WATER COOLER TO REMAIN IN PLACE AND OPERATIONAL.

(6) EXISTING POWER FOR DEVICES/EQUIPMENT TO REMAIN IN PLACE AND OPERATIONAL.


NOTE TO BIDDERS:
THESE CONTRACT DOCUMENTS HAVE BEEN DESIGNED AND DRAWN ASSUMING EXISTING BUILDING CONDITIONS MATCH THE ORIGINAL DRAWINGS. IT HOWEVER, REMAINS THE RESPONSIBILITY OF THE CONTRACTOR TO VERIFY ALL EXISTING CONDITIONS PRIOR TO SUBMISSION OF A BID AND TO THE COMMENCEMENT OF ANY WORK. ANY DISCREPANCIES FOUND BETWEEN WHAT IS SHOWN ON THE DRAWINGS AND THE EXISTING FIELD CONDITIONS SHALL BE BROUGHT TO THE ATTENTION OF THE GENERAL CONTRACTOR OR LOWE'S PROJECT MANAGER TO DETERMINE WHAT ACTION SHOULD BE TAKEN.

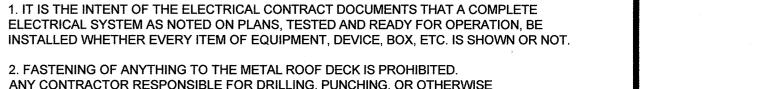



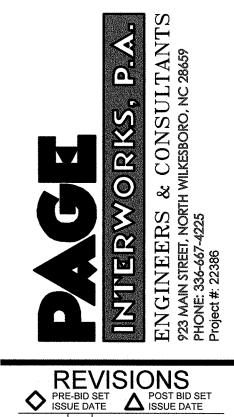

DATE DESCRIPTION

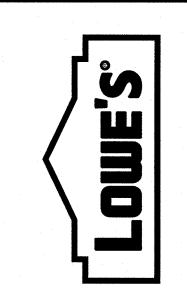

PROJECT NUMBER:

PROJECT LOCATION:


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ISSUE DATE:

SHEET TITLE:

LIGHTING/POWER PLAN RESTROOM REMODEL

SHEET NUMBER:

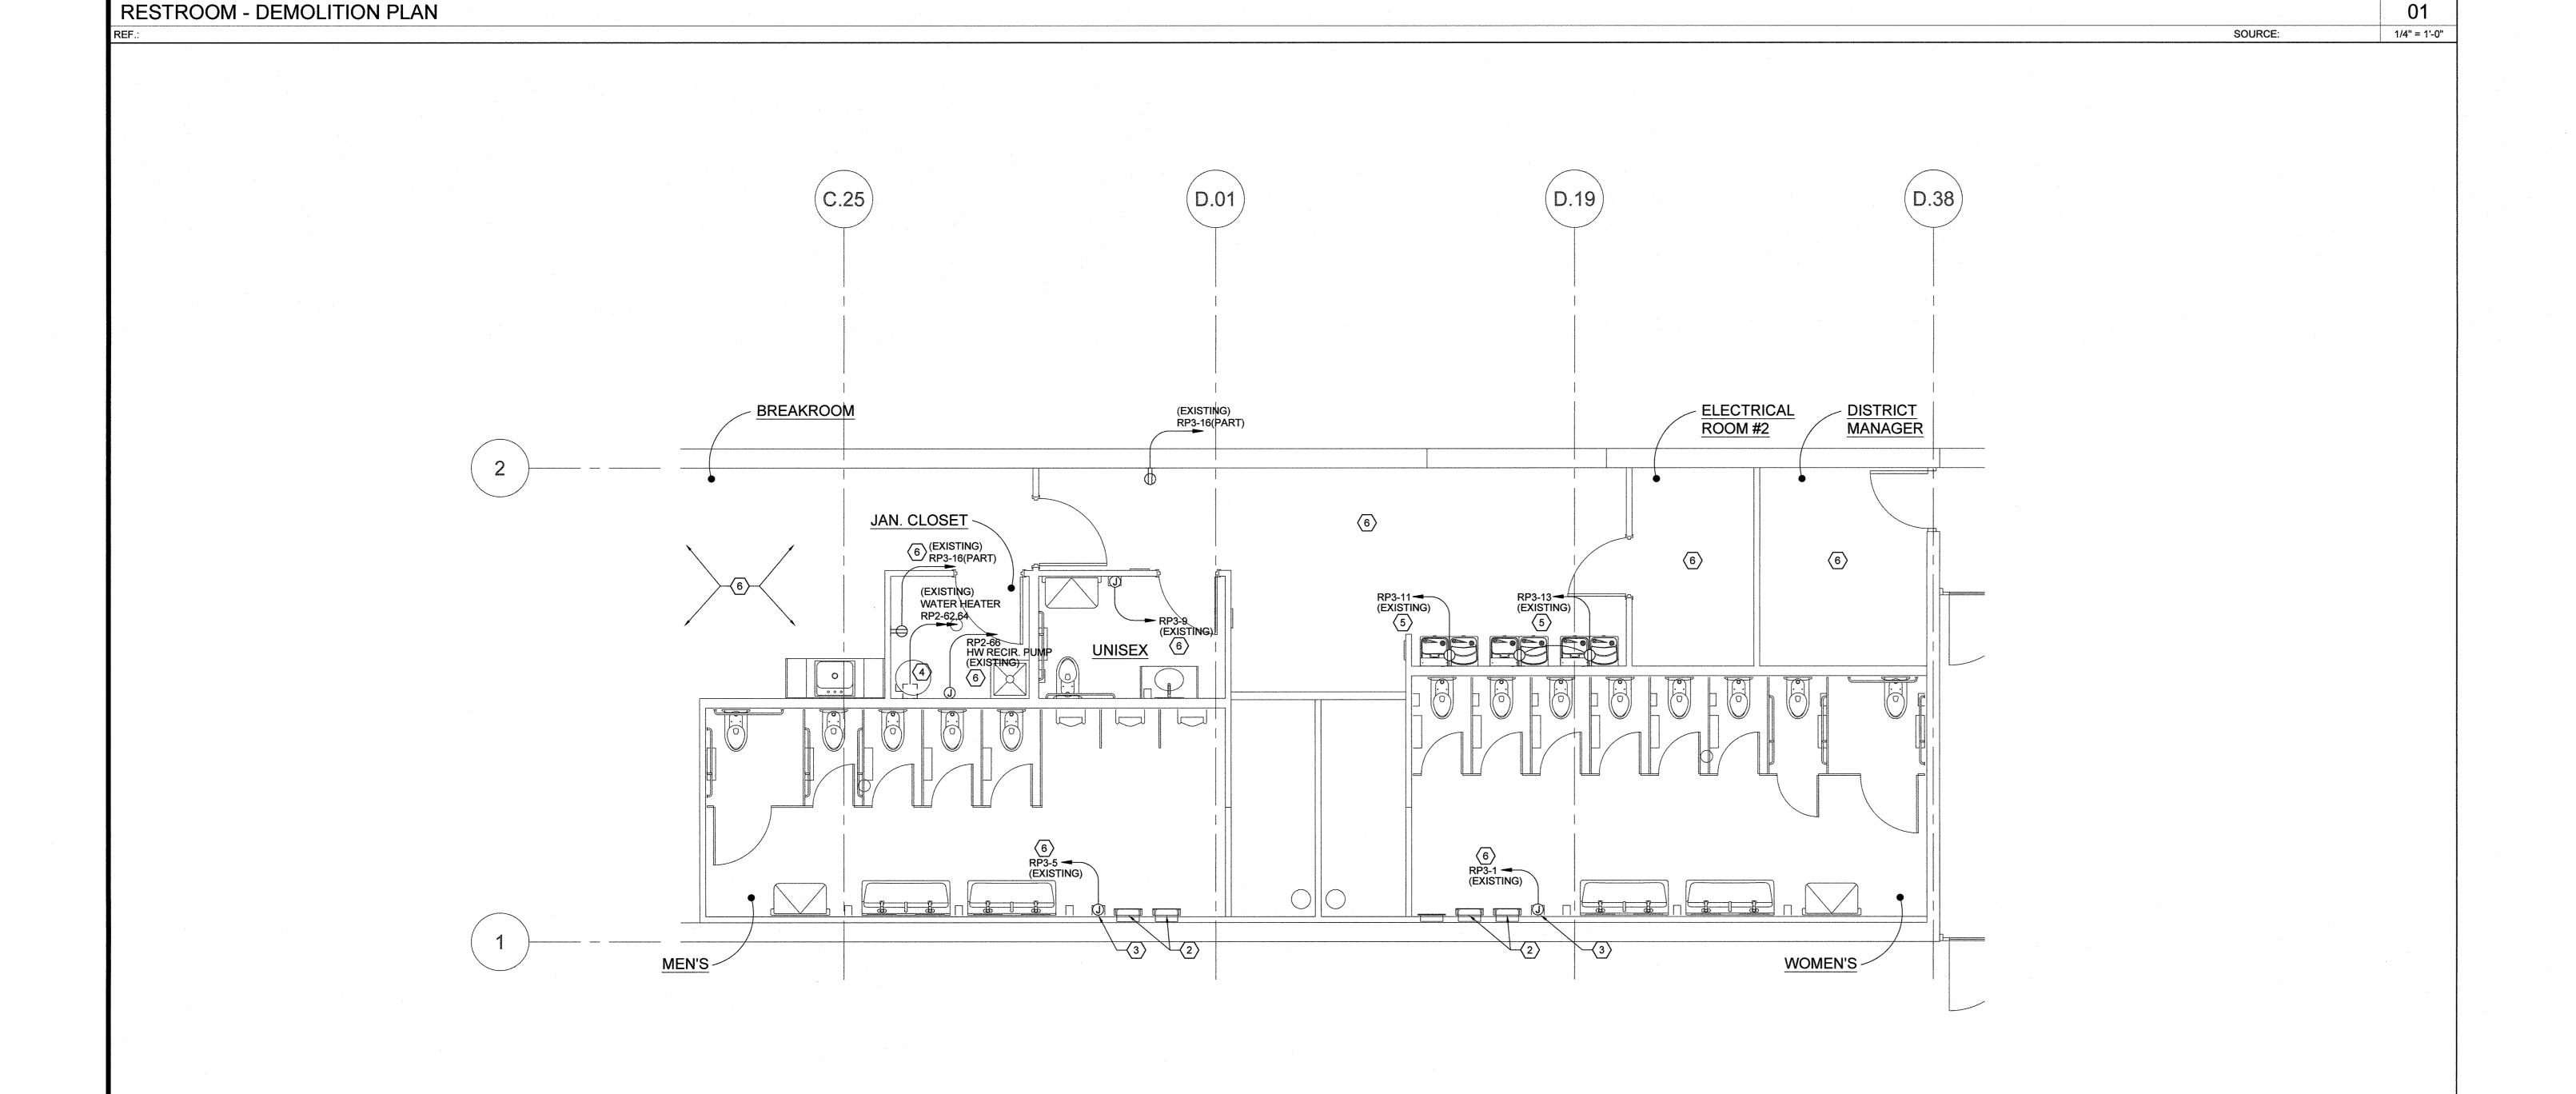

BREAKROOM

RESTROOM - POWER PLAN